

# WARWICK VALLEY CENTRAL SCHOOL DISTRICT

## FEDERAL GRANT/ CAPITAL BOND HIGH SCHOOL UNIT VENTILATOR REPLACEMENT AND AIR CONDITIONING UPGRADE

225 WEST STREET EXT, WARWICK, NY 10990

ISSUED FOR BID - DATE: 11/09/2022




LOCATION PLAN

LIST OF DRAWINGS:


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ENGINEER:



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
CONSULTANT(S):



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HIGH SCHOOL UNIT VENTILATOR REPLACEMENT AND  
AIR CONDITIONING UPGRADE  
225 WEST STREET EXT, WARWICK, NY 10990  
WV HIGH SCHOOL - 89 SANFORDVILLE ROAD, WARWICK, NY 10990  
SED NO. 44-21-01-06-0-001-042


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CHECKED BY	
SHEET SIZE	30" X 42"
SCALE	AS NOTED
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SHEET NO.	CP

FILE PATH - N:\1 - PROJECT DIRECTORIES\1 - E &amp; R Projects\05 - Warwick Valley CSD\05-21-04 Warwick Federal Grant Project\CAD\Packaging\105-21-04 COVER - Page 3.dwg





1 PARTIAL ROOF PLAN  
SCALE: 1/8" = 1'-0"

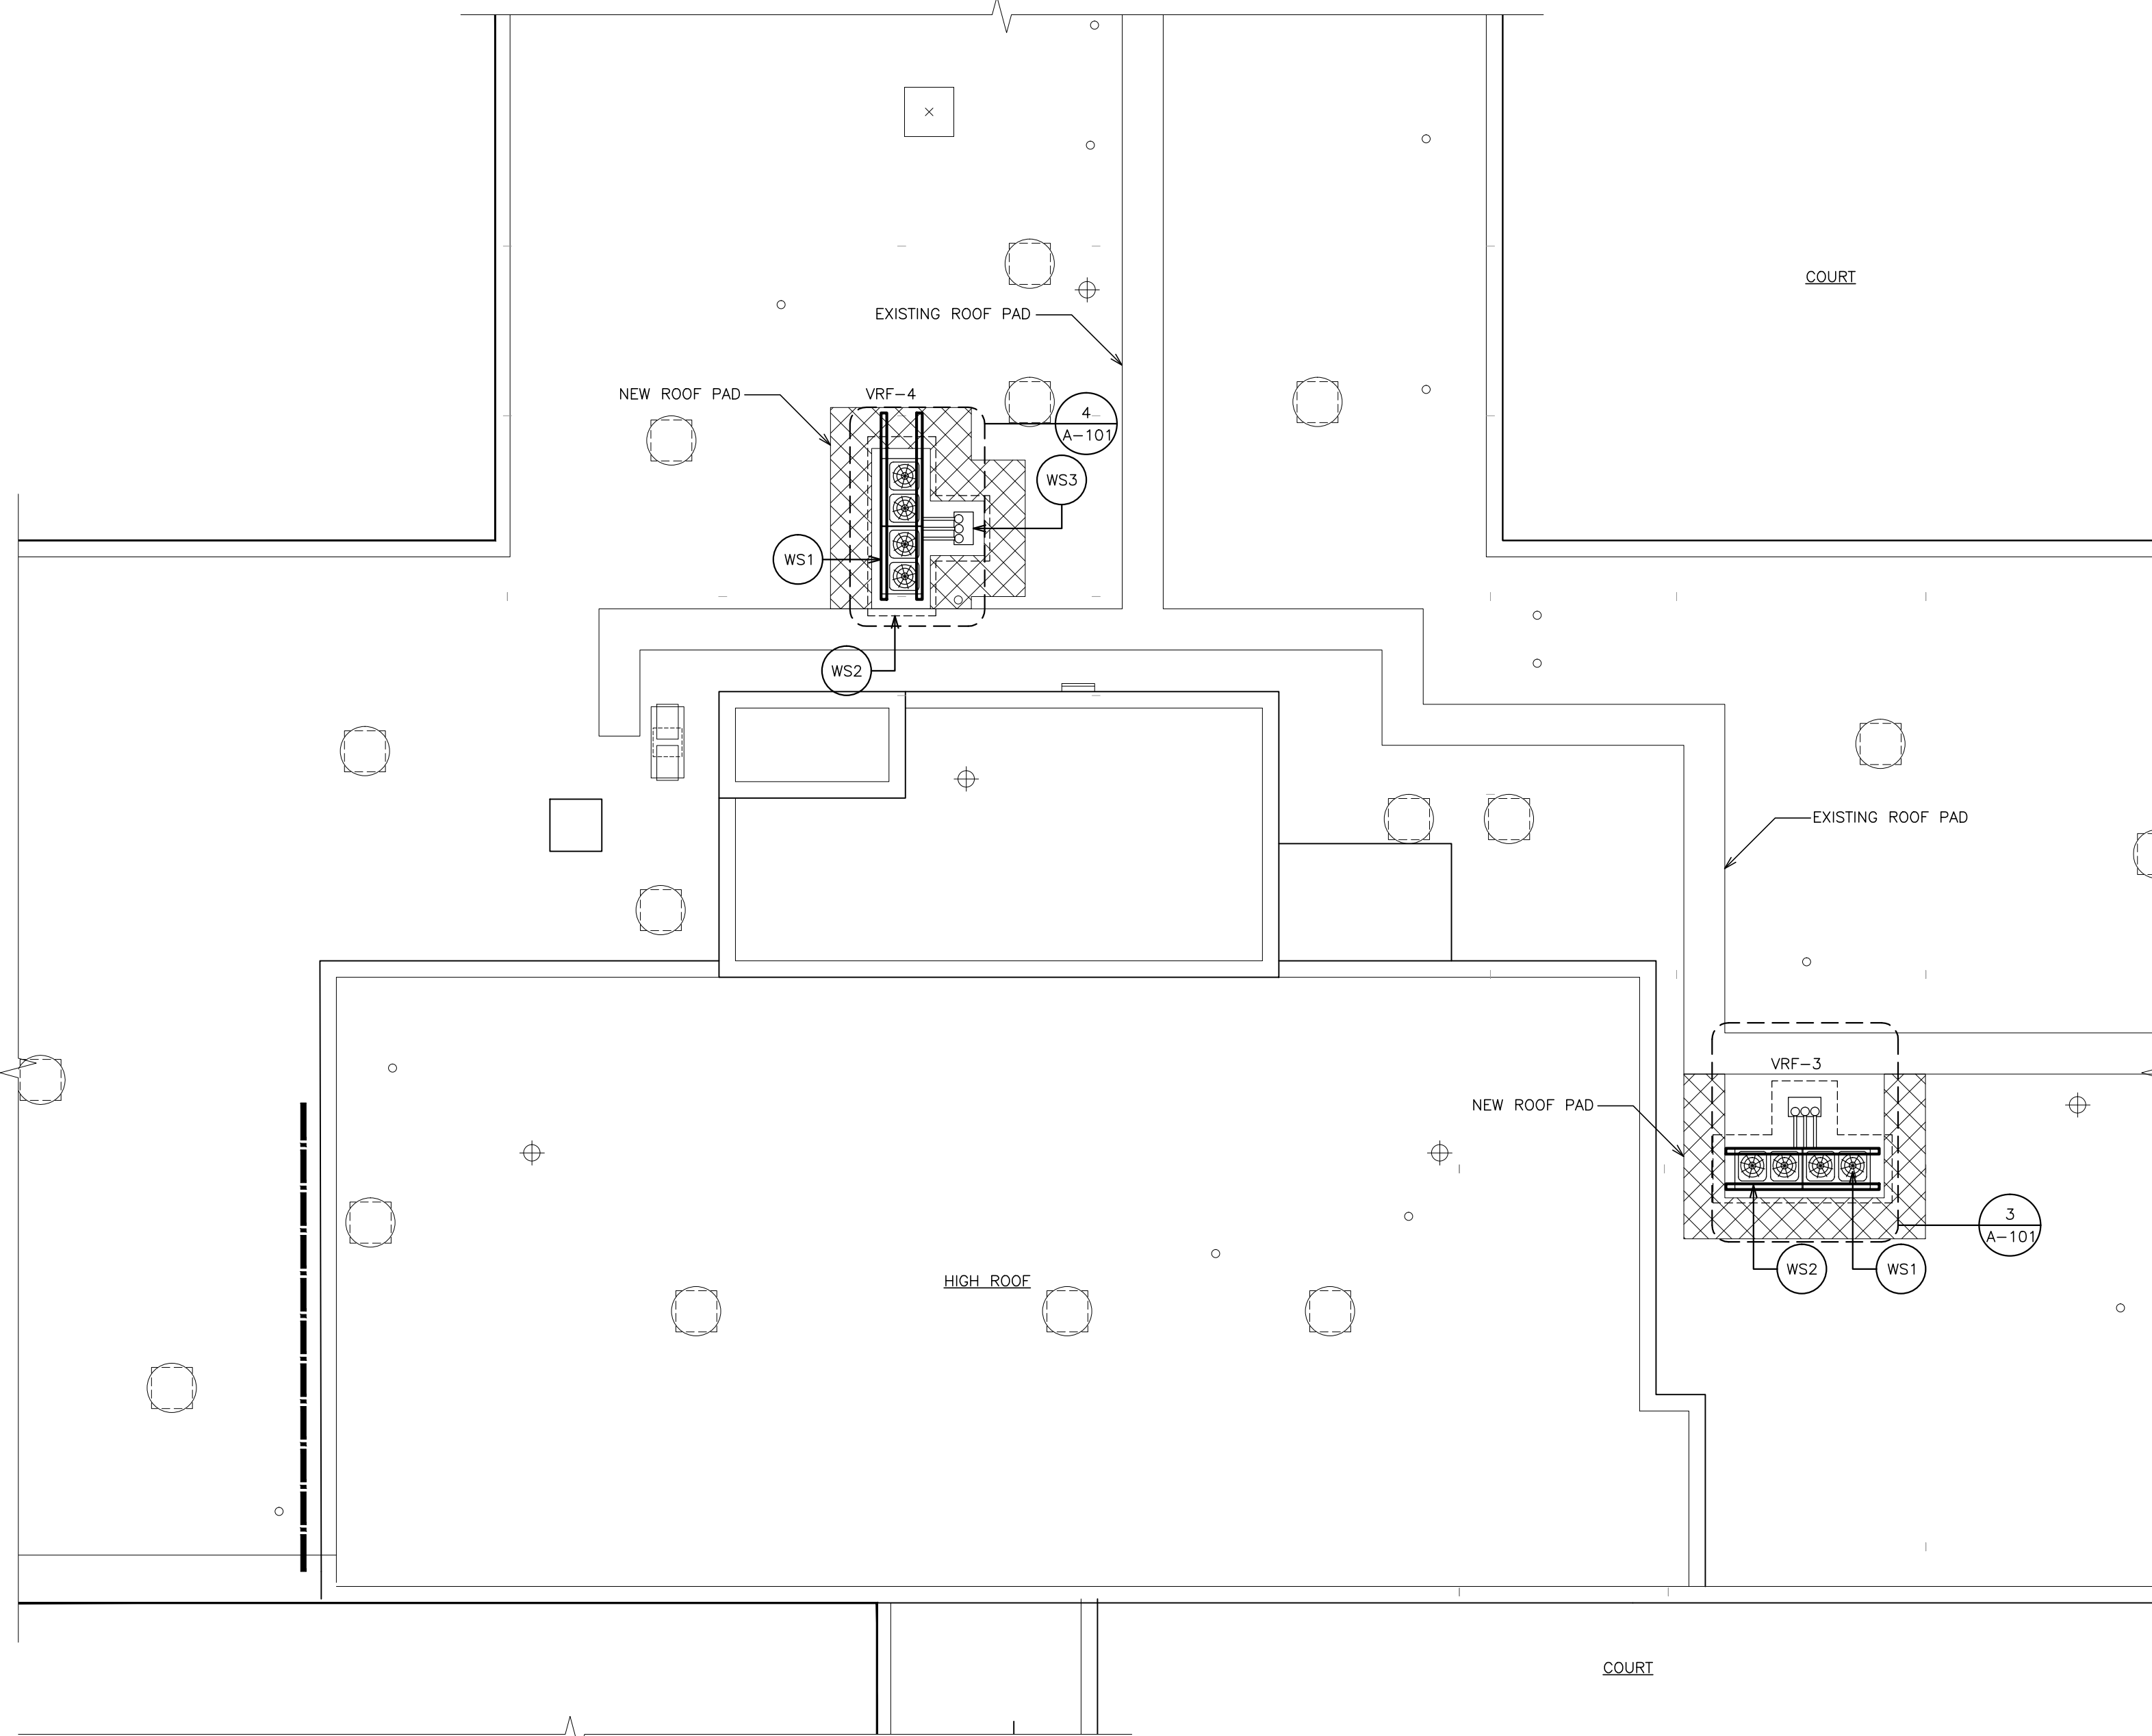


2 PARTIAL ROOF PLAN  
SCALE: 1/8" = 1'-0"

- WORKSCOPE NOTES**
- WS1 NEW HEAT PUMP BY H-CONTRACTOR. COORDINATE WITH MECHANICAL CONTRACTOR FOR LOCATION.
  - WS2 REMOVE EXISTING ROOFING, INSTALL NEW CURB PROVIDED BY H-CONTRACTOR. SEE DETAIL 5/A-101.
  - WS3 NEW PIPE PORTAL. COORDINATE WITH MECHANICAL CONTRACTOR. SEE DETAIL 6/A-101.

- LEGEND:**
- EXISTING ROOF DRAIN
  - EXISTING VENT PIPE
  - EXISTING EXHAUST FAN.
  - PITCH POCKE
  - EXISTING ROOF LADDER
  - EXISTING SKYLIGHT
  - WALKWAY PADS. SEE SPECIFICATIONS
  - EXISTING ROOF HATCH.

NOTE:  
BASF SPRAY POLYURETHANE  
FOAM ROOF WARRANTIED  
THROUGH AUGUST 2026.

LOCAL MAINTENANCE BY:  
A to Z COATINGS  
(570) 558-0932

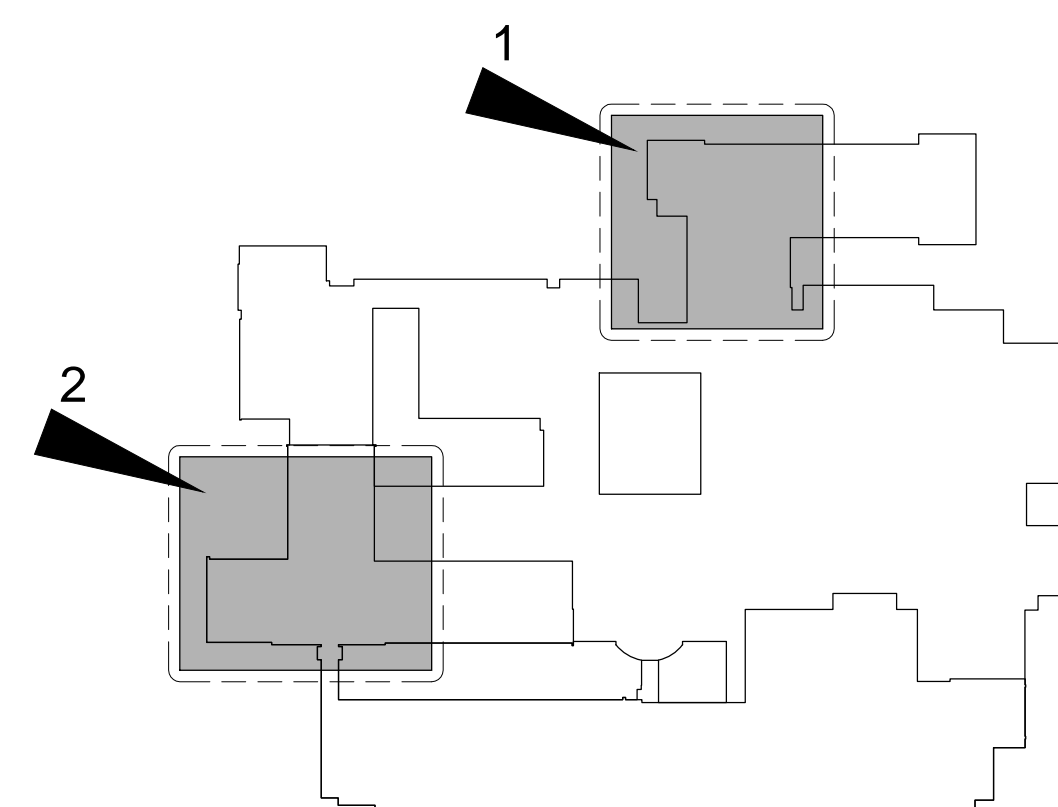


HIGH SCHOOL  
KEY PLAN  
SCALE N.T.S.

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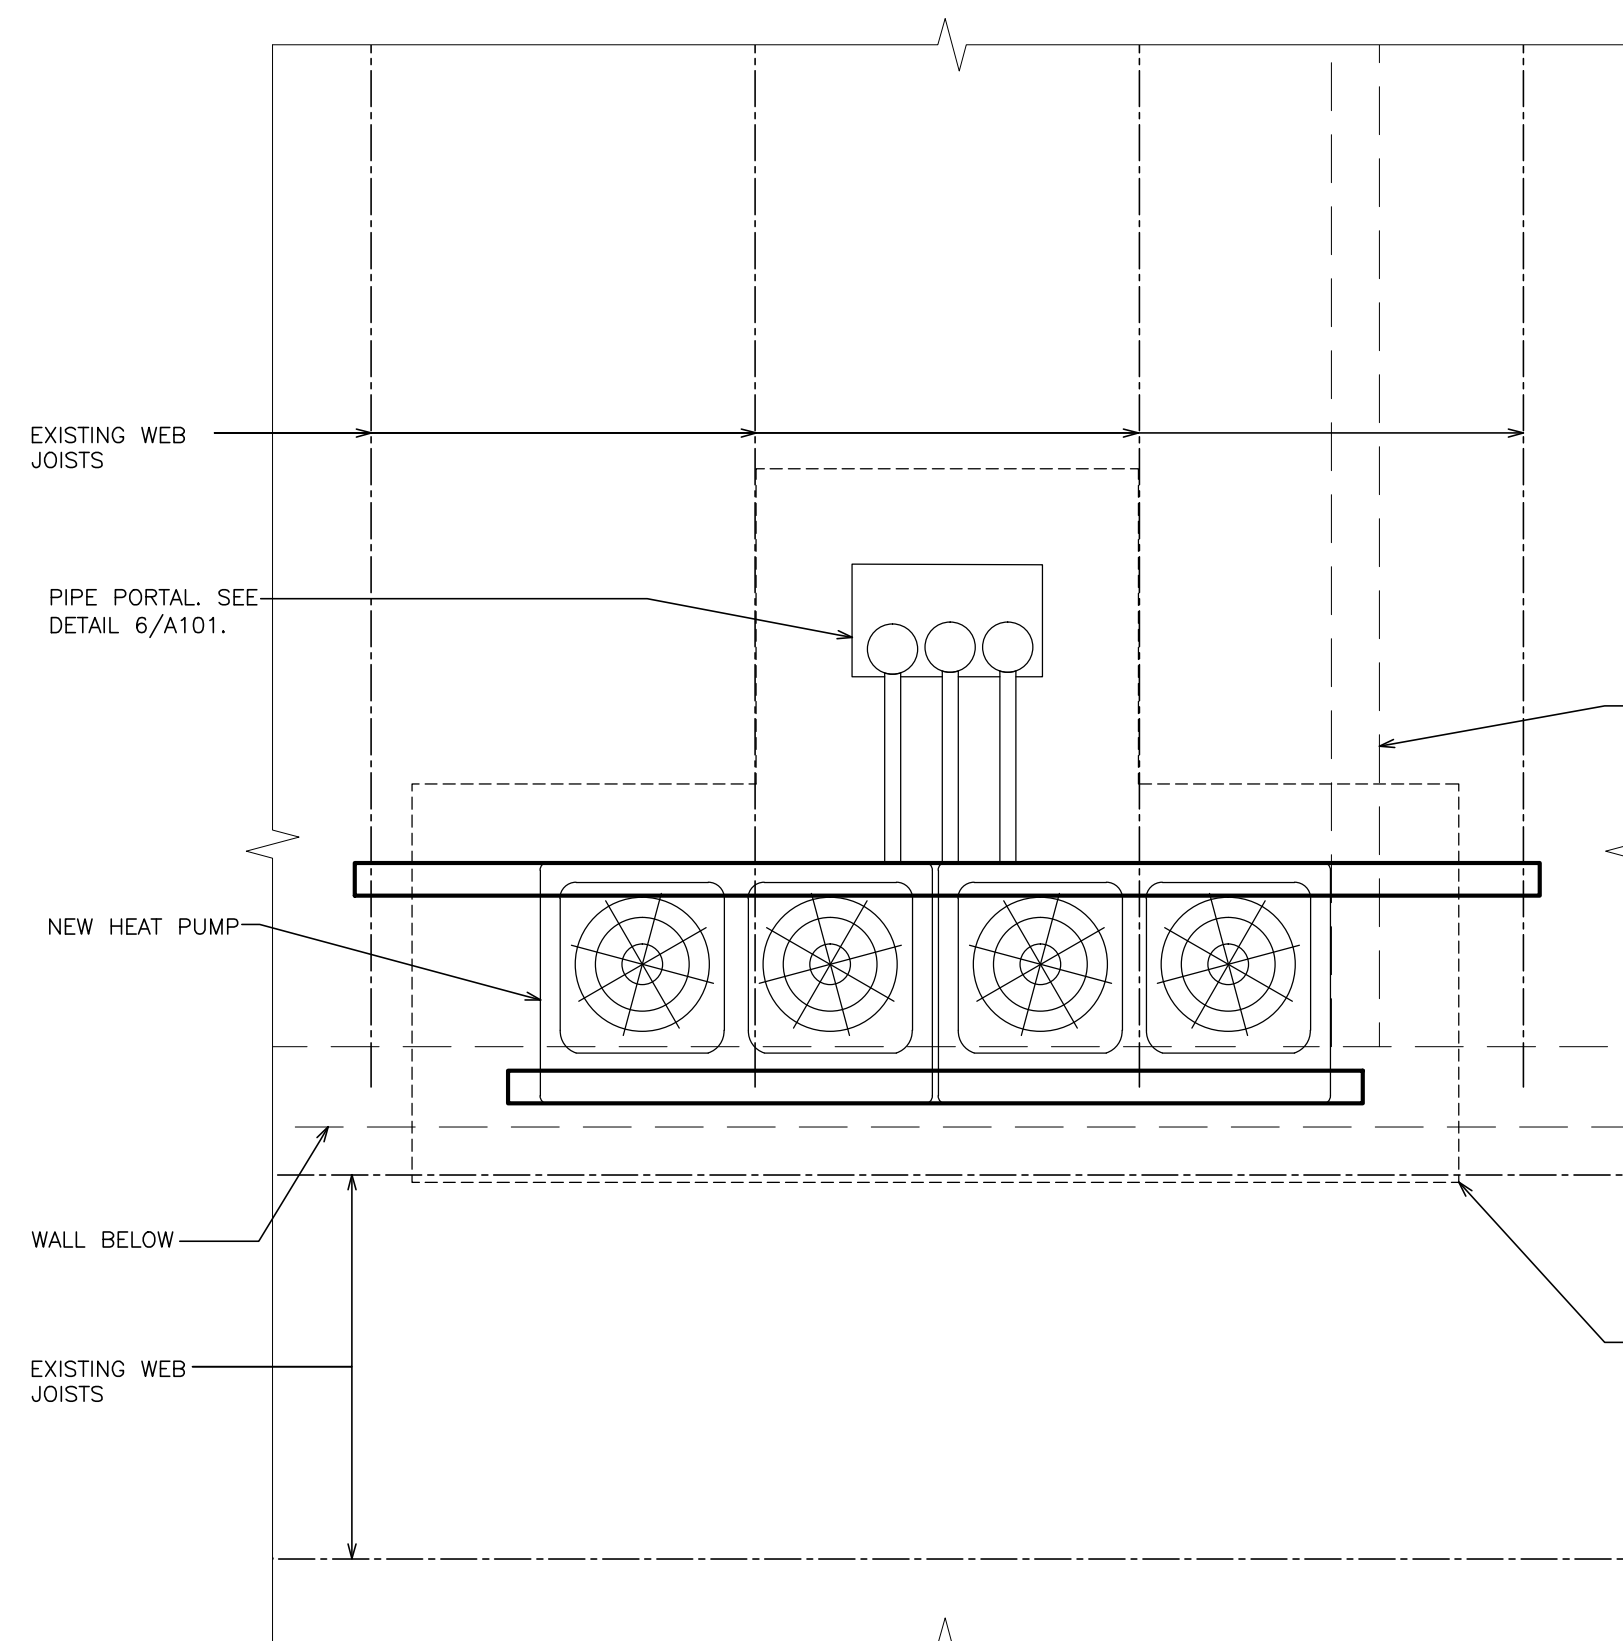


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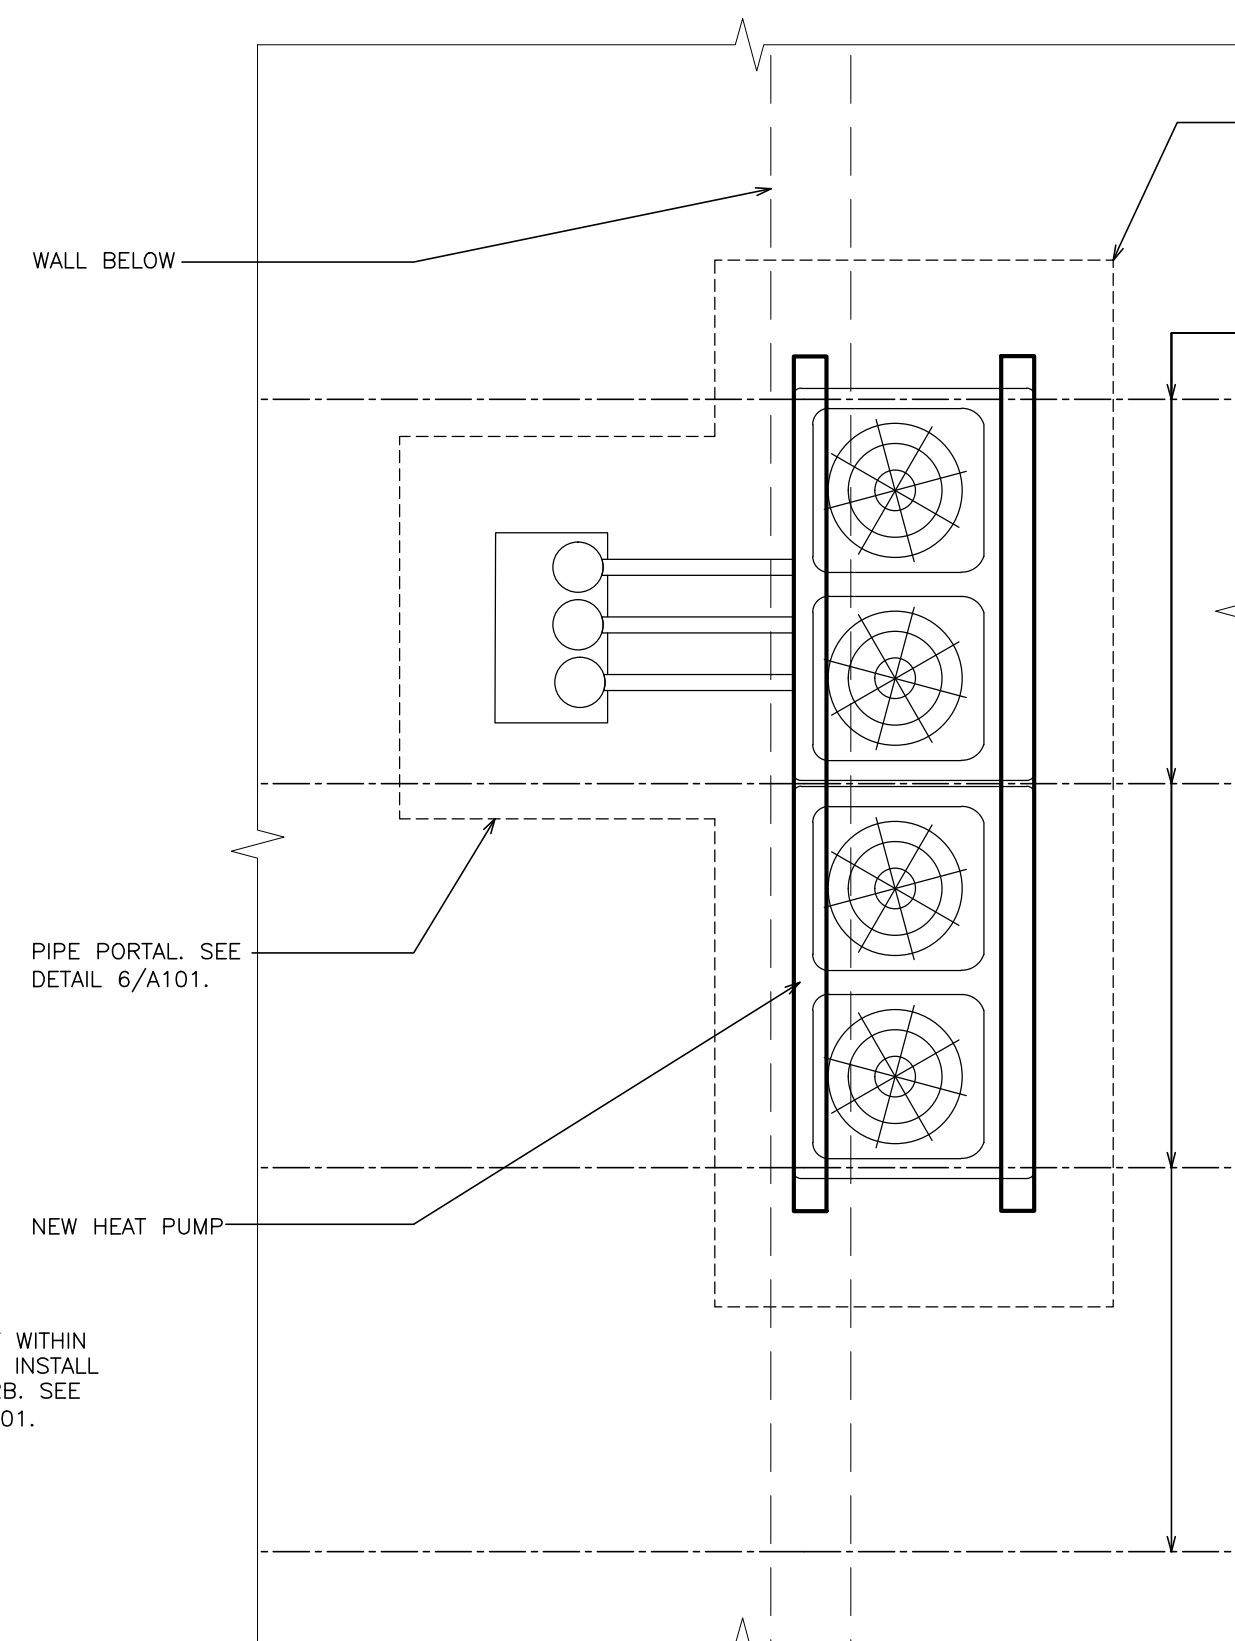
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WARWICK VALLEY  
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PARTIAL ROOF  
PLANS


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**WVHS  
A-100**

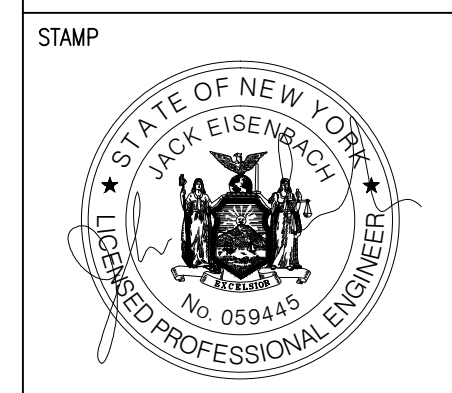


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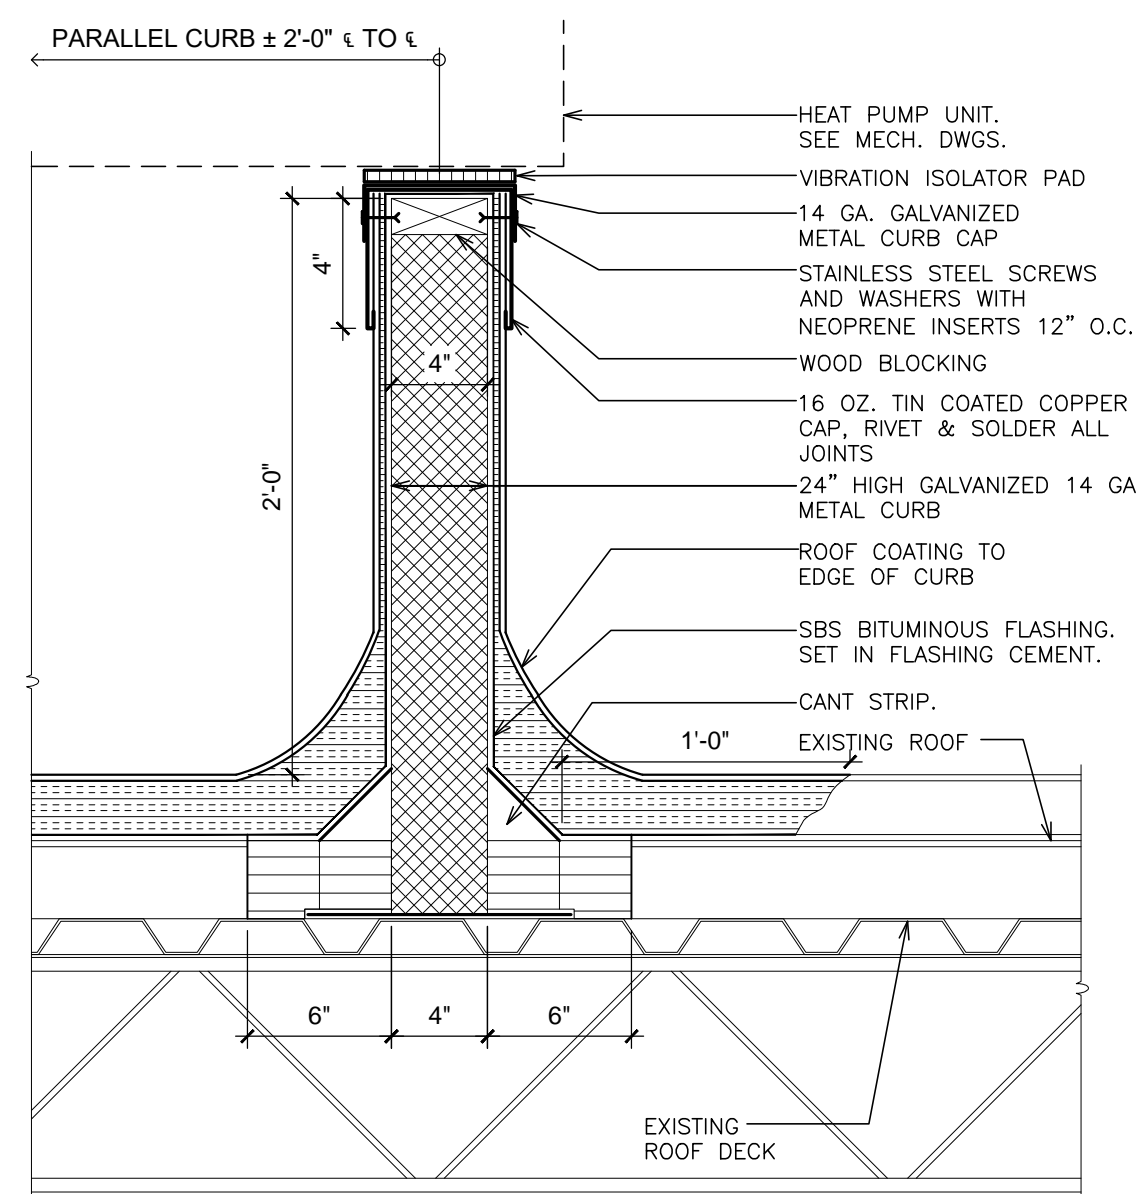
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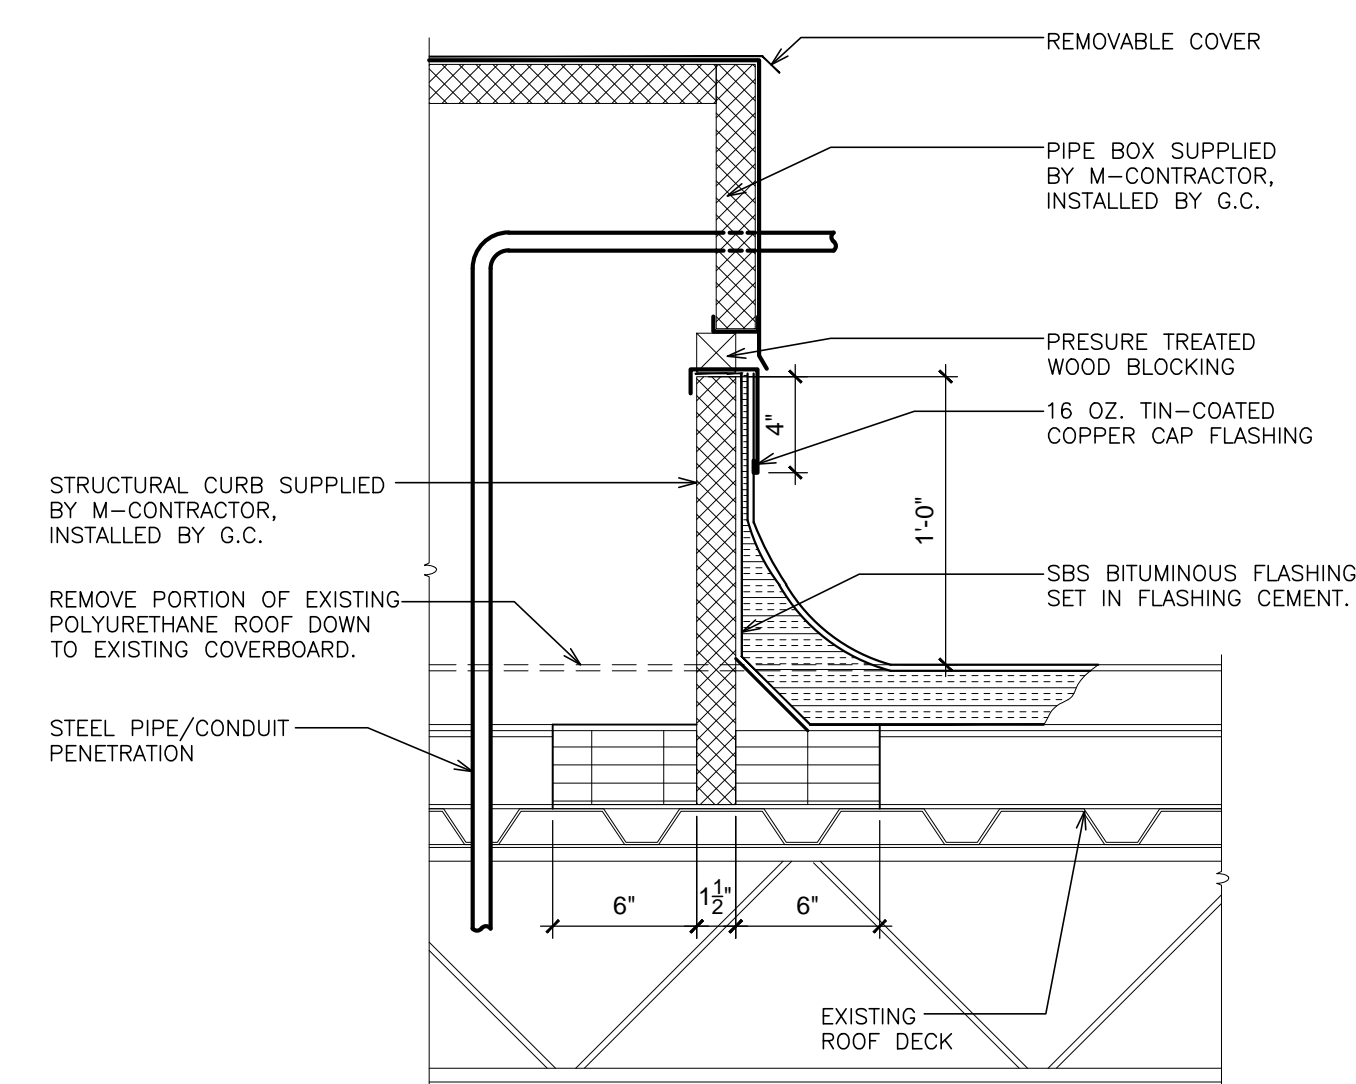
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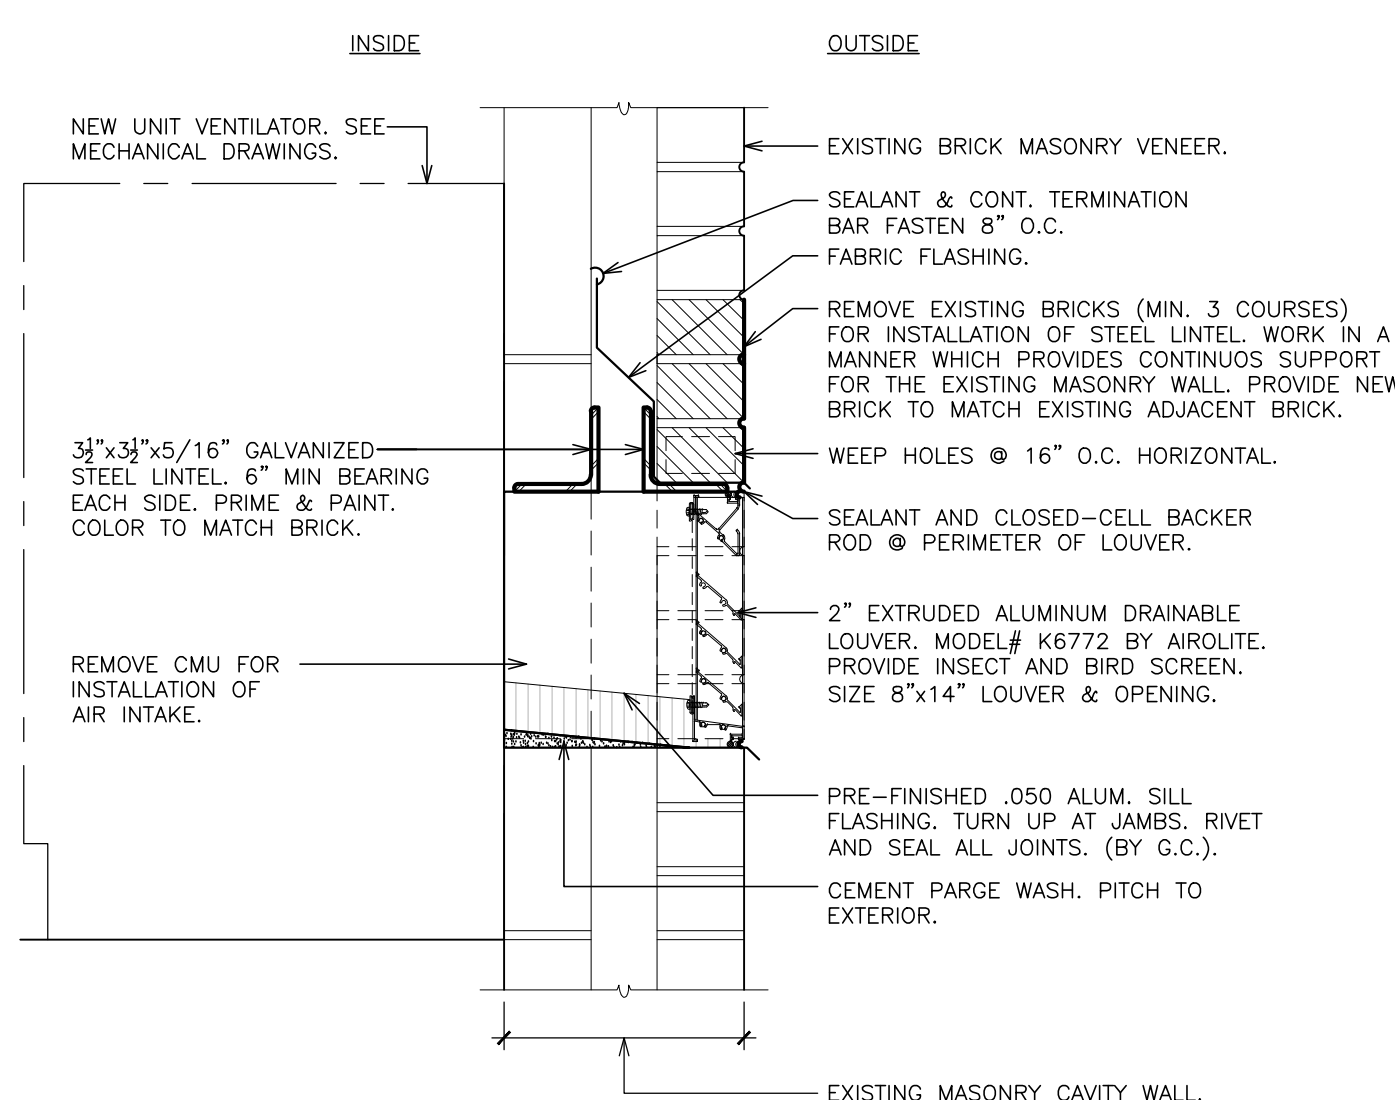
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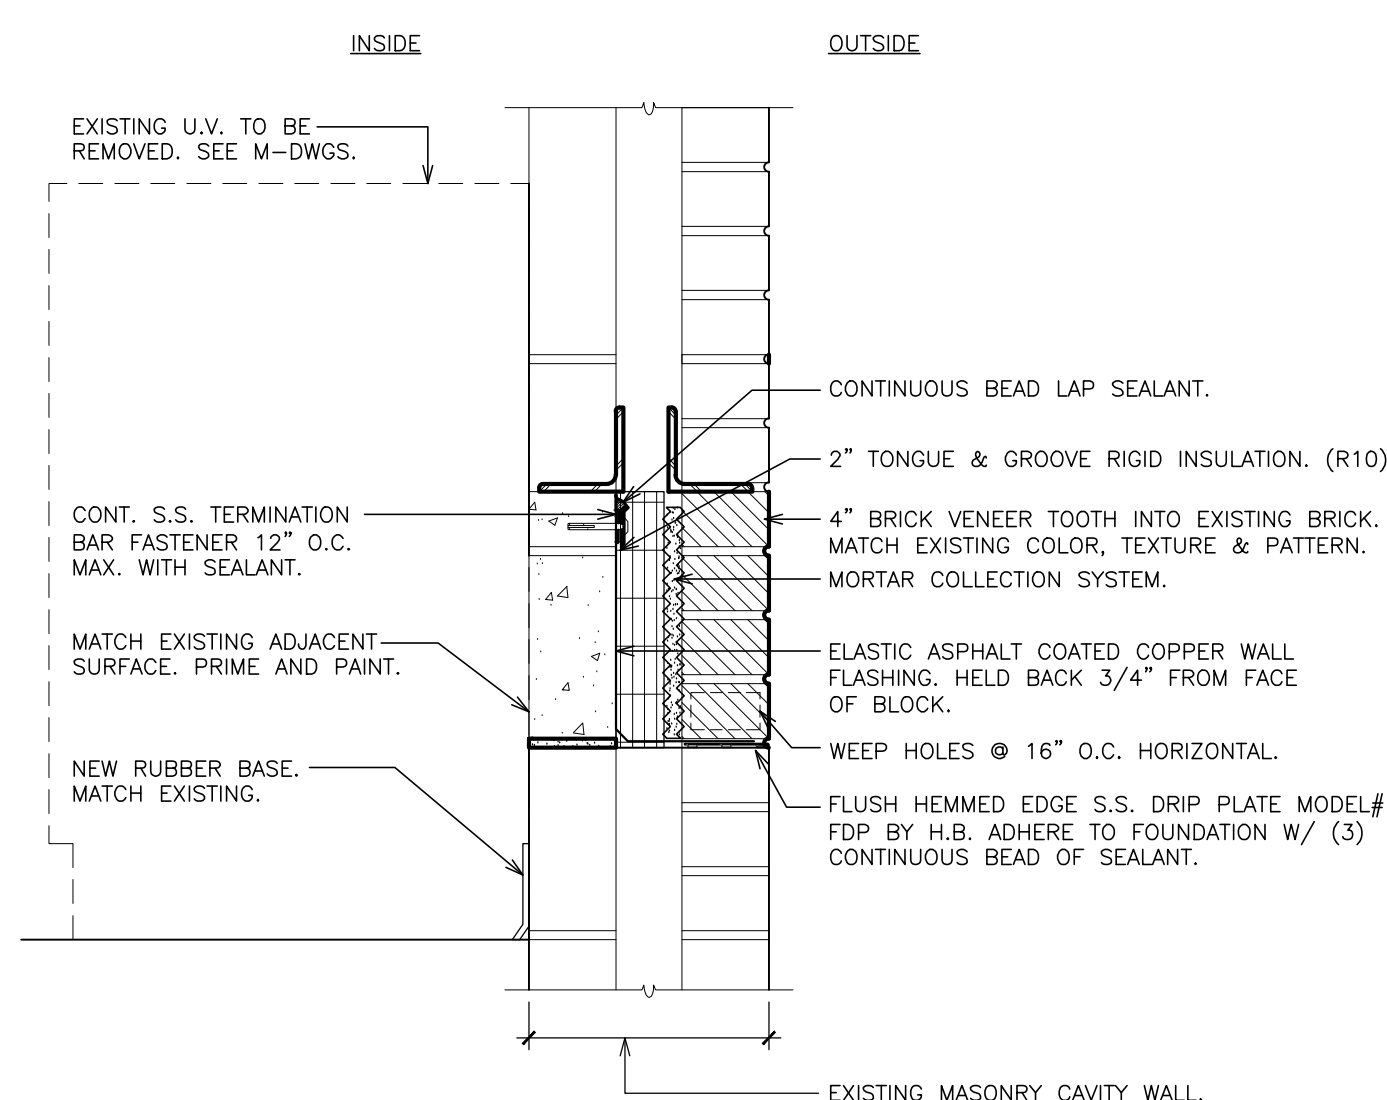
⑤ DETAIL - SUPPORT CURB  
SCALE: 1 1/2" = 1'-0"




⑥ DETAIL - PIPE PORTAL CURB  
SCALE: 1 1/2" = 1'-0"

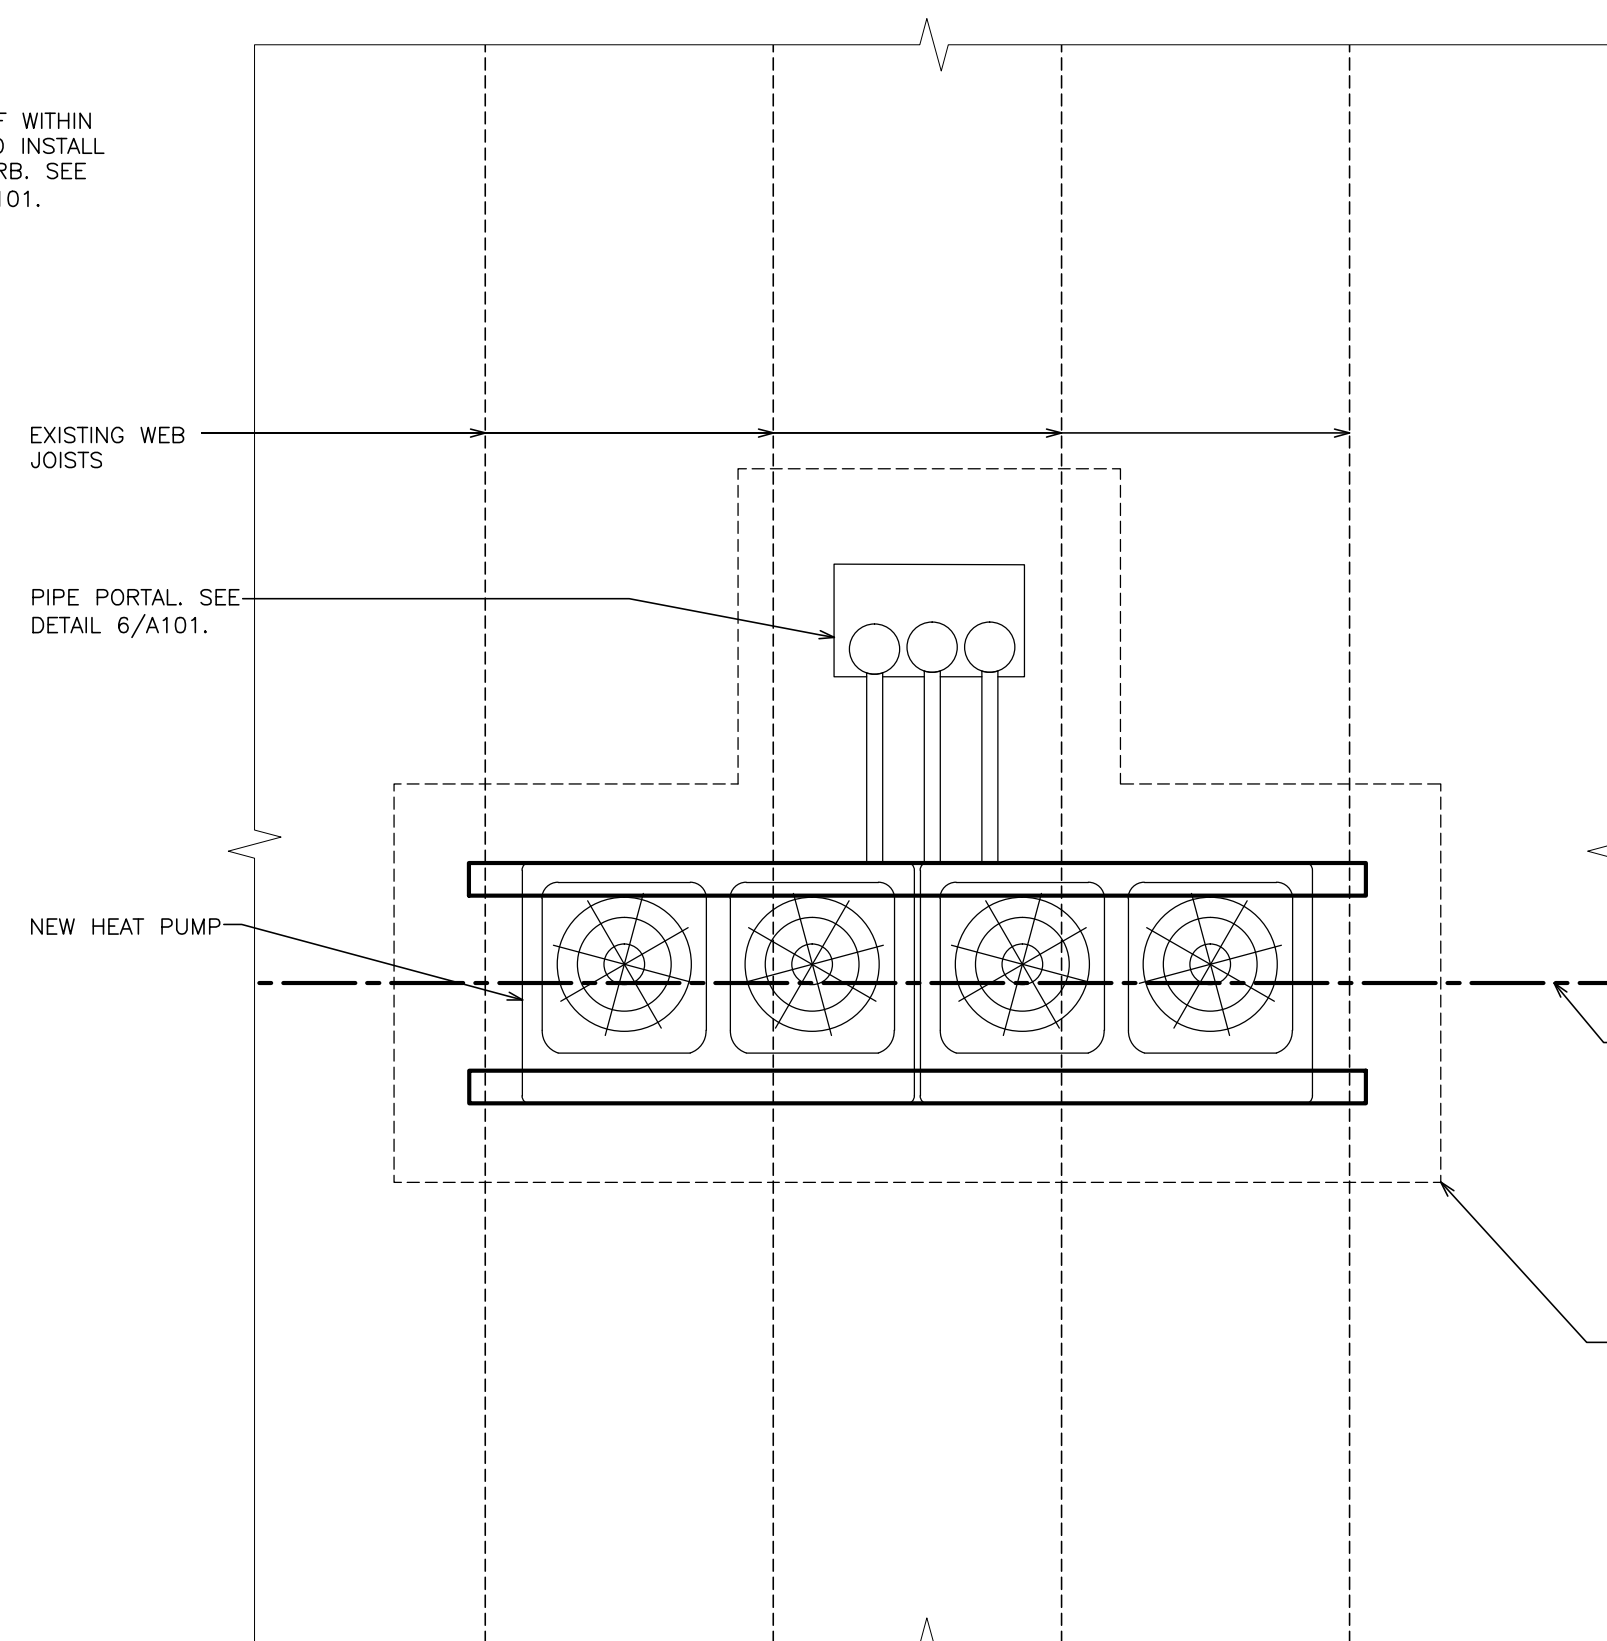

⑦ TYPICAL LOUVER OPENING @ U.V.  
SCALE: 1 1/2" = 1'-0"

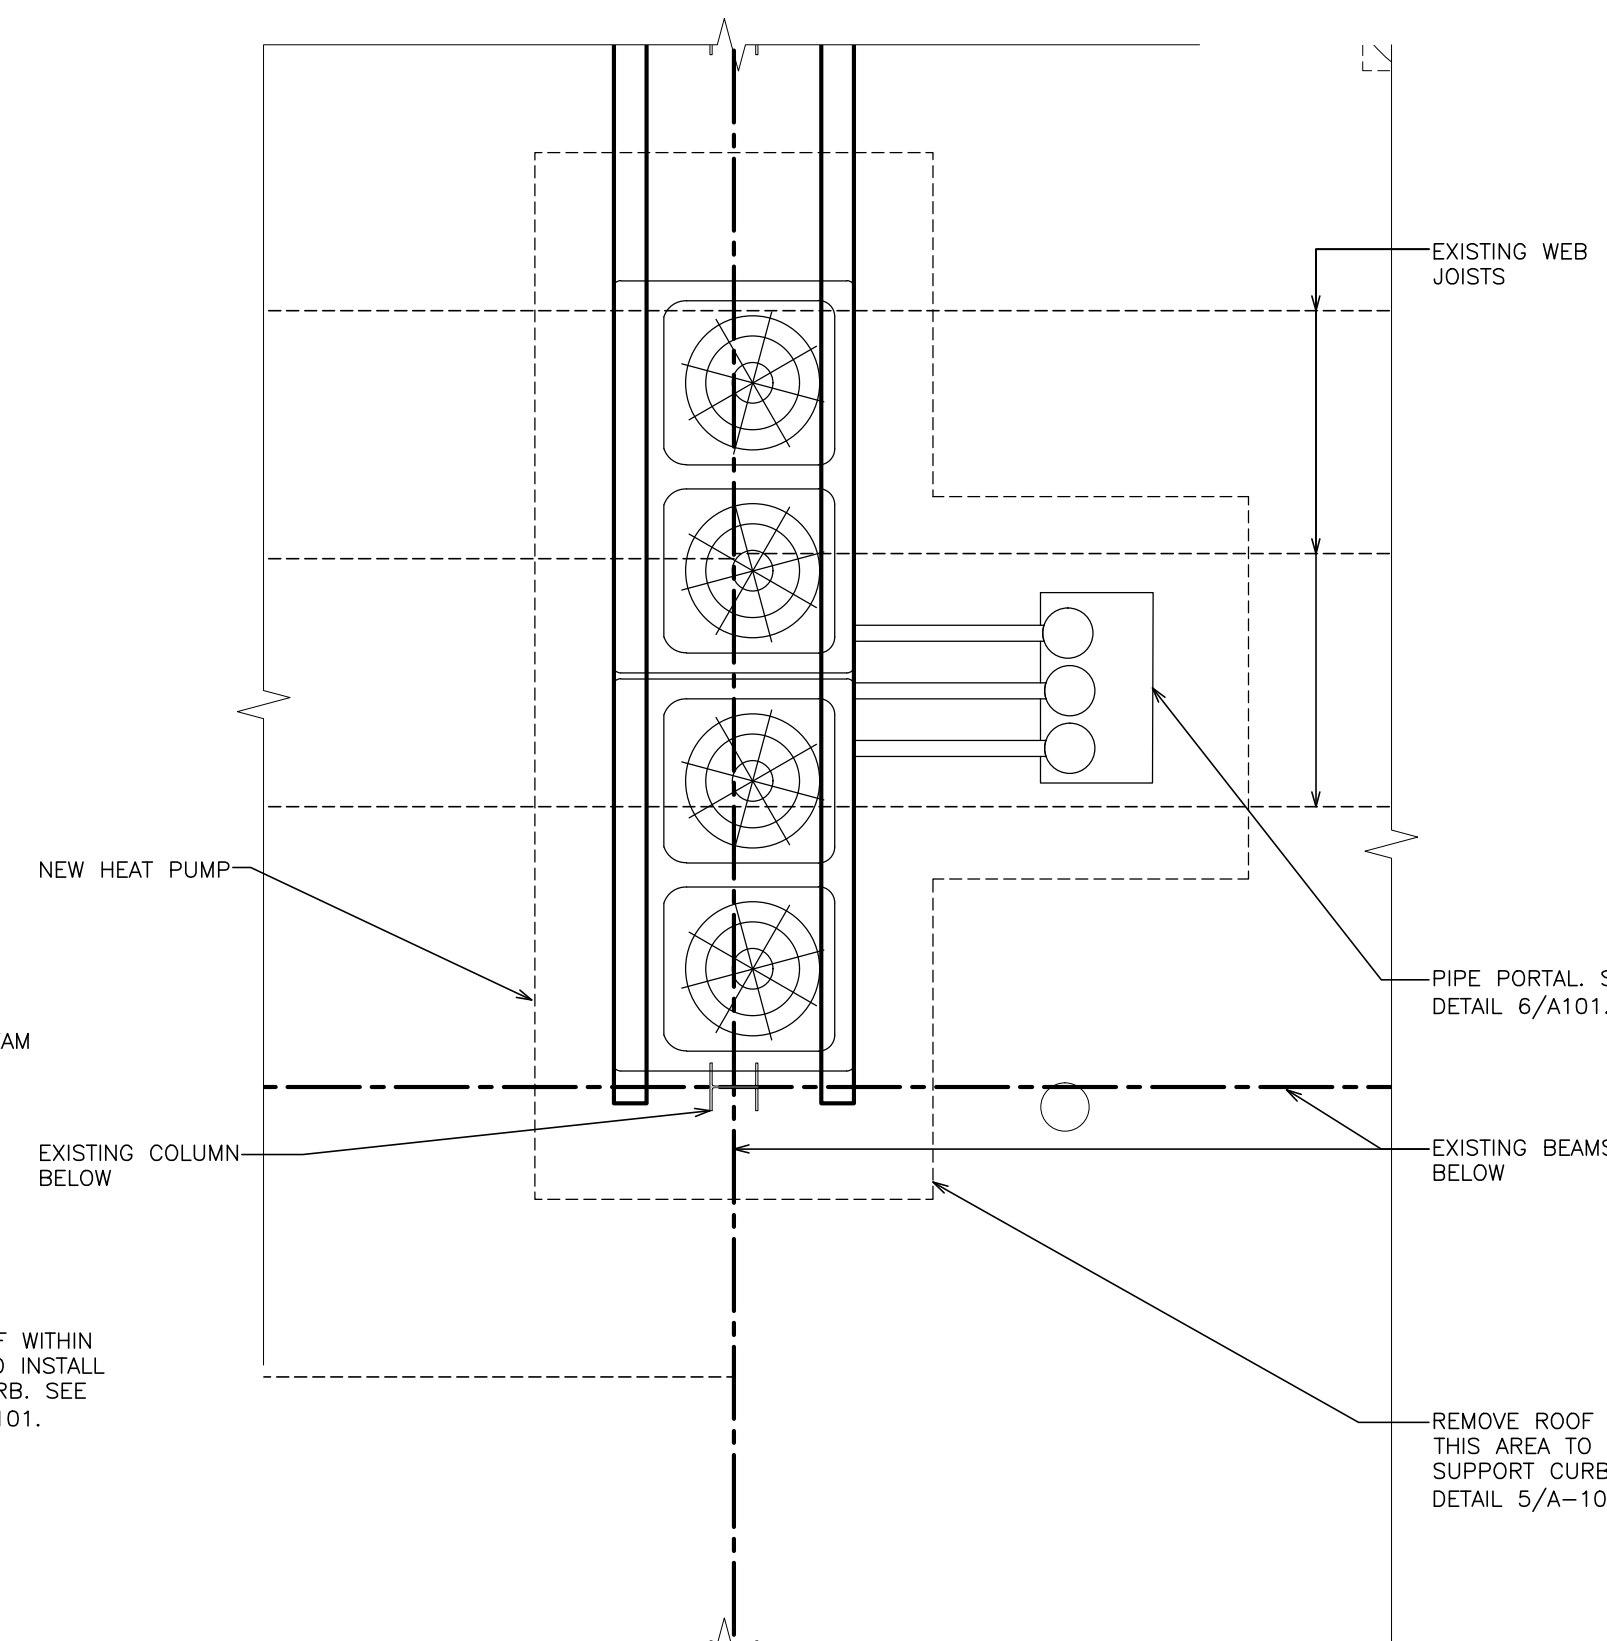

⑧ DETAIL - EXISTING U.V. INFILL  
SCALE: 1 1/2" = 1'-0"

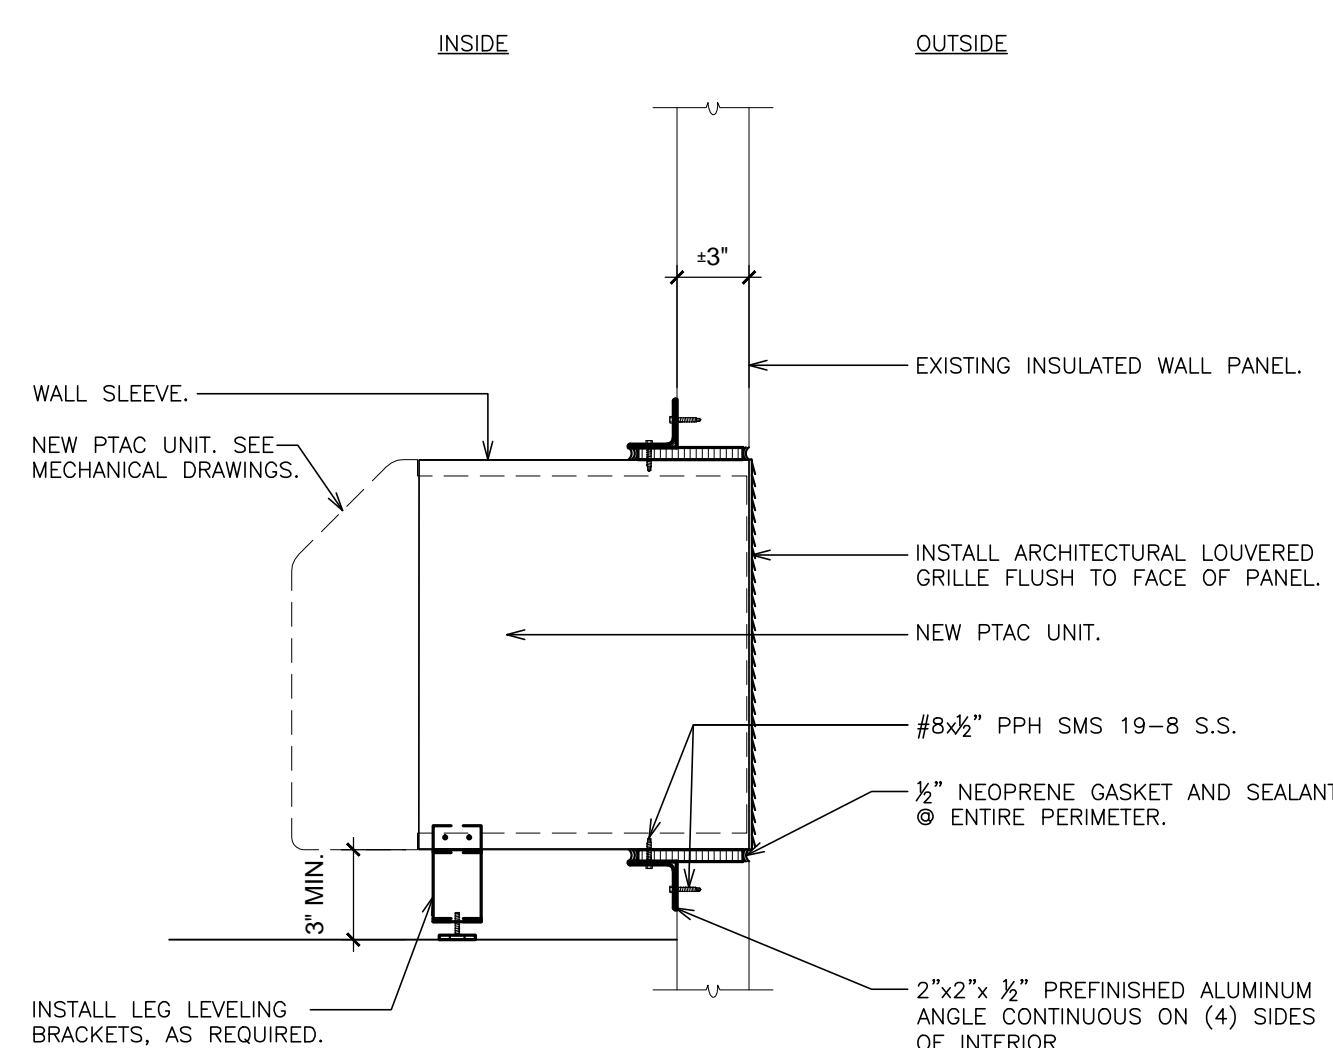

⑨ TYPICAL PTAC WALL SLEEVE  
SCALE: 1 1/2" = 1'-0"

### WORKSCOPE NOTES

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### LEGEND:

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- EXISTING VENT PIPE
- EXISTING EXHAUST FAN.
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- WALKWAY PADS. SEE SPECIFICATIONS
- EXISTING ROOF HATCH.

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JACK G. RENDERO  
No. 059447  
Professional Engineer

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WARWICK VALLEY  
HIGH SCHOOL ROOF  
STRUCTURAL PLANS  
AND  
MISCELLANEOUS  
DETAILS

SHEET NO.

WVHS  
A-101


MECHANICAL GENERAL NOTES:

- DRAWINGS ARE DIAGRAMMATIC AND INDICATE GENERAL ARRANGEMENT OF SYSTEMS AND WORK INCLUDED IN THE CONTRACT. IT IS NOT INTENDED TO SPECIFY OR SHOW EVERY OFFSET, FITTING OR COMPONENT; HOWEVER, CONTRACT DOCUMENTS REQUIRE COMPONENTS AND MATERIALS WHETHER OR NOT INDICATED OR SPECIFICALLY SPECIFIED TO MAKE THE SYSTEMS BEING INSTALLED COMPLETE, CODE COMPLIANT, TESTED AND OPERATIONAL.
- CONTRACTOR SHALL FIELD VERIFY ALL LOCATIONS, DIMENSIONS AND ELEVATIONS PRIOR TO CONSTRUCTION.
- ALL MATERIALS, EQUIPMENT, METHODS OF INSTALLATION, REMOVALS AND DISPOSAL SHALL BE IN ACCORDANCE WITH THE STANDARDS, REGULATIONS, CODES, ORDINANCES, AND LAWS OF LOCAL, STATE, AND FEDERAL GOVERNMENTS, AND OTHER AUTHORITIES THAT HAVE LAWFUL JURISDICTION.
- PERFORM WORK, PROVIDE MATERIALS AND EQUIPMENT FOR SYSTEMS SHOWN, SPECIFIED AND DESCRIBED ON DRAWINGS. COMPLETELY COORDINATE ALL TRADES OF THIS CONTRACT AND PROVIDE COMPLETE AND FULLY FUNCTIONAL INSTALLATION. ALL WORK IN THIS SET TO BE COMPLETED UNDER THIS CONTRACT, UNLESS OTHERWISE INDICATED.
- PROTECT ALL EXISTING AND NEW BUILDING ELEMENTS (INSTALLED BY OTHER CONTRACTS) FROM DAMAGE. CONTRACTOR SHALL RESTORE ALL DAMAGED ELEMENTS TO ORIGINAL OR BETTER CONDITION.
- WORK SHALL BE EXECUTED IN A WORKMANLIKE MANNER AND SHALL PRESENT NEAT, RECTILINEAR APPEARANCE WHEN COMPLETED. MAINTAIN MAXIMUM HEAD ROOM AT ALL TIMES. DO NOT RUN PIPES, DUCTS, AND CONDUIT EXPOSED UNLESS SHOWN AND NOTED TO BE EXPOSED ON DRAWINGS.
- MATERIALS AND EQUIPMENT SHALL BE NEW AND INSTALLED ACCORDING TO MANUFACTURER'S INSTRUCTIONS AND RECOMMENDATIONS. MAINTAIN MANUFACTURER'S EQUIPMENT CLEARANCES.
- CONTRACTOR IS RESPONSIBLE FOR ALL WORK RELATED TO ISOLATING, SHUTTING DOWN, DRAINING, FILLING AND TESTING SYSTEMS TO ALLOW FOR COMPLETION OF WORK. INTERRUPTIONS TO EXISTING SERVICES AND SYSTEMS SHALL BE AS SHORT AS POSSIBLE AND AT A TIME AND DURATION APPROVED BY THE OWNER AND UTILITY AS APPLICABLE. INCLUDE ALL PREMIUM TIME ASSOCIATED WITH INTERRUPTIONS. ALL SYSTEM INTERRUPTIONS SHALL BE SCHEDULED WITH OWNER, UTILITY AND COORDINATED WITH OTHER TRADE WORK.
- ALL EQUIPMENT PIPING, WIRING, INSULATION ETC. INSTALLED IN HVAC AIR PLENUM SPACES SHALL MEET CODE REQUIREMENTS FOR SMOKE AND COMBUSTIBILITY.
- SEAL ALL PENETRATIONS THROUGH FIRE RATED WALLS, PARTITIONS AND FLOORS WITH UL RATED MATERIALS/METHODS EQUIVALENT TO FIRE RATING OF ASSEMBLY.
- COORDINATE ALL WALL/FOUNDATION PENETRATIONS WITH GENERAL CONTRACT AND SEAL WEATHERTIGHT. PROVIDE STAINLESS STEEL ESCUTCHEON PLATE/TRIM RING FOR EACH ABOVE GRADE PENETRATION (BOTH SIDES).
- PROVIDE PROPER ACCESS TO EQUIPMENT THAT REQUIRES INSPECTION, REPLACEMENT OR REPAIR. ACCESS PANELS/DOORS SHALL BE A MINIMUM OF 12"x12", UNLESS OTHERWISE NOTED.
- DO NOT SUPPORT EQUIPMENT FROM SUSPENDED CEILINGS. ALL SUPPORT SHALL BE FROM BUILDING STRUCTURE OR FROM CEILING SUSPENSION SYSTEM WHICH HAS BEEN REINFORCED. SUPPORTS SHALL BE SELECTED AND INSTALLED TO PROVIDE A VIBRATION FREE INSTALLATION.
- CLEANING DURING MECHANICAL WORK: THE MECHANICAL ROOM AND ROOMS WHERE WORK WILL BE DONE TO MINIMIZE DISTURBANCE IN THE BUILDINGS. WORKERS ARE TO USE PATHWAYS AND FACILITIES AGREED UPON WITH THE DISTRICT DESIGNEE IN WRITING. THE AREA OUTSIDE THE BUILDING WHERE CUTTING WELDING OR STORAGE IS ALLOWED IS TO BE FENCED AT ALL TIMES. THE CONTRACTOR WILL ON A DAILY BASIS CLEAN THE GROUNDS AND THE BUILDING OF ANY DEBRIS OR GARBAGE GENERATED BY THEIR WORK.
- PROTECT EXISTING SURFACES AND EQUIPMENT NOT MARKED FOR REMOVAL OR MODIFICATION. CONTRACTOR RESPONSIBLE FOR REPAIR OF EXISTING SURFACES AND/OR EQUIPMENT TO THE APPROVAL OF THE OWNER.
- EACH CONTRACTOR RESPONSIBLE FOR RETURNING WALLS, CEILINGS AND SURFACES THEY DISTURB THAT ARE NOT SCHEDULED FOR REPLACEMENT BACK TO ORIGINAL CONDITIONS.

HVAC REMOVAL NOTES:

- THE SCOPE OF REMOVAL SHOWN ON "REMOVALS" DRAWING IS DIAGRAMMATIC ONLY AND INDICATES THE INTENT OF THE WORK TO BE PERFORMED AND NOT THE COMPLETE SCOPE OF DEMOLITION AND/OR REMOVAL WORK. IT SHALL BE THE RESPONSIBILITY OF THE CONTRACTOR TO REMOVE OR RELOCATE ANY RELATED MECHANICAL DEVICES/ITEMS EVEN IF NOT SPECIFICALLY INDICATED TO BE REMOVED ON THESE DRAWINGS IN ORDER TO ACCOMODATE NEW WORK.
- EQUIPMENT/ITEMS SHOWN CROSS HATCHED ON DRAWINGS ARE ITEMS TO BE REMOVED. ANY DEVICES/ITEMS REMOVED SHALL INCLUDE (BUT SHALL NOT BE LIMITED TO) THE REMOVAL OF ALL ASSOCIATED PIPING, CONTROLS, ETC. THAT ARE NOT INCORPORATED IN THE NEW LAYOUT. THE CONTRACTOR SHALL PERFORM ALL WORK REQUIRED TO INSURE CONTINUITY OF SERVICE TO EXISTING REMAINING EQUIPMENT. NO EXTRAS RELATING TO THE SCOPE OF WORK DESCRIBED WILL BE ALLOWED.
- EQUIPMENT, PIPING, ETC. REQUIRED TO RECONNECT SHALL BE INSTALLED CONCEALED WITHIN THE SUSPENDED CEILINGS, PARTITIONS AND/OR WALLS, FLOORS. NO SURFACE MOUNTED OR EXPOSED EQUIPMENT, PIPING, ETC., SHALL BE PERMITTED, UNLESS SPECIFICALLY INDICATED.
- ALL ITEMS TO BE REMOVED SHALL BE REVIEWED WITH THE OWNER PRIOR TO REMOVAL. OWNER SHALL HAVE FIRST SALVAGE RIGHTS. ITEMS THE OWNER WISHES TO KEEP SHALL BE REMOVED WITH CARE AND STORED AS DIRECTED BY OWNER. ITEMS THE OWNER DOES NOT WISH TO KEEP SHALL BE REMOVED FROM THE SITE AND DISPOSED OF PROPERLY.

MECHANICAL SYMBOLS

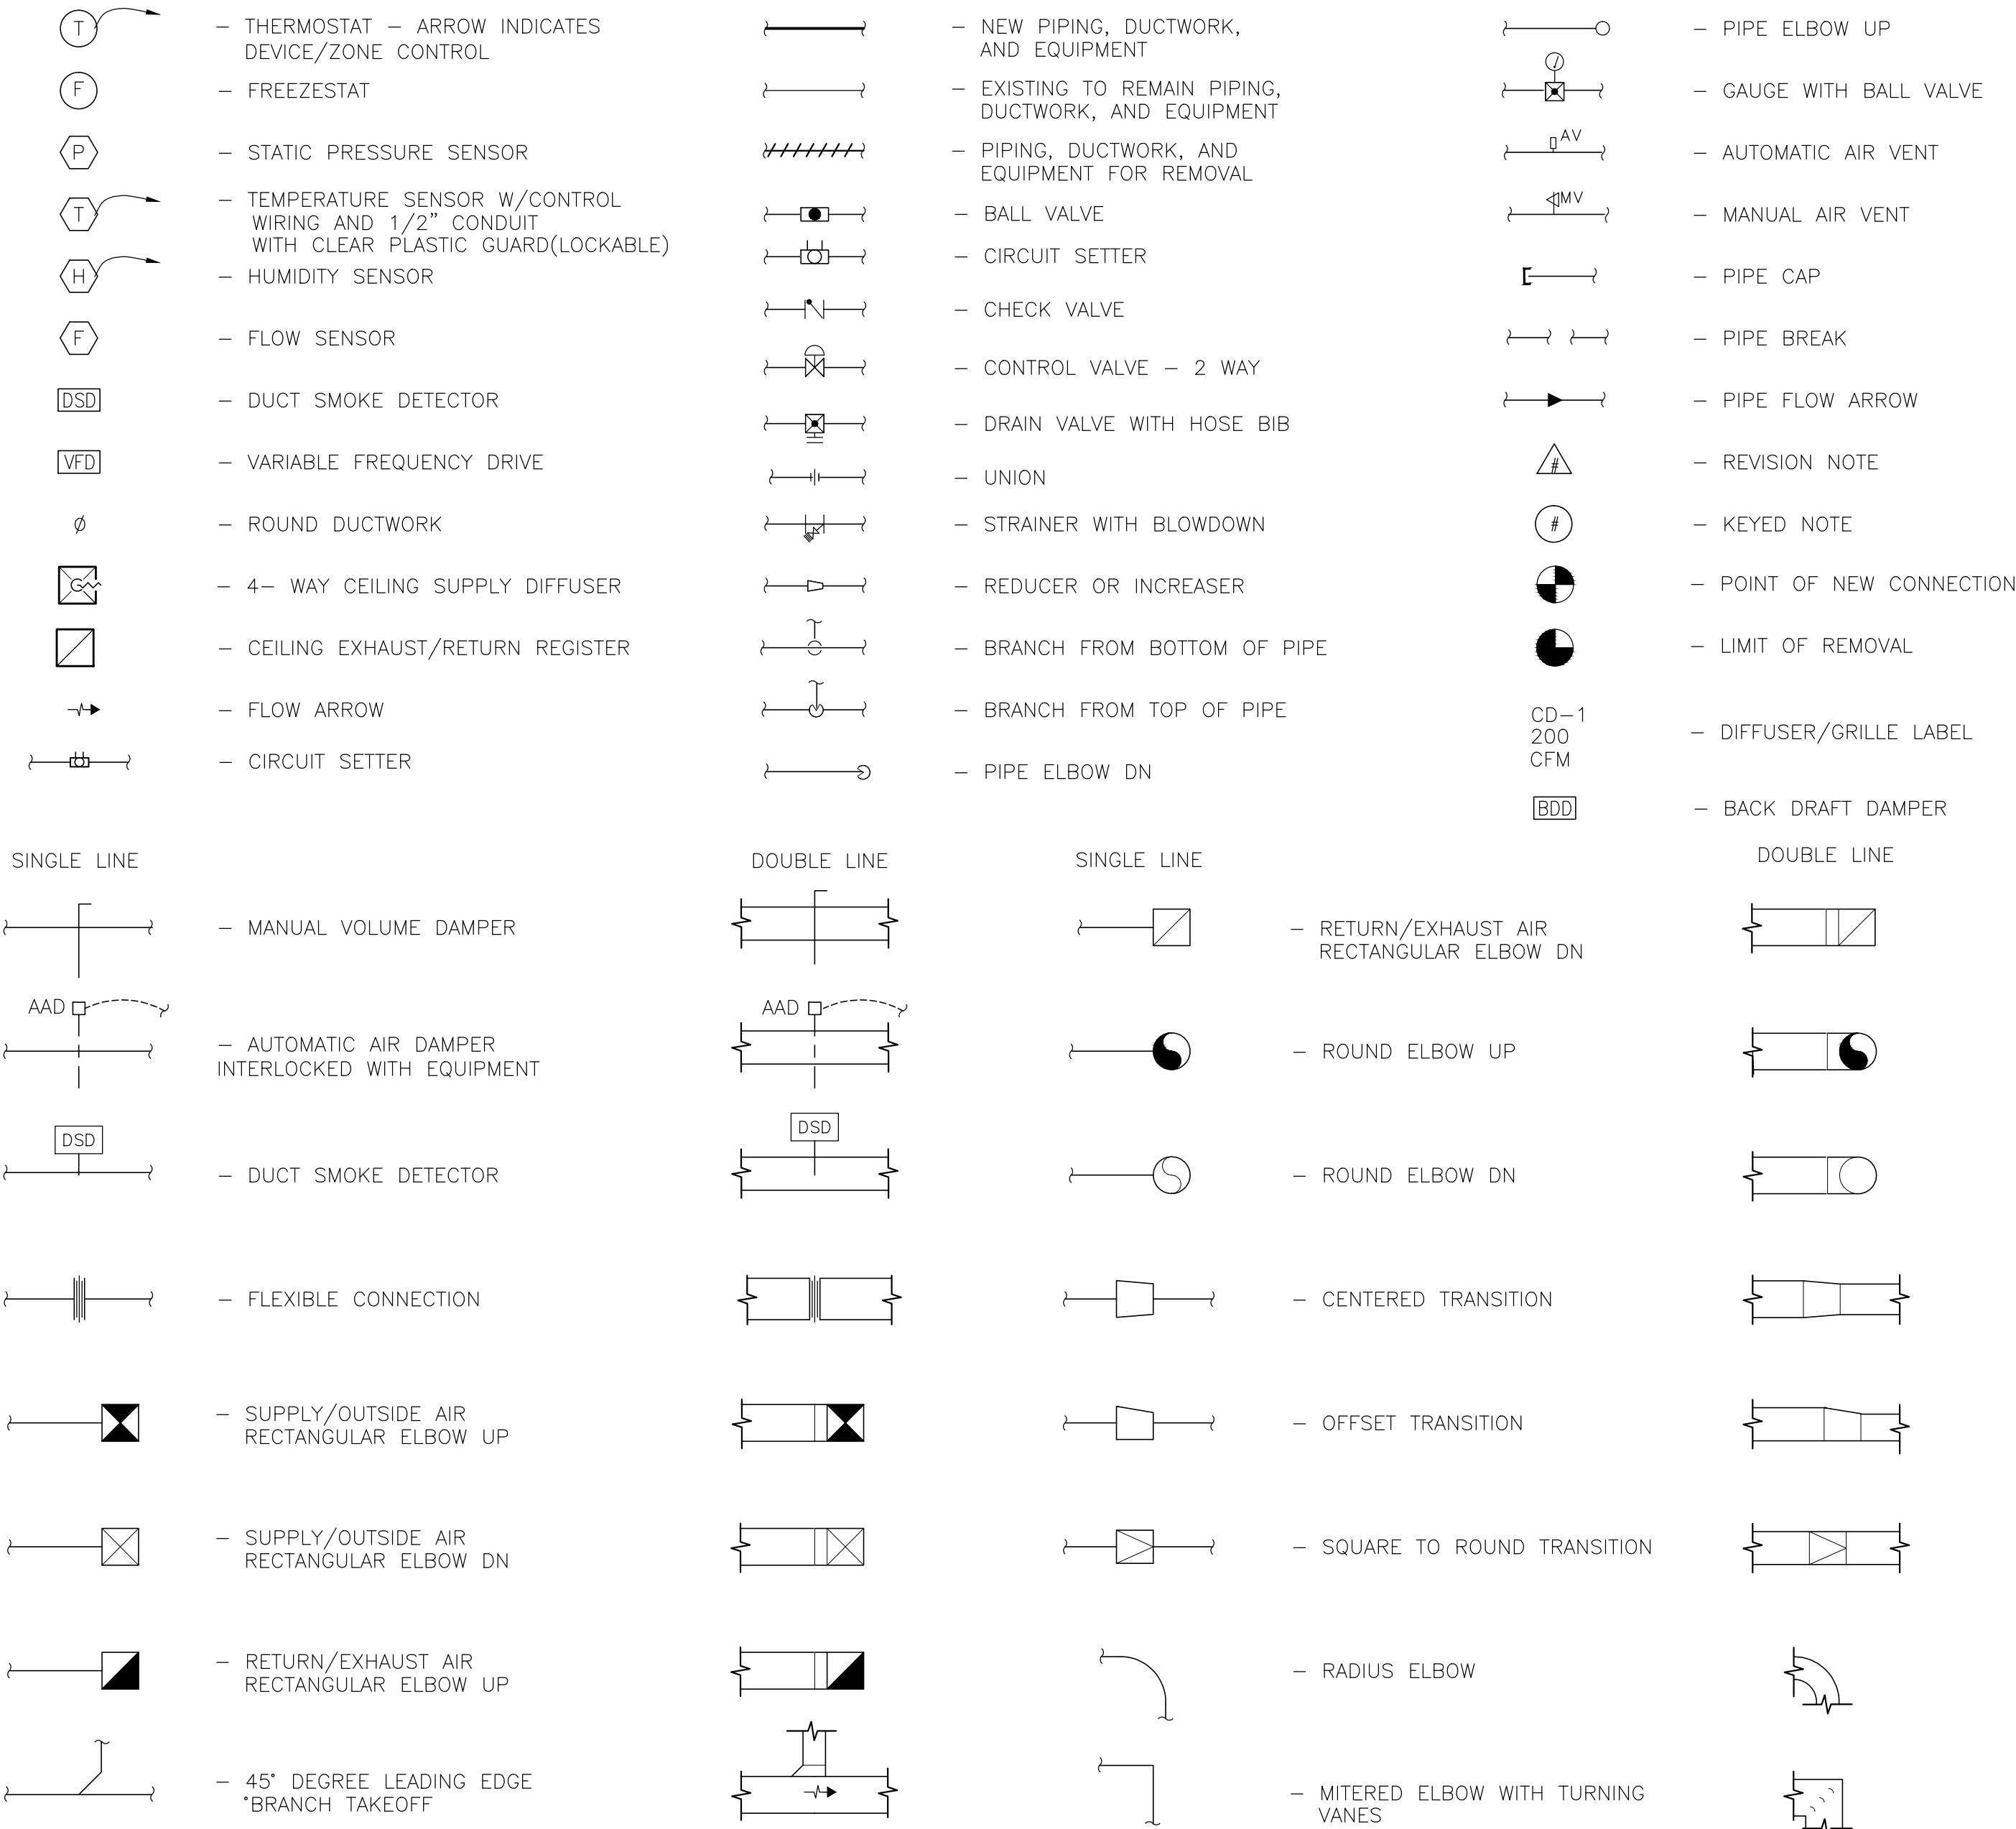

HVAC ABBREVIATIONS

AAD	AUTOMATIC AIR DAMPER
ACCU	AIR COOLED CONDENSING UNIT
AD	ACCESS DOOR
AHU	AIR HANDLING UNIT
AMP	AMPERAGE
BDD	BACKDRAFT DAMPER
BHP	BRAKE HORSEPOWER
BMS	BUILDING MANAGEMENT SYSTEM
BTU	BRITISH THERMAL UNIT
CFM	CUBIC FEET PER MINUTE
CH	CABINET HEATER
CLG	CEILING
C	CONDENSATE
DB	DRYBULB TEMPERATURE
DDC	DIRECT DIGITAL CONTROL (SYSTEM)
DEG	DEGREE
DIA	DIAMETER
DN	DOWN
DP	DEWPOINT TEMPERATURE
DX	DIRECT EXPANSION
EA	EXHAUST AIR
EAT	ENTERING AIR TEMPERATURE
EF	EXHAUST FAN
EFF	EFFICIENCY
EG	EXHAUST GRILLE
ESP	EXTERNAL STATIC PRESSURE
EXH	EXHAUST
F	FAHRENHEIT
FD	FIRE DAMPER
FF	FINAL FILTER
FLR	FLOOR
FPM	FEET PER MINUTE
FSTAT	FREEZESTAT
FT	FEET
FT HD	FEET OF HEAD
FT WG	FEET OF WATER GAUGE
FV	FACE VELOCITY
G	GAS
GAL	GALLON
GPM	GALLONS PER MINUTE
HD	HEAD
HP	HORSEPOWER
L	LOUVER
MAT	MIXED AIR TEMPERATURE
MAU	MAKE-UP AIR UNIT
MBH	1,000 BTU/HR
MCA	MINIMUM BRANCH CIRCUIT AMPACITY
MD	MOTORIZED DAMPER
OA	OUTSIDE AIR
OAI	OUTSIDE AIR INTAKE
PD	PRESSURE DROP
R	REMOVE
RA	RETURN AIR
RL	REFRIGERANT LIQUID
RPM	REVOLUTIONS PER MINUTE
RS	REFRIGERANT SUCTION
S	SATISFACTORY
SAT	SUPPLY AIR TEMPERATURE
SEN	SENSIBLE HEAT
SG	SPECIFIC GRAVITY
SP	STATIC PRESSURE
TAB	TESTING, ADJUSTING, BALANCE
TSTAT	THERMOSTAT
TYP	TYPICAL
UC	UNDER CUT
VD	VOLUME DAMPER
WB	WETBULB
WG	WATER GAUGE
ΔT	TEMPERATURE DIFFERENCE
IC	IRRIGATION CONTRACTOR

HVAC NEW WORK NOTES

- CONTROL WORK COORDINATED THROUGH ITC NORTH USING NEW BMS SYSTEM: JCI FACILITATOR.
- CONTRACTOR RESPONSIBLE TO MAINTAIN A SEALED INSULATED BARRIER FOR DUCTWORK AND ASSOCIATED TO PREVENT FORMATION OF CONDENSATION. PROVIDE NEW INSULATION ON NEW DUCTWORK INSTALLATIONS. DAMAGED AREAS OF EXISTING DUCTWORK INSULATION SHALL BE RECORDED BY THE CONTRACTOR AND BE SUBMITTED TO THE ENGINEER. CONTRACTOR TO REPAIR/REPLACE AND SEAL WITH ADHESIVE ALUMINUM TAPE. REPAIR OR REPLACEMENT OF EXISTING DUCTWORK INSULATION THAT IS NOT ALREADY NOTED ON THE DRAWINGS SHALL BE PROVIDED ON T&M BASIS AGAINST THE CONTRACT ALLOWANCE - REFER TO SPECIFICATIONS.

ENGINEER:



CONSULTANT(S):



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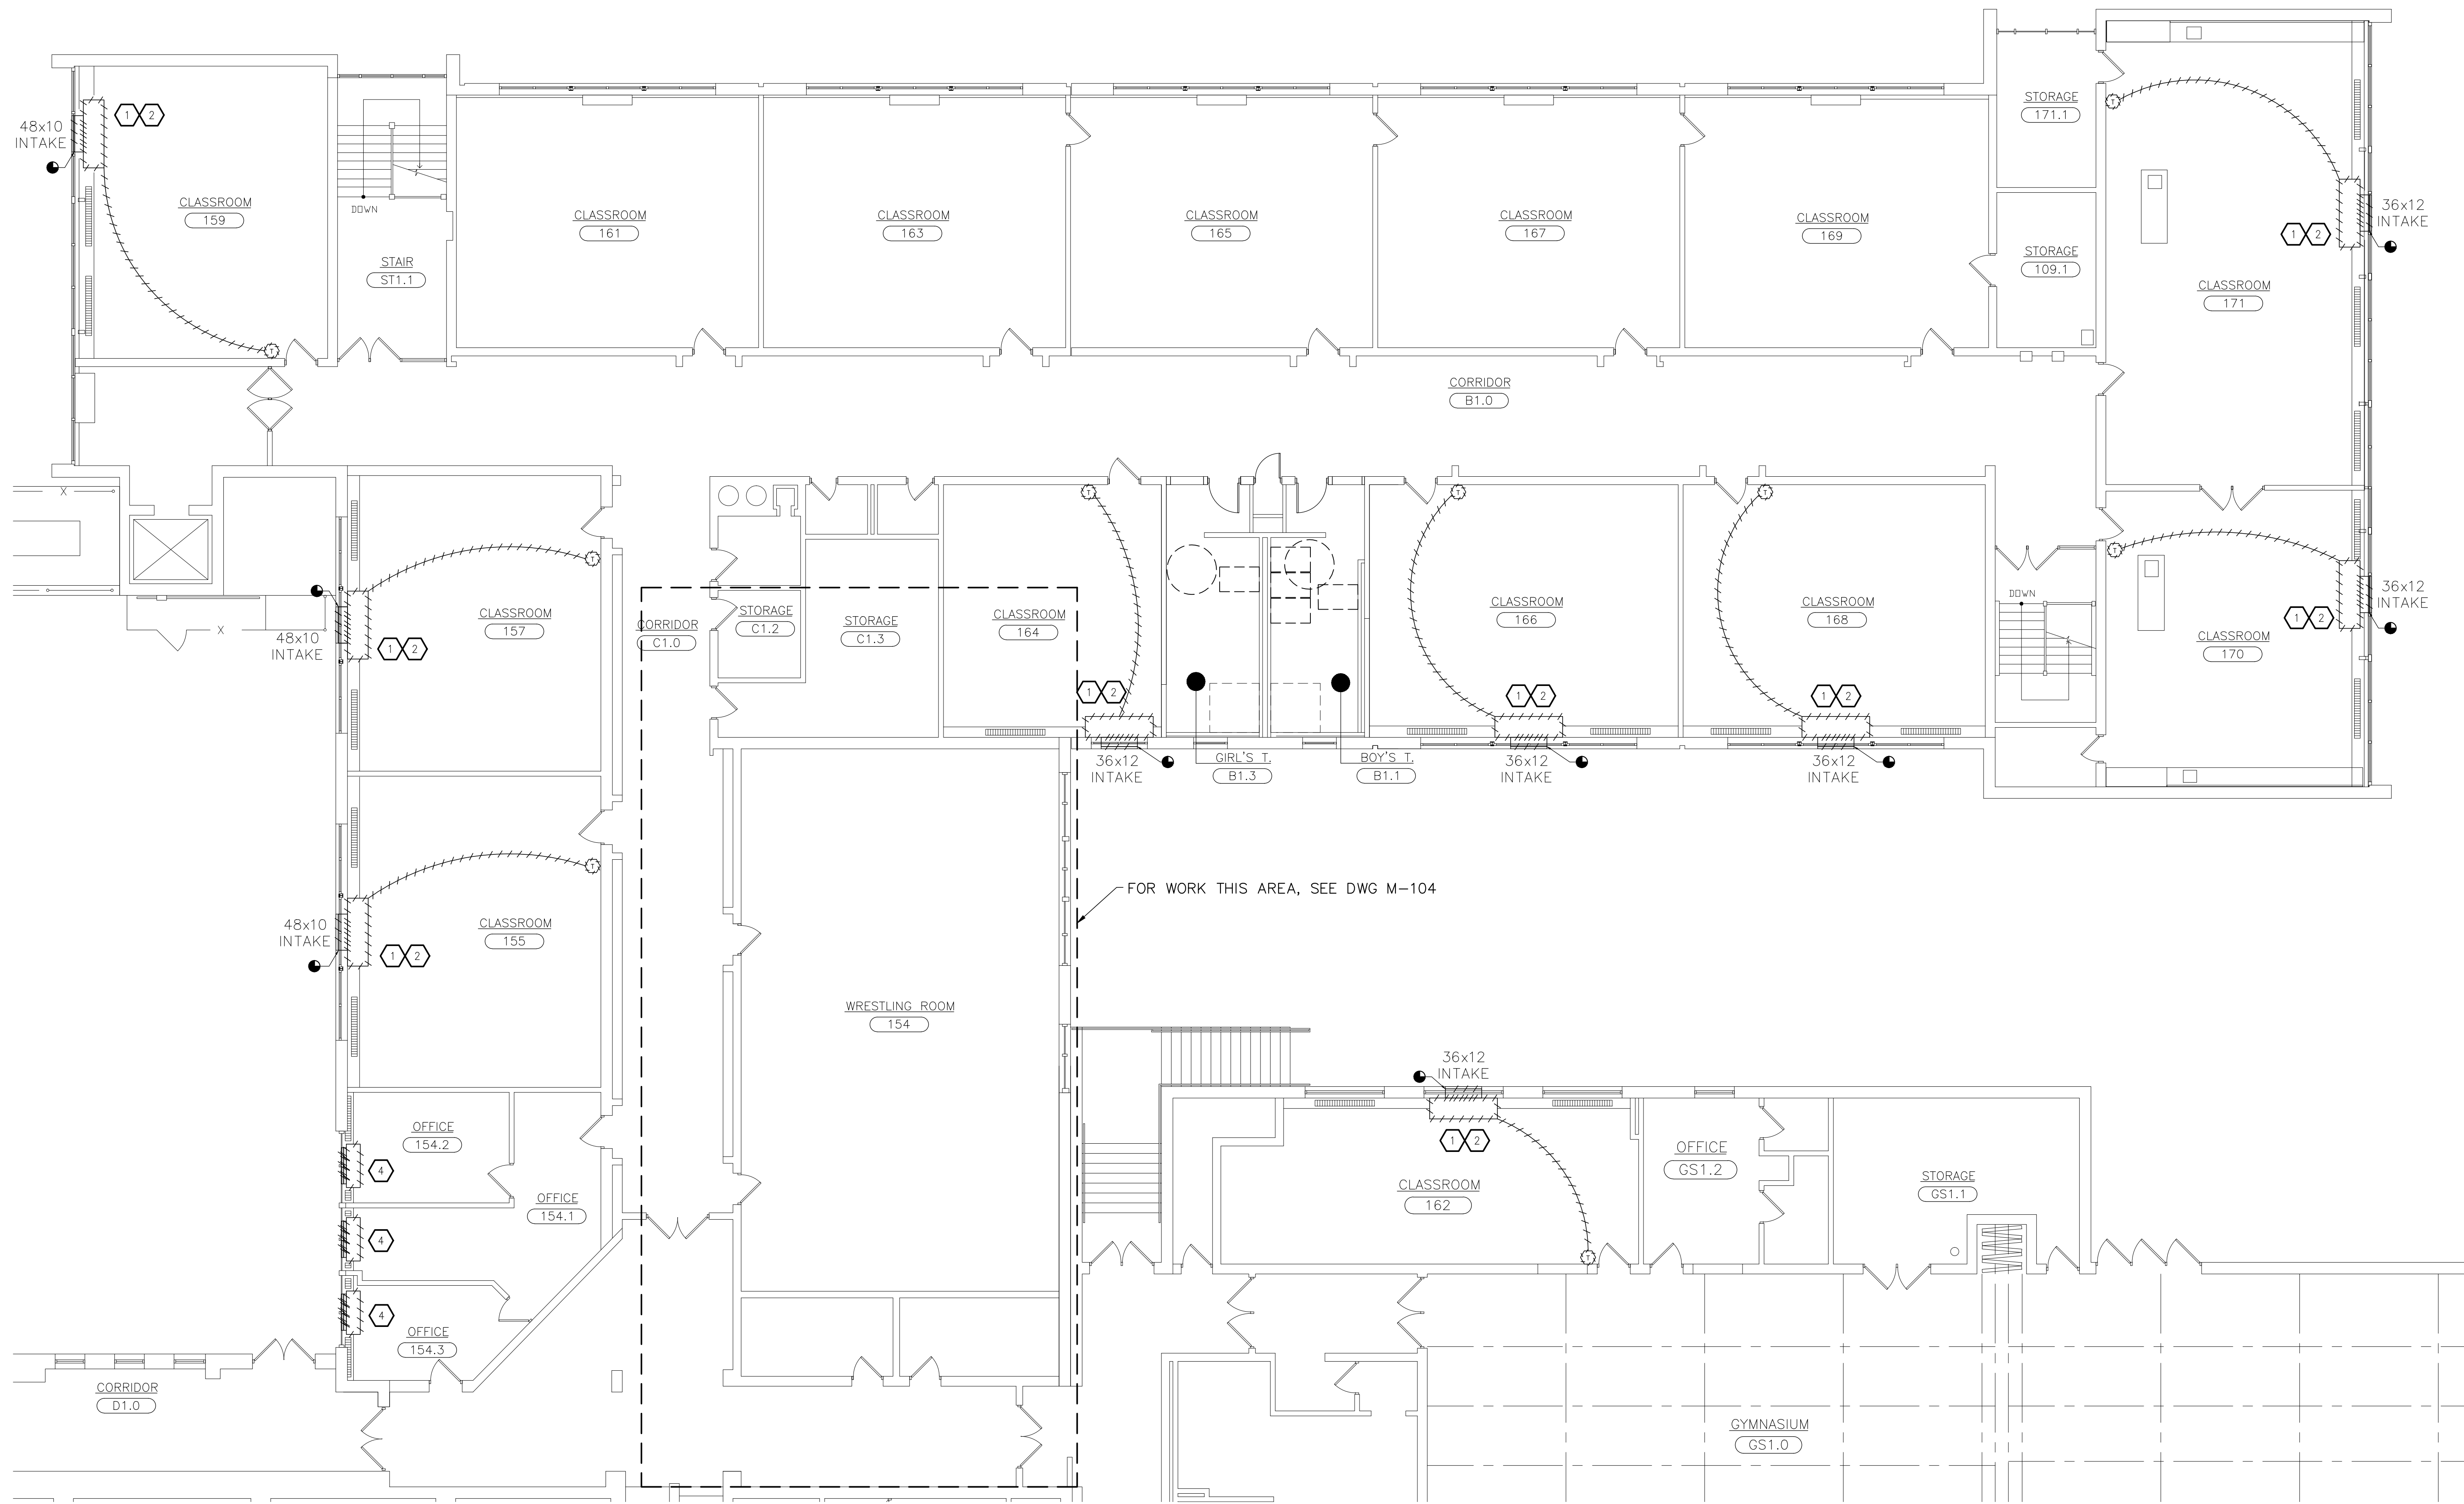
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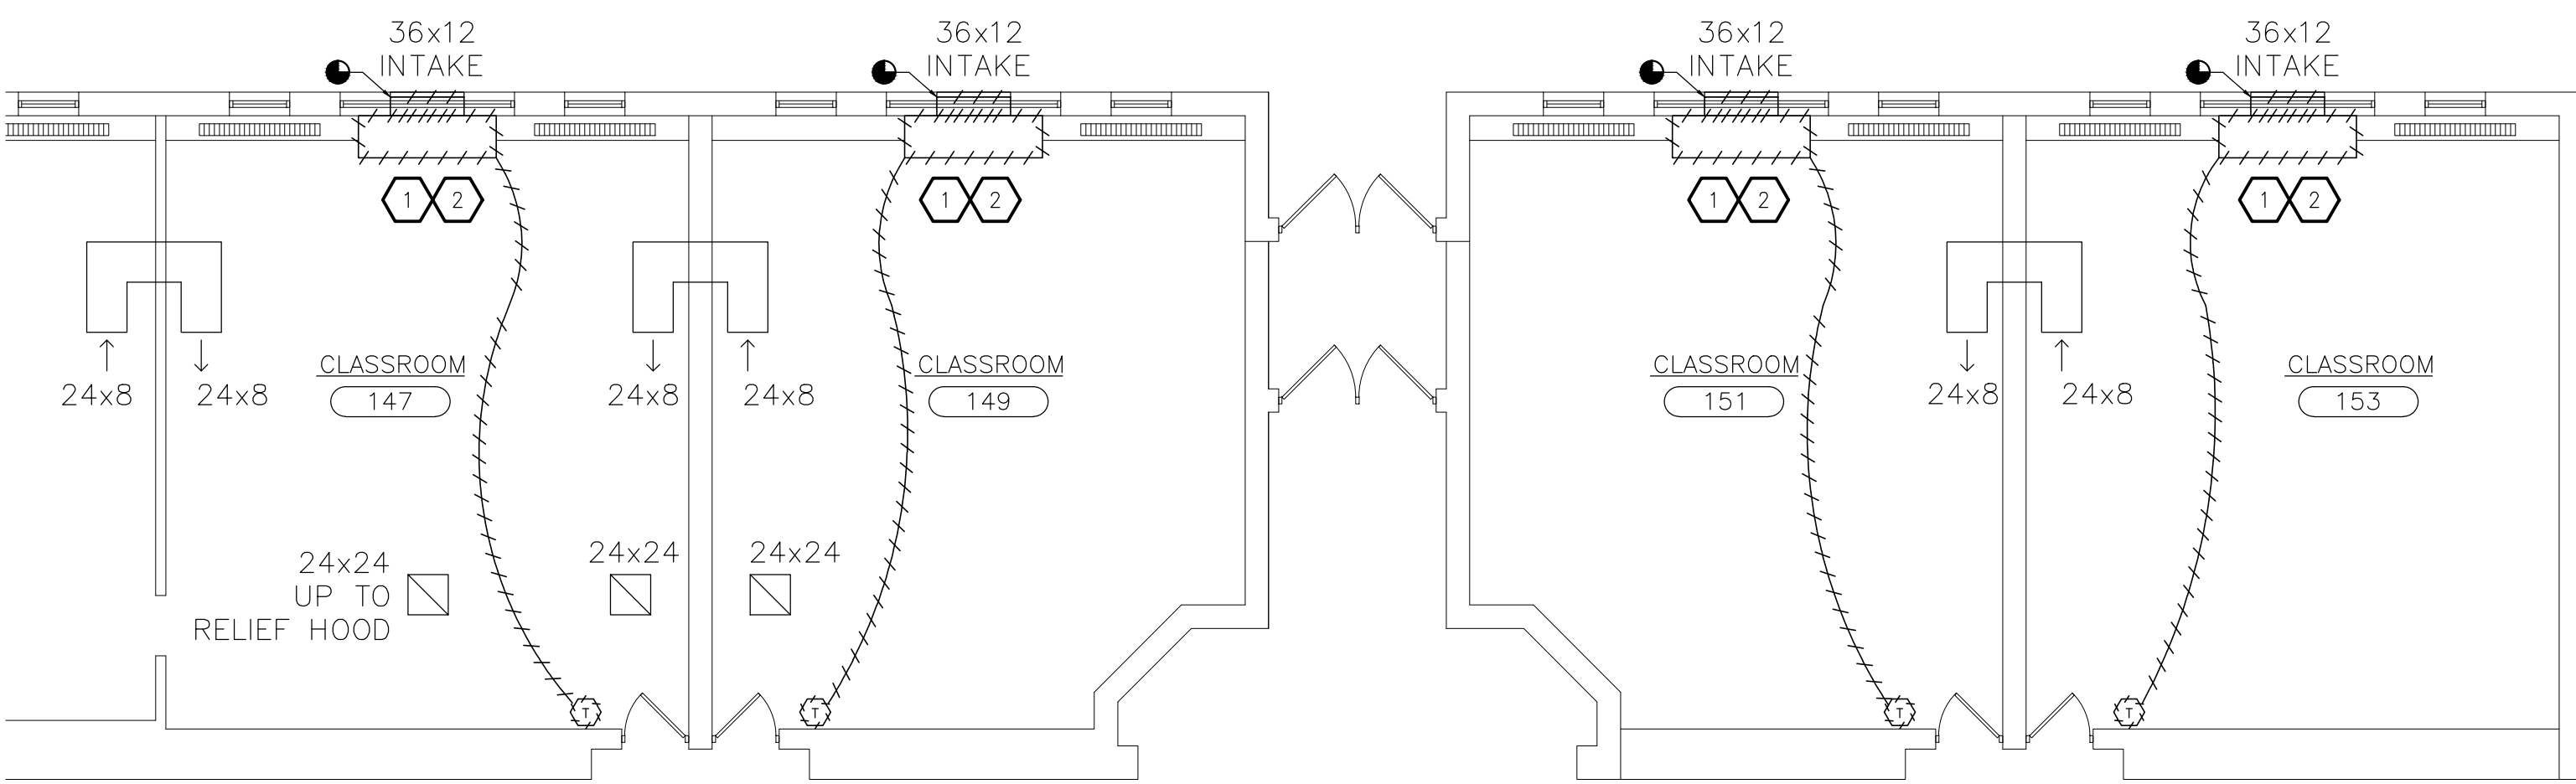
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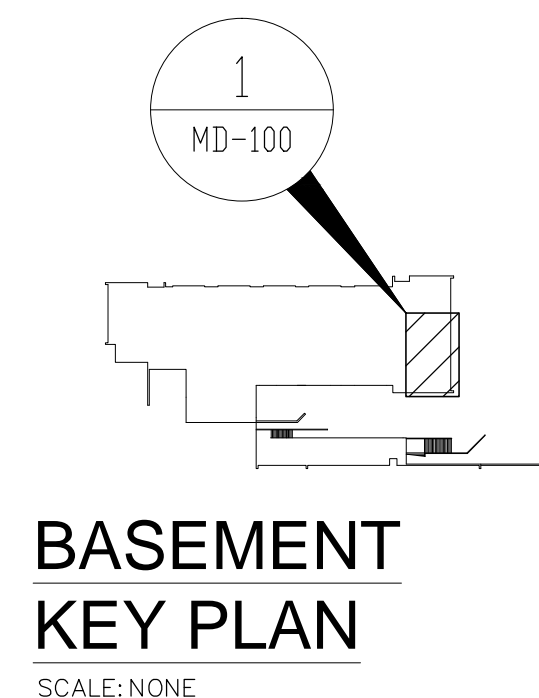


2 PARTIAL FIRST FLOOR PLAN - REMOVALS  
SCALE: 1/8"=1'-0"  
ALL WORK THIS AREA PART OF ALTERNATE (ALT. H-)




3 PARTIAL FIRST FLOOR PLAN - REMOVALS  
SCALE: 1/8"=1'-0"  
ALL WORK THIS AREA PART OF ALTERNATE (ALT. H-)

- KEYED NOTES - REMOVALS:
- 1 REMOVE INTAKE DUCTWORK/ DUCT SLEEVES, EXISTING INTAKE LOUVER TO REMAIN.
  - 2 REMOVE EXISTING FLOOR MOUNTED UNIT VENTILATOR, CUT BACK EXISTING PIPING SERVICING UNIT, REMOVE VALVES AND ASSOCIATED, CUT BACK PORTION OF EXISTING FIN TUBE RADIATION AND COVER AS NECESSARY, DISCONNECT EXISTING CONTROLS.
  - 3 REMOVE EXISTING THERMOSTATS/TEMPERATURE SENSORS, INCLUDING CONTROL WIRING, WIRE MOLDING, CONDUIT, AND ASSOCIATED, BMS CONTROL WIRING TO BE REUSED.
  - 4 REMOVE FAN COIL UNIT, INTAKE DUCT SLEEVE, AND LOUVER, CUT BACK EXISTING PIPING SERVICING UNIT, REMOVE VALVES AND ASSOCIATED, CUT BACK PORTION OF EXISTING FIN TUBE RADIATION AND COVER AS NECESSARY, DISCONNECT EXISTING CONTROLS.



BASEMENT  
KEY PLAN  
SCALE: NONE

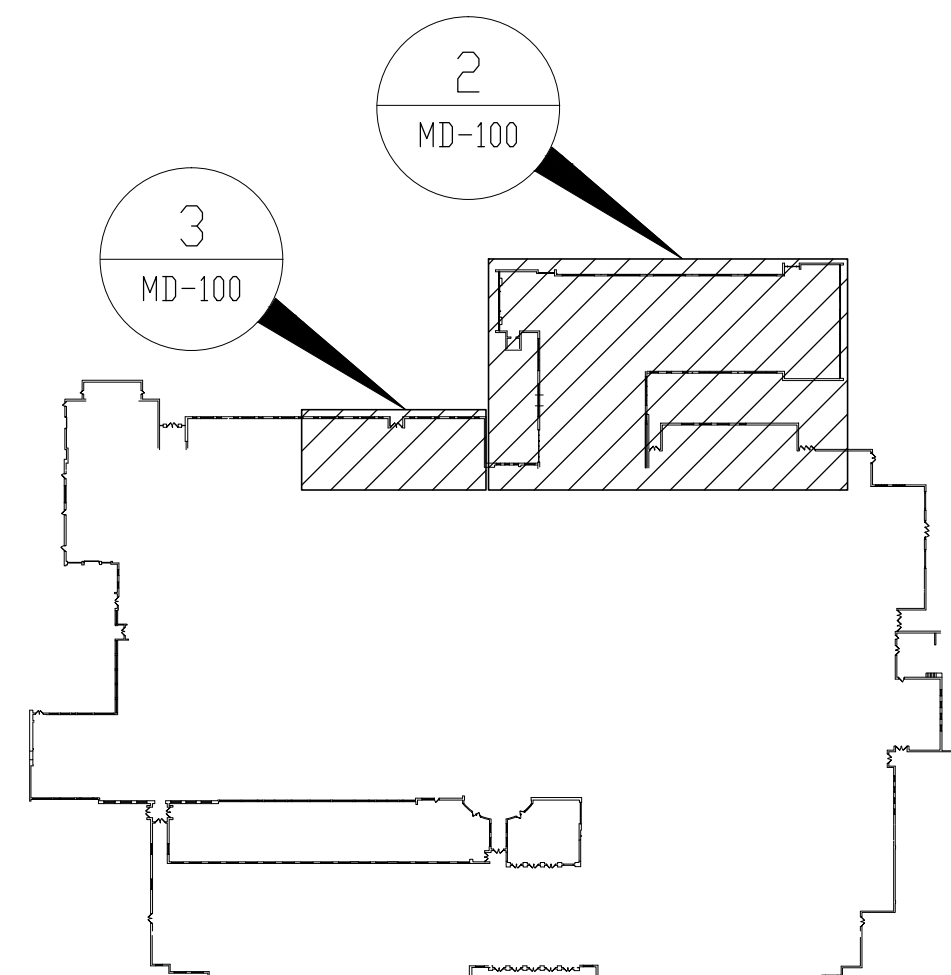

FIRST FLOOR KEY PLAN  
SCALE: NONE

- GENERAL NOTES:
1. PROVIDE ALL ALTERATIONS, RESTORATIONS, AND REPLACEMENTS NECESSARY TO ACCOMMODATE NEW WORK, INCLUDING FIN TUBE COVERS.
  2. NEATLY FIRESTOP ALL INTERIOR WALL AND FLOOR PENETRATIONS.
  3. SEE UV-C LIGHTING SCHEDULES FOR NEW AND EXISTING EQUIPMENT.

1 PARTIAL BASEMENT FLOOR  
PLAN - REMOVALS  
SCALE: 1/8"=1'-0"  
ALL WORK THIS AREA PART OF ALTERNATE (ALT. H-)

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**Eisenbach & Ruhke Engineering, P.C.**  
291 Cassius Street - Union, NY 10884  
TEL: 914.999.4444 FAX: 914.999.4444  
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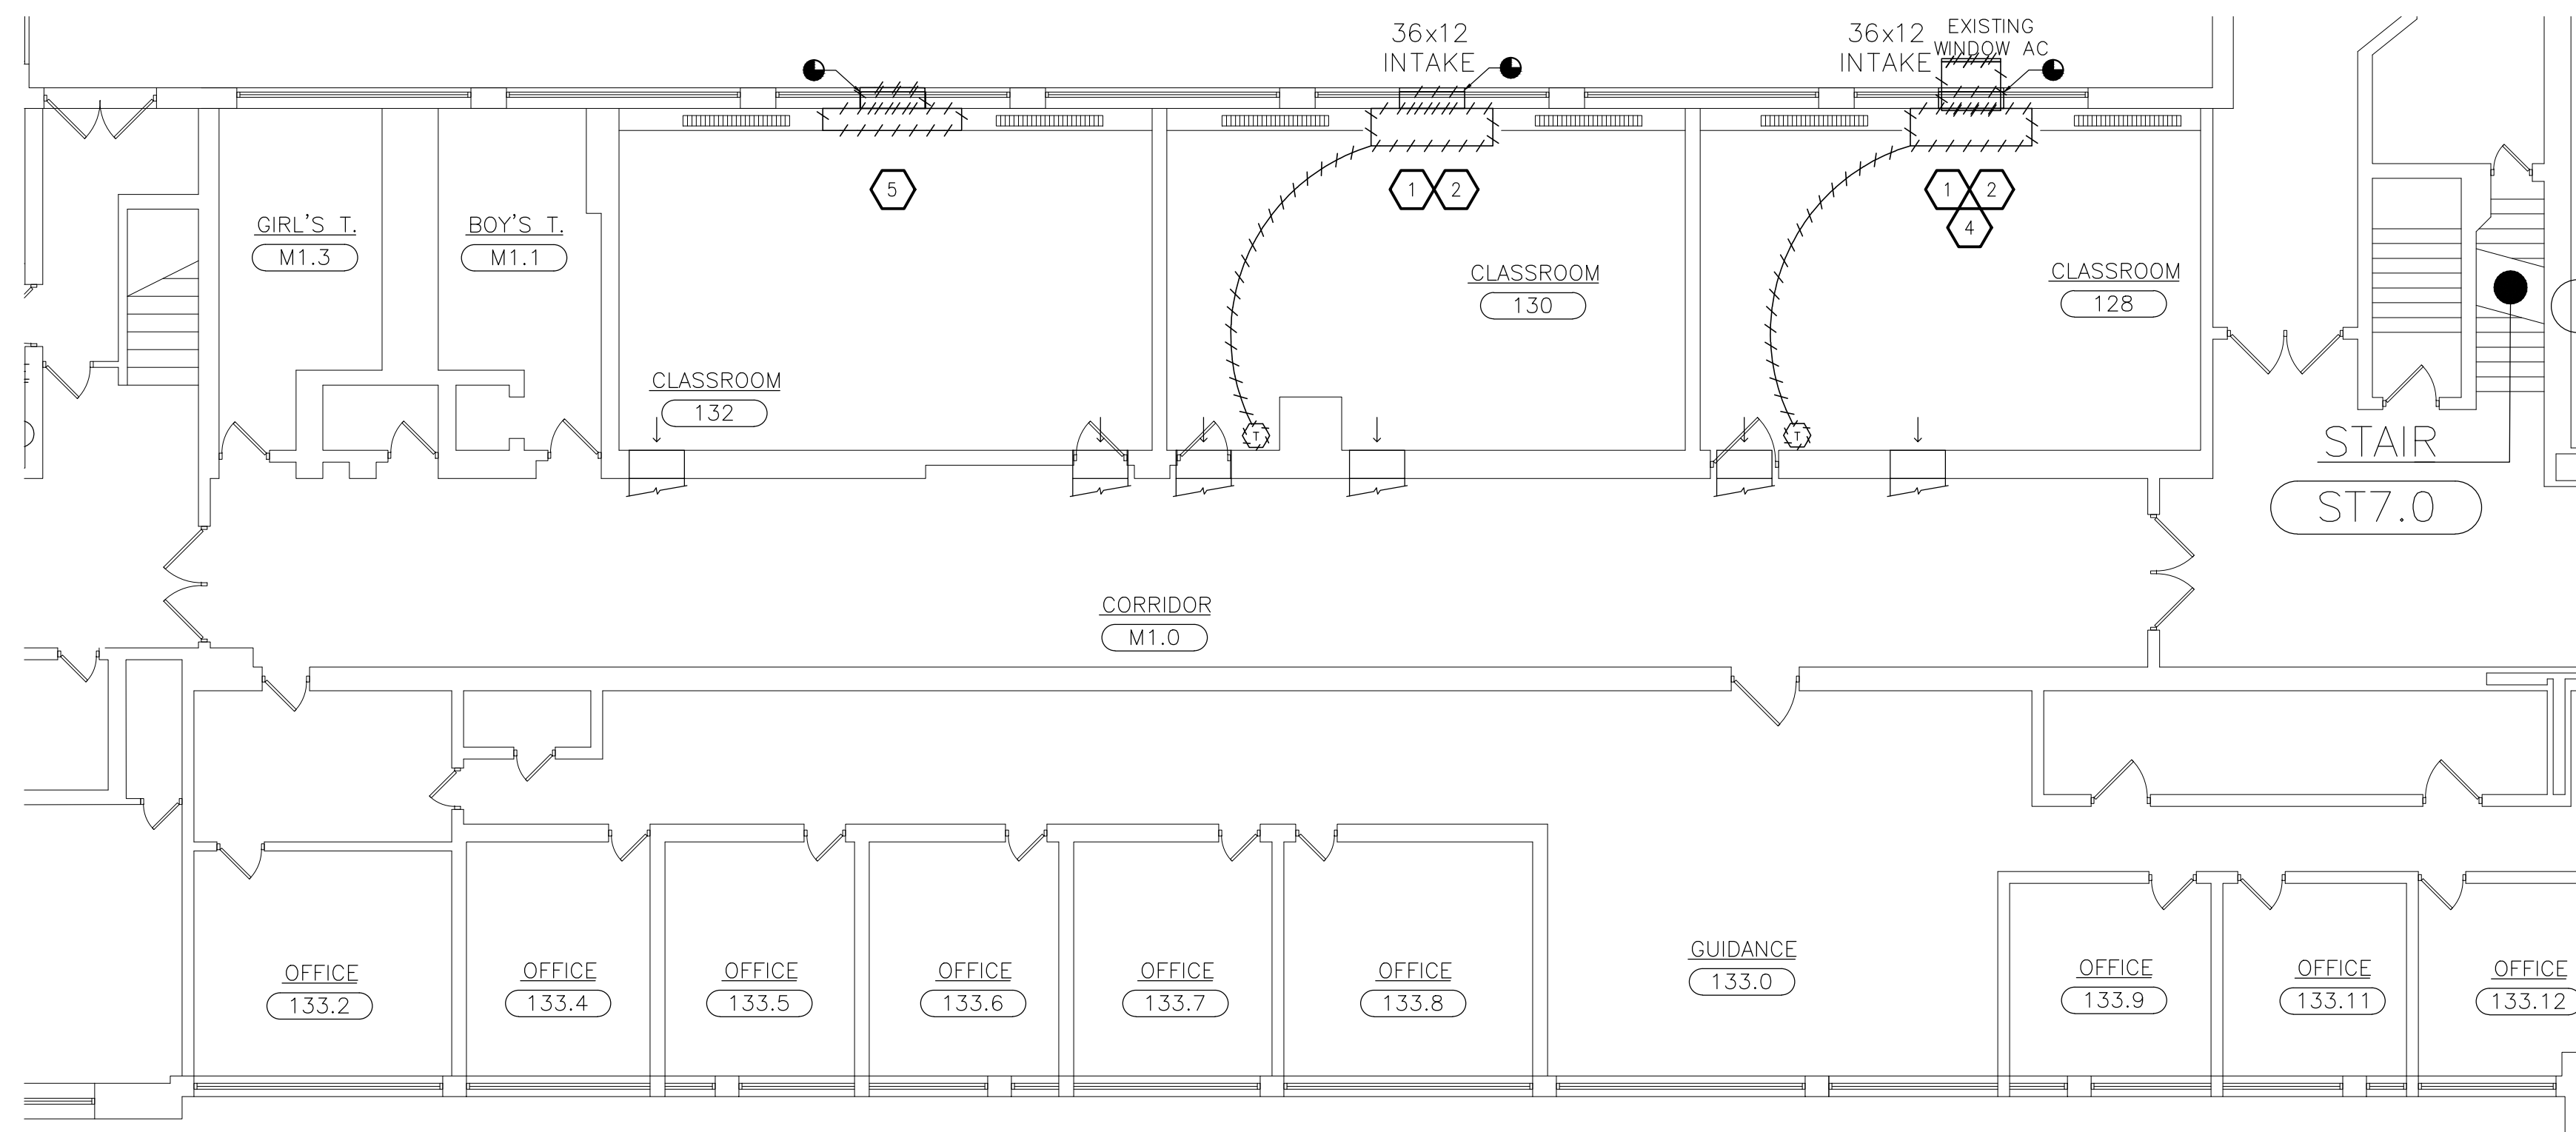
CONSULTANT(S):  
**FULLER D'ANGELO P.C.**  
ARCHITECTS PLANNERS  
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WARWICK VALLEY CENTRAL SCHOOL DISTRICT  
HIGH SCHOOL UNIT VENTILATOR REPLACEMENT AND  
AIR CONDITIONING UPGRADE  
225 WEST STREET EXT. WARWICK, NY 10990  
WV HIGH SCHOOL - 89 SANFORDVILLE ROAD, WARWICK, NY 10990  
SED NO. 44-21-01-06-0-001-042

PROJECT NO.	05-21-04 05-20-06
ISSUED FOR BID	11.09.2022
SED SET	10.19.2022
REVISION	DATE
DRAWN BY	
CHECKED BY	
SHEET SIZE	30" X 42"
SCALE	AS NOTED
SHEET TITLE	PARTIAL BASEMENT AND FIRST FLOOR PLANS - REMOVALS
SHEET NO.	MD-100






2 PARTIAL FIRST FLOOR PLAN - REMOVALS  
SCALE: 1/8"=1'-0"

KEYED NOTES - REMOVALS:

- 1 REMOVE INTAKE DUCTWORK/ DUCT SLEEVES, EXISTING INTAKE LOUVER TO REMAIN.
- 2 REMOVE EXISTING FLOOR MOUNTED UNIT VENTILATOR, CUT BACK EXISTING PIPING SERVICING UNIT, REMOVE VALVES AND ASSOCIATED, CUT BACK PORTION OF EXISTING FIN TUBE RADIATION AND COVER AS NECESSARY, DISCONNECT EXISTING CONTROLS.
- 3 REMOVE EXISTING THERMOSTATS/TEMPERATURE SENSORS, INCLUDING CONTROL WIRING, WIRE MOLDING, CONDUIT, AND ASSOCIATED. BMS CONTROL WIRING TO BE REUSED.
- 4 CAREFULLY REMOVE EXISTING WINDOW AIR CONDITIONER AND INSULATED PANEL AND TURN OVER TO DISTRICT.
- 5 CUT AND MODIFY RADIANT PIPING AND COVER TO PREPARE FOR NEW WORK. CUT HOLE IN MASONRY FOR NEW SLEEVE AND LINTEL.

GENERAL NOTES:

1. PROVIDE ALL ALTERATIONS, RESTORATIONS, AND REPLACEMENTS NECESSARY TO ACCOMMODATE NEW WORK, INCLUDING FIN TUBE COVERS.
2. PROVIDE FIRESTOP AT ALL INTERIOR WALL AND FLOOR PENETRATIONS.
3. SEE UV-C LIGHTING SCHEDULES FOR NEW AND EXISTING EQUIPMENT.

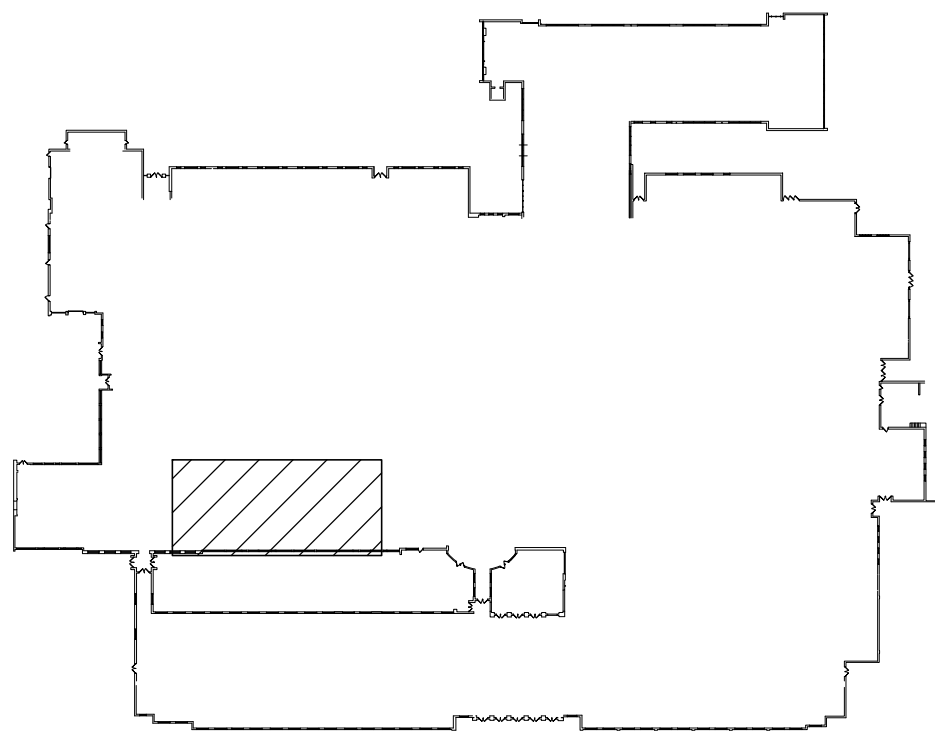

FIRST FLOOR KEY PLAN  
SCALE: NONE



ENGINEER:

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CONSULTANT(S):

**FULLER  
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**ARCHITECTS  
PLANNERS**

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STATE OF NEW YORK  
JACK D'ANGELO  
No. 059445  
REGISTERED PROFESSIONAL ENGINEER


WARWICK VALLEY CENTRAL SCHOOL DISTRICT  
HIGH SCHOOL UNIT VENTILATOR REPLACEMENT AND  
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SED NO. 44-21-01-06-0-001-042

PROJECT NO.	05-21-04 05-20-06
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DRAWN BY	
CHECKED BY	
SHEET SIZE	30" X 42"
SCALE	AS NOTED
SHEET TITLE	
PARTIAL FIRST FLOOR PLAN - REMOVALS	
SHEET NO.	
MD-101	

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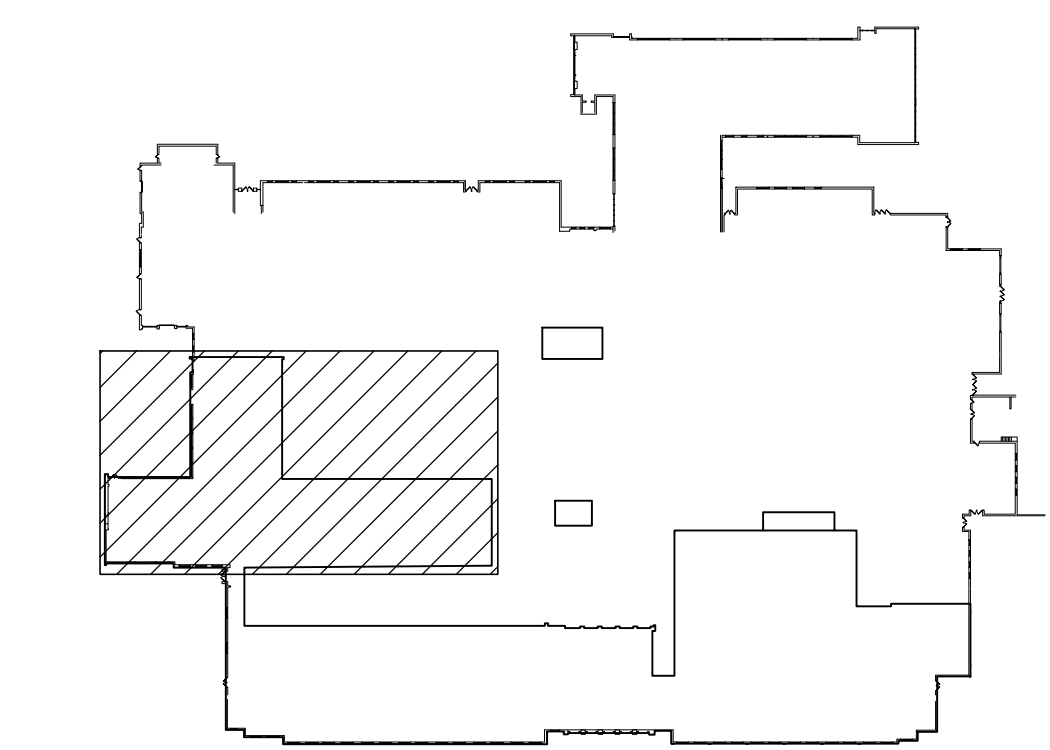
**1 PARTIAL SECOND FLOOR PLAN - REMOVALS**  
SCALE: 1/8"=1'-0"

**KEYED NOTES — REMOVALS:**

1. REMOVE INTAKE DUCTWORK / DUCT SLEEVES, EXISTING INTAKE LOUVER TO REMAIN.
2. REMOVE EXISTING FLOOR MOUNTED UNIT VENTILATOR. CUT BACK EXISTING PIPING SERVING UNIT. REMOVE VALVES AND ASSOCIATED. CUT BACK PORTION OF EXISTING FIN TUBE RADIATION AND COVER AS NECESSARY. DISCONNECT EXISTING CONTROLS.
3. REMOVE EXISTING THERMOSTATS/TEMPERATURE SENSORS, INCLUDING CONTROL WIRING, WIRE MOLDING, CONDUIT, AND ASSOCIATED. BMS CONTROL WIRING TO BE REUSED.
4. REMOVE EXISTING CEILING HUNG UNIT VENTILATOR. CUT BACK EXISTING PIPING SERVING UNIT. REMOVE VALVES AND ASSOCIATED. CUT BACK PORTION OF EXISTING DUCTWORK. REMOVE VIBRATION ISOLATORS AND UNIT SUPPORTS. DISCONNECT EXISTING CONTROLS.
5. CAREFULLY REMOVE EXISTING WINDOW AIR CONDITIONER AND INSULATED PANEL AND TURN OVER TO DISTRICT.
6. CUT AND MODIFY RADIANT PIPING AND COVER TO PREPARE FOR NEW WORK. CUT HOLE IN MASONRY FOR NEW SLEEVE AND LINTEL.
7. REMOVE INDICATED EXISTING HVAC EQUIPMENT IN CLASSROOM AND ANY CORRESPONDING ROOF EQUIPMENT IN ITS ENTIRETY. CUT AND CAP PIPING SERVING UNIT. PATCH AND SEAL ROOF AT PENETRATIONS.

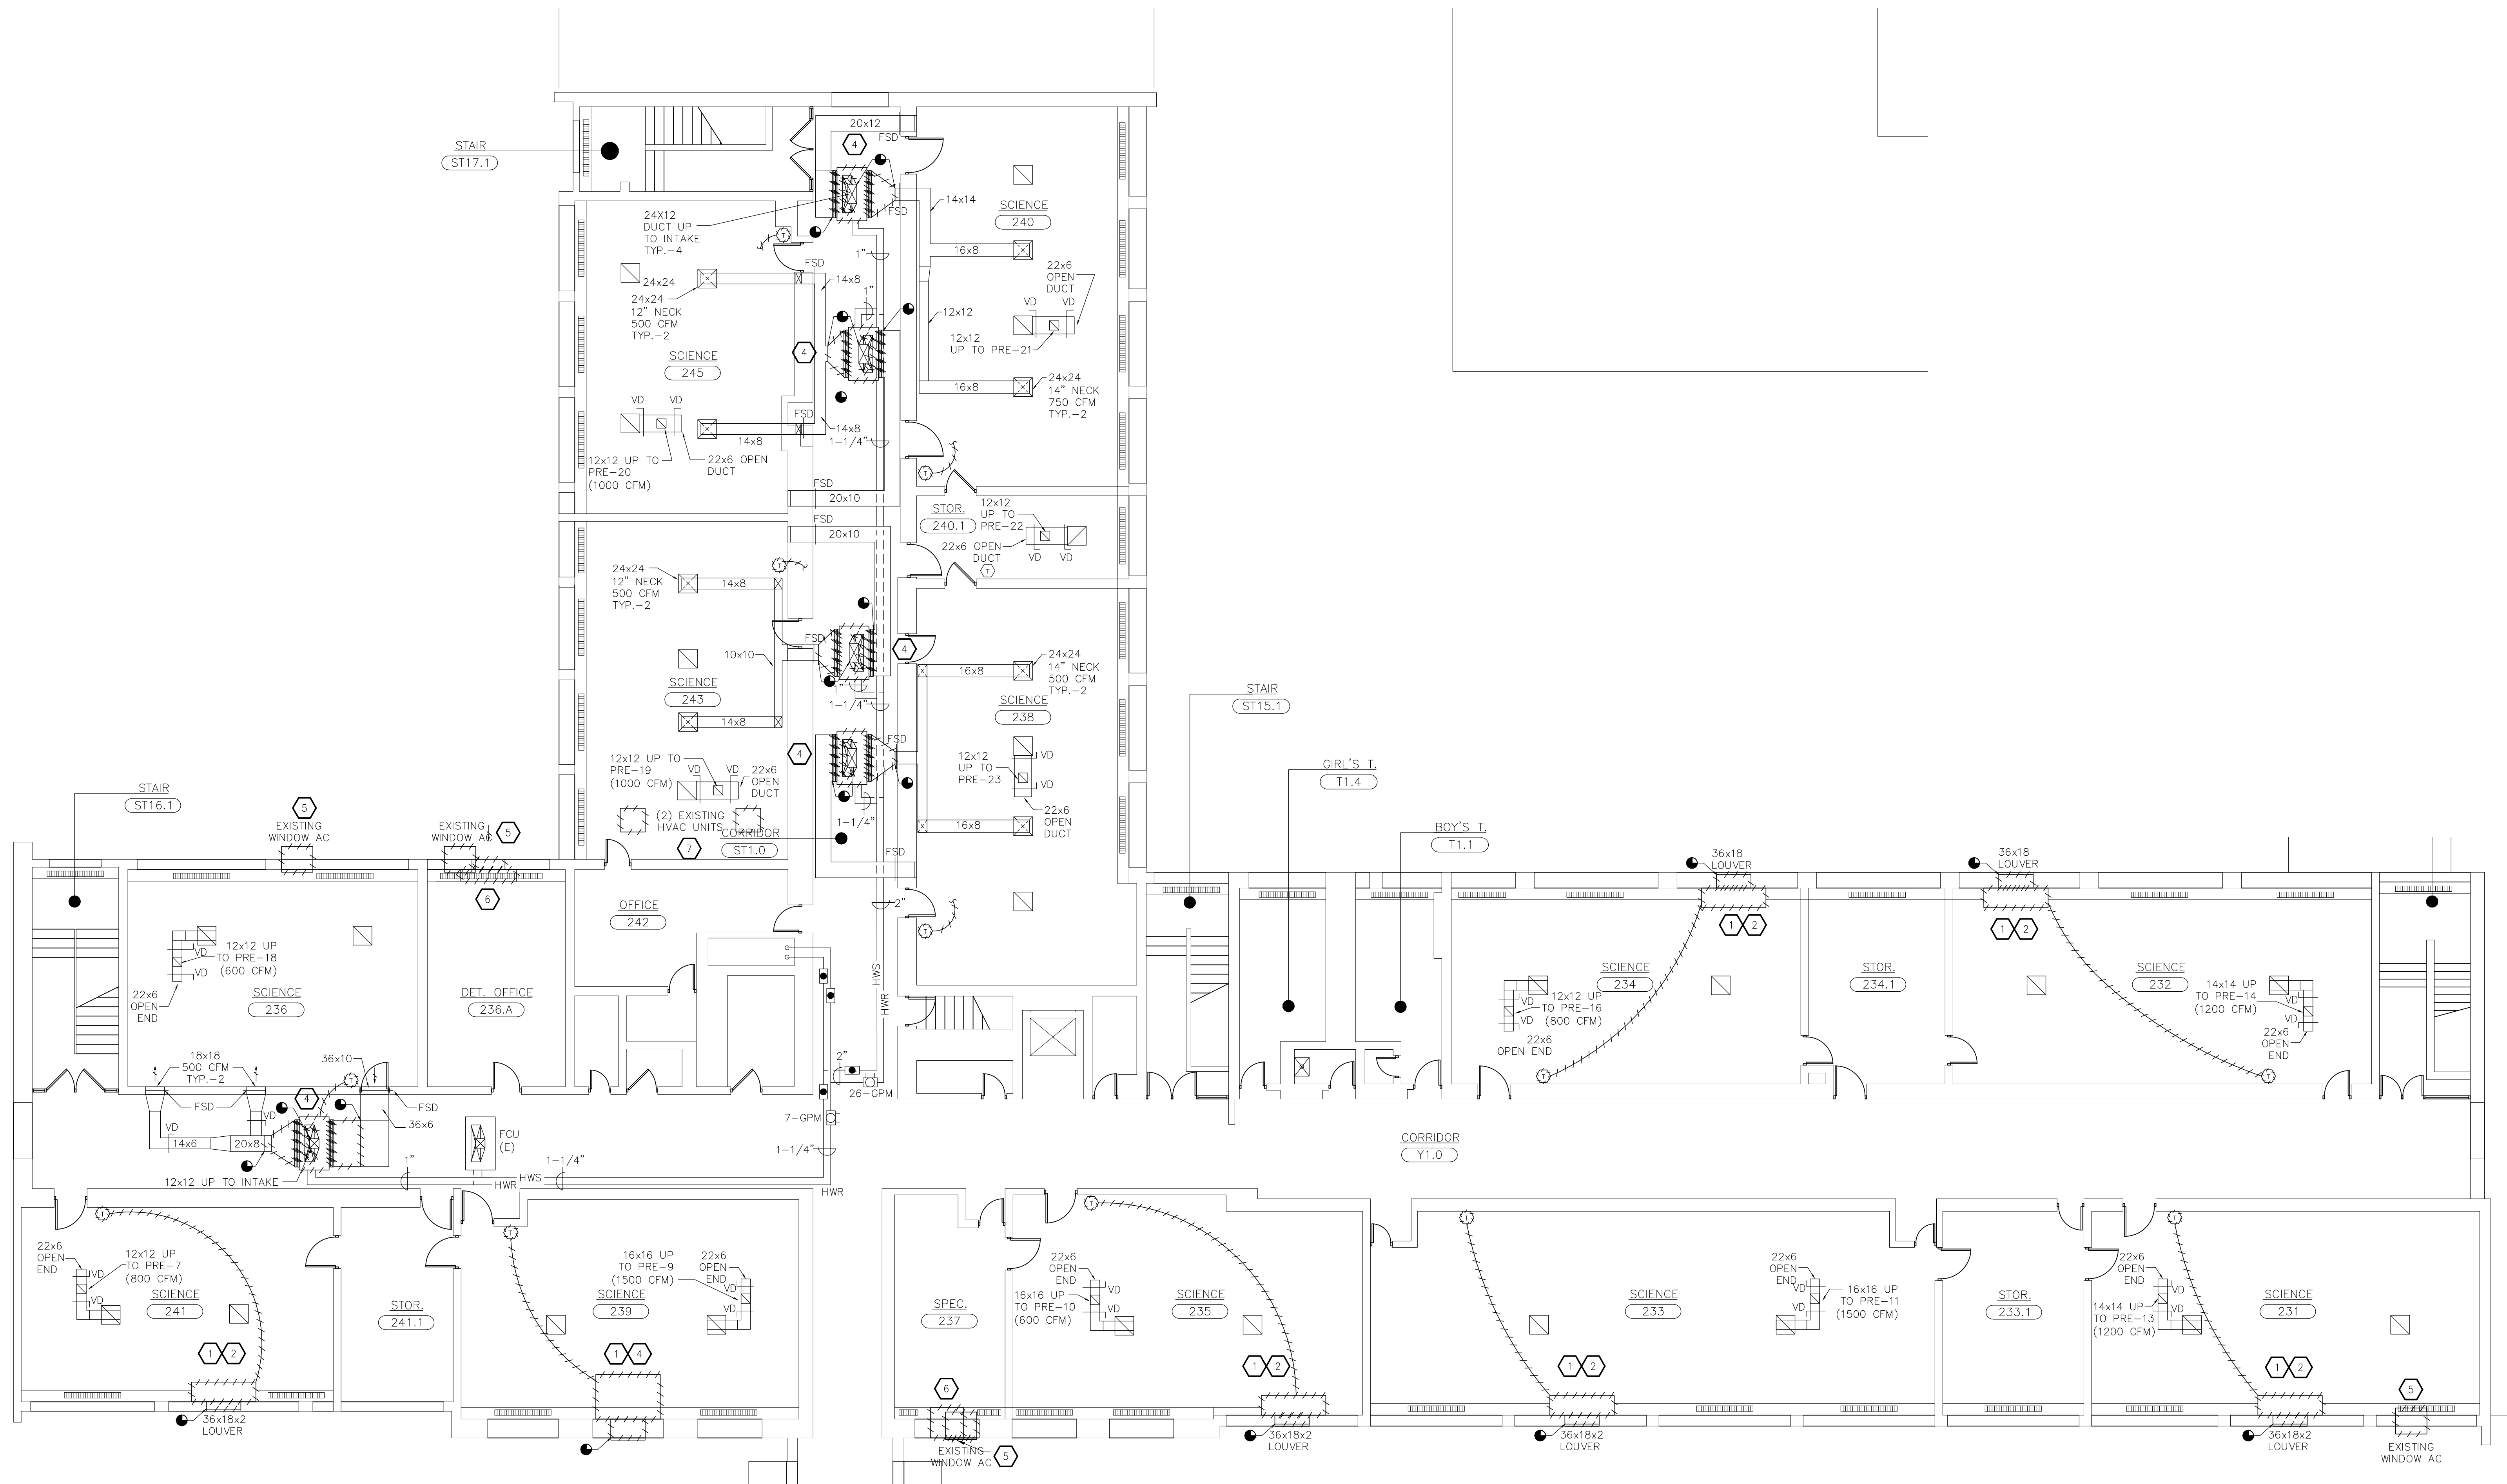**GENERAL NOTES:**


1. PROVIDE ALL ALTERATIONS, RESTORATIONS, AND REPLACEMENTS NECESSARY TO ACCOMMODATE NEW WORK, INCLUDING FIN TUBE COVERS.
2. PROVIDE FIRESTOP AT ALL INTERIOR WALL AND FLOOR PENETRATIONS.
3. SEE UV-C LIGHTING SCHEDULES FOR NEW AND EXISTING EQUIPMENT.



**SECOND FLOOR KEY PLAN**  
SCALE: NONE

ENGINEER:  
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**WARWICK VALLEY CENTRAL SCHOOL DISTRICT  
HIGH SCHOOL UNIT VENTILATOR REPLACEMENT AND  
AIR CONDITIONING UPGRADE**  
225 WEST STREET EXT. WARWICK, NY 10990  
WW HIGH SCHOOL — 89 SANFORDVILLE ROAD, WARWICK, NY 10990  
SED NO. 44-21-01-06-0-001-042


PROJECT NO.	05-21-04 05-20-06
ISSUED FOR BID	11.09.2022
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REVISION	DATE
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CHECKED BY	
SHEET SIZE	30" X 42"
SCALE	AS NOTED
SHEET TITLE	PARTIAL SECOND FLOOR PLAN - REMOVALS
SHEET NO.	

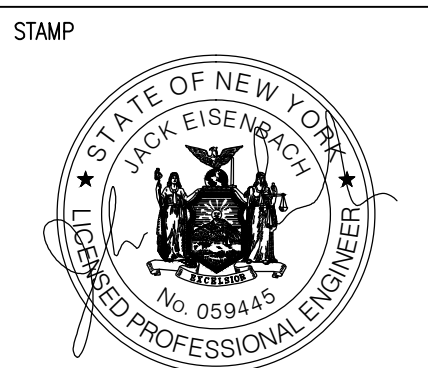**MD-102**


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WW HIGH SCHOOL — 89 SANFORDVILLE ROAD, WARWICK, NY 10990  
SED NO. 44-21-01-06-0-001-042



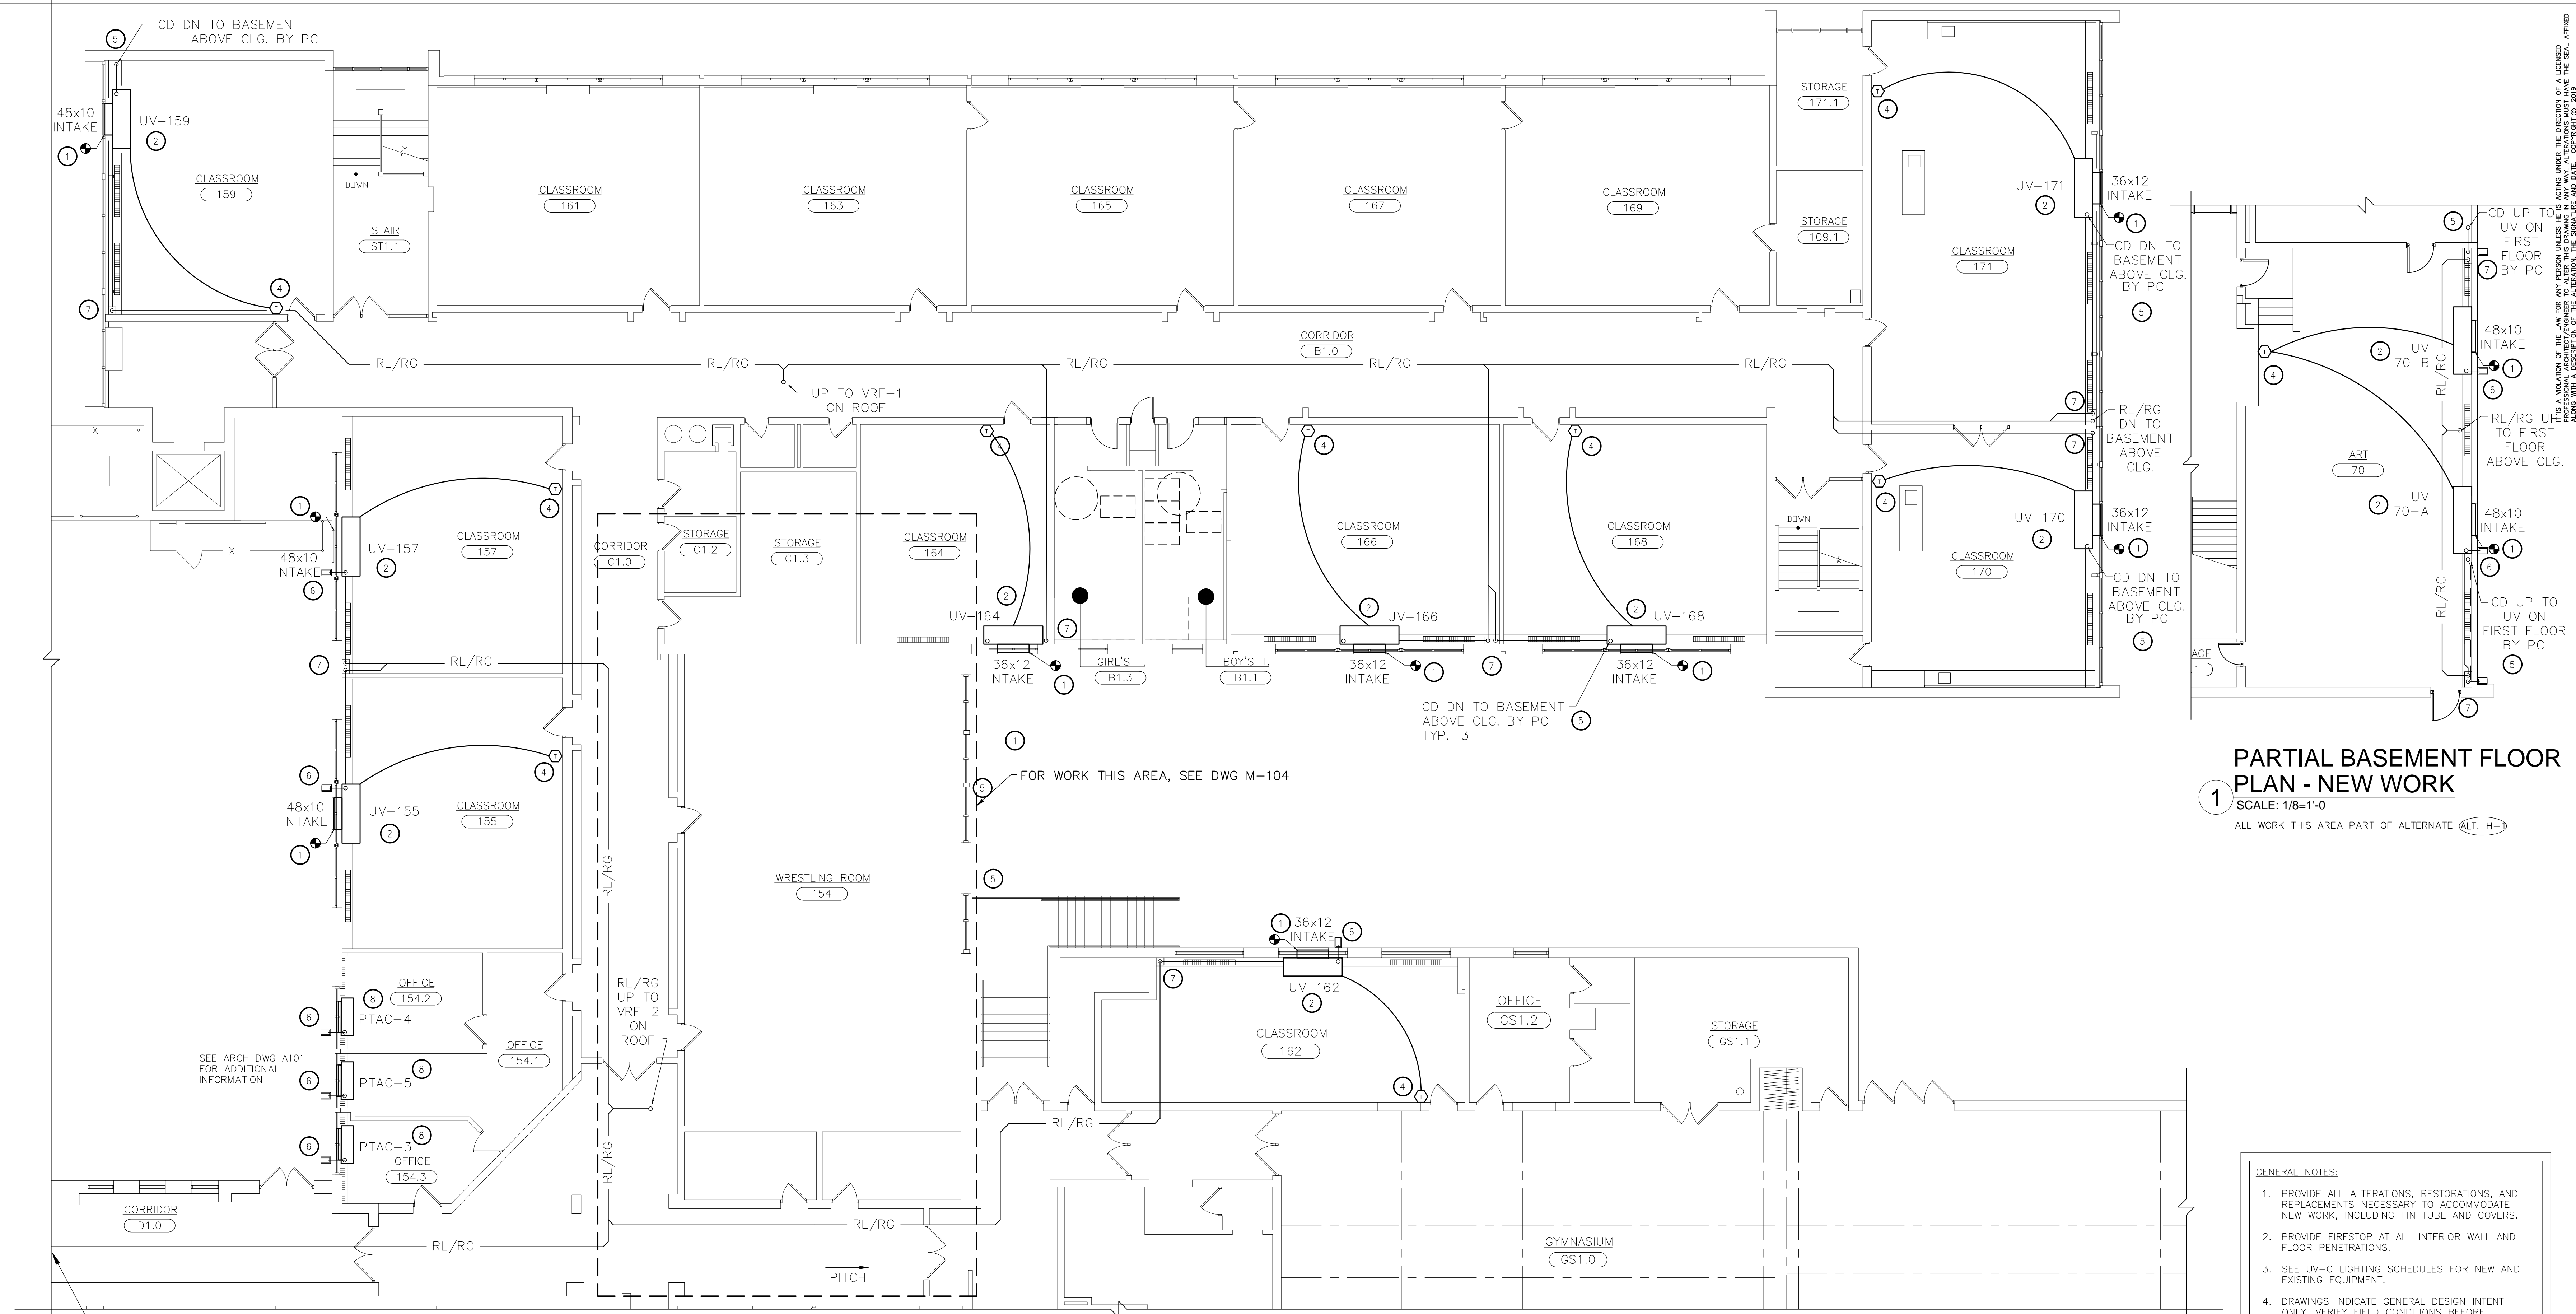

**PARTIAL BASEMENT FLOOR PLAN - NEW WORK**  
SCALE: 1/8"=1'-0"  
ALL WORK THIS AREA PART OF ALTERNATE (ALT. H-1)

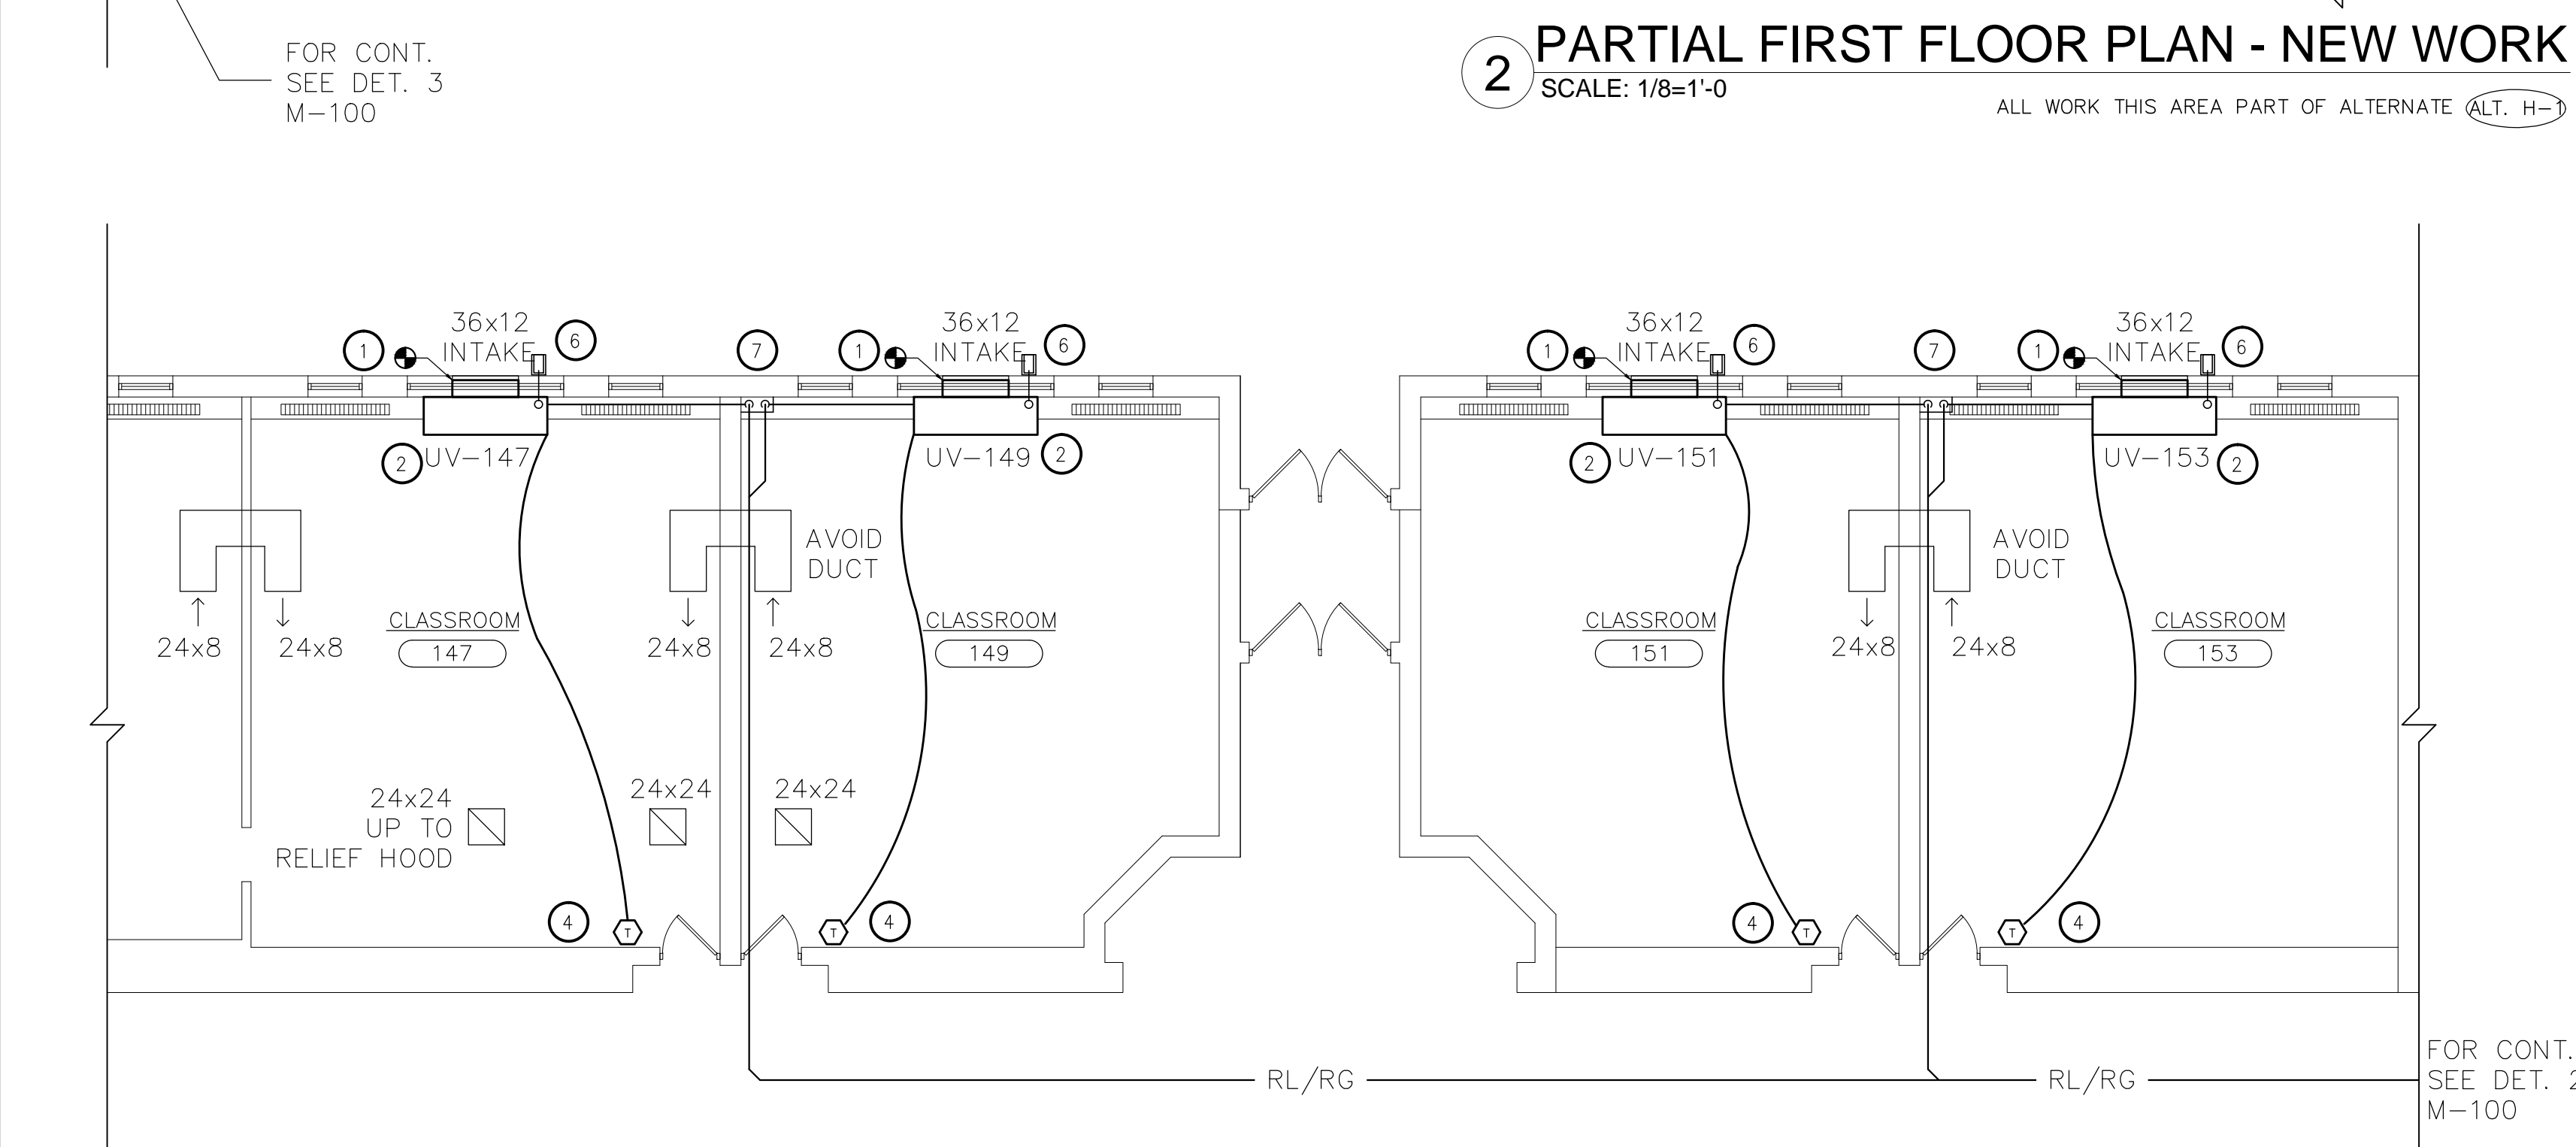

**PARTIAL FIRST FLOOR PLAN - NEW WORK**  
SCALE: 1/8"=1'-0"  
ALL WORK THIS AREA PART OF ALTERNATE (ALT. H-1)


- KEYED NOTES - NEW WORK:**
- 1 PROVIDE INTAKE SLEEVE THROUGH WALL AND CONNECT TO EXISTING INTAKE LOUVER. PROPERLY SUPPORT SLEEVE, CAULK GAPS, AND SEAL AROUND SLEEVE AND INTAKE LOUVER TO MAKE WEATHERTIGHT. VERIFY INTAKE LOUVER IN FIELD.
  - 2 PROVIDE NEW FLOOR MOUNTED UNIT VENTILATORS. SEE SCHEDULE ON M-502. PROVIDE AND CONNECT NEW INSULATED REFRIGERATION PIPING. EXTEND AND PROVIDE PIPING WITH NEW VALVES AND ASSOCIATED TO CONNECT EXISTING HOT WATER PIPING TO NEW UNIT. RECONNECT EXISTING FIN TUBE RADIATION TO RUN BEHIND NEW UNITS. PROVIDE UNIT WITH DRAIN PAN BELOW UNIT COILS AND CONNECT TO CONDENSATE PIPING. RECONNECT AND REUSE CONTROLS WHEN APPLICABLE. PROVIDE ALTERATIONS TO CONTROLS TO MAKE COMPATIBLE WITH NEW UNITS. FIELD VERIFY COIL CONNECTION SIDES BEFORE ORDERING MATERIALS AND EQUIPMENT. REUSE ELECTRICAL CIRCUITS. PROVIDE POWER TO UV'S VRF CONTROLS AND ASSOCIATED.
  - 3 ALL NEW EQUIPMENT TO BE CONNECTED TO AND MONITORED BY THE BMS. COORDINATE WITH DISTRICT CONTROLS VENDOR.
  - 4 PROVIDE NEW WIRED TEMPERATURE SENSOR, CONNECT TO SPECIFIED NEW UNIT AND TO BMS. PROVIDE CONTROL WIRING, WIRE MOLDING, CONDUIT, AND ASSOCIATED TO MATCH EXISTING. MOUNT LOCATION AND WIRE PATH TO MATCH EXISTING. BMS CONTROL WIRING TO BE REUSED WHEN APPLICABLE. VERIFY IN FIELD.
  - 5 INDICATED CONDENSATE PIPING AND CONNECTION TO BE PROVIDED BY PLUMBING CONTRACTOR. MECHANICAL CONTRACTOR TO FURNISH PC WITH SPLASHBLOCKS WHERE APPLICABLE. PC WORK SHOWN FOR REFERENCE ONLY.
  - 6 PROVIDE 3/4" COPPER CONDENSATE PIPING TO THE EXTERIOR. SEE DETAILS FOR MORE INFORMATION. MAKE PENETRATIONS TO EXTERIOR WEATHERTIGHT. PROVIDE SPLASHBLOCKS SLOPED AWAY FROM FOUNDATION.
  - 7 PROVIDE AND SUPPORT SHEET METAL PIPE CHASES FOR REFRIGERANT AND/OR CONDENSATE LINES. MATCH ADJACENT FIN TUBE COVER MATERIALS AND COLORS. FIELD VERIFY DIMENSIONS. COORDINATE WITH PLUMBING CONTRACTOR WORK.
  - 8 PROVIDE NEW PTAC UNIT WITH WALL SLEEVE AND LOUVER. SEE SCHEDULE ON M-502. PROVIDE CONTROLLER TO CONNECT TO BMS; EXTEND AND PROVIDE PIPING WITH NEW VALVES AND ASSOCIATED TO CONNECT EXISTING HOT WATER PIPING TO NEW UNIT. RECONNECT EXISTING FIN TUBE RADIATION TO RUN BEHIND NEW UNITS. PROVIDE CONTROLS COMPATIBLE WITH NEW UNIT. FIELD VERIFY COIL CONNECTION SIDES IN FIELD. REUSE ELECTRICAL CIRCUITS.

**PARTIAL FIRST FLOOR PLAN - NEW WORK**  
SCALE: 1/8"=1'-0"  
ALL WORK THIS AREA PART OF ALTERNATE (ALT. H-1)

**BASEMENT KEY PLAN**  
SCALE: NONE

**FIRST FLOOR KEY PLAN**  
SCALE: NONE

- GENERAL NOTES:**
1. PROVIDE ALL ALTERATIONS, RESTORATIONS, AND REPLACEMENTS NECESSARY TO ACCOMMODATE NEW WORK, INCLUDING FIN TUBE AND COVERS.
  2. PROVIDE FIRESTOP AT ALL INTERIOR WALL AND FLOOR PENETRATIONS.
  3. SEE UV-C LIGHTING SCHEDULES FOR NEW AND EXISTING EQUIPMENT.
  4. DRAWINGS INDICATE GENERAL DESIGN INTENT ONLY. VERIFY FIELD CONDITIONS BEFORE ORDERING MATERIALS AND EQUIPMENT. IDENTIFY CONFLICTS AND SUBMIT IN WRITING TO ENGINEER.
  5. TO ENSURE COMPLIANCE WITH ASHRAE-15, DO NOT RUN REFRIGERANT PIPING IN ROOMS OTHER THAN THOSE SHOWN UNLESS APPROVED BY ENGINEER.
  6. FIN TUBE COVERS THAT MUST BE ALTERED TO ACCOMPLISH WORK SHALL REQUIRE THE ADDITION OF FIN TUBE COVER CAPS/ TRIM TO MATCH EXISTING TO COVER NEWLY FORMED GAPS AND SHARP EDGES. COVERS SHALL REMAIN PROPERLY SUPPORTED. ANY WALL NEWLY EXPOSED AFTER ALTERATION TO BE PAINTED TO MATCH SURROUNDING CONDITIONS.

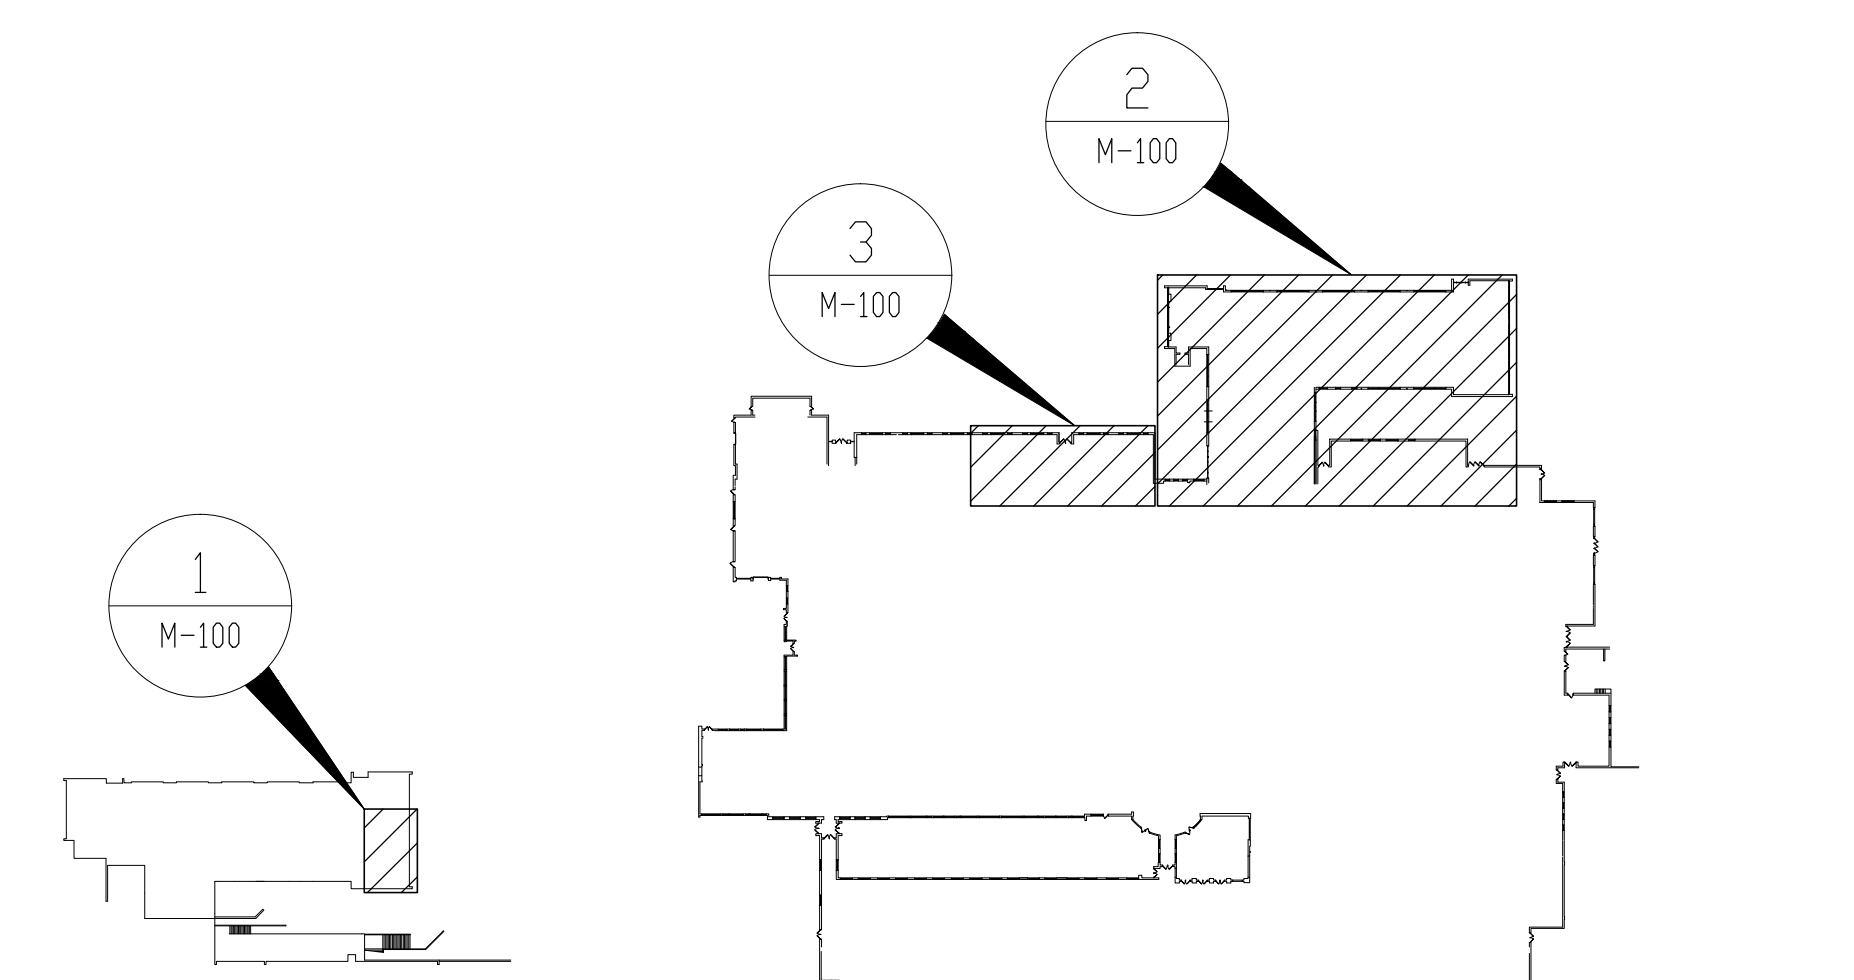

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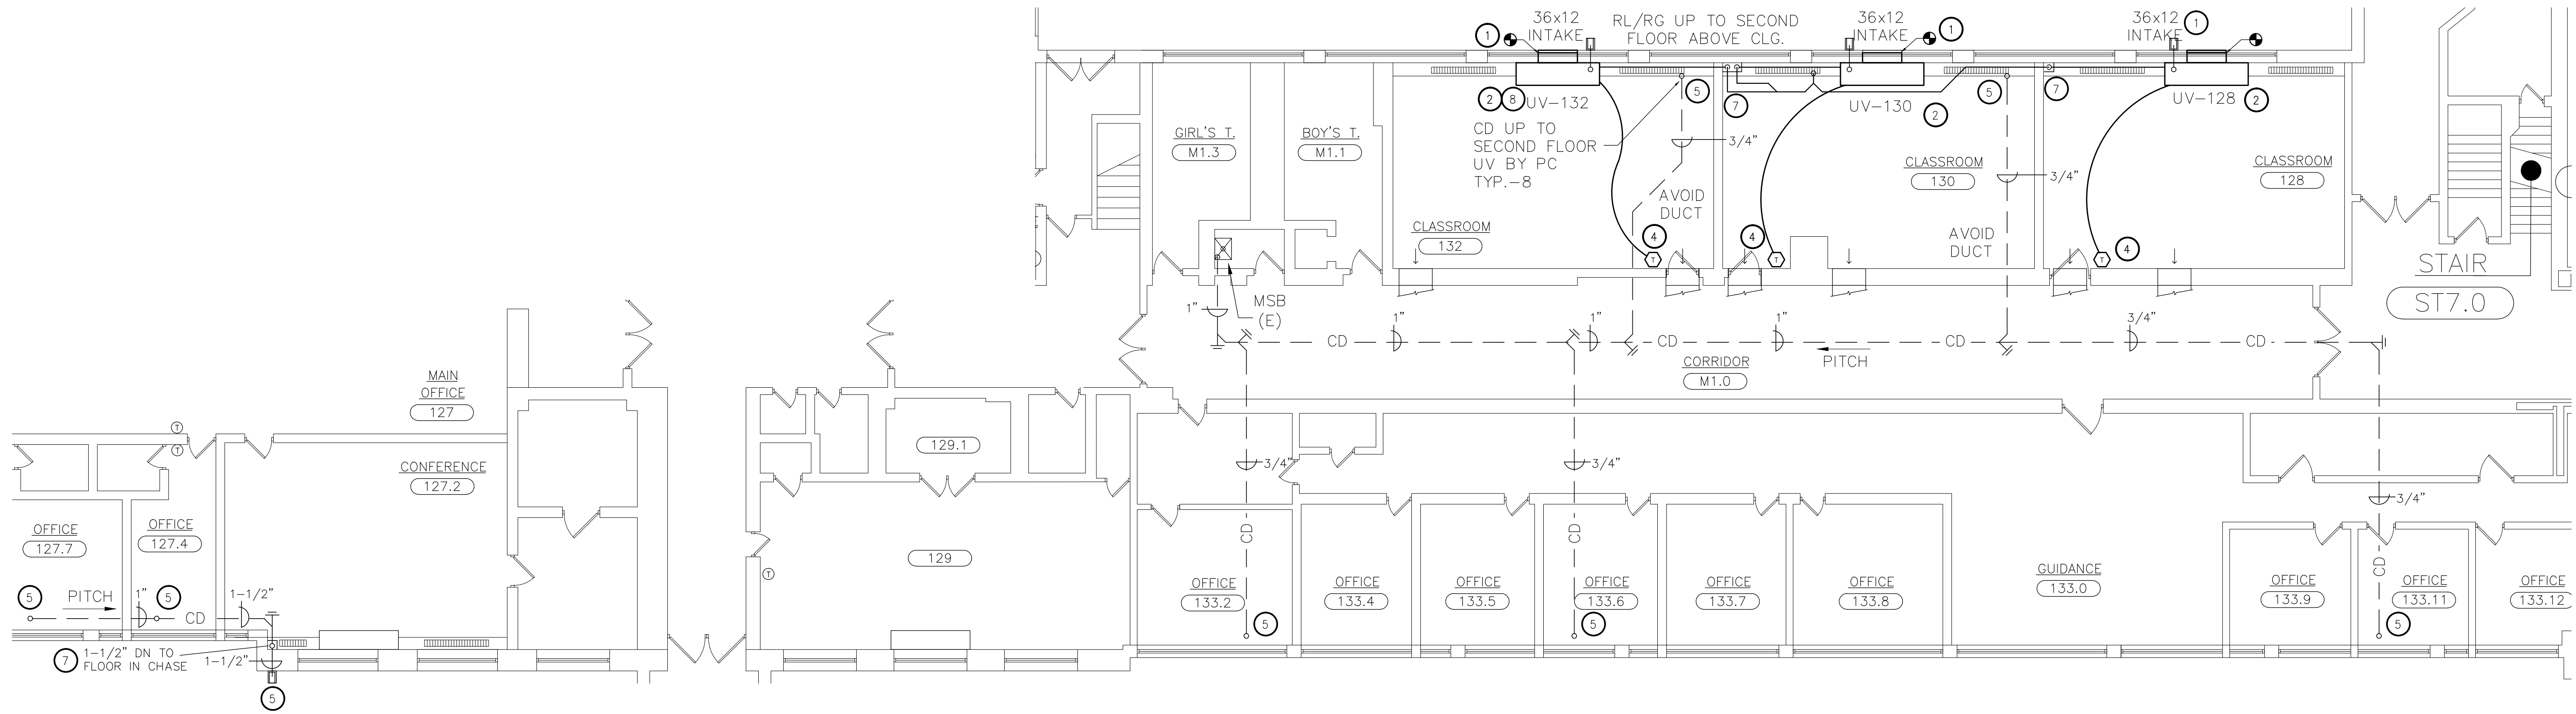
STAMP  
STATE OF NEW YORK  
JAMES J. FULLER  
No. 059445  
Professional Engineer

WARWICK VALLEY CENTRAL SCHOOL DISTRICT  
HIGH SCHOOL UNIT VENTILATOR REPLACEMENT AND  
AIR CONDITIONING UPGRADE  
225 WEST STREET EXT. WARWICK, NY 10990  
WV HIGH SCHOOL - 89 SANFORDVILLE ROAD, WARWICK, NY 10990  
SED NO. 44-21-01-06-0-001-042

PROJECT NO.	05-21-04 05-20-06
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SET	10.19.2022
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CHECKED BY	
SHEET SIZE	30" x 42"
SCALE	AS NOTED
SHEET TITLE <b>PARTIAL BASEMENT AND FIRST FLOOR PLANS - NEW WORK</b>	
SHEET NO. <b>M-100</b>	

FILE PATH - N:\1 - PROJECT DIRECTORIES\1 - E & R Projects\05 - Warwick Valley CSD\05-21-04\Warwick Federal Grant Project\05-21-04-M100-M104, M110.dwg






2 PARTIAL FIRST FLOOR PLAN - NEW WORK  
SCALE: 1/8"=1'-0"

KEYED NOTES - NEW WORK:

- 1 PROVIDE INTAKE SLEEVE THROUGH WALL AND CONNECT TO NEW INTAKE LOUVER. PROPERLY SUPPORT SLEEVE, CAULK GAPS, AND SEAL AROUND SLEEVE AND INTAKE LOUVER TO MAKE WEATHERTIGHT. PROVIDE LINTEL.
- 2 PROVIDE NEW FLOOR MOUNTED UNIT VENTILATORS. SEE SCHEDULE ON M-502. PROVIDE AND CONNECT NEW INSULATED REFRIGERATION PIPING. EXTEND AND PROVIDE PIPING WITH NEW VALVES AND ASSOCIATED TO CONNECT EXISTING HOT WATER PIPING TO NEW UNIT. RECONNECT EXISTING FIN TUBE RADIATION TO RUN BEHIND NEW UNITS. PROVIDE UNIT WITH DRAIN PAN BELOW UNIT COILS AND CONNECT TO CONDENSATE PIPING. RECONNECT AND REUSE CONTROLS WHEN APPLICABLE. PROVIDE ALTERATIONS TO CONTROLS TO MAKE COMPATIBLE WITH NEW UNITS. FIELD VERIFY COIL CONNECTION SIDES BEFORE ORDERING MATERIALS AND EQUIPMENT. REUSE ELECTRICAL CIRCUITS. PROVIDE POWER TO UV'S VRF CONTROLS AND ASSOCIATED.
- 3 ALL NEW EQUIPMENT TO BE CONNECTED TO AND MONITORED BY THE BMS. COORDINATE WITH DISTRICT CONTROLS VENDOR.
- 4 PROVIDE NEW WIRED TEMPERATURE SENSOR, CONNECT TO SPECIFIED NEW UNIT AND TO BMS. PROVIDE CONTROL WIRING, WIRE MOLDING, CONDUIT, AND ASSOCIATED TO MATCH EXISTING. PROVIDE BMS CONTROL WIRING. VERIFY IN FIELD.
- 5 INDICATED CONDENSATE PIPING AND CONNECTION TO BE PROVIDED BY PLUMBING CONTRACTOR. MECHANICAL CONTRACTOR TO FURNISH PC WITH SPLASHBLOCKS WHERE APPLICABLE. PC WORK SHOWN FOR REFERENCE ONLY.
- 6 PROVIDE 3/4" COPPER CONDENSATE PIPING TO THE EXTERIOR. SEE DETAILS FOR MORE INFORMATION. MAKE PENETRATIONS TO EXTERIOR WEATHERTIGHT. PROVIDE SPLASHBLOCKS SLOPED AWAY FROM FOUNDATION.
- 7 PROVIDE AND SUPPORT SHEET METAL PIPE CHASES FOR REFRIGERANT AND/OR CONDENSATE LINES. MATCH ADJACENT FIN TUBE COVER MATERIALS AND COLORS. FIELD VERIFY DIMENSIONS. COORDINATE WITH PLUMBING CONTRACTOR WORK.
- 8 EXTEND UNIT VENTILATOR HYDRONIC HEATING CIRCUIT TO NEW UNIT VENTILATOR FROM NEAREST MAIN. VERIFY IN FIELD PRIOR TO BID.

GENERAL NOTES:

1. PROVIDE ALL ALTERATIONS, RESTORATIONS, AND REPLACEMENTS NECESSARY TO ACCOMMODATE NEW WORK, INCLUDING FIN TUBE AND COVERS.
2. PROVIDE FIRESTOP AT ALL INTERIOR WALL AND FLOOR PENETRATIONS.
3. SEE UV-C LIGHTING SCHEDULES FOR NEW AND EXISTING EQUIPMENT.
4. DRAWINGS INDICATE GENERAL DESIGN INTENT ONLY. VERIFY FIELD CONDITIONS BEFORE ORDERING MATERIALS AND EQUIPMENT. IDENTIFY CONFLICTS AND SUBMIT IN WRITING TO ENGINEER.
5. TO ENSURE COMPLIANCE WITH ASHRAE-15, DO NOT RUN REFRIGERANT PIPING IN ROOMS OTHER THAN THOSE SHOWN UNLESS APPROVED BY ENGINEER.
6. FIN TUBE COVERS THAT MUST BE ALTERED TO ACCOMPLISH WORK SHALL REQUIRE THE ADDITION OF FIN TUBE COVER CAPS/ TRIM TO MATCH EXISTING TO COVER NEWLY FORMED GAPS AND SHARP EDGES. COVERS SHALL REMAIN PROPERLY SUPPORTED. ANY WALL NEWLY EXPOSED AFTER ALTERATION TO BE PAINTED TO MATCH SURROUNDING CONDITIONS.

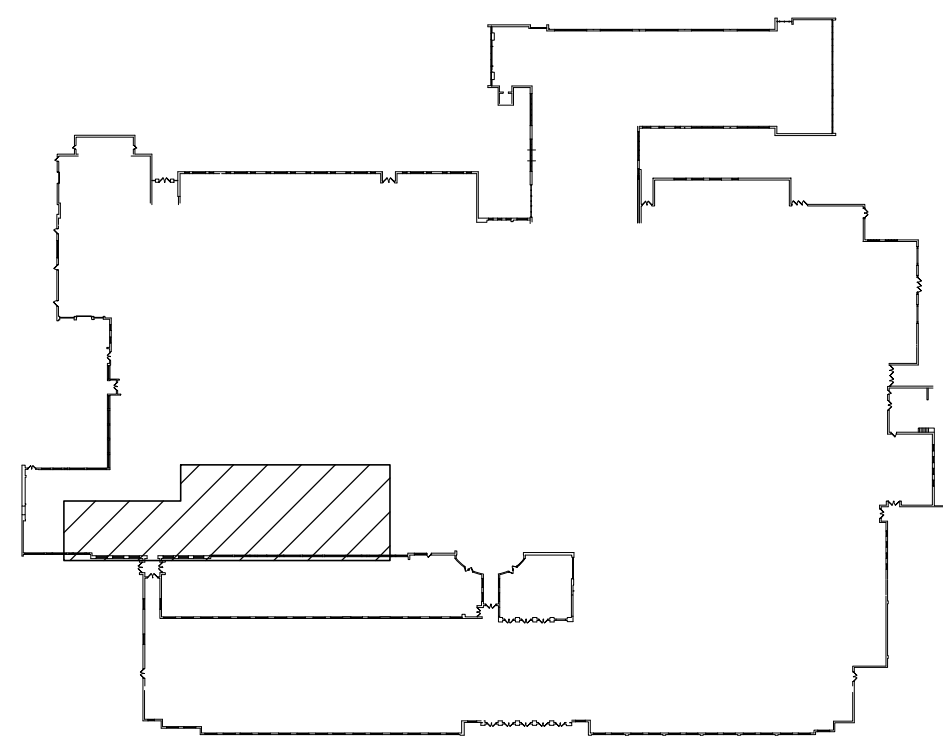

FIRST FLOOR KEY PLAN  
SCALE: NONE



WARWICK VALLEY CENTRAL SCHOOL DISTRICT  
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M-101


ENGINEER:  
**ER**  
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FILE PATH - N:\1 - PROJECT DIRECTORIES\1 - E & R Projects\05 - Warwick Valley CSD\05-21-04 Warwick Federal Grant Project\05-21-04-M100-M104, M110.dwg



**1 PARTIAL SECOND FLOOR PLAN - NEW WORK**  
SCALE: 1/8"=1'-0"

**KEYED NOTES - NEW WORK:**


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- 6 PROVIDE NEW HORIZONTAL UNIT VENTILATOR. SEE SCHEDULE ON M-502. PROVIDE AND CONNECT NEW INSULATED REFRIGERATION PIPING. EXTEND AND PROVIDE PIPING WITH NEW VALVES AND ASSOCIATED TO CONNECT EXISTING HOT WATER PIPING TO NEW UNIT. PROVIDE DUCTWORK TO CONNECT AND TRANSITION SUPPLY, RETURN, AND OUTSIDE AIR DUCTWORK TO NEW UNIT. PROVIDE VIBRATION ISOLATORS AND FLEXIBLE CONNECTIONS. SUPPORT UNIT AND DUCTWORK FROM STRUCTURE. PROVIDE INSULATION TO DUCTWORK. RECONNECT AND REUSE CONTROLS WHEN APPLICABLE. PROVIDE ALTERATIONS TO CONTROLS TO MAKE COMPATIBLE WITH NEW UNITS. FIELD VERIFY COIL CONNECTION SIDES IN FIELD. SEE SPECIFICATIONS REGARDING AN ALLOWANCE FOR REPAIR AND REPLACEMENT OF DUCTWORK INSULATION AS NEEDED.
- 7 PROVIDE AND SUPPORT SHEET METAL PIPE CHASES FOR REFRIGERANT PIPING AND/OR CONDENSATE PIPING. MATCH ADJACENT FIN TUBE COVER MATERIALS AND COLORS. FIELD VERIFY DIMENSIONS. COORDINATE WITH PLUMBING CONTRACTOR WORK.
- 8 PROVIDE NEW PTAC UNIT WITH WALL SLEEVE AND LOUVER. SEE SCHEDULE ON M-502. PROVIDE CONTROLLER TO CONNECT TO BMS. EXTEND AND PROVIDE PIPING WITH NEW VALVES AND ASSOCIATED TO CONNECT EXISTING HOT WATER PIPING TO NEW UNIT. RECONNECT EXISTING FIN TUBE RADIATION TO RUN BEHIND NEW UNITS. PROVIDE CONTROLS COMPATIBLE WITH NEW UNIT. FIELD VERIFY COIL CONNECTION SIDES IN FIELD. REUSE ELECTRICAL CIRCUITS.
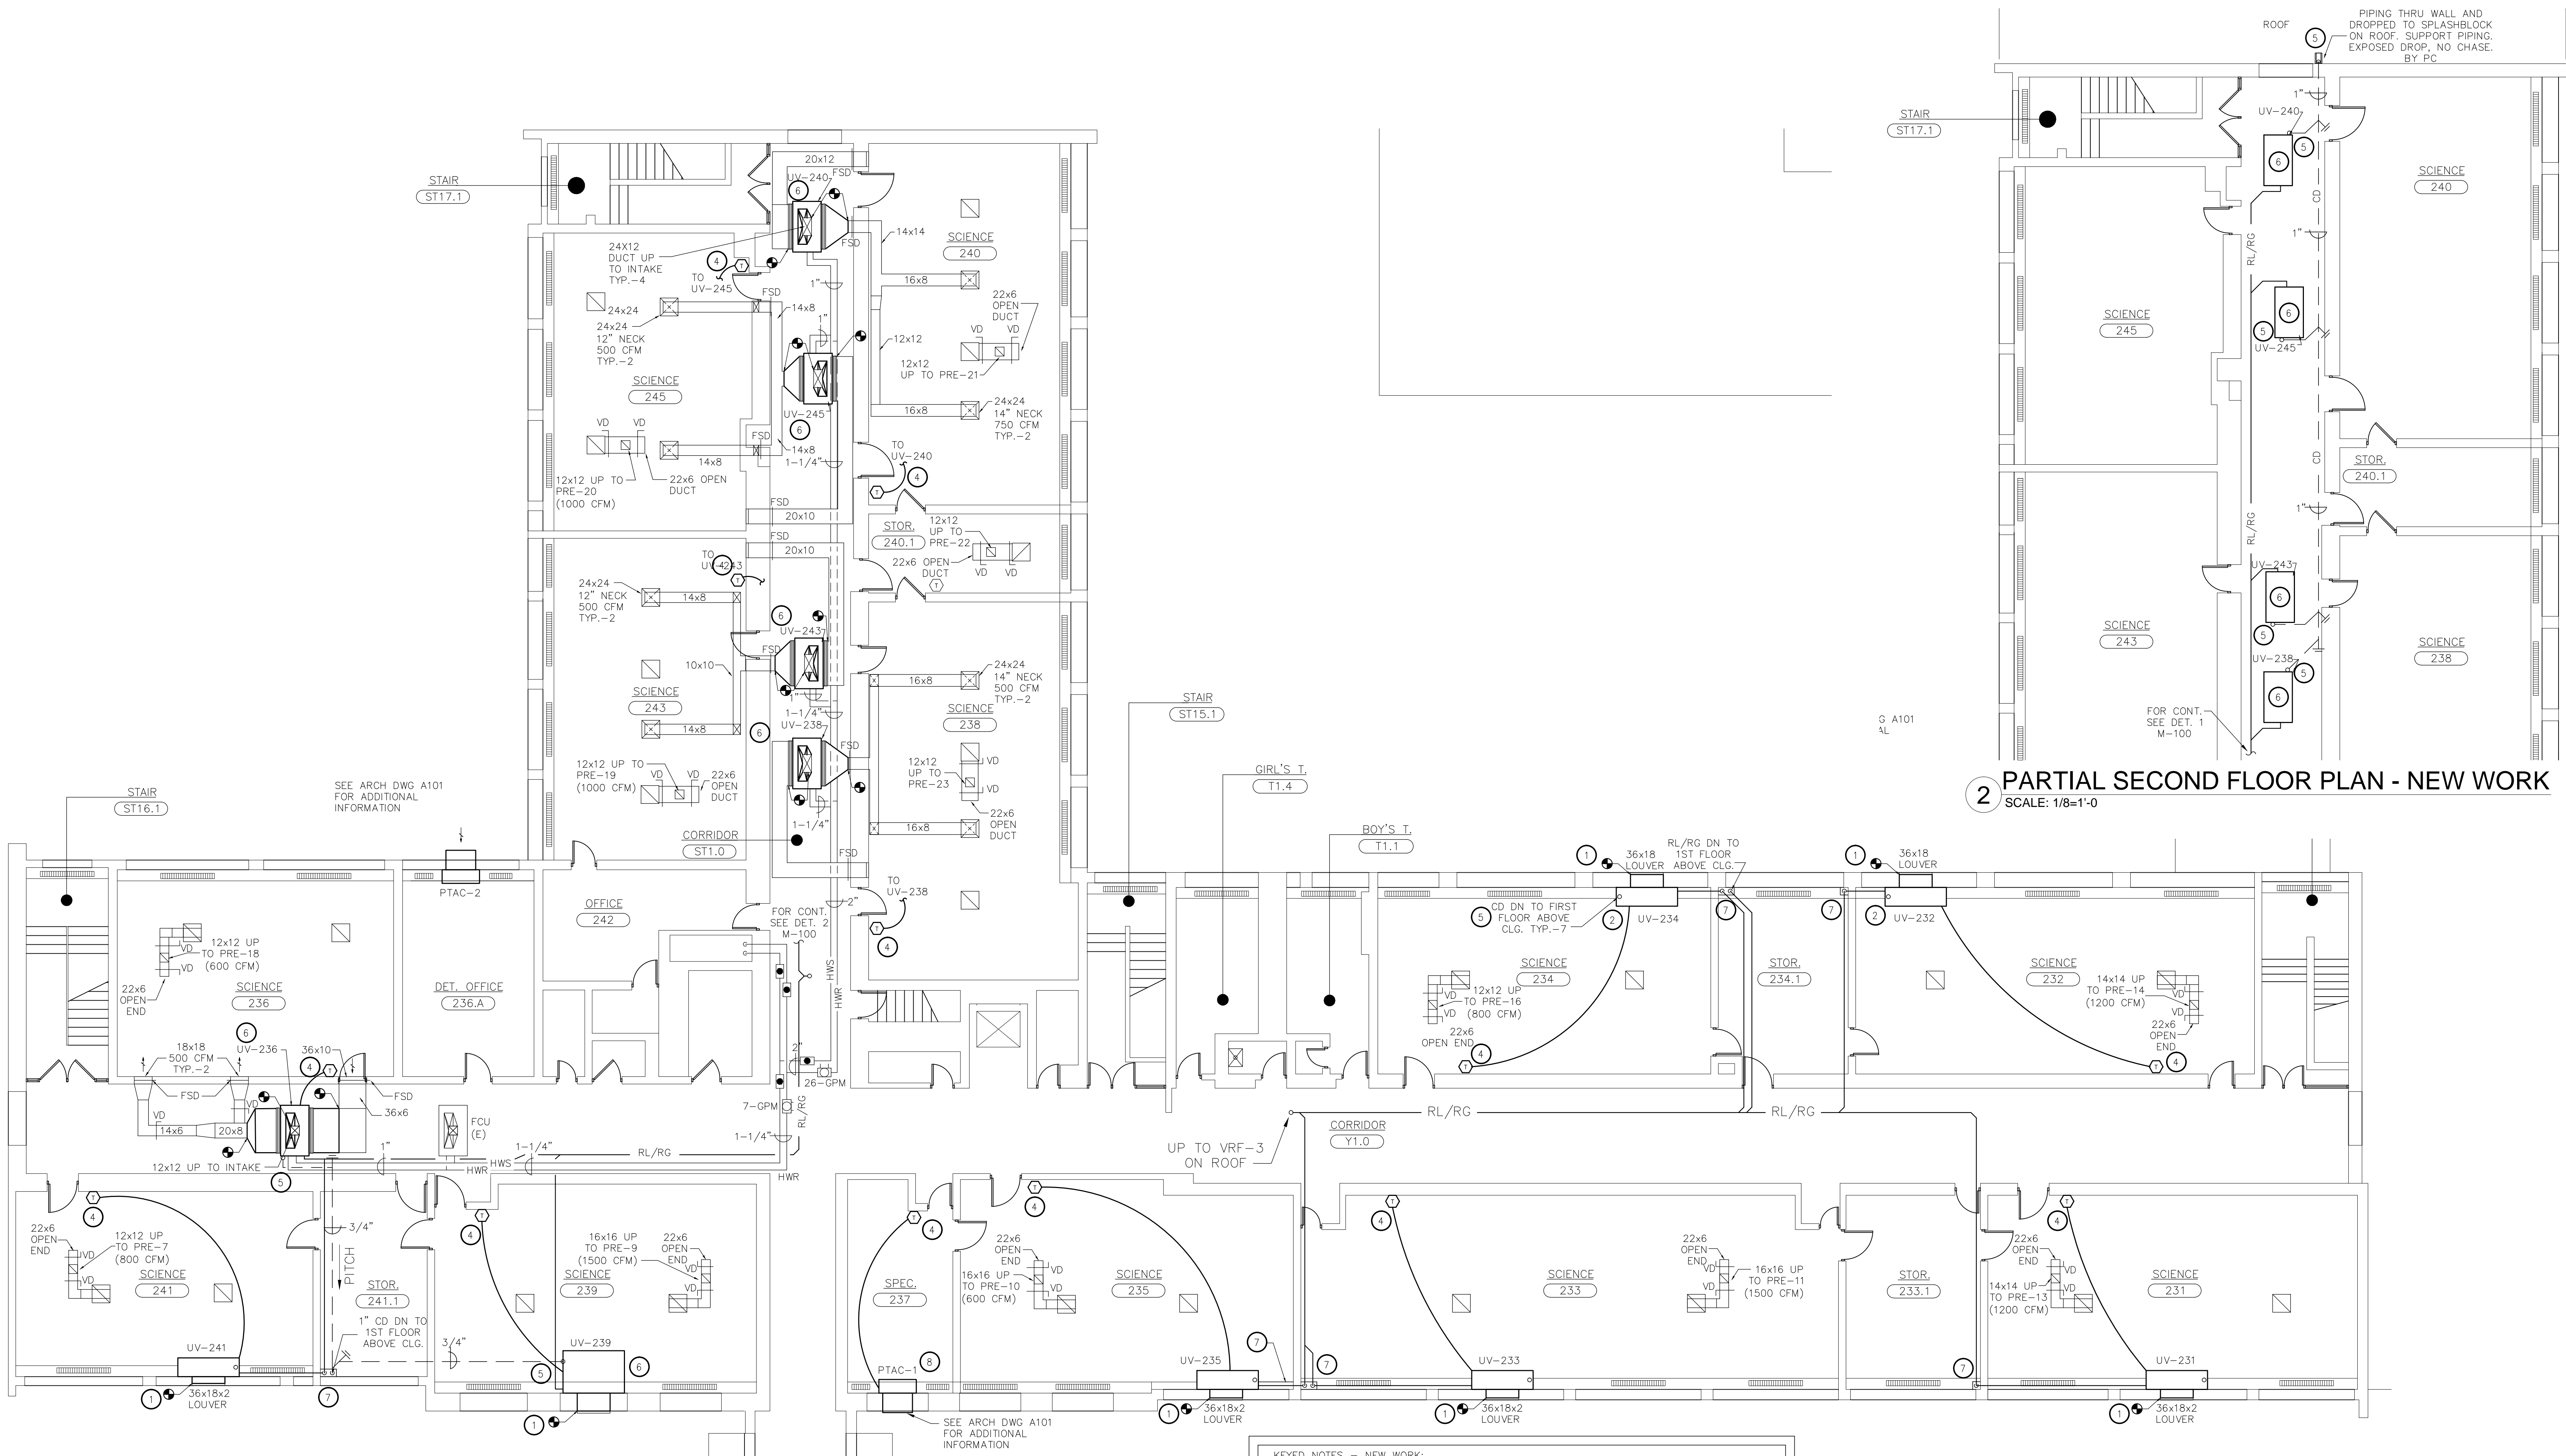
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2. PROVIDE FIRESTOP AT ALL INTERIOR WALL AND FLOOR PENETRATIONS.
3. SEE UV-C LIGHTING SCHEDULES FOR NEW AND EXISTING EQUIPMENT.
4. DRAWINGS INDICATE GENERAL DESIGN INTENT ONLY. VERIFY FIELD CONDITIONS BEFORE ORDERING MATERIALS AND EQUIPMENT. IDENTIFY CONFLICTS AND SUBMIT IN WRITING TO ENGINEER.
5. TO ENSURE COMPLIANCE WITH ASHRAE-15, DO NOT RUN REFRIGERANT PIPING IN ROOMS OTHER THAN THOSE SHOWN UNLESS APPROVED BY ENGINEER.
6. FIN TUBE COVERS THAT MUST BE ALTERED TO ACCOMPLISH WORK SHALL REQUIRE THE ADDITION OF FIN TUBE COVER CAPS/ TRIM TO MATCH EXISTING TO COVER NEWLY FORMED GAPS AND SHARP EDGES. COVERS SHALL REMAIN PROPERLY SUPPORTED. ANY WALL NEWLY EXPOSED AFTER ALTERATION TO BE PAINTED TO MATCH SURROUNDING CONDITIONS.

**SECOND FLOOR KEY PLAN**

SCALE: NONE

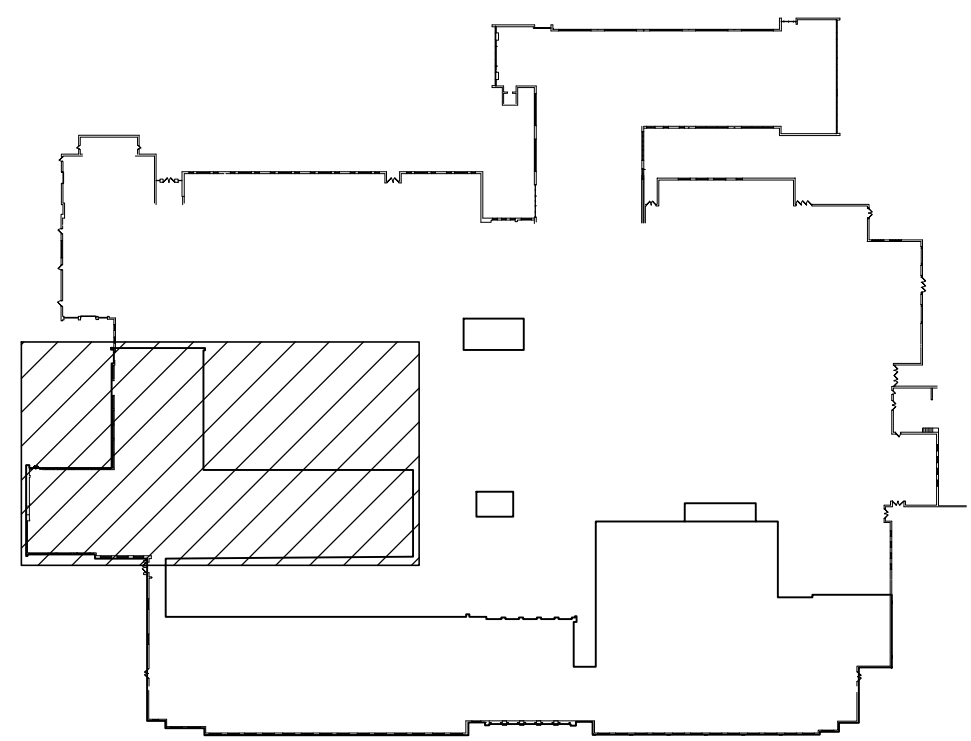

**2 PARTIAL SECOND FLOOR PLAN - NEW WORK**  
SCALE: 1/8"=1'-0"

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ENGINEER:

**Eisenbach & Ruhke Engineering, P.C.**  
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TEL: 914.892.4444  
WWW.EENGPC.COM

CONSULTANT(S):

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**ARCHITECTS  
PLANNERS**

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**WARWICK VALLEY CENTRAL SCHOOL DISTRICT  
HIGH SCHOOL UNIT VENTILATOR REPLACEMENT AND  
AIR CONDITIONING UPGRADE**

225 WEST STREET EXT. WARWICK, NY 10990

WW HIGH SCHOOL - 89 SANFORDVILLE ROAD, WARWICK, NY 10990


SED NO. 44-21-01-06-0-001-042

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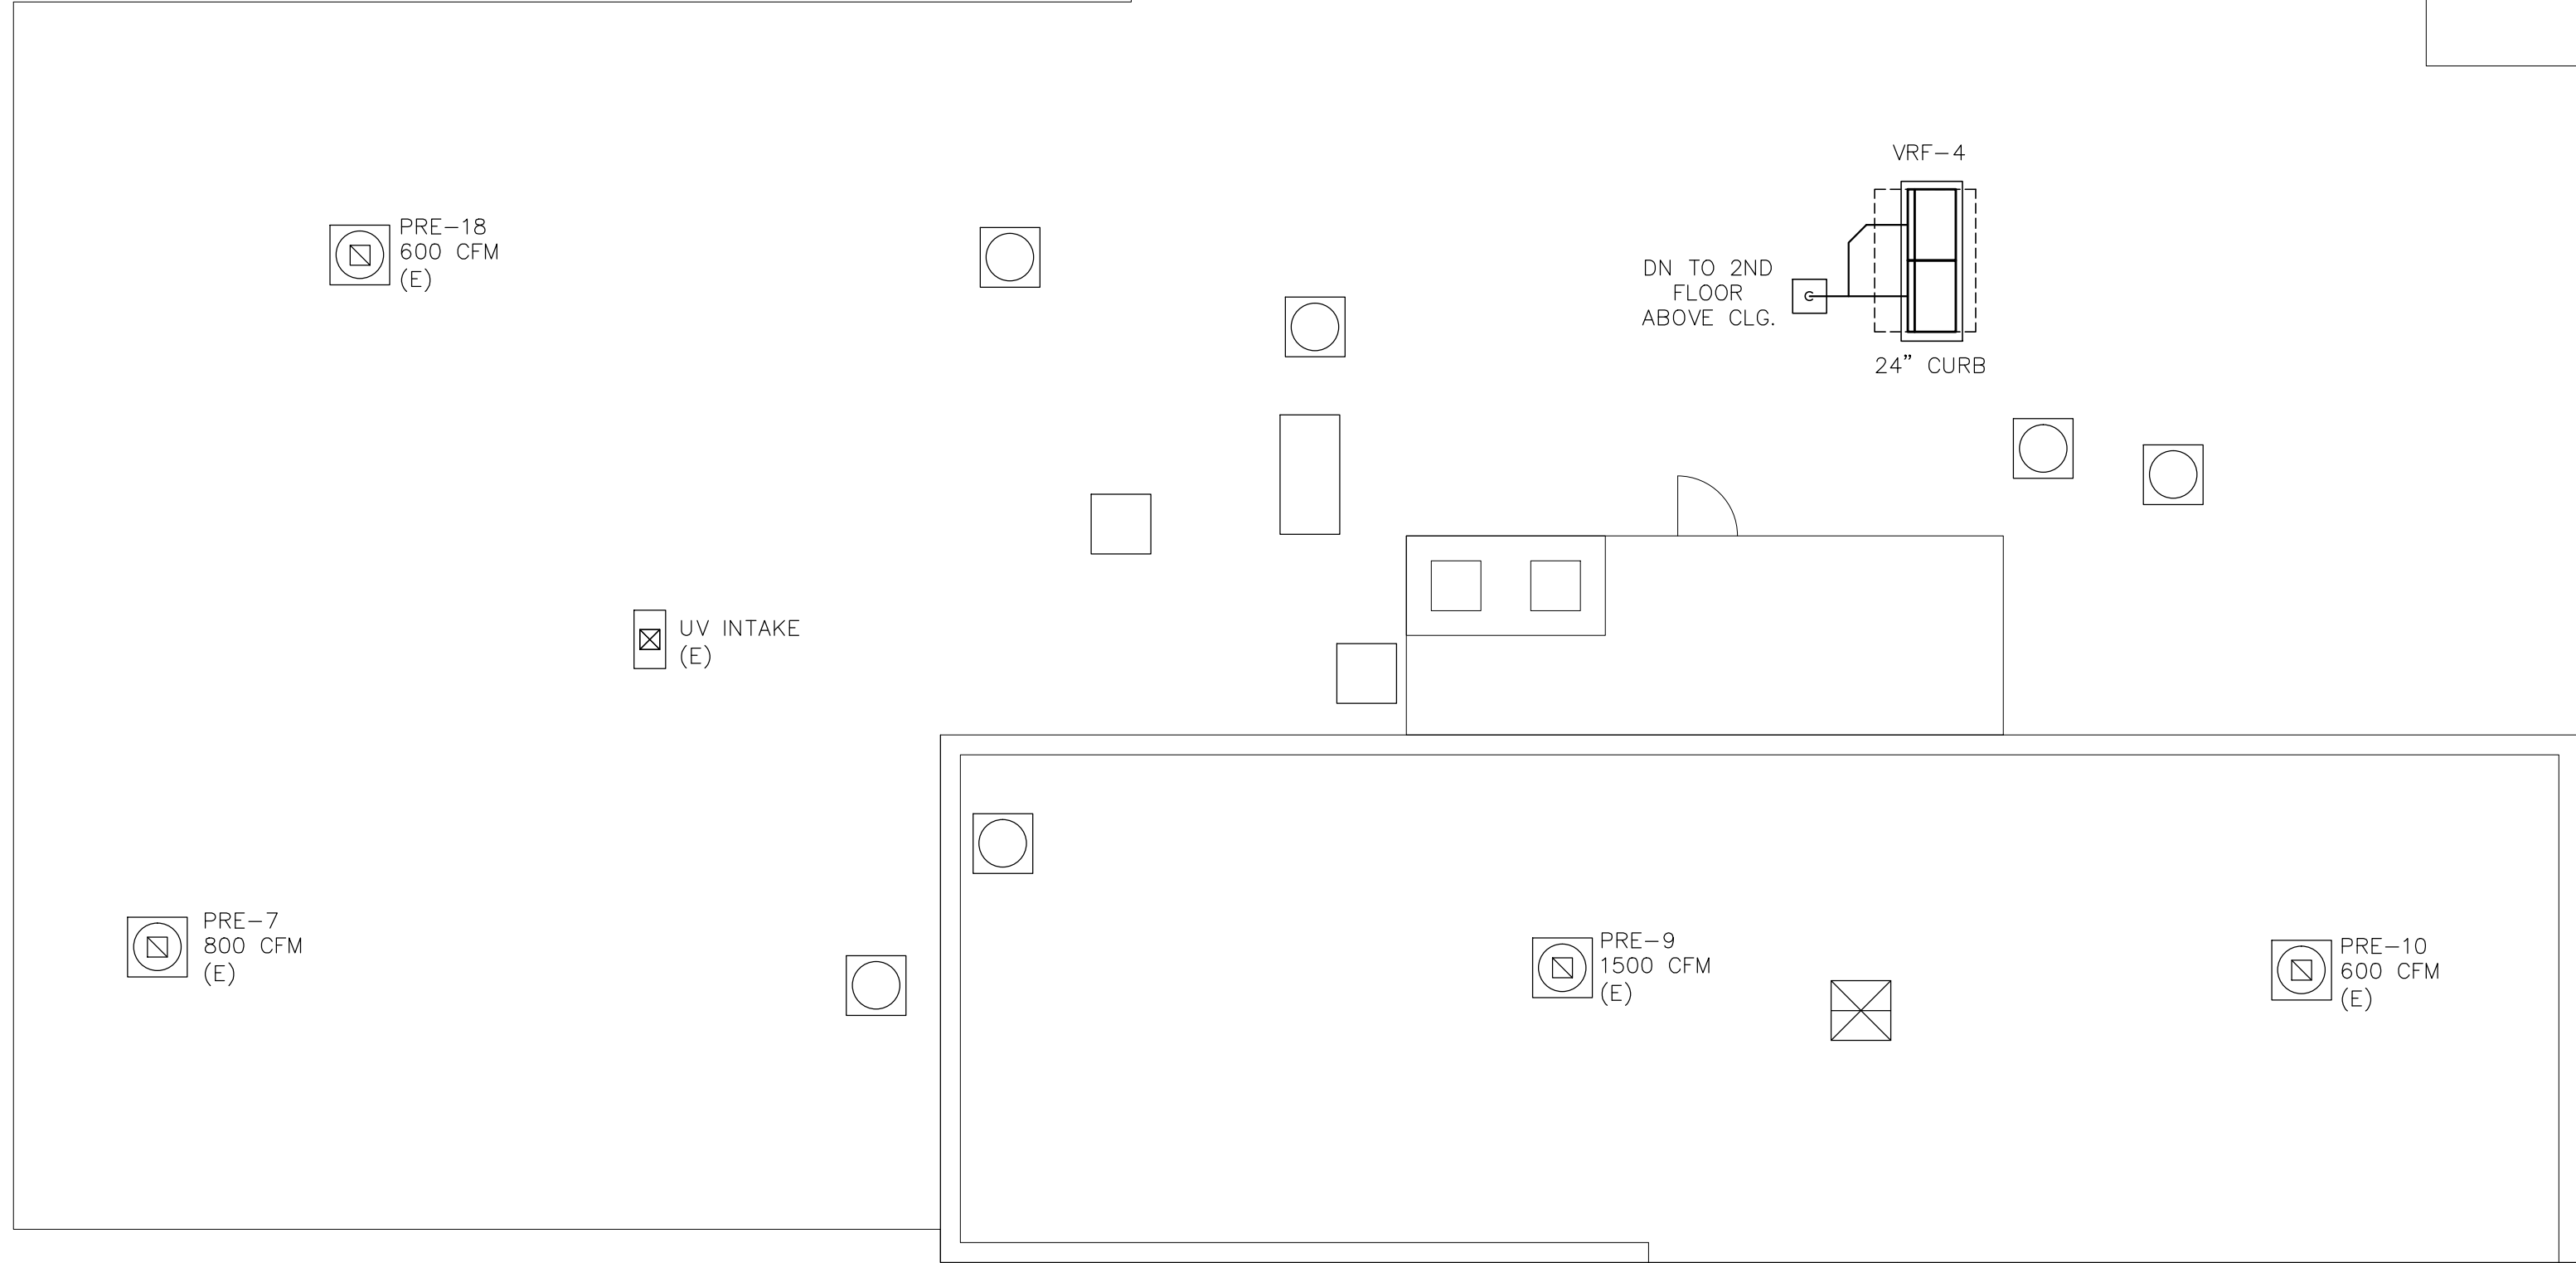
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ISSUED FOR BID	11.09.2022
SED SET	10.19.2022
REVISION	DATE
DRAWN BY	
CHECKED BY	
SHEET SIZE	30" X 42"
SCALE	AS NOTED
SHEET TITLE	PARTIAL SECOND FLOOR PLAN - NEW WORK
SHEET NO.	

**M-102**



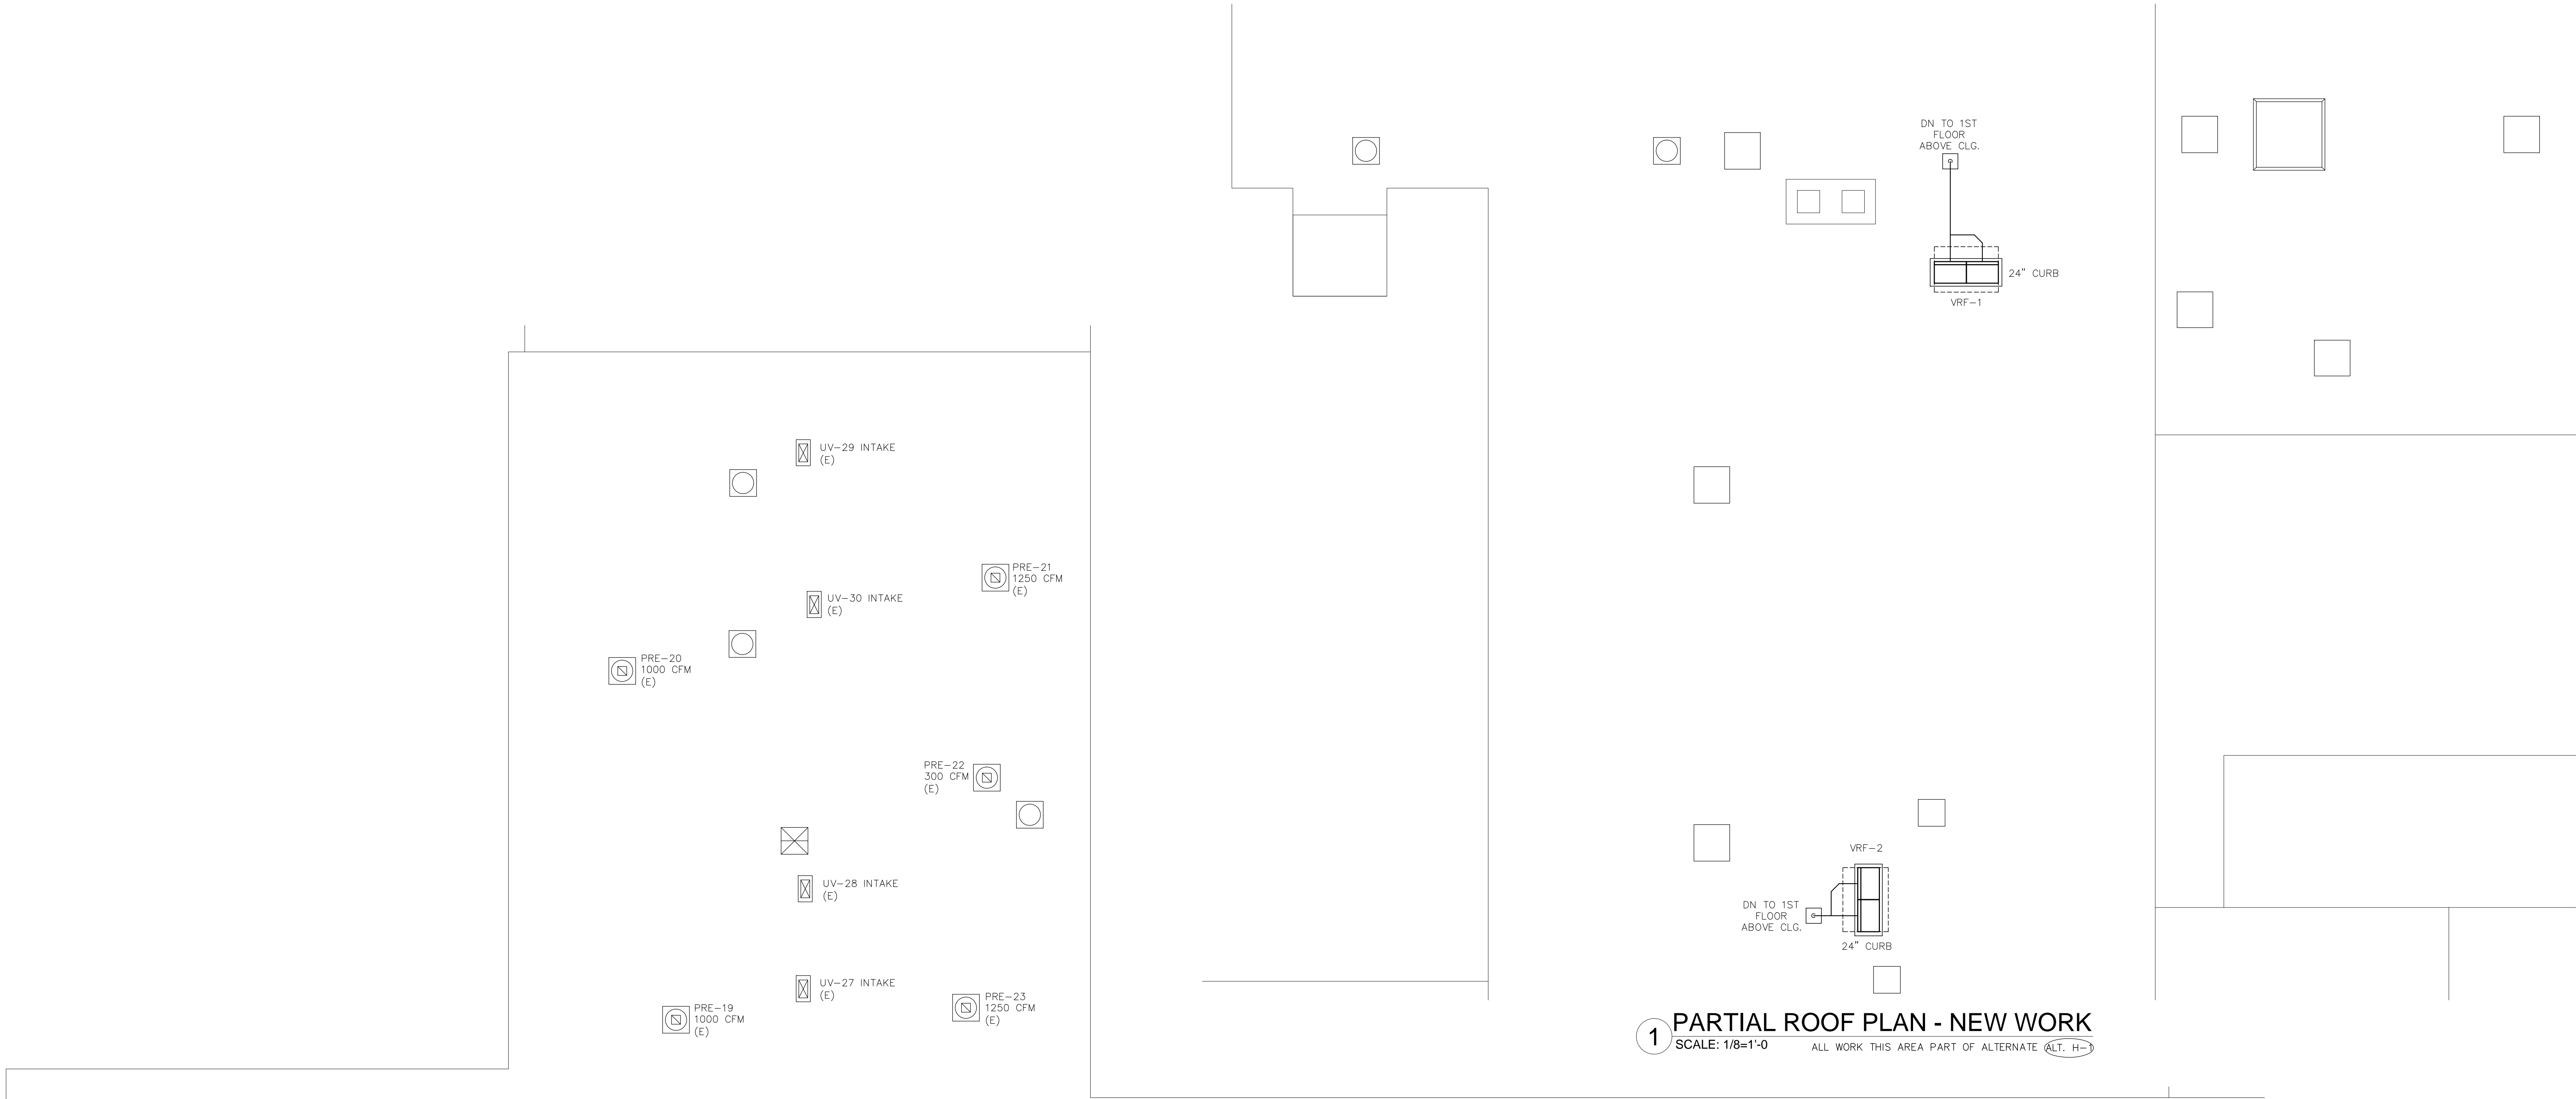


1 PARTIAL ROOF PLAN - NEW WORK  
SCALE: 1/8"=1'-0" ALL WORK THIS AREA PART OF ALTERNATE ALT. H-1



2 PARTIAL ROOF PLAN - NEW WORK  
SCALE: 1/8"=1'-0"

- KEYED NOTES -- NEW WORK:
- 1 PROVIDE NEW VRF ON NEW 24" CURB. PROVIDE MULTI-UNIT CONNECTION PIPING KIT, REFRIGERANT PIPING, INSULATION, ROOF PIPING SUPPORTS, AND ROOF PIPE PORTAL SEAL ROOF PENETRATION TO BE WEATHER TIGHT AND TO MAINTAIN ROOF WARRANTY. CONNECT VRF TO EMS.
  - 2 PLACEMENT OF VRFS AND PENETRATIONS ARE APPROXIMATE. VERIFY FIELD CONDITIONS. COORDINATE WITH ALL TRADES.

- GENERAL NOTES:
1. PROVIDE ALL ALTERATIONS, RESTORATIONS, AND REPLACEMENTS NECESSARY TO ACCOMMODATE NEW WORK.
  2. ALL WORK ON ROOF MUST BE COORDINATED TO MAINTAIN ROOF WARRANTY.
  3. DRAWINGS INDICATE GENERAL DESIGN INTENT ONLY. VERIFY FIELD CONDITIONS BEFORE ORDERING MATERIALS AND EQUIPMENT. IDENTIFY CONFLICTS AND SUBMIT IN WRITING TO ENGINEER.

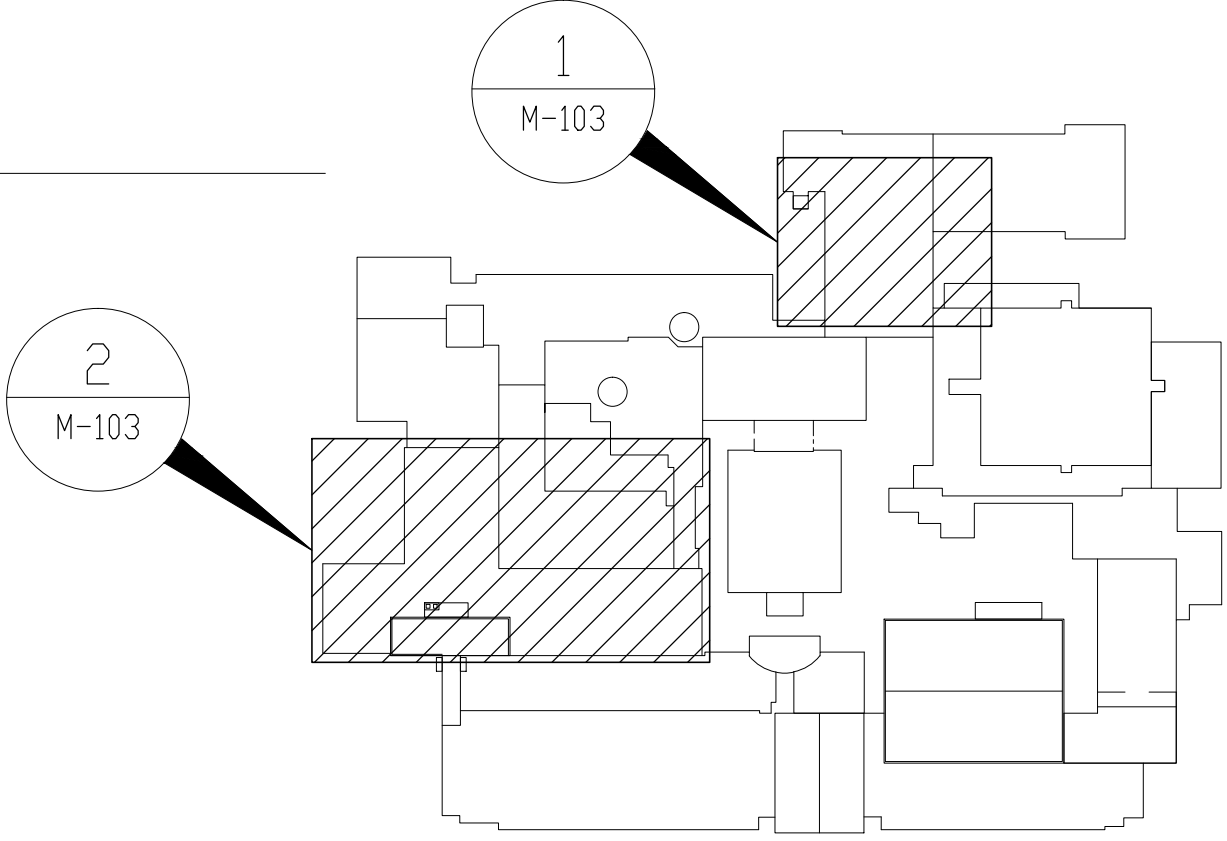

ROOF KEY PLAN  
SCALE: NONE

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Eisenbach & Ruhke Engineering, P.C.  
299 Connetquot Street - Union, NY 13501  
TEL: 518.535.7118, fax: 518.535.8165  
www.erenge.com





CONSULTANT(S):  
  
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WARWICK VALLEY CENTRAL SCHOOL DISTRICT  
HIGH SCHOOL UNIT VENTILATOR REPLACEMENT AND  
AIR CONDITIONING UPGRADE  
225 WEST STREET EXT. WARWICK, NY 10990  
WV HIGH SCHOOL - 89 SANFORDVILLE ROAD, WARWICK, NY 10990  
SED NO. 44-21-01-06-0-001-042


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ISSUED FOR BID	11.09.2022
SED SET	10.19.2022
REVISION	DATE
DRAWN BY	
CHECKED BY	
SHEET SIZE	30" X 42"
SCALE	AS NOTED
SHEET TITLE	PARTIAL ROOF PLAN - NEW WORK
SHEET NO.	M-103

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
**ENGINEER:**



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201 Genesee Street • Utica, NY 13501  
Ph 315-726-1916 Fax 315-726-8365  
[www.ericpe.com](http://www.ericpe.com)

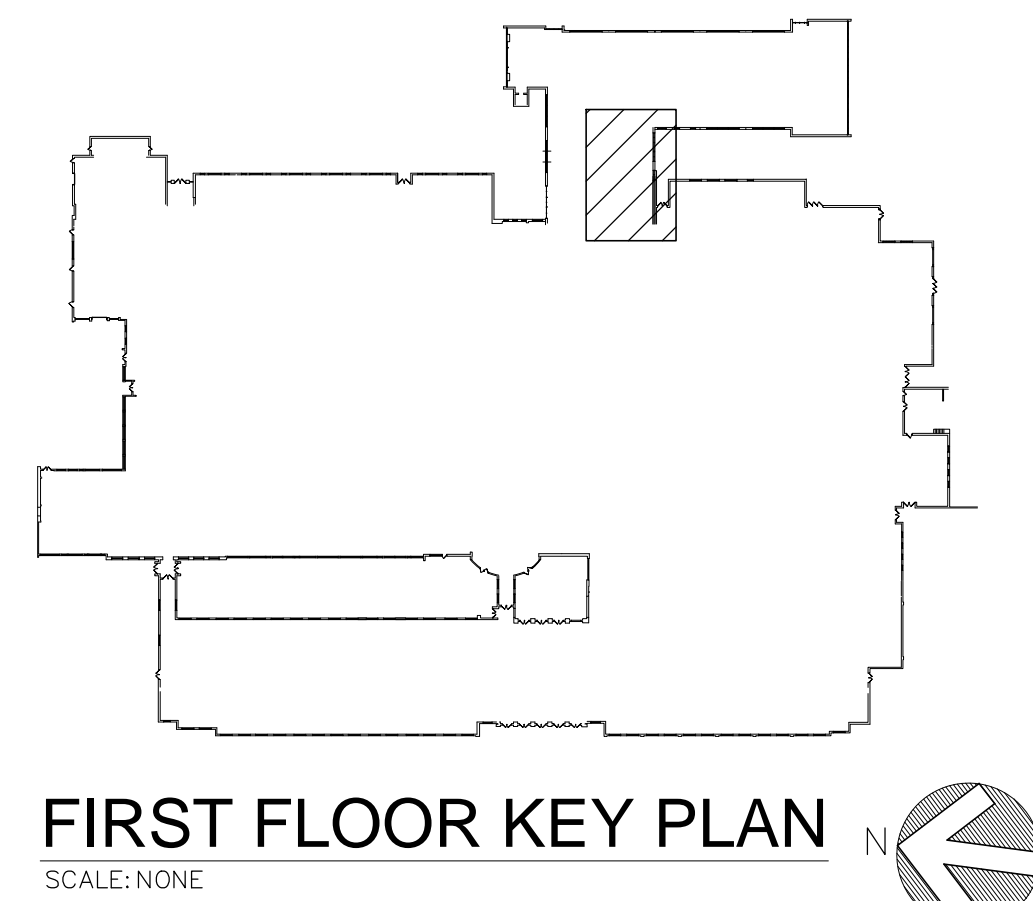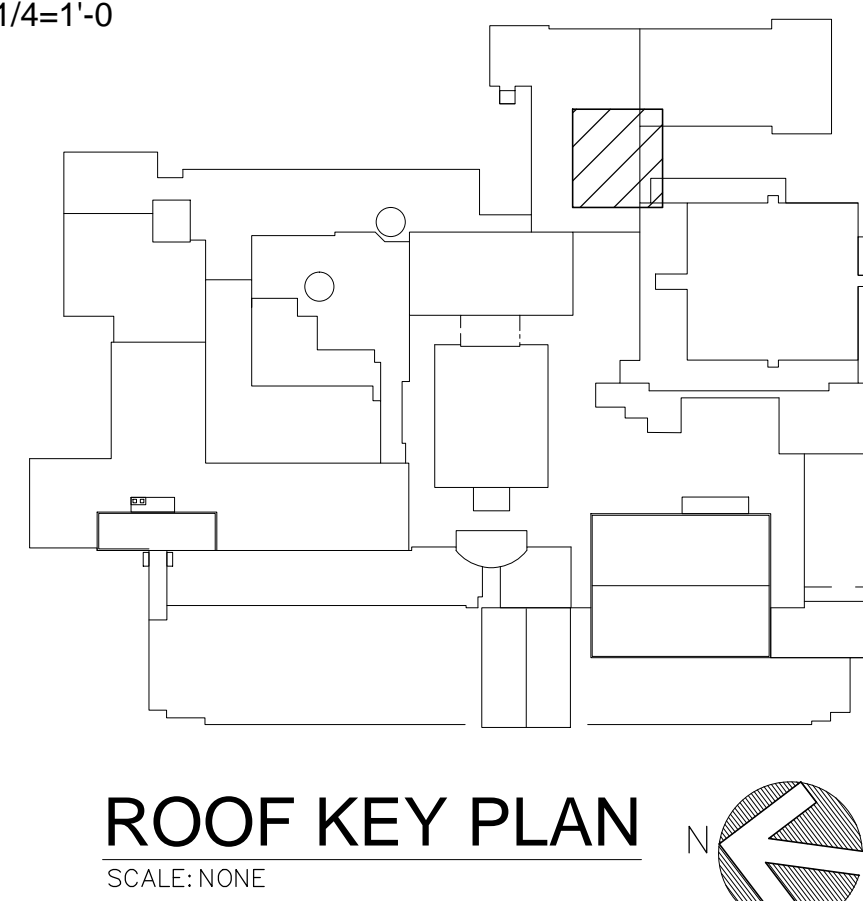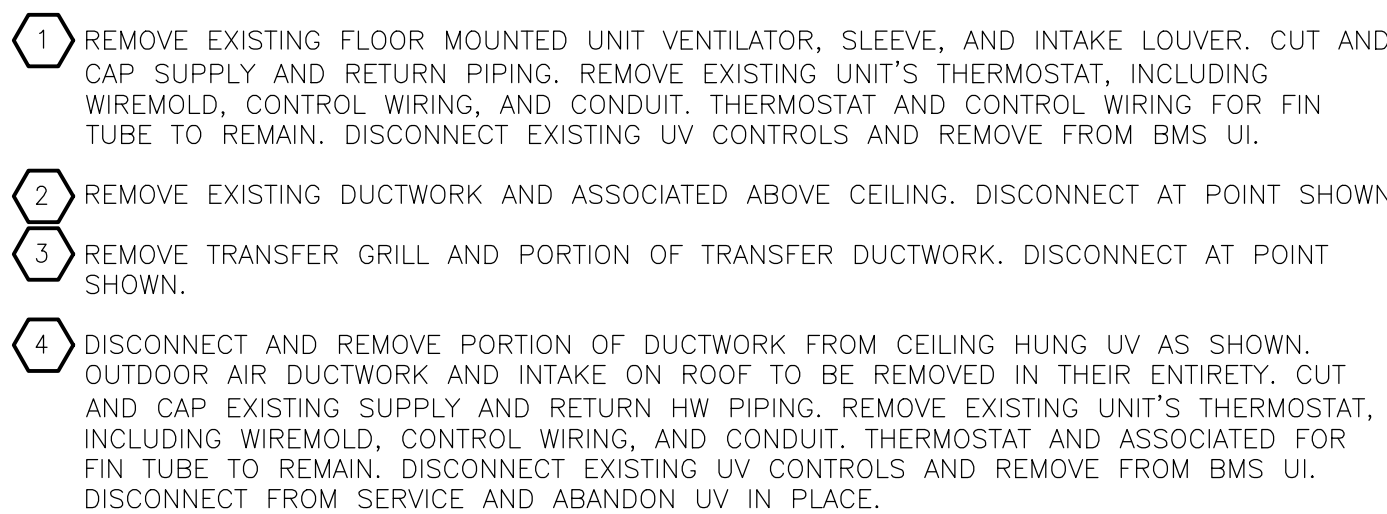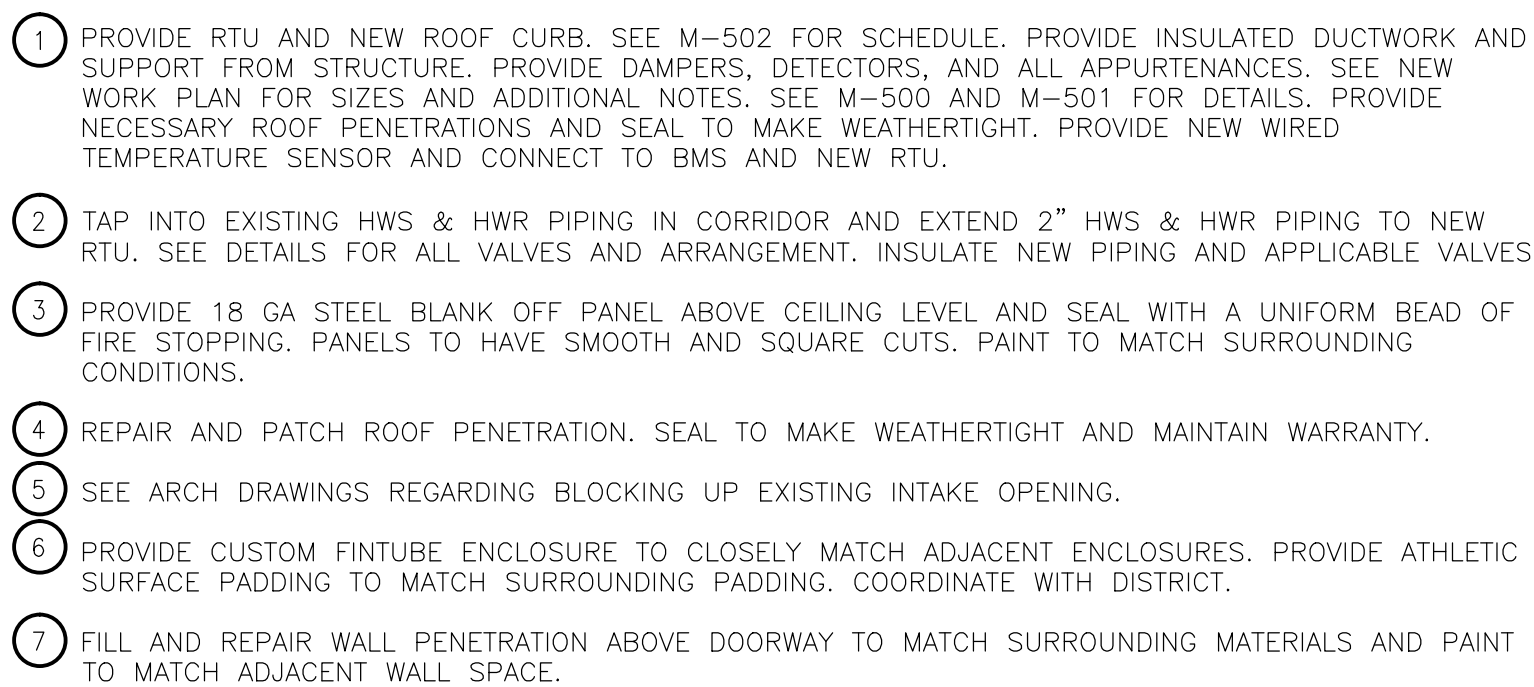
**CONSULTANT(S):**

**FULLER  
D'ANGELO  
P.C.**



**ARCHITECTS  
PLANNERS**

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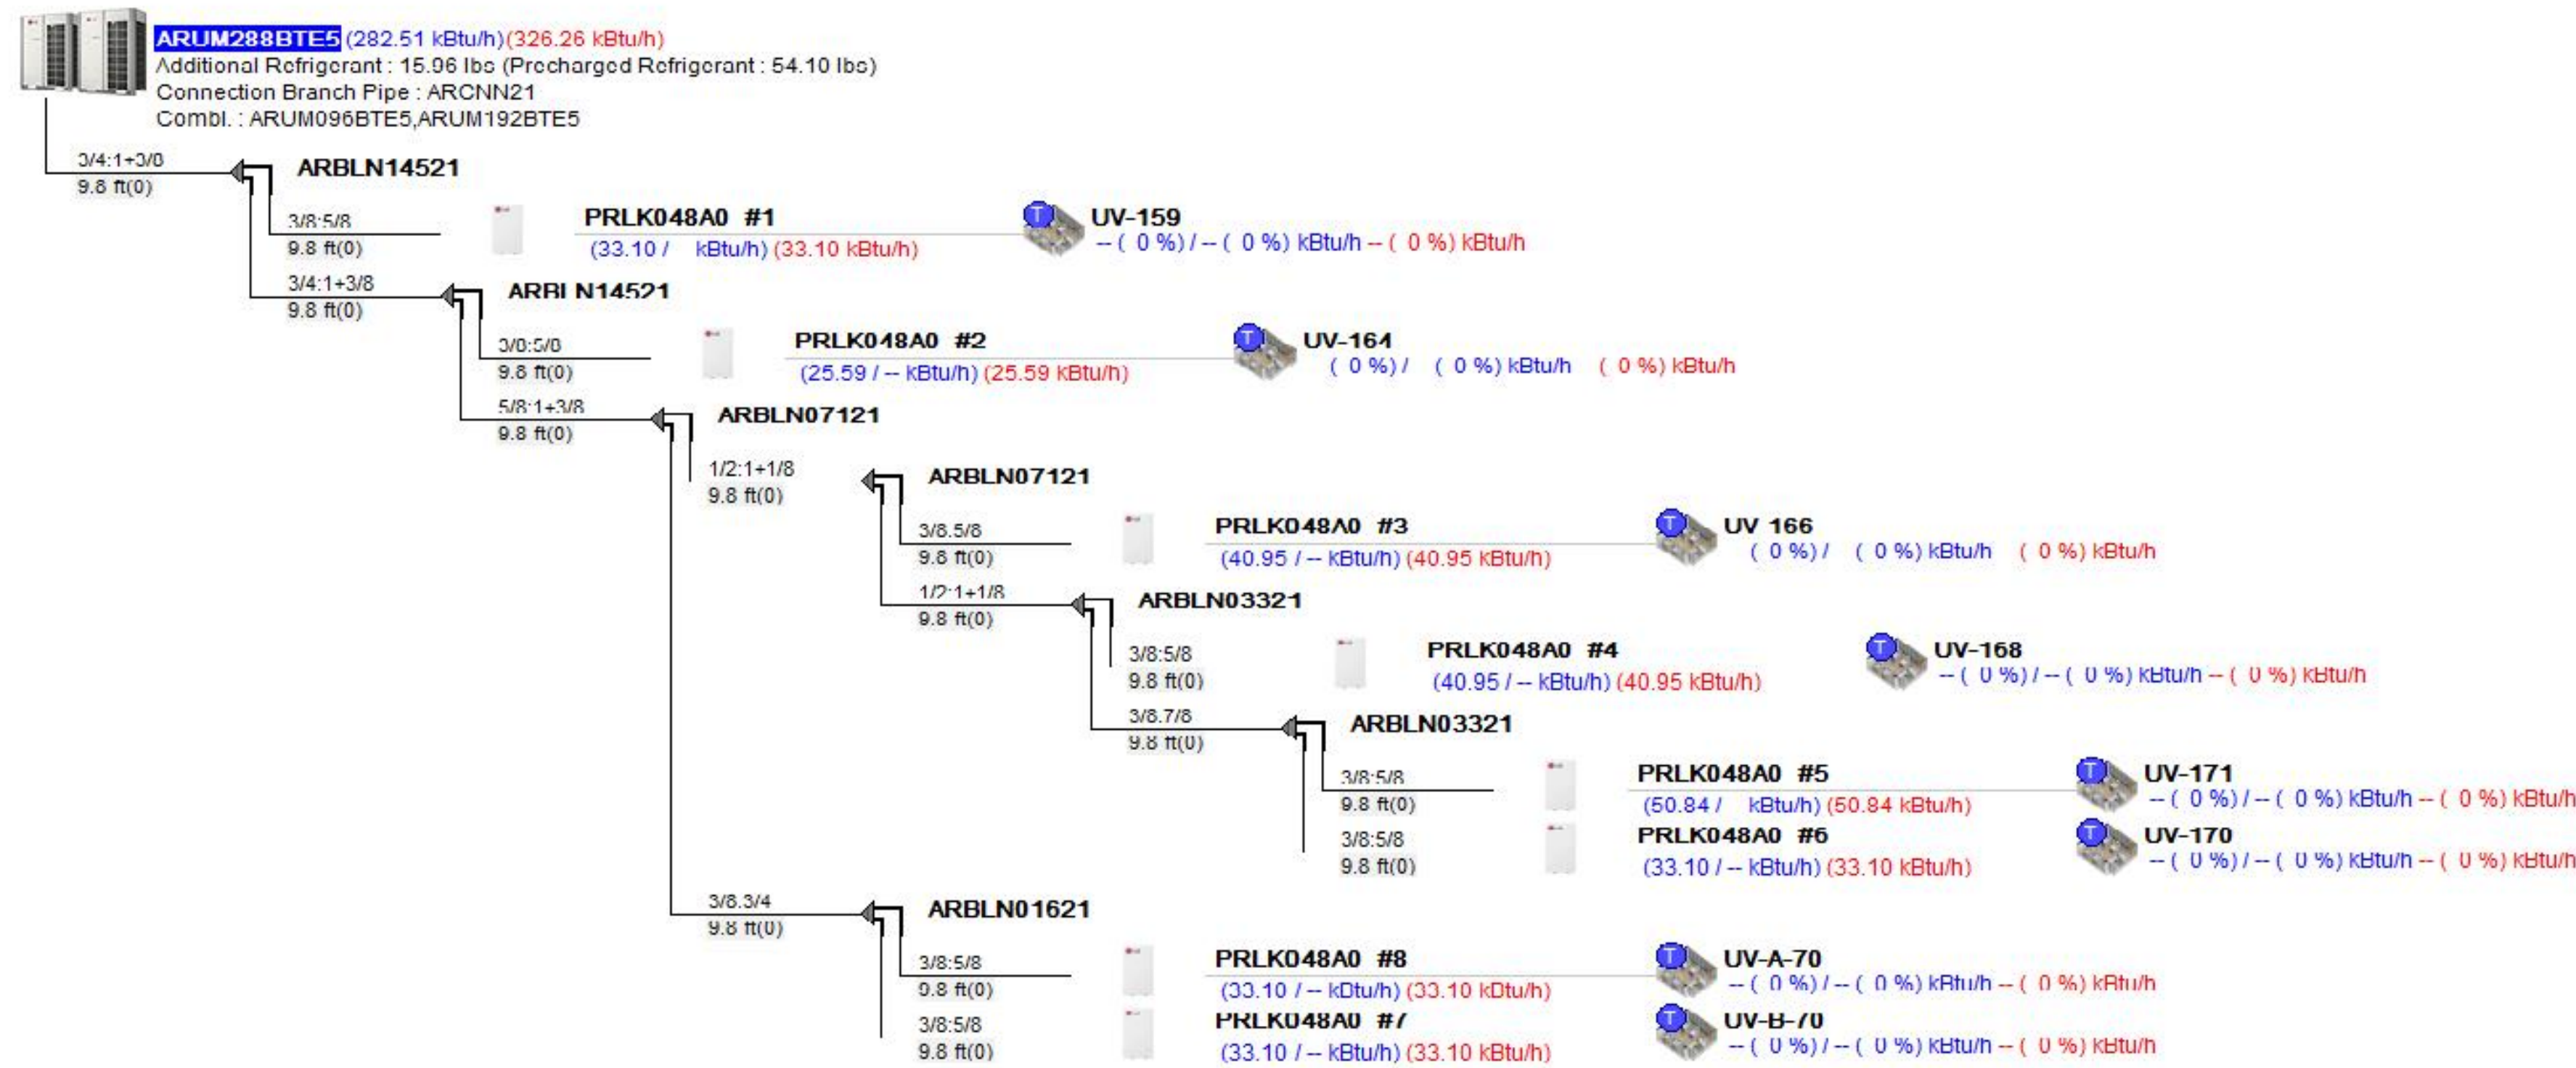
WARWICK VALLEY CENTRAL SCHOOL DISTRICT  
HIGH SCHOOL UNIT VENTILATOR REPLACEMENT AND  
AIR CONDITIONING UPGRADE  
225 WEST STREET EXT. WARWICK, NY 10900  
WV HIGH SCHOOL – 89 SANFORDVILLE ROAD, WARWICK, NY 10930

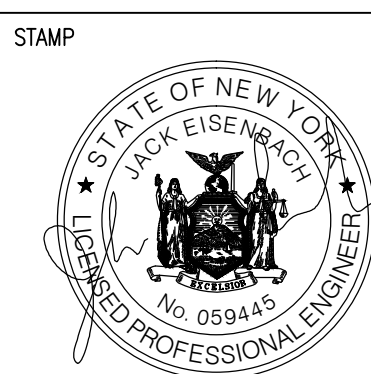HSA 05-21-04 Workcard Federal Grant Project (CAU) Package3, HSA1	PROJECT NO.	05-21-04 05-20-06
	ISSUED FOR BID	11.09.2022
	SED SET	10.19.2022
	REVISION	DATE
	DRAWN BY	
	CHECKED BY	
	SHEET SIZE	30" x 42"
	SCALE	AS NOTED

Warwick Valley  
SHEET TITLE  
WRESTLING ROOM -  
DEMOLITION AND NEW  
WORK


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**HS**  
**M-104**






Indoor Units	: 8 of 45
Combination Ratio	: 290.7 of 288.0 (101%)
Total Pipe	: 147.6 of 3280.8 ft
ODU factory charge	: 54.10 lbs
Additional Refrigerant	: 15.96 lbs
Total refrigerant	: 70.06 lbs
Minimum room volume	: 2694.70 ft³
(Based on 26.0 lbs / 1000.0 ft³)	

1 ONE LINE DIAGRAM - VRF-1  
SCALE: NONE ALL WORK THIS AREA PART OF ALTERNATE (ALT. H-1)

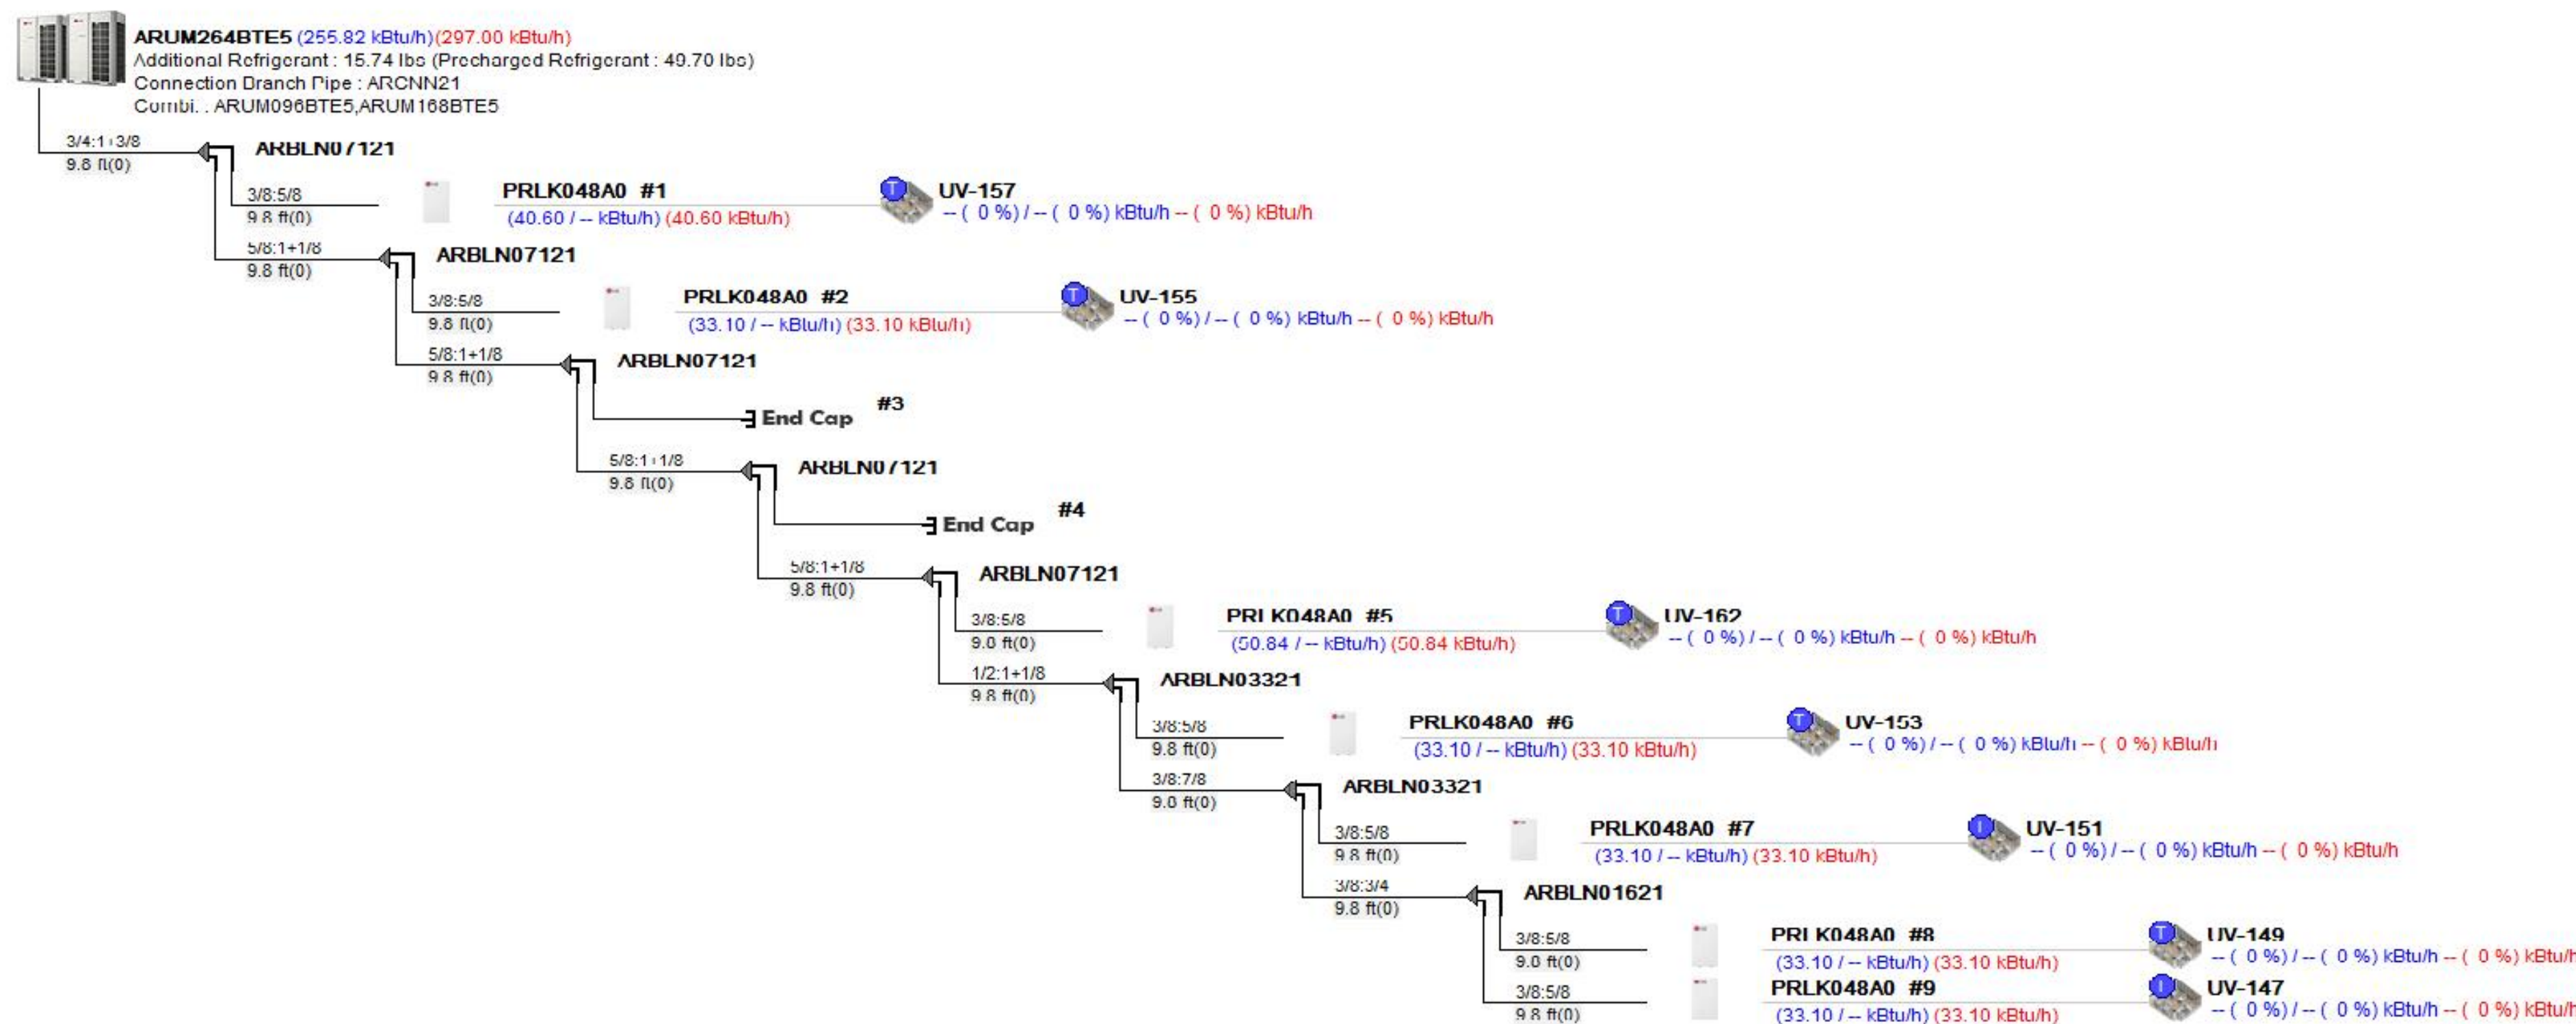


Indoor Units	: 7 of 42
Combination Ratio	: 256.9 of 264.0 (97%)
Total Pipe	: 147.6 of 3280.8 ft
ODU factory charge	: 49.70 lbs
Additional Refrigerant	: 15.74 lbs
Total refrigerant	: 65.44 lbs
Minimum room volume	: 2516.93 ft³
(Based on 26.0 lbs / 1000.0 ft³)	

2 ONE LINE DIAGRAM - VRF-2  
SCALE: NONE ALL WORK THIS AREA PART OF ALTERNATE (ALT. H-1)

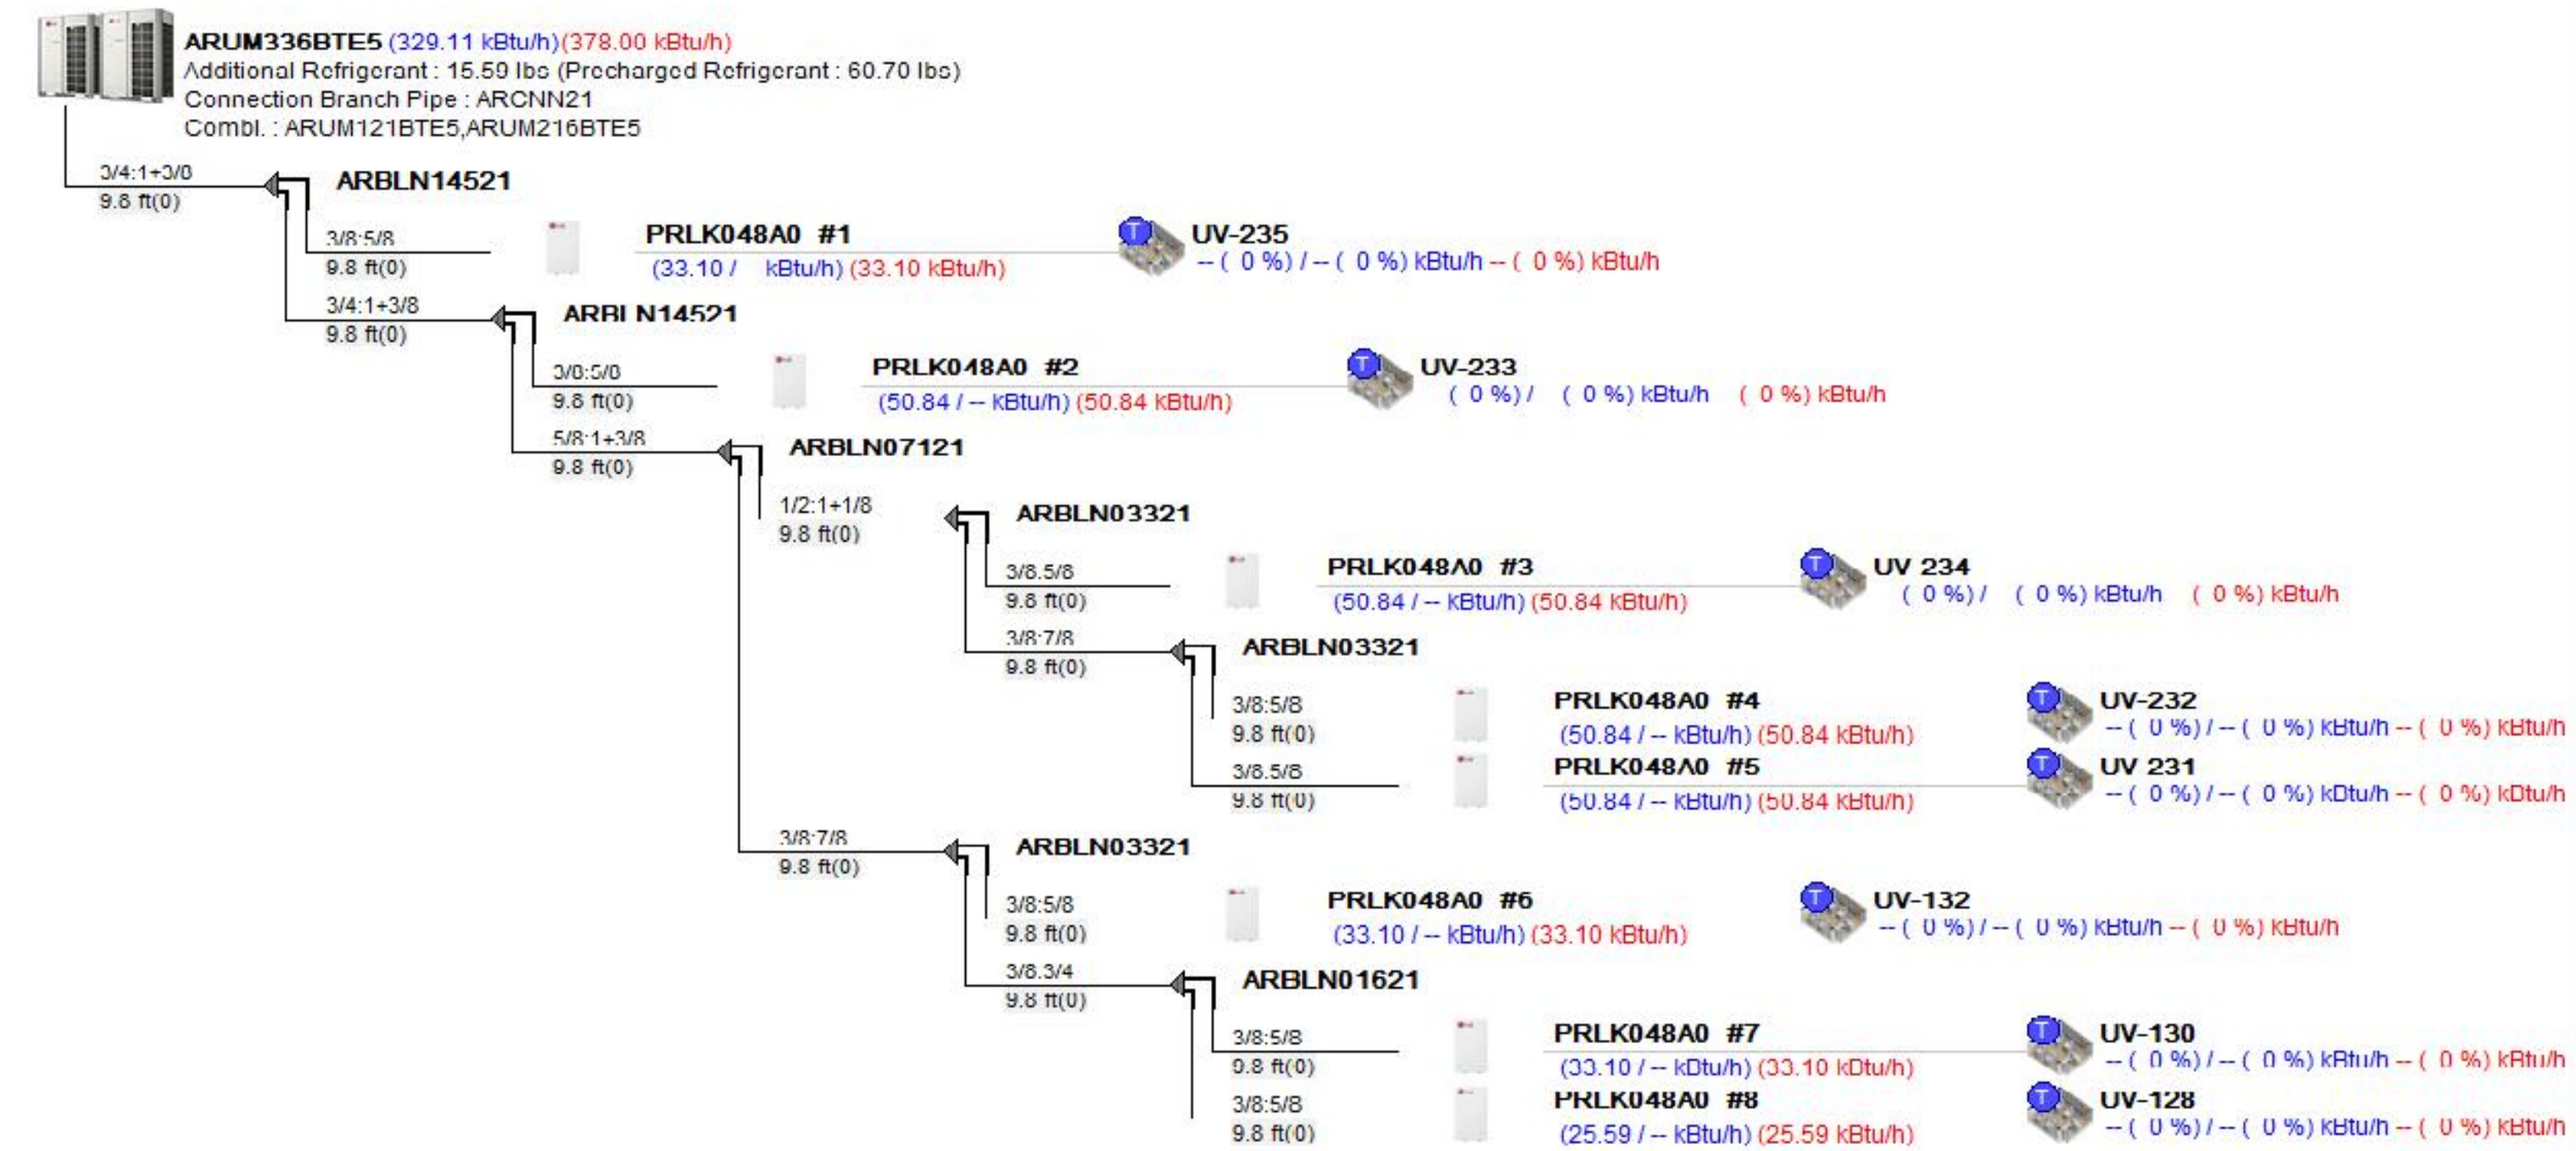

Indoor Units	: 8 of 55
Combination Ratio	: 328.2 of 336.0 (98%)
Total Pipe	: 147.6 of 3280.8 ft
ODU factory charge	: 60.70 lbs
Additional Refrigerant	: 15.59 lbs
Total refrigerant	: 76.29 lbs
Minimum room volume	: 2934.11 ft³
(Based on 26.0 lbs / 1000.0 ft³)	

3 ONE LINE DIAGRAM - VRF-3  
SCALE: NONE

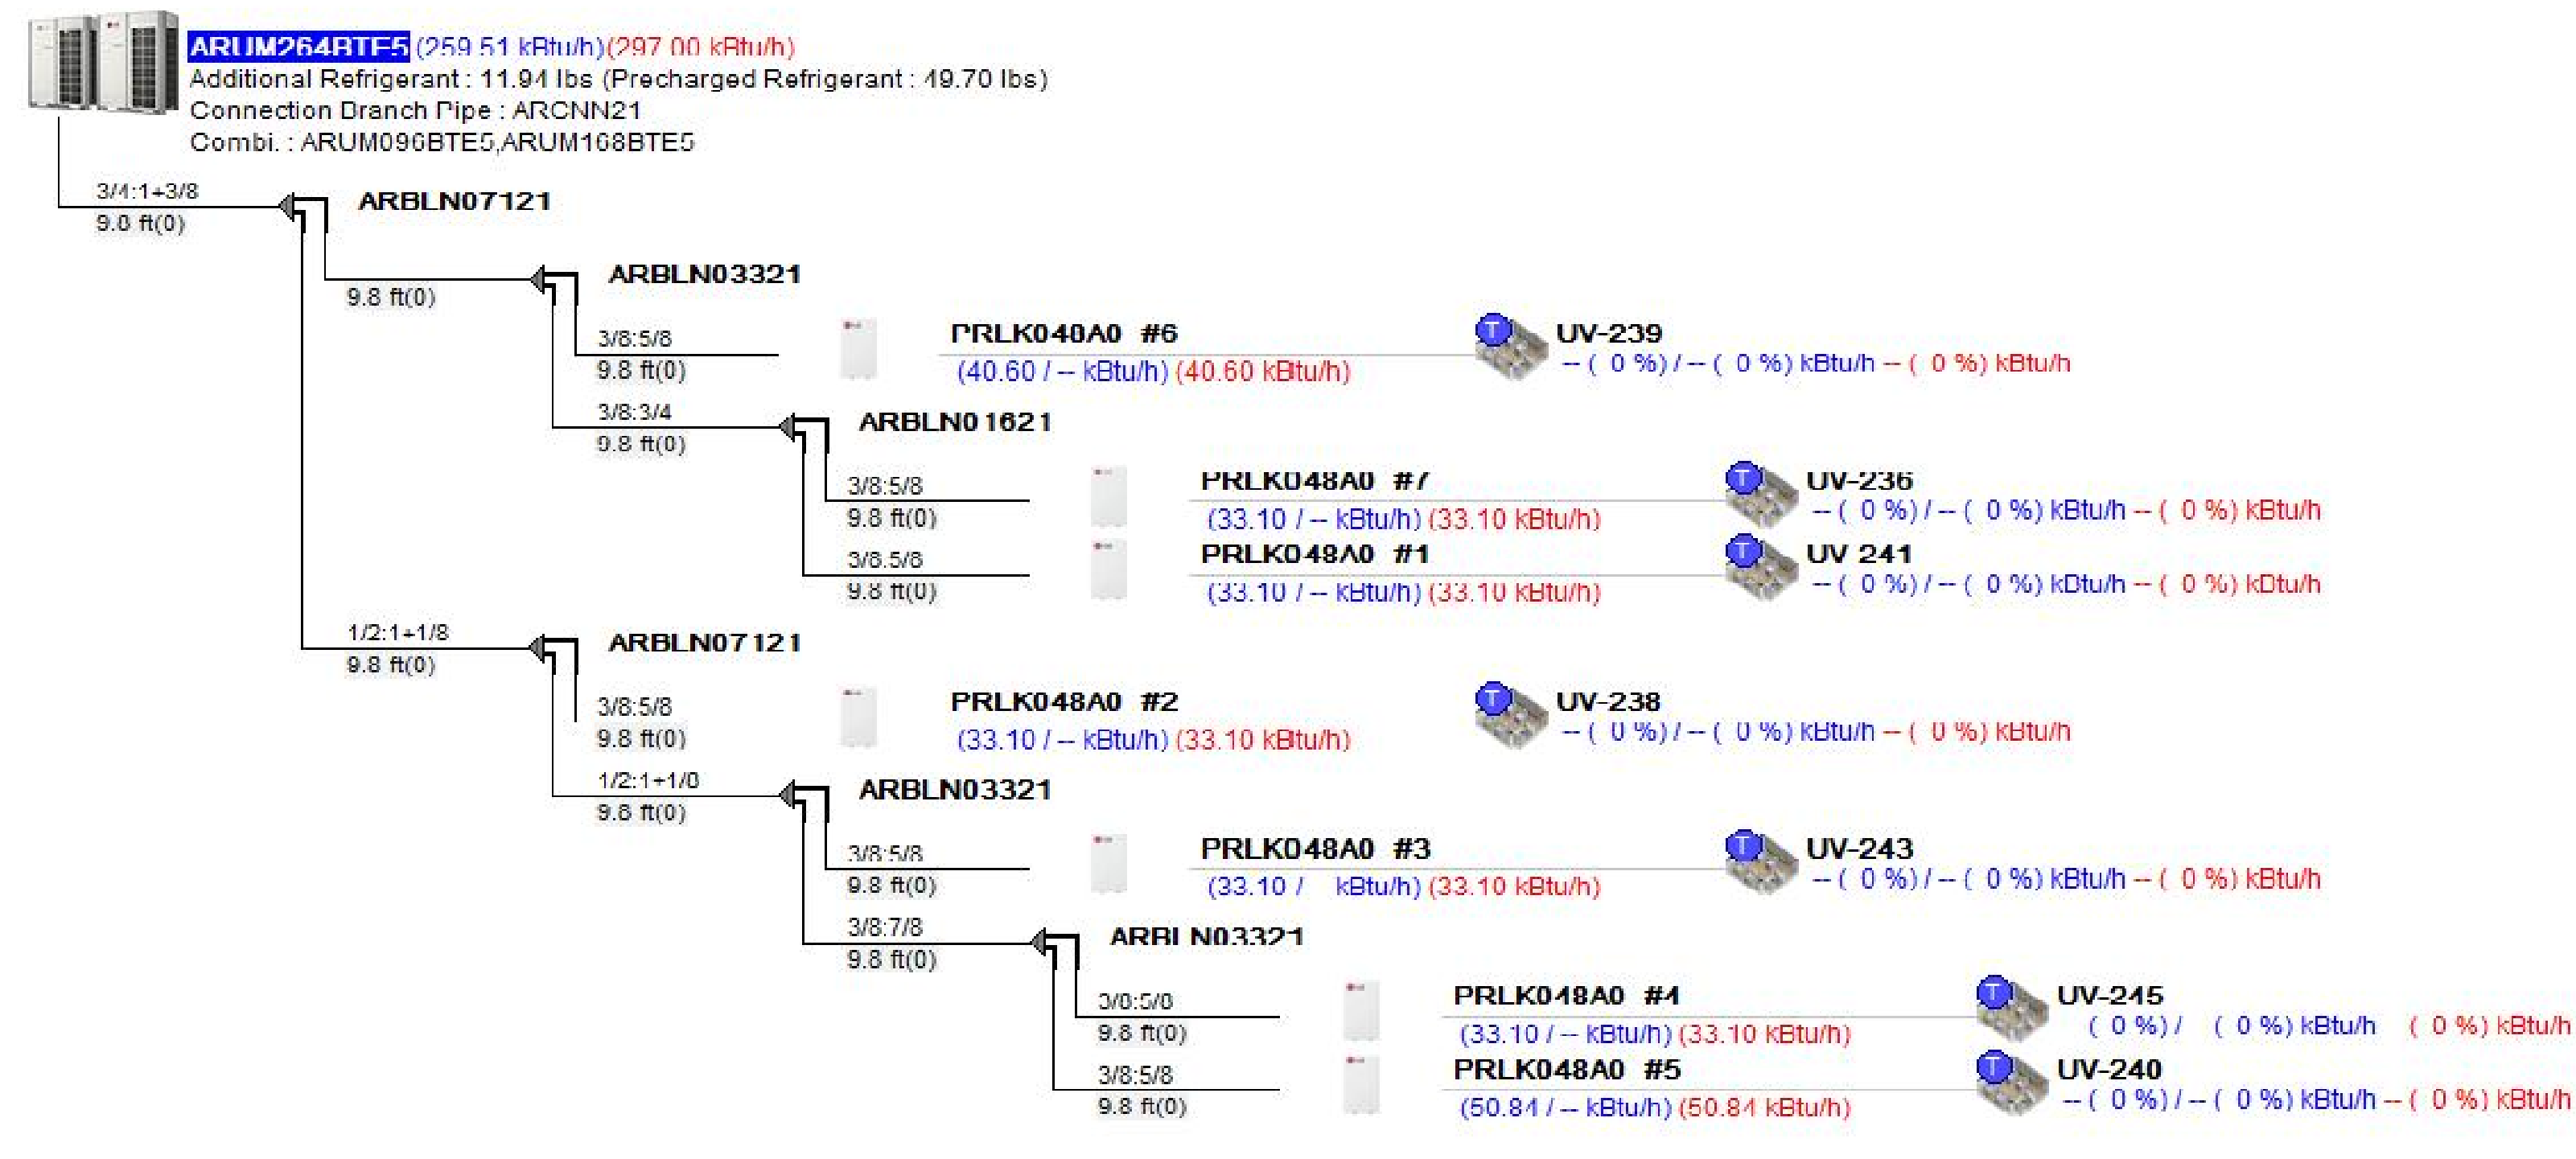

Indoor Units	: 7 of 42
Combination Ratio	: 256.9 of 264.0 (97%)
Total Pipe	: 128.0 of 3280.8 ft
ODU factory charge	: 49.70 lbs
Additional Refrigerant	: 11.94 lbs
Total refrigerant	: 61.64 lbs
Minimum room volume	: 2370.91 ft³
(Based on 26.0 lbs / 1000.0 ft³)	

4 ONE LINE DIAGRAM - VRF-4  
SCALE: NONE



GENERAL NOTES:  
1. GENERAL INTENT FOR SYSTEM ROUTING AND SIZING FOR BIDDING PURPOSES ONLY. PIPE SIZING AND ROUTING SHALL BE VERIFIED WITH MANUFACTURER AND BE BASED ON FINAL LOCATIONS OF EQUIPMENT. INSTALL AND CHARGE SYSTEM PER MANUFACTURER RECOMMENDATIONS.

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P.C.  
ARCHITECTS  
PLANNERS


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STATE OF NEW YORK  
JACK D'ANGELO  
No. 059447  
REGISTERED PROFESSIONAL ENGINEER


WARWICK VALLEY CENTRAL SCHOOL DISTRICT  
HIGH SCHOOL UNIT VENTILATOR REPLACEMENT AND  
AIR CONDITIONING UPGRADE  
225 WEST STREET EXT. WARWICK, NY 10990  
WV HIGH SCHOOL - 89 SANFORDVILLE ROAD, WARWICK, NY 10990  
SED NO. 44-21-01-06-0-001-042

PROJECT NO.	05-21-04 05-20-06
ISSUED FOR BID	11.09.2022
SET SET	10.19.2022
REVISION	DATE
DRAWN BY	
CHECKED BY	
SHEET SIZE	30" X 42"
SCALE	AS NOTED
SHEET TITLE	VRF SYSTEM TREES
SHEET NO.	M-111



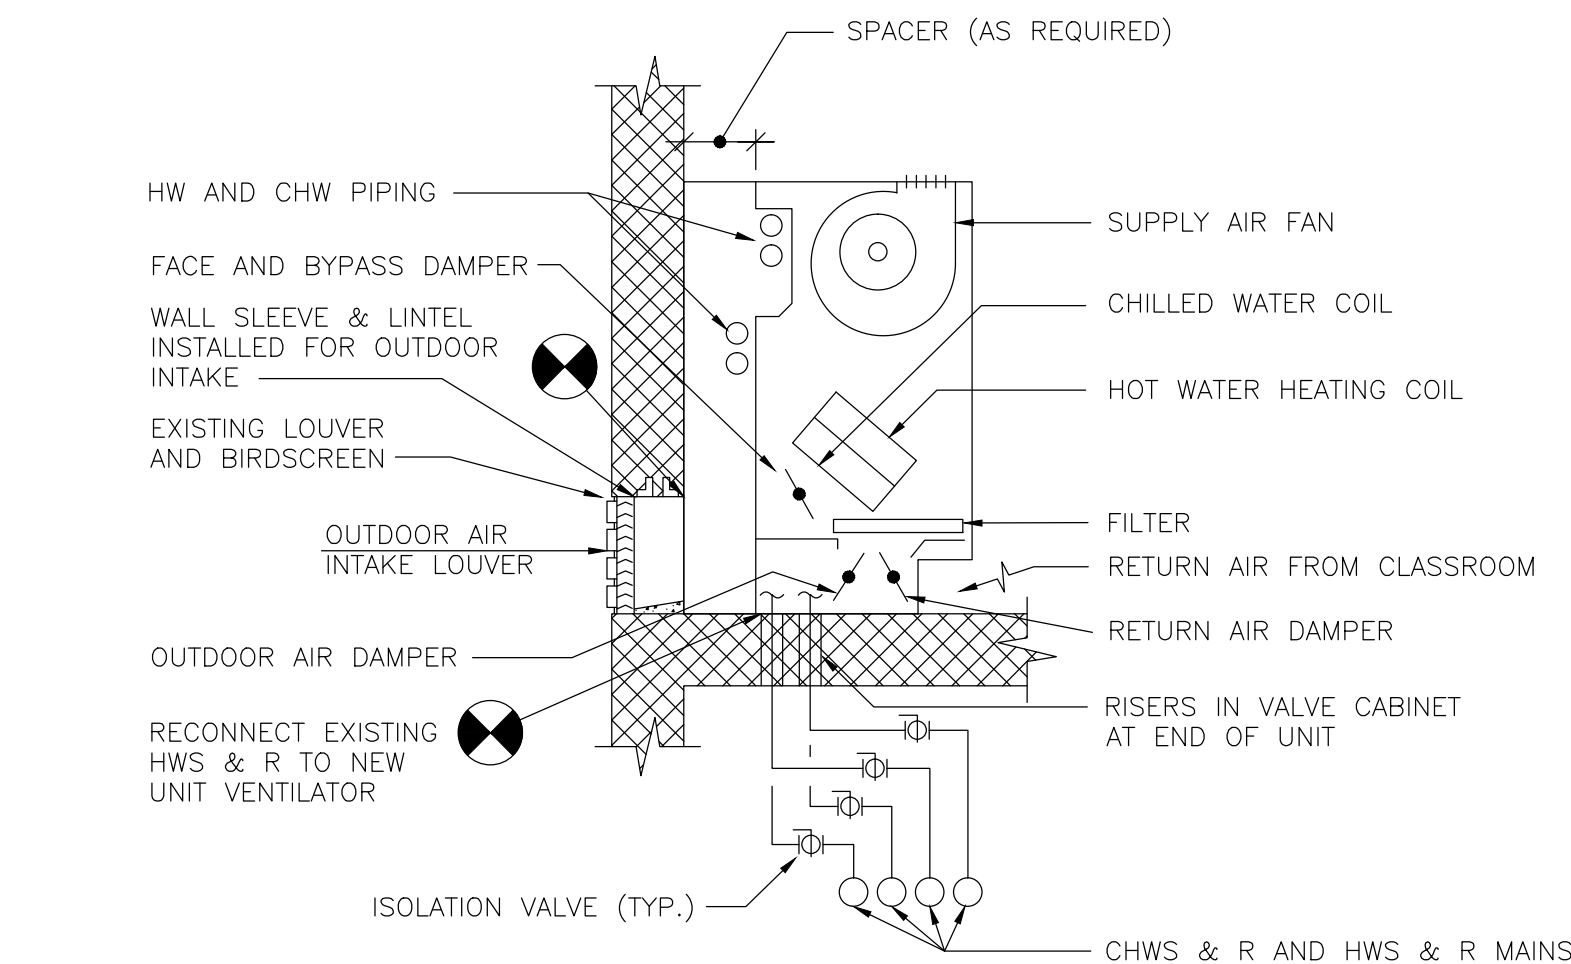


**8 VERTICAL UNIT VENTILATOR DETAIL**  
SCALE: NONE

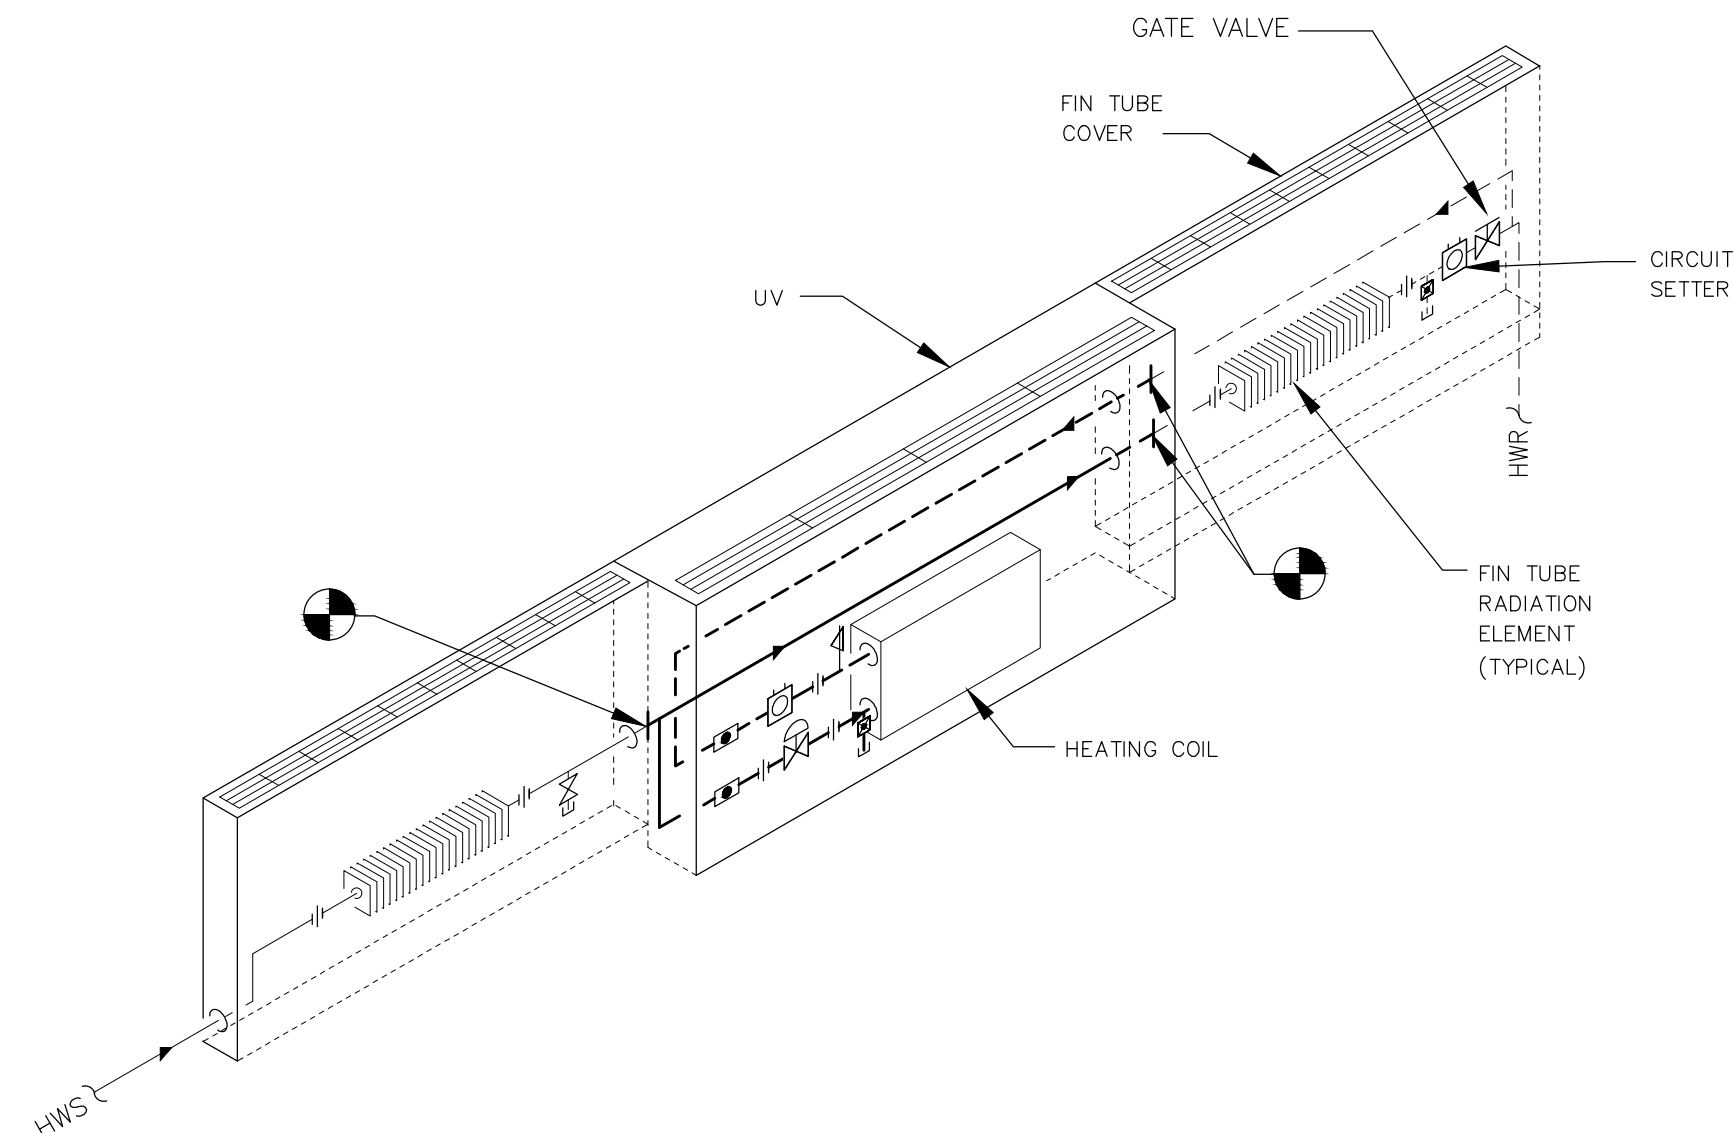

NOTES:

1. LOCATE CONTROL VALVES, SHUTOFF VALVES, AND CIRCUIT SETTERS SO THAT THEY ARE EASILY ACCESSIBLE FOR INSPECTION AND MAINTENANCE. PROVIDE ACCESS DOORS IN APPROPRIATE LOCATIONS WHERE INSTALLATION REQUIRES VALVES AND/OR CIRCUIT SETTERS TO BE CONCEALED.
2. WHEN FIN RADIATION IS INSTALLED IN CLASSROOMS WITH UNIT VENTILATORS, VALVES ARE LOCATED BEHIND OPEN SHELVING OR FIN TUBE ENCLOSURE AS APPLICABLE.
3. PROVIDE ENCLOSURES AS REQUIRED TO CONCEAL REFRIGERANT LINES.
4. MODIFY FIN-TUBE ENCLOSERS AS REQUIRED TO PERMIT NEW UV INSTALLATIONS. REUSE/MODIFY END CAPS AS APPLICABLE.
5. PNEUMATIC LINES FEEDING EXISTING WALL HUNG THERMOSTAT MUST BE PLUGGED AND THERMOSTAT REMOVED


**9 TYPICAL CLASSROOM UNIT VENT W/FTR PIPING DETAIL**  
SCALE: NONE

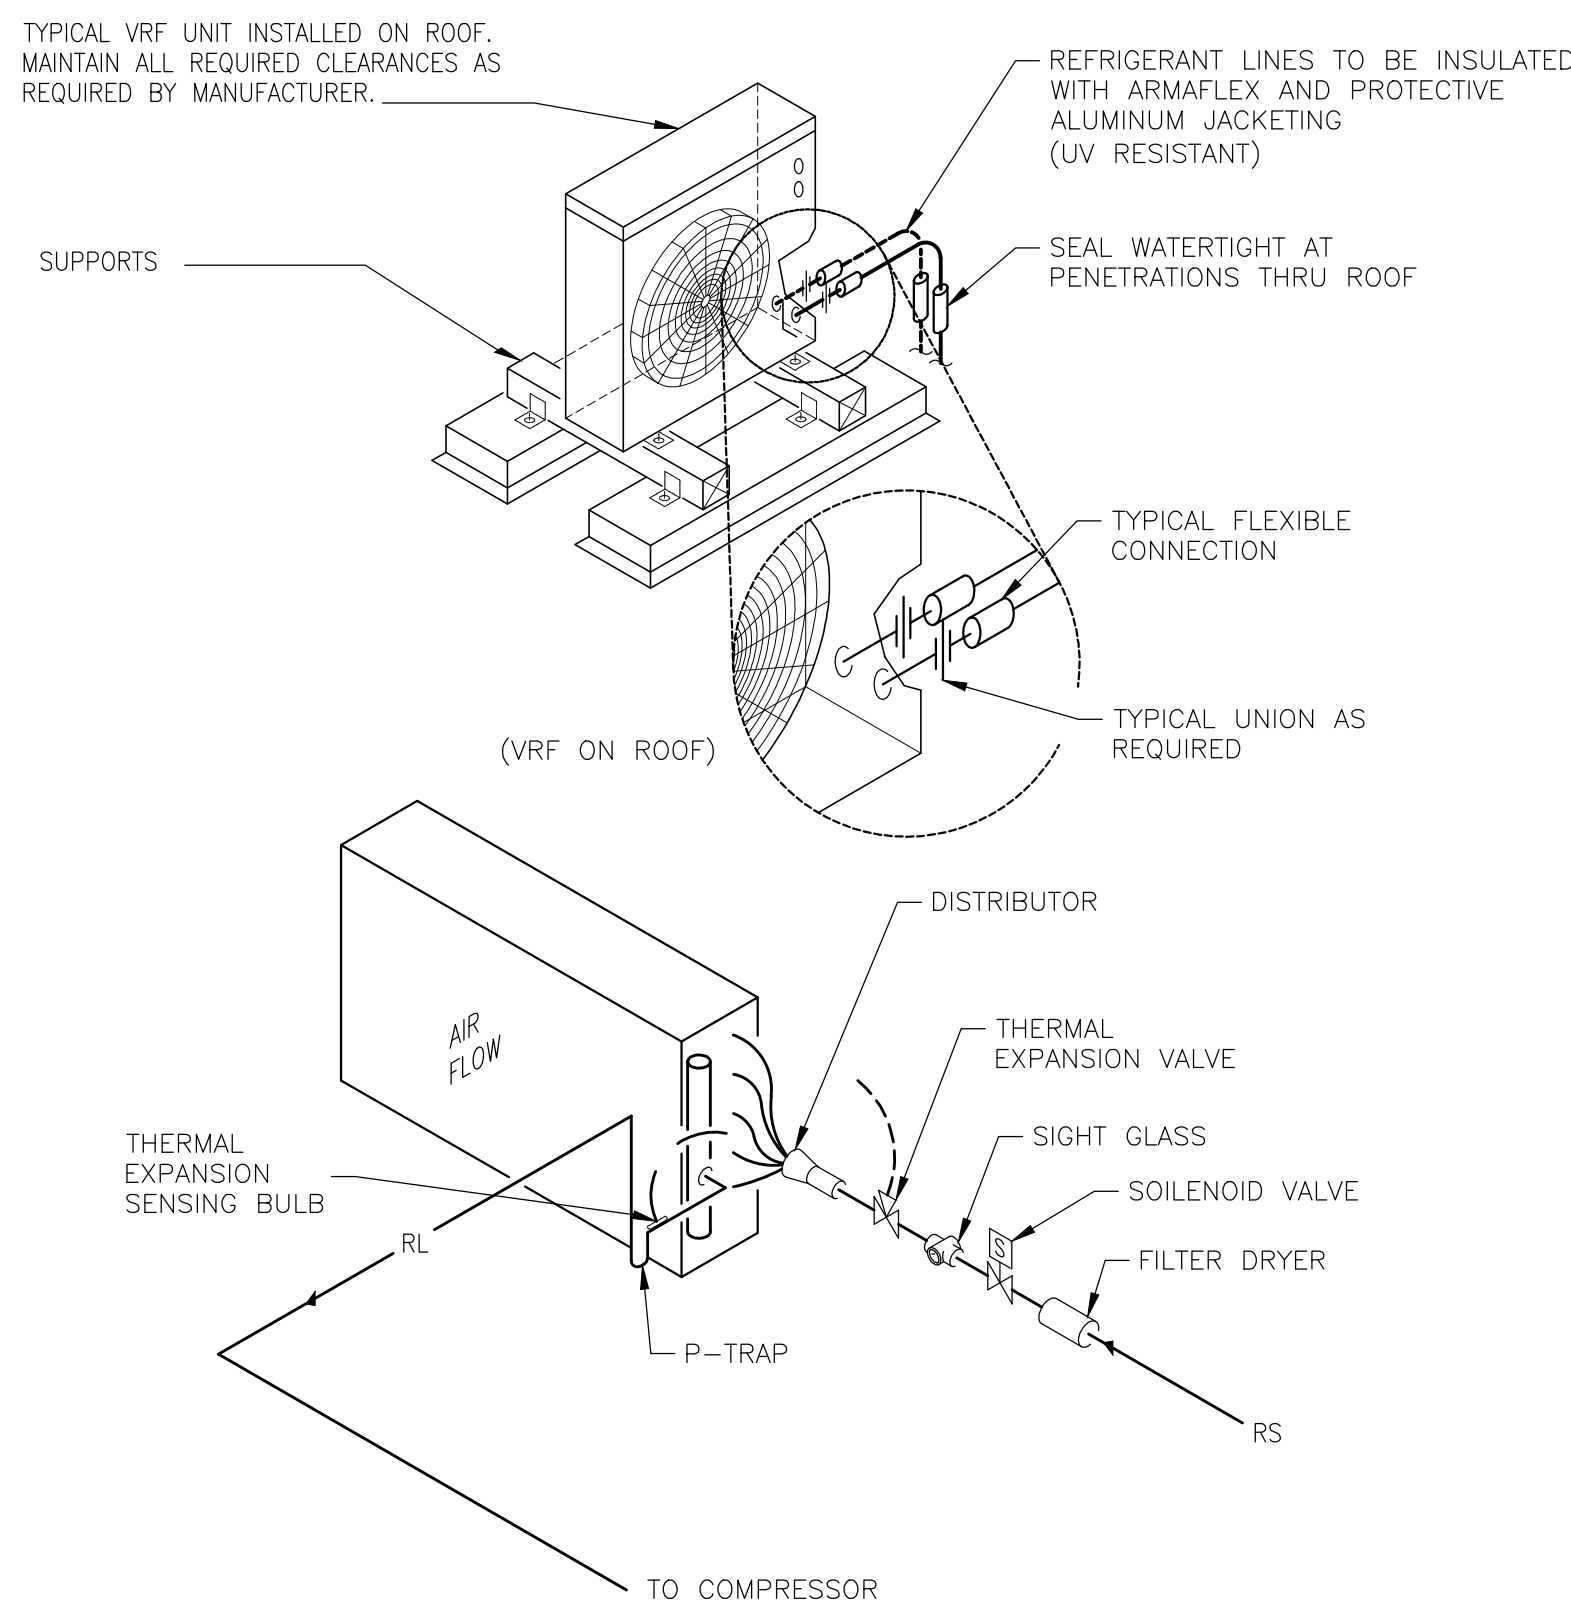

NOTES:

1. INSTALL PER MANUFACTURERS RECOMMENDATIONS.
2. PROVIDE ENCLOSURES AS REQUIRED TO CONCEAL REFRIGERANT LINES


**10 PIPING CONNECTIONS AT DIRECT EXPANSION COOLING COIL**  
SCALE: NONE

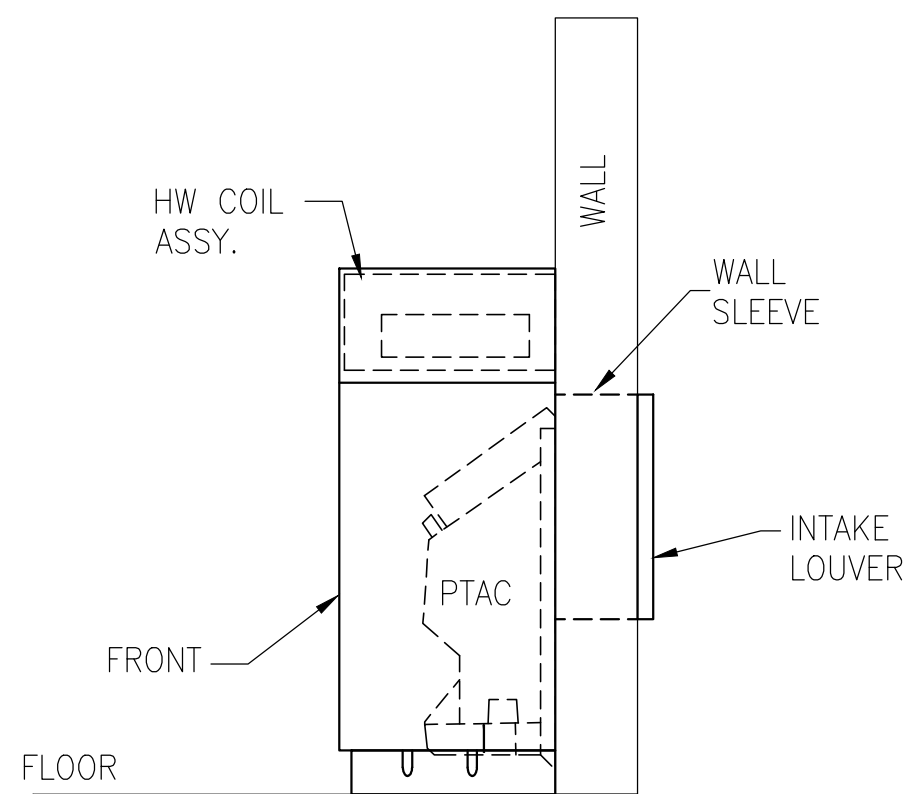


NOTES:

1. LOCATE CONTROL VALVES, SHUTOFF VALVES, AND CIRCUIT SETTERS SO THAT THEY ARE EASILY ACCESSIBLE FOR INSPECTION AND MAINTENANCE. PROVIDE ACCESS DOORS IN APPROPRIATE LOCATIONS WHERE INSTALLATION REQUIRES VALVES AND/OR CIRCUIT SETTERS TO BE CONCEALED. CONSULT MANUFACTURER DATA FOR BRANDS AND TYPES.
2. WHEN FIN RADIATION IS INSTALLED IN CLASSROOMS WITH UNIT VENTILATORS, VALVES ARE LOCATED BEHIND OPEN SHELVING OR FIN TUBE ENCLOSURE AS APPLICABLE.
3. PROVIDE ENCLOSURES AS REQUIRED TO CONCEAL REFRIGERANT LINES.
4. MODIFY FIN-TUBE ENCLOSERS AS REQUIRED TO PERMIT NEW INSTALLATIONS. REUSE/MODIFY END CAPS AS APPLICABLE.

**4 PTAC HYDRONIC CABINET**  
SCALE: NONE

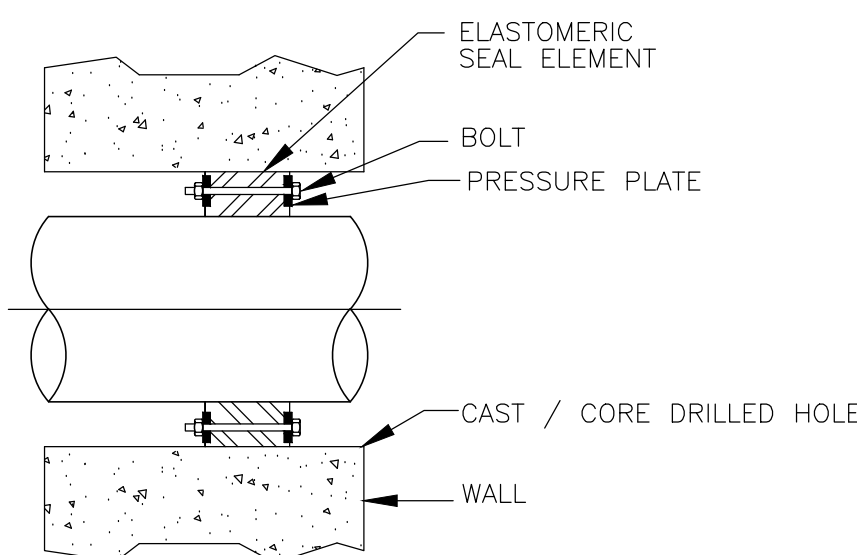


**5 PIPE SLEEVE AT WALL PENETRATION**  
SCALE: NONE

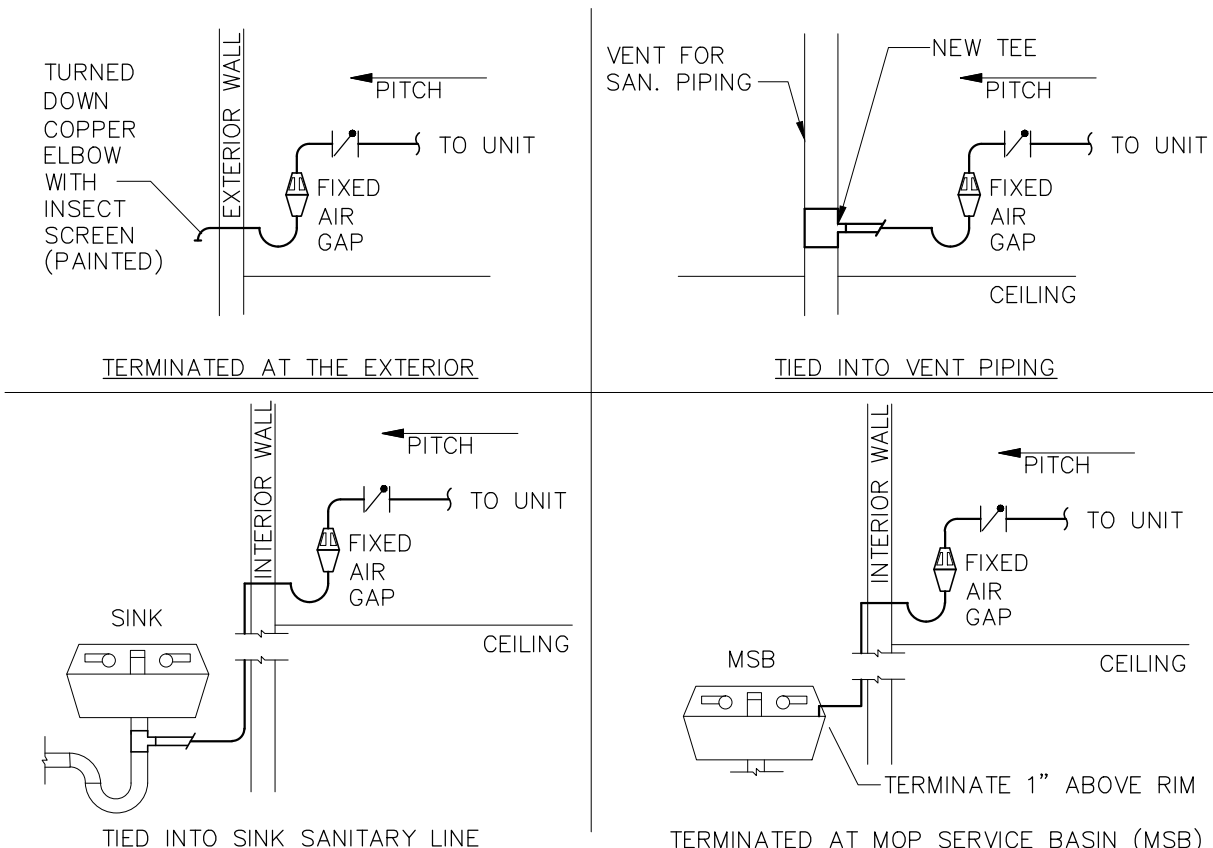

NOTE:  
RUN CONDENSATE PIPING WITH TRAP AND VENT FROM ALL EVAPORATOR COILS TO LOCATION SPECIFIED. PROVIDE INSULATION AND SUPPORT. SIZE TO BE 3/4" UNLESS OTHERWISE SPECIFIED.

PIPING AT WALL PENETRATIONS TO BE SLEEVED, CHANGEOVER FROM PVC TO COPPER FOR EXTERIOR TERMINATION TO BEGIN BEFORE EXTERIOR WALL PENETRATION.  
(TYPICAL FROM ALL EVAPORATOR / DX COILS)  
SEE M DWGS FOR LOCATIONS


**6 CONDENSATE LINE CONNECTION DETAIL**  
SCALE: NONE

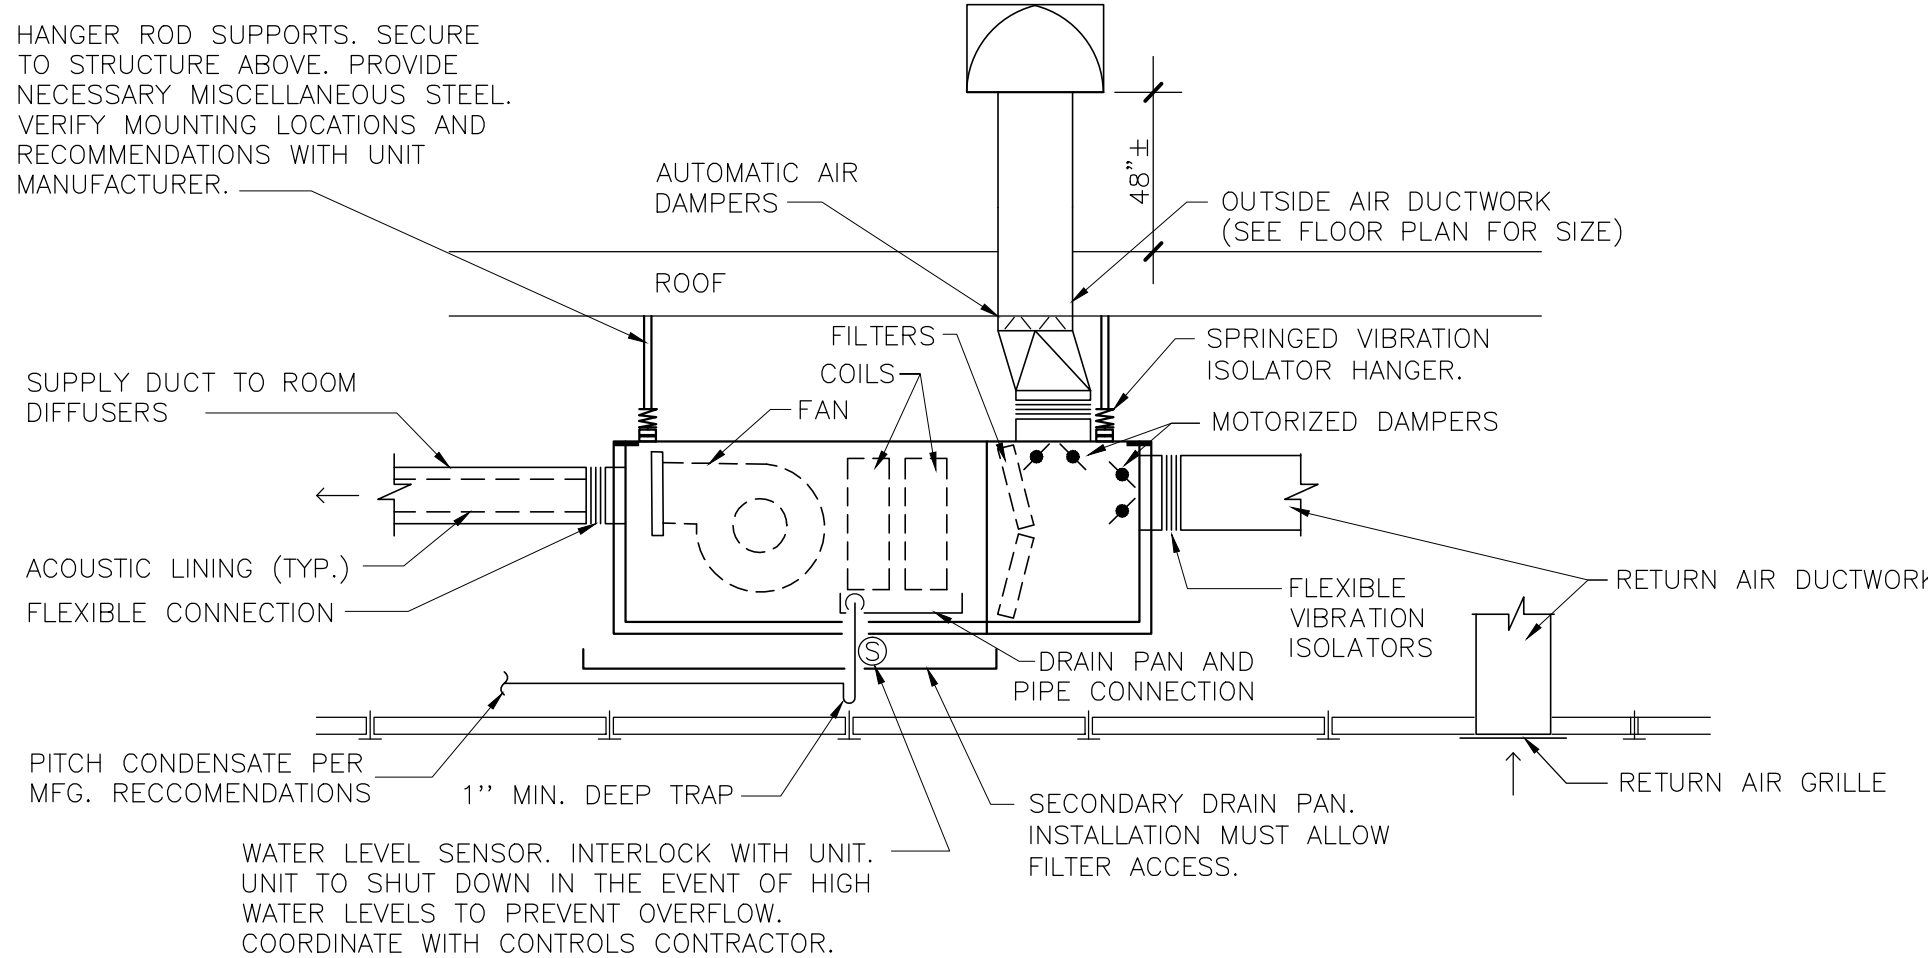


NOTES:

1. COORDINATE EXACT LOCATION OF UNITS WITH EXISTING AND NEW BUILDING COMPONENTS TO ALLOW PROPER UNIT CONNECTIONS AND MAINTENANCE.

**7 CEILING HUNG (HORIZONTAL) UNIT VENTILATOR DETAIL**  
SCALE: NONE

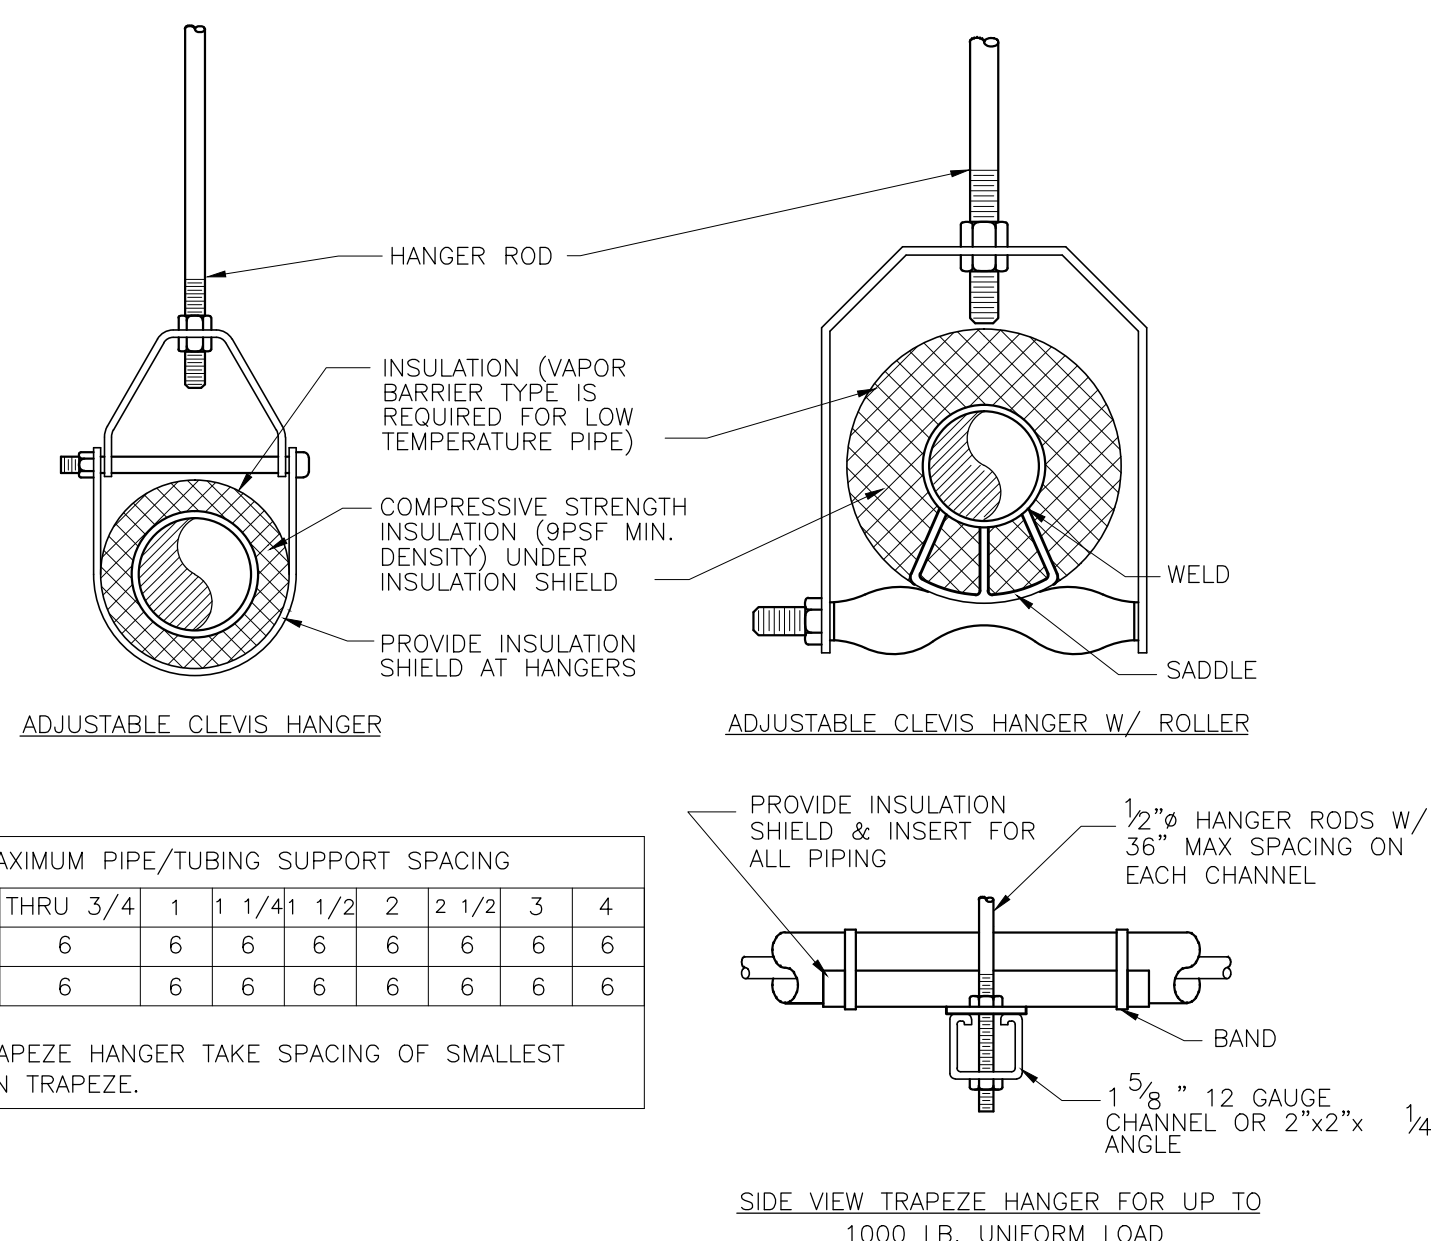


**1 PIPE SUPPORT DETAIL**  
SCALE: NONE

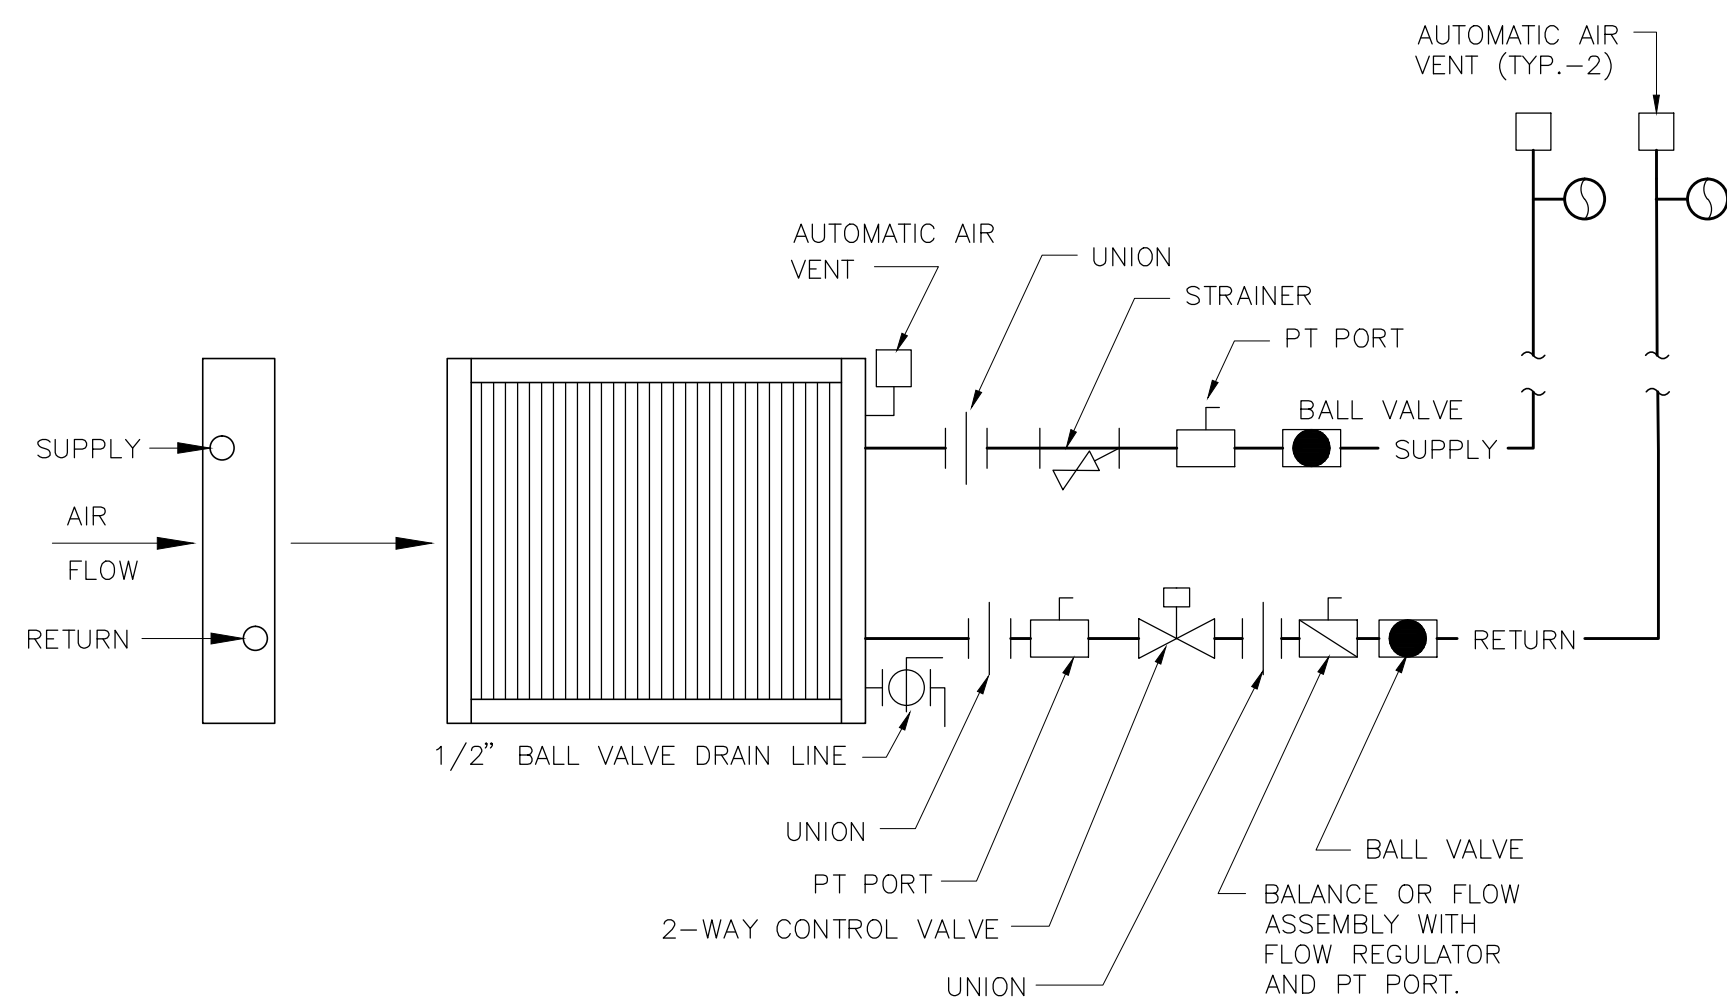

NOTES:

1. LOCATE CONTROL VALVES, SHUTOFF VALVES, AND CIRCUIT SETTERS SO THAT THEY ARE EASILY ACCESSIBLE FOR INSPECTION AND MAINTENANCE. PROVIDE ACCESS DOORS IN APPROPRIATE LOCATIONS WHERE INSTALLATION REQUIRES VALVES AND/OR CIRCUIT SETTERS TO BE CONCEALED.
2. WHEN FIN RADIATION IS INSTALLED IN CLASSROOMS WITH UNIT VENTILATORS, VALVES ARE LOCATED BEHIND OPEN SHELVING, UV CABINET, OR FIN TUBE ENCLOSURE AS APPLICABLE.
3. PROVIDE ENCLOSURES AS REQUIRED TO CONCEAL REFRIGERANT LINES.
4. PROVIDE AIR VENTS AT ALL HIGH POINTS IN PIPING SYSTEM.
5. PROVIDE ALL VALVES AND ASSOCIATED SHOWN.
6. INSULATE SUPPLY AND RETURN.

**2 UNIT VENTILATOR, FAN COIL UNIT, HYDRONIC PTAC HOT WATER COIL DETAIL**  
SCALE: NONE

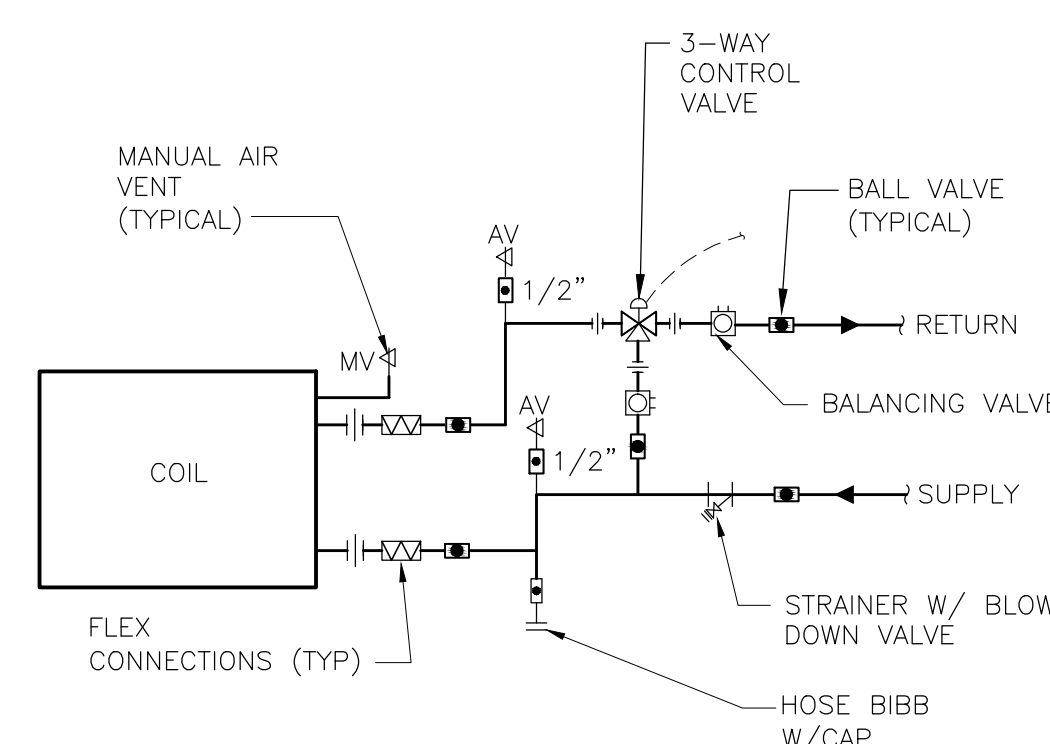

NOTES:

1. SUPPORT PIPES FROM STRUCTURE OR FLOOR STANCHION AS APPLICABLE.
2. COILS MOUNTED IN DUCTS TO BE PROVIDED WITH ACCESS PANELS UPSTREAM OF THE COIL.
3. PIPE COIL TO ALLOW REMOVAL OF COIL WITHOUT REMOVING PIPING BEYOND UNIONS OR FLANGES.
4. FOR UNITS PROVIDED WITH OTHER THAN ONE COIL, PROVIDE FLOW BALANCER, FLANGES, FLEXIBLE CONNECTOR, DRAINS, AND AIR VENTS FOR EACH COIL.
5. COOLING COIL SIMILAR

**3 COIL PIPING DETAIL 3 WAY VALVE**  
SCALE: NONE

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**WARWICK VALLEY CENTRAL SCHOOL DISTRICT  
HIGH SCHOOL UNIT VENTILATOR REPLACEMENT AND  
AIR CONDITIONING UPGRADE**  
225 WEST STREET EXT. WARWICK, NY 10990  
WV HIGH SCHOOL - 89 SANFORDVILLE ROAD, WARWICK, NY 10990

SED NO. 44-21-01-06-0-001-042


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ISSUED FOR BID	11.09.2022
SED SET	10.19.2022
REVISION	DATE
DRAWN BY	
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SHEET SIZE	30" X 42"
SCALE	AS NOTED
SHEET TITLE	
DETAILS	
SHEET NO.	

**M-500**


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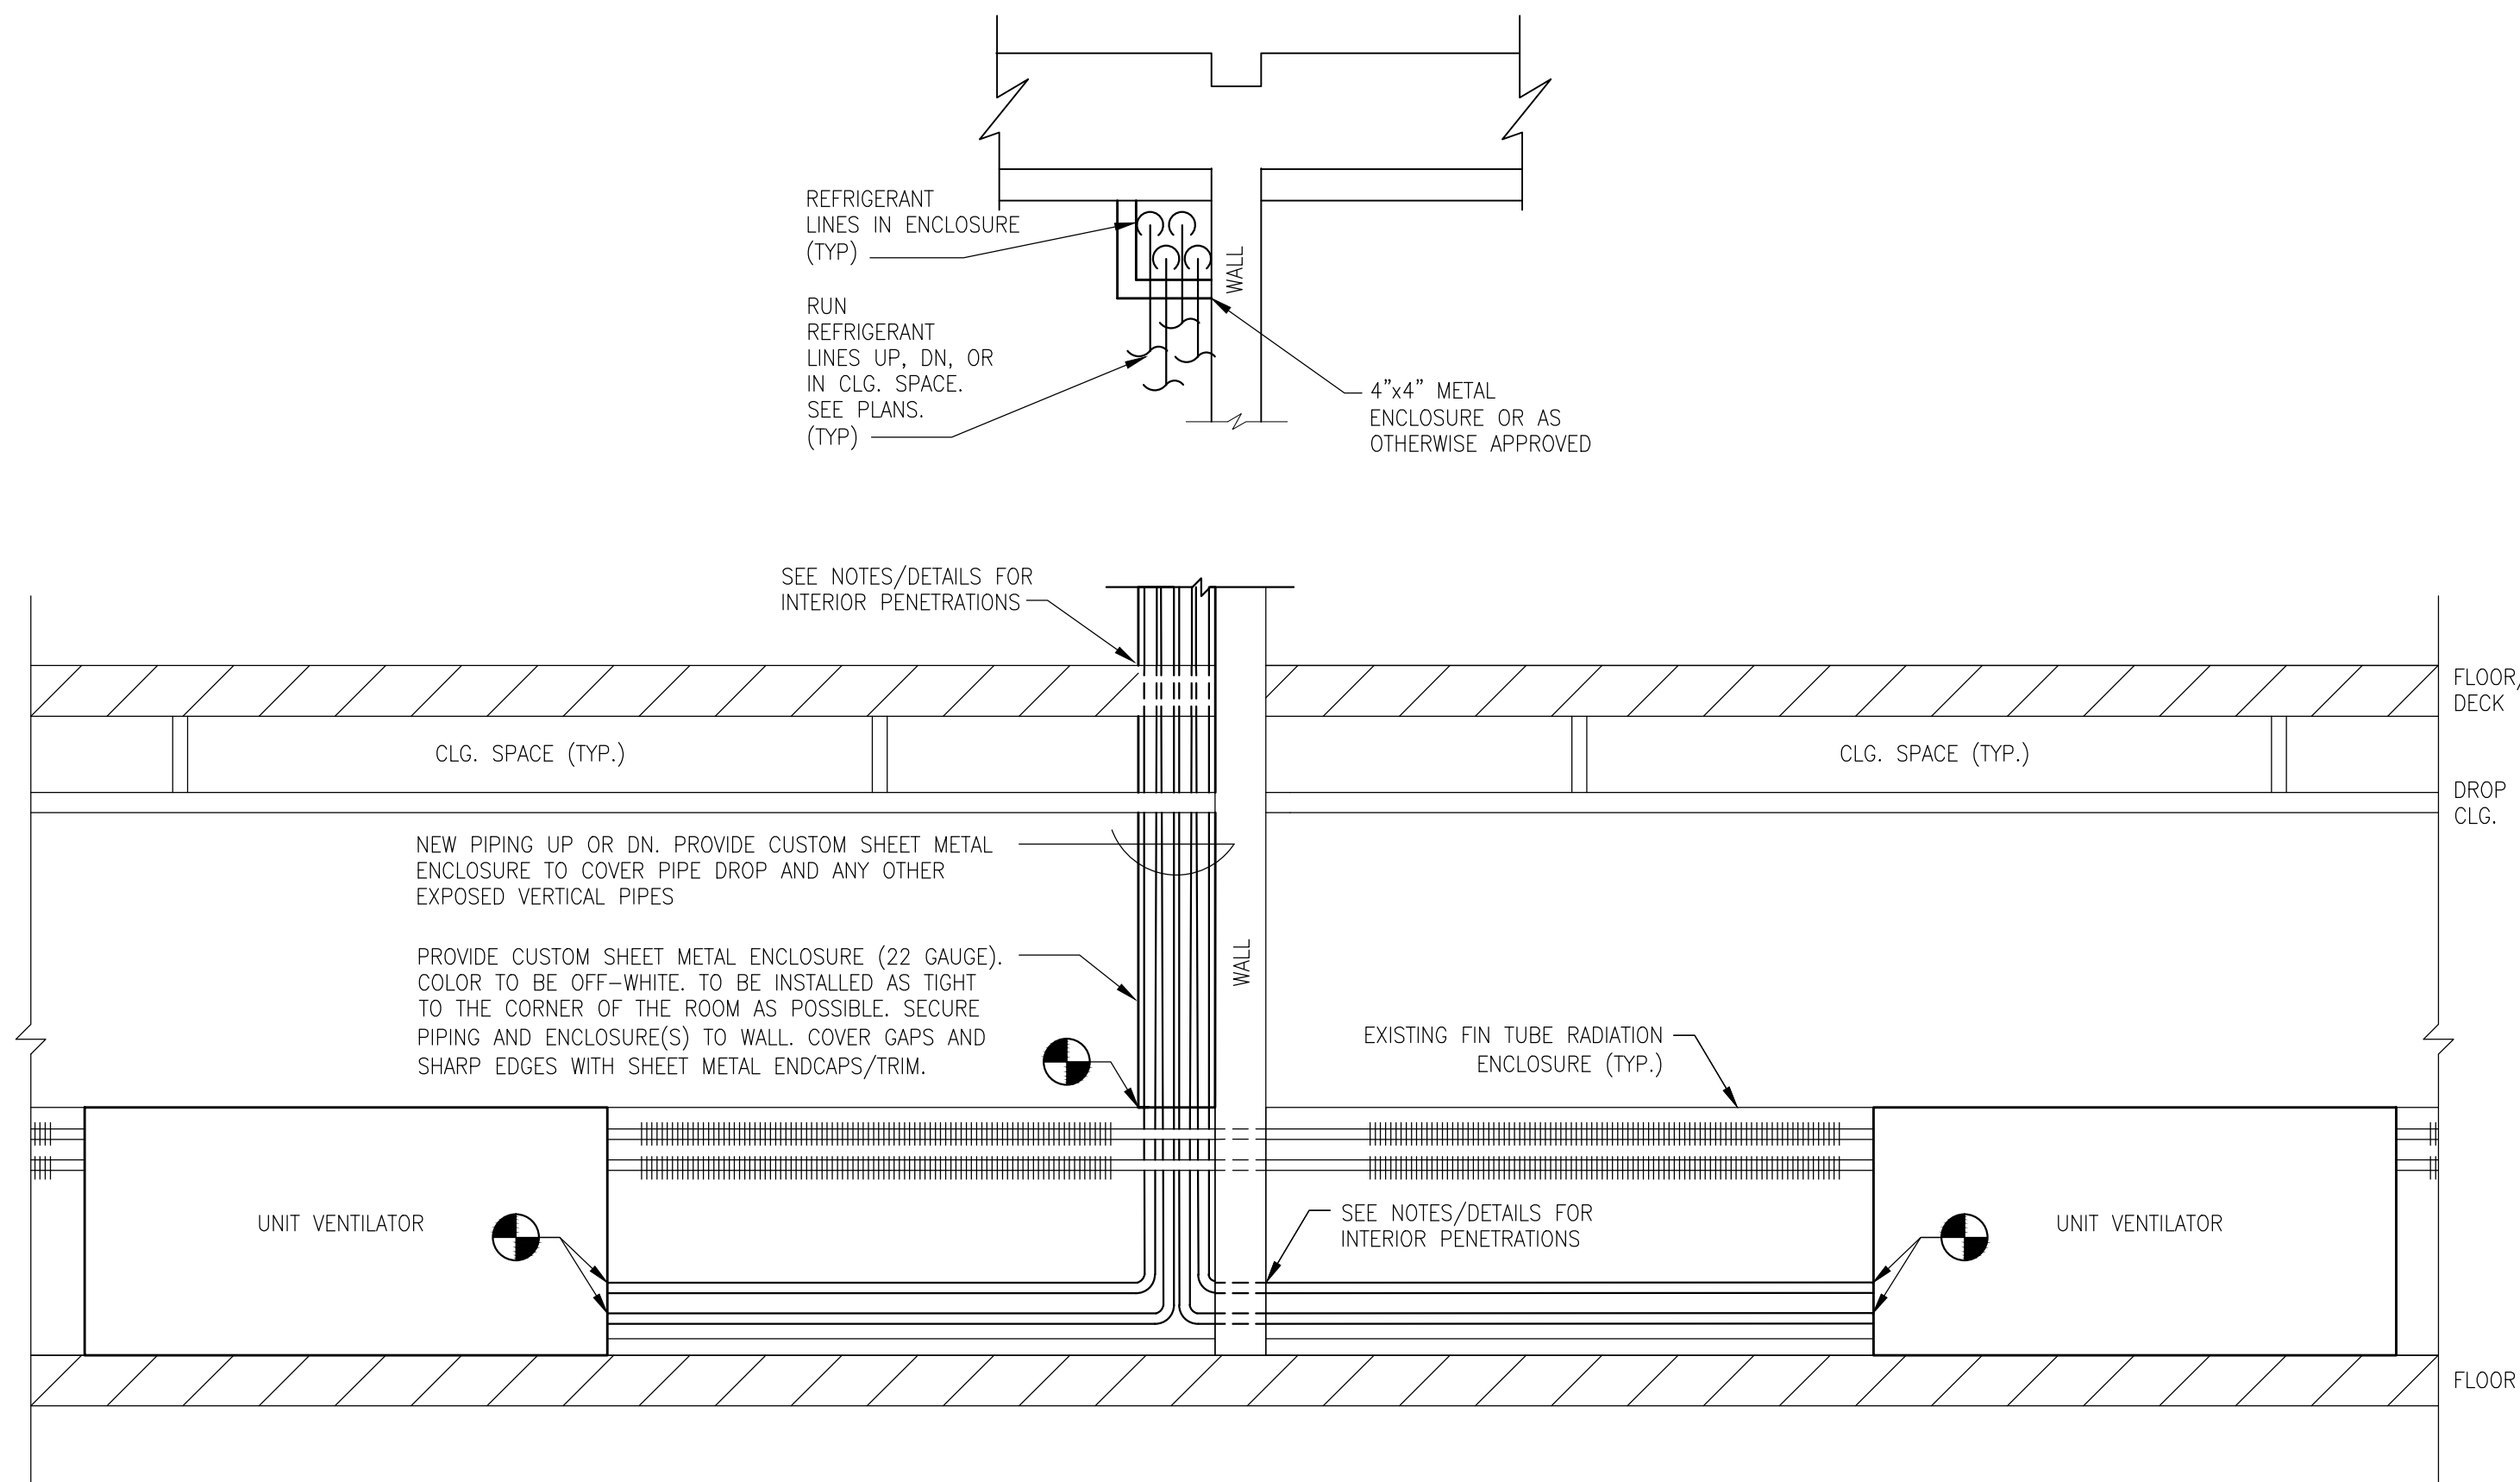
COORDINATION NOTE:  
1. COORDINATION- IT SHALL BE THE RESPONSIBILITY OF THE ELECTRICAL AND MECHANICAL CONTRACTORS TO COORDINATE THEIR WORK. THE HVAC CONTRACTOR SHALL TAKE THE LEAD IN THE COORDINATION EFFORT AND PRODUCE THE COORDINATION DRAWINGS. COORDINATION DRAWINGS SHALL BE SUBMITTED FOR APPROVAL TO THE ENGINEER PRIOR TO STARTING ANY WORK. CEILING SPACE IS VERY LIMITED AND DUCTWORK/PIPING INSTALLATION AND LOCATION IS CRITICAL. THE PURPOSE OF THESE DRAWINGS IS TO COORDINATE THE LOCATIONS OF ALL PIPING, DUCTWORK, AND ASSOCIATED ELECTRICAL EQUIPMENT. ALL ELECTRICAL EQUIPMENT SHALL BE INSTALLED AND LOCATED IN ACCORDANCE WITH THE NATIONAL ELECTRICAL CODE (NEC). MECHANICAL EQUIPMENT CANNOT INFILTRATE THE ELECTRICAL EQUIPMENTS WORKING CLEARANCE AND WORKING SPACE, NOR CAN IT BE INSTALLED DIRECTLY ABOVE OR BELOW TO THE STRUCTURE, AS IDENTIFIED WITHIN THE NEC, ARTICLE 110 - "REQUIREMENTS FOR ELECTRICAL INSTALLATION". THIS COORDINATION IS REQUIRED FOR ALL PHASES OF THIS PROJECT. FAILURE TO FOLLOW THIS PROCEDURE DOES NOT RELIEVE THE CONTRACTOR FROM THE DUTIES AND WILL NOT CONSTITUTE A REASON FOR A CHANGE ORDER.



4 PIPE SLEEVE AT WALL PENETRATION  
SCALE: NONE

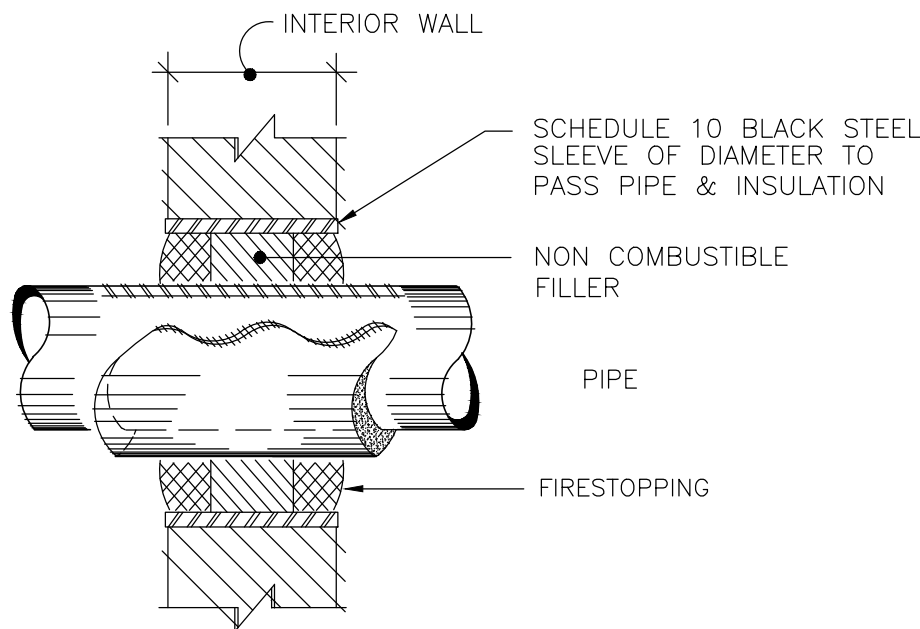


5 PIPE/CONDUIT CURB ASSEMBLY DETAILS  
SCALE: NONE

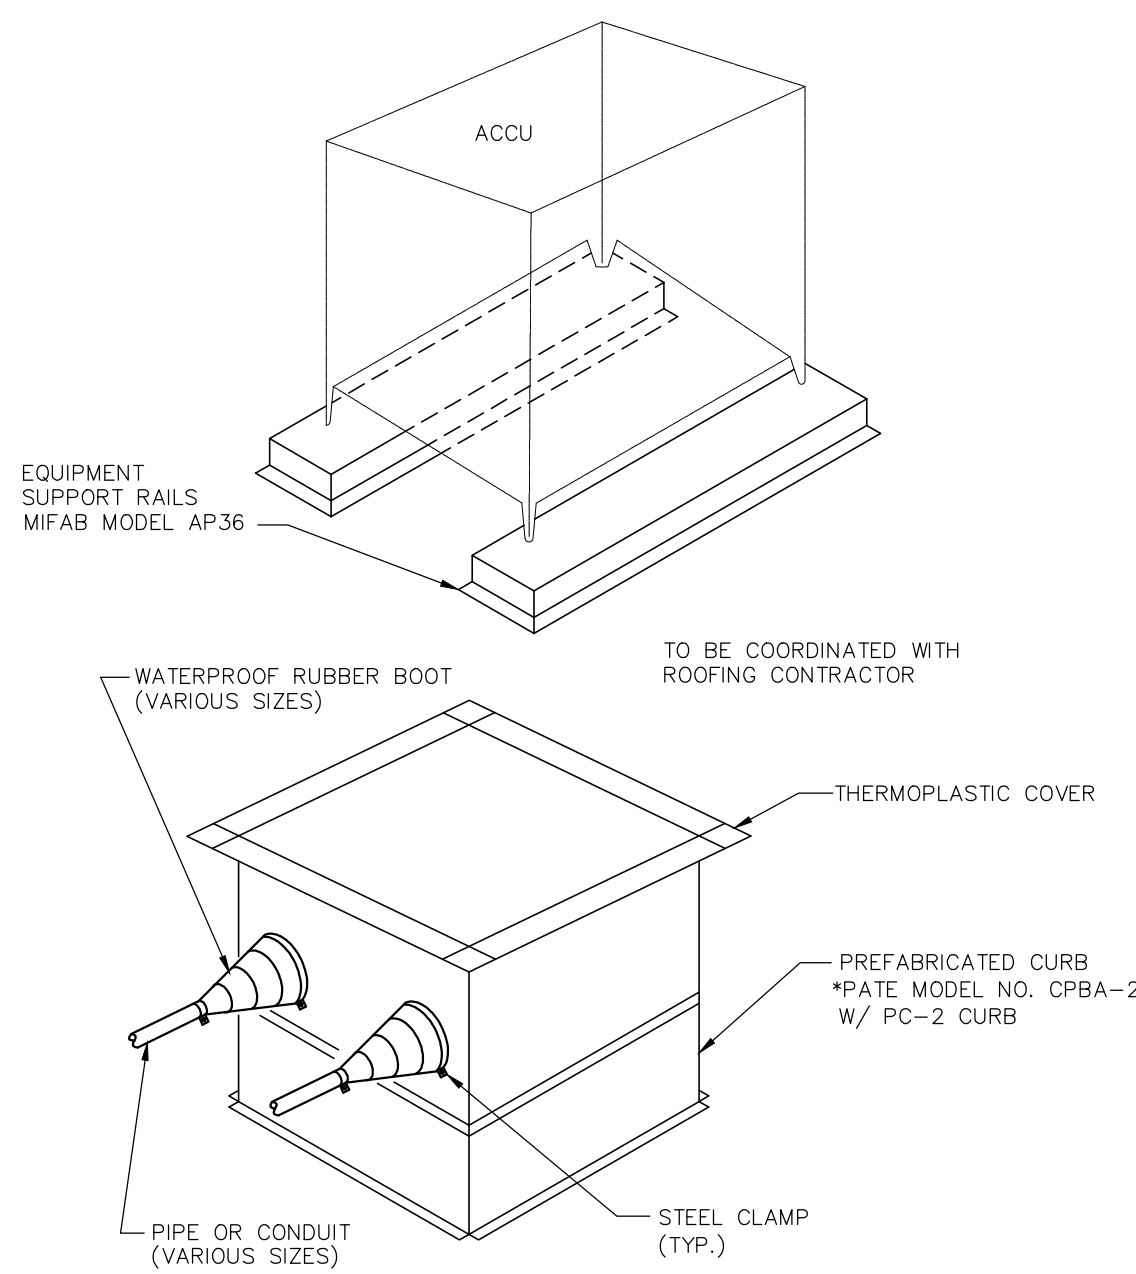

1 CUSTOM PIPING ENCLOSURE DETAIL (TYPICAL)  
SCALE: NONE

NEW WORK NOTES:


SEE MANUFACTURER INSTALLATION RECOMMENDATIONS. ACTUAL PIPING PATHS WILL VARY. SEE DRAWINGS FOR INTENT. VERIFY COIL CONNECTION SIDES BEFORE ORDERING EQUIPMENT.

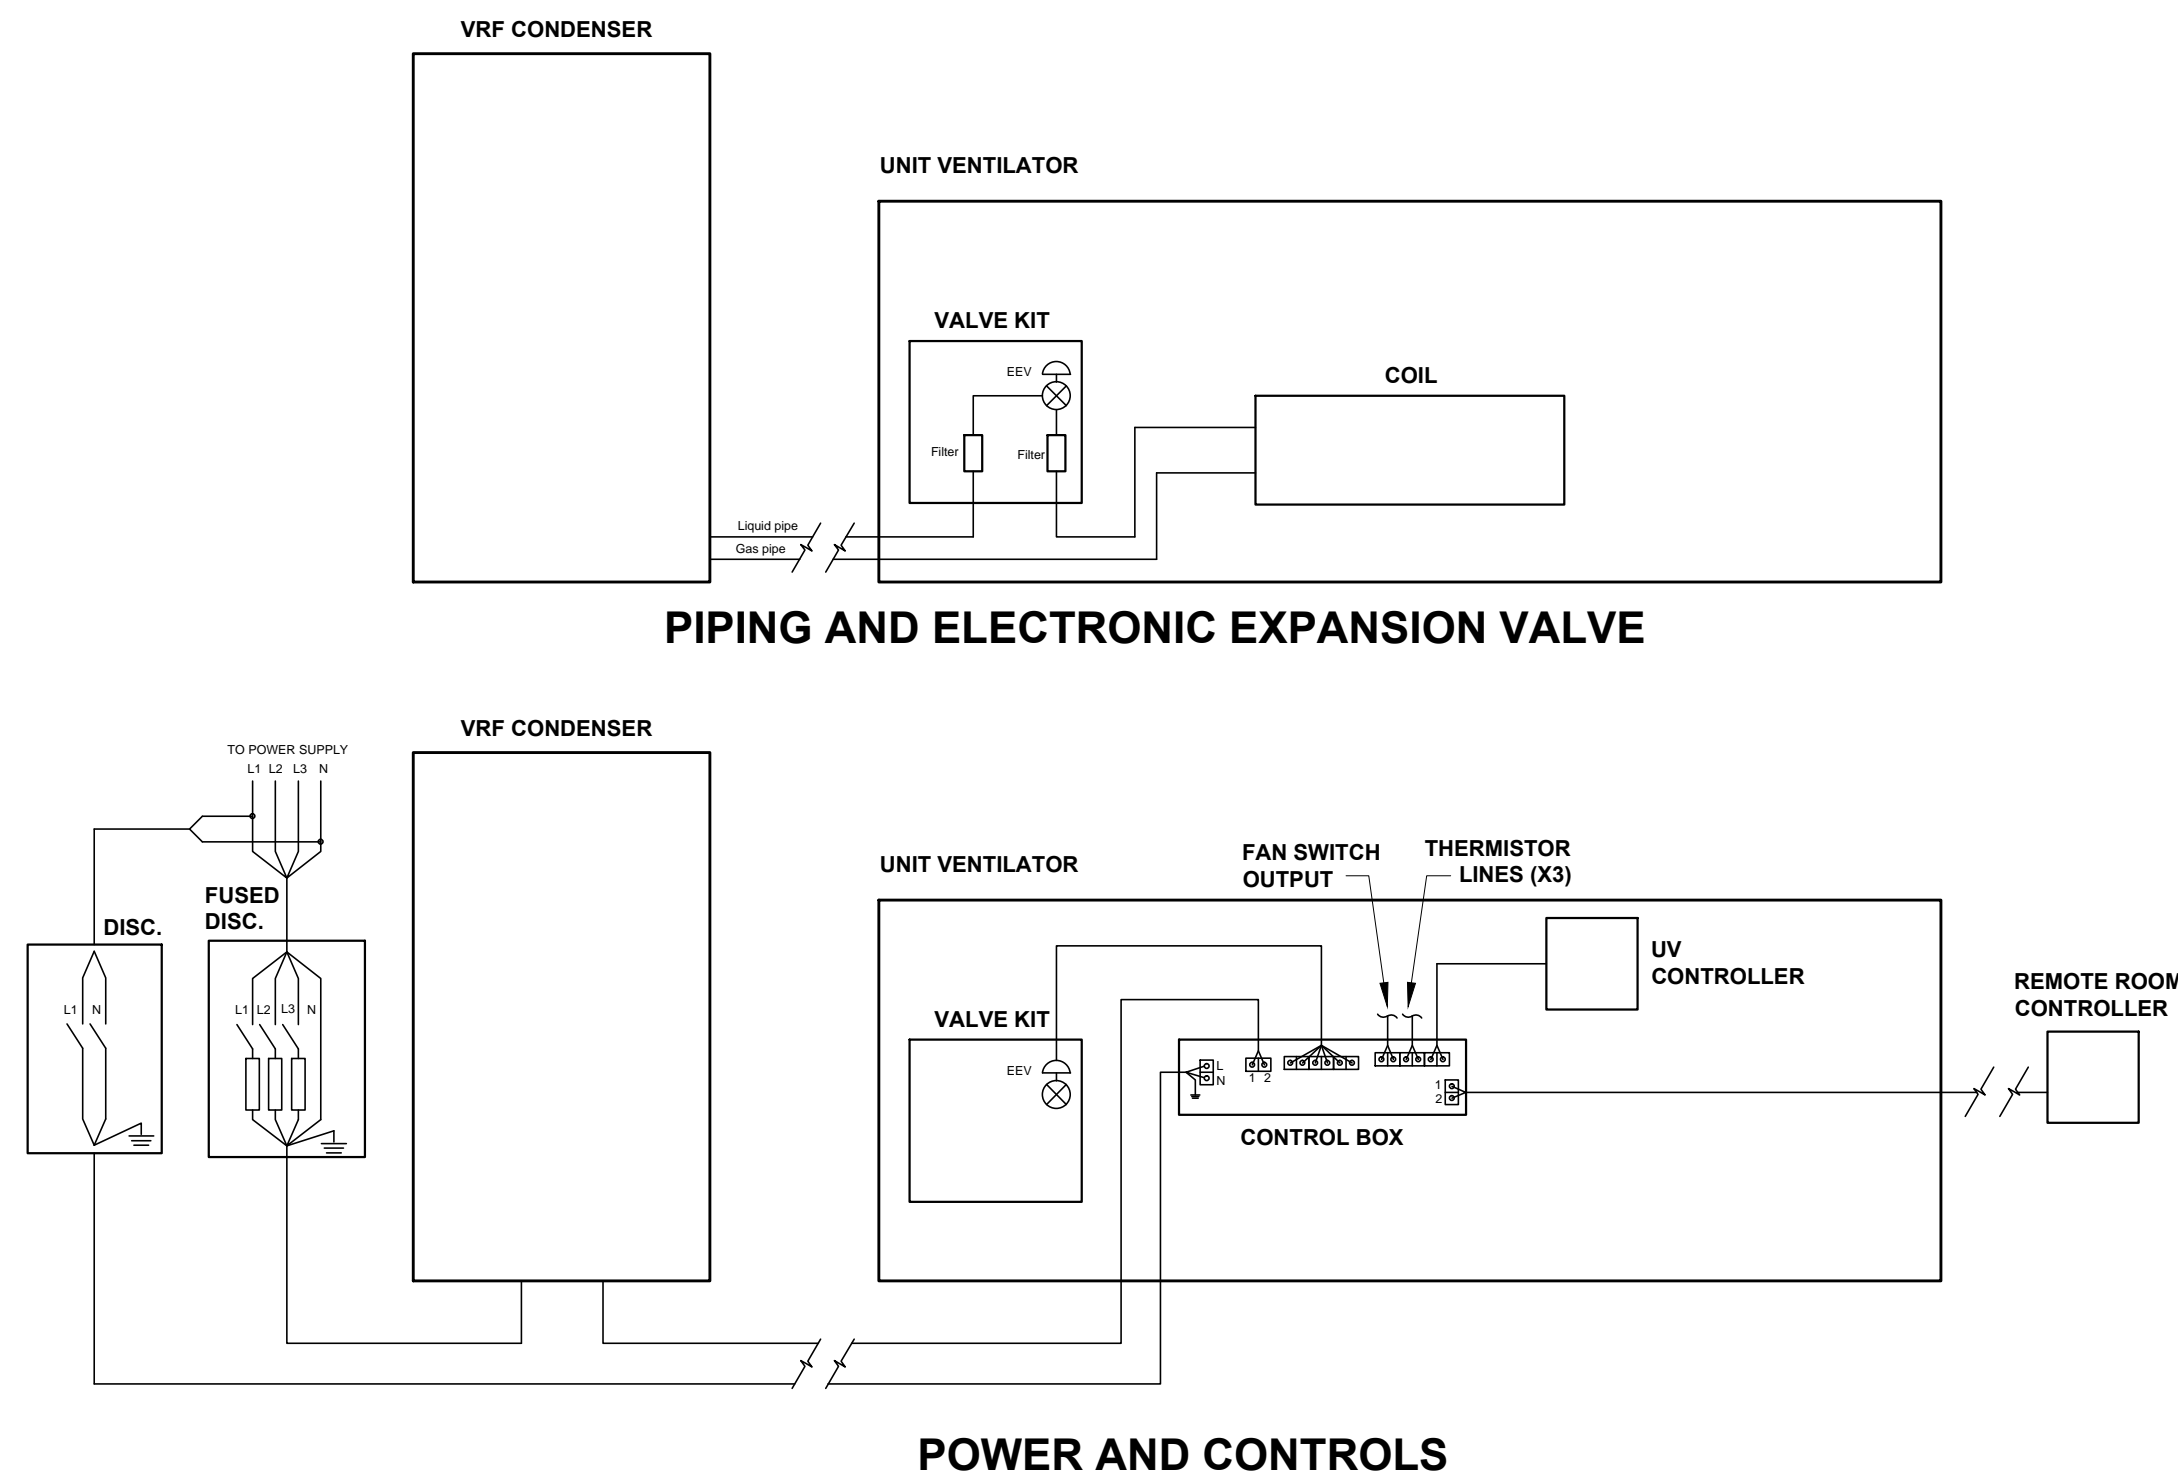

2 VRF-UNIT VENTILATOR PIPING AND ELECTRICAL DETAILS  
SCALE: NONE

NEW WORK NOTES:

SEE MANUFACTURER RECOMMENDATIONS REGARDING THERMISTOR PLACEMENT. MULTI UNIT POWER OPTION NOT SHOWN BUT IS TO BE INCLUDED. EVV TO BE POWERED PER MANUFACTURER RECOMMENDATIONS.

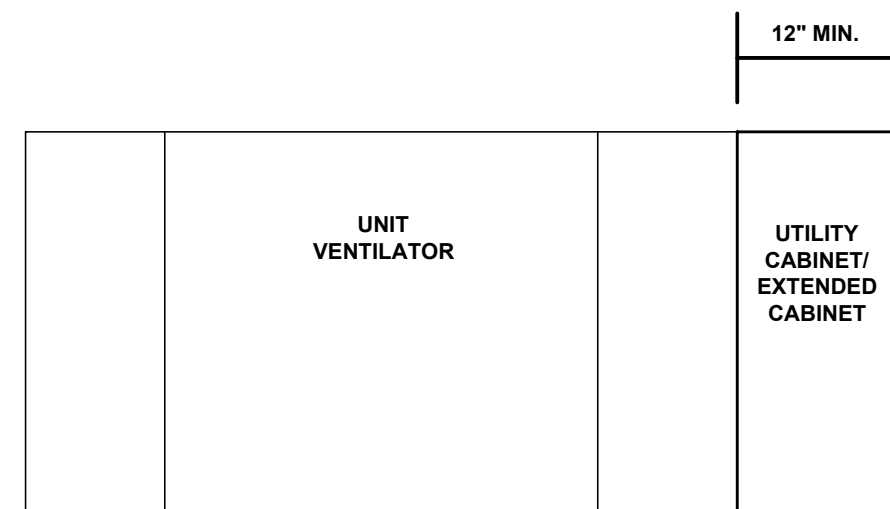


3 UNIT VENTILATOR EXTENDED CABINET  
SCALE: NONE

NEW WORK NOTES:

UTILITY/ EXTENDED CABINET TO MATCH UNIT VENTILATOR CABINET HEIGHT, DEPTH, COLOR, APPEARANCE AND MANUFACTURER. COIL CONNECTION SIDE TO BE VERIFIED IN FIELD BEFORE ORDERING EQUIPMENT. MAKE ALL ALTERATIONS TO FIN TUBE AND COVERS AS NECESSARY. UTILITY CABINET TO HOUSE VRF CONTROL BOX AND VRF ELECTRONIC EXPANSION VALVE.

ENGINEER:  
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WARWICK VALLEY CENTRAL SCHOOL DISTRICT  
HIGH SCHOOL UNIT VENTILATOR REPLACEMENT AND  
AIR CONDITIONING UPGRADE  
225 WEST STREET EXT. WARWICK, NY 10990  
WV HIGH SCHOOL - 89 SANFORDVILLE ROAD, WARWICK, NY 10990  
SED NO. 44-21-01-06-0-001-042

PROJECT NO.	05-21-04 05-20-06
ISSUED FOR BID	11.09.2022
SET SET	10.19.2022
REVISION	DATE
DRAWN BY	
CHECKED BY	
SHEET SIZE	30" X 42"
SCALE	AS NOTED
SHEET TITLE	
DETAILS	
SHEET NO.	

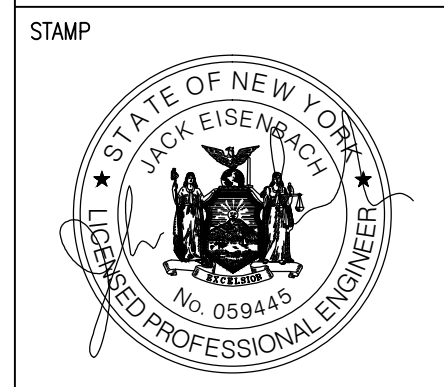
M-501






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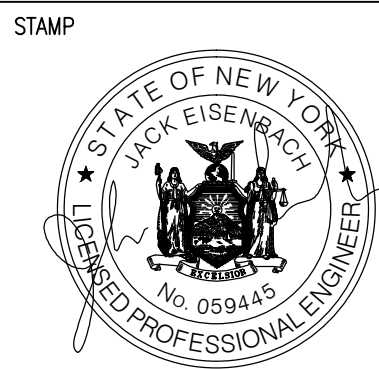
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SED NO. 44-21-01-06-0-001-042

HIGH SCHOOL UV-C LIGHTING SCHEDULE (ALTERNATE)							
NEW UVC CIRCUIT MARK	LOCATION/SERVICE	HVAC UNIT TYPE	HVAC UNIT NOMINAL AIR FLOW (CFM)	UV-C INSTALL LOCATION	UV-C FIXTURE MODEL NO.	UV-C FIXTURE VOLTAGE/PH	HVAC UNIT VOLTAGE/PH
FIRST FLOOR							
UVC-HS-79	128	UV *	750	115/1	IN CABINET	UV-FCU-CL 90H-P-B-VENT	1 110-240/1
UVC-HS-80	130	UV *	1000	115/1	IN CABINET	UV-FCU-CL 90H-P-B-VENT	1 110-240/1
UVC-HS-81	132	UV *	1000	115/1	IN CABINET	UV-FCU-CL 90H-P-B-VENT	1 110-240/1
UVC-HS-82	154 Wrestling Rm	RTU *	2400	208/3		UV-FCU-CL 90H-P-B-VENT	1 110-240/1
SECOND FLOOR							
UVC-HS-83	231	UV *	1500	115/1	IN CABINET	UV-FCU-CL 90H-P-B-VENT	1 110-240/1
UVC-HS-84	232	UV *	1500			UV-FCU-CL 90H-P-B-VENT	1
UVC-HS-85	233	UV *	1500			UV-FCU-CL 90H-P-B-VENT	1
UVC-HS-86	234	UV *	1500			UV-FCU-CL 90H-P-B-VENT	1
UVC-HS-87	235	UV *	1000			UV-FCU-CL 90H-P-B-VENT	1
UVC-HS-88	236	HORIZ. UV *	1000			UV-FCU-CL 90H-P-B-VENT	1
UVC-HS-89	238	HORIZ. UV *	1000			UV-FCU-CL 90H-P-B-VENT	1
UVC-HS-90	239	UV *	1250			UV-FCU-CL 90H-P-B-VENT	1
UVC-HS-91	240	HORIZ. UV *	1500			UV-FCU-CL 90H-P-B-VENT	1
UVC-HS-92	241	UV *	1000			UV-FCU-CL 90H-P-B-VENT	1
UVC-HS-93	243	HORIZ. UV *	1000			UV-FCU-CL 90H-P-B-VENT	1
UVC-HS-94	245	HORIZ. UV *	1000	↓	↓	UV-FCU-CL 90H-P-B-VENT	1 ↓
(*) INDICATES UNIT IS PROVIDED NEW AS PART OF CURRENT PROJECT. REFER TO M DRAWINGS FOR MORE INFORMATION. DO NOT PROVIDE UV-C FIXTURES TO EXISTING TO BE REMOVED EQUIPMENT.							

HIGH SCHOOL UV-C LIGHTING SCHEDULE						ALL WORK THIS AREA PART OF ALTERNATE (ALT. H-1)		
NEW UVC CIRCUIT MARK	LOCATION/SERVICE	HVAC UNIT TYPE	HVAC UNIT NOMINAL AIR FLOW (CFM)	UV-C INSTALL LOCATION	UV-C FIXTURE MODEL NO.	UV-C FIXTURE VOLTAGE/PH	QTY.	HVAC UNIT VOLTAGE/PH
BASEMENT								
UVC-HS-95	70	UV *	1500	115/1	IN CABINET	UV-FCU-CL 90H-P-B-VENT	1	110-240/1
UVC-HS-96		UV *	1500	115/1	IN CABINET	UV-FCU-CL 90H-P-B-VENT	1	110-240/1
FIRST FLOOR								
UVC-HS-97	Main Office Conference Rm.	UV	1000	115/1	IN CABINET	UV-FCU-CL 90H-P-B-VENT	1	110-240/1
UVC-HS-98	Main Office	HORIZ. UV	1000		IN CABINET	UV-FCU-CL 90H-P-B-VENT	1	
UVC-HS-99	147	UV *	1000		IN CABINET	UV-FCU-CL 90H-P-B-VENT	1	
UVC-HS-100	149	UV *	1000		IN CABINET	UV-FCU-CL 90H-P-B-VENT	1	
UVC-HS-101	151	UV *	1000		IN CABINET	UV-FCU-CL 90H-P-B-VENT	1	
UVC-HS-102	153	UV *	1000		IN CABINET	UV-FCU-CL 90H-P-B-VENT	1	
UVC-HS-103	155	UV *	1000		IN CABINET	UV-FCU-CL 90H-P-B-VENT	1	
UVC-HS-104	157	UV *	1000		IN CABINET	UV-FCU-CL 90H-P-B-VENT	1	
UVC-HS-105	159	UV *	1000		IN CABINET	UV-FCU-CL 90H-P-B-VENT	1	
UVC-HS-106	162	UV *	1500		IN CABINET	UV-FCU-CL 90H-P-B-VENT	1	
UVC-HS-107	164	UV *	750		IN CABINET	UV-FCU-CL 90H-P-B-VENT	1	
UVC-HS-108	166	UV *	1250		IN CABINET	UV-FCU-CL 90H-P-B-VENT	1	
UVC-HS-109	168	UV *	1250		IN CABINET	UV-FCU-CL 90H-P-B-VENT	1	
UVC-HS-110	170	UV *	1250		IN CABINET	UV-FCU-CL 90H-P-B-VENT	1	
UVC-HS-111	171	UV *	1500	▽	IN CABINET	UV-FCU-CL 90H-P-B-VENT	1	▽
(*) INDICATES UNIT IS PROVIDED NEW AS PART OF CURRENT PROJECT. REFER TO M DRAWINGS FOR MORE INFORMATION. DO NOT PROVIDE UV-C FIXTURES TO EXISTING TO BE REMOVED EQUIPMENT.								

ALTERNATE NOTE  
(ALT. H-1) EQUIPMENT AND ASSOCIATED WORK WITH THIS MARK TO BE PROVIDED AS PART OF ALTERNATE H-1 ONLY. ALL OTHER UNMARKED WORK TO BE PROVIDED AS PART OF BASE BID.


### UV-C LIGHT FIXTURE SPECIFICATION AND INSTALLATION NOTES

- NOTE 1: PROVIDE UV-C LIGHT FIXTURES AND BULBS FROM COGNITUV BRAND, NO SUBSTITUTION, AND ANY HARDWARE, SHIELDING, WIRING, DRIVERS, RELAYS, TRANSFORMERS, AND ALL APPURTENANCES NECESSARY FOR INSTALLATION.
- NOTE 2: PROVIDE POWER TO LIGHT FIXTURES USING 2#12 -W1#12 GRD WIRING. PROVIDE 3/4" CONDUIT OR METAL CLADDING TO POWER AND CONTROL WIRING. POWER AND CONTROL WIRING TO BE IN SEPARATE CONDUIT/MC TO AVOID INTERFERENCE.
- NOTE 3: UV-C CONTRACTOR TO PROVIDE AND COORDINATE CUTTING, PATCHING, SEALING, AND REINSULATING OF DISTURBED DUCTWORK. REINFORCE DUCTWORK TO MAINTAIN RIGIDITY AND PROVIDE SUPPORT TO PREVENT DUCTWORK SAGGING, DEFORMATION, OR VIBRATION. TEST AND SEAL ALL PENETRATIONS TO BE AIRTIGHT.
- NOTE 4: EACH UV-C LIGHTING CIRCUIT MUST INCLUDE AN INDIVIDUAL SERVICE SWITCH. ONE SERVICE SWITCH MUST DISCONNECT POWER FROM ALL UV-C FIXTURES ON THE CIRCUIT. THIS SERVICE SWITCH SHALL NOT DISCONNECT POWER TO THE HVAC UNIT, CONTROLLER, OR FAN. THE SERVICE SWITCH FACE PLATES MUST INDICATE ON AND OFF DIRECTIONS.
- NOTE 5: THE SERVICE SWITCH SHALL HAVE A STATUS INDICATING LED, EITHER INCORPORATED INTO THE SWITCH OR OTHERWISE ADDED. THE SERVICE SWITCH LED SHALL ILLUMINATE ONLY IF THE UV-C FIXTURE(S) ARE ON AND ILLUMINATED. IF THERE ARE FACTORY-MOUNTED STATUS LEDS ON THE UV-C FIXTURES AND THEY ARE VISIBLE FROM THE OUTSIDE OF THE FIXTURE, THE SWITCH STATUS LED MAY BE OMITTED.
- NOTE 6: UV-C LIGHTING AND ALL APPURTENANCES MUST BE POSITIONED TO BE ACCESSIBLE WITHIN REASON TO ALLOW FOR CLEANING, MAINTENANCE, AND REPLACEMENT OF BULB(S). VERIFY PLACEMENT BASED ON FIELD CONDITIONS. PROVIDE PAINTED ACCESS PANELS AS NEEDED.
- NOTE 7: TIE INTO SPECIFIED HVAC EQUIPMENT CONTROLS. REFER TO THE UV-C ACTIVATION CONDITIONS DETAIL REGARDING WHEN THE UV-C FIXTURE(S) SHALL BE ACTIVATED.
- NOTE 8: CONNECT TO BMS CONTROLS AND INTEGRATE TO TRIP TROUBLE CODES FOR MALFUNCTIONS, SUCH AS A NON-FUNCTIONAL BALLAST OR BULB. PROVIDE UV-C FIXTURE WITH OPTIONS AND EQUIPMENT TO COMMUNICATE WITH EXISTING BMS. VERIFY IN FIELD.
- NOTE 9: AFFIX 1" PLASTIC OR VINYL LABELS TO EACH UV-C LIGHT FIXTURE AND SERVICE SWITCH WITH THE CORRESPONDING UV-C CIRCUIT MARK NOTED ABOVE. EACH UV-C FIXTURE TO BE MARKED WITH AN APPROPRIATE WARNING LABEL. PROVIDE PLASTIC OR VINYL PURPLE MARKERS TO APPROXIMATELY MARK LOCATIONS OF UV-C FIXTURES ABOVE CEILINGS. AFFIX TO T-BAR FOR DROP CEILINGS. AFFIX A LABEL READING "UV-C ON" NEAR ALL STATUS INDICATING LEDS, WHETHER FACTORY-MOUNTED OR OTHERWISE. FOR CIRCUITS THAT REQUIRE POWER TO COME FROM A NEARBY AVAILABLE POWER PANEL, AFFIX LABEL TO CIRCUIT SWITCH INDICATING PANEL'S ROOM NUMBER, PANEL NAME, AND BREAKER NUMBER.
- NOTE 10: CONTROLS TO BE COORDINATED WITH DISTRICT CONTROLS VENDER.
- NOTE 11: ALL LOCATIONS, ORIENTATIONS, AND TYPES OF UV-C LIGHT FIXTURES ARE APPROXIMATE. DETERMINE FINAL LOCATION/ORIENTATION BASED ON MANUFACTURER'S RECOMMENDATIONS AND FIELD CONDITIONS.
- NOTE 12: FOR UNITS WITH FIXTURES INDICATED TO BE MOUNTED "IN CABINET", PROVIDE AT LEAST ONE (1) SNAP-ACTION TYPE SWITCH TO EACH OF THE SCHEDULED HVAC UNITS' (UV, AHU, RTU, ETC.) ACCESS DOORS/PANELS AND/OR ADJACENT DUCTWORK ACCESS DOORS/PANELS. HARDWIRE POWER TO SWITCHES TO AUTOMATICALLY TURN OFF ALL UV-C LIGHTS ON THE APPLICABLE UV-C CIRCUIT IF ANY PANELS ARE OPENED. PROVIDE ALL WIRING AND APPURTENANCES. SEE SCHEDULE FOR UNIT TYPES. VERIFY ACCESS DOORS/PANELS IN FIELD.
- NOTE 13: "IN CABINET" INSTALLATIONS SHALL MAKE USE OF LIGHT SHIELDING AND REQUIRE PROPER AIMING DURING INSTALLATION. REFER TO MANUFACTURER'S RECOMMENDATIONS.

### HVAC UNIT LEGEND


- RTU - ROOF TOP UNIT  
AHU - AIR HANDLING UNIT  
UV - VERTICAL UNIT VENTILATOR - FLOOR MOUNTED  
HORIZ. UV - HORIZONTAL UNIT VENTILATOR - CEILING HUNG  
FCU - VERTICAL FAN COIL UNIT - FLOOR MOUNTED  
HORIZ. FCU - HORIZONTAL FAN COIL UNIT - CEILING HUNG  
VRF - VARIABLE REFRIGERANT FLOW SYSTEM  
HRU - HEAT RECOVERY UNIT  
MAU - MAKE-UP AIR UNIT

### CIRCUIT NAMING CONVENTION

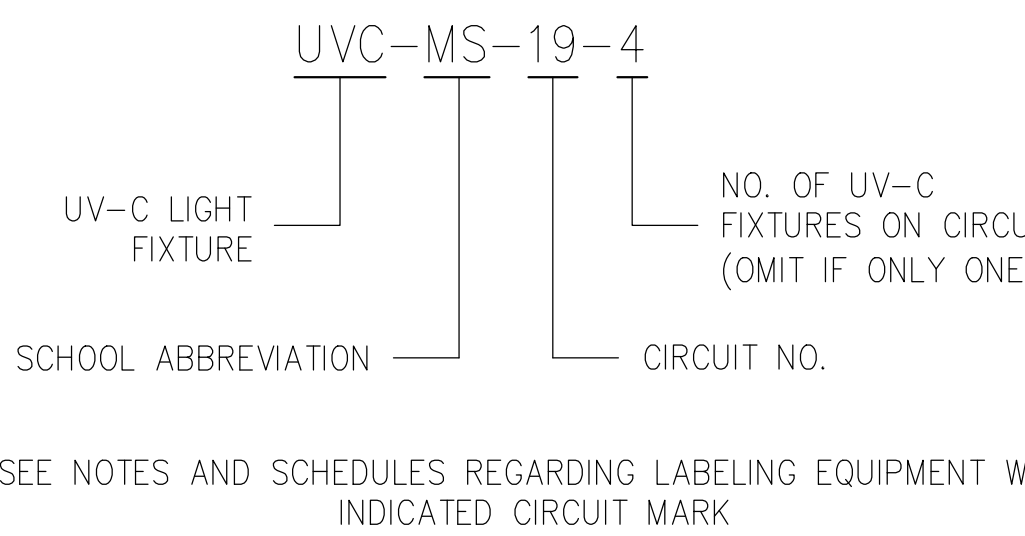


PROJECT NO.	05-21-04 09-20-06
ISSUED FOR BID	11.09.2022
SET SET	10.19.2022
REVISION	DATE
DRAWN BY	
CHECKED BY	
SHEET SIZE	30" X 42"
SCALE	AS NOTED
SHEET TITLE	
HIGH SCHOOL UV-C LIGHT FIXTURE SCHEDULE	
SHEET NO.	
M-503	


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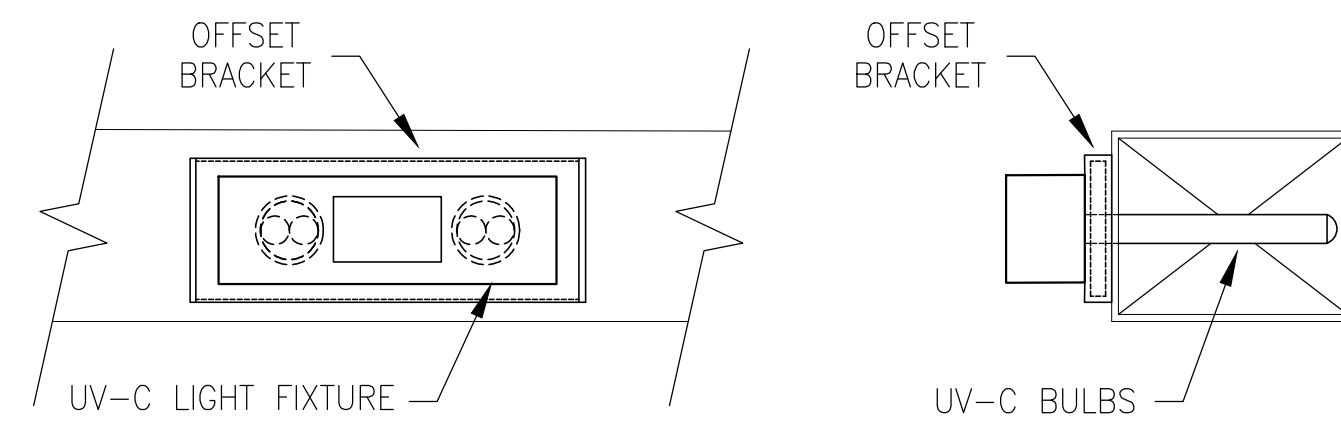
1 ROOFTOP UNIT VERTICAL DUCT UV-C LIGHT INSTALLATION  
SCALE: NONE

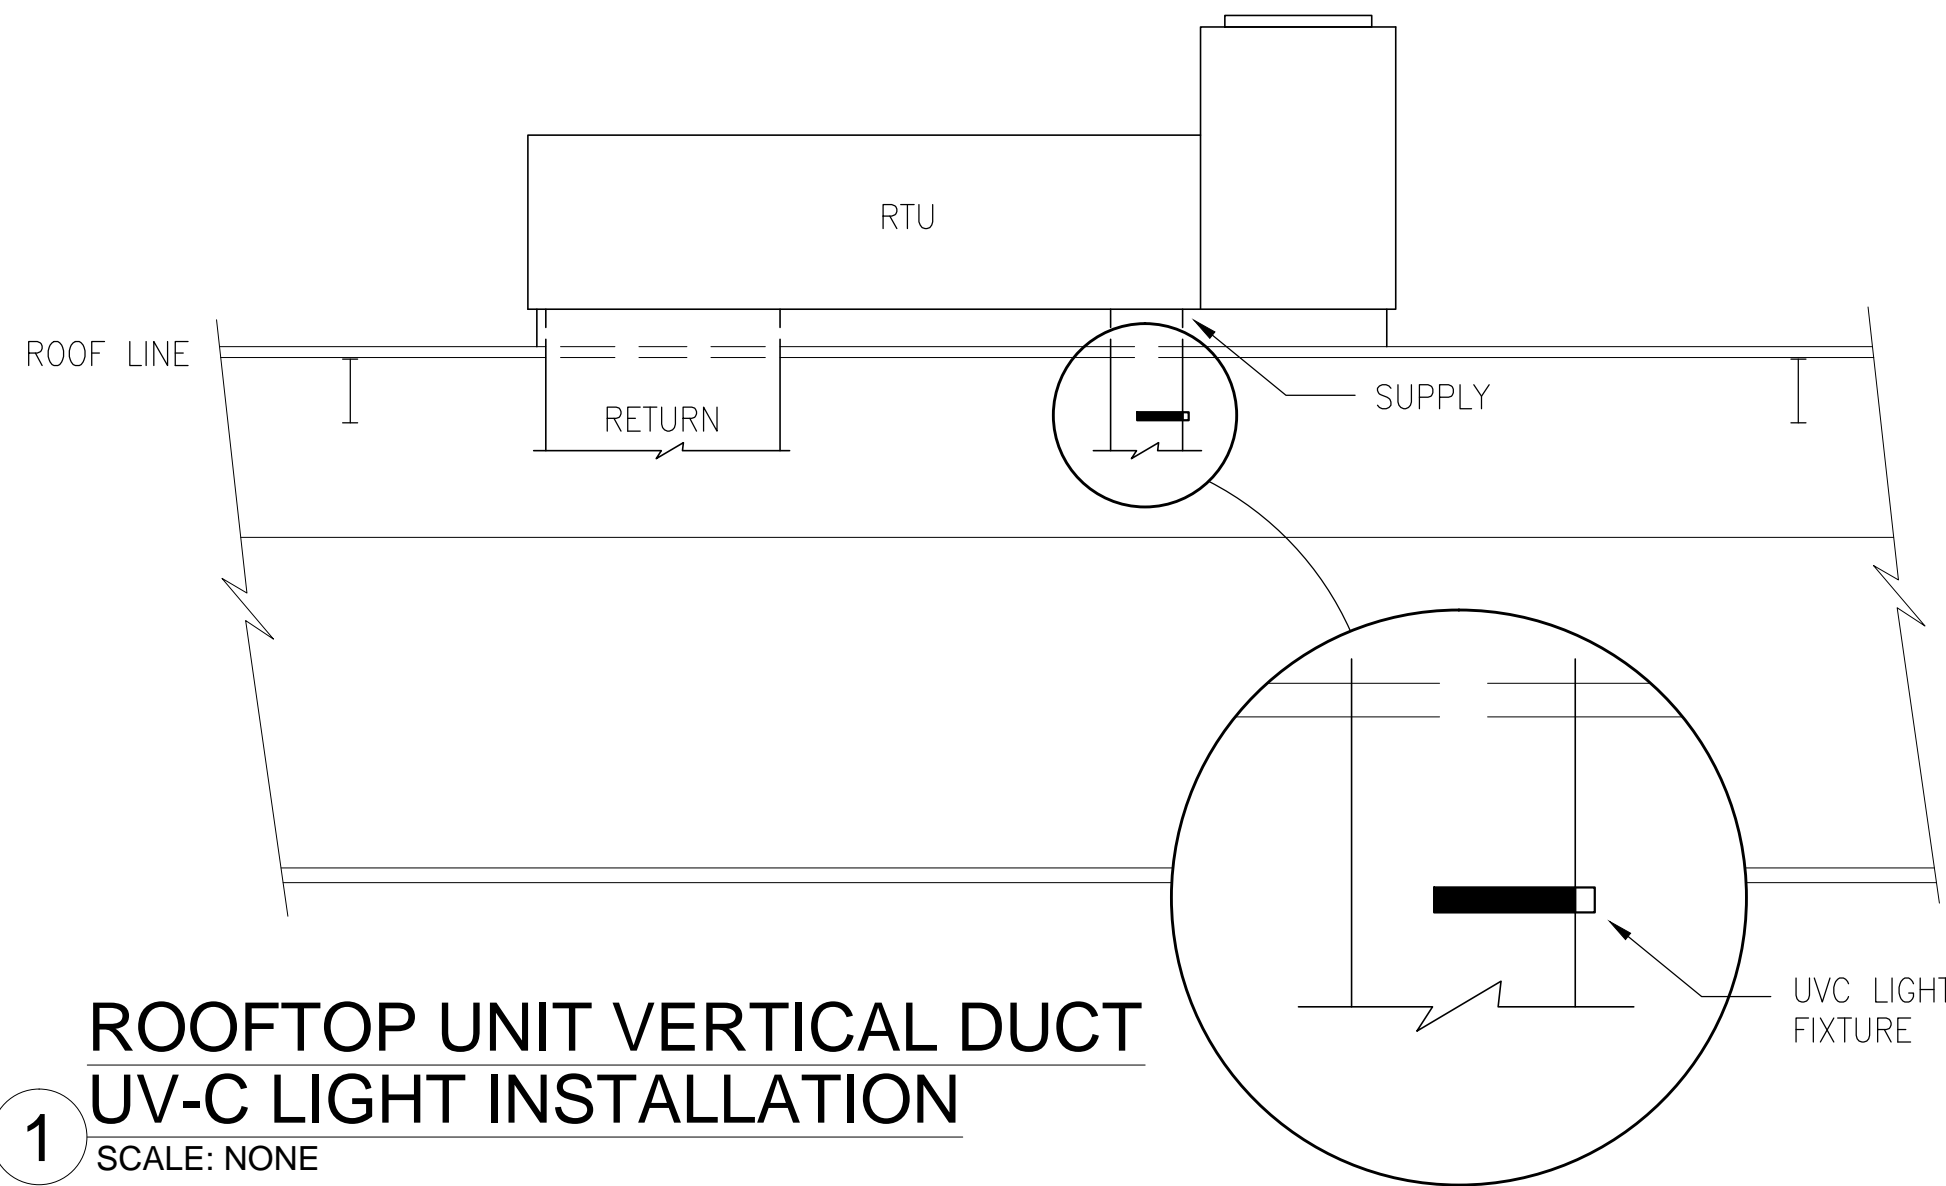

2 DUCTWORK UV-C LIGHT TYPICAL INSTALLATION DETAIL  
SCALE: NONE

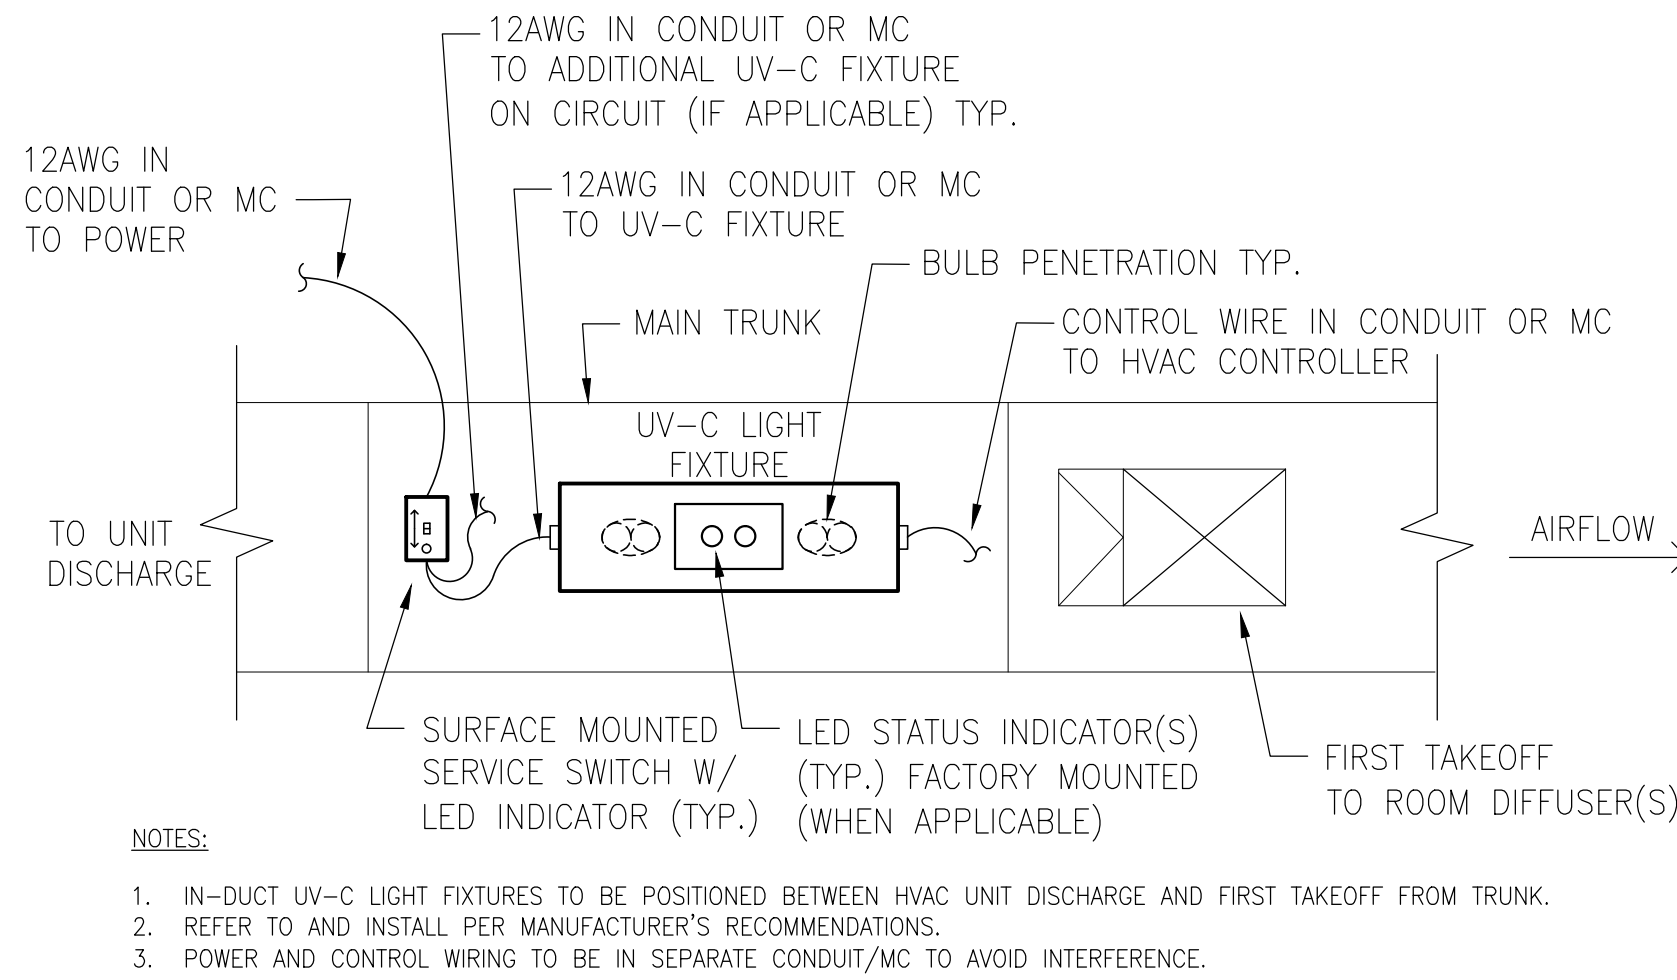

3 VERTICAL UV/FCU UV-C LIGHT TYPICAL INSTALLATION DETAIL  
SCALE: NONE

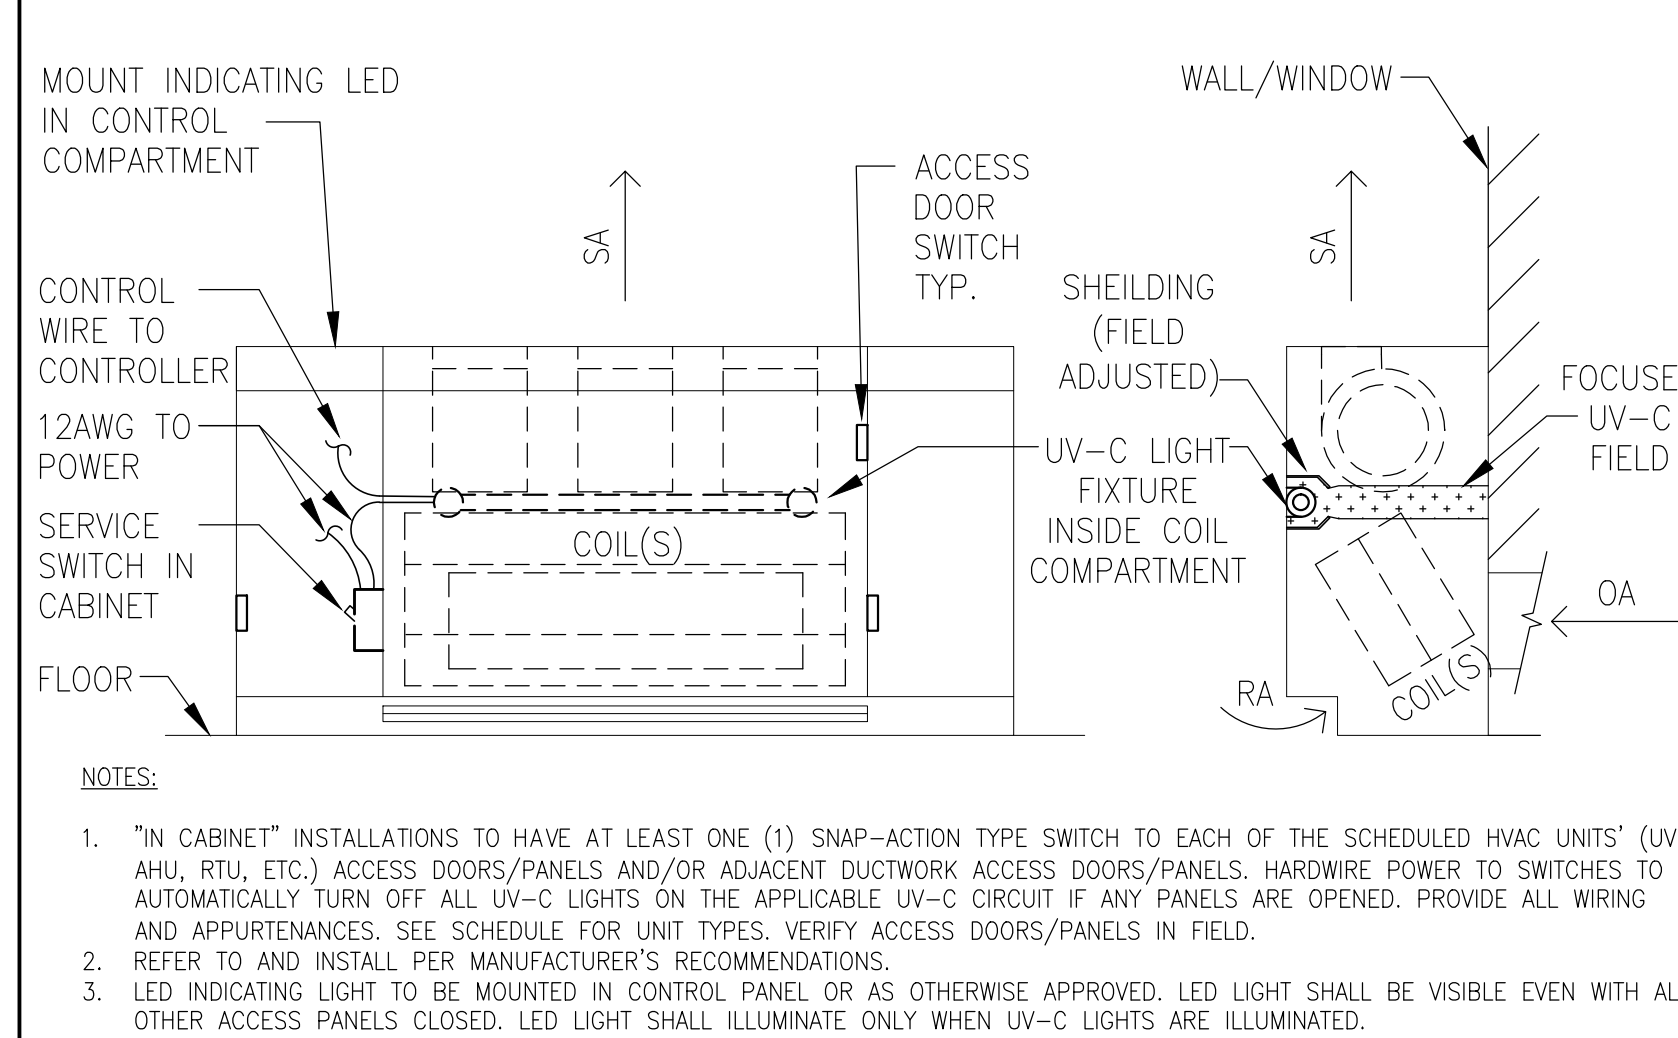

4 OFFSET BRACKET PLACEMENT FOR HIGH WATTAGE BULB IN SMALL DUCT  
SCALE: NONE

EQUIPMENT:	LABELS REQUIRED:
UV-C LIGHT FIXTURES	<ul style="list-style-type: none"><li>UV-C CIRCUIT MARK</li><li>"UV-C ON" AT INDICATING LEDS</li><li>WARNING LABEL (BY MANUFACTURER)</li><li>BLANK LABEL ON CEILINGS FOR QUICK LOCATION (WHEN APPLICABLE)</li></ul>
SERVICE SWITCH	<ul style="list-style-type: none"><li>UV-C CIRCUIT MARK</li><li>"UV-C ON" AT INDICATING LEDS (WHEN APPLICABLE)</li><li>PANEL LOCATION, NAME, BREAKER # (WHEN APPLICABLE)</li></ul>



NOTE: LABEL COLOR TO BE PURPLE, OR AS SELECTED BY DISTRICT

5 LABELING REQUIREMENTS AND LOCATIONS  
SCALE: NONE

UV-C & LED "OFF" CONDITIONS (REASONS IN BOLD)		"ON" CONDITIONS	
<b>"UNOCCUPIED MODE"</b> UNIT/ FAN (ON)	<b>"OCCUPIED MODE"</b> UNIT/ FAN (ON)	<b>"OCCUPIED MODE"</b> UNIT/ FAN (ON)	<b>"OCCUPIED MODE"</b> UNIT/ FAN (ON)
DISC. SWITCH (ON) SWITCH LED (OFF) ALL ACCESS DOOR SNAP SWITCHES (CLOSED) UV-C (OFF) UV-C (OFF)	DISC. SWITCH (OFF) SWITCH LED (OFF) ALL ACCESS DOOR SNAP SWITCHES (CLOSED) UV-C (OFF) UV-C (OFF)	DISC. SWITCH (ON) SWITCH LED (OFF) ANY ACCESS DOOR SNAP SWITCH (OPEN) UV-C (OFF) UV-C (OFF)	DISC. SWITCH (ON) SWITCH LED (ON) ALL ACCESS DOOR SNAP SWITCHES (CLOSED) UV-C (ON) UV-C (ON)
NOTE 1	NOTE 2	NOTE 3	NOTE 4


- NOTES:
- UV-C FIXTURES SHALL NOT ENGAGE DURING "UNOCCUPIED" MODE. "OCCUPIED MODE" TO BE ACTIVE WITHIN THE TIME FRAME FROM ONE HOUR BEFORE SCHOOL UNTIL ONE HOUR AFTER SCHOOL "UNOCCUPIED MODE" TO BE ACTIVE OUTSIDE OF THAT TIME FRAME (COORDINATE TIME-FRAME SETTING WITH DISTRICT REPRESENTATIVE), OR AS DEFINED BY THE HVAC EQUIPMENT.
  - THE DISCONNECTING SWITCH IN THE "OFF" POSITION SHALL NOT ILLUMINATE THE LED AND SHALL DISCONNECT ALL UV-C LIGHTS ON THE CIRCUIT. UV-C FIXTURES SHALL NOT ENGAGE IF THE DISCONNECTING SWITCH IS "OFF".
  - HVAC UNITS WITH UV-C LIGHT FIXTURES INSTALLED INSIDE OF THE UNIT'S CABINET (WHEN APPLICABLE) SHALL HAVE SNAP SWITCH SENSORS INSTALLED TO ALL ACCESS DOORS. IF ANY ACCESS DOOR SNAP SWITCH SENSORS ARE OPEN THE UV-C FIXTURES SHALL NOT ENGAGE.
  - THE UV-C LIGHT FIXTURES AND DISCONNECTING SWITCH LED SHALL ENGAGE AND ILLUMINATE ONLY WHEN: DURING "OCCUPIED MODE", WHEN THE HVAC UNIT IS "ON", ALL SNAP SWITCH SENSORS ARE CLOSED, AND DISCONNECTING SWITCH IS "ON".

6 UV-C LIGHT FIXTURE ACTIVATION CONDITIONS  
SCALE: NONE

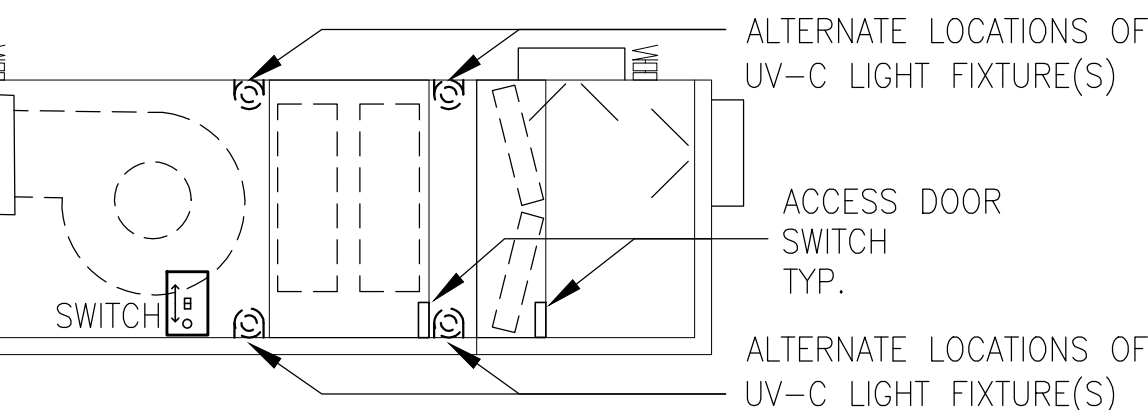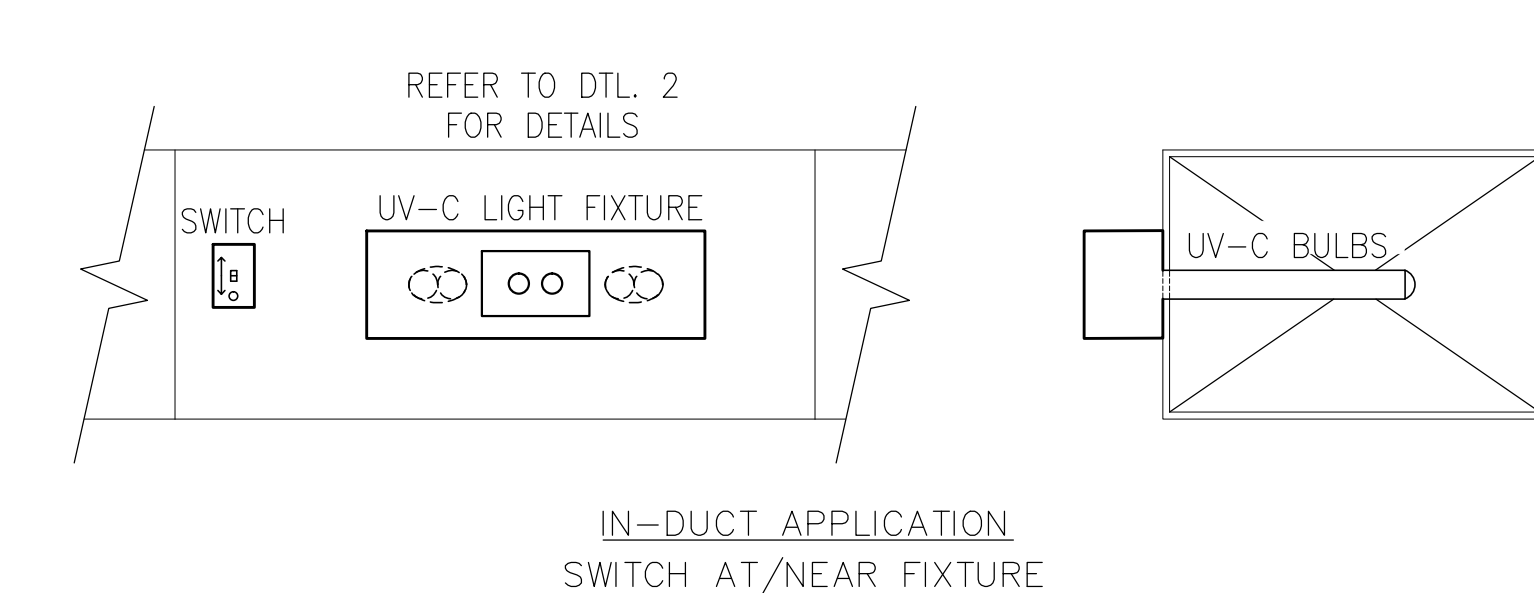


IN-CABINET HORIZONTAL AHU/UV/FCU APPLICATION  
SWITCH ON EXTERIOR OF HVAC UNIT

7 UV-C LIGHT FIXTURE & DISCONNECT SWITCH INSTALLATION LOCATIONS  
SCALE: NONE

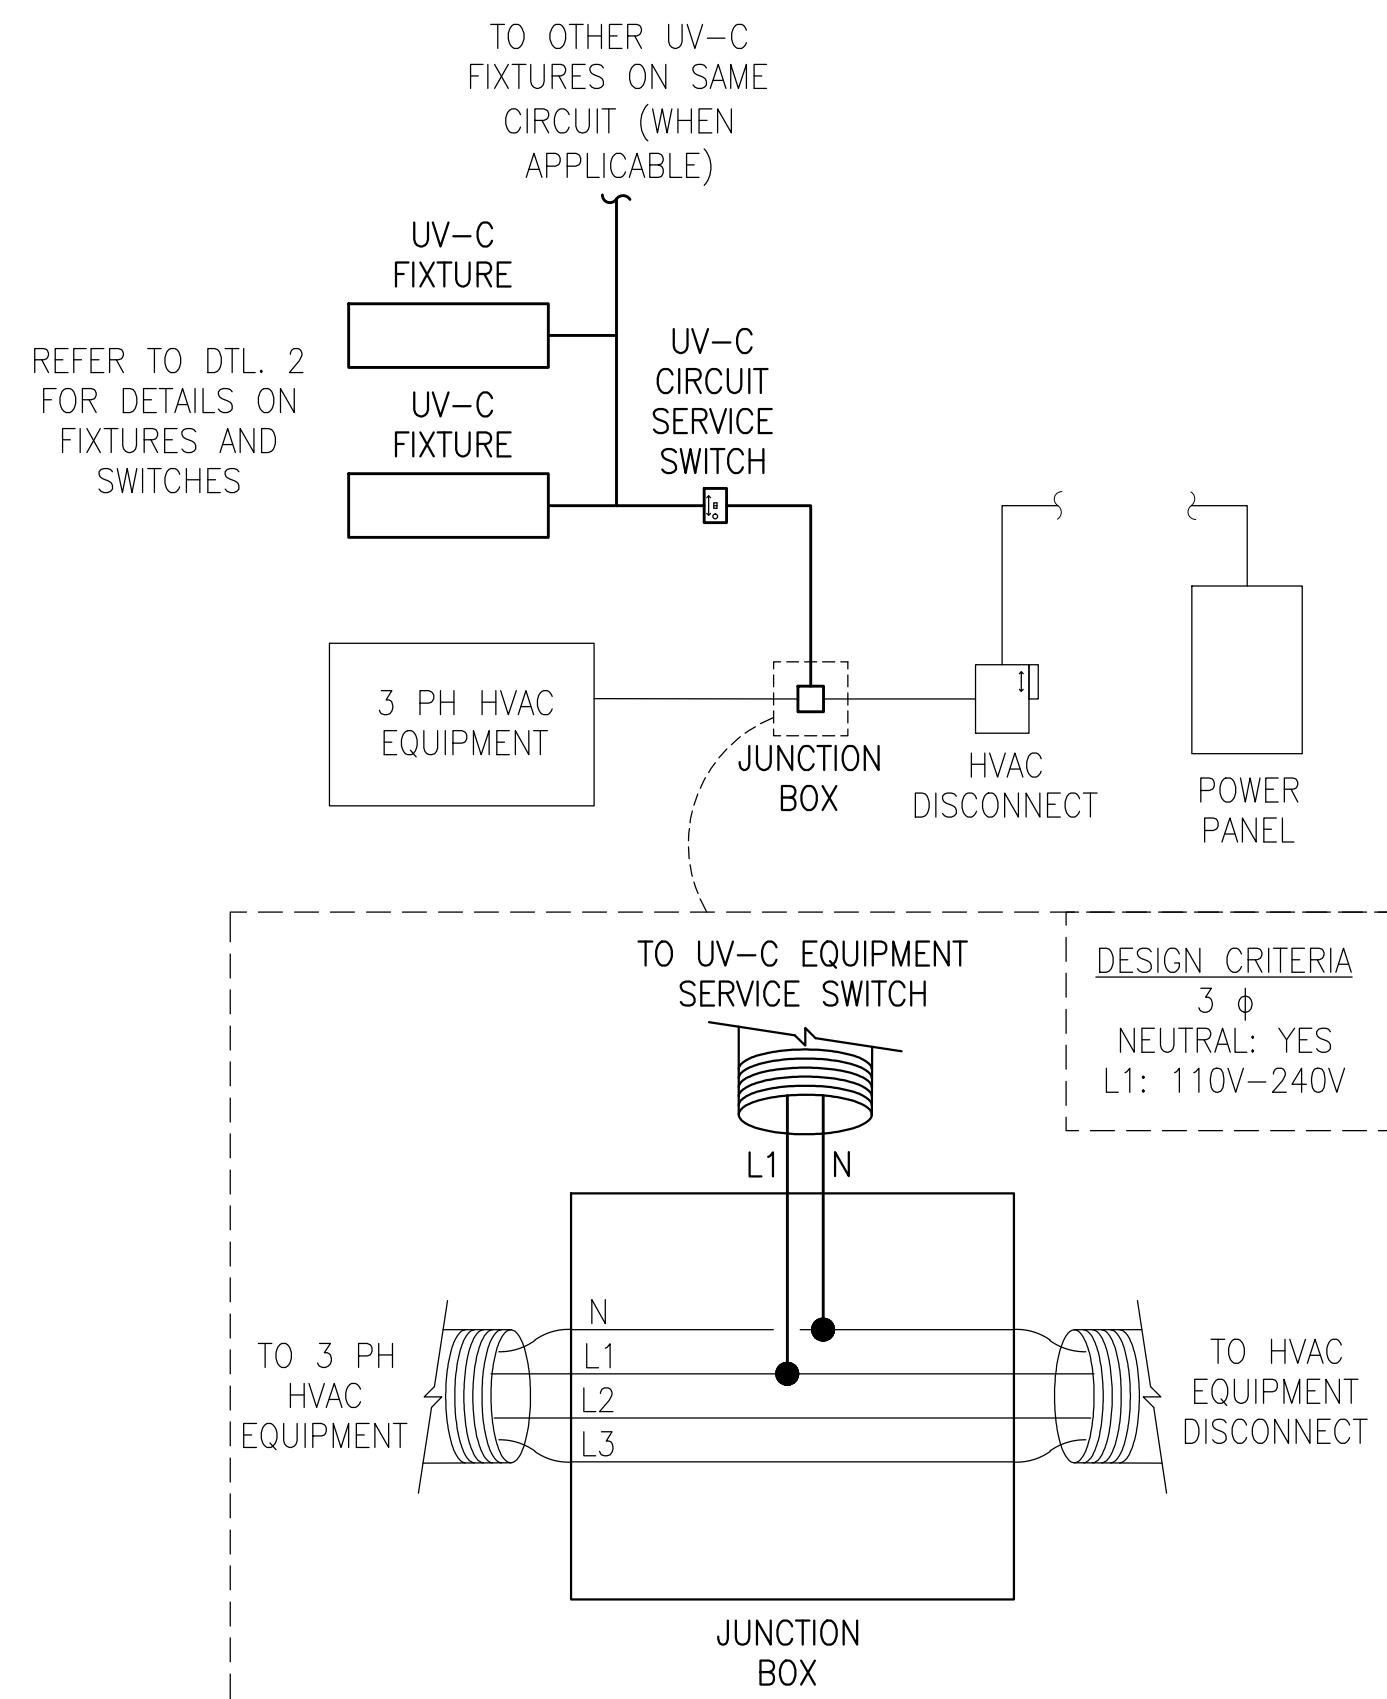


8 UV-C POWER DIAGRAM THREE PHASE W/ NEUTRAL & L1=110V-240V  
SCALE: NONE

- NOTES:
- CIRCUIT MAY BE POWERED FROM HVAC EQUIPMENT'S POWER CIRCUIT WHEN A NEUTRAL WIRE IS PRESENT. BEFORE TAPPING, ONE LEG'S CIRCUIT VOLTAGE MUST TEST TO THE SPECIFIED VOLTAGE RANGE ABOVE. INSTALL 4"x4"x2" JUNCTION BOX BETWEEN HVAC DISCONNECT AND HVAC EQUIPMENT AS SHOWN.

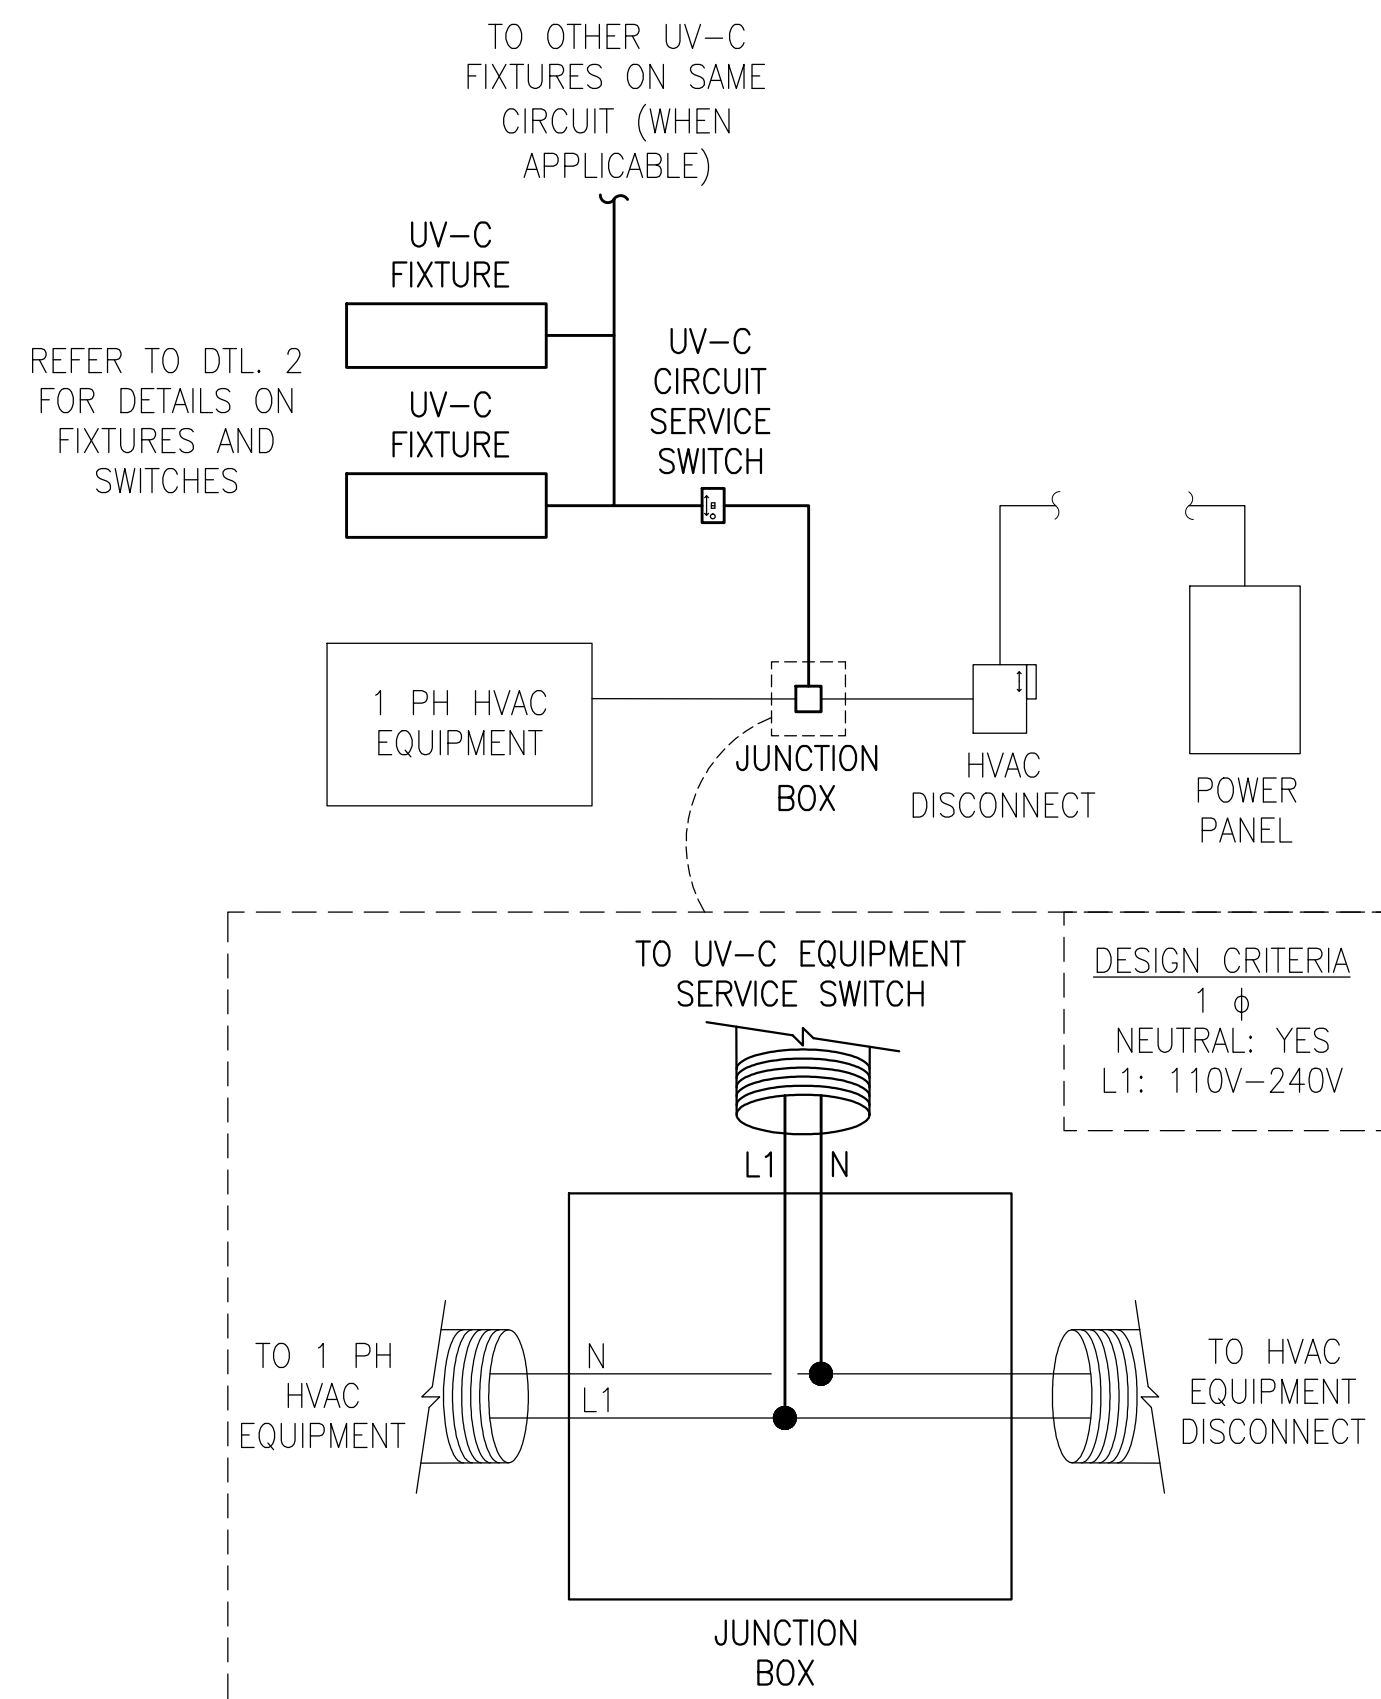


9 UV-C POWER DIAGRAM SINGLE PHASE W/ NEUTRAL & L1=110V-240V  
SCALE: NONE

- NOTES:
- CIRCUIT MAY BE POWERED FROM HVAC EQUIPMENT'S POWER CIRCUIT WHEN A NEUTRAL WIRE IS PRESENT. BEFORE TAPPING, CIRCUIT VOLTAGE MUST TEST TO THE SPECIFIED VOLTAGE RANGE ABOVE. INSTALL 4"x4"x2" JUNCTION BOX BETWEEN HVAC DISCONNECT AND HVAC EQUIPMENT AS SHOWN.

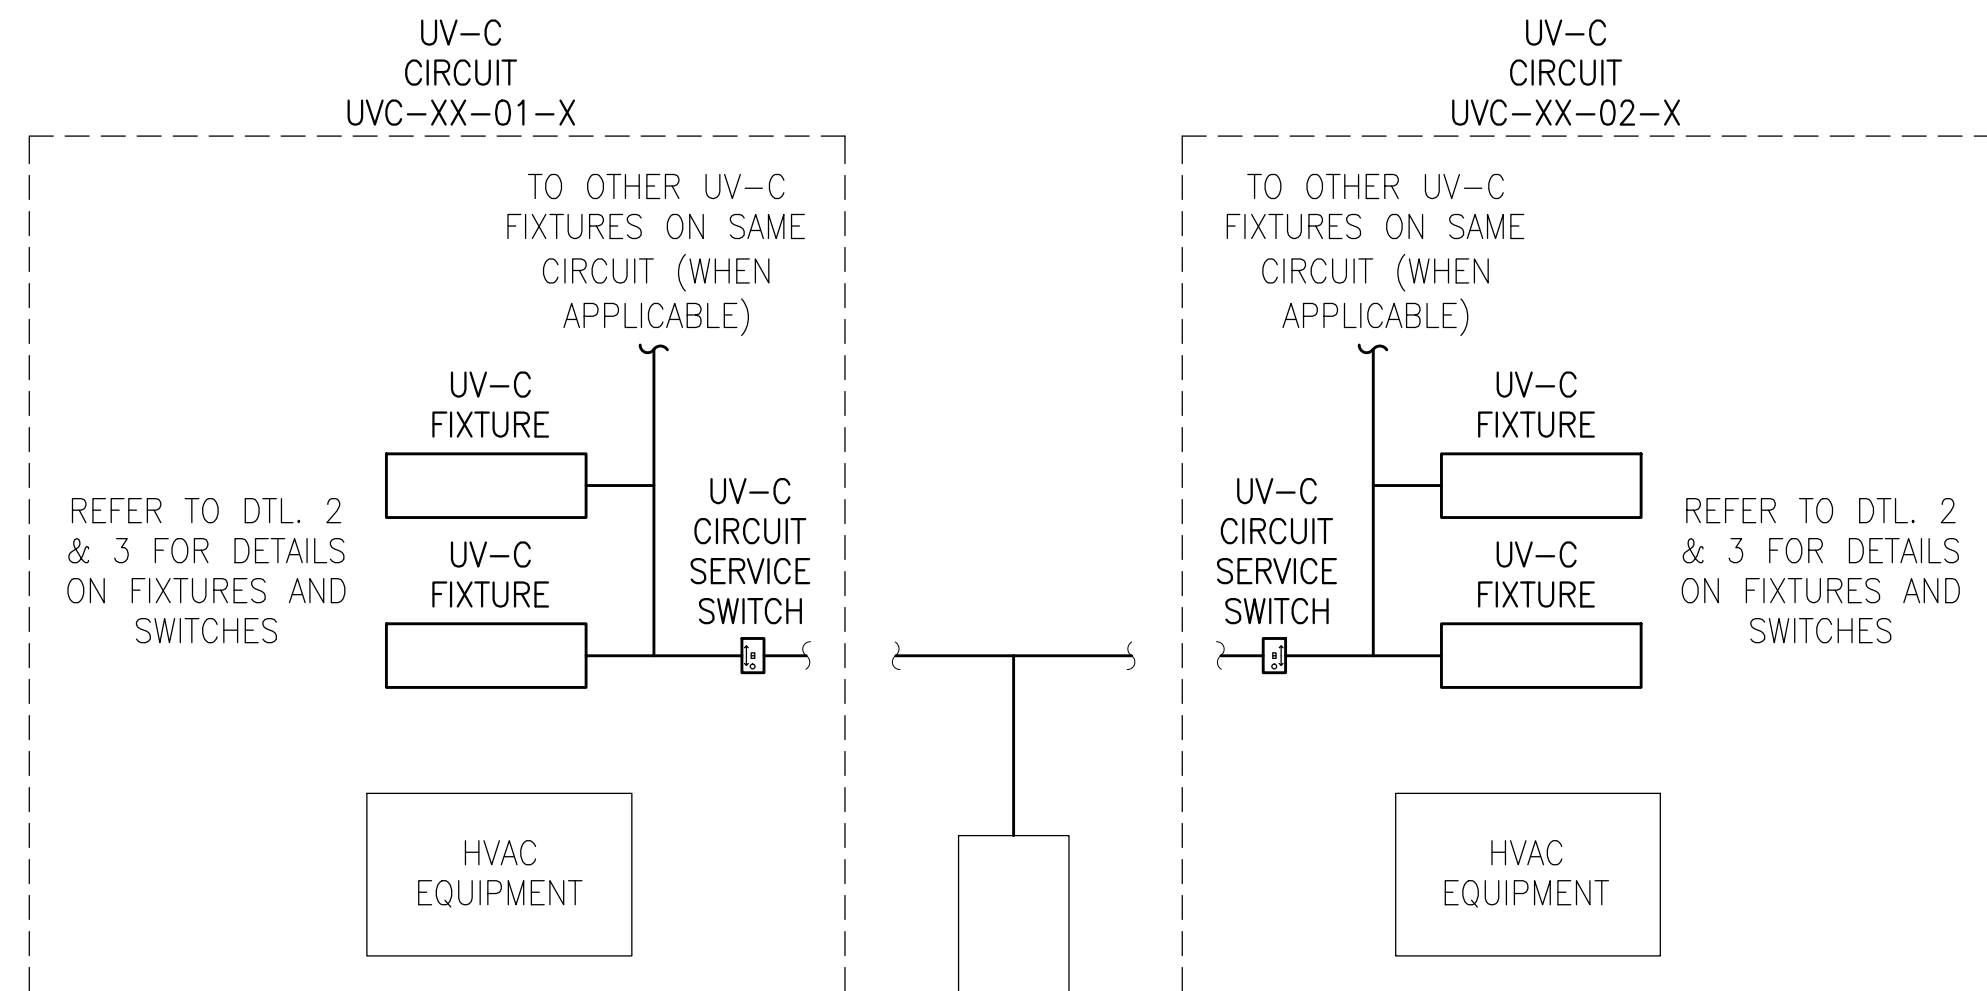

10 UV-C POWER DIAGRAM THREE PHASE W/O NEUTRAL AND/OR 240V-480V  
SCALE: NONE

- NOTES:
- UV-C CIRCUIT MUST BE POWERED FROM AN AVAILABLE NEARBY PANEL IF NEUTRAL IS NOT PRESENT IN HVAC EQUIPMENT POWER CIRCUIT, OR EXCEEDS THE VOLTAGE RANGE NOTED ABOVE. SEE UV-C SCHEDULES FOR PROPOSED POWER SOURCES. DO NOT TAP INTO OTHER UNSPECIFIED EXISTING CIRCUITS. UV-C CIRCUITS TO BE GROUPED TOGETHER WHENEVER FEASIBLE. PROVIDE NEW BREAKER, CLEARLY IDENTIFY ROOM NUMBER, PANEL NAME, AND BREAKER NUMBER AT UV-C FIXTURE SERVICE SWITCH. IDENTIFY NEW CIRCUIT AT PANEL.

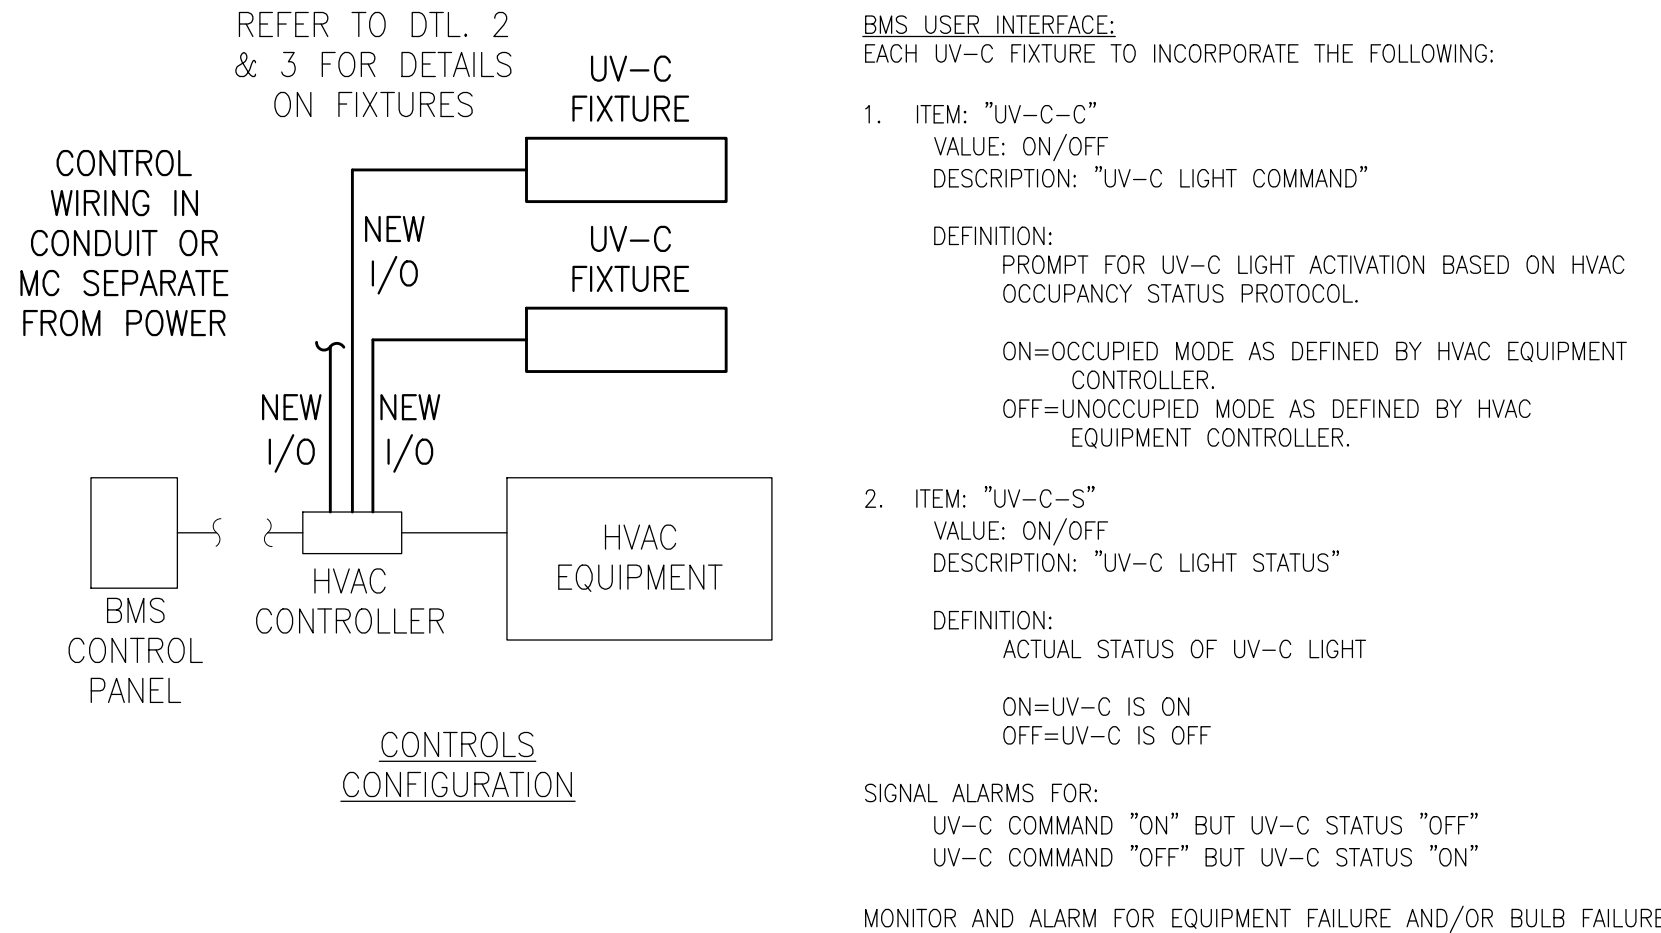

11 UV-C CONTROLS DIAGRAM  
SCALE: NONE

- NOTES:
- UV-C EQUIPMENT SHALL BE INTEGRATED INTO THE EXISTING BMS AS SHOWN. ACTIVATION PROTOCOL SHALL BE BASED UPON THE "UV-C FIXTURE ACTIVATION CONDITIONS" DETAIL.

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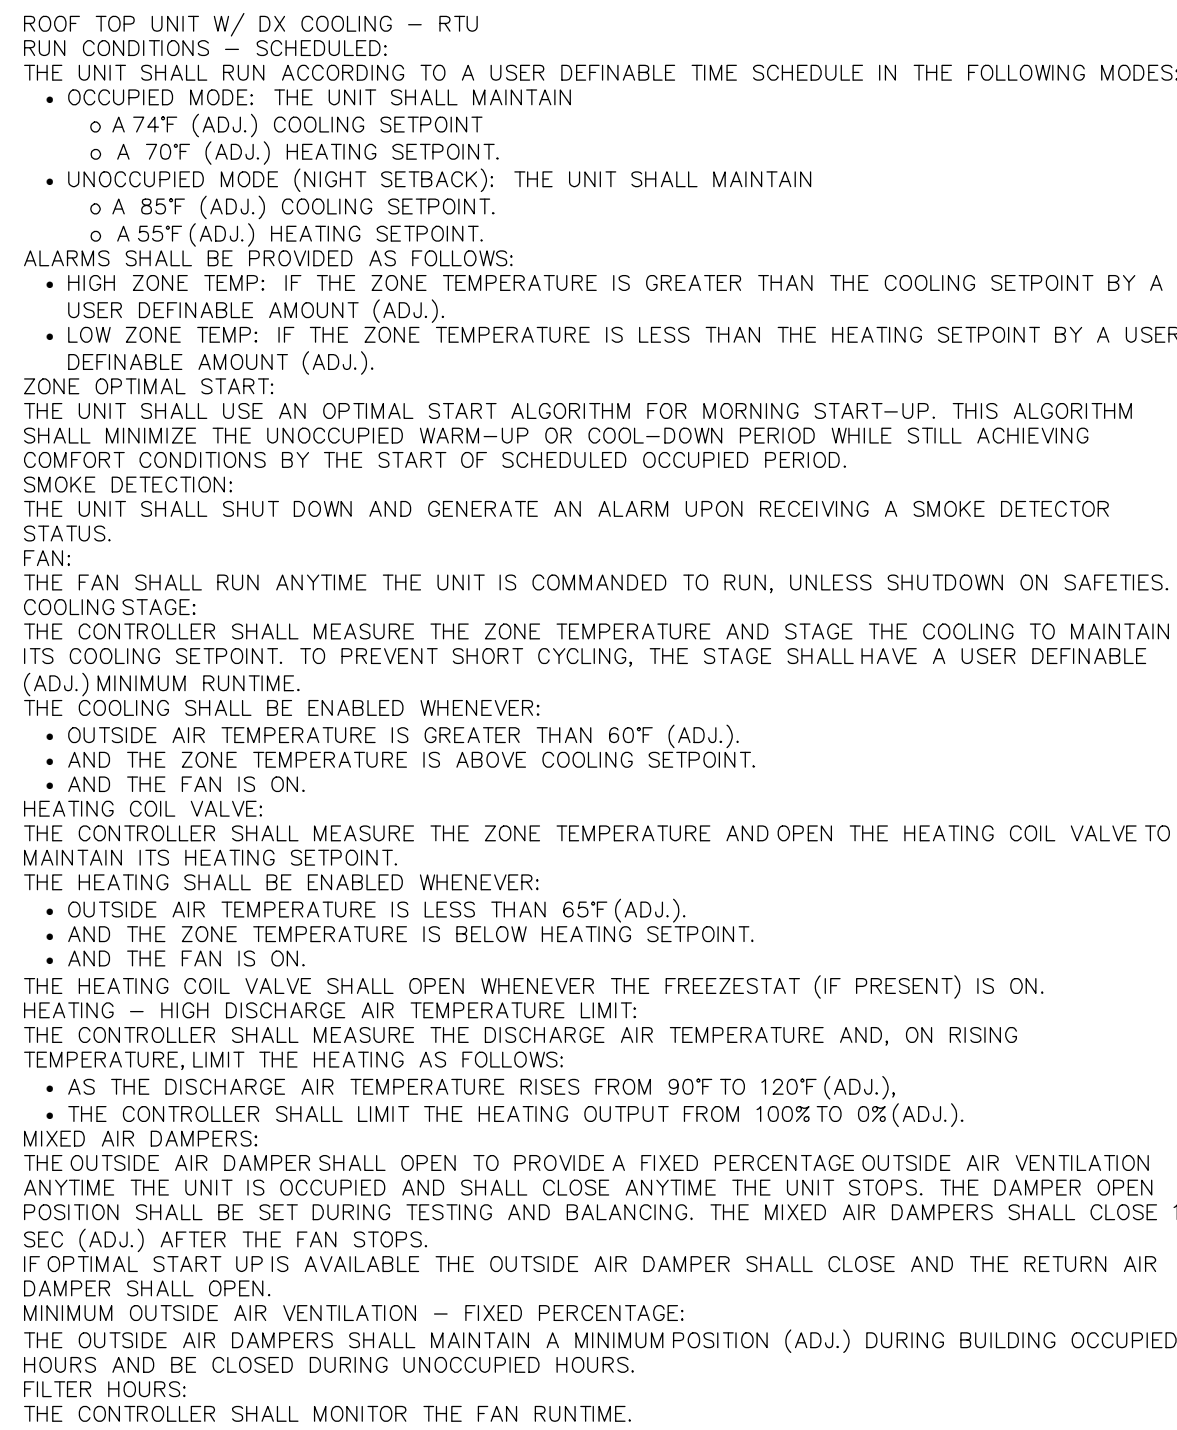
STATE OF NEW YORK  
JAMES J. HARRIS  
REGISTERED PROFESSIONAL ENGINEER  
No. 059446

WARWICK VALLEY CENTRAL SCHOOL DISTRICT  
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SHEET TITLE	UV-C LIGHT FIXTURE DETAILS
SHEET NO.	

M-504







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ALARMS SHALL BE PROVIDED AS FOLLOWS:
CHANGE REQUIRED: FILTER HAS BEEN IN USE FOR MORE THAN 2200
DISCHARGE AIR TEMPERATURE
THE CONTROLLER SHALL MONITOR THE DISCHARGE AIR
ALARMS SHALL BE PROVIDED AS FOLLOWS:
HIGH DISCHARGE AIR TEMP: IF DISCHARGE AIR TEMPERATURE IS GREATER THAN 120°F (ADD).
LOW DISCHARGE AIR TEMP: IF DISCHARGE AIR TEMPERATURE IS LESS THAN 40°F (ADD).
THE CONTROLLER SHALL MONITOR THE FAN STATUS
ALARMS SHALL BE PROVIDED AS FOLLOWS:
FAN FAILURE: COMMAND ON, BUT THE STATUS IS OFF.
FAN IN HAND: COMMAND OFF, BUT THE STATUS IS ON.
FAN RUNTIME EXCEEDED: FAN STATUS RUNTIME EXCEEDS A USER DEFINABLE LIMIT (ADD.).
ENVIRONMENTAL INDEX:
WHEN THE ZONE IS OCCUPIED, THE CONTROLLER WILL MONITOR THE DEVIATION OF THE ZONE TEMPERATURE
FROM THE HEATING OR COOLING SETPOINT AND CALCULATE A 0 – 100% ENVIRONMENTAL INDEX WHICH GIVES AN
INDICATION OF HOW WELL THE ZONE TEMPERATURE IS BEING MAINTAINED. THE ENVIRONMENTAL INDEX IS THE
PERCENTAGE OF TIME SINCE OCCUPANCY BEGAN THAT THE ENVIRONMENTAL INDEX WAS 70% OR HIGHER.


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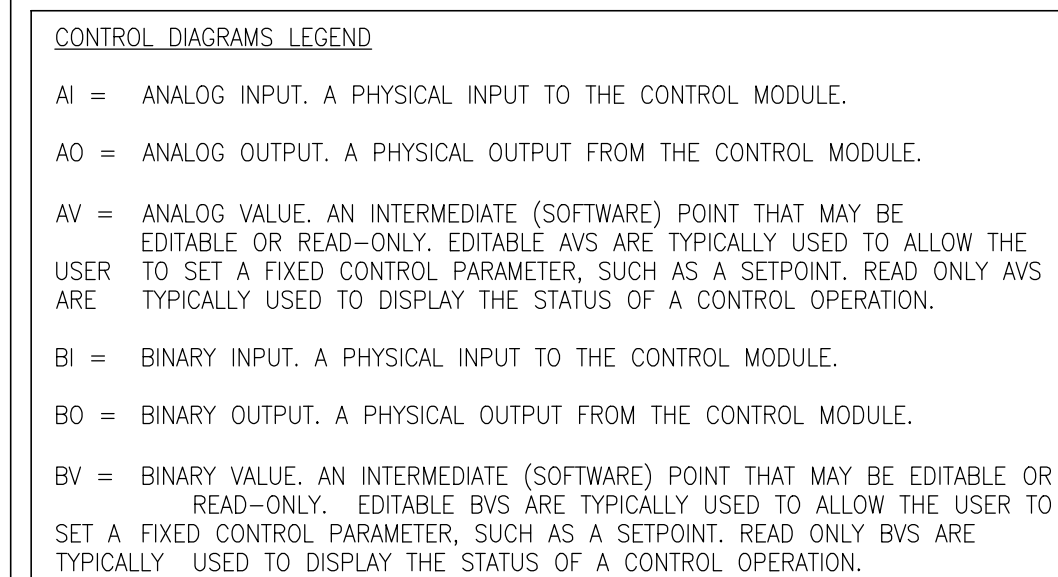
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## SCALE: NONE

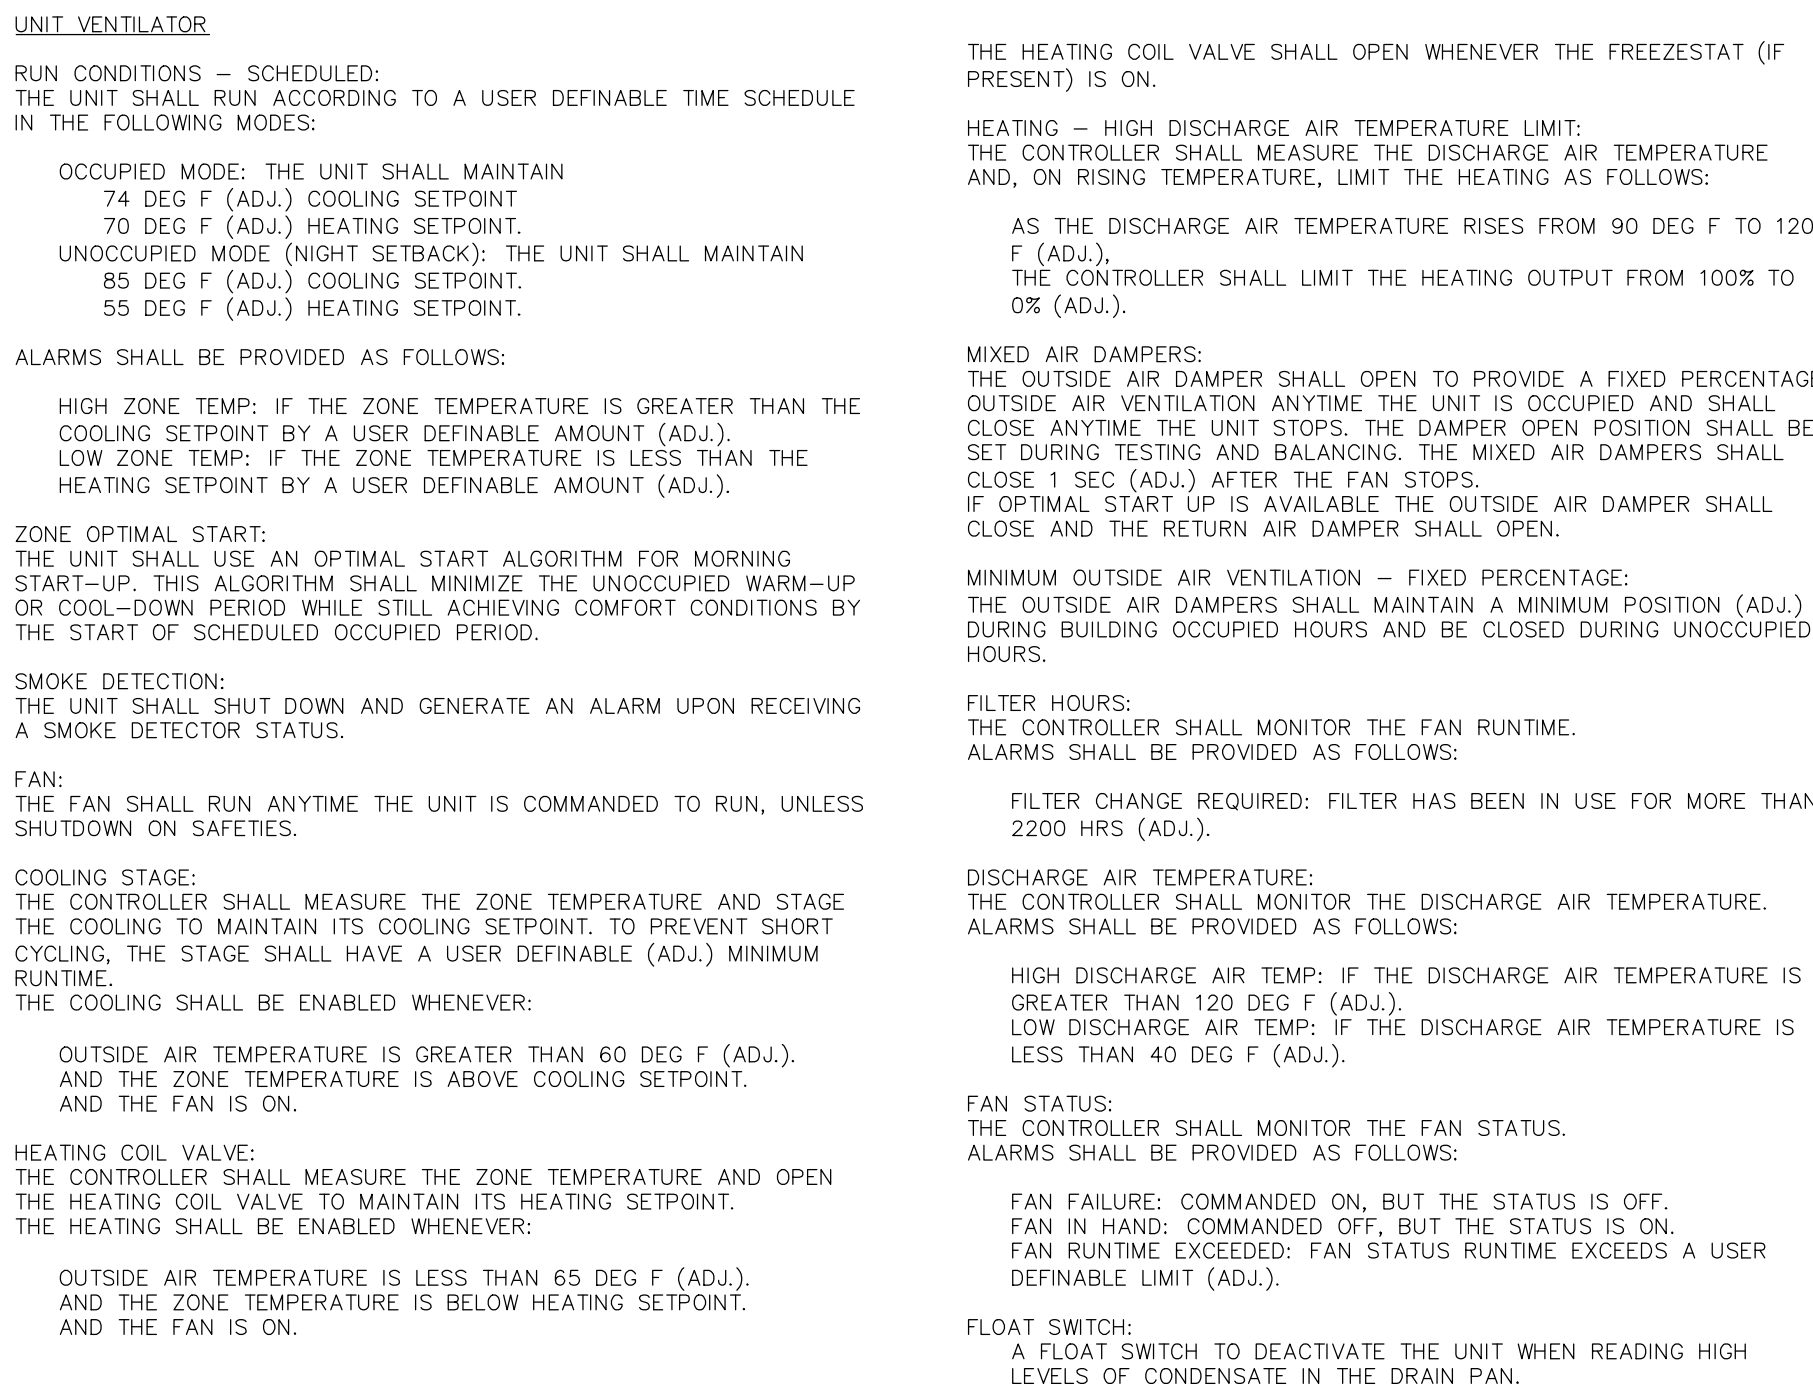

## SCALE: NONE



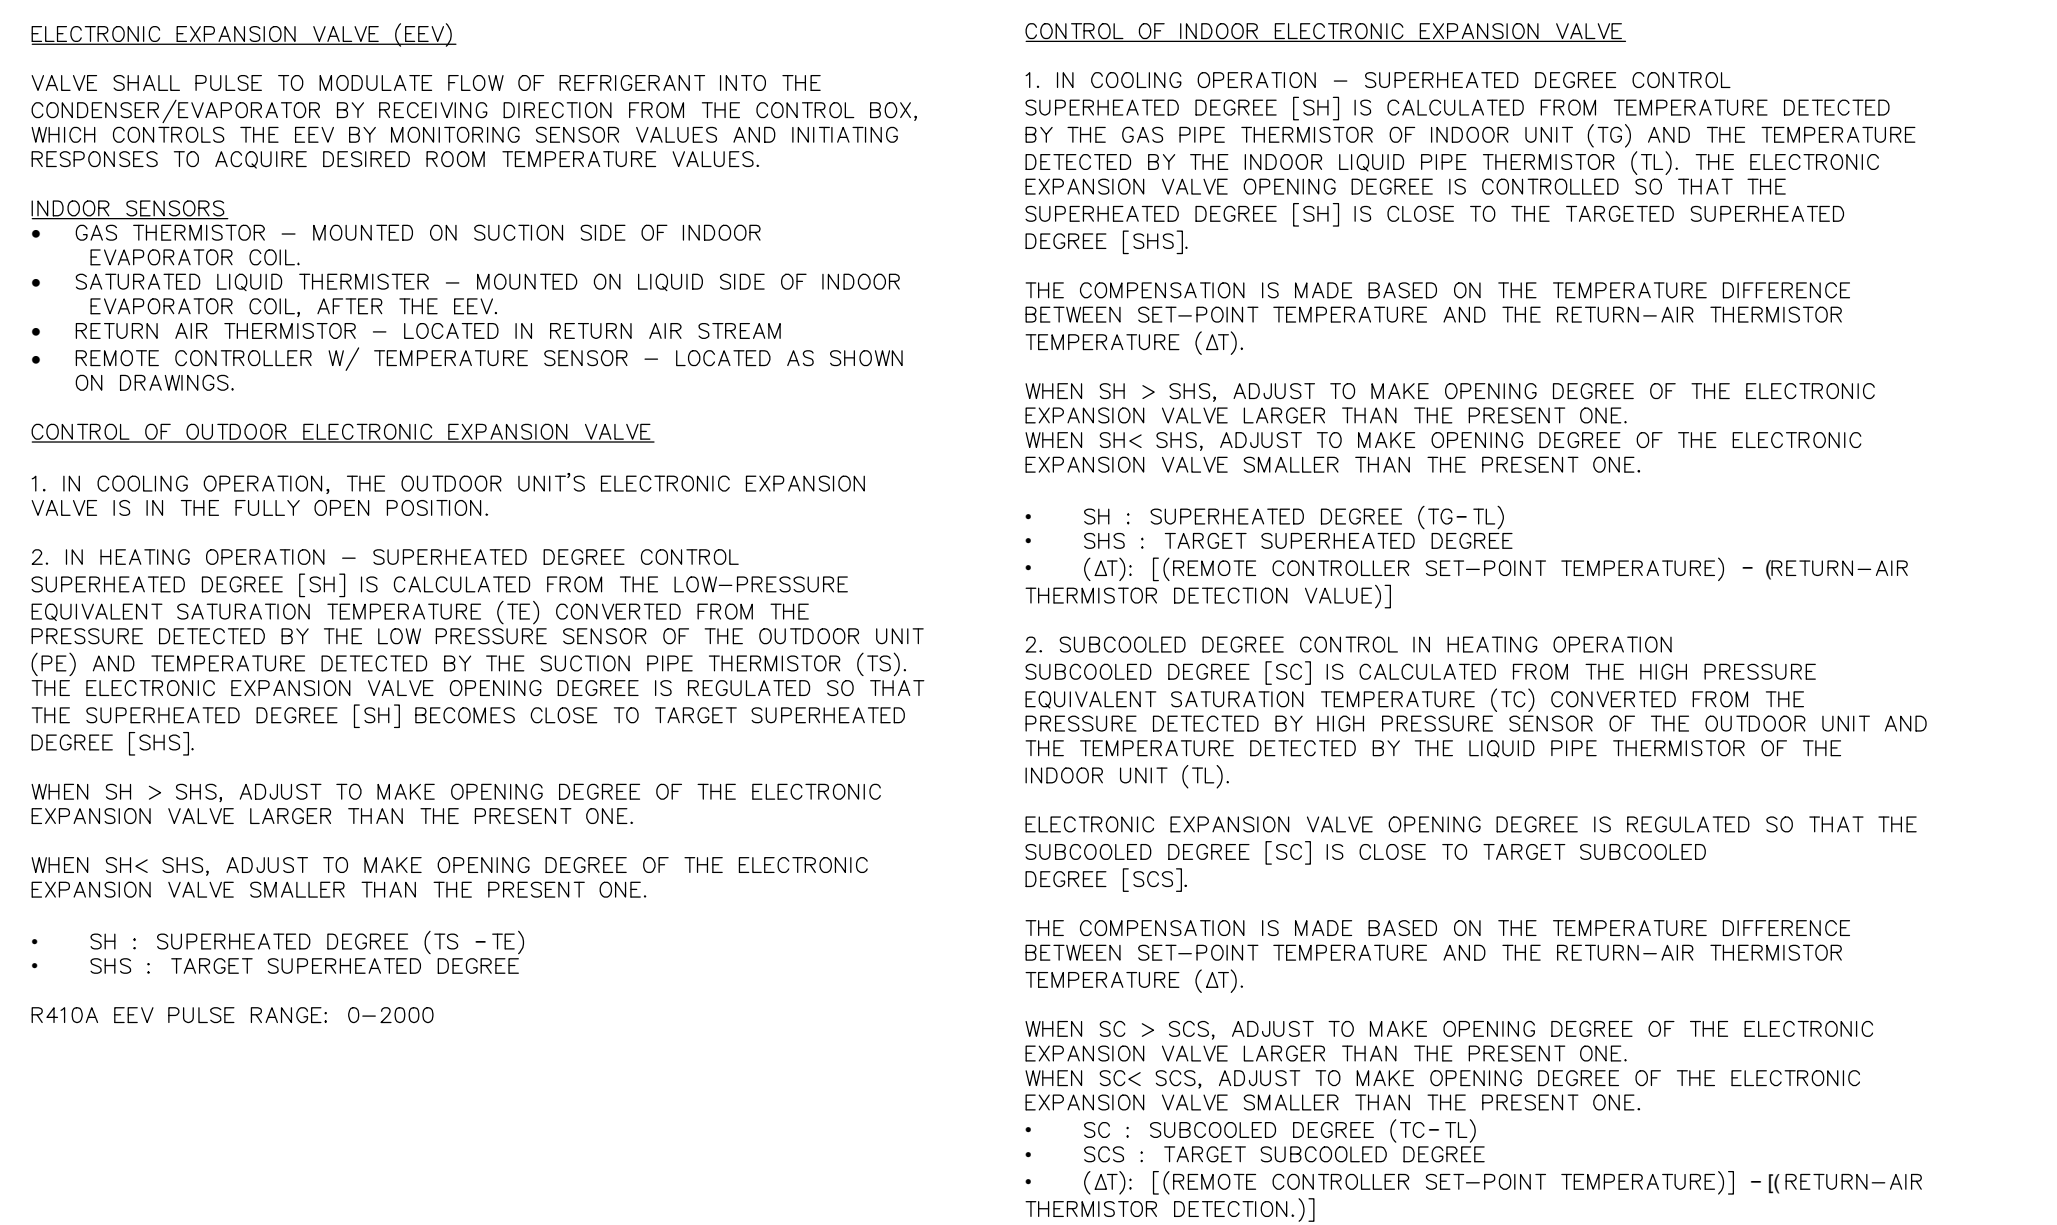

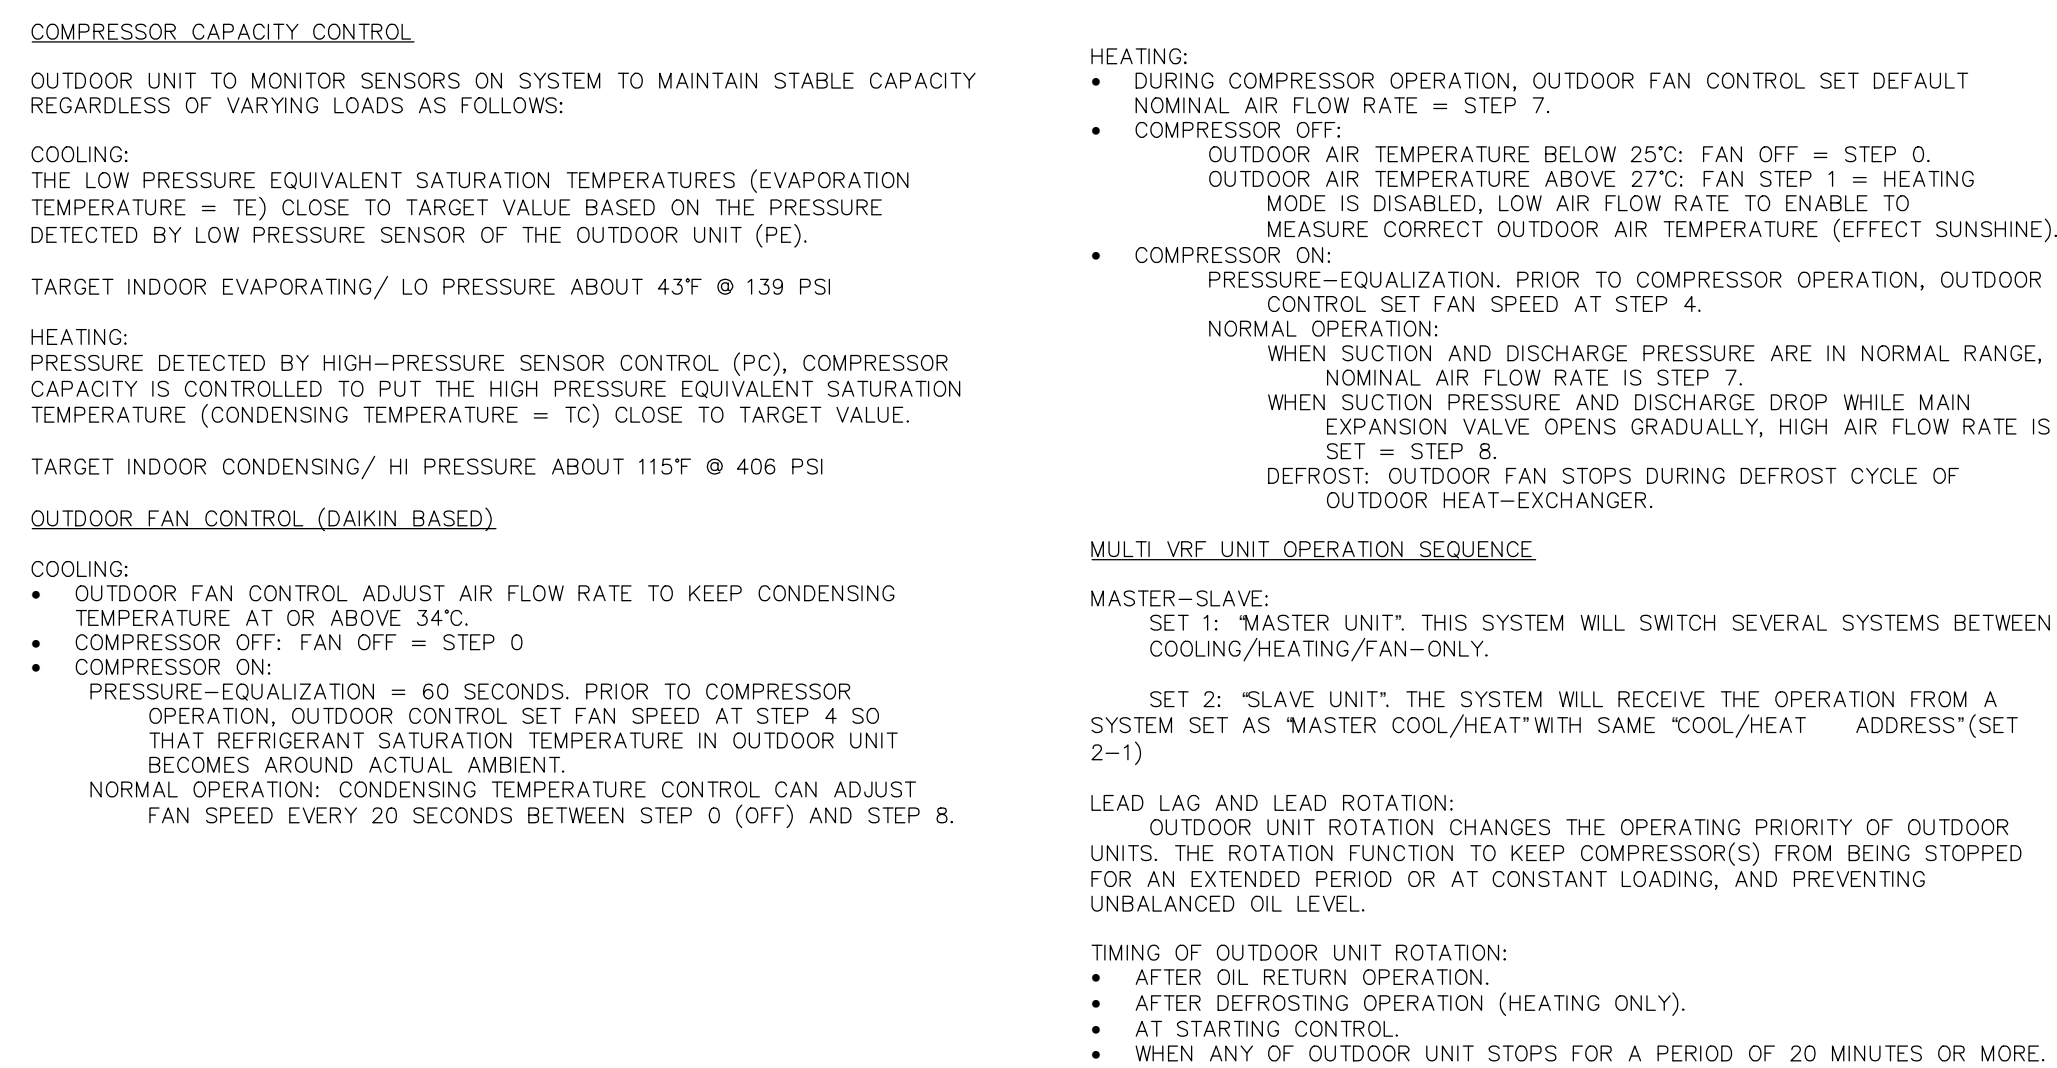GENERAL SYMBOLS:

#

KEYED NOTE

HEAVY LINE-WEIGHT INDICATES TO PROVIDE DEVICES/EQUIPMENT AS NEW

INDICATES DEVICES/EQUIPMENT TO BE REMOVED

INDICATES CONNECTION TO EXISTING

INDICATES POINT OF DISCONNECT

(E)

'(E)' NEXT TO LIGHT LINE-WEIGHT INDICATES EXISTING DEVICES/EQUIPMENT TO REMAIN

(ER)

'(ER)' NEXT TO LIGHT LINE-WEIGHT INDICATES EXISTING DEVICES/EQUIPMENT TO BE REMOVED AND RELOCATED. REFER TO DEFINITIONS FOR INFORMATION

(RE)

'(RE)' NEXT TO LIGHT LINE-WEIGHT INDICATES EXISTING DEVICES/EQUIPMENT TO BE REINSTALLED. REFER TO DEFINITIONS FOR INFORMATION

#####

REMOVALS (EQUIPMENT,CONDUIT,WIRING ETC.)

=====

EXISTING TO REMAIN

=====

NEW WORK

POWER SYMBOLS:

DUPLEX RECEPTACLE

QUAD RECEPTACLE

#

SPECIAL RECEPTACLE (NEMA CONFIGURATION AS INDICATED)

MOTOR CONNECTION (REFER TO EQUIPMENT CONTROL SCHEDULE)

ELECTRICAL CONNECTION

CONTACTOR

JUNCTION BOX

DISCONNECT SWITCH (NON-FUSED)

DISCONNECT SWITCH (FUSED)

PUSH BUTTON

EM

EM - INDICATES EMERGENCY SHUT-OFF

MANUAL MOTOR STARTER

COMBINATION MAGNETIC MOTOR STARTER

VARIABLE FREQUENCY DRIVE

208V PANELBOARD (RECESSED)

208V PANELBOARD (SURFACE)

TELEPHONE/DATA SYMBOLS:

COMMUNICATIONS OUTLET

#D

INDICATES NUMBER OF DATA JACKS

#1

INDICATES NUMBER OF TELEPHONE JACKS

WAP

WAP - WIRELESS ACCESS POINT

PRES

INDICATES PRESENTATION STATION OUTLET

PROJ

INDICATES PROJECTOR STATION OUTLET

ONE-LINE SYMBOLS:

#A

CIRCUIT BREAKER

##A

FUSE

##A

FUSED DISCONNECT SWITCH

GROUND

FOOA.MLCO

PANELBOARD

FIRE ALARM SYMBOLS:

30

AUDIO/VISUAL SIGNALING DEVICE. NUMBER DENOTES CANDELA RATING.

30

VISUAL SIGNALING DEVICE. NUMBER DENOTES CANDELA RATING.

PULL STATION

SMOKE DETECTOR. R SUBSCRIPT: PROVIDE ACCESSORY EQUIPMENT/WIRING/PROGRAMMING FOR ELEVATOR RECALL AND SHUNT TRIP.

HEAT DETECTOR

CONTROL MODULE

MONITOR MODULE

DUCT SMOKE DETECTOR

REMOTE TEST STATION

MAGNETIC DOOR HOLDER

TAMPER SWITCH

FIRE DOOR RELEASE

FLOW SWITCH

FAN SHUT-DOWN

FIRE ALARM CONTROL PANEL

FIRE ALARM ANNUNCIATOR PANEL

CARBON MONOXIDE DETECTOR (ELECTROCHEMICAL STYLE) (SYSTEM SENSOR CO1224TR OR EQUAL) (INSTALL PER MANUFACTURERS RECOMMEND. AND PER NFPA 720)

CARBON DIOXIDE DETECTOR

GAS DETECTOR

SPECIAL SYSTEMS SYMBOLS:

ACCP

AC SYSTEM CONTROL PANEL

ACMS

AC SYSTEM MASTER CONTROL STATION

CR

CARD READER

DC

DOOR CONTACT

REX

ELECTRIC DOOR STRIKE

IC

REQUEST TO EXIT

IC

INTERCOM STATION

C1

CLOCK (NO DESIGNATION DENOTES CLASSROOM CLOCK).

C1

C1 - DENOTES SINGLE FACE HALLWAY CLOCK.

C2

C2 - DENOTES DUAL FACE HALLWAY CLOCK.

PUBLIC ADDRESS SPEAKER (CEILING)

PUBLIC ADDRESS SPEAKER (WALL)

PUBLIC ADDRESS HORN SPEAKER (WALL)

CEILING MOUNTED CCTV CAMERA

WALL MOUNTED CCTV CAMERA

LIGHTING SYMBOLS:

(REFER TO LIGHT FIXTURE SCHEDULE)

o.b.c

INDICATES SWITCH LEG

D

DIMMER SWITCH

K

KEYED

3

3-WAY

4

4-WAY

OCCUPANCY SENSOR

C#

INDICATES CEILING SENSOR TYPE (REFER TO OCCUPANCY SENSOR SCHEDULE)

W#

INDICATES WALL SENSOR TYPE (REFER TO OCCUPANCY SENSOR SCHEDULE).

X#

CEILING-MOUNTED EXIT LIGHT. HATCH MARKS INDICATES ILLUMINATED FACE, ARROW INDICATES DIRECTION OF TRAVEL.

X#

WALL-MOUNTED EXIT LIGHT. HATCH MARKS INDICATES ILLUMINATED FACE, ARROW INDICATES DIRECTION OF TRAVEL.

X#

DUAL HEAD WALL-MOUNTED EMERGENCY BATTERY PACK LUMINAIRE.

X#

SINGLE HEAD WALL-MOUNTED EMERGENCY BATTERY PACK LUMINAIRE.

F#

2'x4' CEILING MOUNTED LIGHT FIXTURE, F# INDICATES TYPE.

F#

2'x2' CEILING MOUNTED LIGHT FIXTURE, F# INDICATES TYPE.

F#

1'x4' CEILING MOUNTED LIGHT FIXTURE, F# INDICATES TYPE.

F#

CEILING MOUNTED DOWNLIGHT FIXTURE, F# INDICATES TYPE.

F#

4' WALL MOUNTED LIGHT FIXTURE, F# INDICATES TYPE.

F#

WALL MOUNTED FIXTURE, F# INDICATES TYPE.

GENERAL DEMOLITION NOTES:

1. DEMOLITION DRAWINGS ARE BASED ON FIELD OBSERVATION. REPORT ANY CONFLICTS TO THE ENGINEER BEFORE DISTURBING EXISTING EQUIPMENT.

2. BEGINNING OF DEMOLITION MEANS THE CONTRACTOR ACCEPTS ALL EXISTING CONDITIONS.

3. VERIFY SCOPE OF WORK: CONTRACTOR SHALL VISIT THE JOB SITE PRIOR TO SUBMITTING A BID TO DETERMINE THE SCOPE OF THE WORK, AND TO BECOME FAMILIAR WITH THE EXISTING CONDITIONS THAT WILL AFFECT THEIR WORK AND, THEREFORE, THEIR BID.

4. UNLESS NOTED OTHERWISE, EXISTING ELECTRICAL EQUIPMENT SHOWN ON THESE PLANS ARE A PART OF CONTRACT. TO MAINTAIN DRAWING CLARITY NOT ALL EXISTING ELECTRICAL EQUIPMENT HAS BEEN SHOWN. FIELD VERIFY EXISTING CONDITIONS AND NOTIFY ARCHITECT/ ENGINEER OF ANY CONFLICTS.

5. UNLESS NOTED OTHERWISE, REMOVE ALL ELECTRICAL ITEMS SHOWN ON THESE PLANS AS INDICATED BY CROSS HATCHED LINES AND/OR KEYED NOTES.

6. UNLESS NOTED OTHERWISE, DEMOLITION OF ELECTRICAL EQUIPMENT/DEVICES INCLUDES REMOVAL OF CIRCUITRY BACK TO ASSOCIATED SOURCE/PANEL. THIS INCLUDES REMOVAL OF THE DEVICE, WIRING, CONDUIT, BOXES, CONTROL DEVICES, ETC.

7. WHERE POSSIBLE, EXISTING CONDUITS/RACEWAYS (ASSOCIATED WITH REMOVED EQUIPMENT AND WIRING) MAY BE RE-USED FOR NEW CIRCUITING. EXISTING CONDUITS/RACEWAYS MUST BE IN GOOD CONDITION, AND IN COMPLIANCE WITH NEC/SPECIFICATION REQUIREMENTS. NOTIFY ENGINEER PRIOR TO REUSING.

8. EXISTING CIRCUIT BREAKERS ASSOCIATED WITH ELECTRICAL EQUIPMENT SCHEDULED FOR DEMOLITION SHALL REMAIN FOR SPARES UNLESS REMOVAL IS REQUIRED TO MAKE ADDITIONAL SPACE (IN EXISTING PANELBOARDS) FOR NEW CIRCUIT BREAKERS.

9. MAINTAIN THE ELECTRICAL INTEGRITY OF ALL EXISTING BRANCH CIRCUITS INTERRUPTED BY REMOVAL WORK. PROVIDE ALL WIRING, CONDUIT, AND HARDWARE REQUIRED TO MAINTAIN CONTINUITY OF ELECTRICAL EQUIPMENT REMAINING ON EXISTING BRANCH CIRCUITS NOT BEING COMPLETELY REMOVED OR OUTSIDE WORK THE WORK AREA.

10. UNLESS NOTED OTHERWISE, REMOVE EXISTING ELECTRICAL DEVICES, AND ASSOCIATED CIRCUITRY, LOCATED ON OR IN WALLS SCHEDULED FOR REMOVAL. REFER TO ARCHITECTURAL DRAWINGS FOR DEMOLITION COORDINATION.

11. UNLESS NOTED OTHERWISE, REMOVE EXISTING ELECTRICAL DEVICES, AND ASSOCIATED CIRCUITRY, LOCATED ON OR IN CEILINGS SCHEDULED FOR REMOVAL. TO MAINTAIN DRAWING CLARITY, EXISTING CEILINGS SCHEDULED FOR DEMOLITION HAVE NOT BEEN IDENTIFIED ON THIS DRAWING. REFER TO ARCHITECTURAL DRAWINGS FOR DEMOLITION COORDINATION.

12. WHERE REMOVALS OCCUR ON SERVICES THAT ARE TO REMAIN IN OPERATION, CAP OR OTHERWISE TERMINATE THE REMAINING SERVICES BENEATH FINISHED SURFACES.

13. ALL CONDUITS STUBBED THRU FLOOR SERVING ITEMS TO BE REMOVED, AND NOT SHOWN OR REQUIRED TO BE REUSED, SHALL BE CUT OFF FLUSH, SLAB LEVEL WITH CONCRETE.

14. PORTIONS OF FEEDERS RISERS WHICH REQUIRE REMOVAL DUE TO DEMOLITION WORK, BUT WHICH ARE REQUIRED TO REMAIN ENERGIZED, SHALL BE CUT AT ACCESSIBLE LOCATIONS, REROUTED AND RECONNECTED. EXTEND EXISTING FEEDERS AS REQUIRED. MATCH EXISTING FEEDERS IN CONDUCTOR SIZE (AMPACITY RATING), RACEWAY SIZE, ETC.

15. CAREFULLY REMOVE, PROTECT AND STORE ALL EQUIPMENT TO BE REUSED IN A SAFE PLACE UNTIL READY FOR REINSTALLATION. CLEAN MATERIALS BEFORE REINSTALLATION AND ENSURE EQUIPMENT IS STILL FULLY OPERATIONAL.

16. THE CONTRACTOR IS RESPONSIBLE FOR REMOVAL OR RELOCATION OF ITEMS; NOT SHOWN ON THESE DRAWINGS TO ACCOMMODATE THE RENOVATIONS. CONTRACTOR SHALL INCLUDE, IN BASE BID, AN ALLOWANCE FOR UNFORESEEN CONDITIONS WHEN CONCEALED WORK IS EXPOSED. CLAIMS FOR ADDITIONAL DEMOLITION WORK WILL NOT BE ACCEPTED EXCEPT FOR CERTAIN CASES CONSIDERED JUSTIFIABLE BY THE ARCHITECT/ENGINEER.

FIRE ALARM NOTES:

1. CONTRACTOR SHALL VERIFY AND COORDINATE WITH THE BUILDING FIRE ALARM MAINTENANCE VENDOR FOR TYPE OF FIRE ALARM DEVICES TO BE USED.

2. CONTRACTOR SHALL BE RESPONSIBLE TO RETAIN AND COORDINATE THE BUILDING FIRE ALARM MAINTENANCE VENDOR FOR PROGRAMMING AND FINAL CONNECTIONS. CONTRACTOR SHALL INCLUDE PROGRAMMING AND FINAL CONNECTION COSTS IN THEIR BID.

3. FIRE ALARM WIRING DIAGRAMS SHOWN ARE GENERAL ARRANGEMENTS ONLY. OBTAINED PRIOR TO THE COMMENCEMENT OF THE WORK. ALL PERMIT COSTS AND INSPECTION FEES SHALL BE INCLUDED AS PART OF THIS CONTRACT.

4. PERMITS AND APPROVALS NECESSARY FOR INSTALLATION OF WORK SHALL BE OBTAINED PRIOR TO THE COMMENCEMENT OF THE WORK. ALL PERMIT COSTS AND INSPECTION FEES SHALL BE INCLUDED AS PART OF THIS CONTRACT.

5. CONTRACTOR SHALL BE RESPONSIBLE TO MAINTAIN AND PROTECT FIRE ALARM NOTIFICATION DEVICES, SMOKE DETECTORS AND OTHER FIRE ALARM SAFETY DEVICES IN OPERATION AT ALL TIMES. IF ANY PORTION OF FIRE ALARM SYSTEM IS DISABLED, NOTIFY BUILDING CUSTODIAN IMMEDIATELY.

6. IN AREAS WHERE DUST AND DIRT WILL BE AIRBOURNE DURING DEMOLITION AND CONSTRUCTION THE CONTRACTOR SHALL PROVIDE PLASTIC WRAP/POWERS SMOKE DETECTORS AND THEN REMOVE ONCE SPACE IS CLEAR. IF A FIRE ALARM DEVICE IS LOCATED ON A WALL OR CEILING TO BE REMOVED, UNLESS OTHERWISE INDICATED THE DEVICE SHALL BE REMOVED AND STORED. ONCE CONSTRUCTION IS COMPLETE THE DEVICE SHALL BE REINSTALLED IN ITS ORIGINAL LOCATION OR AS CLOSE TO ITS ORIGINAL LOCATION AS FEASIBLE. REUSE EXISTING WIRING IF POSSIBLE, PROVIDE NEW WIRING IF NECESSARY.

7. UNLESS DIRECTED OTHERWISE BY FIRE ALARM SYSTEM MANUFACTURER FIRE ALARM DEVICE WIRING SHALL BE AS FOLLOWS (FOR BIDDING PURPOSES ONLY)  
SIGNAL WIRING - #14 AWG TWISTED/SHEILD  
BELL WIRING - #14 AWG TWISTED CABLE  
STROBE WIRING - #14 TWISTED CABLE  
THE WIRING SHALL HAVE THE FOLLOWING CHARACTERISTICS:  
A. A MINIMUM TEMPERATURE RATING 150 C  
B. A MINIMUM AVERAGE INSULATION THICKNESS OF 15 MILS  
C. A MINIMUM AVERAGE JACKET THICKNESS OF 25 MILS  
D. THE COLOR OF THE CABLE SHALL BE RED  
E. THE CABLE SHALL BE A TYPE FPLP (PLENUM TYPE) WHEN CONDUIT IS USED TO PURCHASING  
F. THE CABLE SHALL BE VISIBLY MARKED EXTERNALLY THAT IT MEETS THE ABOVE REQUIREMENTS AND IS LISTED BY UL.CONFIRM WIRING TYPE AND QUANTITY WITH FIRE ALARM SYSTEM MANUFACTURER PRIOR.

8. PROVIDE MC FIRE ALARM CABLE WITH RED STRIPE AS MANUFACTURED BY AFC SERIES 1800 WHEN CABLE IS CONCEALED OR ABOVE HUNG CEILING. WHEN FIRE ALARM CABLE IS RUN EXPOSED IN FINISHED AREAS, CABLE SHALL RUN IN WIREMOLD V-700. WHEN FIRE ALARM CABLE IS RUN EXPOSED IN UNFINISHED AREAS, PROVIDE PLENUM RATED CABLE IN MIN. 1/2" CONDUIT.

9. STROBES SHALL HAVE A MINIMUM LIGHT OUTPUT OF 75 CANDELA AND A FLASH-RATE OF 1-3 HZ.

10. SHUTDOWN OF HVAC SYSTEM EQUIPMENT (NOT LIMITED TO, ROOF TOP, 10. EXHAUST FANS, ETC.) OF 1000 CFM OR GREATER, SHALL BE PERFORMED VIA A RELAY INTERFACE SYSTEM. SEND SIGNAL TO BUILDING AUTOMATED TEMPERATURE CONTROL (ATC) SYSTEM INDICATING SHUTDOWN HAS OCCURED. EQUIPMENT RESTART SHALL BE BY BUILDING ATC SYSTEM UPON FIRE ALARM RESET TO NORMAL MODE. RESTART OF EQUIPMENT SHALL BE SEQUENTIAL.

11. AFTER THE SYSTEM MODIFICATIONS ARE COMPLETE TEST ALL COMPONENTS IN ACCORDANCE WITH SEQUENCE OF OPERATION PRIOR TO FIRE DEPARTMENT INSPECTION.

12. A CARBON MONOXIDE DETECTORS SHALL BE PROVIDED IN ALL BOILER ROOMS. ACTIVATION INITIATE A SUPERVISORY SIGNAL AT THE FIRE ALARM CONTROL PANEL AND ANNUNCIATOR PANEL WHEN 70 PPM ARE REACHED WITHIN 60-240 MINUTES OR 150 PPM ARE REACHED WITHIN 10-50 PER UL 2034.

GENERAL NEW WORK NOTES:

1. UNLESS NOTED AS EXISTING OR PROVIDED BY OTHERS, CONTRACTOR SHALL PROVIDE ALL MATERIALS SHOWN ON DRAWINGS. ALL MATERIALS PROVIDED SHALL BE NEW, UNUSED CONDITION.

2. ALL WORK PERFORMED UNDER THIS CONTRACT SHALL BE PROVIDED WITH MINIMUM DISRUPTION TO THE BUILDING SYSTEMS AND STAFF. CONTINUOUS OPERATION OF THE BUILDING SYSTEMS, OUTSIDE OF WORK AREA, SHALL BE MAINTAINED THROUGHOUT THE ENTIRE PROJECT. TEMPORARY SHUTDOWN OF SYSTEMS SHALL ONLY BE ALLOWED WITH WRITTEN CONSENT OF THE OWNER. EXISTING ALARM AND EMERGENCY SYSTEMS SHALL NOT BE DISRUPTED AT ANY TIME DURING THE PROJECT.

3. REMOVE & REINSTALL EXISTING CONSTRUCTION (CEILINGS, LIGHTING, ELECTRICAL EQUIPMENT, FIRE ALARM DEVICES, FURNISHINGS, ETC.) AS NECESSARY TO COMPLETE THE REMOVALS & RENOVATION WORK REQUIRED BY THE DRAWINGS & SPECIFICATIONS. REPLACE ANY ITEMS DAMAGED BY OR DUE TO THIS REMOVAL & REINSTALLATION WITH NEW ITEMS TO MATCH EXISTING. (APPLIES TO AREAS WITHIN & OUTSIDE OF THE PROJECT AREA).

4. IN AREAS WHERE CEILING IS BEING REMOVED, EXISTING CONDUITS AND CABLING WHICH ARE NOT INDEPENDENTLY SUPPORTED ABOVE THE CEILING SHALL BE INDEPENDENTLY SUPPORTED FROM THE STRUCTURE ABOVE USING SPECIFIC METHODS.

5. SURFACE MOUNT ALL WIRING DEVICES, LIGHTING CONTROLS, TELECOMMUNICATION DEVICES, FIRE ALARM DEVICES, ETC. LOCATED ON EXISTING MASONRY WALLS. PROVIDE SURFACE MOUNTED BOXES, RACEWAYS, WIREMOLD, ETC. PER SPECIFICATIONS.

6. COVERS ASSOCIATED WITH JUNCTION AND PULL BOXES SHALL BE READILY ACCESSIBLE.

7. PROVIDE PULL BOXES WHERE REQUIRED BY CODE AND WHERE NECESSARY FOR CONDUCTOR INSTALLATION. PROVIDE PULL BOXES EVERY 100' FOR ALL EMPTY RACEWAY RUNS. PRIOR TO INSTALLATION OF PULL BOXES, COORDINATE WITH OTHER TRADES.

8. PROVIDE SEPARATE RACEWAYS AND BOXES FOR CONDUCTORS OF NORMAL AND EMERGENCY CIRCUITS.

9. DO NOT COMBINE MORE THAN THREE PHASE CONDUCTORS, THREE NEUTRAL CONDUCTORS PLUS THREE GROUND CONDUCTORS, IN ANY ONE BRANCH CIRCUIT CONDUIT, UNLESS OTHERWISE INDICATED ON DRAWINGS.

10. THE USE OF NON-METALLIC SURFACE RACEWAY OR EXPOSED NON-METALLIC RACEWAY IN ASSEMBLY SPACES AND MEANS OF EGRESS AREAS IS PROHIBITED.

11. THE USE OF SHARED NEUTRALS IN LIGHTING AND RECEPTACLE BRANCH CIRCUITS IS PROHIBITED. PROVIDE SEPARATE NEUTRAL AND GROUND FOR EVERY CIRCUIT.

12. PROTECT EXISTING SURFACES.

13. WALK-THRU WITH OWNER REPRESENTATIVE AND VERIFY ALL ELECTRICAL DEVICE LOCATIONS PRIOR TO INSTALLATION.

14. INSTALL ALL CIRCUITRY PARALLEL OR PERPENDICULAR TO WALLS, FLOOR, AND CEILING.

15. REFER TO ELECTRICAL EQUIPMENT AND CONTROL SCHEDULE FOR HVAC/PLUMBING EQUIPMENT CIRCUITRY, CONTROLS & ADDITIONAL INFORMATION.

16. TO MAINTAIN DRAWING CLARITY, MOTOR CONTROL DEVICES, FOR HVAC/PLUMBING EQUIPMENT, HAVE NOT BEEN SHOWN. REFER TO ELECTRICAL EQUIPMENT & CONTROL SCHEDULE FOR TYPES OF MOTOR CONTROL DEVICES REQUIRED, LOCATIONS WHERE CONTROL DEVICES ARE SCHEDULED FOR INSTALLATION, AND ADDITIONAL INFORMATION.

17. COORDINATE LOCATIONS AND MOUNTING HEIGHTS OF ELECTRICAL EQUIPMENT/DEVICES WITH ARCHITECTURAL PLANS, ELEVATIONS, FURNITURE LAYOUTS, AND WITH OTHER DIVISIONS PRIOR TO INSTALLATION. CORRECT ANY INACCURACY RESULTING FROM FAILURE TO DO SO WITHOUT COST TO OWNER.

18. THE CONTRACTOR IS RESPONSIBLE FOR PROVIDING ALL SUPPORT HARDWARE FOR SECURELY FASTENING THE ELECTRICAL CONTROL DEVICES AND ENCLOSURES TO THE BUILDING STRUCTURE. THE PROVIDED HARDWARE INCLUDES, BUT IS NOT LIMITED TO, INTERMEDIATE STEEL ANGLE, UNISTRUCT, FASTENERS, JOISTS CLAMPS, ETC. MOUNT STARTERS, VFD'S, DISCONNECTS, RELAYS, AND OTHER ELECTRICAL CONTROL DEVICES AND ENCLOSURES AT LOCATION(S) INDICATED IN ELECTRIC EQUIPMENT & CONTROL SCHEDULE(S). ALLOW MAINTENANCE ACCESS AND SERVICE SPACE AT EACH LOCATION.

19. WHERE NEW CIRCUIT BREAKERS ARE REQUIRED FOR INSTALLATION IN EXISTING ELECTRICAL PANELS, CONTRACTOR SHALL PROVIDE CIRCUIT BREAKERS WHICH ARE COMPATIBLE WITH EXISTING ELECTRICAL PANELS. MATCH FRAME SIZES, KIAC RATINGS, ETC.

20. UPON COMPLETION OF THIS PROJECT, THE CONTRACTOR SHALL PROVIDE COMPLETE, TYPE-WRITTEN, AND UP-TO-DATE PANELBOARD DIRECTORIES FOR ALL PANELBOARDS (NEW AND EXISTING) AFFECTED BY THIS PROJECT. PROVIDE OWNER WITH TWO COPIES OF UPDATED PANELBOARD CIRCUIT BREAKER DIRECTORIES.

21. EACH RECEPTACLE, SWITCH AND JUNCTION BOX, PROVIDED, OR ALTERED, UNDER THIS CONTRACT, SHALL BE LABELED WITH THE CORRESPONDING POWER PANEL NAME AND CIRCUIT BREAKER NUMBER. ALL LABELING SHALL BE TYPEWRITTEN USING A LABEL MAKER AND SHALL BE PERMANENTLY AFFIXED TO EACH RECEPTACLE. HANDWRITTEN LABELS WILL NOT BE ACCEPTED. PRIOR TO START OF LABELING, MEET WITH OWNER TO DETERMINE LABELING SCHEME TO BE UTILIZED. PROVIDE LABELING TO MEET OWNER REQUIREMENTS.

22. ALL ITEMS THAT REQUIRE ACCESS, SUCH AS FOR OPERATING, CLEANING, SERVICING, MAINTENANCE, AND CALIBRATION, SHALL BE EASILY AND SAFELY ACCESSIBLE BY PERSONS STANDING AT FLOOR LEVEL, OR STANDING ON PERMANENT PLATFORMS, WITHOUT THE USE OF PORTABLE LADDERS. EXAMPLES OF THESE ITEMS INCLUDE, BUT ARE NOT LIMITED TO: ALL TYPES OF SWITCHES, PANELBOARDS, OCCUPANCY SENSORS, CONTROL DEVICES, ETC.. PRIOR TO COMMENCING INSTALLATION WORK, REFER CONFLICTS BETWEEN THIS REQUIREMENT AND CONTRACT DRAWINGS TO OWNER FOR RESOLUTION.

23. CLEANING DURING ELECTRICAL WORK: THE MECHANICAL ROOM AND ROOMS WHERE WORK WILL BE DONE TO MINIMIZE DISTURBANCE IN THE BUILDINGS. WORKERS ARE TO USE PATHWAYS AND FACILITIES AGREED UPON WITH THE DISTRICT DESIGNEE IN WRITING. THE AREA OUTSIDE THE BUILDING WHERE CUTTING WELDING OR STORAGE IS ALLOWED IS TO BE FENCED AT ALL TIMES. THE CONTRACTOR WILL ON A DAILY BASIS CLEAN THE GROUNDS AND THE BUILDING OF ANY DEBRIS OR GARBAGE GENERATED BY THEIR WORK.

24. EACH CONTRACTOR RESPONSIBLE FOR RETURNING WALLS, CEILINGS AND SURFACES THEY DISTURB THAT ARE NOT SCHEDULED FOR REPLACEMENT BACK TO ORIGINAL CONDITIONS.

GENERAL WORK NOTES:

ALL WORK IN ELECTRICAL DRAWINGS, UNLESS OTHERWISE NOTED, IS ENTIRELY PROVIDED BY THE DISTRICT.

ABBREVIATIONS

EX-- EXISTING

A-- AMPERE

NF-- NON-FUSED

EXT-- EXTERIOR

AC-- ABOVE, COUNTER

NC-- NOT IN CONTRACT

FA-- FIRE ALARM

AFT-- ABOVE FINISHED FLOOR

NL-- NIGHT LIGHT

NTS-- NOT TO SCALE

FL-- FLOOR

AHU-- AIR HANDLING UNIT

ON-- ON CENTER

FLA-- FULL LOAD AMPS

A/V-- AUDIO/VISUAL

P-- POLE

FLUOR-- FLUORESCENT

AWG-- AMERICAN WIRE GAUGE

PNL-- PANEL

GC-- GENERAL CONTRACTOR

AU-- AT UNIT

PRI-- PRIMARY

GF-- GROUND FAULT CIRCUIT

BKR-- BREAKER

SEC-- SECONDARY

C-- CONDUIT

GND-- GROUND

SW-- SWITCH

CB-- CIRCUIT BREAKER

HP-- HORSEPOWER

TEL-- TELEPHONE

OKT-- CIRCUIT

HVAC-- HEATING VENTILATION & AIR CONDITIONING

TV-- TELEVISION

CLG-- CEILING

TYP-- TYPICAL

DEMO-- DEMOLISH/DEMOLITION

KVA-- KILOVOLT AMPS

UGE-- UNDERGROUND ELECTRIC

DTL-- DETAIL

KW-- KILOWATTS

UNO-- UNLESS NOTED OTHERWISE

DWG-- DRAWING

LTO-- LIGHTING

EA-- EACH

MC-- MECHANICAL CONTRACTOR

EC-- ELECTRICAL CONTRACTOR

MCA-- MINIMUM CIRCUIT AMPS

WG-- WIRE GUARD

EF-- EXHAUST FAN

MCB-- MAIN CIRCUIT BREAKER

WP-- WEATHERPROOF

EM-- EMERGENCY

MOP-- MAIN DISTRIBUTION PANEL

XFMR-- TRANSFORMER

EC-- ELECTRICAL CONTRACTOR

MC-- MECHANICAL CONTRACTOR

PC-- PLUMBING CONTRACTOR

NOTE: ABBREVIATIONS MAY OR MAY NOT USE PERIODS, EXAMPLE A.F.F. OR AFF

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IT IS A VIOLATION OF THE LAW FOR ANY PERSON UNLESS HE IS ACTUALLY UNDER THE DIRECTION OF A LICENSED PROFESSIONAL ARCHITECT TO PREPARE OR TO ALLOW ANY OTHER PERSON TO PREPARE ANY ARCHITECTURAL DRAWING OR PLAN WITHOUT HIS SIGNATURE AND SEAL.

DATE: 01/06/2010

STAMP

STATE OF NEW YORK

PROFESSIONAL ENGINEER

NO. 050446

WARWICK VALLEY CENTRAL SCHOOL DISTRICT

HIGH SCHOOL UNIT VENTILATOR REPLACEMENT AND

AIR CONDITIONING UPGRADE

225 WEST STREET EXT. WARWICK, NY 10990

WV HIGH SCHOOL - 89 SANFORDVILLE ROAD, WARWICK, NY 10990

SED NO. 44-21-01-06-0-001-042

PROJECT NO.

05-21-04

05-20-06

ISSUED FOR BID

11.09.2022

SED SET

10.19.2022

REVISION

DATE

DRAWN BY

CHECKED BY

SHEET SIZE

30" X 42"

SCALE


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SHEET TITLE

ABBREVIATIONS AND SYMBOLS


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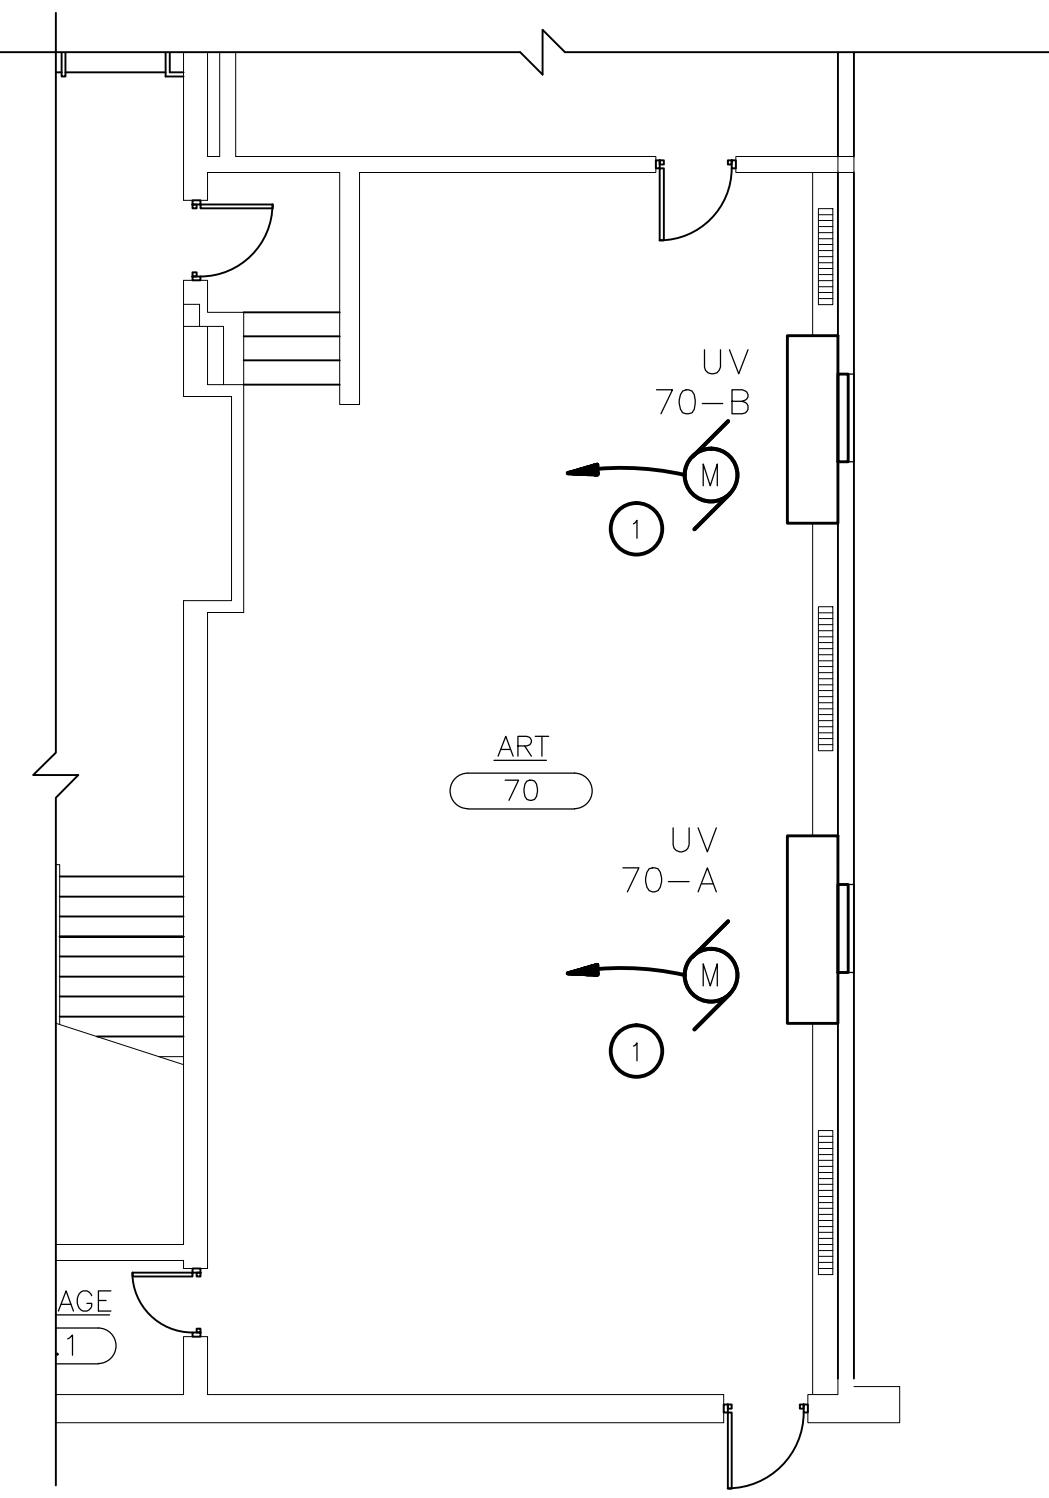


2 PARTIAL FIRST FLOOR PLAN - DEMO & NEW WORK  
SCALE: 1/8"=1'-0"


- KEYED NOTES - NEW WORK:
- 1 PROVIDE DISCONNECTION OF POWER TO EXISTING EQUIPMENT AND REUSE EXISTING CIRCUITS/ RECONNECT TO NEW EQUIPMENT FOR NEW WORK. PROVIDE ALL APPURTENANCES. SEE ELECTRIC EQUIPMENT AND CONTROL SCHEDULE ON E500.
  - 2 DISCONNECT POWER AND REMOVE BACK TO NEAREST JUNCTION BOX

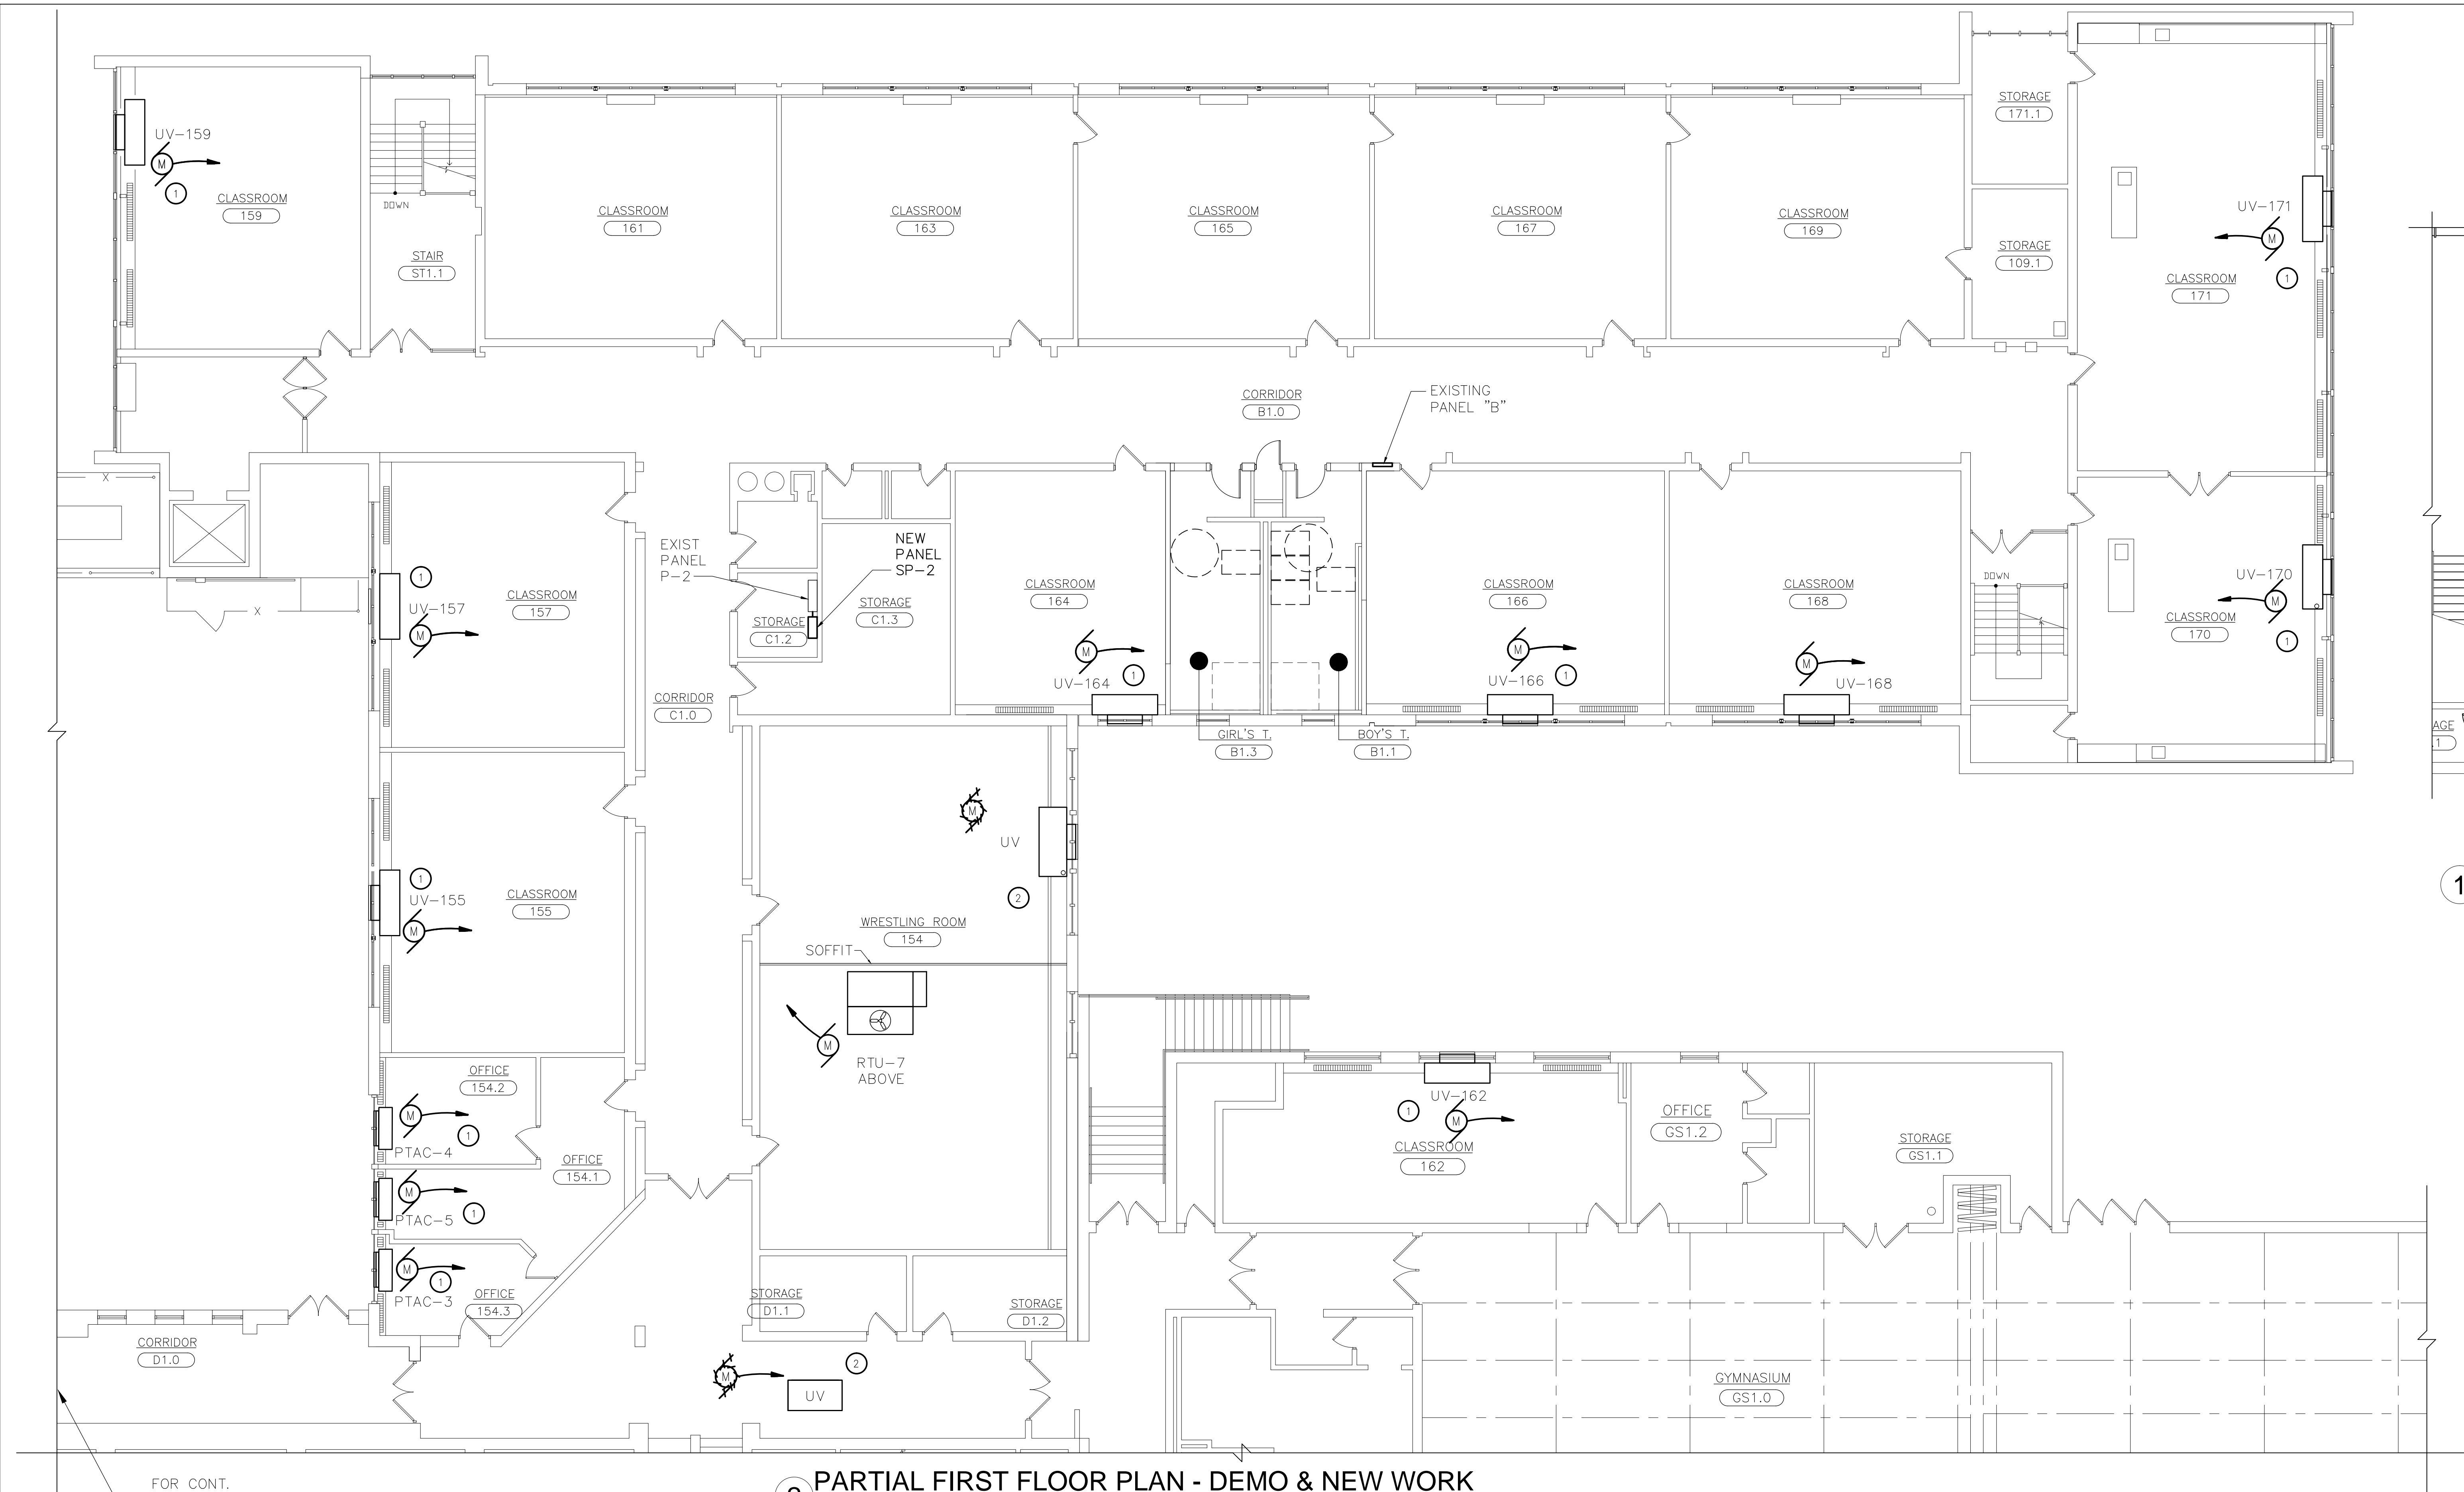


3 PARTIAL FIRST FLOOR PLAN - DEMO & NEW WORK  
SCALE: 1/8"=1'-0"

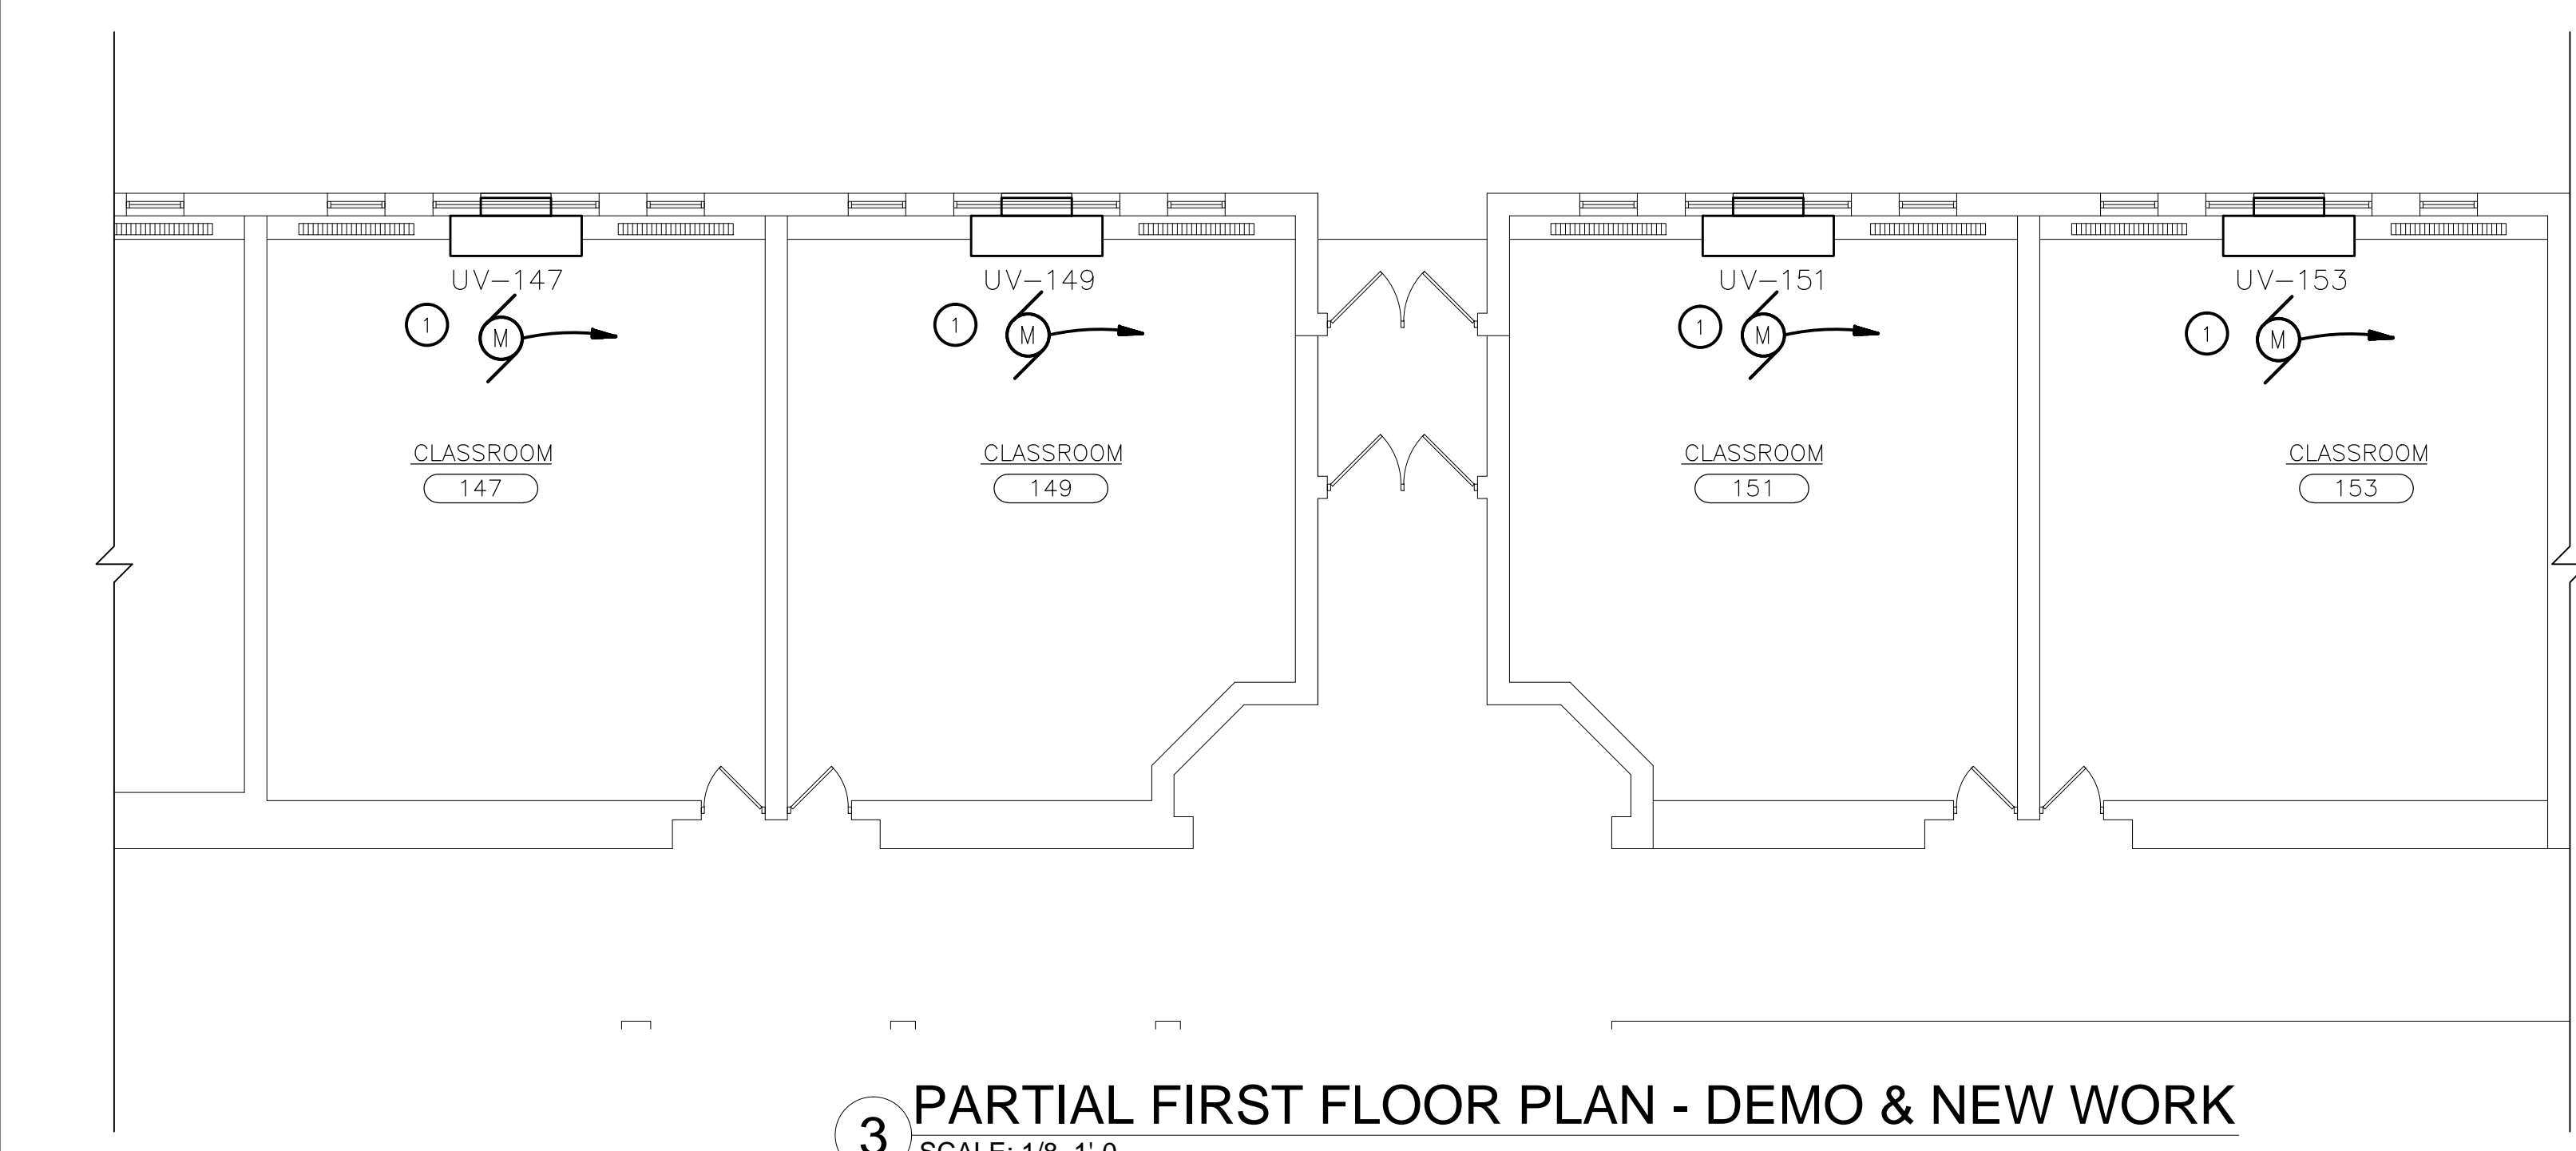

1 PARTIAL BASEMENT FLOOR PLAN - DEMO & NEW WORK  
SCALE: 1/8"=1'-0"

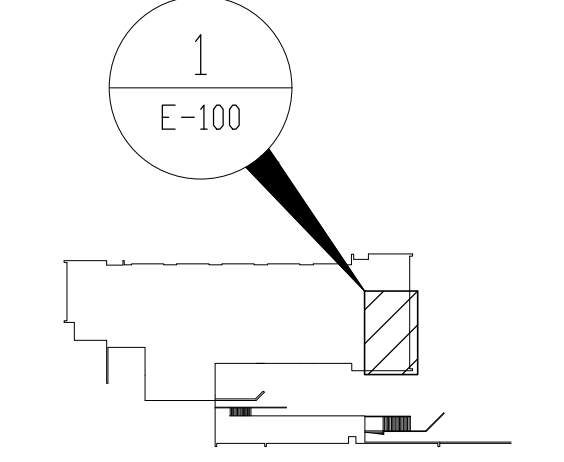

BASEMENT KEY PLAN  
SCALE: NONE

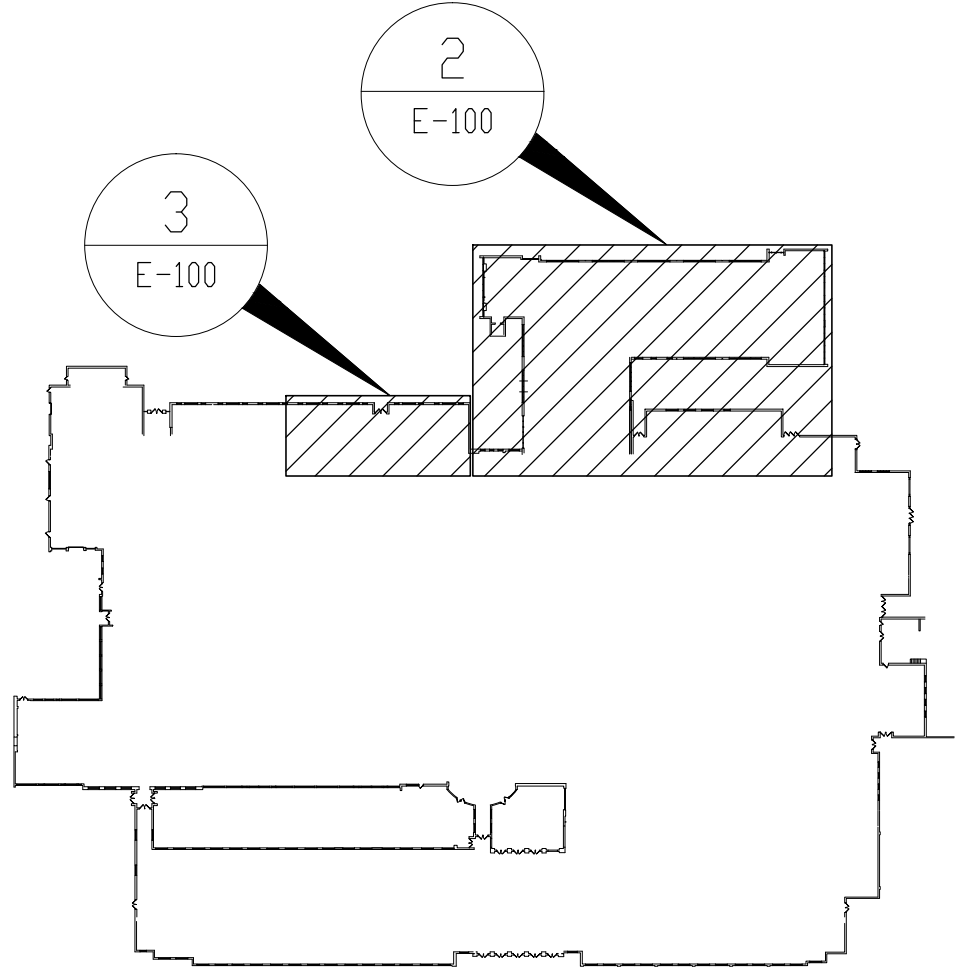

FIRST FLOOR KEY PLAN  
SCALE: NONE

BIDDING NOTE  
ALL WORK ON THIS SHEET TO BE PROVIDED IN ITS ENTIRETY BY THE DISTRICT AND IS PROVIDED FOR REFERENCE ONLY.

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ENGINEER:  
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250 Corporate Street - Union, NY 10981  
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CONSULTANT(S):  
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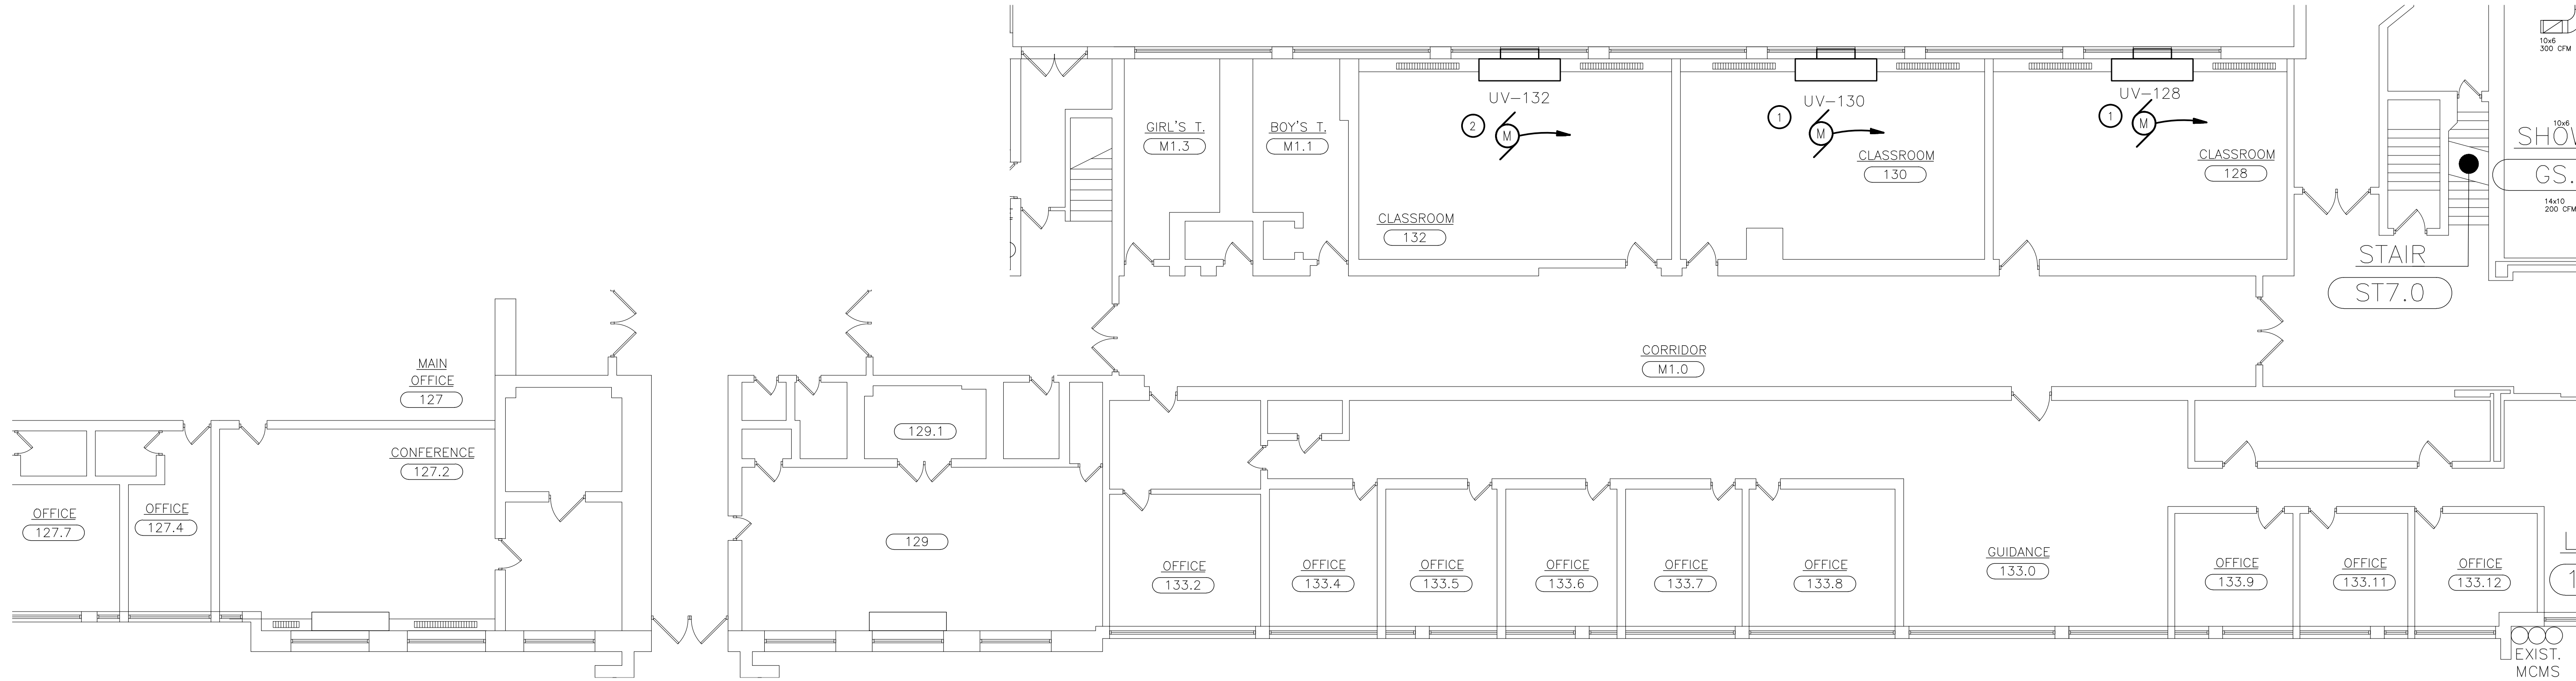
STATE OF NEW YORK  
JACK G. GENDRON  
No. 059447  
Professional Engineer

WARWICK VALLEY CENTRAL SCHOOL DISTRICT  
HIGH SCHOOL UNIT VENTILATOR REPLACEMENT AND  
AIR CONDITIONING UPGRADE  
225 WEST STREET EXT. WARWICK, NY 10990  
WV HIGH SCHOOL - 80 SANFORDVILLE ROAD, WARWICK, NY 10990  
SED NO. 44-21-01-06-0-001-042

PROJECT NO.	05-21-04 08-20-06
ISSUED FOR BID	11.09.2022
SET	10.19.2022
REVISION	DATE
DRAWN BY	
CHECKED BY	
SHEET SIZE	30" X 42"
SCALE	AS NOTED

SHEET TITLE  
PARTIAL BASEMENT  
AND FIRST FLOOR  
PLANS - DEMO & NEW  
WORK


SHEET NO.  
**E-100**



1 PARTIAL FIRST FLOOR PLAN - DEMO & NEW WORK  
SCALE: 1/8"=1'-0"

- KEYED NOTES - NEW WORK:
- 1 PROVIDE DISCONNECTION OF POWER TO EXISTING EQUIPMENT AND REUSE EXISTING CIRCUITS/ RECONNECT TO NEW EQUIPMENT FOR NEW WORK. PROVIDE ALL APPURTENANCES. SEE ELECTRIC EQUIPMENT AND CONTROL SCHEDULE ON E500.
  - 2 PROVIDE POWER TO NEW UNIT VENTILATOR. PROVIDE ALL APPURTENANCES. SEE ELECTRIC EQUIPMENT AND CONTROL SCHEDULE ON E500.


BIDDING NOTE  
ALL WORK ON THIS SHEET TO BE PROVIDED IN ITS ENTIRETY BY THE DISTRICT AND IS PROVIDED FOR REFERENCE ONLY.

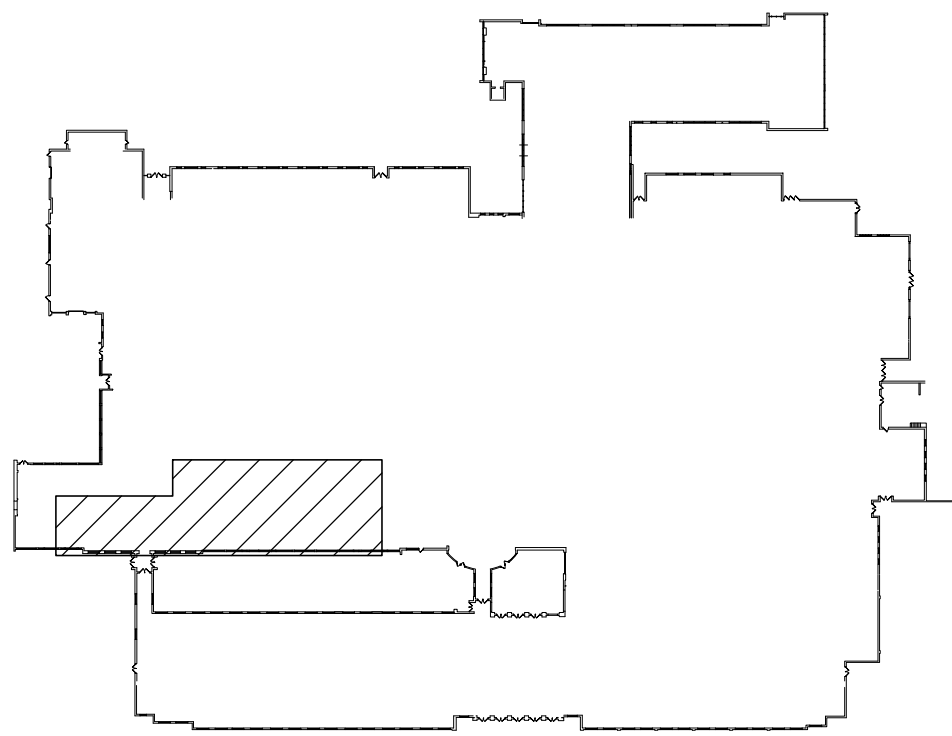

FIRST FLOOR KEY PLAN  
SCALE: NONE




ENGINEER:



Eisenbach & Ruhke Engineering, P.C.  
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www.erenpc.com

CONSULTANT(S):




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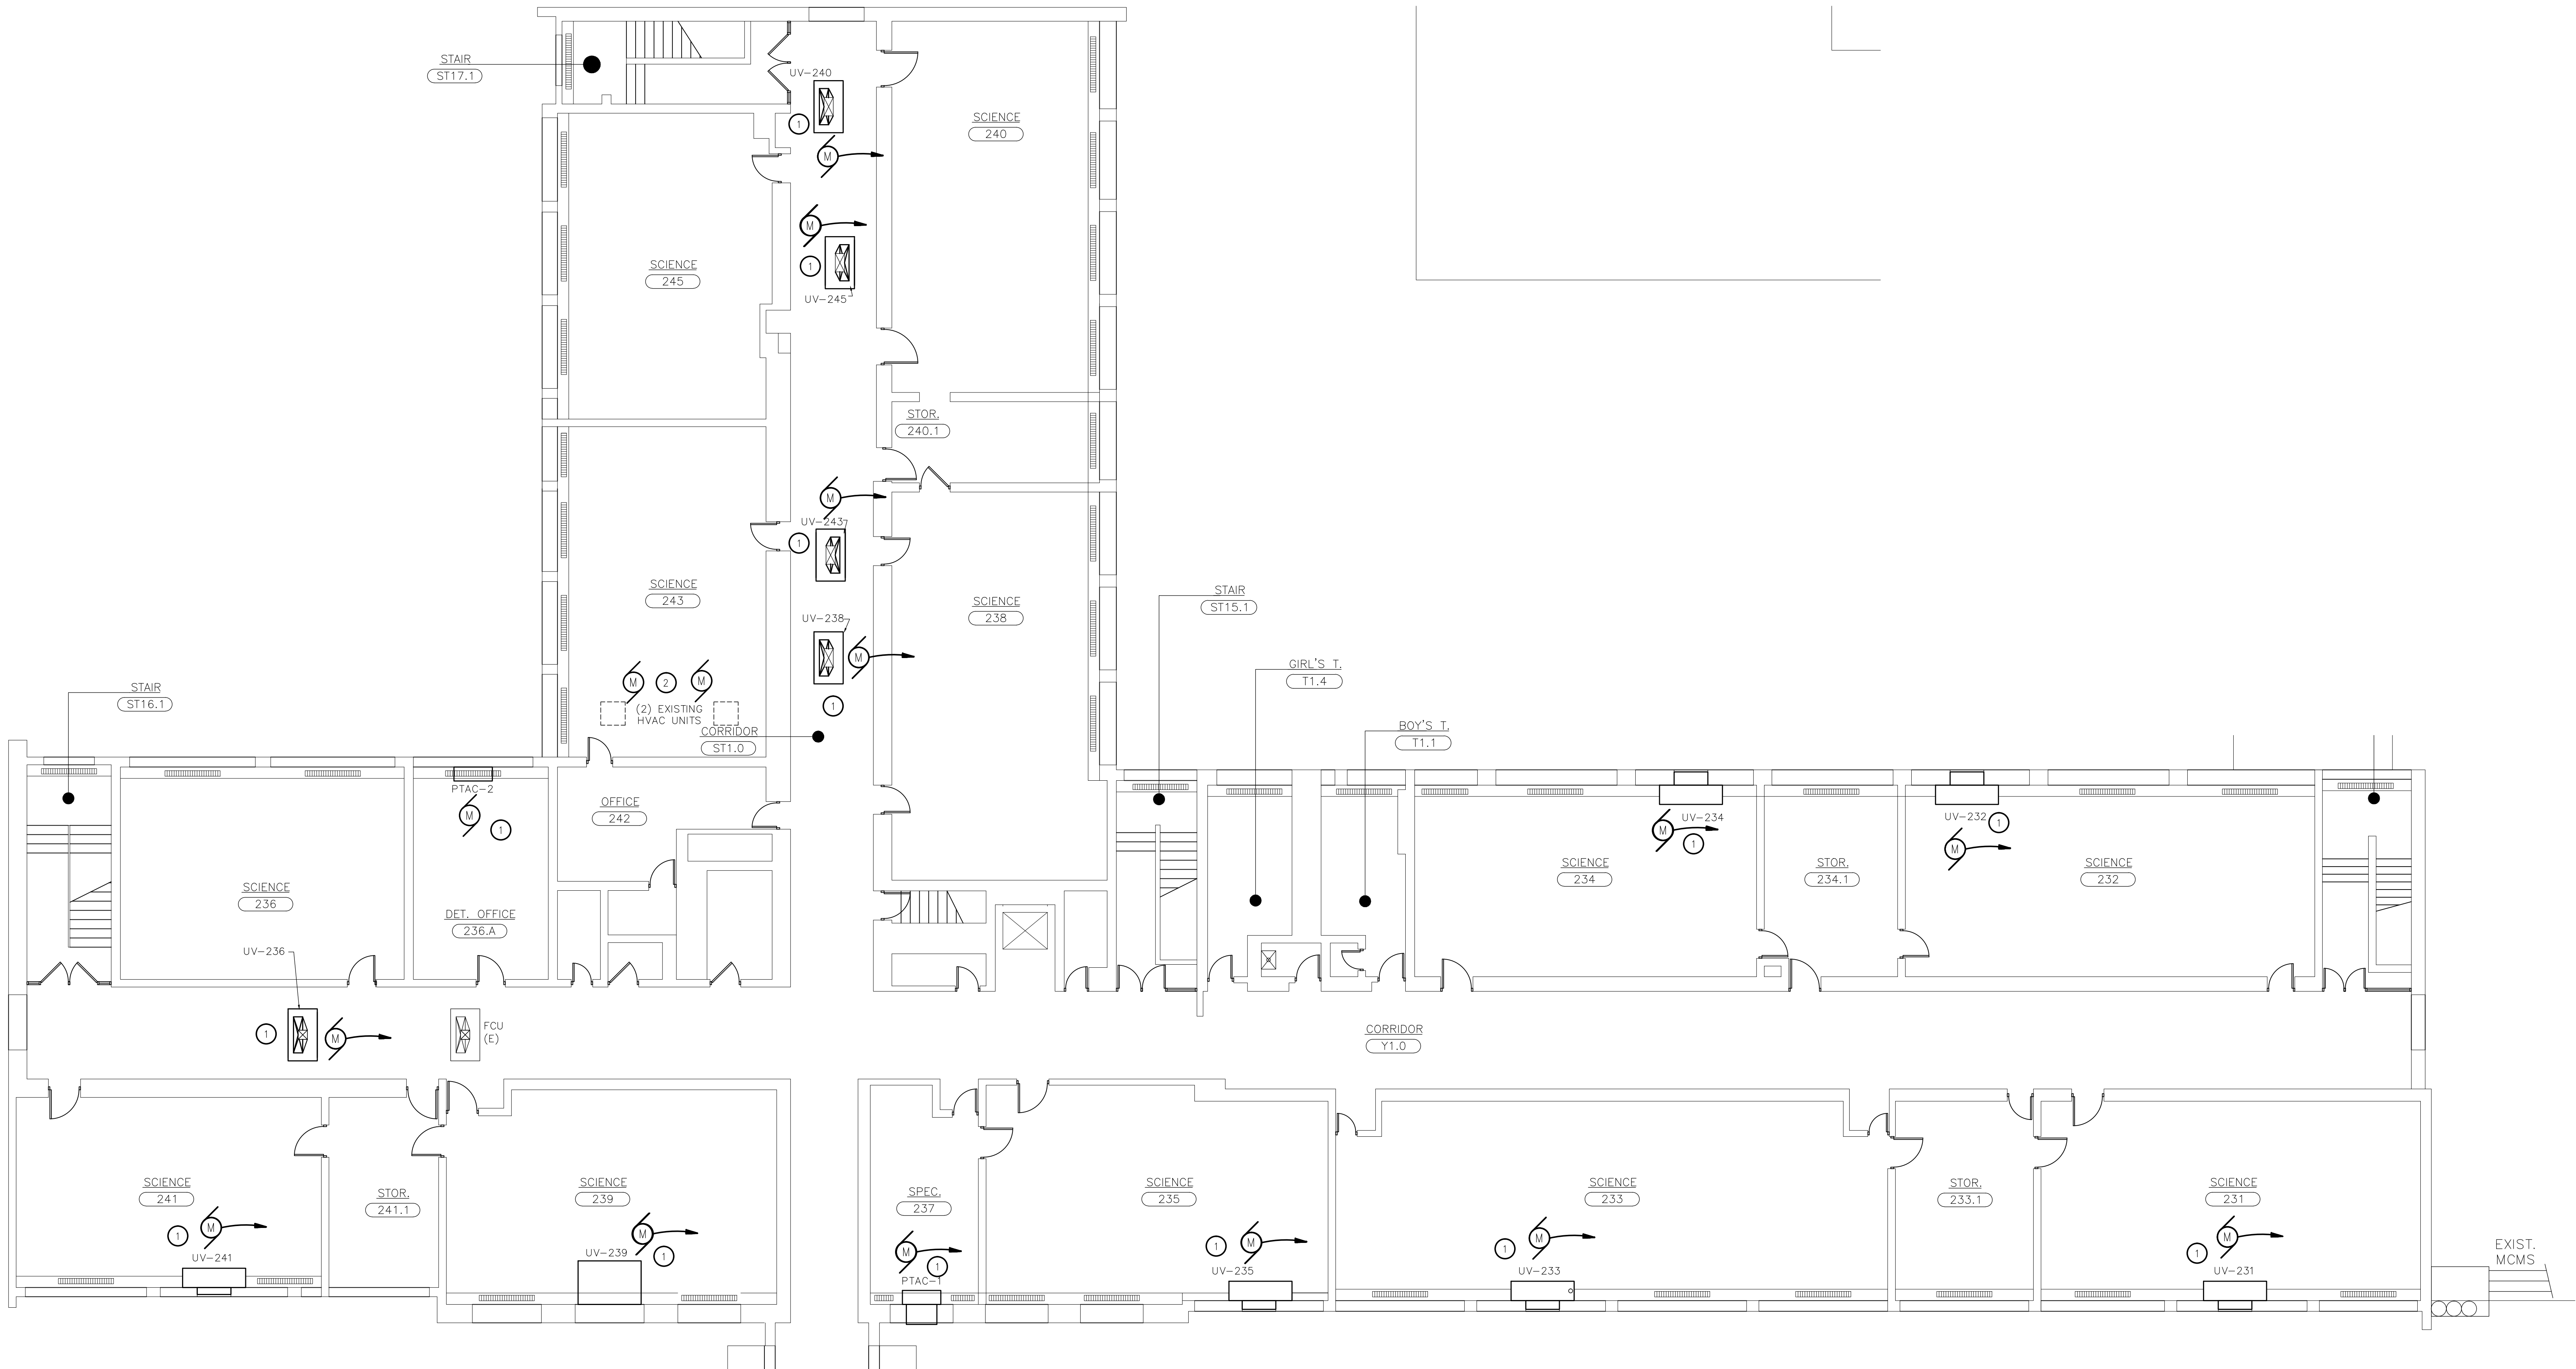
STAMP



WARWICK VALLEY CENTRAL SCHOOL DISTRICT  
HIGH SCHOOL UNIT VENTILATOR REPLACEMENT AND  
AIR CONDITIONING UPGRADE  
225 WEST STREET EXT. WARWICK, NY 10990  
WV HIGH SCHOOL - 89 SANFORDVILLE ROAD, WARWICK, NY 10990  
SED NO. 44-21-01-06-0-001-042

PROJECT NO.	05-21-04 05-20-06
ISSUED FOR BID	11.09.2022
SET	10.19.2022
REVISION	DATE
DRWN BY	
CHECKED BY	
SHEET SIZE	30" X 42"
SCALE	AS NOTED
SHEET TITLE	PARTIAL FIRST FLOOR PLAN - DEMO & NEW WORK
SHEET NO.	E-101






1 PARTIAL SECOND FLOOR PLAN - DEMO & NEW WORK  
SCALE: 1/8"=1'-0"

- KEYED NOTES - NEW WORK:
- 1 PROVIDE DISCONNECTION OF POWER TO EXISTING EQUIPMENT AND REUSE EXISTING CIRCUITS/ RECONNECT TO NEW EQUIPMENT FOR NEW WORK. PROVIDE ALL APPURTENANCES. SEE ELECTRIC EQUIPMENT AND CONTROL SCHEDULE ON E500.
  - 2 DISCONNECT POWER TO (2) HVAC UNITS AND REMOVE BACK TO NEAREST JUNCTION BOX.

BIDDING NOTE  
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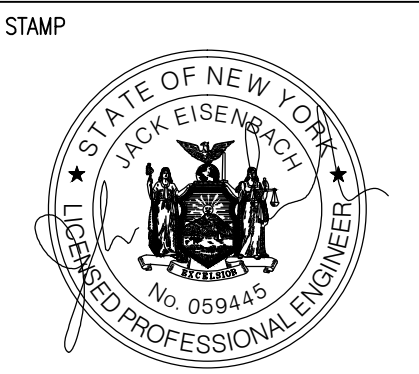


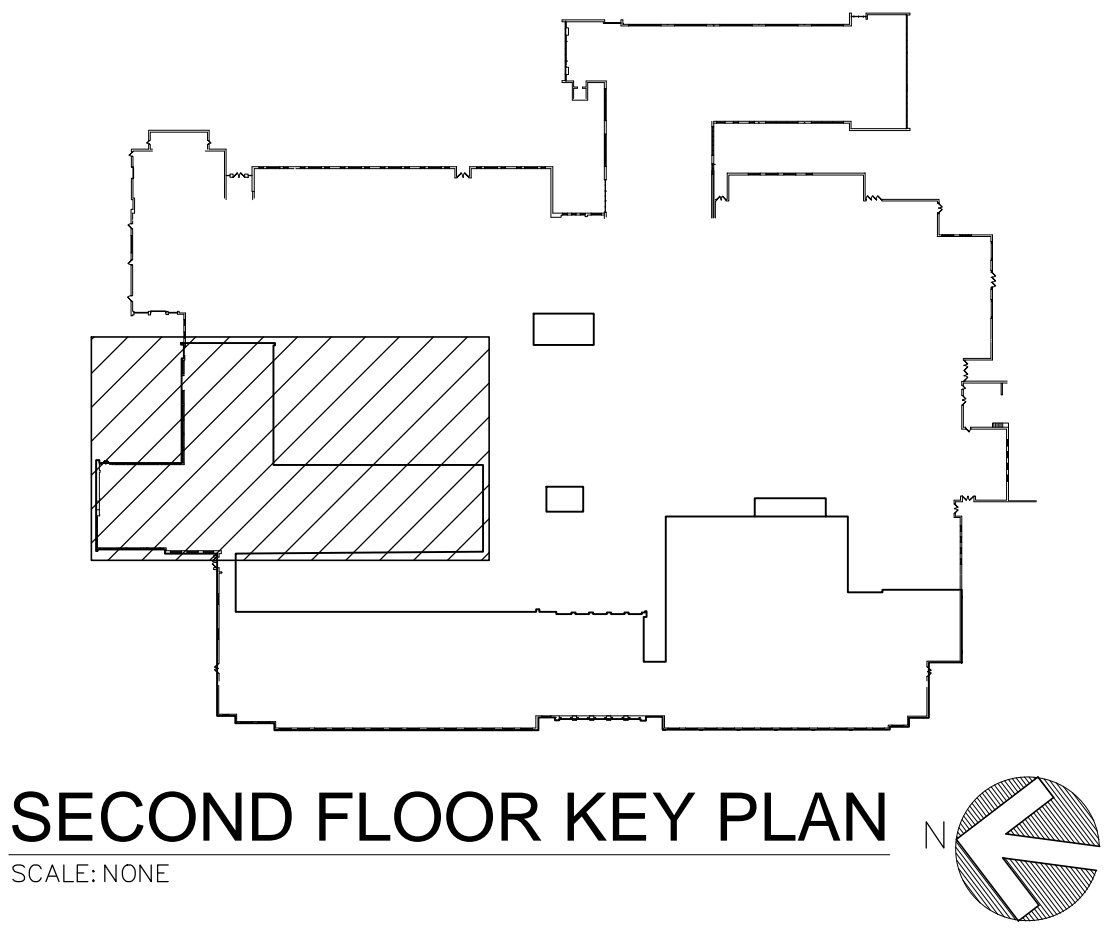SECOND FLOOR KEY PLAN  
SCALE: NONE

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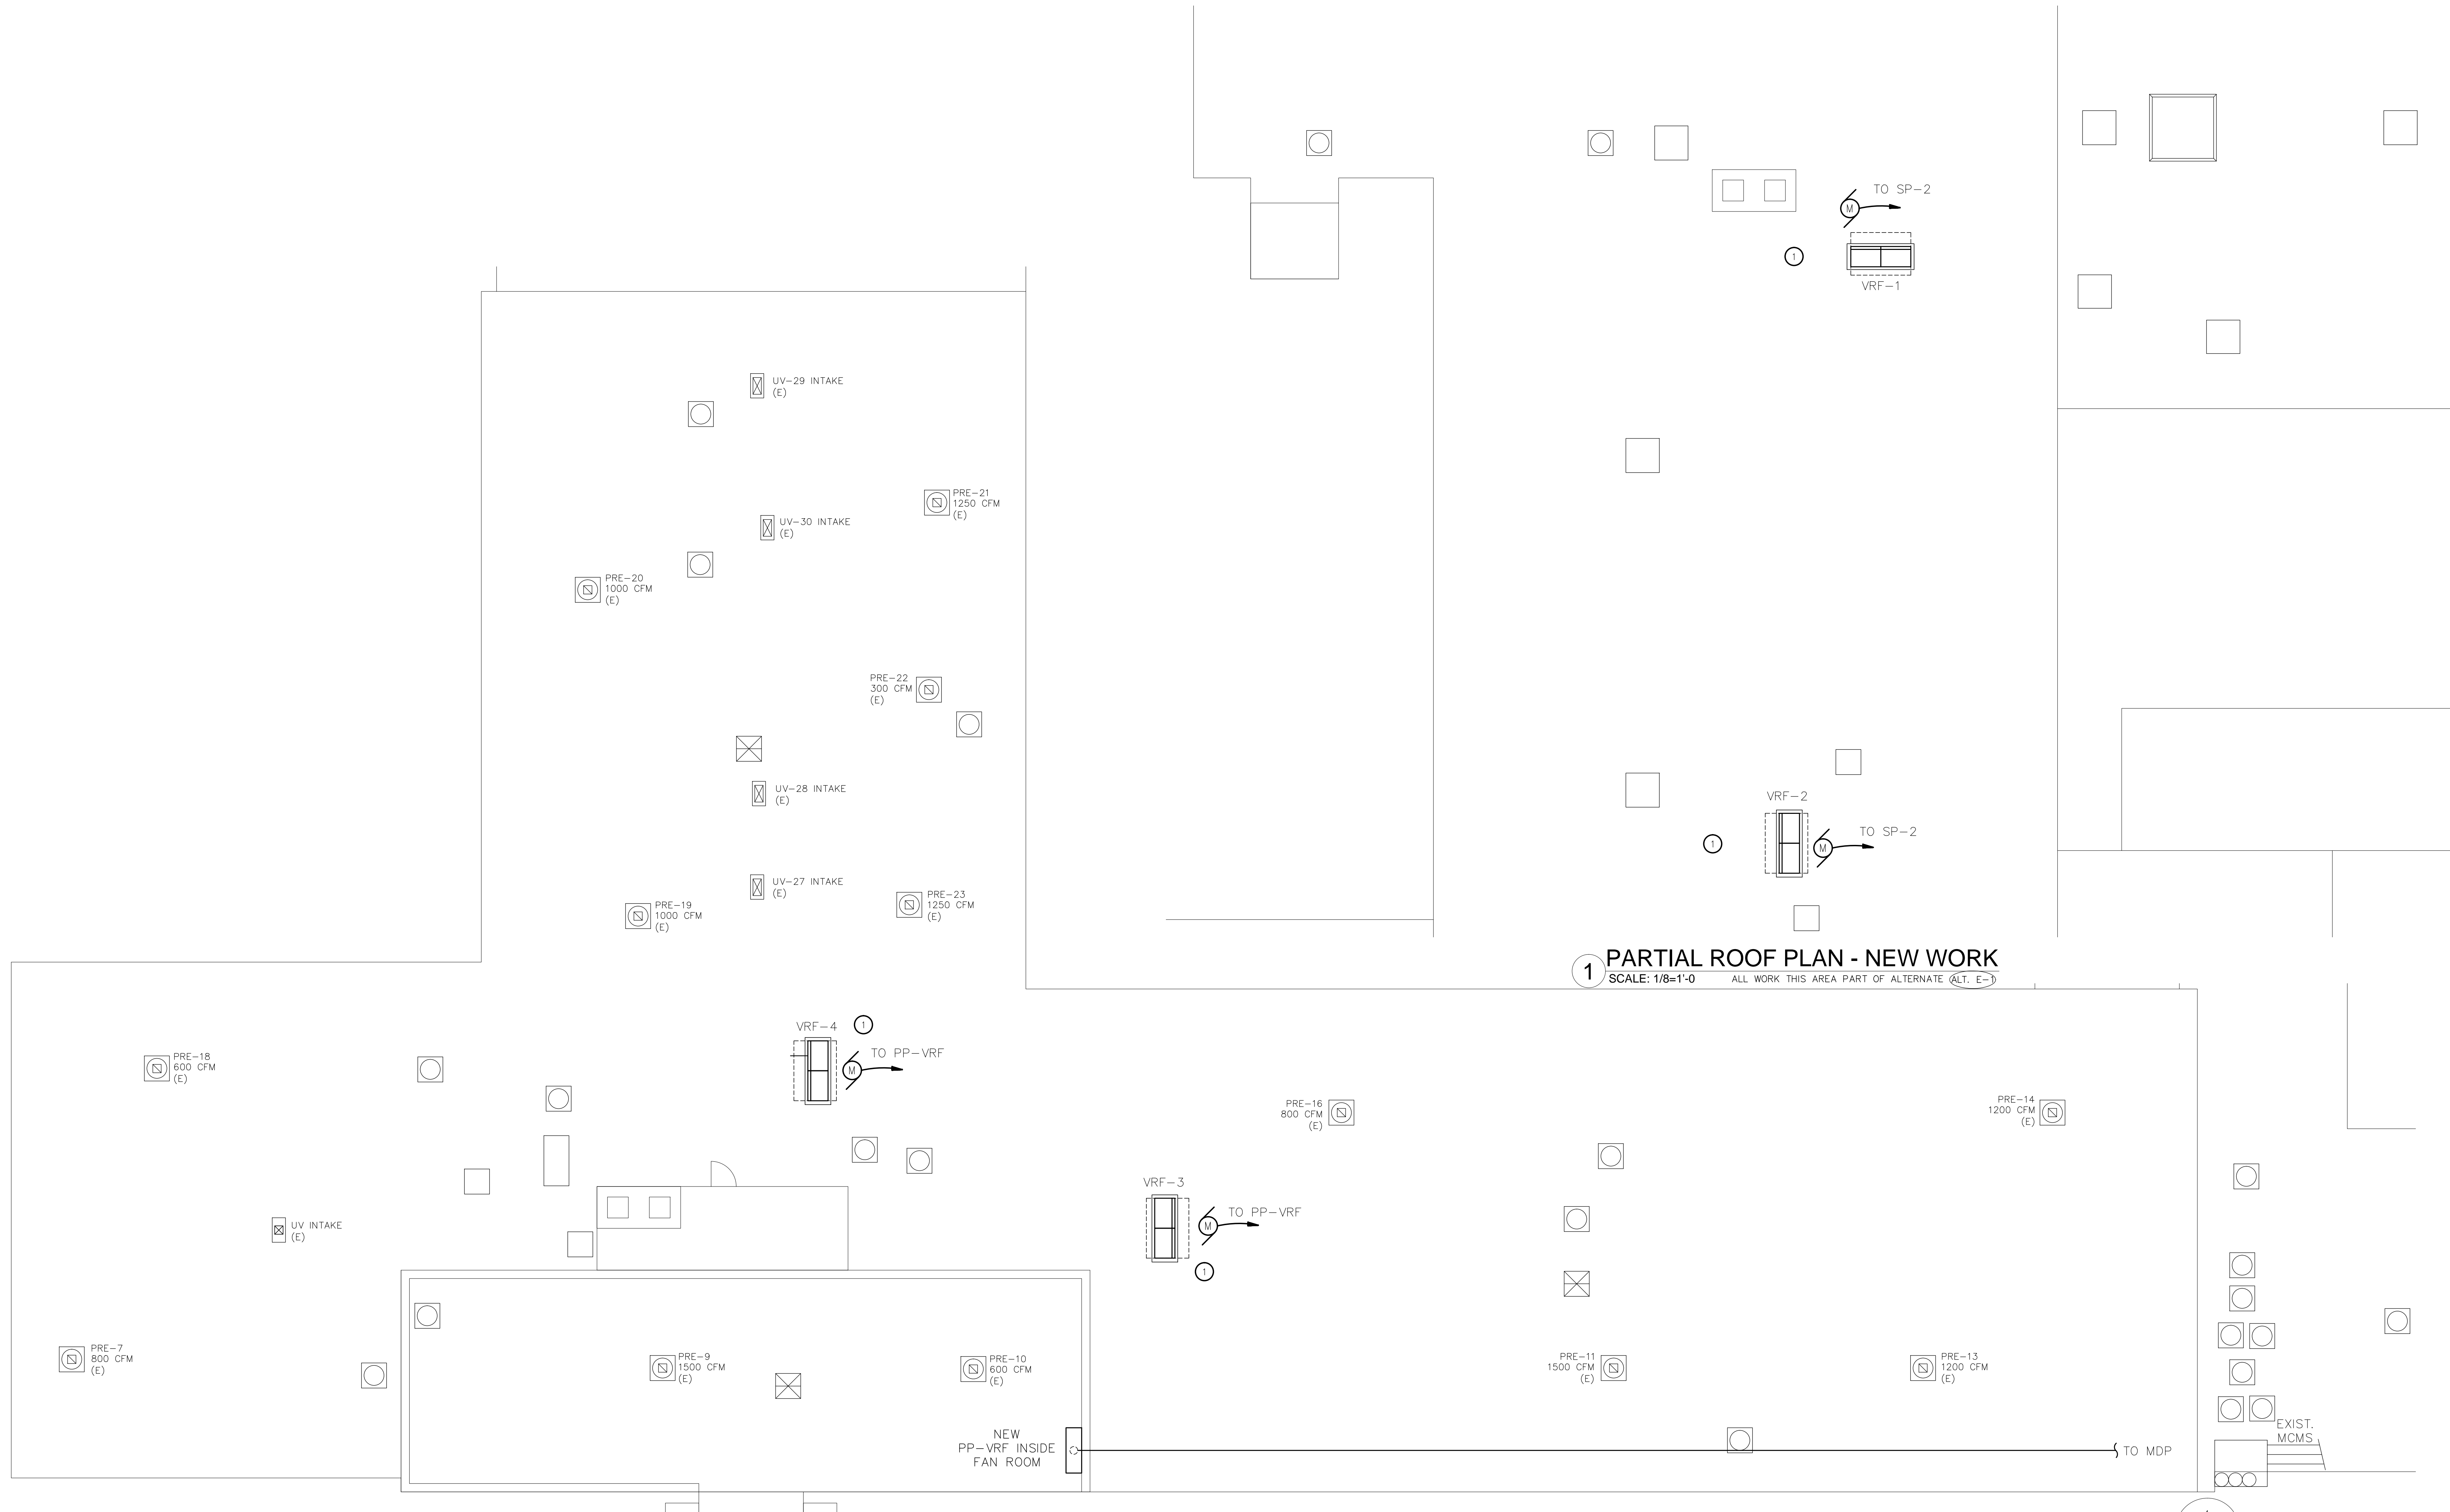
ENGINEER:  
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WARWICK VALLEY CENTRAL SCHOOL DISTRICT  
HIGH SCHOOL UNIT VENTILATOR REPLACEMENT AND  
AIR CONDITIONING UPGRADE  
225 WEST STREET EXT. WARWICK, NY 10990  
WW HIGH SCHOOL - 89 SANFORDVILLE ROAD, WARWICK, NY 10990  
SED NO. 44-21-01-06-0-001-042

PROJECT NO.	05-21-04 06-20-06
ISSUED FOR BID	11.09.2022
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REVISION	DATE
DRAWN BY	
CHECKED BY	
SHEET SIZE	30" X 42"
SCALE	AS NOTED
SHEET TITLE	PARTIAL SECOND FLOOR PLAN - DEMO & NEW WORK
SHEET NO.	




1 PARTIAL ROOF PLAN - NEW WORK  
SCALE: 1/8"=1'-0" ALL WORK THIS AREA PART OF ALTERNATE (ALT. E-3)

2 PARTIAL ROOF PLAN - NEW WORK  
SCALE: 1/8"=1'-0"

KEYED NOTES - NEW WORK:  
1 PROVIDE POWER TO NEW VRF(S). PROVIDE ALL APPURTENANCES. SEE ELECTRIC EQUIPMENT AND CONTROL SCHEDULE ON E500.

BIDDING NOTE  
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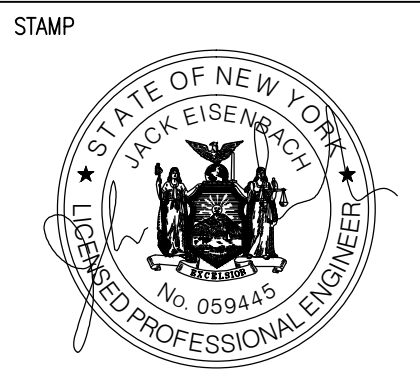


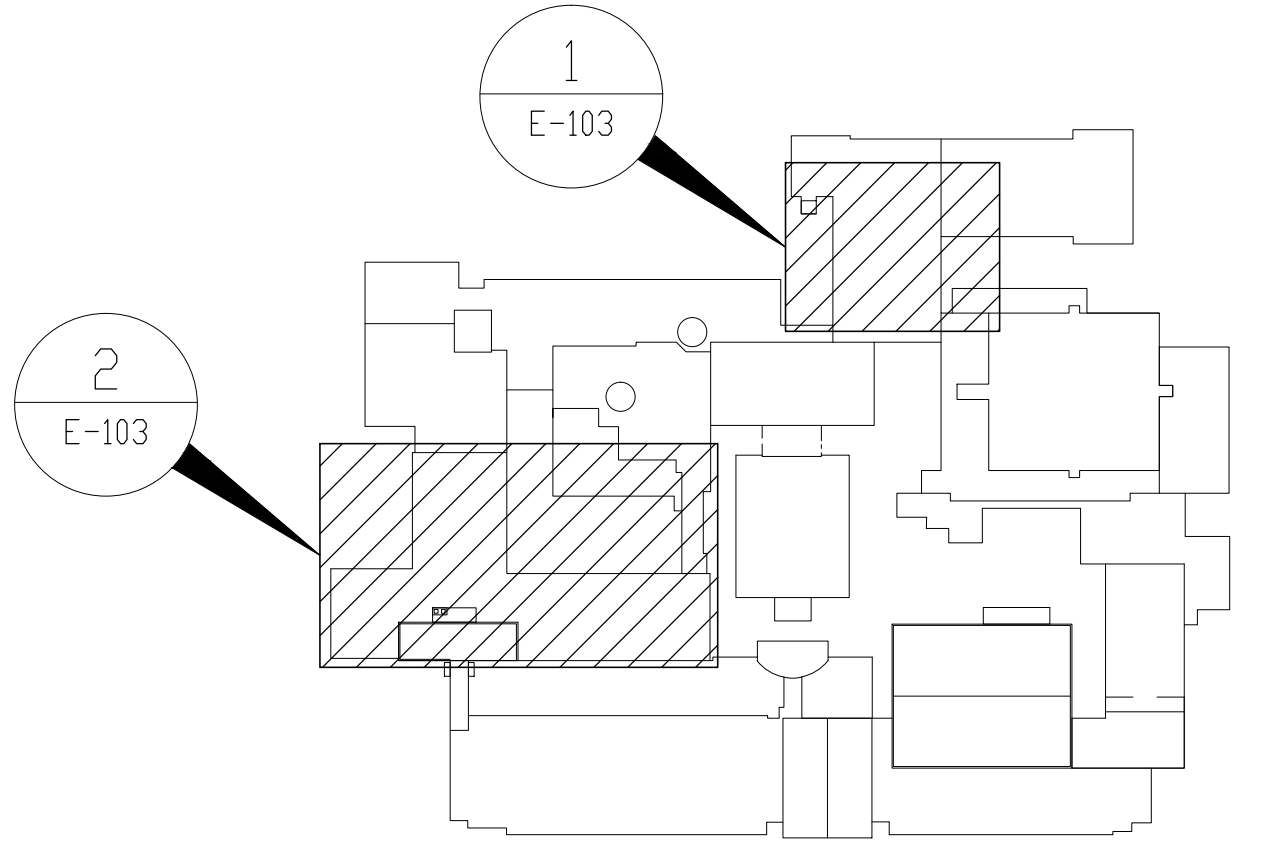ROOF KEY PLAN  
SCALE: NONE

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WARWICK VALLEY CENTRAL SCHOOL DISTRICT  
HIGH SCHOOL UNIT VENTILATOR REPLACEMENT AND  
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225 WEST STREET EXT. WARWICK, NY 10990  
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ISSUED FOR BID	11.09.2022
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DRWN BY	
CHECKED BY	
SHEET SIZE	30" X 42"
SCALE	AS NOTED
SHEET TITLE	PARTIAL ROOF PLAN - NEW WORK
SHEET NO.	E-103



ELECTRIC EQUIPMENT AND CONTROL SCHEDULE																										
EQUIPMENT				SUPPLY											CONTROLLER DEVICE TYPE & ACCESSORIES (UNO, PROVIDED BY ELECTRICAL CONTRACTOR)											
DESIGNATION	DESCRIPTION	LOCATION	SIZE	VOLTAGE/ PHASE/HZ	PANEL/ CONTROL CENTER	CIRCUIT NUMBER	BREAKER SIZE (A)	POWER WIRING FROM PANEL TO CONTROL UNIT		POWER WIRING FROM CONTROL UNIT TO EQUIPMENT *		GROUND WIRE (SIZED PER NEC)	PACKAGED CONTROL UNIT (BY OTHERS)	VARIABLE FREQUENCY DRIVE (VFD)	CONTROL STARTER	NON-FUSED DISCONNECT SWITCH	CONTROL DEVICE INSTALL LOCATION	DUCT SMOKE DETECTOR (SUPPLY)	DUCT SMOKE DETECTOR (RETURN)	FIRE ALARM FAN SHUTDOWN	DISCONNECT SWITCH			REF. NOTES	REMARKS	
								WIRE	COND.	WIRE	COND.										FRAME	FUSE	LOCATION			
VRF-1	VRF OUTDOOR UNIT	ROOF	3.6 (x2)	60	55.1	208V/3ø/60HZ	PANEL "SP-2"	CB #2,4,6	80	2 AWG		FACTORY WIRE	---	---	FACTORY WIRE	BY BMS	FACTORY WIRE	OU		YES	---	---	---		(ALT. E-1)	
	VRF OUTDOOR UNIT	ROOF	3.6 (x2)	60	55.1	208V/3ø/60HZ	PANEL "SP-2"	CB #1,3,5	40	8 AWG		FACTORY WIRE	---	---	FACTORY WIRE	BY BMS	FACTORY WIRE	OU		YES	---	---	---		(ALT. E-1)	
VRF-2	VRF OUTDOOR UNIT	ROOF	3.6 (x2)	60	55.1	208V/3ø/60HZ	PANEL "SP-2"	CB #7,9,11	70	4 AWG		FACTORY WIRE	---	---	FACTORY WIRE	BY BMS	FACTORY WIRE	OU		YES	---	---	---		(ALT. E-1)	
	VRF OUTDOOR UNIT	ROOF	3.6 (x2)	60	55.1	208V/3ø/60HZ	PANEL "SP-2"	CB #8,10,12	40	8 AWG		FACTORY WIRE	---	---	FACTORY WIRE	BY BMS	FACTORY WIRE	OU		YES	---	---	---		(ALT. E-1)	
VRF-3	VRF OUTDOOR UNIT	ROOF	3.6 (x2)	60	55.1	208V/3ø/60HZ	PANEL "P-4"	CB #2,4,6	80	2 AWG		FACTORY WIRE	---	---	FACTORY WIRE	BY BMS	FACTORY WIRE	OU		YES	---	---	---			
	VRF OUTDOOR UNIT	ROOF	3.6 (x2)	60	55.1	208V/3ø/60HZ	PANEL "P-4"	CB #1,3,5	40	8 AWG		FACTORY WIRE	---	---	FACTORY WIRE	BY BMS	FACTORY WIRE	OU		YES	---	---	---			
VRF-4	VRF OUTDOOR UNIT	ROOF	3.6 (x2)	60	55.1	208V/3ø/60HZ	PANEL "P-4"	CB #7,9,11	70	4 AWG		FACTORY WIRE	---	---	FACTORY WIRE	BY BMS	FACTORY WIRE	OU		YES	---	---	---			
	VRF OUTDOOR UNIT	ROOF	3.6 (x2)	60	55.1	208V/3ø/60HZ	PANEL "P-4"	CB #8,10,12	40	8 AWG		FACTORY WIRE	---	---	FACTORY WIRE	BY BMS	FACTORY WIRE	OU		YES	---	---	---			
PTAC-5	PACKAGE AC W/ HEAT	OFFICE 154.1	FRAC	15	6.3	115V/1ø/60HZ	REUSE EXIST.	REUSE EXIST.	20	12 AWG	3/4"	FACTORY WIRE	---	12 AWG	---	FACTORY WIRE	BY BMS	FACTORY WIRE	OU		YES	---	---	---		(ALT. E-1)
PTAC-4	PACKAGE AC W/ HEAT	OFFICE 154.2	FRAC	15	6.3	115V/1ø/60HZ	REUSE EXIST.	REUSE EXIST.	20	12 AWG	3/4"	FACTORY WIRE	---	12 AWG	---	FACTORY WIRE	BY BMS	FACTORY WIRE	OU		YES	---	---	---		(ALT. E-1)
PTAC-3	PACKAGE AC W/ HEAT	OFFICE 154.3	FRAC	15	6.3	115V/1ø/60HZ	REUSE EXIST.	REUSE EXIST.	20	12 AWG	3/4"	FACTORY WIRE	---	12 AWG	---	FACTORY WIRE	BY BMS	FACTORY WIRE	OU		YES	---	---	---		(ALT. E-1)
PTAC-1	PACKAGE AC W/ HEAT	CLASS 237	FRAC	15	6.3	115V/1ø/60HZ	REUSE EXIST.	REUSE EXIST.	20	12 AWG	3/4"	FACTORY WIRE	---	12 AWG	---	FACTORY WIRE	BY BMS	FACTORY WIRE	OU		YES	---	---	---		
PTAC-2	PACKAGE AC W/ HEAT	CLASS 236.A	FRAC	15	6.3	115V/1ø/60HZ	LOCAL PANEL	REUSE EXIST.	20	12 AWG	3/4"	FACTORY WIRE	---	12 AWG	---	FACTORY WIRE	BY BMS	FACTORY WIRE	OU		YES	---	---	---		
UV-70-A	UNIT VENTILATOR	CLASS. 70	FRAC	15	6.3	115V/1ø/60HZ	REUSE EXIST.	REUSE EXIST.	20	12 AWG	3/4"	FACTORY WIRE	---	12 AWG	---	FACTORY WIRE	BY BMS	FACTORY WIRE	OU		YES	---	---	---		(ALT. E-1)
UV-70-B	UNIT VENTILATOR	CLASS. 70	FRAC	15	6.3	115V/1ø/60HZ	REUSE EXIST.	REUSE EXIST.	20	12 AWG	3/4"	FACTORY WIRE	---	12 AWG	---	FACTORY WIRE	BY BMS	FACTORY WIRE	OU		YES	---	---	---		(ALT. E-1)
UV-128	UNIT VENTILATOR	CLASS. 128	FRAC	15	6.3	115V/1ø/60HZ	LOCAL PANEL	REUSE EXIST.	20	12 AWG	3/4"	FACTORY WIRE	---	12 AWG	---	FACTORY WIRE	BY BMS	FACTORY WIRE	OU		YES	---	---	---		
UV-130	UNIT VENTILATOR	CLASS. 130	FRAC	15	6.3	115V/1ø/60HZ	REUSE EXIST.	REUSE EXIST.	20	12 AWG	3/4"	FACTORY WIRE	---	12 AWG	---	FACTORY WIRE	BY BMS	FACTORY WIRE	OU		YES	---	---	---		
UV-132	UNIT VENTILATOR	CLASS. 132	FRAC	15	6.3	115V/1ø/60HZ	LOCAL PANEL	REUSE EXIST.	20	12 AWG	3/4"	FACTORY WIRE	---	12 AWG	---	FACTORY WIRE	BY BMS	FACTORY WIRE	OU		YES	---	---	---		
UV-147	UNIT VENTILATOR	CLASS. 147	FRAC	15	6.3	115V/1ø/60HZ	REUSE EXIST.	REUSE EXIST.	20	12 AWG	3/4"	FACTORY WIRE	---	12 AWG	---	FACTORY WIRE	BY BMS	FACTORY WIRE	OU		YES	---	---	---		(ALT. E-1)
UV-149	UNIT VENTILATOR	CLASS. 149	FRAC	15	6.3	115V/1ø/60HZ	REUSE EXIST.	REUSE EXIST.	20	12 AWG	3/4"	FACTORY WIRE	---	12 AWG	---	FACTORY WIRE	BY BMS	FACTORY WIRE	OU		YES	---	---	---		(ALT. E-1)
UV-151	UNIT VENTILATOR	CLASS. 151	FRAC	15	6.3	115V/1ø/60HZ	REUSE EXIST.	REUSE EXIST.	20	12 AWG	3/4"	FACTORY WIRE	---	12 AWG	---	FACTORY WIRE	BY BMS	FACTORY WIRE	OU		YES	---	---	---		(ALT. E-1)
UV-153	UNIT VENTILATOR	CLASS. 153	FRAC	15	6.3	115V/1ø/60HZ	REUSE EXIST.	REUSE EXIST.	20	12 AWG	3/4"	FACTORY WIRE	---	12 AWG	---	FACTORY WIRE	BY BMS	FACTORY WIRE	OU		YES	---	---	---		(ALT. E-1)
RTU-7	ROOFTOP AIR HANDLER	WRES RM 154	1.7	70	50	208V/3ø/60HZ	PANEL "P-2"	CB #38,40,42	70	4 AWG		FACTORY WIRE	---	---	FACTORY WIRE	BY BMS	FACTORY WIRE	OU		YES	---	---	---			
UV-155	UNIT VENTILATOR	CLASS. 155	FRAC	15	6.3	115V/1ø/60HZ	REUSE EXIST.	REUSE EXIST.	20	12 AWG	3/4"	FACTORY WIRE	---	12 AWG	---	FACTORY WIRE	BY BMS	FACTORY WIRE	OU		YES	---	---	---		(ALT. E-1)
UV-157	UNIT VENTILATOR	CLASS. 157	FRAC	15	6.3	115V/1ø/60HZ	REUSE EXIST.	REUSE EXIST.	20	12 AWG	3/4"	FACTORY WIRE	---	12 AWG	---	FACTORY WIRE	BY BMS	FACTORY WIRE	OU		YES	---	---	---		(ALT. E-1)
UV-159	UNIT VENTILATOR	CLASS. 159	FRAC	15	6.3	115V/1ø/60HZ	REUSE EXIST.	REUSE EXIST.	20	12 AWG	3/4"	FACTORY WIRE	---	12 AWG	---	FACTORY WIRE	BY BMS	FACTORY WIRE	OU		YES	---	---	---		(ALT. E-1)
UV-162	UNIT VENTILATOR	CLASS. 162	FRAC	15	6.3	115V/1ø/60HZ	REUSE EXIST.	REUSE EXIST.	20	12 AWG	3/4"	FACTORY WIRE	---	12 AWG	---	FACTORY WIRE	BY BMS	FACTORY WIRE	OU		YES	---	---	---		(ALT. E-1)
UV-164	UNIT VENTILATOR	CLASS. 164	FRAC	15	6.3	115V/1ø/60HZ	REUSE EXIST.	REUSE EXIST.	20	12 AWG	3/4"	FACTORY WIRE	---	12 AWG	---	FACTORY WIRE	BY BMS	FACTORY WIRE	OU		YES	---	---	---		(ALT. E-1)
UV-166	UNIT VENTILATOR	CLASS. 166	FRAC	15	6.3	115V/1ø/60HZ	REUSE EXIST.	REUSE EXIST.	20	12 AWG	3/4"	FACTORY WIRE	---	12 AWG	---	FACTORY WIRE	BY BMS	FACTORY WIRE	OU		YES	---	---	---		(ALT. E-1)
UV-168	UNIT VENTILATOR	CLASS. 168	FRAC	15	6.3	115V/1ø/60HZ	REUSE EXIST.	REUSE EXIST.	20	12 AWG	3/4"	FACTORY WIRE	---	12 AWG	---	FACTORY WIRE	BY BMS	FACTORY WIRE	OU		YES	---	---	---		(ALT. E-1)
UV-170	UNIT VENTILATOR	CLASS. 170	FRAC	15	6.3	115V/1ø/60HZ	REUSE EXIST.	REUSE EXIST.	20	12 AWG	3/4"	FACTORY WIRE	---	12 AWG	---	FACTORY WIRE	BY BMS	FACTORY WIRE	OU		YES	---	---	---		(ALT. E-1)
UV-171	UNIT VENTILATOR	CLASS. 171	FRAC	15	6.3	115V/1ø/60HZ	REUSE EXIST.	REUSE EXIST.	20	12 AWG	3/4"	FACTORY WIRE	---	12 AWG	---	FACTORY WIRE	BY BMS	FACTORY WIRE	OU		YES	---	---	---		(ALT. E-1)
UV-231	UNIT VENTILATOR	CLASS. 231	FRAC	15	6.3	115V/1ø/60HZ	REUSE EXIST.	REUSE EXIST.	20	12 AWG	3/4"	FACTORY WIRE	---	12 AWG	---	FACTORY WIRE	BY BMS	FACTORY WIRE	OU		YES	---	---	---		
UV-232	UNIT VENTILATOR	CLASS. 232	FRAC	15	6.3	115V/1ø/60HZ	REUSE EXIST.	REUSE EXIST.	20	12 AWG	3/4"	FACTORY WIRE	---	12 AWG	---	FACTORY WIRE	BY BMS	FACTORY WIRE	OU		YES	---	---	---		
UV-233	UNIT VENTILATOR	CLASS. 233	FRAC	15	6.3	115V/1ø/60HZ	REUSE EXIST.	REUSE EXIST.	20	12 AWG	3/4"	FACTORY WIRE	---	12 AWG	---	FACTORY WIRE	BY BMS	FACTORY WIRE	OU		YES	---	---	---		
UV-234	UNIT VENTILATOR	CLASS. 234	FRAC	15	6.3	115V/1ø/60HZ	REUSE EXIST.	REUSE EXIST.	20	12 AWG	3/4"	FACTORY WIRE	---	12 AWG	---	FACTORY WIRE	BY BMS	FACTORY WIRE	OU		YES	---	---	---		
UV-235	UNIT VENTILATOR	CLASS. 235	FRAC	15	6.3	115V/1ø/60HZ	REUSE EXIST.	REUSE EXIST.	20	12 AWG	3/4"	FACTORY WIRE	---	12 AWG	---	FACTORY WIRE	BY BMS	FACTORY WIRE	OU		YES	---	---	---		
UV-236	UNIT VENTILATOR	CLASS. 236	FRAC	15	6.3	115V/1ø/60HZ	REUSE EXIST.	REUSE EXIST.	20	12 AWG	3/4"	FACTORY WIRE	---	12 AWG	---	FACTORY WIRE	BY BMS	FACTORY WIRE	OU		YES	---	---	---		
UV-238	UNIT VENTILATOR	CLASS. 238	FRAC	15	6.3	115V/1ø/60HZ	REUSE EXIST.	REUSE EXIST.	20	12 AWG	3/4"	FACTORY WIRE	---	12 AWG	---	FACTORY WIRE	BY BMS	FACTORY WIRE	OU		YES	---	---	---		
UV-239	UNIT VENTILATOR	CLASS. 239	FRAC	15	6.3	115V/1ø/60HZ	REUSE EXIST.	REUSE EXIST.	20	12 AWG	3/4"	FACTORY WIRE	---	12 AWG	---	FACTORY WIRE	BY BMS	FACTORY WIRE	OU		YES	---	---	---		
UV-240	UNIT VENTILATOR	CLASS. 240	FRAC	15	12	115V/1ø/60HZ	REUSE EXIST.	REUSE EXIST.	20	12 AWG	3/4"	FACTORY WIRE	---	12 AWG	---	FACTORY WIRE	BY BMS	FACTORY WIRE	OU		YES	---	---	---		
UV-241	UNIT VENTILATOR	CLASS. 241	FRAC	15	6.3	115V/1ø/60HZ	REUSE EXIST.	REUSE EXIST.	20	12 AWG	3/4"	FACTORY WIRE	---	12 AWG	---	FACTORY WIRE	BY BMS	FACTORY WIRE	OU		YES	---	---	---		
UV-243	UNIT VENTILATOR	CLASS. 243	FRAC	15	6.3	115V/1ø/60HZ	REUSE EXIST.	REUSE EXIST.	20	12 AWG	3/4"	FACTORY WIRE	---	12 AWG	---	FACTORY WIRE	BY BMS	FACTORY WIRE	OU		YES	---	---	---		
UV-245	UNIT VENTILATOR	CLASS. 245	FRAC	15	6.3	115V/1ø/60HZ	REUSE EXIST.	REUSE EXIST.	20	12 AWG	3/4"	FACTORY WIRE	---	12 AWG	---	FACTORY WIRE	BY BMS	FACTORY WIRE	OU		YES	---	---	---		

UV-245 UV-UNIT VENTILATOR - LOCATION IN RM 245 - TYP.

AU - AT UNIT  
OU - ON UNIT  
N/A - NOT APPLICABLE  
FRAC. - FRACTIONAL

- FOLLOW NEC 2020 (NFPA 70) REQUIREMENTS.
- PROVIDE GFCI OUTLETS AT VRF-3&4 WIRED WITH 2-#12 AND 1-#12 GND IN 3" CONDUIT FROM EXISTING NEARBY PANEL. PROVIDE NEW 20A CIRCUIT BREAKER AND ALL APPURTENANCES.
- PROVIDE GFCI OUTLET AT RTU-7 WIRED WITH 2-#12 AND 1-#12 GND IN 3" CONDUIT FROM EXISTING PANEL P-2. PROVIDE NEW 20A CIRCUIT BREAKER AND ALL APPURTENANCES.
- AS PART OF ALTERNATE WORK, PROVIDE GFCI OUTLETS AT VRF-1&2 WIRED WITH 2-#12 AND 1-#12 GND IN 3" CONDUIT FROM EXISTING PANEL P-2 AND SHARE CIRCUIT WITH RTU-7'S GFCI. PROVIDE NEW 20A CIRCUIT BREAKER AND ALL APPURTENANCES.
- PROVIDE NEW TYPED PANEL BOARD LEGENDS IN NEW AND EXISTING PANELS. FOR EXISTING PANELS, REPLACE EXISTING PANEL BOARD LEGEND TO REFLECT ALL CHANGES MADE.

(ALT. E-1)

## NEW PANEL SCHEDULE

PANEL ID: PANEL "P-4" 120-208V/3 PHASE/4 WIRE				NEW PANEL				LOCATION: FAN ROOM			
NOTES	CIR. No.	CIRCUIT DESCRIPTION	BKR	ø	BKR	CIRCUIT DESCRIPTION	CIR. No.	NOTES			
	1			A			2				
2	3	(NEW) VRF-3	40A	B	80A	(NEW) VRF-3	4	2			
	5			C			6				
	7			A			8				
2	9	(NEW) VRF-4	70A	B	40A	(NEW) VRF-4	10	2			
	11			C			12				

PLUMBING ABBREVIATIONS			
A/E	ARCHITECT / ENGINEER	I/W	INDIRECT WASTE
AD	AREA DRAIN	IWH	INSTANTANEOUS WATER HEATER
AD	ACCESS DOOR	KW	KILOWATT
ADA	AMERICANS WITH DISABILITIES ACT	LAV	LAVATORY
AFF	ABOVE FINISH FLOOR	M	METER
AFG	ABOVE FINISHED GRADE	MC	MECHANICAL CONTRACTOR
AHJ	AUTHORITY HAVING JURISDICTION	MBH	1000 BTUH
ANSI	AMERICAN NATIONAL STANDARDS INSTITUTE	MH	MANHOLE
AP	ACCESS PANEL	NC	NORMALLY CLOSED
ASHRAE	AMERICAN SOCIETY OF HEATING, REFRIGERATION & AIR CONDITIONING ENGINEERS	NG	NATURAL GAS
ASME	AMERICAN SOCIETY OF MECHANICAL ENGINEERS	NIC	NOT IN CONTRACT
ASPE	AMERICAN SOCIETY OF PLUMBING ENGINEERS	NOM	NOMINAL
		NPW	NON POTABLE WATER
AWWA	AMERICAN WATERWORKS ASSOCIATION	NTS	NOT TO SCALE
BFG	BELOW FINISHED GRADE	O2	OXYGEN
BHP	BREAK HORSEPOWER	OD	OUTSIDE DIAMETER
BOR	BASE OF RISER	OSHA	OCCUPATIONAL SAFETY AND HEALTH ADMINISTRATION
BTU	BRITISH THERMAL UNIT	P	PUMP
BTUH	BRITISH THERMAL UNIT PER HOUR	PC	PLUMBING CONTRACTOR
C	CELSIUS	PD	PUMP DISCHARGE
CA	COMBUSTION AIR	PDI	PLUMBING AND DRAINAGE INSTITUTE
CA	COMPRESSED AIR	PF	PLUMBING FIXTURE
CGA	COMPRESSED GAS ASSOCIATION	PG	PRESSURE GAGE
CI	CAST IRON	PPM	PARTS PER MILLION
CO	CLEANOUT	PRS	PRESSURE REDUCING STATION
CO2	CARBON DIOXIDE	PRV	PRESSURE REDUCING VALVE
COND	CONDENSATE	PSI	POUNDS PER SQUARE INCH
CP	CIRCULATING PUMP	PSIA	POUNDS PER SQUARE INCH ATMOSPHERE
CPVC	CHLORINATED POLYVINYL CHLORIDE	PSIG	POUNDS PER SQUARE INCH GAUGE
CU	COPPER	PVC	POLYVINYL CHLORIDE
CW	COLD WATER (DOMESTIC)	RD	ROOF DRAIN
D	DRAIN	RL	RAIN LEADER
DIA	DIAMETER	RO	REVERSE OSMOSIS WATER
DFU	DRAINAGE FIXTURE UNIT	RPZ	REDUCED PRESSURE ZONE BACKFLOW PREVENTER
DN	DOWN	SAN	SANITARY SEWER
DPCO	DECK PLATE CLEANOUT	SMACNA	SHEET METAL AND AIR CONDITIONING CONTRACTORS NATIONAL ASSOCIATION
DWG	DRAWING	SCFM	STANDARD CUBIC FOOT/MINUTE
DWH	DOMESTIC WATER HEATER	SCW	SOFTENED COLD WATER
DWV	DRAIN WASTE VENT	SP	SUMP PUMP
EC	ELECTRICAL CONTRACTOR	SOFT	SQUARE FEET
EL	ELEVATION	SS	STAINLESS STEEL
ET	EXPANSION TANK	ST	STORM SEWER
EWC	ELECTRIC WATER COOLER	T&P	TEMPERATURE & PRESSURE (RELIEF VALVE)
EXIST	EXISTING	TD	TRENCH DRAIN
F	FAHRENHEIT	TDH	TOTAL DYNAMIC HEAD
FD	FLOOR DRAIN	TEMP	TEMPERATURE/TEMPORARY
FU	FIXTURE UNITS	TMV	THERMOSTATIC MIXING VALVE
FV	FLUSH VALVE	TP	TRAP PRIMER
G	NATURAL GAS	TSTAT	THERMOSTAT
GAL	GALLON	TW	TEMPERED WATER
GALV	GALVANIZED	TYP	TYPICAL
GC	GENERAL CONTRACTOR	UC	UNDERCUT
GPH	GALLONS PER HOUR	UH	UNIT HEATER
GPM	GALLONS PER MINUTE	UL	UNDERWRITERS LABORATORY
H&CW	HOT AND COLD WATER	UPC	UNIFORM PLUMBING CODE
HB	HOSE BIBB	UR	URINAL
HC	HEATING & HVAC CONTRACTOR	V	VENT
HD	HUB DRAIN	VB	VACUUM BREAKER
HP	HORSEPOWER	VTR	VENT THROUGH ROOF
HS	HAND SINK	WC	WATER CLOSET
HW	HOT WATER (DOMESTIC)	WCO	WALL CLEANOUT
INV	INVERT	WH	WALL HYDRANT
IC	IRRIGATION CONTRACTOR	WHA	WATER HAMMER ARRESTER
		WSFU	WATER SUPPLY FIXTURE UNIT
		XA	EXHAUST AIR

PLUMBING SYMBOLS			
	- NEW PIPING AND EQUIPMENT		- GAUGE WITH BALL VALVE
	- EXISTING TO REMAIN PIPING AND EQUIPMENT		- AUTOMATIC AIR VENT
	- PIPING AND EQUIPMENT FOR REMOVAL		- MANUAL AIR VENT
	- BALL VALVE		- THERMOMETER
	- BALL VALVE (HOSE END & CAP)		- BUTTERFLY VALVE
	- BALANCING VALVE		- PIPE CAP
	- CHECK VALVE		- END OF LINE CLEAN OUT
	- CONTROL VALVE - 2 WAY		- HOSE BIBB
	- DRAIN VALVE WITH HOSE BIBB		- FLOOR DRAIN
	- FLANGED CONNECTION		- FLOOR DRAIN WITH P-TRAP
	- FUSIBLE LINK OIL SHUTOFF VALVE		- DECK PLATE CLEAN OUT
	- FLOW CONTROL VALVE		- GAS OUTLET
	- GATE VALVE		- WATER HAMMER ARRESTOR
	- GLOBE VALVE		- WALL HYDRANT
	- GAS COCK		- VACUUM BREAKER
	- LUBRICATED PLUG VALVE		- INLINE PUMP
	- PRESSURE REDUCING VALVE		- WATER METER
	- RELIEF VALVE		- SUCTION DIFFUSER
	- STRAINER WITH BLOWDOWN		- FLEXIBLE CONNECTOR
	- STRAINER WITH BLOWDOWN		- PIPE BREAK
	- SOLENOID VALVE		- PIPE FLOW ARROW
	- THREE-WAY CONTROL VALVE		- REVISION/KEYED NOTE
	- TRIPLE DUTY GLOBE VALVE		- KEYED NOTE
	- UNION		- KEYED NOTE
	- REDUCER OR INCREASER		- KEYED NOTE
	- BRANCH FROM BOTTOM OF PIPE		- POINT OF NEW CONNECTION
	- BRANCH FROM TOP OF PIPE		- LIMIT OF REMOVAL
	- PIPE ELBOW DN		- SAW CUT FLOOR
	- PIPE ELBOW UP		
	PIPE FLOW ARROW		
	BELOW SLAB PIPING		
	CW		
	HW		
	HWC		
	IW		
	SAN		
	D		
	V		
	G		
	SAN		
	SLEEVE		

- GENERAL PLUMBING NOTES:
- DRAWINGS ARE DIAGRAMMATIC AND INDICATE GENERAL ARRANGEMENT OF SYSTEMS AND WORK INCLUDED IN THE CONTRACT. IT IS NOT INTENDED TO SPECIFY OR SHOW EVERY OFFSET, FITTING OR COMPONENT; HOWEVER, CONTRACT DOCUMENTS REQUIRE COMPONENTS AND MATERIALS WHETHER OR NOT INDICATED OR SPECIFICALLY SPECIFIED TO MAKE THE SYSTEMS BEING INSTALLED COMPLETE, CODE COMPLIANT, TESTED AND OPERATIONAL.
  - CONTRACTOR SHALL FIELD VERIFY ALL LOCATIONS, DIMENSIONS AND ELEVATIONS PRIOR TO CONSTRUCTION.
  - ALL MATERIALS, EQUIPMENT, METHODS OF INSTALLATION, REMOVALS AND DISPOSAL SHALL BE IN ACCORDANCE WITH THE STANDARDS, REGULATIONS, CODES, ORDINANCES, AND LAWS OF LOCAL, STATE, AND FEDERAL GOVERNMENTS, AND OTHER AUTHORITIES THAT HAVE LAWFUL JURISDICTION.
  - PERFORM WORK, PROVIDE MATERIALS AND EQUIPMENT FOR SYSTEMS SHOWN, SPECIFIED AND DESCRIBED ON DRAWINGS. COMPLETELY COORDINATE ALL TRADES OF THIS CONTRACT AND PROVIDE COMPLETE AND FULLY FUNCTIONAL INSTALLATION. ALL WORK IN THIS SET TO BE COMPLETED UNDER THIS CONTRACT, UNLESS OTHERWISE INDICATED.
  - PROTECT ALL EXISTING AND NEW BUILDING ELEMENTS FROM DAMAGE. CONTRACTOR SHALL RESTORE ALL DAMAGED ELEMENTS TO ORIGINAL OR BETTER CONDITION.
  - WORK SHALL BE EXECUTED IN A WORKMANLIKE MANNER AND SHALL PRESENT NEAT, RECTILINEAR APPEARANCE WHEN COMPLETED. MAINTAIN MAXIMUM HEAD ROOM AT ALL TIMES. DO NOT RUN PIPES, DUCTS, AND CONDUIT EXPOSED UNLESS SHOWN AND NOTED TO BE EXPOSED ON DRAWINGS.
  - MATERIALS AND EQUIPMENT SHALL BE NEW AND INSTALLED ACCORDING TO MANUFACTURER'S INSTRUCTIONS AND RECOMMENDATIONS. MAINTAIN MANUFACTURER'S EQUIPMENT CLEARANCES.
  - CONTRACTOR IS RESPONSIBLE FOR ALL WORK RELATED TO ISOLATING, SHUTTING DOWN, DRAINING, FILLING AND TESTING SYSTEMS TO ALLOW FOR COMPLETION OF WORK. INTERRUPTIONS TO EXISTING SERVICES AND SYSTEMS SHALL BE AS SHORT AS POSSIBLE AND AT A TIME AND DURATION APPROVED BY THE OWNER AND UTILITY AS APPLICABLE. INCLUDE ALL PREMIUM TIME ASSOCIATED WITH INTERRUPTIONS. ALL SYSTEM INTERRUPTIONS SHALL BE SCHEDULED WITH OWNER, UTILITY AND COORDINATED WITH OTHER TRADE WORK.
  - ALL EQUIPMENT PIPING, WIRING, INSULATION ETC. INSTALLED IN HVAC AIR PLENUM SPACES SHALL MEET CODE REQUIREMENTS FOR SMOKE AND COMBUSTIBILITY.
  - SEAL ALL PENETRATIONS THROUGH FIRE RATED WALLS, PARTITIONS AND FLOORS WITH UL RATED MATERIALS/METHODS EQUIVALENT TO FIRE RATING OF ASSEMBLY.
  - PROVIDE PROPER ACCESS TO EQUIPMENT THAT REQUIRES INSPECTION, REPLACEMENT OR REPAIR. ACCESS PANELS/DOORS SHALL BE A MINIMUM OF 12"x12", UNLESS OTHERWISE NOTED.
  - DO NOT SUPPORT EQUIPMENT FROM SUSPENDED CEILINGS. ALL SUPPORT SHALL BE FROM BUILDING STRUCTURE OR FROM CEILING SUSPENSION SYSTEM WHICH HAS BEEN REINFORCED. SUPPORTS SHALL BE SELECTED AND INSTALLED TO PROVIDE A VIBRATION FREE INSTALLATION.
  - PLUMBING CONTRACTOR IS RESPONSIBLE FOR JETTING/SNAKING ALL SANITARY WASTE LINES (ALL FLOOR DRAINS) SHOWN ON THE DRAWINGS TO BE FULLY OPERATIONAL. (AS APPLICABLE)
  - CLEANING DURING PLUMBING WORK: THE MECHANICAL ROOM AND ROOMS WHERE WORK WILL BE DONE TO MINIMIZE DISTURBANCE IN THE BUILDINGS. WORKERS ARE TO USE PATHWAYS AND FACILITIES AGREED UPON WITH THE DISTRICT DESIGNEE IN WRITING. THE AREA OUTSIDE THE BUILDING WHERE CUTTING, WELDING OR STORAGE IS ALLOWED IS TO BE FENCED AT ALL TIMES. THE CONTRACTOR WILL ON A DAILY BASIS CLEAN THE GROUNDS AND THE BUILDING OF ANY DEBRIS OR GARBAGE GENERATED BY THEIR WORK.
  - EACH CONTRACTOR RESPONSIBLE FOR RETURNING WALLS, CEILINGS AND SURFACES THEY DISTURB THAT ARE NOT SCHEDULED FOR REPLACEMENT BACK TO ORIGINAL CONDITIONS.

IT IS A VIOLATION OF THE LAW FOR ANY PERSON UNLESS HE IS ACTING UNDER THE DIRECTION OF A LICENSED PROFESSIONAL ARCHITECT/ENGINEER TO SEAL OR SIGN ANY DRAWING OR SPECIFICATION. ANY PERSON WHO VIOLATES THIS PROVISION SHALL BE SUBJECT TO A FINE OF \$1,000.00 AND/OR IMPRISONMENT FOR A TERM OF UP TO 1 YEAR.

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STATE OF NEW YORK  
JACK D'ANGELO  
No. 059447  
REGISTERED PROFESSIONAL ENGINEER

WARWICK VALLEY CENTRAL SCHOOL DISTRICT  
HIGH SCHOOL UNIT VENTILATOR REPLACEMENT AND  
AIR CONDITIONING UPGRADE  
225 WEST STREET EXT. WARWICK, NY 10990  
WV HIGH SCHOOL - 89 SANFORDVILLE ROAD, WARWICK, NY 10990  
SED NO. 44-21-01-06-0-001-042


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ISSUED FOR BID	11.09.2022
SET	10.19.2022
REVISION	DATE
DRAWN BY	
CHECKED BY	
SHEET SIZE	30" X 42"
SCALE	AS NOTED

ABBREVIATIONS  
AND NOTES

SHEET NO.


P-001



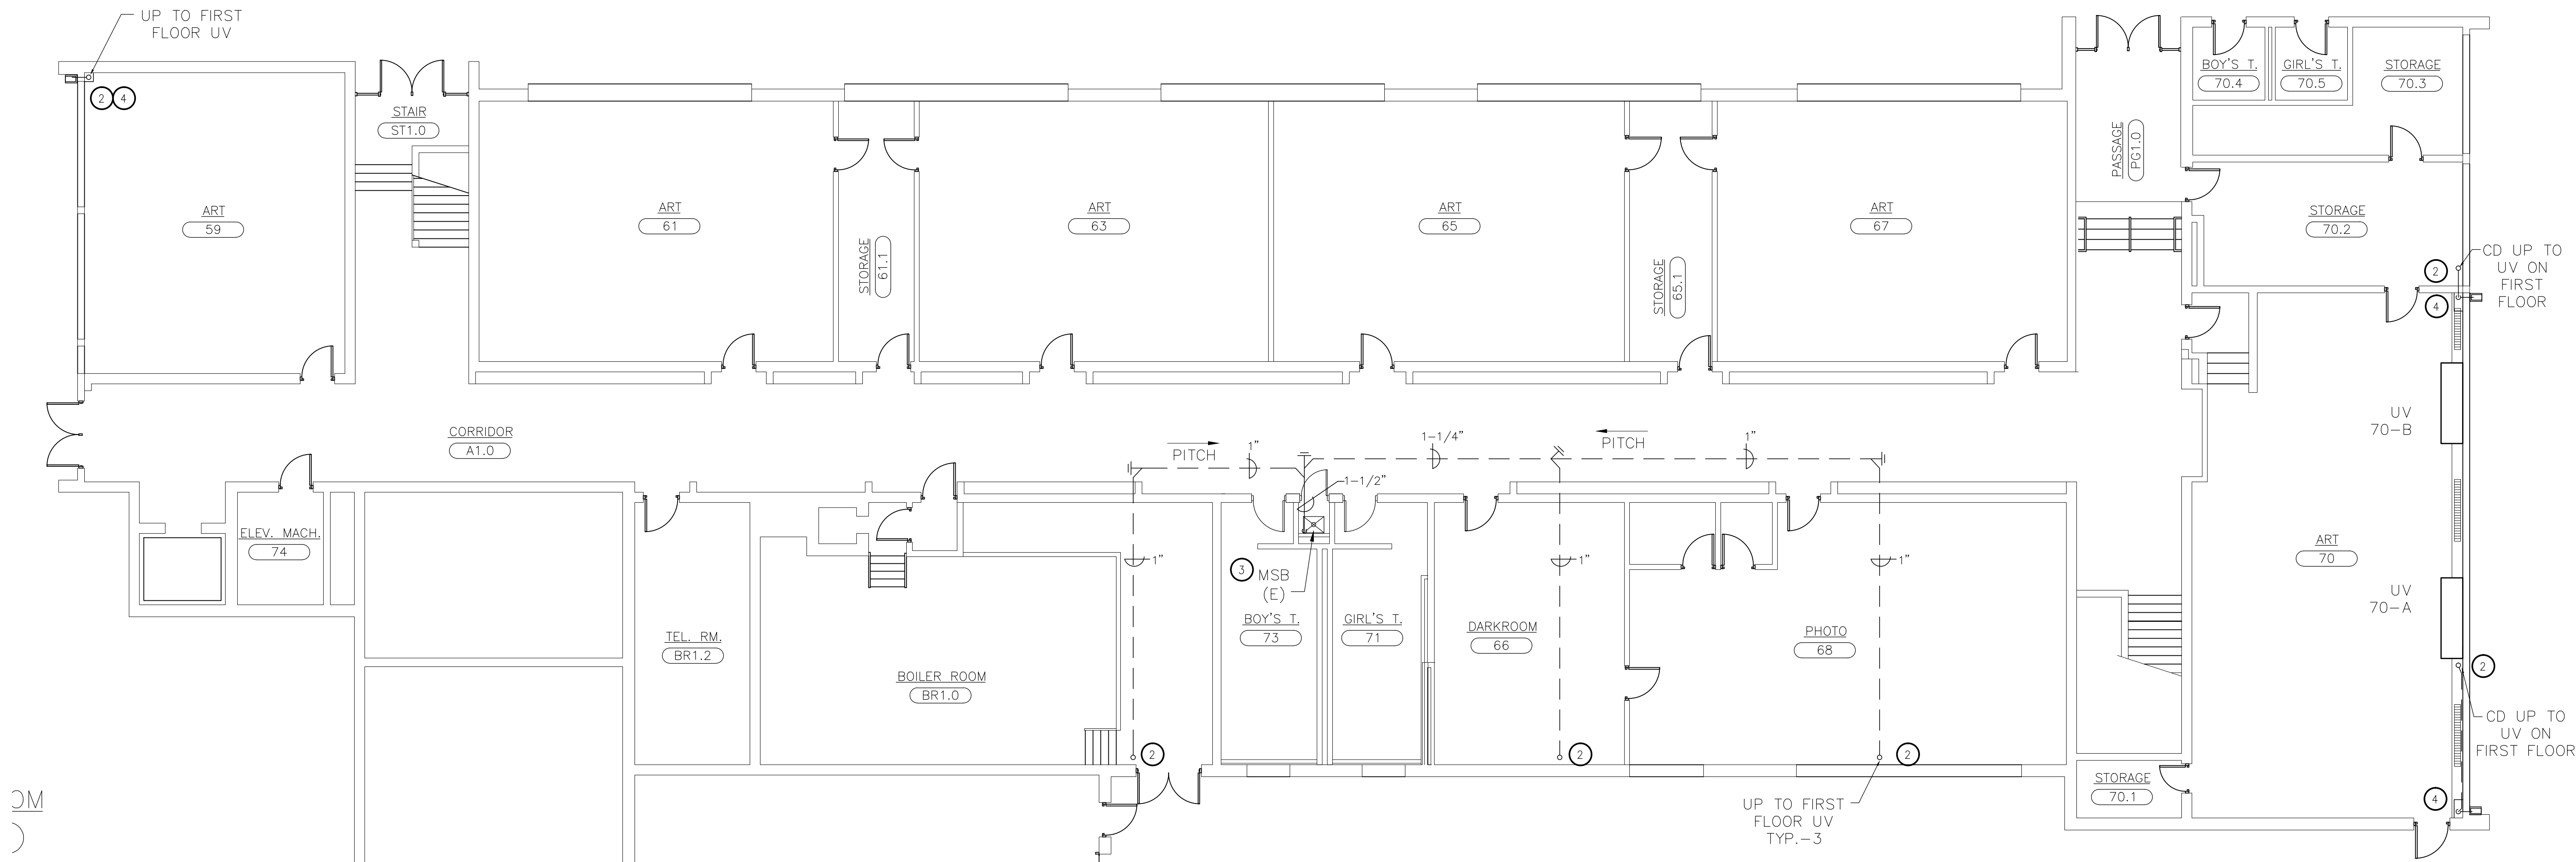

1 PARTIAL BASEMENT FLOOR PLAN - NEW WORK  
SCALE: 1/8"=1'-0"

ALL WORK THIS AREA PART OF ALTERNATE ALT. H-3

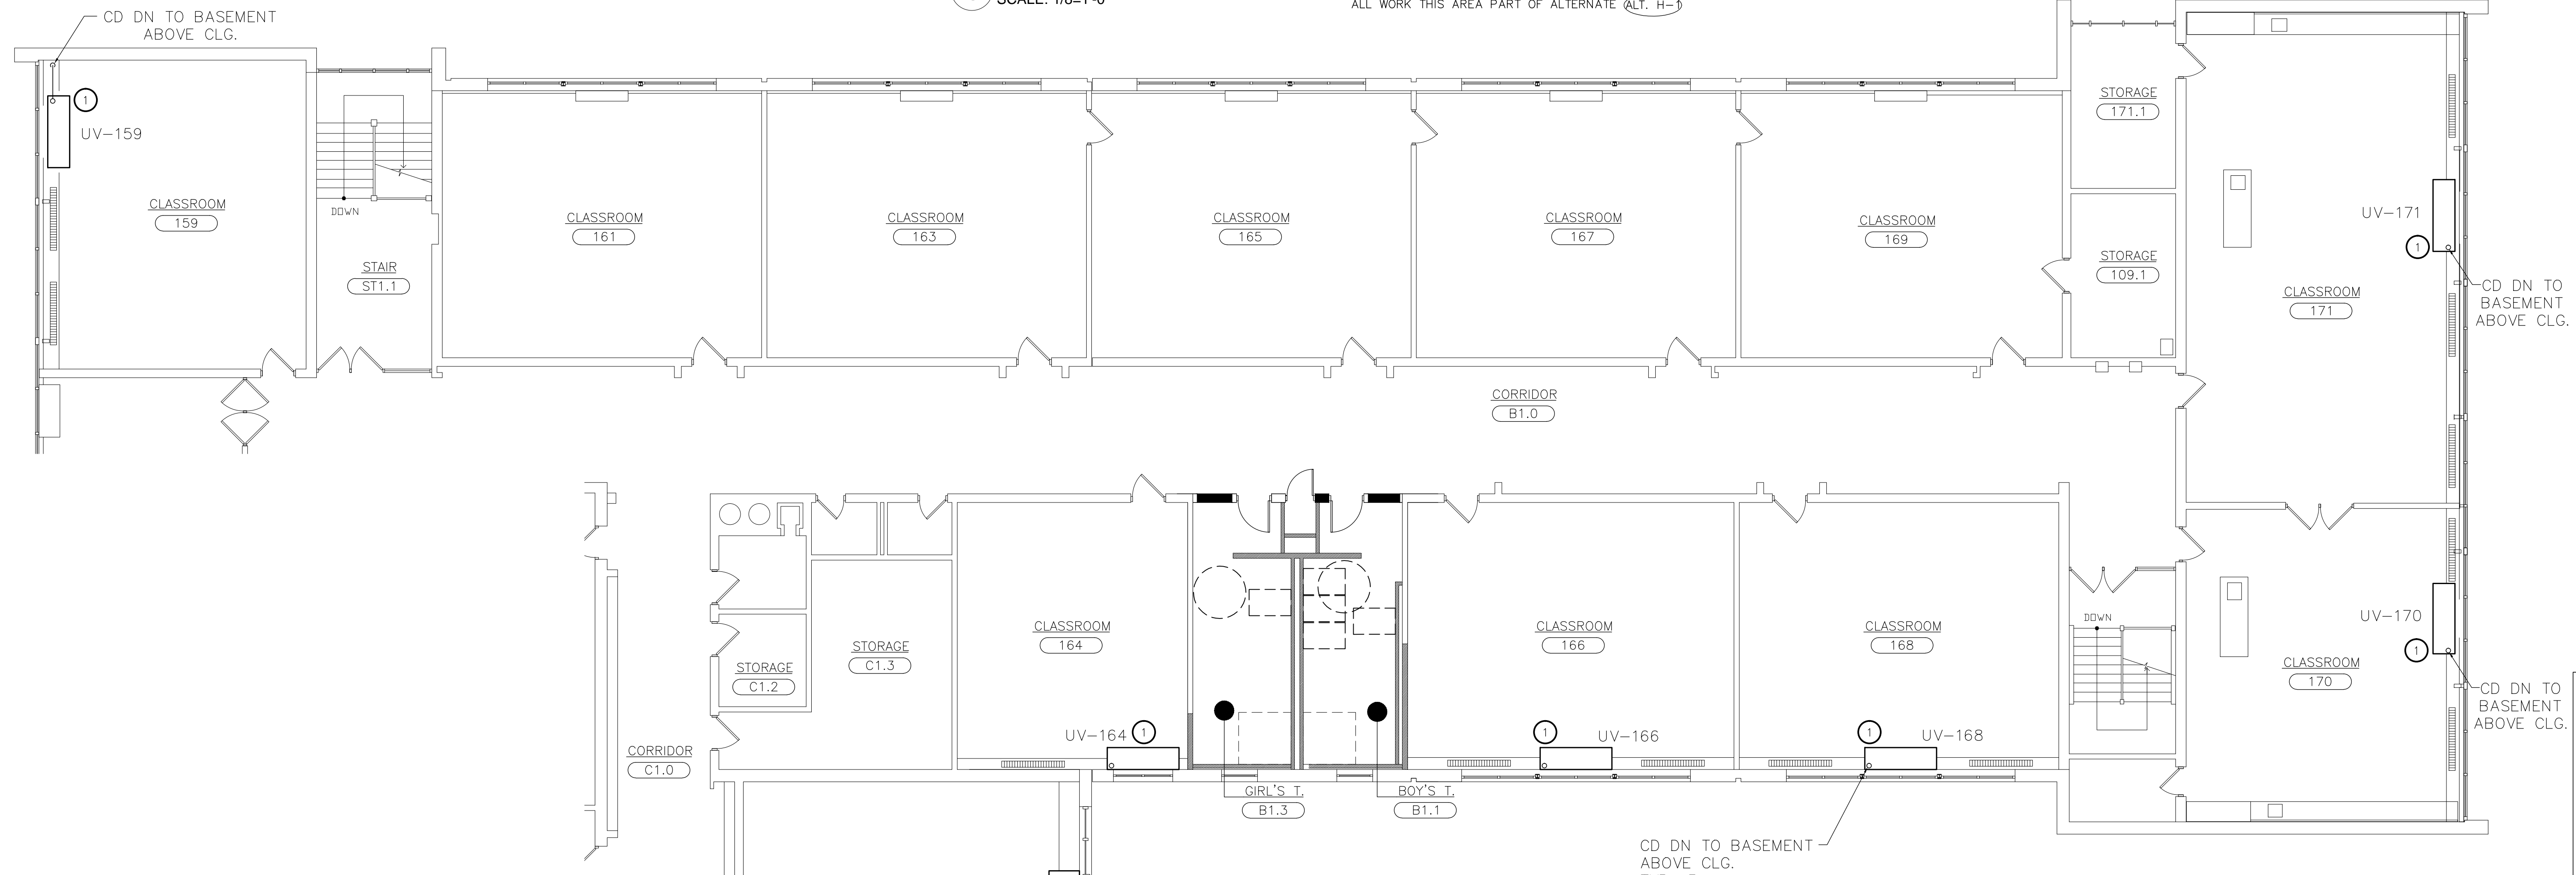

2 PARTIAL FIRST FLOOR PLAN - NEW WORK  
SCALE: 1/8"=1'-0"


ALL WORK THIS AREA PART OF ALTERNATE ALT. H-3

KEYED NOTES - NEW WORK:


- 1 PROVIDE AND CONNECT CONDENSATE PIPING TO INDICATED NEW UVS.
- 2 PROVIDE PVC CONDENSATE PIPING AND CLEANOUTS TO TIE INTO UVS ON THE FLOOR ABOVE. RUN PIPING ABOVE DROP CEILINGS WITH 1/8" PER FOOT PITCH.
- 3 TERMINATE CONDENSATE PIPING AT MSB INDICATED. SEE DETAILS FOR MORE INFORMATION.
- 4 DROP CONDENSATE PIPING INSIDE NEW PIPE CHASE AND TERMINATE OUTSIDE WITH COPPER ELBOW AS SHOWN. MAKE PENETRATIONS TO EXTERIOR WEATHERTIGHT. INSTALL SPLASHBLOCKS ON GRADE SLOPED AWAY FROM FOUNDATION. SEE DETAILS FOR MORE INFORMATION. MECHANICAL CONTRACTOR TO PROVIDE SHEET METAL PIPE CHASE AND FURNISH P.C. WITH SPLASHBLOCKS.

GENERAL NOTES:

1. PROVIDE ALL ALTERATIONS, RESTORATIONS, AND REPLACEMENTS NECESSARY TO ACCOMMODATE NEW WORK.
2. PROVIDE FIRESTOP AT ALL INTERIOR WALL AND FLOOR PENETRATIONS.
3. DRAWINGS INDICATE GENERAL DESIGN INTENT ONLY. VERIFY FIELD CONDITIONS BEFORE ORDERING MATERIALS AND EQUIPMENT. IDENTIFY CONFLICTS AND SUBMIT IN WRITING TO ENGINEER.

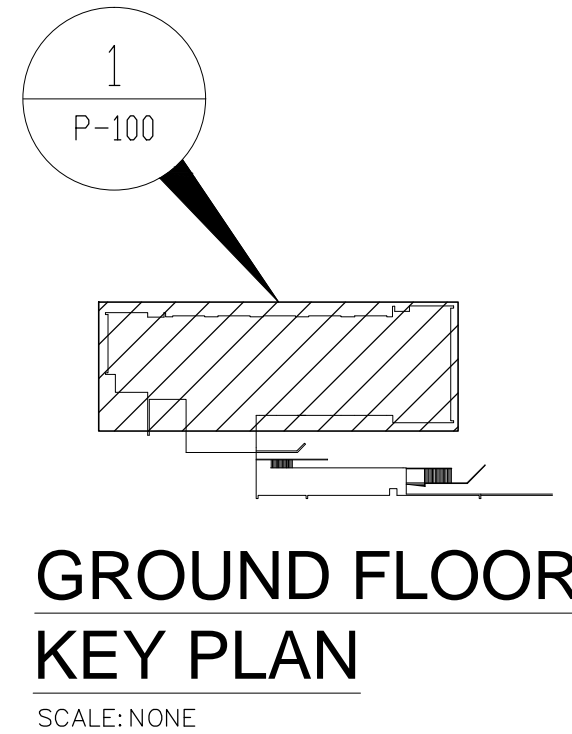

GROUND FLOOR KEY PLAN  
SCALE: NONE

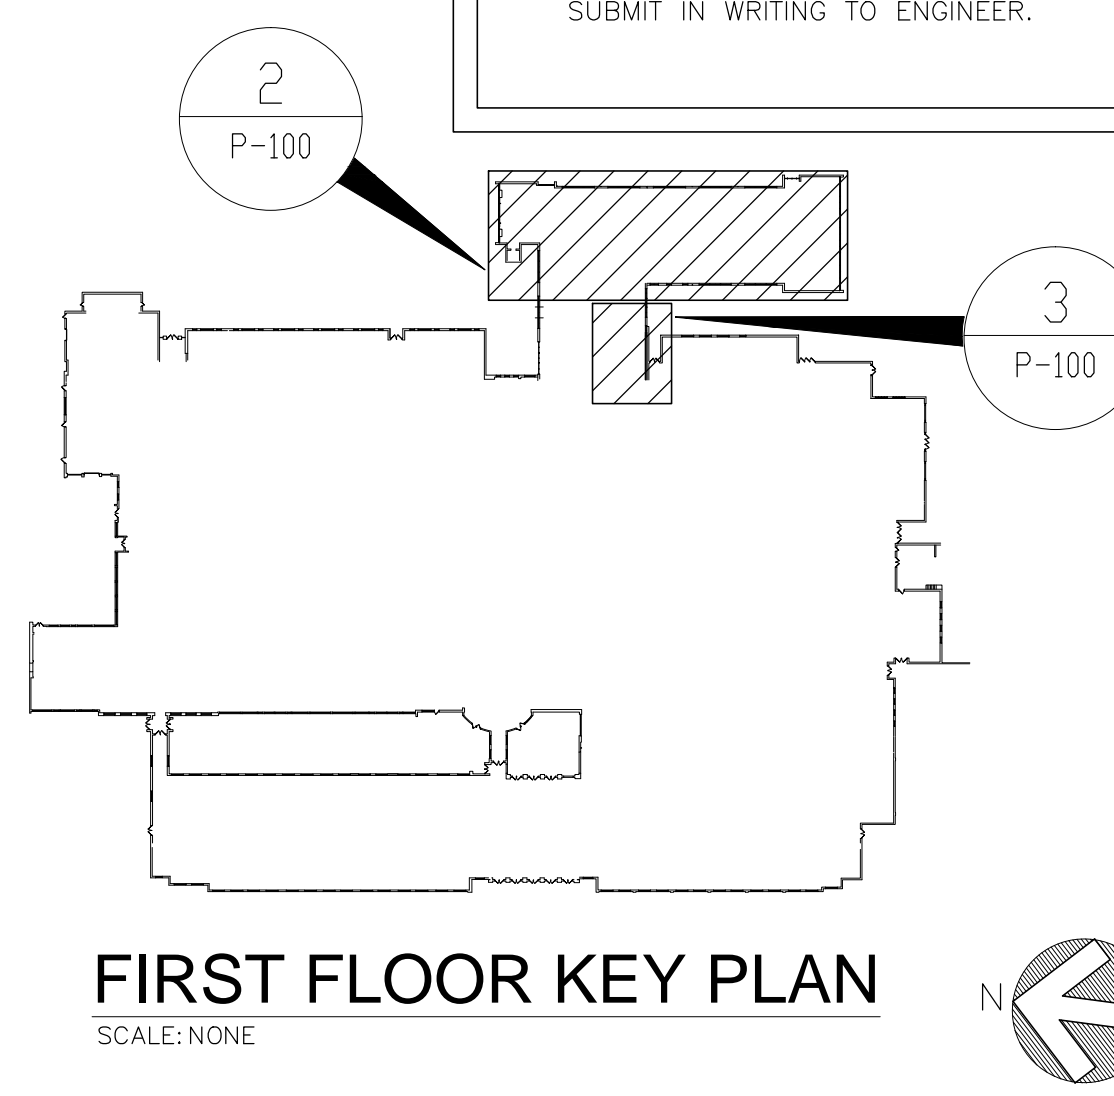

FIRST FLOOR KEY PLAN  
SCALE: NONE

ENGINEER:  
**Eisenbach & Ruhke Engineering, P.C.**  
291 Cassadaga Street - Utica, NY 13501  
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STAMP  
STATE OF NEW YORK  
JACK G. D'ANGELO  
No. 059447  
REGISTERED PROFESSIONAL ENGINEER


WARWICK VALLEY CENTRAL SCHOOL DISTRICT  
HIGH SCHOOL UNIT VENTILATOR REPLACEMENT AND  
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REVISION	DATE
DRAWN BY	
CHECKED BY	
SHEET SIZE	30" X 42"
SCALE	AS NOTED

SHEET TITLE  
PARTIAL BASEMENT  
AND FIRST FLOOR  
PLANS - NEW WORK

SHEET NO.  
**P-100**

FILE PATH - N:\1 - PROJECT DIRECTORIES\1 - E & R Projects\05 - Warwick Valley CSD\05-21-04 Warwick Federal Grant Project\05-21-04 P-100-P-102.dwg

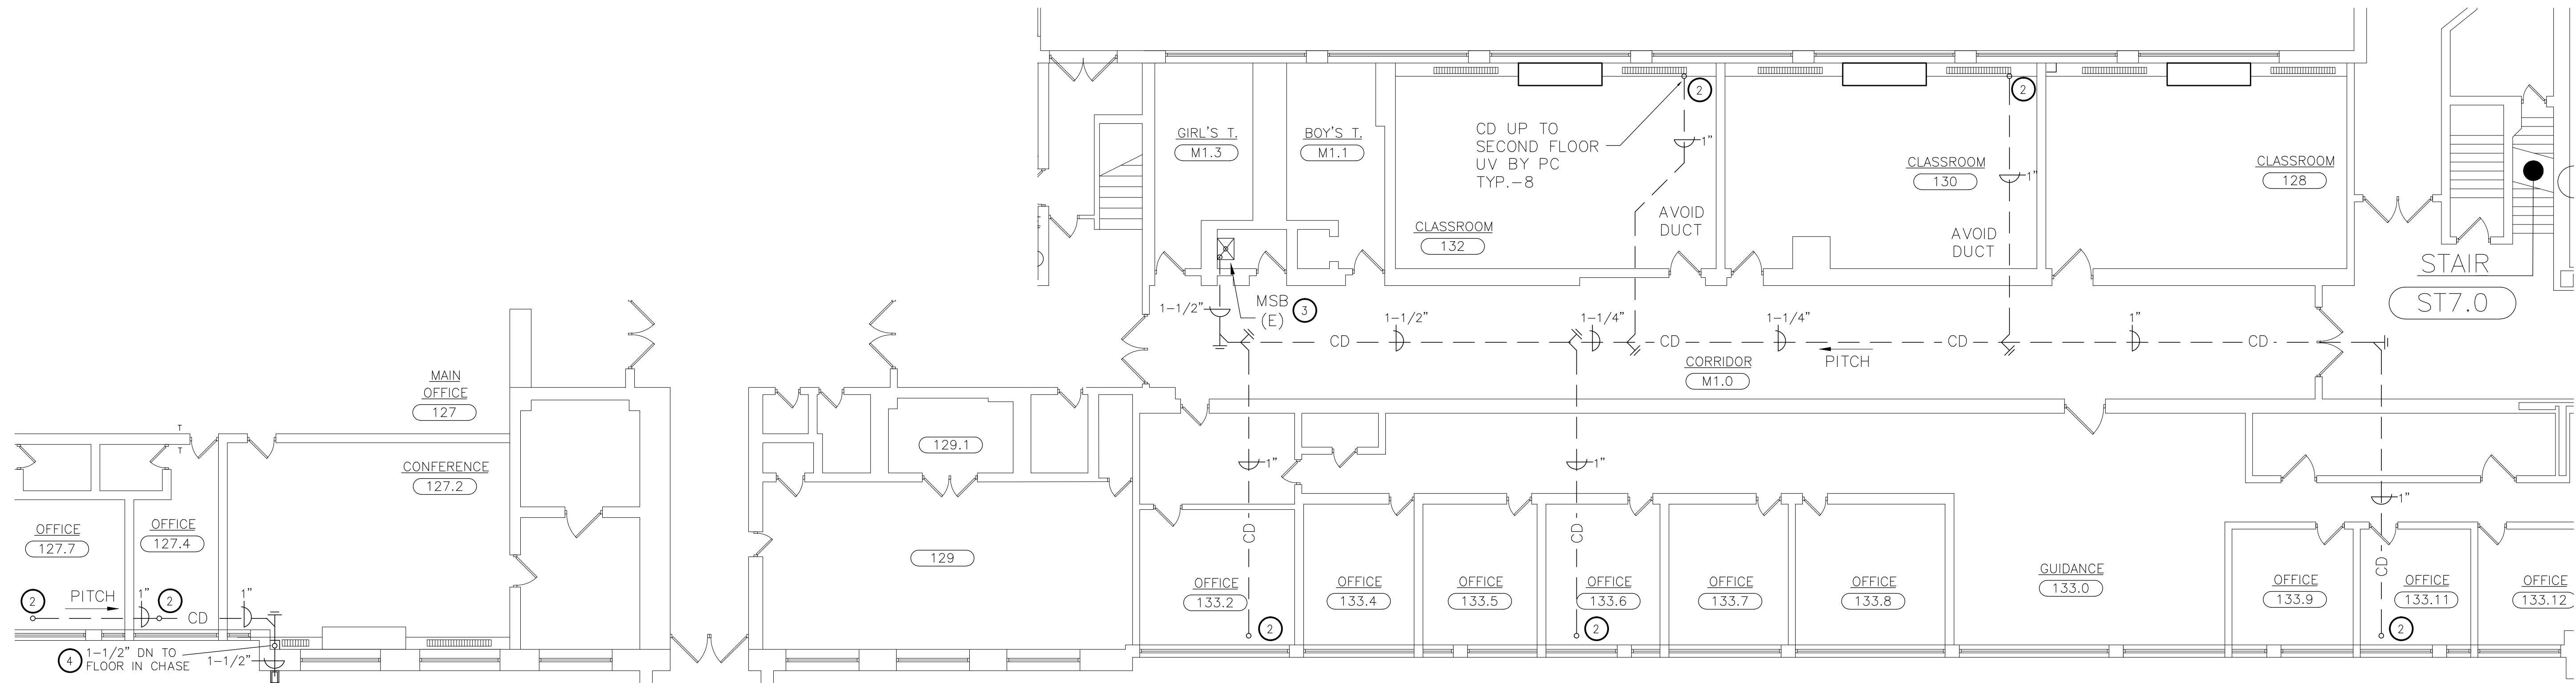


**1 PARTIAL FIRST FLOOR PLAN - NEW WORK**  
SCALE: 1/8"=1'-0"

**KEYED NOTES - NEW WORK:**


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- 4 DROP CONDENSATE PIPING INSIDE NEW PIPE CHASE AND TERMINATE OUTSIDE WITH COPPER ELBOW AS SHOWN. MAKE PENETRATIONS TO EXTERIOR WEATHERTIGHT. INSTALL SPLASHBLOCKS ON GRADE SLOPED AWAY FROM FOUNDATION. SEE DETAILS FOR MORE INFORMATION. MECHANICAL CONTRACTOR TO PROVIDE SHEET METAL PIPE CHASE AND FURNISH P.C. WITH SPLASHBLOCKS.

**GENERAL NOTES:**

1. PROVIDE ALL ALTERATIONS, RESTORATIONS, AND REPLACEMENTS NECESSARY TO ACCOMMODATE NEW WORK.
2. PROVIDE FIRESTOP AT ALL INTERIOR WALL AND FLOOR PENETRATIONS.
3. DRAWINGS INDICATE GENERAL DESIGN INTENT ONLY. VERIFY FIELD CONDITIONS BEFORE ORDERING MATERIALS AND EQUIPMENT. IDENTIFY CONFLICTS AND SUBMIT IN WRITING TO ENGINEER.

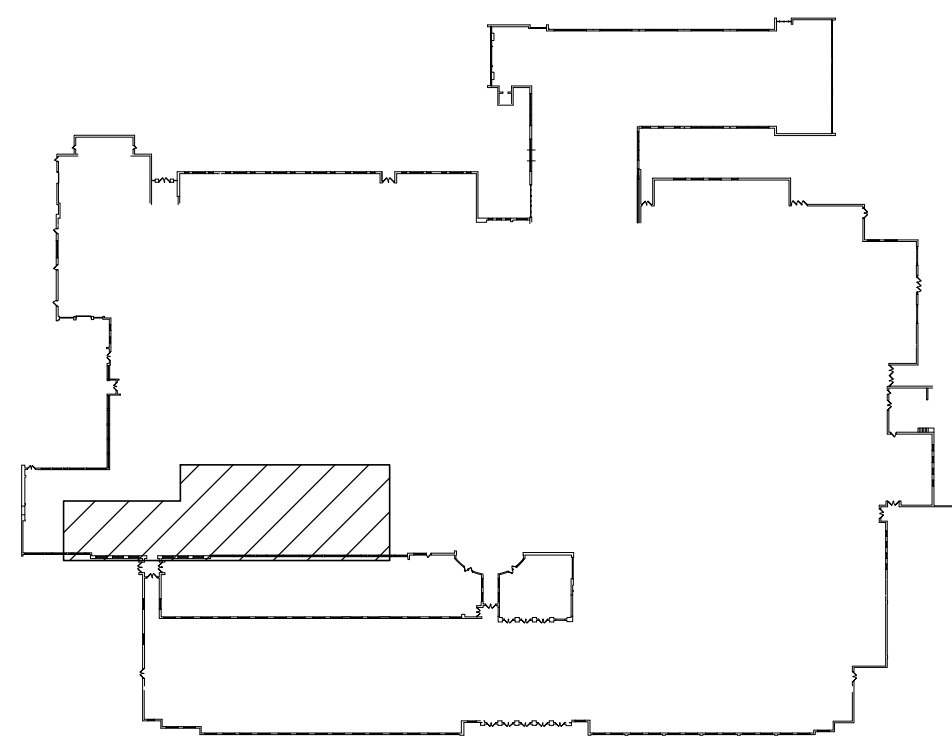


**FIRST FLOOR KEY PLAN**  
SCALE: NONE

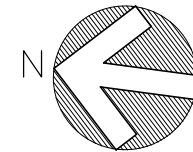

ENGINEER:  
**Eisenbach & Ruhke Engineering, P.C.**  
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**WARWICK VALLEY CENTRAL SCHOOL DISTRICT  
HIGH SCHOOL UNIT VENTILATOR REPLACEMENT AND  
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225 WEST STREET EXT. WARWICK, NY 10990  
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SED NO. 44-21-01-06-0-001-042

PROJECT NO.	05-21-04 05-20-06
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SED SET	10.19.2022
REVISION	DATE
DRAWN BY	
CHECKED BY	
SHEET SIZE	30" X 42"
SCALE	AS NOTED
SHEET TITLE	PARTIAL FIRST FLOOR PLAN - NEW WORK
SHEET NO.	

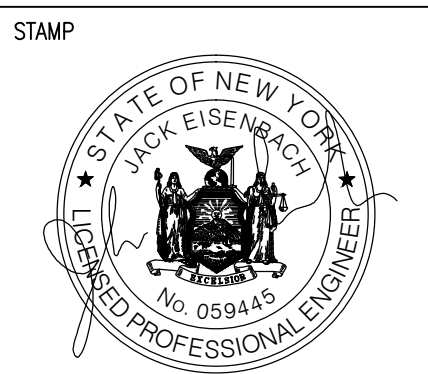**P-101**


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- |   |
|---|
| <p><u>GENERAL NOTES:</u></p> <ol style="list-style-type: none"> <li>1. PROVIDE ALL ALTERATIONS, RESTORATIONS, AND REPLACEMENTS NECESSARY TO ACCOMMODATE NEW WORK.</li> <li>2. PROVIDE FIRESTOP AT ALL INTERIOR WALL AND FLOOR PENETRATIONS.</li> <li>3. DRAWINGS INDICATE GENERAL DESIGN INTENT ONLY. VERIFY FIELD CONDITIONS BEFORE ORDERING MATERIALS AND EQUIPMENT. IDENTIFY CONFLICTS AND SUBMIT IN WRITING TO ENGINEER.</li> </ol> |
|---|



## SECOND FLOOR KEY PLAN



ALL INSULATION TO COMPLY WITH 2020 NYS ENERGY CONSERVATION CONSTRUCTION CODE

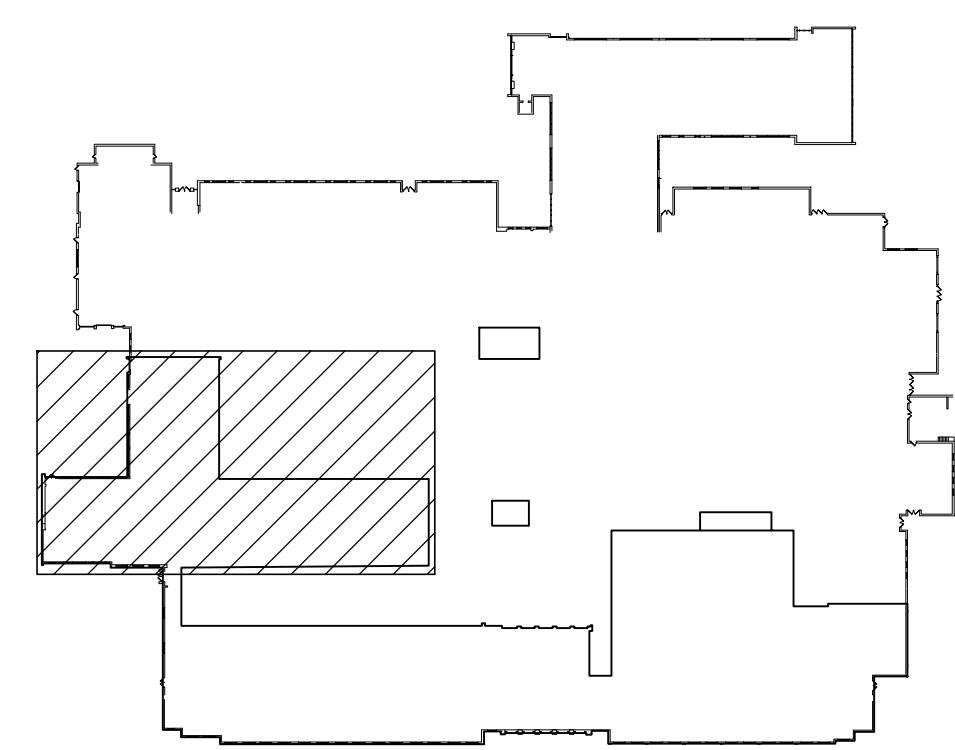

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SED NO. 44-21-01-06-0-001-042

SHEET NO.

P-500