

GENERAL PLUMBING NOTES:

- 1. DRAWINGS ARE DIAGRAMMATIC AND INDICATE GENERAL ARRANGEMENT OF SYSTEMS AND WORK INCLUDED IN THE CONTRACT. IT IS NOT INTENDED TO SPECIFY OR SHOW EVERY OFFSET, FITTING OR COMPONENT; HOWEVER, CONTRACT DOCUMENTS REQUIRE COMPONENTS AND MATERIALS WHETHER OR NOT INDICATED OR SPECIFICALLY SPECIFIED TO MAKE THE SYSTEMS BEING INSTALLED COMPLETE, CODE COMPLIANT, TESTED AND OPERATIONAL.
- 2. CONTRACTOR SHALL FIELD VERIFY ALL LOCATIONS, DIMENSIONS AND ELEVATIONS PRIOR TO CONSTRUCTION.
- 3. ALL MATERIALS, EQUIPMENT, METHODS OF INSTALLATION, REMOVALS AND DISPOSAL SHALL BE IN ACCORDANCE WITH THE STANDARDS, REGULATIONS, CODES, ORDINANCES, AND LAWS OF LOCAL, STATE, AND FEDERAL GOVERNMENTS, AND OTHER AUTHORITIES THAT HAVE LAWFUL JURISDICTION.
- 4. PERFORM WORK, PROVIDE MATERIALS AND EQUIPMENT FOR SYSTEMS SHOWN, SPECIFIED AND DESCRIBED ON DRAWINGS. COMPLETELY COORDINATE ALL TRADES OF THIS CONTRACT AND PROVIDE COMPLETE AND FULLY FUNCTIONAL INSTALLATION. ALL WORK IN THIS SET TO BE COMPLETED UNDER THIS CONTRACT, UNLESS OTHERWISE INDICATED.
- 5. PROTECT ALL EXISTING AND NEW BUILDING ELEMENTS FROM DAMAGE. CONTRACTOR SHALL RESTORE ALL DAMAGED ELEMENTS TO ORIGINAL OR BETTER CONDITION.
- 6. WORK SHALL BE EXECUTED IN A WORKMANLIKE MANNER AND SHALL PRESENT NEAT, RECTILINEAR APPEARANCE WHEN COMPLETED. MAINTAIN MAXIMUM HEAD ROOM AT ALL TIMES. DO NOT RUN PIPES, DUCTS, AND CONDUIT EXPOSED UNLESS SHOWN AND NOTED TO BE EXPOSED ON DRAWINGS.
- 7. MATERIALS AND EQUIPMENT SHALL BE NEW AND INSTALLED ACCORDING TO MANUFACTURER'S INSTRUCTIONS AND RECOMMENDATIONS. MAINTAIN MANUFACTURER'S EQUIPMENT CLEARANCES.
- 8. CONTRACTOR IS RESPONSIBLE FOR ALL WORK RELATED TO ISOLATING, SHUTTING DOWN, DRAINING, FILLING AND TESTING SYSTEMS TO ALLOW FOR COMPLETION OF WORK.
 INTERRUPTIONS TO EXISTING SERVICES AND SYSTEMS SHALL BE AS SHORT AS POSSIBLE AND AT A TIME AND DURATION APPROVED BY THE OWNER AND UTILITY AS APPLICABLE.
 INCLUDE ALL PREMIUM TIME ASSOCIATED WITH INTERRUPTIONS. ALL SYSTEM INTERRUPTIONS SHALL BE SCHEDULED WITH OWNER, UTILITY AND COORDINATED WITH OTHER TRADE WORK.
- 9. ALL EQUIPMENT PIPING, WIRING, INSULATION ETC. INSTALLED IN HVAC AIR PLENUM SPACES SHALL MEET CODE REQUIREMENTS FOR SMOKE AND COMBUSTIBILITY.
- 10. SEAL ALL PENETRATIONS THROUGH FIRE RATED WALLS, PARTITIONS AND FLOORS WITH UL RATED MATERIALS/METHODS EQUIVALENT TO FIRE RATING OF ASSEMBLY.
- 11. PROVIDE PROPER ACCESS TO EQUIPMENT THAT REQUIRES INSPECTION, REPLACEMENT OR REPAIR. ACCESS PANELS/DOORS SHALL BE A MINIMUM OF 12"X12", UNLESS OTHERWISE NOTED.
- 12. DO NOT SUPPORT EQUIPMENT FROM SUSPENDED CEILINGS.
 ALL SUPPORT SHALL BE FROM BUILDING STRUCTURE OR
 FROM CEILING SUSPENSION SYSTEM WHICH HAS BEEN
 REINFORCED. SUPPORTS SHALL BE SELECTED AND
 INSTALLED TO PROVIDE A VIBRATION FREE INSTALLATION.
- 13. PLUMBING CONTRACTOR IS RESPONSIBLE FOR
 JETTING/SNAKING ALL SANITARY WASTE LINES (ALL FLOOR
 DRAINS) SHOWN ON THE DRAWINGS TO BE FULLY
 OPERATIONAL. (AS APPLICABLE)
- 14. CLEANING DURING PLUMBING WORK: THE MECHANICAL ROOM AND ROOMS WHERE WORK WILL BE DONE TO MINIMIZE DISTURBANCE IN THE BUILDINGS. WORKERS ARE TO USE PATHWAYS AND FACILITIES AGREED UPON WITH THE DISTRICT DESIGNEE IN WRITING. THE AREA OUTSIDE THE BUILDING WHERE CUTTING, WELDING OR STORAGE IS ALLOWED IS TO BE FENCED AT ALL TIMES. THE CONTRACTOR WILL ON A DAILY BASIS CLEAN THE GROUNDS AND THE BUILDING OF ANY DEBRIS OR GARBAGE GENERATED BY THEIR WORK.
- 24. EACH CONTRACTOR RESPONSIBLE FOR RETURNING WALLS, CEILINGS AND SURFACES THEY DISTURB THAT ARE NOT SCHEDULED FOR REPLACEMENT BACK TO ORIGINAL CONDITIONS.

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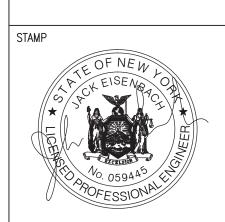
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ENGINEER:

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CK VALLEY CENTRAL SCHOOL D
HOOL UNIT VENTILATOR REPLACEMI
DITIONING UPGRADE

JEET EXT, WARWICK, NY 10990

OL - 89 SANFORDVILLE ROAD. WARWICK, NY 10990

WAR HIGH AIR CC 225 WEST W HIGH S

SHEET SIZE 30" X 42"

SCALE AS NOTED


SHEET TITLE

ABBREVIATIONS
AND NOTES

CHECKED BY

HFFT NO

P-001

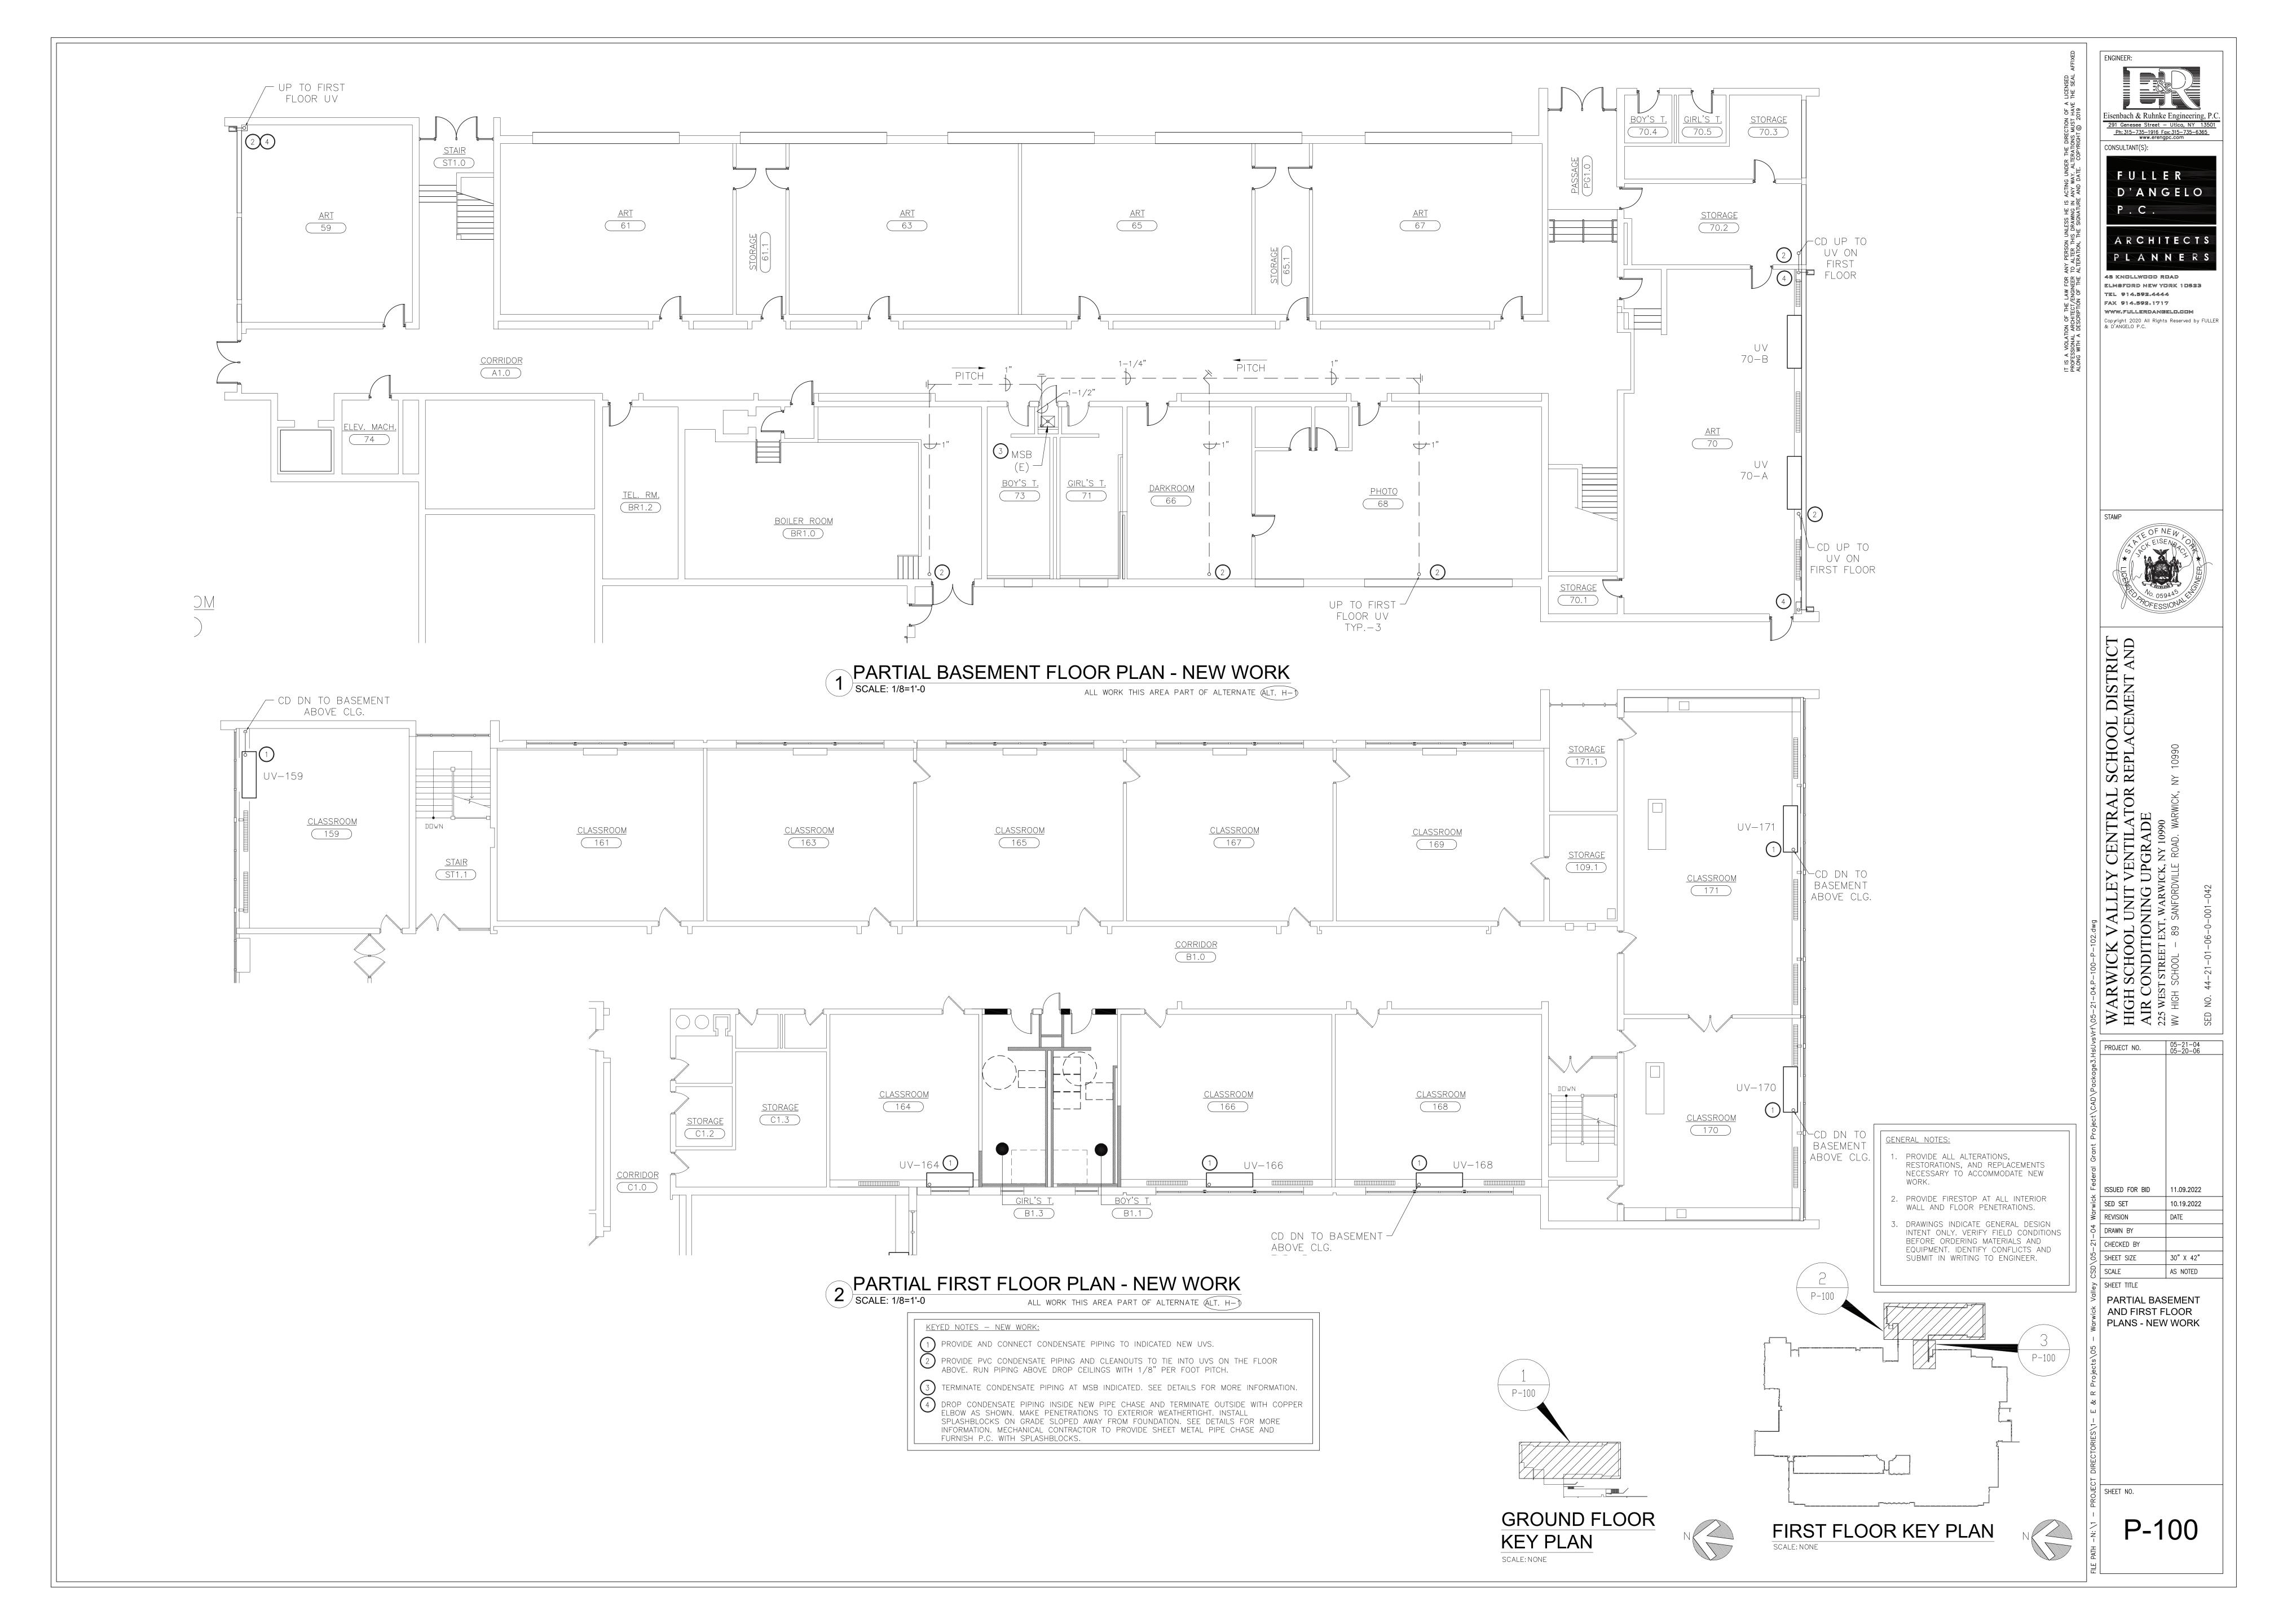

PARTIAL FIRST FLOOR PLAN - NEW WORK SCALE: 1/8=1'-0

KEYED NOTES - NEW WORK:

1) PROVIDE AND CONNECT CONDENSATE PIPING TO INDICATED NEW UVS.

PROVIDE PVC CONDENSATE PIPING AND CLEANOUTS TO TIE INTO UVS ON THE FLOOR ABOVE. RUN PIPING ABOVE DROP CEILINGS WITH 1/8" PER FOOT PITCH.

TERMINATE CONDENSATE PIPING AT MSB INDICATED. SEE DETAILS FOR MORE INFORMATION.

4 DROP CONDENSATE PIPING INSIDE NEW PIPE CHASE AND TERMINATE OUTSIDE WITH COPPER

DROP CONDENSATE PIPING INSIDE NEW PIPE CHASE AND TERMINATE OUTSIDE WITH COPPER ELBOW AS SHOWN. MAKE PENETRATIONS TO EXTERIOR WEATHERTIGHT. INSTALL SPLASHBLOCKS ON GRADE SLOPED AWAY FROM FOUNDATION. SEE DETAILS FOR MORE INFORMATION. MECHANICAL CONTRACTOR TO PROVIDE SHEET METAL PIPE CHASE AND FURNISH P.C. WITH SPLASHBLOCKS.


GENERAL NOTES:


1. PROVIDE ALL ALTERATIONS, RESTORATIONS, AND REPLACEMENTS NECESSARY TO ACCOMMODATE NEW WORK.

2. PROVIDE FIRESTOP AT ALL INTERIOR WALL AND FLOOR PENETRATIONS.

3. DRAWINGS INDICATE GENERAL DESIGN INTENT

3. DRAWINGS INDICATE GENERAL DESIGN INTENT ONLY. VERIFY FIELD CONDITIONS BEFORE ORDERING MATERIALS AND EQUIPMENT. IDENTIFY CONFLICTS AND SUBMIT IN WRITING TO ENGINEER.

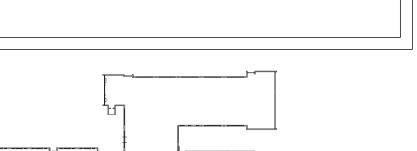

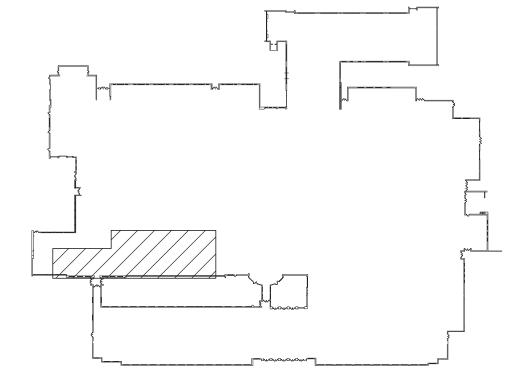

FIRST FLOOR KEY PLAN
SCALE: NONE



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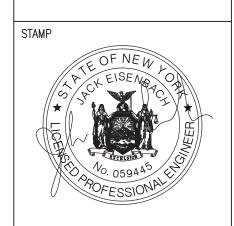
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WARWICK VALLEY CENTRAL SCHOOL DISTI HIGH SCHOOL UNIT VENTILATOR REPLACEMENT

AIR CONDITIONING UPGRADE

225 WEST STREET EXT, WARWICK, NY 10990


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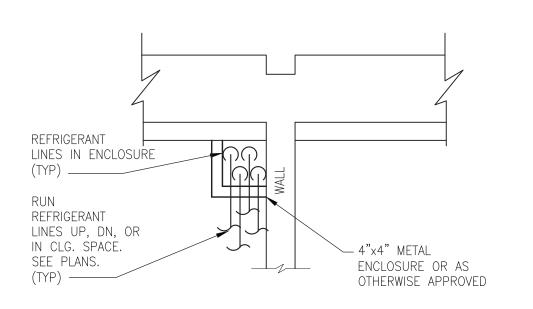
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<u>ب</u>	ISSUED FOR BID	11.09.2022				
wicl	SED SET	10.19.2022				
War	REVISION	DATE				
-04	DRAWN BY					
-21-	CHECKED BY					
05-	SHEET SIZE	30" X 42"				
Valley CSD\05-21-04	SCALE	AS NOTED				
ey	SHEET TITLE					
\al	PARTIAL FIRST FLOOR					


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PLAN - NEW WORK

P-101





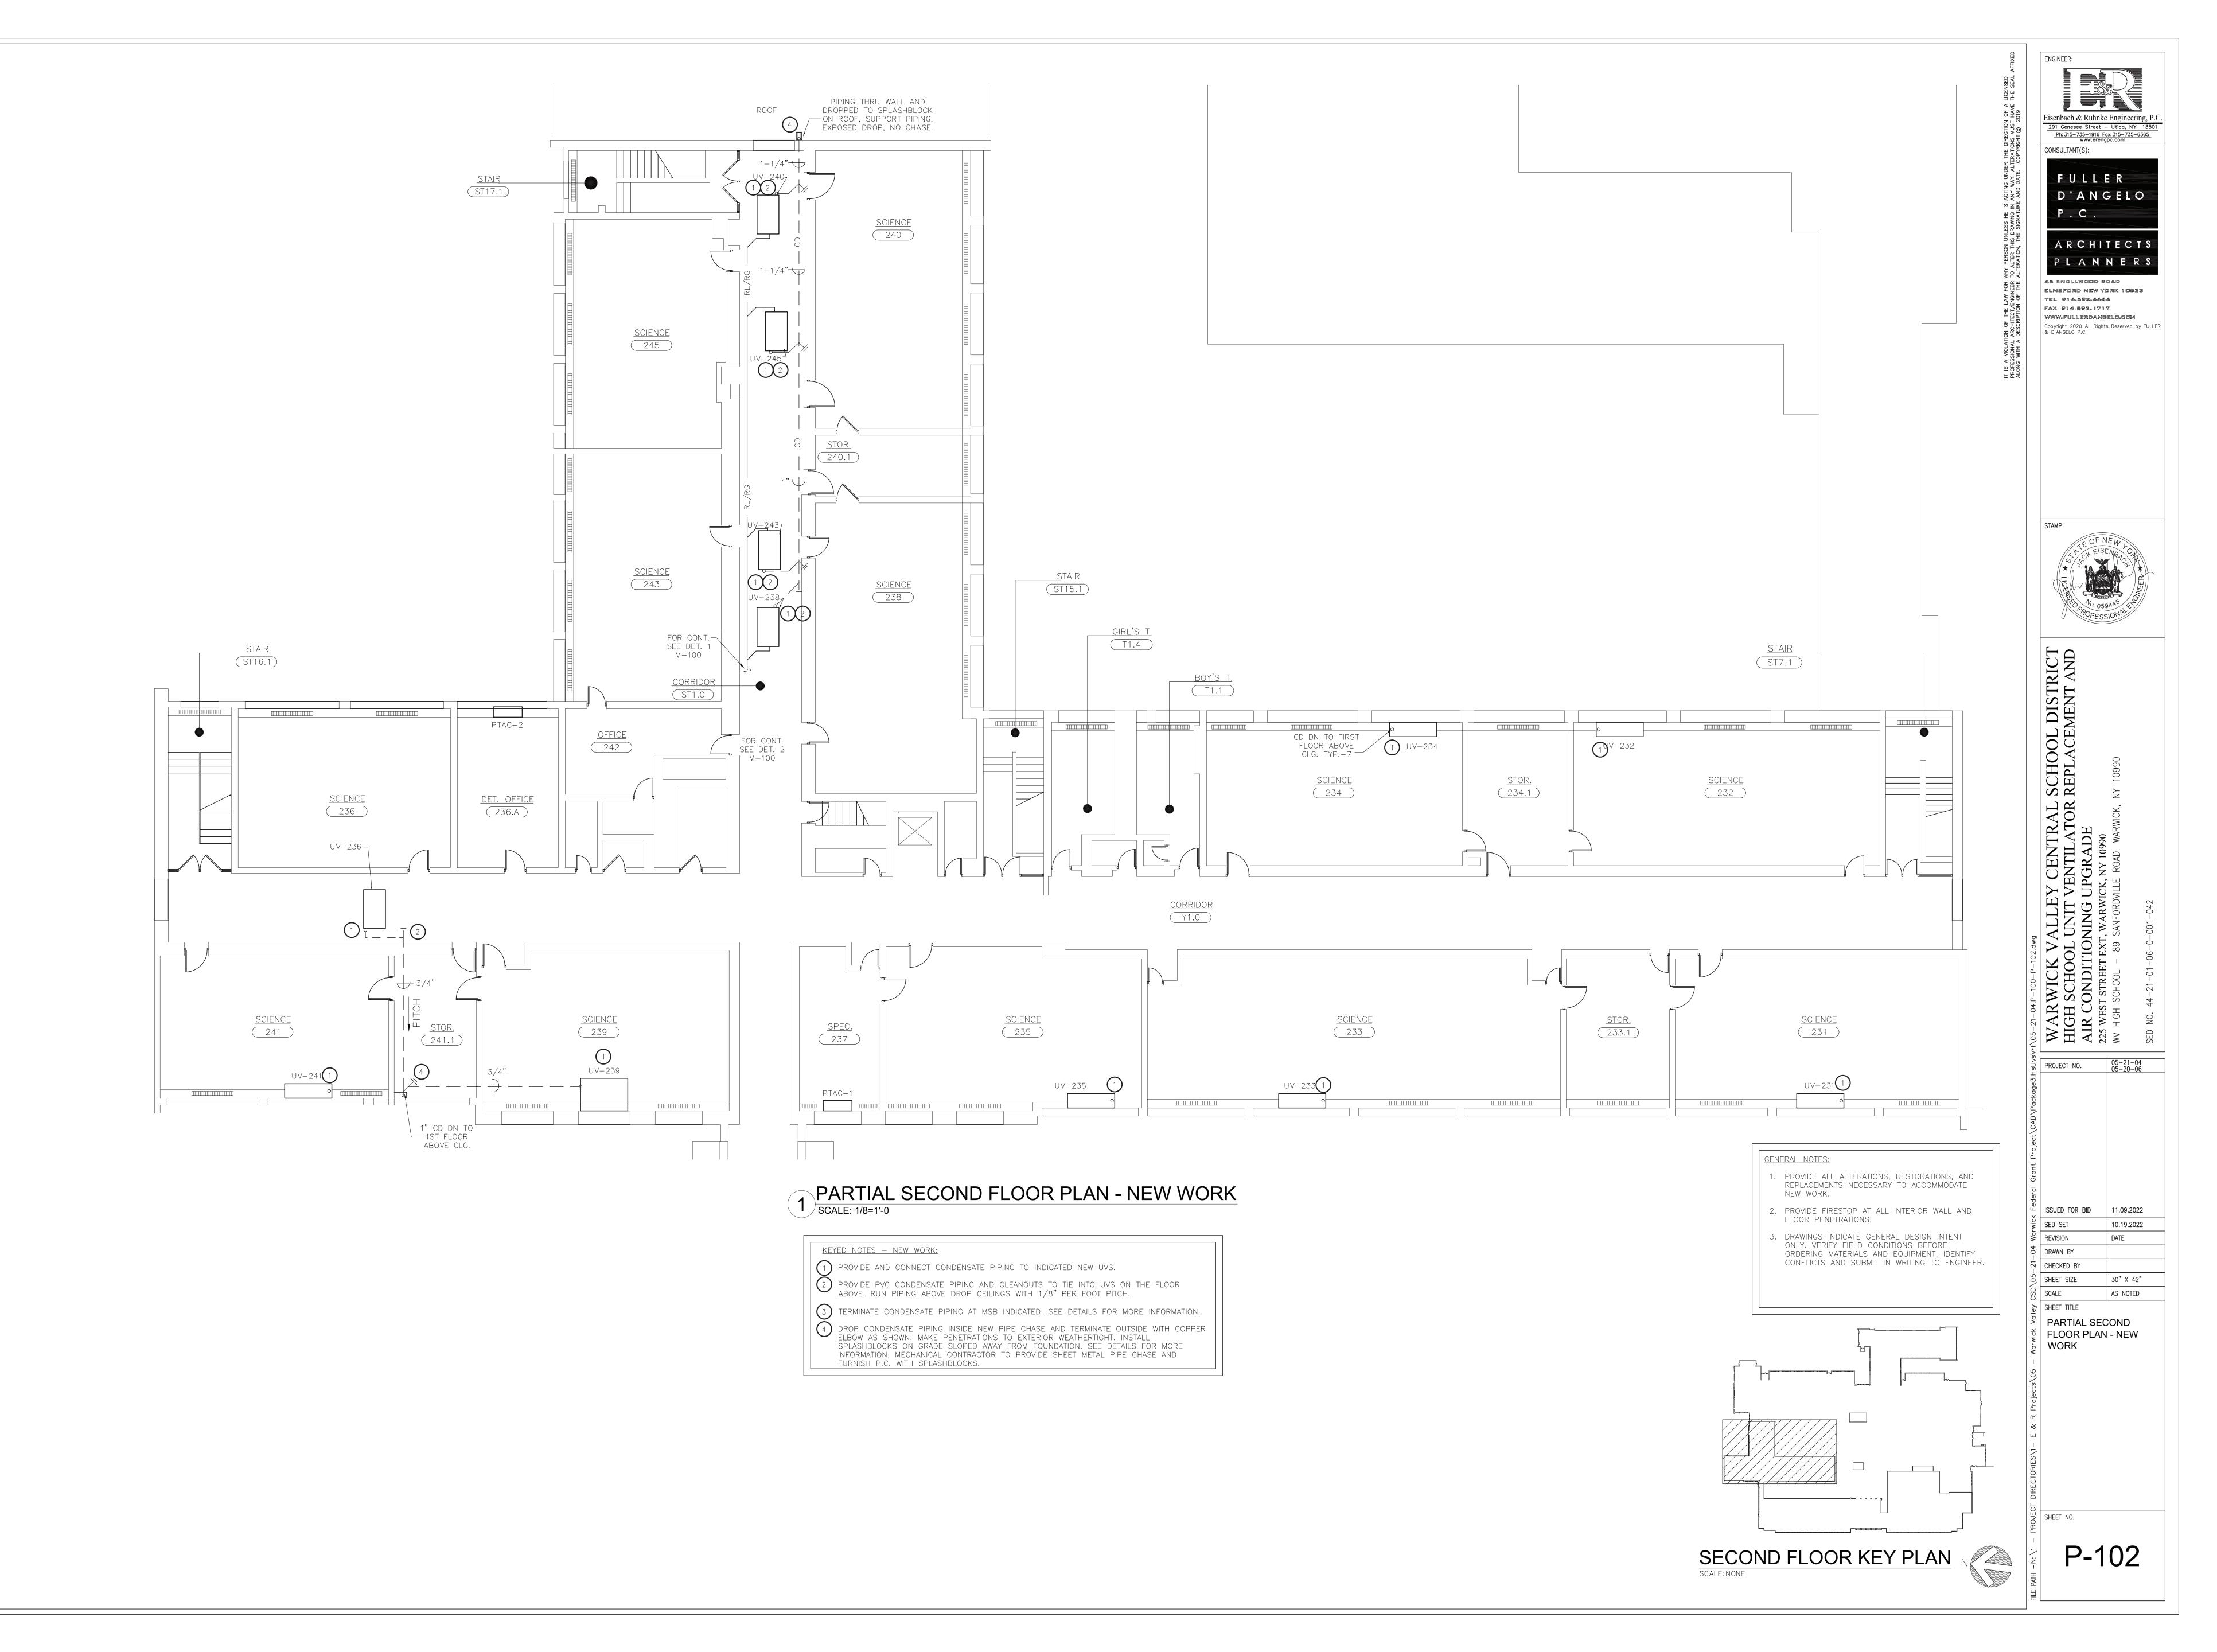

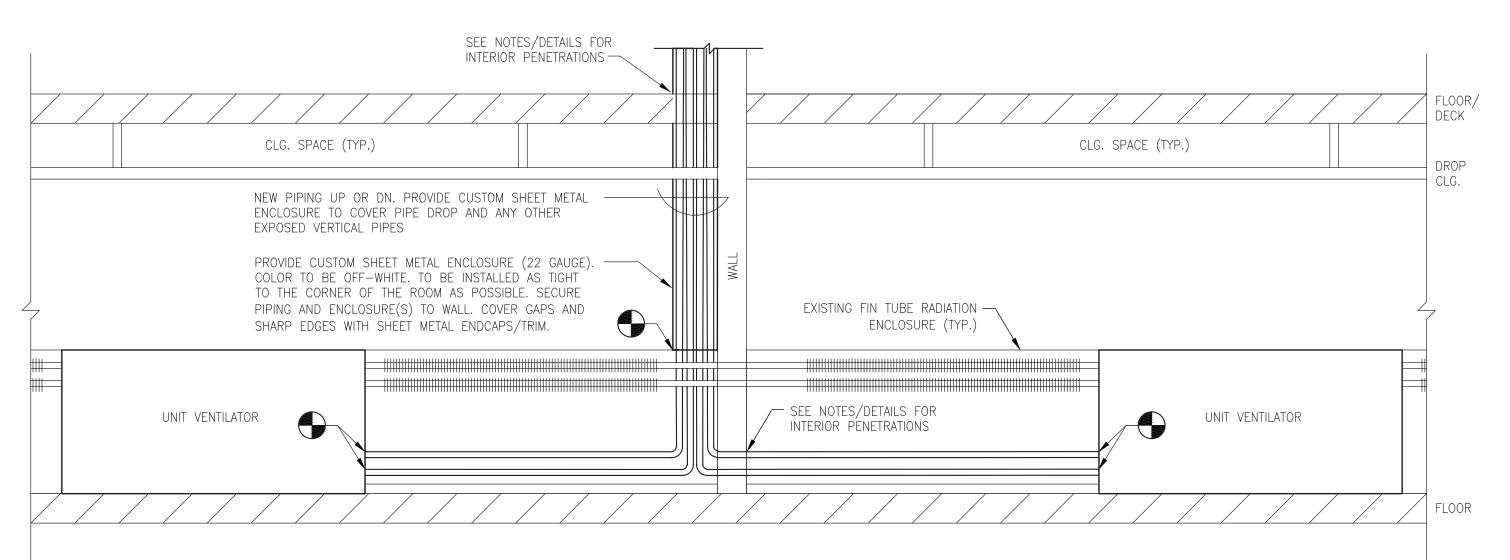
4 CUSTOM PIPING ENCLOSURE DETAIL (TYPICAL) SCALE: NONE

NEW WORK NOTES:

SEE MANUFACTURER INSTALLATION RECOMMENDATIONS. ACTUAL PIPING PATHS WILL VARY. SEE DRAWINGS FOR INTENT. VERIFY COIL CONNECTION SIDES BEFORE ORDERING EQUIPMENT.

				INSUL	ATION SCH	EDULE						
TYPE	EQUIPMENT OR SYSTEM SERVED	INSULATION CLASS (a)		JACKETING CLASS (b)		THICKNESS (IN) NOMINAL PIPE SIZE (IN)						
		INTERIOR CONCEALED	INTERIOR EXPOSED	EXTERIOR	INTERIOR GENERAL	EQUIPMENT ROOMS	EXTERIOR	<1"	1"-<1\frac{1}{2}"	1½"- <4"	4 "- <8"	≥8 & UP
A	DCW, COOLING COIL	FE			0			0.5	0.5	1.0	1.0	1.0
A	CÓNDENSATE		FE			0		0.5	0.5	1.0	1.0	1.0
В	DHW/ DHWR	FG			1			1.5	1.5	2	2	2
В			FG			1		1.5	1.5	2	2	2
C	IW, SAN, CW EXTERIOR -											
				FG			2	1.5	1.5	1.5	1.5	1.5
(a)	FG — FIBROUS GLASS		(b) 0 NC)NE							
FE — FLEXIBLE ELASTOMERIC				ALL SERVICE (d) BLANKET								
UR — — URETHANE CS — — CALCIUM SILICATE			3 C	POLYVINYL CHLORIDE CANVAS (e) RIGID BOARD								
FR — — FIRE RATED				4 P	POLYVINYL CHLORIDE							

ALL INSULATION TO COMPLY WITH 2020 NYS ENERGY CONSERVATION CONSTRUCTION CODE

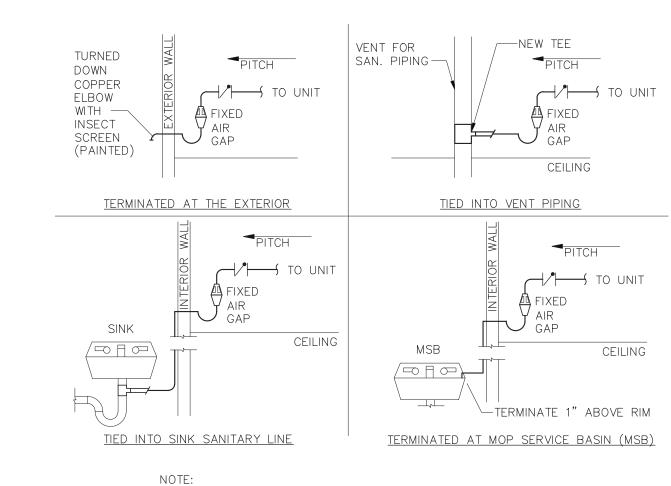


RUN CONDENSATE PIPING WITH TRAP AND VENT FROM ALL EVAPORATOR COILS TO LOCATION SPECIFIED. PROVIDE INSULATION AND SUPPORT. SIZE TO BE 3/4" UNLESS OTHERWISE SPECIFIED.

PIPING AT WALL PENETRATIONS TO BE SLEEVED. CHANGEOVER FROM PVC TO COPPER FOR EXTERIOR TERMINATION TO BEGIN BEFORE EXTERIOR WALL PENETRATION.


(TYPICAL FROM ALL EVAPOARTOR/ DX COILS)

CONDENSATE PIPING CONNECTION DETAIL SCALE: NONE

SEE M DWGS FOR LOCATIONS

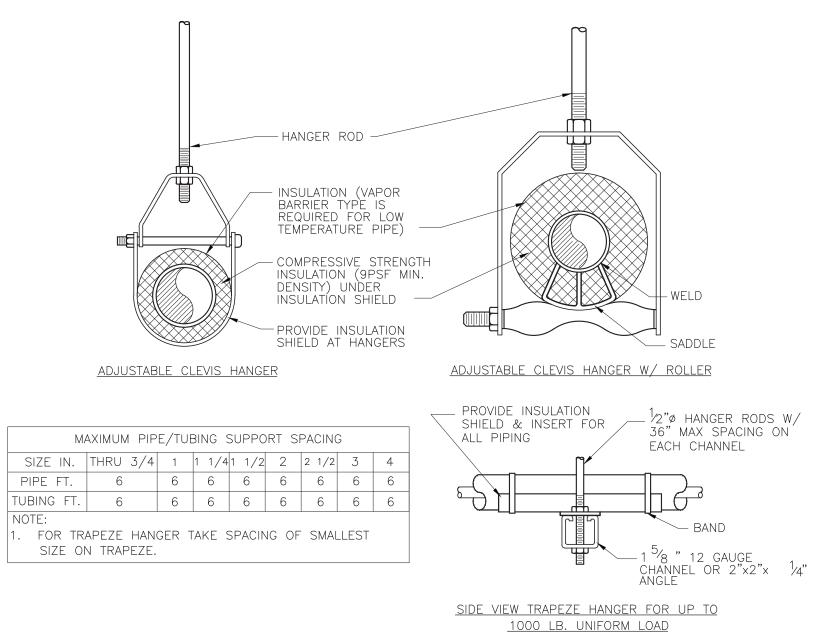



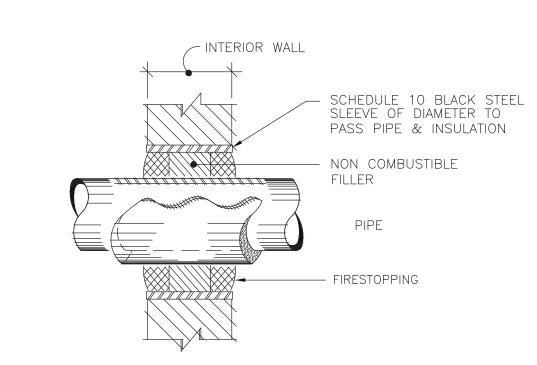



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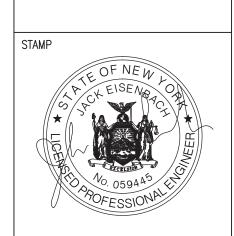
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-21-	CHECKED BY	
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SCHEDULE AND

DETAILS

SHEET NO.

P-500