

GENERAL PLUMBING NOTES:

- I. DRAWINGS ARE DIAGRAMMATIC AND INDICATE GENERAL ARRANGEMENT OF SYSTEMS AND WORK INCLUDED IN THE CONTRACT. IT IS NOT INTENDED TO SPECIFY OR SHOW EVERY OFFSET, FITTING OR COMPONENT; HOWEVER, CONTRACT DOCUMENTS REQUIRE COMPONENTS AND MATERIALS WHETHER OR NOT INDICATED OR SPECIFICALLY SPECIFIED TO MAKE THE SYSTEMS BEING INSTALLED COMPLETE, CODE COMPLIANT, TESTED AND OPERATIONAL.
- 2. CONTRACTOR SHALL FIELD VERIFY ALL LOCATIONS,
 DIMENSIONS AND ELEVATIONS PRIOR TO CONSTRUCTION.
- 3. ALL MATERIALS, EQUIPMENT, METHODS OF INSTALLATION, REMOVALS AND DISPOSAL SHALL BE IN ACCORDANCE WITH THE STANDARDS, REGULATIONS, CODES, ORDINANCES, AND LAWS OF LOCAL, STATE, AND FEDERAL GOVERNMENTS, AND OTHER AUTHORITIES THAT HAVE LAWFUL JURISDICTION.
- 4. PERFORM WORK, PROVIDE MATERIALS AND EQUIPMENT FOR SYSTEMS SHOWN, SPECIFIED AND DESCRIBED ON DRAWINGS. COMPLETELY COORDINATE ALL TRADES OF THIS CONTRACT AND PROVIDE COMPLETE AND FULLY FUNCTIONAL INSTALLATION. ALL WORK IN THIS SET TO BE COMPLETED UNDER THIS CONTRACT, UNLESS OTHERWISE INDICATED.
- 5. PROTECT ALL EXISTING AND NEW BUILDING ELEMENTS FROM DAMAGE. CONTRACTOR SHALL RESTORE ALL DAMAGED ELEMENTS TO ORIGINAL OR BETTER CONDITION.
- 6. WORK SHALL BE EXECUTED IN A WORKMANLIKE MANNER AND SHALL PRESENT NEAT, RECTILINEAR APPEARANCE WHEN COMPLETED. MAINTAIN MAXIMUM HEAD ROOM AT ALL TIMES. DO NOT RUN PIPES, DUCTS, AND CONDUIT EXPOSED UNLESS SHOWN AND NOTED TO BE EXPOSED ON DRAWINGS.
- 7. MATERIALS AND EQUIPMENT SHALL BE NEW AND INSTALLED ACCORDING TO MANUFACTURER'S INSTRUCTIONS AND RECOMMENDATIONS. MAINTAIN MANUFACTURER'S EQUIPMENT CLEARANCES.
- 8. CONTRACTOR IS RESPONSIBLE FOR ALL WORK RELATED TO ISOLATING, SHUTTING DOWN, DRAINING, FILLING AND TESTING SYSTEMS TO ALLOW FOR COMPLETION OF WORK.
 INTERRUPTIONS TO EXISTING SERVICES AND SYSTEMS SHALL BE AS SHORT AS POSSIBLE AND AT A TIME AND DURATION APPROVED BY THE OWNER AND UTILITY AS APPLICABLE.
 INCLUDE ALL PREMIUM TIME ASSOCIATED WITH INTERRUPTIONS. ALL SYSTEM INTERRUPTIONS SHALL BE SCHEDULED WITH OWNER, UTILITY AND COORDINATED WITH OTHER TRADE WORK.
- 9. ALL EQUIPMENT PIPING, WIRING, INSULATION ETC. INSTALLED IN HVAC AIR PLENUM SPACES SHALL MEET CODE REQUIREMENTS FOR SMOKE AND COMBUSTIBILITY.
- 10. SEAL ALL PENETRATIONS THROUGH FIRE RATED WALLS, PARTITIONS AND FLOORS WITH UL RATED MATERIALS/METHODS EQUIVALENT TO FIRE RATING OF ASSEMBLY.
- 11. PROVIDE PROPER ACCESS TO EQUIPMENT THAT REQUIRES INSPECTION, REPLACEMENT OR REPAIR. ACCESS PANELS/DOORS SHALL BE A MINIMUM OF 12"X12", UNLESS OTHERWISE NOTED.
- 12. DO NOT SUPPORT EQUIPMENT FROM SUSPENDED CEILINGS. ALL SUPPORT SHALL BE FROM BUILDING STRUCTURE OR FROM CEILING SUSPENSION SYSTEM WHICH HAS BEEN

STALLED TO PROVIDE A VIBRATION FREE INSTALLATION.

14. CLEANING DURING PLUMBING WORK: THE MECHANICAL ROOM AND ROOMS WHERE WORK WILL BE DONE TO MINIMIZE DISTURBANCE IN THE BUILDINGS. WORKERS ARE TO USE PATHWAYS AND FACILITIES AGREED UPON WITH THE DISTRICT DESIGNEE IN WRITING. THE AREA OUTSIDE THE BUILDING WHERE CUTTING, WELDING OR STORAGE IS ALLOWED IS TO BE FENCED AT ALL TIMES. THE CONTRACTOR WILL ON A DAILY BASIS CLEAN THE GROUNDS AND THE BUILDING OF ANY DEBRIS OR GARBAGE GENERATED BY THEIR WORK.

15. EACH CONTRACTOR RESPONSIBLE FOR RETURNING WALLS, CEILINGS AND SURFACES THEY DISTURB THAT ARE NOT SCHEDULED FOR REPLACEMENT BACK TO ORIGINAL CONDITIONS.

COORDINATION NOTE:

1. COORDINATE WITH ALL CONTRACTORS AND DISTRICT.

2. SEE SITE DRAWINGS FOR ADDITIONAL CONTRACTOR WORK AS MARKED.

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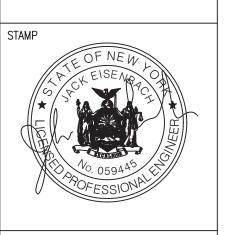
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WARWICK VALLEY CENTRAL SCHOOL DIST
HIGH SCHOOL RENOVATIONS, FIELD WORK AND
EXTERIOR BATHROOM BUILDING

225 WEST STREET EXT, WARWICK, NY 10990

BB SED NO. 44-21-01-06-7-041-001 (F-WY FOOTBALL FIELD) 89 SANFORDVILLE ROAD. WARWICK, NY 104-21-01-06-0-001-040 (HS-WY HIGH SCHOOL) 89 SANFORDVILLE ROAD. WARWICK, NY 104-21-01-06-0-001-040 (HS-WY HIGH SCHOOL) 89 SANFORDVILLE ROAD. WARWICK, NY 104-21-01-06-0-001-040 (HS-WY HIGH SCHOOL) 89 SANFORDVILLE ROAD. WARWICK, NY 104-21-01-06-0-001-040 (HS-WY HIGH SCHOOL) 89 SANFORDVILLE ROAD. WARWICK, NY 104-21-01-06-0-001-040

ADDENDUM 1 5.3.2022

BID SET 04.08.2022

REVISION DATE

DRAWN BY

CHECKED BY

SHEET SIZE 30" X 42"


SCALE AS NOTED


ABBREVIATIONS
AND NOTES

PROJECT NO.

SHEET NO.

P-001

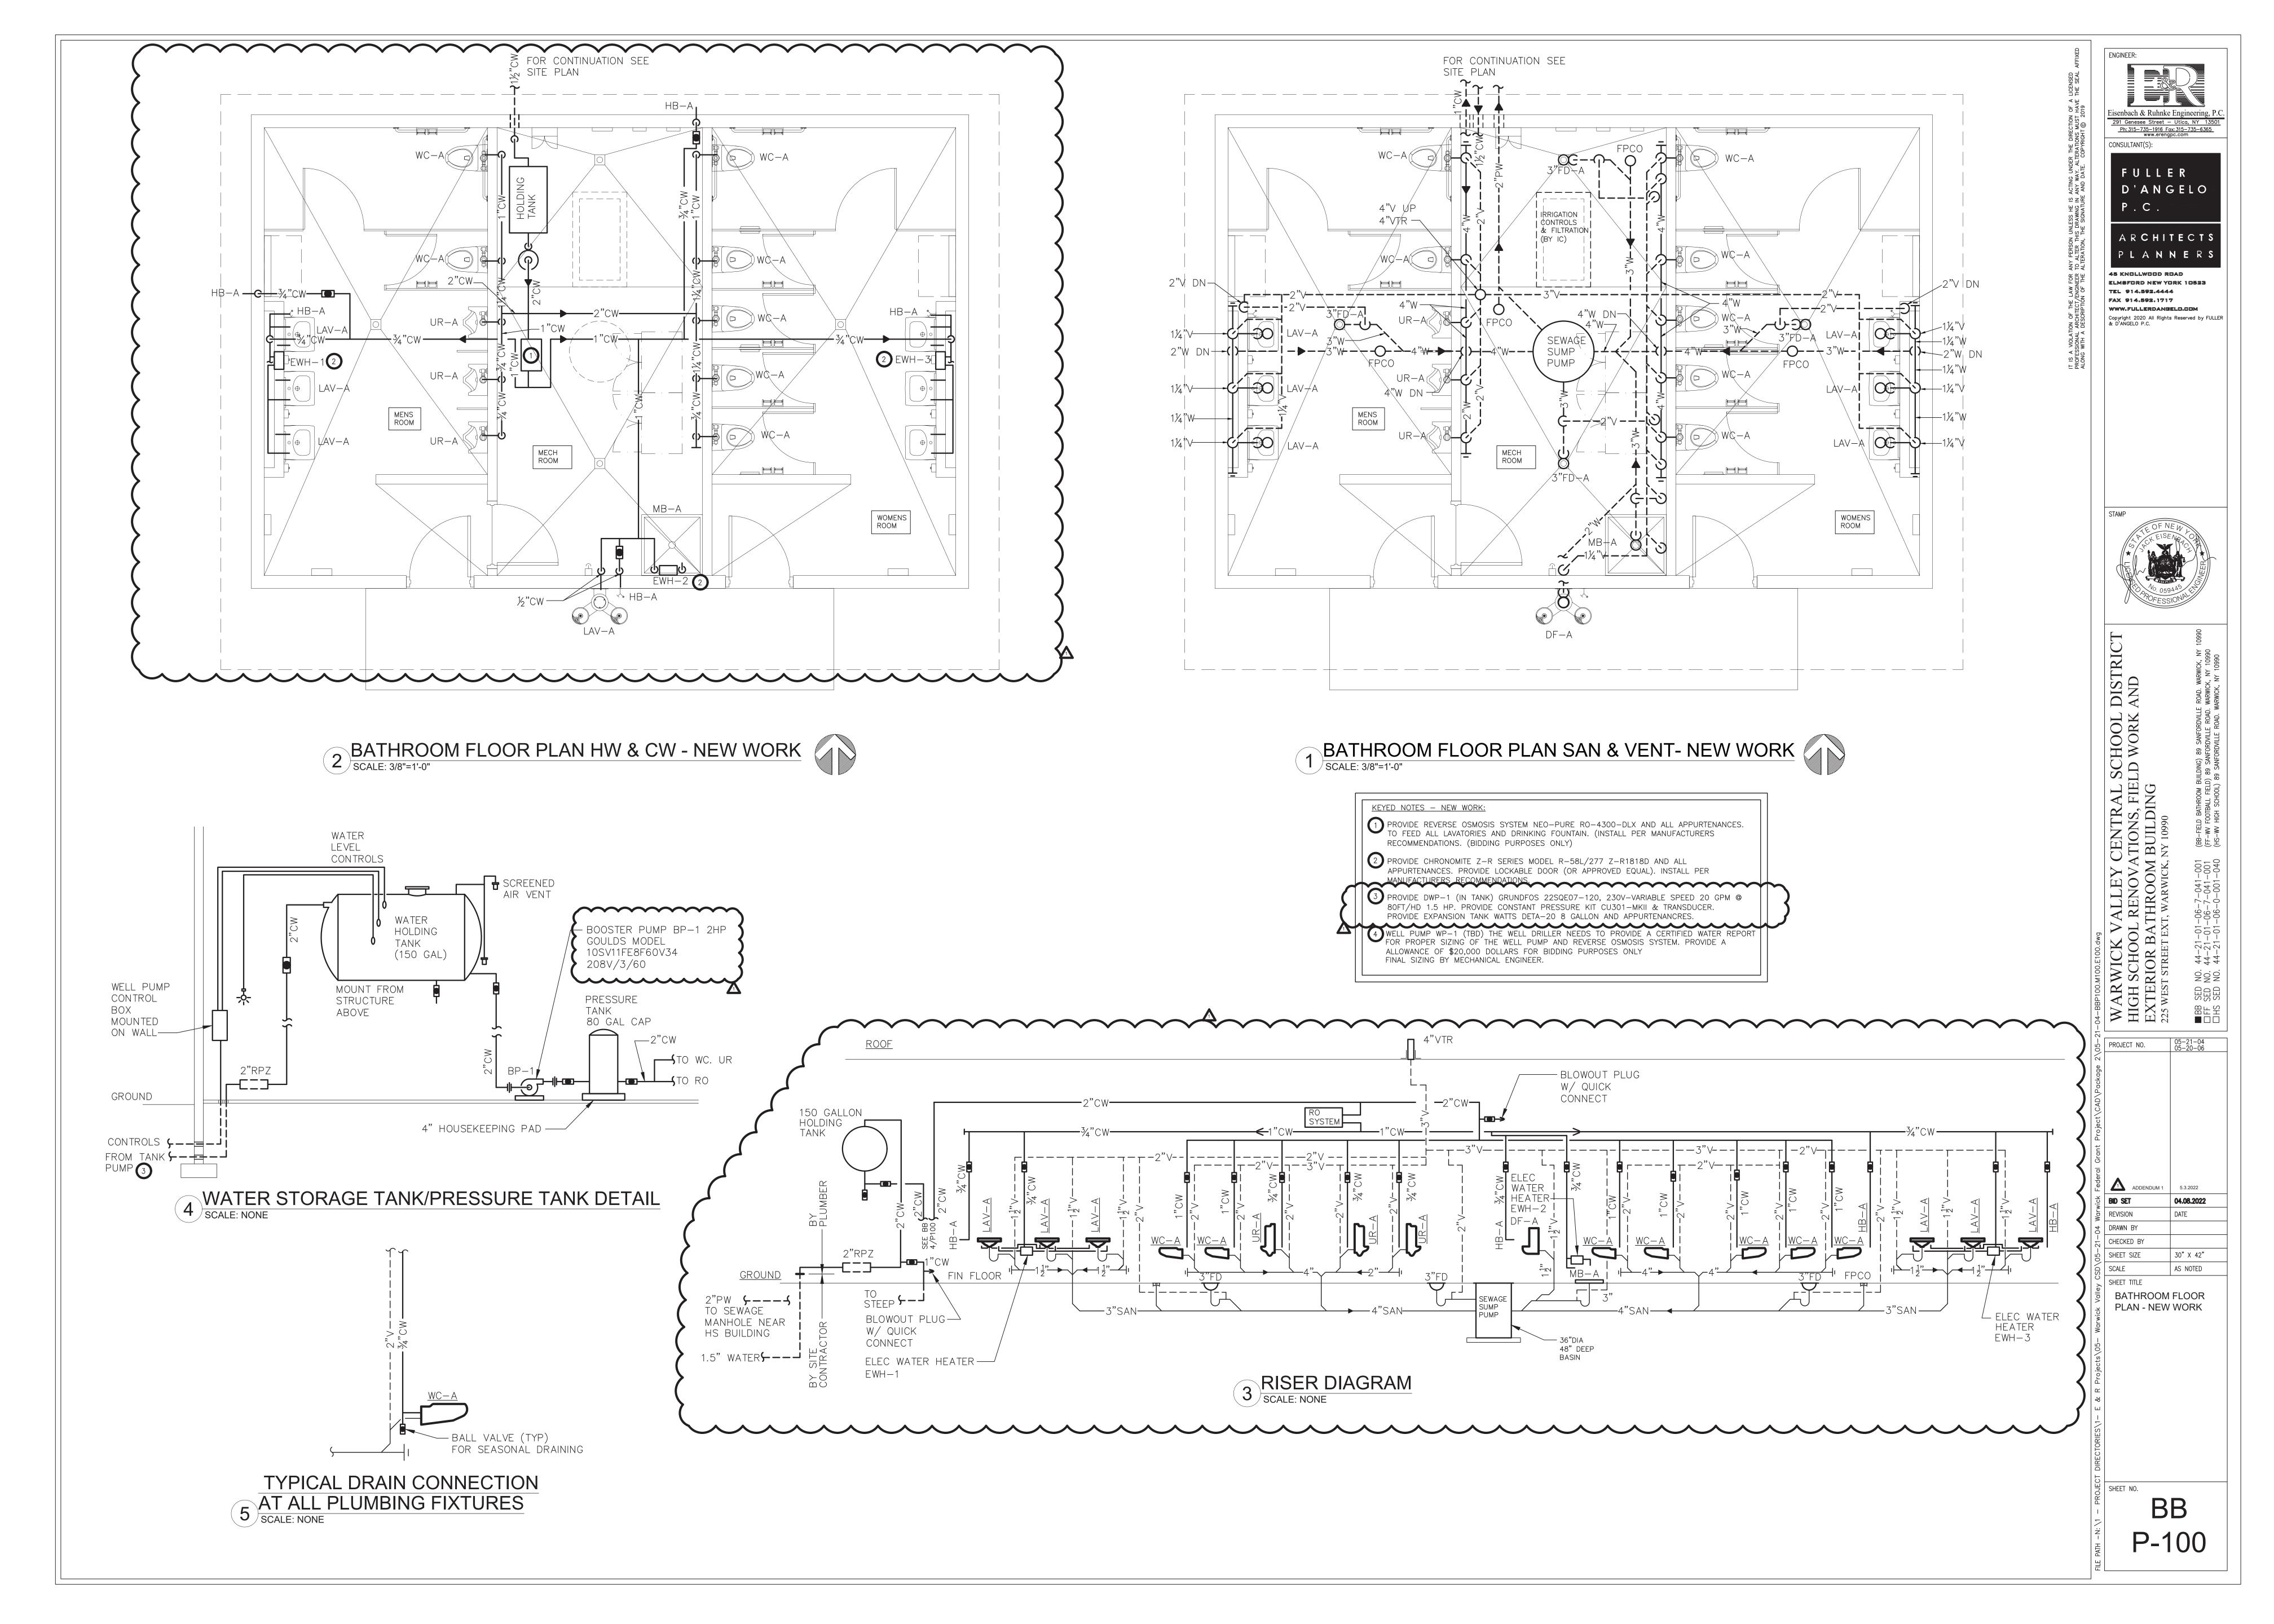

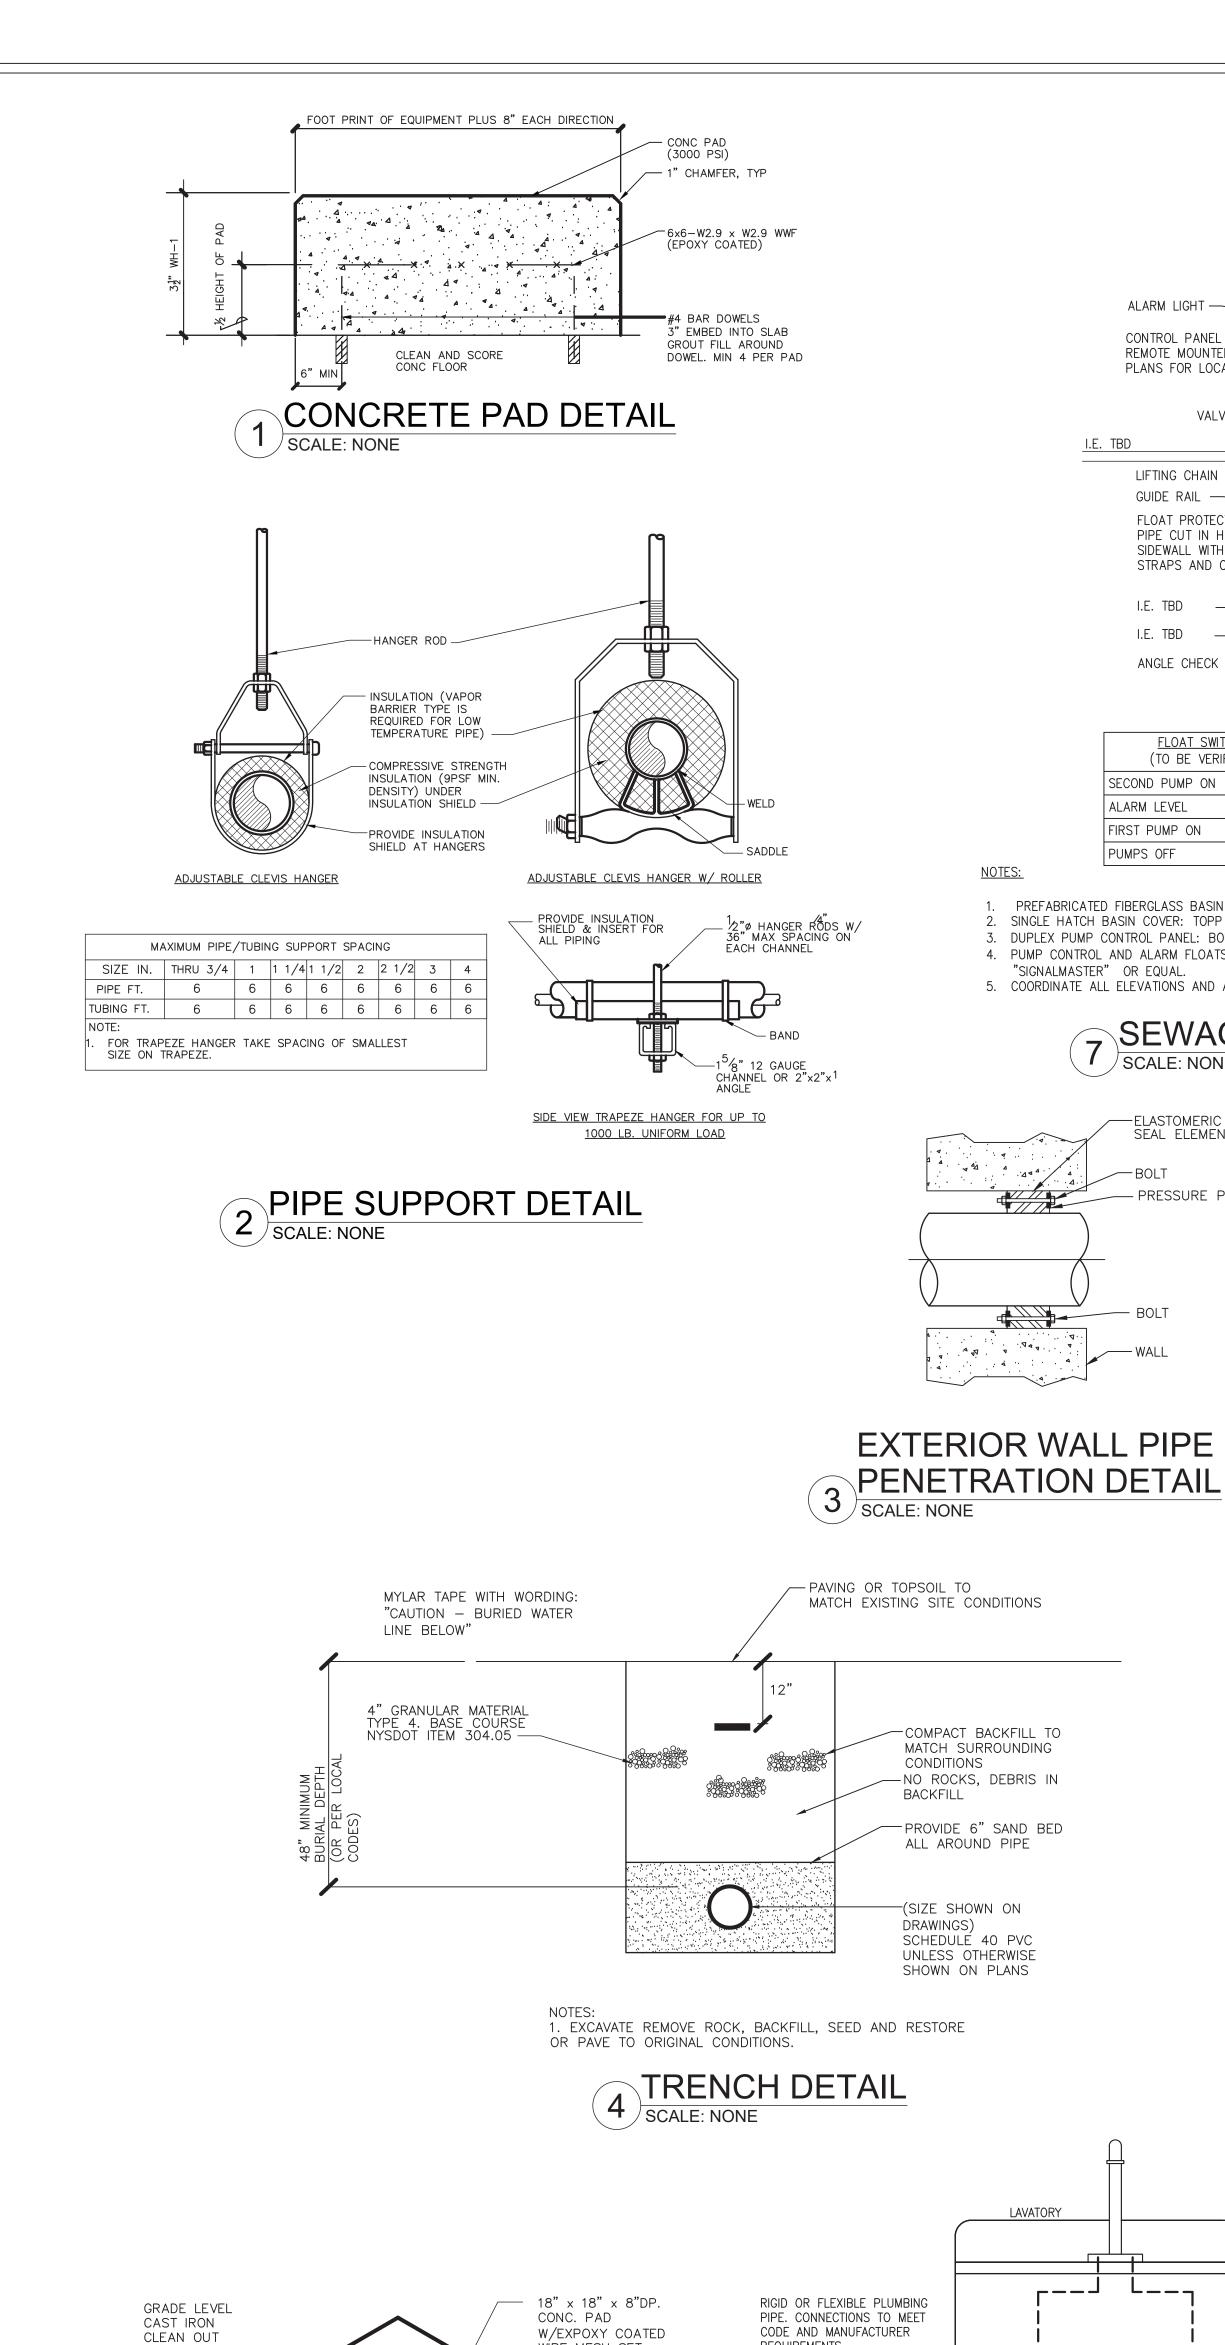

REQUIREMENTS

PROVIDE METAL

HEATER

POINT OF USE WATER HEATER

LOCKABLE

ENCLOSURE -

WIRE MESH SET

FLUSH W/ GRADE

OR EXISTING


CONDITIONS

(FLUSH COVER)-

4"SAN -

GRADE LEVEL CLEANOUT DETAIL

SCALE: NONE

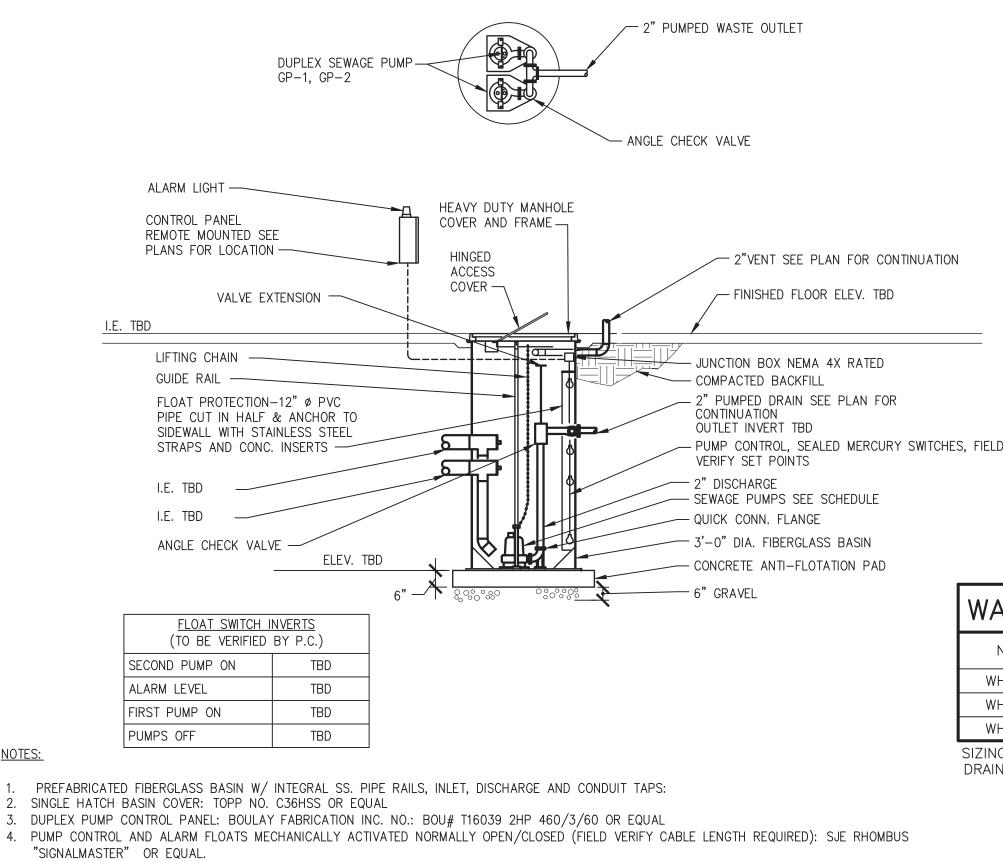


SCALE: NONE

TBD	XTENSION —	ACCESS COVER —	T SEE PLAN FOR CONTINUATION ED FLOOR ELEV. TBD
GUIDE RAIL FLOAT PROTECTION PIPE CUT IN HALF SIDEWALL WITH STA STRAPS AND CONC I.E. TBD ANGLE CHECK VAL	-12" Ø PVC & ANCHOR TO AINLESS STEEL C. INSERTS	JUNCTION BOY COMPACTED E 2" PUMPED D CONTINUATION OUTLET INVER PUMP CONTRO VERIFY SET P 2" DISCHARGE SEWAGE PUMP QUICK CONN. 3'-0" DIA. FIE	DRAIN SEE PLAN FOR N RT TBD OL, SEALED MERCURY SWITCHES, FIELD POINTS E PS SEE SCHEDULE FLANGE BERGLASS BASIN NTI-FLOTATION PAD
FLOAT SWITCH	<u>INVERTS</u>	— 1 % % % % % % % % % % % % % % % % % %	WATER
(TO BE VERIFIED SECOND PUMP ON	BY P.C.)		NO.
ALARM LEVEL	TBD		WHA-A
FIRST PUMP ON	TBD		WHA-B
PUMPS OFF	TBD		WHA-C
D FIBERGLASS BASIN W/ BASIN COVER: TOPP NO.		AILS, INLET, DISCHARGE AND CONDUIT TAPS:	SIZING DATA DRAINAGE S

BACKFLOW ASSEMBLY CLEARANCES:

-BALL VALVE

W/REMOVABLE

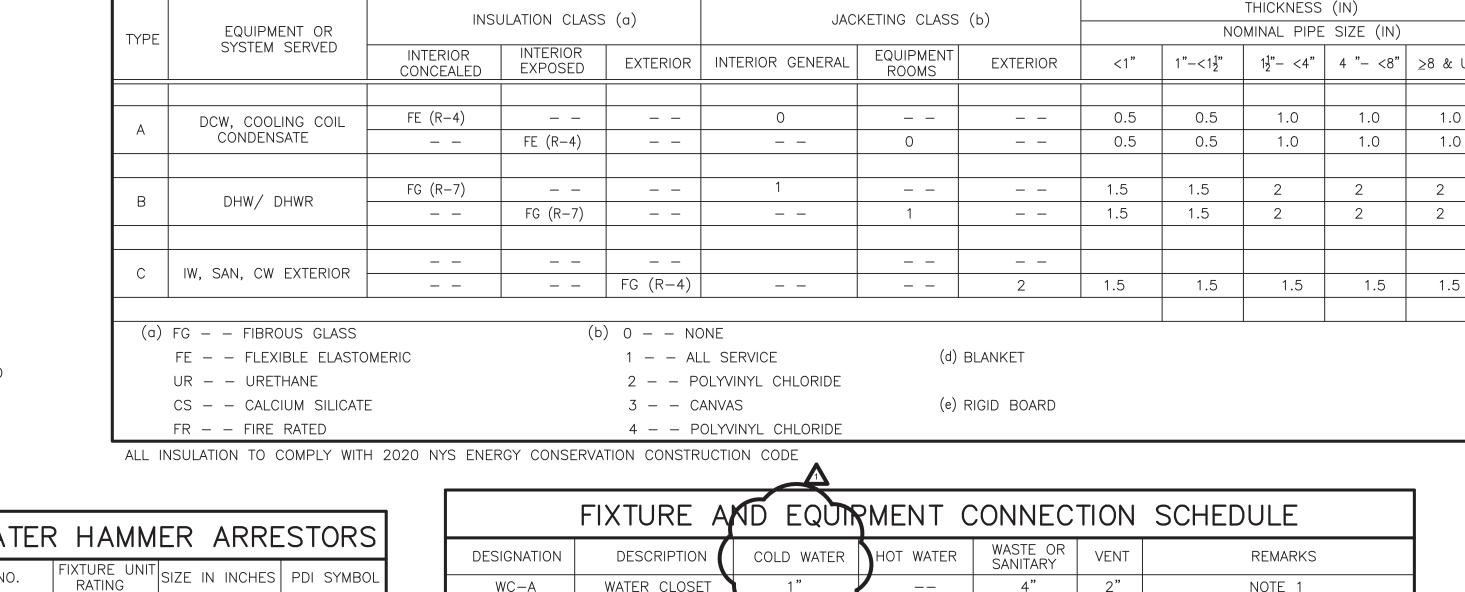

INSULATION SCHEDULE

	FIXTURE A	ND EQUIN	RMENT C	CONNEC	SCHEDULE			
DESIGNATION	DESCRIPTION	COLD WATER	HOT WATER	WASTE OR SANITARY	VENT	REMARKS		
WC-A	WATER CLOSET	1"		4"	2"	NOTE 1		
UR-A	URINAL	3/4"		2"	2"	NOTE 2		
LAV-A	LAVATORY	1/2	1/2"	1-1/4"	1-1/4"	NOTE 3		
FD-A	FLOOR DRAIN			3"	2"	NOTE 4		
FPCO	CLEANOUT			4"		NOTE 5		
DF-A	DRINKING FOUNTAIN	3/4"		1 1/2"	1-1/4"	NOTE 9		
MB-A	MOP BASIN	3/4"	3/4"	3"	2"	NOTE 8		
HB-A	HOSE BIBB	3/4"				NOTE 10		

NOTES:

1/2"

3/4"

Α

1 - 11

12 - 32

33-60

WALL MOUNTED WATER CLOSET AMERICAN STANDARD AFWALL 3351.101 WITH 5901.110 SEAT AND SLOAN FLUSH VALVE ROYAL 111 ESS-1.6-OR-HW WALL MOUNTED URINAL AMERICAN STANDARD WASHBROOK 6590.001 WITH SLOAN FLUSH VALVE ROYAL 186 ESS-1.0-HW WALL HUNG LAVATORY AMERICAN STANDARD 0355.012 W/JR SMITH CARRIER 0700, MCGUIRE 2167-LK-F AND


MCGUIRE 8912-F. FAUCET AMERICAN STANDARD 605B-205, PK00.HAC, 605XTMV1070 HARD WIRED AC MULTI AC PROVIDE STAINLESS STEEL FLEXIBLE SUPPLIES, CW,HW BRASSCRAFT S1-A AND SHUT OFF VALES W/ REMOVABLE HANDLES. LAV GUARD BY ARCHITECT FLOOR DRAIN MODEL JR SMITH 2010C-A WITH TRAP SEAL BY PROVENT SYSTEMS OR APPROVED EQUAL.


PROVIDE CLEANOUT JR SMITH MODEL 4020 OR APPROVED EQUAL ALL PLUMBING FIXTURES TO BE PROVIDED WITH SHUT-OFF VALVES AS SPECIFIED


INSTALL ALL CARRIERS PER MANUFACTURERS RECOMMENDATIONS. COORDINATE WITH ARCHITECTURAL DRAWINGS FOR CARRIER HEIGHTS. PROVIDE MOP BASIN FIAT MSB-3636 WITH FIAT 830-AA. PROVIDE MOP BRACKET 889-CC, VINYL GUARDS E-77-AA AND HOSE BRACKET 832-AA

9. PROVIDE ELKAY MODEL LK4409BF - BLACK OR APPROVED EQUAL 10. PROVIDE JR SMITH HOSE BIBB 5685(H) WITH REMOVABLE HANDLE OR APPROVED EQUAL

	PUMP SCHEDULE												
NO.	LOCATION	SERVICE	GPM	HEAD FT		MO	TOR		DESIGN MAKE				
NO.	LOCATION	SLIVICE	GEWI	WATER	WATTS/HP	VOLTAGE	PHASE	MAX. RPM	DESIGN WARE				
GP-1	MECH ROOM	SEWAGE	25	40	1.5	460	60	1750	WEIL 2436				
GP-2	MECH ROOM	SEWAGE	25	40	1.5	460	60	1750	WEIL 2436				

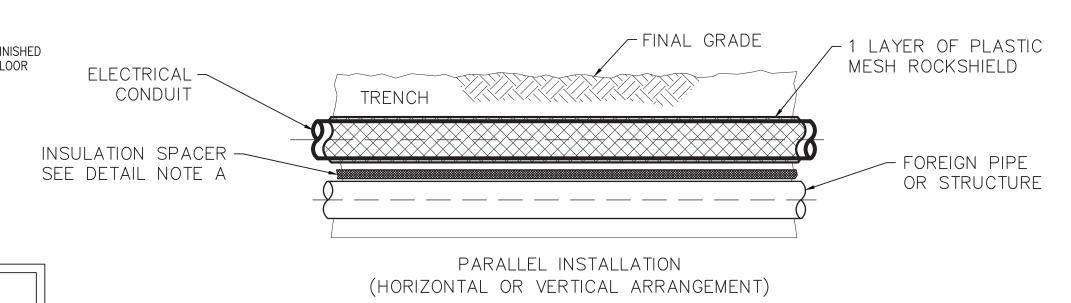


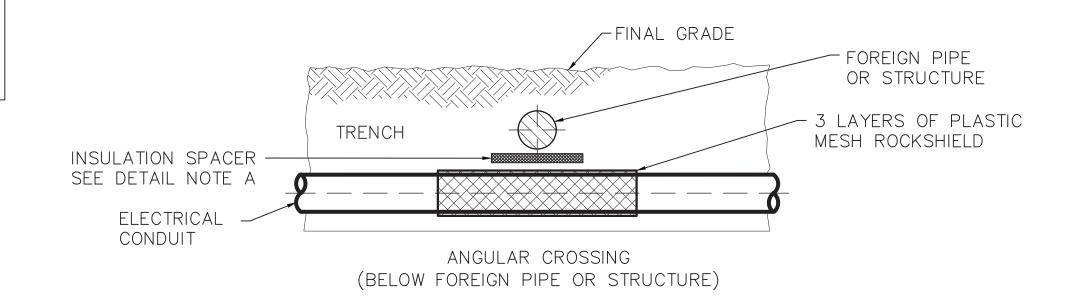

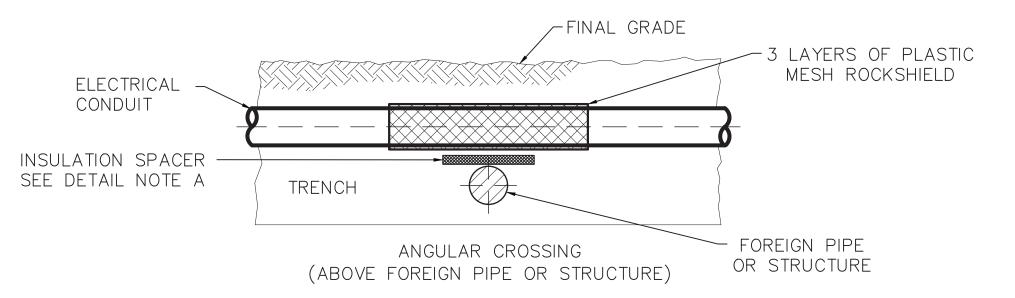

ANGULAR & PARALLEL CROSSING OF SUBSURACE STRUCTURE GAS PIPE PROTECTION BELOW GRADE CLEARANCES

SCALE: NONE

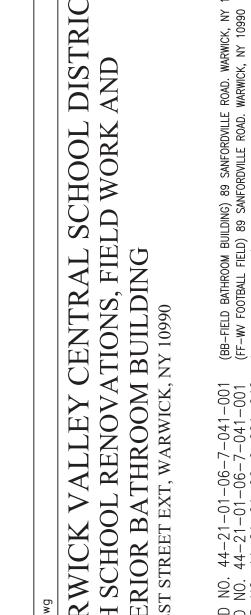

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HI EX 225	
PROJECT NO.	05-21-04 05-20-06
ADDENDUM 1	5.3.2022
BID SET	04.08.2022
REVISION	DATE


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SHEET SIZE	30" X 42"
SCALE	AS NOTED


SCHEDULES

AND DETAILS


P-500


DETAIL NOTES: A. A INSULATIONSPACER SHALL BE INSTALLED BETWEEN METALIC WATER/SEWER PIPE TO PREVENT ELECTRICAL CONTACT WITH THE SUBSURFACE STRUCTURE B. REFER TO SPECIFICATIONS FOR ADDITIONAL REQUIREMENTS

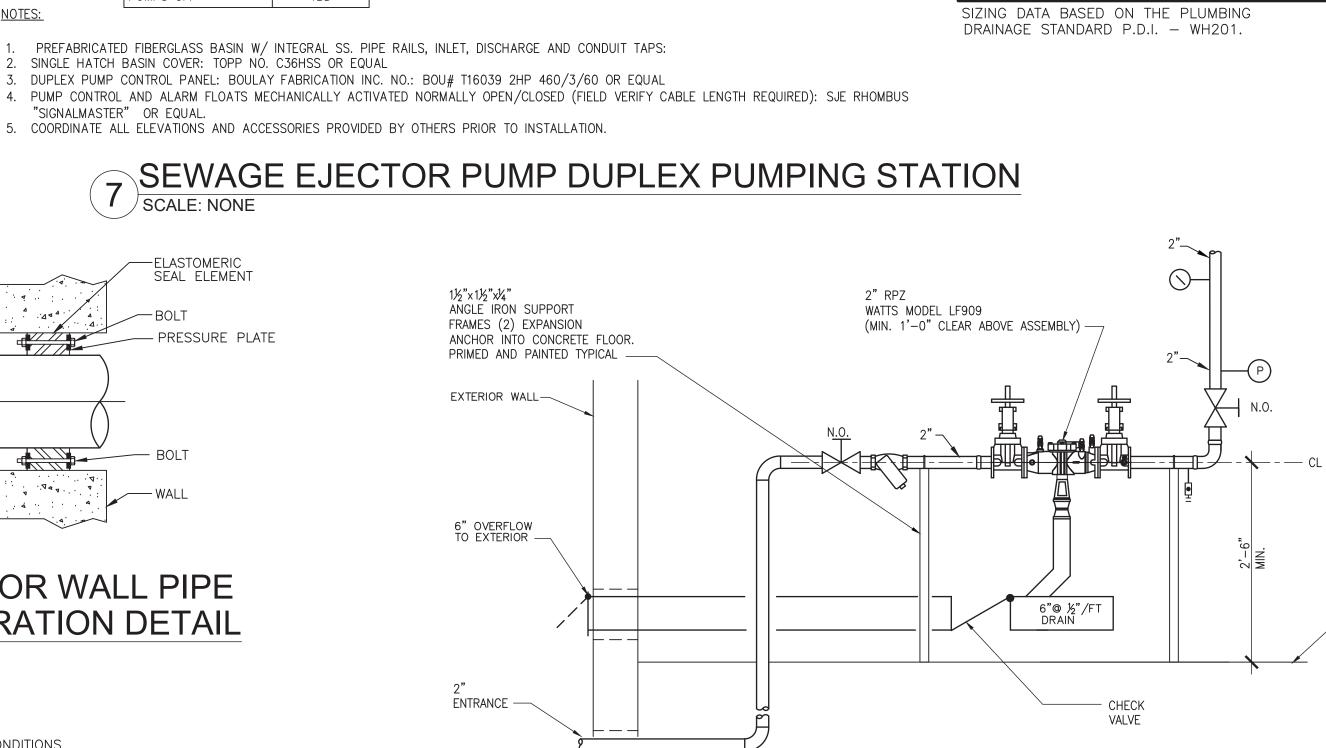

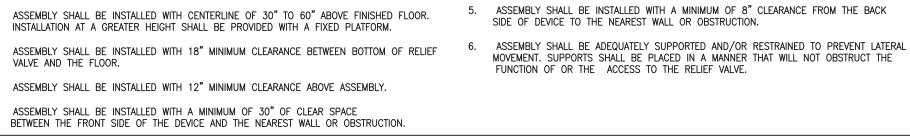

BACKFLOW PREVENTER DETAIL

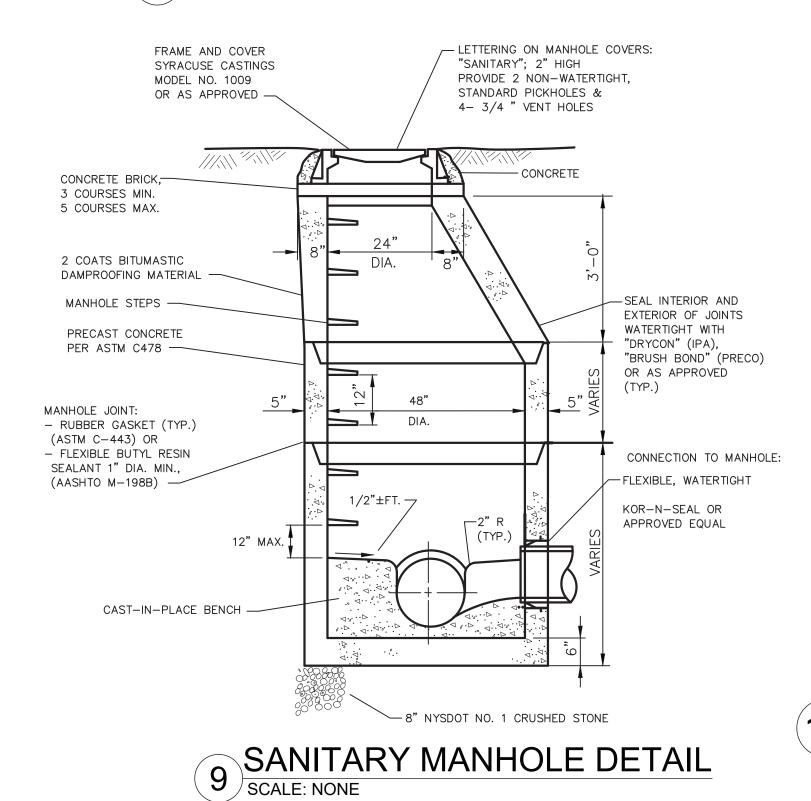


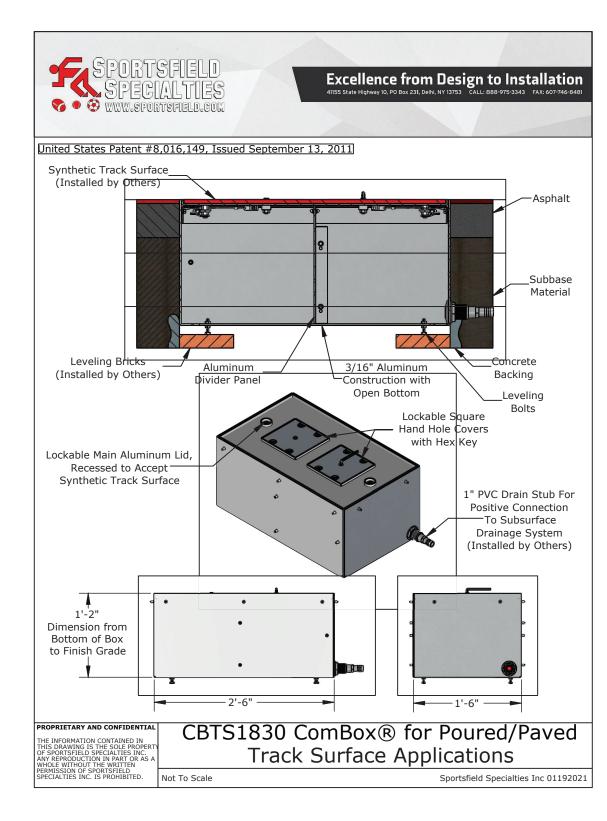

PULLBOX APPLICATION

NEW WORK

SCALE: NTS

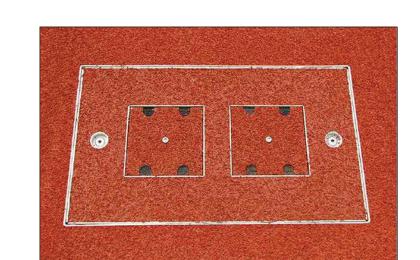

TRACK SURFACED PULLBOX

NEW WORK

SCALE: NTS

KEYED NOTES - NEW WORK:

- DISTRICT SHALL PROVIDE AND INSTALL NEW SPORTSFIELD SPECIALTIES CBTS1830 COMBOXES (PULLBOX) PER MANUFACTURERS INSTRUCTIONS. DISTRICT SHALL INSTALL ONE GCFI OUTLET INTO EACH PULLBOX (11) AND WIRED BACK TO 120V PANELBOARD LOCATED IN CONCESSION STAND. MAXIMUM OF SIX GCFI OUTLETS PER BRANCH CIRCUIT. DISTRICT SHALL PROVIDE AND INSTALL ALL WIRING, CONDUIT, CIRCUIT BREAKERS AND SUPPLIES TO COMPLETE INSTALLATION OF POWER CIRCUITS. GCFI OUTLETS SHALL BE INSTALLED IN WEATHERPROOF HOUSINGS WITHIN PULLBOXES.
- DISTRICT SHALL PROVIDE AND INSTALL MUSCO STADIUM LIGHTING ONTO FOUR EXISTING AND ONE NEW LIGHT POLE AS INDICATED. INSTALL STADIUM LIGHTING PER MANUFACTURER INSTRUCTIONS. DISTRICT SHALL PROVIDE MUSCO RECOMMENDED STADIUM LIGHTING CONTROLS, WIRING, STARTERS, CONDUIT AND SUPPLIES NECESSARY TO ENSURE A COMPLETE LIGHTING SYSTEM.
- DISTRICT SHALL PROVIDE AND INSTALL WALLPACK LIGHTING (L6) AS INDICATED ONTO EXISTING GRANDSTAND FOR PATH LIGHTING. DISTRICT SHALL PROVIDE AND INSTALL LIGHTS, WIRING, CONDUIT, CIRCUIT BREAKER, SUPPLIES AND HARDWARE AS REQUIRED FOR A COMPLETE LIGHT SYSTEM AND CONNECT TO THE EXISTING 120V PANELBOARD LOCATED INSIDE THE CONCESSION STAND. REFER TO LIGHTING FIXTURE SCHEDULE ON DRAWING E-500 FOR SPECIFICATIONS.
- DISTRICT SHALL PROVIDE AND INSTALL THREE POLE LIGHTS (PL1) ALONG EXISTING PAVEMENT AS INDICATED. DISTRICT SHALL PROVIDE AND INSTALL LIGHT POLES, WIRING, CONDUIT, CIRCUIT BREAKER, SUPPLIES AS REQUIRED TO COMPLETE SYSTEM AND CONNECT TO NEW 277V PANELBOARD TO BE LOCATED IN THE EXTERIOR BATHROOM BUILDING MECHANICAL ROOM. REFER TO LIGHTING FIXTURE SCHEDULE ON DRAWING E-500 FOR SPECIFICATIONS.
- DISTRICT SHALL PROVIDE AND INSTALL THREE 2" SCHEDULE 80 PVC CONDUIT AS INDICATED TO ALL PULLBOXES. LONG SWEEPS SHALL BE USED TO ENTER/EXIT PULLBOXES, CONDUIT SHALL BE MADE WATER TIGHT AND CAPPED INSIDE PULLBOX WHERE PERMITTED. INSTALL BACKUP PULL ROPES IN CONDUIT FOR USE DURING MEETS. DISTRICT SHALL PROVIDE AND INSTALL COMMUNICATION WIRING (BELDEN 9533 CABLE) LINKING ALL PULLBOXES USING 3 PIN XLR (MALE & FEMALE) AND CONNECT TO THE PRESS
- ELECTRICAL CONTRACTOR (EC) SHALL PROVIDE AND INSTALL 2 SETS OF 500 MCM CABLES IN 4" SCHEDULE 80 PVC CONDUITS TO NEW 400A 277/480V, 3PH, 60HZ PANEL PP-1 IN BATHROOM BUILDING (BB). GENERAL CONTRACTOR (GC) SHALL PROVIDE TRENCHING AND BACKFILL REFER TO DRAWING E-502 FOR TRENCHING AND RELATED DETAILS.

BOX AND SCORER'S TABLE. DISTRICT SHALL PROVIDE AND INSTALL CAT 5 ETHERNET (T56EA/B RJ45) NETWORT CABLE TO ALL PULLBOXES.

EC TO PROVIDE AND INSTALL 1 $\frac{1}{2}$ " SCHEDULE 80 PVC CONDUIT FROM SCOREBOARD TO BLEACHERS. EC TO EXTEND PVC CONDUIT 6" ABOVE GROUND AND CAP WATER TIGHT AT SCOREBOARD. EC SHALL INSTALL 2 PULL ROPES IN CONDUIT FOR FUTURE WIRING BY OTHERS FROM BLEACHERS TO SCOREBOARD. PVC CONDUIT SHALL EXTEND 20" ABOVE GRADE AT BLEACHERS TO A NEW WATERTIGHT JUNCTION BOX ALSO PROVIDED BY EC. TRENCHING AND BACKFILL BY GC, REFER TO DRAWING E-502 FOR DETAILS.

GENERAL NOTES:

- 1. INSTALL SPORTSFIELD SPECIALTIES CBTS 1830 COMBOXES WITHIN CLOSE PROXIMITY TO TRACK EDGES SUCH THAT TRACK SURFACE COATING CAN BE INSTALLED ON AND 12-16" AROUND PERIMETER OF COMBOX PROVIDING A CONTINUOUS TRACK SURFACE AS PICTURED IN DETAIL 3 OF THIS DRAWING. COMBOXES SHALL BE INSTALLED SUCH THAT THE WHEN SURFACED THE COMBOX SHALL BE LEVEL WITH THE FINISHED TRACK
- ELEVATION.

 2. INSTALL SPORTSFIELD SPECIALTIES CBTS 1830 COMBOXES PER MANUFACTURER INSTRUCTIONS, DETAIL 2 OF THIS DRAWING PROVIDES INSTALLATION DIAGRAM. MANUFACTURER INSTRUCTIONS TO BE PROVIDED AT A LATER DATE.
- 3. ALL WORK BY DISTRICT OR OTHERS SHALL MEET NFPA (NEC 2020) STANDARDS.
 4. ALL WORK BY DISTRICT OR OTHERS SHALL MEET STANDARDS SET FORTH BY THE FOLLOWING:
- 4.1. NATIONAL FEDERATION OF STATE HIGH SCHOOL ASSOCIATIONS (NFHS)
- 4.2. NATIONAL COLLEGIATE ATHLETIC ASSOCIATION (NCAA)
- 4.3. INTERNATIONAL ASSOCIATION OF ATHLETICS FEDERATIONS (IAAF)
 4.4. AMERICAN SPORTS BUILDERS ASSOCIATION (ASBA)
- 4.5. MANUFACTURERS DATA AND RECOMMENDED INSTALLATIONS REQUIREMENTS
 4.6. WHERE THESE STANDARDS CONFLICT WITH OTHER REQUIREMENTS, THE MOST RESTRICTIVE REQUIREMENT SHALL GOVERN.

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45 KNOLLWOOD ROAD


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WARWICK VALLEY CENTRAL SCHOOL D
HIGH SCHOOL RENOVATIONS, FIELD WORK AN
EXTERIOR BATHROOM BUILDING
225 WEST STREET EXT, WARWICK, NY 10990

BB SED NO. 44-21-01-06-7-041-001 (F-wy football field) 89 SANFORDVILLE ROAD. WARW

ADDENDUM 1 5.3.2022

BID SET 04.08.2022

REVISION DATE

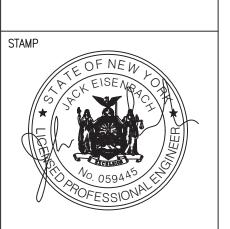DRAWN BY

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SHEET SIZE 30" X 42"

SCALE AS NOTED


PARTIAL SITE PLAN -

NEW WORK

PROJECT NO.

SHEET NO.

FF E-103

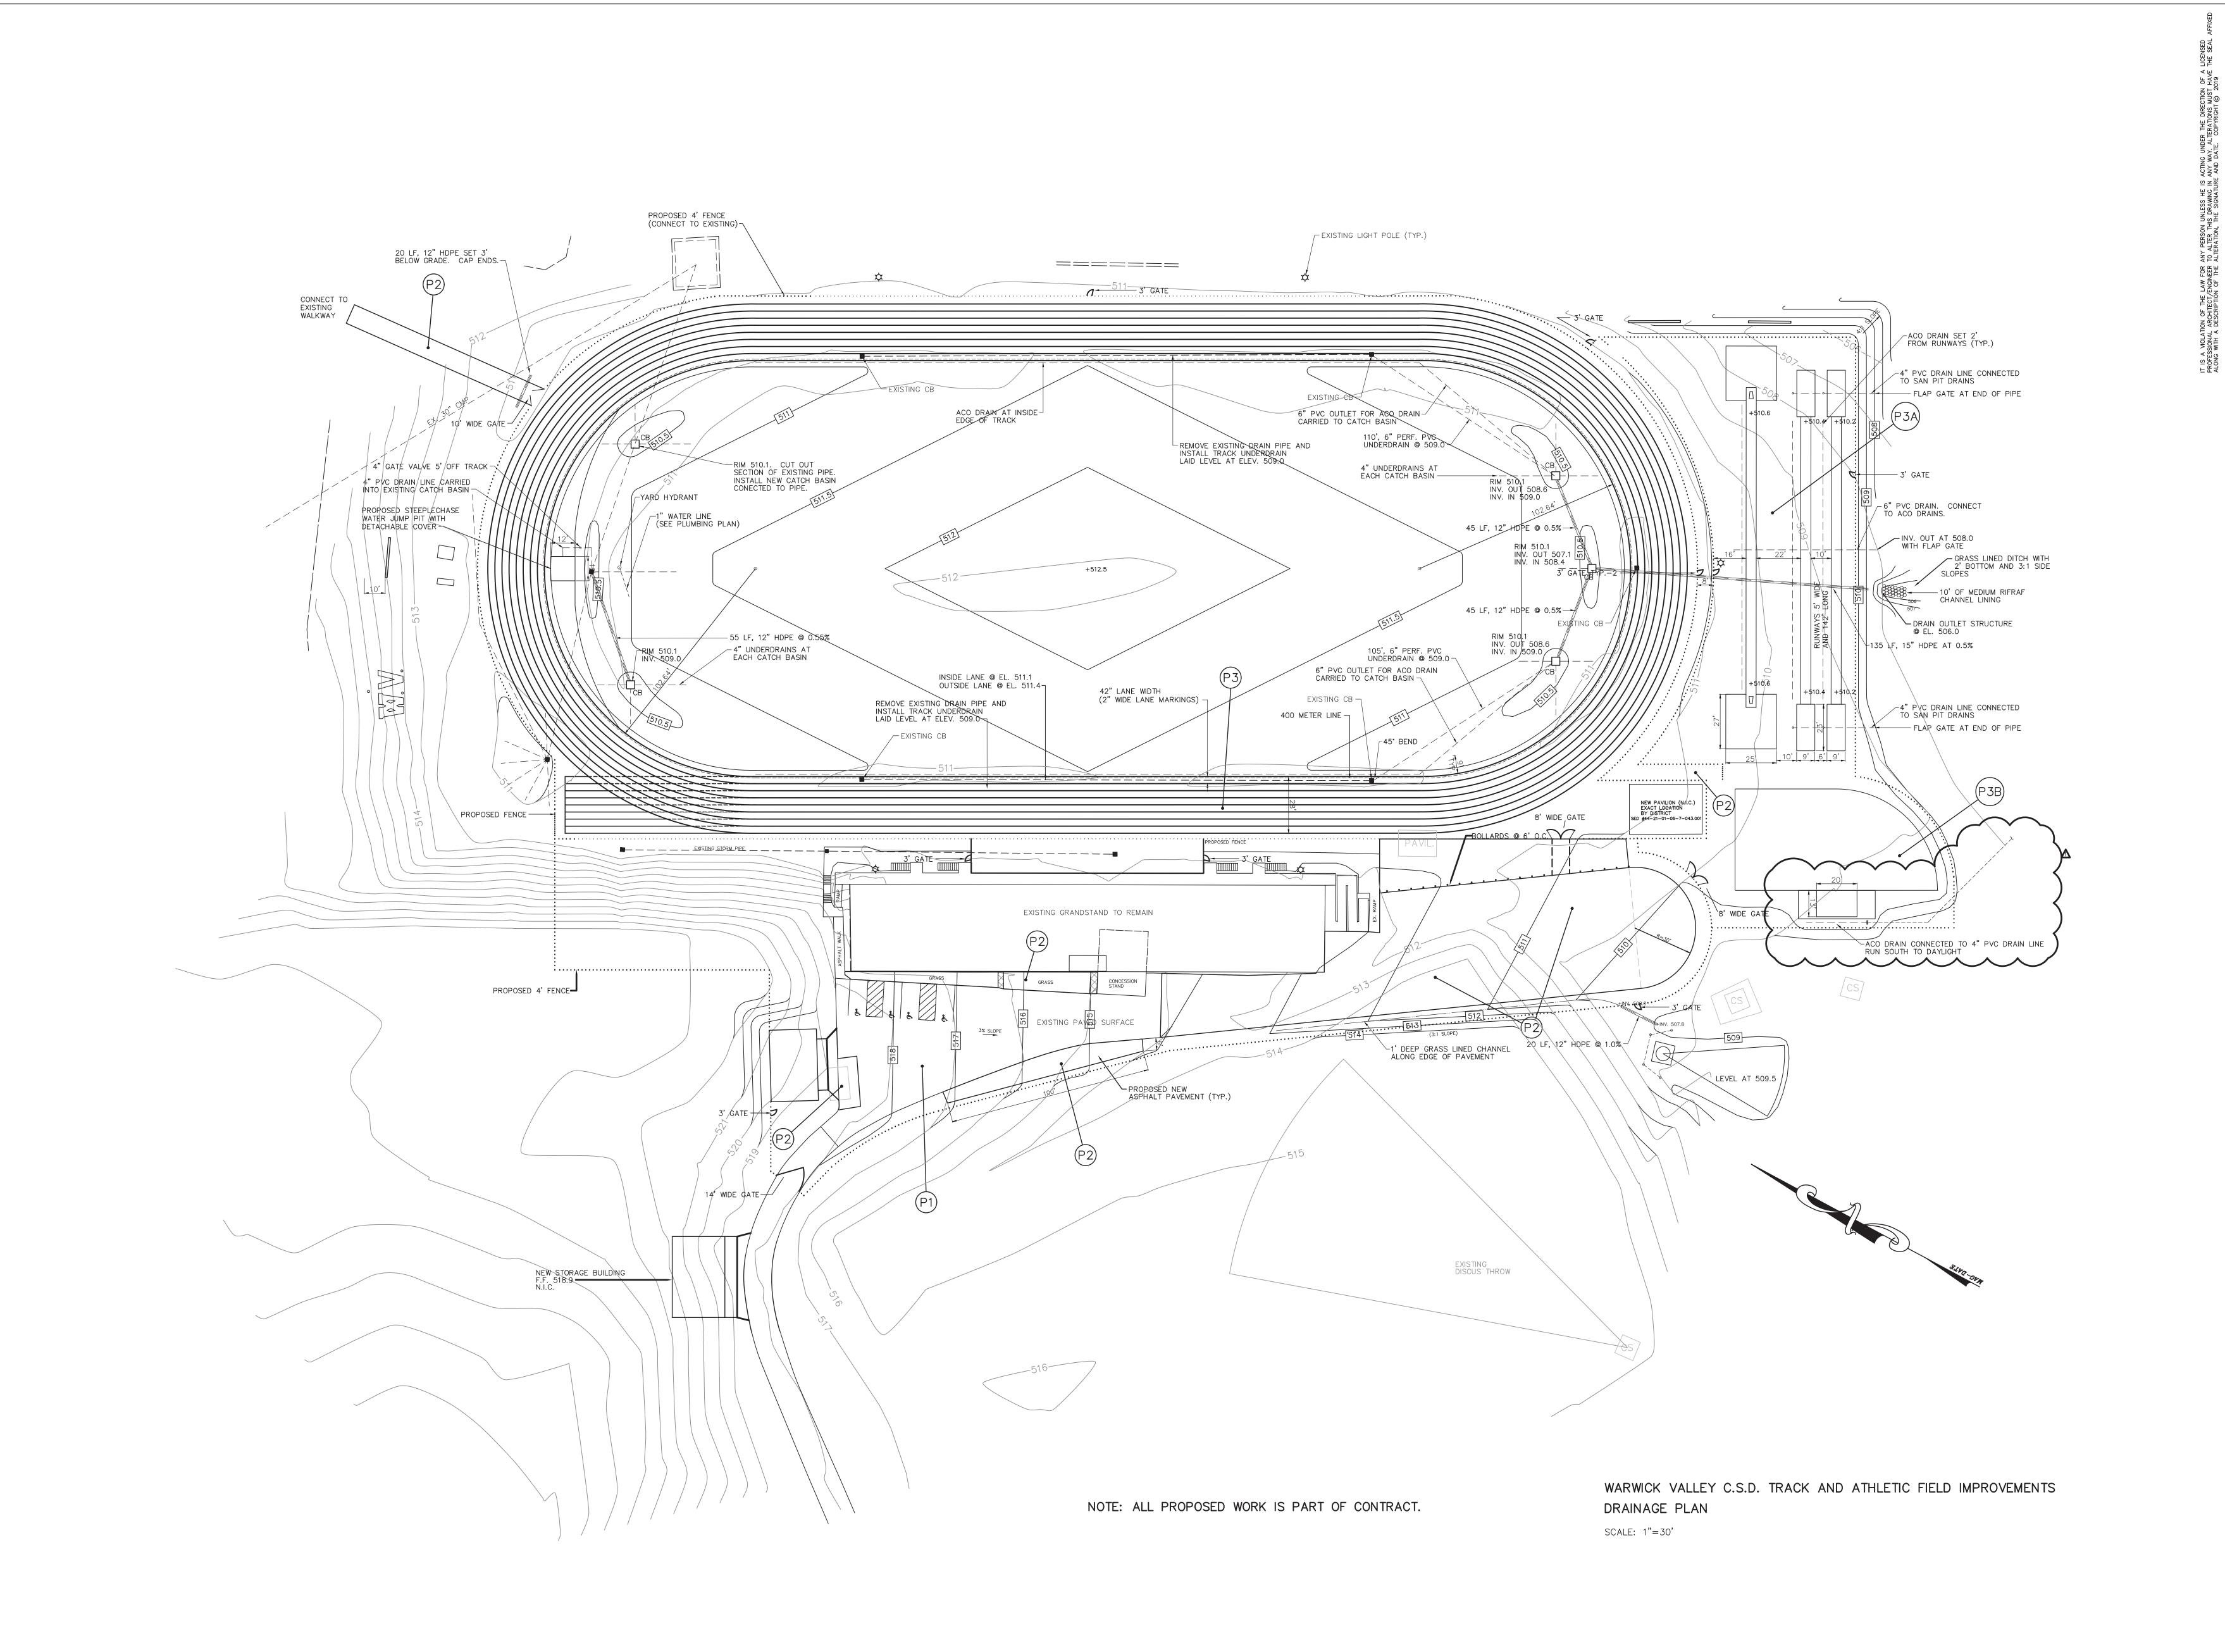

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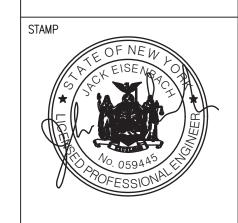
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WARWICK VALLEY CENTRAL SCHOOL DISTRICT
HIGH SCHOOL RENOVATIONS, FIELD WORK AND
EXTERIOR BATHROOM BUILDING

225 WEST STREET EXT, WARWICK, NY 10990

BB SED NO. 44-21-01-06-7-041-001 (FF-W FOOTBALL FIELD) 89 SANFORDVILLE ROAD. WARWICK, NY 10990

ADDENDUM 1 05.03.2022

BID SET 04.08.2022

REVISION DATE

DRAWN BY

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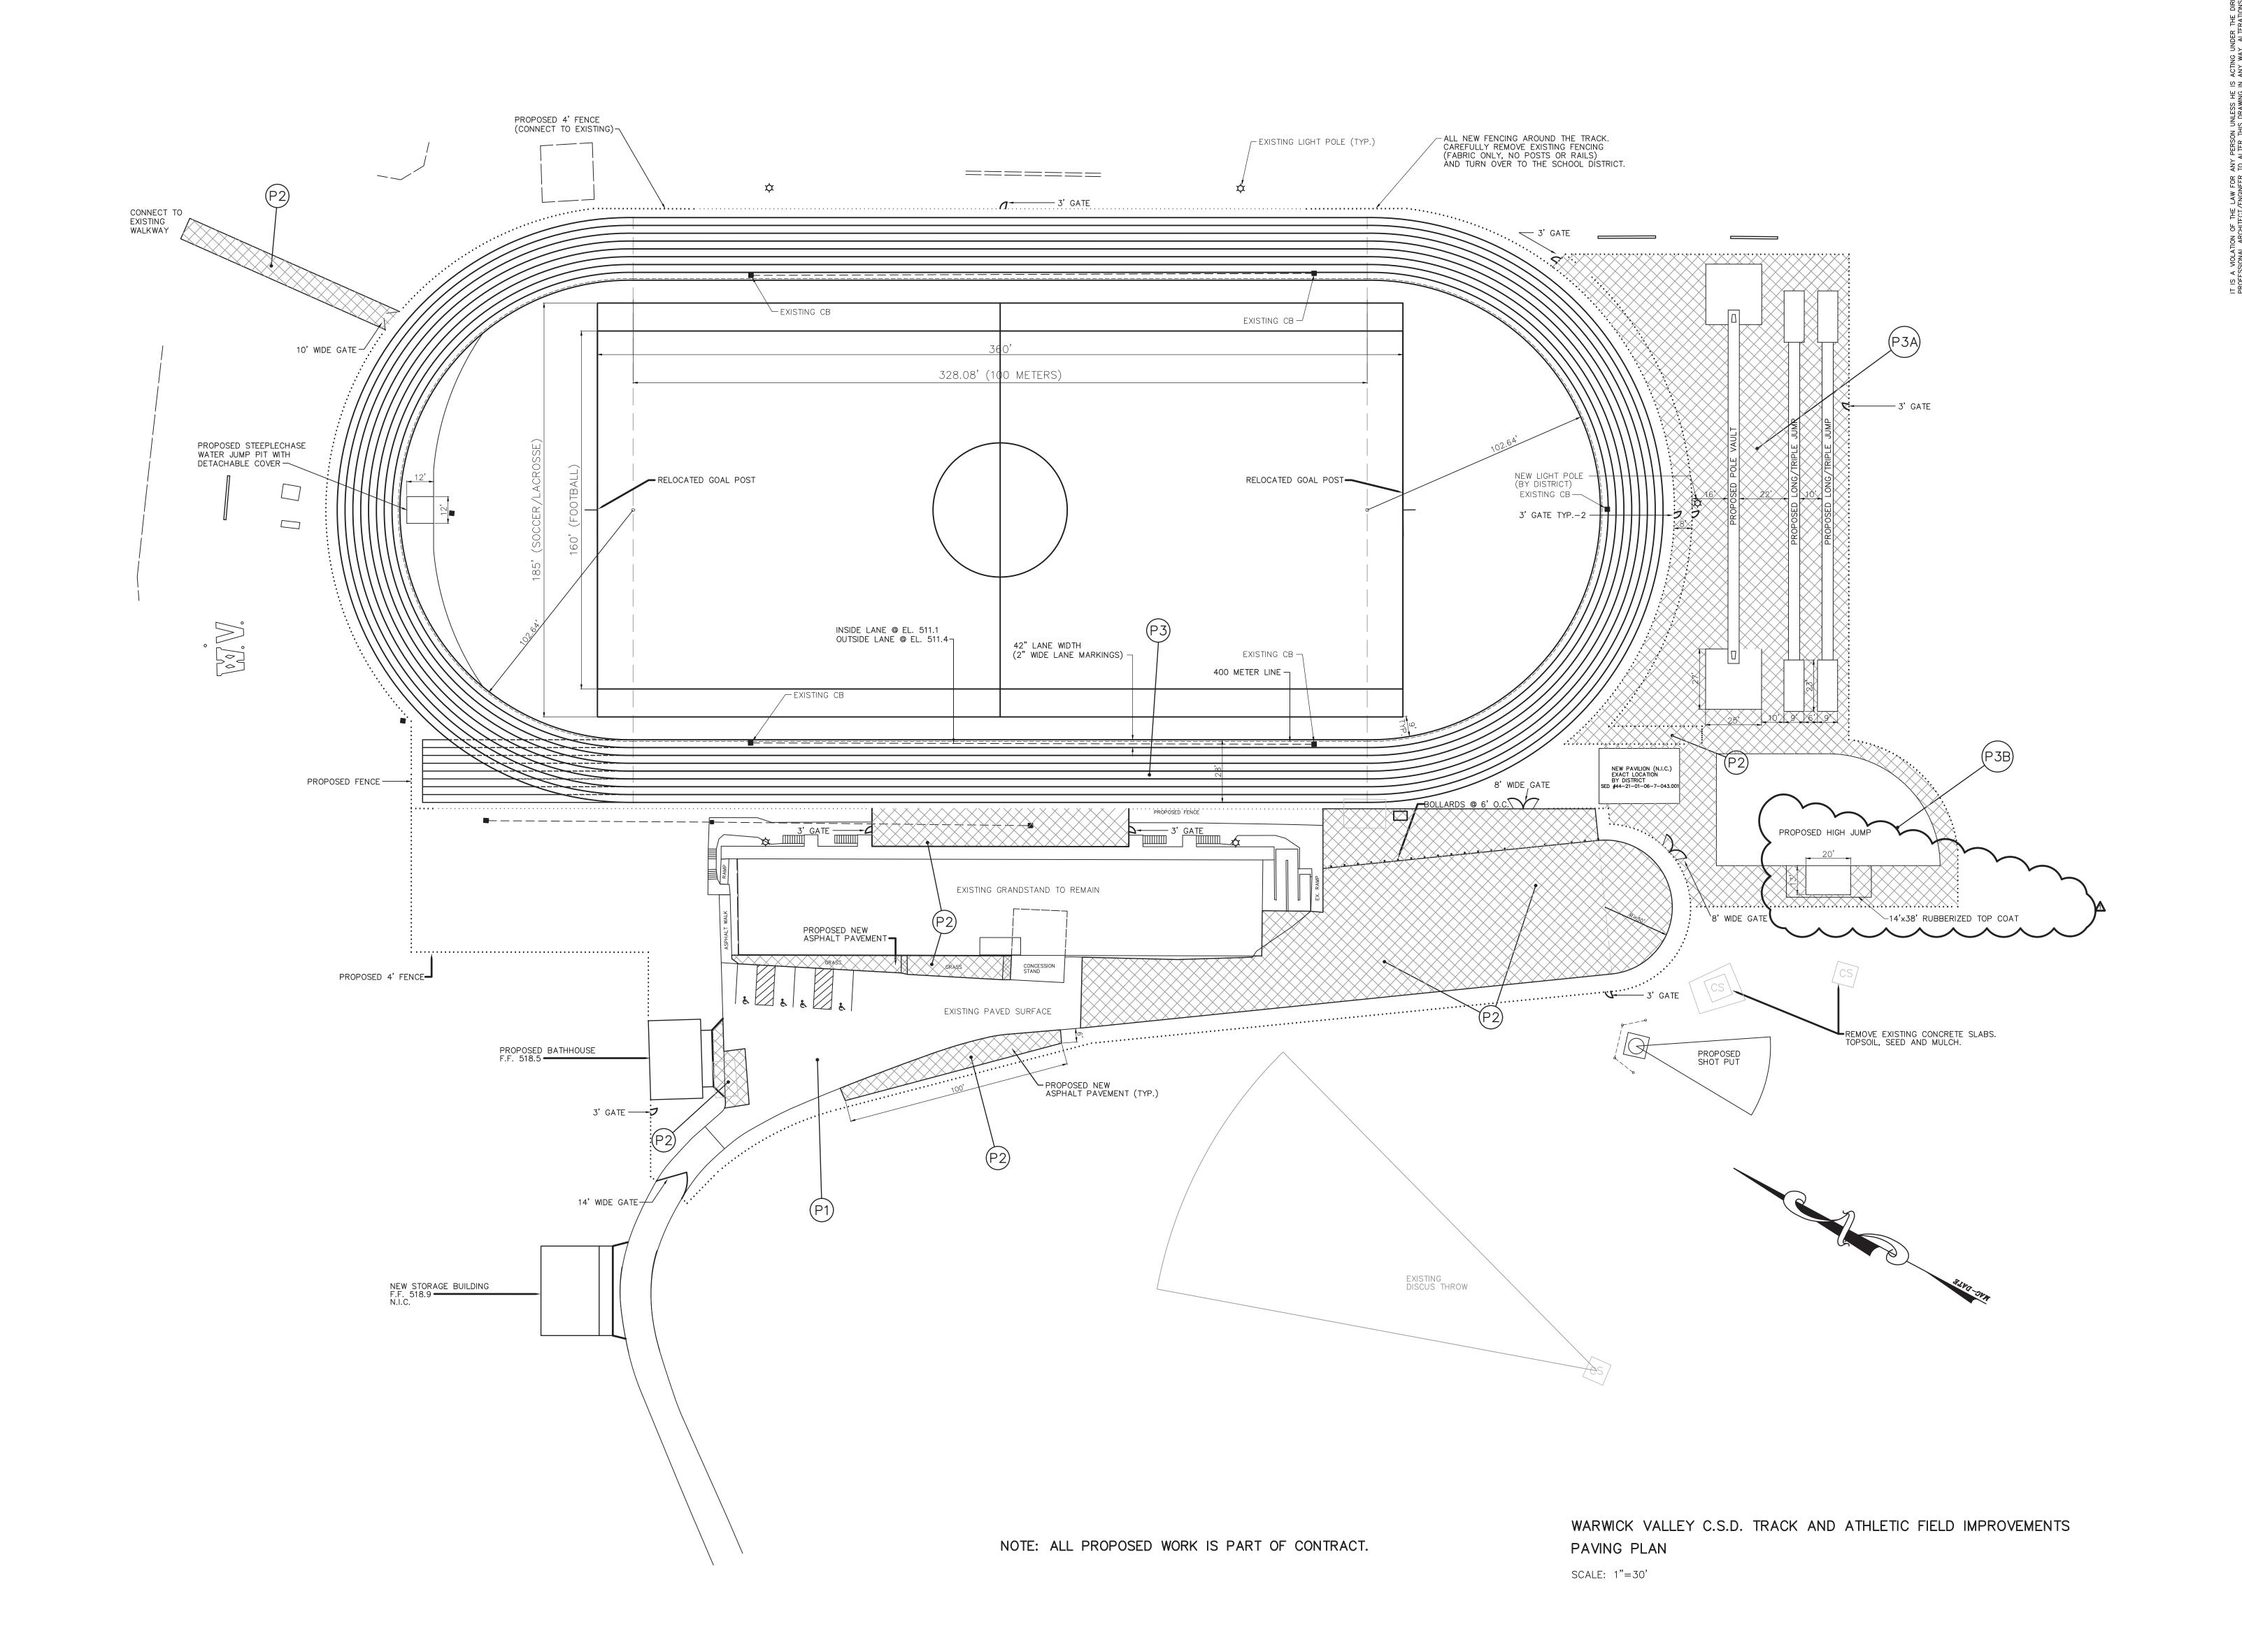
AS NOTED

DRAINAGE PLAN

SHEET TITLE

SHEET NO

S-122






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WARWICK VALLEY CENTRAL SCHOOL DISTF HIGH SCHOOL RENOVATIONS, FIELD WORK AND EXTERIOR BATHROOM BUILDING

225 WEST STREET EXT, WARWICK, NY 10990

SCHOOL RENOVATIONS, FIELD WORK AND 1255 WEST STREET EXT, WARWICK, NY 10990

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SCHOOL RENOVATIONS, FIELD WORK AND 10990

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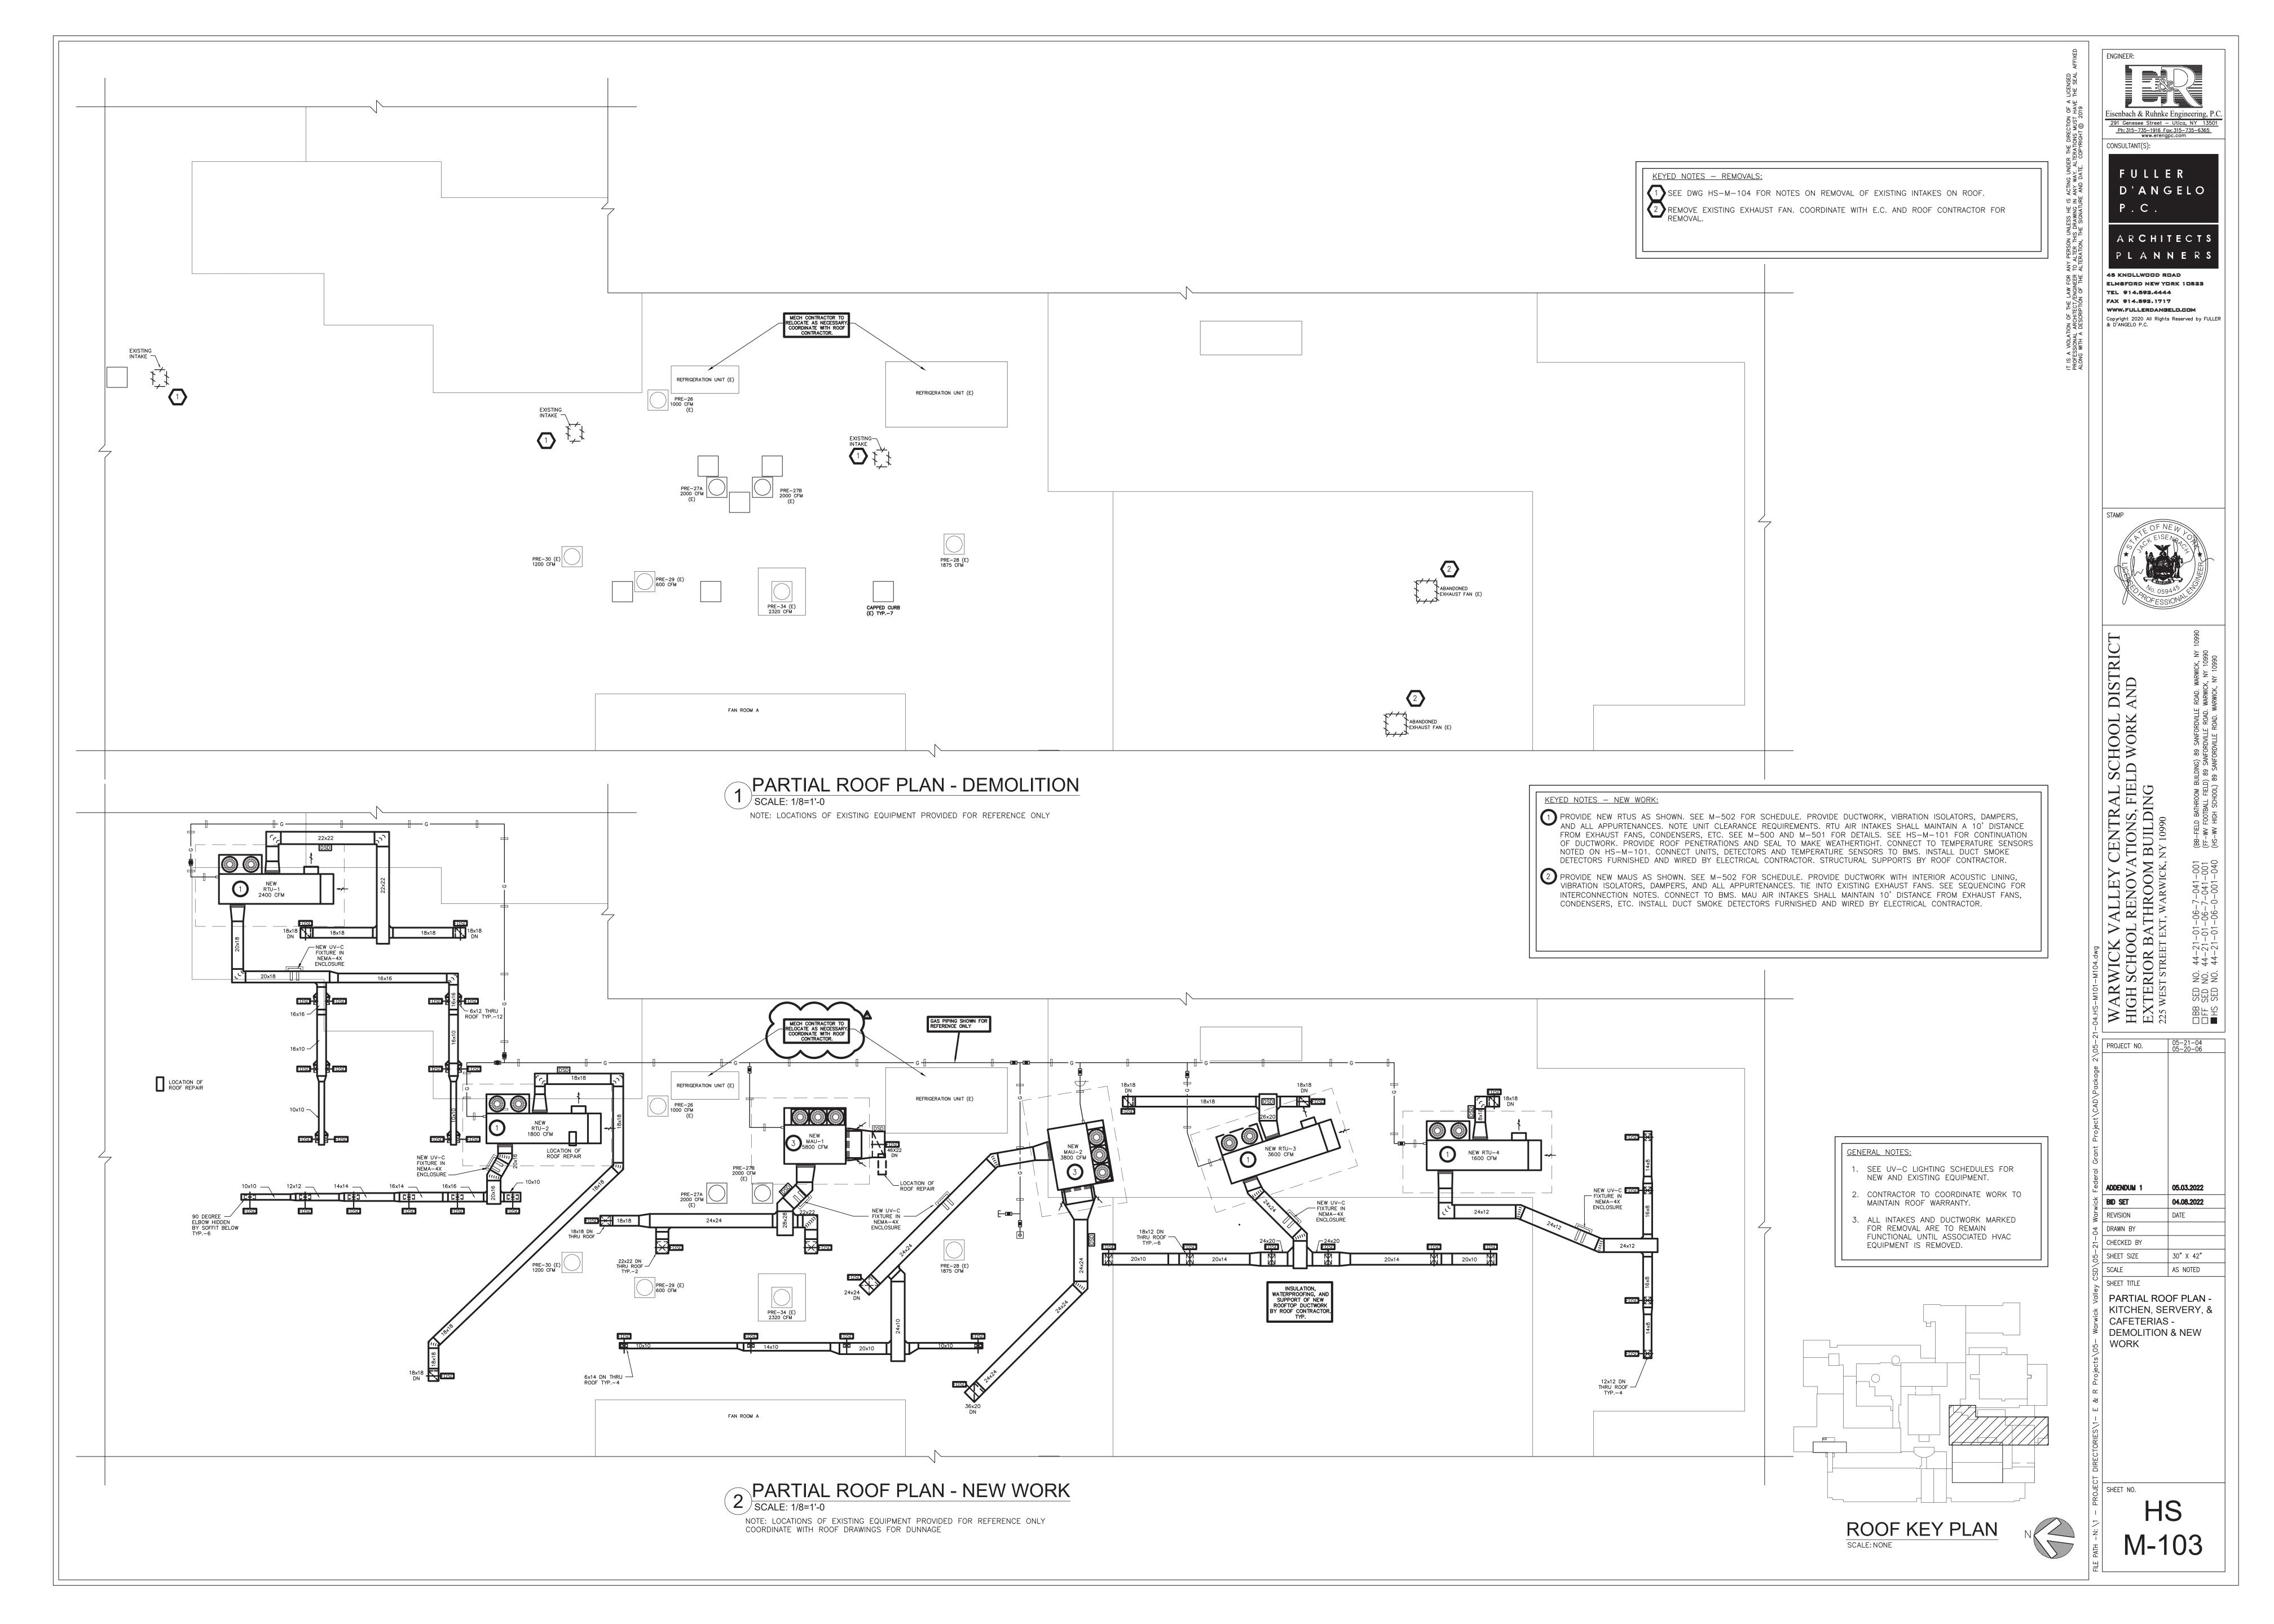
SCALE AS NOTED

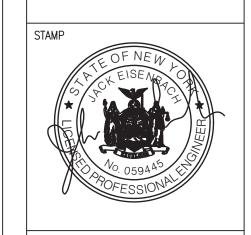SHEEL NO

SHEET TITLE


PAVING PLAN

S-124



PAN	IEL II	D: PP-1 VOLTS/PHASE/WIRE 277V/480Y/3PH/4W	PA 40		SIZE	MIN SCC LOCATION: N 22 KAIC	IECH F	ROOM
NOTES	CIR. No.	CIRCUIT DESCRIPTION	BKR.	ø	BKR.	CIRCUIT DESCRIPTION	CIR. No.	NOTES
	1			Α			2	
	3	IRRIGATION PUMP (PUMP PROVIDED BY IC)	40A	В	30A	GRINDER PUMP GP-2	4	1
	5			С			6	1
	7			Α	75A	ELECTRIC WATER HEATER EWH-2	8	
	9	GRINDER PUMP GP-1	30A	В	75A	ELECTRIC WATER HEATER EWH-3	10	1
	11	1		С	20A	PUMP CONTROLS	12	7
	13	SPACE	20A	Α	20A	ELECTRIC UNIT HEATER EUH1 (BOYS)	14	
	15	SPACE	20A	В	20A	ELECTRIC UNIT HEATER EUH3 (GIRLS)	16	7
	17	SPACE	20A	С	20A	ELECTRIC UNIT HEATER EUH2 (MECH RM)	18	1
	19	SPACE	20A	Α			20	
	21			В	60A	277/480V 50kVA 3PHASE TRANSFORMER	22	
	23	WELL PUMP	20A	С			24	
	25			Α	20A	SPACE	26	
	27	ELECTRIC WATER HEATER EWH-1	20A	В	20A	SPACE	28	
	29	SPACE		С	20A	SPACE	30	
	31	SPACE		Α	20A	SPACE	32	
	33	SPARE	20A	В	20A	SPARE	34	
	35	SPARE	20A	С	20A	SPARE	36	
	37	SPARE	20A	Α	20A	SPARE	38	
	39	SPARE	20A	В	20A	SPARE	40	
	41	SPARE	20A	С	20A	SPARE	42	

PAN	NEL II	D: PP-2	VOLTS/PHASE/WIRE 120V/208Y/3PH/4W		NEL 0A	SIZE	MIN SCC LOCATION: I 22 KAIC	MECH ROOM			
NOTES	CIR. No.		CIRCUIT DESCRIPTION	BKR.	ø	BKR.	CIRCUIT DESCRIPTION	CIR. No.	NOTES		
	1	LIGHTS		20A	Α	20A	EXHAUST FAN EF-1	2			
	3	LIGHTS		20A	В	20A	EXHAUST FAN EF-2	4			
	5	RECEPTAC	LES (GFI)	20A	С	20A	EXHAUST FAN EF-3	6			
	7	RECEPTAC	LES (GFI)	20A	Α			8			
	9	POLE MOU	NTED LIGHTS	20A	В	20A	BOOSTER PUMP BP-1	10			
	11	SPACE			С			12			
	13				Α	20A	POLE MOUNTED LIGHTS	14			
	15	DOMESTIC	WATER PUMP DWP-1 (IN TANK)	20A	В	20A	HAND-DRYER (BOYS)	16			
	17				С	20A	HAND-DRYER (GIRLS	18			
	19	SPACE			Α		SPACE	20			
	21	SPARE		20A	В	20A	SPARE	22			
	23	SPARE		20A	С	20A	SPARE	24			
	25	SPARE		20A	Α	20A	SPARE	26			
	27	SPARE		20A	В	20A	SPARE	28			
	29	SPARE		20A	С	20A	SPARE	30			

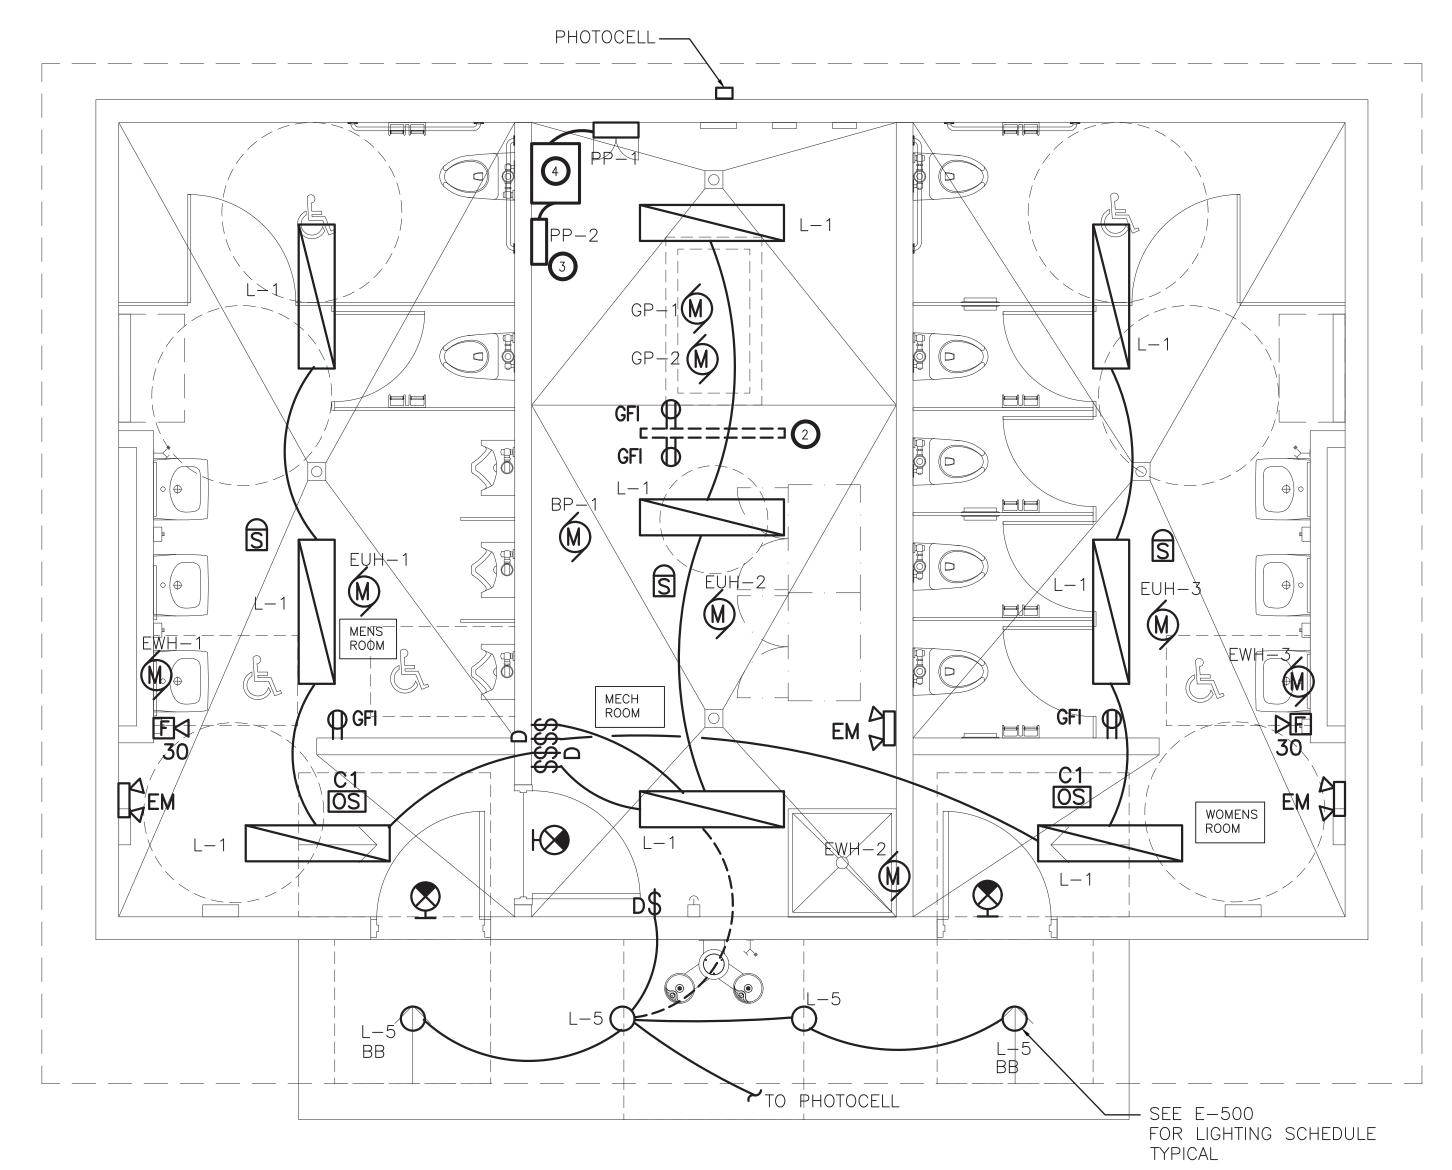

1 BATHROOM FLOOR PLAN - NEW WORK SCALE: 3/8"=1'-0"



KEYED NOTES - NEW WORK:

- PROVIDE LIGHT FIXTURES, WIRING, CONDUITS, SWITCHING AND ALL APPURTENANCES AS SHOWN.
- PROVIDE UNISTRUT FRAME FOR MOUNTING CONTROL PANELS AND OUTLETS PROVIDE 4'-0" WIDE BY 4'-0" HIGH (2) 34"PLYWOOD PAINTED GREY BOTH SIDES. MOUNT 3'-0" AFF.
- PROVIDE A 100 AMP PANEL (PP-2) 120-208V 3PH 4 WIRE 60 HZ, MIN SCC 22 KAIC WITH ASSOCIATED STEPDOWN TRANSFORMER 45 KVA AND APPURTENANCES.
- PROVIDE AND INSTALL 45kVA 277/480V 3PHASE PRIMARY TO 120/208V WYE SECONDARY TRANSFORMER, EATON MODEL V48M28T4516 OR EQUIVALENT.

									ELE	ECTRIC	EQUIPMEN	T AND	CONTRO	L SCHEDU	JLE										
EQUIPMENT SUPPLY													CONTROLLER DEVICE TYPE & ACCESSORIES (UNO, PROVIDED BY ELECTRICAL CONTRACTOR)												
DESIGNAT	ION DESCRIPTION	ROOM LOCATION	SIZE		VOLTAGE/ PHASE/HZ	PANEL/ CONTROL CENTER	CIRCUIT NUMBER	BREAKER SIZE	POWER WI PANEL TO UNIT	RING FROM CONTROL	POWER WIRIN CONTROL UN EQUIPMENT	IG FROM IT TO	GROUND WIF (SIZED PER NEC)		VARIABLE FREQUENCY DRIVE	CONTROL STARTER	NON-FUSED DISCONNECT SWITCH	DEVICE INSTALL	DUCT SMOKE DETECTOR	DUCT SMOKE DETECTOR	FIRE ALARM FAN	DISCONNEC	CT SWITCH	REF NOT	DESIGNATION
			HP/WATT	s MOP	MCA				WIRE	COND.	WIRE	COND.	1	OTHERS)	(VFD)		1	LOCATION	(SUPPLY)	(RETURN)		FRAME	FUSE	LOCATION	
GP-1	GRINDER PUMP (OUTDOOR BATHROOM)	MECH RM	1.5	20	3.4 460V/3¢/60H	z PP-1	SEE PANEL SCHED	30A	#12	1"	FACTORY WIRED		#12				FACTORY WIRE	AT UNIT				60			
GP-2	GRINDER PUMP (OUTDOOR BATHROOM)	MECH RM	1.5	20	3.4 460V/3ф/60Н	z PP-1	SEE PANEL SCHED	30A	#12	1"	FACTORY WIRED		#12				FACTORY WIRE	AT UNIT				60			
EF-1	EXHAUST FAN	BOYS	217 WATT	s 20	4 120V/1¢/60H	z PP-2	SEE PANEL SCHED	20A	#12	1"			#12				FACTORY WIRE	AT UNIT				60			
EF-2	EXHAUST FAN	MECH RM	100 WATT:	s 20	2 120V/1¢/60H	z P P-2	SEE PANEL SCHED	20A	#12	1"			#12				FACTORY WIRE	AT UNIT				60			
EF-3	EXHAUST FAN	GIRLS	217 WATT	s 20	4 120V/1¢/60H	z P P-2	SEE PANEL SCHED	20A	#12	1"			#12				FACTORY WIRE	AT UNIT				60			
EUH-1	ELECTRIC UNIT HEATER	BOYS		20	10.8 277V/1ф/60Н	z PP-1	SEE PANEL SCHED	20A	#12	1"			#12				FACTORY WIRE	AT UNIT				60			
EUH-2	ELECTRIC UNIT HEATER	MECH RM		20	10.8 277V/1ф/60Н	z PP-1	SEE PANEL SCHED	20A	#12	1"			#12				FACTORY WIRE	AT UNIT				60			
EUH-3	ELECTRIC UNIT HEATER	GIRLS		20	10.8 277V/1ф/60Н	z PP-1	SEE PANEL SCHED	20A	#12	1"			#12				FACTORY WIRE	AT UNIT				60			
EWH-1	ELECTRIC WATER HEATER	BOYS		75	58 277V/1¢/60H	z PP-1	SEE PANEL SCHED	75A	#4	1½"			#8				FACTORY WIRE	AT UNIT				100			
EWH-2	ELECTRIC WATER HEATER	MECH RM		75	58 277V/1¢/60H	z PP-1	SEE PANEL SCHED	75A	#4	11/4"			#8				FACTORY WIRE	AT UNIT				100			
EWH-3	ELECTRIC WATER HEATER	GIRLS		75	58 277V/1φ/60H	Z PP-1	SEE PANEL SCHED	75A	#4	11/4"			#8				FACTORY WIRE	AT UNIT				100			
WP-1	WELL PUMP	EXTERIOR				~																			NOTE 2
BP-1	BOOSTER PUMP	MECH RM	2	20	4 208V/3¢/60H		SEE PANEL SCHED	20A	#12	1"			#12				FACTORY WIRE	AT UNIT				60			
DWP-1	DOMESTIC WATER PUMP (IN TANK) EXTERIOR	1.5	20	8.4 230V/3¢/60H	Z PP−2 /	SEE PANEL SCHED	20A	#12	1"			#12				FACTORY WIRE	AT UNIT				60			

AU — AT UNIT N/A — NOT APPLICABLE FRAC. — FRACTIONAL

1. FOLLOW NEC 2020 (NFPA 70) REQUIREMENTS. 2. WELL PUMP WP-1 (TBD) THE WELL DRILLER NEEDS TO PROVIDE A CERTIFIED WATER REPORT FOR PROPER SIZING OF THE WELL PUMP AND REVERSE OSMOSIS SYSTEM. PROVIDE A ALLOWANCE OF \$20,000 DOLLARS FOR BIDDING PURPOSES ONLY FINAL SIZING BY MECHANICAL ENGINEER.


AS PART OF BASE BID, ALL WORK ON THIS DRAWING SHALL BE PROVIDED IN ITS ENTIRETY BY THE ELECTRICAL CONTRACTOR.



CONSULTANT(S): FULLER D'ANGELO P.C.

ARCHITECTS PLA**NNERS**

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PROJECT NO.

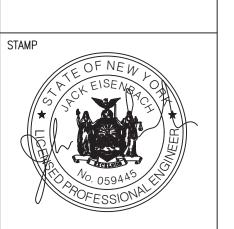ADDENDUM 1 04.08.2022 REVISION t DRAWN BY CHECKED BY 30" X 42"

AS NOTED

SHEET TITLE BATHROOM FLOOR PLAN - NEW WORK

SCALE

불 SHEET NO. BB