

GENERAL PLUMBING NOTES:

- I. DRAWINGS ARE DIAGRAMMATIC AND INDICATE GENERAL ARRANGEMENT OF SYSTEMS AND WORK INCLUDED IN THE CONTRACT. IT IS NOT INTENDED TO SPECIFY OR SHOW EVERY OFFSET, FITTING OR COMPONENT; HOWEVER, CONTRACT DOCUMENTS REQUIRE COMPONENTS AND MATERIALS WHETHER OR NOT INDICATED OR SPECIFICALLY SPECIFIED TO MAKE THE SYSTEMS BEING INSTALLED COMPLETE, CODE COMPLIANT, TESTED AND OPERATIONAL.
- 2. CONTRACTOR SHALL FIELD VERIFY ALL LOCATIONS, DIMENSIONS AND ELEVATIONS PRIOR TO CONSTRUCTION.
- 3. ALL MATERIALS, EQUIPMENT, METHODS OF INSTALLATION, REMOVALS AND DISPOSAL SHALL BE IN ACCORDANCE WITH THE STANDARDS, REGULATIONS, CODES, ORDINANCES, AND LAWS OF LOCAL, STATE, AND FEDERAL GOVERNMENTS, AND OTHER AUTHORITIES THAT HAVE LAWFUL JURISDICTION.
- PERFORM WORK, PROVIDE MATERIALS AND EQUIPMENT FOR SYSTEMS SHOWN, SPECIFIED AND DESCRIBED ON DRAWINGS. COMPLETELY COORDINATE ALL TRADES OF THIS CONTRACT AND PROVIDE COMPLETE AND FULLY FUNCTIONAL INSTALLATION. ALL WORK IN THIS SET TO BE COMPLETED UNDER THIS CONTRACT, UNLESS OTHERWISE INDICATED.
- 5. PROTECT ALL EXISTING AND NEW BUILDING ELEMENTS FROM DAMAGE. CONTRACTOR SHALL RESTORE ALL DAMAGED ELEMENTS TO ORIGINAL OR BETTER CONDITION.
- 6. WORK SHALL BE EXECUTED IN A WORKMANLIKE MANNER AND SHALL PRESENT NEAT, RECTILINEAR APPEARANCE WHEN COMPLETED. MAINTAIN MAXIMUM HEAD ROOM AT ALL TIMES. DO NOT RUN PIPES, DUCTS, AND CONDUIT EXPOSED UNLESS SHOWN AND NOTED TO BE EXPOSED ON DRAWINGS.
- 7. MATERIALS AND EQUIPMENT SHALL BE NEW AND INSTALLED ACCORDING TO MANUFACTURER'S INSTRUCTIONS AND RECOMMENDATIONS. MAINTAIN MANUFACTURER'S EQUIPMENT CLEARANCES.
- 8. CONTRACTOR IS RESPONSIBLE FOR ALL WORK RELATED TO ISOLATING, SHUTTING DOWN, DRAINING, FILLING AND TESTING SYSTEMS TO ALLOW FOR COMPLETION OF WORK. INTERRUPTIONS TO EXISTING SERVICES AND SYSTEMS SHALL BE AS SHORT AS POSSIBLE AND AT A TIME AND DURATION APPROVED BY THE OWNER AND UTILITY AS APPLICABLE. INCLUDE ALL PREMIUM TIME ASSOCIATED WITH INTERRUPTIONS. ALL SYSTEM INTERRUPTIONS SHALL BE SCHEDULED WITH OWNER, UTILITY AND COORDINATED WITH OTHER TRADE WORK.
- 9. ALL EQUIPMENT PIPING, WIRING, INSULATION ETC. INSTALLED IN HVAC AIR PLENUM SPACES SHALL MEET CODE REQUIREMENTS FOR SMOKE AND COMBUSTIBILITY.
- 10. SEAL ALL PENETRATIONS THROUGH FIRE RATED WALLS, PARTITIONS AND FLOORS WITH UL RATED MATERIALS/METHODS EQUIVALENT TO FIRE RATING OF ASSEMBLY
- 11. PROVIDE PROPER ACCESS TO EQUIPMENT THAT REQUIRES INSPECTION, REPLACEMENT OR REPAIR. ACCESS PANELS/DOORS SHALL BE A MINIMUM OF 12"X12", UNLESS OTHERWISE NOTED.
- 12. DO NOT SUPPORT EQUIPMENT FROM SUSPENDED CEILINGS.
 ALL SUPPORT SHALL BE FROM BUILDING STRUCTURE OR
 FROM CEILING SUSPENSION SYSTEM WHICH HAS BEEN
 REINFORCED. SUPPORTS SHALL BE SELECTED AND
 INSTALLED TO PROVIDE A VIBRATION FREE INSTALLATION.
- 13. PLUMBING CONTRACTOR IS RESPONSIBLE FOR JETTING/SNAKING ALL SANITARY WASTE LINES (ALL FLOOR DRAINS) SHOWN ON THE DRAWINGS TO BE FULLY OPERATIONAL.
- 14. CLEANING DURING PLUMBING WORK: THE MECHANICAL ROOM AND ROOMS WHERE WORK WILL BE DONE TO MINIMIZE DISTURBANCE IN THE BUILDINGS. WORKERS ARE TO USE PATHWAYS AND FACILITIES AGREED UPON WITH THE DISTRICT DESIGNEE IN WRITING. THE AREA OUTSIDE THE BUILDING WHERE CUTTING, WELDING OR STORAGE IS ALLOWED IS TO BE FENCED AT ALL TIMES. THE CONTRACTOR WILL ON A DAILY BASIS CLEAN THE GROUNDS AND THE BUILDING OF ANY DEBRIS OR GARBAGE GENERATED BY THEIR WORK.
- 24. EACH CONTRACTOR RESPONSIBLE FOR RETURNING WALLS, CEILINGS AND SURFACES THEY DISTURB THAT ARE NOT SCHEDULED FOR REPLACEMENT BACK TO ORIGINAL CONDITIONS.

COORDINATION NOTE:

COORDINATE WITH ALL CONTRACTORS AND DISTRICT.

2. SEE SITE DRAWINGS FOR ADDITIONAL CONTRACTOR WORK AS MARKED.

Eisenbach & Ruhnke Engineering, P.C.

291 Genesee Street – Utica, NY 13501

Ph: 315-735-1916 Fax: 315-735-6365

www.erengpc.com

CONSULTANT(S):

CONSULTANT(S):

FULLER
D'ANGELO
P.C.

ARCHITECTS
PLANNERS


45 KNOLLWOOD ROAD
ELMSFORD NEW YORK 10523

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www.fullerdangelo.com

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WARWICK VALLEY CENTRAL SCHOOL DIST HIGH SCHOOL RENOVATIONS, FIELD WORK AND EXTERIOR BATHROOM BUILDING

225 WEST STREET EXT, WARWICK, NY 10990

BB SED NO. 44-21-01-06-7-041-001 (F-wy football field) 89 Sanfordville Road. Warwick, NY 10910 (F-wy football field) 89 Sanfordville Road. Warwick, NY 10910 (HS-wy High School) 89 Sanfordville Road. Warwick, NY 10910 (HS-wy High School) 89 Sanfordville Road. Warwick, NY 10910 (HS-wy High School) 89 Sanfordville Road. Warwick, NY 10910 (HS-wy High School) 89 Sanfordville Road. Warwick, NY 10910 (HS-wy High School) 89 Sanfordville Road. Warwick, NY 10910 (HS-wy High School) 89 Sanfordville Road. Warwick, NY 10910 (HS-wy High School) 89 Sanfordville Road. WARWICK, NY 10910 (HS-wy High School) 89 Sanfordville Road. WARWICK, NY 10910 (HS-wy High School) 89 Sanfordville Road. WARWICK, NY 10910 (HS-wy High School) 89 Sanfordville Road. WARWICK, NY 10910 (HS-wy High School) 89 Sanfordville Road. WARWICK, NY 10910 (HS-wy High School) 89 Sanfordville Road. WARWICK, NY 10910 (HS-wy High School) 89 Sanfordville Road. WARWICK, NY 10910 (HS-wy High School) 89 Sanfordville Road. WARWICK, NY 10910 (HS-wy High School) 89 Sanfordville Road. WARWICK, NY 10910 (HS-wy High School) 89 Sanfordville Road. WARWICK, NY 10910 (HS-wy High School) 89 Sanfordville Road. WARWICK, NY 10910 (HS-wy High School) 89 Sanfordville Road.

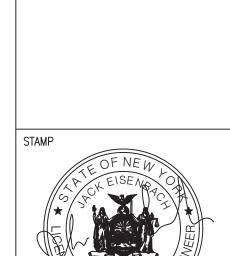BID SET 04.08.2022

REVISION DATE

DRAWN BY

CHECKED BY

SHEET SIZE 30" X 42"

SCALE AS NOTED


SHEET TITLE

ABBREVIATIONS

ABBREVIATIONS AND NOTES

PROJECT NO.

SHEET NO.

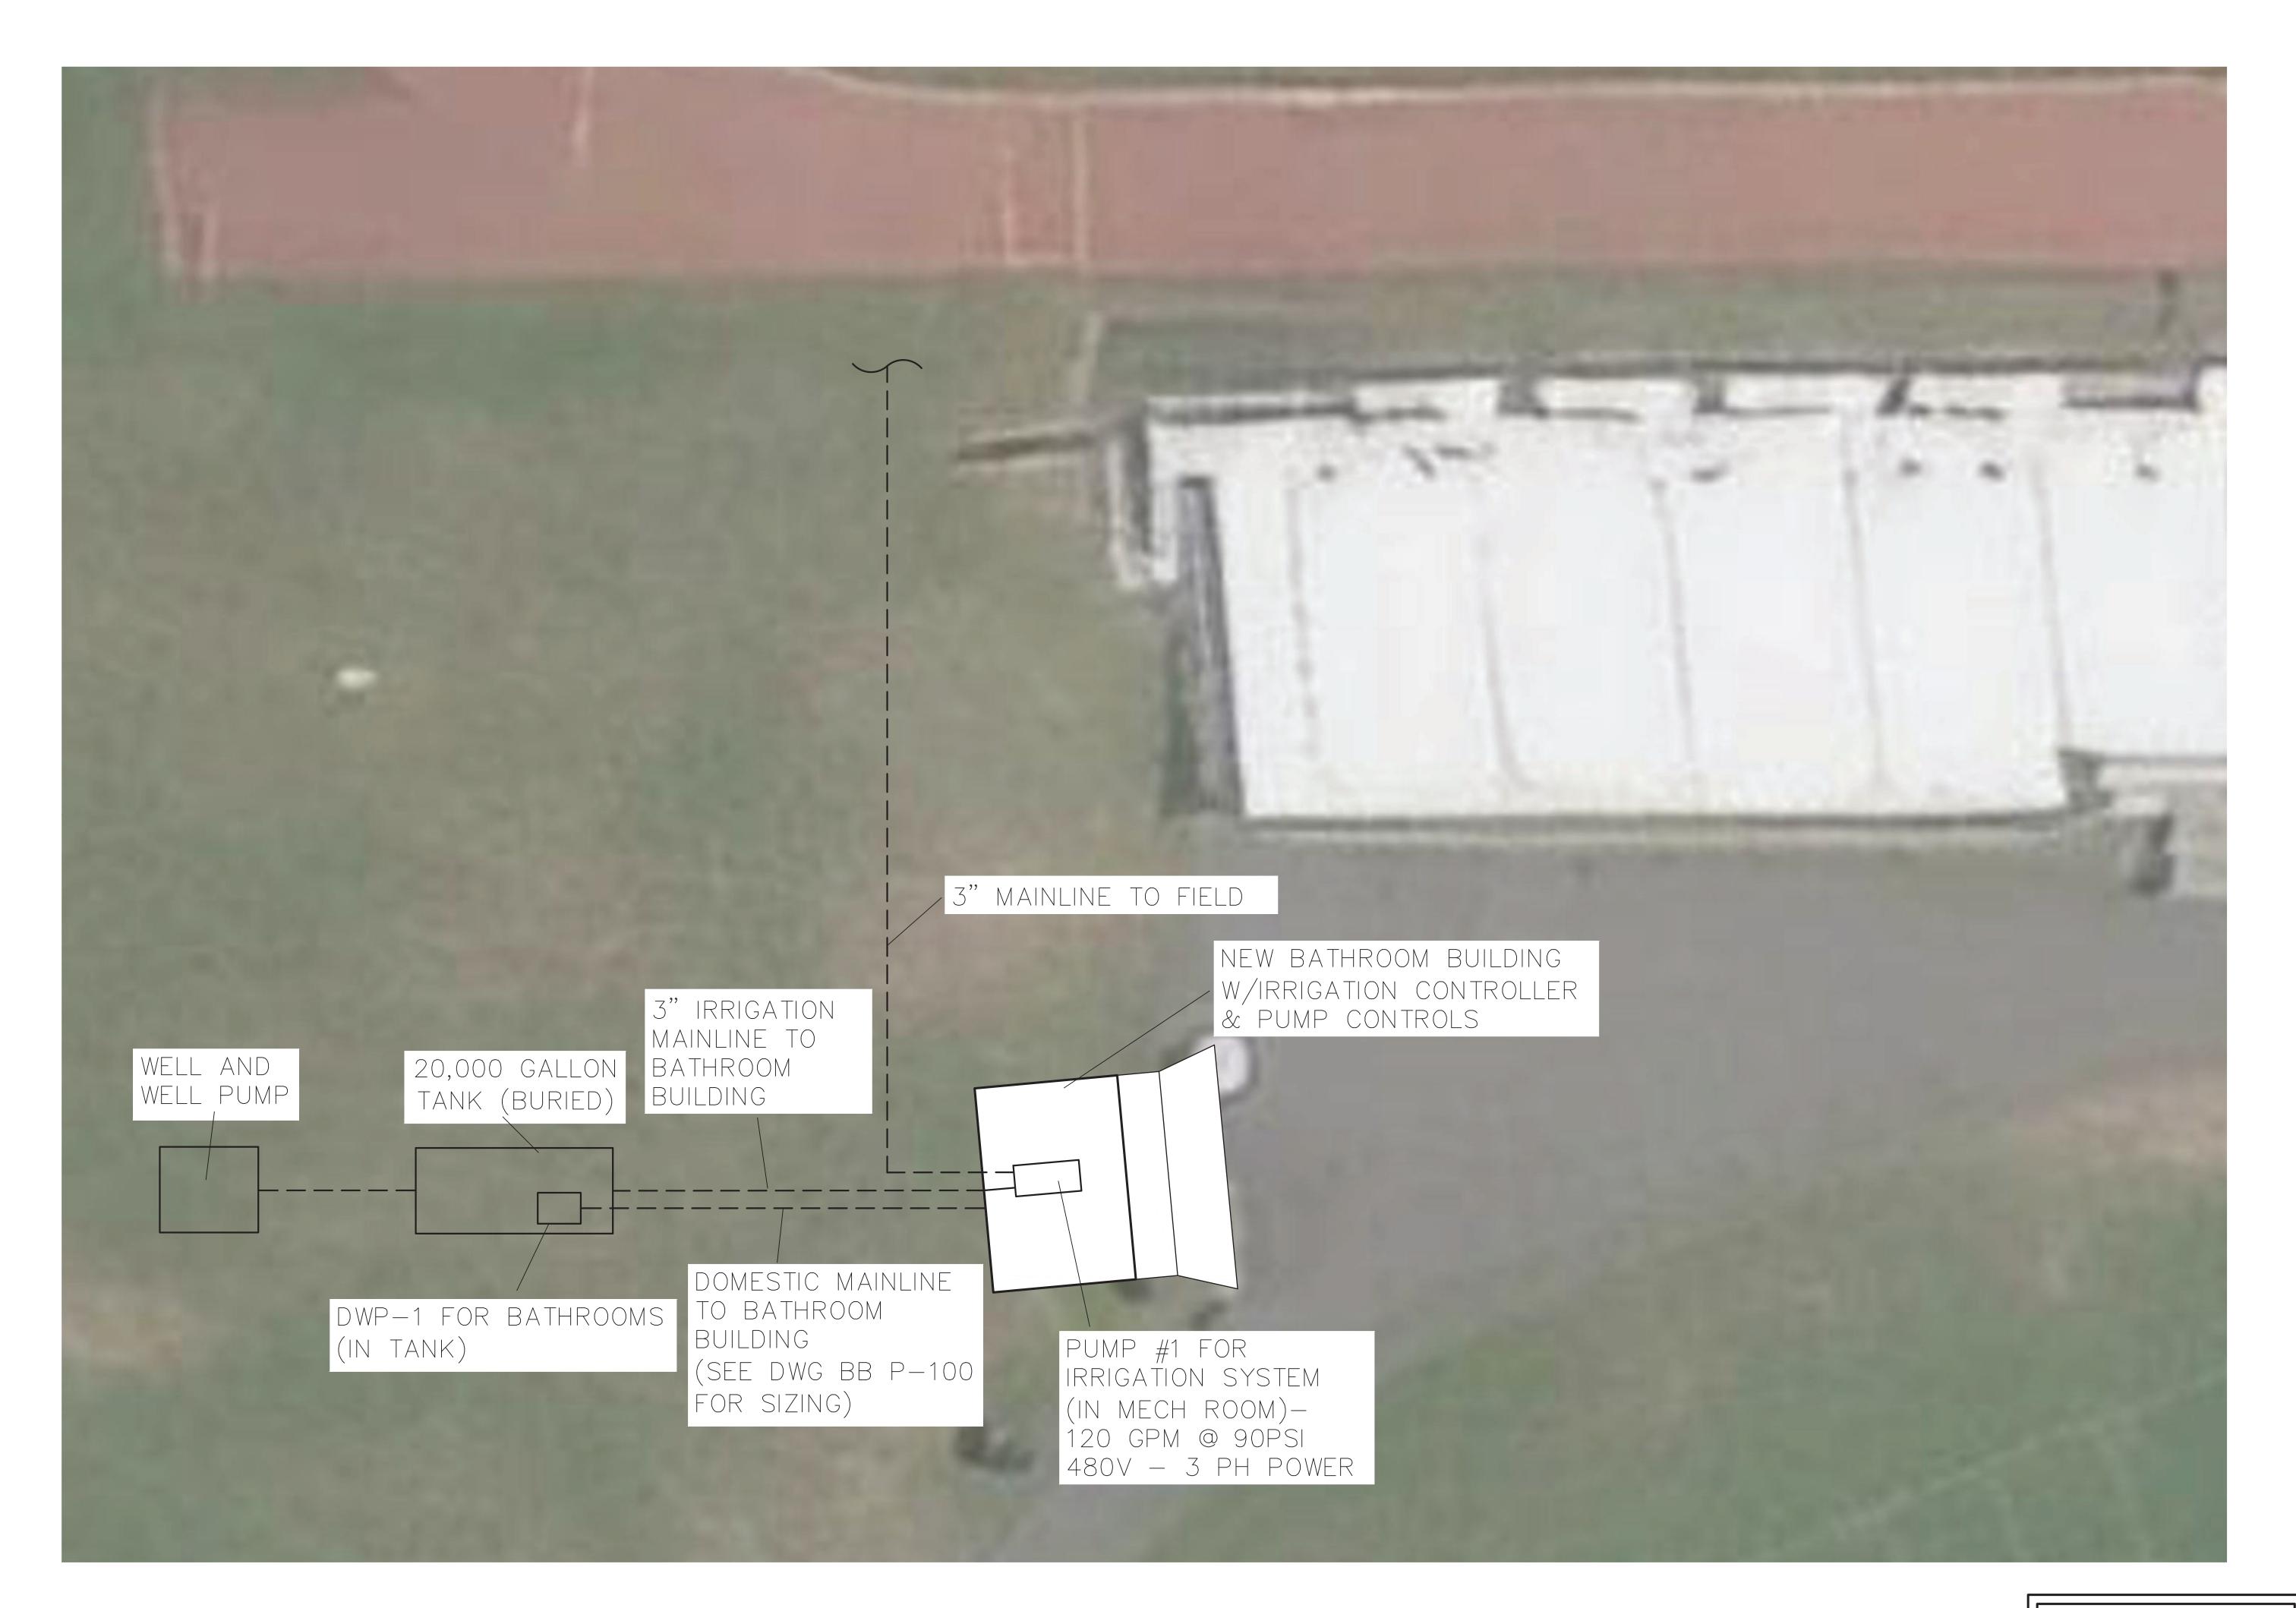

COORDINATION NOTE:

- COORDINATE WITH SITE AND BATHROOM BUILDING DRAWINGS.
- 2. COORDINATE WITH ALL CONTRACTORS AND DISTRICT.

FF P-100

Eisenbach & Ruhnke Engineering, P.C.

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www.erengpc.com

CONSULTANT(S):

FULLER

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ARCHITECTS

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PLANNER

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WARWICK VALLEY CENTRAL SCHOOL DIST HIGH SCHOOL RENOVATIONS, FIELD WORK AND EXTERIOR BATHROOM BUILDING 225 WEST STREET EXT, WARWICK, NY 10990

BID SET


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04.08.2022


30" X 42" AS NOTED

PARTIAL SITE PLAN -NEW WORK



NEW BATHROOM

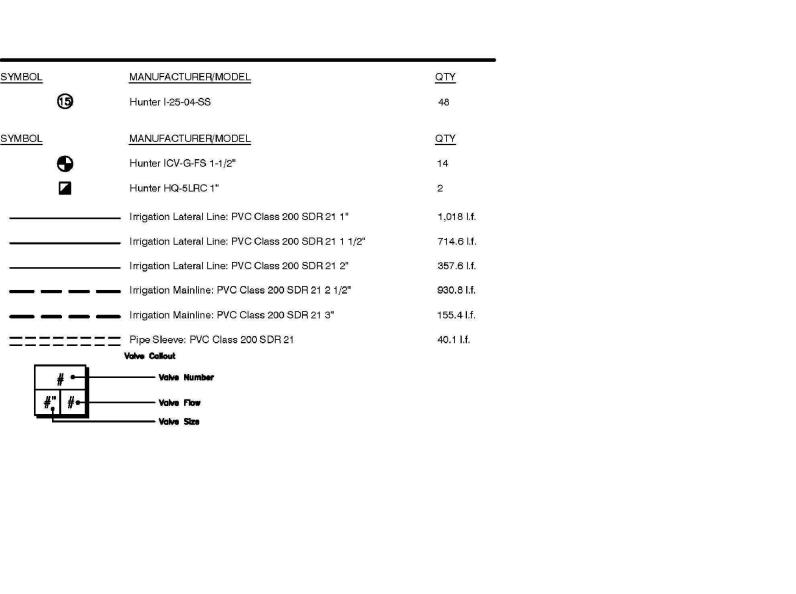NUMBER	MODEL	TYPE	PRECIP	IN./WEEK	MIN./WEEK	GAL./WEEK	GAL./D
1	Hunter ICV-G-FS	Turf Rotor	0.43 in/h	1	142	5,708	OF ILI,
2	Hunter ICV-G-FS	Turf Rotor	0.43 in/h	1	140	5,628	
3	Hunter ICV-G-FS	Turf Rotor	0.85 in/h	1	71	3,806	
4	Hunter ICV-G-FS	Turf Rotor	0.47 in/h	1	129	5,186	
5	Hunter ICV-G-FS	Turf Rotor	0.46 in/h	1	132	5,306	
6	Hunter ICV-G-FS	Turf Rotor	0.45 in/h	1	133	5,347	
7	Hunter ICV-G-FS	Turf Rotor	0.96 in/h	1	63	3,377	
8	Hunter ICV-G-FS	Turf Rotor	0.46 in/h	1	131	5,266	
9	Hunter ICV-G-FS	Turf Rotor	0.44 in/h	1	136	5,467	
10	Hunter ICV-G-FS	Turf Rotor	0.84 in/h	1	72	3,859	
11	Hunter ICV-G-FS	Turf Rotor	0.81 in/h	1	74	3,966	
12	Hunter ICV-G-FS	Turf Rotor	1.15 in/h	1	53	2,841	
13	Hunter ICV-G-FS	Turf Rotor	1.14 in/h	1	53	2,841	
14	Hunter ICV-G-FS	Turf Rotor	0.46 in/h	1	130	5,226	
		TOTALS:			1,459	63,824	

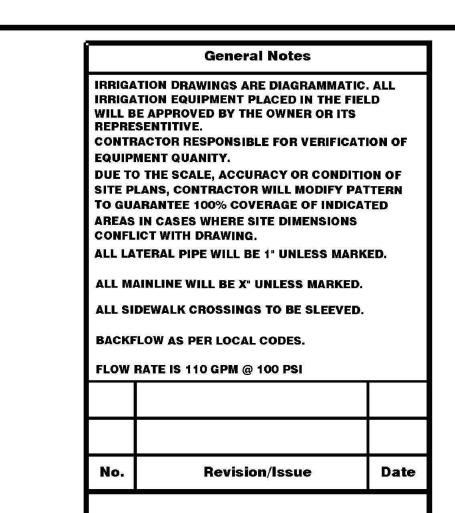

CENTRAL TURE & REGISTRON SUPPLY

DESIGN SERVICES
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E-MAIL: DESIGN@CENTRALTIS.COM

CENTRAL LOCATIONS

NEW YORK

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351 WEST RT. 59 NANUET, NY. 10954 STORE: (845) 356-7000 FAX: (845) 356-7068 EMAIL: NANUET@CENTRALTIS.COM

20 MARCONI BLVD COPIAGUE, NY 11726 STORE: (631) 249-4694 FAX: (631) 249-4696 EMAIL: COPIAGUE@CENTRALTIS.COM

502 CENTER AVE.
MAMARONECK, NY 10543
STORE: (914) 381-5520
FAX: (914) 381-5535
EMAIL: MAMARONECK@CENTRALTIS.COM

2711 LEXINGTON AVE.
MOHEGAN LAKE, NY 10547
STORE: (914) 743-1818
FAX: (914) 743-1820
EMAIL: MOHEGAN@CENTRALTIS.COM

Project Name and Address

Project 15 ·	Warwick High School	Sheet
Date	12-07-21	l
Drawn by: JP	Checked by: JP	IR-0
Scale	1" = 30'-0"	1

WARWICK HIGH SCHOOL WARWICK, NY

THIS DESIGN DRAWING IS THE PROOF CENTRAL IRRIGATION SUPPLY IN ANY UNAUTHORIZED USE, ALTERAT DUPLICATION THEREOF IS PROHIBIT

COORDINATION NOTE:

COORDINATE WITH SITE AND BATHROOM
 BUILDING DRAWINGS.

2. COORDINATE WITH ALL CONTRACTORS AND DISTRICT.

STAMP

ST

ENGINEER:

CONSULTANT(S):

FULLER

D'ANGELO

ARCHITECTS

PLANNERS

ELMSFORD NEW YORK 10523

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Eisenbach & Ruhnke Engineering, F

DING

BATHROOM BUILDING) 89 SANFORDVILLE ROAD. WARWICK, NY 10990

SH SCHOOL) 89 SANFORDVILLE ROAD. WARWICK, NY 10990

SH SCHOOL) 89 SANFORDVILLE ROAD. WARWICK, NY 10990

ERIOR BATHROOM BUILDING
SST STREET EXT, WARWICK, NY 10990

D NO. 44-21-01-06-7-041-001 (F-W FOOTBALL FIELD
D NO. 44-21-01-06-7-041-001 (F-W FOOTBALL FIELD
D NO. 44-21-01-06-0-001-040 (F-W HIGH SCHOOL)

PROJECT NO. 05-21-04 05-20-06

9 SET 94.08.2022 VISION DATE

BID SET

REVISION

DATE

DRAWN BY

CHECKED BY

SHEET SIZE

30" X 42"


SCALE AS NOTED

SHEET TITLE

PARTIAL SITE PLAN -

PARTIAL SITE PLAN NEW WORK


SHEET NO.

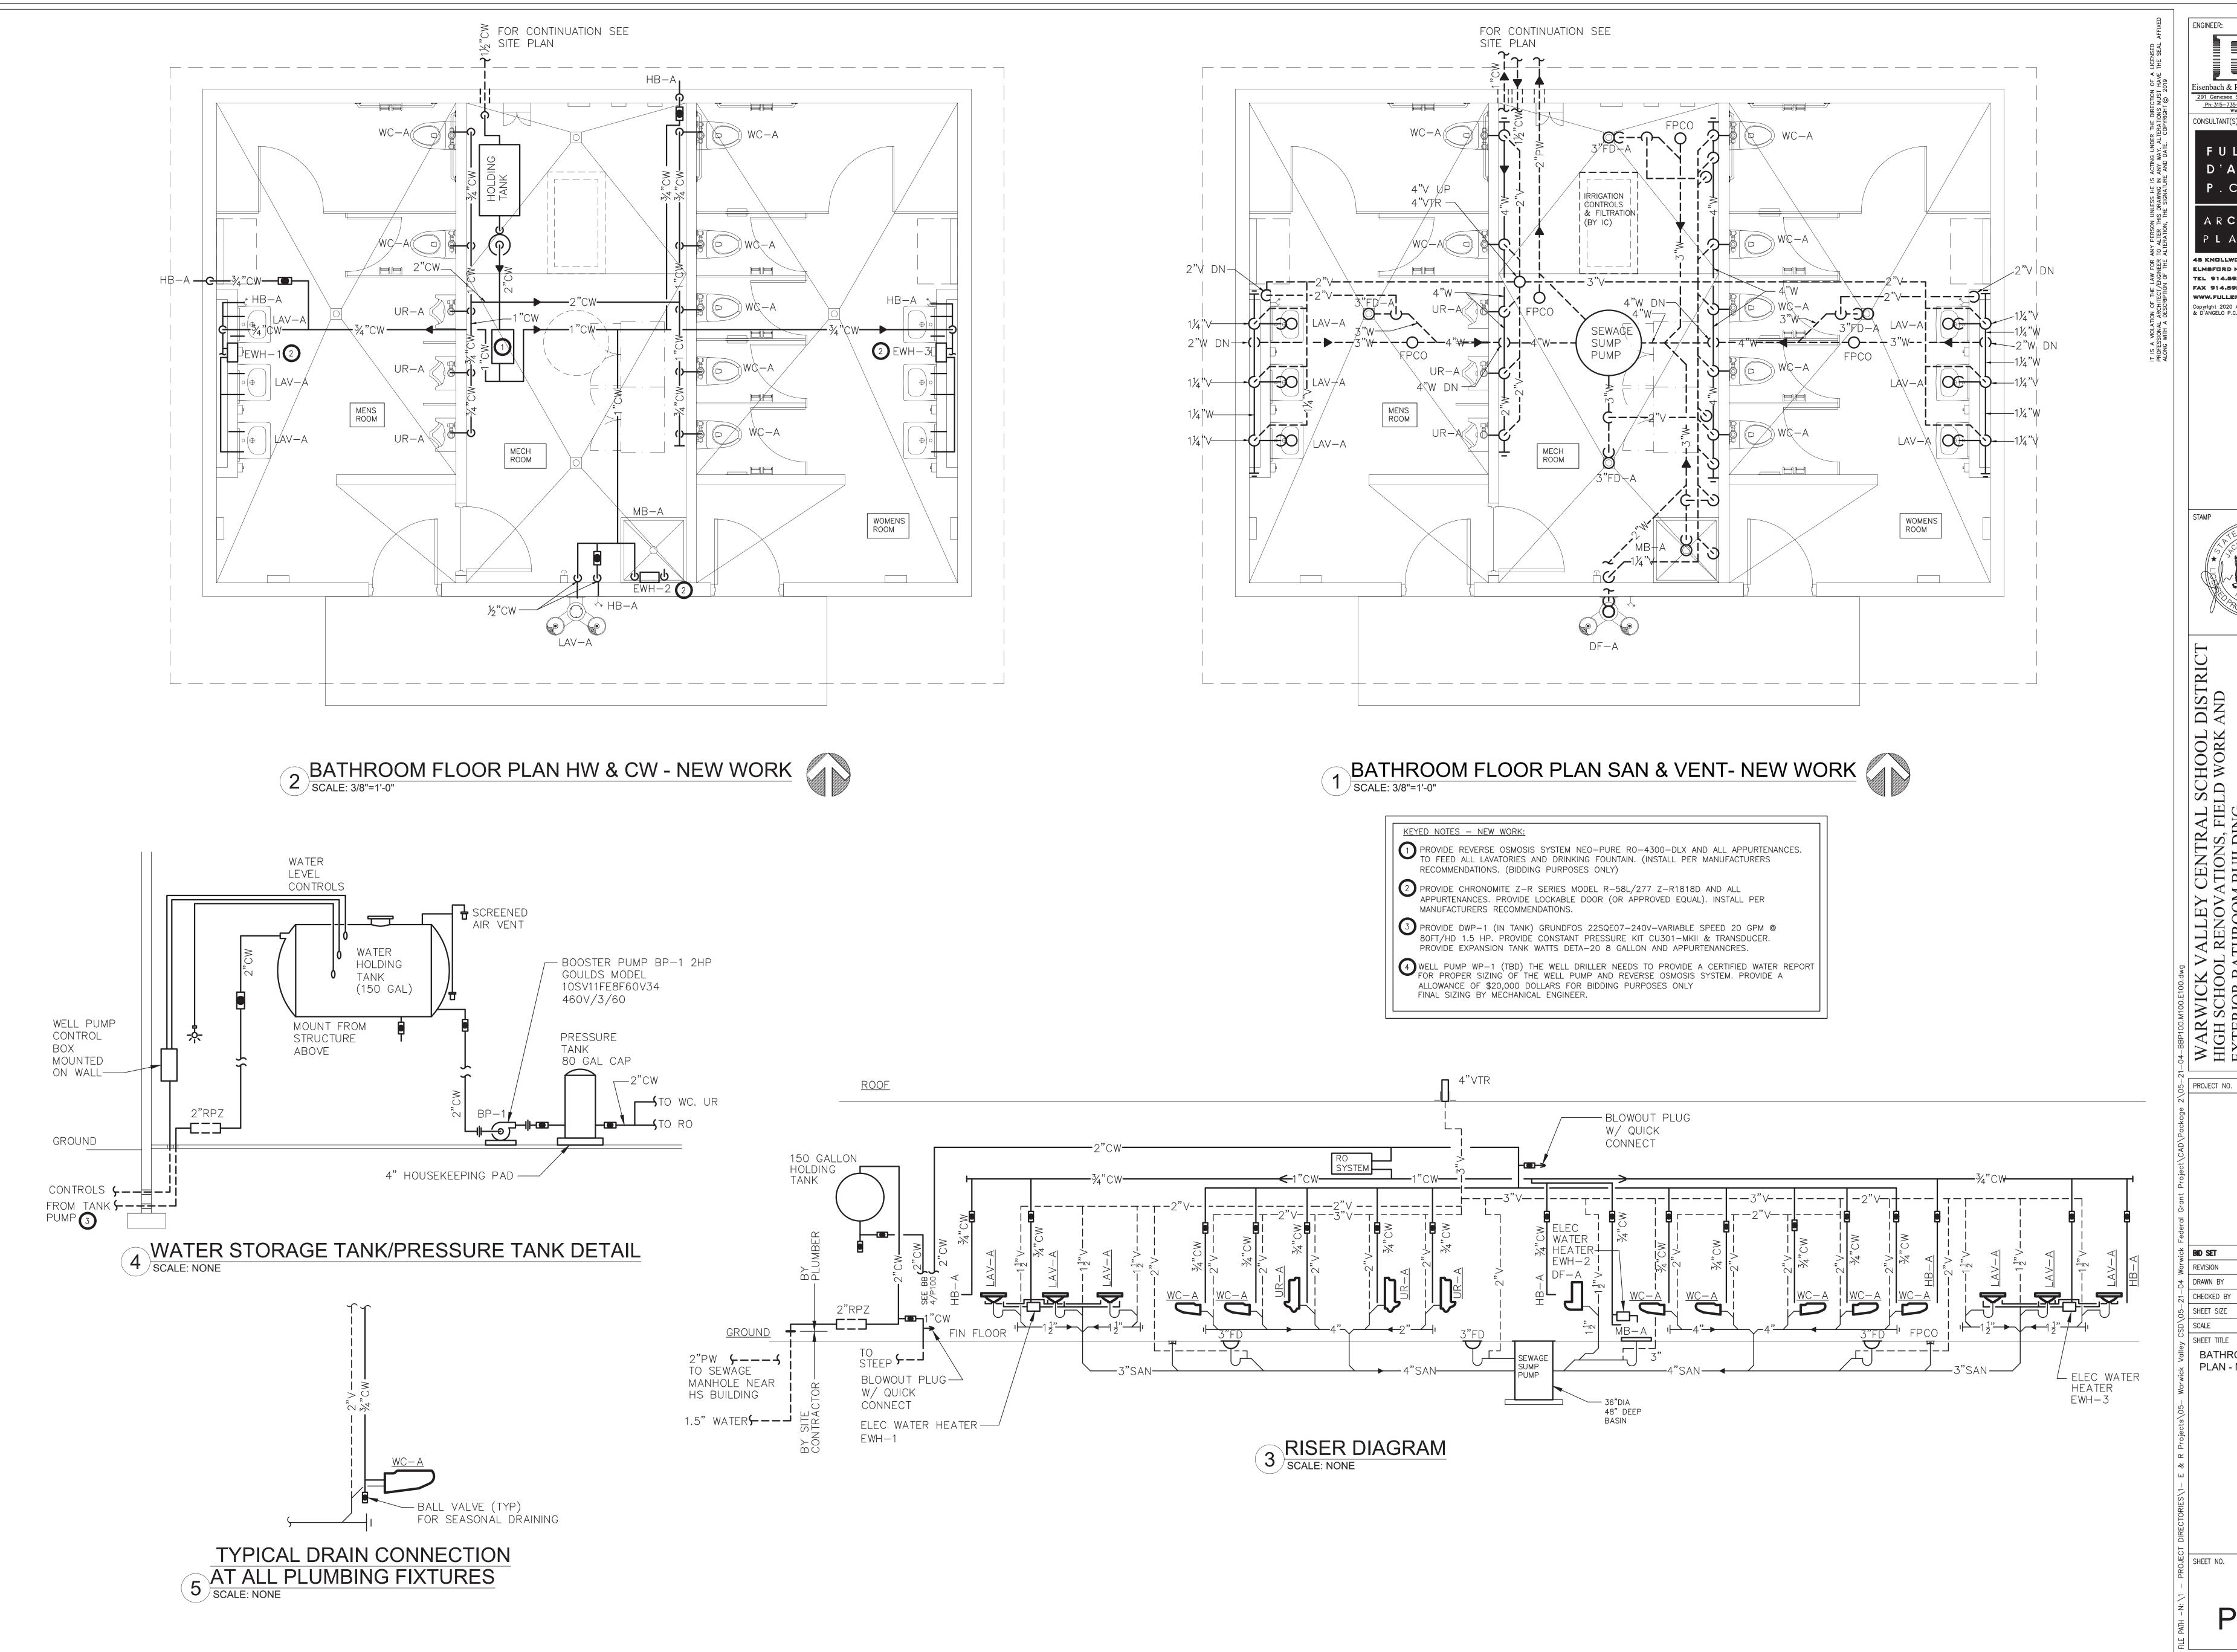

CONSULTANT(S): FULLER D'ANGELO

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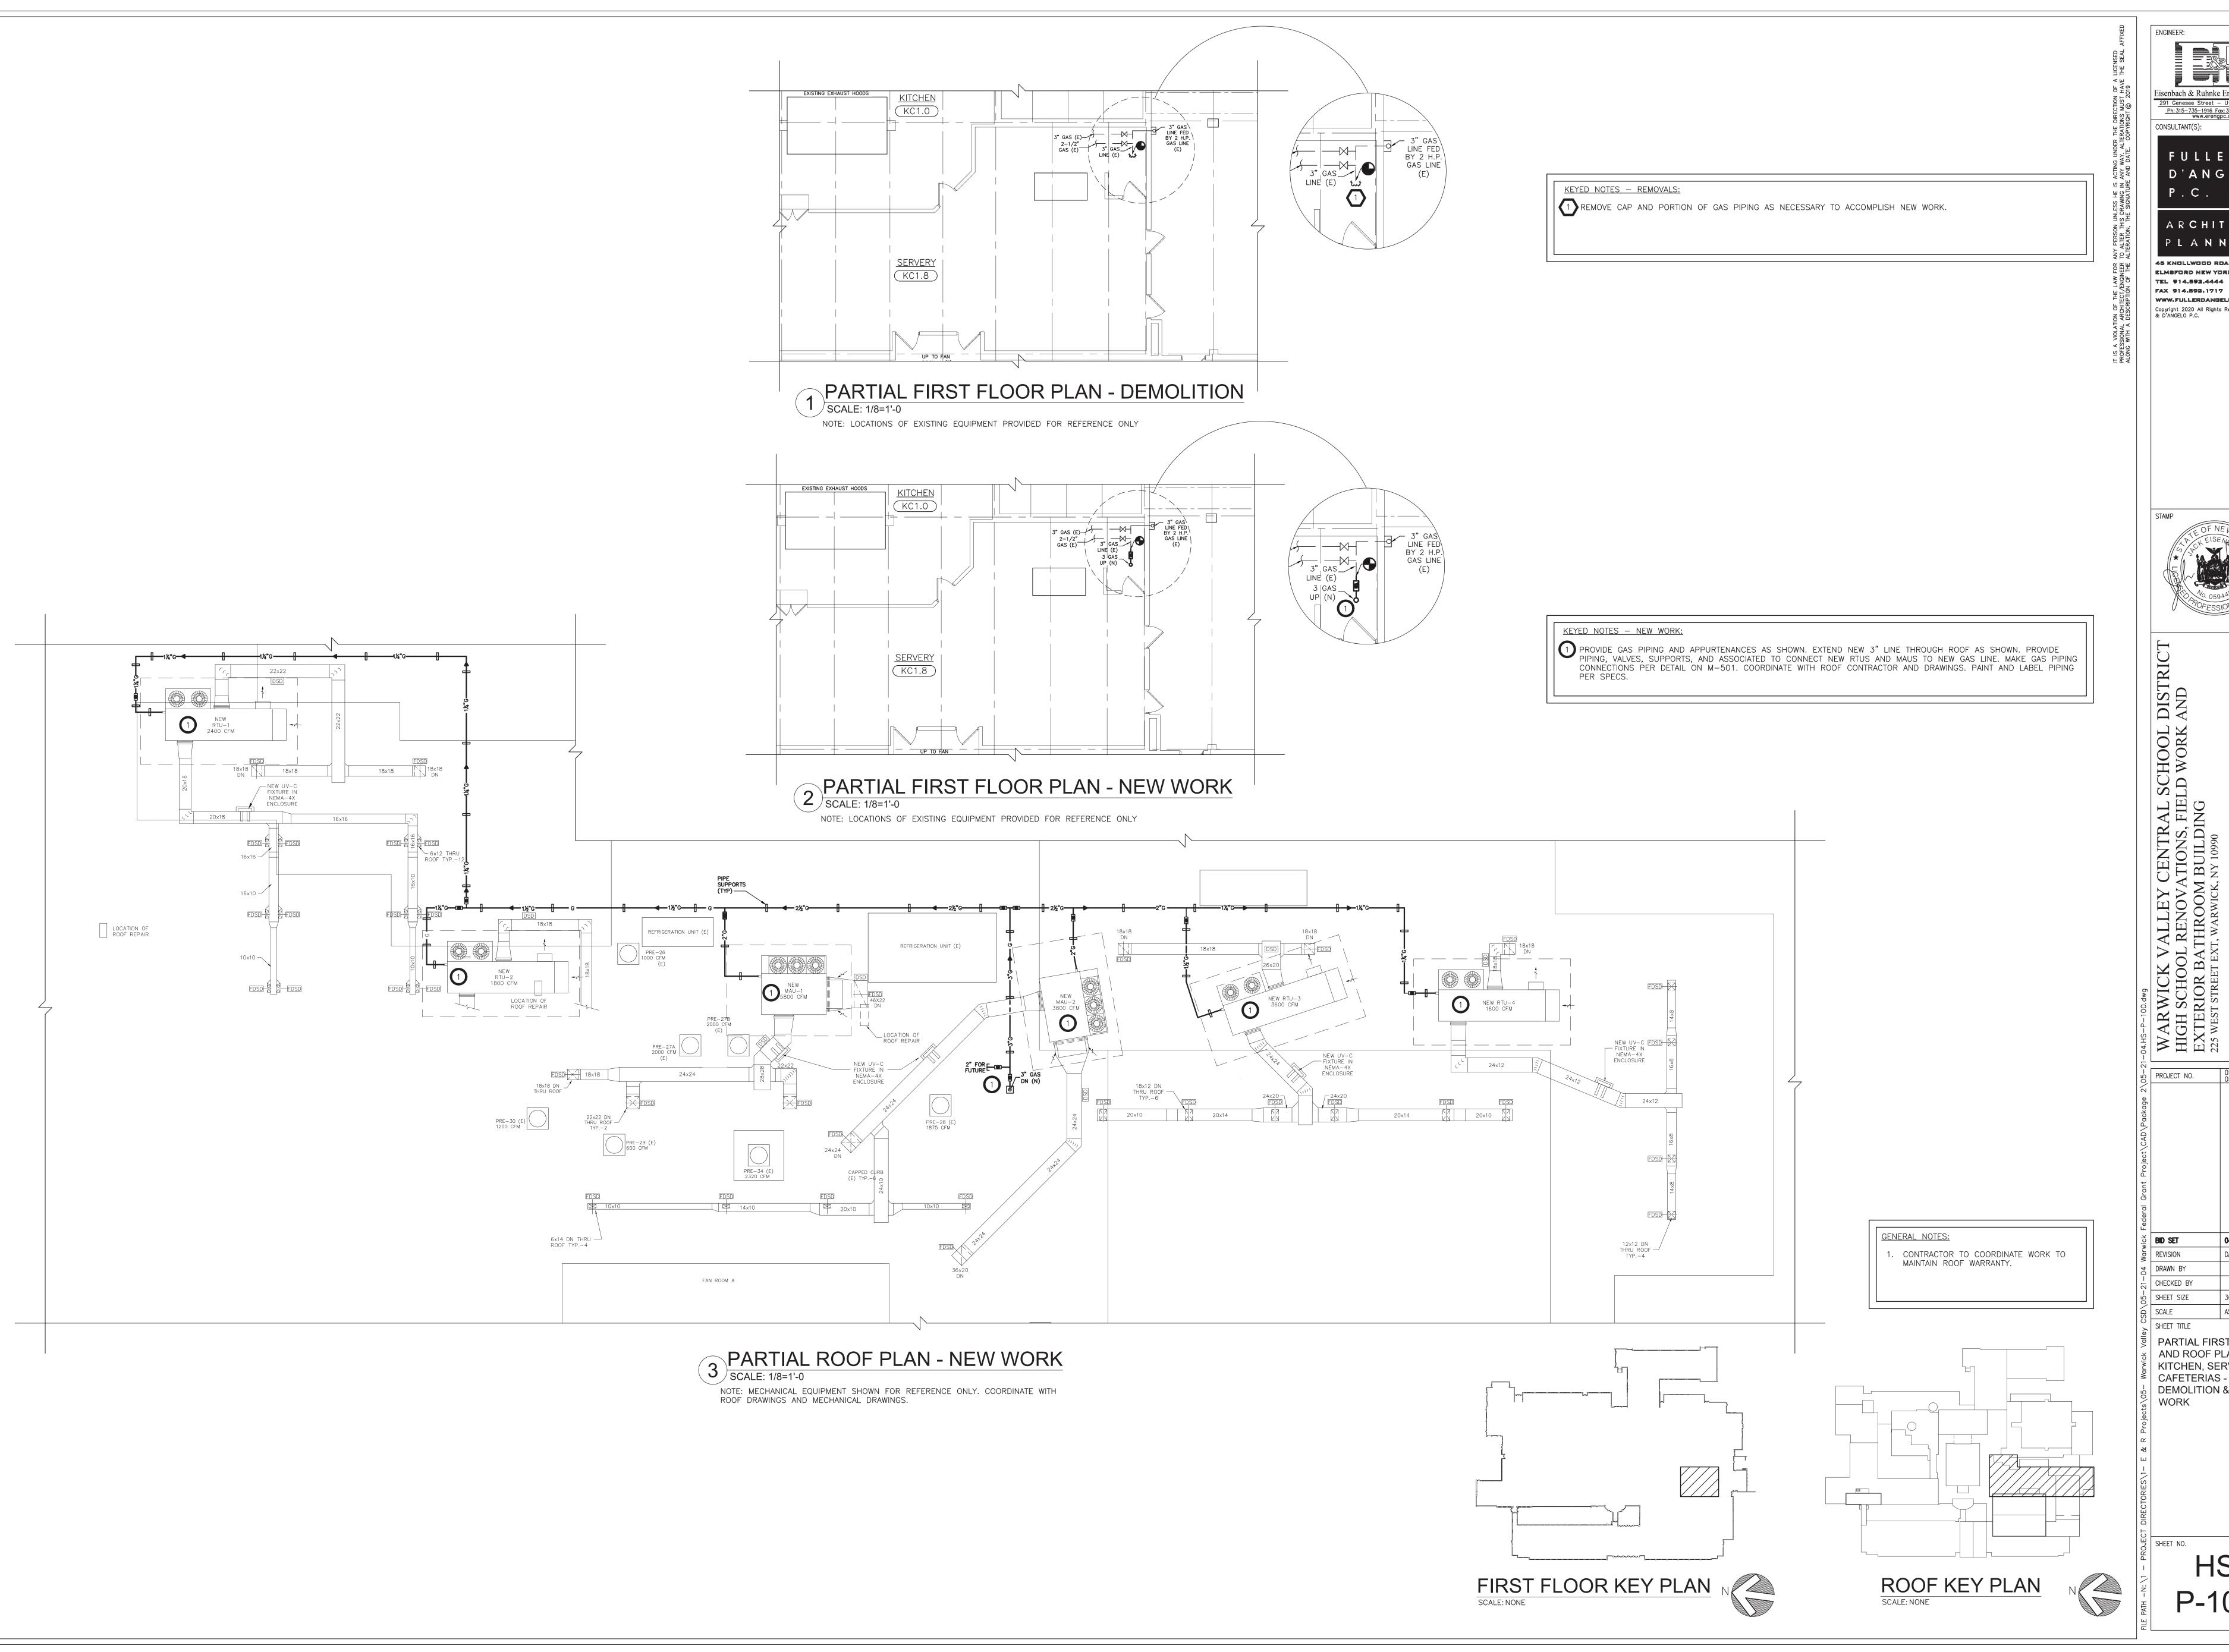


04.08.2022 30" X 42" AS NOTED

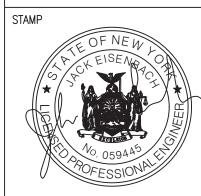BATHROOM FLOOR

PLAN - NEW WORK

BB




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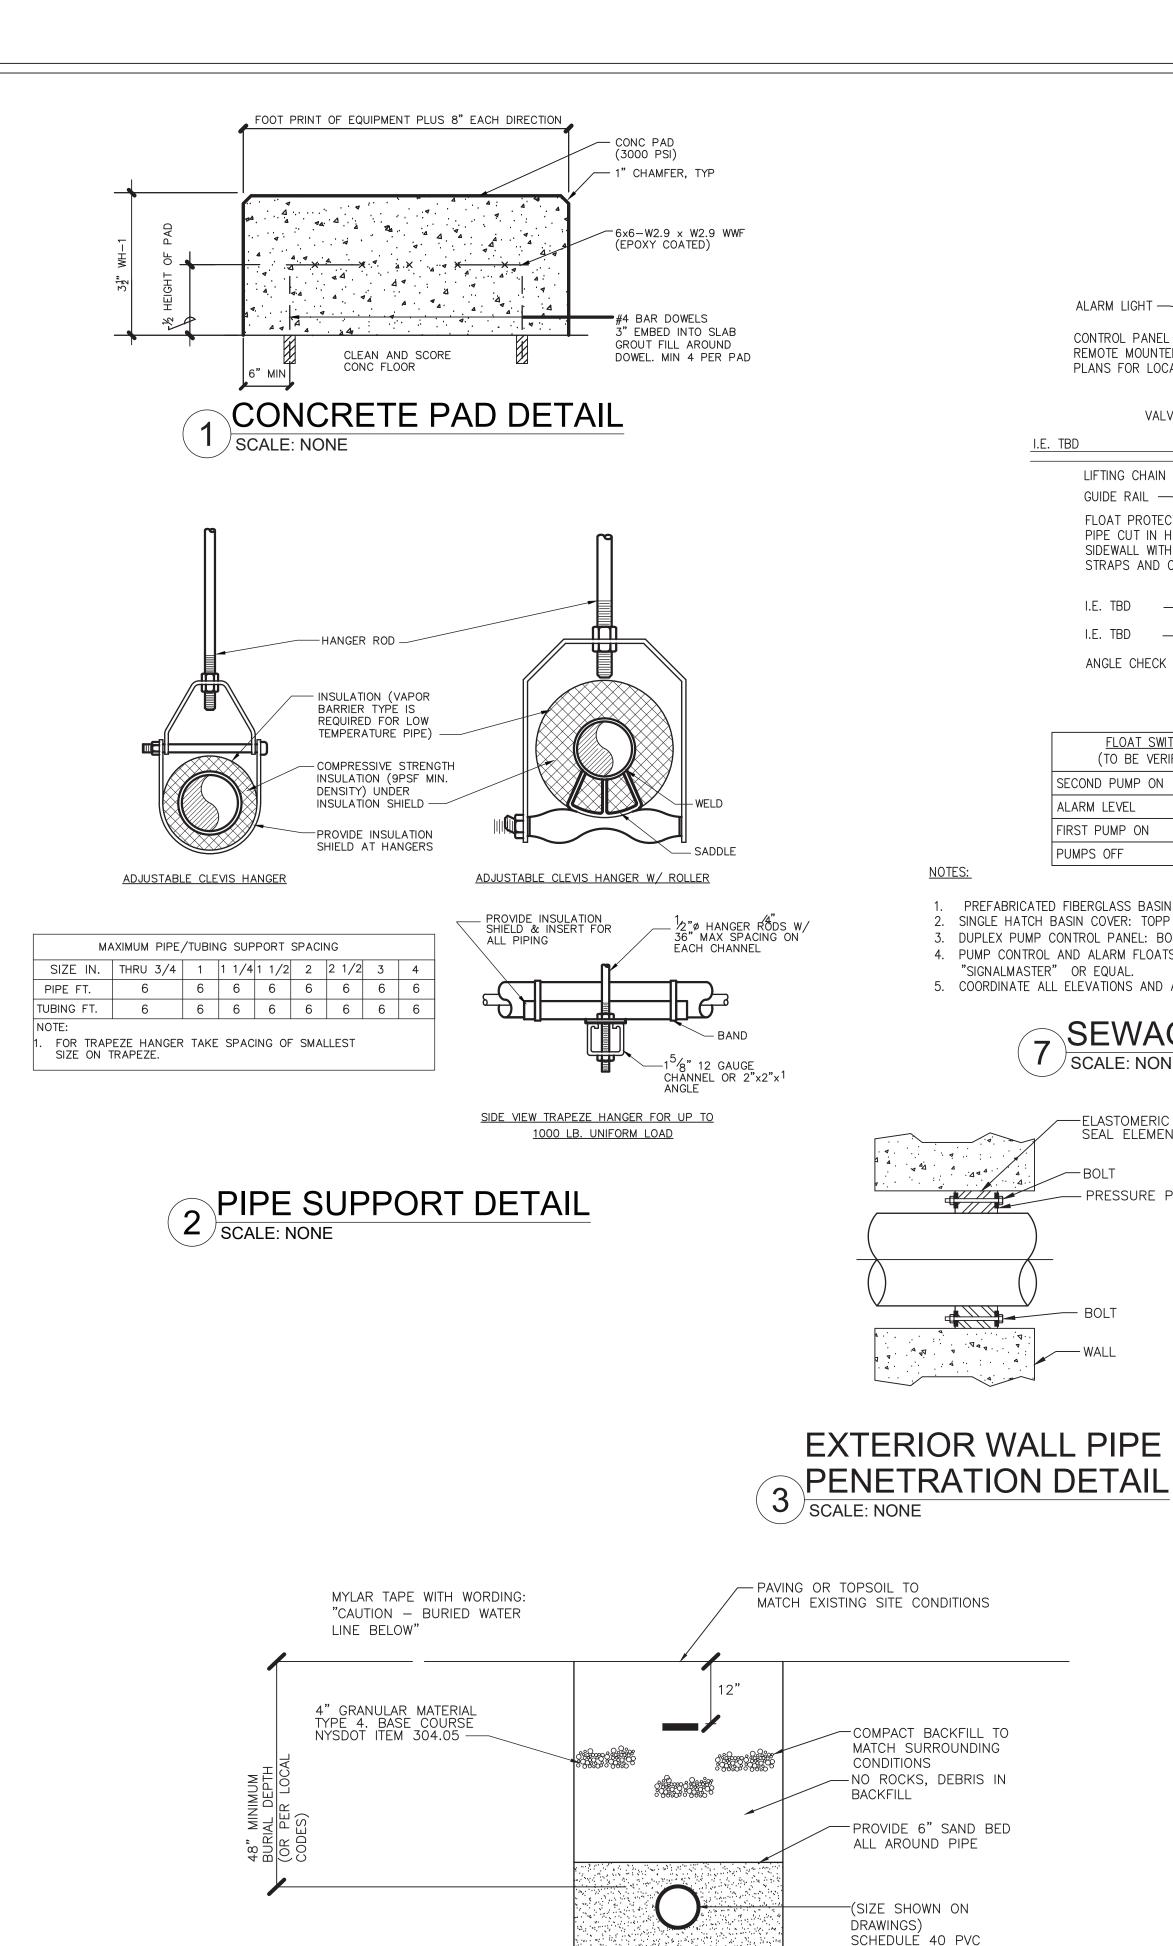
04.08.2022


30" X 42"

AS NOTED

PARTIAL FIRST FLOOR AND ROOF PLANS -

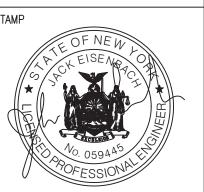KITCHEN, SERVERY, & DEMOLITION & NEW



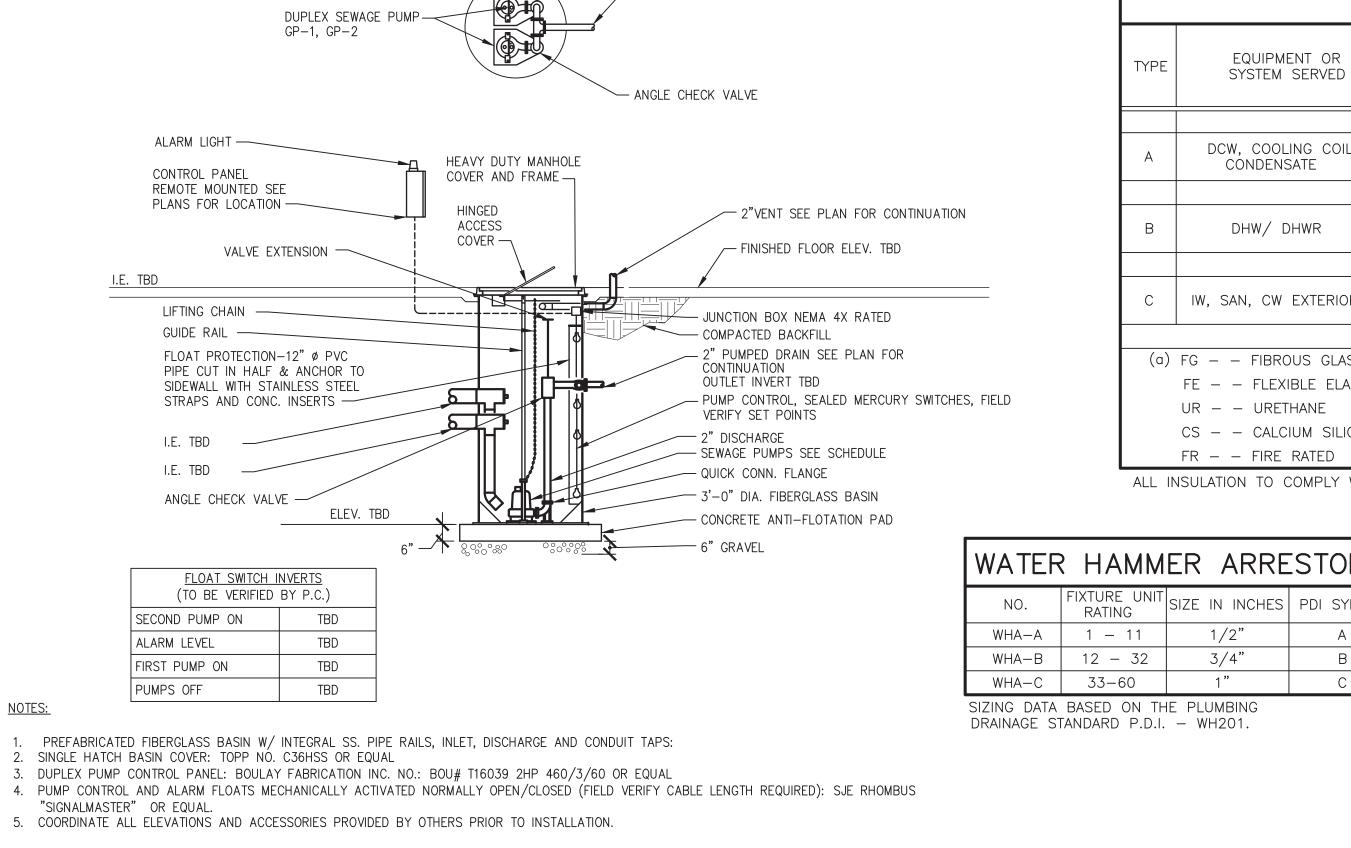

SEWAGE EJECTOR PUMP DUPLEX PUMPING STATION

- 2" PUMPED WASTE OUTLET

		INICI	II ATIONI OLASS	(a)	IACI	ZETINIC CLASS	(h)			THICKNESS	(IN)	
TYPE	EQUIPMENT OR SYSTEM SERVED		JLATION CLASS (a)		JACKETING CLASS (b)			NOMINAL PIPE SIZE (IN)				
	STSTEW SERVED	INTERIOR CONCEALED	INTERIOR EXPOSED	EXTERIOR	INTERIOR GENERAL	EQUIPMENT ROOMS	EXTERIOR	<1"	1"-<11"	1½"- <4"	4 "- <8"	≥8 & UF
	DCW, COOLING COIL	FE (R-4)			0			0.5	0.5	1.0	1.0	1.0
A	CONDENSATE		FE (R-4)			0		0.5	0.5	1.0	1.0	1.0
		FG (R-7)			1			1.5	1.5	2	2	2
В	DHW/ DHWR		FG (R-7)			1		1.5	1.5	2	2	2
	IW CAN OW EVTERIOR											
	IW, SAN, CW EXTERIOR			FG (R-4)			2	1.5	1.5	1.5	1.5	1.5
(a)	FG — FIBROUS GLASS		(b) 0 NO	DNE							
` ,	FE FLEXIBLE ELASTO	MERIC	`	•	L SERVICE	(d) E	BLANKET					
	UR URETHANE			2 P	OLYVINYL CHLORIDE							
	CS CALCIUM SILICATE	-		3 C	ANVAS	(e) F	RIGID BOARD					
	FR FIRE RATED			4 P	OLYVINYL CHLORIDE							

_					FIXTURE AND EQUIPMENT CONNECTION SCHEDULE						
F		ER ARRE	STORS	DESIGNATION	DESCRIPTION	COLD WATER	HOT WATER	WASTE OR SANITARY	VENT	REMARKS	
FIXTURE UNIT SIZE IN INCHES PDI SYMBOL		WC-A	WATER CLOSET	3/4"		4"	2"	NOTE 1			
1 - 11 1/2" A		UR-A	URINAL	3/4"		2"	2"	NOTE 2			
	12 - 32	3/4"	В	LAV-A	LAVATORY	1/2"	1/2"	1-1/4"	1-1/4"	NOTE 3	
	33-60	1"	С	FD-A	FLOOR DRAIN			3"	2"	NOTE 4	
TA BASED ON THE PLUMBING STANDARD P.D.I. — WH201.				FPCO	CLEANOUT			4"		NOTE 5	
				DF-A	DRINKING FOUNTAIN	3/4"		1 1/2"	1-1/4"	NOTE 9	
				MB-A	MOP BASIN	3/4"	3/4"	3"	2"	NOTE 8	
				HB-A	HOSE BIBB	3/4"				NOTE 10	

UR-A	URINAL	3/4		2	2	NOTE 2
LAV-A	LAVATORY	1/2"	1/2"	1-1/4"	1-1/4"	NOTE 3
FD-A	FLOOR DRAIN			3"	2"	NOTE 4
FPCO	CLEANOUT			4"		NOTE 5
DF-A	DRINKING FOUNTAIN	3/4"		1 1/2"	1-1/4"	NOTE 9
MB-A	MOP BASIN	3/4"	3/4"	3"	2"	NOTE 8
HB-A	HOSE BIBB	3/4"				NOTE 10
	·		·			·

NOTES:

- WALL MOUNTED WATER CLOSET AMERICAN STANDARD AFWALL 3351.101 WITH 5901.110 SEAT AND SLOAN FLUSH VALVE ROYAL 111 ESS-1.6-OR-HW WALL MOUNTED URINAL AMERICAN STANDARD WASHBROOK 6590.001 WITH SLOAN FLUSH VALVE ROYAL 186 ESS-1.0-HW WALL HUNG LAVATORY AMERICAN STANDARD 0355.012 W/JR SMITH CARRIER 0700, MCGUIRE 2167-LK-F AND
- MCGUIRE 8912-F. FAUCET AMERICAN STANDARD 605B-205, PK00.HAC, 605XTMV1070 HARD WIRED AC MULTI AC PROVIDE STAINLESS STEEL FLEXIBLE SUPPLIES, CW,HW BRASSCRAFT S1-A AND SHUT OFF VALES W/ REMOVABLE HANDLES. LAV GUARD BY ARCHITECT FLOOR DRAIN MODEL JR SMITH 2010C-A WITH TRAP SEAL BY PROVENT SYSTEMS OR APPROVED EQUAL.
- PROVIDE CLEANOUT JR SMITH MODEL 4020 OR APPROVED EQUAL ALL PLUMBING FIXTURES TO BE PROVIDED WITH SHUT-OFF VALVES AS SPECIFIED
- INSTALL ALL CARRIERS PER MANUFACTURERS RECOMMENDATIONS. COORDINATE WITH ARCHITECTURAL DRAWINGS FOR CARRIER HEIGHTS. PROVIDE MOP BASIN FIAT MSB-3636 WITH FIAT 830-AA. PROVIDE MOP BRACKET 889-CC, VINYL GUARDS E-77-AA AND HOSE BRACKET 832-AA
- 9. PROVIDE ELKAY MODEL LK4409BF BLACK OR APPROVED EQUAL 10. PROVIDE JR SMITH HOSE BIBB 5685(H) WITH REMOVABLE HANDLE OR APPROVED EQUAL

MECH ROOM

PUMP SCHEDULE										
NO.	LOCATION	SERVICE	GPM	ODM HEAD FT MOTOR					DECICN MAKE	
NO.	LOCATION	SERVICE	GPIVI	WATER	WATTS/HP	VOLTAGE	PHASE	MAX. RPM	DESIGN MAKE	
GP-1	MECH ROOM	SEWAGE	25	40	1.5	460	60	1750	WEIL 2436	


40

1.5


460

60

1750

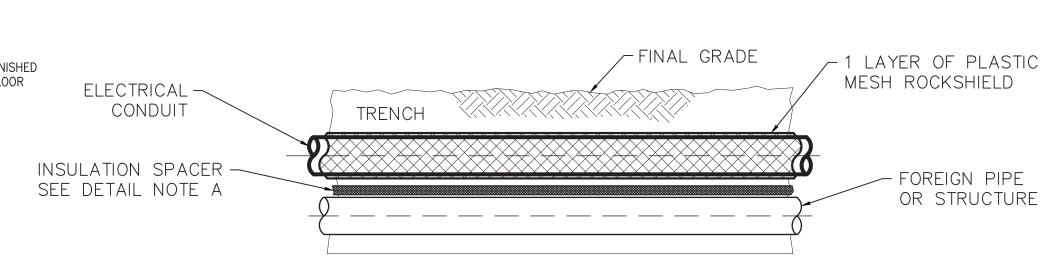


25

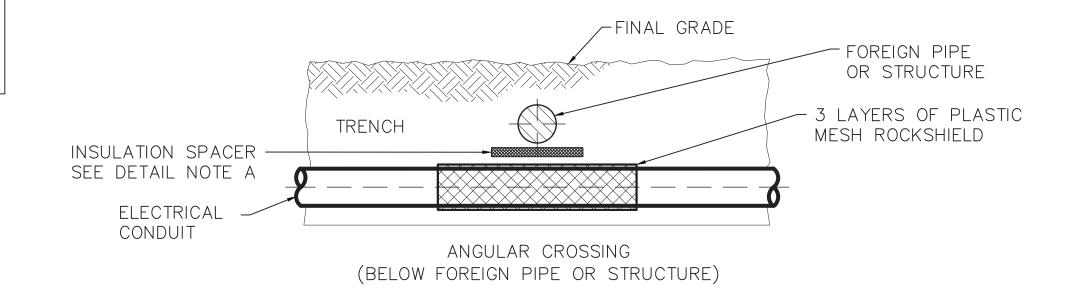


PARALLEL INSTALLATION


(HORIZONTAL OR VERTICAL ARRANGEMENT)

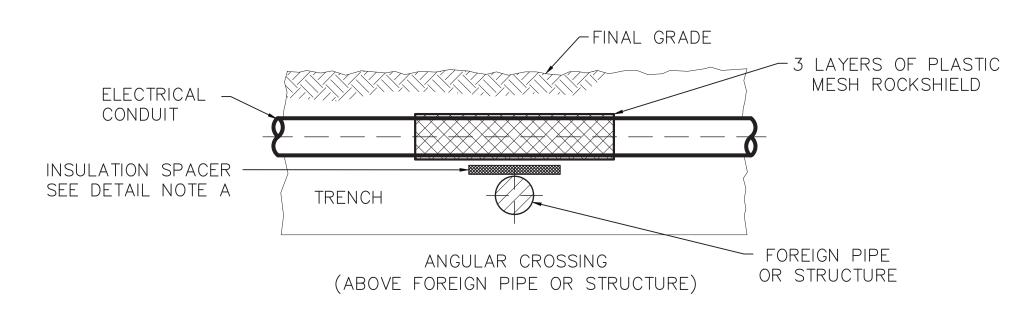


A. A INSULATIONSPACER SHALL BE INSTALLED BETWEEN METALIC WATER/SEWER PIPE TO PREVENT ELECTRICAL CONTACT WITH THE SUBSURFACE STRUCTURE


DETAIL NOTES: B. REFER TO SPECIFICATIONS FOR ADDITIONAL REQUIREMENTS

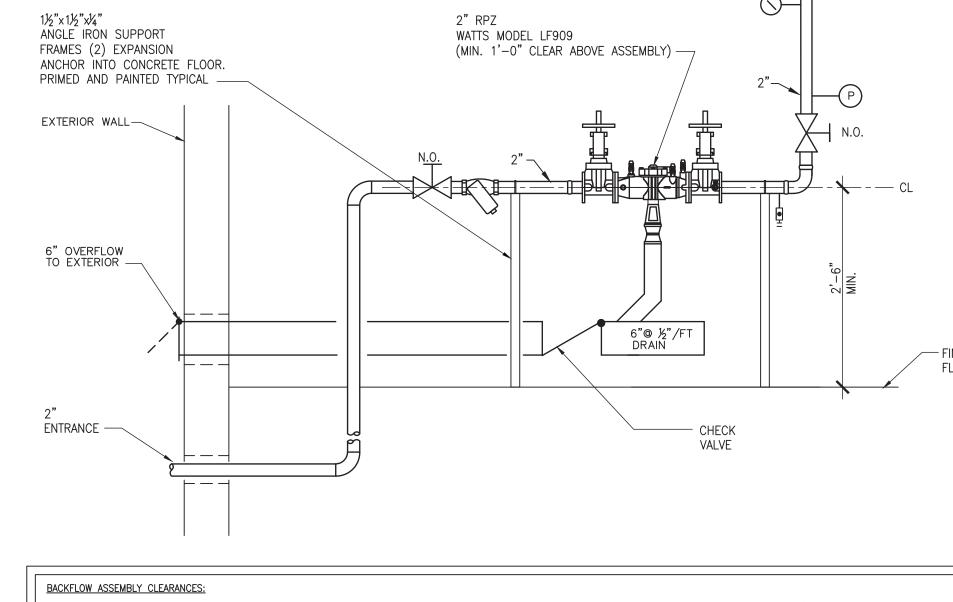


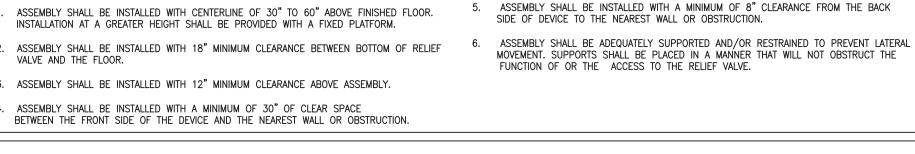

BACKFLOW PREVENTER DETAIL

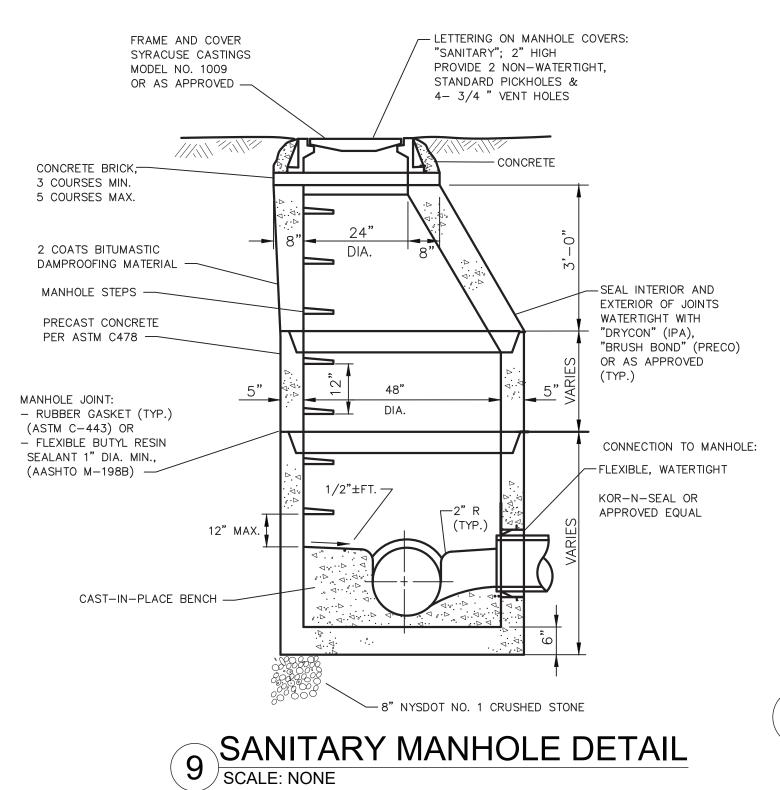

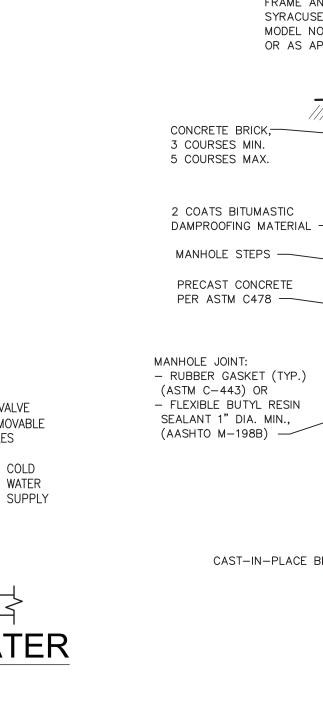

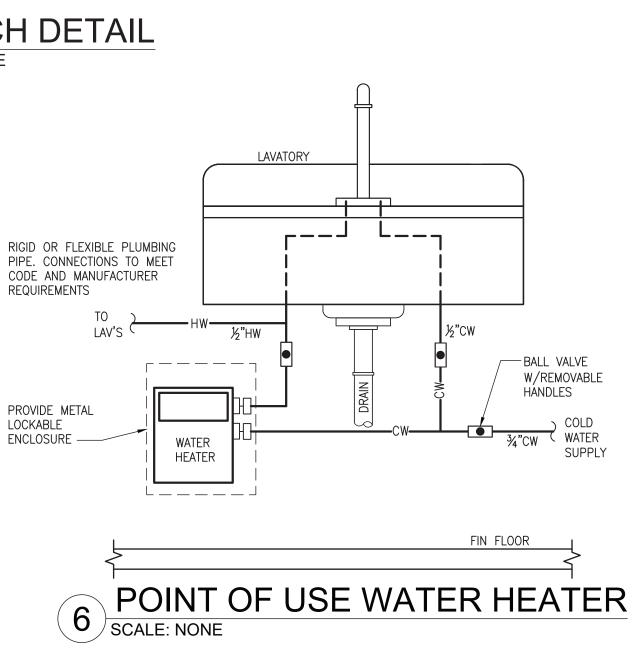

UNLESS OTHERWISE SHOWN ON PLANS

1. EXCAVATE REMOVE ROCK, BACKFILL, SEED AND RESTORE

OR PAVE TO ORIGINAL CONDITIONS.

18" x 18" x 8"DP.

W/EXPOXY COATED

WIRE MESH SET

FLUSH W/ GRADE

CONC. PAD

OR EXISTING

CONDITIONS

CAST IRON

CLEAN OUT


(FLUSH COVER)-

4"SAN -

GRADE LEVEL CLEANOUT DETAIL

SCALE: NONE

SCALE: NONE

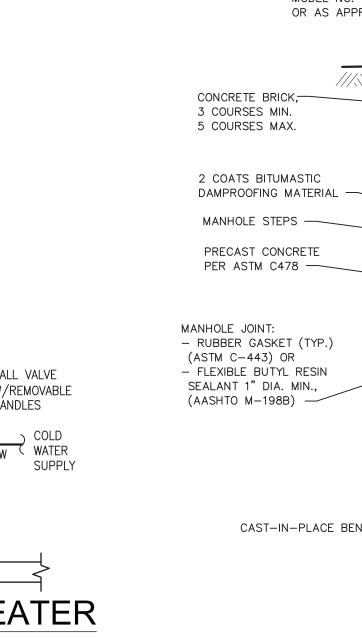


ANGULAR & PARALLEL CROSSING OF SUBSURACE STRUCTURE GAS PIPE PROTECTION BELOW GRADE CLEARANCES

SCALE: NONE

<u>Ph: 315-735-1916 Fax: 315-735-6365</u> www.erengpc.com CONSULTANT(S): FULLER

D'ANGELO A R **C H I T E C T S** PLANNER:

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PROJECT NO.

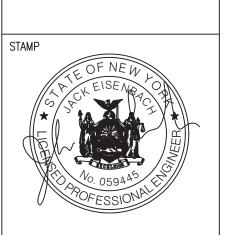04.08.2022 REVISION DRAWN BY CHECKED BY 30" X 42" SHEET SIZE

AS NOTED SHEET TITLE SCHEDULES AND DETAILS