

WESTCHESTER COUNTY

	STCHESTER COUNTY
ADDRESS 105	WALKER ROAD



WESTCHESTER COUNTY, NEW YORK DEPARTMENT OF PUBLIC WORKS AND TRANSPORTATION DIVISION OF ENGINEERING

CONTRACT No. 17-521 NEW EQUIPMENT STORAGE BUILDING RICHARD A. FLYNN, SR. FIRE TRAINING CENTER VALHALLA CAMPUS VALHALLA, NEW YORK

SHEET NO.	SHEET TITLE	DPW FILE NO.	SHEET NO.	SHEET TITLE	DPW FILE NO.
TS-001	TITLE SHEET	38-47-T-683-0	FIRE PROTECTION		
TS-002	CODE SHEET	38-47-G-684-0	FP-001	FIRE PROTECTION SYMBOLS, ABBREVIATIONS & GENERAL NOTES	38-47-FP-712-
CIVII			FP-201	FIRE PROTECTION NEW WORK PLAN	38-47-FP-713-
CIVIL C-100	SITE PLAN	38-47-G-685-0	FP-701	FIRE PROTECTION DETAILS	38-47-FP-714-
C-101	GRADING PLAN	38-47-G-686-0			
C-102	UTILITY PLAN	38-47-G-687-0	PLUMBING		
C-102.1	GAS & TELEPHONE LINE PLAN	38-47-G-688-0	P-001	PLUMBING SYMBOLS, ABBREVIATIONS & GENERAL NOTES	38-47-P-715-0
C-103	EROSION & SEDIMENT CONTROL AND REMOVALS PLAN	38-47-G-689-0	P-201	PLUMBING NEW WORK PLAN	38-47-P-716-0
C-104	CIVIL DETAILS I	38-47-G-690-0	P-401	PLUMBING BACKFLOW PREVENTER PLAN	38-47-P-717-0
C-105	CIVIL DETAILS II	38-47-G-691-0	P-701	PLUMBING DETAILS	38-47-P-718-0
C-106	CIVIL DETAILS III	38-47-G-692-0			
C-107	LANDSCAPE PLAN	38-47-G-693-0	MECHANICAL		
ARCHITECTURAL			M-001	MECHANICAL SYMBOLS, ABBREVIATIONS & GENERAL NOTES	38-47-M-719-
A-101	FLOOR PLAN	38-47-A-694-0	M-201	MECHANICAL NEW WORK PLAN	38-47-M-720-
A-102	ROOF PLAN	38-47-A-695-0	M-601	MECHANICAL SCHEDULES	38-47-M-721-
A-200	ELEVATIONS	38-47-A-696-0	M-701	MECHANICAL DETAILS	38-47-M-722-
A-201	BUILDING SECTION	38-47-A-697-0			
A-300	INTERIOR ELEVATION & DETAILS I	38-47-A-698-0	ENERGY COMPLIANCE		
A-401	REFLECTED CEILING PLAN	38-47-A-699-0			
A-500	WALL SECTIONS	38-47-A-700-0	EN-001	ENERGY COMPLIANCE	38-47-EN-723-
A-505	WALL DETAILS I	38-47-A-701-0	EN-002	ELECTRICAL ENERGY COMPLIANCE	38-47-EN-724-
A-506	DETAILS II	38-47-A-702-0			
A-550	ROOF PANEL DETAILS & COMMON WALL DETAILS	38-47-A-703-0	ELECTRICAL		70 /
A-551	WALL PANELS IN VERTICAL/HORIZ. ORIENTATION DETAILS	38-47-A-704-0	E-001	ELECTRICAL SYMBOLS, ABBREVIATIONS & GENERAL NOTES	38-47-E-725-(
A-701	DOOR & WINDOW SCHEDULE & TYPES	38-47-A-705-0	E-101	ELECTRICAL SITE PLAN	38-47-E-726-
A-702	DOOR & WINDOW INSTALLATION DETAILS	38-47-A-706-0	E-201	ELECTRICAL LIGHTING PLAN	38-47-E-727-0
A-800	FINISH SCHEDULE	38-47-A-707-0	E-301	ELECTRICAL POWER & COMMUNICATION PLAN	38-47-E-728-0
	•		E-302	ELECTRICAL ROOF PLAN	38-47-E-729-0
STRUCTURAL			E-401	FIRE ALARM PLAN	38-47-E-730-0
N-100	STRUCTURAL NOTES	38-47-S-708-0	E-501	ELECTRICAL ONE-LINE DIAGRAM & SCHEDULES	38-47-E-731-0
FO-100	FOUNDATION PLAN	38-47-S-709-0	E-502	FIRE ALARM RISER DIAGRAM	38-47-E-732-0
FO-200	FOUNDATION SECTIONS & DETAILS. SHEET 1 OF 2	38-47-S-710-0	E-601	ELECTRICAL SCHEDULES	38-47-E-733-0
FO-201	FOUNDATION SECTIONS & DETAILS. SHEET 2 OF 2	38-47-S-711-0	E-701	ELECTRICAL DETAILS	38-47-E-734-0
			E-702	ELECTRICAL DETAILS	38-47-E-735-0

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IN CHARGE OF	DC	
CHECKED BY	DC	
MADE BY	CC	

11-8-21 RECOMMENDED FOR DESIGN DATE

ADAM KAPLINSKI, R.A. ASSOCIATE ARCHITECT DEPARTMENT OF PUBLIC WORKS AND TRANSPORTATION

11.9.2021 RECOMMENDED FOR CONSTRUCTION DATE

WIND SPEED:

RISK CATEGORY

EXPOSURE:

SEISMIC:

GAYLE M. KATZMAN, P.E. FIRST DEPUTY COMMISSIONER DEPARTMENT OF PUBLIC WORKS AND TRANSPORTATION

APPROVED FOR CONSTRUCTION

ROOF DESIGN CRITERIA FOR METAL ROOF

120 MPH, 3 SECOND PEAK GUST

SEE ENGINEER'S DRAWINGS N-100.00

RICHARD G. WISHNIE COMMISSIONER DEPARTMENT OF EMERGENCY SERVICES

METAL ROOF W/METAL EDGE TRIM

PERIMETER

CORNERS

EDGE PERIMETER

EDGE CORNERS

PERIMETER ZONE = 10 FEET

WIND UPLIFT W/ SAFETY FACTOR 2

50 PSF

84 PSF

126 PSF

100 PSF

150 PSF

APPROVED FOR CONSTRUCTION

CONTRACTOR PROVIDE PROJECT


SPECIFIC ROOF MANUFACTURER'S

SIGNED ASSEMBLY LETTER AND


SAMPLE WARRANTY WITH REQUIRED

WIND SPEED LISTED PRIOR TO START


HUGH J. GREECHAN, JR., P.E. COMMISSIONER DEPARTMENT OF PUBLIC WORKS AND TRANSPORTATION

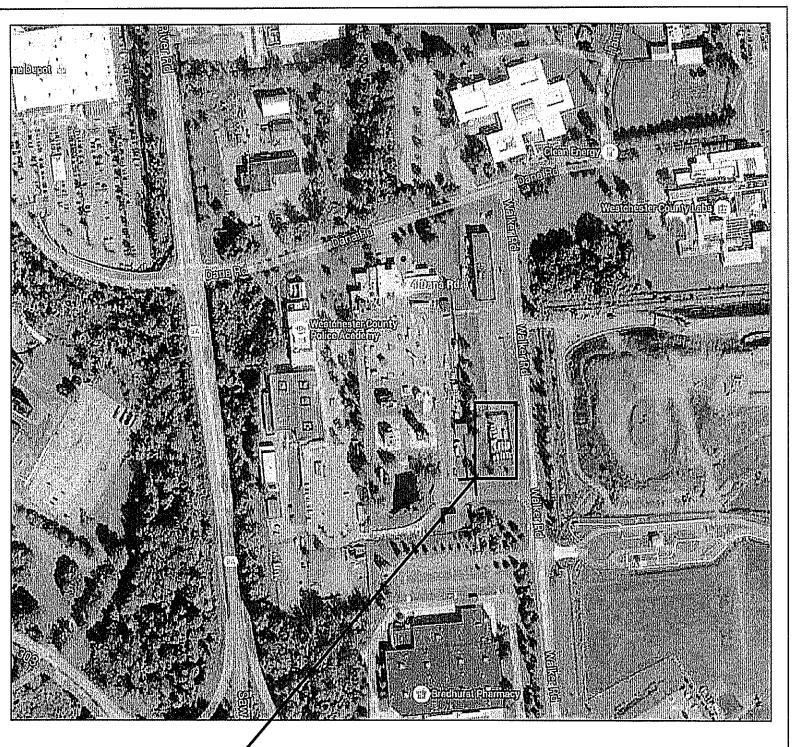

LOCATION MAP

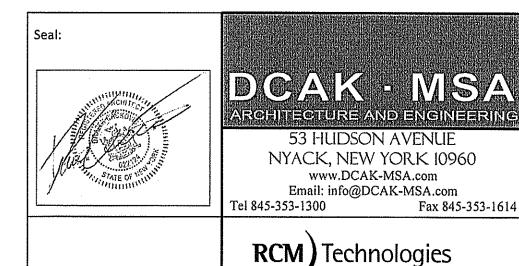



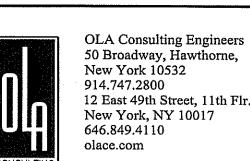


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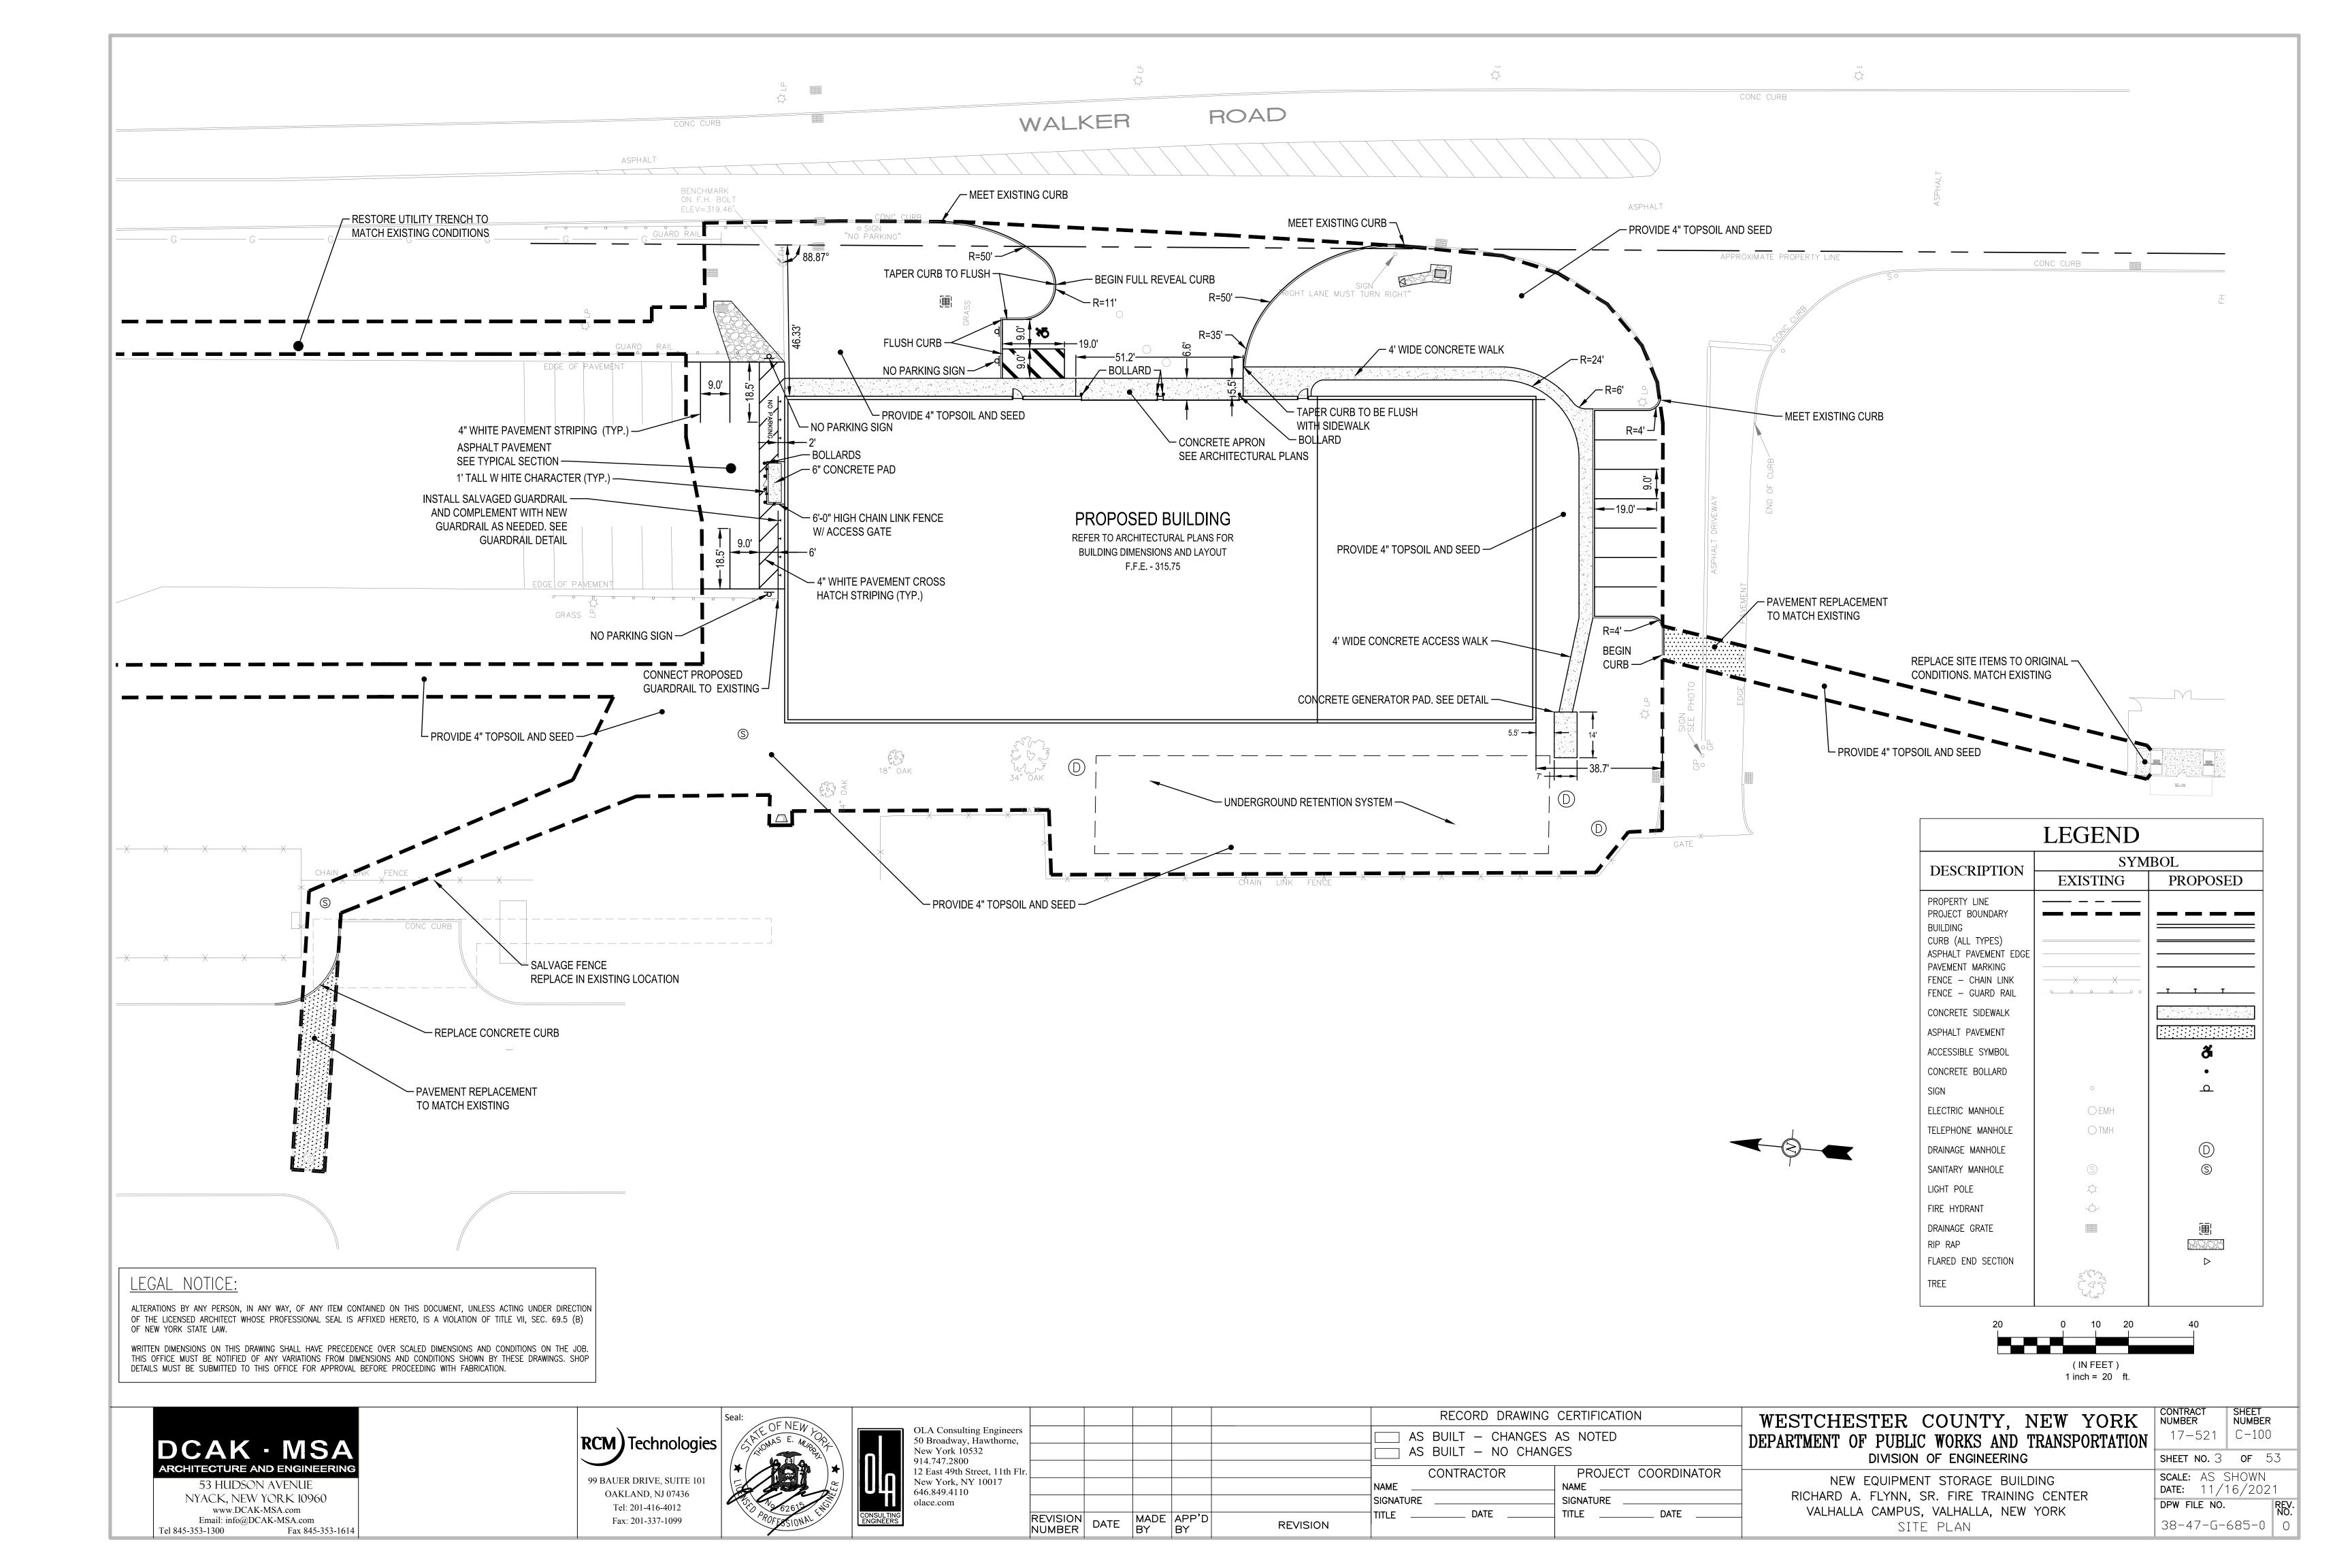
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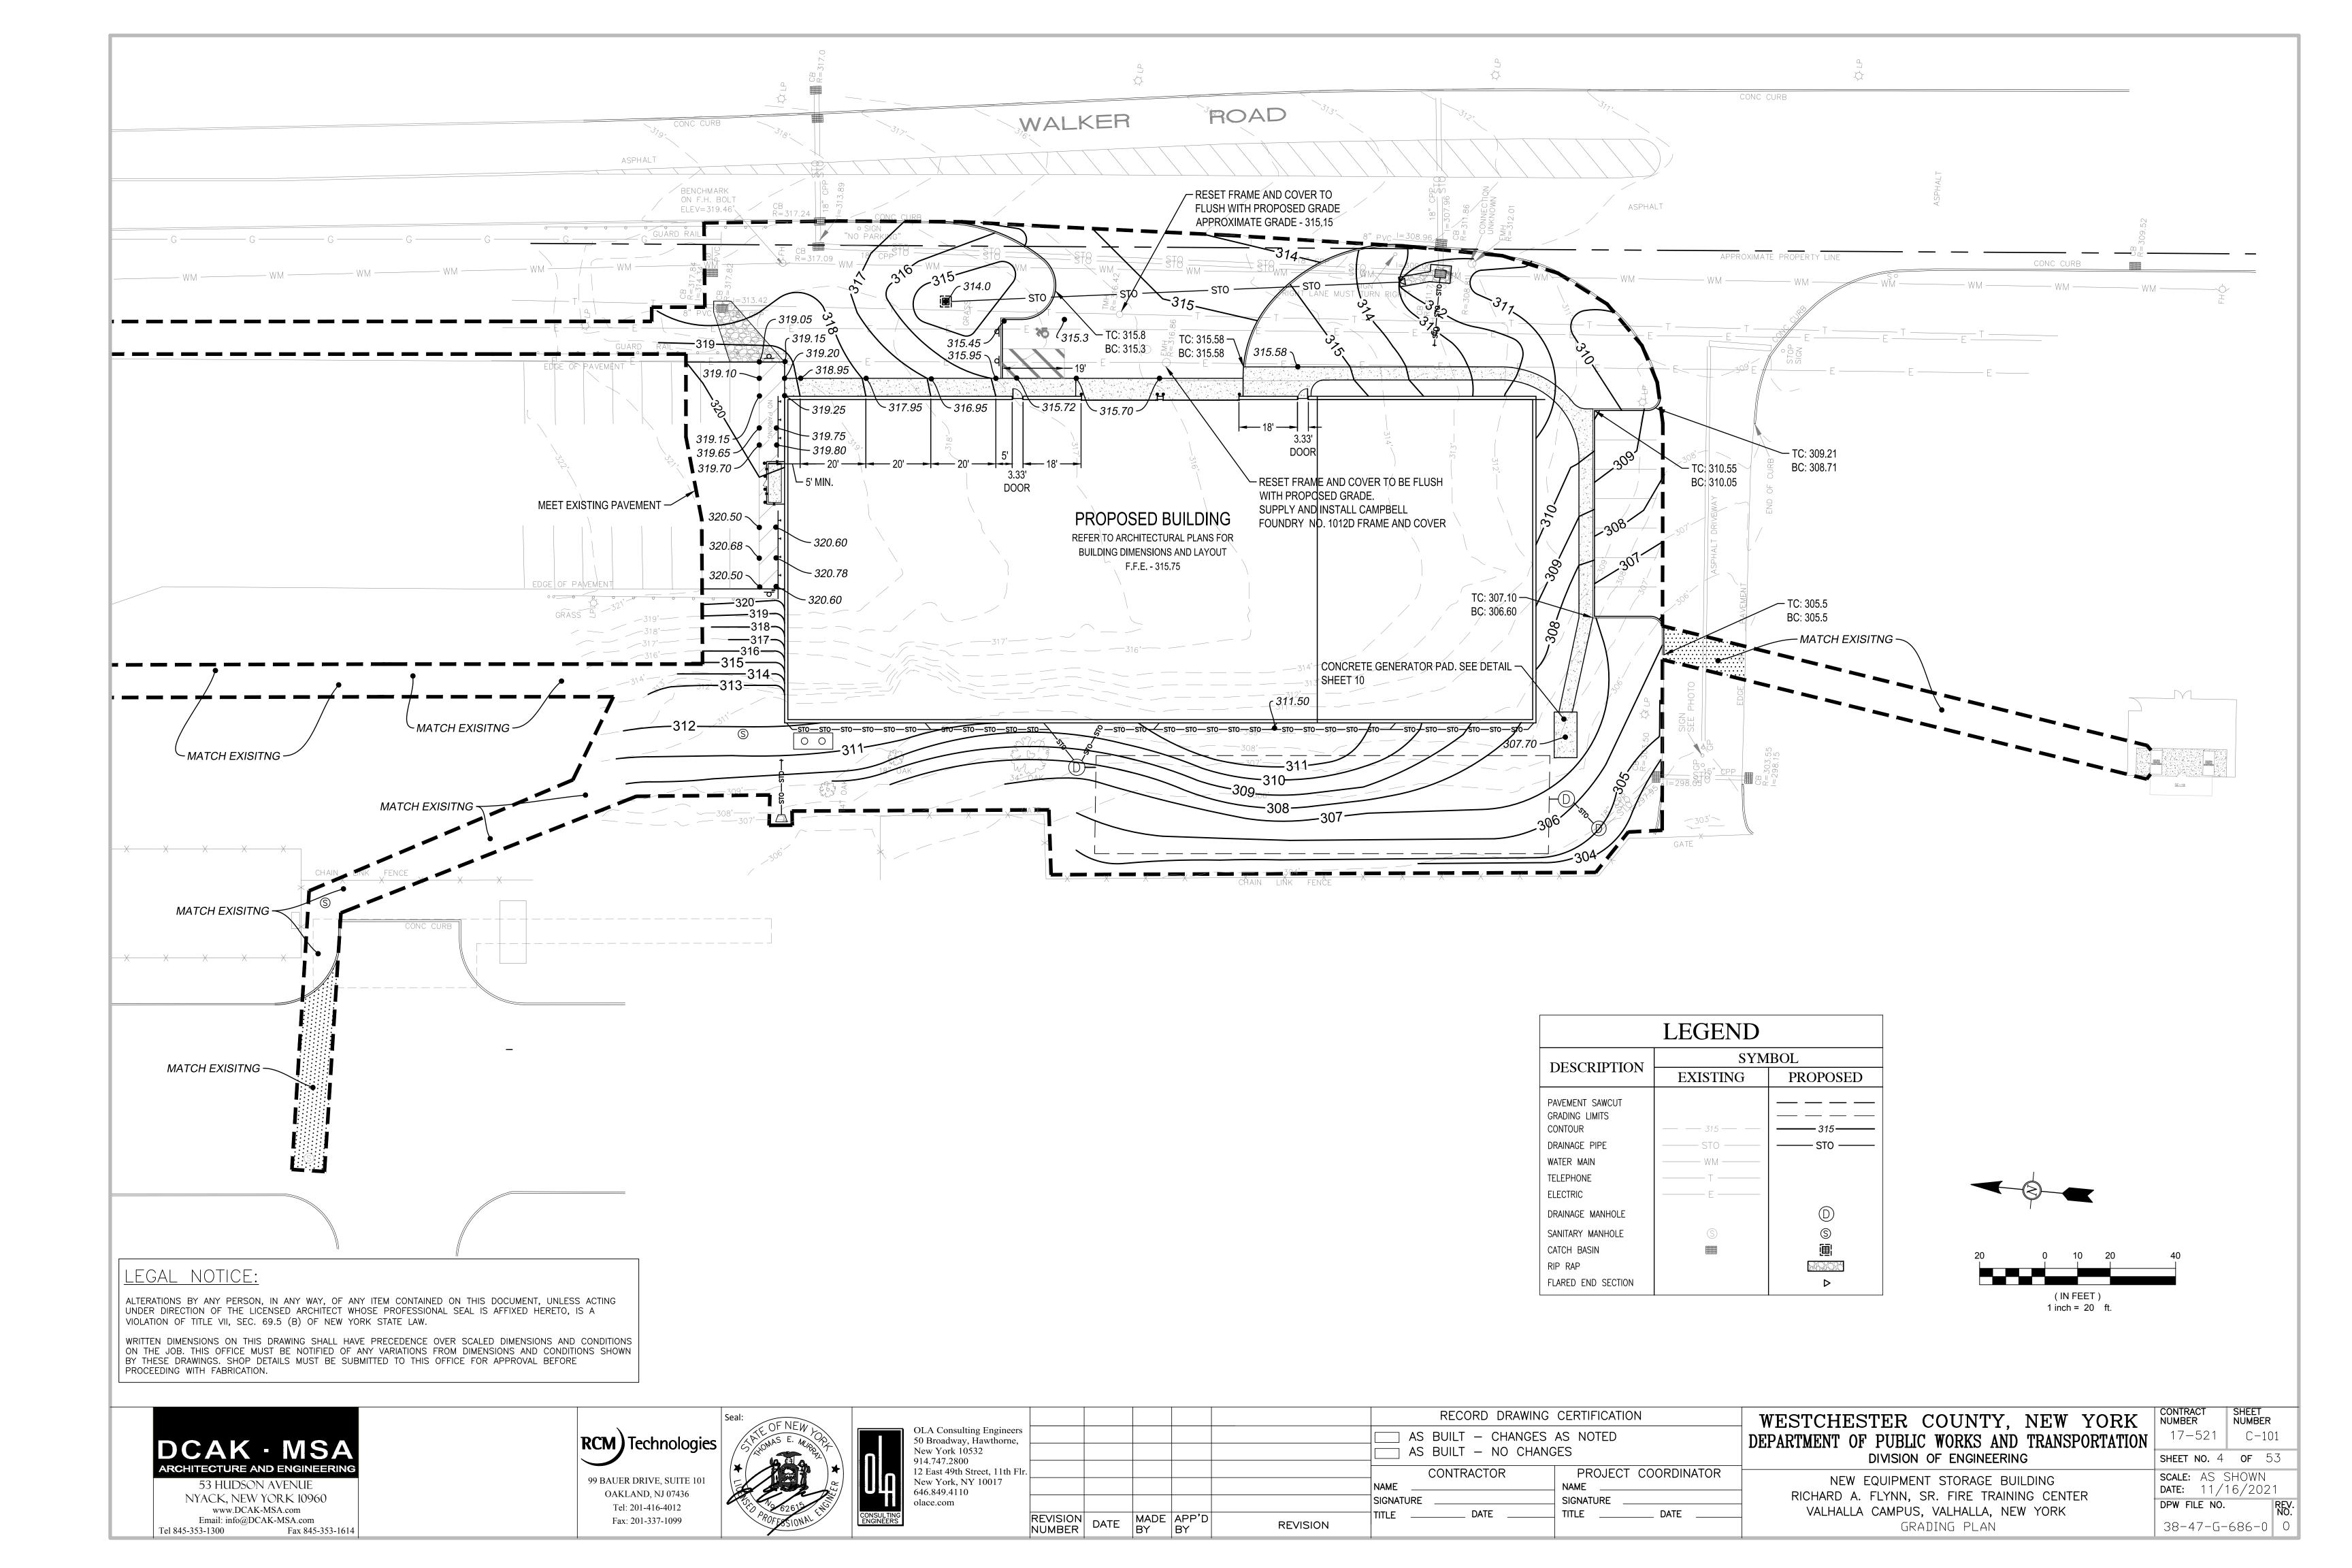
DIVISION OF ENGINEERING NEW EQUIPMENT STORAGE BUILDING RICHARD A. FLYNN, SR. FIRE TRAINING CENTER VALHALLA CAMPUS, VALHALLA, NEW YORK


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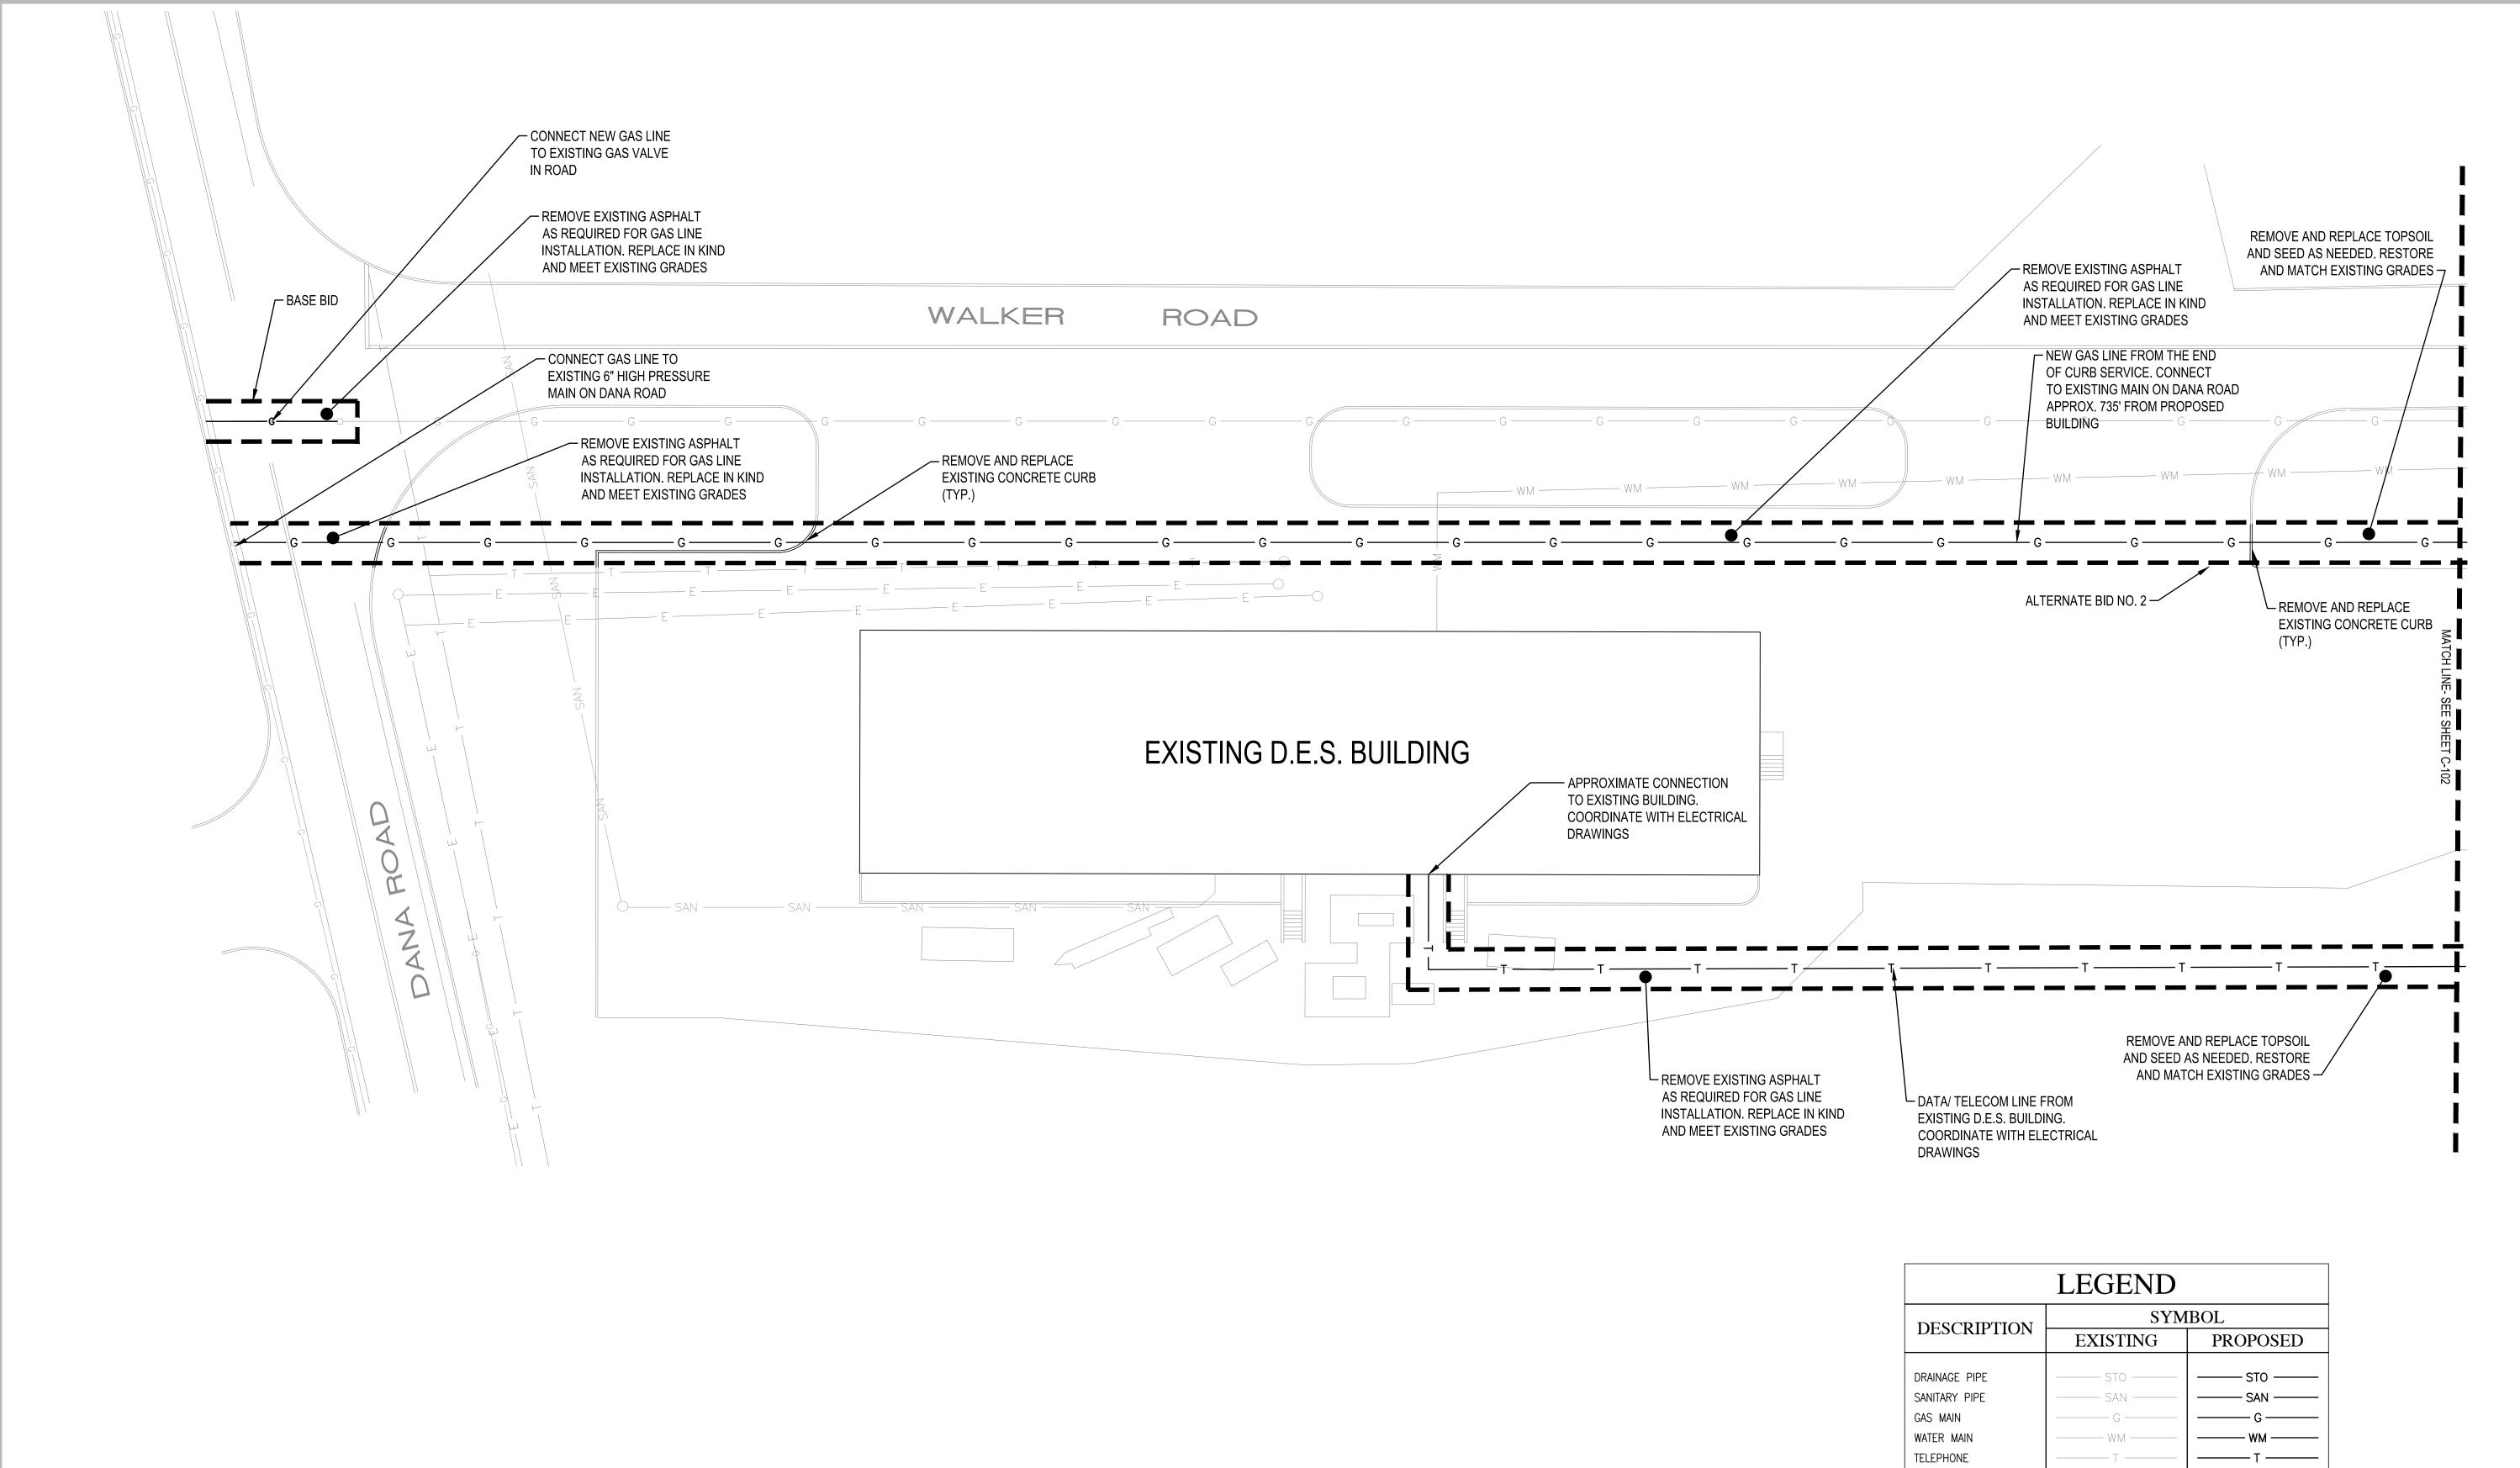
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Tel 845-353-1300


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LEGEND							
DESCRIPTION	SYMBOL						
DESCRIPTION	EXISTING	PROPOSED					
DRAINAGE PIPE	STO	STO					
SANITARY PIPE	SAN	SAN					
GAS MAIN	G	G — G					
WATER MAIN	WM	wм					
TELEPHONE	T						
ELECTRIC	E	E —— E					
DRAINAGE MANHOLE							
SANITARY MANHOLE	S	S					
CATCH BASIN		圓					
RIP RAP							
FLARED END SECTION		▶					
GATE VALVE		\bowtie					

PROJECT COORDINATOR

TITLE _____ DATE ____

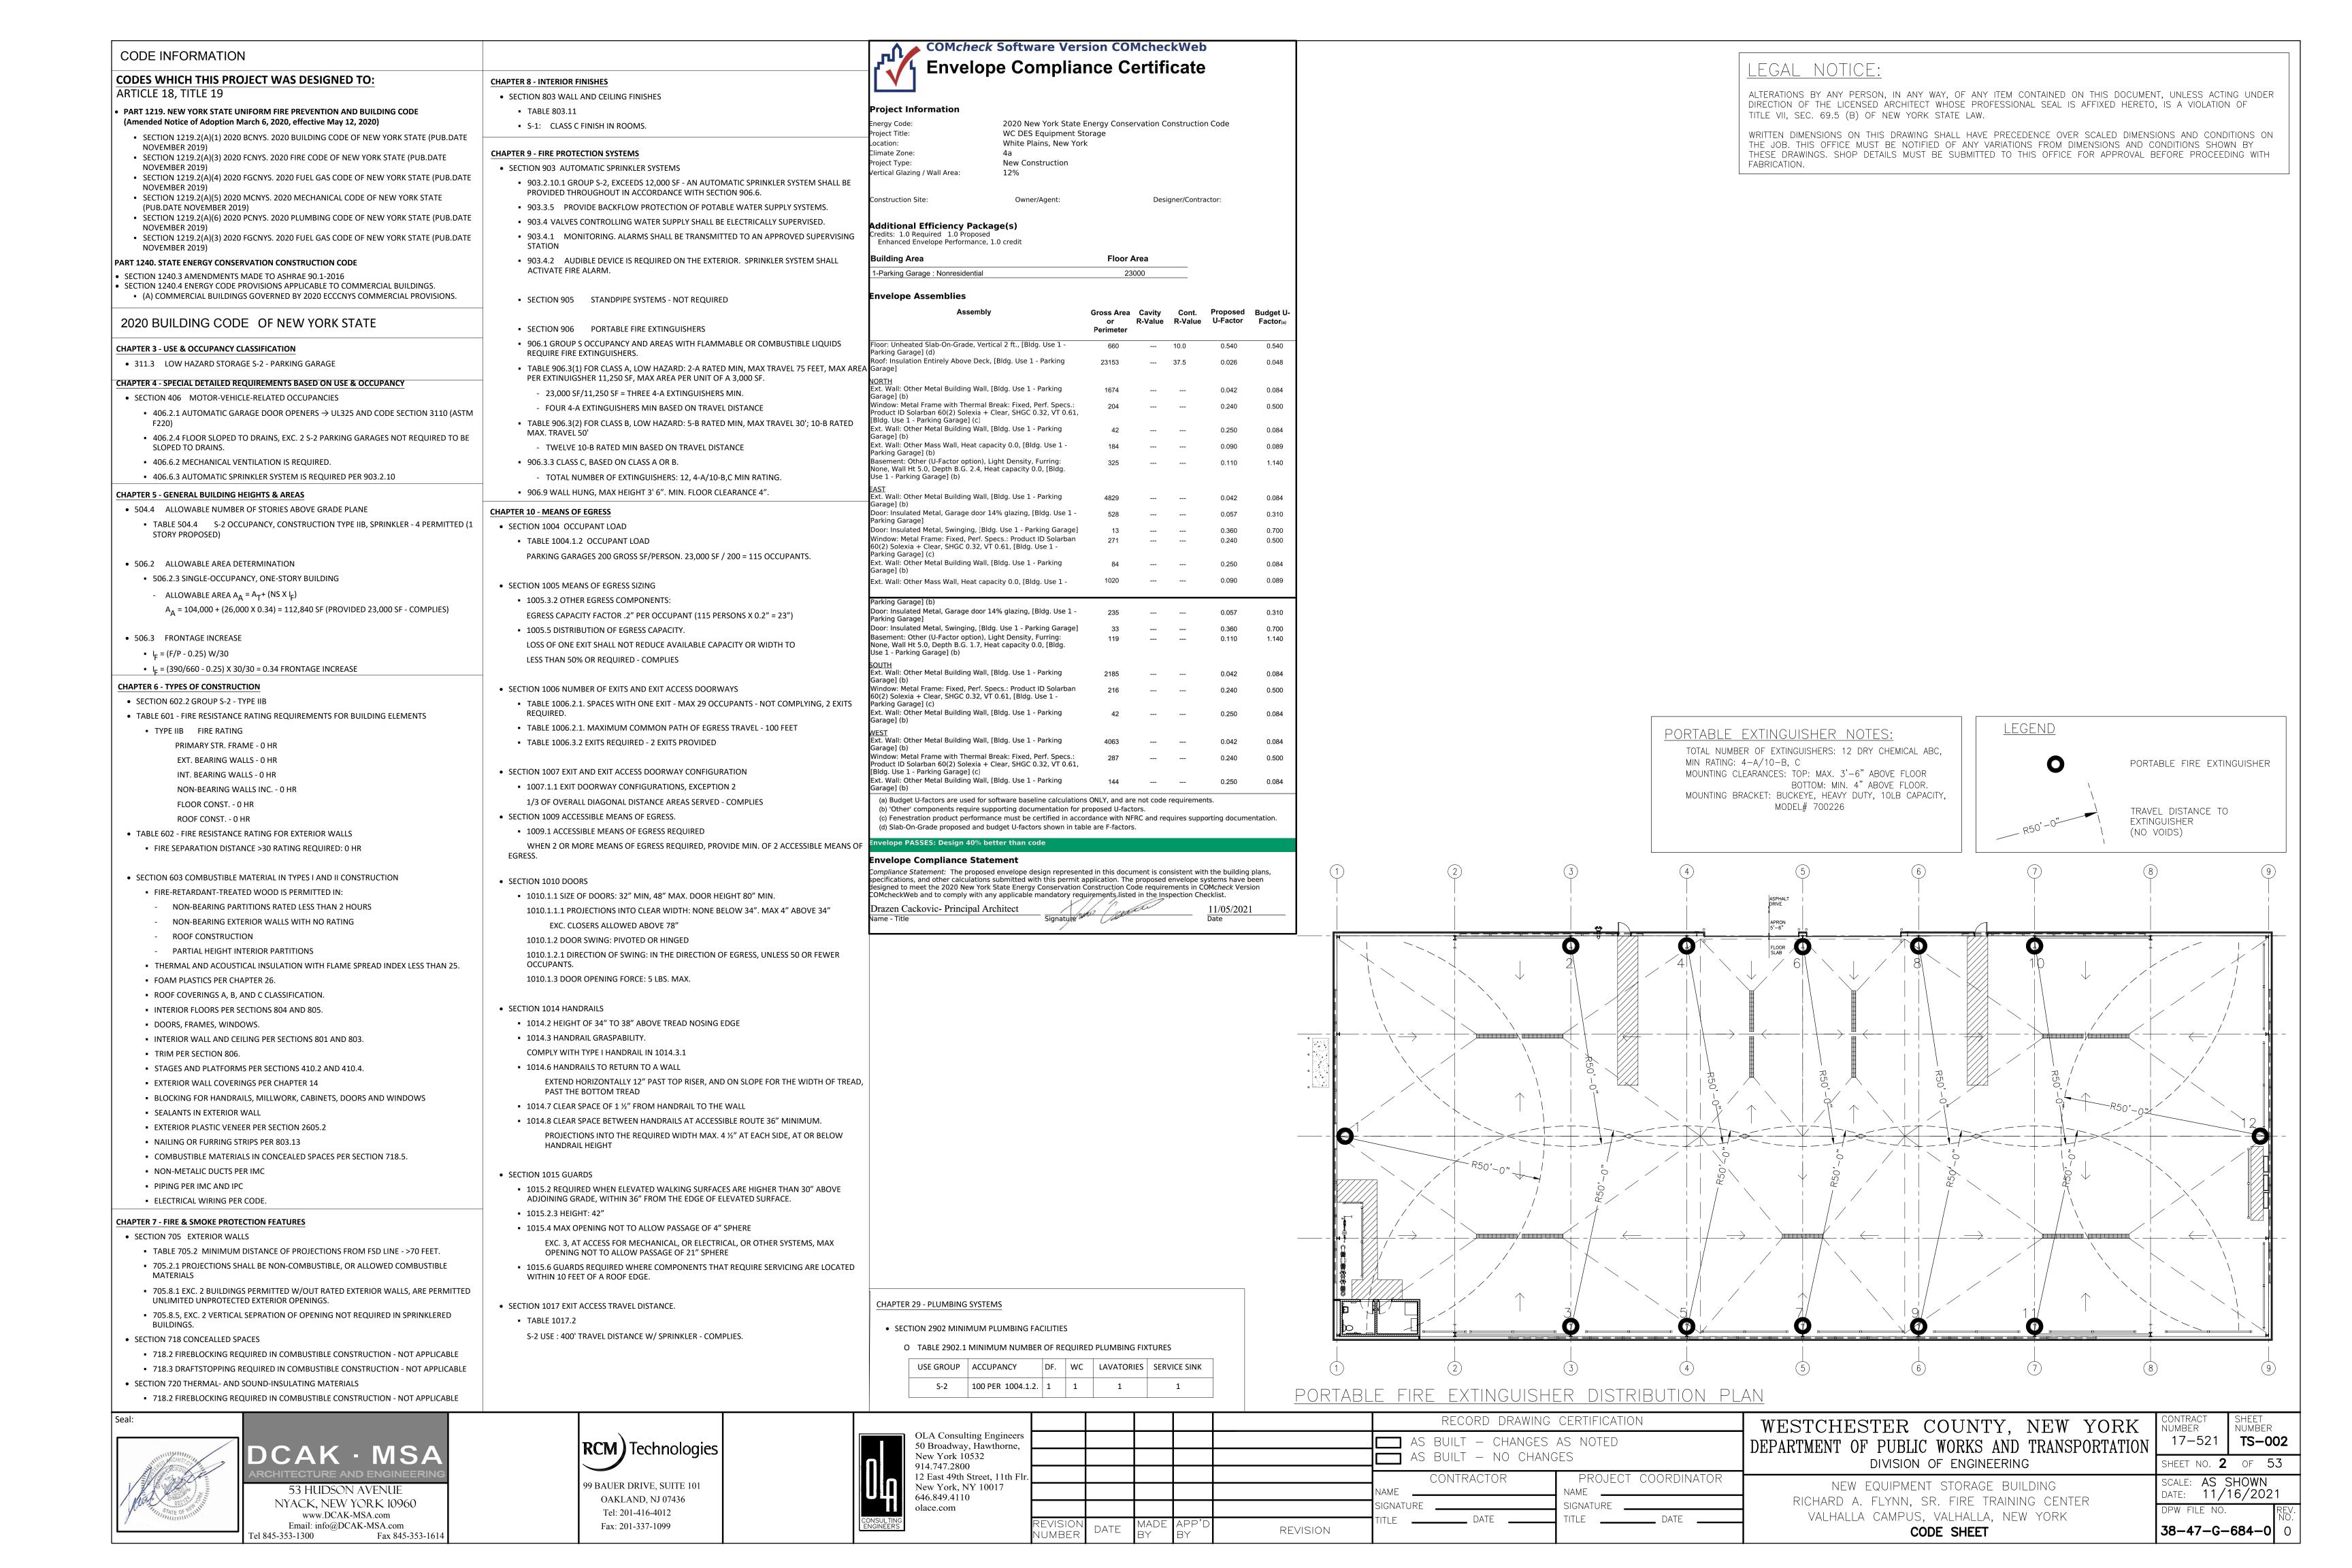

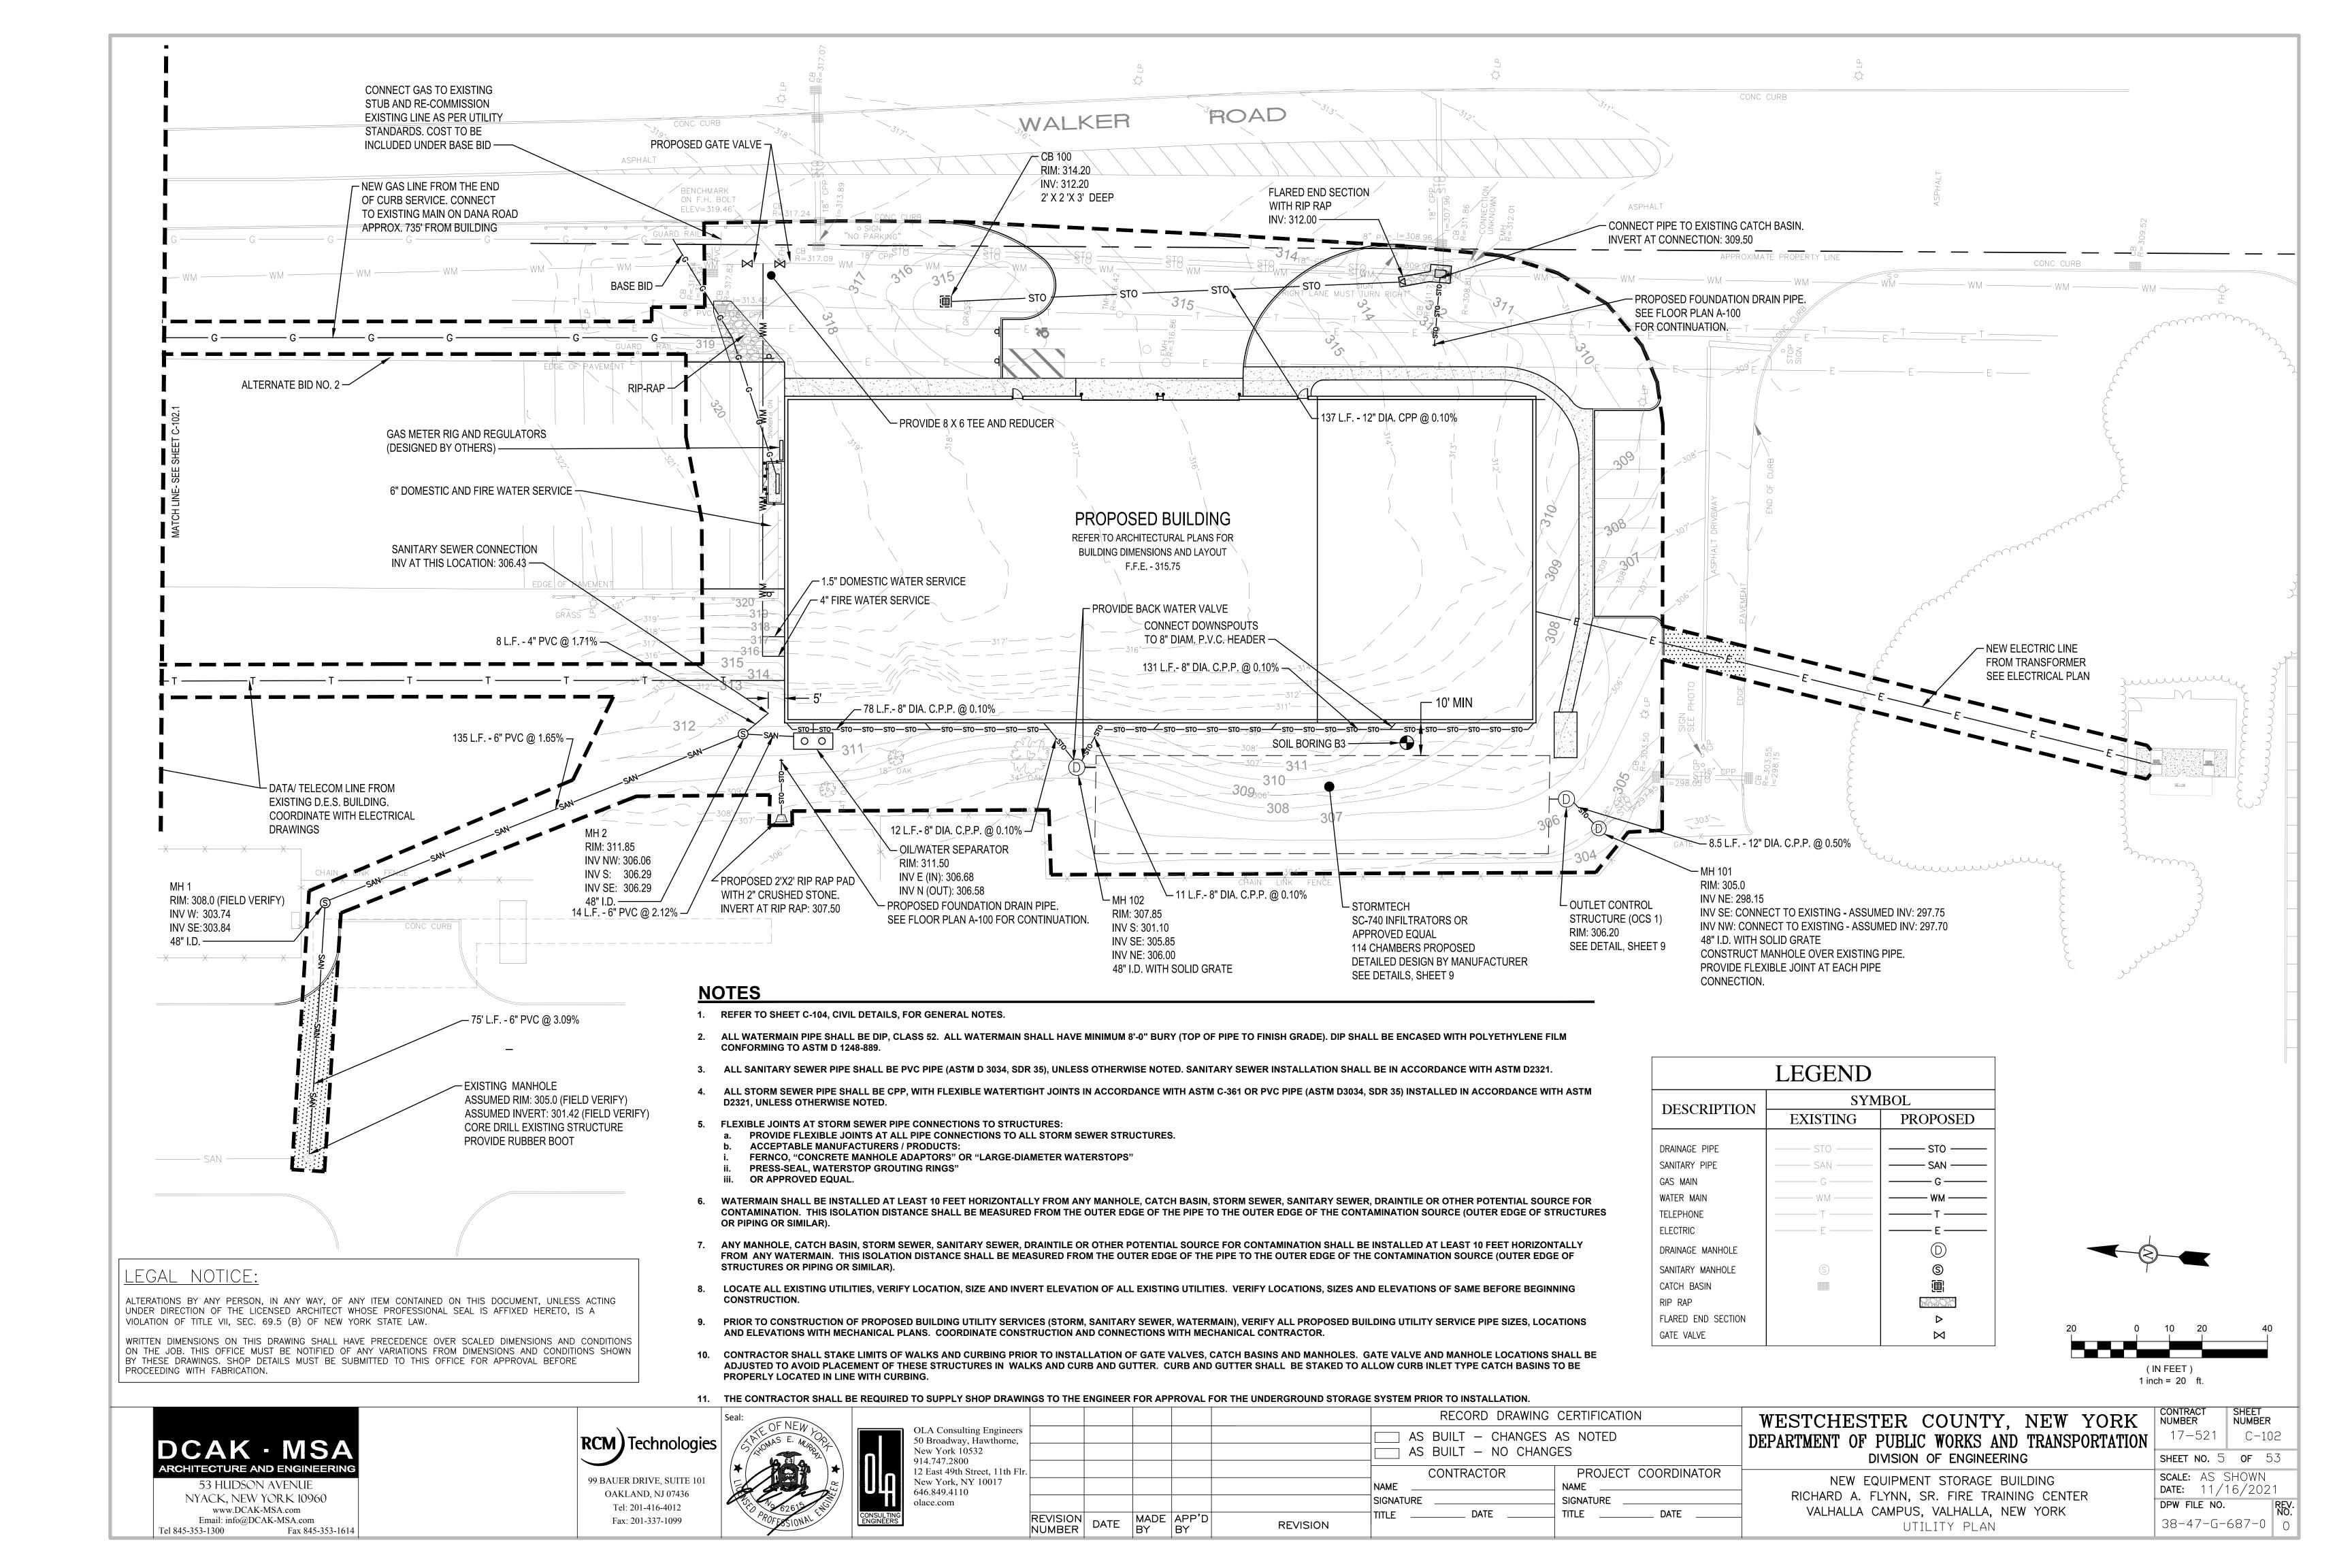

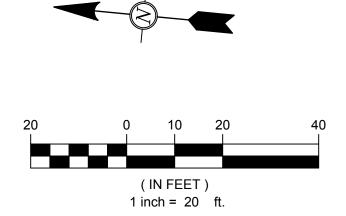www.DCAK-MSA.com

Email: info@DCAK-MSA.com

Fax 845-353-1614

RCM Technologies 99 BAUER DRIVE, SUITE 101

OAKLAND, NJ 07436

Tel: 201-416-4012

Fax: 201-337-1099




	OLA Consulting Engineer 50 Broadway, Hawthorne, New York 10532 914.747.2800 12 East 49th Street, 11th F New York, NY 10017 646.849.4110 olace.com
SULTING INEERS	


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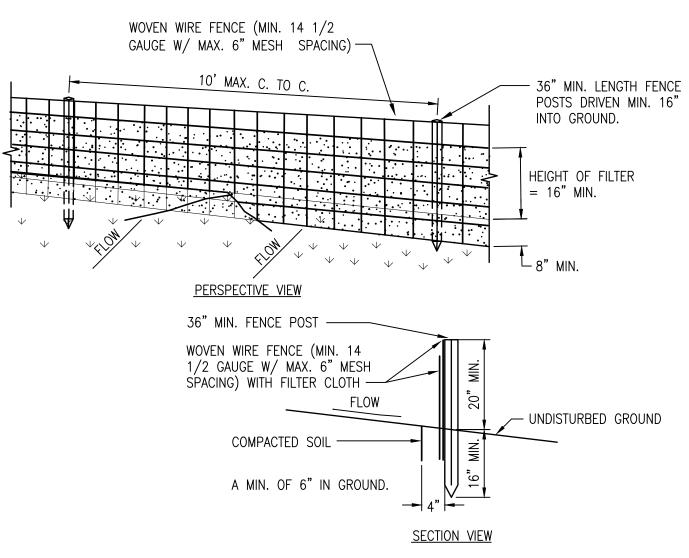
WESTCHESTER COUNTY, NEW YORK	
DEPARTMENT OF PUBLIC WORKS AND TRANSPORTATION	
DIVISION OF ENGINEERING	
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NEW EQUIPMENT STORAGE BUILDING RICHARD A. FLYNN, SR. FIRE TRAINING CENTER VALHALLA CAMPUS, VALHALLA, NEW YORK GAS AND TELEPHONE LINE PLAN

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SCALE: AS SHOWN DATE: 11/16/2021							
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STABILIZE ENTIRE PILE WITH

VEGETATION OR COVER -

SILT FENCE

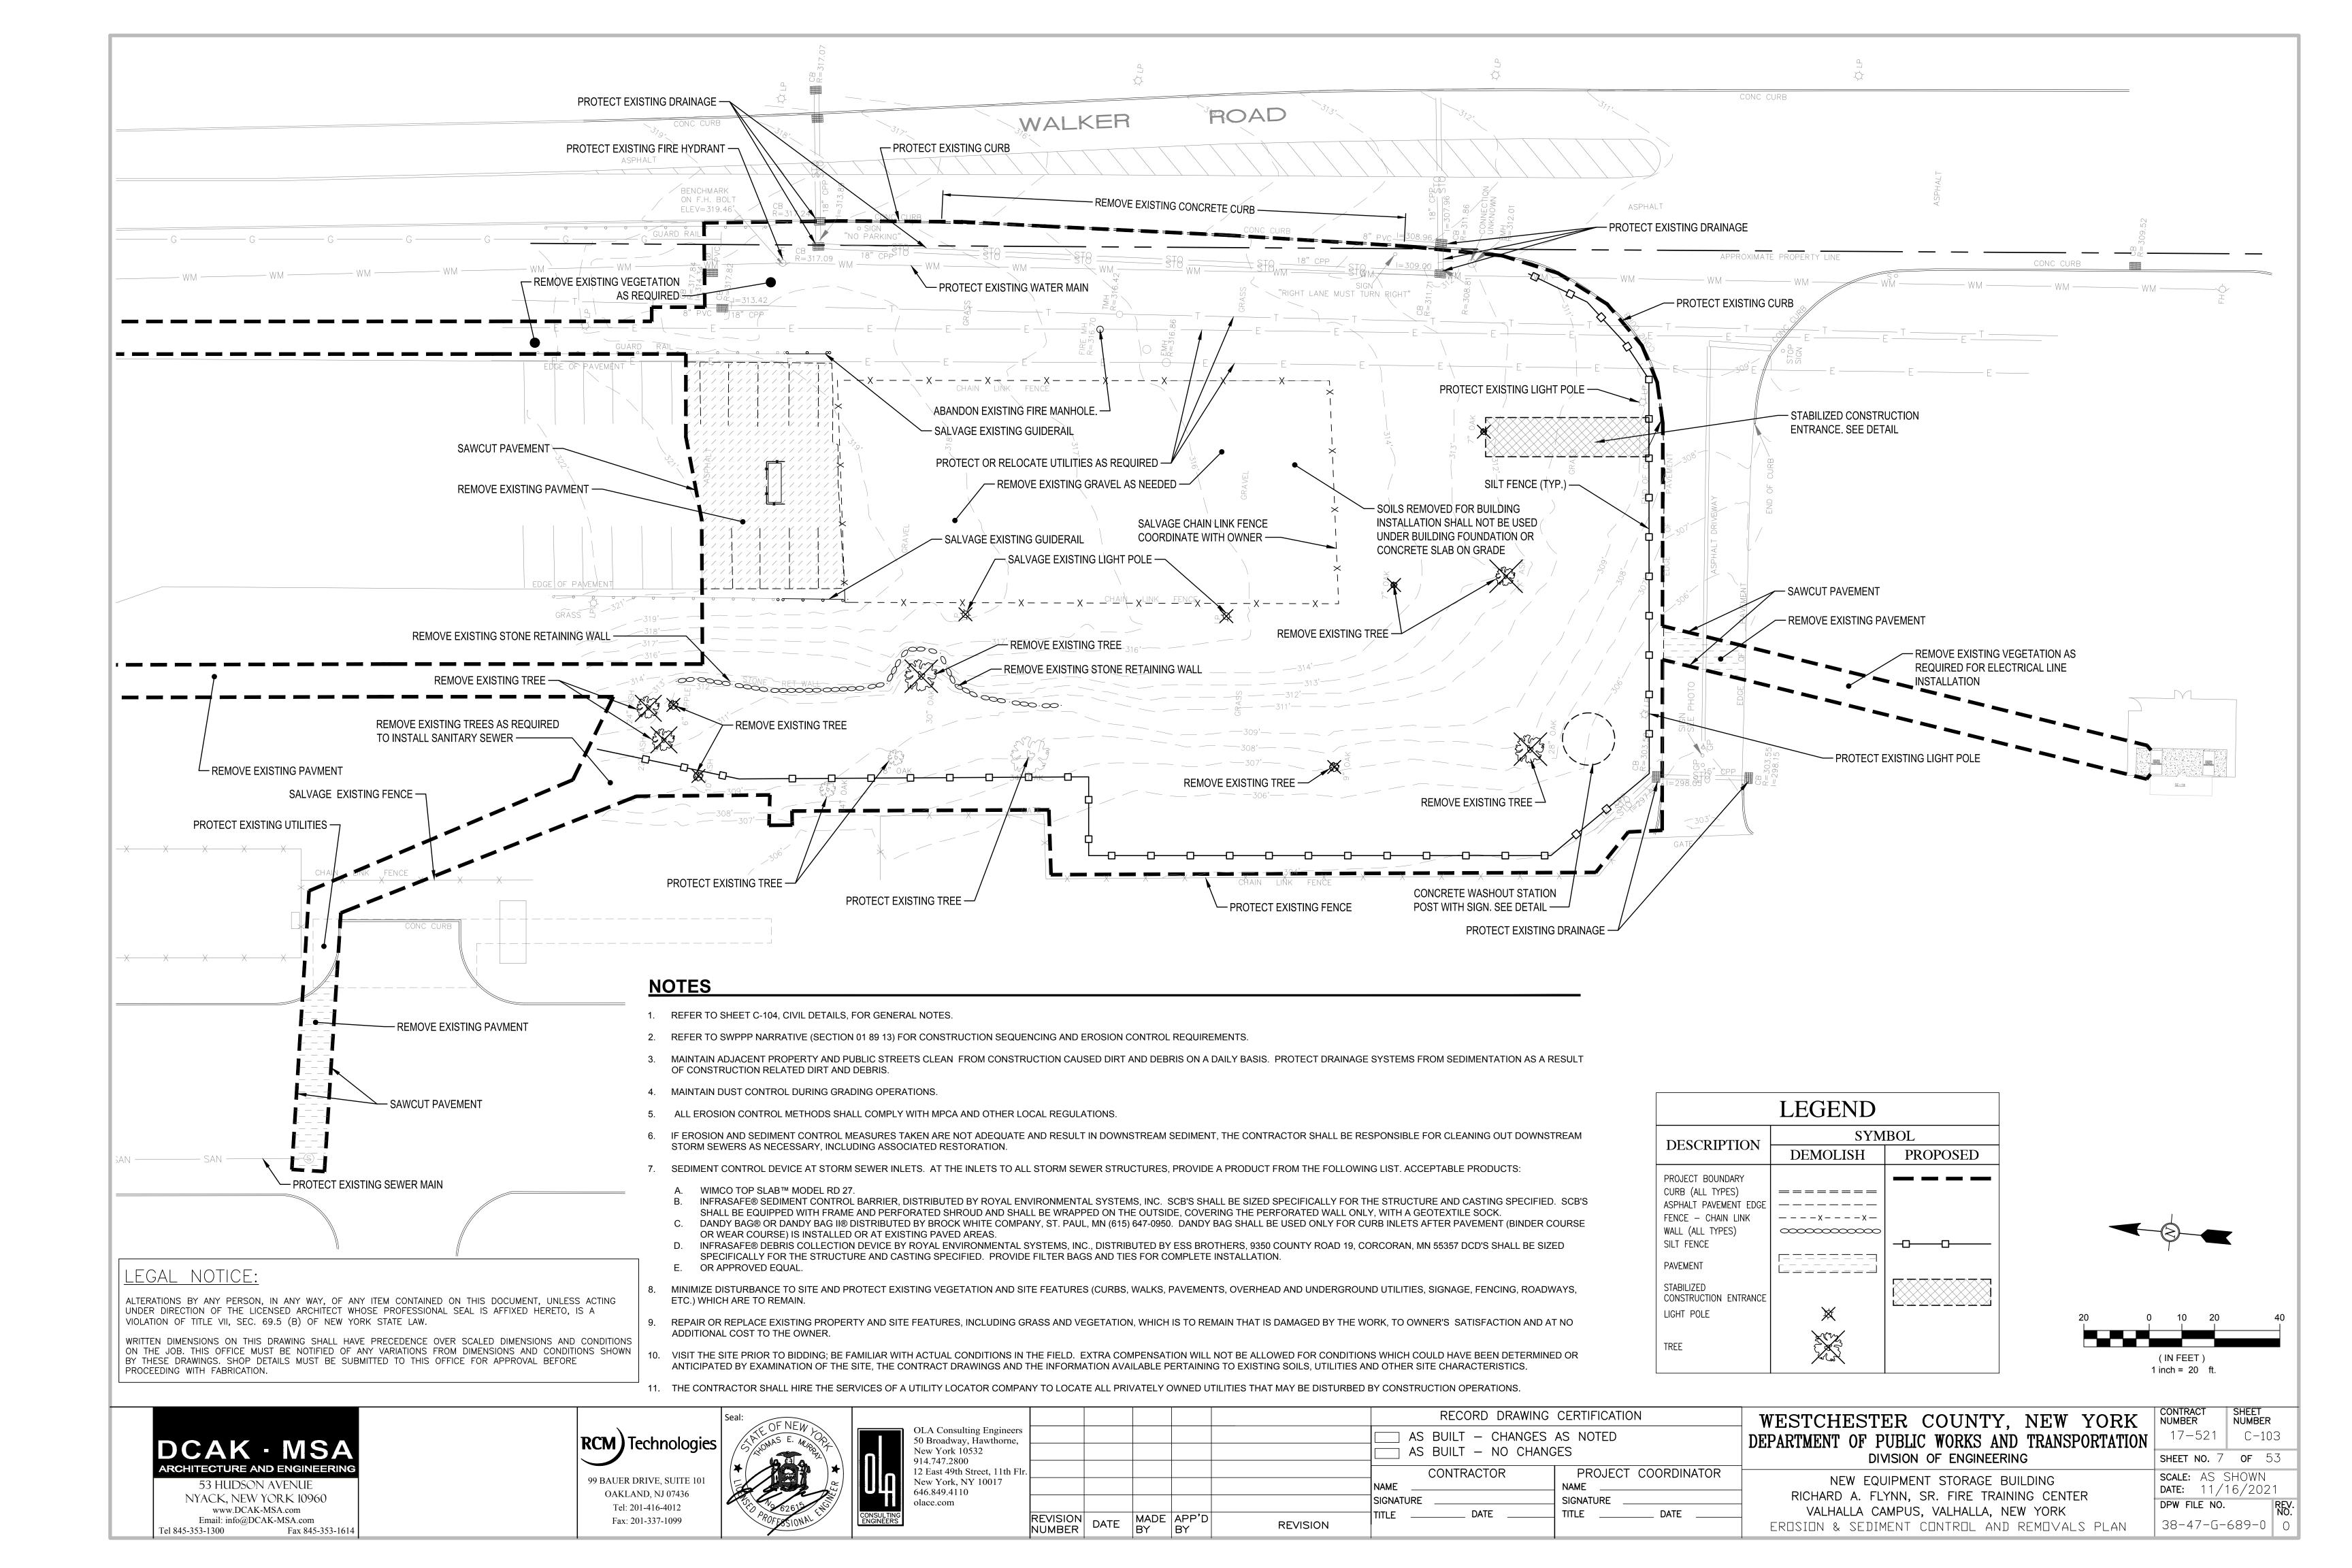N.T.S.

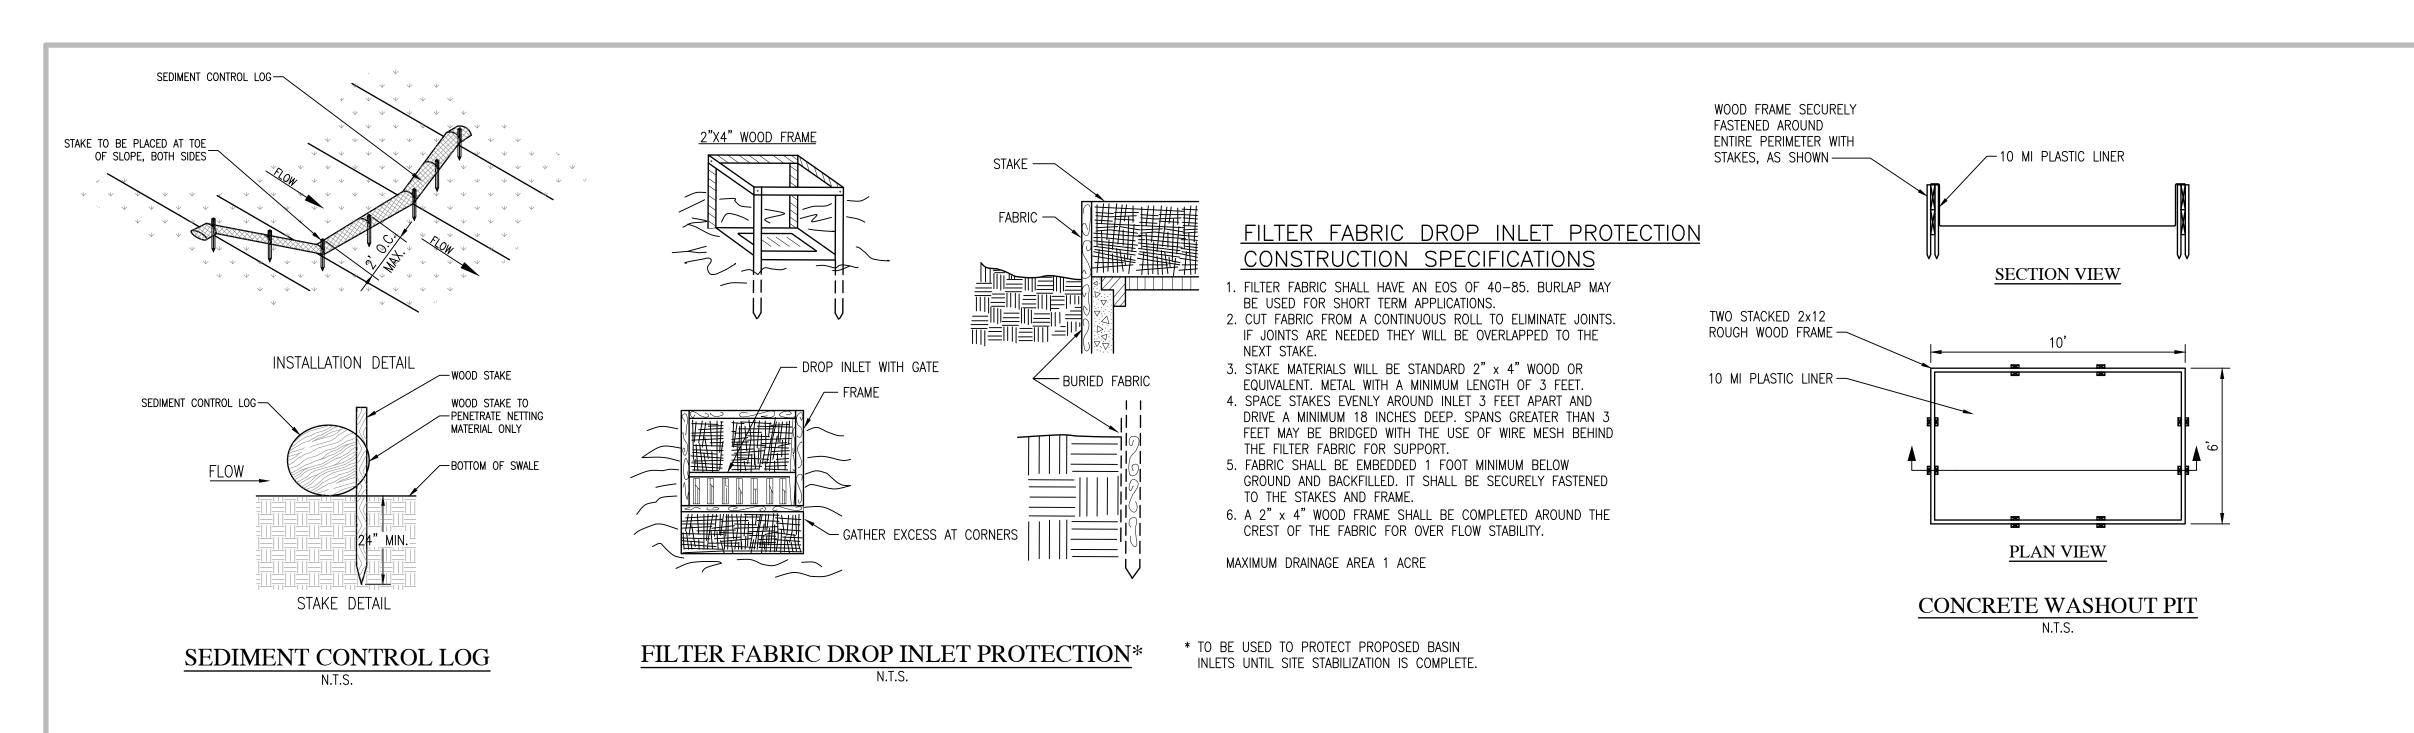HAY BALES OR SILT FENCE

SOIL STOCKPILING

- 2:1 MAX. SLOPE

MIN. SLOPE

SILT FENCE

CONSTRUCTION SPECIFICATIONS 1. WOVEN WIRE FENCE TO BE FASTENED SECURELY TO FENCE POSTS WITH WIRE TIES OR STAPLES. POSTS SHALL BE STEEL

EITHER "T" OR "U" TYPE OR HARDWOOD. 2. FILTER CLOTH TO BE TO BE FASTENED SECURELY TO WOVEN WIRE FENCE WITH TIES SPACED EVERY 24" AT TOP AND MID SECTION. FENCE SHALL BE WOVEN WIRE, 12 1/2 GAUGE, 6" MAXIMUM MESH OPENING.

3. WHEN TWO SECTIONS OF FILTER CLOTH ADJOIN EACH OTHER THEY SHALL BE OVER-LAPPED BY SIX INCHES AND FOLDED. FILTER CLOTH SHALL BE EITHER FILTER X, MIRAFI 100X, STABILINKA T140N, OR APPROVED EQUIVALENT. 4. PREFABRICATED UNITS SHALL BE GEOFAB, ENVIROFENCE, OR

APPROVED EQUIVALENT. 5. MAINTENANCE SHALL BE PERFORMED AS NEEDED AND MATERIAL REMOVED WHEN "BULGES" DEVELOP IN THE SILT

EROSION CONTROL NOTES: I. ALL EROSION AND SEDIMENT CONTROL METHODS AND MATERIALS SHALL CONFORM TO THE LATEST WESTCHESTER COUNTY'S BEST MANAGEMENT PLAN FOR EROSION AND SEDIMENT CONTROL FOR


CONSTRUCTION RELATED ACTIVITIES. 2. THE CONTRACTOR SHALL BE RESPONSIBLE FOR INSTALLING AND MAINTAINING ALL DEVICES THROUGHOUT THE LIFE OF THE CONSTRUCTION ACTIVITY OR AS DIRECTED BY THE SWPPP

<u>NOTES: (MINIMUM REQUIREMENTS)</u> THE COST OF ALL EROSION CONTROL WORK PERFORMED BY THE CONTRACTOR SHALL BE INCLUDED IN THE VARIOUS CONTRACT ITEMS.

CONTRACTOR SHALL PROVIDE SILT FENCE ALONG EDGE OF WETLANDS LOCATED AT THE SOUTHEAST CORNER OF THE PARKING AREA.

CONTRACTOR SHALL PROVIDE DROP INLET PROTECTION AT THE EXISTING AND PROPOSED CATCH BASINS.

CONTRACTOR SHALL PROVIDE PROTECTION AROUND ALL STOCK PILES TO PREVENT EROSION SEDIMENT FROM ENTERING THE WATER.

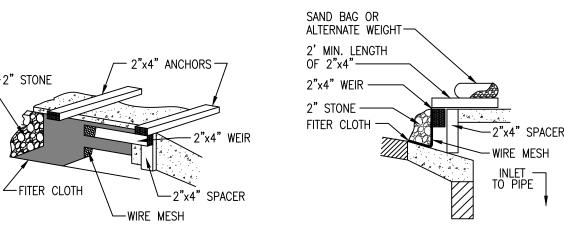

CURB INLET PROTECTION

CONSTRUCTION SPECIFICATIONS

1. FILTER FABRIC SHALL HAVE AN EOS OF 40-85. 2. WOODEN FRAME SHALL BE CONSTRUCTED OF 2"x4" CONSTRUCTION

GRADE LUMBER. WIRE MESH ACROSS THROAT SHALL BE A CONTINUOUS DIECE 30 INCH MINIMUM WIDTH WITH A LENGTH 4 FEET LONGER THAN THE THROAT. IT SHALL BE SHAPED AND SECURELY NAILED TO A 2"x4" WEIR.

4. THE WEIR SHALL BE SECURELY NAILED TO A 2"x4" SPACERS 9 INCHES LONG SPACED NO MORE THAN 6 FEET APART. 5. THE ASSEMBLY SHALL BE PLACED AGAINST THE INLET AND SECURED BY 2"x4" ANCHORS 2 FEET LONG EXTENDING ACROSS THE TOP OF THE

INLET AND HELD IN PLACE BY SANDBAGS OR ALTERNATE WEIGHTS. 6. PROVIDE INLET PROTECTION FOR ALL DRAINAGE STRUCTURES 300 FT. DOWN GRADE FROM WORK AREA.

CURB INLET PROTECTION DETAIL

50' MIN. EXISTING 6" MIN. STONE SEE NOTE PAVEMENT -FILTER - MOUNTABLE BERM CLOTH — (OPTIONAL) <u>PROFILE</u> 50' MIN. **EXISTING** GROUND -12' MIN: | EXISTING PAVEMENT <u>PLAN VIEW</u>

STABILIZED CONSTRUCTION ENTRANCE

STABILIZED CONSTRUCTION SPECIFICATIONS

1. STONE SIZE - USE 3-6" STONE, OR RECLAIMED OR RECYCLED

CONCRETE EQUIVALENT. 2. LENGTH – NOT LESS THAN 50 FEET

3. THICKNESS - NOT LESS THAN TWELVE (12) INCHES.

4. WIDTH - TWELVE (20) FOOT MINIMUM, BUT NOT LESS THAN THE

FULL WIDTH AT POINTS WHERE INGRESS OR EGRESS OCCURS. 5. FILTER CLOTH - WILL BE PLACED OVER THE ENTIRE AREA PRIOR TO PLACING OF STONE.

6. SURFACE WATER - ALL SURFACE WATER FLOWING OR DIVERTED TOWARD CONSTRUCTION ENTRANCES SHALL BE PIPED ACROSS THE ENTRANCE. IF PIPING IS IMPRACTICAL, A MOUNTABLE BERM WITH 5:1 SLOPES WILL BE PERMITTED

7. MAINTENANCE - THE ENTRANCE SHALL BE MAINTAINED IN A CONDITION WHICH WILL PREVENT TRACKING OR FLOWING OF SEDIMENT ONTO PUBLIC RIGHTS-OF-WAY, ALL SEDIMENT SPILLED, DROPPED, WASHED OR TRACTED ONTO PUBLIC RIGHTS-OF-WAY

PROJECT COORDINATOR

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MUST BE REMOVED IMMEDIATELY. 8. WHEN WASHING IS REQUIRED, IT SHALL BE DONE ON A AREA STABILIZED WITH STONE AND WHICH DRAINS INTO AN APPROVED SEDIMENT TRAPPING DEVICE.

9. PERIODIC INSPECTION AND NEEDED MAINTENANCE SHALL BE PROVIDED AFTER EACH RAIN.

GENERAL NOTES

- ALL CONSTRUCTION MUST COMPLY WITH APPLICABLE STATE AND LOCAL ORDINANCES.
- 2. THE CONTRACTOR WILL BE RESPONSIBLE FOR AND SHALL PAY FOR ALL CONSTRUCTION STAKING / LAYOUT.
- 3. THE CONTRACTOR SHALL OBTAIN AND PAY FOR ALL RELATED CONSTRUCTION PERMITS.
- CONTRACTOR SHALL BE RESPONSIBLE FOR ALL TRAFFIC CONTROL SIGNAGE (CONSTRUCTION ZONES) NECESSARY TO CONSTRUCT PROPOSED IMPROVEMENTS. ALL SIGNAGE LAYOUTS MUST BE DESIGNED BY THE CONTRACTOR AND APPROVED BY LOCAL AUTHORITIES.
- INSTALL CONTROL FENCING AND BARRICADING AS NECESSARY TO PROTECT THE PUBLIC.
- INSPECT SITE AND REVIEW SOIL BORINGS TO DETERMINE EXTENT OF WORK AND NATURE OF MATERIALS TO
- CHECK ALL PLAN AND DETAIL DIMENSIONS AND VERIFY SAME BEFORE FIELD LAYOUT.
- REFER TO ARCHITECTURAL PLANS FOR BUILDING AND STOOP DIMENSIONS AND LAYOUT.
- 9. REFER TO THE STORM WATER POLLUTION PREVENTION PLAN (SWPPP) NARRATIVE FOR EROSION CONTROL
- 10. MAINTAIN ADJACENT PROPERTY AND PUBLIC STREETS CLEAN FROM CONSTRUCTION CAUSED DIRT AND DEBRIS ON A DAILY BASIS. PROTECT DRAINAGE SYSTEMS FROM SEDIMENTATION AS A RESULT OF CONSTRUCTION RELATED DIRT AND DEBRIS.
- 11. MAINTAIN DUST CONTROL DURING GRADING OPERATIONS.
- 12. ALL EROSION CONTROL METHODS SHALL COMPLY WITH LOCAL REGULATIONS.
- 13. CONTRACTOR SHALL MINIMIZE DISTURBANCE TO SITE AND PROTECT EXISTING SITE FEATURES (INCLUDING TURF AND VEGETATION) WHICH ARE TO REMAIN.
- 14. PROPOSED CONTOURS AND SPOT ELEVATIONS ARE SHOWN TO FINISH GRADE UNLESS OTHERWISE NOTED.
- 15. SPOT ELEVATIONS SHOWN IN PARKING LOTS, DRIVES AND ROADS INDICATE GUTTER GRADES, UNLESS NOTED OTHERWISE. SPOT ELEVATIONS WITH LABELS OUTSIDE THE BUILDING PERIMETER INDICATE PROPOSED GRADES OUTSIDE THE BUILDING. SPOT ELEVATIONS WITH LABELS INSIDE THE BUILDING PERIMETER INDICATE PROPOSED FINISH FLOOR ELEVATIONS.
- 16. THE CONTRACTOR SHALL BE SOLELY RESPONSIBLE FOR DETERMINING QUANTITIES OF CUT, FILL AND WASTE MATERIALS TO BE HANDLED, AND FOR AMOUNT OF GRADING TO BE DONE IN ORDER TO COMPLETELY PERFORM ALL WORK INDICATED ON THE DRAWINGS. IMPORT SUITABLE MATERIAL AND EXPORT UNSUITABLE / EXCESS / WASTE MATERIAL AS REQUIRED. ALL COSTS ASSOCIATED WITH IMPORTING AND EXPORTING MATERIALS SHALL BE INCIDENTAL TO THE CONTRACT.
- 17. NO FINISHED SLOPES SHALL EXCEED 4' HORIZONTAL TO 1' VERTICAL (4:1), UNLESS OTHERWISE NOTED.
- 18. ALL DISTURBED AREAS OUTSIDE THE BUILDING PAD WHICH ARE NOT DESIGNATED TO BE PAVED OR RECEIVE AGLIME, SHALL RECEIVE AT LEAST 6" OF TOPSOIL AND SHALL BE SEEDED.
- 19. FAILURE OF TURF DEVELOPMENT: IN THE EVENT THE CONTRACTOR FAILS TO PROVIDE AN ACCEPTABLE TURF, THE CONTRACTOR SHALL RE-SEED ALL APPLICABLE AREAS, AT NO ADDITIONAL COST TO THE OWNER, TO THE SATISFACTION OF THE ENGINEER
- 20. ALL WATERMAIN PIPE SHALL BE DIP, CLASS 52. ALL WATERMAIN SHALL HAVE MINIMUM 4'-6" BURY (TOP OF PIPE TO FINISH GRADE).
- 21. ALL SANITARY SEWER PIPE SHALL BE PVC PIPE (ASTM D 3034, SDR 35), UNLESS OTHERWISE NOTED. SANITARY SEWER INSTALLATION SHALL BE IN ACCORDANCE WITH ASTM D2321
- 22. ALL STORM SEWER PIPE SHALL BE CPP, WITH FLEXIBLE WATERTIGHT JOINTS IN ACCORDANCE WITH ASTM C-361 OR PVC PIPE (ASTM D3034, SDR 35) INSTALLED IN ACCORDANCE WITH ASTM D2321, UNLESS OTHERWISE NOTED.
- 23. FLEXIBLE JOINTS AT STORM SEWER PIPE CONNECTIONS TO STRUCTURES:
- a. PROVIDE FLEXIBLE JOINTS AT ALL PIPE CONNECTIONS TO ALL STORM SEWER STRUCTURES. **ACCEPTABLE MANUFACTURERS / PRODUCTS:**
- FERNCO, "CONCRETE MANHOLE ADAPTORS" OR "LARGE-DIAMETER WATERSTOPS"
- PRESS-SEAL, WATERSTOP GROUTING RINGS" OR APPROVED EQUAL.
- 24. WATERMAIN SHALL BE INSTALLED AT LEAST 10 FEET HORIZONTALLY FROM ANY MANHOLE, CATCH BASIN, STORM SEWER, SANITARY SEWER, DRAINTILE OR OTHER POTENTIAL SOURCE FOR CONTAMINATION. THIS ISOLATION DISTANCE SHALL BE MEASURED FROM THE OUTER EDGE OF THE PIPE TO THE OUTER EDGE OF THE CONTAMINATION SOURCE (OUTER EDGE OF STRUCTURES OR PIPING OR SIMILAR).
- 25. ANY MANHOLE, CATCH BASIN, STORM SEWER, SANITARY SEWER, DRAINTILE OR OTHER POTENTIAL SOURCE FOR CONTAMINATION SHALL BE INSTALLED AT LEAST 10 FEET HORIZONTALLY FROM ANY WATERMAIN. THIS ISOLATION DISTANCE SHALL BE MEASURED FROM THE OUTER EDGE OF THE PIPE TO THE OUTER EDGE OF THE CONTAMINATION SOURCE (OUTER EDGE OF STRUCTURES OR PIPING OR SIMILAR).
- 26 LOCATE ALL EXISTING UTILITIES, VERIFY LOCATION, SIZE AND INVERT ELEVATION OF ALL EXISTING UTILITIES. VERIFY LOCATIONS, SIZES AND ELEVATIONS OF SAME BEFORE BEGINNING CONSTRUCTION.
- 27. PRIOR TO CONSTRUCTION OF PROPOSED BUILDING UTILITY SERVICES (STORM, SANITARY SEWER, WATERMAIN), VERIFY ALL PROPOSED BUILDING UTILITY SERVICE PIPE SIZES, LOCATIONS AND ELEVATIONS WITH MECHANICAL PLANS. COORDINATE CONSTRUCTION AND CONNECTIONS WITH MECHANICAL CONTRACTOR.
- 28. CONTRACTOR SHALL MAINTAIN DRAINAGE FROM EXISTING BUILDING AT ALL TIMES. PROVIDE TEMPORARY STORM SEWER (INCLUDING, BUT NOT LIMITED TO, CATCH BASINS, MANHOLES, PIPING, ETC.) AS REQUIRED. EXISTING STORM SEWER SHALL NOT BE REMOVED UNTIL TEMPORARY OR PERMANENT STORM SEWER IS INSTALLED AND FUNCTIONAL. COORDINATE ALL REMOVALS WITH APPROPRIATE TRADES (SITE UTILITY CONTRACTOR, MECHANICAL CONTRACTOR, ETC.) AS REQUIRED.
- 29. CONTRACTOR SHALL STAKE LIMITS OF WALKS AND CURBING PRIOR TO INSTALLATION OF GATE VALVES, CATCH BASINS AND MANHOLES. GATE VALVE AND MANHOLE LOCATIONS SHALL BE ADJUSTED TO AVOID PLACEMENT OF THESE STRUCTURES IN WALKS AND CURB AND GUTTER. CURB AND GUTTER SHALL BE STAKED TO ALLOW CURB INLET TYPE CATCH BASINS TO BE PROPERLY LOCATED IN LINE WITH CURBING.

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MIN. SLOPE



OAKLAND, NJ 07436

Tel: 201-416-4012

Fax: 201-337-1099



CONSTRUCTION SPECIFICATIONS

1. AREA CHOSEN FOR STOCKPILING OPERATIONS SHALL BE DRY

4. SEE SILT FENCE DETAIL FOR INSTALLATION OF SILT FENCE.

3. UPON COMPLETION OF SOIL STOCKPILING EACH PILE SHALL BE

SURROUNDED WITH EITHER SILT FENCING OR HAY BALES, THEN

2. MAXIMUM SLOPE OF STOCKPILES SHALL BE 2:1.

STABILIZED WITH VEGETATION OR COVERED.

SOIL STOCKPILING

AND STABLE.

CONSULTING ENGINEERS

OLA Consulting Engineers
50 Broadway, Hawthorne,
New York 10532
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12 East 49th Street, 11th Flr
New York, NY 10017
646.849.4110
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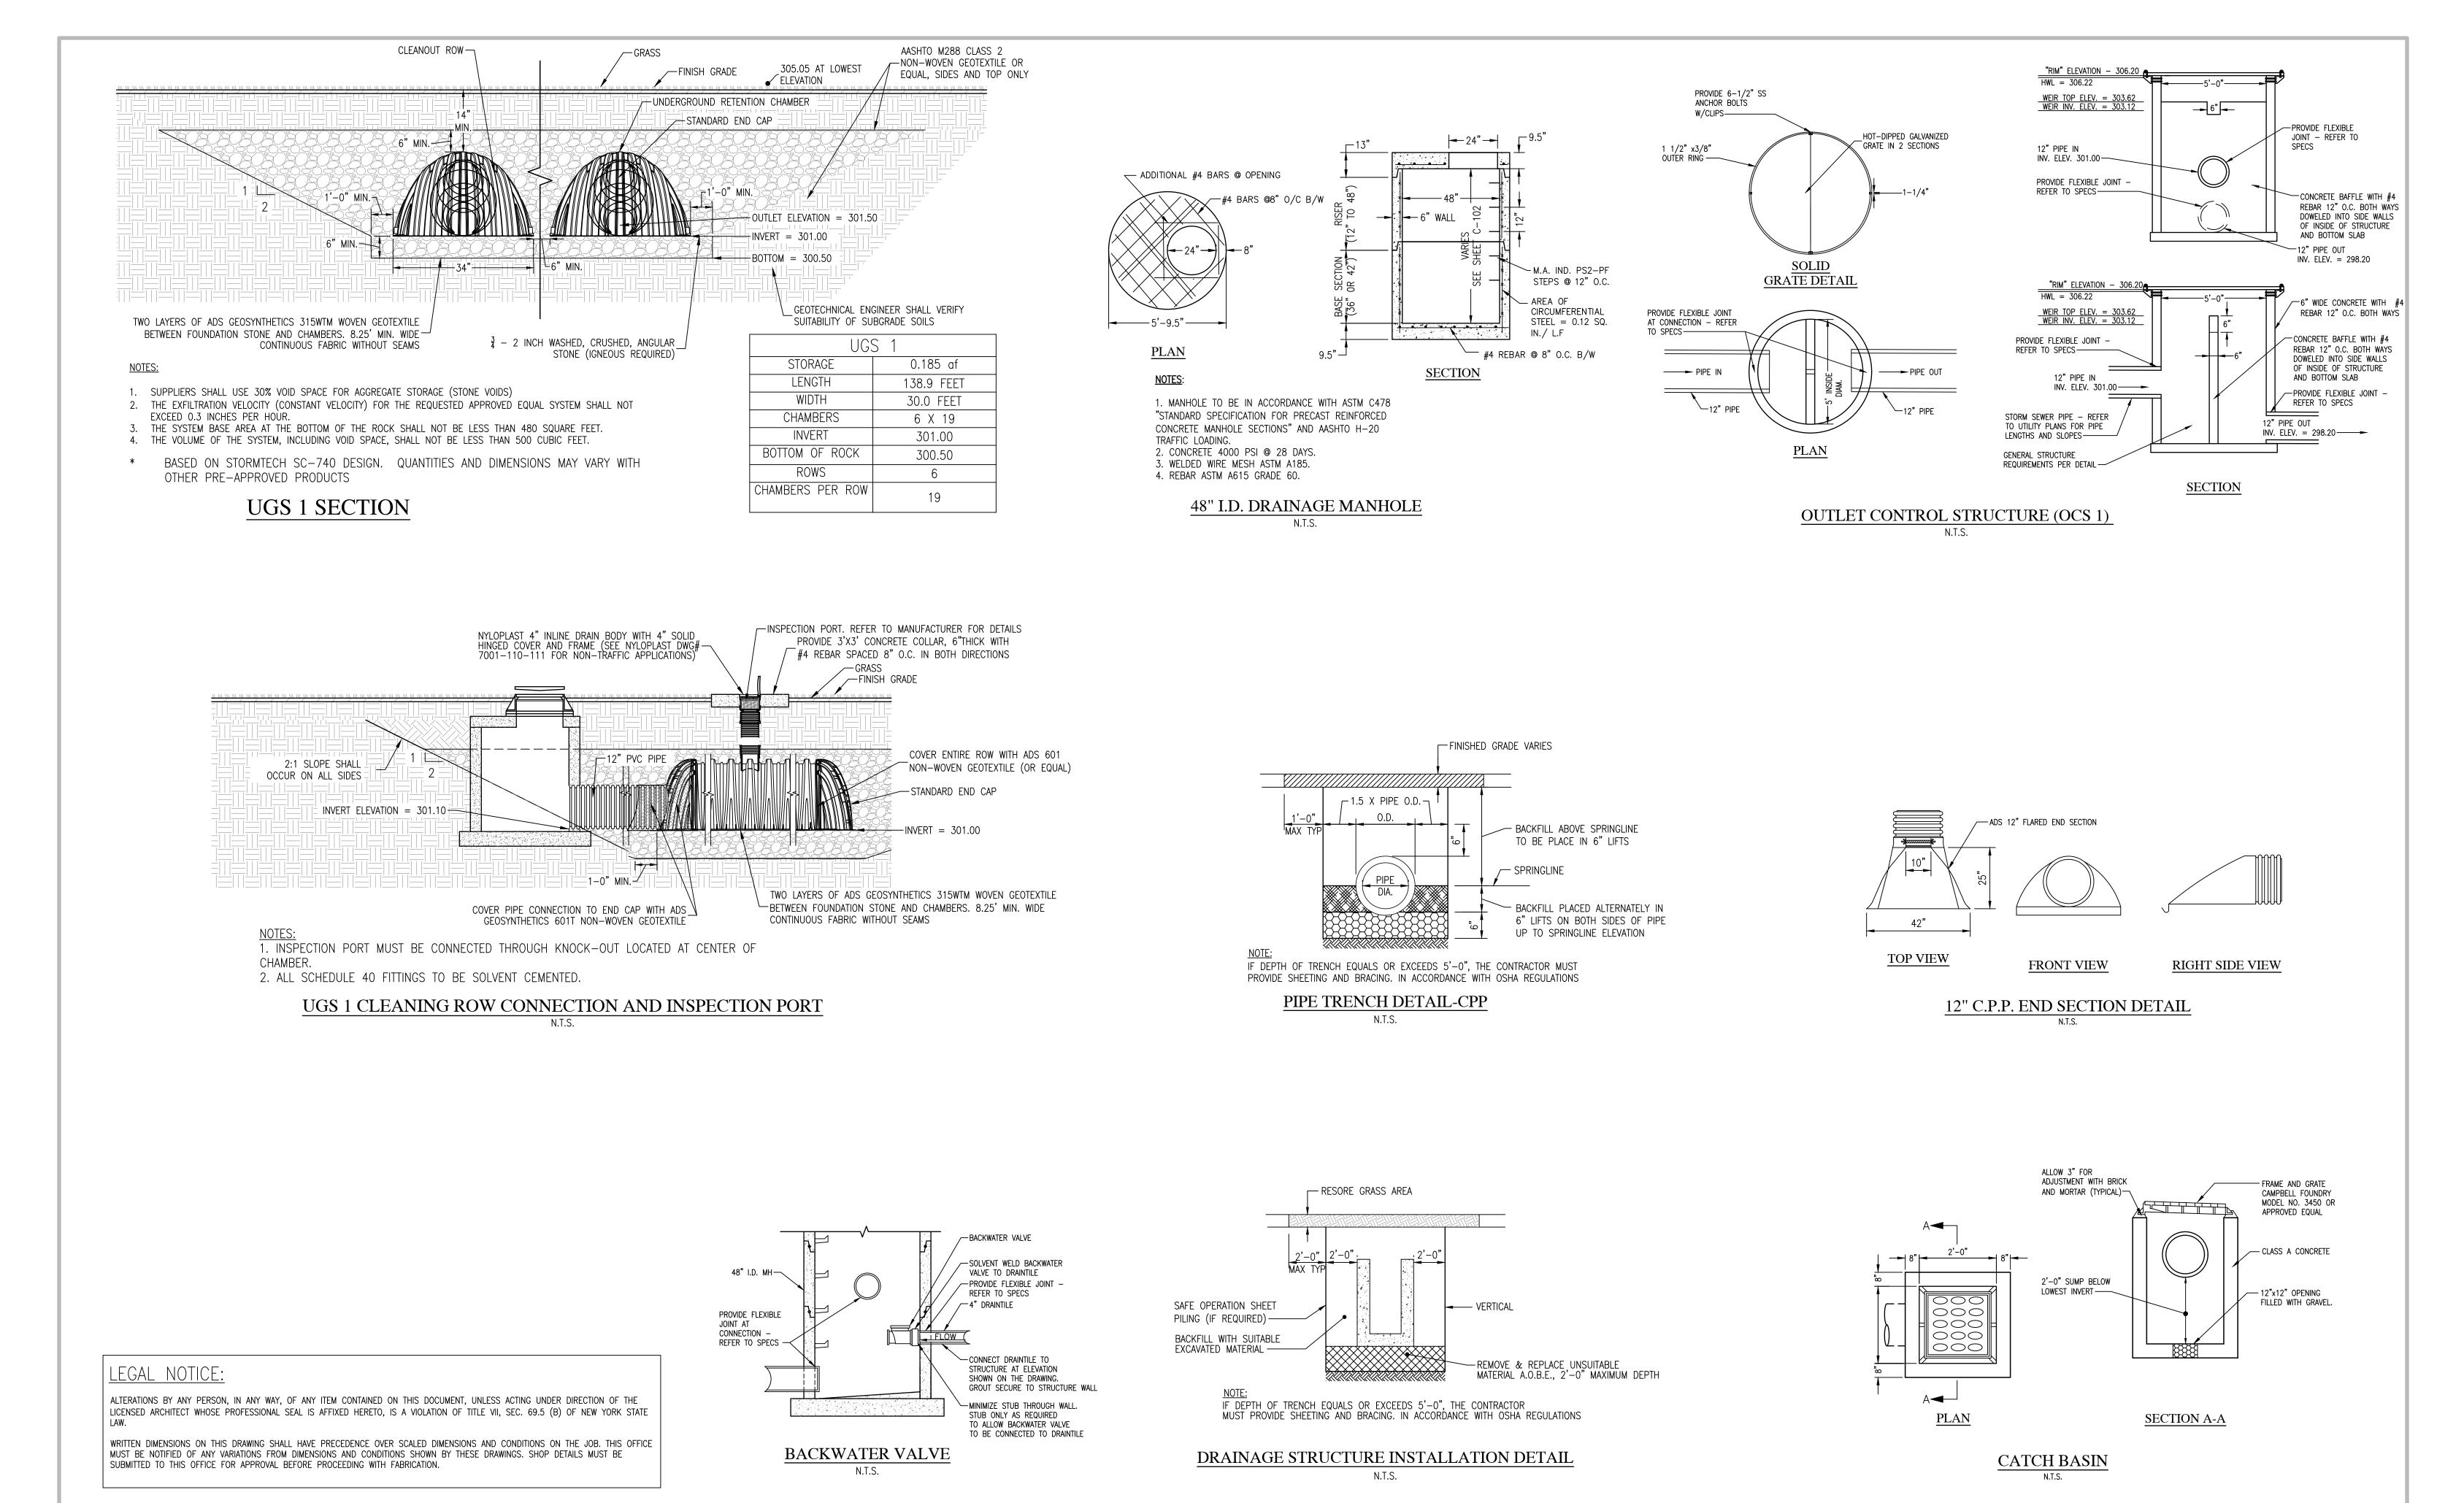
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WESTCHESTER COUNTY, NEW YORK DEPARTMENT OF PUBLIC WORKS DIVISION OF ENGIN NEW EQUIPMENT STORAG

RICHARD A. FLYNN, SR. FIRE

VALHALLA CAMPUS, VALHALL

JBLIC WORKS AND TRANSPORTATION	17-521	C-10)4
SION OF ENGINEERING	SHEET NO. 8	of 5	3
PMENT STORAGE BUILDING NN, SR. FIRE TRAINING CENTER	SCALE: AS S DATE: 11/1		1
MPUS, VALHALLA, NEW YORK	DPW FILE NO.		REV NO
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ARCHITECTURE AND ENGINEERING

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NYACK, NEW YORK 10960

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Tel 845-353-1300

PCM Technologies

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OAKLAND, NJ 07436

Tel: 201-416-4012

Fax: 201-337-1099

FOR NEW LOOP AND A G2615 TO AROFE SIONAL LINE

OLA Consulting Engineers 50 Broadway, Hawthorne, New York 10532 914.747.2800 12 East 49th Street, 11th Flush New York, NY 10017 646.849.4110 olace.com

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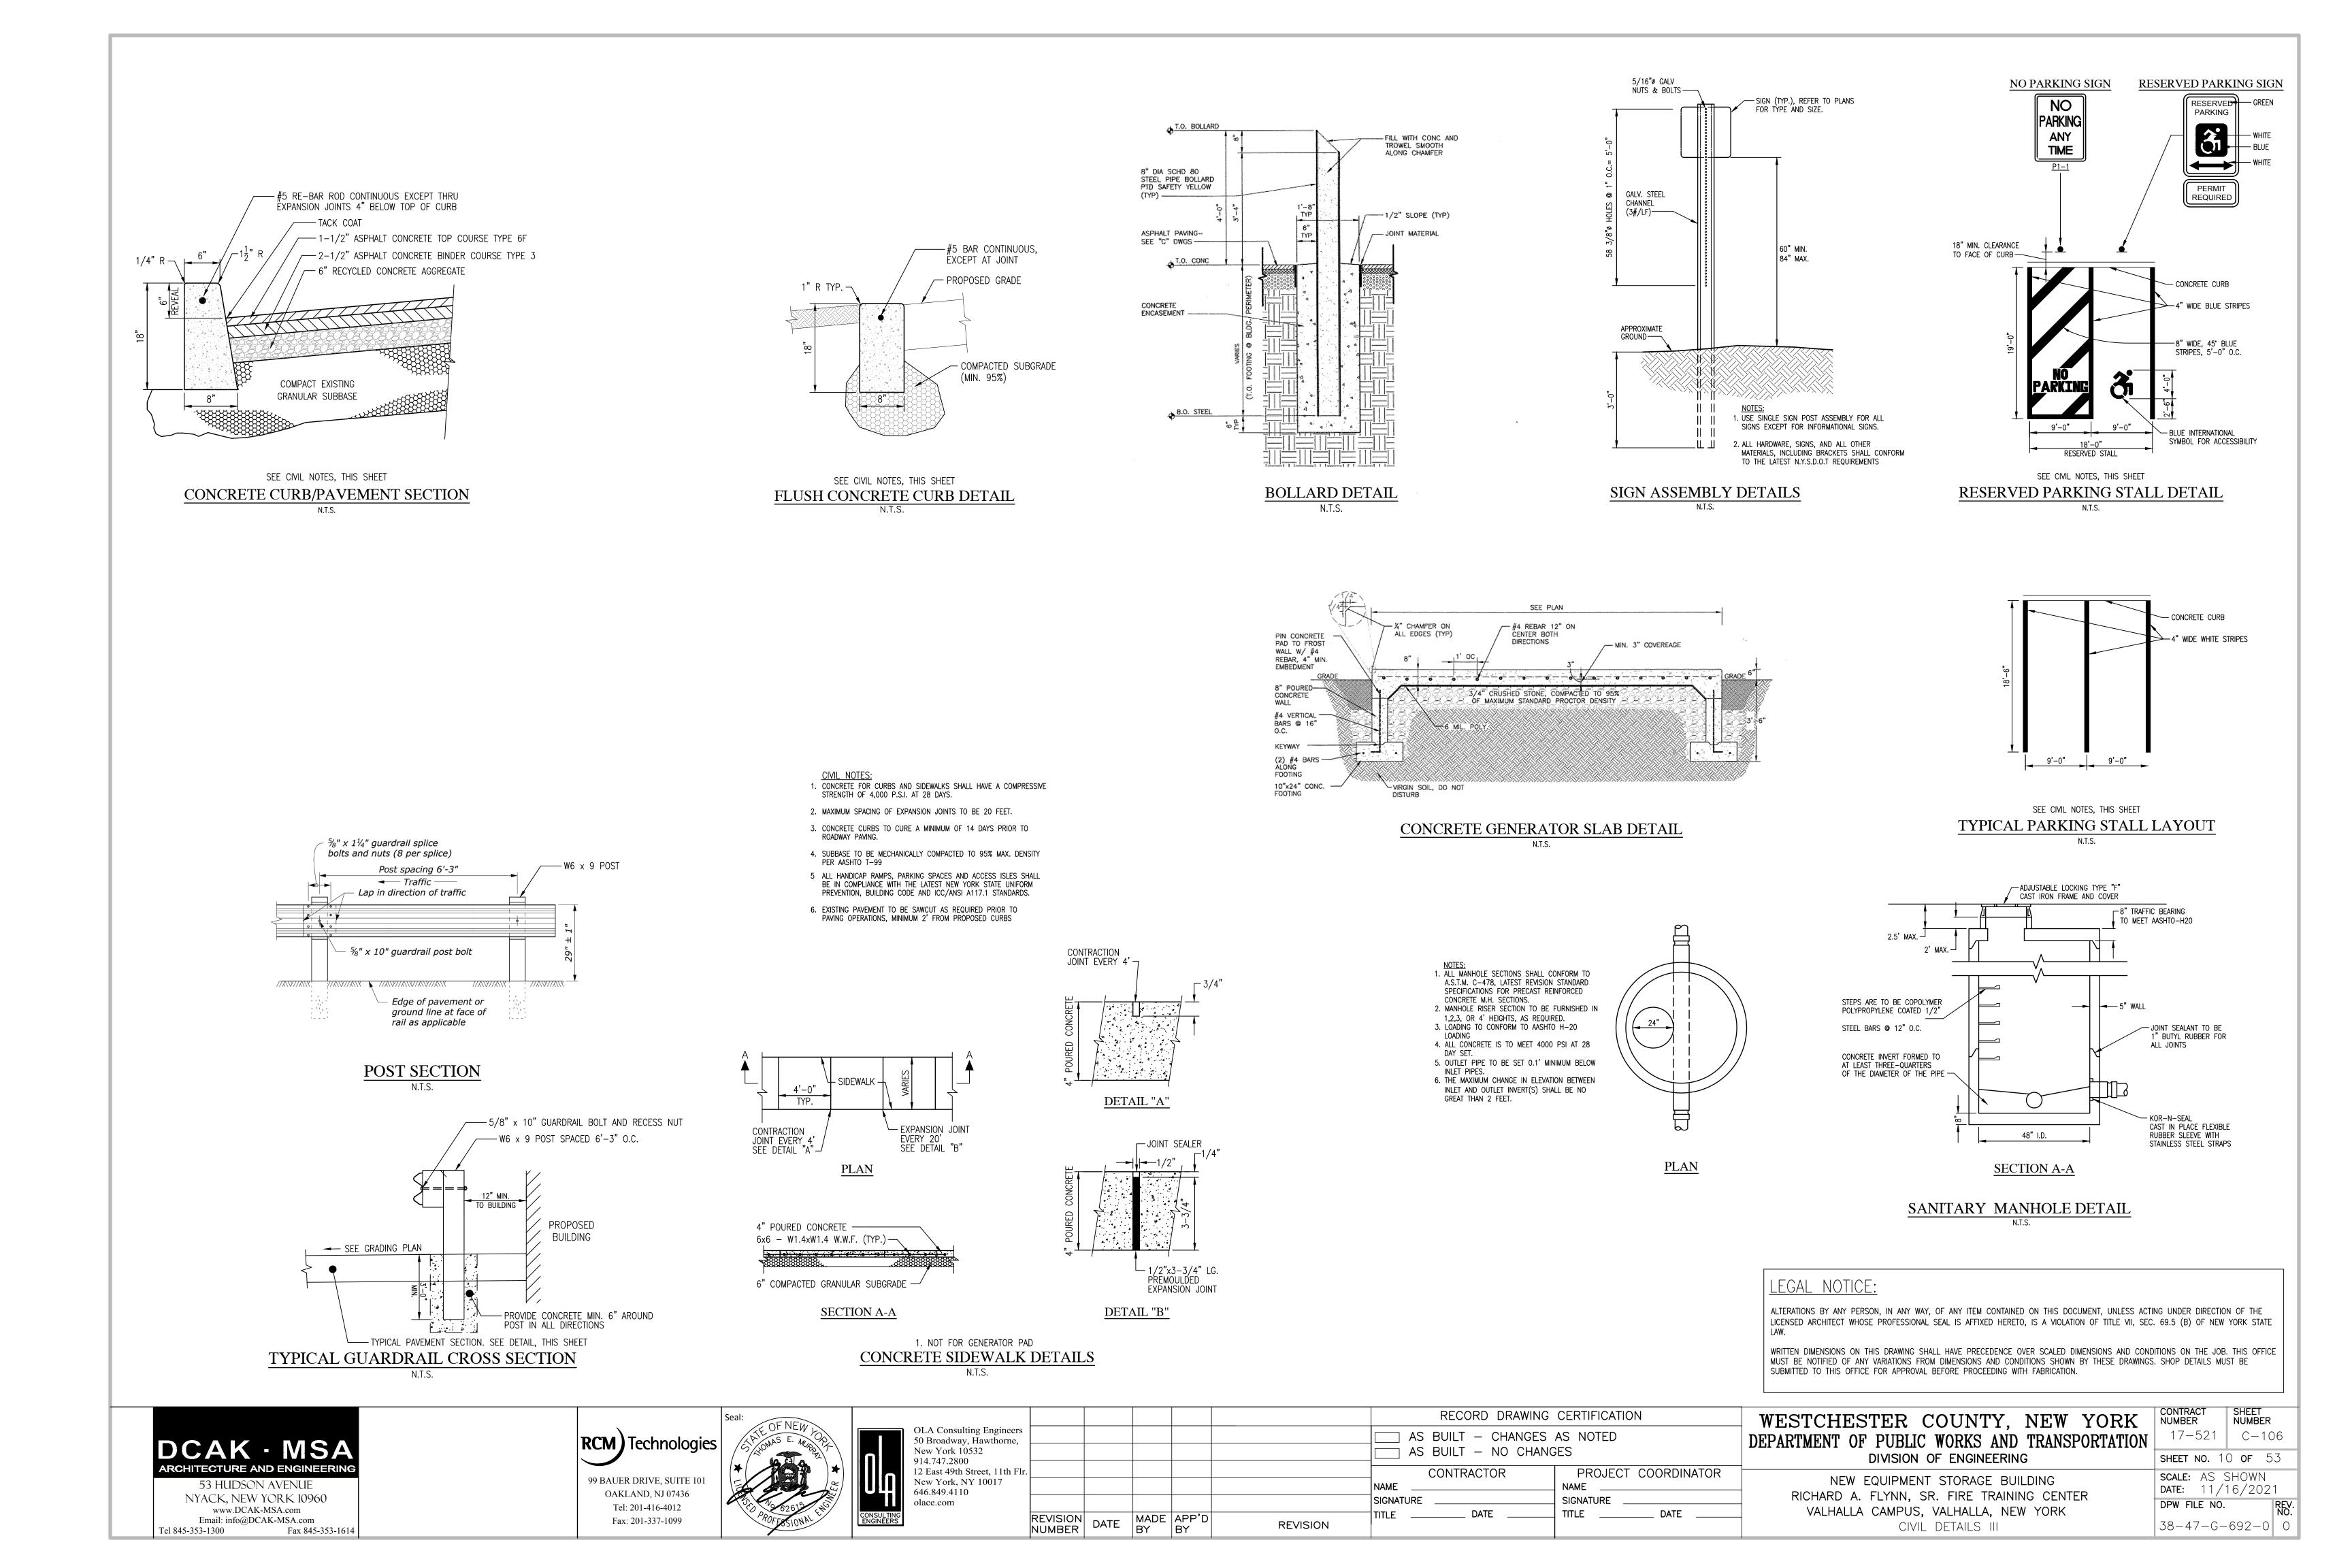
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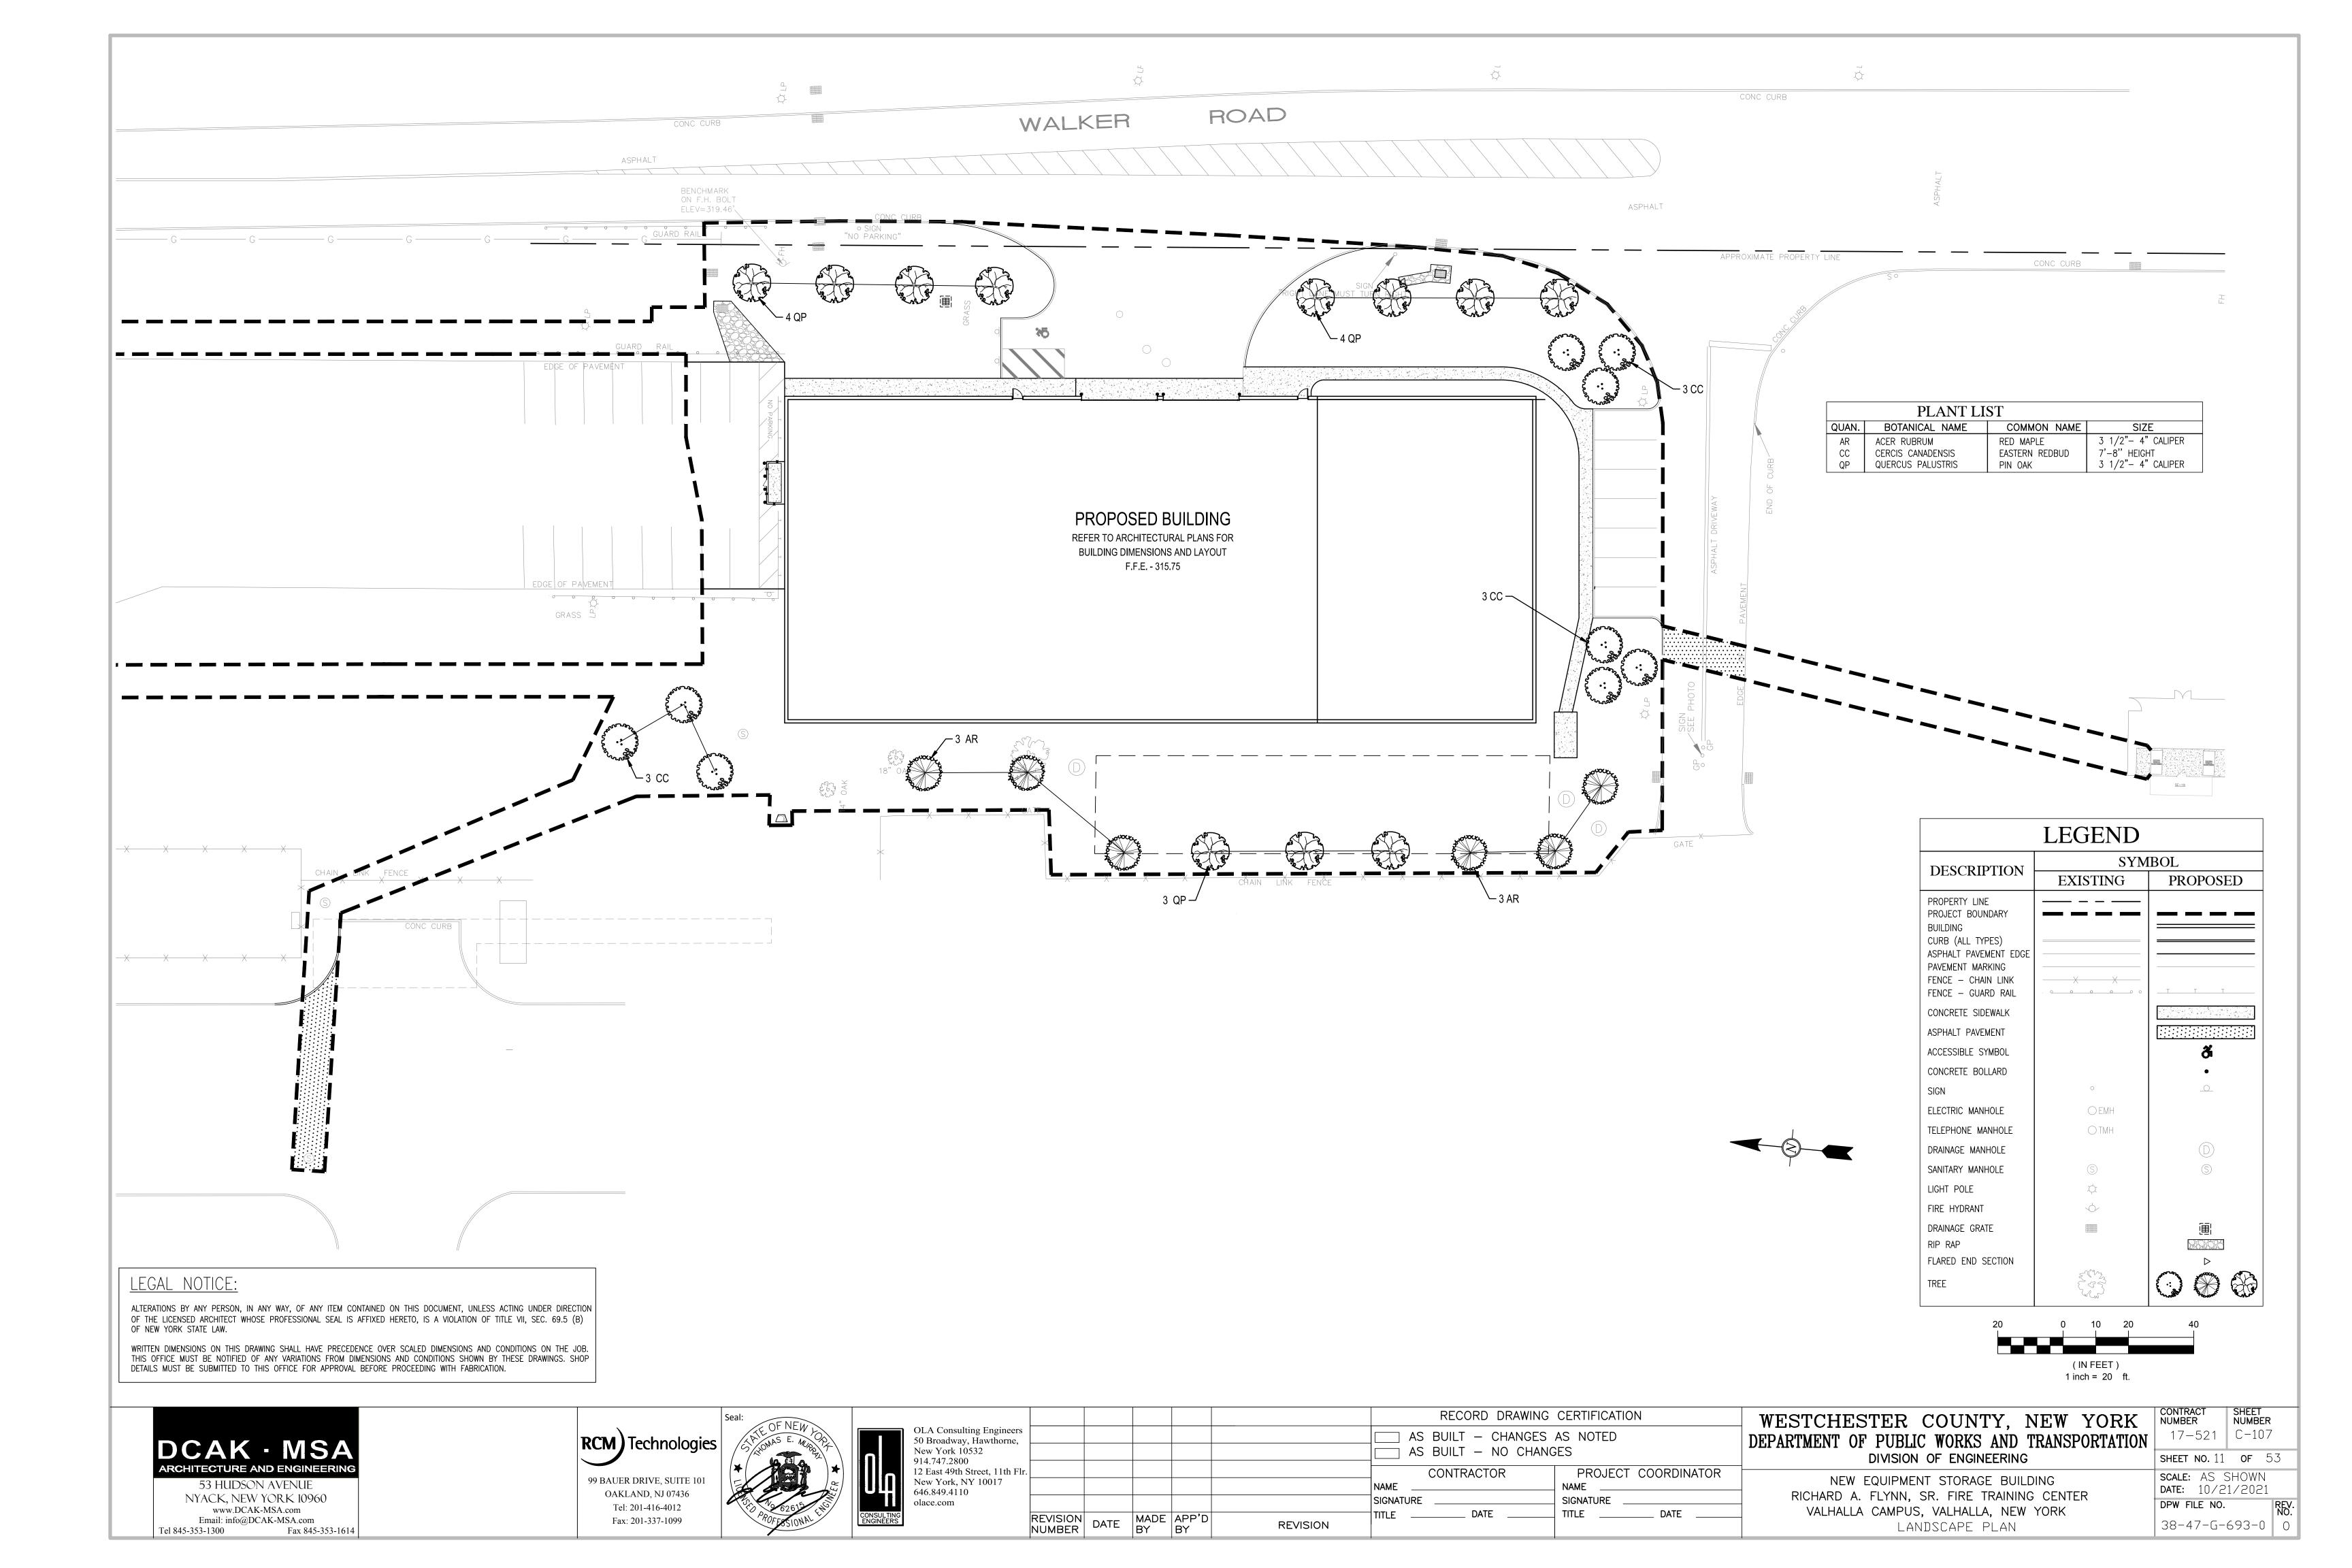
WESTCHESTER COUNTY, NEW YORK DEPARTMENT OF PUBLIC WORKS AND TRANSPORTATION DIVISION OF ENGINEERING


NEW EQUIPMENT STORAGE BUILDING
RICHARD A. FLYNN, SR. FIRE TRAINING CENTER
VALHALLA CAMPUS, VALHALLA, NEW YORK
CIVIL DETAILS II


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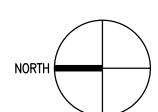






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Fax: 201-337-1099

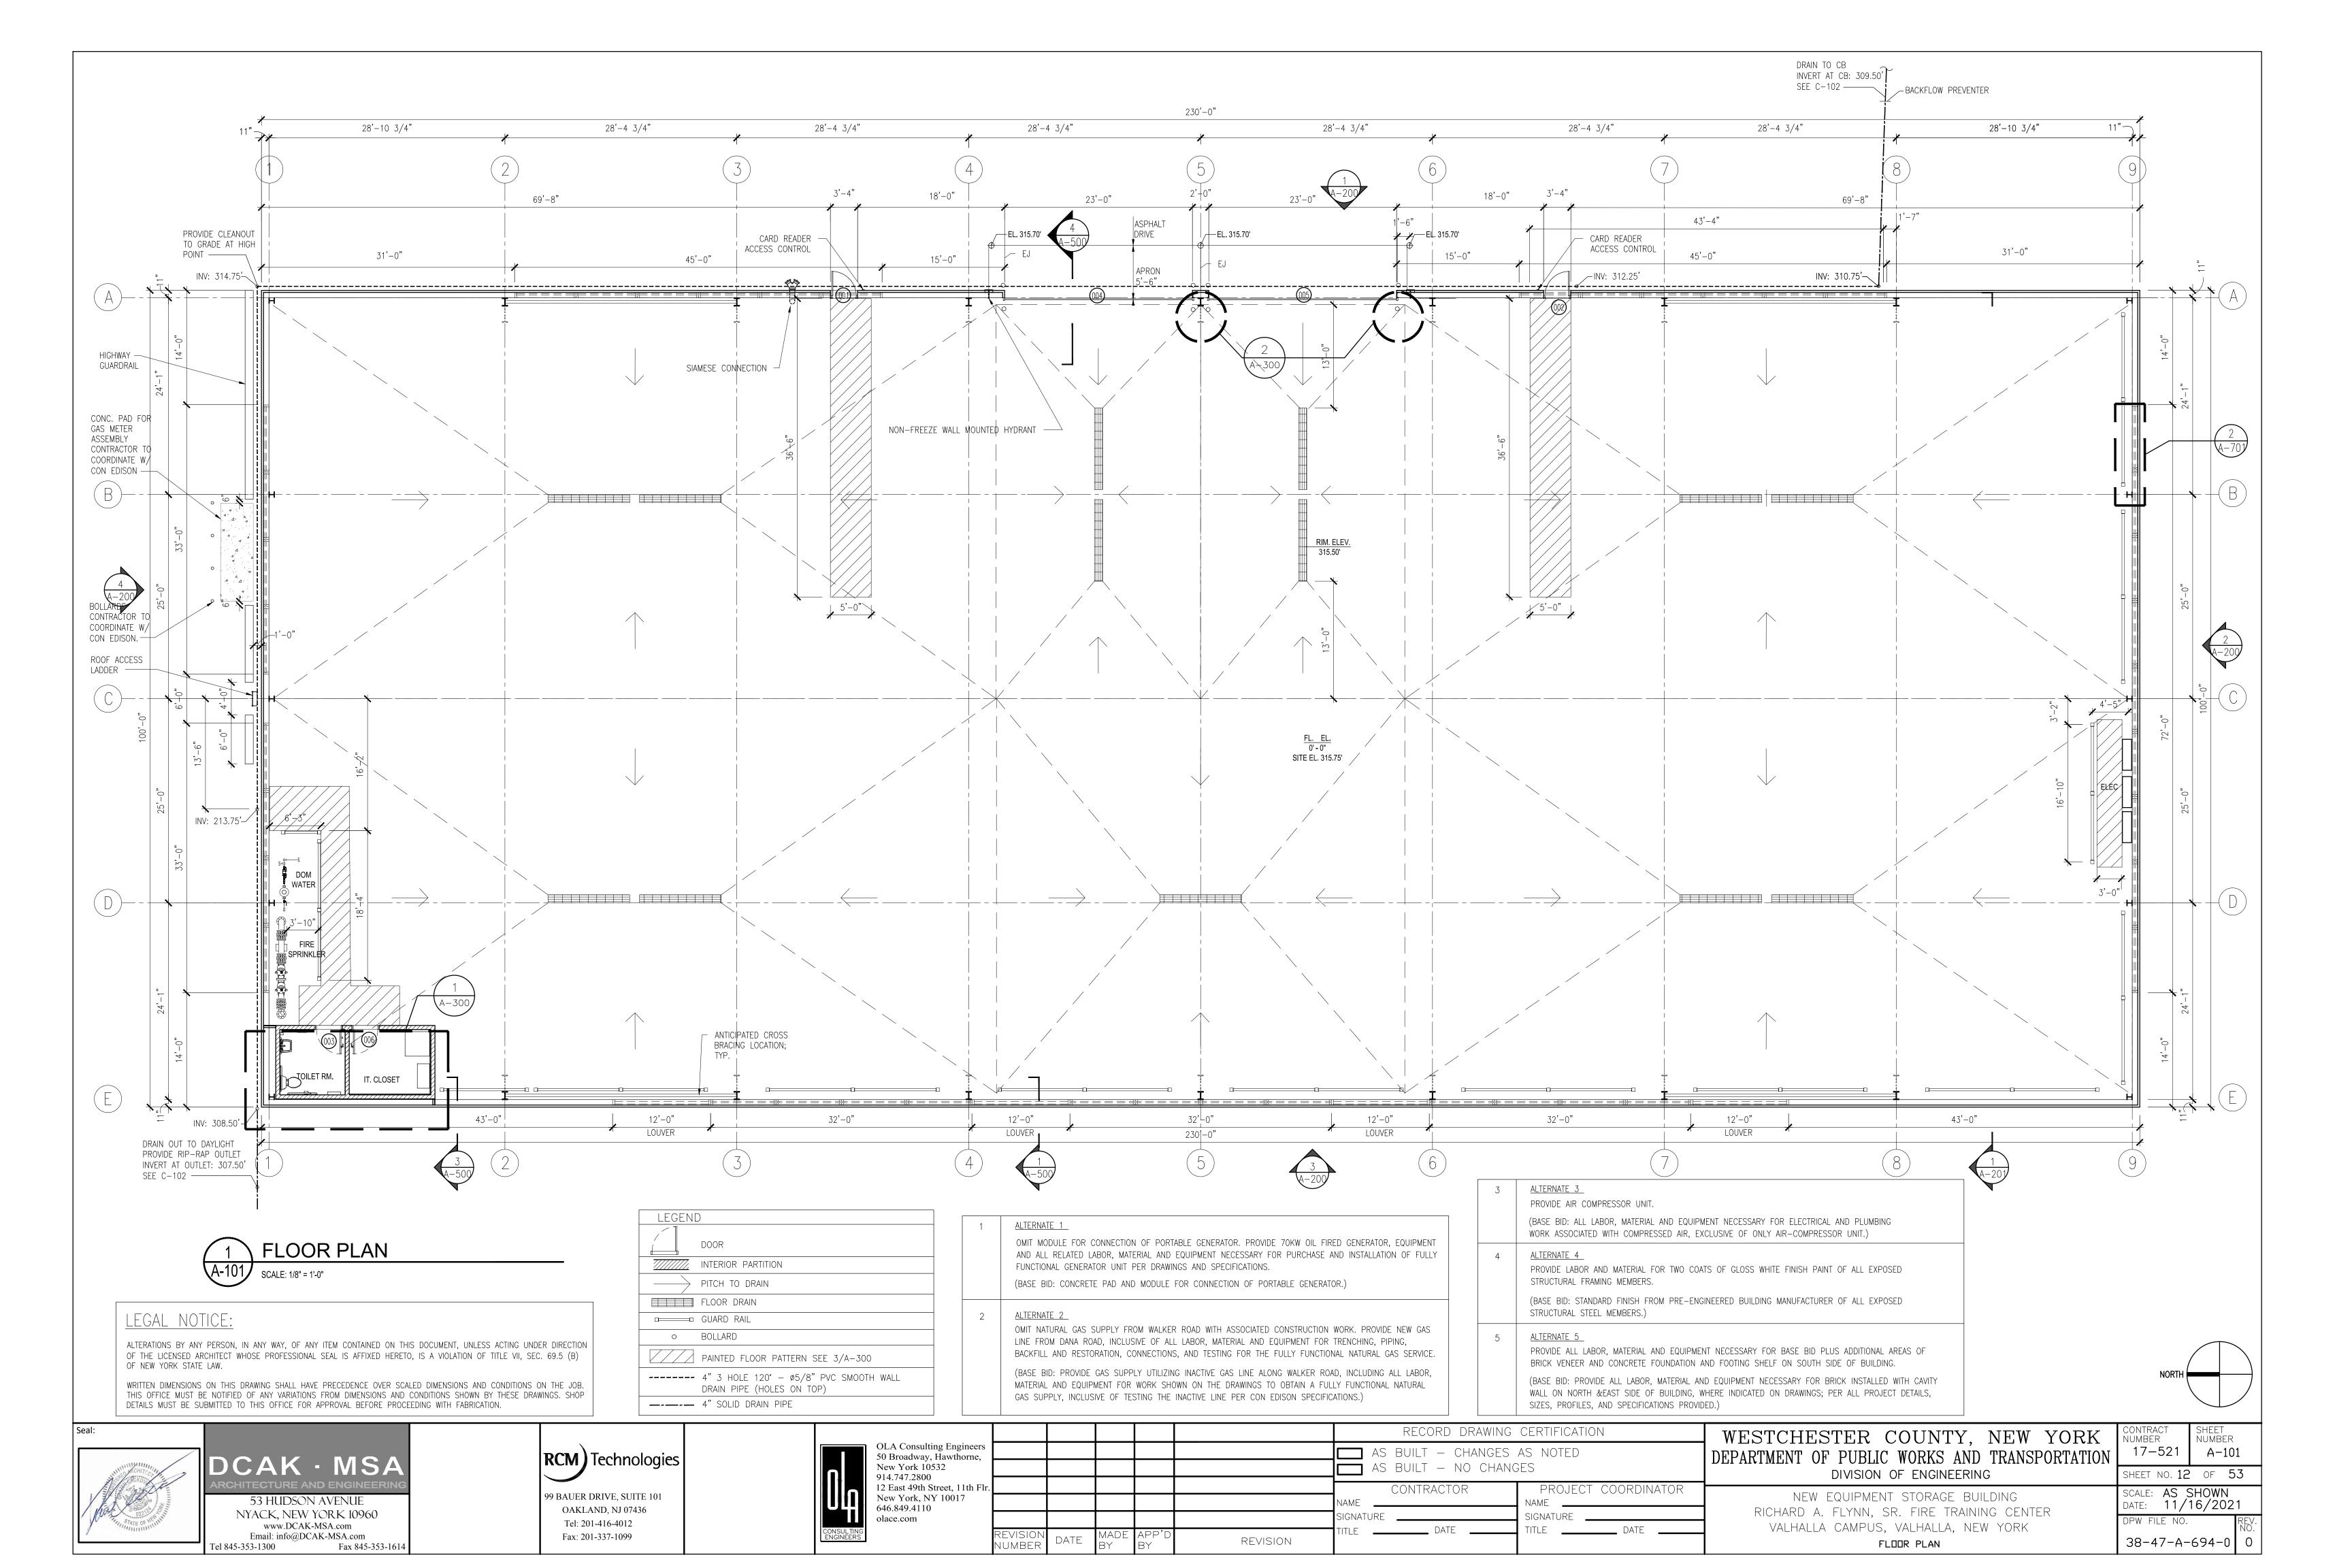

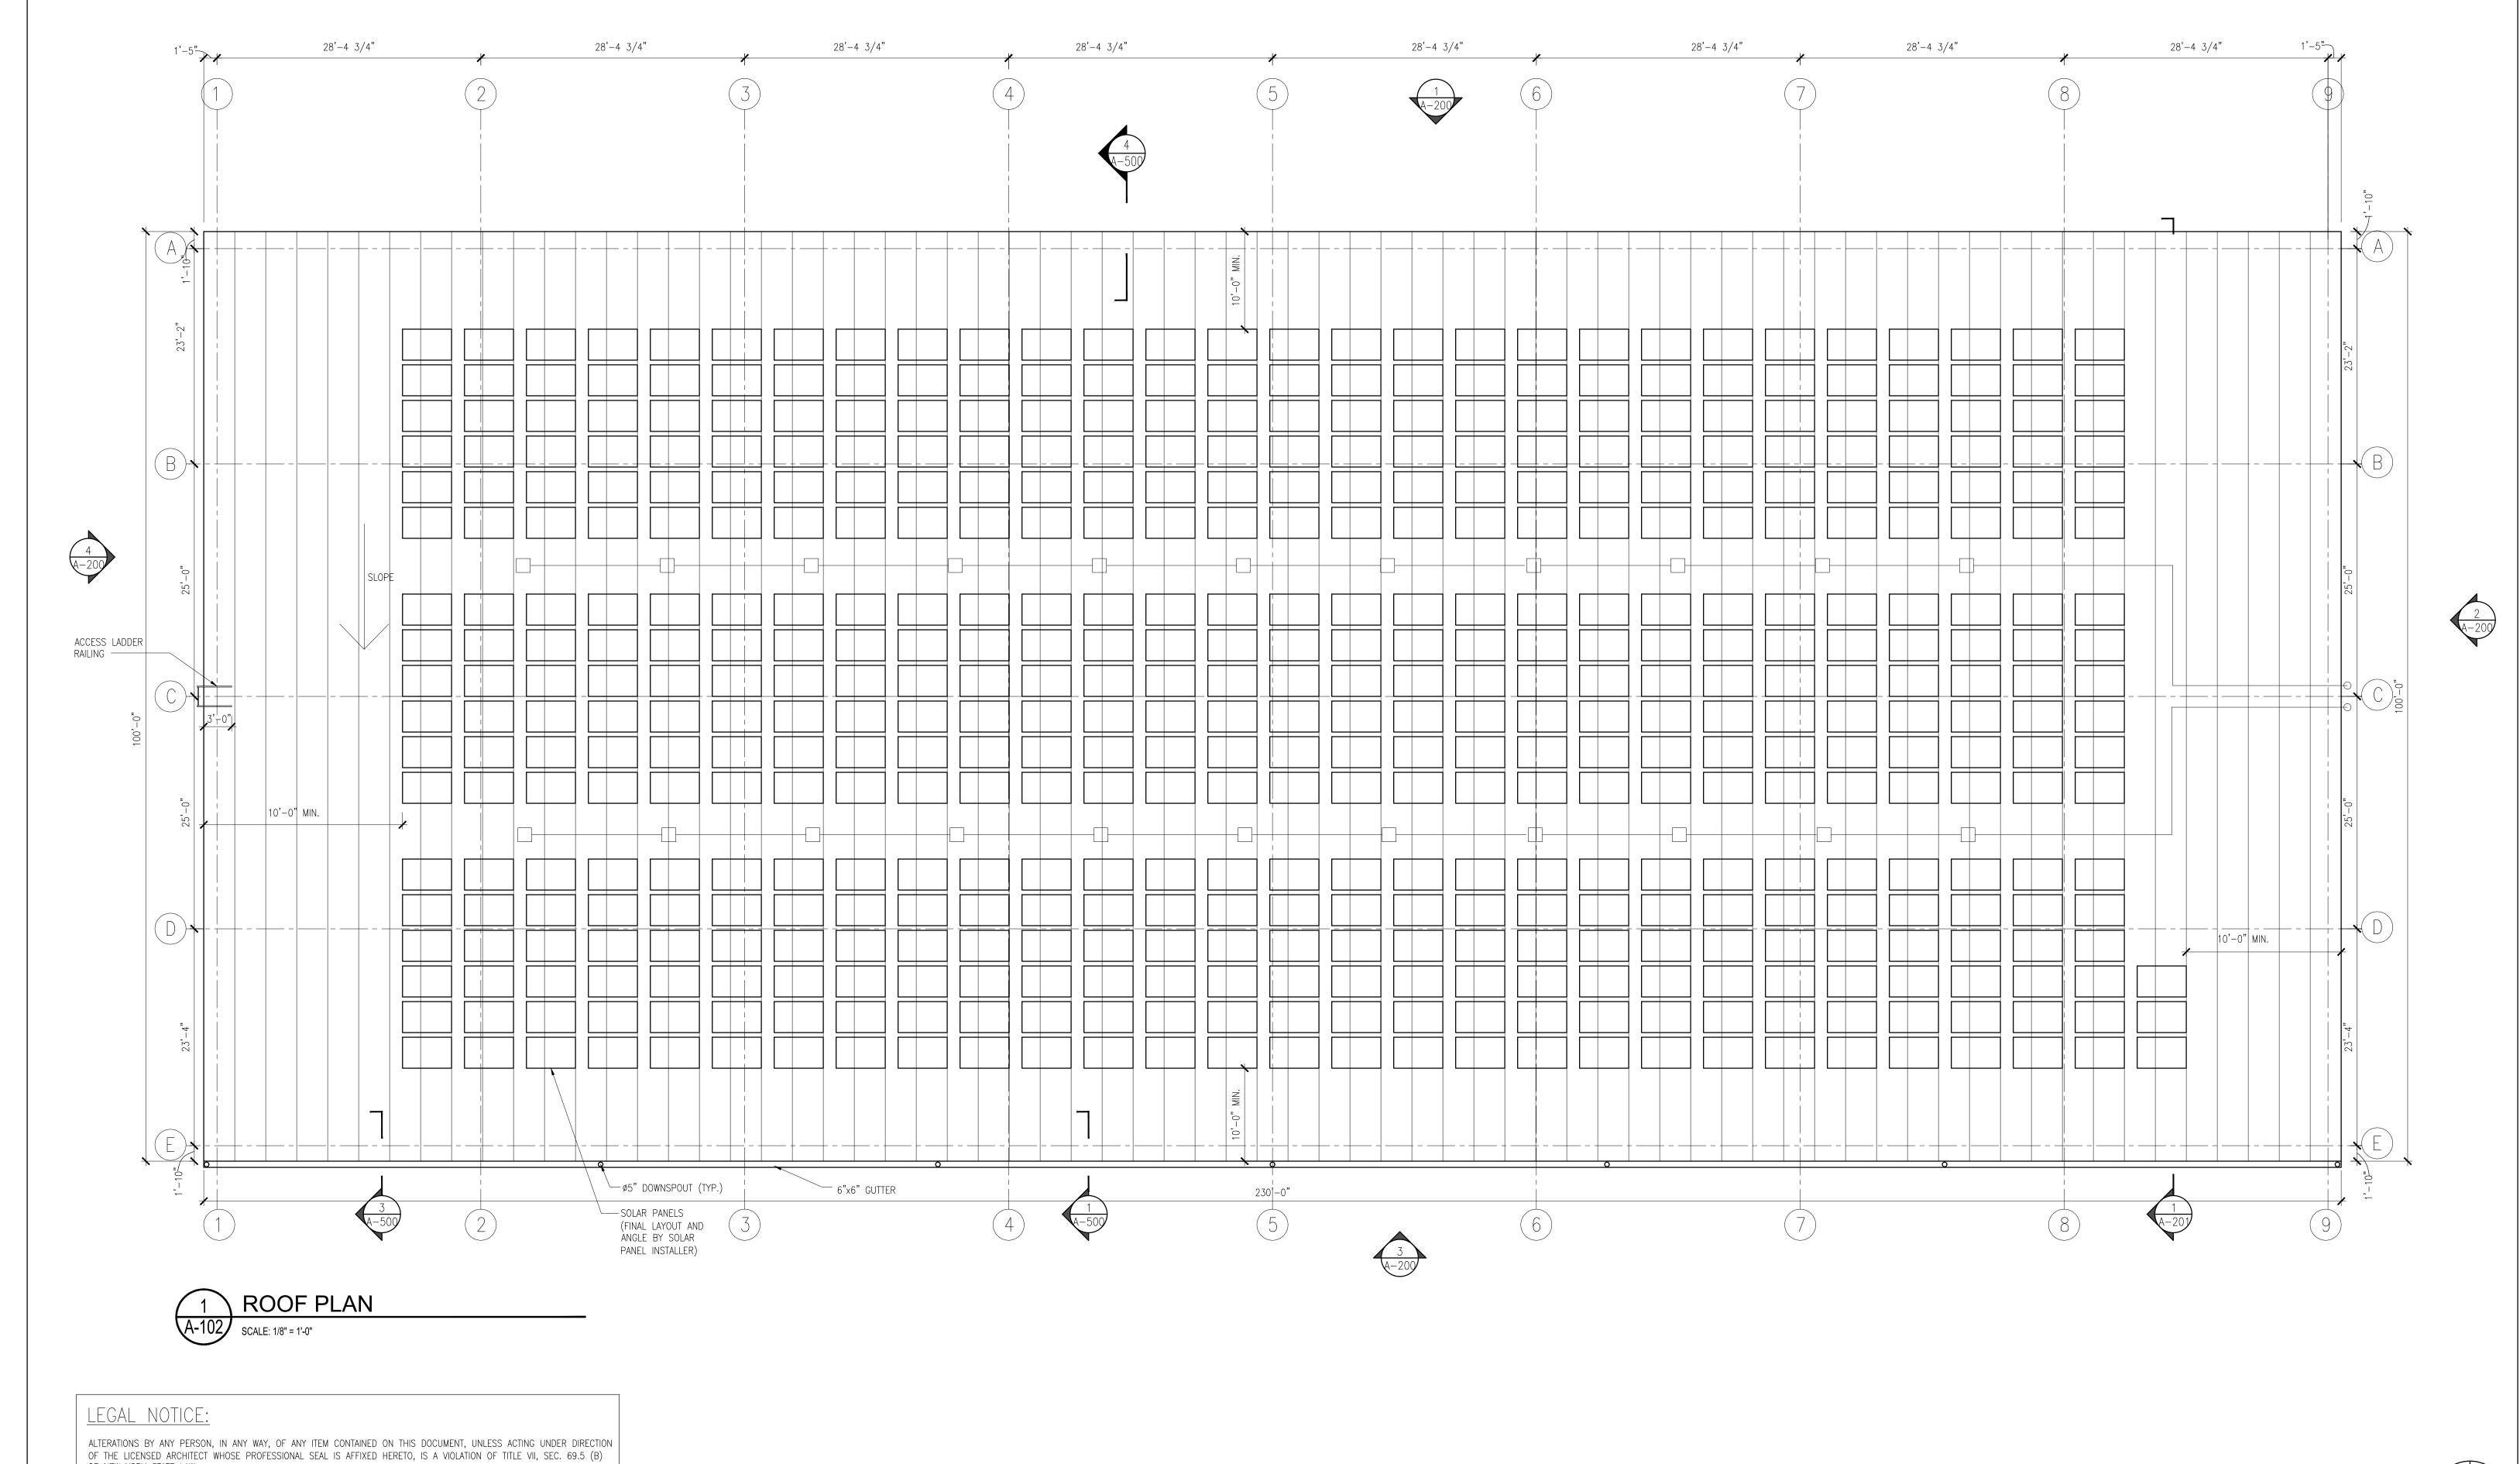
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A Consulting Engineers Broadway, Hawthorne,					
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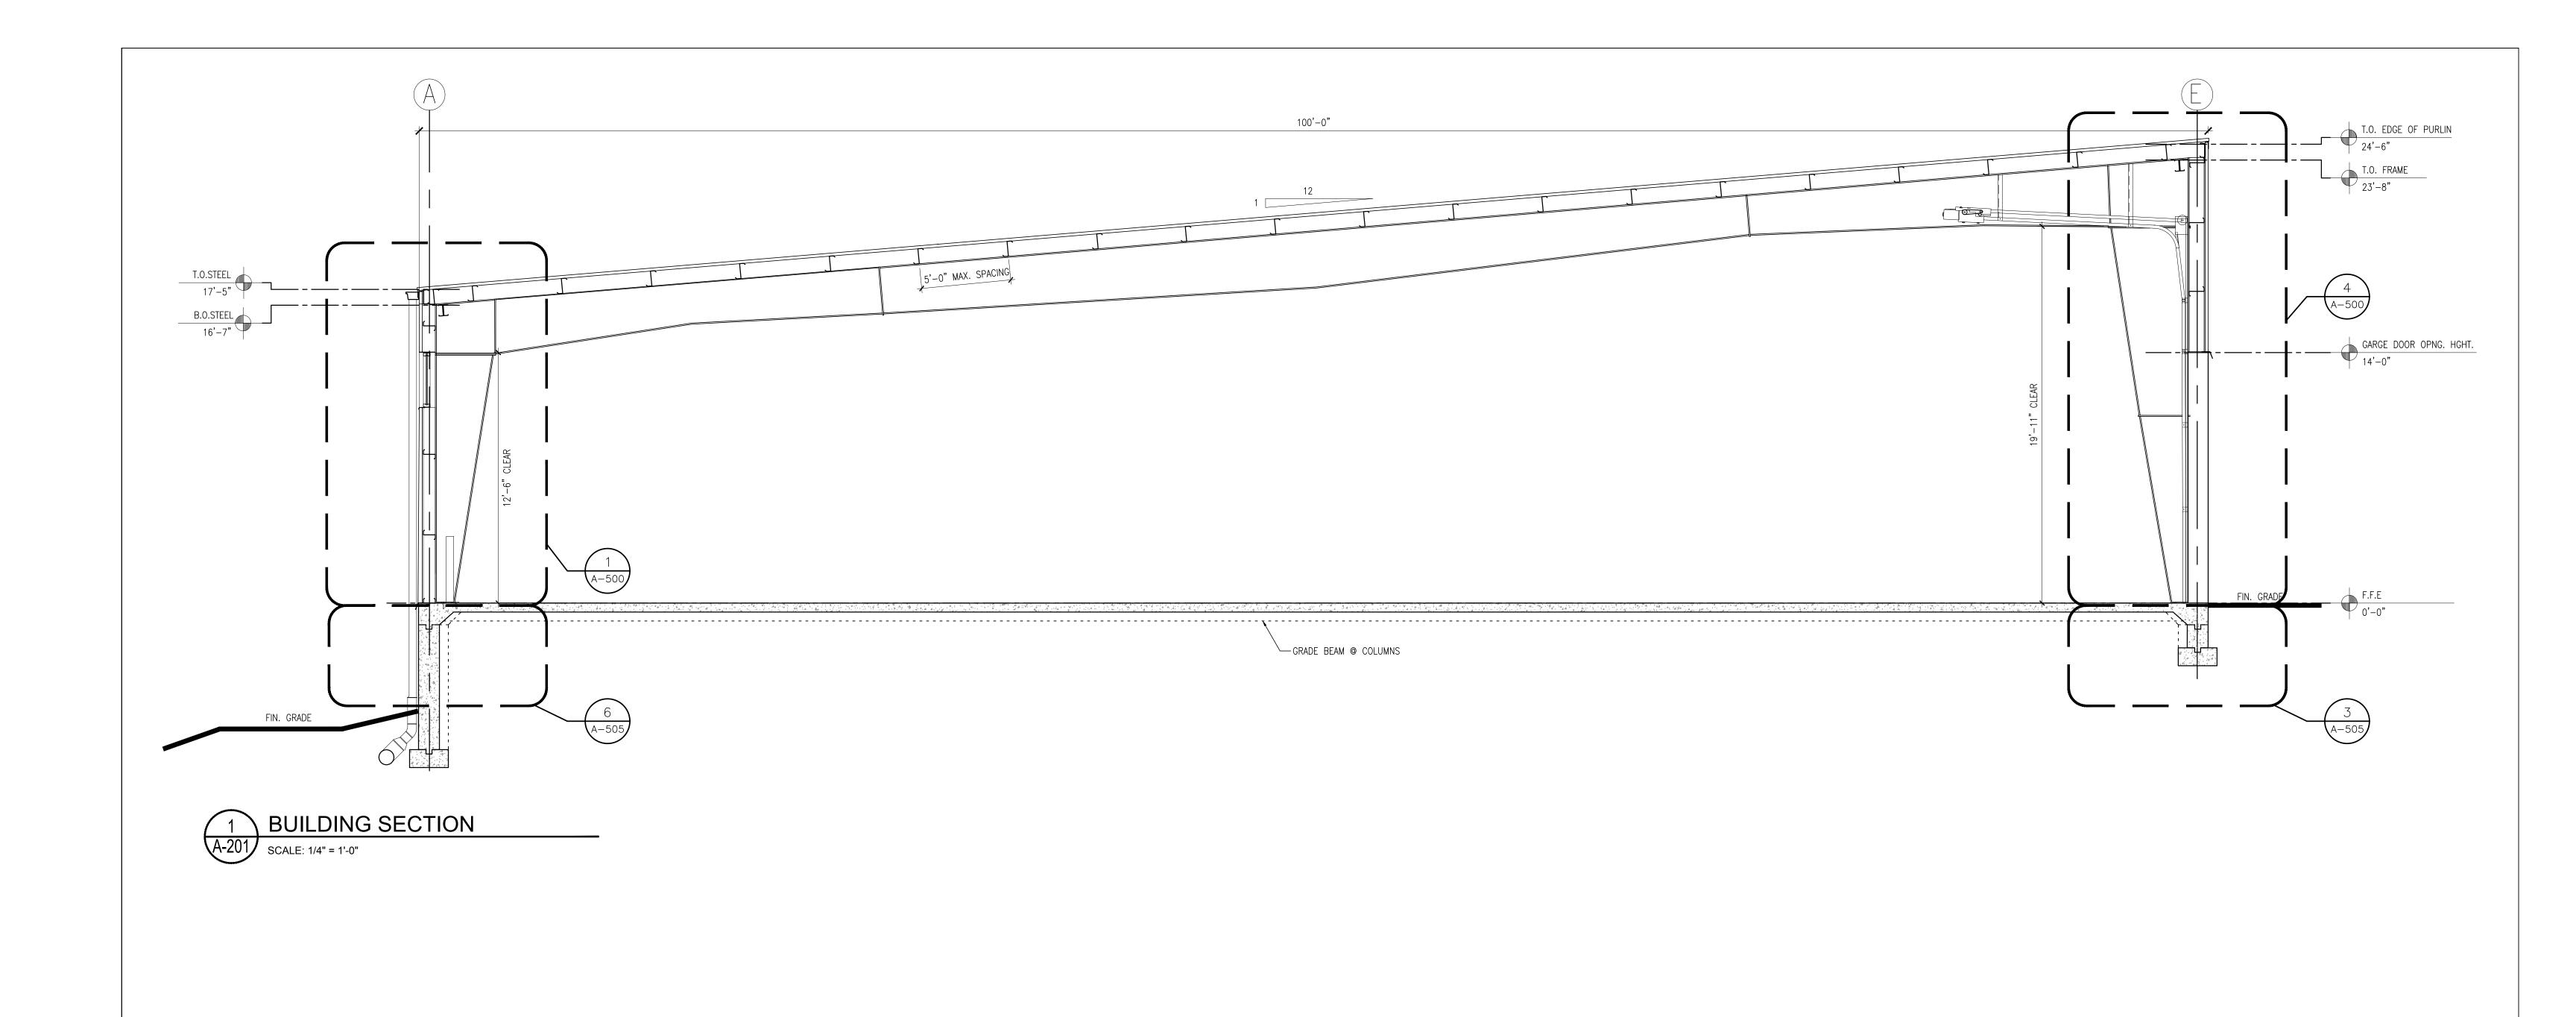
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ROOF PLAN

STCHESTER COUNTY, NEW YORK TMENT OF PUBLIC WORKS AND TRANSPORTATION	CONTRACT NUMBER 17-521	SHEET NUMBER A-107	
DIVISION OF ENGINEERING	SHEET NO. 13	of 5	3
NEW EQUIPMENT STORAGE BUILDING RICHARD A. FLYNN, SR. FIRE TRAINING CENTER	SCALE: AS S DATE: 11/1	HOWN 16/202	1
VALHALLA CAMPUS, VALHALLA, NEW YORK	DPW FILE NO.		REV. NO.





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	New York 10532	
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	New York, NY 10017	Г
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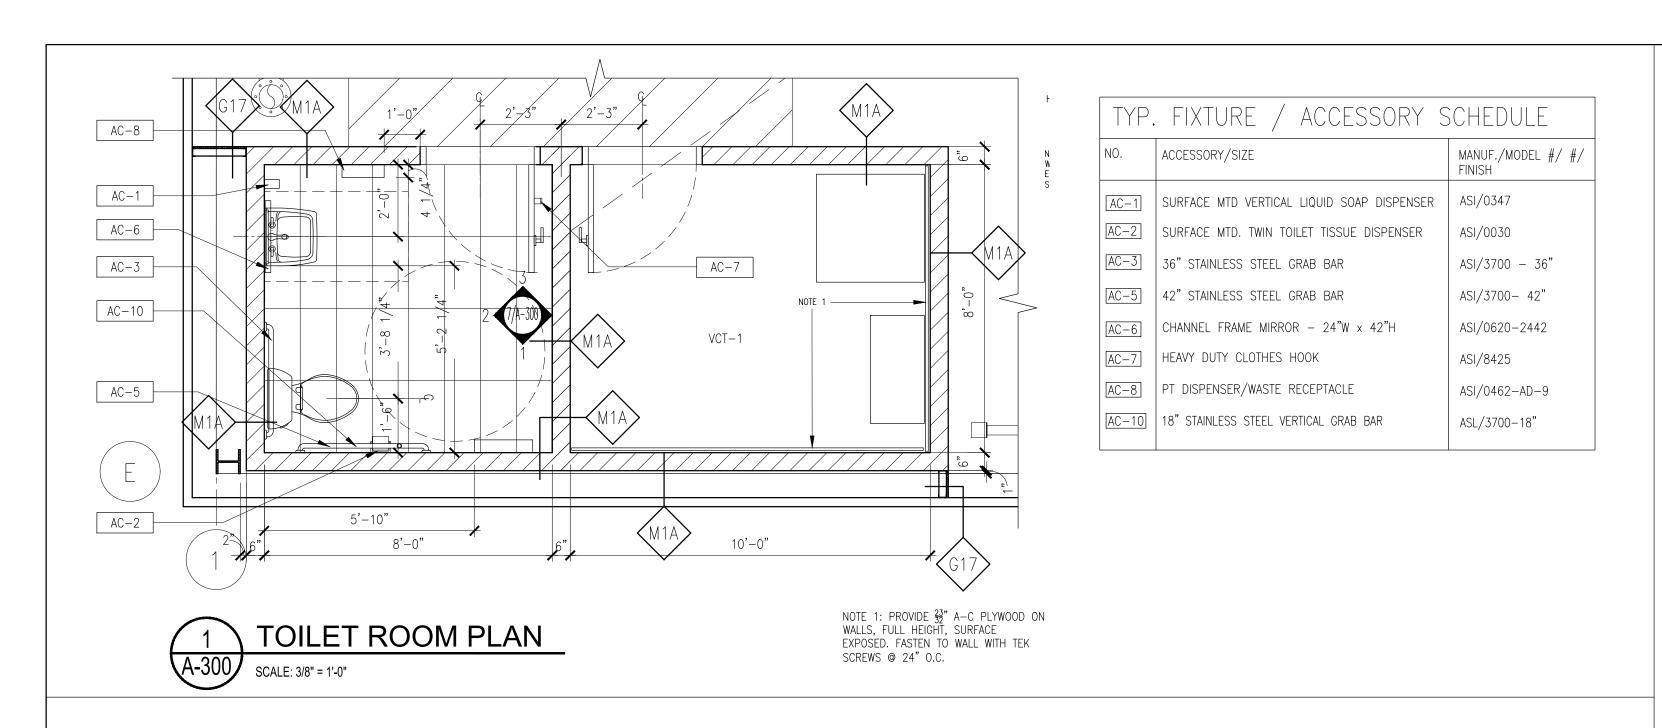
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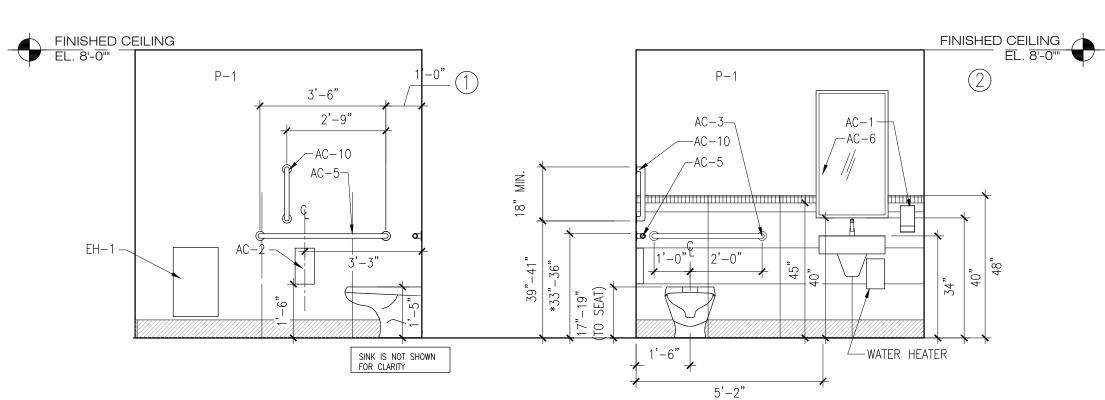
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DIVISION OF ENGINEERING	SHEET NO.

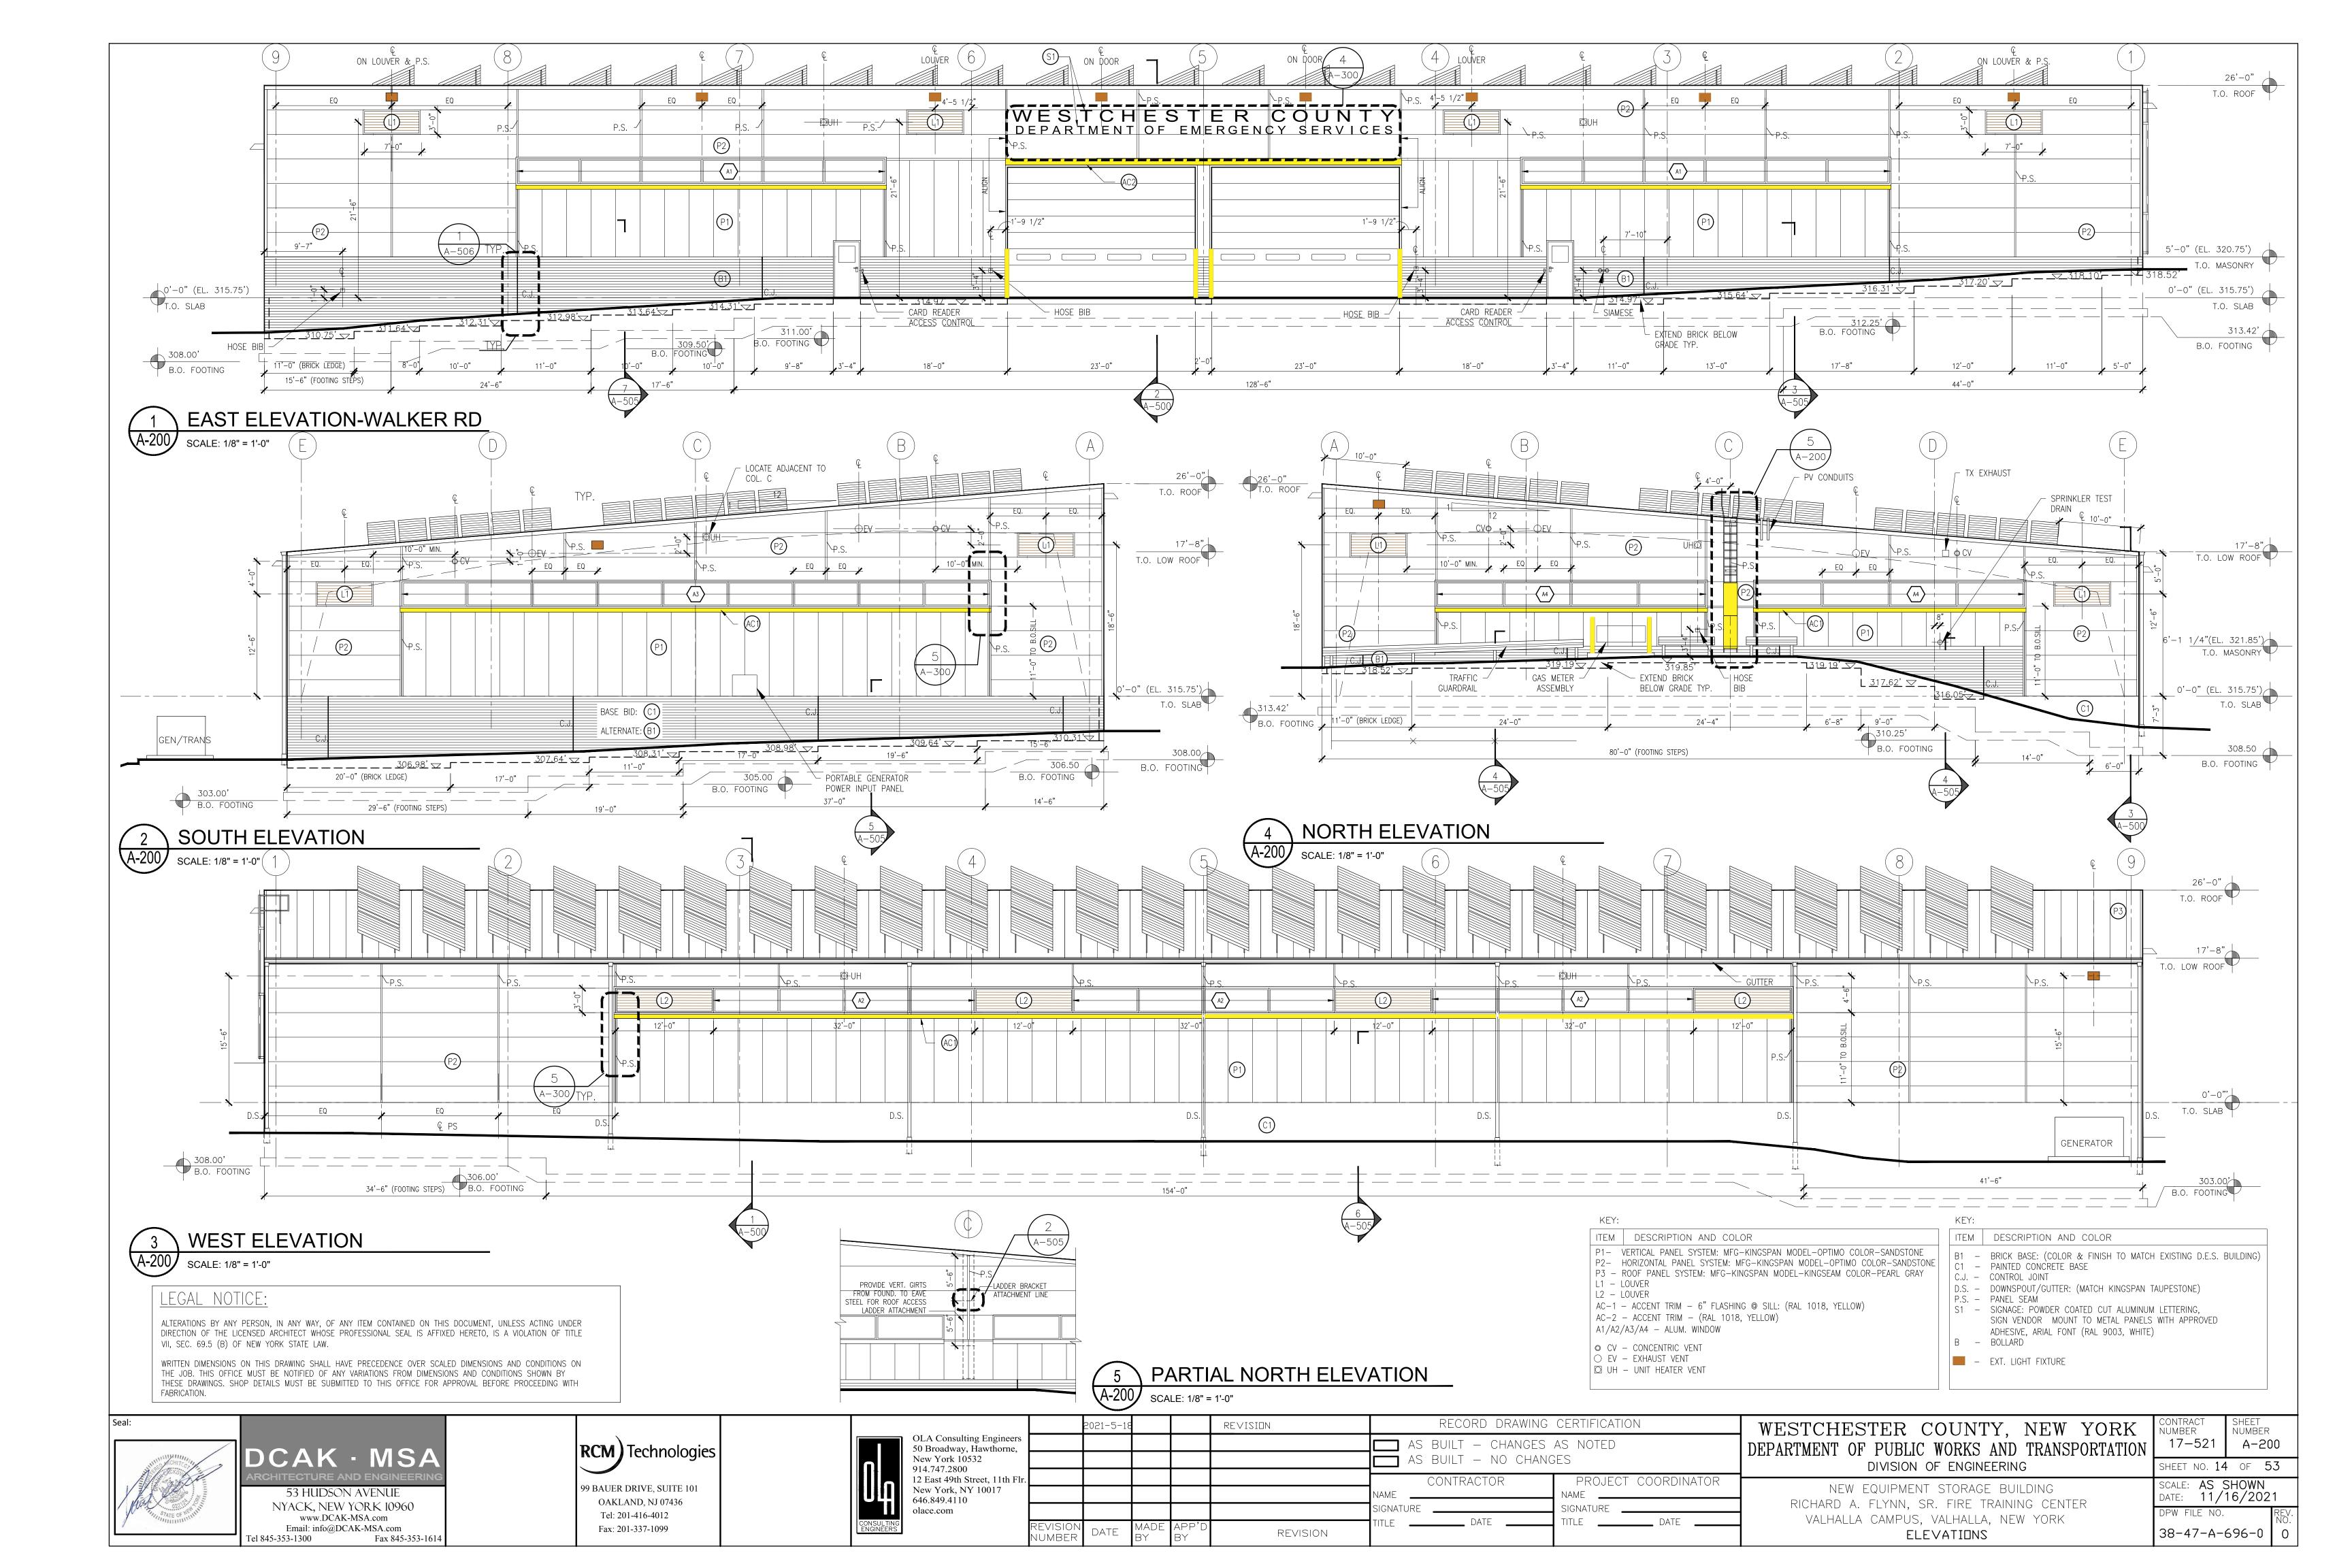
NEW EQUIPMENT STORAGE BUILDING RICHARD A. FLYNN, SR. FIRE TRAINING CENTER VALHALLA CAMPUS, VALHALLA, NEW YORK BUILDING SECTION

rion	17-521	A-201	
	SHEET NO. 15	5 OF 53	
	SCALE: AS S	SHOWN 16/2021	
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	38-47-A-	697-0 0	

SHEET NUMBER





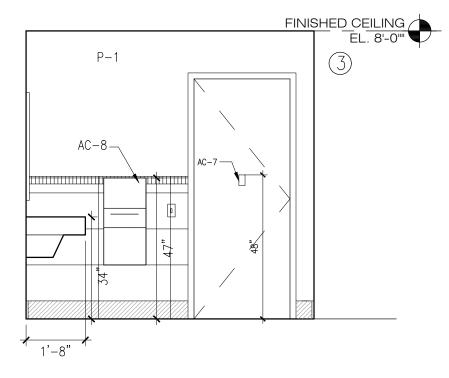



GENERAL NOTES:


- A. NOT USED
- B. NOT USED
- C. ALL BATHROOM ACCESSORIES TO BE STAINLESS STEEL WITH SATIN FINISH.
- D. PROVIDE PAINTED WOOD SPACER BEHIND MIRRORS AND OTHER ACCESSORIES ABOVE CERAMIC TILE TO FILL GAP BETWEEN MIRROR FRAME AND GWB. COLOR TO MATCH WALL.
- E. PROVIDE LAVATORY PIPE/VALVE AND TRAP INSULATION PER ADA CODE.
- F. PROVIDE ADA COMPLIANT DOOR AND HARDWARE
- G. PROVIDE ADA COMPLIANT TACTILE SIGN CONSISTING OF PICTOGRAM, ROOM NAME AND BRAILLE MOUNTED BETWEEN 48"& 60" HIGH.
- H. TILE PATTERN SHALL BE CENTERED IN THE SPACE U.O.N.


CERAMIC TILE LEGEND				
	FLOOR TILE	WALL TILE		
	CT-I	СТ-3		
	-	CT-4 BULL NOSE		
	-	CT-2 BASE		


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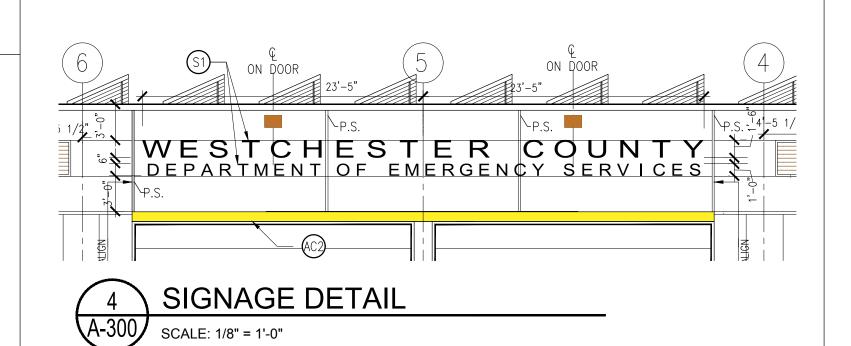
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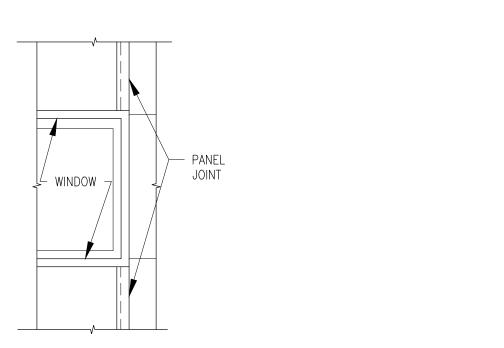







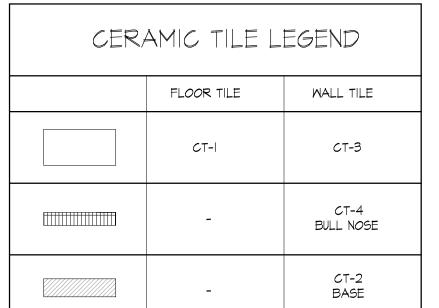

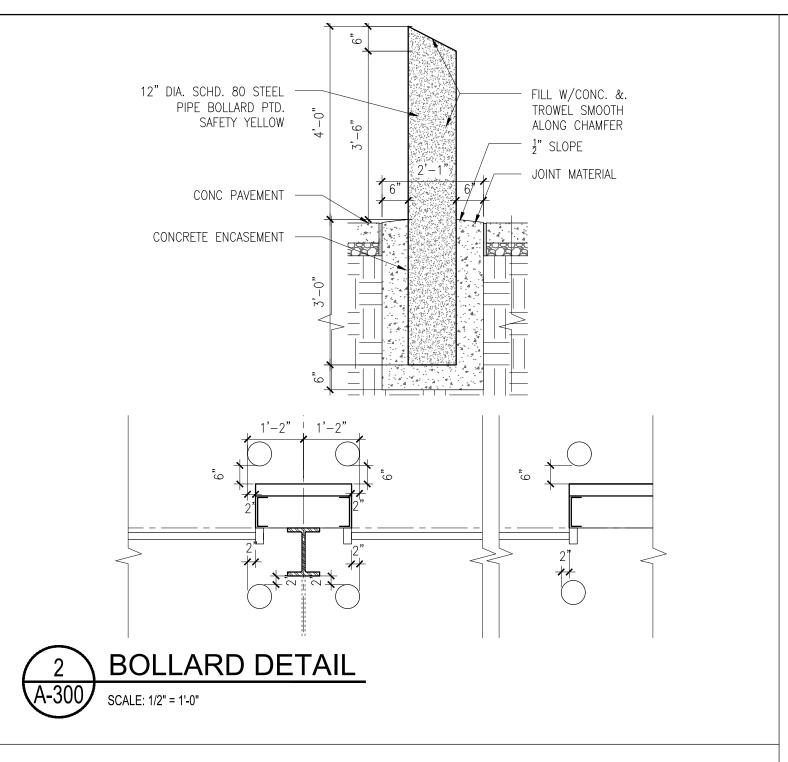


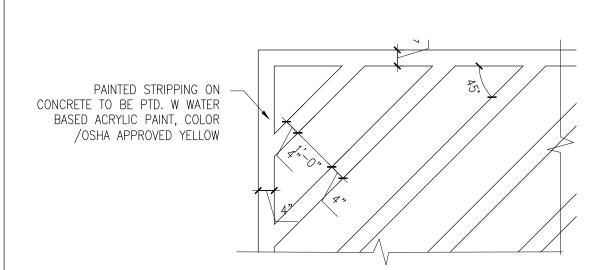



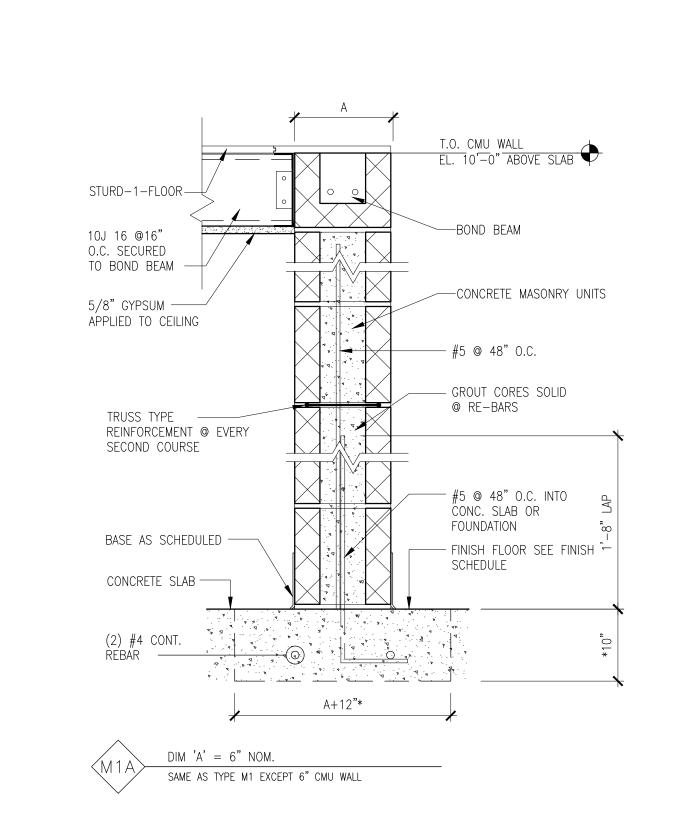



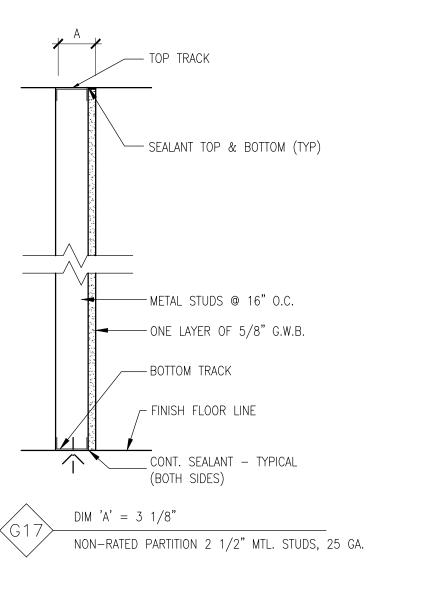





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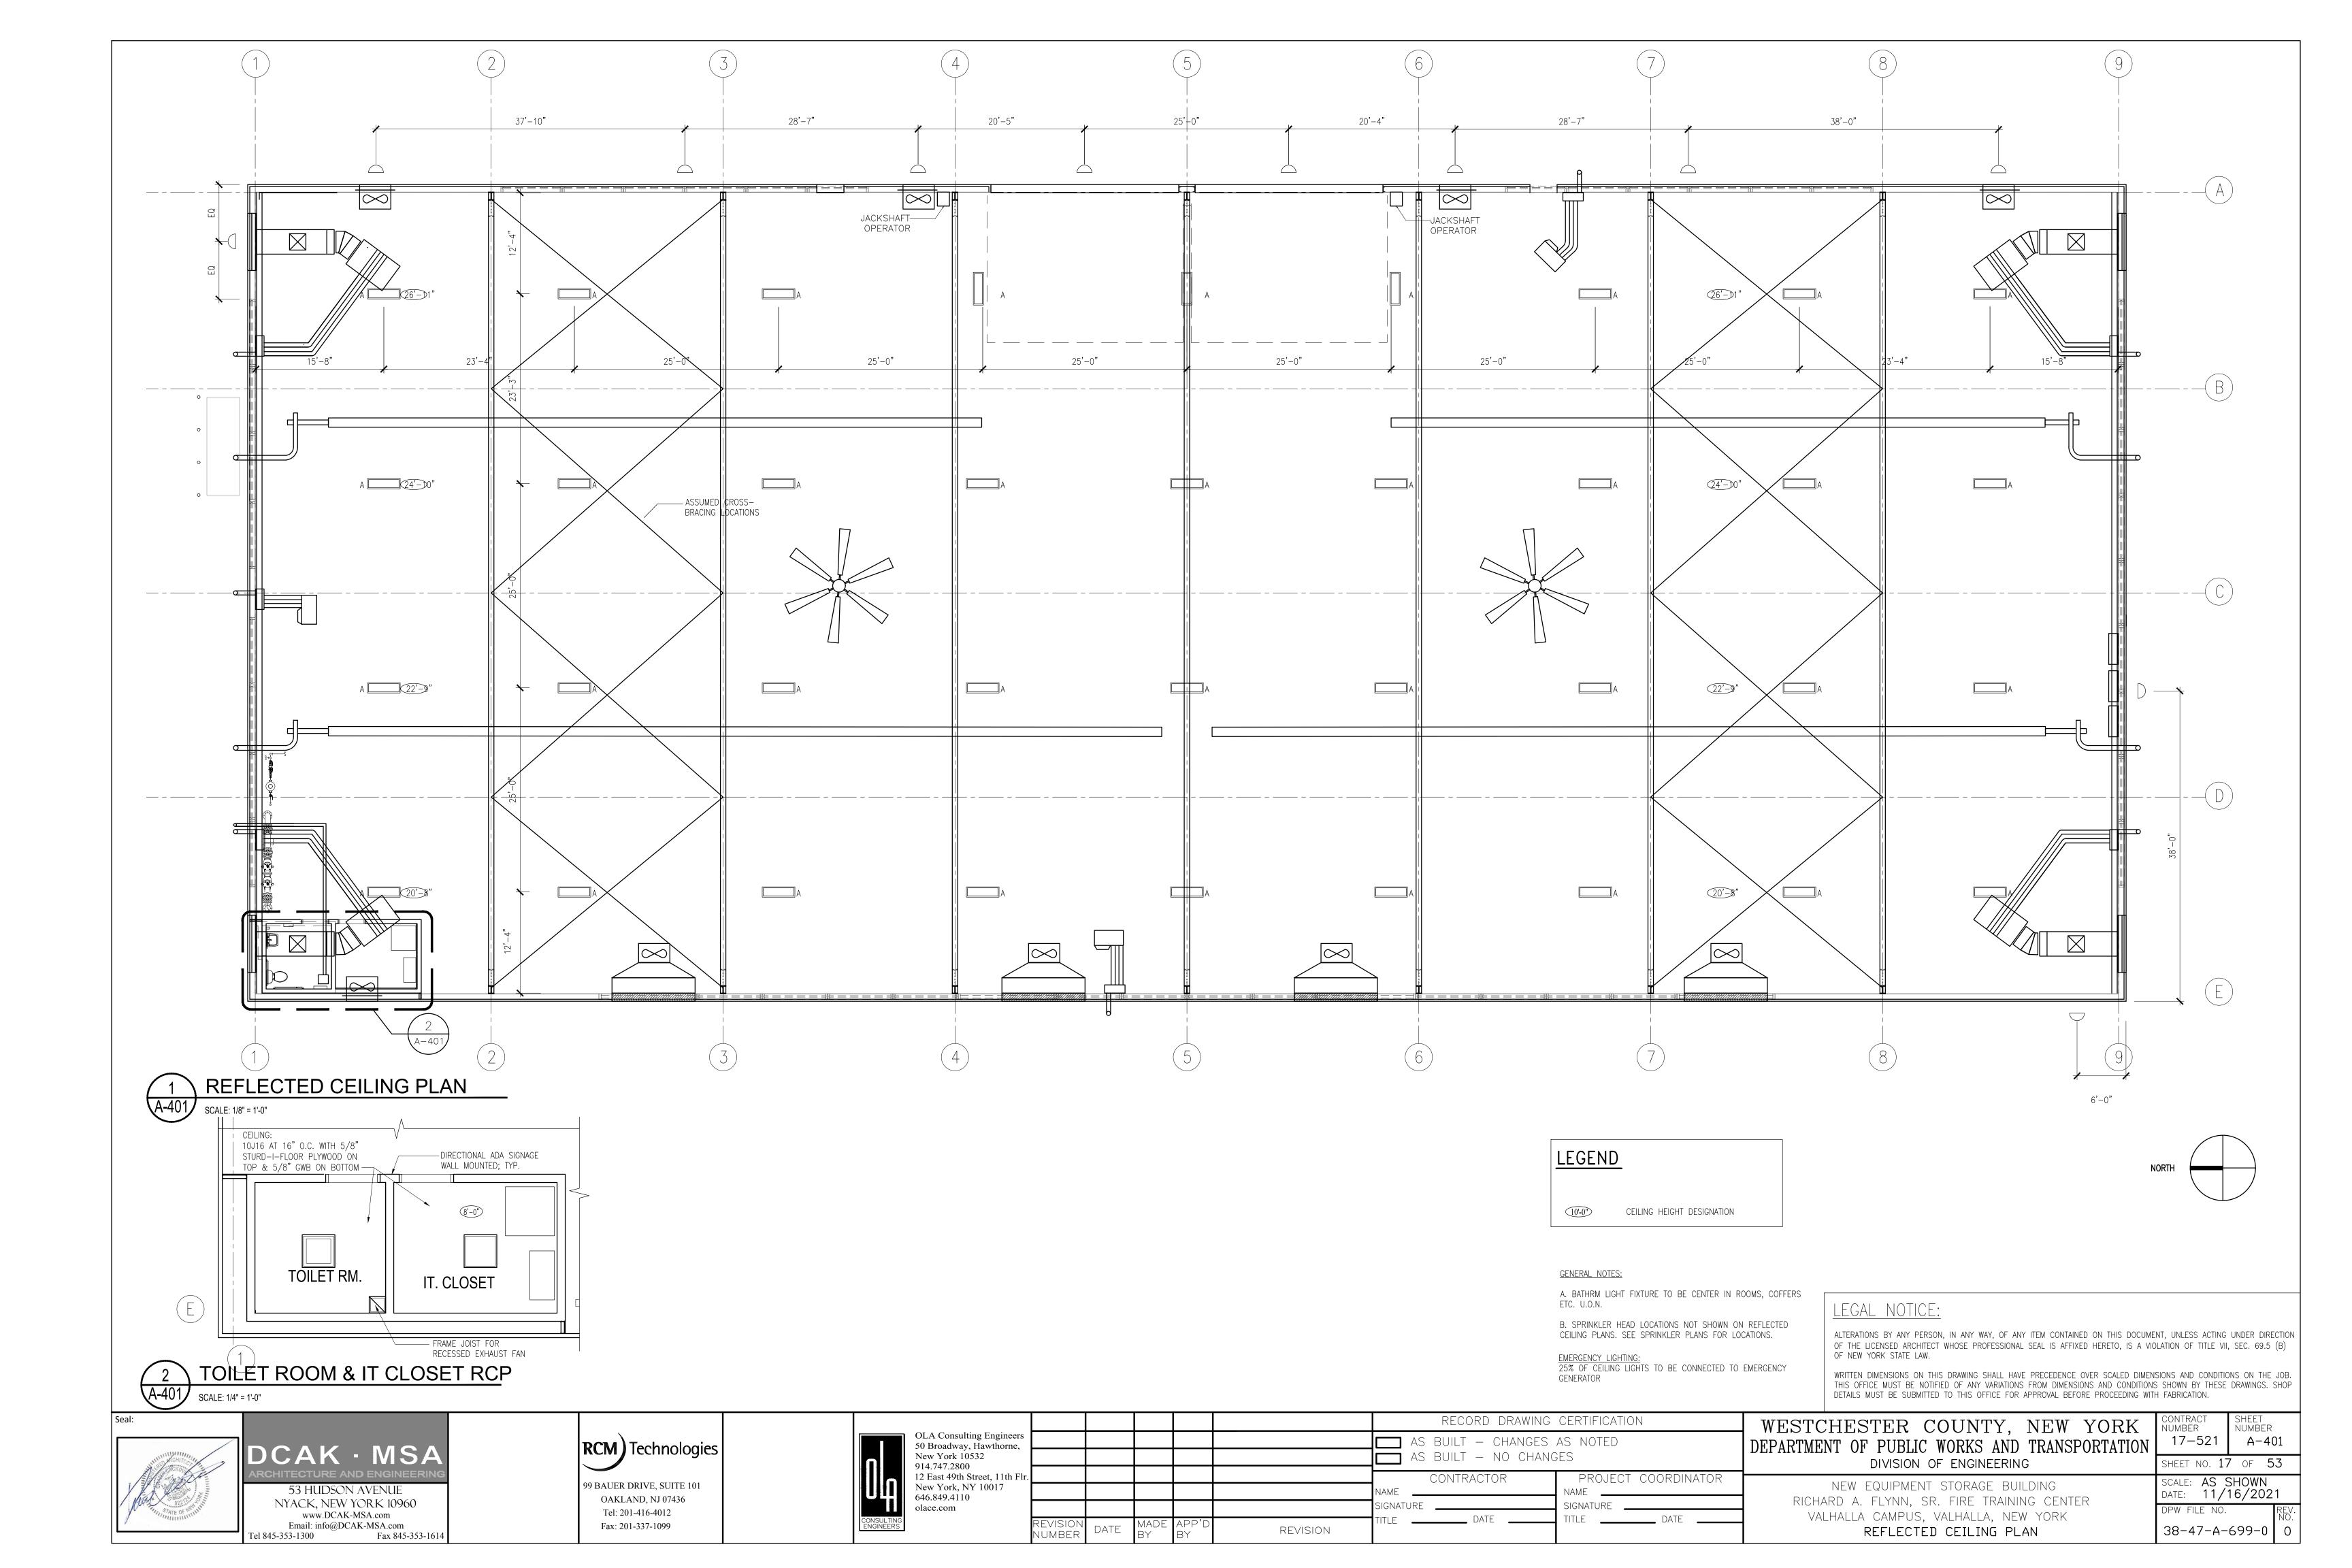
WESTCHESTER COUNTY, NEW YORK DEPARTMENT OF PUBLIC WORKS AND TRANSPORTATION


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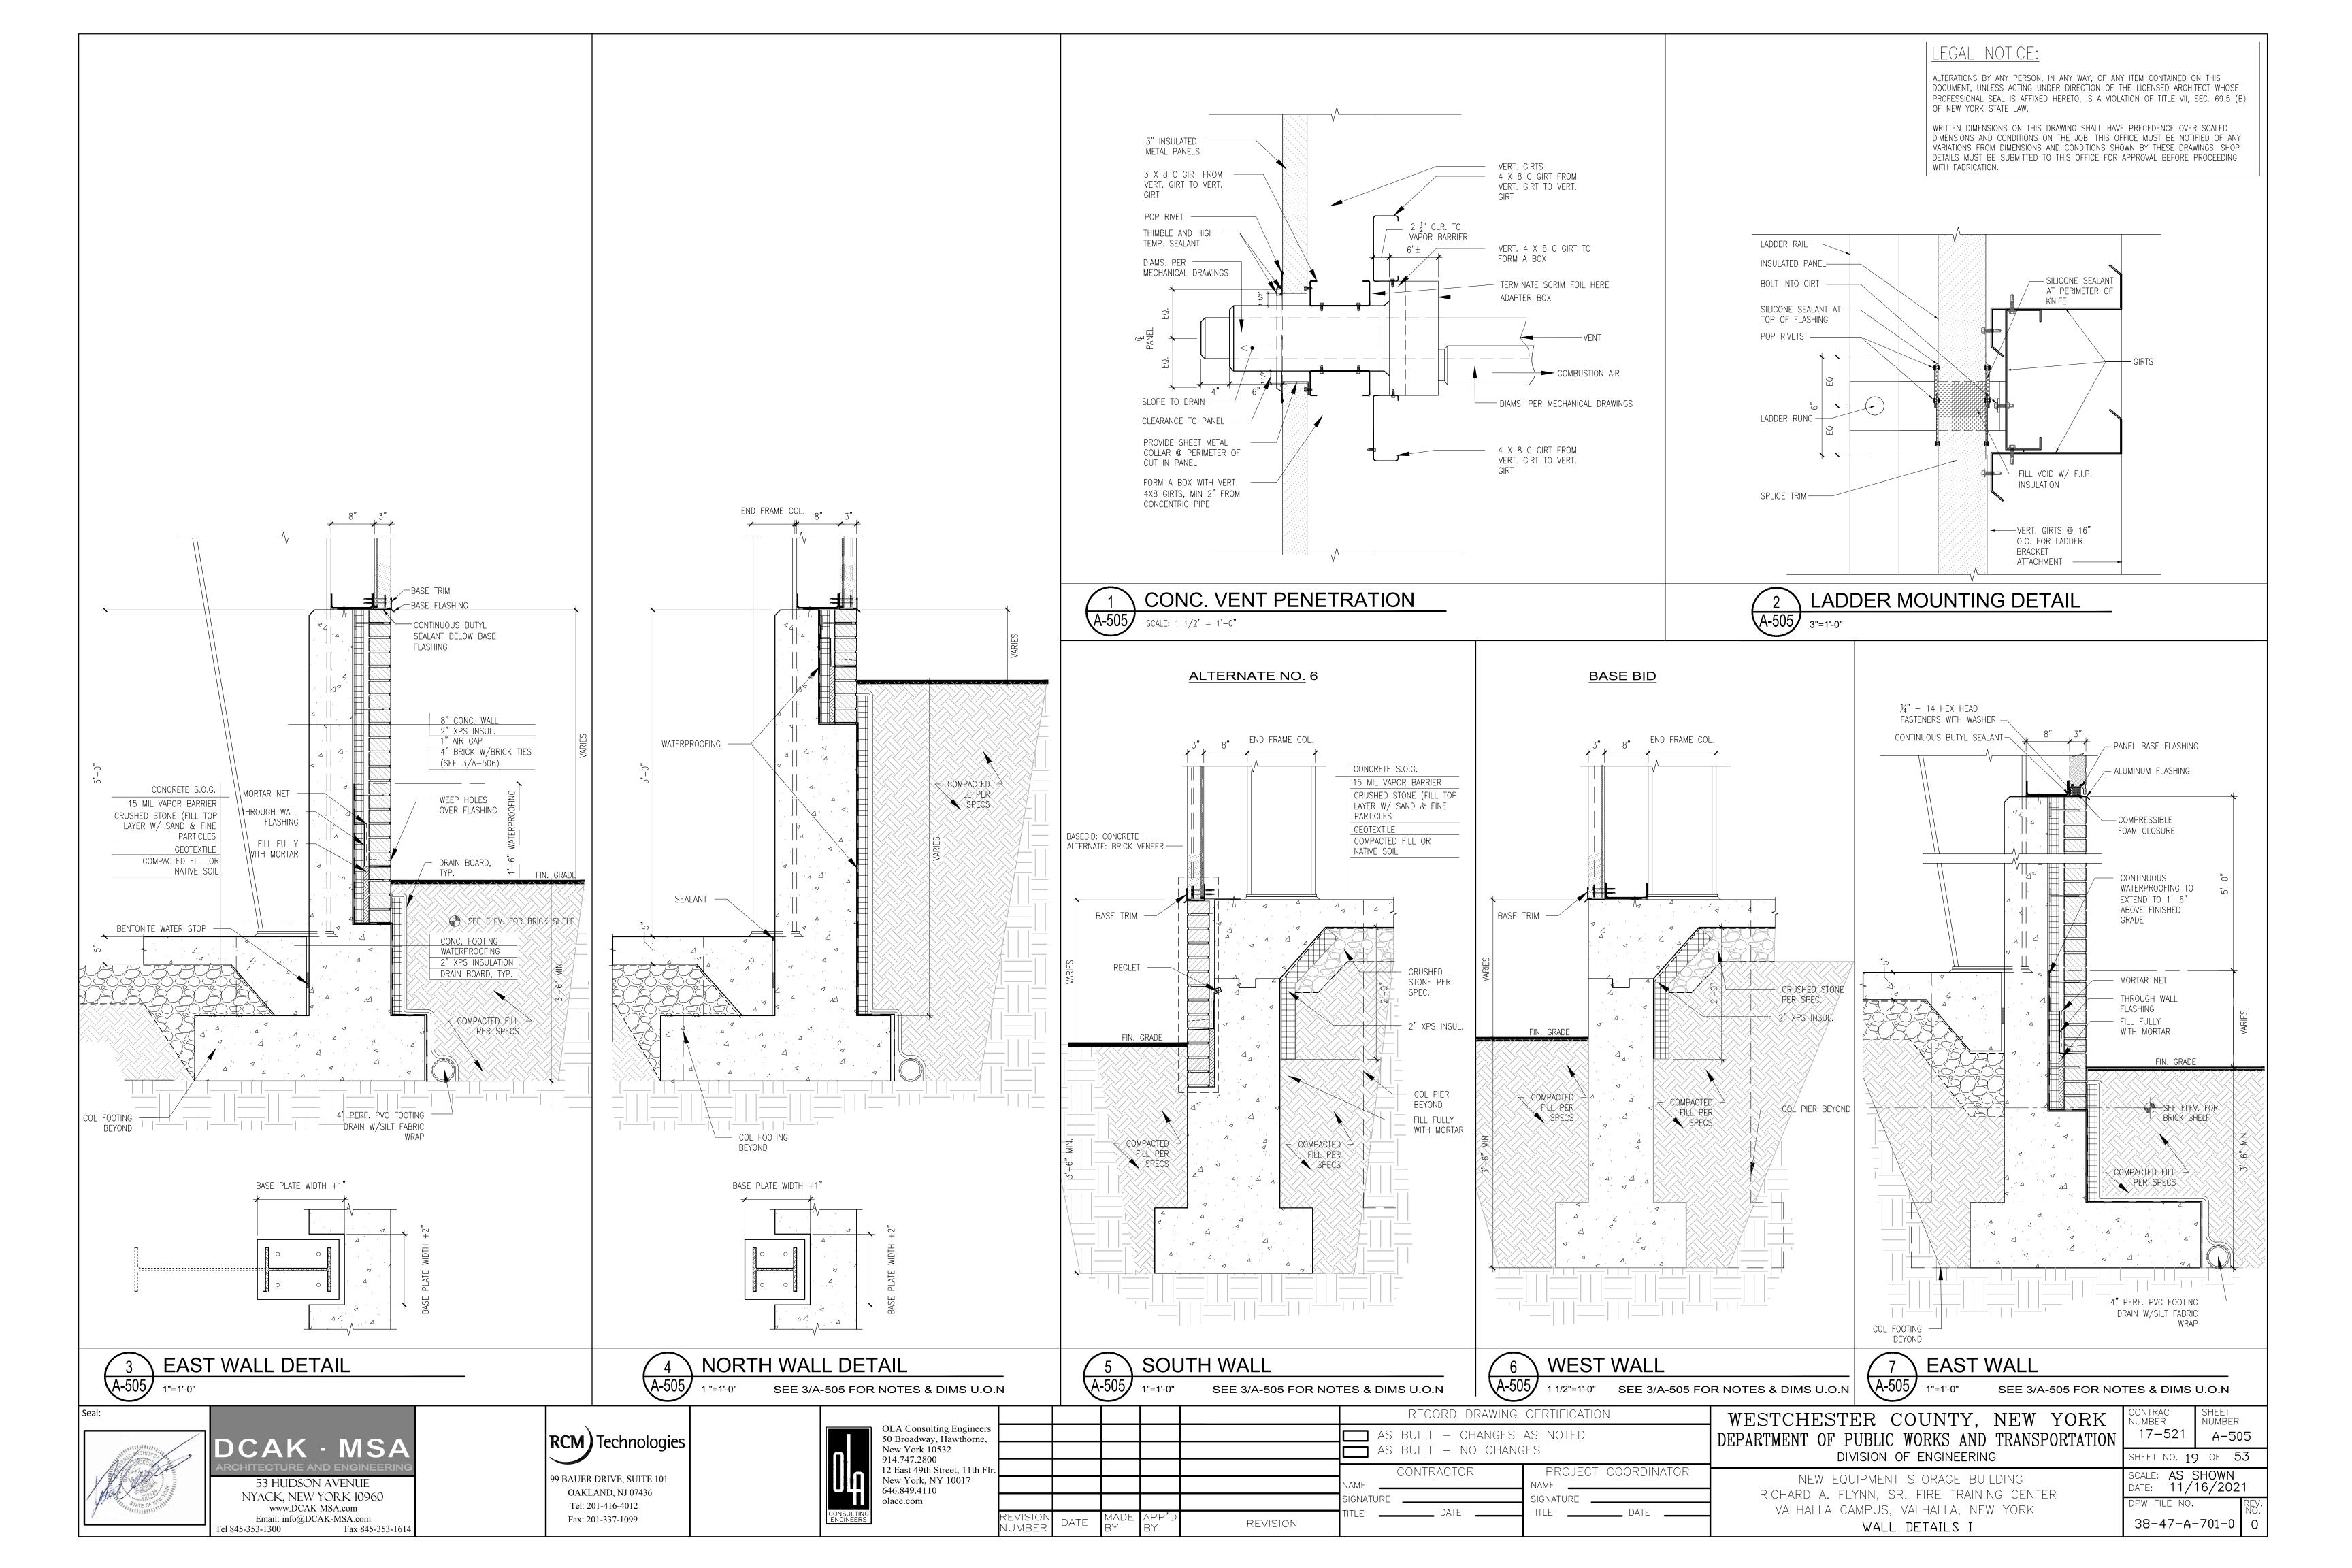
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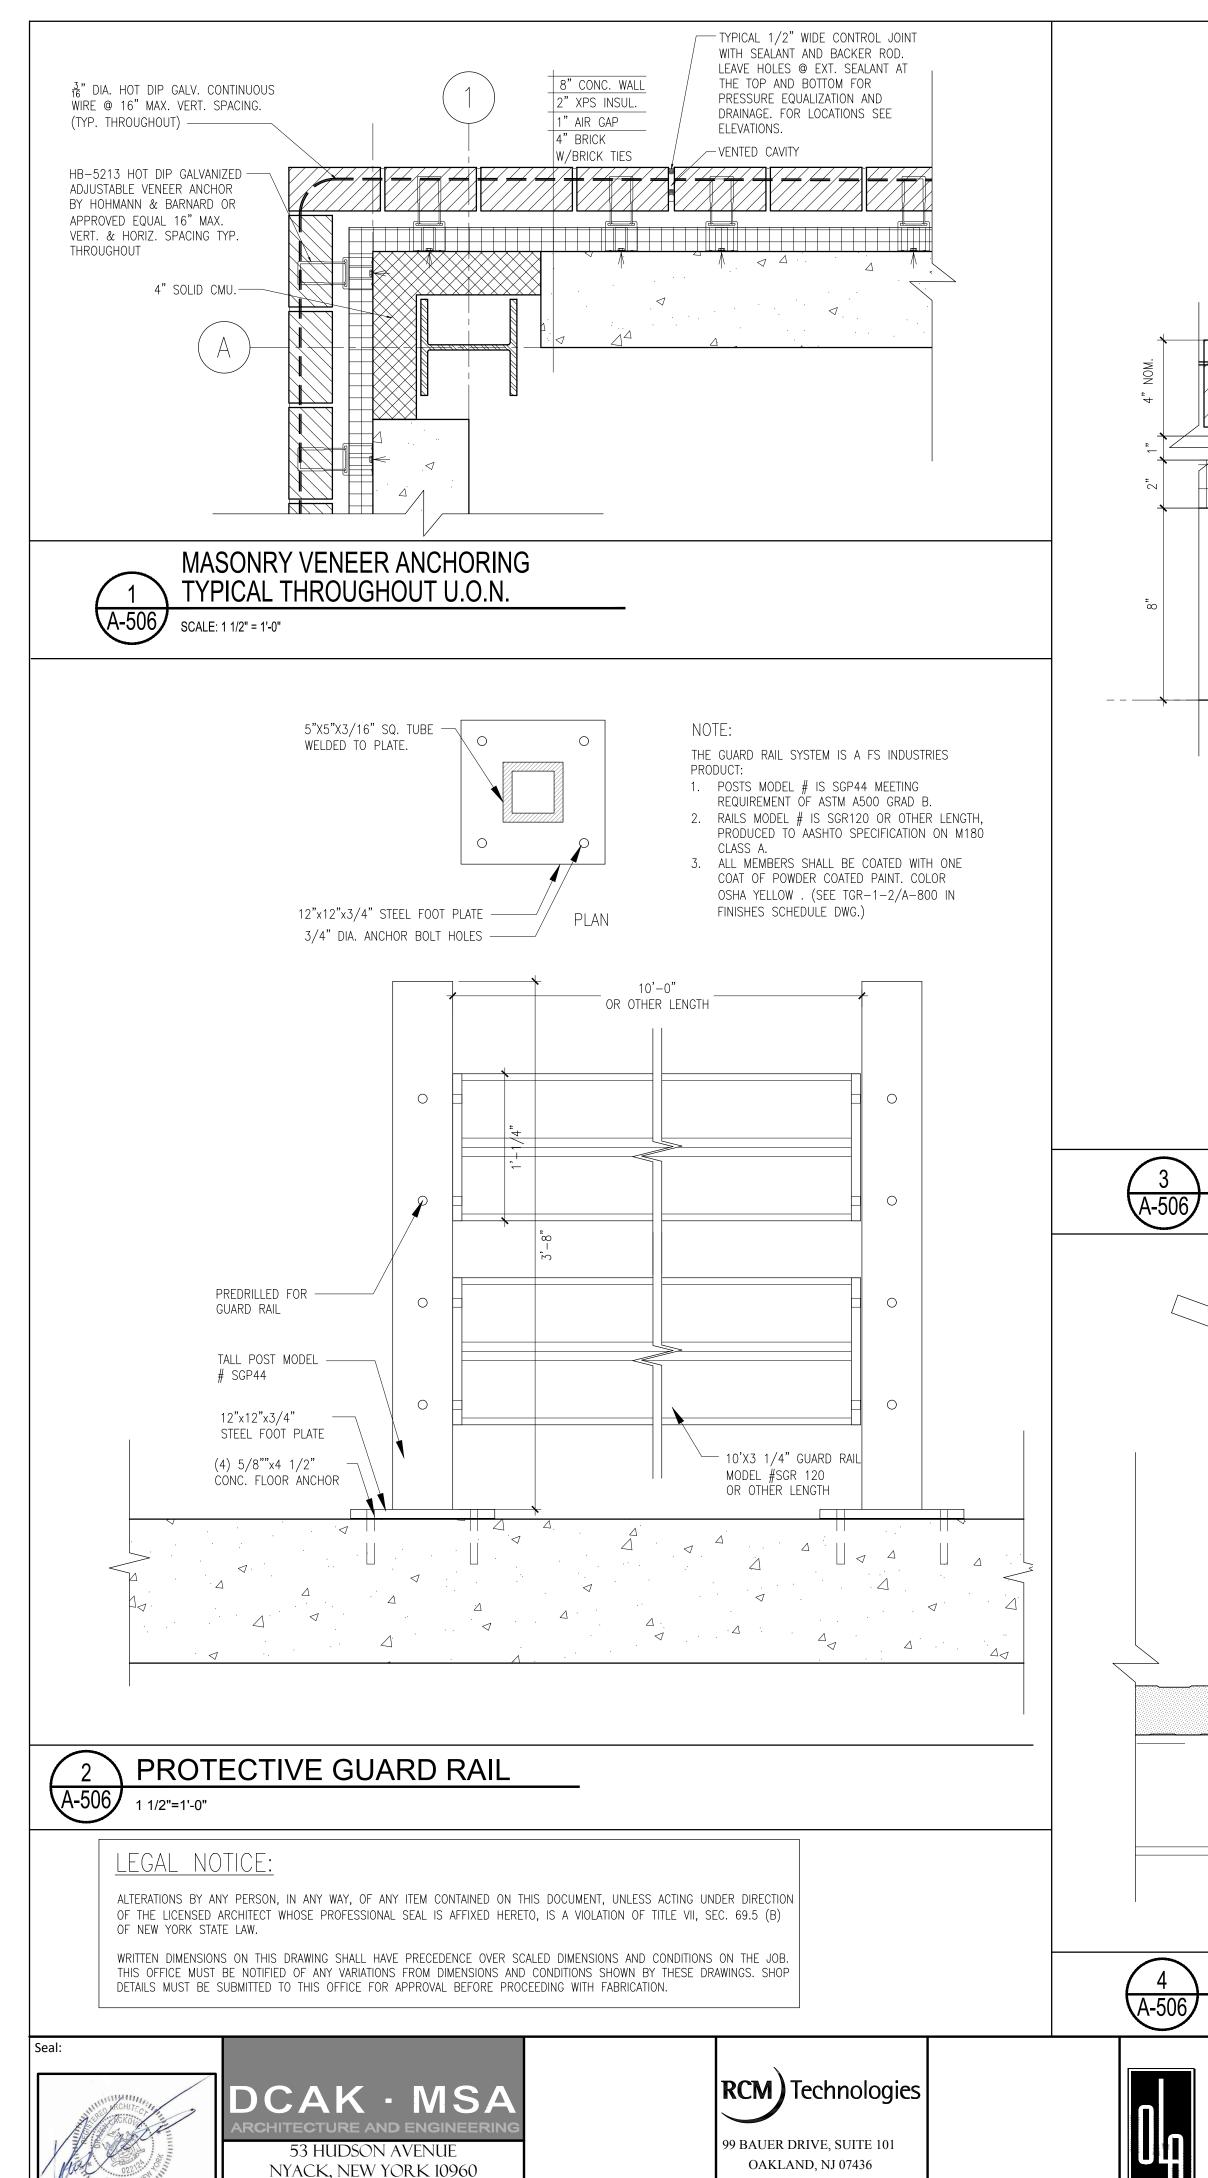
CONTRACT NUMBER SHEET NUMBER 17-521 A-300 SHEET NO. 16 OF 53 SCALE: AS SHOWN DATE: 11/16/2021


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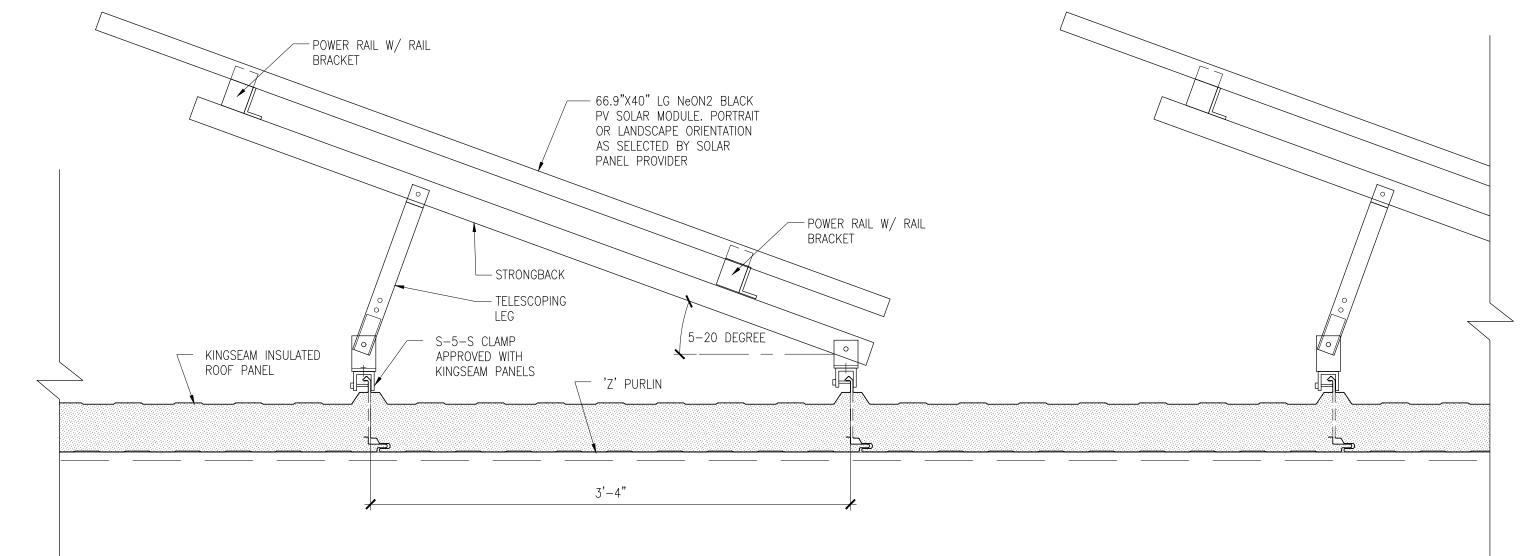






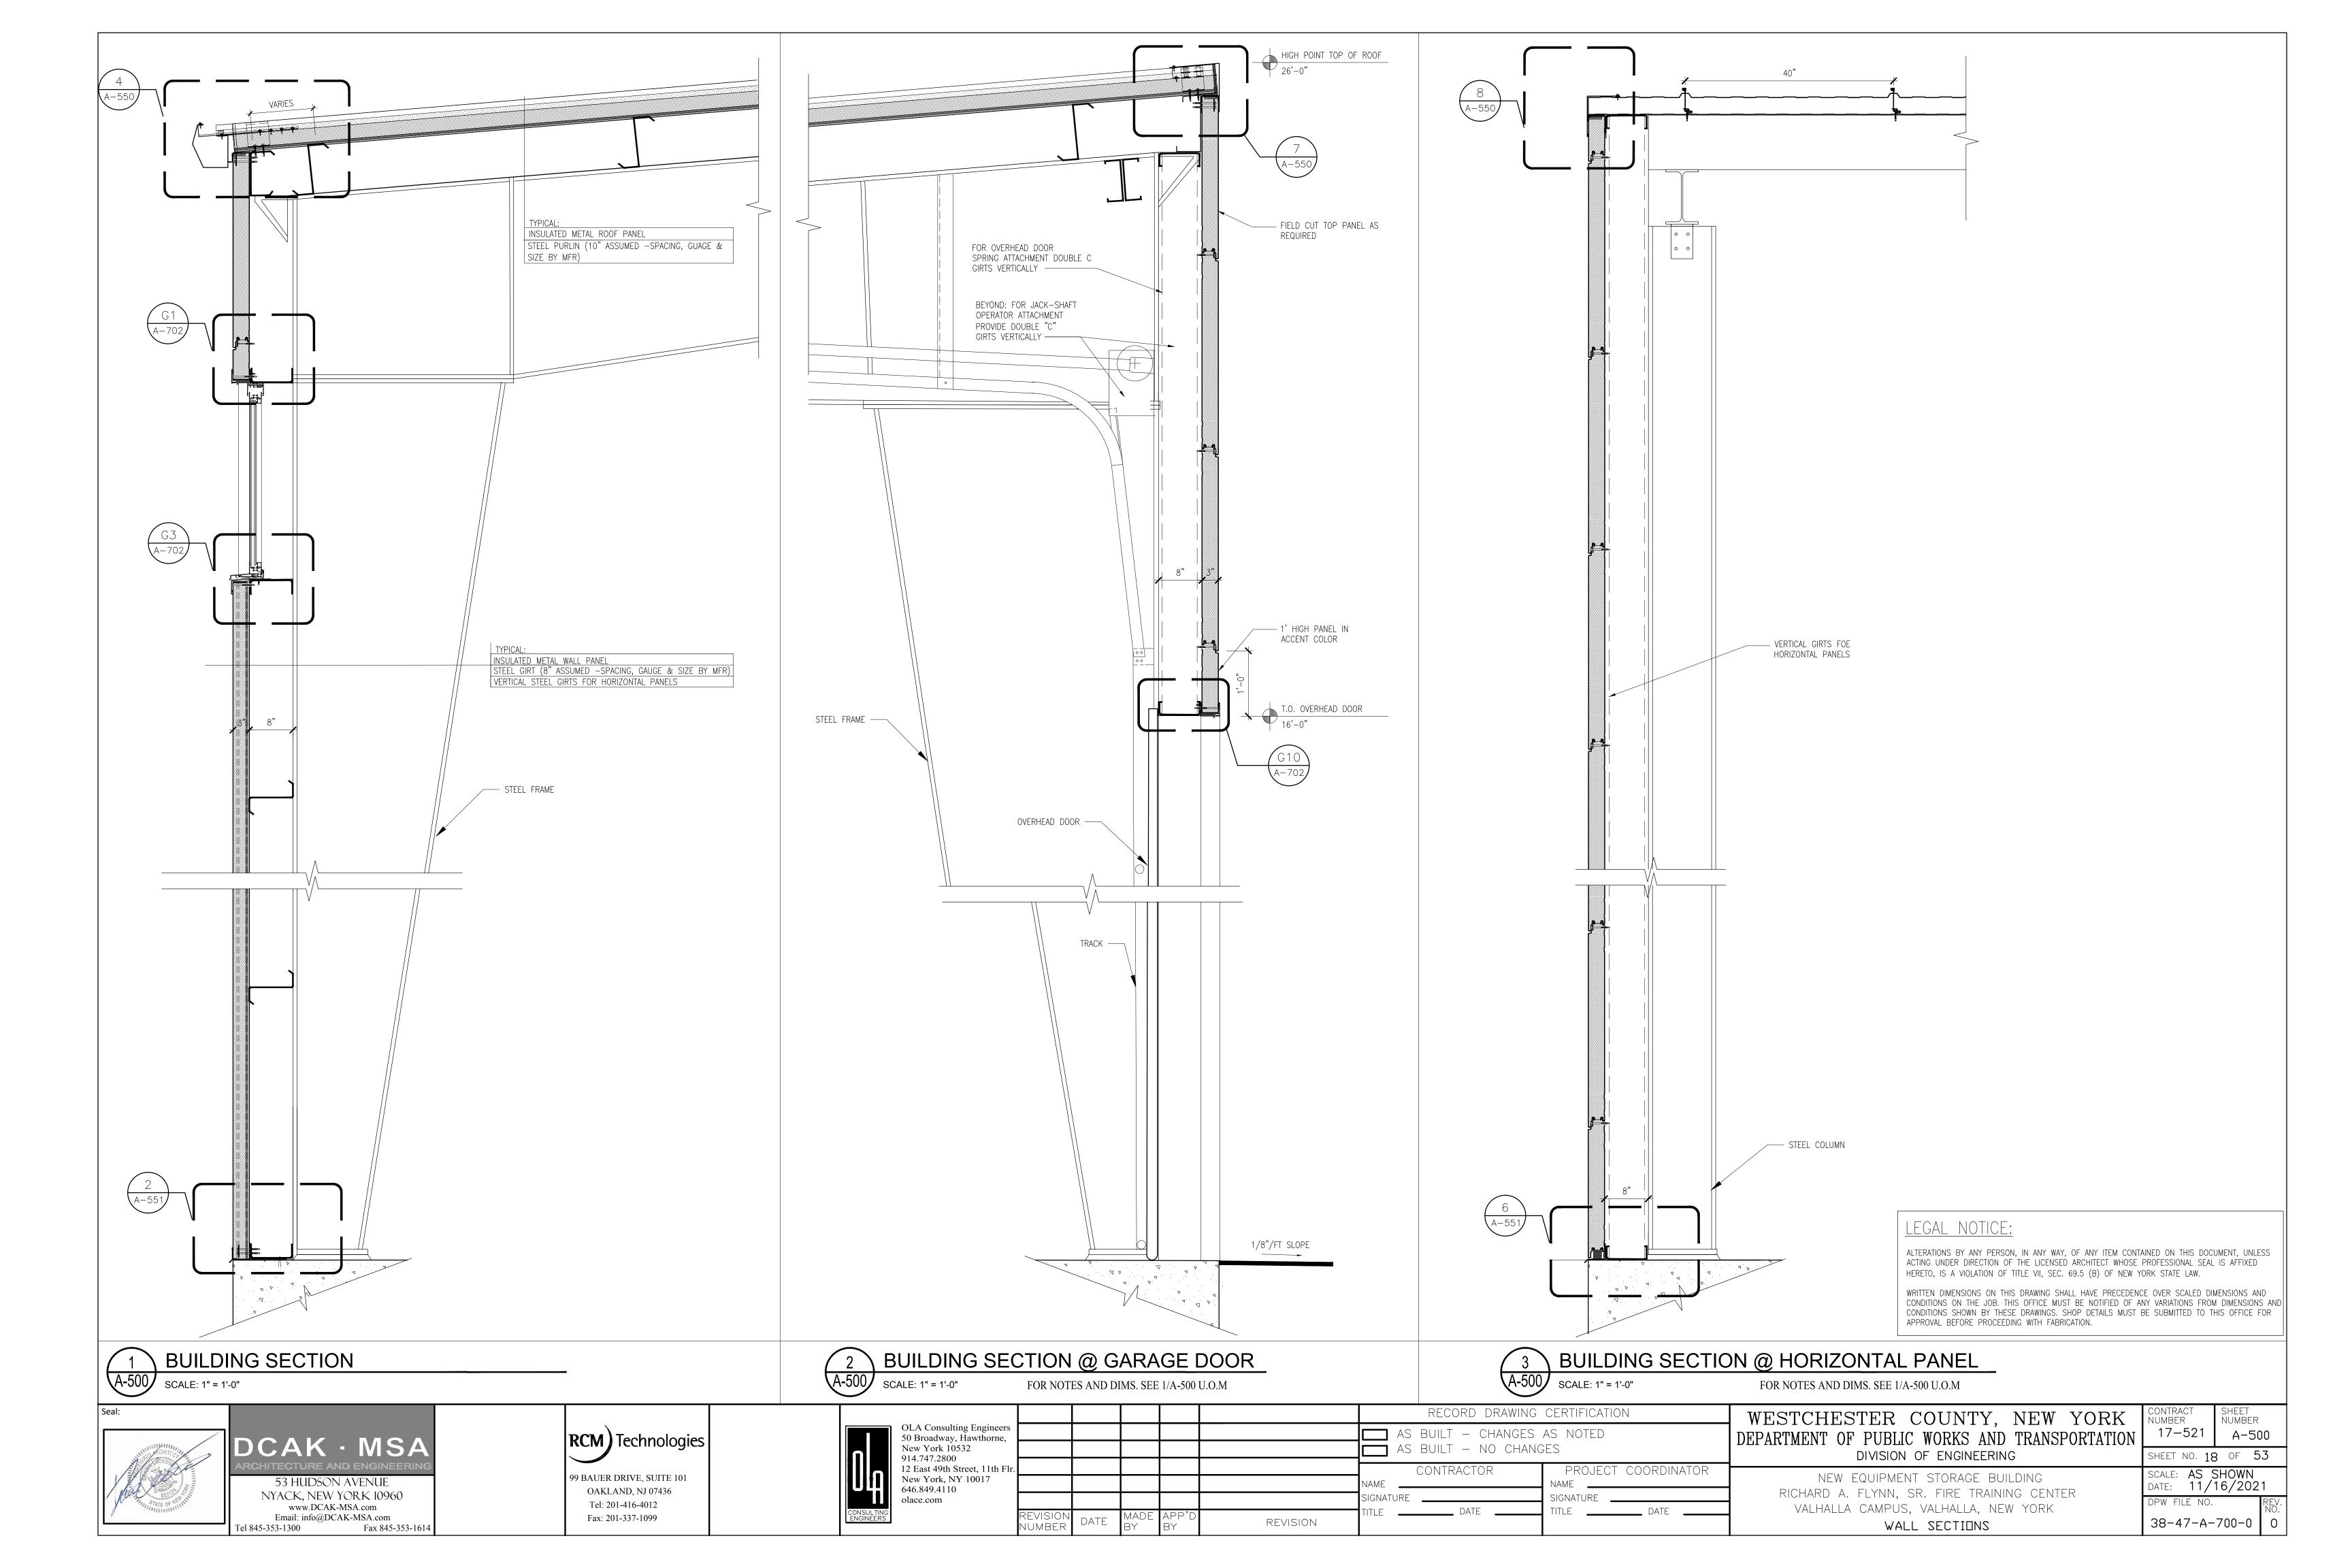

3 BRICK & METAL PANEL CORNER DETAIL A-506 3"=1'-0"

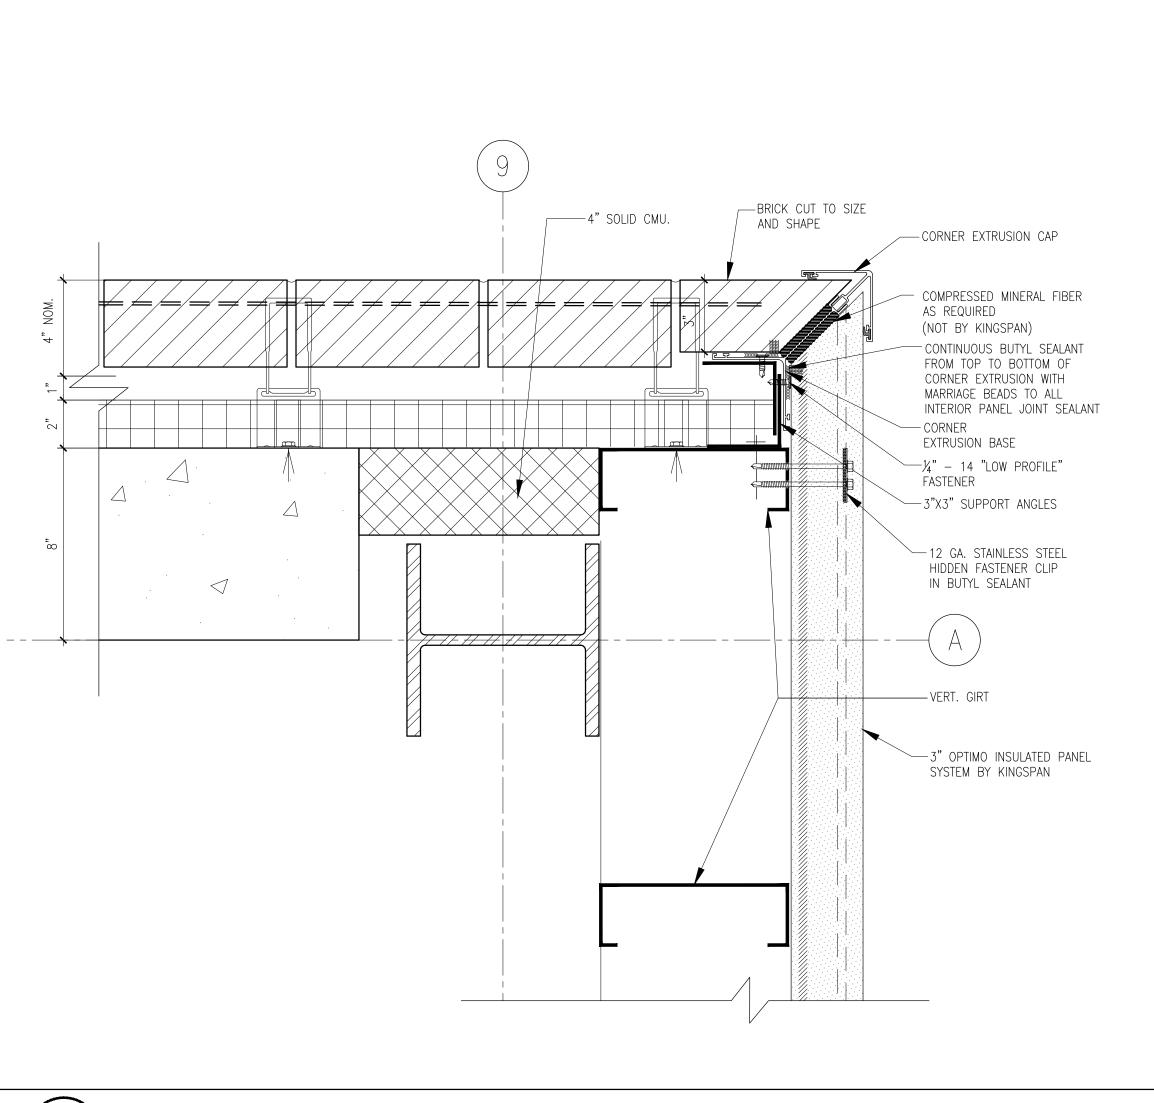

SOLAR PANEL ROOF INSTALLATION IS A DELEGATED DESIGN & ENGINEERING FOR SOLAR PANEL INSTALLER.

BASIS OF DESIGN ON THIS DRAWING: PLP PREFORMED LINE PRODUCTS, POWER RAIL P6 TILT INSTALLATION.

SOLAR PANEL RAIL SYSTEM SHALL INCLUDE:

- NON PENETRATING: • CLAMP TO ROOF PANEL STANDING SEAM (S-5-S OR SIMILAR)
- TILT KIT WITH MOUNTING FEET COMPATIBLE W/ STANDING SEAM CLAMP, FIXED LEG, TELESCOPING LEG, STRONGBACK RAIL BRACKETS, AND HARDWARE.
- POWER RAILS W/ CLAMPS, EXTENSINS, SPLICES AND HARDWARE INCLUDING HARDWARE FOR SELECTED SOLAR PANEL MOUNTING.
- LATERAL FORCE BRACING. GROUNDING SYSTEM.
- OTHER HARDWARE, ATTACHMENTS & ACCESSORIES FOR A FULLY COMPLIANT

38-47-A-702-0 | 0

SOLAR PANEL RACK SYSTEM. SHOP DRAWINGS AND SUBMITTALS SIGNED AND SEALED BY PROFESSIONAL ENGINEER IN N.Y.S. CERTIFYING COMPLIANCE W/ DEAD, LIVE, SNOW, WIND AND

SEISMIC LOADING IN ACCORDANCE W/ N.Y.S. CODES.

SOLAR PANEL INSTALLATION DETAIL SCALE: 1 1/2"=1'-0"



Tel: 201-416-4012


Fax: 201-337-1099




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WESTCHESTER COUNTY, NEW YORK CONTRACT NUMBER SHEET NUMBER 17-521 A-506 DEPARTMENT OF PUBLIC WORKS AND TRANSPORTATION SHEET NO. 20 OF 53 DIVISION OF ENGINEERING SCALE: AS SHOWN NEW EQUIPMENT STORAGE BUILDING DATE: 11/16/2021 RICHARD A. FLYNN, SR. FIRE TRAINING CENTER DPW FILE NO. VALHALLA CAMPUS, VALHALLA, NEW YORK

DETAILS II



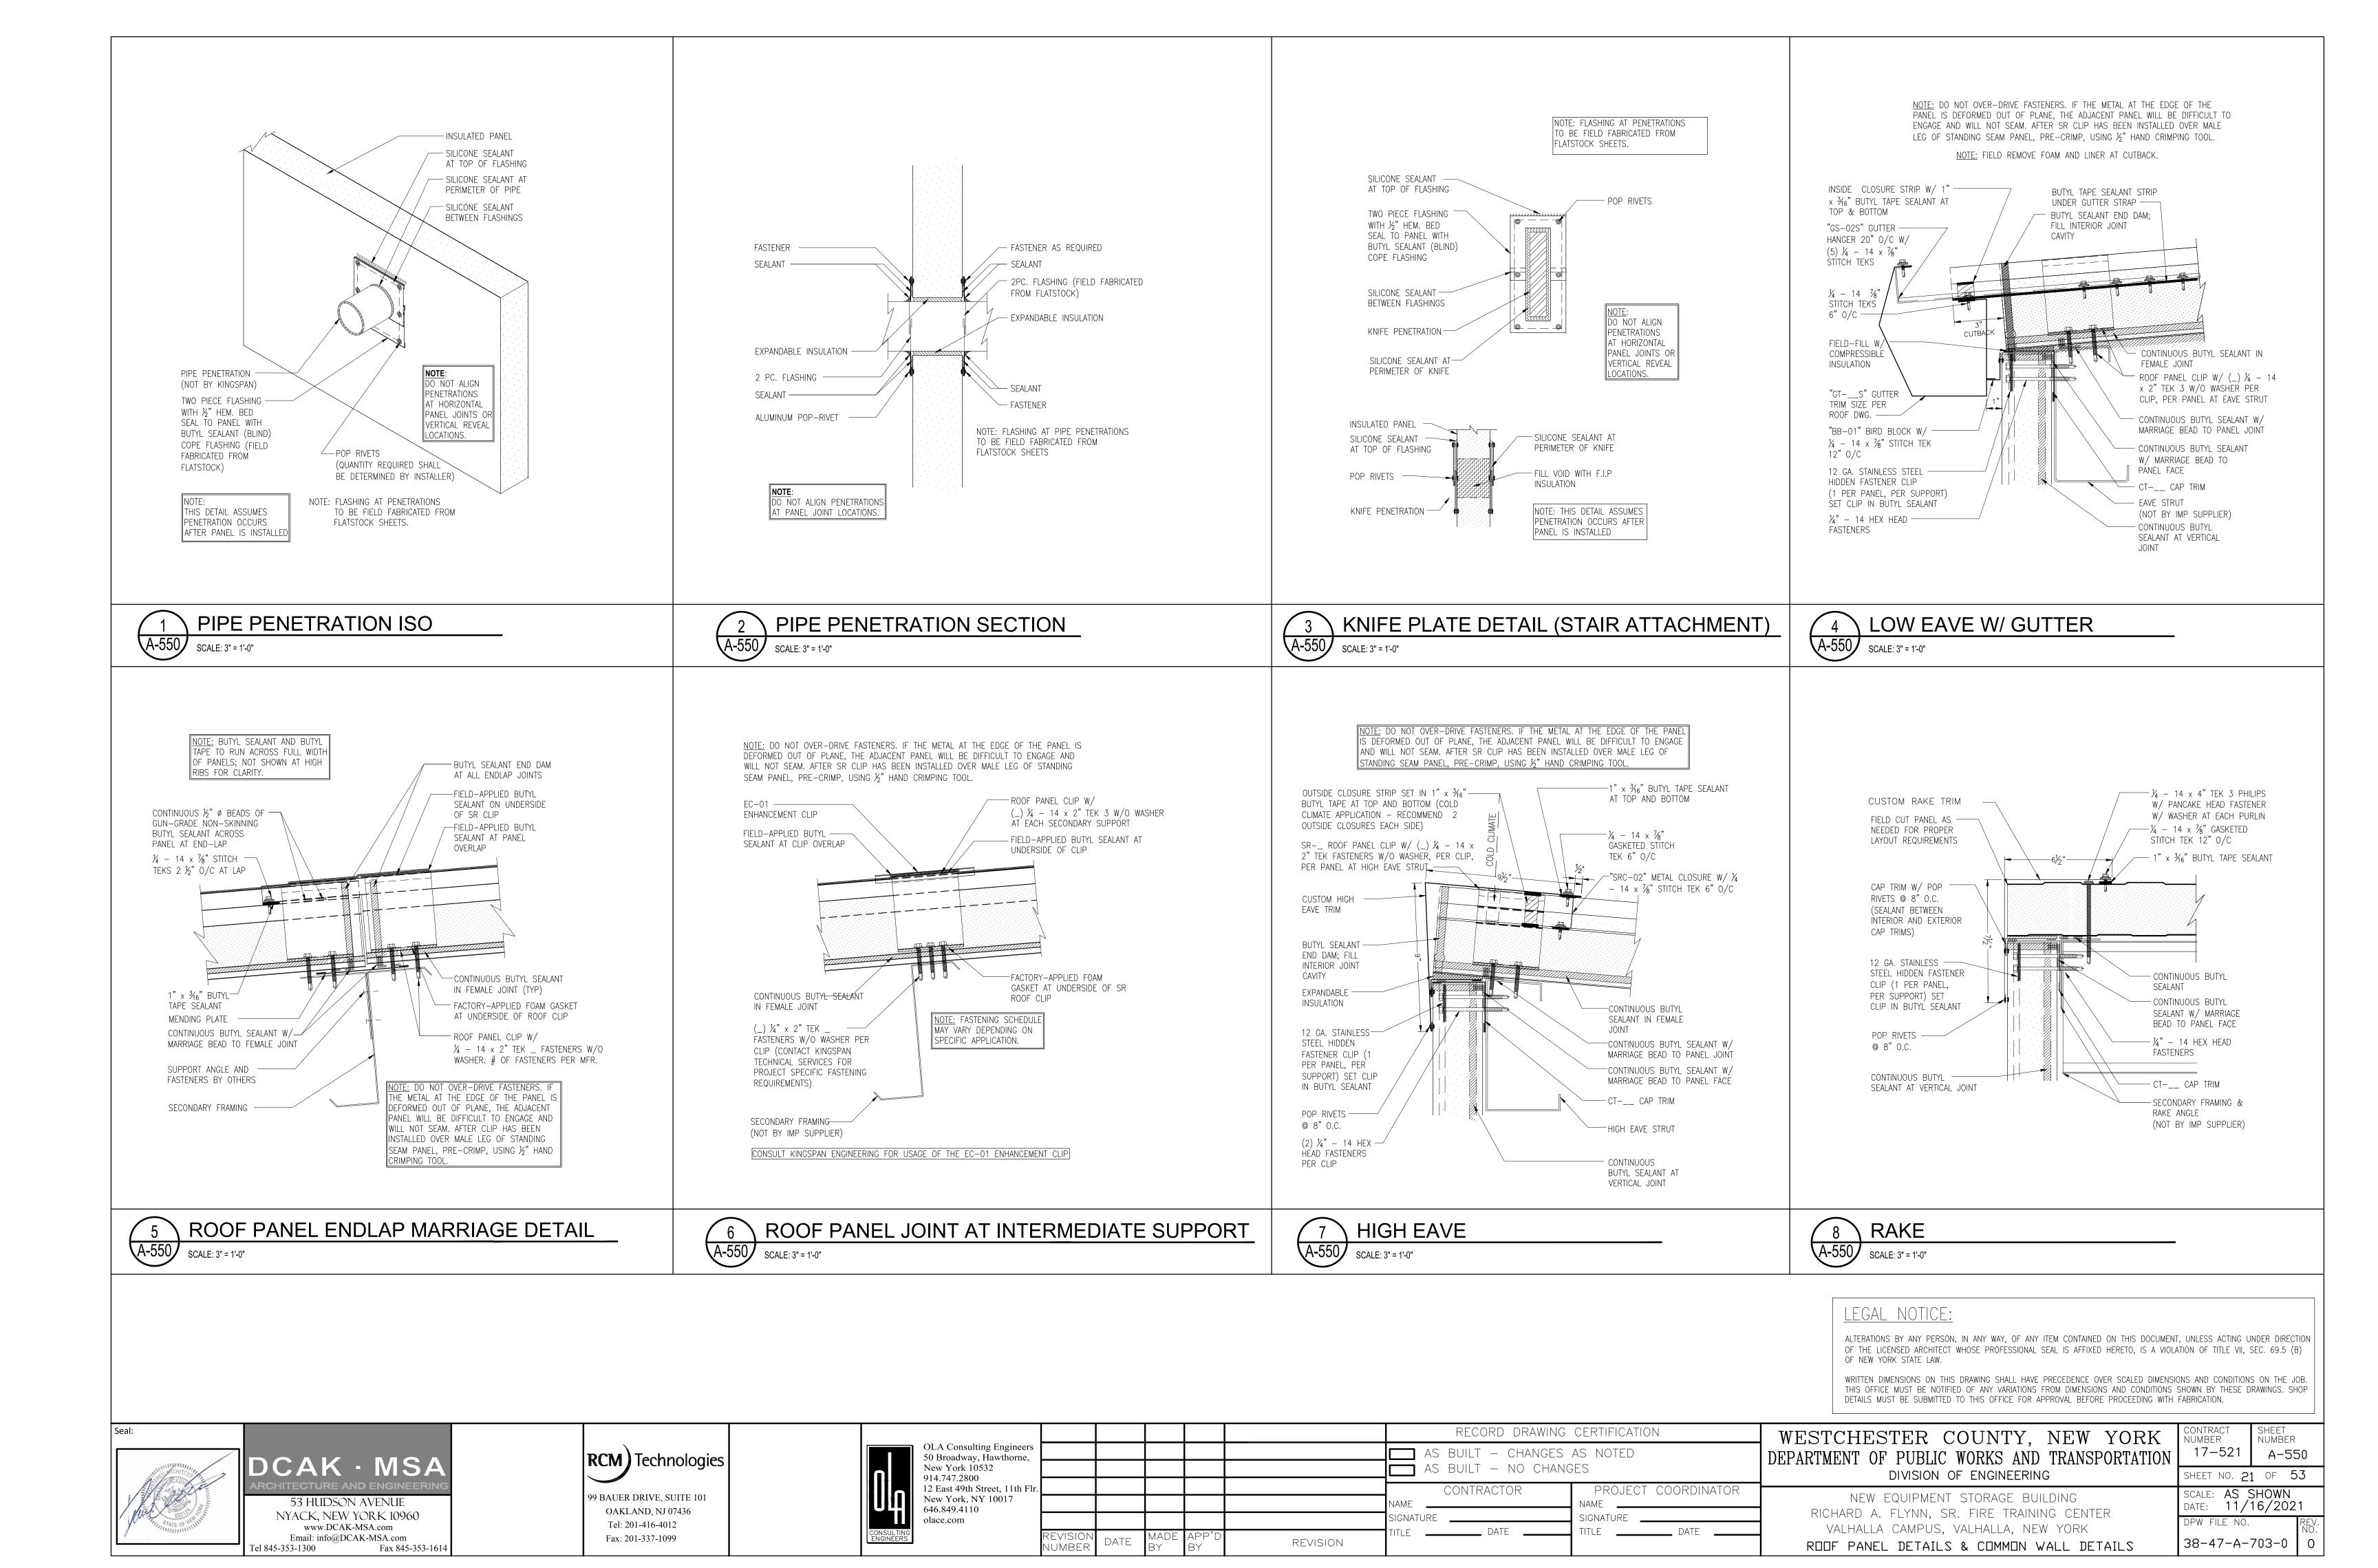

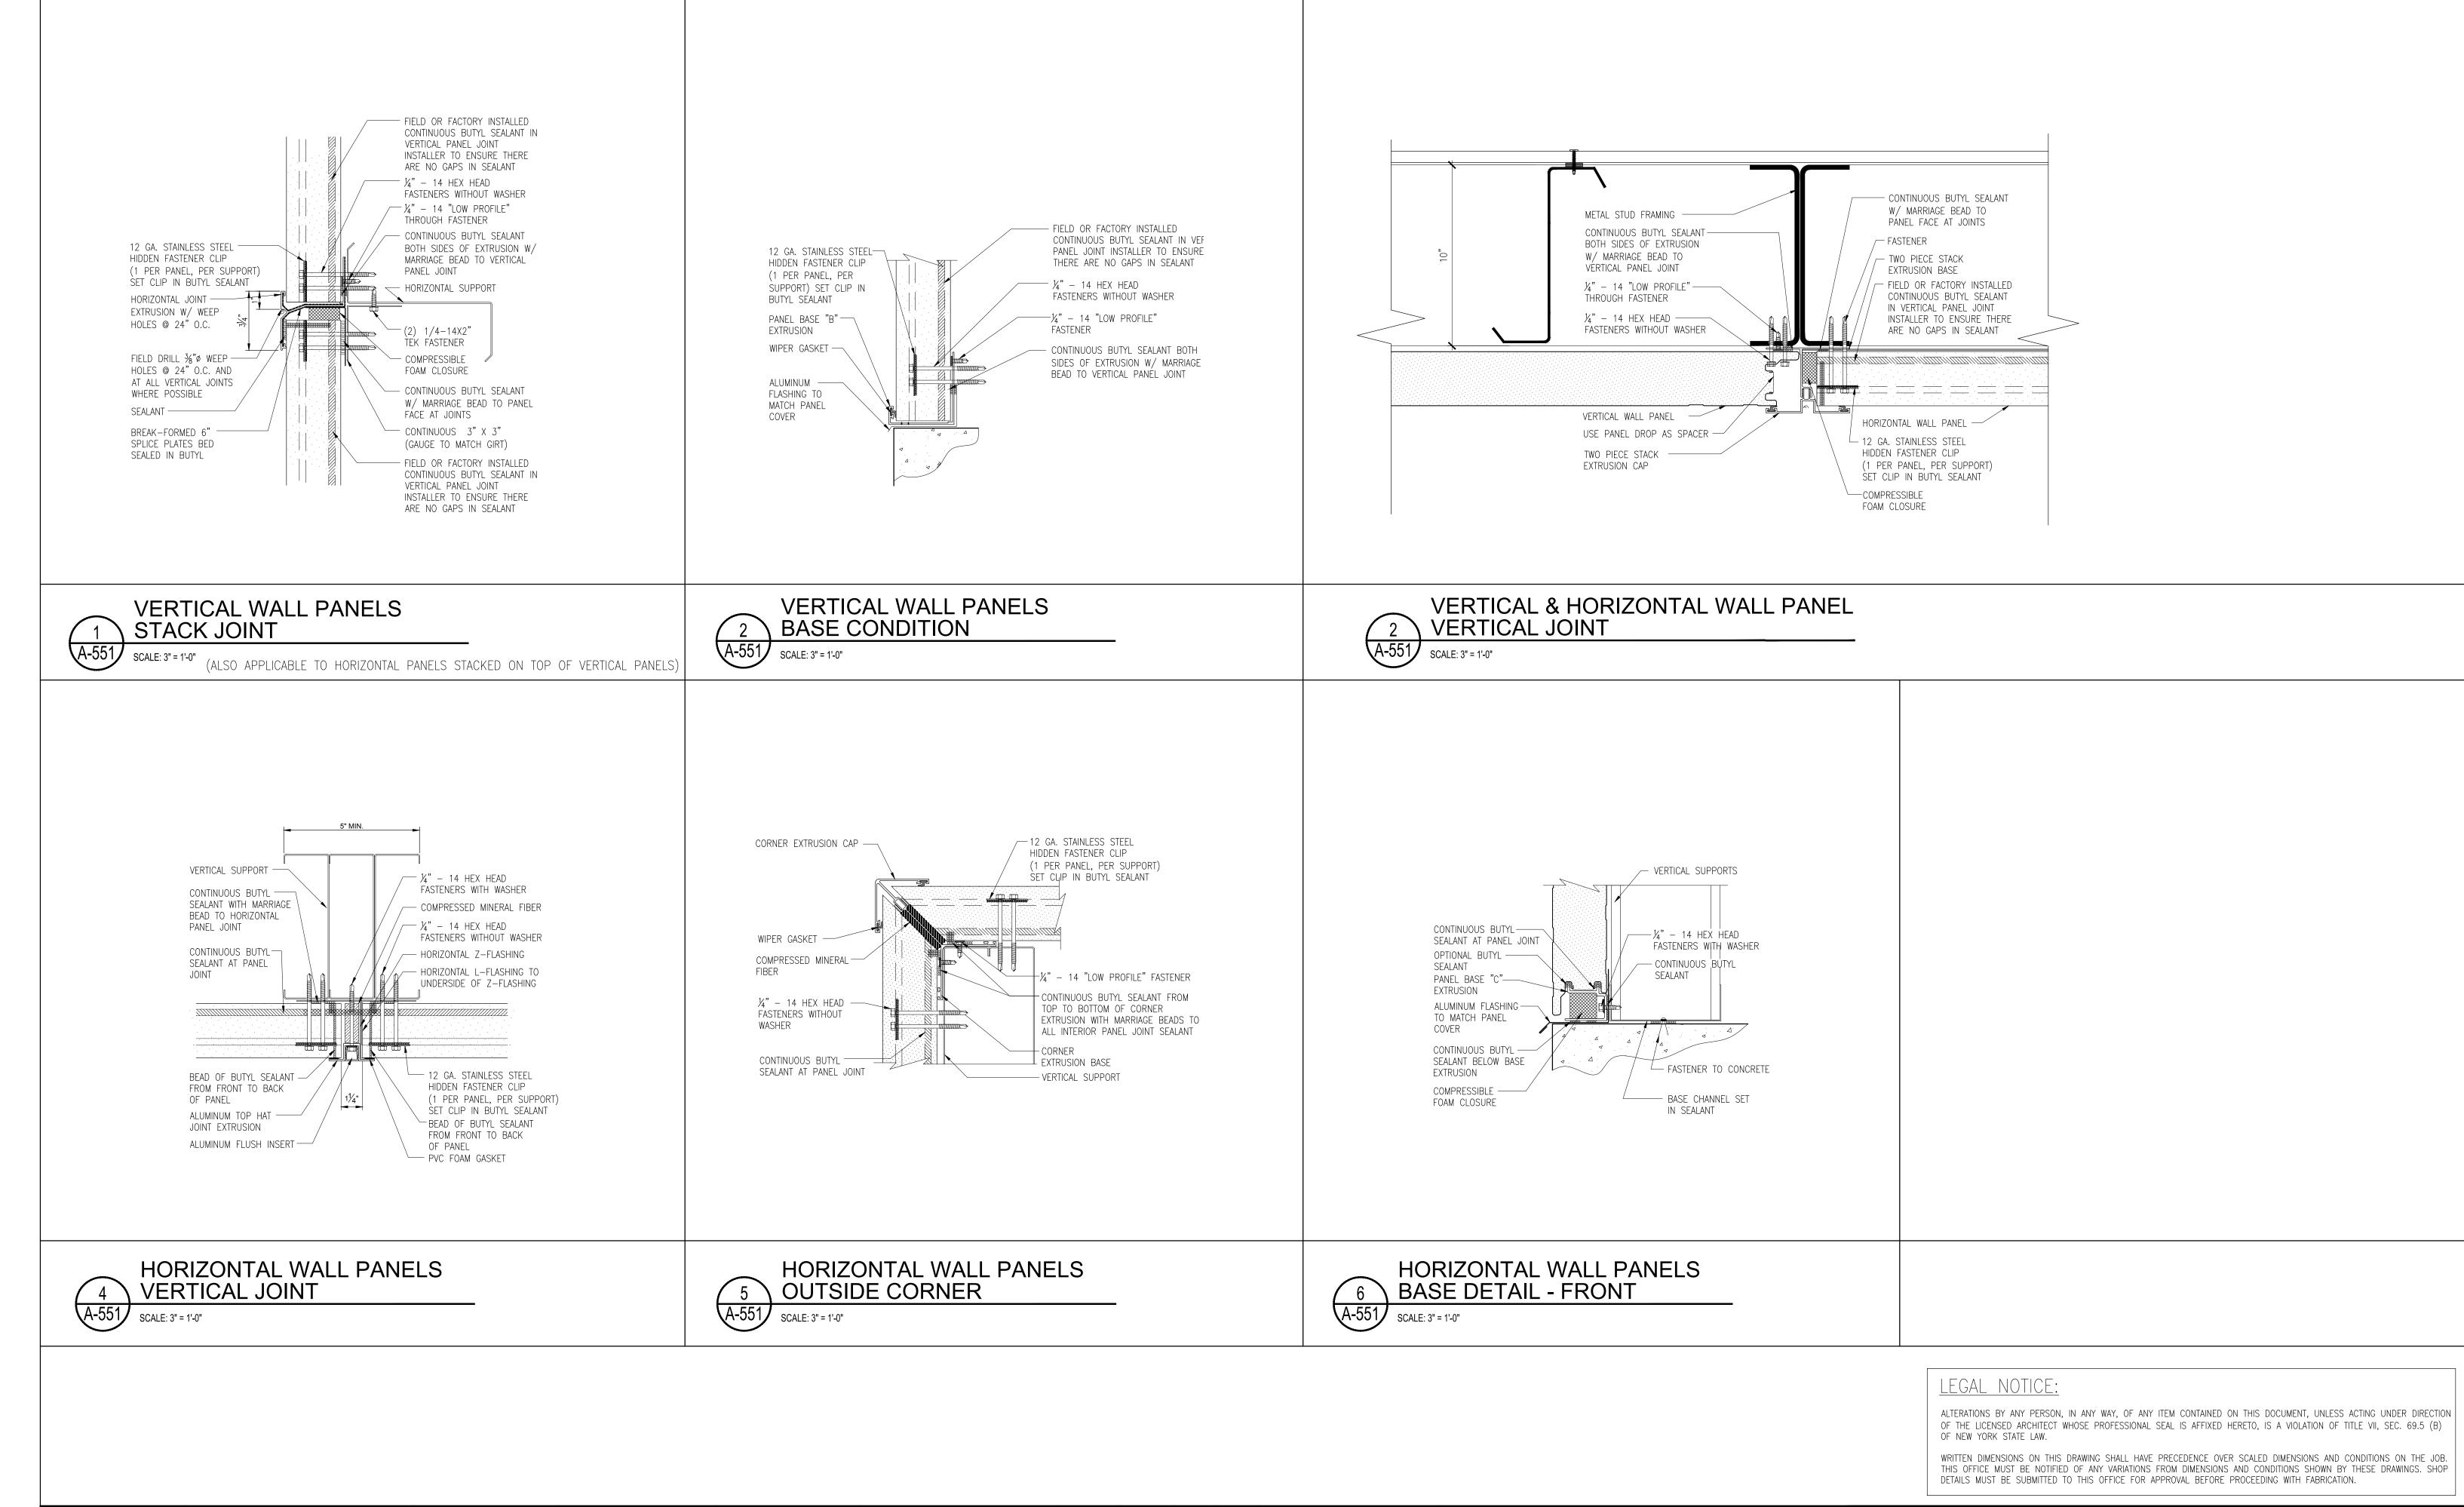





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CONTRACT NUMBER WESTCHESTER COUNTY, NEW YORK NUMBER 17-521 A-551 DEPARTMENT OF PUBLIC WORKS AND TRANSPORTATION SHEET NO. 22 OF 53 DIVISION OF ENGINEERING SCALE: AS SHOWN NEW EQUIPMENT STORAGE BUILDING DATE: 11/16/2021 RICHARD A. FLYNN, SR. FIRE TRAINING CENTER DPW FILE NO. VALHALLA CAMPUS, VALHALLA, NEW YORK 38-47-A-704-0 0 WALL PANELS IN VERTICAL/HORIZ, DRIENTATION DETAILS





New York, NY 10017 53 HUDSON AVENUE 646.849.4110 OAKLAND, NJ 07436 NYACK, NEW YORK 10960 olace.com Tel: 201-416-4012 www.DCAK-MSA.com Email: info@DCAK-MSA.com Fax: 201-337-1099 REVISION

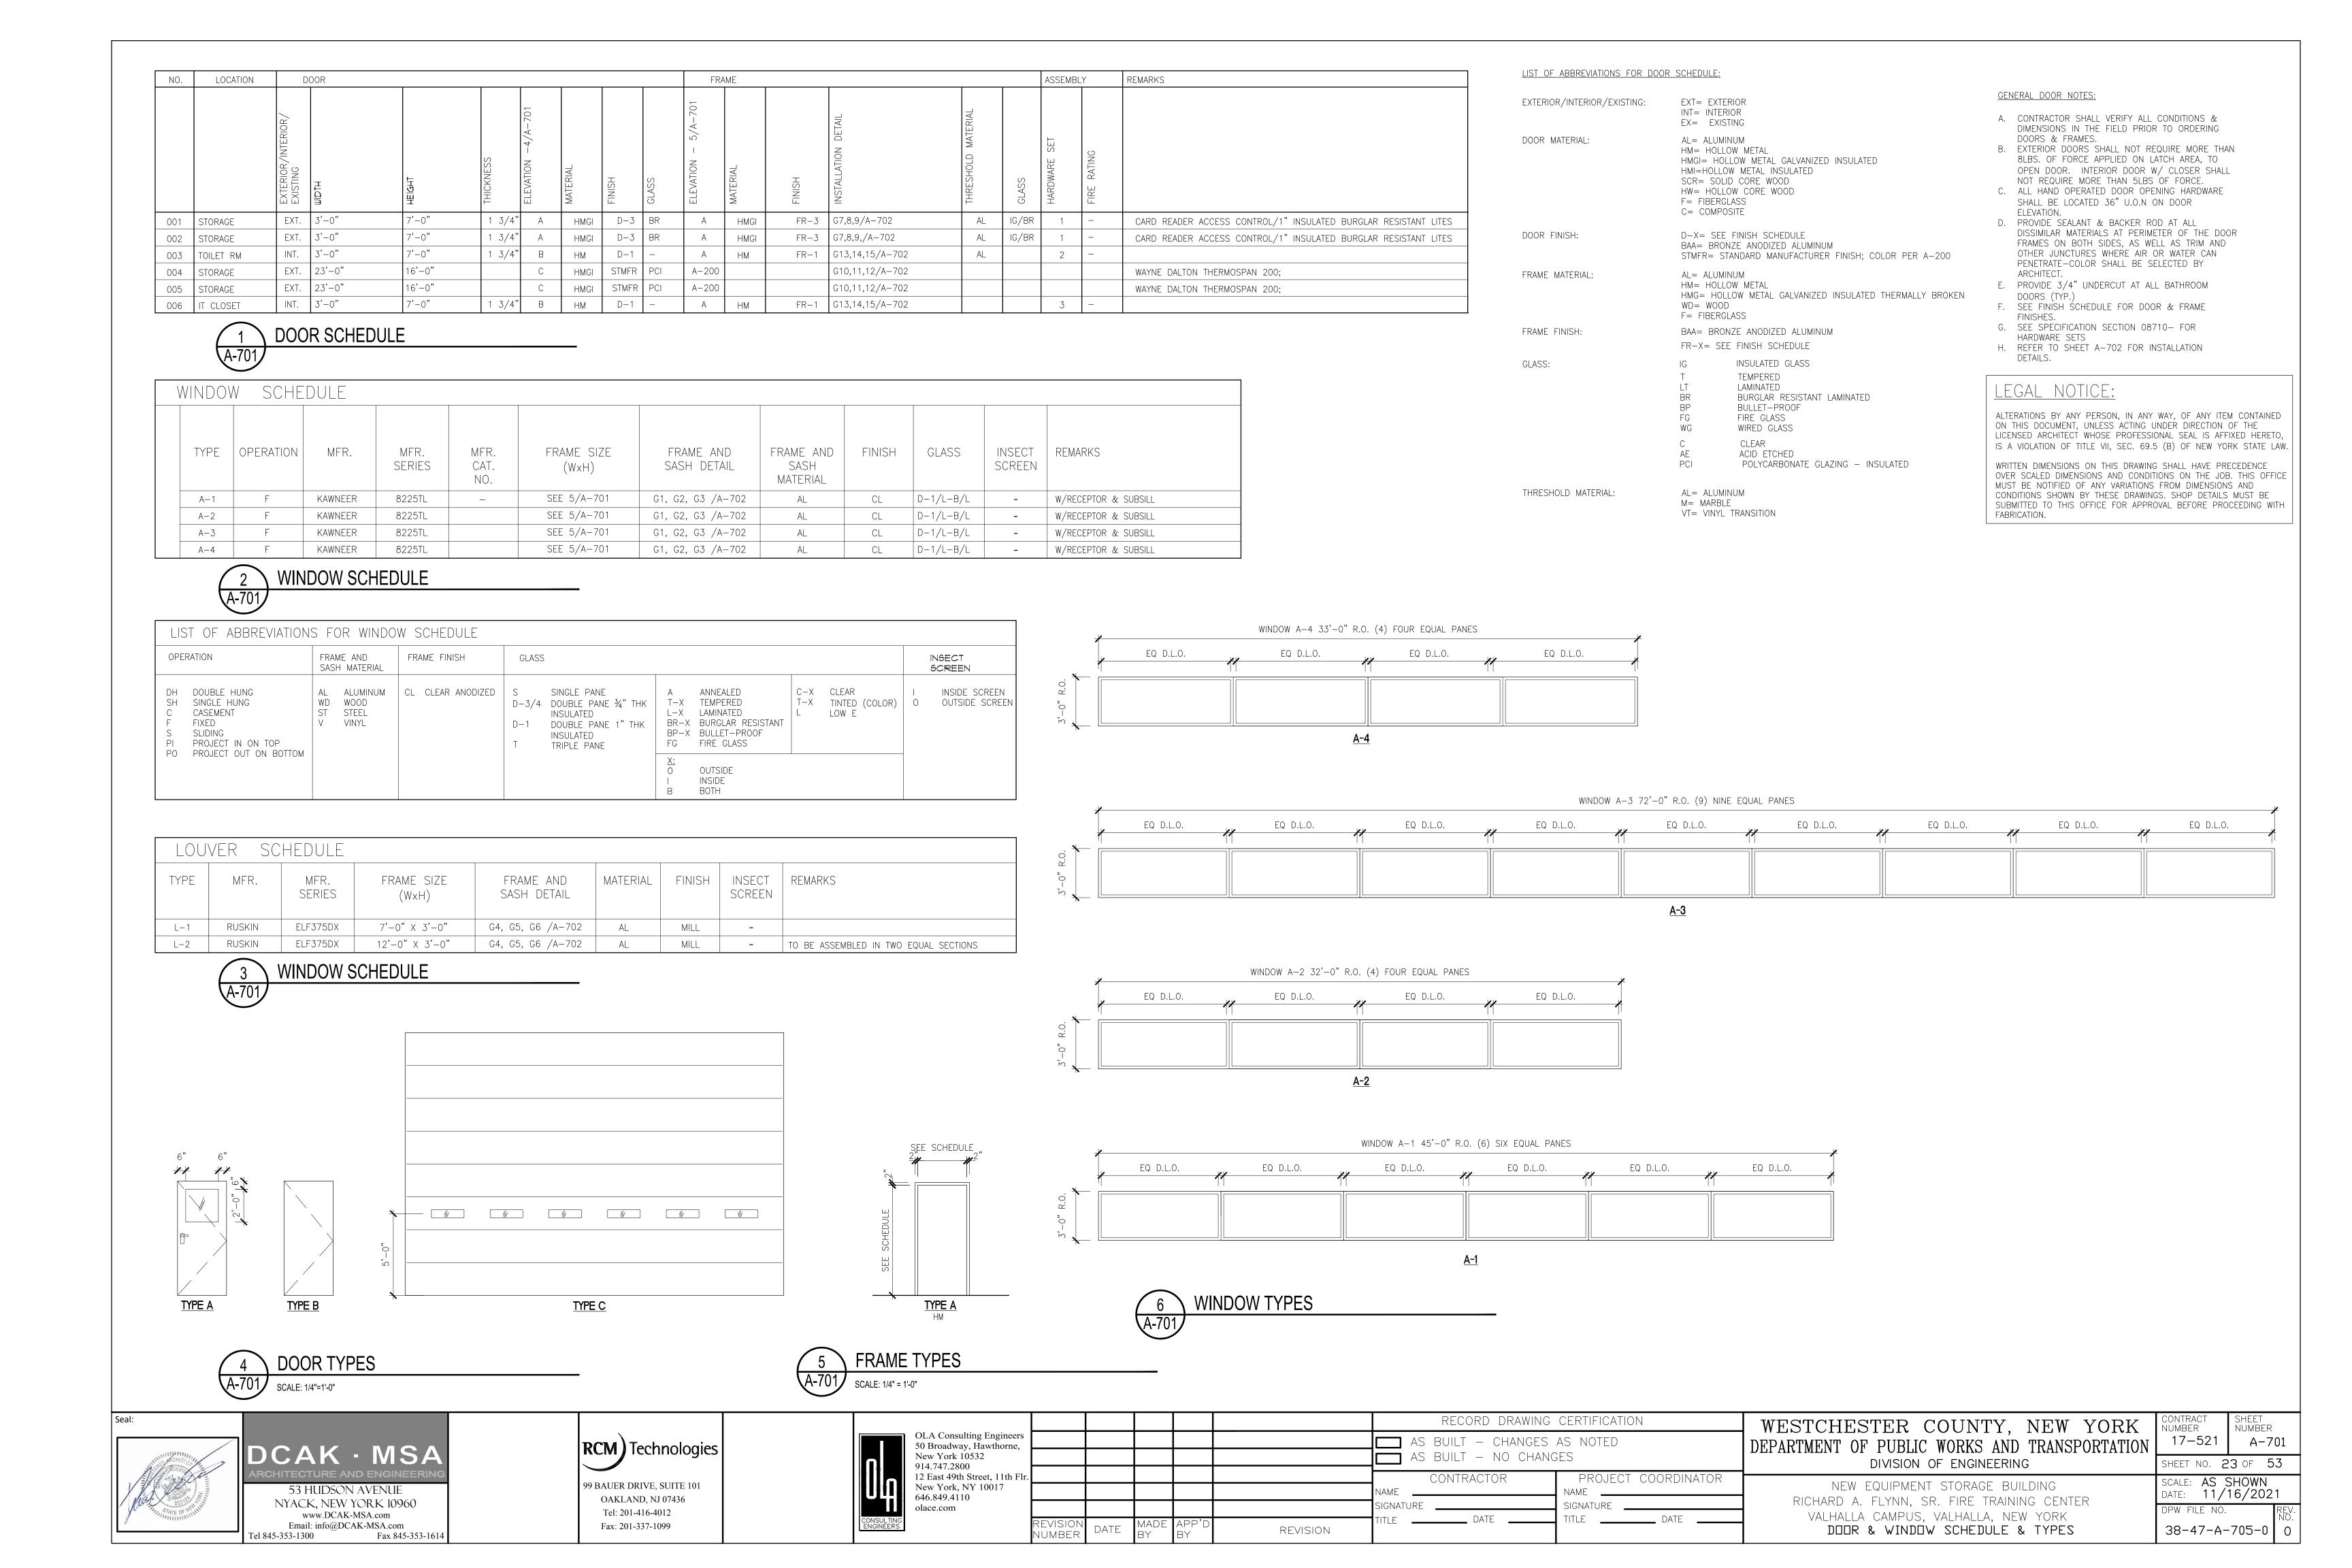NEW EQUIPMENT STORAGE BUILDING RICHARD A. FLYNN, SR. FIRE TRAINING CENTER

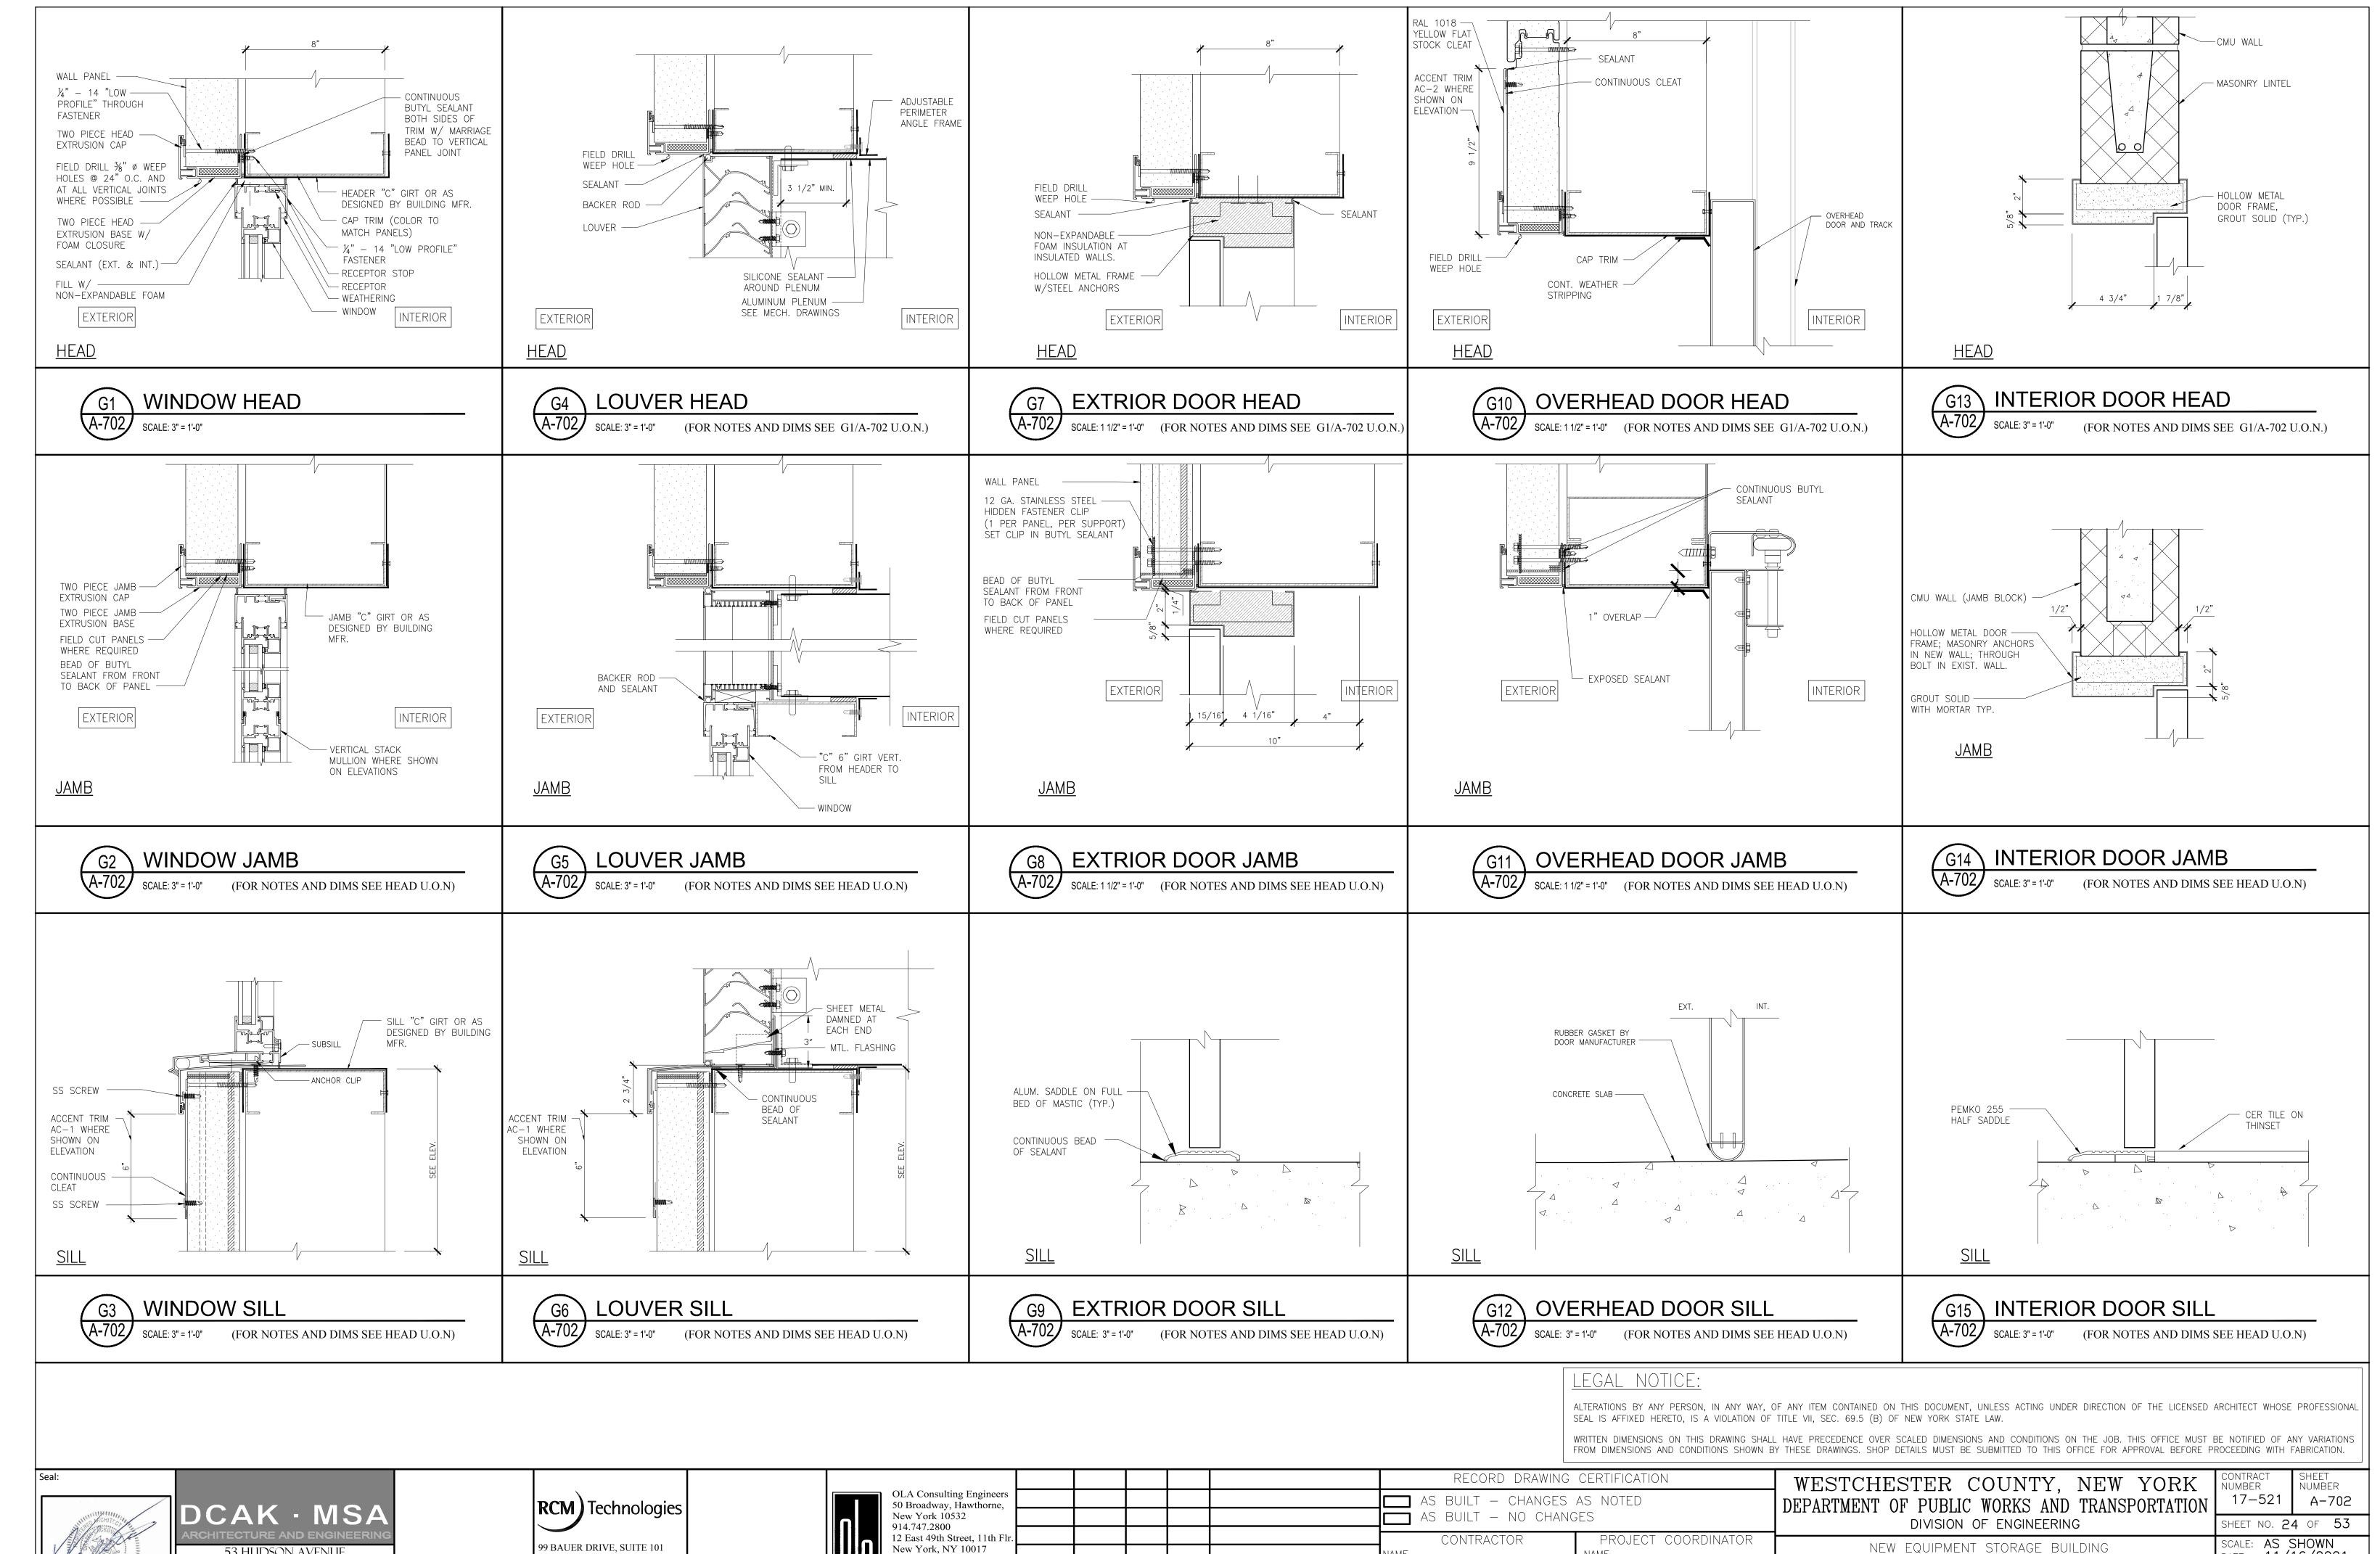VALHALLA CAMPUS, VALHALLA, NEW YORK

DATE: 11/16/2021 38-47-A-706-0 DOOR & WINDOW INSTALLATION DETAILS

FINISH SCHEDULE

RM.#	LOCATION	FLOOR	BASE	WALL	CEILING	REMARKS
001	BATHROOM	CT-1	CT-2	P-1, P-3, CT-3, CT-4	PGWB	WALL SCHEDULE APPLIES TO INTERIOR & EXTERIOR WALL SURFACES EXPOSED TO GARAGE
002	IT CLOSET	VCT-1	VB-1	P-1, P-4	PGWB	WILL SOMEDOLE AND LIES TO INTERNOT A EXTENSIVE SOME TO SANDE
003	STORAGE	SC-1	NB	M-3	M-3	

ACOUSTICAL TILE CEILING NOTE

LAYOUT - CENTER CEILING TO ROOMS OR SPACES. COORDINATE WITH LIGHTING LAYOUT (SEE ELECTRICAL DRAWINGS) IF LIGHT FIXTURE IS IN THE CENTER OF THE ROOM THEN THE CENTER LINE OF ROOM IS AT THE CENTER LINE OF FIXTURE. IF THERE ARE TWO ROWS OF LIGHTS IN THE CENTER OF THE ROOM THEN THE CENTER LINE OF THE ROOM IS CENTERED BETWEEN LIGHTS.

GENERAL FINISH NOTES

A. PROVIDE SMOOTH AND LEVEL TRANSITION BETWEEN DIFFERENT FLOOR MATERIALS.

C. INSTALL FLOORING PRIOR TO INSTALLATION OF CASEWORK & EQUIPMENT

B. EXTEND ROOM FINISHES INTO ADJACENT CLOSETS AND SIMILAR SPACES U.O.N.

E. CERAMIC TILE INSTALLATION: PROCEED IN ACCORDANCE W/ DETAILS AND SPECS OF TCA (TILE COUNCIL OF AMERICA) HAND BOOK FOR CERAMIC TILE INSTALLATION. ALL FLOOR INSTALLATION OVER CONCRETE SLABS SHALL BE IN ACCORDANCE TO

AFET	Y ITEMS EXTERIOR						
P-1	GAS PIPE	TGR-1	TRAFFIC GUARD RAILS (INT. & EXT.)	EC-1	ELECTRIC CONDUIT	CGR-1	CORNER GUARDS & BOLLARDS
2. :	BENJAMIN MOORE	MFR. :	BENJAMIN MOORE	MFR. :	BENJAMIN MOORE	MFR. :	BENJAMIN MOORE
PRIMER SECONI DTM GI THIRD	COAT: COLORTECH ACRYLIC METAL 1 V110 10 COAT: BM UNTRA SPEC HD ACRYLIC 1.OSS HP28 1.COAT: BM UNTRA SPEC HD ACRYLIC 1.OSS HP28 1.OSS HP28	PRIMER 2) SECONI DTM G 3) THIRD	COAT: COLORTECH ACRYLIC METAL 1 V110 D COAT: BM UNTRA SPEC HD ACRYLIC LOSS HP28 COAT: BM UNTRA SPEC HD ACRYLIC LOSS HP28	PRIMER 2) SECONE DTM GL 3) THIRD (COAT: COLORTECH ACRYLIC METAL V110 D COAT: BM UNTRA SPEC HD ACRYLIC LOSS HP28 COAT: BM UNTRA SPEC HD ACRYLIC LOSS HP28	PRIMER 2) SECONI DTM GI 3) THIRD	COAT: COLORTECH ACRYLIC METAL R V110 D COAT: BM UNTRA SPEC HD ACRYLIC LOSS HP28 COAT: BM UNTRA SPEC HD ACRYLIC LOSS HP28
.OR :	SAFETY BLUE 35	COLOR :	RAL 1018 YELLOW	COLOR : S	SAFETY ORANGE 65	COLOR :	RAL 1018 YELLOW

			D. WALL PAINT PATTERN : REFER TO INTE	RIOR ELEVATION 7/A-300					3) THIRD COAT: BM UNTRA SPEC HD ACRYLIC DTM GLOSS HP28 COLOR: SAFETY BLUE 35	THIRD COAT: BM UNTRA SPEC HD ACRYLIC DTM GLOSS HP28 COLOR: RAL 1018 YELLOW	3) THIRD COAT: BM UNTRA SPEC HD ACRYLIC DTM GLOSS HP28 COLOR: SAFETY ORANGE 65	3) THIRD COAT: BM UNTRA SPEC HD ACRYLIC DTM GLOSS HP28 COLOR: RAL 1018 YELLOW
FLOOR FINISHES												
	CT-1 PORCELAIN TILE	SC-1 SEALED CONCRETE										
MFR.: ARMSTRONG MF MODEL: EXCELON SDT MC COLOR: FOSSIL GREY 51956 INSTALLATION: MASTIC CC	TE: 12"X24" TR:: ATLAS CONCORDE DDEL: SEASTONE COLORED IN BODY PORCELEAN DLOR: BLACK ROUT: COLOR TO MATCH TILE	MFR.: SONNEBORN — CONCRETE REPAIR SYTEMS PRODUCT: KURE—N—SEAL WB WATERBORNE ACRYLIC TRANSPARENT CURING, SEALING AND DUSTPROOFING COMPOUND APPLY 2 COATS. COLOR: CLEAR										
WALL BASE										·		
CT-2 BASE PORCELAIN TILE	VB-1 VINYL BASE NB	BASE										
MODEL: SEASTONE MC COLORED IN BODY PORCELEAN CC	TR.: JOHNSONITE DDEL: COVEBASE DLOR: #20 CHARCAOL STALLATION: MASTIC											
WALL FINISHES INTERIOR												
P-1 PAINTED CMU	P-2 PAINTED CONCRETE	P-2A PAINTED CONCRETE	P-3 PAINTED GYPSUM BOARD	P-3A PAINTED GYPS	JM BOARD	P-4 PAINTED PLYWOOD		IWF	 	I		T
MFR.: BENJAMIN MOORE	MFR. : BENJAMIN MOORE	MFR.: BENJAMIN MOORE	MFR. : BENJAMIN MOORE	MFR. : BENJAMIN M		MFR. : BENJAMIN MOORE	N	O WALL	 			<u> </u>
1) FIRST COAT: COROTECH ACRYLIC BLOCK FILLER V 2) SECOND COAT: COROTECH PRE-CATALYZED WATERBORNE EPOXY SEMI-GLOSS V341 3) THIRD COAT: COROTECH PRE-CATALYZED WATERBOEPOXY SEMI-GLOSS V341 COLOR: SEAPEANE OC-19 NOTE:	114 1) FIRST COAT: BENJAMIN MOORE ULTRA SPECE EXTERIOR ACRYLIC HIGH BUILD MASONRY F 2) SECOND COAT: COROTECH PRE—CATALYZED	PRIMER 609 ÉXTERIOR ACRYLIC HIGH BUILD MASONRY PF 2) SECOND COAT: COROTECH PRE-CATALYZED WATERBORNE EPOXY SEMI-GLOSS V341	IMER 609 LATEX PRIMER N534 2) SECOND COAT: BENJAMIN MOORE ULTRA S LATEX EGGSHELL 485	LATEX PRIMER N534 2) SECOND COAT: BENJAN LATEX EGGSHELL 485	MOORE ULTRA SPEC SCUFF-X	1) FIRST COAT: BENJAMIN MOORE LATEX PRIMER N534 2) SECOND COAT: BENJAMIN MOOR LATEX EGGSHELL 487 3) THIRD COAT: BENJAMIN MOORE LATEX EGGSHELL 487 COLOR: SEAPEANE OC-19 NOTE:	ULTRA SPEC 500 INTERIOR RE ULTRA SPEC SCUFF-X	INISH				
WALL FINIOUS WITCHES	•	WALL FINISHED LEVERNOR		·		,	•			•	·	·
WALL FINISHES INTERIOR	CT-4 BULLNOSE PORCELAIN TILE	WALL FINISHES EXTERIOR	P-6 PAINTED BLOCK	BR-1 BRICK BA							T	
CT-3 PORCELAIN TILE SIZE: 12"X24"	SIZE: 3X24"	P-5 PAINTED CONCRETE MFR.: BENJAMIN MOORE	MFR. : BENJAMIN MOORE	BR-1 BRICK BAS					+ +			
MFR.: ATLAS CONCORDE	MFR.: ATLAS CONCORDE		/EXTERIOR 1) FIRST COAT: COROTECH ACRYLIC BLOCK FIL	BUILDING	JK UN EXISTING DES							
MODEL: SEASTONE COLORED IN BODY PORCELEAN	MODEL: SEASTONE COLORED IN BODY PORCELEAN	ACRYLIC HIGH BUILD MASONRY PRIMER NO68										
COLOR: GREY GROUT: COLOR TO MATCH TILE	COLOR: BLACK	2) SECOND COAT: BENJAMIN MOORE ULTRA SPEC EXT SA										
GROUT: COLOR TO WATCH TILE	GROUT: COLOR TO MATCH TILE	3) THIRD COAT: BENJAMIN MOORE ULTRA SPEC EXT SATI		EXT SATIN N446								
CEILING FINISHES												
PGWB PAINTED GYPSUM BOARD	NC NC											
MFR.: BENJAMIN MOORE	NO CEILING FINISH		'									
1) FIRST COAT: BENJAMIN MOORE ULTRA SPEC 500 LATEX PRIMER N534 2) SECOND COAT: BENJAMIN MOORE ULTRA SPEC 50 INTERIOR LATEX FLAT N536 3) THIRD COAT: BENJAMIN MOORE ULTRA SPEC 500 INTERIOR LATEX FLAT N536 COLOR: TBD	0											
SHEEN: SATIN												
DOOR FINISHES INTERIOR		EXTERIOR										
<u> </u>			FR-3 DOOR FRAMES - GALVANIZED. HM									
MFR.: BENJAMIN MOORE PRIMER: (1) COAT – BM SUPER SPEC HP ALKYD METAL PRIMER HP06 FINISH COAT: (2) COATS – BM SUPER SPEC HP D.T.M. ACRYLIC SEMI–GLOSS HP29 COLOR: SHENANDOAH TAUPE AC 36 SHEEN: SEMI–GLOSS		MFR.: BENJAMIN MOORE 1) FIRST COAT: COLORTECH ACRYLIC METAL PRIMER V110 2) SECOND COAT: BM UNTRA SPEC HD ACRYLIC DTM SEMI-GLOSS HP29 3) THIRD COAT: BM UNTRA SPEC HD ACRYLIC DTM SEMI-GLOSS HP29 COLOR: SHENANDOAH TAUPE AC 36	MFR.: BENJAMIN MOORE 1) FIRST COAT: COLORTECH ACRYLIC METAL PRIMER V110 2) SECOND COAT: BM UNTRA SPEC HD ACRYLIC DTM SEMI-GLOSS HP29 3) THIRD COAT: BM UNTRA SPEC HD ACRYLIC DTM SEMI-GLOSS HP29 COLOR: SHENANDOAH TAUPE AC 36									
		SOLON . SHERWINDOWN INCHE NO DO	SOLON . GILLWINDOWN INOIL NO JU						I		<u> </u>	
FINISH OF MISCELLANEOUS ITEM	IS INTERIOR	EXTERIOR										
	M-3 STEEL FRAMES & COLUMNS	M-4 STEEL LINTELS & COLUMNS	M-5 GALVANIZED	M-7	M-8	F-1 ROOF FACIA	RL ROOF ACCESS, LADDER &	LADDER DOOR	1			
MFR. : BENJAMIN MOORE	MFR. : BENJAMIN MOORE	MFR.: BENJAMIN MOORE	MFR. : BENJAMIN MOORE	ALUMINUM GUTTERS & DOWNSPOUTS	ALUMINUM LOUVERS	MFR.: ROOF MANUFACTURER	MFR.: BENJAMIN MOORE			1	1	
1) FIRST COAT: COLORTECH ACRYLIC METAL PRIMER V110 2) SECOND COAT: BM UNTRA SPEC HD ACRYLIC DTM GLOSS HP28 3) THIRD COAT: BM UNTRA SPEC HD ACRYLIC	1) FIRST COAT: COLORTECH ACRYLIC METAL PRIMER 2) SECOND COAT: BM UNTRA SPEC HD ACRYLIC DTM 3) THIRD COAT: BM UNTRA SPEC HD ACRYLIC DTM	PRIMER V110 2) SECOND COAT: BM UNTRA SPEC HD ACRYI DTM SEMI-GLOSS HP29 3) THIRD COAT: BM UNTRA SPEC HD ACRYLIC	´ DTM SEMI-GLOSS HP29 3) THIRD COAT: BM UNTRA SPEC HD ACRYLIC	COLOR : TERRATONE	COLOR: CLEAR ANODIZED ALUMINUM	MODEL: TO MATCH ROOF SYSTEM COLOR: TO MATCH WALL PANELS TYPE P-2	FIRST COAT: COLORTECH ACRYLIC PRIMER V110 2) SECOND COAT: BM UNTRA SPEC DTM GLOSS HP28 3) THIRD COAT: BM UNTRA SPEC H	HD ACRYLIC				
DTM GLOSS HP28 COLOR: TBD	COLOR: SEA PEARL	DTM SEMI-GLOSS HP29	DTM SEMI-GLOSS HP29				DTM GLOSS HP28					
		COLOR: TBD	COLOR: TBD				COLOR: RAL 1018 YELLOW					

Seal:		
A SPOKO	DCAK -	
STATE OF RELIGIO	53 HUDSON NYACK, NEW Y www.DCAK-M Email: info@DCA	ORK 10960 MSA.com K-MSA.com
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CONSULTING ENGINEERS

						RECORD DRAWING	CERTIFICATION	-
OLA Consulting Engineers 50 Broadway, Hawthorne,						AS BUILT — CHANGES	AS NOTED	$\lceil_{ ext{D}}\rceil$
New York 10532 914.747.2800						AS BUILT — NO CHANG	GES	رم
12 East 49th Street, 11th Flr. New York, NY 10017 646.849.4110						CONTRACTOR NAME	PROJECT COORDINATOR NAME	
olace.com						SIGNATURE DATE	SIGNATURE DATE	-
3	REVISION NUMBER	DATE	MADE BY	APP'D BY	REVISION	TITLE DATE	TITLE DATE	

WESTCHESTER COUNTY, NEW YORK PARTMENT OF PUBLIC WORKS AND TRANSPORTATION	CO NU
DIVISION OF ENGINEERING	SH

CONTRACT SHEET NUMBER A-800 SHEET NO. 25 OF 53 SCALE: AS SHOWN DATE: 11/16/2021 NEW EQUIPMENT STORAGE BUILDING RICHARD A. FLYNN, SR. FIRE TRAINING CENTER DPW FILE NO. VALHALLA CAMPUS, VALHALLA, NEW YORK 38-47-A-707-0 FINISH SCHEDULE

GENERAL NOTES:

- 1. ALL WORK SHALL CONFORM TO THE REQUIREMENTS OF THE NEW YORK STATE BUILDING CODE, LATEST EDITION.
- 2. THE CONTRACTOR SHALL VERIFY ALL DIMENSIONS AND CONDITIONS IN THE FIELD PRIOR TO COMMENCING WORK. IT IS THE CONTRACTOR'S RESPONSIBILITY TO NOTIFY THE ENGINEER/ ARCHITECT OF ANY DISCREPANCY THAT MAY EXIST.
- PRINCIPAL OPENINGS THROUGH THE FRAMING ARE SHOWN ON THESE DRAWINGS. PROVIDE ALL OPENINGS REQUIRED BY MECHANICAL, ELECTRICAL, OR PLUMBING TRADES, WHETHER OR NOT SHOWN IN THE STRUCTURAL DRAWINGS. ANY DEVIATION FROM THE OPENINGS SHOWN ON THE STRUCTURAL DRAWINGS SHALL BE BROUGHT TO THE ENGINEER'S ATTENTION FOR REVIEW.
- THE CONTRACTOR SHALL COMPLY WITH ALL APPLICABLE LAWS AND CODES NECESSARY TO ADEQUATELY PROTECT ALL PERSONS PROPERTY FROM INJURY, DAMAGE OR LOSS. HE SHALL INSTALL AND MAINTAIN ALL REASONABLE SAFEGUARDS, NOTICES, BARRIERS, SCAFFOLDING, LADDERS, AND PRECAUTIONS REQUIRED TO PROVIDE ALL PROTECTION.
- 5. THE CONTRACTOR SHALL BE RESPONSIBLE FOR REMOVAL OF ALL DEBRIS FROM THE CONSTRUCTION SITE IMMEDIATELY AFTER COMPLETION OF THEIR WORK IN SAFE AND LEGAL MANNER.
- 6. THE CONTRACTOR SHALL COORDINATE THESE DRAWINGS WITH ALL ARCHITECTURAL AND MECHANICAL DRAWINGS AND COORDINATE THE WORK AMONG THE VARIOUS TRADES.
- ALTERNATE CONNECTION DETAILS MAY BE APPROVED IF SUCH DETAILS ARE SUBMITTED TO THE ENGINEER FOR REVIEW, HOWEVER, THE ENGINEER SHALL BE THE SOLE JUDGE OF ACCEPTABILITY.
- 8. THE CONTRACTOR SHALL BE COMPLETELY RESPONSIBLE FOR THE SAFETY OF ADJACENT STRUCTURES, PROPERTY, HIS WORKMEN, AND THE PUBLIC, AS AFFECTED BY THE CONSTRUCTION OF THIS PROJECT.

FOUNDATION NOTES:

- . THE FOUNDATION DESIGN IS BASED ON BORING AND GEOTECHNICAL REPORTS PERFORMED BY KEVIN L. PATTON, P.E., DATED JANUARY 5, 2018.
- 2. ALL STRUCTURES SHALL BE CARRIED DOWN TO SOIL HAVING A MINIMUM BEARING CAPACITY OF 1.5 TONS PER SQUARE FOOT. ELEVATIONS GIVEN ARE TOP OF CONCRETE & ARE NOT TO BE CONSTRUED AS LIMITING IN ANY WAY THE DEPTH OF EXCAVATION INQUIRED TO REACH GOOD BEARING.
- COMPACT FILL TO 95% OF MAXIMUM DRY DENSITY AT OPTIMUM MOISTURE CONTENT AS DETERMINED BY THE MODIFIED PROCTOR IN ACCORDANCE WITH (ASTM D-1557 OR D-2922) FOR EACH 2000 SQUARE FEET OF EACH LAYER. LOCATION OF TESTS RANDOMLY SELECTED BY TESTING AGENCY.
- 4. EXTERIOR CONSTRUCTION SHALL BE CARRIED DOWN TO A MINIMUM OF 3'-6"BELOW FINISHED EXTERIOR GRADE.
- NO FOUNDATIONS SHALL BE PLACED IN WATER OR ON FROZEN GROUND.
- 6. ALL FOOTING EXCAVATIONS ARE TO BE FINISHED BY HAND.
- UNLESS OTHERWISE NOTED. ALL FOOTINGS AND PILASTERS SHALL BE CENTERED UNDER SUPPORTED MEMBERS.
- 8. WHERE FOUNDATION ELEMENTS ARE TO HAVE FILL ON BOTH SIDES, EACH SIDE SHALL BE FILLED SIMULTANEOUSLY, MAINTAINING A COMMON ELEVATION.
- 9. COORDINATE UNDER FLOOR DRAIN REQUIREMENTS WITH ARCHITECTURAL AND MECHANICAL DRAWINGS AND THE REQUIREMENTS OF THE GEOTECHNICAL ENGINEER.
- 10. CONTRACTOR SHALL PROVIDE CONTINUOUS CONTROL OF SURFACE AND UNDERGROUND WATER AS REQUIRED DURING CONSTRUCTION SUCH THAT THE WORK IS DONE IN A DRY CONDITION. HOWEVER. THE CONTRACTOR SHALL INSURE THAT GROUND WATER LEVELS UNDER ADJACENT STRUCTURES ARE NOT LOWERED BY CONSTRUCTION TECHNIQUES.
- 1. BUILDING WALLS RETAINING EARTH RELY ON THE COMPLETED FLOOR SLABS FOR LATERAL SUPPORT. IF REQUIRED BY THE CONSTRUCTION SEQUENCE. THE CONTRACTOR SHALL TEMPORARILY BRACE ALL BUILDING WALLS AGAINST WHICH BACK FILL IS TO BE PLACED UNTIL ALL FLOOR SLABS SUPPORTING THE WALLS ARE IN PLACE AND HAVE ATTAINED AT LEAST 75% OF THEIR SPECIFIED DESIGN STRENGTH. DESIGN OF TEMPORARY BRACES SHALL BE BY A REGISTERED PROFESSIONAL STRUCTURAL ENGINEER LICENSED BY THE STATE OF NEW YORK.
- 12. IN NO CASE SHALL BULLDOZERS OR OTHER HEAVY EQUIPMENT BE PERMITTED CLOSER THAN 8 FEET FROM ANY FOUNDATION WALL. IF IT IS NECESSARY TO OPERATE SUCH EQUIPMENT CLOSER THAN 8 FEET TO THE WALL, THE CONTRACTOR SHALL BE THE SOLE RESPONSIBLE PARTY AND AT HIS OWN EXPENSE SHALL PROVIDE ADEQUATE SUPPORTS OR BRACE THE WALL TO WITHSTAND THE ADDITIONAL LOADS SUPERIMPOSED FROM SUCH EQUIPMENT.
- 13. THE MAXIMUM SLOPE BETWEEN THE BOTTOMS OF TWO ADJACENT FOOTINGS BEARING ON COMPETENT SOIL SHALL NOT EXCEED 2 HORIZONTAL TO 1 VERTICAL.
- 14. FURNISH AND PLACE ALL SUPPORTS, TEMPORARY AND PERMANENT, WHETHER SHORING, BRACING, NEEDLING, UNDERPINNING, OR SHEET PILING, NECESSARY TO BRACE EXCAVATIONS.

CONCRETE NOTES:

- 1. ALL CONCRETE WORK SHALL CONFORM TO THE LATEST EDITION OF THE ACI BUILDING CODE REQUIREMENTS FOR REINFORCED CONCRETE (ACI 318) AND THE NEW YORK STATE BUILDING CODE. IN CASE OF CONFLICT, THE STATE BUILDING CODE SHALL GOVERN.
- 2. ALL CONCRETE SHALL BE CONTROLLED CONCRETE, MIXED AND PLACED UNDER THE SUPERVISION OF AN APPROVED CONCRETE TESTING AGENCY.
- 3. FOR LOCATIONS LISTED BELOW, CONCRETE SHALL BE NORMAL WEIGHT CONCRETE WITH SAND AND GRAVEL AGGREGATE, TYPE I OR TYPE II PORTLAND CEMENT AND A MINIMUM COMPRESSIVE STRENGTH (f'c) IN 28 DAYS AS FOLLOWS:

4,000 PSI 5,000 PSI SLABS ON GRADE FOUNDATION 4,000 PSI

- 4. ALL CONCRETE SHALL CONTAIN AN AIR ENTRAINMENT ADMIXTURE, AIR CONTENT TO BE 5%± 1%.
- 5. MAXIMUM WATER/CEMENT RATIO FOR SLAB ON GRADE SHALL BE 0.40.
- 6. ALL CONCRETE SHALL BE PLACED WITHOUT HORIZONTAL CONSTRUCTION JOINTS, UNLESS OTHERWISE NOTED. HORIZONTAL WALL REINFORCEMENT SHALL BE CONTINUOUS THROUGH VERTICAL CONSTRUCTION JOINTS.
- 7. CONSTRUCTION JOINT LOCATIONS OTHER THAN SHOWN ON THE DRAWINGS ARE PERMITTED SUBJECT TO PRIOR APPROVAL OF THE ENGINEER. EXPANSION JOINT AND CONTROL JOINT LOCATIONS ARE MANDATORY AS SHOWN. CONTRACTOR SHALL SUBMIT DRAWINGS SHOWING INTENDED PLACING SEQUENCES AND LOCATIONS OF CONSTRUCTIONS JOINTS TO THE ENGINEER FOR APPROVAL. CONSTRUCTION JOINTS SHALL BE LOCATED SO AS TO PROVIDE A 60'-0" MAXIMUM HORIZONTAL LENGTH OF CONCRETE PLACEMENT IN ANY DIRECTION.
- 8. UNLESS OTHERWISE SHOWN ON DRAWINGS, SLABS ON GRADE SHALL BE CAST IN ALTERNATING STRIPS, ONE (1) COLUMN BAY WIDE. ADJACENT SECTIONS SHALL BE PLACED NO SOONER THAN THREE DAYS APART. CONTRACTOR MAY PROPOSE A JOINTING METHOD OR PLACEMENT SCHEDULE THAT VARIES FROM THE FOREGOING FOR THE ENGINEER'S CONSIDERATION
- 9. GROUT UNDER COLUMN BASE PLATES AND UNDER OTHER BEARING PLATES SHALL BE NON-SHRINK, NONMETALLIC GROUT WITH A MINIMUM COMPRESSIVE STRENGTH OF 5000 PSI AT 3 DAYS.
- 10. PIPES OR CONDUITS PLACED IN SLABS ON GRADE SHALL NOT BE PLACED CLOSER THAN 3 DIAMETERS ON CENTERS AND SHALL HAVE AN OUTSIDE DIAMETER LESS THAN 1/3 OF THE SLAB THICKNESS AND BE POSITIONED SO THAT THEY DO NOT INTERFERE WITH SLAB REINFORCEMENT.
- 11. ALL KEYS SHALL BE 2" X 4" (NOMINAL) UNLESS OTHERWISE SHOWN ON THE DRAWINGS.
- 12. CONCRETE CAST ON SLOPED SURFACES SHALL BEGIN AT THE LOWEST ELEVATION AND CONTINUE MONOLITHICALLY TOWARD THE HIGHER ELEVATIONS UNTIL THE INTENDED POUR IS COMPLETED.
- 13. NO CONCRETE SHALL BE CAST BEFORE REVIEW AND APPROVAL OF THE REINFORCING AND EMBEDDED ITEMS HAVE BEEN OBTAINED FROM THE ARCHITECT, OR HIS DESIGNATED REPRESENTATIVE.
- 14. ALL EXPOSED EDGES OF CONCRETE MEMBERS SHALL BE CHAMFERED UNLESS SHOWN OTHERWISE ON THE DRAWINGS.
- 15. CONCRETE MUST REACH THE FOLLOWING PERCENTAGES OF ITS 28-DAY COMPRESSIVE STRENGTH (F'C) BEFORE FORMS OR SHORES MAY BE REMOVED.

WALLS AND BEAM SIDES

- 16. WHERE FINISH IS NOT SPECIFIED, CONFORM TO REQUIREMENTS OF ACI 301 -"SPECIFICATIONS FOR STRUCTURAL CONCRETE FOR BUILDINGS."
- 17. INSTALL DOWELED CONSTRUCTION JOINTS BETWEEN POURS FOR SLABS ON GROUND AND WHERE INDICATED.

REINFORCED MASONRY:

- 1. ALL MASONRY WORK SHALL CONFORM TO THE "BUILDING CODE REQUIREMENTS FOR MASONRY STRUCTURES" (ACI 530-95/ASCE 5-95/TMS 402-95).
- 2. ALL CONCRETE MASONRY UNITS (CMU) SHALL CONFORM TO ASTM C90, LIGHTWEIGHT WITH NET COMPRESSIVE STRENGTH OF 1,900 PSI.
- 3. MORTAR FOR BLOCK WALL CONSTRUCTION SHALL BE TYPE M OR S CONFORMING TO ASTM C270.
- 4. GROUT FOR BLOCK PIERS AND BLOCK WALLS SHALL CONFORM TO ASTM C476 WITH A MINIMUM COMPRESSIVE STRENGTH OF 3000 PSI DETERMINED IN ACCORDANCE WITH THE PROVISIONS OF ASTM C1019.
- 5. REINFORCING BARS SHALL CONFORM TO ASTM A615, GRADE 60, EXCEPT BARS TO BE WELDED SHALL CONFORM TO ASTM A706.
- 6. WIRE FOR JOINT REINFORCING SHALL CONFORM TO ASTM A82, YIELD POINT = 70 KSI (MIN.).

7. UNLESS NOTED OTHERWISE ON PLANS, PROVIDE THE FOLLOWING MINIMUM

REINFORCEMENT: 6" CMU WALL - 3/16" DUR-O-WAL @ 16" O.C. VERTICALLY. 8", 10" AND 12" CMU WALL - HEAVY 3/16" DUR-O-WAL

@ 16 O.C. VERTICALLY.

REINFORCED MASONRY CONTINUED:

- 8. PROVIDE BOND BEAMS WITH 2 #5 CONTINUOUS, AT THE TOP OF WALLS AND PARAPETS. AT EACH FLOOR LEVEL, AND WHERE SHOWN ON THE DRAWINGS.
- 9. UNLESS NOTED OTHERWISE ON THE PLANS OR DETAILS, PROVIDE #4 BARS VERTICAL AT 4-0" ON CENTER IN ALL MASONRY WALLS. AND PROVIDE (1) #4 VERTICAL REINFORCEMENT BAR AT EACH SIDE OF THE MASONRY OPENINGS AND ALT BAR SHOWN FOR THE WALL
- 10.EXTEND ADDITIONAL REINFORCEMENT A MINIMUM OF 36 BAR DIAMETERS BEYOND THE OPENING, UNLESS OTHERWISE NOTED
- 11. THE MINIMUM LENGTH OF LAP FOR REINFORCING BARS EMBEDDED IN GROUT IS 48 BAR DIAMETERS, UNLESS OTHERWISE NOTED ON THE DRAWINGS
- 12. PLACE REINFORCING BARS BEFORE GROUTING. PLACE GROUT IN LIFTS NOT EXCEEDING 5 FEET. CONSOLIDATE EACH LIFT BY MECHANICAL VIBRATION.
- 13. PROPERLY SECURE REINFORCING BARS TO MAINTAIN THE POSITIONS INDICATED ON THE DRAWINGS. BARS TO BE LOCATED IN CENTER OF CELL UNLESS OTHERWISE NOTED.
- 14. ALL CMU SHALL BE BRACED DURING CONSTRUCTION FOR CODE LATERAL DESIGN LOADS UNTIL PERMANENT RESTRAINTS HAVE BEEN INSTALLED.
- 15. FOR ATTACHMENT OF MASONRY DIRECTLY TO STEEL BEAMS OR STEEL COLUMN ANCHORS TO BE HOHMANN & BARNARD 360 HOT GALVANIZED 12 GA. STEEL CHANNELS MINIMUM 8" LONG WELDED TO BEAM OR COLUMN WITH #365 BEND GRIPSTAY ANCHOR 1 1/4" x12 GA. HOT DIPPED GALVANIZED. 4" LONG x1 1/2" HOOK. FILL ALL BLOCK CELLS RECEIVING ANCHORS SOLID WITH GROUT.

REINFORCING NOTES:

- 1. ALL CONCRETE REINFORCING BARS SHALL CONFORM TO ASTM A615. GRADE 60 EXCEPT WHERE NOTED, ALL REINFORCING BARS TO BE WELDED SHALL CONFORM TO ASTM A706. REINFORCING BARS MAY NOT BE WELDED WITHOUT PRIOR APPROVAL OF THE STRUCTURAL ENGINEER.
- 2. ALL WELDED WIRE FABRIC (W.W.F.) SHALL CONFORM TO ASTM 185. (FY=65 KSI MIN.) W.W.F. SHALL BE PROVIDED IN FLAT SHEETS. THE FOLLOWING W.W.F. SHALL BE USED FOR AREAS SPECIFIED BELOW UNLESS OTHERWISE SHOWN ON THE DRAWINGS:

SLAB ON GRADE: $4x4 / W4.0 \times W4.0$

- 3. REINFORCEMENT SHALL BE CONTINUOUS THROUGH ALL CONSTRUCTION JOINTS UNLESS OTHERWISE NOTED ON DRAWINGS.
- 4. DETAILING OF CONCRETE REINFORCEMENT AND ACCESSORIES SHALL BE IN ACCORDANCE WITH ACI 315 - "MANUAL OF STANDARD PRACTICE FOR DETAILING REINFORCED CONCRETE STRUCTURES," LATEST EDITION.
- 5. PROVIDE AND SCHEDULE WITH THE SHOP DRAWINGS. ALL NECESSARY ACCESSORIES TO HOLD REINFORCING SECURELY IN POSITION. MINIMUM REQUIREMENTS SHALL BE:

HIGH CHAIRS 4'-0" ON CENTER SLAB BOLSTERS 4'-0" ON CENTER SUPPORT BARS FOR HIGH CHAIRS NO. 5

- ALL CONTINUOUS REINFORCEMENT SHALL HAVE A MINIMUM LAP AS REQUIRED FOR A CLASS B SPLICE (AC1 318-95, SECTION 12.15.1) UNLESS NOTED OTHERWISE.
- 7. ALL LAPS IN W.W.F. SHALL BE ONE MESH PLUS TWO INCHES AT SPLICES.
- 8. CONCRETE PROTECTION FOR REINFORCEMENT SHALL BE PROVIDED AS FOLLOWS UNLESS OTHERWISE SHOWN ON THE DRAWINGS:
 - A. SURFACES CAST AGAINST EARTH, 3 INCHES
 - B. FORMED SURFACES EXPOSED TO FARTH OR WEATHER #6 THROUGH #18 BARS 2 INCHES #5 BARS AND SMALLER 1 ½ INCHES
 - C. FORMED SURFACES NOT EXPOSED TO EARTH OR WEATHER SLABS, WALLS. 3/4" INCHES BEAMS, COLUMNS 1 1/2 INCHES

D. SLABS ON GRADE

(FROM TOP OF SLAB) 1 ½ INCHES

MAXIMUM DEVIATION FROM THESE REQUIREMENTS SHALL BE ± 1/4 INCH FOR SECTIONS 10 INCHES THICK OR LESS; AND ± ½ INCH FOR SECTIONS OVER 10 INCHES THICK. SEE ACI 318-89, SECTION 7.7.1 FOR CONDITIONS NOT LISTED.

- 9. ALL HOOKS SHOWN ON DRAWINGS SHALL BE STANDARD HOOKS UNLESS NOTED OTHERWISE.
- 10. WHERE CONTINUOUS BARS ARE CALLED FOR. THEY SHALL RUN CONTINUOUSLY AROUND CORNERS AND BE LAPPED AT NECESSARY SPLICES, OR HOOKED AT DISCONTINUOUS ENDS. LAP LENGTHS SHALL BE AS GIVEN IN THE SPLICE AND DEVELOPMENT TABLE. LAP BEAM TOP BARS AT MID-SPAN AND BEAM BOTTOM BARS AT SUPPORTS. UNLESS OTHERWISE NOTED.
- 11. PROVIDE ADDITIONAL REINFORCING AT THE SIDES AND CORNERS OF ALL OPENINGS IN CONCRETE IN ACCORDANCE WITH THE TYPICAL DETAILS. MINIMUM ADDITIONAL REINFORCING SHALL BE AS FOLLOWS:
 - 2 #5 TOP AND BOTTOM IN SLABS

2 - #5 EACH FACE IN WALLS

2 - #5 X 4' - 0" LONG DIAGONALLY EACH CORNER OF OPENING

EXTEND BARS A MINIMUM OF 2' - 0" BEYOND OPENING PROVIDE HOOK WHERE EXTENSION IS NOT POSSIBLE.

SPECIAL INSPECTION:

- 1. OWNER SHALL RETAIN SERVICES OF PROFESSIONAL ENGINEER LICENSED IN THE STATE OF NEW YORK TO PERFORM ALL SPECIAL INSPECTIONS.
- 2. ALL SPECIAL INSPECTIONS SHALL BE PERFORMED BY OR UNDER THE DIRECT SUPERVISION OF A LICENSED PROFESSIONAL ENGINEER AS DEFINED BY CHAPTER 17 CODE OF NEW YORK STATE.
 - 3. STRUCTURAL TESTS AND INSPECTIONS DEFINED BY THE NYS CODE, CHAPTER 17 AND AS REQUIRED IN THIS SECTION SHALL BE PERFORMED BY A SPECIAL INSPECTOR HIRED BY OWNER. COPIES OF ALL REPORTS SHALL BE PROVIDED TO THE CODE ENFORCEMENT OFFICIAL AND THE REGISTERED DESIGN PROFESSIONALS (ARCHITECT AND STRUCTURAL ENGINEER).

MATERIAL VERIFICATION:

.PERIODIC .PERIODIC WELD RODS **FABRICATION:** VERIFICATION OF FABRICATION AND QUALITY CONTROL PROCEDURES PER SECTION 1704.2

INSTALLATION: BOLTS SHALL BE INSPECTED IN ACCORDANCE WITH AISC SPECIFICATION BEARING TYPE ..PERIODIC ..CONTINUOUS SLIP CRITICAL.

WELDING SHALL BE INSPECTED IN ACCORDANCE WITH AWS D1.1

STEEL FRAME INSTALLATION SHALL BE PERIODICALLY INSPECTED FOR CONFORMANCE WITH THE APPROVED CONSTRUCTION DRAWINGS

REINFORCING STEEL PLACEMENT: SLABS ON GRADE, METAL DECK. .PERIODIC FOOTING PIERS & FOUNDATION WALLS... ..PERIODIC .CONTINUOUS ELEVATED STRUCTURAL SLAB. ANCHOR BOLT INSTALLATION. ..CONTINUOUS ..PERIODIC USE OF DESIGN MIX. SAMPLE OF CONCRETE .CONTINUOUS .. CONTINUOUS CONCRETE PLACEMENT CONCRETE CURING. ..PERIODIC

SUBGRADE SOILS AND FILL SHALL BE INSPECTED IN ACCORDANCE SECTION 1704.7 AND TABLE 1704.7

STRUCTURAL DESIGN CRITERIA

1. CODES AND STANDARDS:

A. "NEW YORK STATE BUILDING CODE, 2020" (IBC 2018). B. "AMERICAN SOCIETY OF CIVIL ENGINEERS ASCE 7-16".

DESIGN LOADS:

1. <u>DEAD LOADS</u>

5 PSF FRAMING DECK 3 PSF 1 PSF INSULATION 2 PSF 11 PSF **CEILING**

2. LIVE LOADS 20 PSF **ROOFS**

GROUND SNOW LOAD Pg = 30 PSFROOF SNOW LOAD Pf = 21 PSF

3. SNOW LOAD (REFER SECTION 1608 OF N.Y.S.B.C.)

4. WIND LOAD (REFERS SECTION 1609 OF N.Y.S.B.C.):

BASIC WIND SPEED **EXPOSURE CATEGORY**

5. SEISMIC LOAD (REFERS CHAPTER 11-12 OF ASCE/SEI 7-16):

120 MPH

SEISMIC SITE CLASS SEISMIC OCCUPANCY CATEGORY: 0.270 g 0.072 gS1: SDS: $2/3 \times 1.6 \times 0.239 =$ 0.285 g SD1: $2/3 \times 2.4 \times 0.066 =$ 0.115 g SEISMIC DESIGN CATEGORY:

6. OTHER 7 PSF COLLATERAL SOLAR PANELS 6 PSF 5 PSF ROOF TOP

7. RISK CATEGORY

LEGAL NOTICE:

ALTERATIONS BY ANY PERSON, IN ANY WAY, OF ANY ITEM CONTAINED ON THIS DOCUMENT, UNLESS ACTING UNDER DIRECTION OF THE LICENSED ARCHITECT WHOSE PROFESSIONAL SEAL IS AFFIXED HERETO, IS A VIOLATION OF TITLE VII, SEC. 69.5 (B) OF NEW YORK STATE LAW.

WRITTEN DIMENSIONS ON THIS DRAWING SHALL HAVE PRECEDENCE OVER SCALED DIMENSIONS AND CONDITIONS ON THE JOB. THIS OFFICE MUST BE NOTIFIED OF ANY VARIATIONS FROM DIMENSIONS AND CONDITIONS SHOWN BY THESE DRAWINGS. SHOP DETAILS MUST BE SUBMITTED TO THIS OFFICE FOR APPROVAL BEFORE PROCEEDING WITH FABRICATION.

DRAWING LIST:

STRUCTURAL NOTES FO-100

FOUNDATION PLAN

FOUNDATION SECTIONS & DETAILS. SHEET 1 OF 2 F0-200 FOUNDATION SECTIONS & DETAILS, SHEET 2 OF 2

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TI	REVISION	APP'D BY	MADE BY	DATE	REVISION NUMBER

RECORD DRAWING CERTIFICATION AS BUILT — CHANGES AS NOTED AS BUILT - NO CHANGES CONTRACTOR PROJECT COORDINATOR NAME

SIGNATURE __

TITLE _____ DATE

WESTCHESTER COUNTY, NEW YORK DEPARTMENT OF PUBLIC WORKS AND TRANSPORTATION DIVISION OF ENGINEERING


NEW EQUIPMENT STORAGE BUILDING RICHARD A. FLYNN, SR. FIRE TRAINING CENTER VALHALLA CAMPUS, VALHALLA, NEW YORK STRUCTURAL NOTES


17-521 N-100 SHEET NO. **26** OF **53** SCALE: **AS SHOWN** DATE: 11/8/2021

SHEET NUMBER

CONTRACT NUMBER

DPW FILE NO. 38-47-S-708-0 0

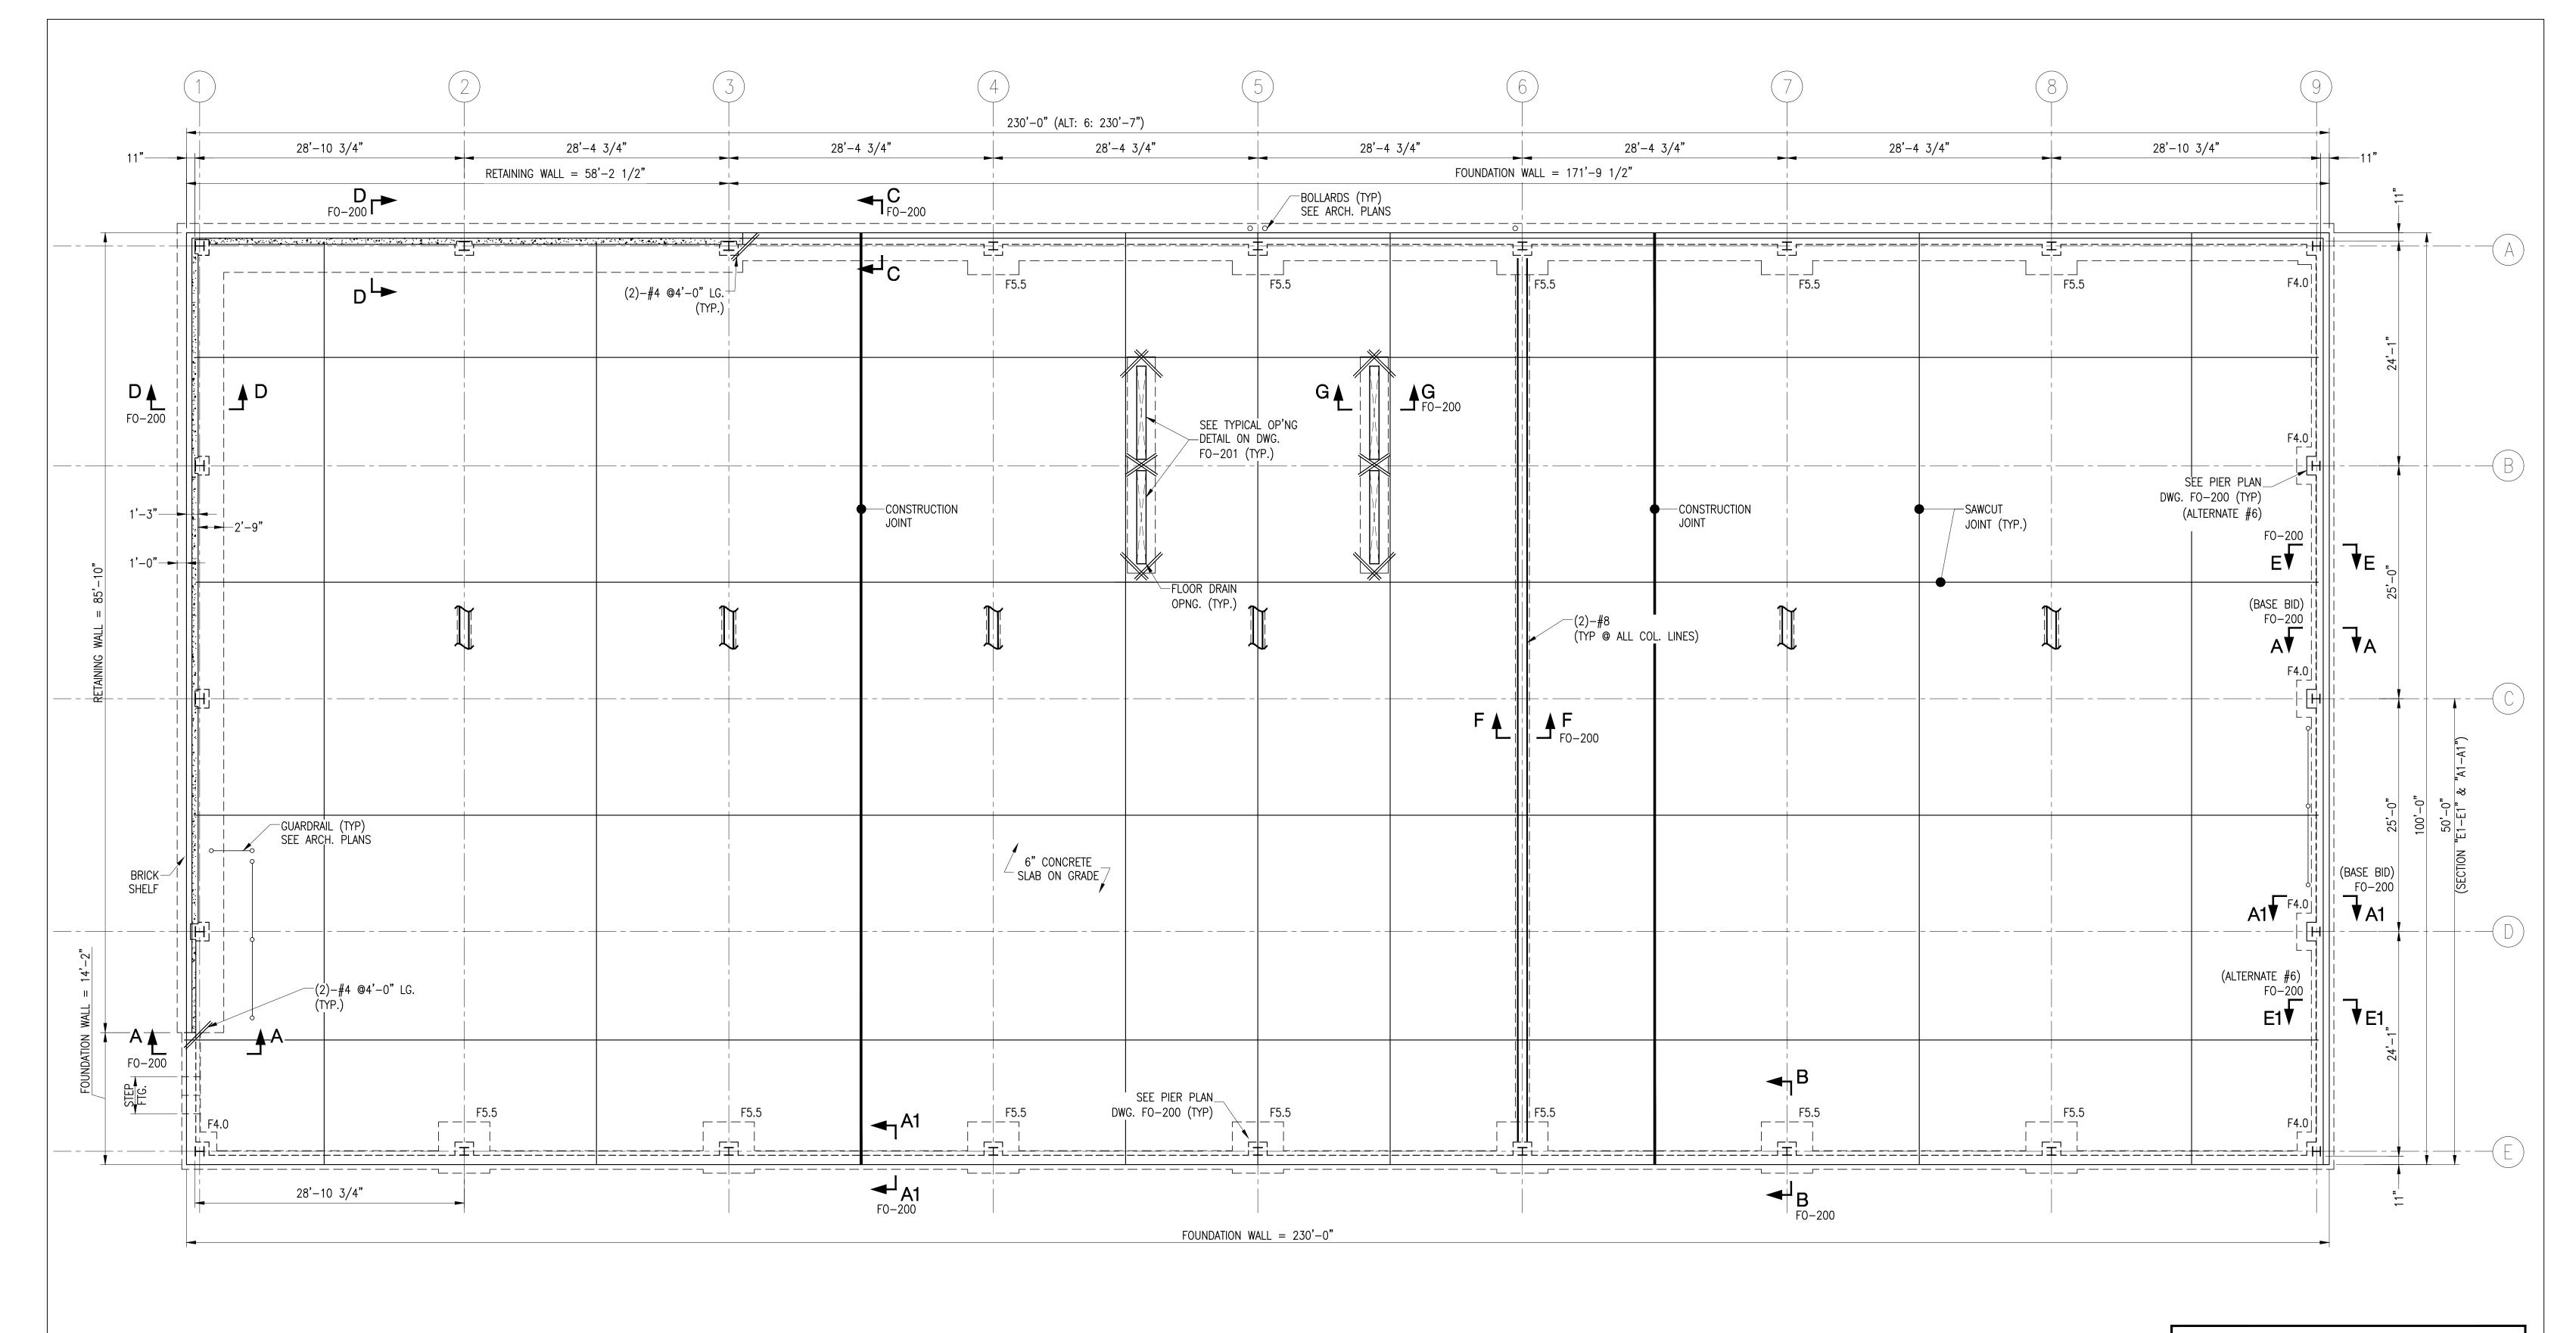

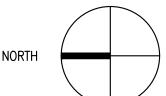

FOUNDATION PLAN SCALE: 1/8" =1'-0"

- 1. FLOOR CONSTRUCTION SHALL BE 6" THICK CONCRETE
- SLAB WITH W.W.F. 4x4 W4.0 x W4.0.
- 2. TOP OF SLAB ELEVATION 0'-0" U.O.N. (UNLESS OTHERWISE NOTED). 3. FX.X - INDICATES FOOTING TYPE. FOR SIZE AND REINFORCEMENT SEE FOOTING SCHEDULE.
- 4. [X'-X"] INDICATES BOTTOM OF FOOTING ELEVATION BELOW TOP OF FINISH GROUND FLOOR.
- 5. CENTERLINE OF FOOTING SHALL BE AT CENTERLINE OF COLUMN U.N.O.
- 6. FOR NOTES SEE DWG. N-100.
- 7. FOR DETAILS AND SECTIONS SEE DWG. FO-200.
- 8. ALL SLABS TO BE OVER FOUNDATION WALL, COORDINATE TOP OF FOUNDATION WALL WITH ARCH. DWGS. SEE DETAILS ON DWG. FO-200.
- 9. FOR TOP OF EXTERIOR CONCRETE FOUNDATION WALL SEE DWG. FO-200.
- 10. COORDINATE COLUMN LOCATIONS WITH FABRICATOR.

FOOTING SCHEDULE									
DESIGNATION		SIZE		DEINICODOEMENT					
DESIGNATION	LENGTH	WIDTH	DEPTH	REINFORCEMENT					
F4.0	4'-0"	4'-0"	1'-4"	(5) #5 E.W. TOP & BOTTOM					
F5.5	5'-6"	5'-6"	1'-4"	(7) #5 E.W. TOP & BOTTOM					
NOTES: 1. FOOTING DESIGN BASED ON 1.5 TSF BEARING.									

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WRITTEN DIMENSIONS ON THIS DRAWING SHALL HAVE PRECEDENCE OVER SCALED DIMENSIONS AND CONDITIONS ON THE JOB. THIS OFFICE MUST BE NOTIFIED OF ANY VARIATIONS FROM DIMENSIONS AND CONDITIONS SHOWN BY THESE DRAWINGS. SHOP DETAILS MUST BE SUBMITTED TO THIS OFFICE FOR APPROVAL BEFORE PROCEEDING WITH FABRICATION.


CONTRACT NUMBER

SHEET NUMBER

17-521 F0-100



RCM) Technologies 99 BAUER DRIVE, SUITE 101 OAKLAND, NJ 07436 Tel: 201-416-4012 Fax: 201-337-1099

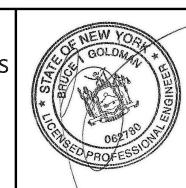

CONSULTING	OLA Consulting Engin 50 Broadway, Hawthor New York 10532 914.747.2800 12 East 49th Street, 11t New York, NY 10017 646.849.4110 olace.com
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OLA Consulting Engineers	
50 Broadway, Hawthorne,	L
New York 10532	
914.747.2800	⊢
12 East 49th Street, 11th Flr.	
New York, NY 10017	
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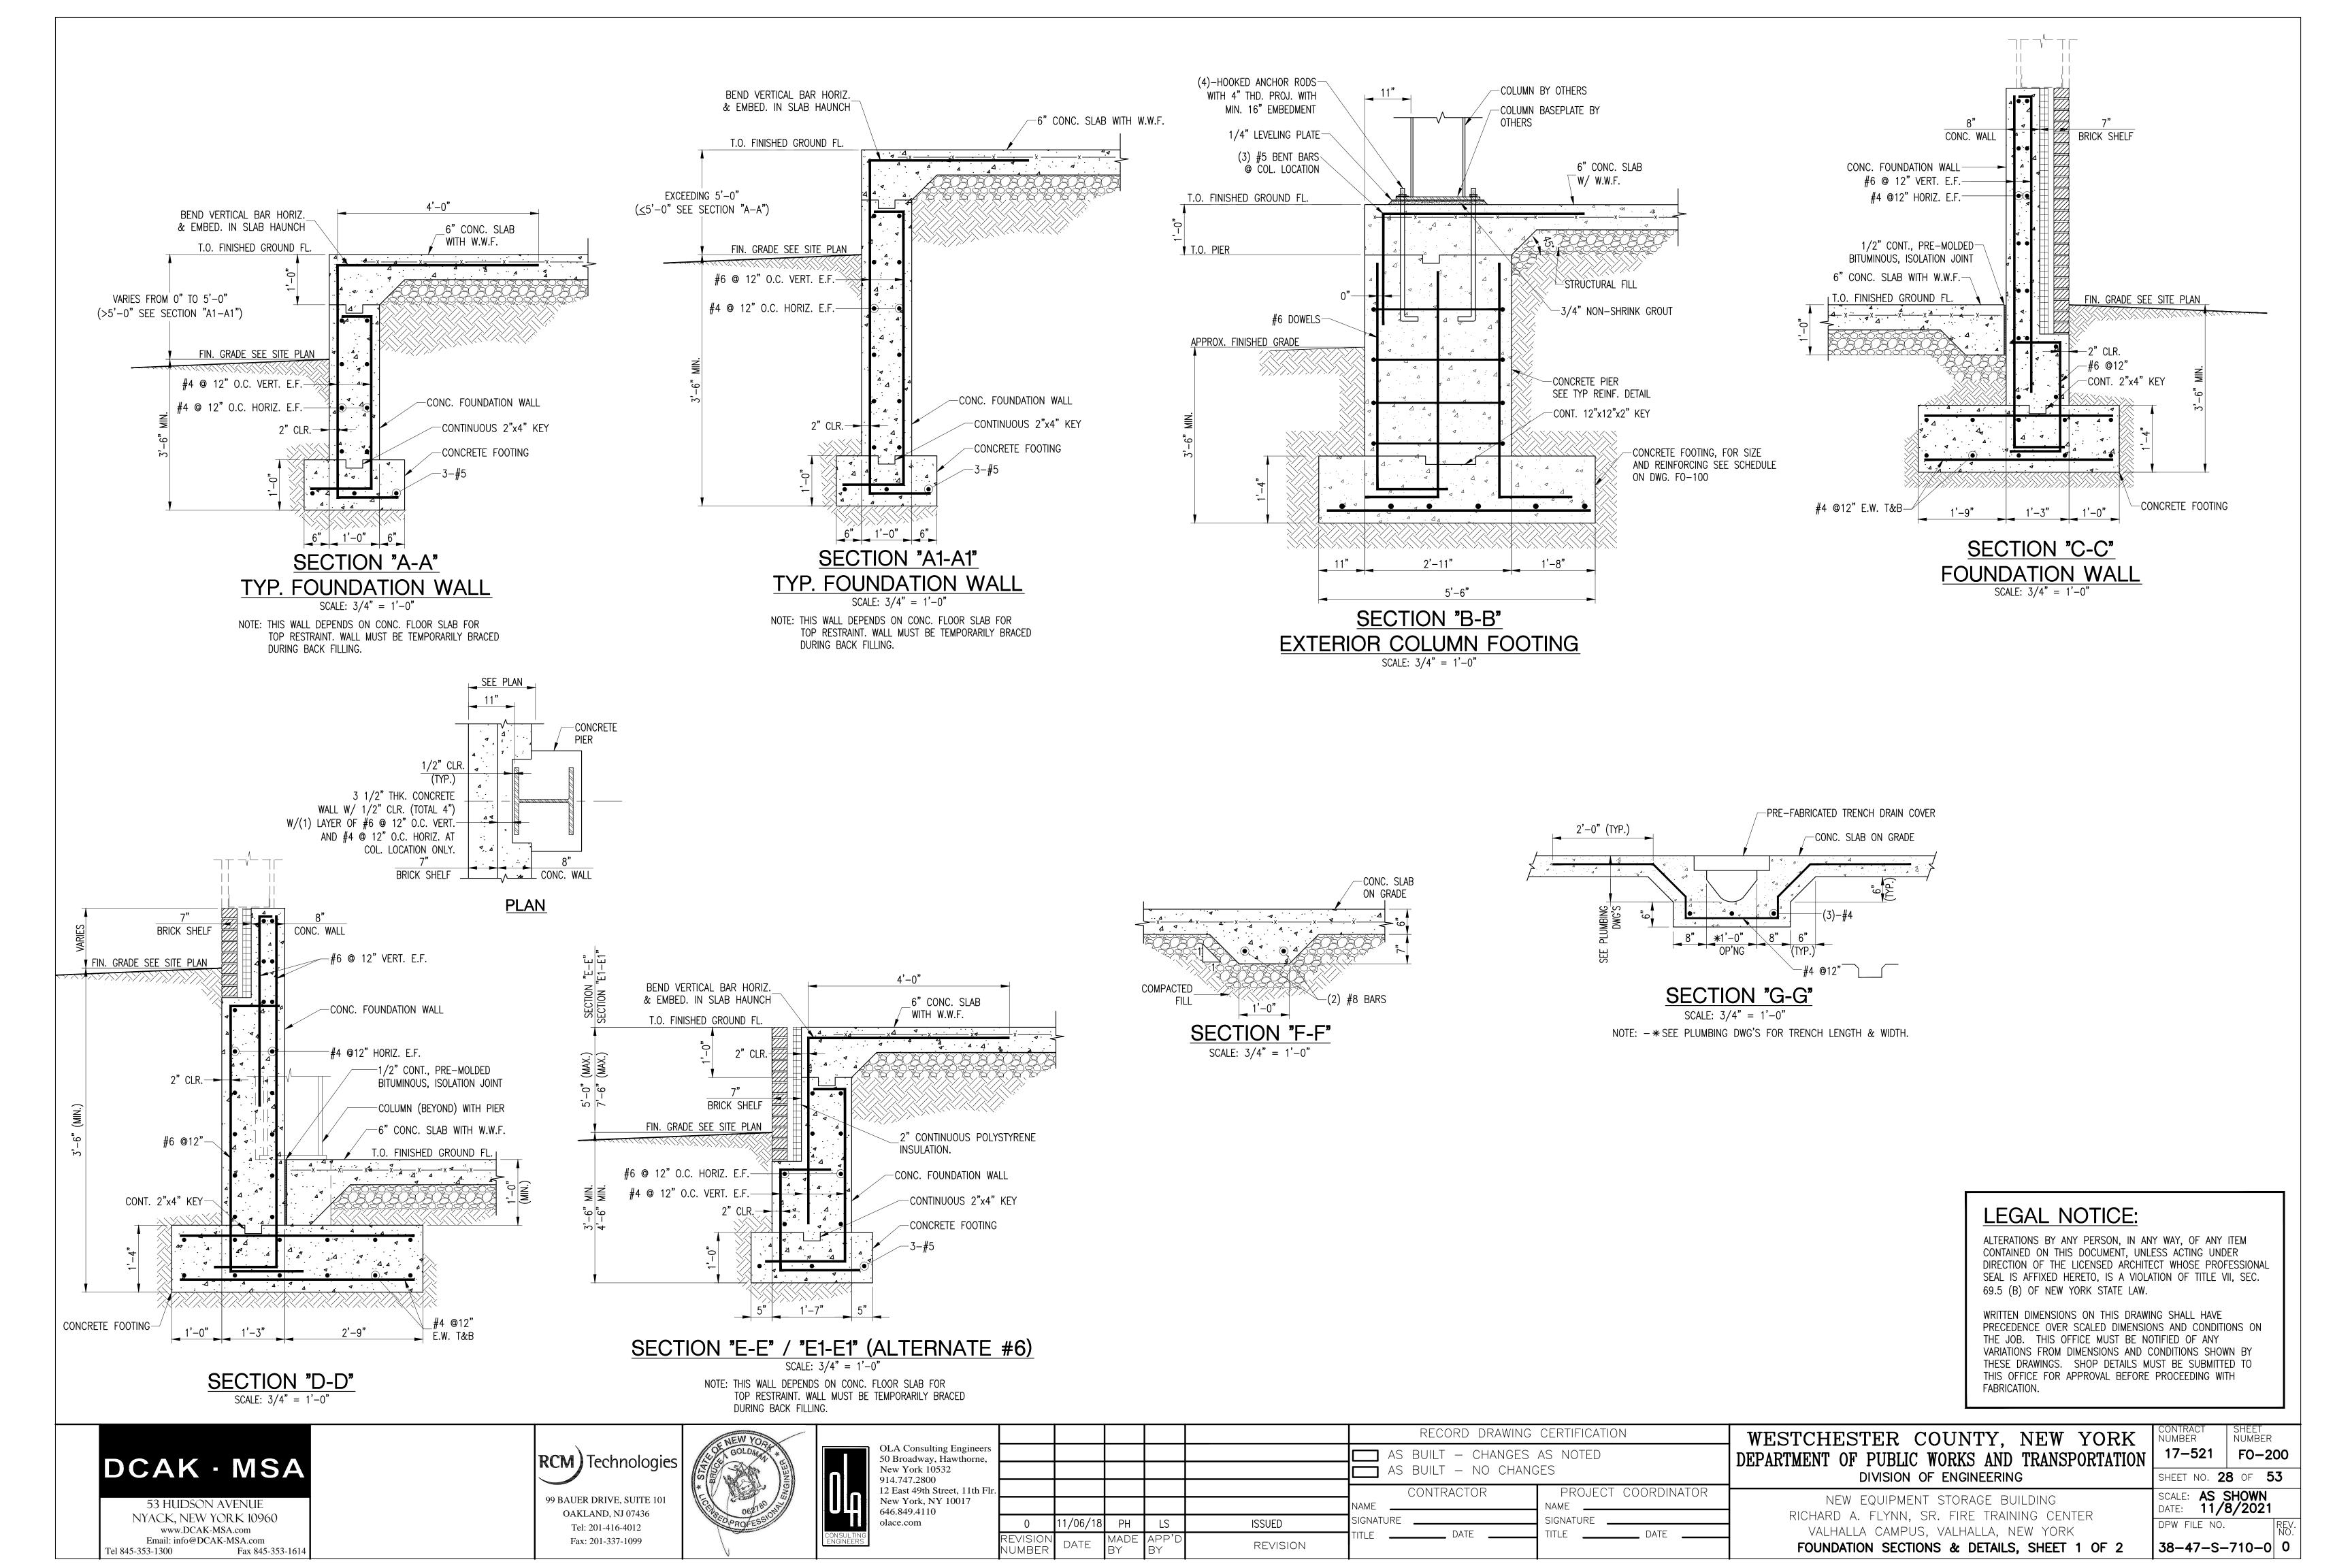
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						AS BUILT — NO CHANGES
lr.						CONTRACTOR PROJECT COORDINAT
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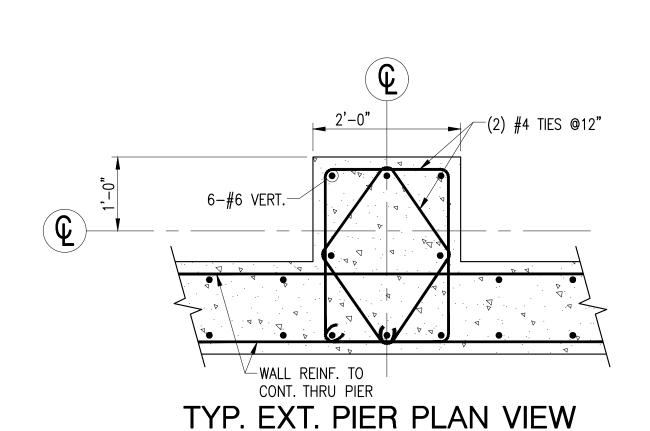
REVISION

WESTCHESTER COUNTY, NEW YORK DEPARTMENT OF PUBLIC WORKS AND TRANSPORTATION DIVISION OF ENGINEERING


SHEET NO. **27** OF **53** SCALE: **AS SHOWN** DATE: **11/8/2021** DPW FILE NO. 38-47-S-709-0 0


NEW EQUIPMENT STORAGE BUILDING RICHARD A. FLYNN, SR. FIRE TRAINING CENTER VALHALLA CAMPUS, VALHALLA, NEW YORK FOUNDATION PLAN






SCALE: 3/4" = 1'-0"(PIER SIZE TO BE VERIFIED, BASED ON BLDG. MANUF. DWG'S)

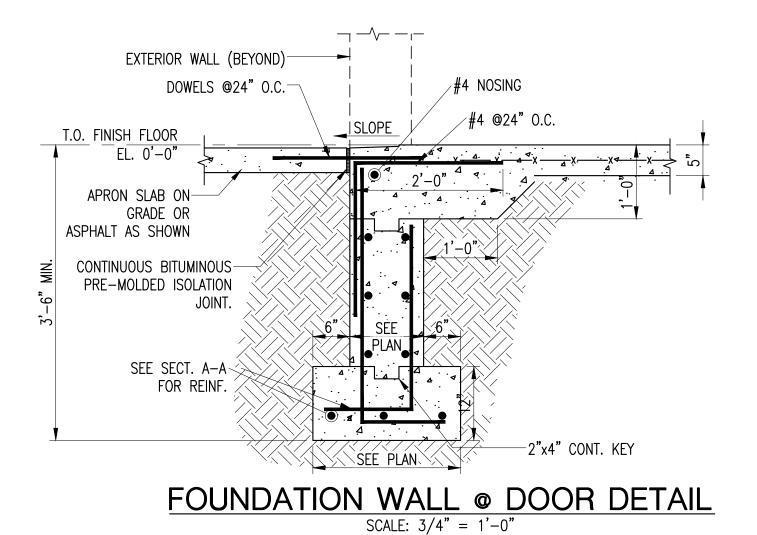

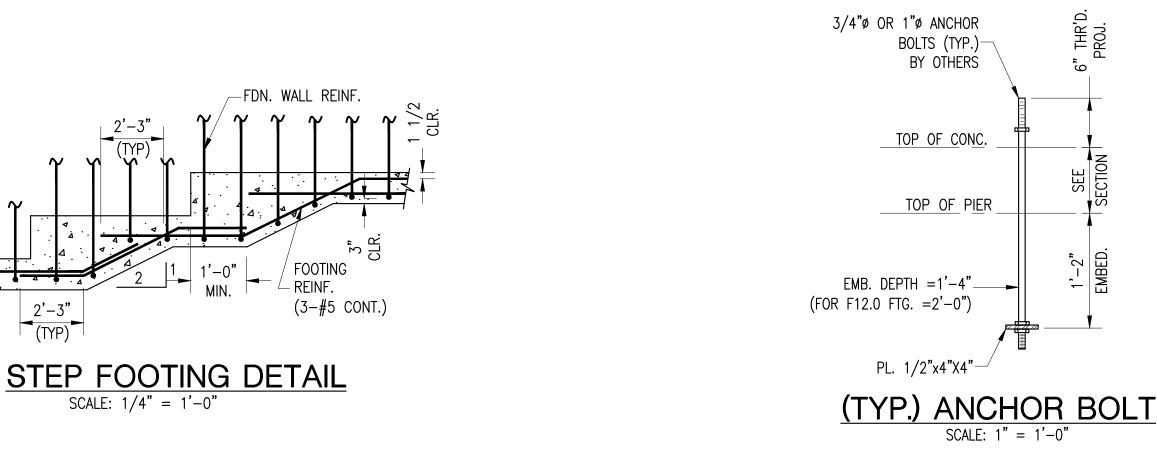


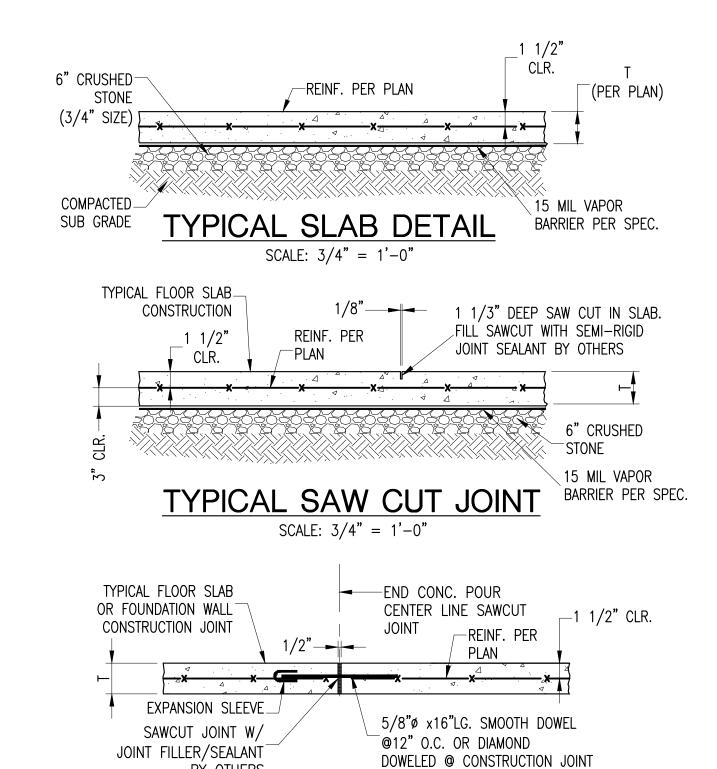


TYPICAL CONSTRUCTION JOINT

SCALE: 3/4" = 1'-0"


BY OTHERS

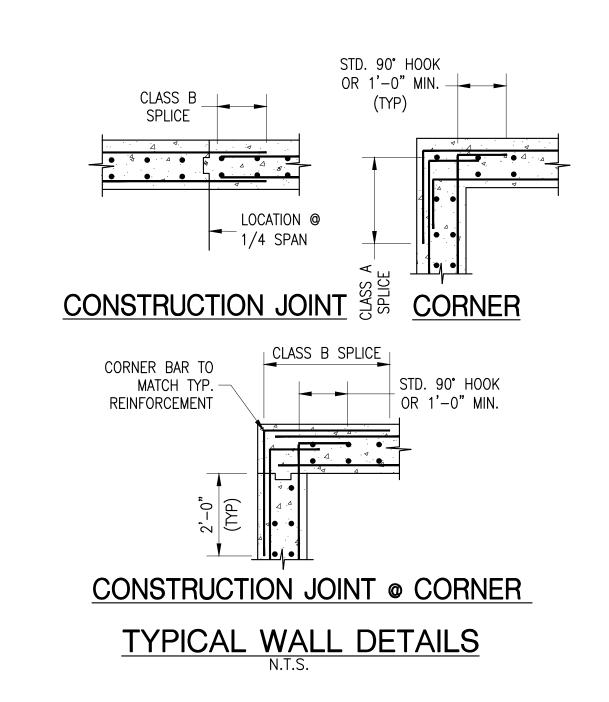

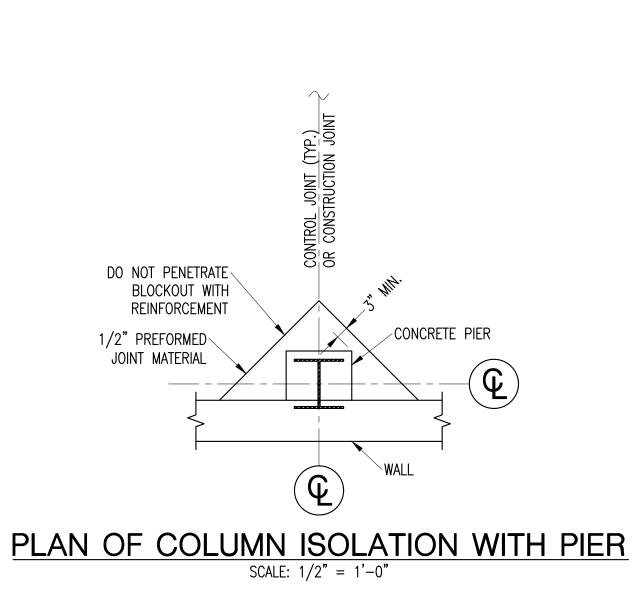

SIGNATURE

_____ DATE

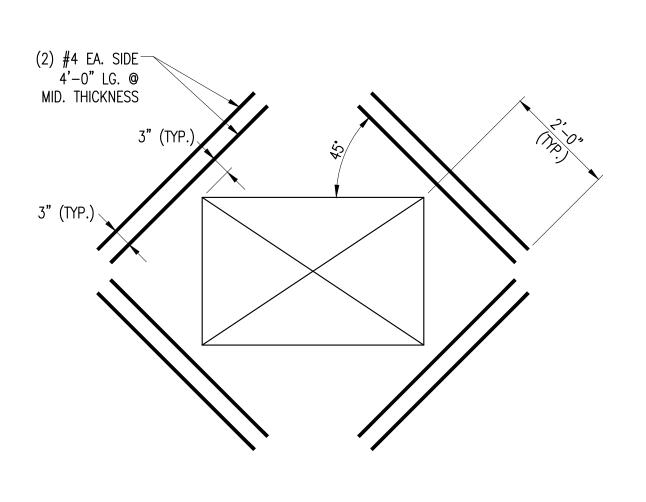

SLAB OPENING REINF. DETAIL SCALE: 3/4" = 1'-0"

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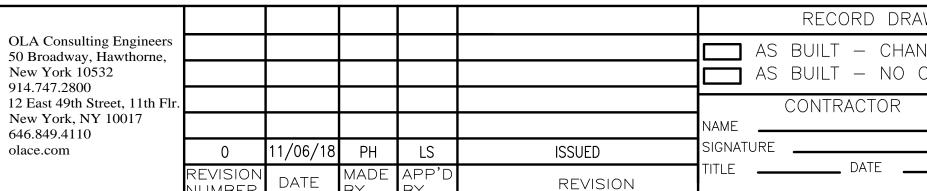
WRITTEN DIMENSIONS ON THIS DRAWING SHALL HAVE PRECEDENCE OVER SCALED DIMENSIONS AND CONDITIONS ON THE JOB. THIS OFFICE MUST BE NOTIFIED OF ANY VARIATIONS FROM DIMENSIONS AND CONDITIONS SHOWN BY THESE DRAWINGS. SHOP DETAILS MUST BE SUBMITTED TO THIS OFFICE FOR APPROVAL BEFORE PROCEEDING WITH FABRICATION.











RECORD DRAWING CERTIFICATION WESTCHESTER COUNTY, NEW YORK AS BUILT — CHANGES AS NOTED DEPARTMENT OF PUBLIC WORKS AND TRANSPORTATION ____ AS BUILT — NO CHANGES DIVISION OF ENGINEERING PROJECT COORDINATOR NEW EQUIPMENT STORAGE BUILDING NAME RICHARD A. FLYNN, SR. FIRE TRAINING CENTER

VALHALLA CAMPUS, VALHALLA, NEW YORK

SHEET NO. **29** OF **53** DPW FILE NO. FOUNDATION SECTIONS & DETAILS, SHEET 2 OF 2


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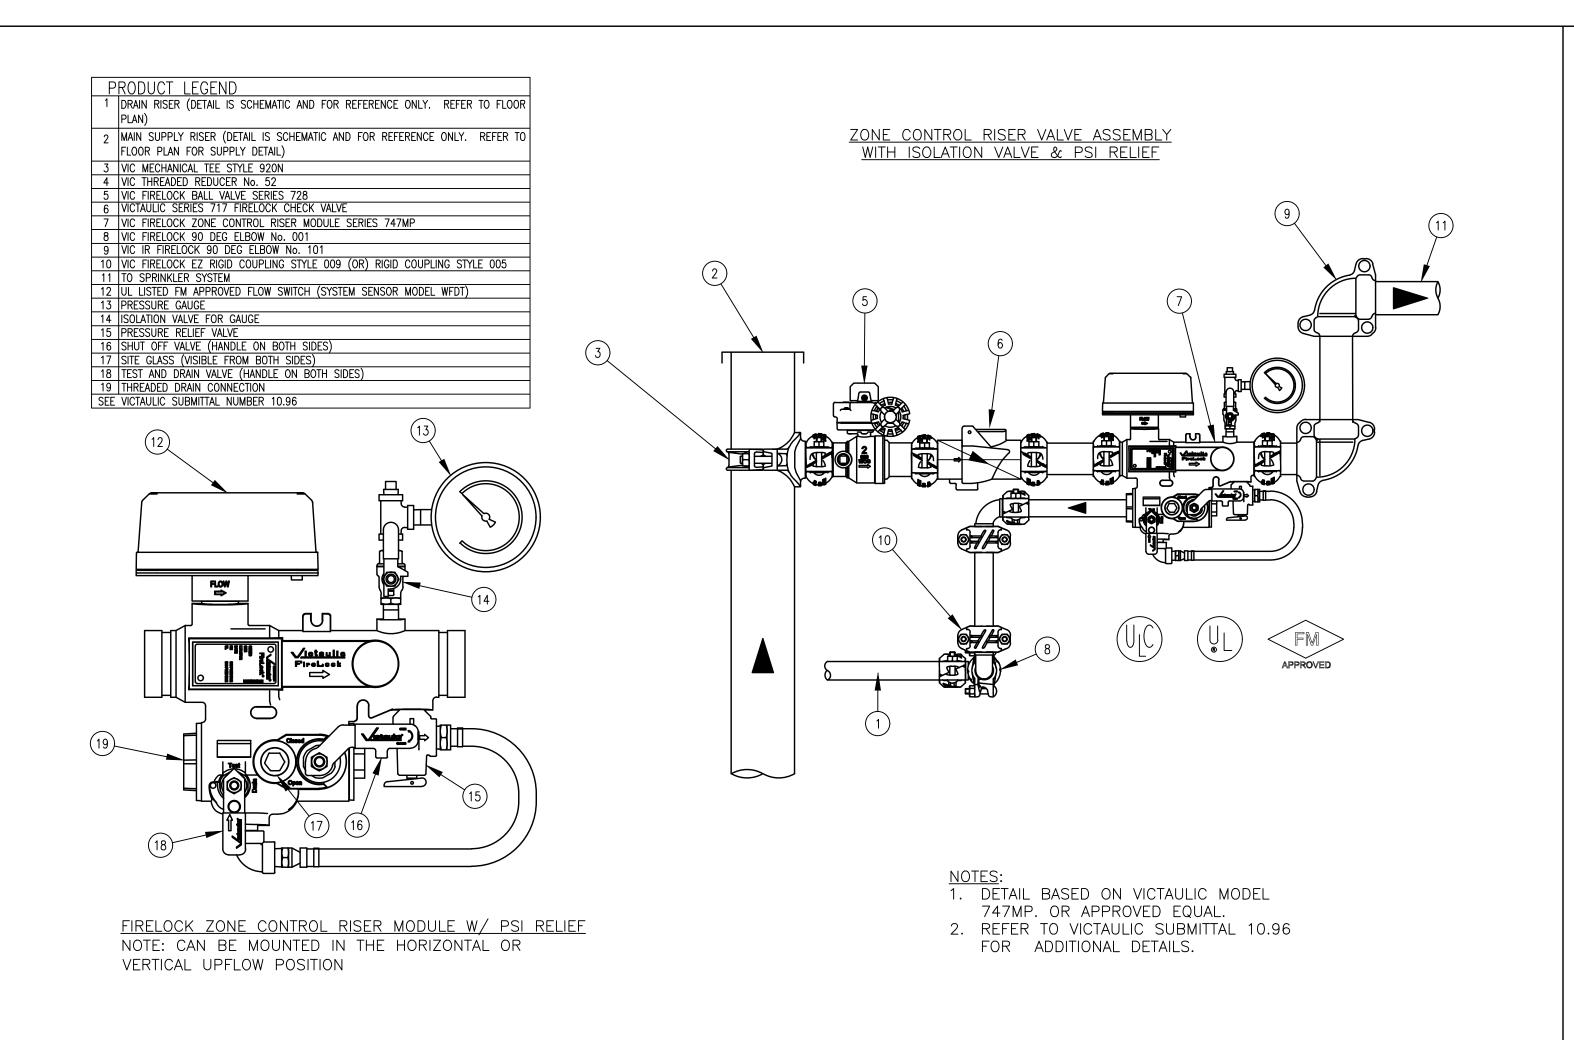
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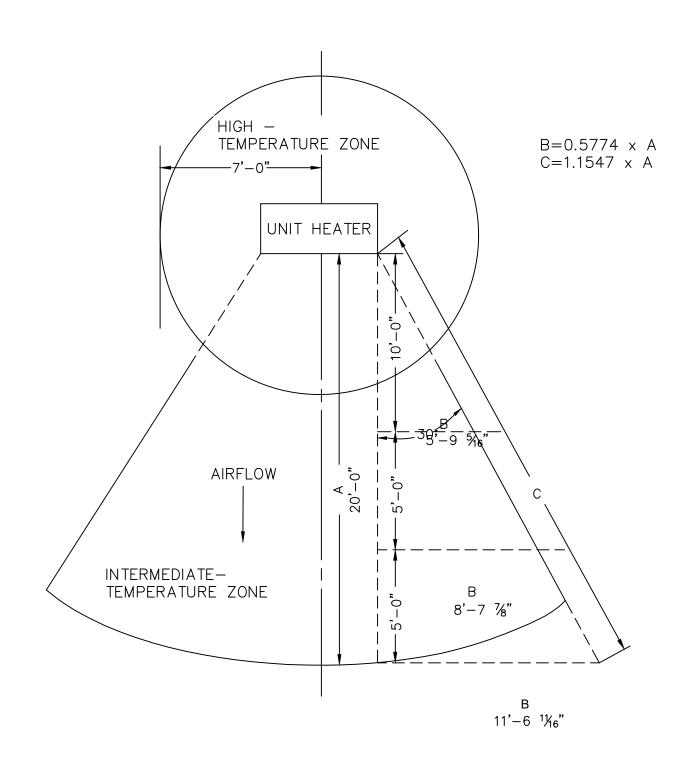
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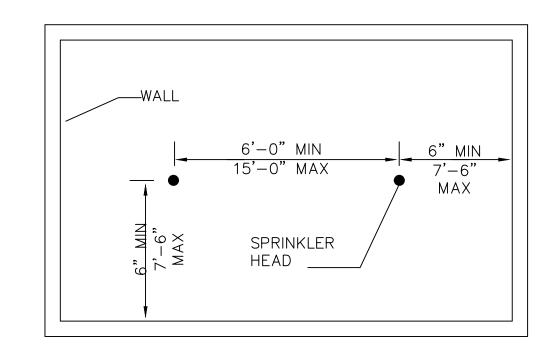
SHEET NUMBER

YDRANT FLOW TEST	SYMBOLS A	<u> </u>	EVIATIONS	SYMBOLS AND ABBREVIATIONS
PRIOR TO FILING FIRE PROTECTION DRAWINGS, THE CONTRACTOR SHALL ARRANGE FOR A	SYMBOL	ABBREVIATION	DESCRIPTION	SYMBOL ABBREVIATION DESCRIPTION
NEW/CURRENT FLOW TEST IN THE VICINITY OF THE BUILDING.		EX.	EXISTING TO REMAIN	TS TAMPER SWITCH
WATER SUPPLY DATA		NEW	NEW WORK	TYP TYPICAL
DATE: 7-30-2021		DEM.	EXISTING TO BE REMOVED	U.O.N. UNLESS OTHERWISE NOTED
PERFORMED BY: WESTCHESTER COUNTY STATIC PRESSURE AT RESIDUAL FIRE 118 DCI	0——	_	ELBOW UP	NOTE: FOR REFERENCE ONLY. NOT ALL SYMBOLS OR ABBREVIATIONS ARE USED IN THIS PROJECT.
HYDRANT:	C	_	ELBOW DOWN	GENERAL NOTES
RESIDUAL PRESSURE AT RESIDUAL FIRE HYDRANT: MEAGURER FLOW AT FLOW FIRE		_	TEE DOWN	1. THE REVISED SPRINKLER SYSTEM SHALL BE DESIGNED AND INSTALLED BY AN
MEASURED FLOW AT FLOW FIRE 780 GPM HYDRANT:		_	TEE UP	EXPERIENCED FIRE PROTECTION CONTRACTOR IN STRICT ACCORDANCE WITH NFPA-13. THE REQUIREMENTS OF THE LANDLORD, LANDLORD'S FIRE INSURANCE UNDERWRITER, AND
NOTES:		_	PIPE CAP OR FLUSHING CONNECTION	ALL GOVERNMENTAL AGENCIES AND AUTHORITIES HAVING JURISDICTION OVER THI PREMESIS.
			GATE VALVE	2. COORDINATE ALL WORK WITH OTHER TRADES TO MINIMIZE INTERFERENCES WITH NE
			OS&Y GATE VALVE BUTTERFLY VALVE	FACILITIES, TO FACILITATE TIMELY COMPLETION AND AVOID NECESSITY FOR CUTTING AN PATCHING. FURNISH TO OTHER AFFECTED TRADES ALL NECESSARY INFORMATION WORKING DRAWINGS OR MATERIALS REQUIRED FOR INSTALLATION AND COMPLETION O
		_	CHECK VALVE	ALL WORK. ALL CONFLICTS, OBSTRUCTIONS AND/OR MODIFICATIONS TO THE SPRINKLE
	111	_	UNION	DESIGN LAYOUT DUE TO FIELD CONDITIONS SHALL BE BROUGHT TO THE ATTENTION C THE ENGINEER PRIOR TO FABRICATION AND INSTALLATION.
		_	TEMPERATURE GAGE	3. CONTRACTOR SHALL CONDUCT FLOW TEST TO ESTABLISH EXACT FLOW AND PRESSUR
DESIGN ODITEDIA	<u> </u>	_	PRESSURE GAGE	AVAILABLE ON THE SITE FOR PREPARATION OF HYDRAULIC CALCULATIONS. 4 ALTER PIPING AS REQUIRED TO SUIT STRUCTURAL MEMBERS CEILING HEIGHT
DESIGN CRITERIA PROTECTION AREA PROTECTION AREA	WF	_	WATER FLOW SWITCH	4. ALTER PIPING AS REQUIRED TO SUIT STRUCTURAL MEMBERS, CEILING HEIGHT DUCTWORK, AND LIGHTS. PROVIDE AT NO EXTRA COST ALL ADDITIONAL PIPING AN FITTINGS REQUIRED TO OFFSET SYSTEM TO AVOID STRUCTURAL, ARCHITECTURA
HAZARD CLASSIFICATION DENSITY PER SPRINKLER (3)	TS	_	TAMPER SWITCH	MECHANICAL, AND ELECTRICAL INTERFERENCES, WHETHER INDICATED OR NOT, BEFORE INSTALLING WORK.
LIGHT HAZARD 0.1 GPM / 1500 SQ. FT. 225 SQ. FT. MAX ORDINARY HAZARD GROUP 1 0.15 GPM / 1500 SQ. FT. 130 SQ. FT. MAX		_	INSPECTORS TEST CONNECTION	5. WHEN INSTALLING SPRINKLER HEADS, THE CONTRACTOR SHALL PROVIDE THE SHORTE
NOTES:	-	_	FLOW ARROW	HYDRAULIC PIPE LENGTH BETWEEN THE FINAL SPRINKLER HEAD LOCATION AND TI BRANCH LINE CONNECTION. MINIMUM 1" FOR TWO HEADS, 1—1/4" FOR THREE HEAD
1.) HAZARD CLASSIFICATION, DENSITY AND MAX. PROTECTION AREA SHALL BE IN ACCORDANCE WITH NFPA 13 — 2016 RECOMMENDATIONS UNLESS OTHERWISE NOTED.	*	_	SPRINKLER GUARD	1-1/2" FOR FIVE HEADS, AND 2" FOR TEN HEADS.
2.) WHERE REQUIRED BY THE BUILDING DEPARTMENT OR AUTHORITY HAVING JURISDICTION FOR PERMIT, THE ENTIRE SYSTEM SHALL BE HYDRAULICALLY	o _e or ● _e	_	EXISTING SPRINKLER TO REMAIN	6. PROVIDE TWO 2-1/2 GALLON PRESSURIZED WATER AND ONE 10 LB ABC DRY CHEMICA EXTINGUISHERS FOR EMERGENCY USE DURING CONSTRUCTION.
CALCULATED. 3.) THE MINIMUM PRESSURE AT EACH SPRINKLER HEAD SHALL BE 7 PSI.	× OR ×	_	EXISTING SPRINKLER TO BE REMOVED	7. PROVIDE DRAIN VALVES AT MAIN SHUT-OFF VALVES AND LOW POINTS.
4.) EQUIVALENT FITTING LENGTHS USED IN HYDRAULIC CALCULATIONS SHALL BE IN ACCORDANCE WITH NFPA 13 — 2016.	•	_	NEW PENDENT SPRINKLER, CONCEALED OR EXPOSED AS NOTED.	8. PROVIDE ALL PIPE OPENINGS THROUGH PARTITIONS WITH PIPE SLEEVES. FOR PIPI
5.) DISCHARGE FROM EACH SPRINKLER SHALL NOT BE LESS THAN REQUIRED AREA COVERAGE BY THIS HEAD. AREA COVERAGE PER HEAD SHALL BE	0	_	NEW UPRIGHT SPRINKLER	PENETRATING FIRE RATED PARTITIONS, THE SPACE BETWEEN THE PIPE AND THE SLEE' SHALL BE SEALED WITH A LISTED FIRE STOPPING ASSEMBLY OR MATERIAL.
DETERMINED IN ACCORDANCE WITH NFPA 13 SECTION 8.6.2.2.1 (2016). 6.) HYDRAULIC CALCULATIONS SHALL BE BROUGHT BACK TO THE CONNECTION	4	_	SIDEWALL SPRINKLER	9. ALL HOSE CONNECTION AND FIRE DEPARTMENT CONNECTION THREADS SHALL BE TEST
TO THE STREET MAIN. FLOW VELOCITY IN SPRINKLER PIPING SHALL NOT EXCEED 20 FEET PER SECOND	•	_	POINT OF CONNECTION	TO VERIFY COMPATIBILITY WITH THREADS USED BY LOCAL FIRE DEPARTMENT, ACCORDANCE WITH NFPA—14 (2016) SECTION 11.3.
(FPS). 7.) DESIGN CRITERIA: GARAGE — ORDINARY HAZARD GROUP 1; TOILET ROOM —	•	_	POINT OF DISCONNECTION	10. THE CONTRACTOR SHALL MAKE A PROVISION FOR (10) EXTRA SPRINKLERS INCLUDING
LIGHT HAZARD.	N1	_	HYDRAULIC REFERENCE NODE	IMMEDIATE BRANCH PIPING, FITTINGS AND ARM—ÒVÉRS. THE CONTRACTOR SHA COORDINATE WITH FINAL CONFIGURATION OF OPEN AND HUNG CEILINGS, ALL HVADUCTWORK AND PIPING AND STRUCTURAL ELEMENTS THROUGHOUT THE AREA OF WORK
	S2 S2	_	HYDRAULIC REFERENCE SPRINKLER	11. THE CONTRACTORS SHALL SUBMIT FOR REVIEW AND APPROVAL A COMPOSITE SHO
		FDC	FIRE DEPARTMENT CONNECTION	DRAWING, FULLY COORDINATED WITH ALL OTHER TRADES INDICATING ALL DUCTWOR MECHANICAL EQUIPMENT, PIPING, ELECTRICAL EQUIPMENT, PLUMBING PIPING AN
		AFF	ABOVE FINISHED FLOOR	EQUIPMENT, LIGHTS, CONDUITS, DIFFUSERS, GRILLES AND FIRE ALARM DEVICES.
		AHC	ABOVE HUNG CEILING	EQUIPMENT NOTES
		ATC	AT CEILING	1 FLOOD CONTROL WALVE ACCEMBLY CHALL BE DACED ON WOTALLIO EIDELOG
		BFP	BACKFLOW PREVENTOR	1. <u>FLOOR CONTROL VALVE ASSEMBLY</u> : SHALL BE BASED ON VICTAULIC FIRELOG COMMERCIAL ZONE RISER MODULE SERIES 747M WITH DRAIN CONNECTION AND SIGH
		DCDA	DOUBLE CHECK DETECTOR ASSEMBLY	GLASS. PROVIDE 4" VICTAULIC FIRELOCK BUTTERFLY VALVE AND CHECK VALVE (EQUAL BEFORE RISER MODULE.
		DCV	DOUBLE CHECK VALVE BFP	2. <u>FIRE DEPARTMENT CONNECTION:</u> SHALL BE BASED ON POTTER ROEMER 5753 OR EQU AT BUILDING FACADE. SIAMESE SHALL BE PLACED BETWEEN 18 INCHES AND 36 INCH
		DN.	DOWN	ABOVE THE SIDEWALK. FIRE DEPARTMENT CONNECTION SHALL HAVE TWO (2) INTERNALLY THREADED SWIVEL FITTINGS WITH THREADS CONFORMING TO AHJ STANDARI
		FCA	FLOOR CONTROL ASSEMBLY	WITH 4" OUTLET. PROVIDE AUTOMATIC BALL DRIP AT FDC FACE PLATE.
		FLFD	FLOOR DRAIN FUNNEL FLOOR DRAIN	3. SPRINKLERS: REFER TO DRAWINGS FOR SPRINKLER HEAD SCHEDULE.
		GPM	GALLONS PER MINUTE	
		JP	JOCKEY PUMP	
		NFPA	NATIONAL FIRE PROTECTION ASSOCIATION	
		(NO)	NORMALLY OPEN	
		(NC)	NORMALLY CLOSED	
		NTS	NOT TO SCALE	
		PRV	PRESSURE REDUCING VALVE	
		PSI	POUNDS PER SQUARE INCH	
		RPZ	REDUCED PRESSURE ZONE BFP	
		SF	SQUARE FOOT	
OLA Consulting Engineers			RECORD DRAWING CERTIFICATION	WESTCHESTER COUNTY, NEW YORK CONTRACT SHEE NUMBER NUMBER TO TRANSPORTATION 17-521 FP.
OLA Consulting Engineers			AS BUILT — CHANGES AS NOTED AS BUILT — NO CHANGES	BEI INVINIBILIT OF TOBERS WORKS THE TWENTER OF THE TOTAL THE TENTER OF THE TOTAL THE T
A, Inc. 50 Broadway, Hawthorne, New York 10532		II I F	(3 BOILT 110 CTI/(10L3	THINK HAND THE PROPERTY OF THE
			CONTRACTOR PROJECT COORDINATO	DIVISION OF ENGINEERING OR NEW EQUIPMENT STORAGE BUILDING PICHARD A FLYNN SR FIRE TRAINING CENTER DATE: 11/16/2








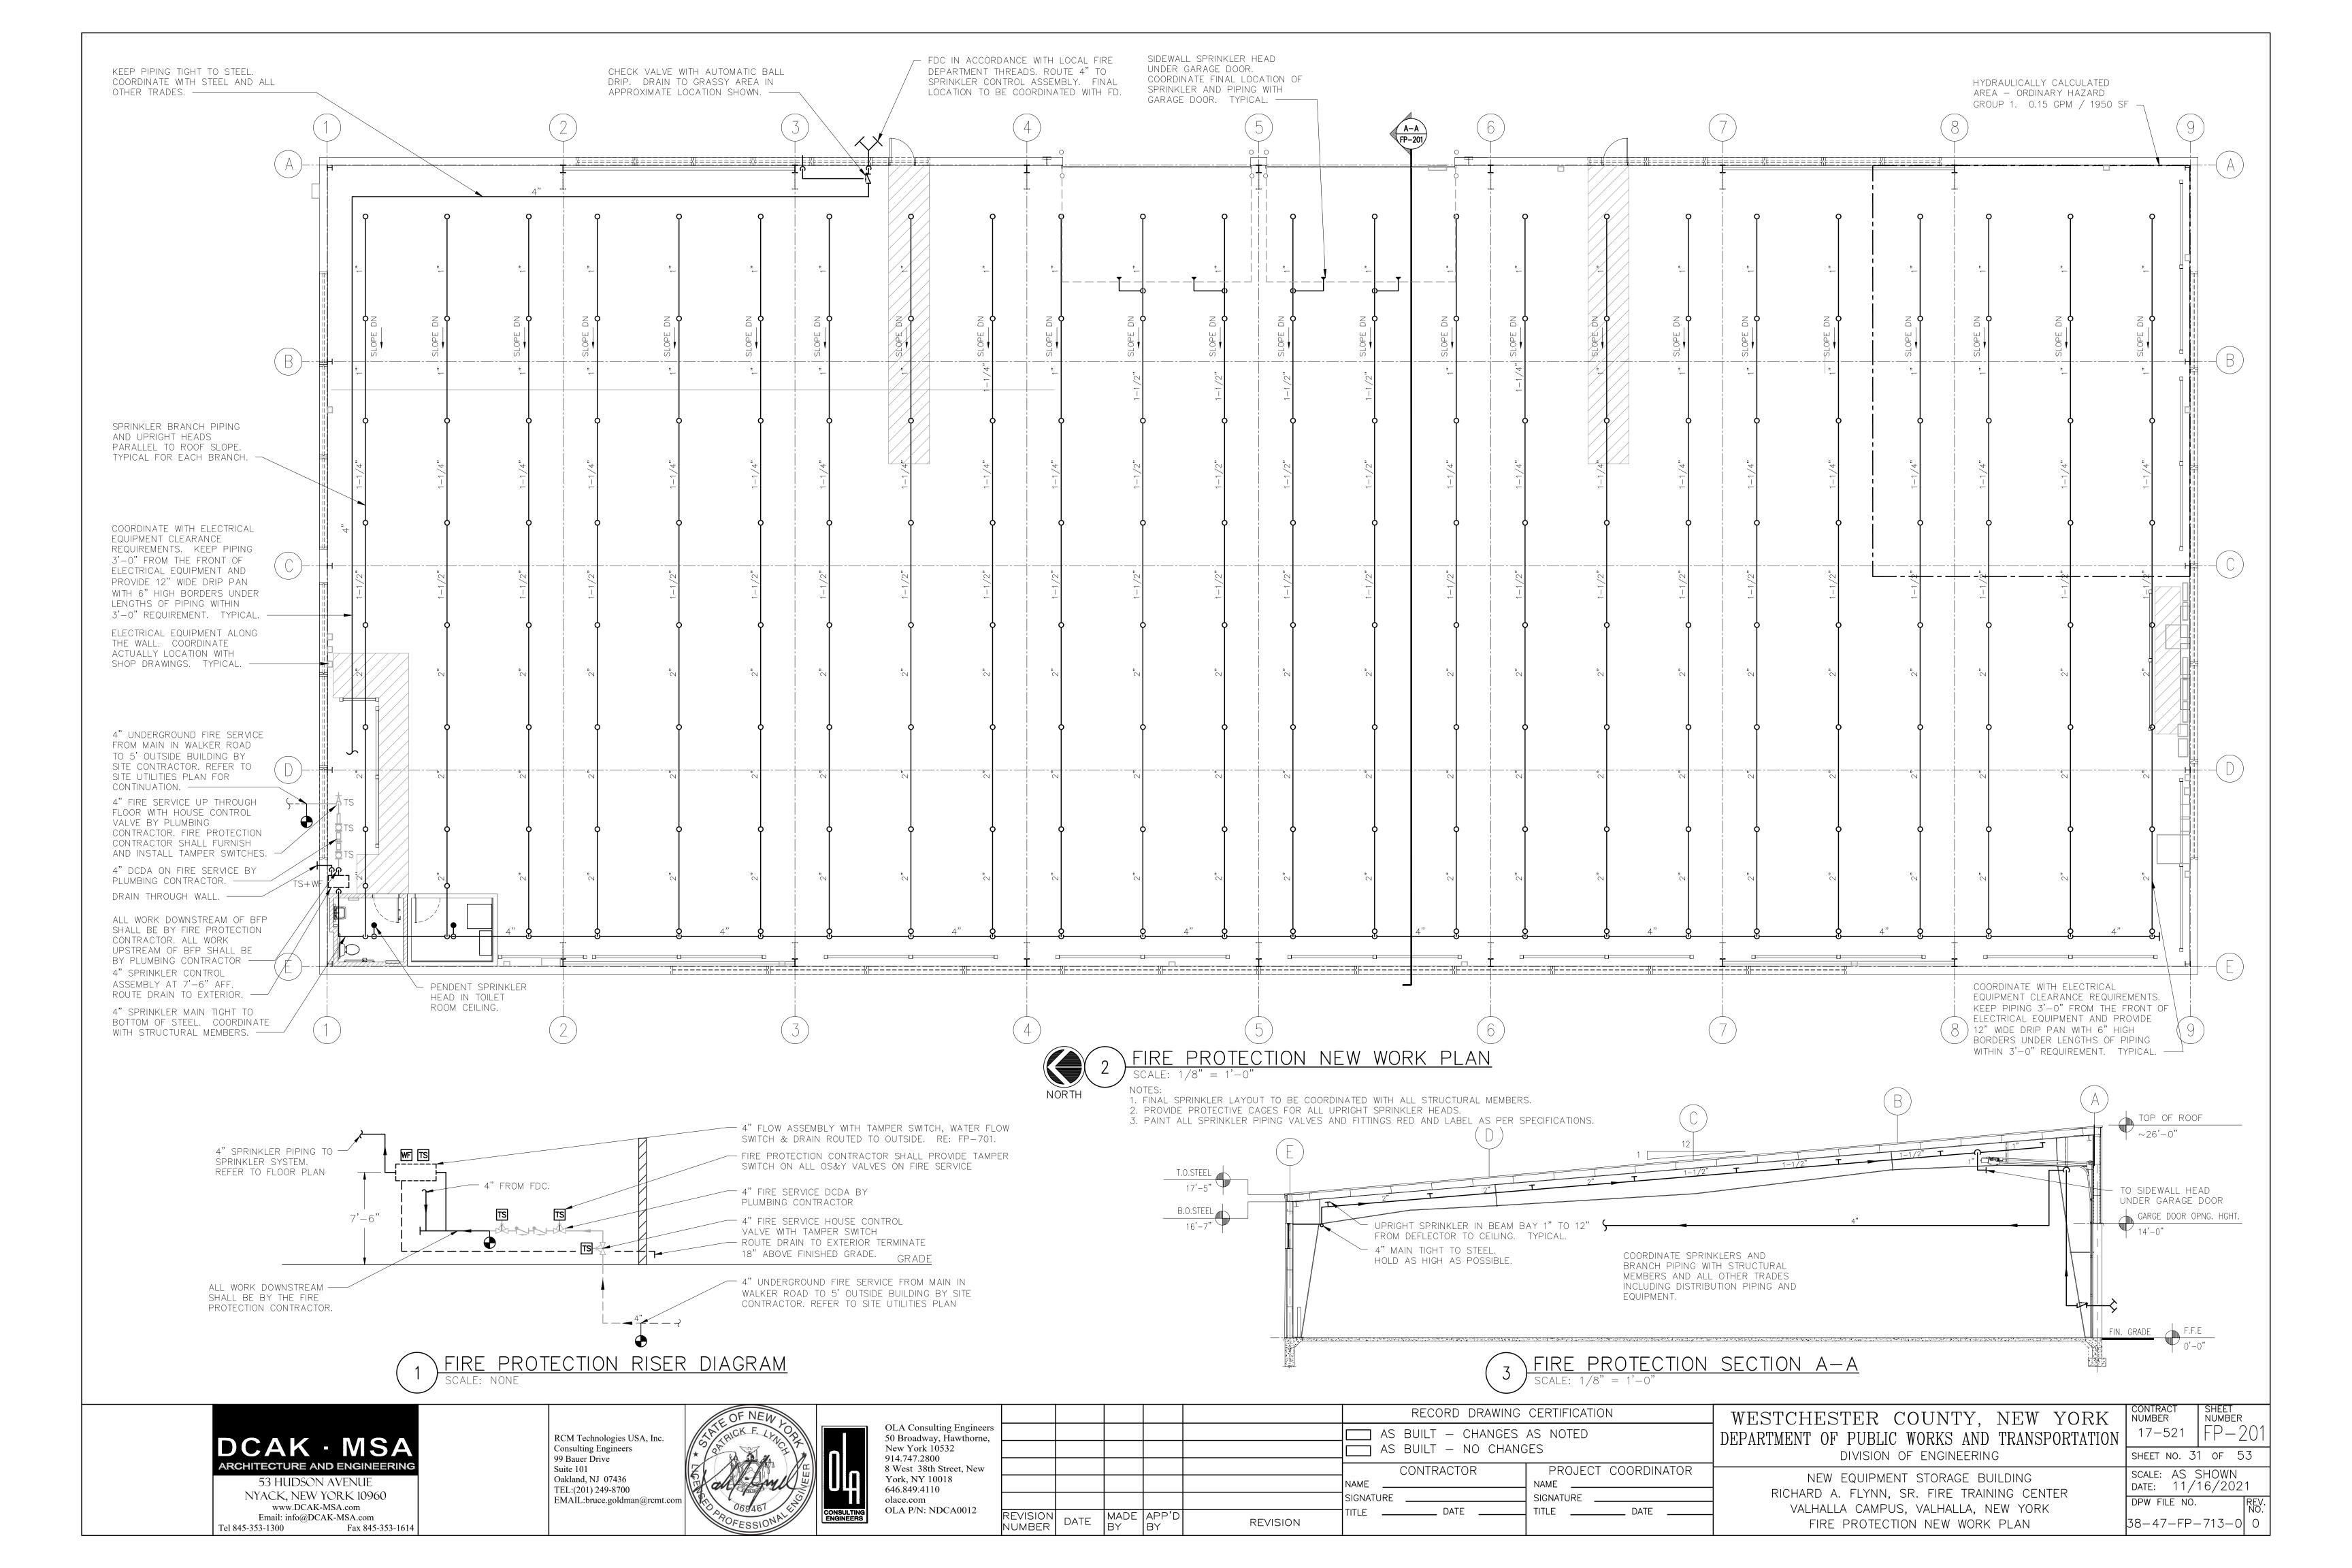

LIGHT HAZARD ORDINARY HAZARD MAX AREA PER HEAD 225 SQ. FT. 130 SQ. FT.

DENSITY PER 1500 SQ. FT 0.10 GPM/SQ. FT. 0.16 GPM/SQ. FT.

SPRINKLER HEAD SPACING CRITERIA

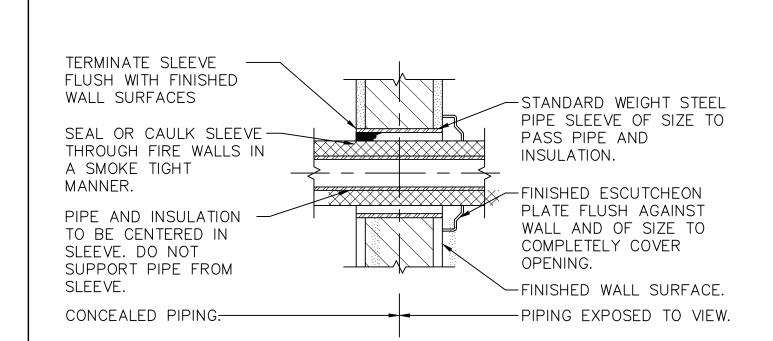

-ROOF STRUCTURE. REFER TO

MANUFACTURED BY UNISTRUT.

-THREADED HANGER ROD. REFER TO SCHEDULE BELOW FOR SIZE.

ARCHITECTURAL PLANS.

STEEL RESTRAINING STRAP.

-CLEVIS HANGER TYPICAL

∠BEAM CLAMP AS

-CARRIER PIPE


PIPE WALL SLEEVE DETAIL

SPRINKLER ZONE CONTROL RISER MODULE WITH CHECK VALVE & PSI RELIEF


			<u>SPI</u>	RINKLER HEAD	SCHEDULE	_			
SYM.	TYPE	LOCATION	FINISH	MANUF.	MODEL	HEAD TEMP.	MAX CLG. TEMP	ORIFICE	K-FACTOR
⊗	CONCEALED PENDENT	FINISHED AREAS PER PLANS	COVER PER ARCHITECT	RELIABLE	G5-56	165 ° F	100 ° F	1/2"	5.6
0	O UPRIGHT EXPOSED AREAS PER PLANS		CHROME PLATED	RELIABLE	F1FR	165 ° F	100°F	1/2"	5.6
\triangleright	SIDEWALL	GARAGE DOORS	CHROME PLATED	RELIABLE	G6-56	165 ° F	100°F	1/2"	5.6

NOTES:

- . SPRINKLER HEADS SHALL BE INSTALLED AS PER MANUFACTURER'S RECOMMENDATIONS . PROVIDE UPRIGHT SPRINKLER HEADS WITH PROTECTIVE CAGES FOR ALL SPRINKLER HEADS. ALL SPRINKLER HEADS THROUGHOUT THE PROJECT AREA SHALL BE OF THE ORDINARY TEMPERATURE RATING EXCEPT AS
- A. SPRINKLER HEADS LOCATED CLOSE TO HEATERS, SHALL BE OF THE TEMPERATURE RATING AS REQUIRED BY NFPA-13.
 B. ALL HEAT GENERATING EQUIPMENT WHICH CAN AFFECT THE TEMPERATURE RATING OF THE SPRINKLER HEADS SHALL BE CLEARLY IDENTIFIED ON THE SHOP DRAWINGS PRIOR TO SUBMISSION FOR APPROVAL.

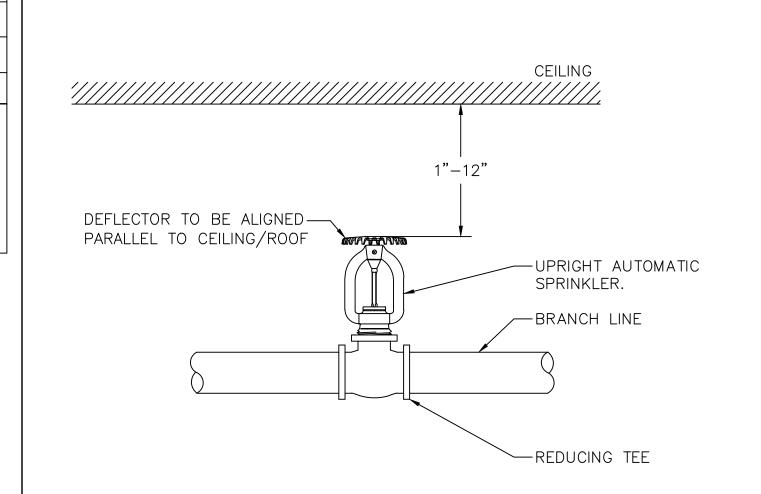

TYPICAL UPRIGHT SPRINKLER

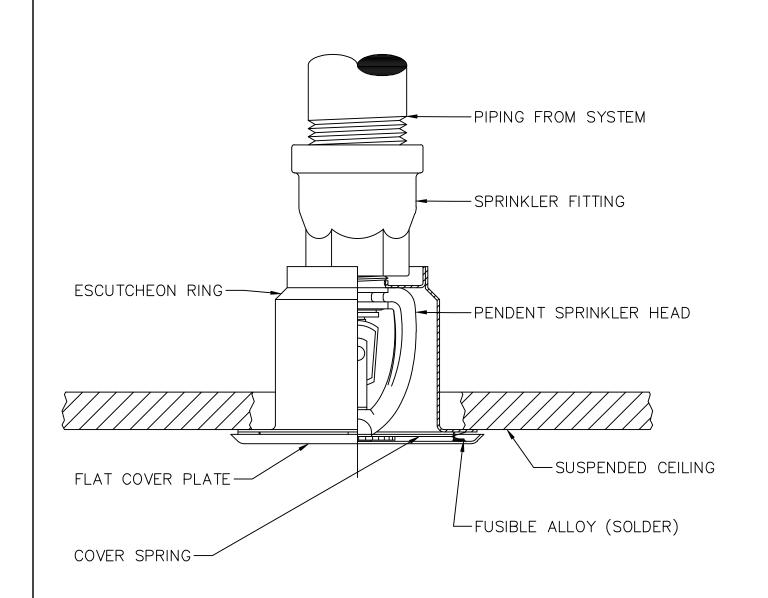

SPRINKLER TEMPERATURE ZONES

AT UNIT HEATERS

1.) CLEVIS HANGERS WITH WELDED INSULATION SHIELDS SIMILAR TO RAUCH FIG. 100SH ON ALL PIPES LARGER THAN 1".

PIPE HANGER SCHEDULE

PIPE DIA. 3/4"-2" 2 1/2"-3" 4"-5" 6" 8"-12"

HANGER DIA. 3/8" | 1/2" | 5/8" | 3/4" | 7/8"

2.) FOR PIPES 1" OR SMALLER, A BAND HANGER WITH INSULATION SHIELD MAY BE USED SIMILAR TO RAUCH FIG. NO. 1ASH.

3.) FOR NON-INSULATED PIPE, INSULATION SHIELDS MAY BE OMITTED. 4.) ALL PIPE HANGERS SHALL BE GALVANIZED STEEL OR FACTORY PAINTED BLACK WITH

5.) FOR NON FERROUS PIPING WITHOUT INSULATION, ALL HANGERS SHALL BE COPPER PLATED

OR FURNISHED WITH A DI-ELECTRIC BETWEEN PIPE AND HANGERS.

6.) WHERE EXISTING BUILDING STRUCTURAL COMPONENTS HAVE FIREPROOF MATERIAL, ANY AREA THAT IS DISTURBED OR DAMAGED AS A RESULT OF HANGER INSTALLATION SHALL BE PATCHED WITH UL AND FM APPROVED FIREPROOFING TO MATCH EXISTING.

<u>PIPE HANGER DETAIL</u>

DCAK · MSA ARCHITECTURE AND ENGINEERING 53 HUDSON AVENUE NYACK, NEW YORK 10960

www.DCAK-MSA.com


Email: info@DCAK-MSA.com

Fax 845-353-1614

SPRINKLER HEAD SCHEDULE

Tel 845-353-1300

RCM Technologies USA, Inc. Consulting Engineers 99 Bauer Drive Suite 101 Oakland, NJ 07436 TEL:(201) 249-8700 EMAIL:bruce.goldman@rcmt.com

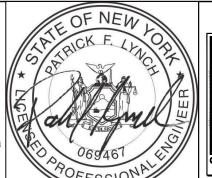

OLA Consulting E 50 Broadway, Haw New York 10532 914.747.2800 8 West 38th Street, York, NY 10018 646.849.4110 olace.com OLA P/N: NDCA00

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WESTCHESTER COUNTY, NEW YORK DEPARTMENT OF PUBLIC WORKS AND TRANSPORTATION DIVISION OF ENGINEERING NEW EQUIPMENT STORAGE BUILDING RICHARD A. FLYNN, SR. FIRE TRAINING CENTER

VALHALLA CAMPUS, VALHALLA, NEW YORK

FIRE PROTECTION DETAILS

SHEET NUMBER CONTRAC NUMBER |FP-70|17-521 SHEET NO. 32 OF 53 SCALE: AS SHOWN DATE: 11/16/2021 DPW FILE NO. 38-47-FP-714-0|0

CONCEALED PENDENT SPRINKLER HEAD IN SUSPENDED CEILING

	PLUMBING SCHEDULE											
	SYN	MBOLS		PLI	JMBING C	CONNECTIO	DNS					
TAG	PLAN	ELEVATION	FIXTURES	WASTE	VENT	COLD WATER	HOT WATER	DESCRIPTION				
P-1	0 0 0		LAVATORY	2"	1½"	3/4"	3/4"	KOHLER SOHO WALL-MOUNTED BATHROOM LAVATORY K-2084-L. FAUCET: ZURN Z6950-XL-S AND SHALL BE HARDWIRED. SOAP DISPENSER: Z6950-SD. REFER TO SPECIFICATIONS FOR ALL REQUIRED OPTIONS.				
P-2	0:0		WATER CLOSET	4"	2"	11/4"	_	AMERICAN STANDARD MADERA FLOWISE TOILET MODEL 3043.001 WITH SELECTRONIC FLUSH VALVE MODEL 606B.121, 1.28 GPF. PROVIDE HARD WIRE AC TRANSFORMER. REFER TO SPECIFICATIONS FOR ALL REQUIRED OPTIONS.				
NFWH	井	T	NON-FREEZE WALL HYDRANT	_	_	3/4"	_	SMITH #5609QT — CAST BRASS, THREADED, NON_FREEZE, HEAVY—DUTY HYDRANT WITH NIKALOY BOX AND LOCKING COVER, BRASS OPERATING PARTS, 3/4" HPT HOSE OUTLET, 3/4" IPS OUTSIDE, ELBOW ADAPTER, "T" HANDLE KEY, AND INTEGRAL VACUUM BREAKER. PIPING SERVING NFWH TO BE ROUTED DOWN ON INTERIOR SIDE OF OUTER WALL INSULATION.				
НВ	+	工	HOSE BIB	_	_	3/4"	_	IN FINISHED AREAS, WASHDOWN FAUCET SHALL BE POLISHED CHROME—PLATED WALL FAUCET WITH WALL FLANGE, ½" INLET, ¾" HOSE THREAD OUTLET AND REMOVABLE LOOSE KEY T—HANGDLE: CHICAGO #293—6 WITH #E27 VACUUM BREAKER OR ACCEPTABLE EQUIVALENT.				
TD			TRENCH DRAIN	_	_	_	_	ZURN ZFV812-U4-BG-DB DRAIN #2002 - 12" WIDE REVEAL FIBER REINFORCED VINYLESTER CONTINUOUS 10'-0" TRENCH DRAIN SYSTEM, CLASS D (H-20) GALVANIZED DUCTILE IRON BAR GRATE, 4" NO-HUB OUTLET, AND DOME STRAINER. COORDINATE OUTLET LOCATION IN FIELD.				
CODP			CLEANOUT DECKPLATE	_	_	_	_	FLOOR CLEANOUT WITH ADJUSTABLE HEAD, ANCHOR FLANGE, CUT—OFF SECTIONS AND ROUND TOP: ZURN #Z1400 OR APPROVED EQUAL. PROVIDE EXTRA HEAVY DUTY NON—TILT CAST IRON TOP.				
TG-1	_	_	TRAP GUARD	_	_	_	_	GREEN DRAIN™ INLINE FLOOR DRAIN TRAP SEAL WITH UV RESISTANT ABS PLASTIC FRAME, SILICONE RUBBER SEALING FLAPPER, AND FOUR FLECIBLE SEALING RIBS. TESTED AND CERTIFIED TO THE ASSE 1072 STANDARD AND LISTED WITH IAPMO AND ICC. (PROVIDE AT ALL FLOOR DRAINS)				

ADD / ALTERNATE NOTES

COMPRESSOR - PROVIDE ADD / ALTERNATE PRICE TO FURNISH AND INSTALL THE FOLLOWING AIR COMPRESSOR. COMPRESSOR SHALL BE INGERSOLL RAND MODEL# UP6-15CTAS-150 120 GAL TANK WITH 15 HP MOTOR 480V/3PH/60HZ. UNIT SHALL INCLUDE INTERNAL COOLING SYSTEM, COMPRESSED AIR FILTRATION, AIR DRYER, AND UNIT MOUNTED CONTROL PANEL. PROVIDE OPTIONAL SERVICE MAINTENANCE INDICATOR WHICH INCLUDES HOUR METER, MAINTENANCE METER, INDICATOR OF FAULT CONDITION, REAL TIME CLOCK, BACK LIGHT, SERVICE DUE WARNING, SERVICE OVERDUE.

ALL COMPRESSED AIR PIPING SHALL BE PART OF THE BASE BID.

DCAK - MSA ARCHITECTURE AND ENGINEERING 53 HUDSON AVENUE NYACK, NEW YORK 10960 www.DCAK-MSA.com Email: info@DCAK-MSA.com

Fax 845-353-1614


Tel 845-353-1300

NOTES:

1.) REFER TO SPECIFICATIONS FOR MOUNTING HEIGHTS.

2.) REFER TO ARCHITECTURAL FLOOR PLANS FOR EXACT LOCATION.

RCM Technologies USA, Inc. Consulting Engineers 99 Bauer Drive Suite 101 Oakland, NJ 07436 TEL:(201) 249-8700 EMAIL:bruce.goldman@rcmt.com

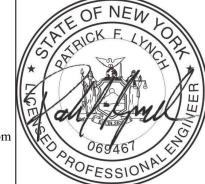

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SYMBOL & ABBREVIATIONS

NEW

CW

HW

S

CA

CODP

WCO

VTR

FAI

DCV

TYP

EWH

SYMBOL

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ABBREVIATION DESCRIPTION

NEW WORK

COLD WATER

HOT WATER

WASTE LINE

SOIL LINE

GAS LINES

PLUG VALVE

CHECK VALVE

MANUAL AIR VENT

PRESSURE REDUCING VALVE

CLEAN OUT DECK PLATE

CONCENTRIC REDUCER

ECCENTRIC REDUCER

FLEXIBLE CONNECTION

WALL CLEAN OUT

BALL VALVE

TEE DOWN

TEE UP

ELBOW UP

PIPE CAP

STRAINER

FLOW ARROW

PRESSURE GAGE

THERMOMETER

WALL HYDRANT

ABOVE FINISHED FLOOR

ABOVE HUNG CEILING

VENT THROUGH ROOF

FRESH AIR INTAKE

TYPICAL

BACK FLOW PREVENTOR

REDUCED PRESSURE ZONE - BFP

DOUBLE CHECK VALVE - BFP

ELECTRIC WATER HEATER

HOSE BIB

UNION

ELBOW DOWN

COMPRESSED AIR LINES

VENT

GENERAL NOTES

- 1. THE CONTRACT DRAWINGS INDICATE THE EXTENT AND GENERAL ARRANGEMENTS OF THE PLUMBING SYSTEMS. IF ANY DEPARTURES FROM THE DRAWINGS ARE DEEMED NECESSARY BY THE PLUMBING CONTRACTOR. DETAILS OF SUCH DEPARTURES AND THE REASONS THEREFORE SHALL BE SUBMITTED TO THE OWNER AND ENGINEER FOR APPROVAL. NO SUCH DEPARTURES SHALL BE MADE WITHOUT PRIOR WRITTEN APPROVAL OF THE OWNER AND ENGINEER. EQUIPMENT AND PIPING ARRANGEMENTS SHALL PROVIDE ADEQUATE AND ACCEPTABLE CLEARANCES FOR ENTRY, SERVICING, AND MAINTENANCE. ANY CHANGES TO PIPING AND EQUIPMENT LOCATIONS NECESSARY TO AVOID INTERFERENCE WITH OTHER TRADES SHALL BE MADE AT NO EXTRA COST.
 - 2. THE PLUMBING WORK SHALL BE PERFORMED IN STRICT ACCORDANCE WITH THE LATEST EDITION OF THE PREVAILING NEW YORK STATE PLUMBING AND BUILDING CODES, AND ALL LOCAL REGULATIONS THAT MAY APPLY. IN CASE OF CONFLICT BETWEEN THE CONTRACT DOCUMENTS AND A GOVERNING CODE OR ORDINANCE, THE MORE STRINGENT STANDARD SHALL APPLY.
 - 3. THE PLUMBING CONTRACTOR SHALL BE RESPONSIBLE FOR OBTAINING ALL NECESSARY PERMITS AND FOR PAYING RELATED FEES.
 - 4. PRIOR TO FABRICATION, THIS CONTRACTOR SHALL VERIFY ALL MEASUREMENTS AND CONDITIONS ON JOB SITE, AND COORDINATE THIS WORK WITH THE WORK OF ALL OTHER TRADES.
 - 5. PROVIDE ALL PLUMBING FIXTURES, PIPING, VALVES AND ACCESSORY ITEMS AS SPECIFIED AND AS REQUIRED FOR A COMPLETE INSTALLATION. ROUGHING DIMENSIONS OF FIXTURES MUST BE COORDINATED WITH THE GENERAL CONTRACTOR.
- 6. PITCH ALL WASTE, SANITARY, AND STORM DRAIN PIPING AT MAXIMUM SLOPE POSSIBLE, BUT NOT LESS THAN 1/8" PER FOOT.
- 7. NO PIPING SHALL RUN EXPOSED IN TOILET ROOM.
- 8. PROVIDE DIELECTRIC FITTINGS OR COUPLINGS FOR DISSIMILAR METALS.
- 9. PROVIDE SHUTOFF VALVES AT ALL FIXTURES AND EQUIPMENT ON COLD WATER, HOT WATER, AND GAS SUPPLY PIPES.
- 10. ALL WORK SHALL BE PROPERLY TESTED. BALANCED. AND CLEANED AND DISINFECTED. PROVIDE A ONE YEAR WARRANTY FROM DATE OF FINAL INSPECTION ON ALL PARTS AND LABOR.
- 11. PROVIDE ALL PIPE OPENINGS THROUGH PARTITIONS WITH PIPE SLEEVES. FOR PIPES PENETRATING FIRE RATED PARTITIONS, THE SPACE BETWEEN THE PIPE AND THE SLEEVE SHALL BE SEALED WITH FIRE STOPPING MATERIAL. PENETRATIONS FOR PIPING SHALL BE MADE BY CORE DRILLING WHENEVER POSSIBLE. SLEEVE FOR SERVICE PIPE SHALL BE TWO (2) TIMES THE DIAMETER OF THE SERVICE PIPE.
- 12. THE PLUMBING CONTRACTOR SHALL PROVIDE ALL CUTTING, PATCHING, CORE DRILLING, PAINTING, ACCESS PANELS, AND FINAL RESTORATION REQUIRED TO FACILITATE THE INSTALLATION OF PLUMBING PIPING, INCLUDING ABOVE CEILINGS AND IN SHAFTS THAT WILL NOT BE REPLACED OR OPENED UNDER ANY OTHER SCOPE OF WORK RELATED TO THIS PROJECT. CONTRACTOR TO REMOVE AND REPLACE CEILINGS, AND OPEN AND PATCH SHAFTS AND WALLS, AS REQUIRED TO EXECUTE THE PLUMBING WORK.
- 13. ALL MOTOR STARTERS AND DISCONNECT SWITCHES FOR PLUMBING EQUIPMENT SHALL BE FURNISHED BY THE PLUMBING CONTRACTOR AND INSTALLED BY THE ELECTRICAL CONTRACTOR, UNLESS OTHERWISE NOTED. DISCONNECT SWITCHES FURNISHED BY THE PLUMBING CONTRACTOR FOR PLUMBING EQUIPMENT SHALL BE HEAVY DUTY TYPE.
- 14. THIS CONTRACTOR IS RESPONSIBLE FOR ALL PLUMBING FIXTURES AND DISTRIBUTION SYSTEMS, INCLUDING ALL ROUGH-INS AND FINAL CONNECTIONS.
- 15. THE CONTRACTOR SHALL BE RESPONSIBLE FOR PROVIDING TEMPORARY VENTILATION AND EXHAUST AIR WHEN WELDING OR SOLDERING OPERATIONS ARE PERFORMED. AS REQUIRED BY OSHA.
- 16. PROVIDE PVC PROTECTIVE COVER FOR ALL PIPING INSULATION BELOW 10'-0" AFF.
- 17. THE CONTRACTORS SHALL SUBMIT FOR REVIEW AND APPROVAL A COMPOSITE SHOP DRAWING, FULLY COORDINATED WITH ALL OTHER TRADES INDICATING ALL DUCTWORK, MECHANICAL EQUIPMENT, PIPING, ELECTRICAL EQUIPMENT, PLUMBING PIPING AND EQUIPMENT, LIGHTS, CONDUITS, DIFFUSERS, GRILLES AND FIRE ALARM DEVICES.

EQUIPMENT NOTES

- PROTECTIVE SHIELDING GUARDS: WHEREVER PIPING IS EXPOSED BELOW SINKS AND LAVATORIES, PROVIDE MANUFACTURED PLASTIC ENCLOSURES BY TRUEBRO FOR COVERING PLUMBING FIXTURE HOT AND COLD WATER SUPPLIES AND TRAP AND DRAIN PIPING. COMPLY WITH AMERICANS WITH DISABILITIES ACT (ADA) REQUIREMENTS.
- WATER HAMMER ARRESTORS: ZURN INDUSTRIES SHOKTROL SERIES. STAINLESS STEEL CONSTRUCTION, BELLOWS TYPE SIZED IN ACCORDANCE WITH PDI WH-201, PRE-CHARGED SUITABLE FOR OPERATION IN TEMPERATURE RANGE 34 TO 250 DEGREES F AND MAXIMUM 150 PSI WORKING PRESSURE.
- POINT OF USE ELECTRIC TANKLESS HOT WATER HEATER (EWH-1): SHALL BE EEMAX "SINGLE POINT" MODEL SP-3512, 120V/1ø/60HZ, 3.5kW, 29 AMPS, U.L. LISTED, TO HEAT 0.5 GPM @ A TEMPERATURE RISE OF 48°F. UNIT SHALL HAVE ABS-UL RATED COVER. ELEMENT SHALL BE REPLACEABLE CARTRIDGE INSERT. UNIT SHALL HAVE A REPLACEABLE FILTER IN THE INLET CONNECTOR AND A FLOW REGULATOR IN THE OUTLET CONNECTOR. ELEMENT SHALL BE IRON FREE, NICKEL CHROME MATERIAL. HEATER SHALL BE FITTED WITH 3/8" COMPRESSION NUTS AND SLEEVES. HEATER SHALL BE INSTALLED WITH WATER CONNECTIONS ON TOP ONLY. DISCONNECT SWITCH SHALL BE FURNISHED BY THE PLUMBING CONTRACTOR AND INSTALLED BY THE ELECTRICAL CONTRACTOR.
- 4. <u>OIL-WATER SEPARATOR</u>: BASED ON HIGHLAND TANK MODEL HTC-2000 SERIES-G DOUBLE WALL OIL/WATER SEPARATOR WITH INTEGRAL SAND INTERCEPTOR COMPARTMENT, CORELLA COALESCER PLATE SYSTEM AND HIGH GUARD PROTECTION SYSTEM. UNIT SHALL HAVE A TOTAL VOLUME OF 2000 GAL AND A MAXIMUM FLOW RATE OF 200 GAL/MIN. A HIGHLAND TANK ALARM PANEL SHALL BE PROVIDED IN THE BUILDING CAPABLE OF HIGH OIL (VISUAL ALARM), HIGH-HIGH OIL (AUDIBLE AND VISUAL ALARM), AND LEAK DETECTION (AUDIBLE AND VISUAL ALARM). UNIT REQUIRES A 120V/1PH/60HZ POWER CONNECTION WITH ~1 AMP. REFER TO DETAIL ON P-701 INSTALLATION AND SPECIFICATIONS FOR FULL INFORMATION.

WESTCHESTER COUNTY, NEW YORK DEPARTMENT OF PUBLIC WORKS AND TRANSPORTATION DIVISION OF ENGINEERING


> NEW EQUIPMENT STORAGE BUILDING RICHARD A. FLYNN, SR. FIRE TRAINING CENTER VALHALLA CAMPUS, VALHALLA, NEW YORK

P - 00117-521 SHEET NO. 33 OF 53 SCALE: AS SHOWN

SHEET NUMBER

DATE: 11/16/2021 DPW FILE NO. 38-47-P-715-0 | 0 PLUMBING SYMBOLS, ABBREVIATIONS, & GENERAL NOTES

NUMBER

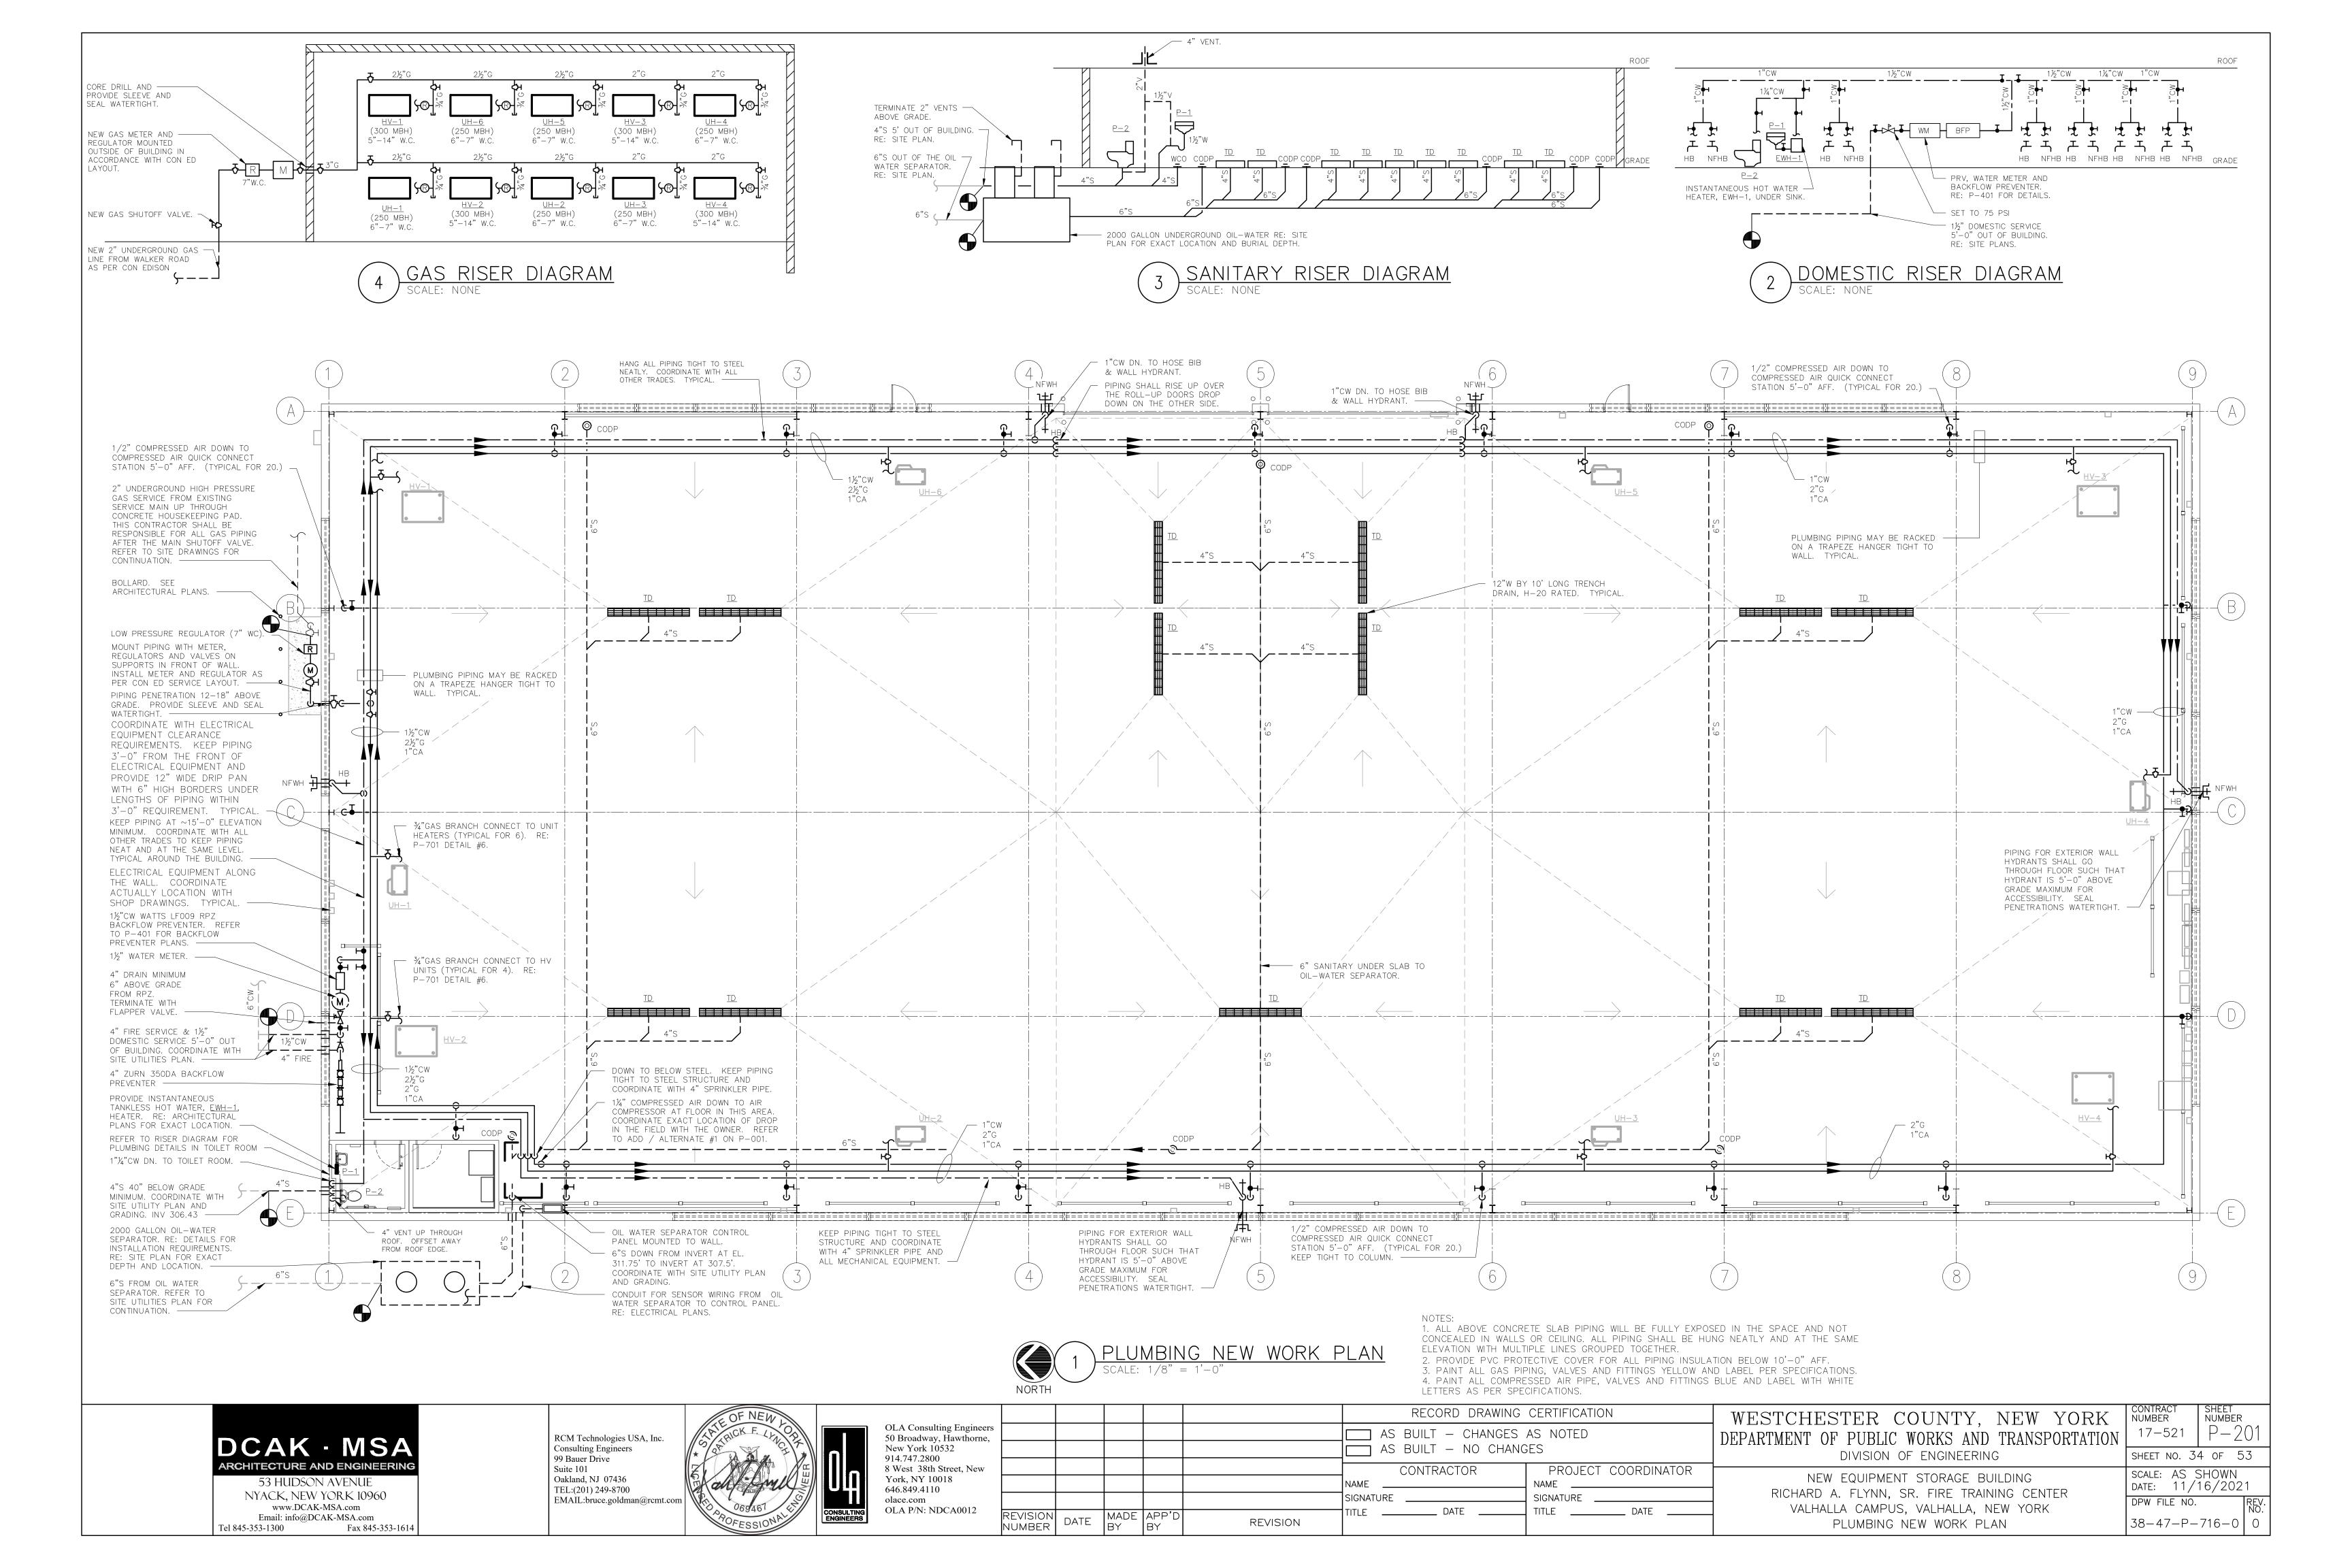

GENERAL NOTES:

- 1. ADEQUATE HEAT AND LIGHT SHALL BE PROVIDED IN LOCATIONS WHERE BACKFLOW PREVENTERS ARE TO BE INSTALLED.
- 2. THE CONTRACTOR SHALL USE ONLY AMERICAN MADE, UL/FM APPROVED VALVES.
- 3. NO WORK SHALL PROCEED WITHOUT THE WESTCHESTER COUNTY DEPARTMENT OF HEALTH TOWN OF MT. PLEASANT APPROVAL. 4. BACKFLOW PREVENTER ARRANGEMENT SHALL NOT BE ALTERED WITHOUT PRIOR APPROVAL BY WESTCHESTER COUNTY DEPARTMENT OF HEALTH.
- 5. BACKFLOW PREVENTION SHALL BE PROTECTED FROM THE HIGHEST FLOOD LEVEL.
- 6. BY-PASSES AROUND BACKFLOW PREVENTER ASSEMBLEY SHALL NOT BE PERMITIED. 7. BACKFLOW PREVENTER DEVICE SHALL BE TESTED INITIALLY AND ANNUALLY BY A CERTIFIED AND LICENSED TESTER. AT THE TIME OF INITIAL TESTING PART A AND B OF DOH 1013 FORM MUST BE COMPLETED, TEST RESULTS (FORM DOH 1013) SHALL BE FORWARDED TO WESTCHESTER
- COUNTY DEPARTMENT OF HEALTH, OWNER AND ENGINEER. 8. THE BACKFLOW PREVENTER SHALL BE REBUILT EVERY FIVE YEARS.
- 9. ALL PLUMBING WORK SHALL BE PERFORMED BY A LICENSED PLUMBER AND ACCORDING TO DEPARTMENT OF PUBLIC WORKS REGULATIONS. 10. CONTRACTOR SHALL DISINFECT AND PRESSURE TEST BACKFLOW PREVENTER ASSEMBLY BEFORE PLACING IN SERVICE. DISINFECTION SHALL BE IN ACCORDANCE WITH AWWA STANDARD C651-05 WITH THE EXCEPTION OF SECTION 4.4.2.
- 11. CONTRACTOR SHALL ADEQUATELY SUPPORT ALL PIPING AND DEVICES.

EQUIPMENT NOTES:

- 1. THE 1½" DOMESTIC WATER BACKFLOW PREVENTER ASSEMBLY SHALL BE WATTS MODEL LF009M2QT 1½" REDUCED PRESSURE ZONE BACKFLOW PREVENTER. ASSEMBLY SHALL BE LEAD FREE SUITABLE FOR PRESSURES UP TO 175 PSI AND TEMPERATURES UP TO 180°F. THE ASSEMBLY SHALL INCLUDE TWO RESILIENT SEATED ISOLATION VALVES, FOUR RESILIENT SEATED TEST COCKS AND AN AIR GAP DRAIN FITTING.
- 2. THE 4" FIRE SERVICE BACKFLOW PREVENTER ASSEMBLY SHALL BE ZURN MODEL 350DA 4" DOUBLE CHECK DETECTOR ASSEMBLY BACKFLOW PREVENTER WITH OSY SHUTOFF VALVES. ASSEMBLY SHALL BE LEAD FREE SUITABLE FOR PRESSURES UP TO 175 PSI AND TEMPERATURES UP TO 110°F (CONSTANT) AND 140°F (INTERMITTENT). ASSEMBLY SHALL HAVE FDA EPOXY COATED CAST IRON BODY, BRONZE SEALS, STAINLESS STEEL TRIM, BRONZE RELIEF VALVE AND BRONZE BODY TEST COCKS. DEVICE SHALL HAVE (2) INTEGRAL UL/FM OUTSIDE STEM AND YOKE RESILIENT SEATED GATE VALVES.
- 3. PRESSURE REDUCING VALVE (PRV): WATTS LFN223BS WITH ADJUSTABLE PRESSURE RANGE.
- 4. BACKWATER VALVE: WATTS BV-200 IN-LINE BACKWATER VALVE.
- 5. THE 1½" DOMESTIC WATER METER WITH INTEGRAL STRAINER SHALL BE SUBJECT TO THE REVIEW AND APPROVAL OF THE LOCAL WATER UTILITY. FINAL WATER METER AND SIZE, MODEL, AND DIMENSIONS SHALL BE DETERMINED & APPROVED BY THE LOCAL WATER UTILITY. THE PLUMBING CONTRACTOR IS RESPONSIBLE FOR COORDINATION AND INSTALLATION AND ALL RELATED WATER DEPARTMENT FEES.



SYMBOL	S AND A	ABBREVIATIONS
SYMBOL	ABBREVIATION	DESCRIPTION
	CW	COLD WATER
-	AFF	ABOVE FINISHED FLOOR
-	BFP	BACK FLOW PREVENTER
_	DCV	DOUBLE CHECK VALVE
_	DN.	ELBOW DOWN
_	MAX.	MAXIMUM
_	MIN.	MINIMUM
_	PC	PLUMBING CONTRACTOR
_	RPZ	REDUCED PRESSURE ZONE
_	TYP	TYPICAL
>	_	DIRECTION OF FLOW

BUILDING INFORMATION

ADDRESS: 105 WALKER ROAD, VALHALLA, NY 10595 COUNTY: WESTCHESTER COUNTY

SITE ELEVATION: THE SITE IS OUTSIDE OF THE 100 YEAR FLOOD PLAIN.


INSTALLATION NOTES:


- A. NO STRAINER IS TO BE USED ON A FIRE LINE WITHOUT INSURANCE UNDERWRITER APPROVAL.
- B. ASSEMBLIES SHOULD BE SPECIFIED AND INSTALLED WITH MANUFACTURER SUPPLIED VALVES. C. WATER LINES SHOULD BE THOROUGHLY FLUSHED BEFORE INSTALLATION OF DEVICE TO
- PREVENT DEBRIS FOULING THE DEVICE CHECK VALVES.
- D. DEVICES MUST BE MOUNTED HORIZONTALLY UNLESS APPROVED FOR VERTICAL INSTALLATION. ASSEMBLIES SHOULD NOT BE INSTALLED IN AREAS CONTAINING CORROSIVE OR TOXIC GASES
- WHICH COULD RENDER THE DEVICE INOPERABLE.

NOTE: INSTALLATION SHALL BE IN ACCORDANCE WITH WESTCHESTER COUNTY DEPARTMENT OF HEALTH REQUIREMENTS.


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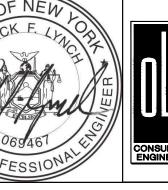
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Tel 845-353-1300

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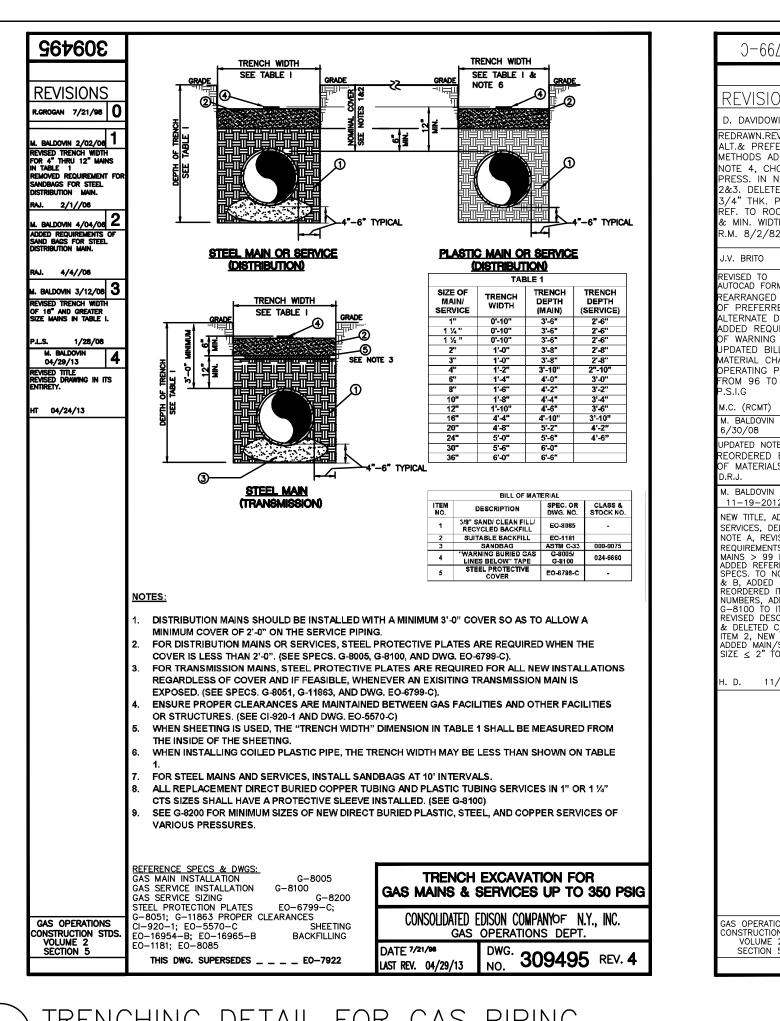
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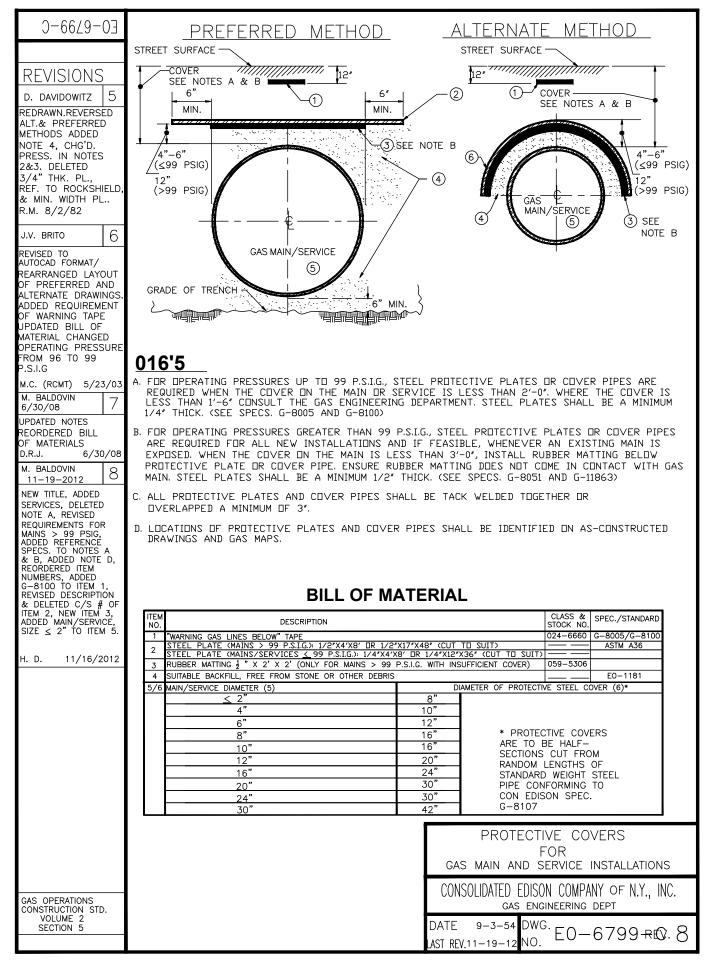
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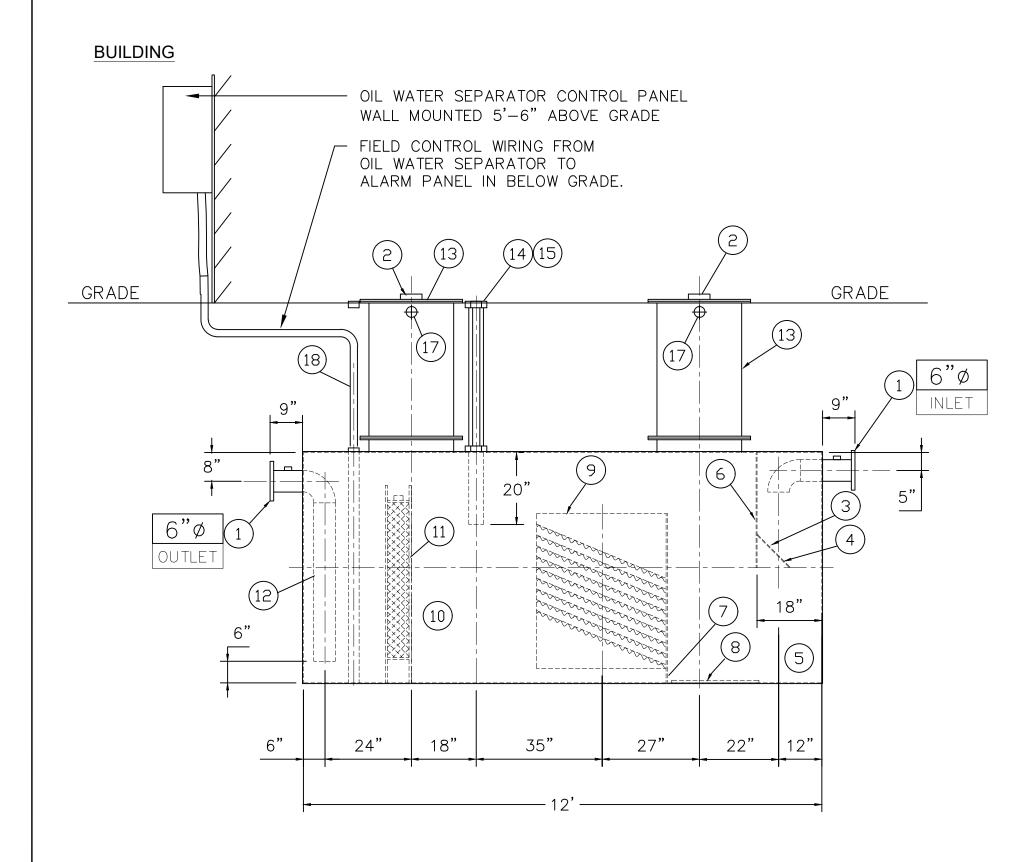
WESTCHESTER COUNTY, NEW YORK DEPARTMENT OF PUBLIC WORKS AND TRANSPORTATION DIVISION OF ENGINEERING
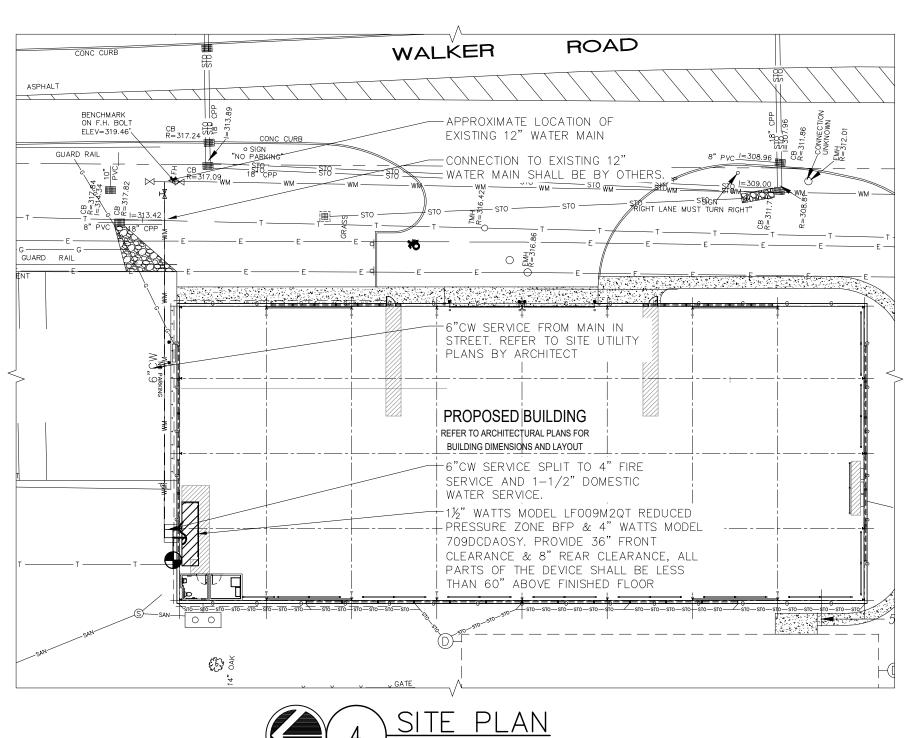
> NEW EQUIPMENT STORAGE BUILDING RICHARD A. FLYNN, SR. FIRE TRAINING CENTER VALHALLA CAMPUS, VALHALLA, NEW YORK PLUMBING BACKFLOW PREVENTER PLAN

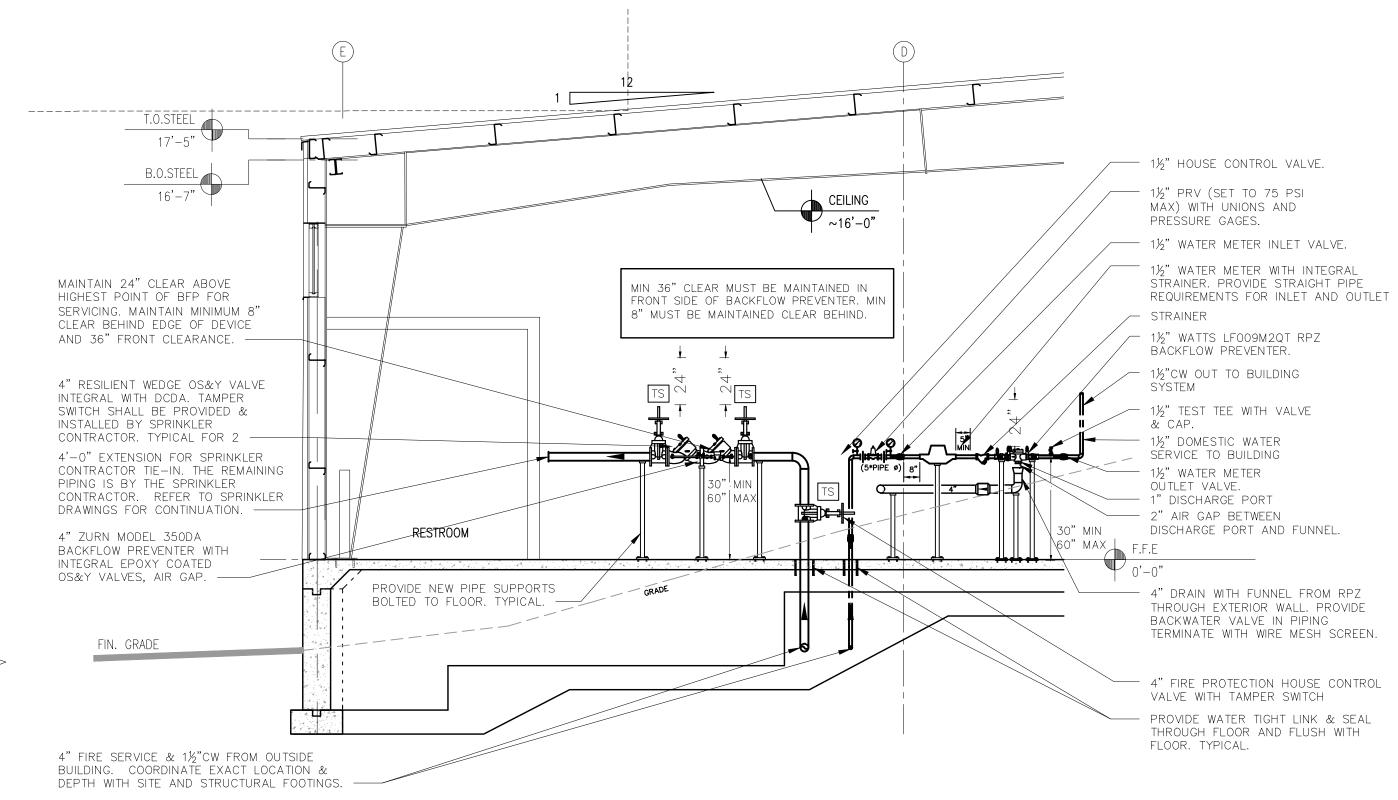SHEET NUMBER CONTRAC' NUMBER $P - 40^{\circ}$ 17-521 SHEET NO. 35 OF 53 SCALE: AS SHOWN DATE: 11/16/2021 DPW FILE NO. 38-47-P-717-O**|** C




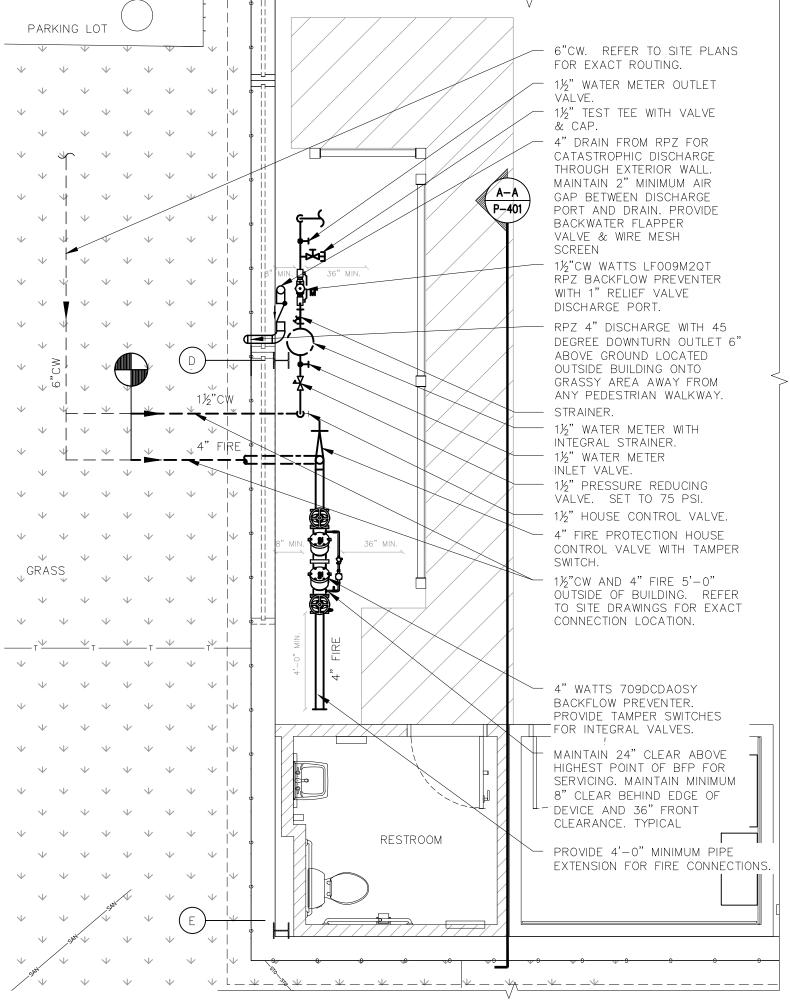



- 1. 150# R.F.S.O. FLANGE W/ 2" FNPT FOR VENT
- 4"ø FNPT FOR GAUGE WITH PLUG
- 3. VELOCITY HEAD DIFFUSION BAFFLE 4. WEAR PLATE
- 5. SEDIMENT CHAMBER
- UNDERFLOW BAFFLE (REMOVABLE)
- 7. SLUDGE BAFFLE 8. STRIKER PLATES
- 9. PARALLEL CORRUGATED PLATE COALESCER. CORELLA PVC PLATES (3" PLATE SPACING)
- 10. OIL/WATER SEPARATOR CHAMBER
- 11. 6" THICK PETROSCREEN COALESCER MATERIAL INSTALLED
- W/ PULL ROD SHIPPED LOOSE 12. STEEL OUTLET DOWNCOMER
- 13. 30"ø MANWAY WITH NEO-CORK GASKET. BOLT-ON EXTENSION SHIPPED LOOSE. COORDINATE EXACT
- EXTENSION REQUIRED WITH FINAL GRADING. 14. 4"Ø FNPT FOR OIL PUMP-OUT WITH INTERNAL PVC PIPE INSTALLED & RISER PIPE SHIPPED LOOSE. COORDINATE EXACT HEIGHT WITH FINAL GRADING AND EXTEND IN FIELD
- 15. 2" FNPT FOR LEVEL SENSOR WITH RISER PIPE SHIPPED
- LOOSE 16. LIFTING LUG
- 17. 2"ø FNPT FOR VENT. EXTEND TO 36" ABOVE GRADE WITH GOOSE NECK.
- 18. 2" FNPT FOR LEAK SENSOR WITH RISER PIPE SHIPPED LOOSE


TRENCHING DETAIL FOR GAS PIPING

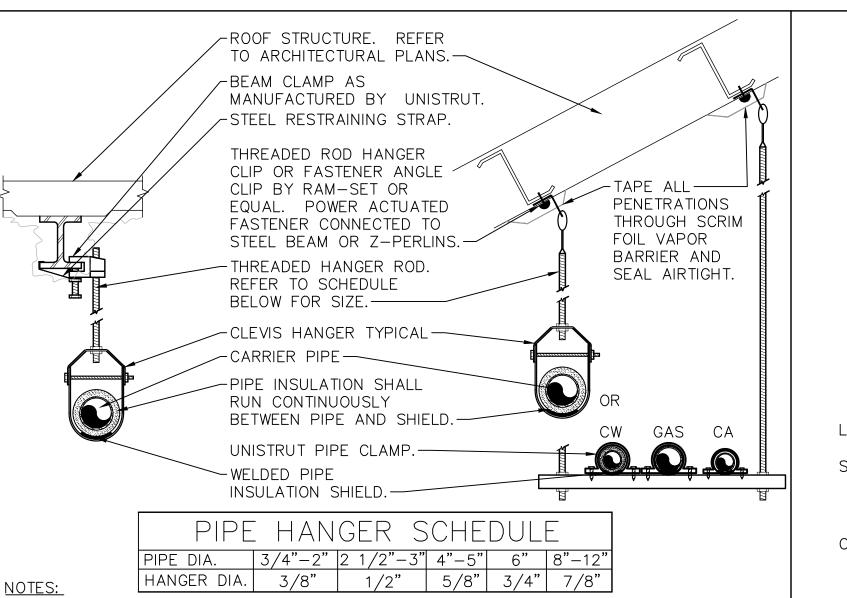

- 1.) CLEVIS HANGERS WITH WELDED INSULATION SHIELDS SIMILAR TO RAUCH FIG. 100SH ON ALL PIPES LARGER THAN 1"
- 2.) FOR PIPES 1" OR SMALLER, A BAND HANGER WITH INSULATION SHIELD MAY BE USED SIMILAR TO RAUCH FIG. NO. 1ASH.
- 3.) FOR NON-INSULATED PIPE, INSULATION SHIELDS MAY BE OMITTED.
- 4.) ALL PIPE HANGERS SHALL BE GALVANIZED STEEL OR FACTORY PAINTED BLACK WITH ENAMEL. 5.) FOR NON FERROUS PIPING WITHOUT INSULATION, ALL HANGERS SHALL BE COPPER
- PLATED OR FURNISHED WITH A DI-ELECTRIC BETWEEN PIPE AND HANGERS. 6.) WHERE EXISTING BUILDING STRUCTURAL COMPONENTS HAVE FIREPROOF MATERIAL, ANY AREA THAT IS DISTURBED OR DAMAGED AS A RESULT OF HANGER INSTALLATION
- SHALL BE PATCHED WITH UL AND FM APPROVED FIREPROOFING TO MATCH EXISTING. 7.) ALL HANGER PENETRATIONS THROUGH VAPOR BARRIER SHALL BE TAPED AND SEALED.
- 8.) REFER TO SPECIFICATIONS FOR SPACING REQUIREMENTS.

Tel 845-353-1300




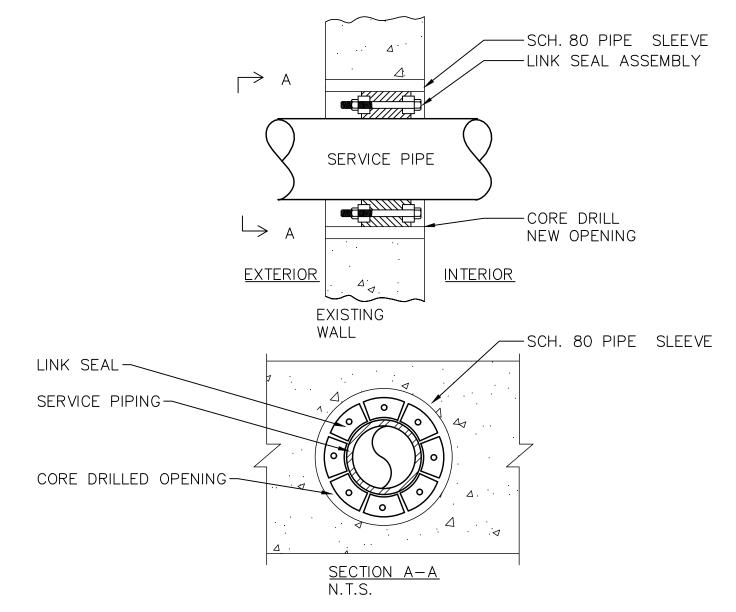


1.) SEAL ASSEMBLY BASED ON THUNDERLINE MODEL "C" LINK-SEAL MODULAR SEAL, WITH EPDM SEAL ELEMENT, COMPOSITE PRESSURE PLATES, STEEL WITH 2-PART ZINC DICHROMATE & ORGANIC COATED NUTS AND BOLTS RATED FOR AN OPERATING TEMPERATURE RANGE OF -40°F TO +250°F


2.) USE LINK SEAL AT ALL LOCATIONS WHERE PIPES PENETRATE EXTERIOR WALLS,


ABOVE GRADE OR BELOW GRADE. PIPE LINK SEAL DETAIL

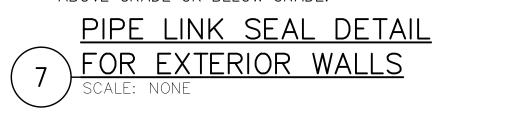

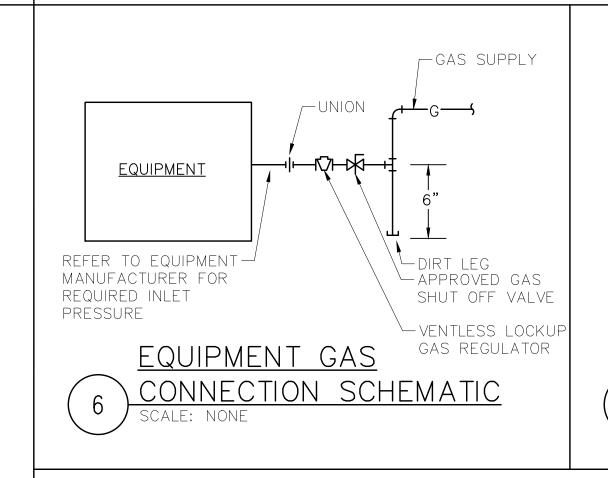



OIL WATER SEPARATOR SCHEMATIC

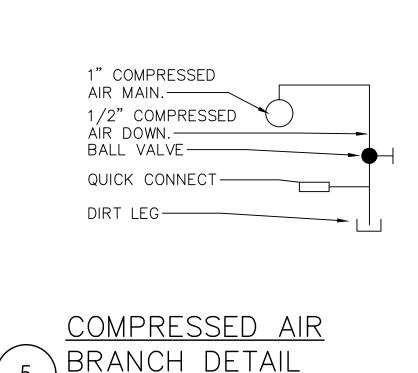

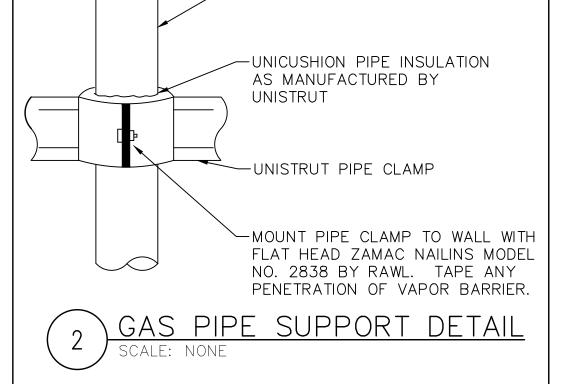

-(N)GAS LINE

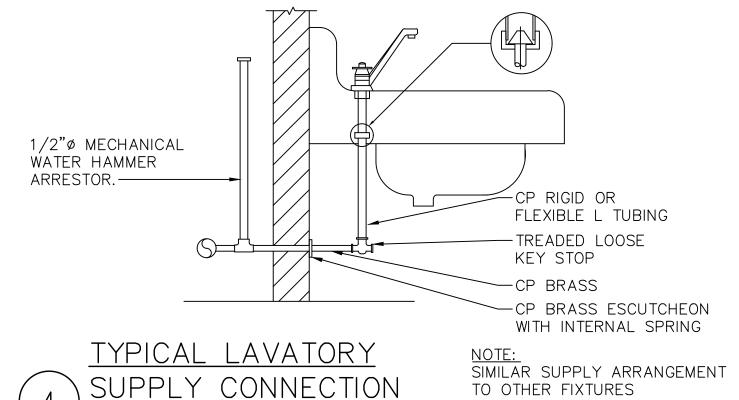

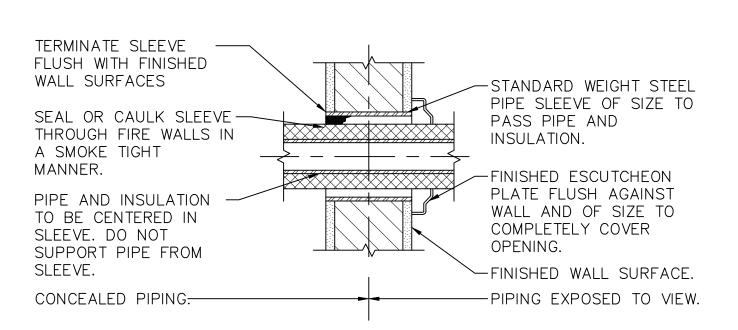






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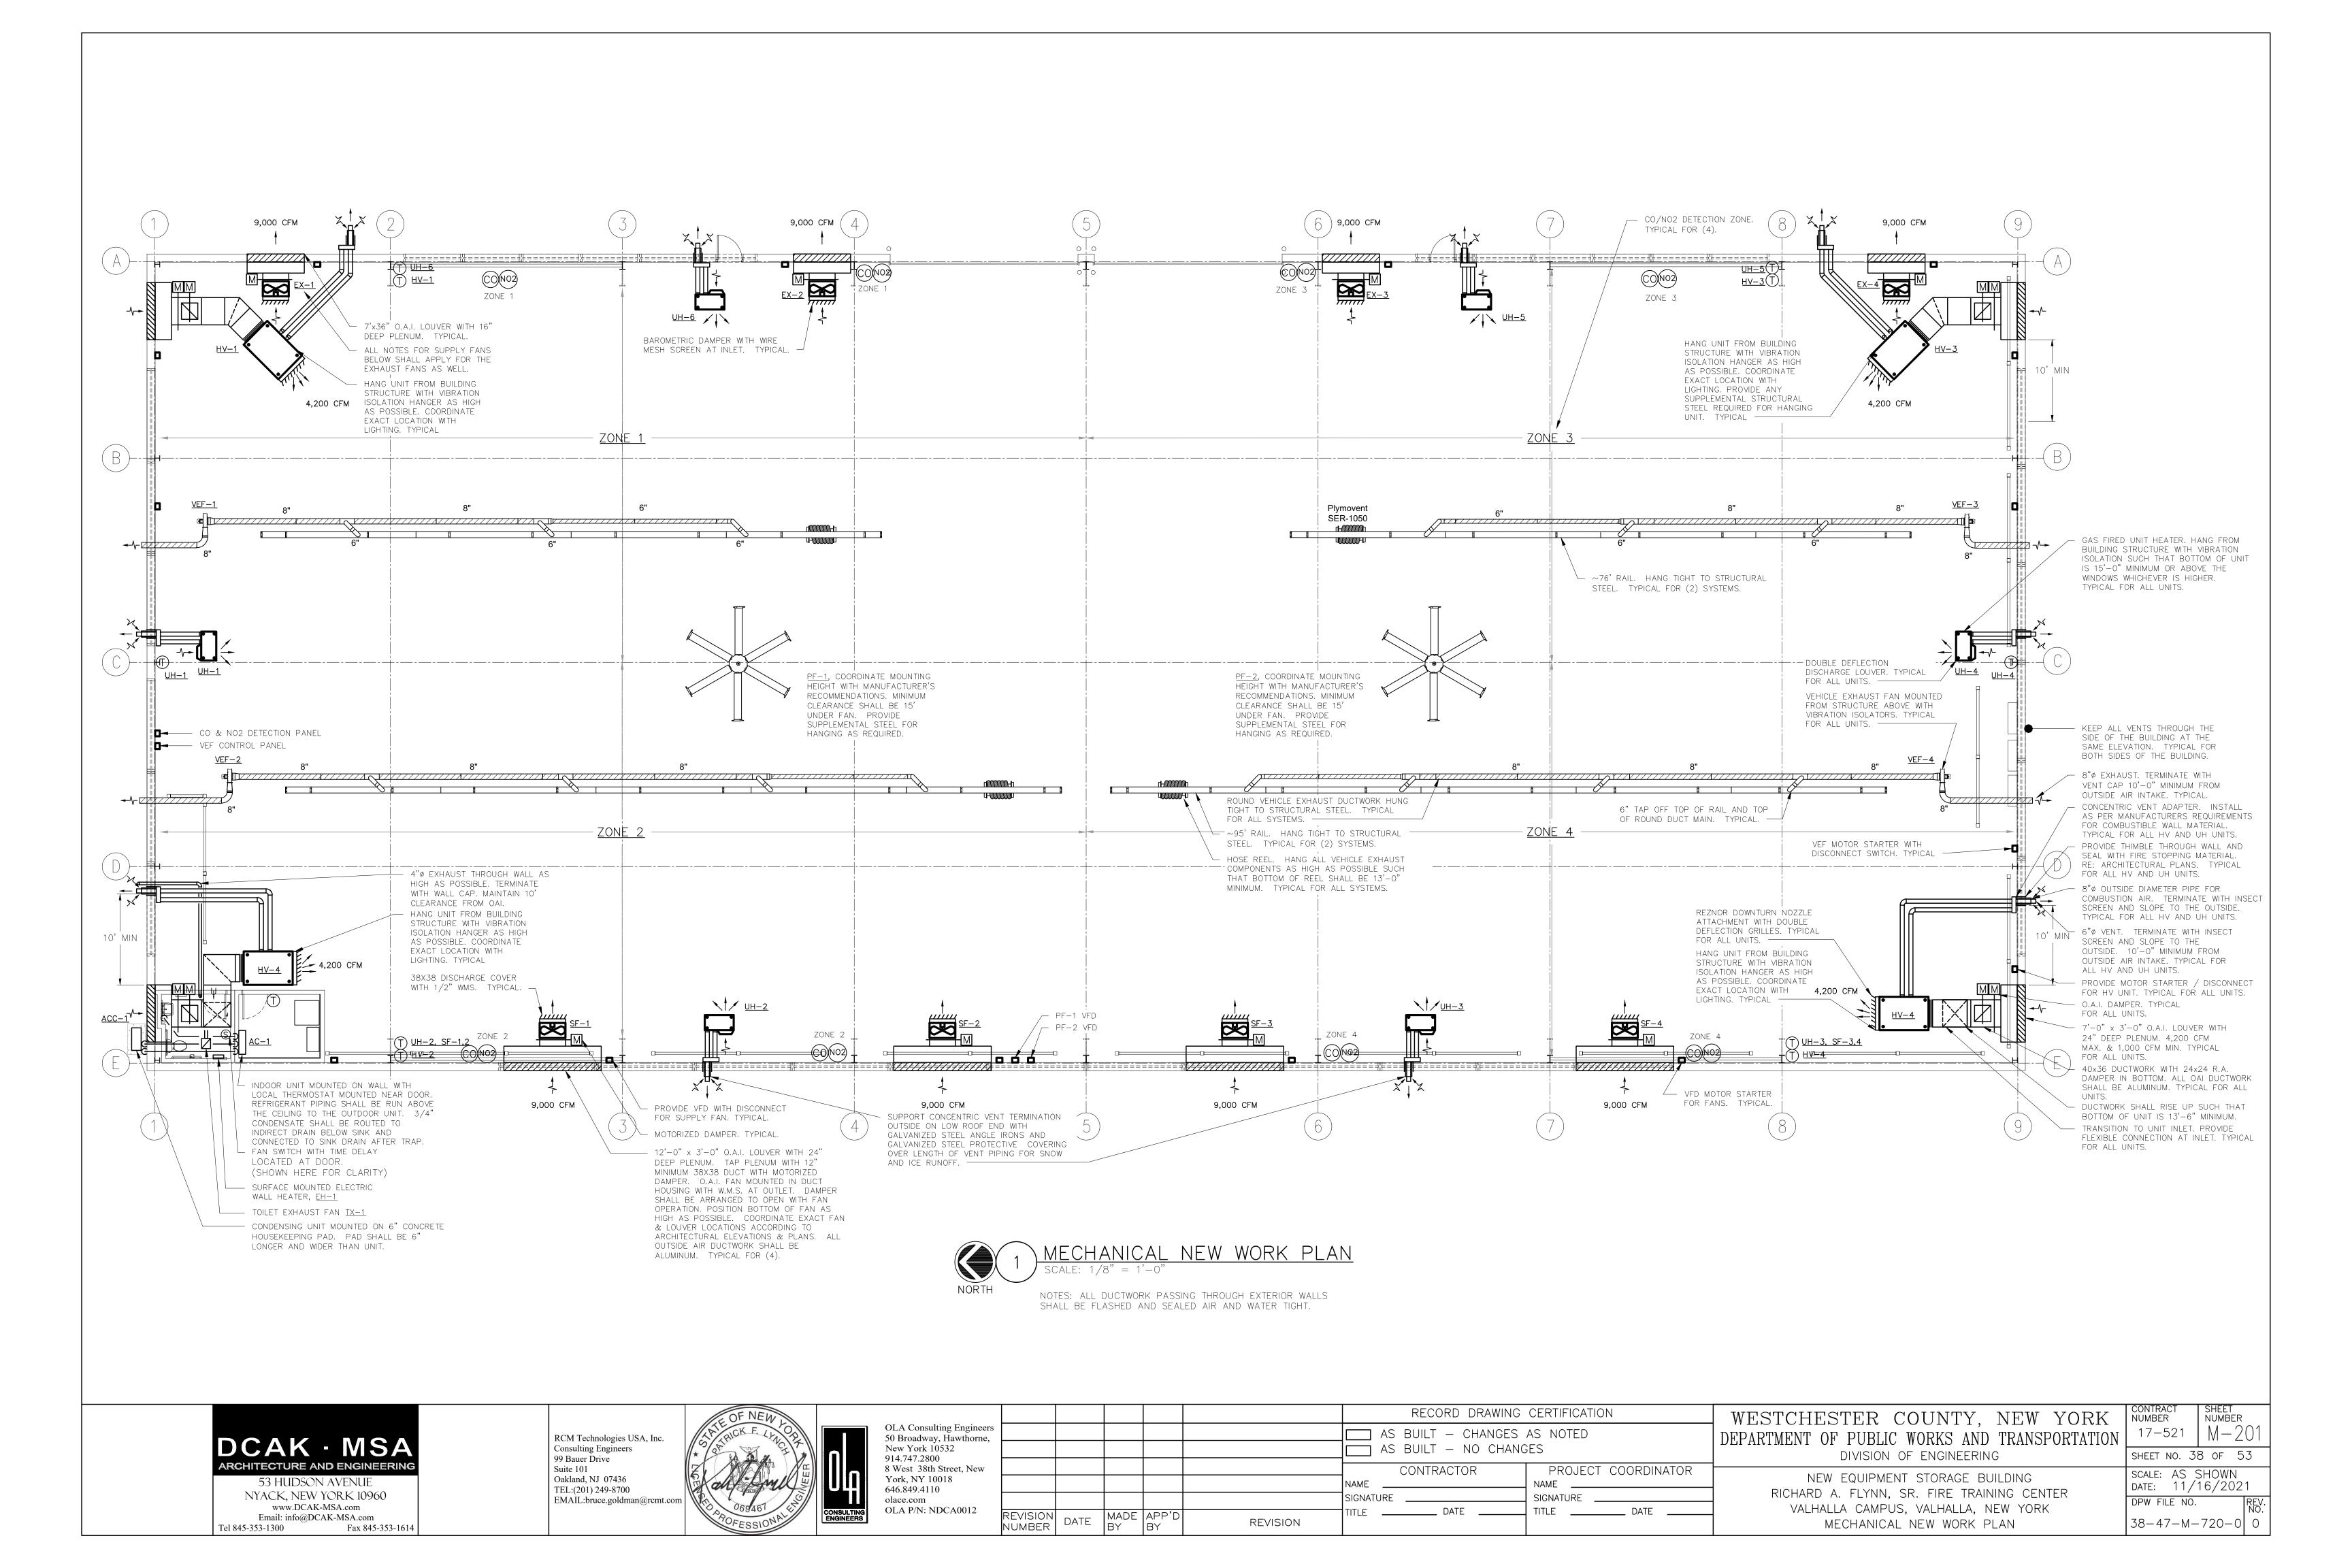
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WESTCHESTER COUNTY, NEW YORK DEPARTMENT OF PUBLIC WORKS AND TRANSPORTATION DIVISION OF ENGINEERING

NEW EQUIPMENT STORAGE BUILDING RICHARD A. FLYNN, SR. FIRE TRAINING CENTER VALHALLA CAMPUS, VALHALLA, NEW YORK PLUMBING DETAILS

CONTRACT NUMBER 17-521	SHEET NUMBER P-7	01
SHEET NO. 31	6 OF 5	3
SCALE: AS S DATE: 11/	SHOWN 16/202	1
DPW FILE NO.		REV. NO.
38-47-P-	718-0	0

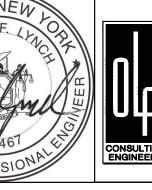		SYMBOL	& ABBRE\	VIATIONS	GENERAL NOTES
		SYMBOL	ABBREVIATION	DESCRIPTION	1. CONTRACT DRAWINGS, AS FAR AS THEY RELATE TO THE GENERAL ARRANGEMENT A
			AFF AP	ABOVE FINISHED FLOOR ACCESS PANEL	LOCATION OF EQUIPMENT, SHEET METAL, AND PIPING, SHALL BE UNDERSTOOD DIAGRAMMATIC. ANY CHANGES TO EQUIPMENT, SHEET METAL, AND PIPING LOCATIC NECESSARY TO AVOID INTERFERENCE WITH OTHER TRADES SHALL BE MADE AT EXTRA COST, AND MUST BE APPROVED BY THE ENGINEER.
		_	BDD	BACKDRAFT DAMPER	2. THE MECHANICAL CONTRACTOR SHALL INSTALL FIRE DAMPERS WITH ACCESS DOORS ALL DUCTS PENETRATING FIRE RATED WALLS, WHETHER SPECIFICALLY SHOWN ON TORAWINGS OR NOT.
				BRAKE HORSEPOWER BRITISH THERMAL UNIT	3. ALL MOTOR STARTERS AND DISCONNECT SWITCHES FOR HVAC EQUIPMENT SHALL
		_		CUBIC FEET PER MINUTE	FURNISHED BY THE MECHANICAL CONTRACTOR AND INSTALLED BY THE ELECTRIC CONTRACTOR, UNLESS OTHERWISE NOTED. DISCONNECT SWITCHES FURNISHED BY
		_	_	CENTERLINE	MECHANICAL CONTRACTOR FOR HVAC EQUIPMENT SHALL BE HEAVY DUTY TYPE.
		_		DRY BULB TEMPERATURE	4. DUCT DIMENSIONS SHOWN ON MECHANICAL DRAWINGS REFER TO INSIDE CLEAR DUDIMENSIONS. WHERE DUCTWORK IS LINED, THE MECHANICAL CONTRACTOR SHA
		_	DIA. OR Ø		INCREASE THE SIZE OF DUCT TO COMPENSATE FOR LINING.
		_	DX	DIRECT EXPANSION	5. LOCATE THERMOSTATS, TEMPERATURE SENSORS, AND CO DETECTORS 5'-6" ABOUT FINISHED FLOOR UNLESS OTHERWISE NOTED. COORDINATE LOCATION WITH FURNITU CABINETS, ETC. FURNISH LOCKING TAMPERPROOF COVER FOR ALL NEW THERMOSTA
		_	EA	EXHAUST AIR	IN PUBLIC AREAS.
		_	EAT	ENTERING AIR TEMPERATURE	6. THE MECHANICAL CONTRACTOR SHALL NOTE THAT, IN ADDITION TO THE SPECIFICATION AND DETAILS GIVEN IN THESE PLANS FOR PIPE HANGERS AND SUPPORTS, ALL HANGE
		_	EF-	EXHAUST FAN	AND SUPPORTS SHALL BE DESIGNED AND INSTALLED IN COMPLIANCE WITH APPLICAL SEISMIC CODES.
		_	EL	ELEVATION	7. THE CONTRACTORS SHALL SUBMIT FOR REVIEW AND APPROVAL A COMPOSITE SH
		_	ER	EXHAUST REGISTER	DRAWING, FULLY COORDINATED WITH ALL OTHER TRADES INDICATING ALL DUCTWO MECHANICAL EQUIPMENT, PIPING, ELECTRICAL EQUIPMENT, PLUMBING PIPING A
		_	ESP	EXTERNAL STATIC PRESSURE	EQUIPMENT, LIGHTS, CONDUITS, DIFFUSERS, GRILLES AND FIRE ALARM DEVICES.
		_	EWT	ENTERING WATER TEMPERATURE	8. ALL WORK SHALL COMPLY WITH STATE BUILDING CODE, LOCAL BUILDING CODE, ENERGY CODE REQUIREMENTS. IN CASE OF CONFLICT BETWEEN THE CONTR. DOCUMENTS AND A GOVERNING CODE OR ORDINANCE, THE MORE STRINGENT STAND.
		_	FPM	FEET PER MINUTE	SHALL APPLY.
		_	FPS	FEET PER SECOND	9. DURING CONSTRUCTION, ALL OPEN OR INCOMPLETE DUCTWORK SHALL BE CAP AIRTIGHT WITH WITH HEAVY POLYETHYLENE PLASTIC. AFTER THE INSTALLATION
		_		GALLONS PER MINUTE	DUCTWORK, REGISTERS, GRILLES, AND DIFFUSERS, THE CONTRACTOR SHALL BLANK ALL REGISTERS, GRILLES, AND DIFFUSERS WITH HEAVY POLYETHYLENE PLASTIC
		_	HP	HORSE POWER	TAPE AIR TIGHT, IN AREAS THAT ARE UNDER CONSTRUCTION, UNTIL WORK IS COMPLIIN THOSE AREAS. FLOOR REGISTERS AND GRILLES SHALL ALSO BE COVERED WITH 1
		_		HEATING AND VENTILATING UNIT	MASONITE.
				LEAVING AIR TEMPERATURE	10. WHEN GENERAL CONSTRUCTION IS COMPLETE, VACUUM CLEAN ALL DIFFUSE REGISTERS, GRILLES, AND HVAC EQUIPMENT IN THE PROJECT AREA OR SERVING
		_	LF	LINEAR FEET	PROJECT AREA. REMOVE ANY CONSTRUCTION DEBRIS. REPLACE ALL AIR FILTERS NEW.
		_	LWT	LEAVING WATER TEMPERATURE	11. THE OWNER'S PERMANENT HVAC EQUIPMENT SHALL NOT BE USED BY ANY CONTRAC DURING CONSTRUCTION FOR TEMPORARY HEATING, COOLING, OR VENTILATION.
			MBH OAI	1000 BRITISH THERMAL UNITS PER HOUR OUTSIDE AIR INTAKE	TEMPORARY HEATING, COOLING, OR VENTILATION IS REQUIRED AT ANY POINT DUF CONSTRUCTION, THE CONTRACTOR SHALL PROVIDE TEMPORARY HEATING, COOLING,
				POUNDS PER SQUARE INCH	VENTILATION EQUIPMENT, DUCTWORK, CONTROLS, AND POWER AT HIS OWN EXPENSE.
				RETURN AIR	12. THE CONTRACTOR SHALL BE RESPONSIBLE FOR PROVIDING TEMPORARY VENTILATION A EXHAUST AIR WHEN WELDING OR SOLDERING OPERATIONS ARE PERFORMED, AS REQUI
		_		REVOLUTIONS PER MINUTE	BY OSHA.
		_	SA	SUPPLY AIR	13. THE MECHANICAL CONTRACTOR SHALL BE RESPONSIBLE FOR OBTAINING AND PAY FOR ALL NECESSARY PERMITS AND FOR PAYING RELATED FEES.
		_	SP	STATIC PRESSURE	14. THE MECHANICAL CONTRACTOR SHALL PROVIDE ALL CUTTING, PATCHING, CORE DRILL
		_	TSP	TOTAL STATIC PRESSURE	ACCESS PANELS, PAINTING, AND FINAL RESTORATION REQUIRED TO FACILITATE INSTALLATION OF HVAC DUCTWORK, CONTROL CONDUITS, AND PIPING, INCLUDING AB CEILINGS AND IN SHAFTS THAT WILL NOT BE REPLACED OR OPENED UNDER ANY OT
		_	TYP.	TYPICAL	SCOPE OF WORK RELATED TO THIS PROJECT. CONTRACTOR TO REMOVE AND REPL CEILINGS, AND OPEN AND PATCH SHAFTS AND WALLS, AS REQUIRED TO EXECUTE
		_	U.O.N.	UNLESS OTHERWISE NOTED	MECHANICAL WORK.
		_	UH-	UNIT HEATER	
		_	WG	INCHES OF WATER GAUGE	
		_	WMS	WIRE MESH SCREEN	
		_	WG	INCHES OF WATER GAUGE	
			NEW	NEW WORK	
			_	THERMOSTAT	
		M	_	MOTORIZED DAMPER	
		CO(NO2)	_	COMBINATION CO & NO2 SENSOR AIR INTO REGISTER	
		₩	_	POINT OF CONNECTION DISCONNECTION	
			_	SUPPLY DUCT UP	
			_	SUPPLY DUCT DOWN	
			_	RETURN DUCT UP	
			_	RETURN DUCT DOWN	
			VD	VOLUME DAMPER	
		6x8		DUCT SIZE - 1ST FIGURE IS SIDE SHOWN	
			FC	FLEXIBLE CONNECTION	
		SECT# DWG#		SECTION CALLOUT	
					TATE CONTRACT SHFF
	RCM Technologies USA, Inc. OLA Consulting Engineers 50 Broadway, Hawthorne,			RECORD DRAWING CERTIFICATION S BUILT — CHANGES AS NOTED	WESTCHESTER COUNTY, NEW YORK CONTRACT SHEE NUMBER OF PUBLIC WORKS AND TRANSPORTATION 17-521 M-
	RCM Technologies USA, Inc. 50 Broadway, Hawthorne,	+ +			DEPARTMENT OF PUBLIC WORKS AND TRANSPORTATION 1/-521 M-
DCAK - MSA	O 10 E 1		A	S BUILT — NO CHANGES	DIVISION OF ENGINEERING SHEET NO. 37 OF
DCAK - MSA ARCHITECTURE AND ENGINEERING 53 HUDSON AVENUE NYACK, NEW YORK 10960	Constitute Bigineers		NAME _	S BUILI — NO CHANGES CONTRACTOR PROJECT COORDINAT NAME	DIVISION OF ENGINEERING SHEET NO. 37 OF



FAN SCHEDULE								
DESIGNATION	EX-1,2,3,4 SF-1,2,3,4	TX-1	PF-1,2					
MANUFACTURER	GREENHECK	GREENHECK	BIG ASS SOLUTIONS					
MODEL	SBE-3H30	SP-A90	BASIC 6					
WEIGHT (LBS)	112	12	231					
FAN TYPE	PROPELLER	CEILING MOUNTED	CEILING FAN					
DRIVE TYPE	BELT	DIRECT	DIRECT					
CFM	9,000	75	66					
ВНР	1.14	_	_					
HP	1.5	16 WATTS	1.5					
RPM	965	900	61					
SP (IN H ₂ O)	0.25	.25	0.5					
VOLTS/Ø/Hz	480/3/60	120/1/60	480/3/60					
STARTER TYPE	VFD	TIME DELAY SWITCH	VFD					

- 1. ALL MOTORS 1 HP OR GREATER SHALL BE PREMIUM EFFICIENCY.
- 2. ALL MOTORS FURNISHED WITH VARIABLE FREQUENCY DRIVES SHALL BE INVERTER DUTY RATED & APPROVED FOR VARIABLE SPEED AND TORQUE APPLICATIONS.
- 3. FURNISH RUBBER IN SHEAR OR SPRING VIBRATION ISOLATORS AS PER THE SPECIFICATION.
- 4. FURNISH WALL MOUNTED SPEED CONTROLLER OR THERMOSTAT AS INDICATED ON PLAN.
- 5. FURNISH MOTOR AND BELT GUARDS FOR ALL EXTERNAL MOTOR DRIVES. 6. MOTOR STARTER AND DISCONNECT SWITCH FOR EACH FAN SHALL BE FURNISHED BY THE MECHANICAL CONTRACTOR AND INSTALLED BY THE ELECTRICAL CONTRACTOR.
- 7. MANUAL MOTOR STARTERS FOR FANS SHALL BE SQUARE D, TYPE T OR M, WITH PUSH-BUTTON START/STOP, PILOT LIGHT, & AUXILIARY CONTACTS, SUITABLE FOR SURFACE MOUNTING.
- 8. TX-1: PROVIDE MODEL WC-4 HOODED WALL CAP WITH BUILT IN BIRDSCREEN & BAROMETRIC BACKDRAFT DAMPER WHERE INDICATED ON PLAN.
- 9. PROVIDE BAROMETRIC DAMPER WITH WIRE MESH SCREEN AT INLET FOR EXHAUST FANS AND OUTLET FOR SUPPLY FANS.
- 10. CONTROLS SHALL BE COMPATIBLE WITH THE BUILDING ANDOVER SYSTEM & NETWORKED INTO THE COUNTY WIDE ANDOVER SYSTEM. COORDINATE WITH CONTROLS CONTRACTOR.

HEATING & VENTILATION UNIT SCHEDULE

DESIGNATION	HV-1	HV-2,3,4
MANUFACTURER	REZNOR	REZNOR
MODEL	SDH-300	SDH-300
WEIGHT OF UNIT (LBS)	629	629
DESIGN DATA:		
SUPPLY AIR (CFM)	4,200	4,200
OUTDOOR AIR MINIMUM (CFM)	1,100	0
OUTDOOR AIR MAXIMUM (CFM)	4,200	4,200
RETURN AIR MINIMUM (CFM)	0	0
RETURN AIR MAXIMUM (CFM)	3,100	4,200
SUMMER OA TEMP (°F) DB/WB	86/72	86/72
SUMMER RA TEMP (°F) DB/WB	80	80
WINTER OA TEMP (°F)	10	10
WINTER RA TEMP (°F)	60	60
GAS-FIRED FURNACE:	•	
E.A.T./L.A.T. (°F)	10/63	10/63
GAS INPUT/OUTPUT (MBH)	300/243	300/243
CONTROL STAGES	8	8
FILTERS:		•
MAIN FILTER	MERV 8	MERV 8
QUANTITY/SIZE	3 / 16×16 3 / 16×20	3 / 16x16 3 / 16x20
SUPPLY FAN:		
DESIGN AIRFLOW (CFM)	4,200	4,200
BHP/HP	2.0/3.0	2.0/3.0
RPM	991	991
ESP/TSP (IN H ₂ 0)	-/0.75	-/0.75
VOLTS/ø/Hz	460/3/60	460/3/60
STARTER TYPE	НОА	НОА
ELECTRICAL DATA — SINGLE POINT	POWER CONNECTION:	
VOLTS/Ø/Hz	460/3/60	460/3/60
FLA/MCA (AMPS)	7.6/9.5	7.6/9.5

NOTES:

STANDARD COMPONENTS:

- 1. 81% EFFICIENCY SEPARATED COMBUSTION SYSTEM.
- 2. CIRCUIT BREAKER PROTECTED TRANSFORMER FOR 24V CONTROLS. 3. INTEGRATED CIRCUIT BOARD WITH DIAGNOSTIC INDICATOR LIGHTS
- 4. MULTI-TRY DIRECT SPARK IGNITION WITH 100% LOCKOUT
- 5. HIGH TEMP LIMIT CONTROL 6. RUBBER-IN-SHEER VIBRATION ISOLATION
- REVERSE AIRFLOW LIMIT SWITCH
- AIRFLOW PRESSURE SWITCH TO VERIFY CIRCULATING BLOWER OPERATION
- 9. SOCKETED. HIGH QUALITY SWITCHING RELAYS TO FACILITATE SERVICE 10. ALL SERVICE AND VENT CONNECTIONS FROM A SINGLE SIDE
- 11. ENGINEERED HEAT EXCHANGER CONDENSATE MANAGEMENT

REQUIRED OPTIONS:

- 1. HORIZONTAL CONCENTRIC ADAPTER BOX (CC6)
- 2. 409 STAINLESS STEEL HEAT EXCHANGERS WITH EXTENDED 10 YEAR WARRANTY 3. BURNER CONTROLS WITH 4:1 GAS MODULATION

- 4. UNIT MOUNTED LOCAL DISCONNECT SWITCH FURNISHED BY THE MECHANICAL CONTRACTOR AND INSTALLED BY THE ELECTRICAL CONTRACTOR.
- 5. FIRESTAT 6. DISCHARGE AIR TEMPERATURE LOW LIMIT
- 7. OVER / UNDER VOLTAGE OR PHASE LOSS PROTECTION
- 8. HIGH AMBIENT LIMIT (BURNER CUTOFF)
- 9. GAS PRESSURE SWITCHES.
- 10. DOWNTURN NOZZLES STYLE CD 25-65° WITH DOUBLE DIRECTIONAL LOUVERS. 11. CONTROL OPTION AG58 - EXTERNAL CONTROLS WITH 8:1 GAS MODULATION. CONTROLS SHALL BE COMPATIBLE WITH THE BUILDING ANDOVER SYSTEM & NETWORKED INTO THE COUNTY WIDE ANDOVER SYSTEM. COORDINATE WITH CONTROLS CONTRACTOR.
- 12. BACNET DDC COMMUNICATION CARD.

EQUIPMENT NOTES

- MOTORIZED DAMPERS: SHALL BE RUSKIN MODEL CD40, 4" DEEP EXTRUDED ALUMINUM AIRFOIL DAMPER. DAMPER SHALL HAVE OPPOSED BLADES, MOTOR AND LINKAGE. DAMPERS SHALL BE 120V/16/60Hz, 3 AMPS MAX. FURNISH DISCONNECT SWITCH.
- 2. <u>LISTED SPECIAL GAS VENTING:</u> FOR ALL GAS FIRED DIRECT VENTING CONDENSING & NON-CONDENSING APPLIANCES SHALL BE HEATFAB "SAF-T VENT CI PLUS". DOUBLE WALL CONSTRUCTION, 1" FIBERGLASS INSULATION, AL-29-4C STAINLESS STEEL. SPECIAL VENT UL 1738 FOR POSITIVE, NEUTRAL, AND NEGATIVE DRAFT UP TO 15"WC. PRODUCT IS RATED FOR ZERO CLEARANCE TO COMBUSTIBLES. PROVIDE STRAIGHT SECTIONS, ELBOWS, OFFSETS, CONNECTION ADAPTERS, WALL SLEEVES, AND SCREENED TERMINATIONS.
- 3. OUTSIDE AIR INTAKE: FOR ALL GAS FIRED DIRECT VENTING CONDENSING & NON-CONDENSING APPLIANCES SHALL BE SINGLE-WALL SPIRAL GALVANIZED STEEL BY SHEET METAL CONNECTORS, INC. ALL DUCTWORK IS 4-PLY SPIRAL LOCKSEAM MEETING ASTM A-653. ALL DUCT CONNECTIONS SHALL BE MADE WITH A DOUBLE LEGGED EPDM GASKET CREATING AN AIR-TIGHT CONNECTION MEETING ASTM A-653. SINGLE-WALL DUCT GUAGE SHALL BE SELECTED FOR POSITIVE, NEUTRAL, AND NEGATIVE DRAFT UP TO 15"WC WITH A MINIMUM GAUGE OF 24. PRODUCT IS RATED FOR ZERO CLEARANCE TO COMBUSTIBLES. PROVIDE STRAIGHT SECTIONS, ELBOWS, OFFSETS, CONNECTION ADAPTERS, WALL SLEEVES, AND SCREENED TERMINATIONS.
- 4. GAS-FIRED UNIT HEATERS (UH-1,2,3,4,5,6): SHALL BE MODINE MODEL PTS250, 250 MBH INPUT. 205 MBH OUTPUT. UNITS SHALL BE DIRECT-VENT SEPARATED COMBUSTION TYPE WITH 6"Ø FLUE OUTLET, 6"Ø AIR INLET, AND 3/4"Ø EXTERNAL GAS CONNECTION. FAN SHALL BE 1/3 HP, 1075 RPM. ELECTRICAL REQUIREMENTS: 120V/1¢/60HZ, 4.6 FAN AMPS (FAN ONLY), 8.1 TOTAL AMPS (UNIT TOTAL). PROVIDE STARTER/LOCAL DISCONNECT, AND 10 YEAR WARRANTY ON HEAT EXCHANGER. FURNISH WITH SINGLE-STAGE, DIRECT SPARK IGNITION CONTROLS, WITH 100% SHUT-OFF AND CONTINUOUS RETRY. PROVIDE HORIZONTAL CONCENTRIC VENT KIT WITH EACH UNIT.
- 5. <u>ELECTRIC WALL HEATER (EH-1):</u> SHALL BE MARKEL MODEL F 3453 T SURFACE MOUNTED, 3,000 WATTS INPUT, 208/1/60, 14.4 AMPS, 10,239 BTUS. ROUGH IN DIMENSIONS 23"Hx15"Wx4.125"D UNITS CORROSION RESISTANT STEEL ELEMENT, BRAZED STEEL FINS. COORDINATE COLOR WITH ARCHITECT. FURNISH AND INSTALL THE FOLLOWING FIELD-INSTALLED OPTIONS: THERMOSTAT & DISCONNECT SWITCH.
- 6. CO & NO, DETECTION SYSTEM: SHALL BE SIERRA MONITOR CORPORATION. PROVIDE SENTRY 5000-IT CONTROLLER (SEE PLANS FOR LOCATION). PROVIDE ALL COMPONENTS AND WIRING FOR A COMPLETE INSTALLATION AND OPERABLE SYSTEM. ALL SPACE TRANSMITTERS SHALL BE MOUNTED 5'-0" AFF IN A PROTECTED LOCATION. PROVIDE EXTERNAL BATTERY BACKUP. PROVIDE SIGNAGE "CO & NO2 DETECTION" ON CONTROL
 - CO TRANSMITTERS SHALL BE 5100-04-IT-S1-01-00-0-0-C • NO₂ TRANSMITTERS SHALL BE 5100-12-IT-S1-01-00-0-0-C
- 7. <u>VEHICLE EXHAUST SYSTEM (VEF-1, VEF-2, VEF-3, VEF-4)</u>: SHALL BE BASED ON PLYMOVENT. EACH SYSTEM SHALL CONSIST OF (1) STATIONARY SPRING ACTUATED HOSE REELS #SER-1050 MOUNTED SUCH THAT BOTTOM OF HOSE REEL IS AT 13' AFF. EACH HOSE REEL SHALL HAVE 33'L 6"\$\phi\$ HOSE #SNF-2 CAPABLE OF 600\text{F} CONTINUOUS & 1250°F INTERMITTENT VEHICLE EXHAUST. 400°F TEMPERATURE RESISTANCE ON ALL COMPONENTS. PROVIDE TAILPIPE ADAPTERS AS LISTED IN THE SPECIFICATIONS. EACH FAN SHALL BE FUA-3000 2HP RATED FOR 720 CFM AT 8"WC SP, 460/3/60, 80LBS. PROVIDE PLYMOVENT ES-90 CONTROL BOX EACH FAN. PROVIDE AN NTX NEMA 4X WALL MOUNT TRANSMITTER FOR EACH SYSTEM WITH 433 MHz RCR24SS RECEIVER MOUNTED TO EACH HOSE REEL. REFER TO VEHICLE EXHAUST SPECIFICATIONS SECTION 238416 FOR FULL EQUIPMENT REQUIREMENTS.
- 8. <u>VEHICLE EXHAUST DUCTWORK:</u> US DUCT CLAMPABLE DUCTING. GALVANIZED DUCT WITH WELDED ENDS, WELDED ANGLE RINGS, OR LOOSE ANGLE RINGS WITH LIPPED ENDS. REFER TO VEHICLE EXHAUST SPECIFICATIONS SECTION 238416 FOR FULL DUCTWORK REQUIREMENTS.

MINI SPLIT DX SYSTEMS **OUTDOOR AIR COOLED CONDENSING UNITS** INDOOR CEILING HIGH WALL MODEL# NOMINAL COOLING HEATING | ELECTRICAL | MCA | MOCP | WXHXD | WEIGHT | EFFICIENCY MODEL# AIRFLOW ELECTRICAL MCA WxHxD WEIGHT NOTES (Tons) | Capacity (BTUH) | Outside (F°) | Capacity (BTUH) | (V/Ph/Hz) | (A) | (A) | (in) | (lbs) | EER | SEER (Tons) (CFM) (V/Ph/Hz) (A) 5800-19000 13,800 208/1/60 | 15 20 | 33X14X27 | 108 | 13.5 | 32 40MPHAQ12XA3 168/252/306/357 208/1/60 35.2x11.7x9.8 38 1,2,3,4,5,6

NOTES:

- 1. EQUIPMENT SELECTION BASED ON CARRIER.
- 2. PROVIDE THE FOLLOWING OPTIONS FOR EACH UNIT:
- WIRED 7-DAY PROGRAMMABLE THERMOSTAT CONDENSATE PUMP
- 24V INTERFACE KIT
- 3. FIELD SUPPLIED LOCAL DISCONNECT SWITCH AT EACH INDOOR UNIT SHALL BE FURNISHED BY THE MECHANICAL CONTRACTOR & INSTALLED BY THE ELECTRICAL CONTRACTOR.

RECORD DRAWING CERTIFICATION

- 4. FIELD SUPPLIED WEATHER PROOF LOCAL DISCONNECT SWITCH AT EACH OUTDOOR UNIT SHALL BE FURNISHED BY THE MECHANICAL CONTRACTOR & INSTALLED BY THE ELECTRICAL CONTRACTOR.
- 5. SINGLE POINT EXTERNAL POWER CONNECTION FOR EACH INDOOR / OUTDOOR SET OF UNITS SHALL BE AT THE OUTDOOR UNIT. THE ELECTRICAL CONTRACTOR SHALL PROVIDE WIRING FROM THE OUTDOOR UNIT TO THE INDOOR UNIT.

6. THE AUTOMATIC TEMPERATURE CONTROLS CONTRACTOR SHALL PROVIDE CONTROL WIRING BETWEEN THE OUTDOOR UNIT AND THE INDOOR UNIT.



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OLA Consulting Engineers 50 Broadway, Hawthorne, New York 10532 914.747.2800 8 West 38th Street, New York, NY 10018 646.849.4110 olace.com OLA P/N: NDCA0012

					AS BUILT - CHANGES	
					AS BUILT — NO CHANC	SES
					CONTRACTOR	PROJECT COORDINATOR
					NAME	NAME
					SIGNATURE	SIGNATURE
			1.5575		TITLE DATE	TITLE DATE
REVISION NUMBER	DATE	BY BY	APP'D BY	REVISION	5/WE	

WESTCHESTER COUNTY, NEW YORK DEPARTMENT OF PUBLIC WORKS AND TRANSPORTATION

DIVISION OF ENGINEERING

NEW EQUIPMENT STORAGE BUILDING RICHARD A. FLYNN, SR. FIRE TRAINING CENTER VALHALLA CAMPUS, VALHALLA, NEW YORK MECHANICAL SCHEDULES

SHEET NUMBER NUMBER $M - 60^{\circ}$ 17-521 SHEET NO. 39 OF 53 SCALE: AS SHOWN DATE: 11/16/2021 DPW FILE NO. 38-47-M-721-0∣0



HANGER DETAIL FOR EXPOSED

HANGER ROD SCHEDULE

DUCT SIZE

UP TO 2 SQ. FT.

2 SQ FT TO 4 SQ FT

ROUND DUCTWORK

-ROOF STRUCTURE. REFER

THREADED ROD HANGER

CLIP BY RAM-SET OR

─BAR JOIST AND/

∖OR "I" BEAM

CLIP OR FASTENER ANGLE

EQUAL. POWER ACTUATED

FASTENER CONNECTED TO

STEEL BEAM OR Z-PERLINS.

TO ARCHITECTURAL PLANS. -



PENETRATIONS

FOIL VAPOR

-HANG DUCT FROM STRUCTURAL

TO THE SUPPORT MEMBER.

EXPOSED RIGID ROUND DUCT

HEX NUT WITH LOCK WASHER.

CIRCULAR HANGER. REFER TO SMACNA HVAC CONSTRUCTION

HANGER DIA MAXIMUM SPACING

STANDARDS METAL AND FLEXIBLE,

8'-0"

8'-0"

HANGER ROD.

FIGURE 4.4.

16 GAUGE - 🔞

11 GAUGE - ½"

SUPPORT MEMBER PROVIDED BY THE GENERAL CONTRACTOR.

REFER TO STRUCTURAL DRAWINGS FOR THREADED ROD CONNECTIONS

BARRIER AND

SEAL AIRTIGHT.

THROUGH SCRIM

PROPELLER FAN-

PLENUM.

PLENUM

EXTERIOR WALL

CAULK AROUND-


PERIMETER OF

SLEEVE

LOUVER-

TRANSITION FAN OUTLET TO-

24" DEEP ALUMINIUM —

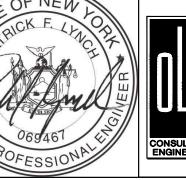

50 Broadway, Hawthorne New York 10532 914.747.2800 8 West 38th Street, New York, NY 10018 646.849.4110 olace.com OLA P/N: NDCA0012

						RECORD DRAWING	CERTIFICATION	ON
ngineers thorne,					1 ——	AS BUILT - CHANGES		
						AS BUILT — NO CHANC	,ES	
, New						CONTRACTOR	PROJECT	COORDINATOR
					NAME .		NAME	
					SIGNATU	RE	SIGNATURE _	
012	REVISION NUMBER	DATE	APP'D BY	REVISION	TITLE -	DATE	TITLE	DATE

PROPELLER FAN-

EXTERIOR WALL-

CAULK AROUND-

PERIMETER OF

SLEEVE

LOUVER-

PLENUM.

PLENUM

SPRING OR RUBBER IN

SHEAR TYPE VIBRATION

SPECIFIED. HANG FROM

BUILDING STRUCTURE.

ELIMINATORS AS

T1/2" GALVANZIED

BACKGUARD--MOTORIZED

— ANGLE FRAME

-ADJUSTABLE PERIMETER

ANGLE FRAME 1"x1"x16

FOR FAN

GAUGE

DAMPER

WIRE MESH SCREEN

TRANSITION FAN OUTLET TO-

24" DEEP ALUMINIUM —

WESTCHESTER COUNTY, NEW YORK DEPARTMENT OF PUBLIC WORKS AND TRANSPORTATION DIVISION OF ENGINEERING NEW EQUIPMENT STORAGE BUILDING RICHARD A. FLYNN, SR. FIRE TRAINING CENTER

VALHALLA CAMPUS, VALHALLA, NEW YORK MECHANICAL DETAILS

 $M - 70^{\circ}$ 17-521 SHEET NO. 40 OF 53 SCALE: AS SHOWN DATE: 11/16/2021 DPW FILE NO. 38-47-M-722-0 0

SEPARATED COMBUSTION 6"

MINIMUM OF 3' AWAY & ABOVE

VENT & 6" OUTDOOR AIR

INTAKE. VENT SHALL A

ANY BUILDING OPENINGS.

✓ MANUFACTURERS

REQUIREMENTS.

1.) HANG UNIT WITH THREADED RODS CONTAINING NEOPRENE TYPE VIBRATION

2.) SUSPEND UNIT HEATERS SECURELY WITH PROVISIONS FOR EASY REMOVAL

4.) PROVIDE A ROOM THERMOSTAT ARRANGED TO TURN ON UNIT AND CYCLE

5.) ALL HANGER PENETRATIONS THROUGH VAPOR BARRIER SHALL BE TAPED

ISOLATORS FROM BUILDING STRUCTURAL MEMBERS.

3.) INSTALL UNITS SO THAT THEY HANG LEVEL AND PLUM.

THE FAN ON A CALL FOR HEAT,

AND REPAIR. COORDINATE EXACT LOCATIONS IN FIELD.

— OUT THROUGH EXTERIOR WALL.

WITH CONCENTRIC VENT PER

GAS PIPING & CONNECTIONS

BY PLUMBING CONTRACTOR.

-DOWNTURN SUPPLY

NOZZLE WITH DOUBLE

SHEET NUMBER


CONTRACT NUMBER

SEAL WATERTIGHT. TERMINATE

BOTTOM OF THE DUCT.

- 2.) WHERE BUILDING STRUCTURAL COMPONENTS HAVE FIREPROOF MATERIAL, ANY AREA THAT IS DISTURBED OR DAMAGED AS A RESULT OF HANGER INSTALLATION SHALL BE PATCHED WITH UL AND FM APPROVED FIREPROOFING TO MATCH EXISTING.
- 3.) ALL HANGER PENETRATIONS THROUGH VAPOR BARRIER SHALL BE TAPED AND
- 1.) FOR DUCTS OVER 49" WIDE, THE STRAP HANGER SHALL BE TURNED UNDER THE

DUCT SIZE HANGER SIZE | MAXIMUM SPACING | UP TO 2 SQ.FT. 1" X 1/16" 8'-0" 1" X 1/8" 8'-0" 2 SQ.FT. TO 4 SQ.FT. 1" X 1/8" 4 SQ.FT. TO 10 SQ.FT. 6'-0" OVER 10 SQ.FT. 1" X 1/8" 4'-0"

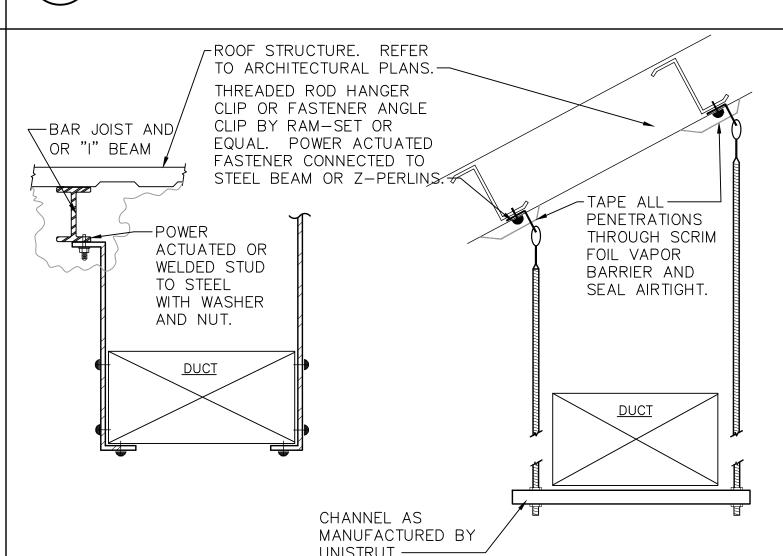

NOTE: DETAILS ARE DIAGRAMMATIC. COORDINATE WITH ARCHITECTURAL DETAILS.

BELT DRIVE EXHAUST FAN DETAIL

HANGER STRAP SCHEDULE	CHANNEL AS MANUFACTURED BY UNISTRUT.
	HANGER STRAP SCHEDULE

DUCT HANGER DETAIL

BELT DRIVE SUPPLY FAN DETAIL COMBUSTION AIR AND VENT. HANG UNITS FROM STRUCTURE ABOVE. COORDINATE REFER TO PLAN FOR SIZE AND WITH STRUCTURAL AND ARCHITECTURAL DRAWINGS. ROUTING. REFER TO EQUIPMENT PROVIDE ANY SUPPLEMENTAL STRUCTURAL STEEL NOTES FOR MATERIAL. — REQUIRED TO HANG UNIT.-SPRING-TYPE VIBRATION ISOLATION HANGERS AS PER SPECIFICATION, TYPICAL. -EXTERIOR WALL. COORDINATE THICKNESS AND TYPE WITH CONTROL (1) BLOWER ARCHITECTURAL DRAWINGS.— SECTION SECTION GAS HEAT WEATHERPROOF ARCHITECTURAL LOUVER WITH INSECT SCREEN. REFER TO

-SPRING OR RUBBER IN

ELIMINATORS AS

T1/2" GALVANZIED

BACKGUARD-

- ANGLE FRAME

-ADJUSTABLE PERIMETER

ANGLE FRAME 1"x1"x16

FOR FAN

GAUGE

-MOTORIZED DAMPER

NOTE: DETAILS ARE DIAGRAMMATIC. COORDINATE WITH ARCHITECTURAL DETAILS.

WIRE MESH SCREEN

SHEAR TYPE VIBRATION

SPECIFIED. HANG FROM

BUILDING STRUCTURE.

VERTICAL GAS FIRED

AND SEALED.

HANG UNIT WITH -

ISOLATORS AS PER

SPECIFICATIONS.

UNIT HEATER -

REMOTE WALL MOUNTED ROOM THERMOSTAT -

THREADED RODS WITH NEOPRENE VIBRATION


DEFLECTION GRILLES. SECTION SUPPLY AIR FLOOR PLANS FOR SIZE. -└-PROVIDE FLEXIBLE INLET CONNECTION. OUTSIDE AIR GAS CONNECTION. GAS PIPING & CONNECTIONS BY PLUMBING CONTRACTOR. — ALUMINUM OUTSIDE AIR PLENUM. REFER TO FLOOR PLAN FOR SIZE. — -MOTORIZED DAMPER. INSULATE OUTSIDE AIR BOTTOM TYPICAL. DUCTWORK AND PLENUM. RETURN AIR REFER TO SPECIFICATIONS. -REFER TO FLOOR PLAN FOR DUCT ROUTING AND TRANSITIONS. -


2.) HANG UNIT WITH THREADED RODS CONTAINING NEOPRENE OR SPRING TYPE VIBRATION ISOLATORS FROM BUILDING STRUCTURAL MEMBERS. 3.) INSTALL UNITS SO THAT THEY HANG LEVEL AND PLUM.

1.) MAINTAIN ALL MANUFACTURER CLEARANCE REQUIREMENTS - COORDINATE WITH ALL OTHER TRADES.

INDOOR GAS FIRED HEATING AND VENTILATING UNIT SCHEMATIC

4.) ALL HANGER PENETRATIONS THROUGH VAPOR BARRIER SHALL BE TAPED AND SEALED.

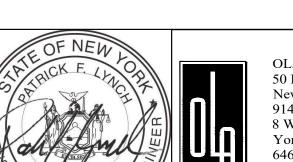

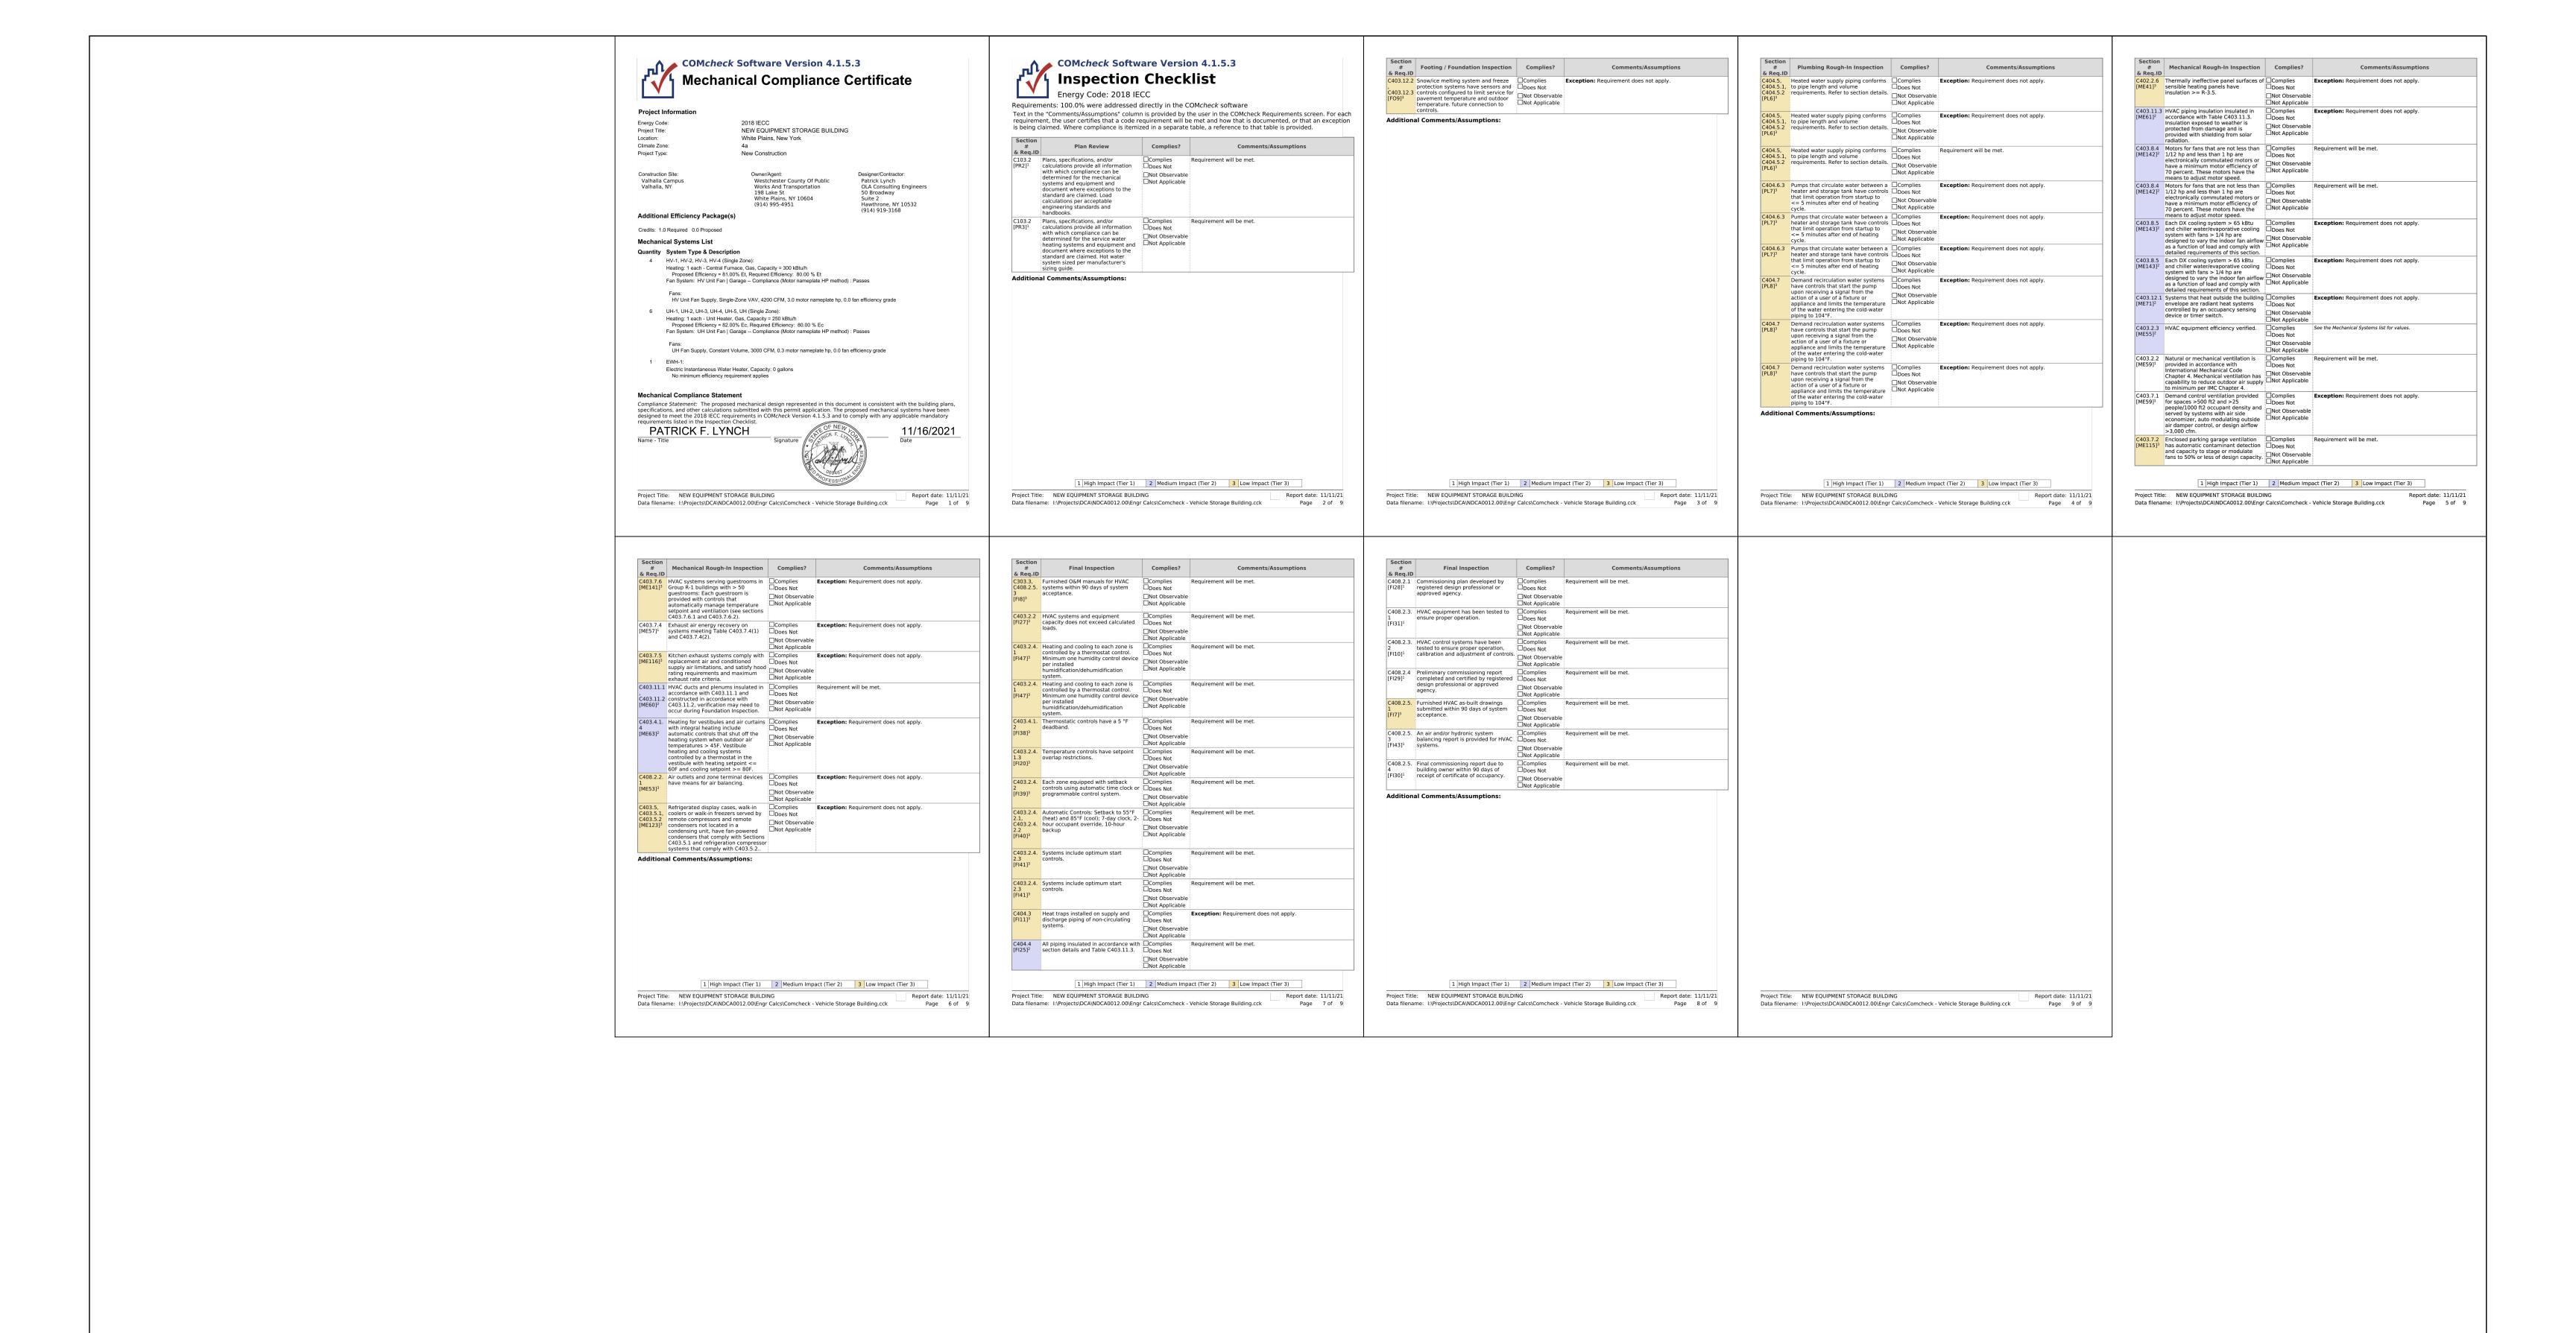

DCAK - MSA

ARCHITECTURE AND ENGINEERING

53 HUDSON AVENUE

NYACK, NEW YORK 10960


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WESTCHESTER COUNTY, NEW YORK
DEPARTMENT OF PUBLIC WORKS AND TRANSPORTATION
DIVISION OF ENGINEERING


NEW EQUIPMENT STORAGE BUILDING
RICHARD A. FLYNN, SR. FIRE TRAINING CENTER
VALHALLA CAMPUS, VALHALLA, NEW YORK
ENERGY COMPLIANCE

CONTRACT NUMBER 17-521 EN-00SHEET NO. 41 OF 53

SCALE: AS SHOWN DATE: 11/16/2021

DPW FILE NO. REV

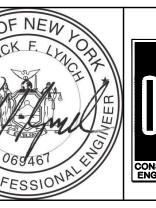38-47-EN-712-0 (

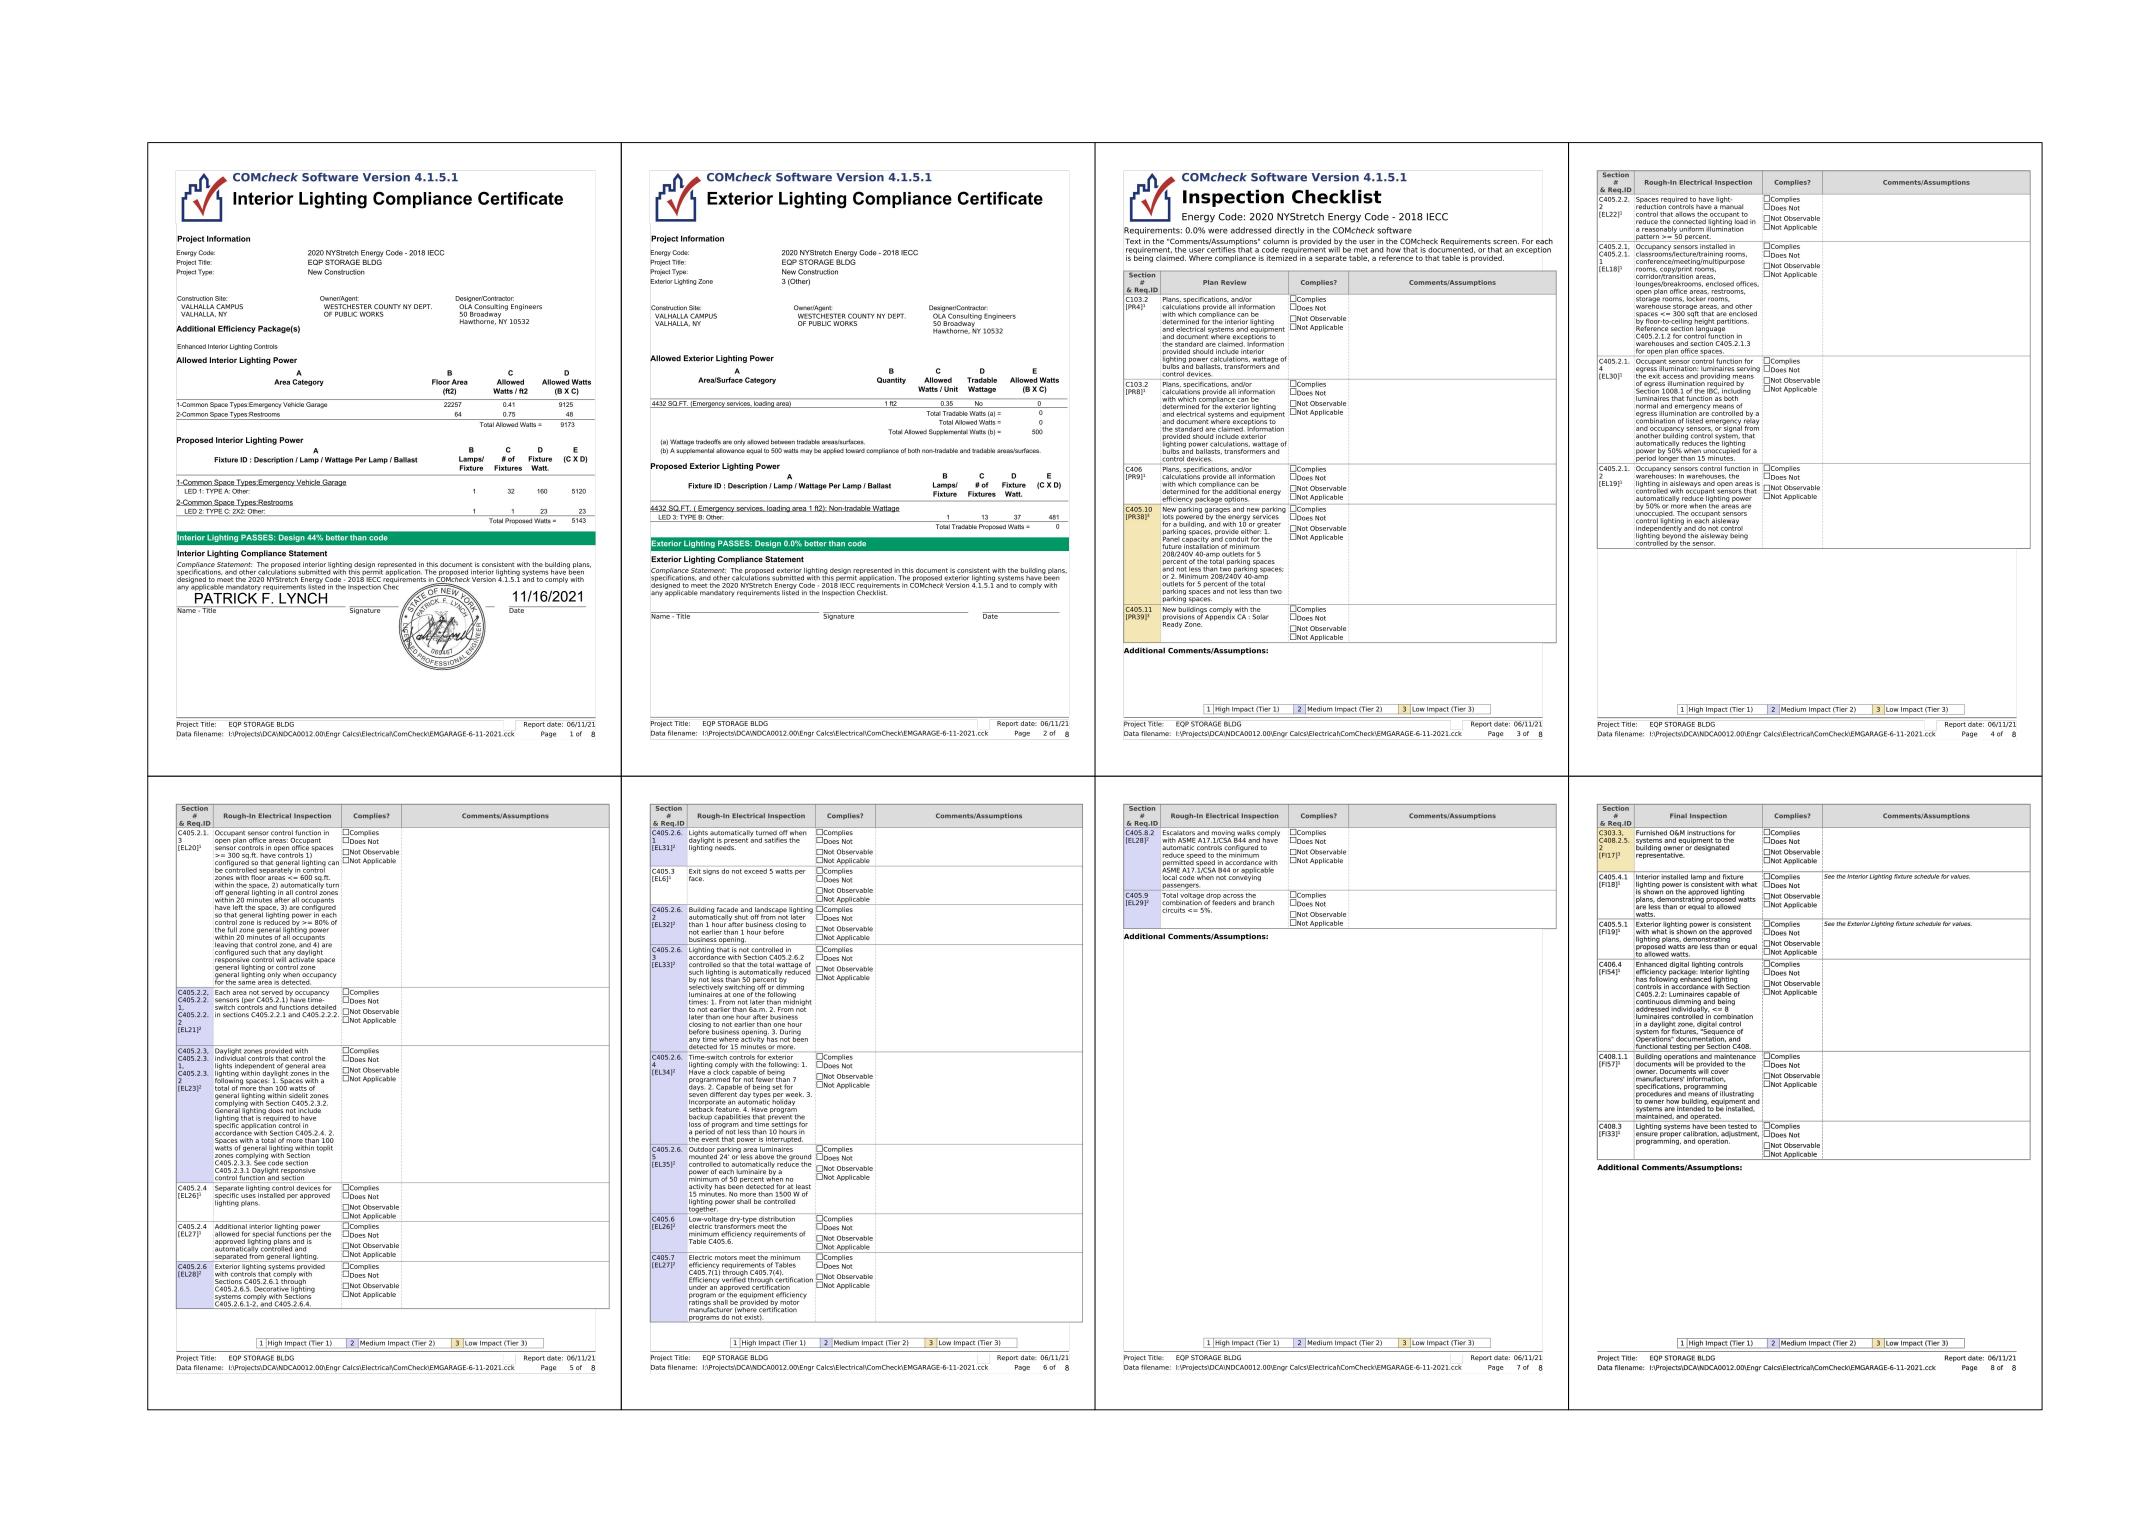



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WESTCHESTER COUNTY, NEW YORK DEPARTMENT OF PUBLIC WORKS AND TRANSPORTATION DIVISION OF ENGINEERING


EN-002 SHEET NO.42 OF 53 SCALE: AS SHOWN NEW EQUIPMENT STORAGE BUILDING DATE: 11/16/2021 RICHARD A. FLYNN, SR. FIRE TRAINING CENTER DPW FILE NO. VALHALLA CAMPUS, VALHALLA, NEW YORK 38-47-EN-724-0 0 ELECTRICAL ENERGY COMPLIANCE

SHEET NUMBER

NUMBER

17-521

YMBOLS	AND ABBREVIATIONS					DEFINITION OF TERMS
SYMBOL	ABBREVIATION DESCRIPTION	SYMBOL	ABBREVIATION	DESCRIPTION	SYMBOL ABBREVIATION DESCRIPTION	7. "INSTALL OR INSTALLATION" MEANS THE ACT OF PHYSICALLY PLACING, APPLYING, SE
	- CONDUIT AND WIRING	Ę	_	FIRE ALARM STROBE 15/75 CD	KW KILO-WATT	7. "INSTALL OR INSTALLATION" MEANS THE ACT OF PHYSICALLY PLACING, APPLYING, SE ERECTING, ANCHORING, SECURING, ETC., CONSTRUCTION MATERIALS, EQUIPMENT, FURN APPLIANCES, AND SIMILAR ITEMS SPECIFIED AND FURNISHED AT THE JOB SITE. INST. OF SPECIFIED ITEMS MUST BE COMPLETE IN ALL RESPECTS.
	- CONDUIT & WIRING TO BE REMOVED UON	F 110	_	FIRE ALARM STROBE 110 CD	MAX MAXIMUM	8. "PROVIDE" MEANS TO FURNISH AND INSTALL CONSTRUCTION MATERIAL, EQUIPMENT, E
—UG	- BURIED CONDUIT	SSH; SC	_	SMOKE DETECTOR. SH — SMOKE HATCH; SC — PLENUM RATED ABOVE CEILING	MCB MAIN CIRCUIT BREAKER	DEFINED ABOVE. 9. THE FOLLOWING ARE DEFINITIONS OF SHOP DRAWING STAMP ACTIONS:
— OH——	- OVERHEAD CONDUCTORS	ŕ		SC — PLENUM RATED ABOVE CEILING	MIN MINIMUM	A. "NO EXCEPTIONS TAKEN" MEANS THAT THE SHOP DRAWING IS CORRECT AS TO
	- HOMERUN TO PANEL, ARROWS INDICATE # 1P	H	_	HEAT DETECTOR	MLO MAIN LUG ONLY	PERFORMANCE, CAPACITY, ETC. AND SUBSTANTIAL CONFORMANCE TO THE CONTED DRAWINGS AND SPECIFICATIONS. FABRICATION AND/OR PURCHASE MAY COMMENCE.
	- MULTI-POLE HOMERUN	(co)	_	CARBON MONOXIDE DETECTOR	MTS MANUAL TRANSFER SWITCH	B. "MAKE CORRECTIONS NOTED" MEANS THAT THE SHOP DRAWING IS CORRECT AS PERFORMANCE, CAPACITY, ETC. AND SUBSTANTIAL CONFORMANCE TO THE CONTI
	- ELECTRICAL EQUIPMENT AS INDICATED	TS	_	FIRE ALARM TAMPER SWITCH	NIC NOT IN CONTRACT	DRAWINGS AND/OR SPECIFICATIONS, SUBJECT TO AND IN COMPLIANCE WITH THE ANNOTATIONS AND/OR CORRECTIONS INDICATED ON THE SHOP DRAWING. FABRIC
	- ELECTRICAL EQUIPMENT TO BE REMOVED UON	WF	_	FIRE ALARM WATER FLOW SWITCH	NTS NOT TO SCALE	AND/OR PURCHASE MAY COMMENCE.
\bigcirc	- ELECTRIC METER	(WS)	_	FIRE ALARM WARDEN STATION	P POLE	C. "AMEND AND RESUBMIT" MEANS THAT THE COMMENTS AND/OR CORRECTION AR EXTENSIVE AND IMPORTANT THAT THE REVIEWER WANTS TO SEE HOW THE COMI
J	- JUNCTION BOX	ANN	_	FIRE ALARM ANNUNCIATOR PANEL	PV PHOTOVOLTAIC	AND/OR CORRECTIONS ARE RESOLVED PRIOR TO RELEASE FOR FABRICATION AN PURCHASE. FABRICATIONS AND/OR PURCHASE MAY <u>NOT</u> COMMENCE.
	- FUSED DISCONNECT SWITCH	СМ	СМ	FIRE ALARM CONTROL MODULE	PNL PANEL	D. "REJECTED" MEANS THAT THE SHOP DRAWING DOES NOT COMPLY OR CONFORM CONTRACT DRAWINGS AND/OR SPECIFICATIONS. FABRICATION AND/OR PURCHAS
	- UNFUSED DISCONNECT SWITCH	MM	MM	FIRE ALARM MONITORING MODULE	PVC POLY VINYL CHLORIDE	COMMENCE.
	- COMBINATION MOTOR STARTER/FUSED DISC.	FACP	FACP	FIRE ALARM CONTROL PANEL	REL. REMOVE AND RELOCATE	
	- MOTOR STARTER	BPS	BPS	BOOSTER POWER SUPPLY	RGS RIGID GALVANIZED STEEL	GENERAL NOTES
<u> </u>	- MOTOR, NUMBER INDICATES HORSE POWER	R	_	FIRE ALARM RELAY	SCH SCHEDULE	A ALL WORK CHOWN IS NEW LINESCO STUEDWISE NOTED (HON) EVICTING TO DEMA
4-6	- BATTERY PACK EMERGENCY LIGHT FIXTURE	w-	EOL	END OF LINE RESISTOR	SPD SURGE PROTECTION DEVICE	1. ALL WORK SHOWN IS NEW UNLESS OTHERWISE NOTED (UON) EXISTING TO REMA 2. THE DRAWINGS ARE TO BE CONSIDERED SCHEMATIC ONLY AND DO NOT NECESS
<u> </u>	- MOTOR RATED TOGGLE SWITCH	CR	_	CARD READER	SW SWITCH(ES)	SHOW THE EXACT LOCATIONS AND DETAILS OF THE WORK TO BE INSTALLED.
→	- DUPLEX RECEPTACLE	<u> </u>	A	AMPERE(S)	TELCO TELEPHONE COMPANY	3. THE ELECTRICAL CONTRACTOR SHALL BE RESPONSIBLE FOR OBTAINING ALL NE PERMITS AND PAYING ALL FEES ASSOCIATED WITH THIS WORK INCLUDING FILIN
	- DOUBLE DUPLEX RECEPTACLE		AC	AIR CONDITIONER	TYP TYPICAL	UTILITY COMPANY (AS REQUIRED), AND WITH LOCAL AUTHORITY HAVING JURISD
\\	- SPECIAL RECEPTACLE		ACC	AIR CONDITIONER CONDENSER	UG UNDERGROUND	4. ELECTRICAL CONTRACTOR SHALL BE RESPONSIBLE TO HIRE A THIRD PARTY EL INSPECTION AGENCY TO PROVIDE UL INSPECTIONS AND SUBMIT A CERTIFICATE
∇	- TELEPHONE OUTLET		AFF	ABOVE FINISHED FLOOR	UON UNLESS OTHERWISE NOTED	INSPECTION PRIOR TO FINAL REQUEST FOR PAYMENT. 5. ALL WORK INVOLVING THE ELECTRIC SERVICE SHALL BE COORDINATED AND AP
×	- DATA OUTLET (x - INDICATES # OF JACKS, 2 JACKS		AF	AMPERAGE OF FUSE	UV UNIT VENTILATOR	THE UTILITY COMPANY.
•	PER LOCATION, UON)		AGL	ABOVE GRADE LEVEL	WP WEATHERPROOF	6. ALL CONDUCTORS SHALL BE COPPER UON "ON DRAWINGS".
T 7	- COMPINIATION TELEPHONE (DATA OUTLET		AHU	AIR HANDLING UNIT	VIF VERIFY IN FIELD	7. ELECTRONIC FILES OF THE MECHANICAL, ELECTRICAL, PLUMBING AND FIRE PRODRAWINGS ARE AVAILABLE TO THE CONTRACTOR. THE ENGINEER MAY GRANT
V 	- COMBINATION TELEPHONE/DATA OUTLET EOL END OF LINE RESISTOR					CONTRACTOR A LIMITED LICENSE TO MAKE A DERIVATIVE WORK OF THE DATAB THE PURPOSE OF SHOP DRAWINGS, SUBMITTALS AND AS—BUILT DRAWINGS. U
			AL	ALUMINIUM	V VOLT(S)	REQUEST, THE ENGINEER SHALL PROVIDE A RELEASE FORM THAT MUST BE SIGNETURED BY THE CONTRACTOR PRIOR TO RELEASE OF THE ELECTRONIC FILES
© 	- CLOCK		ARC	ARC FAULT INTERRUPTER	WG WIRE GUARD	8. CIRCUIT NUMBERS ARE FOR INFORMATION PURPOSES ONLY. ACTUAL CIRCUIT N SHALL BE DETERMINED IN THE FIELD.
	- PUSHBUTTON		AS	AMPERAGE OF SWITCH	WH WATER HEATER	
EP0	EPO EMERGENCY POWER OFF SWITCH		ATS	AUTOMATIC TRANSFER SWITCH	NOTES:	9. CORE DRILLING OR TRENCHING THROUGH AN EXISTING FLOOR SLAB, WHEN REQ SHALL BE COORDINATED WITH THE OWNER. FLOOR SLABS SHALL BE RADAR S PRIOR TO CORE DRILLING OR TRENCHING. ALL WORK, INCLUDING CORE DRILLING
	CB CIRCUIT BREAKER		AWG	AMERICAN WIRE GAUGE	1. ALL SYMBOLS AND ABBREVIATIONS MAY NOT BE APPLICABLE FOR THIS PROJECT.	SCAN, INSTALLATION OF FIRE STOPPING, & CONDUIT/CABLE INSTALLATION SHA PERFORMED DURING NON-BUSINESS HOURS AND INCLUDED IN BASE BID. USE
<u>.</u>	- ENCLOSED CIRCUIT BREAKER			BARE COPPER WIRE	2. SEE LIGHTING FIXTURE SCHEDULE FOR LIGHT FIXTURE SYMBOLS.	CAUTION DURING ANY CUTTING OPERATION TO AVOID DAMAGE TO EXISTING EQUIPMENT/SYSTEMS. ANY ITEMS DAMAGED AS A RESULT OF CORE DRILLING
/ 200AS 150AF	- FUSED SWITCH		BLDG	BUILDING	TYPICAL BRANCH CIRCUIT WIRING LEGEND	REPAIRED AT NO COST TO THE CLIENT. ALL CORES SHALL BE FIRE SEALED.
<u>G</u>	GEN GENERATOR		BMS	BUILDING MANAGEMENT SYSTEM	——— 2-#12 & 1-#12 GND IN 3/4"C (1-1P-20A OR 1-1P-15A CB)	— 10. FOR EACH WALL MOUNTED COMMUNICATIONS OUTLET, PROVIDE A 1900 JUNCTION WITH AN EXTENDER COLLAR AND 1 INCH CONDUIT WITH DRAGLINE FROM OUTLE INCHES BELOW CEILING.
4	- GENERATOR RECEPTACLE		С	CONDUIT	——→ 3-#12 & 1-#12 GND IN 3/4"C (3P-20A OR 3P-15A CB)	11. COMMUNICATION WIRING BY OTHERS. COORDINATE COMMUNICATION JACKS WITH
OR = ///	GND GROUND AS PER LOCAL CODE		CD	CANDELA	——→ 2-#12 & 1-#12 GND IN 3/4"C (2P-20A OR 2P-15A CB)	REPRESENTATIVE, TYPICAL.
TT	- GROUND BAR		CKT	CIRCUIT	LIGHT FIXTURE TYPE	12. WHERE GFI RECEPTACLES ARE CIRCUITED WITH GENERAL CONVENIENCE RECEPT GFI RECEPTACLE SHALL BE THE LAST DEVICE ON THE CIRCUIT.
OR ①	- GROUND ROD		CLG	CEILING	CIRCUIT # SWITCH CONTROL LIGHT FIXTURE	13. INSTALL CONDUIT EXPANSION FITTINGS AT ALL LOCATIONS WHERE CONDUITS C BUILDING OR STRUCTURE EXPANSION JOINTS.
r _o f	- TRANSFER SWITCH		COL	COLUMN	NOTES:	
n OR T	XFMR TRANSFORMER		CU	COPPER	1. EACH 120V AND 277V CIRCUIT SHALL HAVE A DEDICATED NEUTRAL CONDUCTOR. SHARED	14. UNLESS OTHERWISE NOTED, DISCONNECT SWITCHES, STARTERS, HOAS AND MOTOGGLE SWITCHES FOR MECHANICAL PUMPS, CABINET AND UNIT HEATERS, RETROOF FANS, VAV BOXES, COMPRESSORS, FAN COIL UNITS, AIR HANDLERS AND CONDENSERS SHALL BE FURNISHED BY THE MECHANICAL CONTRACTOR AND IN THE FLECTRICAL CONTRACTOR OF COORDINATE ALL WORK WITH THE MECHANICAL
E	CT CURRENT TRANSFORMER		DEM.	DEMOLISH AND REMOVE	NEUTRAL HOMERUNS ARE NOT PERMITTED.	BY THE ELECTRICAL CONTRACTOR. COORDINATE ALL WORK WITH THE MECHANIC CONTRACTOR.
Ś'	- UTILITY POLE		DISC	DISCONNECT	2. CONDUCTORS SHALL BE INCREASED FOR VOLTAGE DROP AND DERATING AS PER APPLICABLE ELECTRICAL CODE. FOR CIRCUITS THAT ARE BETWEEN 100' AND 150' IN LENGTH, PHASE AND NEUTRAL CONDUCTORS SHALL BE #10 AWG. FOR CIRCUITS THAT	15. DISCONNECT SWITCHES FOR MOTORIZED DAMPERS, CFSD/SD AND VAV BOXES
WM	WM WATER MAIN		DWG	DRAWING	ARE BETWEEN 150' AND 225' IN LENGTH, PHASE AND NEUTRAL CONDUCTORS SHALL BE	BY MECHANICAL CONTRACTOR AND INSTALLED AND WIRED BY ELECTRICAL CON
<u>oc</u>	- CEILING MOUNTED OCCUPANCY SENSOR		EF	EXHAUST FAN	#8 AWG. FOR LENGTHS GREATER THAN 225' IN LENGTH, VERIFY CONDUCTOR SIZES WITH ENGINEER.	16. EACH DUPLEX AND QUAD RECEPTACLE SHALL BE LABELED WITH THE CIRCUIT
В	- BOILER BREAK GLASS STATION		EM	EMERGENCY	3. MC CABLE MY BE USED IF CONCEALED IN WALL OR CEILING.	WHICH IT SERVES. ALPHANUMERICS TO BE 1/8" HIGH AND BLACK ON CLEAR BACKGROUND. LABELS SHALL BE SELF ADHESIVE. IDENTIFY ASSOCIATED PAN
#	NC NORMALLY CLOSED CONTACTS		EMT	ELECTRICAL METALLIC TUBING	DEFINITION OF TERMS	CIRCUIT NUMBER.
	NO NORMALLY OPEN CONTACTS		EXIST	EXISTING	1. WHEREVER IN THE CONTRACT DOCUMENTS THE WORD "CLIENT" IS USED, IT MUST BE	17. THE ELECTRICAL CONTRACTOR SHALL PROVIDE ALL CUTTING, PATCHING, PAINTIFINAL RESTORATION REQUIRED TO FACILITATE THE DEMOLITION AND INSTALLAT ELECTRICAL EQUIPMENT, INCLUDING BUT NOT LIMITED TO PANELBOARDS, CONDINGING, DEVICES, FIXTURES, ETC. INCLUDING ABOVE CEILINGS. CONTRACTOR TO
Л ——	MD MOTORIZED DAMPER		EX.	EXISTING TO REMAIN	UNDERSTOOD THAT "WESTCHESTER COUNTY FIRE TRAINING CENTER" IS INTENDED.	AND REPLACE CEILINGS, AND OPEN AND PAICH WALLS, AS REQUIRED TO EXEC
	SD OR CFSD SMOKE DAMPER		F	FLOOR	2. WHEREVER IN THE CONTRACT DOCUMENTS THE WORD "ARCHITECT" IS USED, IT MUST BE UNDERSTOOD THAT "DCAK MSA" IS INTENDED.	ELECTRICAL WORK.
UH.	UH UNIT HEATER		GEN	GENERATOR	3. WHEREVER IN THE CONTRACT DOCUMENTS THE WORD "ENGINEER" IS USED, IT MUST BE UNDERSTOOD THAT "OLA CONSULTING ENGINEERS" IS INTENDED.	18. ALL ELECTRICAL RACEWAYS SHALL BE SURFACE MOUNTED, UON. ROOM #002 A BATHROOM #001 SHALL HAVE RECESSED CONDUITS, SWITCHES, AND OUTLET B
F	- FIRE ALARM MANUAL PULL STATION		GFI	GROUND FAULT INTERRUPTER	4. WHEREVER IN THE CONTRACT DOCUMENTS THE WORDS "ELECTRICAL UTILITY" OR "POWER	
KÓ	- FIRE ALARM COMBINATION AUDIO/VISUAL		HP	HORSEPOWER	COMPANY" ARE USED, IT MUST BE UNDERSTOOD THAT "CON EDISON" IS INTENDED.	
- · Y	DEVICE (15/75 CD — STROBE)		HVAC	HEATING VENTILATION AIR CONDITIONING	5. "WORK" MUST BE DEEMED TO CONSIST OF ALL LABOR AND OPERATIONS, TRANSPORTATION, HOISTING, MATERIALS, TOOLS, EQUIPMENT, SERVICES, INSPECTIONS, INVESTIGATIONS,	
MO ¹¹⁰	- FIRE ALARM COMBINATION AUDIO/VISUAL		IG	ISOLATED GROUND	COORDINATION AND SUPERVISION REQUIRED AND / OR REASONABLY NECESSARY TO PRODUCE THE CONSTRUCTION REQUIRED BY THE CONTRACT DOCUMENTS.	
-	DEVICE (110 CD - STROBE)		KVA	KILO-VOLT-AMPERE	6. "FURNISH" MEANS THE DESIGN, FABRICATION, PURCHASE AND DELIVERY TO THE JOB SITE.	
		C OF NE	EW L		RECORD DRAWING CERTIFICATION	WESTCHESTER COUNTY, NEW YORK CONTRACT NUMBER
	DCAK - MSA RCM Technologies US. Consulting Engineers	A, Inc.	440年	OLA Consulting Engineers 50 Broadway, Hawthorne, New York 10532	AS BUILT — CHANGES AS NOTED	DEPARTMENT OF PUBLIC WORKS AND TRANSPORTATION 17-521
	Consulting Engineers 99 Bauer Drive Suite 101	* 2	MIN BEEN THOU	New York 10532 914.747.2800 8 West 38th Street, New	AS BUILT — NO CHANGES CONTRACTOR PROJECT COORDINATOR	DIVISION OF ENGINEERING SHEET NO. 43
	53 HUDSON AVENUE Oakland, NJ 07436 TEL:(201) 249-8700	Sal S	mell !!	York, NY 10018 646.849.4110	NAME	NEW EQUIPMENT STORAGE BUILDING RICHARD A. FLYNN, SR. FIRE TRAINING CENTER SCALE: AS S DATE: 11/1
	NYACK, NEW YORK 10960 www.DCAK-MSA.com Email: info@DCAK-MSA.com		CONSLENGIN	OLA D/NI. NIDCA 0012	SIGNATURE SIGNATURE DATE DATE DATE	VALHALLA CAMPUS, VALHALLA, NEW YORK DPW FILE NO.
	Email: info@DCAK-MSA.com Tel 845-353-1300 Fax 845-353-1614	TOFFESS	ION	REVISION DATE BY	REVISION	ELECTRICAL SYMBOLS, ABBREVIATIONS, & GENERAL NOTES 38-47-E-7

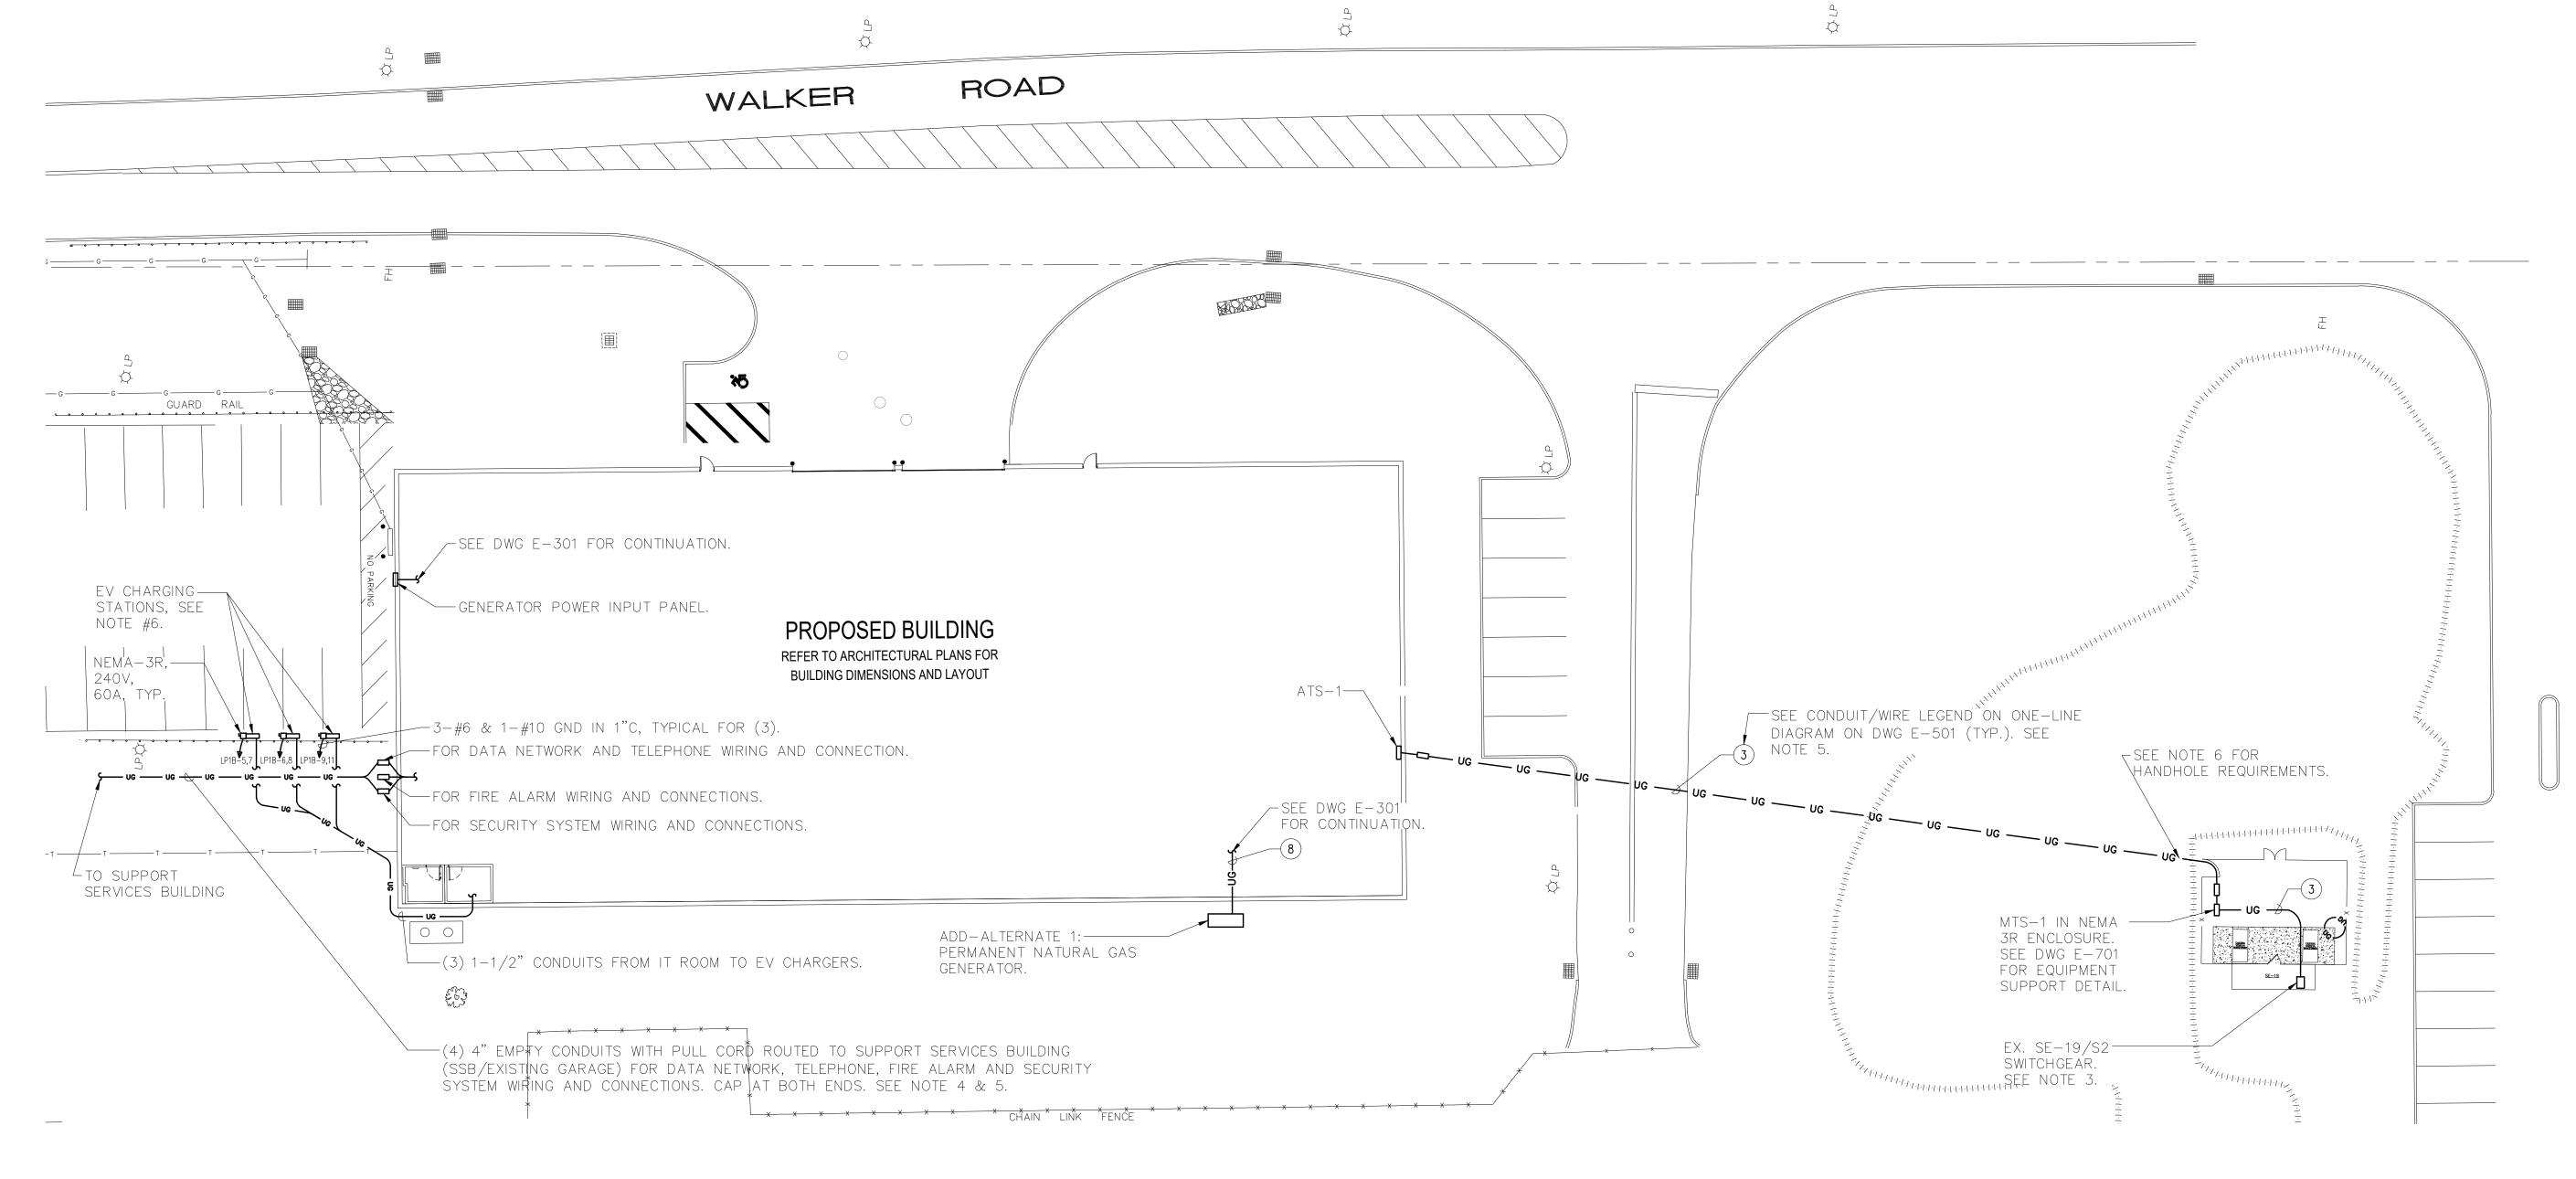

NOTES:

- 1. SEE ONE-LINE DIAGRAM ON DWG E-501.
- 2. FOR ADDITIONAL GENERATOR DETAILS, SEE DWG E-701.
- 3. INTERRUPTION OF EXISTING ELECTRIC SERVICE: DO NOT INTERRUPT ELECTRIC SERVICE TO FACILITIES OCCUPIED BY OWNER OR OTHERS UNLESS PERMITTED UNDER THE FOLLOWING CONDITIONS AND THEN ONLY AFTER ARRANGING TO PROVIDE TEMPORARY ELECTRIC SERVICE. NOTIFY ARCHITECT, ENGINEER, AND OWNER NO FEWER THAN 20 DAYS IN ADVANCE OF PROPOSED INTERRUPTION OF ELECTRIC SERVICE. INDICATE METHOD OF PROVIDING TEMPORARY ELECTRIC SERVICE. DO NOT PROCEED WITH INTERRUPTION OF ELECTRIC SERVICE WITHOUT OWNER'S WRITTEN PERMISSION. COMPLY WITH NFPA 70E.
- 4. ALL DATA AND COMMUNICATION WIRE PULLS AND CONNECTIONS SHALL BE BY OTHERS.
- 5. INSTALL ALL UNDERGROUND CONDUITS IN CONCRETE ENCASED DUCT BANK WHERE CROSSING ROADWAY OR SUBJECT TO VEHICULAR TRAFFIC.
- 6. VEHICLE CHARGING STATIONS SHALL BE PROVIDED BY THE COUNTY. THE CONTRACTOR SHALL BE RESPONSIBLE TO PICK UP THE CHARGERS FROM THE COUNTY AND BRING THEM TO THE SITE. THE CONTRACTOR SHALL BE RESPONSIBLE FOR THE INSTALLATION OF THE CHARGERS AND MAKE OPERATIONAL.




TRENCHING NOTES:

- A. CONTRACTOR SHALL LOCATE ALL EXISTING UNDERGROUND UTILITIES THAT ARE NOT PART OF N.Y. STATE "CODE 753" PRIOR TO DIGGING.
- B. ALL EXCAVATION IN THE AREA OF THE EXISTING UNDERGROUND EQUIPMENT, PIPES AND CONDUITS SHALL BE PERFORMED BY HAND.
- C. ANY AREA/PLANTS OR LANDSCAPING OR PAVEMENTS DISTURBED DURING THE EXCAVATION SHALL BE RESTORED OR REPLACED TO MATCH EXISTING CONDITIONS BY THE CONTRACTOR AT NO COST TO THE OWNER.
- D. ANY EXISTING BURIED CONDUITS, DRAINAGE, SPRINKLER PIPING, ETC. THAT IS DISTURBED AND/OR DAMAGED DURING CONSTRUCTION SHALL BE REPAIRED BY THE CONTRACTOR AT NO COST TO THE OWNER.
- E. THE PLANS SHOW SOME KNOWN SUBSURFACE STRUCTURES, ABOVE GROUND STRUCTURES AND/OR UTILITIES BELIEVED TO EXIST IN THE WORKING AREA, EXACT LOCATION OF WHICH MAY VARY FROM THE LOCATIONS INDICATED. IN PARTICULAR, THE CONTRACTOR IS WARNED THAT THE EXACT OR EVEN APPROXIMATE LOCATION OF SUCH PIPELINES, SUBSURFACE STRUCTURES AND/OR UTILITIES IN THE AREA MAY OR MAY NOT BE SHOWN; AND IT SHALL BE HIS RESPONSIBILITY TO PROCEED WITH GREAT CARE IN EXECUTING ANY WORK. 48 HOURS BEFORE YOU DIG, DRILL OR BLAST, CALL 1-800-962-7962 (NY STATE).



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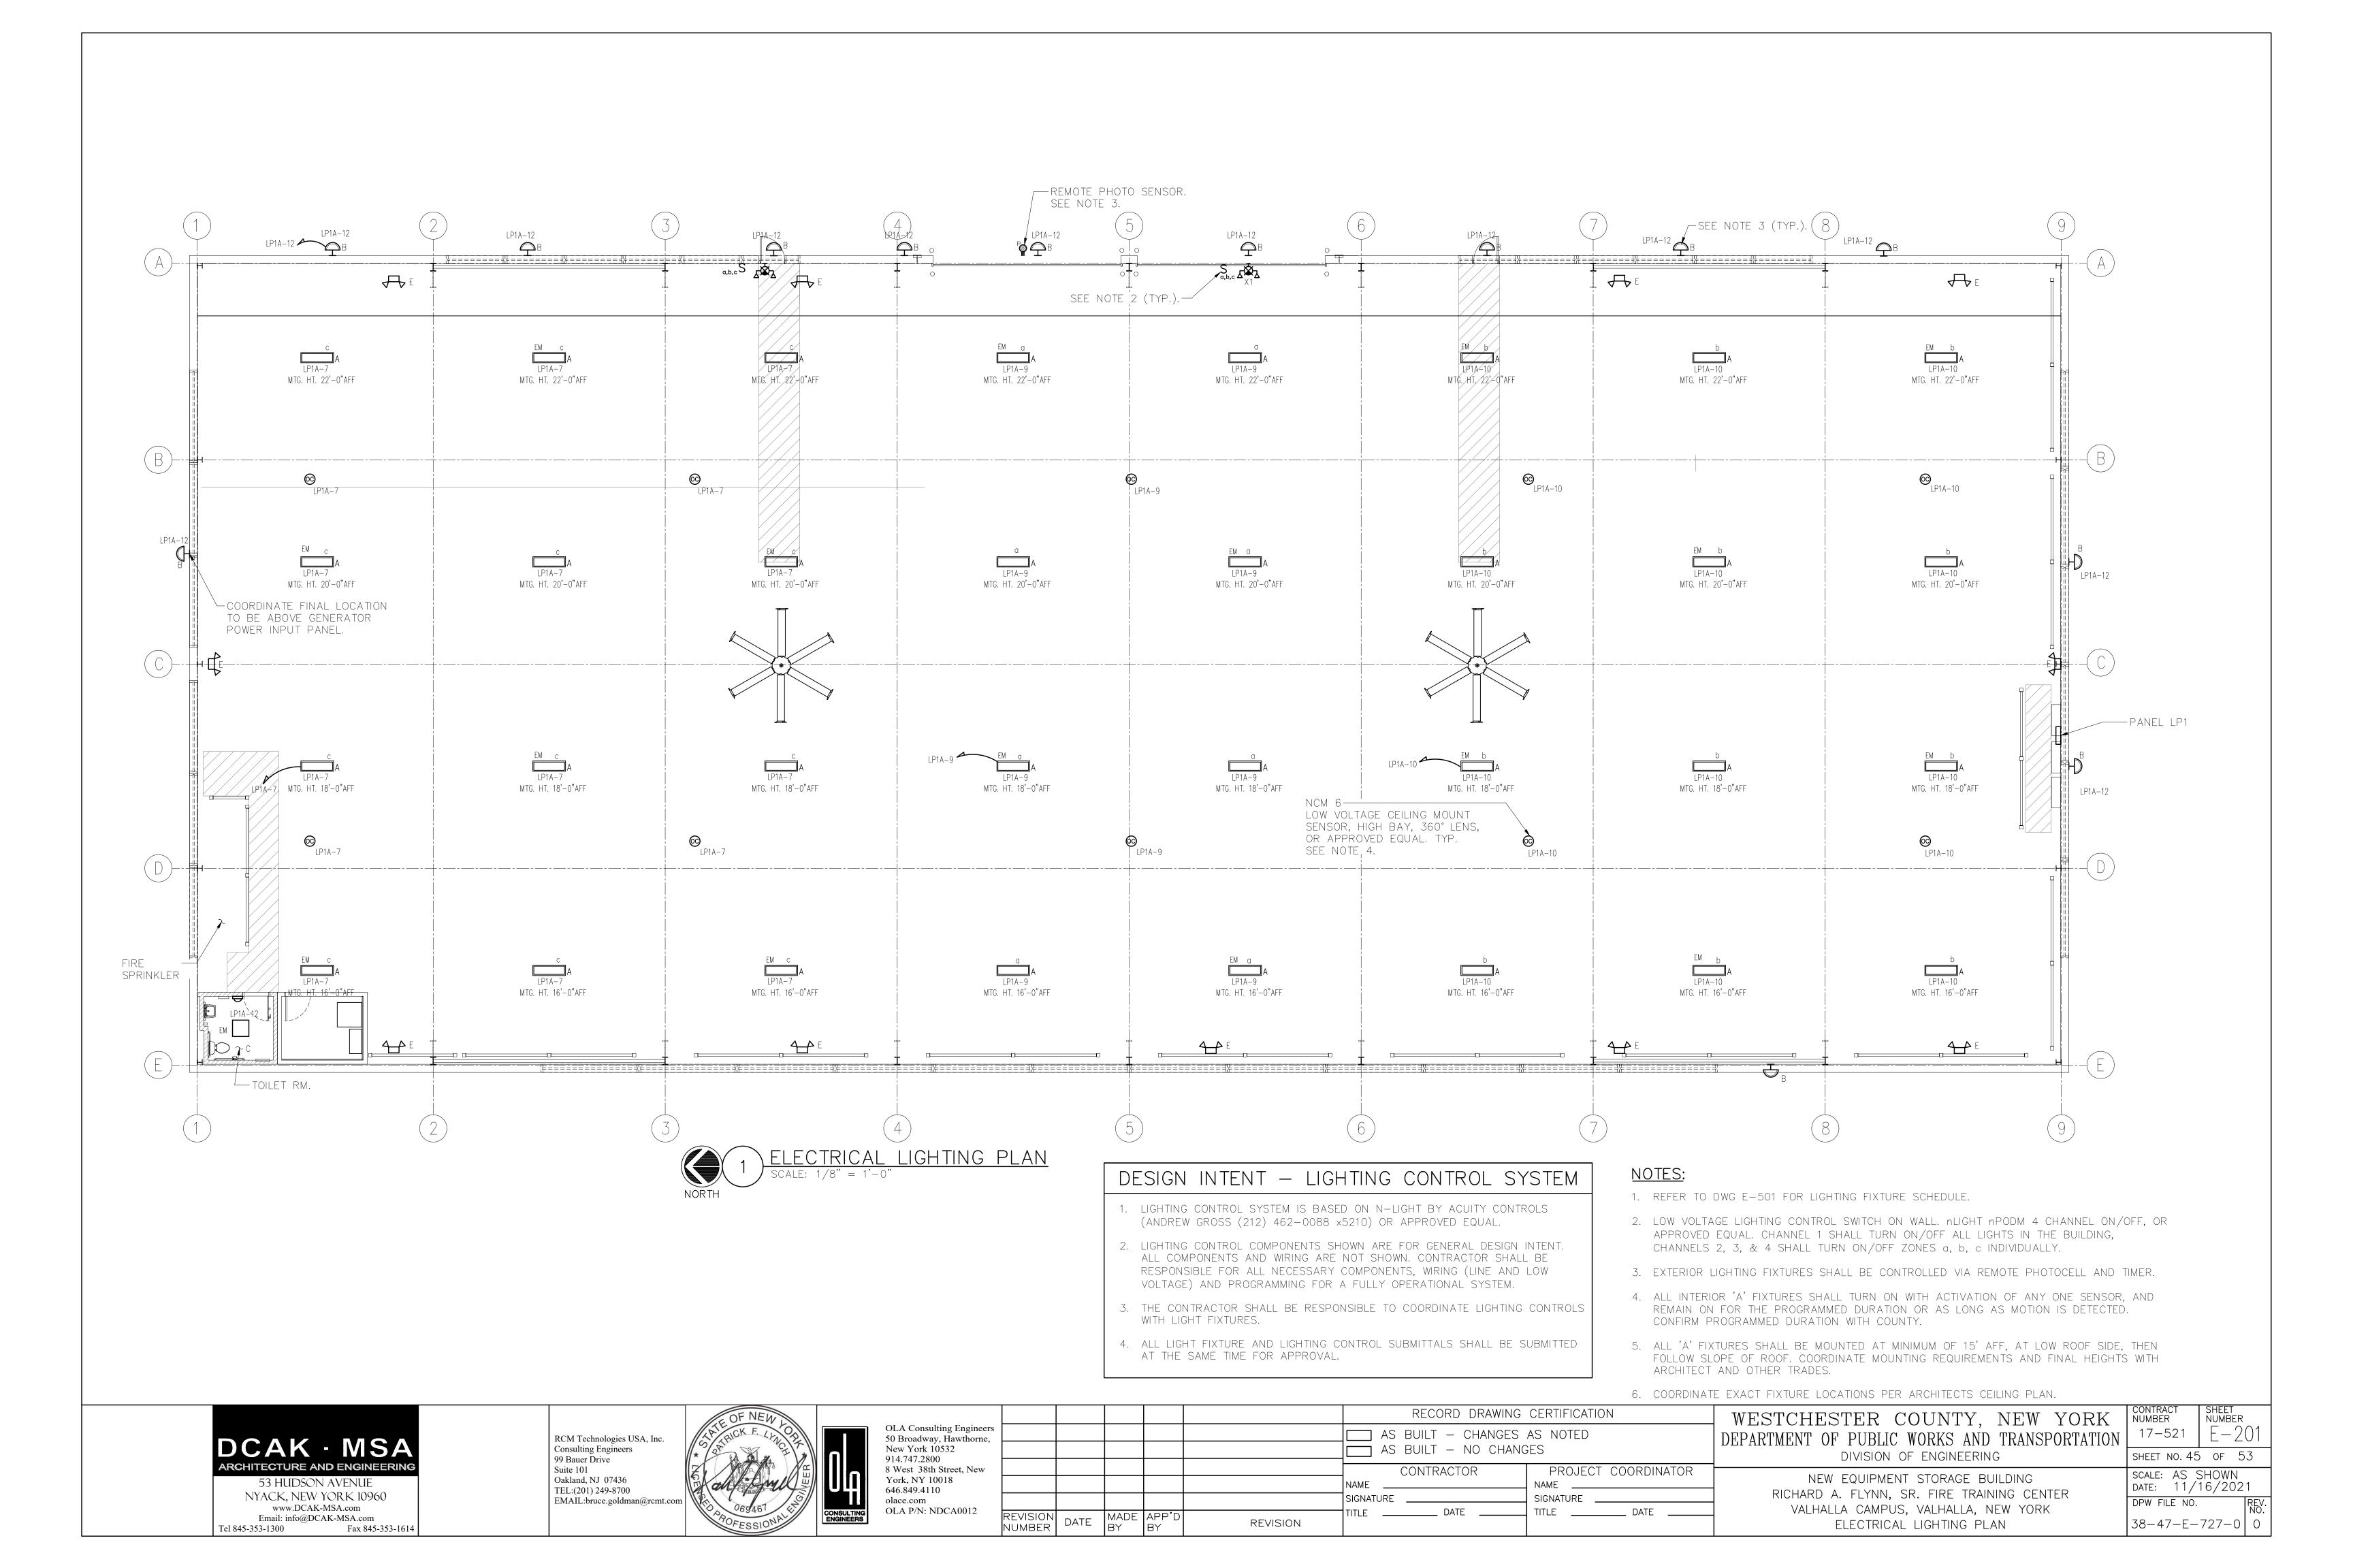


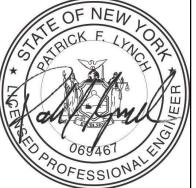
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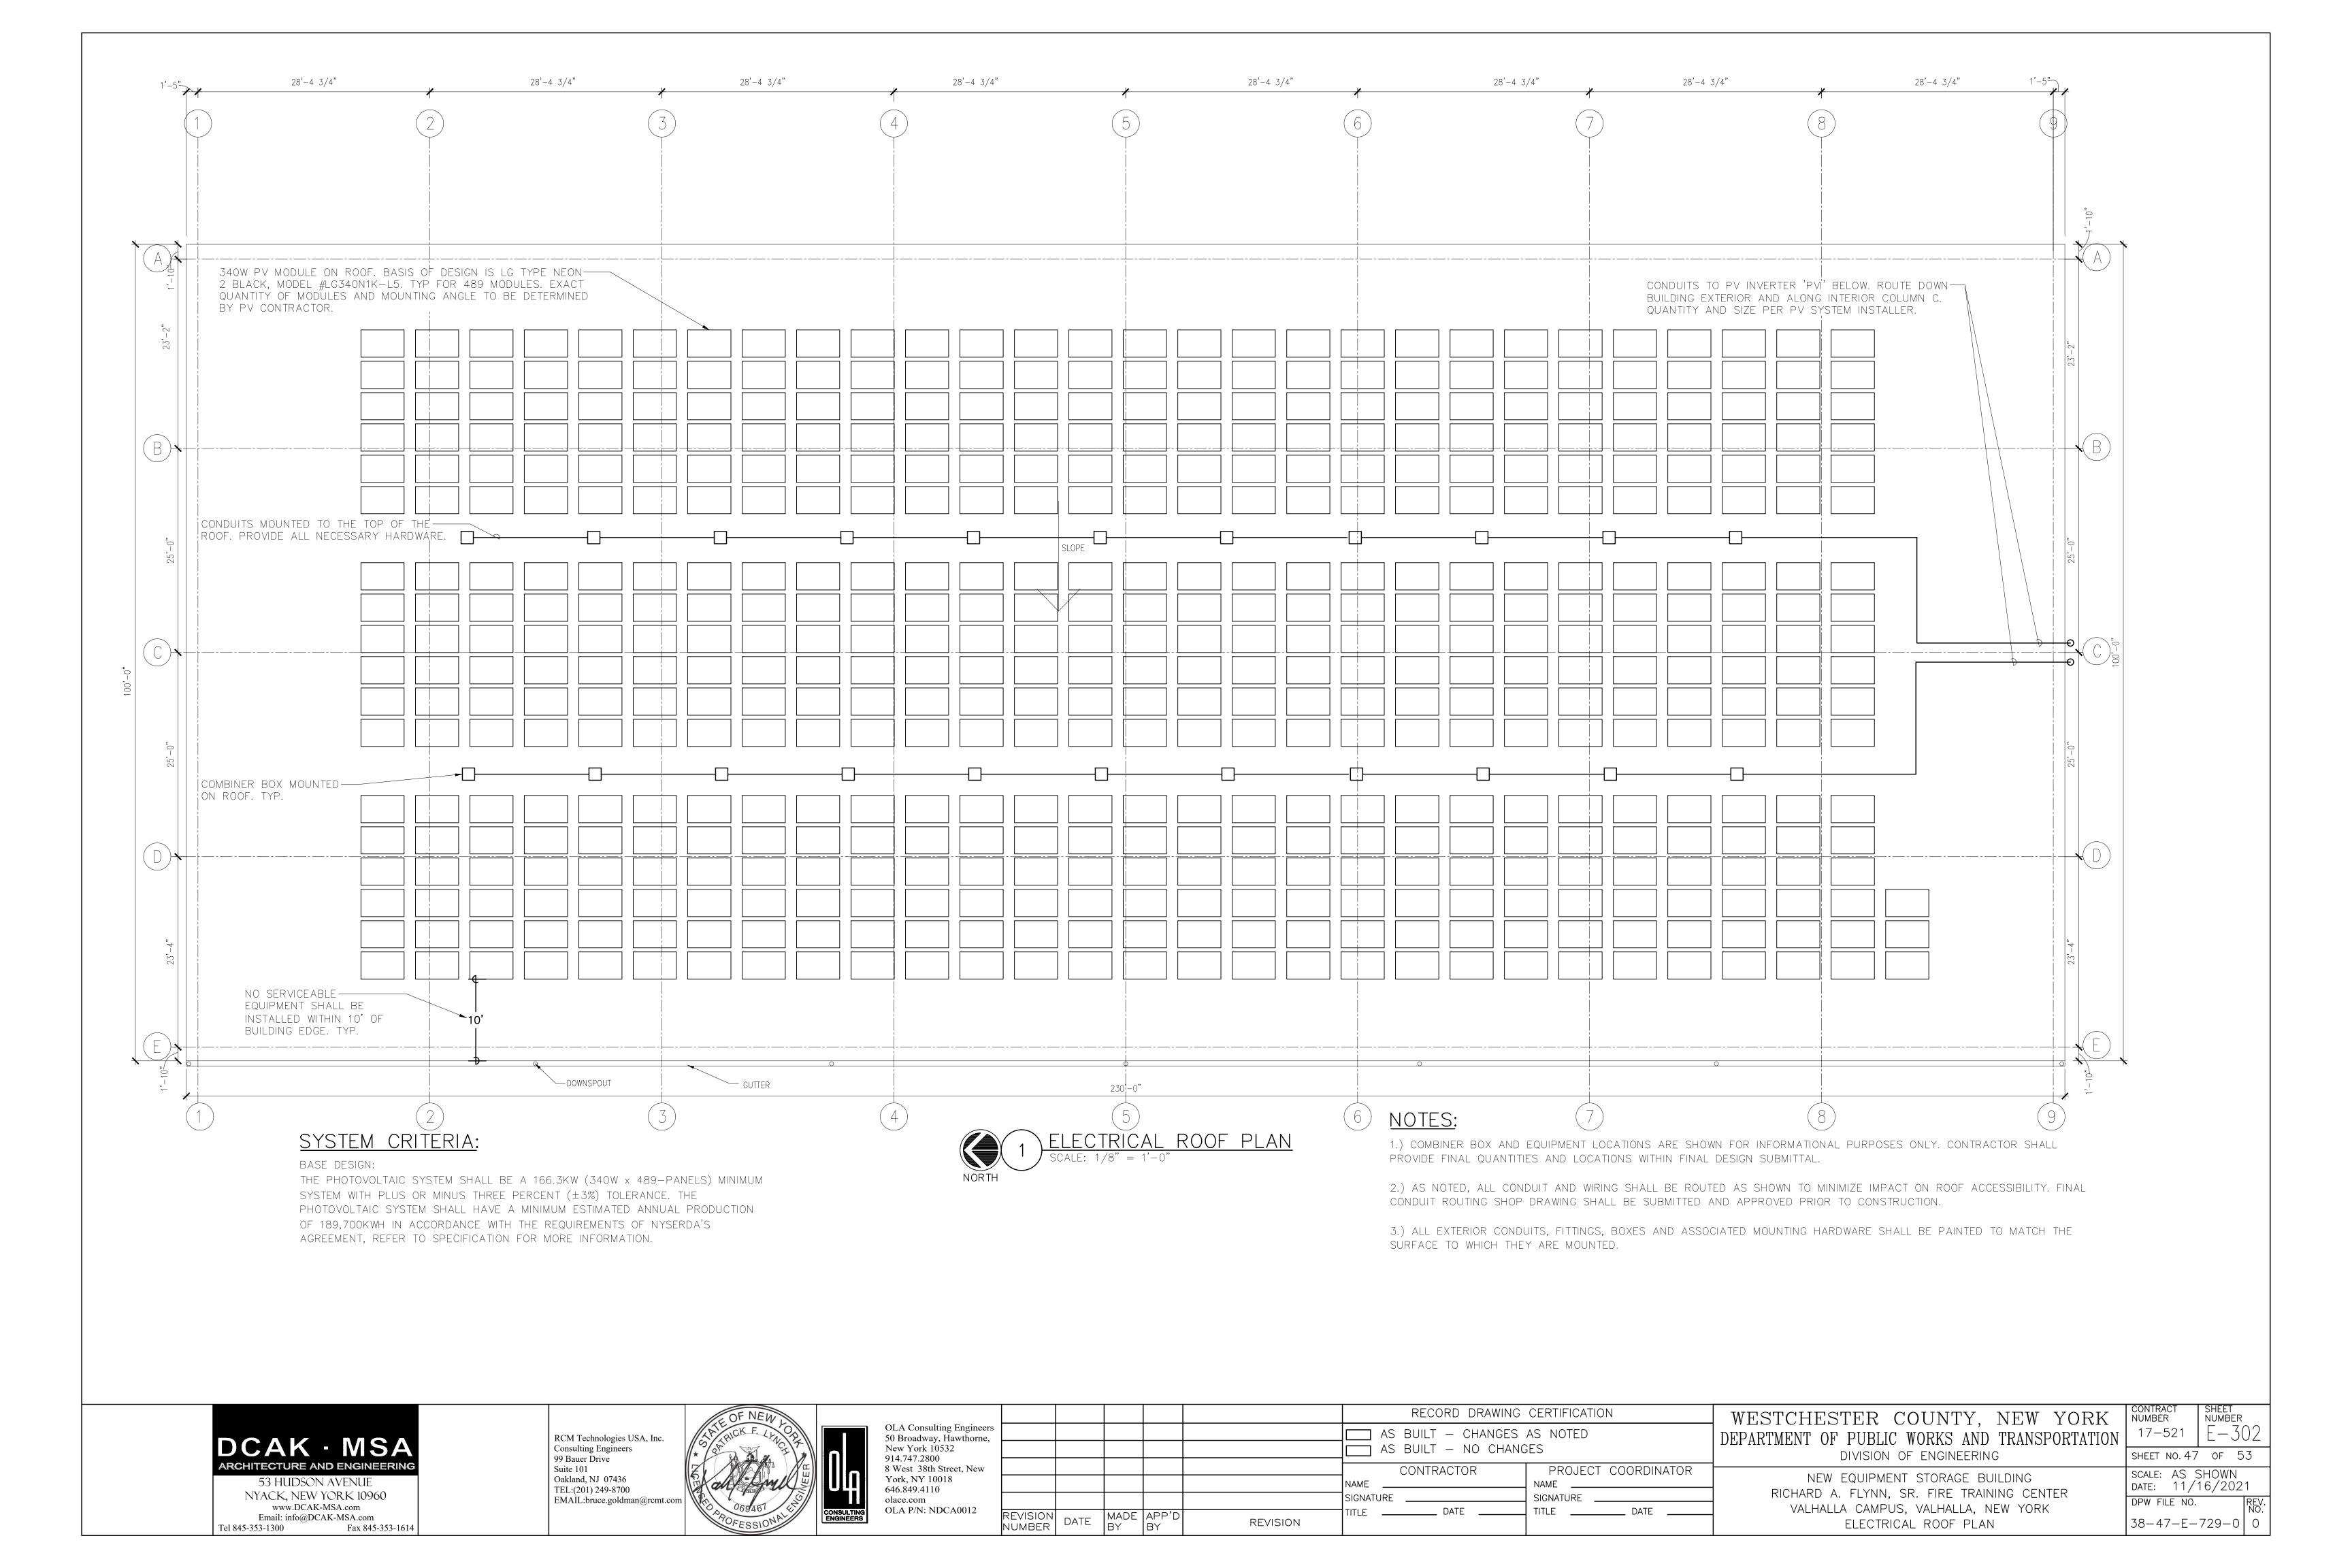
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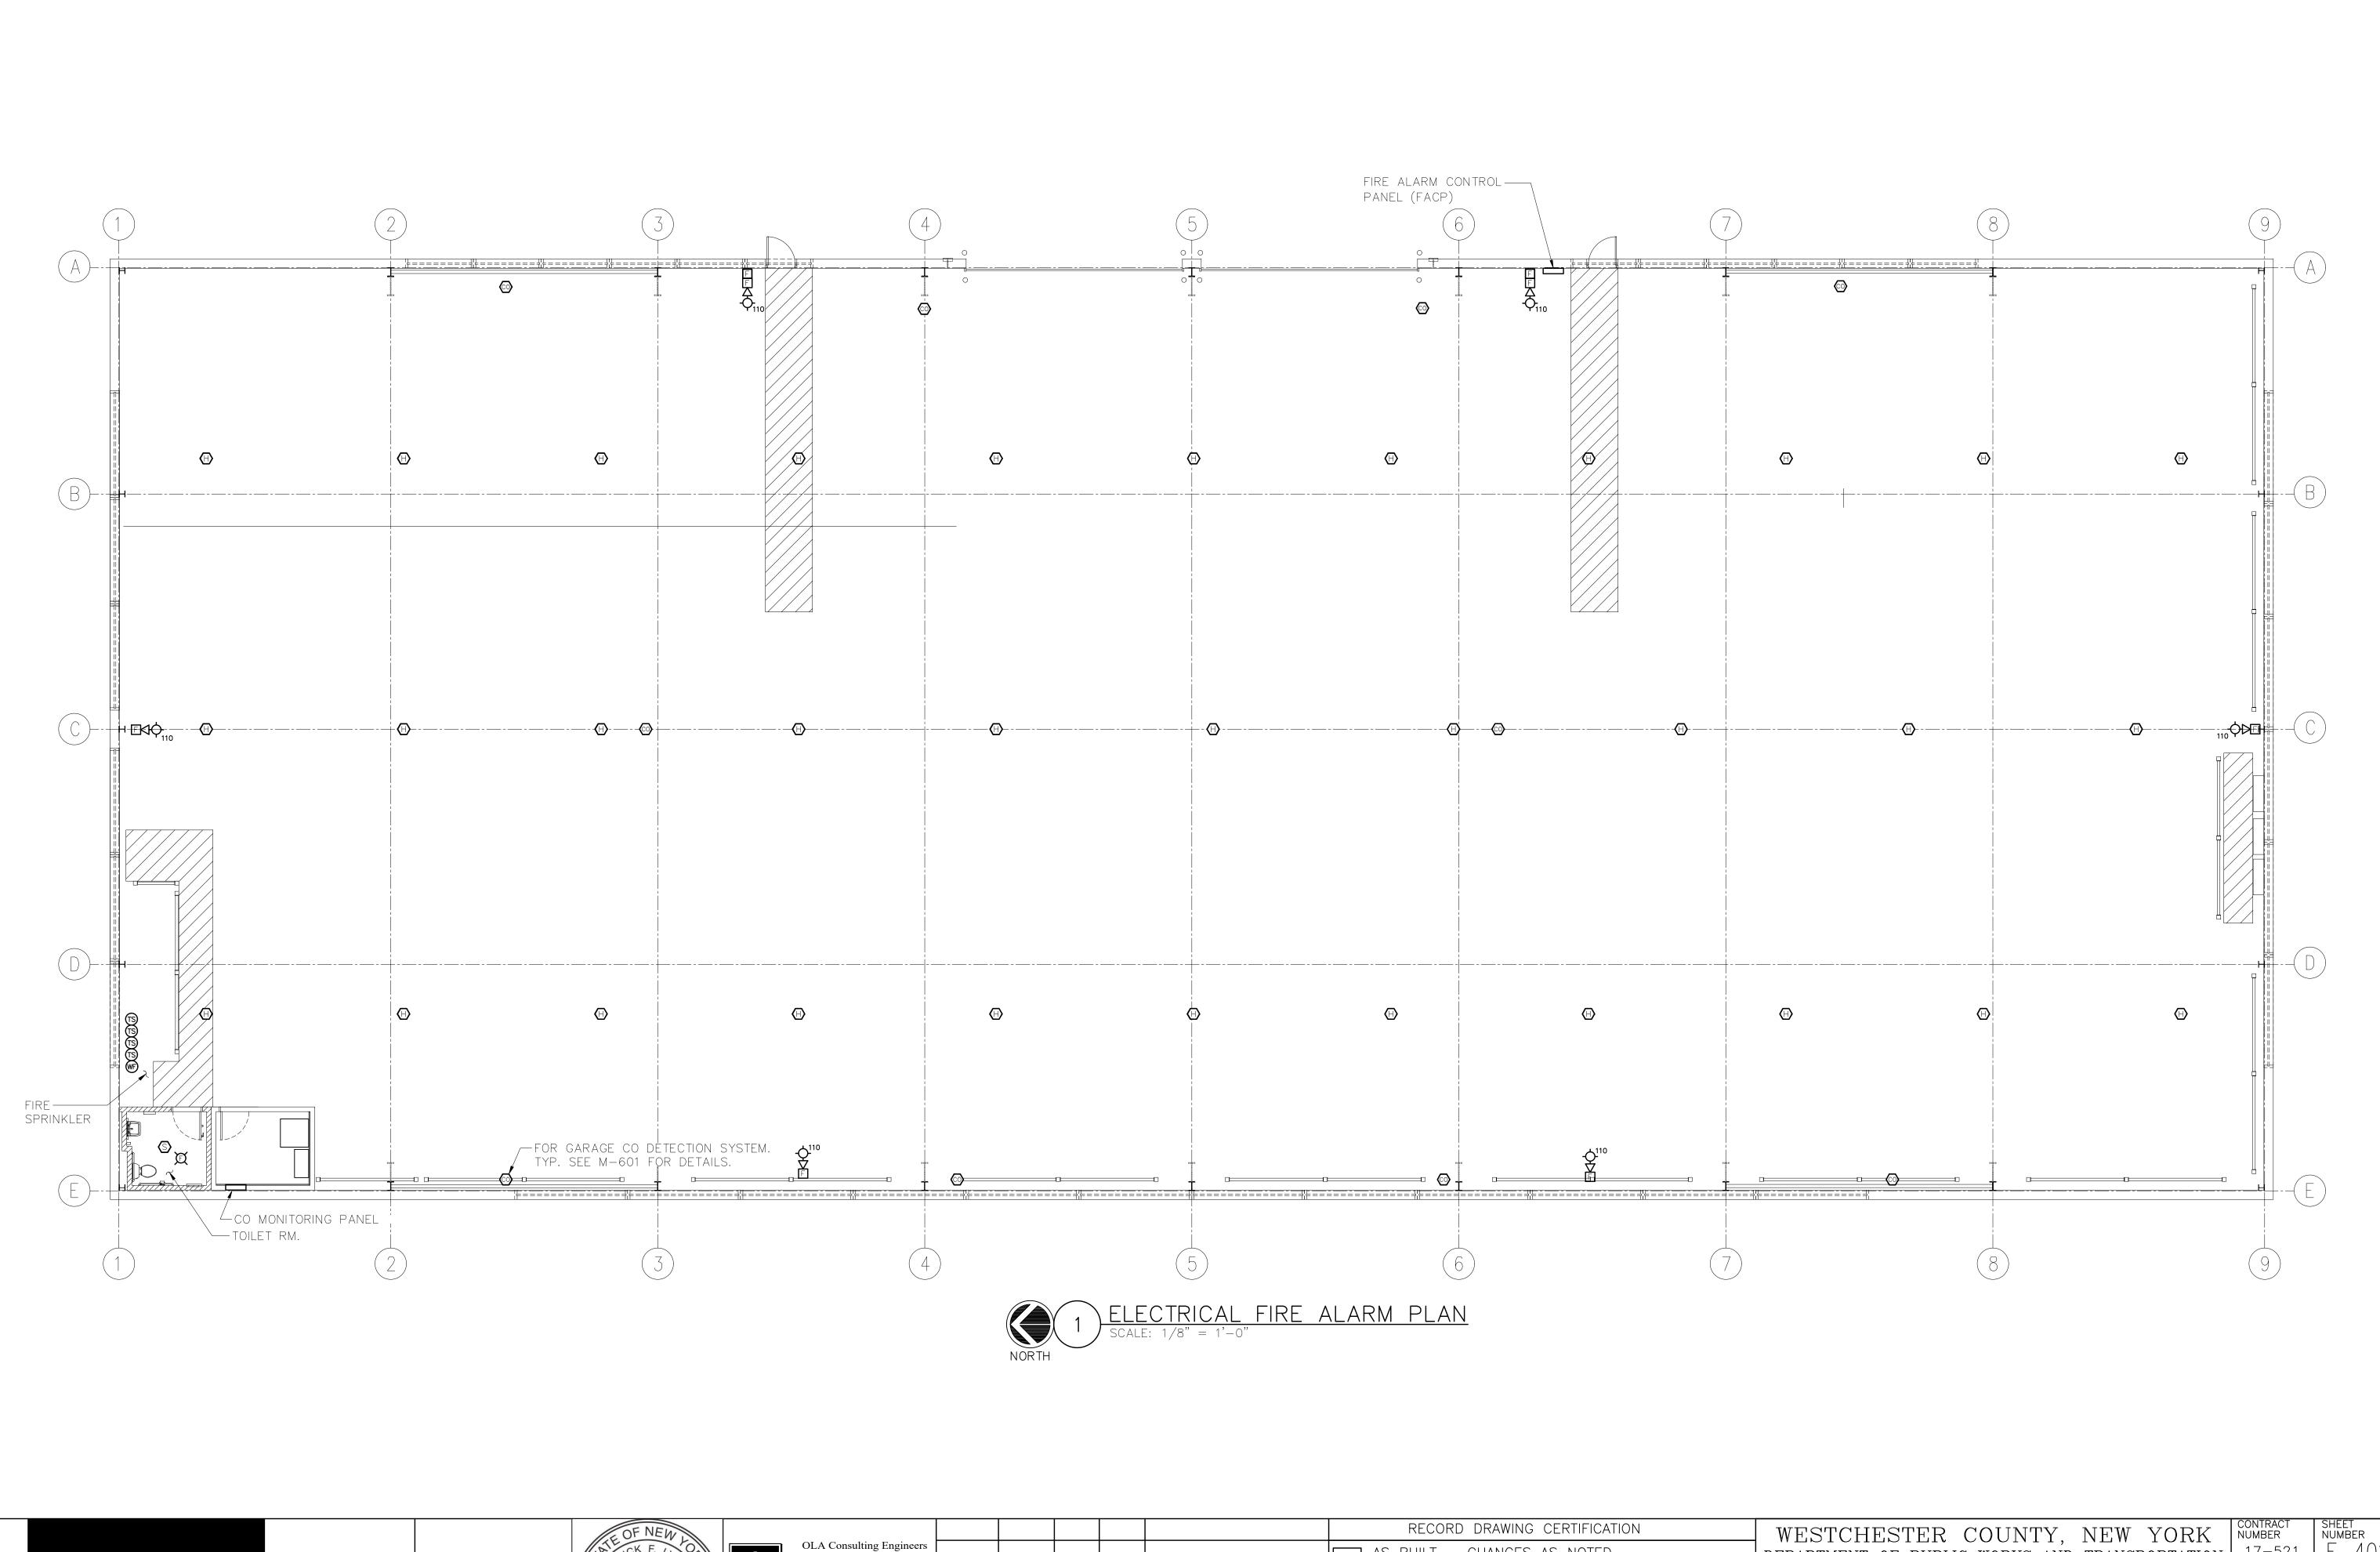
WESTCHESTER COUNTY, NEW YORK EPARTMENT OF PUBLIC WORKS AND TRANSPORTATION DIVISION OF ENGINEERING

NEW EQUIPMENT STORAGE BUILDING RICHARD A. FLYNN, SR. FIRE TRAINING CENTER VALHALLA CAMPUS, VALHALLA, NEW YORK ELECTRICAL SITE PLAN







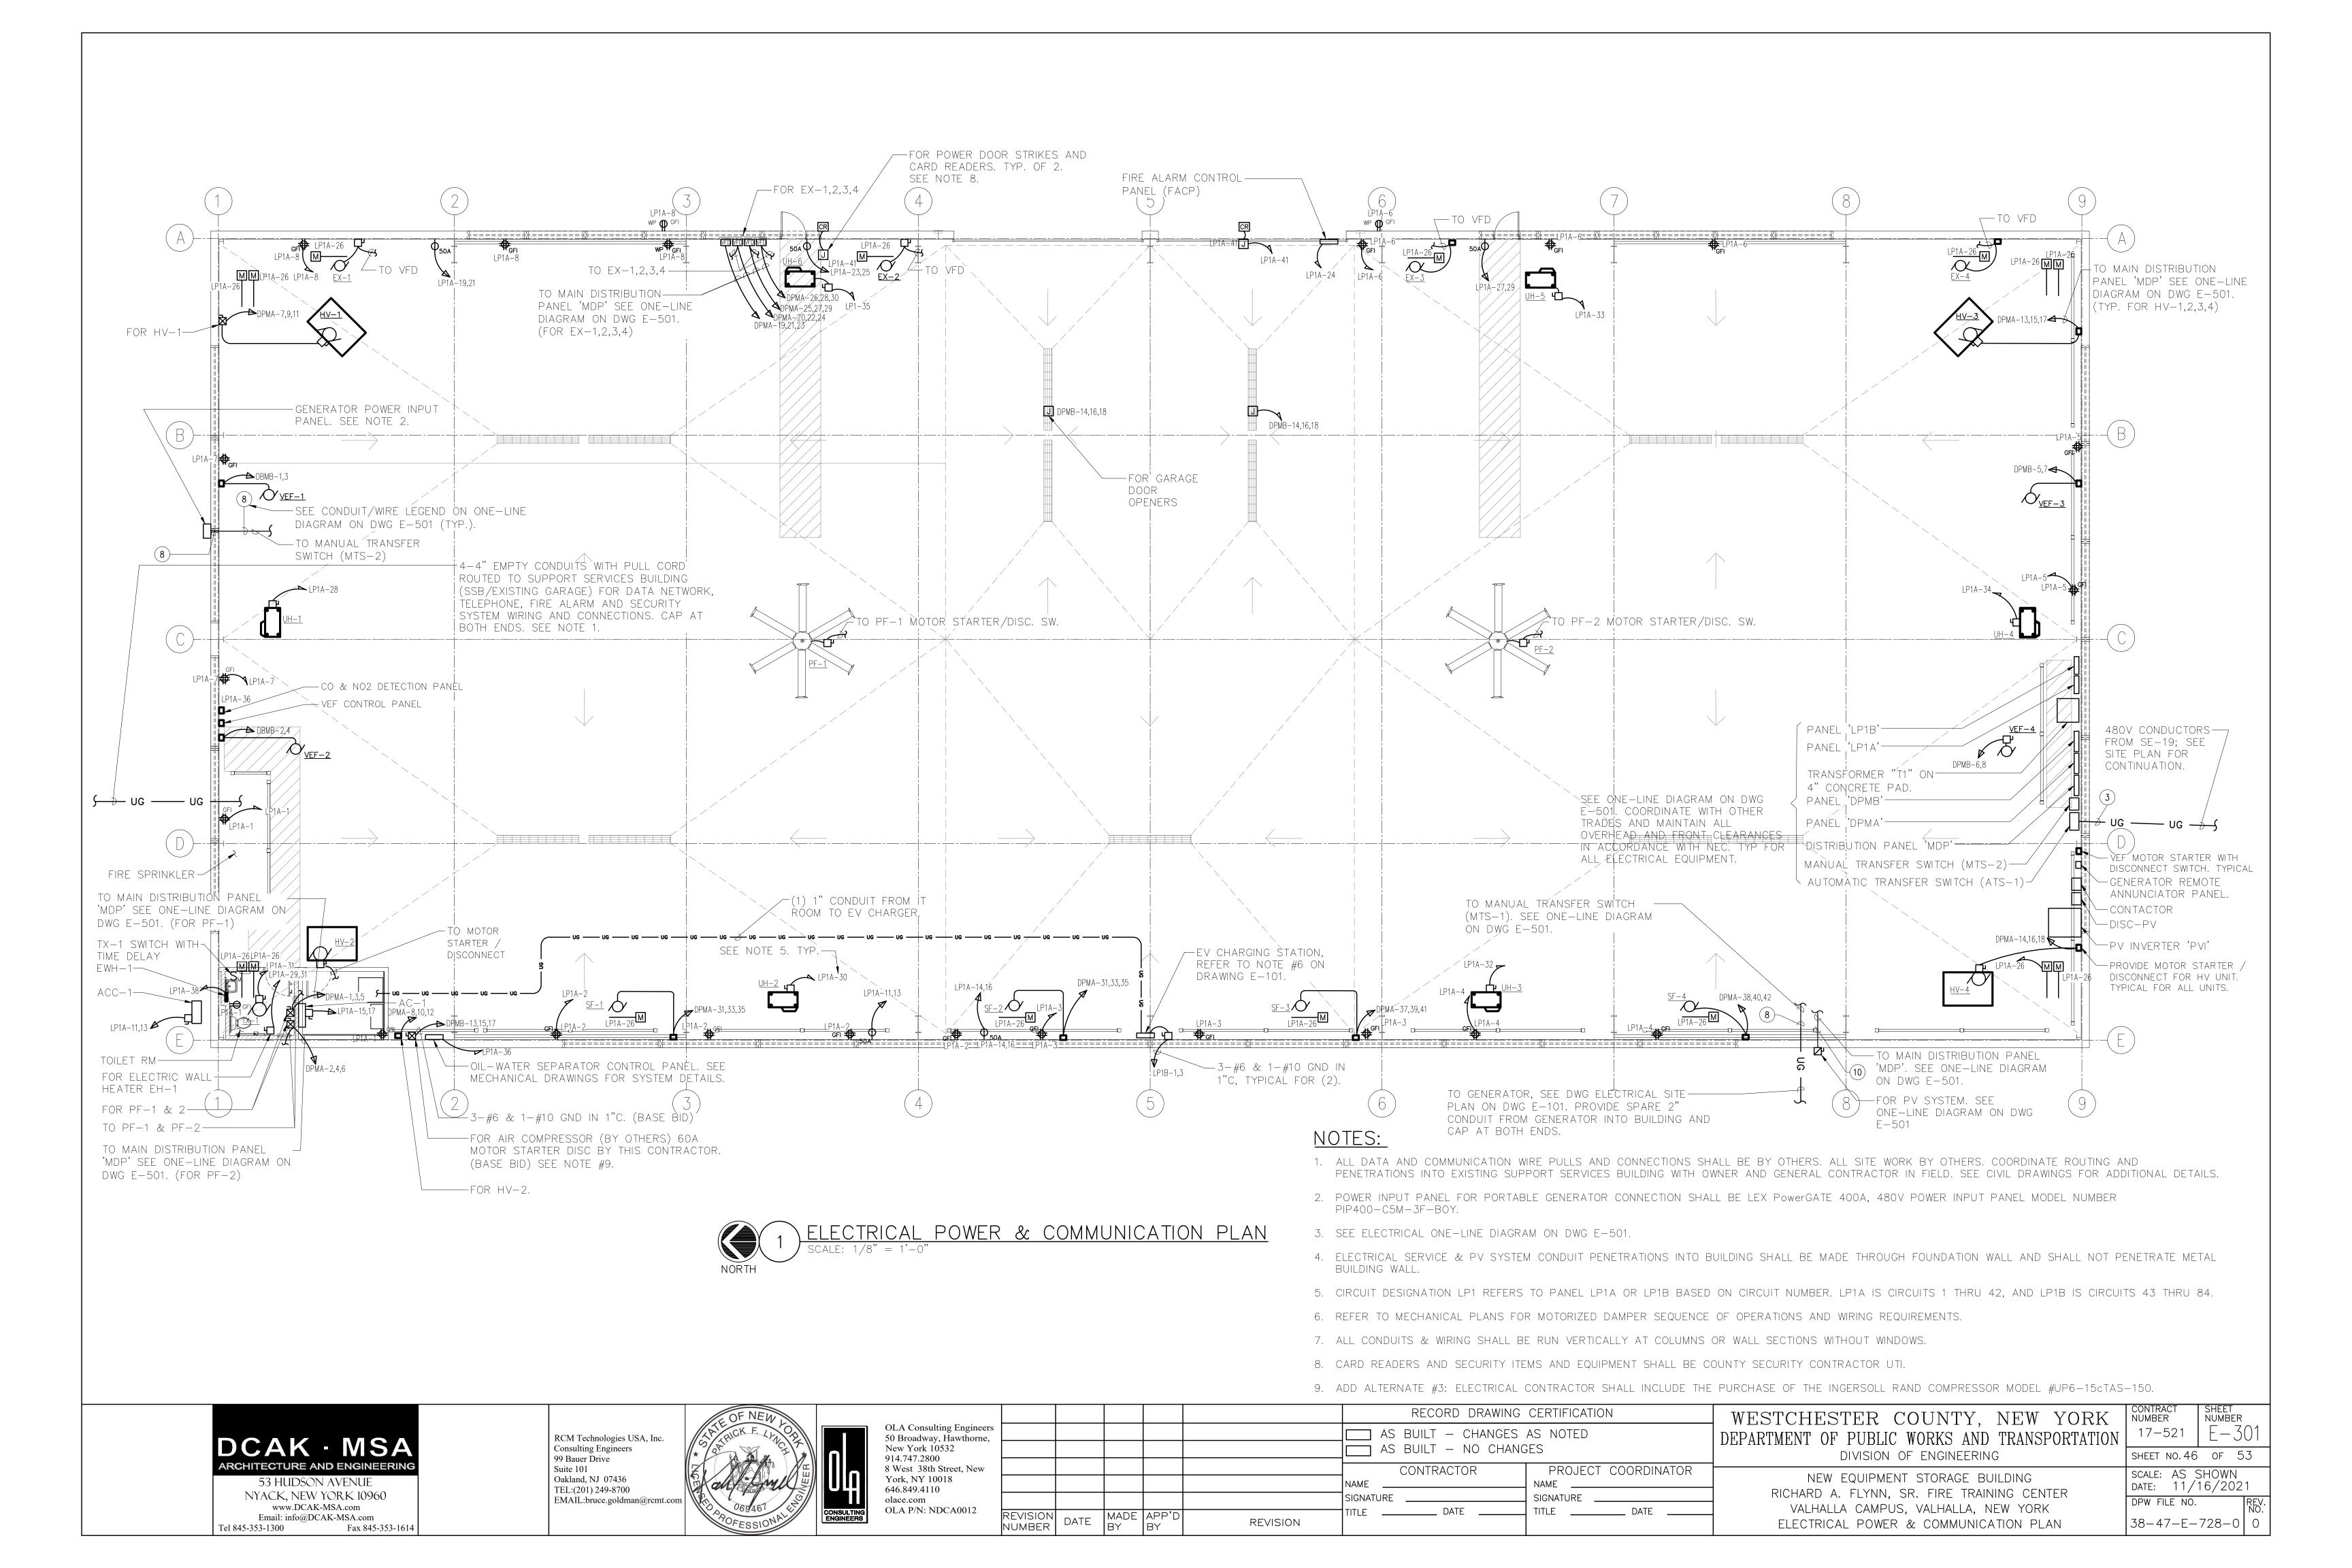

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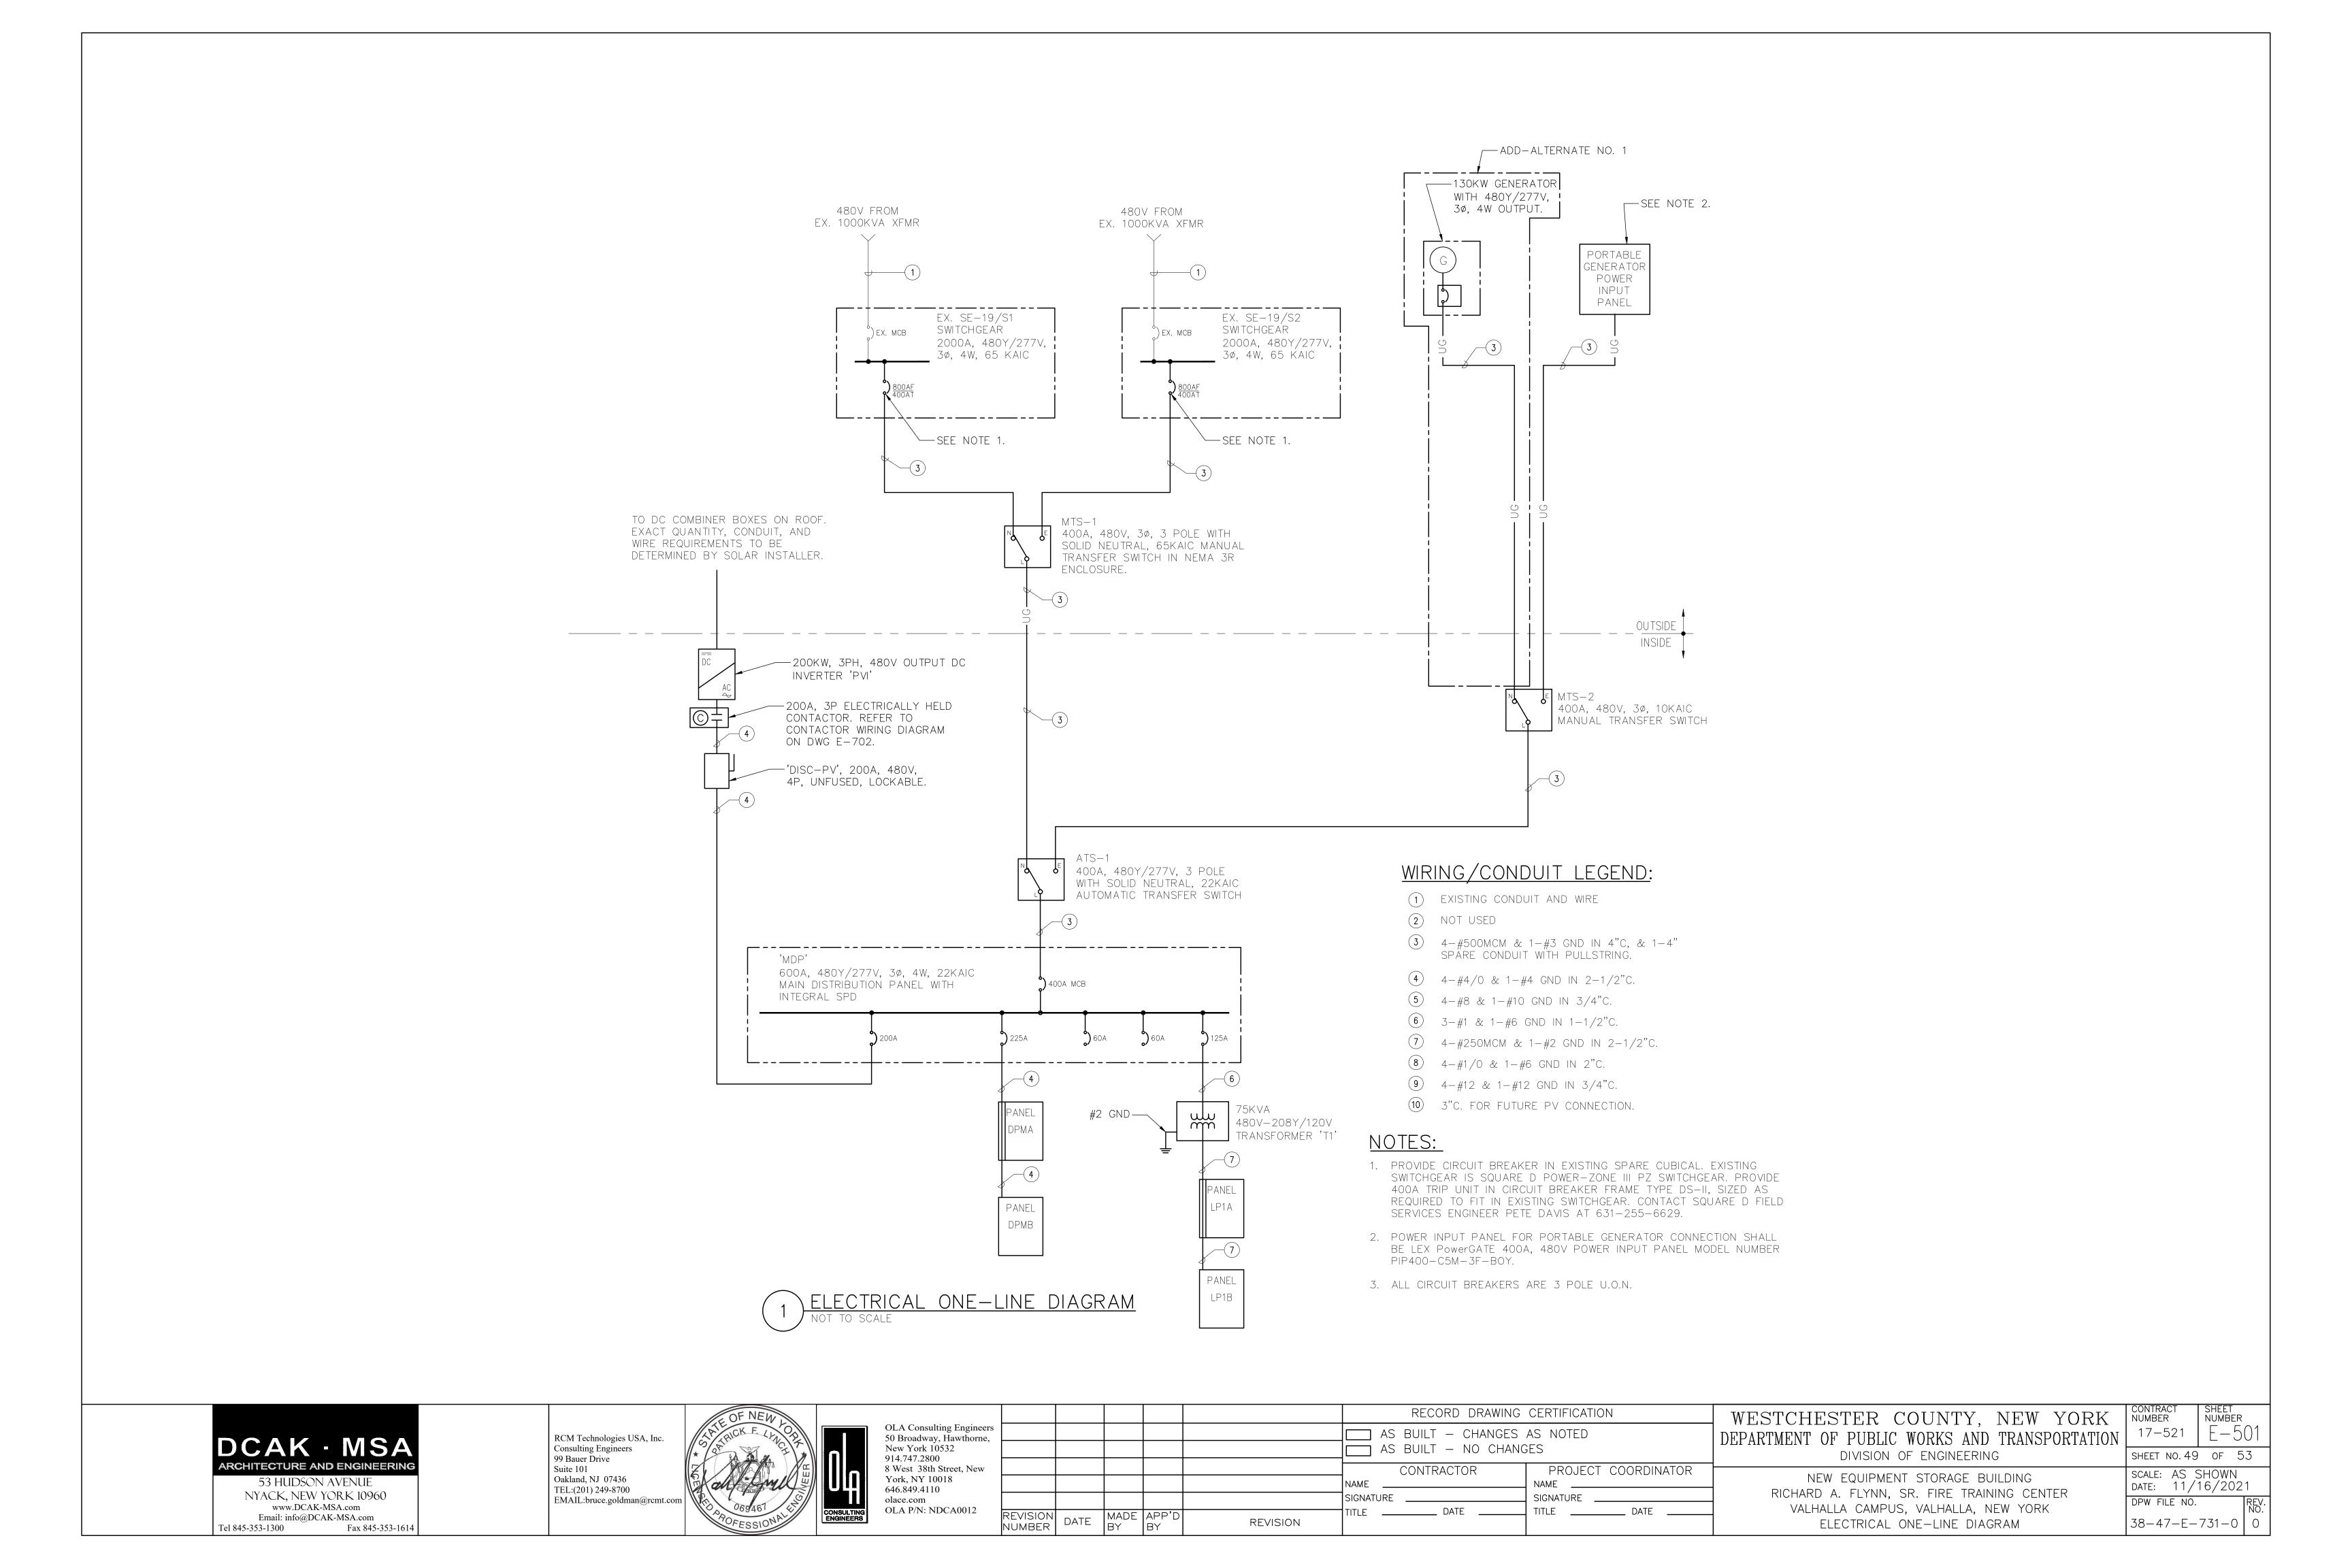
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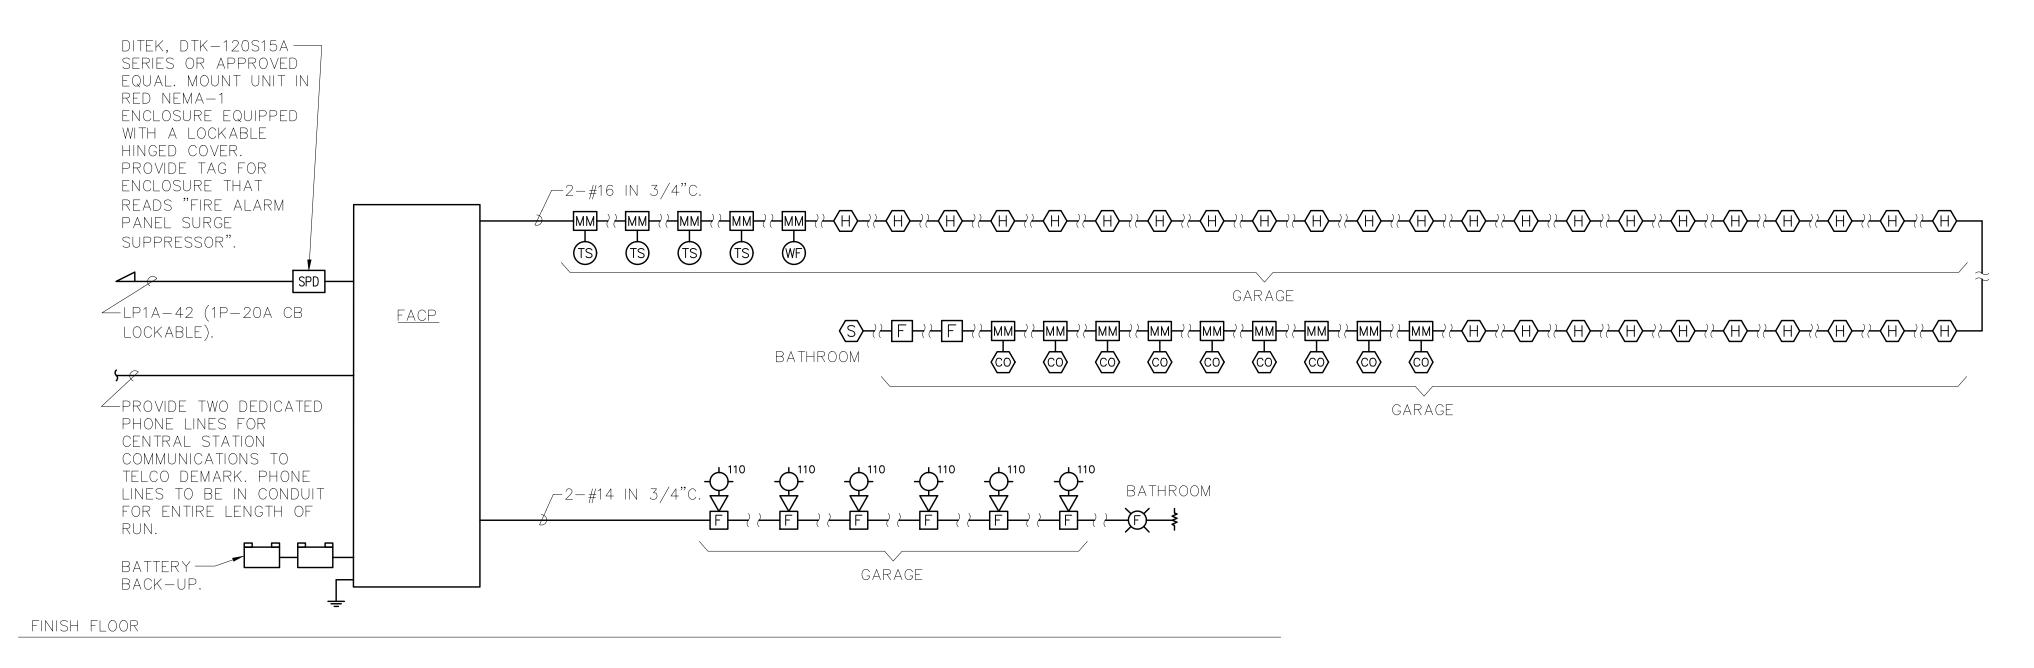
DEPARTMENT OF PUBLIC WORKS AND TRANSPORTATION DIVISION OF ENGINEERING

> NEW EQUIPMENT STORAGE BUILDING RICHARD A. FLYNN, SR. FIRE TRAINING CENTER VALHALLA CAMPUS, VALHALLA, NEW YORK FIRE ALARM PLAN

 $17-521 \quad E-401$ SHEET NO.48 OF 53 SCALE: AS SHOWN DATE: 11/16/2021

DPW FILE NO. 38-47-E-730-0 0





1 FIRE ALARM RISER DIAGRAM NOT TO SCALE

RISER NOTES:

- 1. THIS IS NOT A POINT—TO—POINT WIRING DIAGRAM. PRIOR TO STARTING ANY WORK, A WORKING POINT—TO—POINT WIRING DIAGRAM SHALL BE OBTAINED FROM FIRE ALARM SYSTEM VENDOR AND PERFORM ALL WORK IN ACCORDANCE WITH THAT DIAGRAM.
- 2. ELECTRICAL CONTRACTOR SHALL INCLUDE IN THE BASE BID ALL 120V CIRCUITS THAT ARE REQUIRED TO SUPPORT THE OPERATION OF THE FIRE ALARM SYSTEM. COORDINATE REQUIREMENTS WITH THE FIRE ALARM VENDOR.
- 3. QUANTITY OF STROBE BOOSTER POWER SUPPLY PANELS AND ASSOCIATED 120V CIRCUITS SHALL BE COORDINATED WITH SELECTED FIRE ALARM SYSTEM MANUFACTURER AND/OR FIRE ALARM VENDOR.
- 4. PROVIDE ALL NECESSARY WIRING, MODULES, COMPONENTS, ENTENDER CABINET, AND PROGRAMMING REQUIRED TO CONNECT NEW DEVICES TO EXISTING SYSTEM.
- 5. PROVIDE ALL NECESSARY HARDWARE AND PROGRAMMING TO PROVIDE THE CLIENT WITH 20% SPARE CAPACITY ON ALL INITIATING AND INDICATING CIRCUITS.
- 6. PROVIDE AS PART OF THE BASE CONTRACT ALL LABOR AND MATERIALS TO INSTALL FIFTEEN (15) ADDITIONAL FIRE ALARM DEVICES DURING CONSTRUCTION. THE FIFTEEN (15) FIRE ALARM DEVICES CAN BE BUT NOT LIMITED TO SMOKE DETECTOR, HEAT DETECTOR, DOOR HOLDER, DUCT DETECTOR, FAN SHUTDOWN, TAMPER SWITCHES, FLOW SWITCHES, ETC. INCLUDE ALL LABOR AND MATERIALS INCLUDING WIRE, BOXES, CONDUIT, TERMINATIONS, HARDWARE, SOFTWARE, PROGRAMMING AND TESTING.
- 7. ALL VISUAL ALARM DEVICES SHALL BE ADA COMPLIANT.

- 8. MAKE CONNECTIONS TO SIDES OR BOTTOM OF FACP ONLY.
- 9. ELECTRICAL CONTRACTOR TO PROVIDE A RELAY FOR EACH SMOKE DAMPER/COMBINATION FIRE SMOKE DAMPER. RELAYS ARE NOT SHOWN ON PLANS FOR CLARITY.
- 10. PROVIDE REMOTE LED INDICATORS FOR ALL CONCEALED FIRE ALARM DEVICES SUCH AS DUCT SMOKE DETECTORS, ABOVE CEILING SMOKE DETECTORS, ELEVATOR SHAFT DETECTORS, MONITORING AND CONTROL MODULES, ETC. LED INDICATORS FOR DEVICES MOUNTED ABOVE DROP CEILINGS SHALL BE MOUNTED BELOW ASSOCIATED DEVICES. LABEL INDICATORS TO INDICATE DEVICE SERVED.
- 11. THE CONTRACTOR SHALL BE RESPONSIBLE TO PROVIDE THE ENGINEER WITH AN ACCURATE AS—BUILT FIRE ALARM DRAWING, SHOWING INSTALLED DEVICE LOCATIONS AND A COMPLETE INTERCONNECTION WIRING DIAGRAM OF THE SYSTEM. THE DRAWINGS SHALL BE PROVIDED IN AUTOCAD FORMAT AND HARD COPIES. AS—BUILT DRAWINGS MUST BE PROVIDED TO THE ENGINEER BEFORE PROJECT CAN BE CLOSEOUT.
- 12. CONTRACTOR TO PROVIDE SMOKE DETECTOR(S) IN ALL LOCATIONS CONTAINING FIRE ALARM CONTROL PANELS, DATA GATHERING PANELS, BOOSTER POWER SUPPLIES, OR ANY OTHER FIRE ALARM SYSTEM PANEL, WHETHER SHOWN ON PLANS OR NOT.

DCAK - MSA

ARCHITECTURE AND ENGINEERING

53 HUDSON AVENUE

NYACK, NEW YORK 10960


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OLA P/N: NDCA0012

						RECORD DRAWING CERTIFICATION	-
gineers orne,						AS BUILT — CHANGES AS NOTED AS BUILT — NO CHANGES	Dl
New						CONTRACTOR PROJECT COORDINATOR	
12	REVISION NUMBER	DATE	MADE BY	APP'D BY	REVISION	SIGNATURE SIGNATURE TITLE DATE	

WESTCHESTER COUNTY, NEW YORK
DEPARTMENT OF PUBLIC WORKS AND TRANSPORTATION
DIVISION OF ENGINEERING

NEW EQUIPMENT STORAGE BUILDING RICHARD A. FLYNN, SR. FIRE TRAINING CENTER VALHALLA CAMPUS, VALHALLA, NEW YORK FIRE ALARM RISER DIAGRAM CONTRACT NUMBER 17-521 E-502SHEET NO.50 OF 53

SCALE: AS SHOWN DATE: 11/16/2021

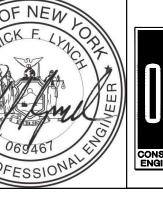DPW FILE NO. REV NO 38-47-E-732-0 0

	LIGHTING FIXTURE SCHEDULE									
FIXTURE DESIGNATION	MANUFACTURER	CATALOG NUMBER	LAMPS	VOLTS	INPUT WATTS	MOUNTING	REMARKS			
А	RAB LIGHTING	ARBAY2-160N EM=E2	LED 22000LM 4000K	120	160	PENDANT	1'x2' HIGH-BAY LED LIGHTING FIXTURE. PROVIDE INTEGRAL BATTERY BALLAST WHERE DENOTED 'EM'			
В	RAB LIGHTING	SLIM37N/BL	LED	120	37	SURFACE	LED WALLPACKS OUTDOOR LIGHTING FIXTURE.			
С	RAB LIGHTING	EZPANHE2'X2'23W/E2	LED	120	24.2	RECESSED	2'X2' RECESSED FIXTURE WITH INTEGRAL BATTERY BALLAST. FIXTURE TYPE BY ARCHITECT.			
E	EATON SURE-LITES	SELD-D-W 60-SD-HAZ	LED (300 LUMEN)	120	5	SURFACE	TWO HEADS EMERGENCY LIGHTING			
X1	EATON SURE-LITES	APC7RSQ	LED	120	3.7	SURFACE	EXIT LIGHTING WITH TWO HEADS EMERGENCY LIGHTING			

NOTES:

- 1. VERIFY ALL FIXTURE CATALOG NUMBERS FOR INTENDED APPLICATIONS WITH REQUIRED ACCESSORIES.
- 2. ALL BALLASTS IN FIXTURES LOCATED OUTDOORS SHALL BE ZERO DEGREE RATED STARTING TEMPERATURE. REFER TO DRAWINGS FOR LOCATION OF FIXTURES.
- 3. LIGHT FIXTURES INDICATED AS EMERGENCY (EM) ON DRAWINGS SHALL CONTAIN AN EMERGENCY BATTERY
 BACK-UP BALLAST INTERNAL TO FIXTURE WITH A VISUAL INDICATING CHARGE LAMP AND TEST SWITCH. EACH
 BATTERY PACK SHALL BE CONNECTED SO THAT THE FIXTURE CAN BE SWITCHED UNDER NORMAL CONDITIONS
 AND IN THE EVENT OF A POWER OUTAGE, THE BATTERY PACK AND LAMPS SHALL AUTOMATICALLY
 ILLUMINATE FOR 90 MINUTES WITH A 1200 LUMEN OUTPUT (TOTAL FROM FIXTURE), MINIMUM.
- 4. ALL EXIT AND EMERGENCY FIXTURES SHALL BE FED FROM UNSWITCHED LEG OF ASSOCIATED LOCAL LIGHTING CIRCUITS.
- 5. IN THE EVENT THE CONTRACTOR CHOOSES TO SUBSTITUTE LIGHT FIXTURES FOR THOSE THAT ARE SPECIFIED ON THE LIGHT FIXTURE SCHEDULE, THE CONTRACTOR SHALL SUBMIT POINT—TO—POINT PHOTOMETRIC CALCULATIONS FOR ALL AREAS WHERE THE SUBSTITUTED FIXTURES ARE INDICATED TO BE INSTALLED ON THE DRAWINGS. THESE CALCULATIONS SHALL BE SUBMITTED ALONG WITH THE LIGHT FIXTURE SHOP DRAWINGS.

	LP1/	4 P/	ANEI	_ SC	HE	DULE	
	main rating: <u>250a</u>	MΑ	IN CB:	<u>250A</u>		KAIC RATING: <u>44KAIC</u>	•
	VOLTAGE: <u>208Y/120V</u>	PH	ASE: 3	<u>s</u> wif	RE: <u>4</u>	MOUNTING: <u>SURFACE</u>	
CIRC. NO.	LOAD DESCRIPTION	BKR. AMPS		NO. OF POLES	BKR. AMPS	LOAD DESCRIPTION	CIRC. NO.
1	RECEPTACLE	20	1	1	20	RECEPTACLE	2
3	RECEPTACLE	20	1	1	20	RECEPTACLE	4
5	RECEPTACLE	20	1	1	20	RECEPTACLE	6
7	LIGHTING	20	1	1	20	LIGHTING	8
9	LIGHTING	20	1	1	20	LIGHTING	10
11	ACC 1	20	2	1	20	LIGHTING	12
13	ACC-1		_	1	20	SPARE	14
15	A C 1	15	2	1	20	SPARE	16
17	AC-1			1	20	GENERATOR	18
19	SPARE	20	1	1	20	GENERATOR	20
21	SPARE	20	1	1	20	GENERATOR	22
23	SPARE	20	1	1	20	FIRE ALARM CONTROL PANEL (FACP)	24
25	SPARE	20	1	1	20	MOTORIZED DAMPERS	26
27	TX-1	20	1	1	20	UH-1	28
29	 EH-1	20	2	1	20	UH-2	30
31		20		1	20	UH-3	32
33	UH-5	20	1	1	20	UH-4	34
35	UH-6	20	1	1	20	OWS CONTROL PANEL & CO DETECTION PANEL	36
37	SPARE	20	1	1	40	EWH-1	38
39	SPARE	20	1	1	20	SPARE	40
41	POWER DOOR STRIKES & CARD READERS	20	1	1	20	FACP	42

FEED THROUGH LUGS TO LP1B

LK — PROVIDE LOCKING TABS ON C.B.; GF — GFI TYPE C.B.; AF — ARC FAULT TYPE C.B.; ST — SHUNT TRIP C.B.

LK - PROVIDE LOCKING TABS ON C.B.; GF - GFI TYPE C.B.; AF - ARC FAULT TYPE C.B.;

NOTES:

MAIN RATING: <u>225A</u> MAIN CB: <u>225A</u> KAIC RATING: <u>22KAIC</u>											
	VOLTAGE: <u>480Y/277</u>	<u>V</u> PH	ASE: 3	<u>5</u> WIF	RE: <u>4</u>	MOUNTING: <u>SURFACE</u>					
CIRC. NO.	LOAD DESCRIPTION	BKR. AMPS	NO. OF POLES	NO. OF POLES	BKR. AMPS	LOAD DESCRIPTION	CIRC NO.				
1 3 5	PF-1	15	3	3	15	PF-2	2 4 6				
7 9 11	HV-1	20	3	3	20	HV-2	8 10 12				
13 15 17	HV-3	20	3	3	20	HV-4	14 16 18				
19 21 23	EX-1	20	3	3	20	EX-2	20 22 24				
25 27 29	EX-3	20	3	3	20	EX-4	26 28 30				
31 33 35	SF-1	20	3	3	20	SF-2	32 34 36				
37 39 41	SF-3	20	3	3	20	SF-4	38 40 42				

FEED THROUGH LUGS TO DPMB

LK — PROVIDE LOCKING TABS ON C.B.; GF — GFI TYPE C.B.; AF — ARC FAULT TYPE C.B.; ST — SHUNT TRIP C.B.

NOTES:

LP1B PANEL SCHEDULE											
	main rating: <u>250a</u>	МА									
	VOLTAGE: <u>208Y/120V</u>	PH.	PHASE: <u>3</u> WIRE: <u>4</u> MOUNTING: <u>SURFACE</u>								
CIRC. NO.	LOAD DESCRIPTION	BKR. AMPS	NO. OF POLES	NO. OF POLES	BKR. AMPS	LOAD DESCRIPTION	CIRC. NO.				
1	208V VEHICLE CHARGING RECEPTACLE	40	2	2	40	208V VEHICLE CHARGING RECEPTACLE	2 4				
5 7	208V VEHICLE CHARGING RECEPTACLE	40	2	2	50	SPARE	6 8				
9	208V VEHICLE CHARGING RECEPTACLE	40	2	2	50	SPARE	10				
13 15	SPARE SPARE	20	1	2	50	SPARE	14				
17 19	SPARE SPARE	20	1	2	50	SPARE	18				
21	SPARE	20	1	1	20	SPACE	22				
23	SPARE	20	1	1	20	SPACE	24				
25	SPARE	20	1	1	20	SPACE	26				
27	SPARE	20	1	1	20	SPACE	28				
29	SPARE	20	1	11	20	SPACE	30				
31	SPARE	20	1	11	20	SPACE	32				
33	SPARE	20	1	1	20	SPACE	34				
35	SPARE	20	1	1	20	SPACE	36				
37	SPARE	20	1		20	SPACE	38				
39	SPARE	20	1		20	SPACE	40				
41	SPARE	20	1	1	20	SPACE	42				

	DPMB PANEL SCHEDULE											
	main rating: <u>225A</u>	MA	IN CB:	KAIC RATING: <u>22KAIC</u>								
	VOLTAGE: 480Y/277V	PH	ASE: 3	MOUNTING: <u>SURFACE</u>								
CIRC. NO.	LOAD DESCRIPTION	BKR. AMPS	NO. OF POLES	NO. OF POLES		LOAD DESCRIPTION	CIR					
1 3	VEHICLE EXHAUST FAN 1	20	2	2	20	VEHICLE EXHAUST FAN 2	2					
5 7	vehicle exhaust fan 3	20	2	2	20	VEHICLE EXHAUST FAN 4	6					
9	SPARE	20	2	2	20	SPARE	1(
13 15 17	AIR COMPRESSOR	50	3	3	20	GARAGE DOOR OPENERS	12 16					
19 21 23	SPARE	20	3	3	20	SPARE	20					
25	SPARE	20	3	3	20	SPARE	28					
31	SPARE	20	3	3	20	SPARE	32					
37 39	SPARE	20	3	3	20	SPARE	38					
41	DROVIDE LOCKING TARS ON CR. CE. CEL	TYDE (<u> </u>		HIT TYPE O.D.	42					

LK - PROVIDE LOCKING TABS ON C.B.; GF - GFI TYPE C.B.; AF - ARC FAULT TYPE C.B.; ST - SHUNT TRIP C.B.

NOTES:

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NOTES:

ST — SHUNT TRIP C.B.

OLA Consulting Engineers 50 Broadway, Hawthorne, New York 10532 914.747.2800 8 West 38th Street, New York, NY 10018 646.849.4110 olace.com OLA P/N: NDCA0012

							RECORD DRAWING	CERTIFICATION	١	
ers e,						-	BUILT — CHANGES BUILT — NO CHANG			DE
						NAME SIGNATURE	CONTRACTOR	NAME SIGNATURE	COORDINATOR	
	REVISION NUMBER	DATE	MADE BY	APP'D BY	REVISION	TITLE	DATE	TITLE	DATE	-

WESTCHESTER COUNTY, NEW YORK
DEPARTMENT OF PUBLIC WORKS AND TRANSPORTATION
DIVISION OF ENGINEERING

NEW EQUIPMENT STORAGE BUILDING RICHARD A. FLYNN, SR. FIRE TRAINING CENTER VALHALLA CAMPUS, VALHALLA, NEW YORK ELECTRICAL SCHEDULES CONTRACT NUMBER


17-521 E-601

SHEET NO.51 OF 53

SCALE: AS SHOWN DATE: 11/16/2021

DPW FILE NO. REV NO.

38-47-E-733-0 0

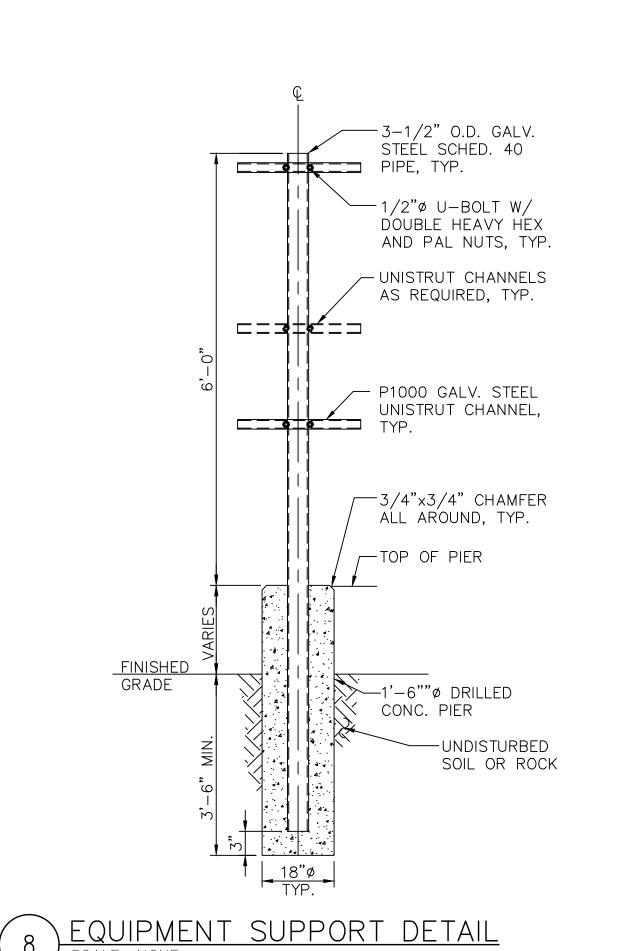

1.) DESIGN TYPICAL FOR MOUNTING SINGLE PIECES OF WALL MOUNTED POWER EQUIPMENT (AUTOMATIC TRANSFER SWITCHES, DISCONNECT SWITCHES, PANELBOARDS, ETC.).

> --- HAZARDOUS UNDERGROUND MARKING TAPE LABELED "CAUTION - ELECTRIC

LINE BURIED BELOW". TAPE SHALL BE

6" WIDE WITH BLACK LETTERING ON A

RED BACKGROUND WITH DETECTABLE

— POWER

CONDUITS.

MANUFACTURED BY PANDUIT PART NO.

----- UNDISTURBED SOIL

(TYP. BOTH SIDES)

SEE MINIMUM

COVER

REQUIREMENT

TABLE.

-BACKFILL WITHIN 6"

OF THE CONDUIT

SHALL BE SAND.

SEE NOTE #2.

ALUMINUM FOIL LAMINATE, AS

HTDU6R-E OR EQUAL.

8"| MAX./<u>-</u>l

TRENCH AREA SHALL BE REPAIRED —

GRADE

6" | MIN.

6" MIN.

Tel 845-353-1300

TO MATCH EXISTING CONDITIONS.

BALANCE OF BACKFILL-

BACKFILL FREE OF SOLID

ADEQUATELY COMPACTED

SHALL BE SUITABLE


MATERIAL GREATER

DIAMETER. BACKFILL

MATERIAL SHALL BE

THAN 6" MAX IN


IN 8" LIFTS.

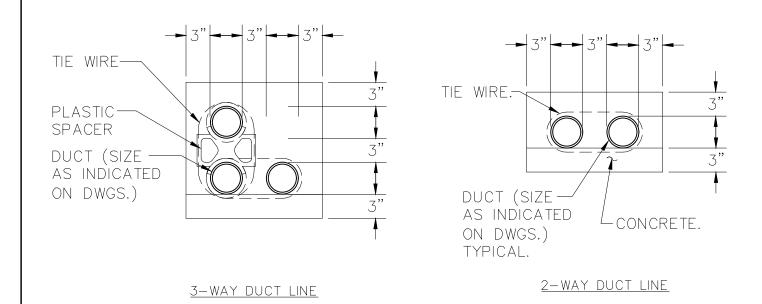

DUCT LINE NOTES:

- 1. CONCRETE SHALL BE 3000 P.S.I. @ 28 DAYS, OR AS SPECIFIED.
- 2. PROVIDE REINFORCING RODS ON TOP OF DUCTS WHEN CROSSING OR PLACED IN ROADWAYS.
- 3. MINIMUM COVER TO TOP OF ENVELOP SHALL BE 24".
- 4. NON-FERROUS TIE WIRES TO BE IMBEDDED IN DUCT BED CONCRETE.
- 5. PROVIDE MINIMUM 6" SPACE BETWEEN POWER AND SIGNAL DUCTS. INCREASE SIZE AS REQUIRED.



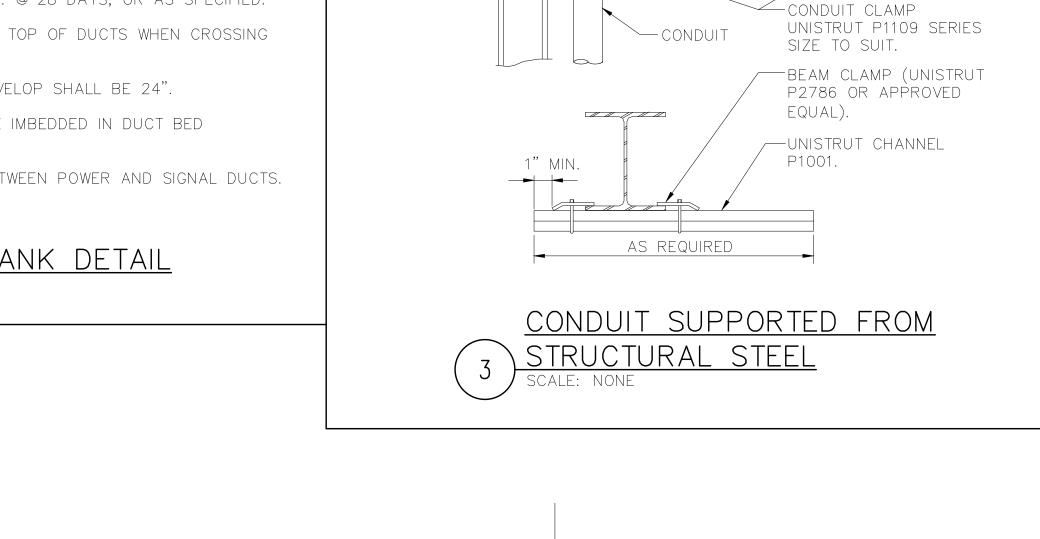

'Z' GIRT VERTICAL

—"Z" GIRT VERTICLE

THE VAPOR BARRIER

SHALL BE TAPED.

-UNISTRUT ----

(TYP.) WELDED

TO STEEL.

CHANNEL P1000

* LENGTH AS REQUIRED ** ANY PENETRATION TO

ON VERTICAL GIRT

TYPICAL CONDUIT SUPPORT

FOR NUMBER OF


CONDUITS


- P 1000 GALVANIZED STEEL CHANNEL BY

-CONDUITS TO UNISTRUT WITH PROPERLY

SIZED CONDUIT CLAMPS. TYP.

UNISTRUT MOUNT TO GIRTS WITH TEK SCREWS. SPACE HORIZONTALLY ON WALL 10'-0" OC

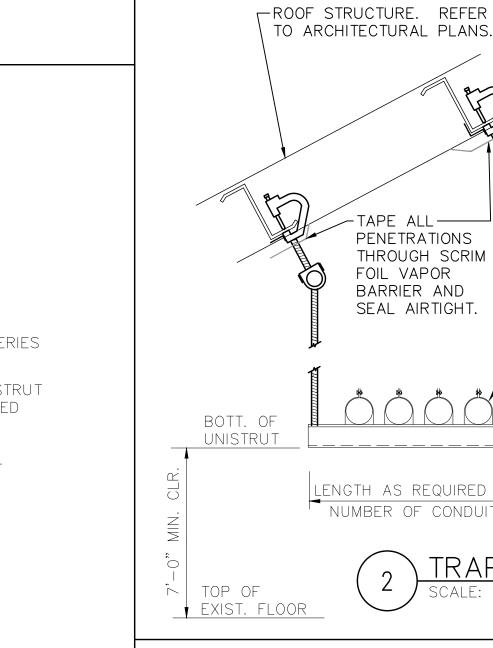

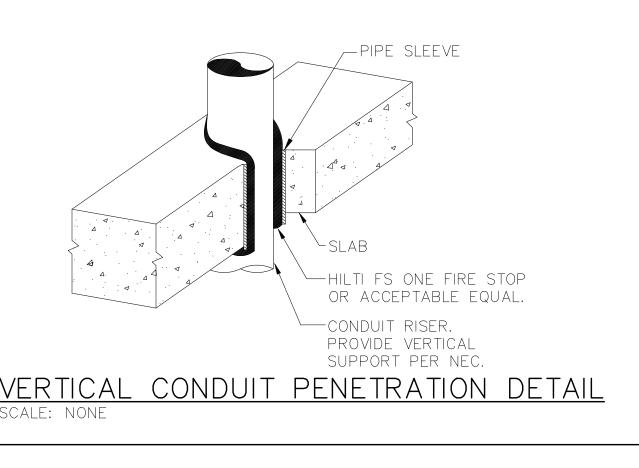


-SWIVEL ATTACHMENT AS MANUFACTURED BY UNISTRUT. -TAPE ALL---PENETRATIONS THROUGH SCRIM FOIL VAPOR BARRIER AND SEAL AIRTIGHT. -CONDUITS SUPPORTED ON TOP OF UNISTRUT, CONNECT WITH PROPERLY SIZED CONDUIT CLAMPS, TYP. -3/8"ø THREADED STEEL ROD, -GALV. P1000 UNISTRUT MEMBER LENGTH AS REQUIRED FOR OR APPROVED EQUAL SPACED NUMBER OF CONDUITS 10'-0" O.C. MAX. TRAPEZE SUPPORT DETAIL ▼ EXIST. FLOOR

LEGEND:

- (1) 4-#12 AWG. START CIRCUIT FROM AUTOMATIC TRÄNSFER SWITCH TO GENERATOR CONTROL
- (2) TWISTED SHIELDED PAIR BELDEN #9841. COMMUNICATIONS CIRCUIT FROM GENERATOR CONTROL PANEL TO REMOTE ANNUNCIATOR.
- (3) 2-#12 AWG. POWER FROM GENERATOR SET BATTERY TO REMOTE ANNUNCIATOR.
- 4 POWER CONDUIT FOR BRANCH CIRCUITS TO GENERATOR SET. SEE CIRCUIT INFORMATION FOR ITEM 5 BELOW.
- (5) (1) DEDICATED 20A CKT FROM LOAD CENTER 'LP1'

NOTES:

- 1. WIRING ON THIS DETAIL SHOWN FOR INFORMATIONAL PURPOSES ONLY. COORDINATE EXACT SIZE, QUANTITY AND TYPE OF WIRING WITH MANUFACTURER'S SUGGESTION FOR EQUIPMENT PURCHASED.
- 2. CONDUITS SHALL BE 1" U.O.N.
- 3. SEE ONE-LINE DIAGRAM FOR POWER OUTPUT FEEDERS INFORMATION.
- 4. SEE DWG E3.1 FOR EQUIPMENT LOCATIONS.

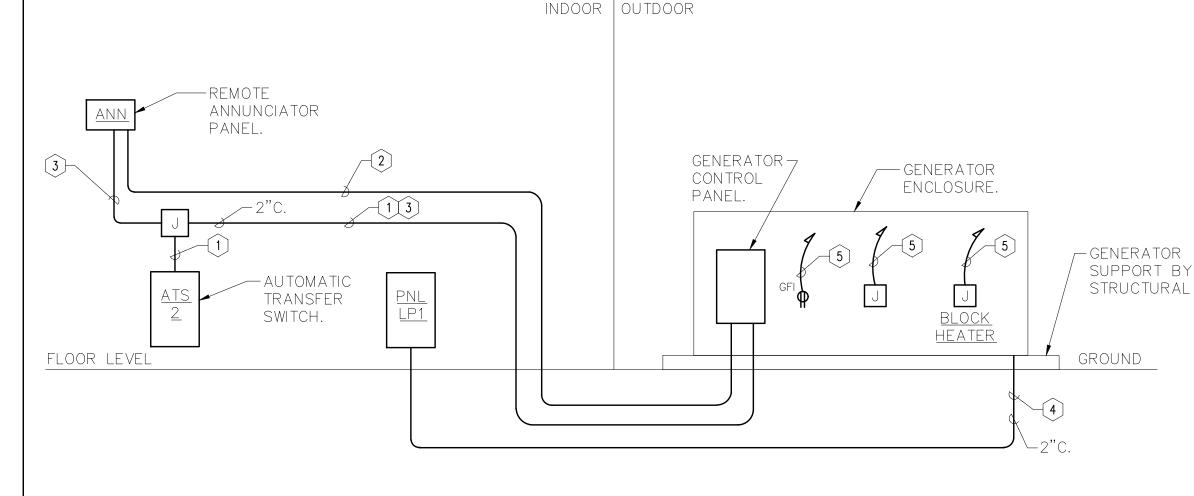

TRENCHING DETAIL FOR CONDUIT - 600V OR LESS


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Fax 845-353-1614

→3" ←

MIN. 6" MIN.→

RCM Technologies USA, Inc. Consulting Engineers 99 Bauer Drive Suite 101 Oakland, NJ 07436 TEL:(201) 249-8700 EMAIL:bruce.goldman@rcmt.com

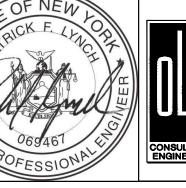

1. DETAIL SHOWN FOR INFORMATION PURPOSES. SAME CONCEPT

2. SAND MAY BE OMITTED FOR INSTALLATIONS WHERE COVER

SHALL ALSO APPLY FOR SINGLE CONDUITS.

REQUIREMENTS ARE 6" OR LESS.

MINIMUM COVER REQUIREMENT TABLE

LOCATION

ALL LOCATION NOT SPECIFIED

N TRENCH BELOW 2-IN. THICK

JNDER MINIMUM OF 4-IN. THICK

CONCRETE EXTERIOR SLAB WITH

NO VEHICULAR TRAFFIC AND THE

SLAB EXTENDING NOT LESS THAN

JNDER STREETS, HIGHWAYS,

5 IN. BEYOND THE UNDERGROUND

ROADS, ALLEYS, DRIVEWAYS, AND

CONCRETE OR EQUIVALENT.

NSTALLATION.

PARKING LOTS.

NOTES:

NONMETALLIC RACEWAYS LISTED

12"

SEE NOTE #2.

24"

FOR DIRECT BURIAL WITHOUT

OTHER APPROVED RACEWAYS

CONCRETE ENCASEMENT OR

OLA Consulting Engineers 50 Broadway, Hawthorne, New York 10532 914.747.2800 8 West 38th Street, New York, NY 10018 646.849.4110 olace.com OLA P/N: NDCA0012

DATE

NUMBER

GENERATOR CONTROL WIRING RISER DIAGRAM (ADD-ALTERNATE No. 1)

RECORD DRAWING CERTIFICATION AS BUILT — CHANGES AS NOTED AS BUILT - NO CHANGES CONTRACTOR PROJECT COORDINATOR NAME SIGNATURE SIGNATURE TITLE _____ DATE _____ DATE MADE APP'C

REVISION

DEPARTMENT OF PUBLIC WORKS AND TRANSPORTATION DIVISION OF ENGINEERING NEW EQUIPMENT STORAGE BUILDING

E - 70117-521 SHEET NO. 52 OF 53 SCALE: AS SHOWN DATE: 11/16/2021 DPW FILE NO. 38-47-E-734-0 O

CONTRAC NUMBER

SHEET NUMBER

WESTCHESTER COUNTY, NEW YORK

RICHARD A. FLYNN, SR. FIRE TRAINING CENTER VALHALLA CAMPUS, VALHALLA, NEW YORK

ELECTRICAL DETAILS

