
	SYMBOL &	: ABBRE	VIATIONS	GENERAL NOTES
		ABBREVIATION		
	J INIDUL			1. CONTRACT DRAWINGS, AS FAR AS THEY RELATE TO THE GENERAL ARRANGEMENT AN LOCATION OF EQUIPMENT, SHEET METAL, AND PIPING, SHALL BE UNDERSTOOD A
		AFF	ABOVE FINISHED FLOOR	DIAGRAMMATIC. ANY CHANGES TO EQUIPMENT, SHEET METAL, AND PIPING LOCATION NECESSARY TO AVOID INTERFERENCE WITH OTHER TRADES SHALL BE MADE AT N
		AP	ACCESS PANEL	EXTRA COST, AND MUST BE APPROVED BY THE ENGINEER.
	_	BDD	BACKDRAFT DAMPER	2. THE MECHANICAL CONTRACTOR SHALL INSTALL FIRE DAMPERS WITH ACCESS DOORS ALL DUCTS PENETRATING FIRE RATED WALLS, WHETHER SPECIFICALLY SHOWN ON TH
	_	BHP	BRAKE HORSEPOWER	DRAWINGS OR NOT.
	_	BTU	BRITISH THERMAL UNIT	3. ALL MOTOR STARTERS AND DISCONNECT SWITCHES FOR HVAC EQUIPMENT SHALL EFFORM FURNISHED BY THE MECHANICAL CONTRACTOR AND INSTALLED BY THE ELECTRICATION OF THE PROPERTY OF THE
	_	CFM	CUBIC FEET PER MINUTE	CONTRACTOR, UNLESS OTHERWISE NOTED. DISCONNECT SWITCHES FURNISHED BY THE MECHANICAL CONTRACTOR FOR HVAC EQUIPMENT SHALL BE HEAVY DUTY TYPE.
	_	Ę.	CENTERLINE	
	_	DB	DRY BULB TEMPERATURE	4. DUCT DIMENSIONS SHOWN ON MECHANICAL DRAWINGS REFER TO INSIDE CLEAR DUC DIMENSIONS. WHERE DUCTWORK IS LINED, THE MECHANICAL CONTRACTOR SHAI
		DIA. OR Ø		INCREASE THE SIZE OF DUCT TO COMPENSATE FOR LINING.
	_	DX	DIRECT EXPANSION	5. LOCATE THERMOSTATS, TEMPERATURE SENSORS, AND CO DETECTORS 5'-6" ABOVE FINISHED FLOOR UNLESS OTHERWISE NOTED. COORDINATE LOCATION WITH FURNITURE
	_	EA	EXHAUST AIR	CABINETS, ETC. FURNISH LOCKING TAMPERPROOF COVER FOR ALL NEW THERMOSTATION IN PUBLIC AREAS.
	_	EAT	ENTERING AIR TEMPERATURE	AND DETAILS GIVEN IN THESE PLANS FOR PIPE HANGERS AND SUPPORTS, ALL HANGEF AND SUPPORTS SHALL BE DESIGNED AND INSTALLED IN COMPLIANCE WITH APPLICABLES
		EF-	EXHAUST FAN	SEISMIC CODES.
		EL	ELEVATION	7. THE CONTRACTORS SHALL SUBMIT FOR REVIEW AND APPROVAL A COMPOSITE SHOOD DRAWING, FULLY COORDINATED WITH ALL OTHER TRADES INDICATING ALL DUCTWOR
		ER	EXHAUST REGISTER	MECHANICAL EQUIPMENT, PIPING, ELECTRICAL EQUIPMENT, PLUMBING PIPING AN EQUIPMENT, LIGHTS, CONDUITS, DIFFUSERS, GRILLES AND FIRE ALARM DEVICES.
		ESP	EXTERNAL STATIC PRESSURE	
		EWT	ENTERING WATER TEMPERATURE	8. ALL WORK SHALL COMPLY WITH STATE BUILDING CODE, LOCAL BUILDING CODE, AND ENERGY CODE REQUIREMENTS. IN CASE OF CONFLICT BETWEEN THE CONTRACT OF AND ADDITIONAL CONFERMINATION OF THE MORE STRINGS OF ADDITIONAL CONFERMINATION OF THE MORE STRINGS OF
	_	FPM	FEET PER MINUTE	DOCUMENTS AND A GOVERNING CODE OR ORDINANCE, THE MORE STRINGENT STANDAI SHALL APPLY.
	_	FPS	FEET PER SECOND	9. DURING CONSTRUCTION, ALL OPEN OR INCOMPLETE DUCTWORK SHALL BE CAPP
	_	GPM	GALLONS PER MINUTE	AIRTIGHT WITH WITH HEAVY POLYETHYLENE PLASTIC. AFTER THE INSTALLATION ODUCTWORK, REGISTERS, GRILLES, AND DIFFUSERS, THE CONTRACTOR SHALL BLANK O
	_	HP	HORSE POWER	ALL REGISTERS, GRILLES, AND DIFFUSERS WITH HEAVY POLYETHYLENE PLASTIC A TAPE AIR TIGHT, IN AREAS THAT ARE UNDER CONSTRUCTION, UNTIL WORK IS COMPLE
	_	HV-	HEATING AND VENTILATING UNIT	IN THOSE AREAS. FLOOR REGISTERS AND GRILLES SHALL ALSO BE COVERED WITH 1/
		LAT	LEAVING AIR TEMPERATURE	10. WHEN GENERAL CONSTRUCTION IS COMPLETE, VACUUM CLEAN ALL DIFFUSEI REGISTERS, GRILLES, AND HVAC EQUIPMENT IN THE PROJECT AREA OR SERVING TO THE PROJECT A
		LF	LINEAR FEET	PROJECT AREA. REMOVE ANY CONSTRUCTION DEBRIS. REPLACE ALL AIR FILTERS W NEW.
	_	LWT	LEAVING WATER TEMPERATURE	11. THE OWNER'S PERMANENT HVAC EQUIPMENT SHALL NOT BE USED BY ANY CONTRACT
	_	MBH	1000 BRITISH THERMAL UNITS PER HOUR	DURING CONSTRUCTION FOR TEMPORARY HEATING, COOLING, OR VENTILATION. TEMPORARY HEATING, COOLING, OR VENTILATION IS REQUIRED AT ANY POINT DUR
	_	OAI	OUTSIDE AIR INTAKE	CONSTRUCTION, THE CONTRACTOR SHALL PROVIDE TEMPORARY HEATING, COOLING, VENTILATION EQUIPMENT, DUCTWORK, CONTROLS, AND POWER AT HIS OWN EXPENSE.
	_	PSI	POUNDS PER SQUARE INCH	12. THE CONTRACTOR SHALL BE RESPONSIBLE FOR PROVIDING TEMPORARY VENTILATION A
	_	RA	RETURN AIR	EXHAUST AIR WHEN WELDING OR SOLDERING OPERATIONS ARE PERFORMED, AS REQUIR BY OSHA.
	_	RPM	REVOLUTIONS PER MINUTE	13. THE MECHANICAL CONTRACTOR SHALL BE RESPONSIBLE FOR OBTAINING AND PAYI
	_	SA	SUPPLY AIR	FOR ALL NECESSARY PERMITS AND FOR PAYING RELATED FEES.
	_	SP	STATIC PRESSURE	14. THE MECHANICAL CONTRACTOR SHALL PROVIDE ALL CUTTING, PATCHING, CORE DRILLING
	_	TSP	TOTAL STATIC PRESSURE	ACCESS PANELS, PAINTING, AND FINAL RESTORATION REQUIRED TO FACILITATE TINSTALLATION OF HVAC DUCTWORK, CONTROL CONDUITS, AND PIPING, INCLUDING ABOUT THE PROPERTY OF THE PROPER
		TYP.	TYPICAL	CEILINGS AND IN SHAFTS THAT WILL NOT BE REPLACED OR OPENED UNDER ANY OTH SCOPE OF WORK RELATED TO THIS PROJECT. CONTRACTOR TO REMOVE AND REPLA
		U.O.N.	UNLESS OTHERWISE NOTED	CEILINGS, AND OPEN AND PATCH SHAFTS AND WALLS, AS REQUIRED TO EXECUTE TO MECHANICAL WORK.
	_	UH-	UNIT HEATER	
		WG	INCHES OF WATER GAUGE	
		WMS	WIRE MESH SCREEN	
	_	WG	INCHES OF WATER GAUGE	
		NEW	NEW WORK	
	T	_	THERMOSTAT	
	M	_	MOTORIZED DAMPER	
	CO(NO2)	_	COMBINATION CO & NO2 SENSOR	
	→	_	AIR INTO REGISTER	
	•	_	POINT OF CONNECTION DISCONNECTION	
		_	SUPPLY DUCT UP	
		_		
		_	SUPPLY DUCT LIP	
		_	RETURN DUCT UP	
		_	RETURN DUCT DOWN	
		VD	VOLUME DAMPER	
	6x8	_	DUCT SIZE — 1ST FIGURE IS SIDE SHOWN	
		FC	FLEXIBLE CONNECTION	
	SECT#		SECTION CALLOUT	
			DECORD DRAWING CERTIFICATION	I CONITDACT CLIFF
	_		RECORD DRAWING CERTIFICATION	WESTCHESTER COUNTY, NEW YORK CONTRACT SHEET
OLA Consulting Engineers		<u> </u>	C DILLT OLIVEIO AC MOTES	
RCM Technologies USA, Inc. Consulting Engineers OLA Consulting Engineers 50 Broadway, Hawthorne, New York 10532			S BUILT — CHANGES AS NOTED S BUILT — NO CHANGES	DELIMINATION
RCM Technologies USA, Inc. Consulting Engineers 99 Bauer Drive OLA Consulting Engineers 50 Broadway, Hawthorne, New York 10532 914,747,2800			S BUILT - NO CHANGES CONTRACTOR PROJECT COORDINATOR	DIVISION OF ENGINEERING SHEET NO. 37 OF
RCM Technologies USA, Inc. Consulting Engineers 99 Bauer Drive OLA Consulting Engineers 50 Broadway, Hawthorne, New York 10532 914.747.2800			S BUILT — NO CHANGES CONTRACTOR PROJECT COORDINATOR NAME	DEFAITMENT OF FODLIC WORKS AND INAMSFORTATION MILE

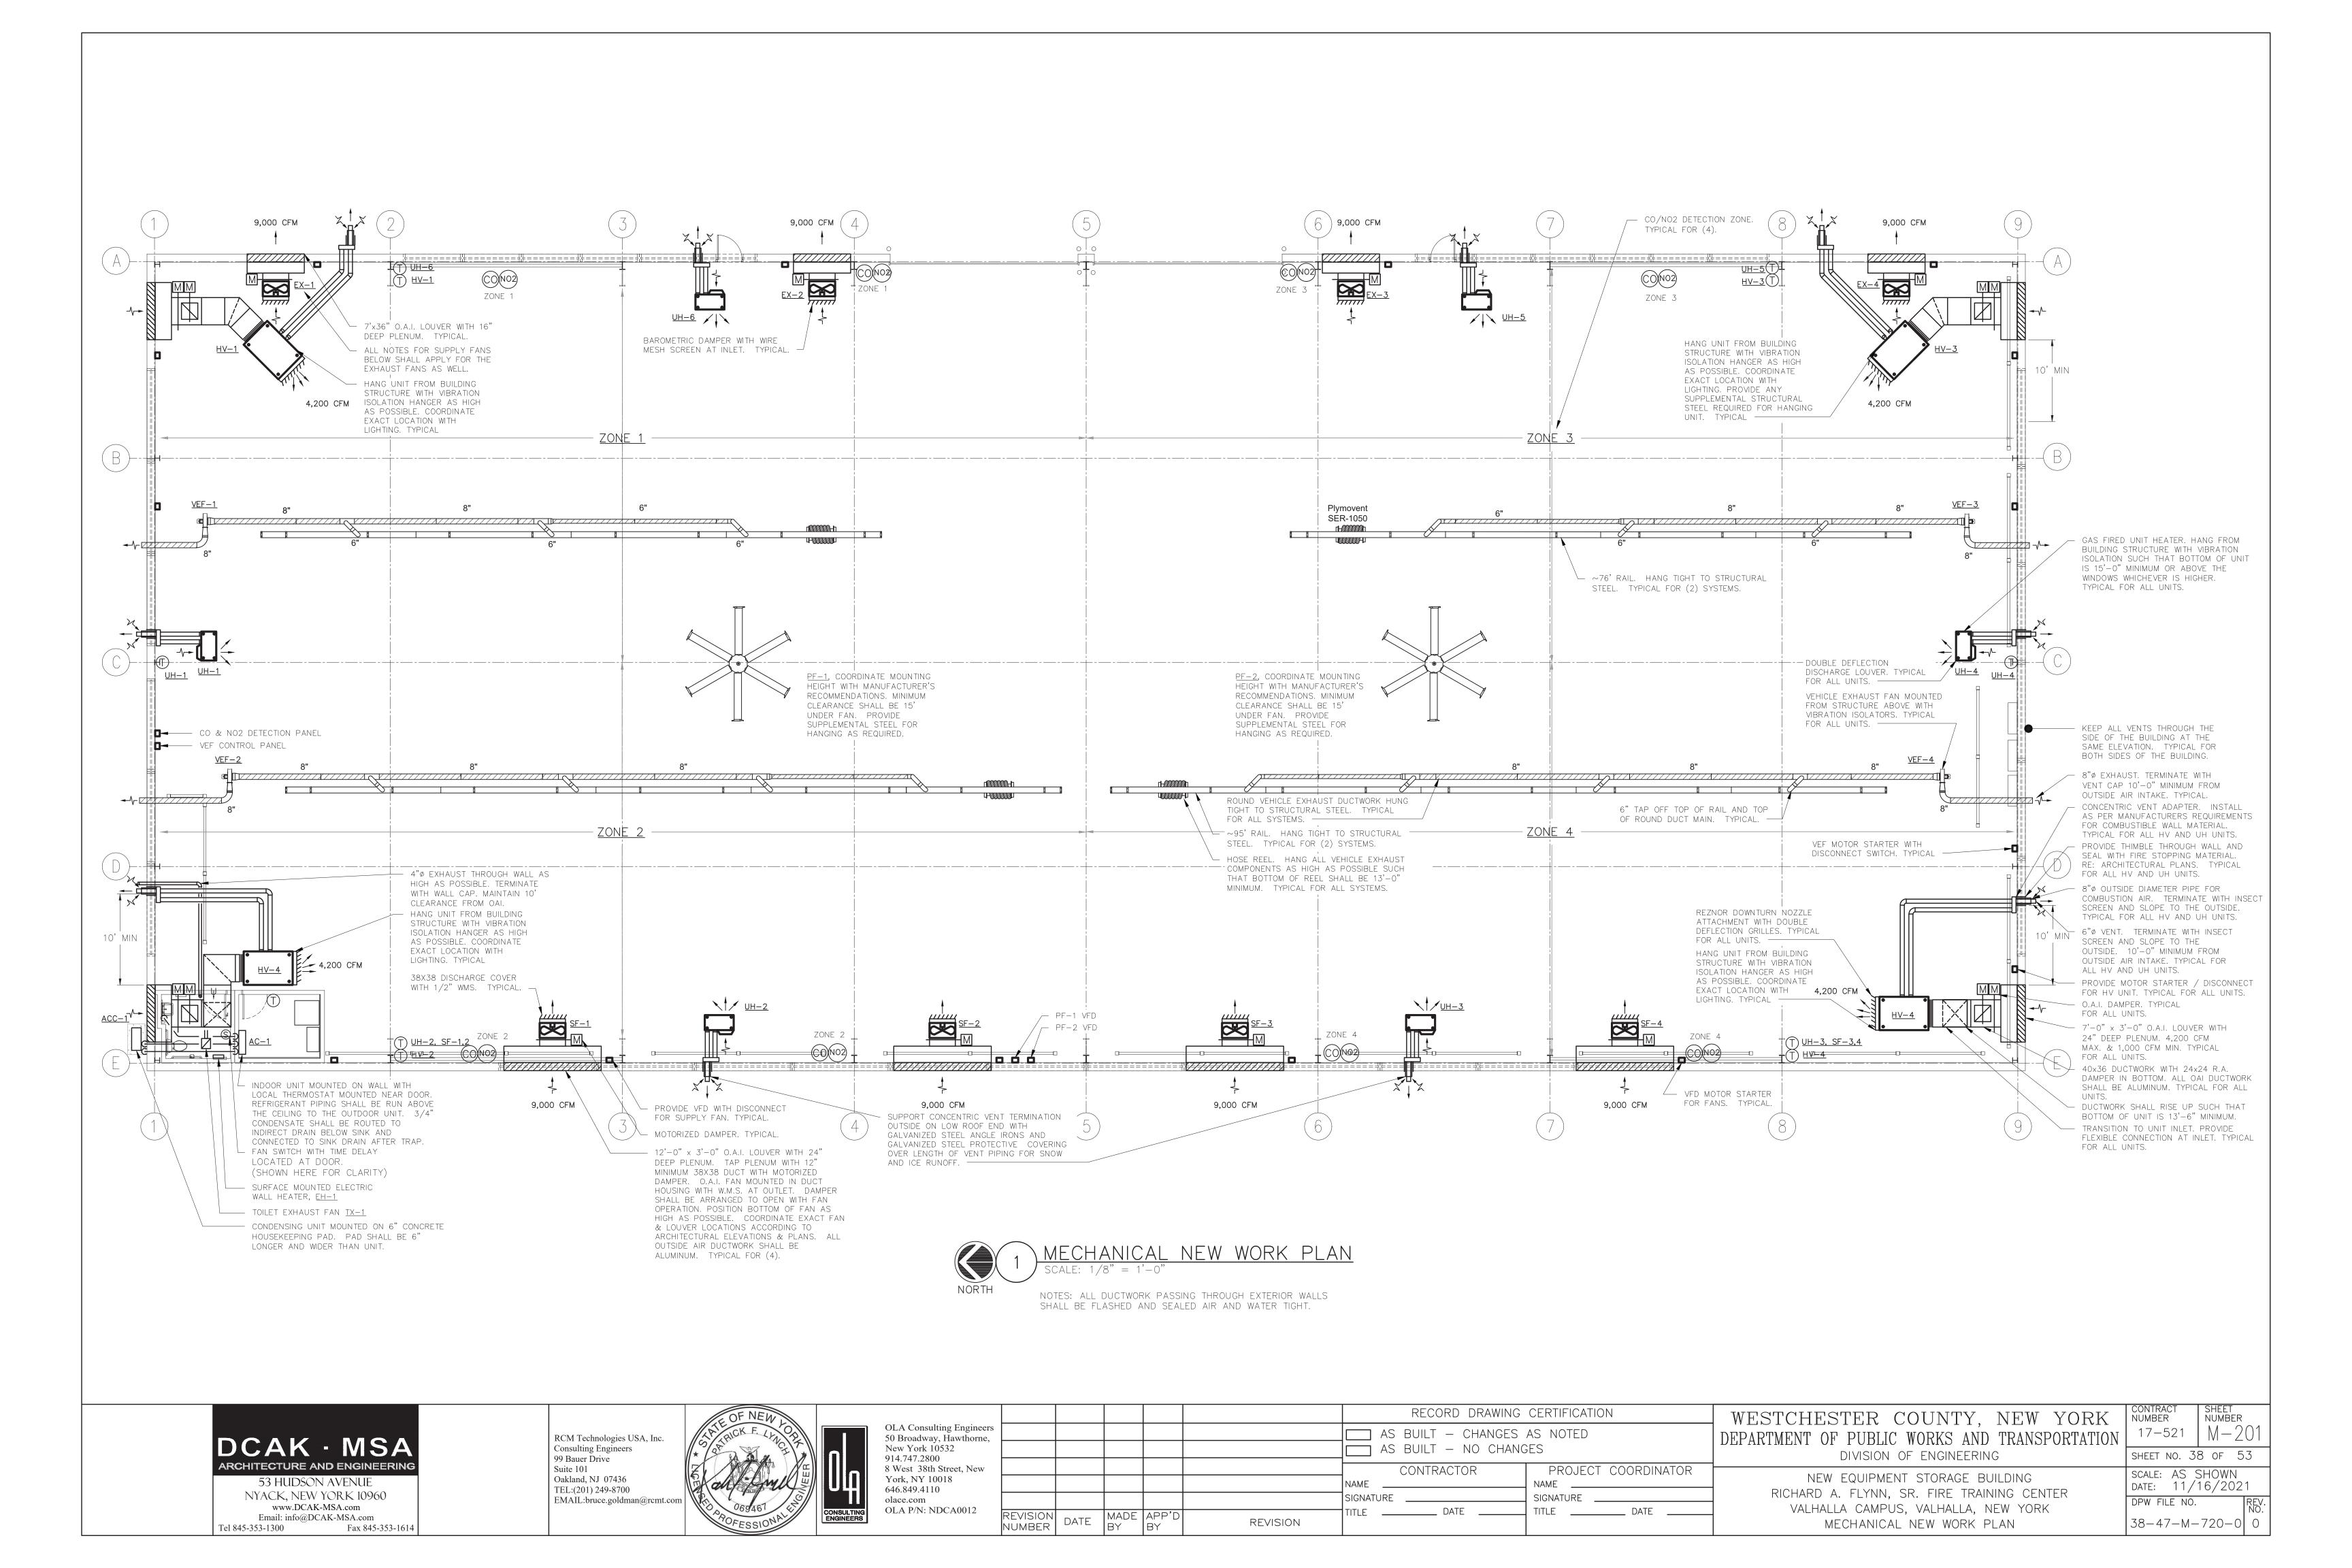

FAN SCHEDULE					
DESIGNATION	EX-1,2,3,4 SF-1,2,3,4	TX-1	PF-1,2		
MANUFACTURER	GREENHECK	GREENHECK	BIG ASS SOLUTIONS		
10DEL	SBE-3H30	SP-A90	BASIC 6		
WEIGHT (LBS)	112	12	231		
AN TYPE	PROPELLER	CEILING MOUNTED	CEILING FAN		
RIVE TYPE	BELT	DIRECT	DIRECT		
CFM	9,000	75	66		
BHP	1.14	_	_		
IP .	1.5	16 WATTS	1.5		
RPM	965	900	61		
SP (IN H ₂ O)	0.25	.25	0.5		
OLTS/ø/Hz	480/3/60	120/1/60	480/3/60		
STARTER TYPE	VFD	TIME DELAY SWITCH	VFD		

- 1. ALL MOTORS 1 HP OR GREATER SHALL BE PREMIUM EFFICIENCY.
- 2. ALL MOTORS FURNISHED WITH VARIABLE FREQUENCY DRIVES SHALL BE INVERTER DUTY RATED & APPROVED FOR VARIABLE SPEED AND TORQUE APPLICATIONS.
- 3. FURNISH RUBBER IN SHEAR OR SPRING VIBRATION ISOLATORS AS PER THE SPECIFICATION.
- 4. FURNISH WALL MOUNTED SPEED CONTROLLER OR THERMOSTAT AS INDICATED ON PLAN.
- 5. FURNISH MOTOR AND BELT GUARDS FOR ALL EXTERNAL MOTOR DRIVES. 6. MOTOR STARTER AND DISCONNECT SWITCH FOR EACH FAN SHALL BE FURNISHED BY THE MECHANICAL CONTRACTOR AND INSTALLED BY THE ELECTRICAL CONTRACTOR.
- 7. MANUAL MOTOR STARTERS FOR FANS SHALL BE SQUARE D, TYPE T OR M, WITH PUSH-BUTTON START/STOP, PILOT LIGHT, & AUXILIARY CONTACTS, SUITABLE FOR SURFACE MOUNTING.
- 8. TX-1: PROVIDE MODEL WC-4 HOODED WALL CAP WITH BUILT IN BIRDSCREEN & BAROMETRIC BACKDRAFT DAMPER WHERE INDICATED ON PLAN.
- 9. PROVIDE BAROMETRIC DAMPER WITH WIRE MESH SCREEN AT INLET FOR EXHAUST FANS AND OUTLET FOR SUPPLY FANS.
- 10. CONTROLS SHALL BE COMPATIBLE WITH THE BUILDING ANDOVER SYSTEM & NETWORKED INTO THE COUNTY WIDE ANDOVER SYSTEM. COORDINATE WITH CONTROLS CONTRACTOR.

HEATING & VENTILATION UNIT SCHEDULE

DESIGNATION	HV-1	HV-2,3,4
MANUFACTURER	REZNOR	REZNOR
MODEL	SDH-300	SDH-300
WEIGHT OF UNIT (LBS)	629	629
DESIGN DATA:		
SUPPLY AIR (CFM)	4,200	4,200
OUTDOOR AIR MINIMUM (CFM)	1,100	0
OUTDOOR AIR MAXIMUM (CFM)	4,200	4,200
RETURN AIR MINIMUM (CFM)	0	0
RETURN AIR MAXIMUM (CFM)	3,100	4,200
SUMMER OA TEMP (°F) DB/WB	86/72	86/72
SUMMER RA TEMP (°F) DB/WB	80	80
WINTER OA TEMP (°F)	10	10
WINTER RA TEMP (°F)	60	60
GAS-FIRED FURNACE:		
E.A.T./L.A.T. (°F)	10/63	10/63
GAS INPUT/OUTPUT (MBH)	300/243	300/243
CONTROL STAGES	8	8
FILTERS:		
MAIN FILTER	MERV 8	MERV 8
QUANTITY/SIZE	3 / 16x16 3 / 16x20	3 / 16x16 3 / 16x20
SUPPLY FAN:		
DESIGN AIRFLOW (CFM)	4,200	4,200
BHP/HP	2.0/3.0	2.0/3.0
RPM	991	991
ESP/TSP (IN H₂O)	-/0.75	-/0.75
VOLTS/ø/Hz	460/3/60	460/3/60
STARTER TYPE	НОА	HOA
ELECTRICAL DATA — SINGLE POINT F	POWER CONNECTION:	
VOLTS/ø/Hz	460/3/60	460/3/60
FLA/MCA (AMPS)	7.6/9.5	7.6/9.5

NOTES:

STANDARD COMPONENTS:

- 1. 81% EFFICIENCY SEPARATED COMBUSTION SYSTEM.
- 2. CIRCUIT BREAKER PROTECTED TRANSFORMER FOR 24V CONTROLS. 3. INTEGRATED CIRCUIT BOARD WITH DIAGNOSTIC INDICATOR LIGHTS
- 4. MULTI-TRY DIRECT SPARK IGNITION WITH 100% LOCKOUT
- 5. HIGH TEMP LIMIT CONTROL
- 6. RUBBER-IN-SHEER VIBRATION ISOLATION
- REVERSE AIRFLOW LIMIT SWITCH
- AIRFLOW PRESSURE SWITCH TO VERIFY CIRCULATING BLOWER OPERATION 9. SOCKETED. HIGH QUALITY SWITCHING RELAYS TO FACILITATE SERVICE
- 10. ALL SERVICE AND VENT CONNECTIONS FROM A SINGLE SIDE 11. ENGINEERED HEAT EXCHANGER CONDENSATE MANAGEMENT

- REQUIRED OPTIONS: 1. HORIZONTAL CONCENTRIC ADAPTER BOX (CC6)
- 2. 409 STAINLESS STEEL HEAT EXCHANGERS WITH EXTENDED 10 YEAR WARRANTY 3. BURNER CONTROLS WITH 4:1 GAS MODULATION

- 4. UNIT MOUNTED LOCAL DISCONNECT SWITCH FURNISHED BY THE MECHANICAL CONTRACTOR AND INSTALLED BY THE ELECTRICAL CONTRACTOR. 5. FIRESTAT
- 6. DISCHARGE AIR TEMPERATURE LOW LIMIT
- 7. OVER / UNDER VOLTAGE OR PHASE LOSS PROTECTION
- 8. HIGH AMBIENT LIMIT (BURNER CUTOFF)
- 9. GAS PRESSURE SWITCHES.

CONTROLS CONTRACTOR.

- 10. DOWNTURN NOZZLES STYLE CD 25-65° WITH DOUBLE DIRECTIONAL LOUVERS. 11. CONTROL OPTION AG58 - EXTERNAL CONTROLS WITH 8:1 GAS MODULATION. CONTROLS SHALL BE COMPATIBLE WITH THE BUILDING ANDOVER SYSTEM & NETWORKED INTO THE COUNTY WIDE ANDOVER SYSTEM. COORDINATE WITH
- 12. BACNET DDC COMMUNICATION CARD.

EQUIPMENT NOTES

- MOTORIZED DAMPERS: SHALL BE RUSKIN MODEL CD40, 4" DEEP EXTRUDED ALUMINUM AIRFOIL DAMPER. DAMPER SHALL HAVE OPPOSED BLADES, MOTOR AND LINKAGE. DAMPERS SHALL BE 120V/16/60Hz, 3 AMPS MAX. FURNISH DISCONNECT SWITCH.
- 2. <u>LISTED SPECIAL GAS VENTING:</u> FOR ALL GAS FIRED DIRECT VENTING CONDENSING & NON-CONDENSING APPLIANCES SHALL BE HEATFAB "SAF-T VENT CI PLUS". DOUBLE WALL CONSTRUCTION, 1" FIBERGLASS INSULATION, AL-29-4C STAINLESS STEEL. SPECIAL VENT UL 1738 FOR POSITIVE, NEUTRAL, AND NEGATIVE DRAFT UP TO 15"WC. PRODUCT IS RATED FOR ZERO CLEARANCE TO COMBUSTIBLES. PROVIDE STRAIGHT SECTIONS, ELBOWS, OFFSETS, CONNECTION ADAPTERS, WALL SLEEVES, AND SCREENED TERMINATIONS.
- 3. OUTSIDE AIR INTAKE: FOR ALL GAS FIRED DIRECT VENTING CONDENSING & NON-CONDENSING APPLIANCES SHALL BE SINGLE-WALL SPIRAL GALVANIZED STEEL BY SHEET METAL CONNECTORS, INC. ALL DUCTWORK IS 4-PLY SPIRAL LOCKSEAM MEETING ASTM A-653. ALL DUCT CONNECTIONS SHALL BE MADE WITH A DOUBLE LEGGED EPDM GASKET CREATING AN AIR-TIGHT CONNECTION MEETING ASTM A-653. SINGLE-WALL DUCT GUAGE SHALL BE SELECTED FOR POSITIVE, NEUTRAL, AND NEGATIVE DRAFT UP TO 15"WC WITH A MINIMUM GAUGE OF 24. PRODUCT IS RATED FOR ZERO CLEARANCE TO COMBUSTIBLES. PROVIDE STRAIGHT SECTIONS, ELBOWS, OFFSETS, CONNECTION ADAPTERS, WALL SLEEVES, AND SCREENED TERMINATIONS.
- 4. GAS-FIRED UNIT HEATERS (UH-1,2,3,4,5,6): SHALL BE MODINE MODEL PTS250, 250 MBH INPUT. 205 MBH OUTPUT. UNITS SHALL BE DIRECT-VENT SEPARATED COMBUSTION TYPE WITH 6"Ø FLUE OUTLET, 6"Ø AIR INLET, AND 3/4"Ø EXTERNAL GAS CONNECTION. FAN SHALL BE 1/3 HP, 1075 RPM. ELECTRICAL REQUIREMENTS: 120V/1¢/60HZ, 4.6 FAN AMPS (FAN ONLY), 8.1 TOTAL AMPS (UNIT TOTAL). PROVIDE STARTER/LOCAL DISCONNECT, AND 10 YEAR WARRANTY ON HEAT EXCHANGER. FURNISH WITH SINGLE-STAGE, DIRECT SPARK IGNITION CONTROLS, WITH 100% SHUT-OFF AND CONTINUOUS RETRY. PROVIDE HORIZONTAL CONCENTRIC VENT KIT WITH EACH UNIT.
- 5. ELECTRIC WALL HEATER (EH-1): SHALL BE MARKEL MODEL F 3453 T SURFACE MOUNTED, 3,000 WATTS INPUT, 208/1/60, 14.4 AMPS, 10,239 BTUS. ROUGH IN DIMENSIONS 23"Hx15"Wx4.125"D UNITS CORROSION RESISTANT STEEL ELEMENT, BRAZED STEEL FINS. COORDINATE COLOR WITH ARCHITECT. FURNISH AND INSTALL THE FOLLOWING FIELD-INSTALLED OPTIONS: THERMOSTAT & DISCONNECT SWITCH.
- 6. CO & NO, DETECTION SYSTEM: SHALL BE SIERRA MONITOR CORPORATION. PROVIDE SENTRY 5000-IT CONTROLLER (SEE PLANS FOR LOCATION). PROVIDE ALL COMPONENTS AND WIRING FOR A COMPLETE INSTALLATION AND OPERABLE SYSTEM. ALL SPACE TRANSMITTERS SHALL BE MOUNTED 5'-0" AFF IN A PROTECTED LOCATION. PROVIDE EXTERNAL BATTERY BACKUP. PROVIDE SIGNAGE "CO & NO2 DETECTION" ON CONTROL
 - CO TRANSMITTERS SHALL BE 5100-04-IT-S1-01-00-0-0-C • NO₂ TRANSMITTERS SHALL BE 5100-12-IT-S1-01-00-0-C
- 7. VEHICLE EXHAUST SYSTEM (VEF-1, VEF-2, VEF-3, VEF-4): SHALL BE BASED ON PLYMOVENT. EACH SYSTEM SHALL CONSIST OF (1) STATIONARY SPRING ACTUATED HOSE REELS #SER-1050 MOUNTED SUCH THAT BOTTOM OF HOSE REEL IS AT 13' AFF. EACH HOSE REEL SHALL HAVE 33'L 6"\$\phi\$ HOSE #SNF-2 CAPABLE OF 600°F CONTINUOUS & 1250°F INTERMITTENT VEHICLE EXHAUST. 400°F TEMPERATURE RESISTANCE ON ALL COMPONENTS. PROVIDE TAILPIPE ADAPTERS AS LISTED IN THE SPECIFICATIONS. EACH FAN SHALL BE FUA-3000 2HP RATED FOR 720 CFM AT 8"WC SP, 460/3/60, 80LBS. PROVIDE PLYMOVENT ES-90 CONTROL BOX EACH FAN. PROVIDE AN NTX NEMA 4X WALL MOUNT TRANSMITTER FOR EACH SYSTEM WITH 433 MHz RCR24SS RECEIVER MOUNTED TO EACH HOSE REEL. REFER TO VEHICLE EXHAUST SPECIFICATIONS SECTION 238416 FOR FULL EQUIPMENT REQUIREMENTS.
- 8. <u>VEHICLE EXHAUST DUCTWORK:</u> US DUCT CLAMPABLE DUCTING. GALVANIZED DUCT WITH WELDED ENDS, WELDED ANGLE RINGS, OR LOOSE ANGLE RINGS WITH LIPPED ENDS. REFER TO VEHICLE EXHAUST SPECIFICATIONS SECTION 238416 FOR FULL DUCTWORK REQUIREMENTS.

MINI SPLIT DX SYSTEMS **OUTDOOR AIR COOLED CONDENSING UNITS** INDOOR CEILING HIGH WALL MODEL# NOMINAL COOLING HEATING | ELECTRICAL | MCA | MOCP | WXHXD | WEIGHT | EFFICIENCY MODEL# AIRFLOW ELECTRICAL MCA WxHxD WEIGHT NOTES (Tons) | Capacity (BTUH) | Outside (F°) | Capacity (BTUH) | (V/Ph/Hz) | (A) | (A) | (in) | (lbs) | EER | SEER (Tons) (CFM) (V/Ph/Hz) (A) 5800-19000 13,800 208/1/60 | 15 20 | 33X14X27 | 108 | 13.5 | 32 40MPHAQ12XA3 168/252/306/357 208/1/60 35.2x11.7x9.8 38 0.3 1,2,3,4,5,6

NOTES:

- 1. EQUIPMENT SELECTION BASED ON CARRIER.
- 2. PROVIDE THE FOLLOWING OPTIONS FOR EACH UNIT: WIRED 7-DAY PROGRAMMABLE THERMOSTAT
- CONDENSATE PUMP
- 24V INTERFACE KIT
- 3. FIELD SUPPLIED LOCAL DISCONNECT SWITCH AT EACH INDOOR UNIT SHALL BE FURNISHED BY THE MECHANICAL CONTRACTOR & INSTALLED BY THE ELECTRICAL CONTRACTOR.
- 4. FIELD SUPPLIED WEATHER PROOF LOCAL DISCONNECT SWITCH AT EACH OUTDOOR UNIT SHALL BE FURNISHED BY THE MECHANICAL CONTRACTOR & INSTALLED BY THE ELECTRICAL CONTRACTOR.
- 5. SINGLE POINT EXTERNAL POWER CONNECTION FOR EACH INDOOR / OUTDOOR SET OF UNITS SHALL BE AT THE OUTDOOR UNIT. THE ELECTRICAL CONTRACTOR SHALL PROVIDE WIRING FROM THE OUTDOOR UNIT TO THE INDOOR UNIT.

6. THE AUTOMATIC TEMPERATURE CONTROLS CONTRACTOR SHALL PROVIDE CONTROL WIRING BETWEEN THE OUTDOOR UNIT AND THE INDOOR UNIT.



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OLA Consulting Engineers 50 Broadway, Hawthorne, New York 10532 914.747.2800 8 West 38th Street, New York, NY 10018 646.849.4110 OLA P/N: NDCA0012

					RECORD DRAWING CERTIFICATION	
					AS BUILT — CHANGES AS NOTED AS BUILT — NO CHANGES	
					CONTRACTOR PROJECT CO	
					IGNATURE SIGNATURE	DATE
EVISION	DATE	l	APP'D	REVISION	ITLE DATE TITLE	DATE

WESTCHESTER COUNTY, NEW YORK DEPARTMENT OF PUBLIC WORKS AND TRANSPORTATION DIVISION OF ENGINEERING

MECHANICAL SCHEDULES

SHEET NO. 39 OF 53 SCALE: AS SHOWN NEW EQUIPMENT STORAGE BUILDING DATE: 11/16/2021 RICHARD A. FLYNN, SR. FIRE TRAINING CENTER VALHALLA CAMPUS, VALHALLA, NEW YORK

DPW FILE NO. 38-47-M-721-0∣0

NUMBER

17-521

SHEET NUMBER

 $M - 60^{\circ}$



HANGER ROD SCHEDULE

HANGER DETAIL FOR EXPOSED

DUCT SIZE

UP TO 2 SQ. FT.

2 SQ FT TO 4 SQ FT

ROUND DUCTWORK

-ROOF STRUCTURE. REFER

THREADED ROD HANGER

CLIP BY RAM-SET OR

─BAR JOIST AND/

∖OR "I" BEAM

CLIP OR FASTENER ANGLE

EQUAL. POWER ACTUATED

FASTENER CONNECTED TO

STEEL BEAM OR Z-PERLINS.

TO ARCHITECTURAL PLANS. -







							RECORD DRAWING	CERTIFICATION
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012	REVISION NUMBER	DATE	MADE BY	APP'D BY	REVISION	TITLE	DATE	TITLE

HANGES AS NOTED PROJECT COORDINATOR SIGNATURE ____ TITLE _____ DATE

WESTCHESTER COUNTY, NEW YORK DEPARTMENT OF PUBLIC WORKS AND TRANSPORTATION DIVISION OF ENGINEERING NEW EQUIPMENT STORAGE BUILDING

M - 70117-521 SCALE: AS SHOWN DPW FILE NO.

<u>DUCT HANGER DETAIL</u>

THAT IS DISTURBED OR DAMAGED AS A RESULT OF HANGER INSTALLATION SHALL


- 2.) WHERE BUILDING STRUCTURAL COMPONENTS HAVE FIREPROOF MATERIAL, ANY AREA
- BE PATCHED WITH UL AND FM APPROVED FIREPROOFING TO MATCH EXISTING.

3.) ALL HANGER PENETRATIONS THROUGH VAPOR BARRIER SHALL BE TAPED AND

1.) FOR DUCTS OVER 49" WIDE, THE STRAP HANGER SHALL BE TURNED UNDER THE BOTTOM OF THE DUCT.

CHANNEL AS

MANUFACTURED BY

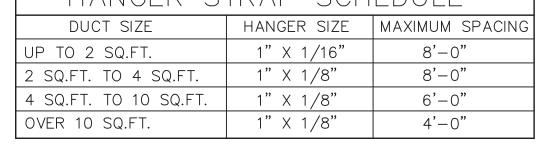

HANGER S	TRAP SCH	EDULE
DUCT SIZE	HANGER SIZE	MAXIMUM SPACING
UP TO 2 SQ.FT.	1" X 1/16"	8'-0"
2 SQ.FT. TO 4 SQ.FT.	1" X 1/8"	8'-0"
4 SQ.FT. TO 10 SQ.FT.	1" X 1/8"	6'-0"
OVER 10 SQ.FT.	1" X 1/8"	4'-0"

UNISTRUT.							
HANGER STRAP SCHEDULE							
DUCT SIZE	HANGER SIZE	MAXIMUM SPACING					
UP TO 2 SQ.FT.	1" X 1/16"	8'-0"					
2 SQ.FT. TO 4 SQ.FT.	1" X 1/8"	8'-0"					
4 SQ.FT. TO 10 SQ.FT.	1" X 1/8"	6'-0"					
OVER 10 SQ.FT.	1" X 1/8"	4'-0"					

FOIL VAPOR BARRIER AND SEAL AIRTIGHT. WEATHERPROOF <u>DUCT</u>

ROOF STRUCTURE. REFER TO ARCHITECTURAL PLANS. THREADED ROD HANGER CLIP OR FASTENER ANGLE	HANG UNITS FROM SOME WITH STRUCTURAL AND PROVIDE ANY SUPPLE REQUIRED TO HANG U
BAR JOIST AND CLIP BY RAM-SET OR EQUAL. POWER ACTUATED FASTENER CONNECTED TO	SPRING-TYPE VIBRAT AS PER SPECIFICATIO

-TAPE ALL----

PENETRATIONS

THROUGH SCRIM

SPRING OR RUBBER IN

SHEAR TYPE VIBRATION

SPECIFIED. HANG FROM

BUILDING STRUCTURE.

ELIMINATORS AS

T1/2" GALVANZIED

BACKGUARD--MOTORIZED

— ANGLE FRAME

-ADJUSTABLE PERIMETER

ANGLE FRAME 1"x1"x16

FOR FAN

GAUGE

DAMPER

NOTE: DETAILS ARE DIAGRAMMATIC. COORDINATE WITH ARCHITECTURAL DETAILS.

BELT DRIVE EXHAUST FAN DETAIL

STEEL BEAM OR Z-PERLINS.#

ACTUATED OR


WELDED STUD

WITH WASHER

TO STEEL

AND NUT.

WIRE MESH SCREEN

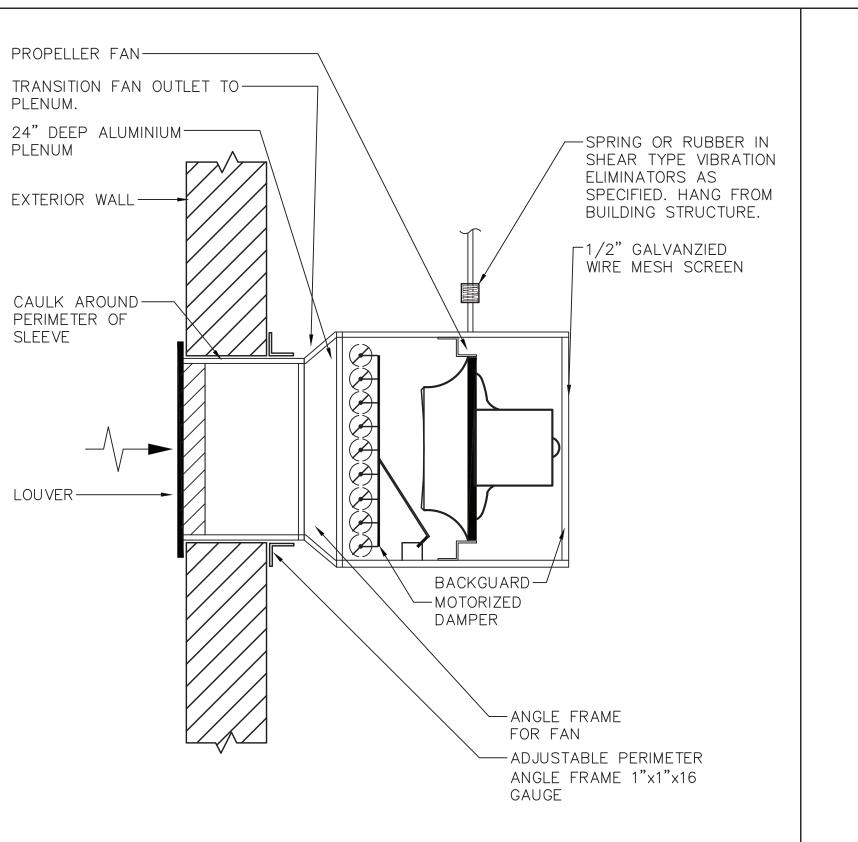

NOTE: DETAILS ARE DIAGRAMMATIC. COORDINATE WITH ARCHITECTURAL DETAILS.

ISOLATORS FROM BUILDING STRUCTURAL MEMBERS. 2.) SUSPEND UNIT HEATERS SECURELY WITH PROVISIONS FOR EASY REMOVAL AND REPAIR. COORDINATE EXACT LOCATIONS IN FIELD.

1.) HANG UNIT WITH THREADED RODS CONTAINING NEOPRENE TYPE VIBRATION

SEPARATED COMBUSTION 6"

MINIMUM OF 3' AWAY & ABOVE

VENT & 6" OUTDOOR AIR

INTAKE. VENT SHALL A

ANY BUILDING OPENINGS.

✓ MANUFACTURERS

REQUIREMENTS.

- OUT THROUGH EXTERIOR WALL.

SEAL WATERTIGHT. TERMINATE

WITH CONCENTRIC VENT PER

GAS PIPING & CONNECTIONS

BY PLUMBING CONTRACTOR.

3.) INSTALL UNITS SO THAT THEY HANG LEVEL AND PLUM.

4.) PROVIDE A ROOM THERMOSTAT ARRANGED TO TURN ON UNIT AND CYCLE THE FAN ON A CALL FOR HEAT,

5.) ALL HANGER PENETRATIONS THROUGH VAPOR BARRIER SHALL BE TAPED AND SEALED.



HANG UNIT WITH -


ISOLATORS AS PER

SPECIFICATIONS.

UNIT HEATER -

REMOTE WALL MOUNTED ROOM THERMOSTAT -

THREADED RODS WITH NEOPRENE VIBRATION

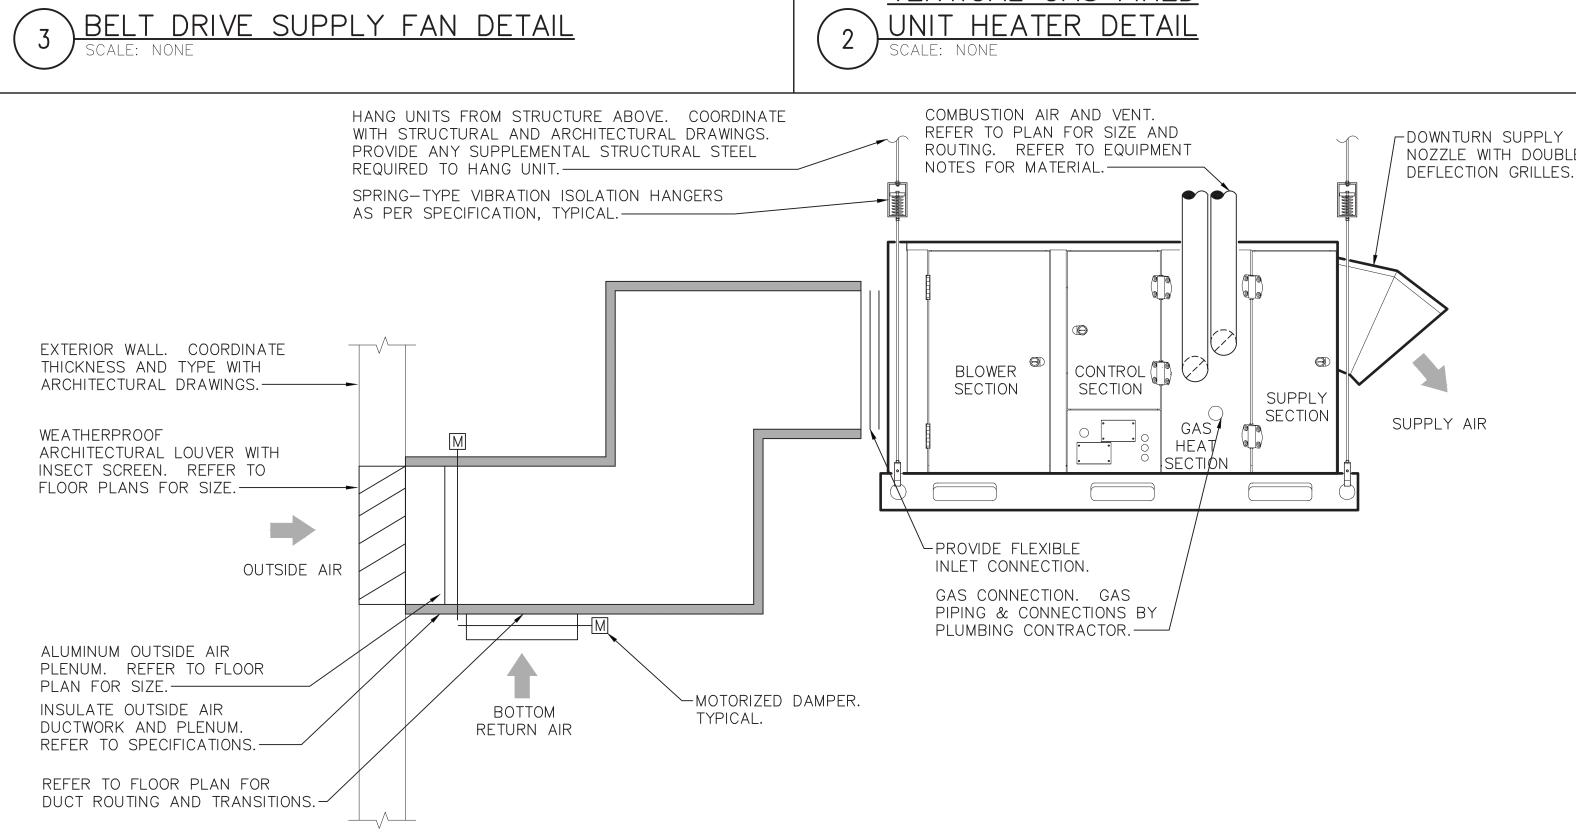

1.) MAINTAIN ALL MANUFACTURER CLEARANCE REQUIREMENTS - COORDINATE WITH ALL OTHER TRADES.

2.) HANG UNIT WITH THREADED RODS CONTAINING NEOPRENE OR SPRING TYPE VIBRATION ISOLATORS FROM BUILDING STRUCTURAL MEMBERS.

3.) INSTALL UNITS SO THAT THEY HANG LEVEL AND PLUM. 4.) ALL HANGER PENETRATIONS THROUGH VAPOR BARRIER SHALL BE TAPED AND SEALED.

INDOOR GAS FIRED HEATING AND VENTILATING UNIT SCHEMATIC



8'-0"

8'-0"

PENETRATIONS

FOIL VAPOR

- HANG DUCT FROM STRUCTURAL

TO THE SUPPORT MEMBER.

EXPOSED RIGID ROUND DUCT

HEX NUT WITH LOCK WASHER.

CIRCULAR HANGER. REFER TO SMACNA HVAC CONSTRUCTION

HANGER DIA MAXIMUM SPACING

STANDARDS METAL AND FLEXIBLE,

HANGER ROD.

FIGURE 4.4.

16 GAUGE - 3"

11 GAUGE - ½"

SUPPORT MEMBER PROVIDED BY THE GENERAL CONTRACTOR.

REFER TO STRUCTURAL DRAWINGS FOR THREADED ROD CONNECTIONS

BARRIER AND

SEAL AIRTIGHT.

THROUGH SCRIM

PROPELLER FAN-

PLENUM.

PLENUM

EXTERIOR WALL

CAULK AROUND-

PERIMETER OF

SLEEVE

LOUVER-

TRANSITION FAN OUTLET TO-

24" DEEP ALUMINIUM ----

O CHANGES

RICHARD A. FLYNN, SR. FIRE TRAINING CENTER VALHALLA CAMPUS, VALHALLA, NEW YORK MECHANICAL DETAILS

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CONTRAC NUMBER

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