PLUMBING SCHEDULE								
	SYN	MBOLS		PLUMBING CONNECTIONS				
TAG	PLAN	ELEVATION	FIXTURES	WASTE	VENT	COLD WATER	HOT WATER	DESCRIPTION
P-1	0 0 0		LAVATORY	2"	1½"	3/4"	3/4"	KOHLER SOHO WALL-MOUNTED BATHROOM LAVATORY K-2084-L. FAUCET: ZURN Z6950-XL-S AND SHALL BE HARDWIRED. SOAP DISPENSER: Z6950-SD. REFER TO SPECIFICATIONS FOR ALL REQUIRED OPTIONS.
P-2	0:0		WATER CLOSET	4"	2"	11/4"	_	AMERICAN STANDARD MADERA FLOWISE TOILET MODEL 3043.001 WITH SELECTRONIC FLUSH VALVE MODEL 606B.121, 1.28 GPF. PROVIDE HARD WIRE AC TRANSFORMER. REFER TO SPECIFICATIONS FOR ALL REQUIRED OPTIONS.
NFWH	井	<b>T</b>	NON-FREEZE WALL HYDRANT	_	_	3/4"	_	SMITH #5609QT - CAST BRASS, THREADED, NON_FREEZE, HEAVY-DUTY HYDRANT WITH NIKALOY BOX AND LOCKING COVER, BRASS OPERATING PARTS, 3/4" HPT HOSE OUTLET, 3/4" IPS OUTSIDE, ELBOW ADAPTER, "T" HANDLE KEY, AND INTEGRAL VACUUM BREAKER. PIPING SERVING NFWH TO BE ROUTED DOWN ON INTERIOR SIDE OF OUTER WALL INSULATION.
НВ	+	<b>T</b>	HOSE BIB	_	_	3/,"	_	IN FINISHED AREAS, WASHDOWN FAUCET SHALL BE POLISHED CHROME—PLATED WALL FAUCET WITH WALL FLANGE, $\frac{1}{2}$ " INLET, $\frac{3}{4}$ " HOSE THREAD OUTLET AND REMOVABLE LOOSE KEY T—HANGDLE: CHICAGO #293—6 WITH #E27 VACUUM BREAKER OR ACCEPTABLE EQUIVALENT.
TD			TRENCH DRAIN	_	_	_	_	ZURN ZFV812-U4-BG-DB DRAIN #2002 - 12" WIDE REVEAL FIBER REINFORCED VINYLESTER CONTINUOUS 10'-0" TRENCH DRAIN SYSTEM, CLASS D (H-20) GALVANIZED DUCTILE IRON BAR GRATE, 4" NO-HUB OUTLET, AND DOME STRAINER. COORDINATE OUTLET LOCATION IN FIELD.
CODP			CLEANOUT DECKPLATE	_	_	_	_	FLOOR CLEANOUT WITH ADJUSTABLE HEAD, ANCHOR FLANGE, CUT—OFF SECTIONS AND ROUND TOP: ZURN #Z1400 OR APPROVED EQUAL. PROVIDE EXTRA HEAVY DUTY NON—TILT CAST IRON TOP.
TG-1	_	_	TRAP GUARD	_	_	_	_	GREEN DRAIN™ INLINE FLOOR DRAIN TRAP SEAL WITH UV RESISTANT ABS PLASTIC FRAME, SILICONE RUBBER SEALING FLAPPER, AND FOUR FLECIBLE SEALING RIBS. TESTED AND CERTIFIED TO THE ASSE 1072 STANDARD AND LISTED WITH IAPMO AND ICC. (PROVIDE AT ALL FLOOR DRAINS)

## ALTERNATE NOTES

COMPRESSOR - PROVIDE ADD / ALTERNATE PRICE TO FURNISH AND INSTALL THE FOLLOWING AIR COMPRESSOR. COMPRESSOR SHALL BE INGERSOLL RAND MODEL# UP6-15CTAS-150 120 GAL TANK WITH 15 HP MOTOR 480V/3PH/60HZ. UNIT SHALL INCLUDE INTERNAL COOLING SYSTEM, COMPRESSED AIR FILTRATION, AIR DRYER, AND UNIT MOUNTED CONTROL PANEL. PROVIDE OPTIONAL SERVICE MAINTENANCE INDICATOR WHICH INCLUDES HOUR METER, MAINTENANCE METER, INDICATOR OF FAULT CONDITION, REAL TIME CLOCK, BACK LIGHT, SERVICE DUE WARNING, SERVICE OVERDUE.

ALL COMPRESSED AIR PIPING SHALL BE PART OF THE BASE BID.

DCAK - MSA ARCHITECTURE AND ENGINEERING 53 HUDSON AVENUE NYACK, NEW YORK 10960 www.DCAK-MSA.com Email: info@DCAK-MSA.com

Fax 845-353-1614

Tel 845-353-1300


NOTES:

1.) REFER TO SPECIFICATIONS FOR MOUNTING HEIGHTS.

2.) REFER TO ARCHITECTURAL FLOOR PLANS FOR EXACT LOCATION.

RCM Technologies USA, Inc. Consulting Engineers 99 Bauer Drive Oakland, NJ 07436 TEL:(201) 249-8700 EMAIL:bruce.goldman@rcmt.com

Suite 101

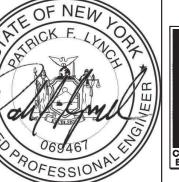

OLA Consulting Engine 50 Broadway, Hawthorn New York 10532 914.747.2800 8 West 38th Street, New York, NY 10018 646.849.4110 olace.com OLA P/N: NDCA0012

								RECORD DRAWING	CERTIFICATION	NC	
neers orne,		AS BUILT - CHANGES AS				NOTED					
						AS BUILT — NO CHANGES					
ew								CONTRACTOR	PROJECT NAME	COORDINATOR	
,						- 1	SIGNATURE		SIGNATURE _	DATE	_
	REVISION NUMBER	DATE	MADE BY	APP'D BY	REVISION		TITLE	DATE	TITLE	DATE	

SYMBOL & ABBREVIATIONS

NEW

CW

HW

S

CA

CODP

WCO

VTR

FAI

DCV

TYP

EWH

SYMBOL

\_\_\_\_

\_\_\_\_

---  $\vee$  ---

\_\_\_\_\_W \_\_\_\_

\_\_\_\_\_S \_\_\_\_

——— G ———

——CA——

 $\overline{\phantom{a}}$ 

 $\longrightarrow$ 

 $\bigcirc$ —

E---

 $\triangleright$ 

4

ABBREVIATION DESCRIPTION

NEW WORK

COLD WATER

HOT WATER

WASTE LINE

SOIL LINE

GAS LINES

PLUG VALVE

CHECK VALVE

MANUAL AIR VENT

PRESSURE REDUCING VALVE

CLEAN OUT DECK PLATE

CONCENTRIC REDUCER

ECCENTRIC REDUCER

FLEXIBLE CONNECTION

WALL CLEAN OUT

BALL VALVE

TEE DOWN

TEE UP

ELBOW UP

PIPE CAP

STRAINER

FLOW ARROW

PRESSURE GAGE

THERMOMETER

WALL HYDRANT

ABOVE FINISHED FLOOR

ABOVE HUNG CEILING

VENT THROUGH ROOF

FRESH AIR INTAKE

TYPICAL

BACK FLOW PREVENTOR

REDUCED PRESSURE ZONE - BFP

DOUBLE CHECK VALVE - BFP

ELECTRIC WATER HEATER

HOSE BIB

UNION

ELBOW DOWN

COMPRESSED AIR LINES

VENT

# GENERAL NOTES

- 1. THE CONTRACT DRAWINGS INDICATE THE EXTENT AND GENERAL ARRANGEMENTS OF THE PLUMBING SYSTEMS. IF ANY DEPARTURES FROM THE DRAWINGS ARE DEEMED NECESSARY BY THE PLUMBING CONTRACTOR, DETAILS OF SUCH DEPARTURES AND THE REASONS THEREFORE SHALL BE SUBMITTED TO THE OWNER AND ENGINEER FOR APPROVAL. NO SUCH DEPARTURES SHALL BE MADE WITHOUT PRIOR WRITTEN APPROVAL OF THE OWNER AND ENGINEER. EQUIPMENT AND PIPING ARRANGEMENTS SHALL PROVIDE ADEQUATE AND ACCEPTABLE CLEARANCES FOR ENTRY, SERVICING, AND MAINTENANCE. ANY CHANGES TO PIPING AND EQUIPMENT LOCATIONS NECESSARY TO AVOID INTERFERENCE WITH OTHER TRADES SHALL BE MADE AT NO EXTRA COST.
  - 2. THE PLUMBING WORK SHALL BE PERFORMED IN STRICT ACCORDANCE WITH THE LATEST EDITION OF THE PREVAILING NEW YORK STATE PLUMBING AND BUILDING CODES, AND ALL LOCAL REGULATIONS THAT MAY APPLY. IN CASE OF CONFLICT BETWEEN THE CONTRACT DOCUMENTS AND A GOVERNING CODE OR ORDINANCE, THE MORE STRINGENT STANDARD SHALL APPLY.
  - 3. THE PLUMBING CONTRACTOR SHALL BE RESPONSIBLE FOR OBTAINING ALL NECESSARY PERMITS AND FOR PAYING RELATED FEES.
  - 4. PRIOR TO FABRICATION, THIS CONTRACTOR SHALL VERIFY ALL MEASUREMENTS AND CONDITIONS ON JOB SITE, AND COORDINATE THIS WORK WITH THE WORK OF ALL OTHER TRADES.
  - 5. PROVIDE ALL PLUMBING FIXTURES, PIPING, VALVES AND ACCESSORY ITEMS AS SPECIFIED AND AS REQUIRED FOR A COMPLETE INSTALLATION. ROUGHING DIMENSIONS OF FIXTURES MUST BE COORDINATED WITH THE GENERAL CONTRACTOR.
- 6. PITCH ALL WASTE, SANITARY, AND STORM DRAIN PIPING AT MAXIMUM SLOPE POSSIBLE, BUT NOT LESS THAN 1/8" PER FOOT.
- 7. NO PIPING SHALL RUN EXPOSED IN TOILET ROOM
- 8. PROVIDE DIELECTRIC FITTINGS OR COUPLINGS FOR DISSIMILAR METALS.
- 9. PROVIDE SHUTOFF VALVES AT ALL FIXTURES AND EQUIPMENT ON COLD WATER, HOT WATER, AND GAS SUPPLY PIPES.
- 10. ALL WORK SHALL BE PROPERLY TESTED, BALANCED, AND CLEANED AND DISINFECTED. PROVIDE A ONE YEAR WARRANTY FROM DATE OF FINAL INSPECTION ON ALL PARTS AND LABOR.
- 11. PROVIDE ALL PIPE OPENINGS THROUGH PARTITIONS WITH PIPE SLEEVES. FOR PIPES PENETRATING FIRE RATED PARTITIONS, THE SPACE BETWEEN THE PIPE AND THE SLEEVE SHALL BE SEALED WITH FIRE STOPPING MATERIAL. PENETRATIONS FOR PIPING SHALL BE MADE BY CORE DRILLING WHENEVER POSSIBLE. SLEEVE FOR SERVICE PIPE SHALL BE TWO (2) TIMES THE DIAMETER OF THE SERVICE PIPE.
- 12. THE PLUMBING CONTRACTOR SHALL PROVIDE ALL CUTTING, PATCHING, CORE DRILLING, PAINTING, ACCESS PANELS, AND FINAL RESTORATION REQUIRED TO FACILITATE THE INSTALLATION OF PLUMBING PIPING, INCLUDING ABOVE CEILINGS AND IN SHAFTS THAT WILL NOT BE REPLACED OR OPENED UNDER ANY OTHER SCOPE OF WORK RELATED TO THIS PROJECT. CONTRACTOR TO REMOVE AND REPLACE CEILINGS, AND OPEN AND PATCH SHAFTS AND WALLS, AS REQUIRED TO EXECUTE THE PLUMBING WORK.
- 13. ALL MOTOR STARTERS AND DISCONNECT SWITCHES FOR PLUMBING EQUIPMENT SHALL BE FURNISHED BY THE PLUMBING CONTRACTOR AND INSTALLED BY THE ELECTRICAL CONTRACTOR, UNLESS OTHERWISE NOTED. DISCONNECT SWITCHES FURNISHED BY THE PLUMBING CONTRACTOR FOR PLUMBING EQUIPMENT SHALL BE HEAVY DUTY TYPE.
- 14. THIS CONTRACTOR IS RESPONSIBLE FOR ALL PLUMBING FIXTURES AND DISTRIBUTION SYSTEMS, INCLUDING ALL ROUGH-INS AND FINAL CONNECTIONS.
- 15. THE CONTRACTOR SHALL BE RESPONSIBLE FOR PROVIDING TEMPORARY VENTILATION AND EXHAUST AIR WHEN WELDING OR SOLDERING OPERATIONS ARE PERFORMED, AS REQUIRED BY OSHA.
- 16. PROVIDE PVC PROTECTIVE COVER FOR ALL PIPING INSULATION BELOW 10'-0" AFF.
- 17. THE CONTRACTORS SHALL SUBMIT FOR REVIEW AND APPROVAL A COMPOSITE SHOP DRAWING, FULLY COORDINATED WITH ALL OTHER TRADES INDICATING ALL DUCTWORK, MECHANICAL EQUIPMENT, PIPING, ELECTRICAL EQUIPMENT, PLUMBING PIPING AND EQUIPMENT, LIGHTS, CONDUITS, DIFFUSERS, GRILLES AND FIRE ALARM DEVICES.

#### EQUIPMENT NOTES

- PROTECTIVE SHIELDING GUARDS: WHEREVER PIPING IS EXPOSED BELOW SINKS AND LAVATORIES, PROVIDE MANUFACTURED PLASTIC ENCLOSURES BY TRUEBRO FOR COVERING PLUMBING FIXTURE HOT AND COLD WATER SUPPLIES AND TRAP AND DRAIN PIPING. COMPLY WITH AMERICANS WITH DISABILITIES ACT (ADA) REQUIREMENTS.
- WATER HAMMER ARRESTORS: ZURN INDUSTRIES SHOKTROL SERIES. STAINLESS STEEL CONSTRUCTION, BELLOWS TYPE SIZED IN ACCORDANCE WITH PDI WH-201, PRE-CHARGED SUITABLE FOR OPERATION IN TEMPERATURE RANGE 34 TO 250 DEGREES F AND MAXIMUM 150 PSI WORKING PRESSURE.
- POINT OF USE ELECTRIC TANKLESS HOT WATER HEATER (EWH-1): SHALL BE EEMAX "SINGLE POINT" MODEL SP-3512, 120V/1ø/60HZ, 3.5kW, 29 AMPS, U.L. LISTED, TO HEAT 0.5 GPM @ A TEMPERATURE RISE OF 48°F. UNIT SHALL HAVE ABS-UL RATED COVER. ELEMENT SHALL BE REPLACEABLE CARTRIDGE INSERT. UNIT SHALL HAVE A REPLACEABLE FILTER IN THE INLET CONNECTOR AND A FLOW REGULATOR IN THE OUTLET CONNECTOR. ELEMENT SHALL BE IRON FREE, NICKEL CHROME MATERIAL. HEATER SHALL BE FITTED WITH 3/8" COMPRESSION NUTS AND SLEEVES. HEATER SHALL BE INSTALLED WITH WATER CONNECTIONS ON TOP ONLY. DISCONNECT SWITCH SHALL BE FURNISHED BY THE PLUMBING CONTRACTOR AND INSTALLED BY THE ELECTRICAL CONTRACTOR.
- 4. <u>OIL-WATER SEPARATOR</u>: BASED ON HIGHLAND TANK MODEL HTC-2000 SERIES-G DOUBLE WALL OIL/WATER SEPARATOR WITH INTEGRAL SAND INTERCEPTOR COMPARTMENT, CORELLA COALESCER PLATE SYSTEM AND HIGH GUARD PROTECTION SYSTEM. UNIT SHALL HAVE A TOTAL VOLUME OF 2000 GAL AND A MAXIMUM FLOW RATE OF 200 GAL/MIN. A HIGHLAND TANK ALARM PANEL SHALL BE PROVIDED IN THE BUILDING CAPABLE OF HIGH OIL (VISUAL ALARM), HIGH-HIGH OIL (AUDIBLE AND VISUAL ALARM), AND LEAK DETECTION (AUDIBLE AND VISUAL ALARM). UNIT REQUIRES A 120V/1PH/60HZ POWER CONNECTION WITH ~1 AMP. REFER TO DETAIL ON P-701 INSTALLATION AND SPECIFICATIONS FOR FULL INFORMATION.

WESTCHESTER COUNTY, NEW YORK DEPARTMENT OF PUBLIC WORKS AND TRANSPORTATION DIVISION OF ENGINEERING

> NEW EQUIPMENT STORAGE BUILDING RICHARD A. FLYNN, SR. FIRE TRAINING CENTER VALHALLA CAMPUS, VALHALLA, NEW YORK

P - 001SHEET NO. 33 OF 53 SCALE: AS SHOWN DATE: 11/16/2021 DPW FILE NO.


38-47-P-715-0 | 0

NUMBER

17-521

SHEET NUMBER

PLUMBING SYMBOLS, ABBREVIATIONS, & GENERAL NOTES

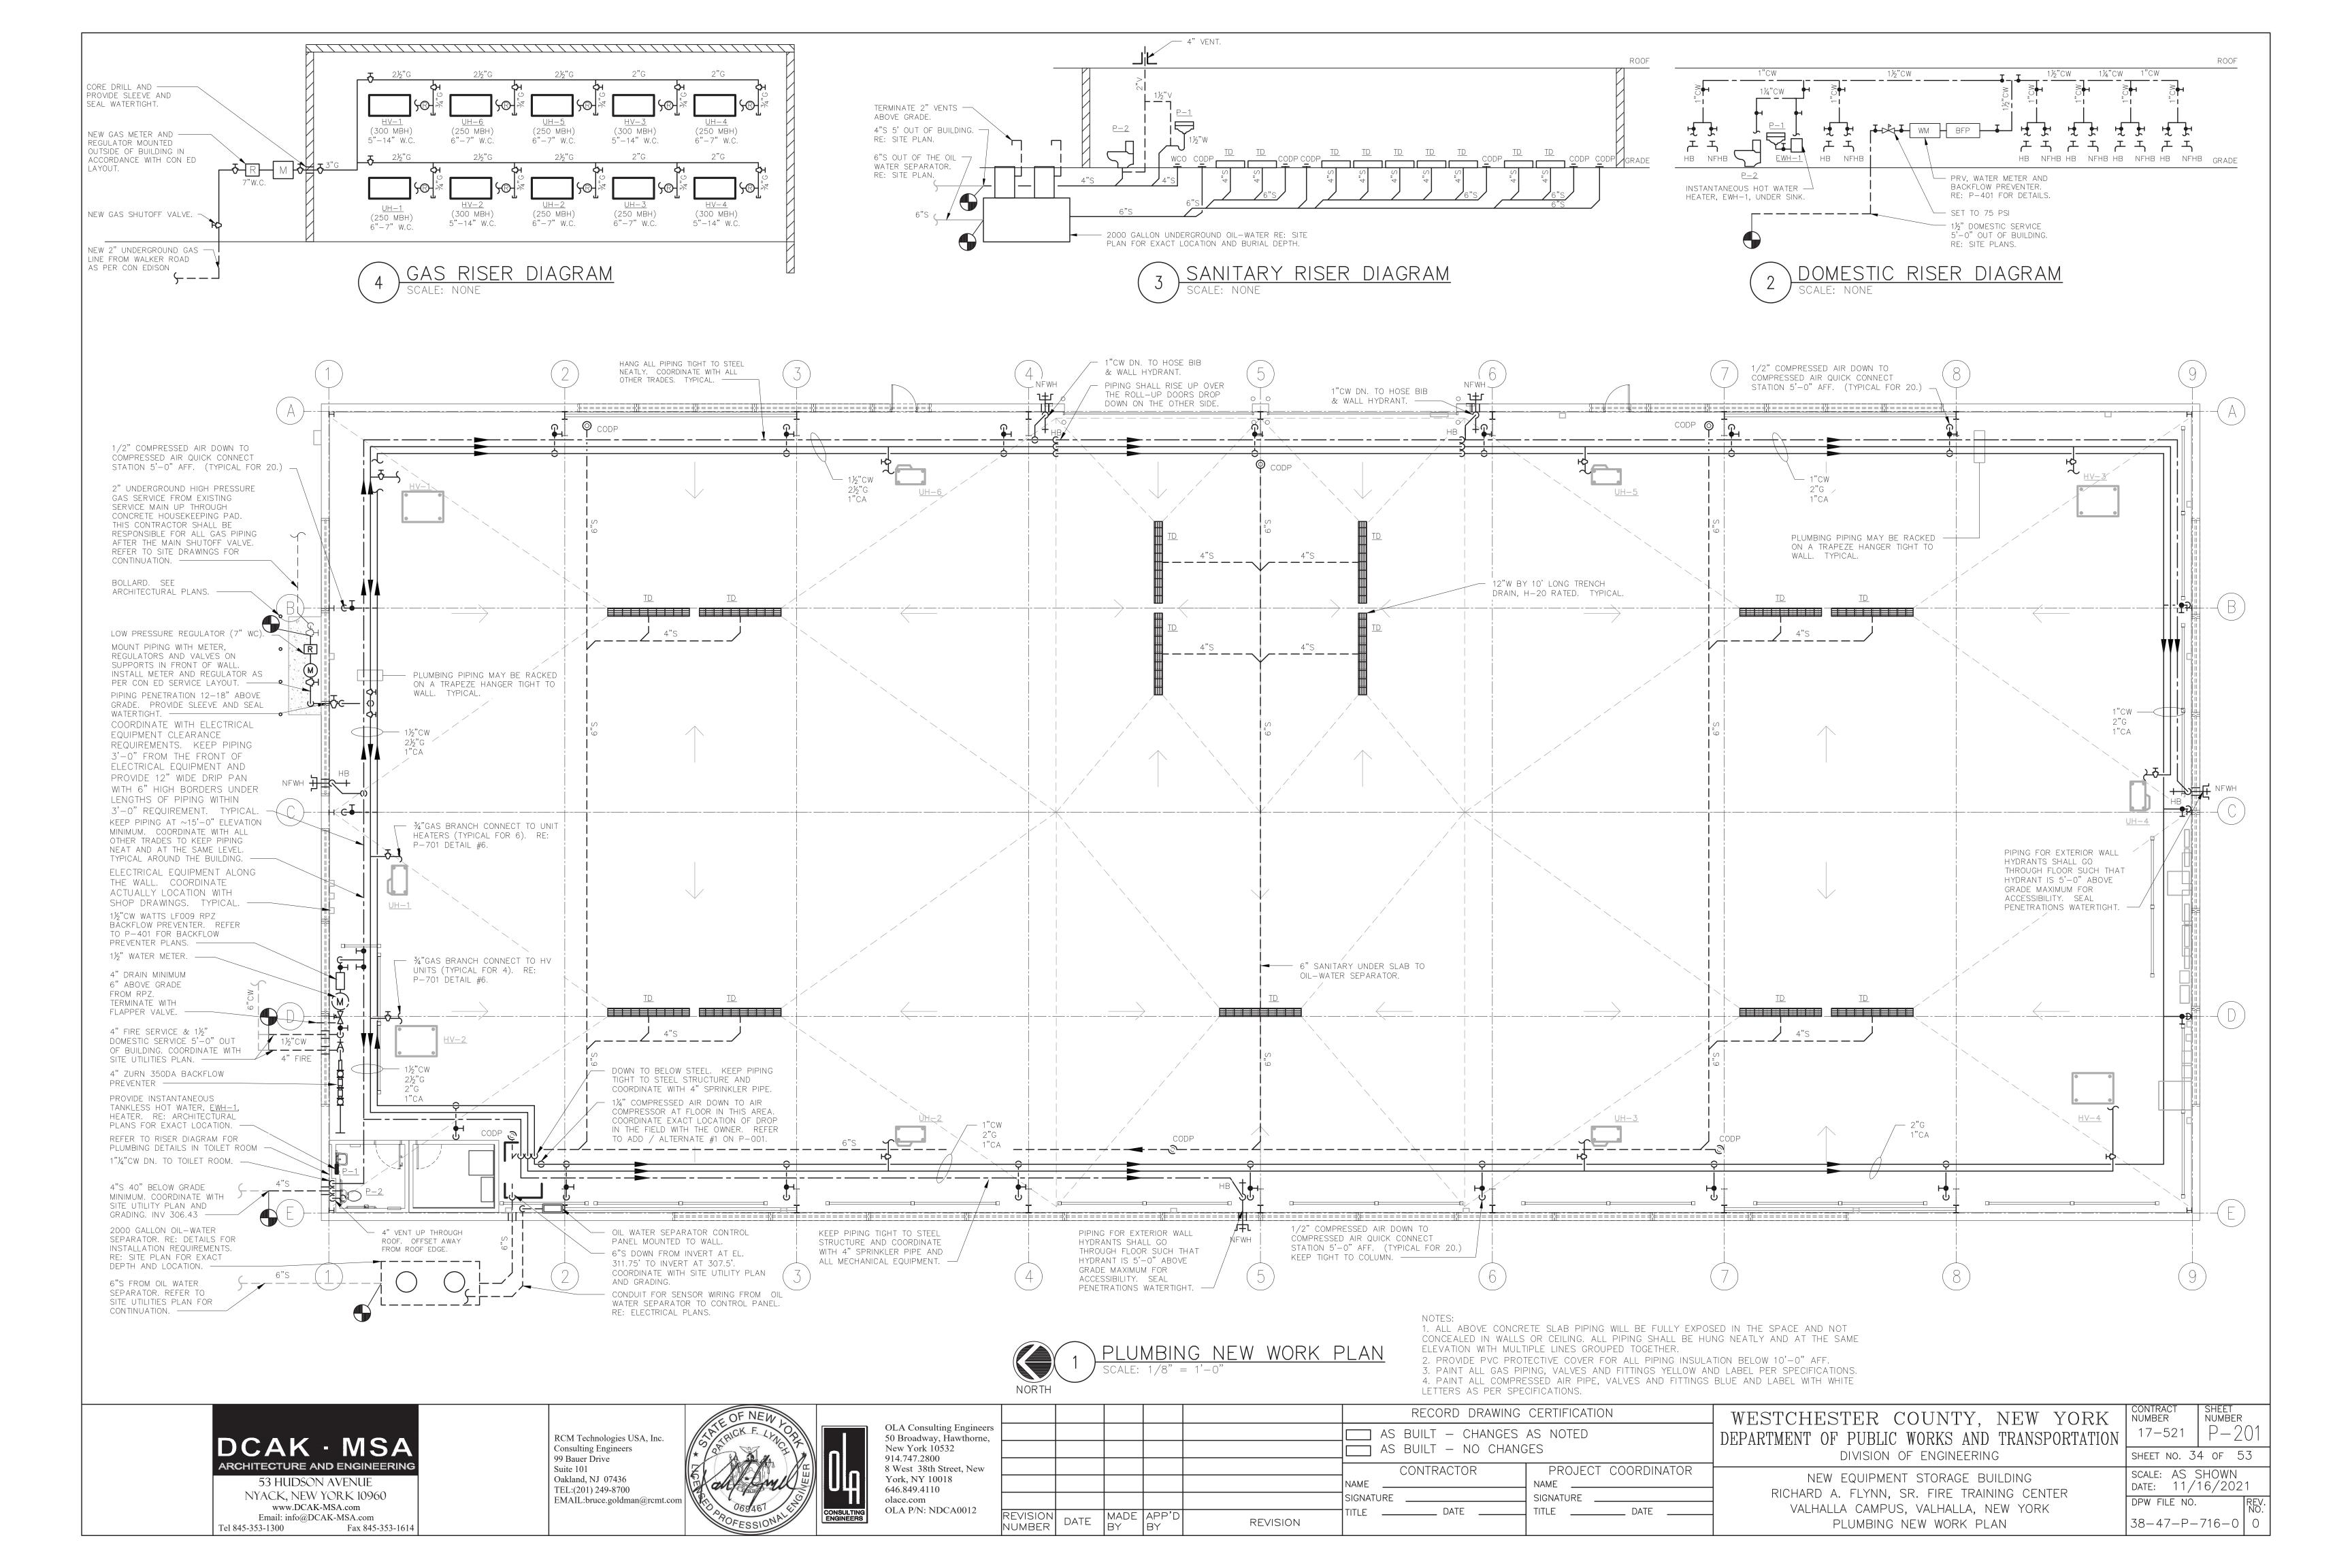


### GENERAL NOTES:

- 1. ADEQUATE HEAT AND LIGHT SHALL BE PROVIDED IN LOCATIONS WHERE BACKFLOW PREVENTERS ARE TO BE INSTALLED.
- 2. THE CONTRACTOR SHALL USE ONLY AMERICAN MADE, UL/FM APPROVED VALVES.
- 3. NO WORK SHALL PROCEED WITHOUT THE WESTCHESTER COUNTY DEPARTMENT OF HEALTH TOWN OF MT. PLEASANT APPROVAL. 4. BACKFLOW PREVENTER ARRANGEMENT SHALL NOT BE ALTERED WITHOUT PRIOR APPROVAL BY WESTCHESTER COUNTY DEPARTMENT OF HEALTH.
- 5. BACKFLOW PREVENTION SHALL BE PROTECTED FROM THE HIGHEST FLOOD LEVEL.
- 6. BY-PASSES AROUND BACKFLOW PREVENTER ASSEMBLEY SHALL NOT BE PERMITIED. 7. BACKFLOW PREVENTER DEVICE SHALL BE TESTED INITIALLY AND ANNUALLY BY A CERTIFIED AND LICENSED TESTER. AT THE TIME OF INITIAL TESTING PART A AND B OF DOH 1013 FORM MUST BE COMPLETED, TEST RESULTS (FORM DOH 1013) SHALL BE FORWARDED TO WESTCHESTER
- COUNTY DEPARTMENT OF HEALTH, OWNER AND ENGINEER. 8. THE BACKFLOW PREVENTER SHALL BE REBUILT EVERY FIVE YEARS.
- 9. ALL PLUMBING WORK SHALL BE PERFORMED BY A LICENSED PLUMBER AND ACCORDING TO DEPARTMENT OF PUBLIC WORKS REGULATIONS. 10. CONTRACTOR SHALL DISINFECT AND PRESSURE TEST BACKFLOW PREVENTER ASSEMBLY BEFORE PLACING IN SERVICE. DISINFECTION SHALL BE IN ACCORDANCE WITH AWWA STANDARD C651-05 WITH THE EXCEPTION OF SECTION 4.4.2.
- 11. CONTRACTOR SHALL ADEQUATELY SUPPORT ALL PIPING AND DEVICES.

#### **EQUIPMENT NOTES:**

- 1. THE 1½" DOMESTIC WATER BACKFLOW PREVENTER ASSEMBLY SHALL BE WATTS MODEL LF009M2QT 1½" REDUCED PRESSURE ZONE BACKFLOW PREVENTER. ASSEMBLY SHALL BE LEAD FREE SUITABLE FOR PRESSURES UP TO 175 PSI AND TEMPERATURES UP TO 180°F. THE ASSEMBLY SHALL INCLUDE TWO RESILIENT SEATED ISOLATION VALVES, FOUR RESILIENT SEATED TEST COCKS AND AN AIR GAP DRAIN FITTING.
- 2. THE 4" FIRE SERVICE BACKFLOW PREVENTER ASSEMBLY SHALL BE ZURN MODEL 350DA 4" DOUBLE CHECK DETECTOR ASSEMBLY BACKFLOW PREVENTER WITH OSY SHUTOFF VALVES. ASSEMBLY SHALL BE LEAD FREE SUITABLE FOR PRESSURES UP TO 175 PSI AND TEMPERATURES UP TO 110°F (CONSTANT) AND 140°F (INTERMITTENT). ASSEMBLY SHALL HAVE FDA EPOXY COATED CAST IRON BODY, BRONZE SEALS, STAINLESS STEEL TRIM, BRONZE RELIEF VALVE AND BRONZE BODY TEST COCKS. DEVICE SHALL HAVE (2) INTEGRAL UL/FM OUTSIDE STEM AND YOKE RESILIENT SEATED GATE VALVES.
- 3. PRESSURE REDUCING VALVE (PRV): WATTS LFN223BS WITH ADJUSTABLE PRESSURE RANGE.
- 4. BACKWATER VALVE: WATTS BV-200 IN-LINE BACKWATER VALVE.
- 5. THE 1½" DOMESTIC WATER METER WITH INTEGRAL STRAINER SHALL BE SUBJECT TO THE REVIEW AND APPROVAL OF THE LOCAL WATER UTILITY. FINAL WATER METER AND SIZE, MODEL, AND DIMENSIONS SHALL BE DETERMINED & APPROVED BY THE LOCAL WATER UTILITY. THE PLUMBING CONTRACTOR IS RESPONSIBLE FOR COORDINATION AND INSTALLATION AND ALL RELATED WATER DEPARTMENT FEES.

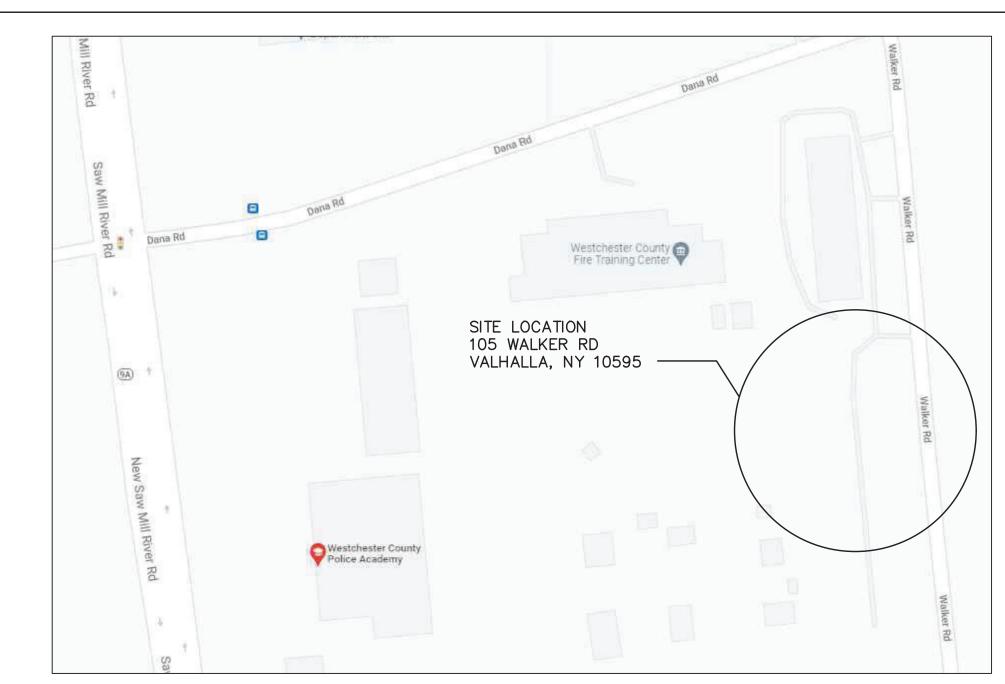

SYMBOL	S AND A	ABBREVIATIONS
SYMBOL	ABBREVIATION	DESCRIPTION
	CW	COLD WATER
_	AFF	ABOVE FINISHED FLOOR
_	BFP	BACK FLOW PREVENTER
_	DCV	DOUBLE CHECK VALVE
_	DN.	ELBOW DOWN
_	MAX.	MAXIMUM
_	MIN.	MINIMUM
_	PC	PLUMBING CONTRACTOR
_	RPZ	REDUCED PRESSURE ZONE
_	TYP	TYPICAL
<b></b>	_	DIRECTION OF FLOW

#### BUILDING INFORMATION

ADDRESS: 105 WALKER ROAD, VALHALLA, NY 10595 COUNTY: WESTCHESTER COUNTY

SITE ELEVATION: THE SITE IS OUTSIDE OF THE 100 YEAR FLOOD PLAIN.


#### INSTALLATION NOTES:


- A. NO STRAINER IS TO BE USED ON A FIRE LINE WITHOUT INSURANCE UNDERWRITER APPROVAL.
- B. ASSEMBLIES SHOULD BE SPECIFIED AND INSTALLED WITH MANUFACTURER SUPPLIED VALVES. C. WATER LINES SHOULD BE THOROUGHLY FLUSHED BEFORE INSTALLATION OF DEVICE TO
- PREVENT DEBRIS FOULING THE DEVICE CHECK VALVES. D. DEVICES MUST BE MOUNTED HORIZONTALLY UNLESS APPROVED FOR VERTICAL INSTALLATION.
- ASSEMBLIES SHOULD NOT BE INSTALLED IN AREAS CONTAINING CORROSIVE OR TOXIC GASES WHICH COULD RENDER THE DEVICE INOPERABLE.

NOTE: INSTALLATION SHALL BE IN ACCORDANCE WITH WESTCHESTER COUNTY DEPARTMENT OF HEALTH REQUIREMENTS.


UNAUTHORIZED ALTERATION OR ADDITION TO THIS DOCUMENT IS A DIRECT VIOLATION OF SECTION 7209 (2) OF THE NEW YORK STATE EDUCATION LAW

ONLY COPIES FROM THE ORIGINAL OF THIS DRAWING THAT ARE MARKED WITH THE ORIGINAL SEAL AND SIGNATURE OF THE ENGINEER SHALL BE CONSIDERED AS TRUE VALID COPIES.

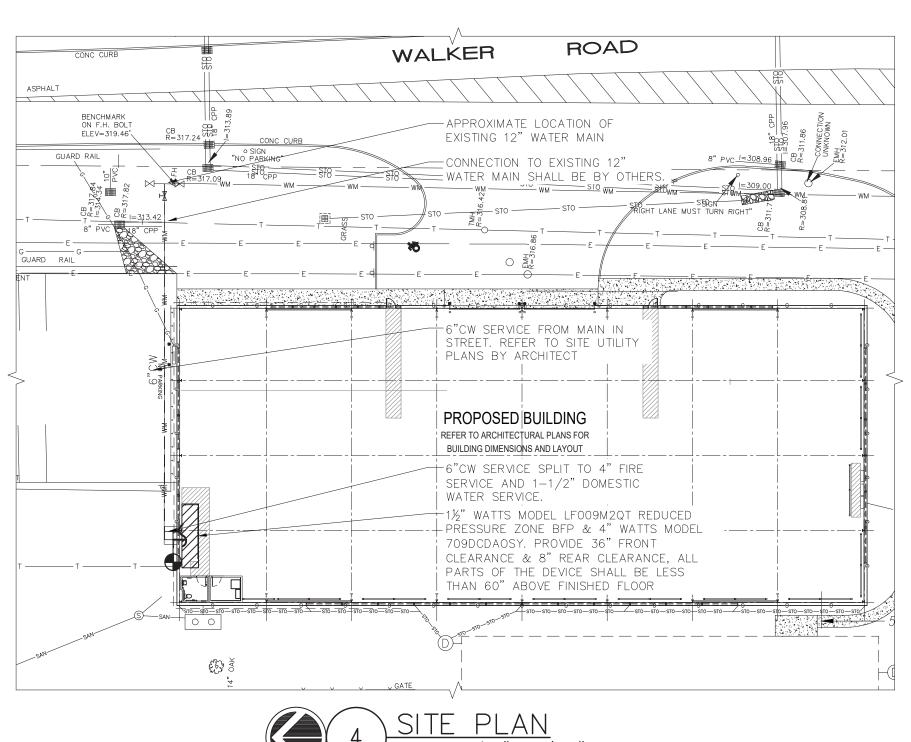

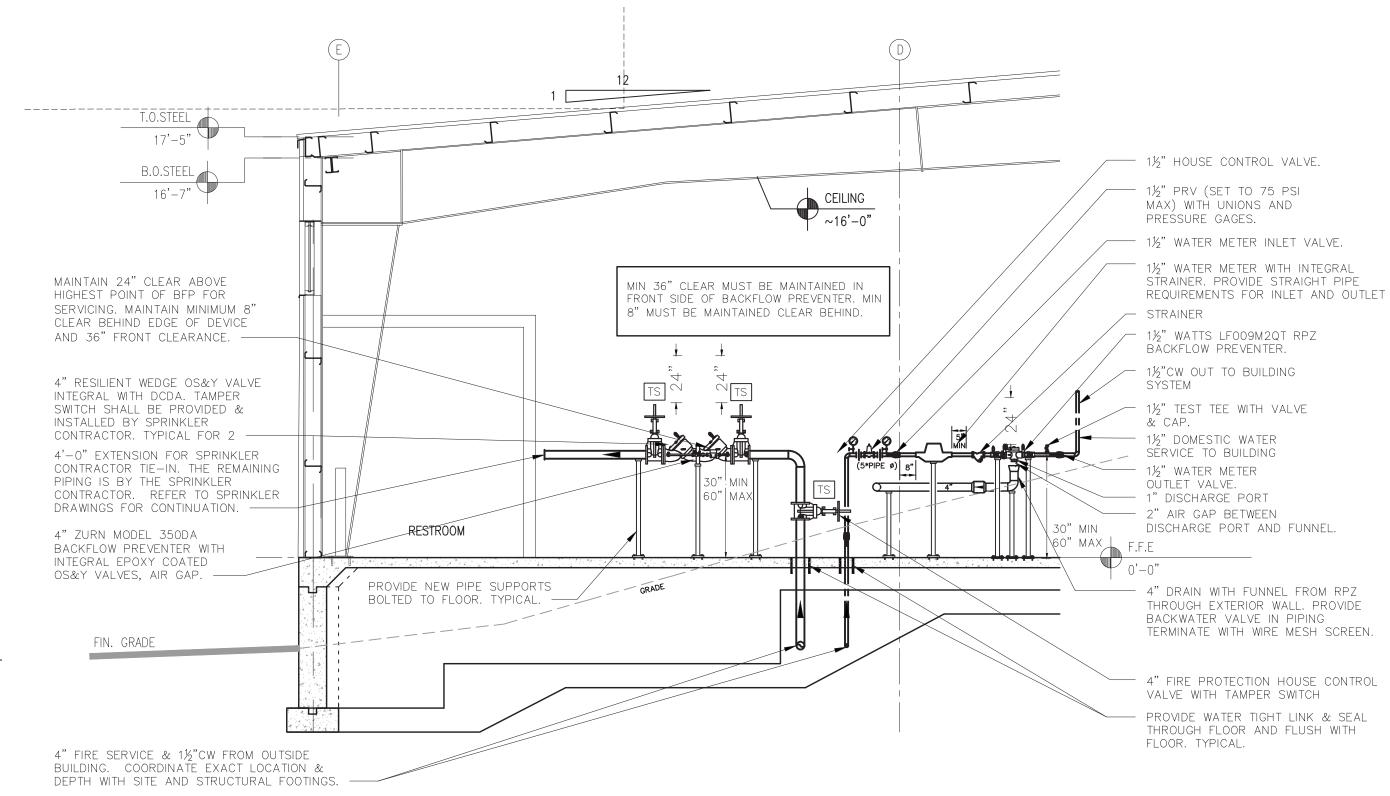

PLUMBING ELEVATION A-A

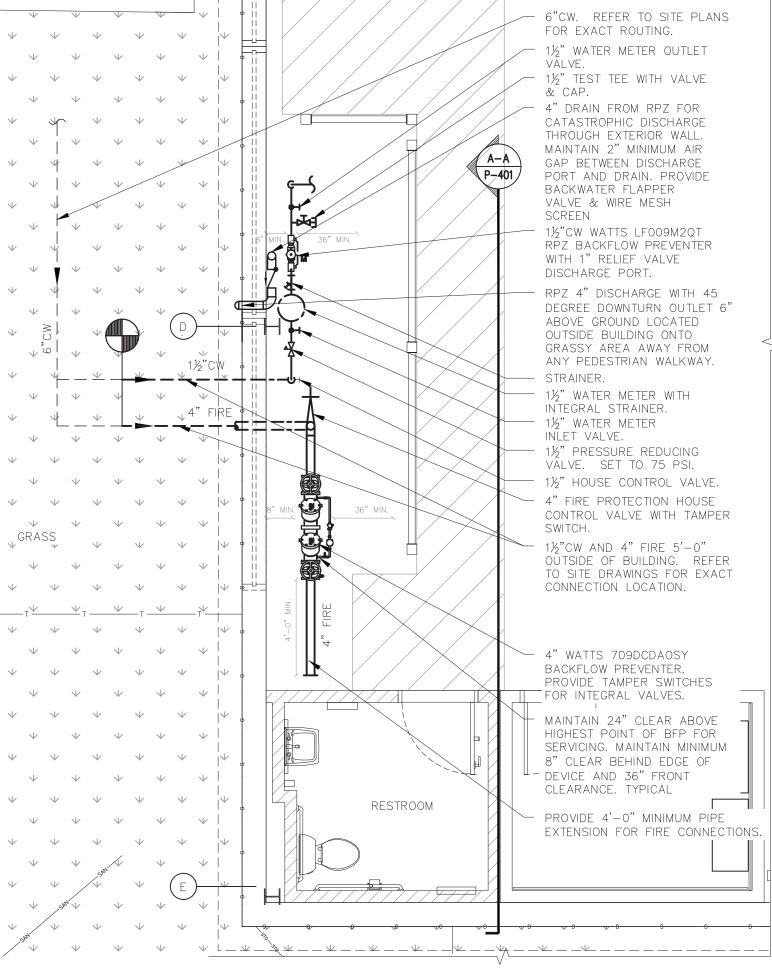

<u>Jmbing new work part plan</u>



ARCHITECTURE AND ENGINEERING 53 HUDSON AVENUE NYACK, NEW YORK 10960 www.DCAK-MSA.com Email: info@DCAK-MSA.com

Fax 845-353-1614

Tel 845-353-1300

RCM Technologies USA, Inc. Consulting Engineers 99 Bauer Drive Suite 101 Oakland, NJ 07436 TEL:(201) 249-8700 EMAIL:bruce.goldman@rcmt.com




OLA Consulting En 50 Broadway, Hawtl New York 10532 914.747.2800 8 West 38th Street, York, NY 10018 646.849.4110 olace.com OLA P/N: NDCA00


						RECORD DRAWING CERTIFICATION				
Engineers wthorne,						_		UILT — CHANGES AS NOTED UILT — NO CHANGES		
t, New						NAME	CONTRACTOR	PROJECT NAME	COORDINATOR	
						SIGNATURE		SIGNATURE _		
	REVISION NUMBER	DATE	MADE BY	APP'D BY	REVISION	TITLE	DATE	TITLE	DAIL	


WESTCHESTER COUNTY, NEW YORK DEPARTMENT OF PUBLIC WORKS AND TRANSPORTATION DIVISION OF ENGINEERING

> NEW EQUIPMENT STORAGE BUILDING RICHARD A. FLYNN, SR. FIRE TRAINING CENTER VALHALLA CAMPUS, VALHALLA, NEW YORK PLUMBING BACKFLOW PREVENTER PLAN

SHEET NUMBER NUMBER  $P - 40^{\circ}$ 17-521 SHEET NO. 35 OF 53 SCALE: AS SHOWN DATE: 11/16/2021 DPW FILE NO. 38-47-P-717-0|C

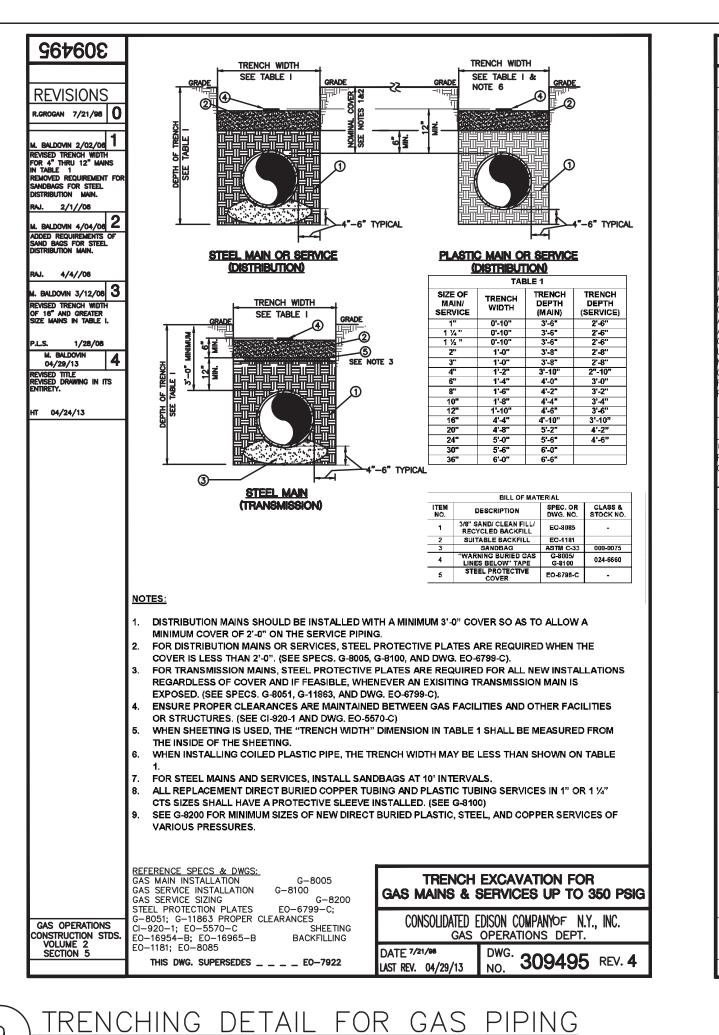

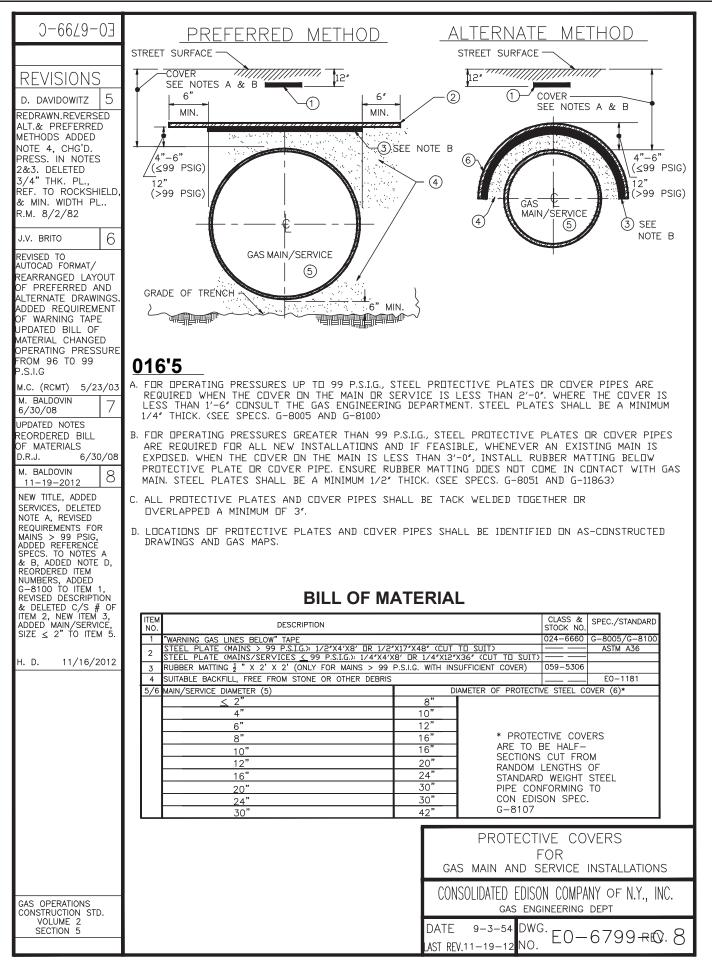

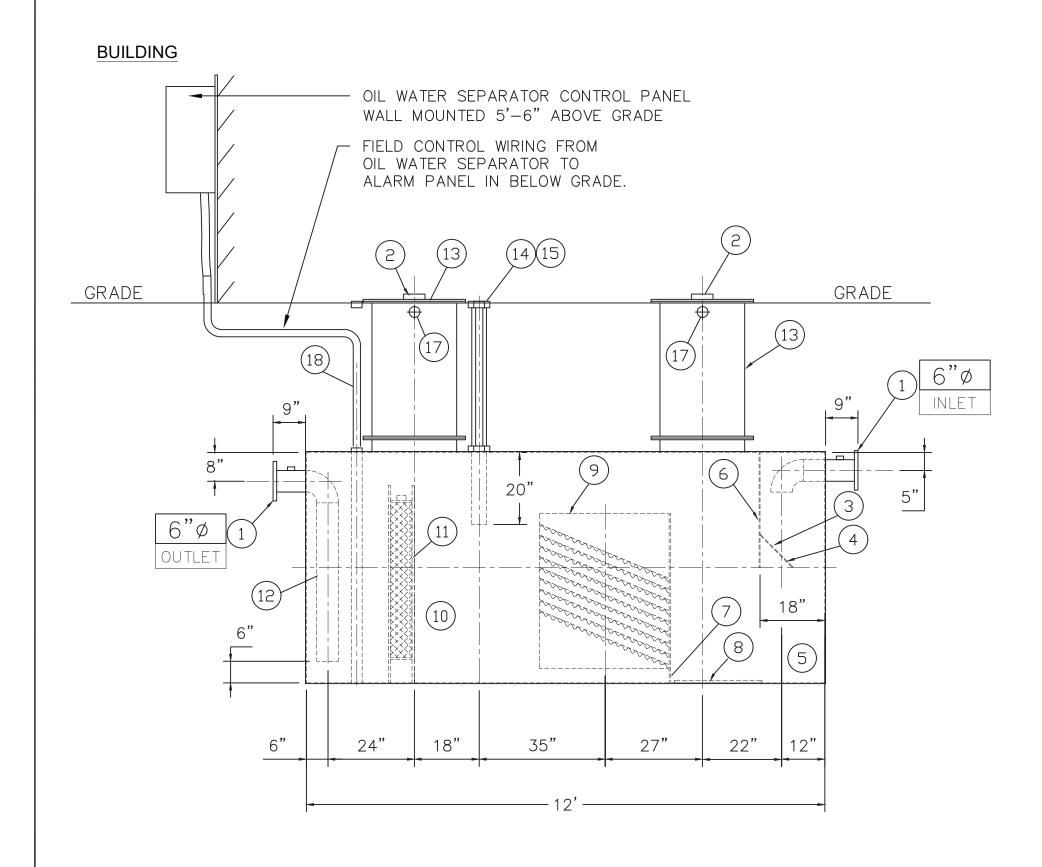



- 1. 150# R.F.S.O. FLANGE W/ 2" FNPT FOR VENT
- 4"Ø FNPT FOR GAUGE WITH PLUG
- 3. VELOCITY HEAD DIFFUSION BAFFLE 4. WEAR PLATE
- 5. SEDIMENT CHAMBER
- 6. UNDERFLOW BAFFLE (REMOVABLE)
- 7. SLUDGE BAFFLE
- 8. STRIKER PLATES 9. PARALLEL CORRUGATED PLATE COALESCER. CORELLA PVC
- PLATES (3" PLATE SPACING) 10. OIL/WATER SEPARATOR CHAMBER
- 11. 6" THICK PETROSCREEN COALESCER MATERIAL INSTALLED
- W/ PULL ROD SHIPPED LOOSE 12. STEEL OUTLET DOWNCOMER
- 13. 30"ø MANWAY WITH NEO-CORK GASKET. BOLT-ON EXTENSION SHIPPED LOOSE. COORDINATE EXACT
- EXTENSION REQUIRED WITH FINAL GRADING. 14. 4"Ø FNPT FOR OIL PUMP-OUT WITH INTERNAL PVC PIPE INSTALLED & RISER PIPE SHIPPED LOOSE. COORDINATE
- 15. 2" Ø FNPT FOR LEVEL SENSOR WITH RISER PIPE SHIPPED

EXACT HEIGHT WITH FINAL GRADING AND EXTEND IN FIELD

- LOOSE 16. LIFTING LUG
- 17. 2"ø FNPT FOR VENT. EXTEND TO 36" ABOVE GRADE WITH GOOSE NECK.
- 18. 2" FNPT FOR LEAK SENSOR WITH RISER PIPE SHIPPED LOOSE



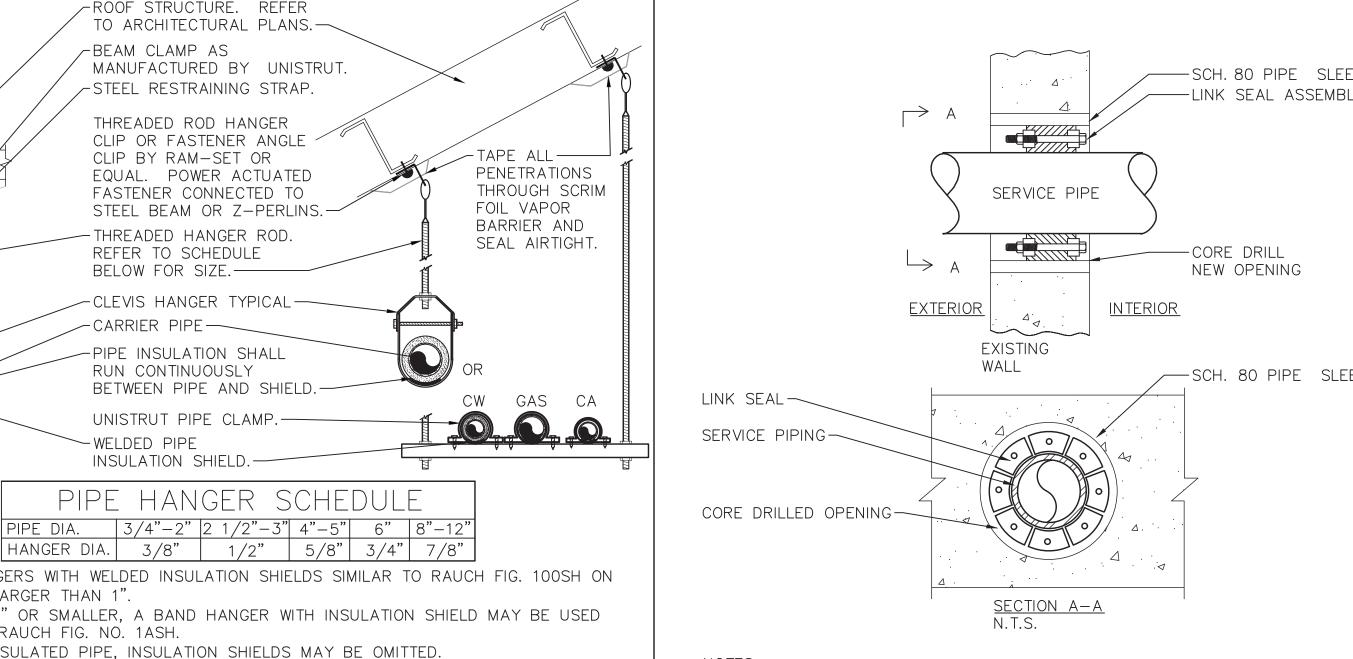

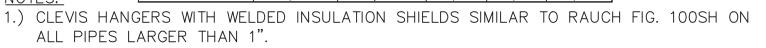


- 2.) FOR PIPES 1" OR SMALLER, A BAND HANGER WITH INSULATION SHIELD MAY BE USED SIMILAR TO RAUCH FIG. NO. 1ASH.
- 3.) FOR NON-INSULATED PIPE, INSULATION SHIELDS MAY BE OMITTED.
- 4.) ALL PIPE HANGERS SHALL BE GALVANIZED STEEL OR FACTORY PAINTED BLACK WITH ENAMEL.
- PLATED OR FURNISHED WITH A DI-ELECTRIC BETWEEN PIPE AND HANGERS. 6.) WHERE EXISTING BUILDING STRUCTURAL COMPONENTS HAVE FIREPROOF MATERIAL, ANY AREA THAT IS DISTURBED OR DAMAGED AS A RESULT OF HANGER INSTALLATION

5.) FOR NON FERROUS PIPING WITHOUT INSULATION, ALL HANGERS SHALL BE COPPER

- SHALL BE PATCHED WITH UL AND FM APPROVED FIREPROOFING TO MATCH EXISTING. 7.) ALL HANGER PENETRATIONS THROUGH VAPOR BARRIER SHALL BE TAPED AND SEALED.
- 8.) REFER TO SPECIFICATIONS FOR SPACING REQUIREMENTS.

Tel 845-353-1300


PIPE HANGER DETAIL

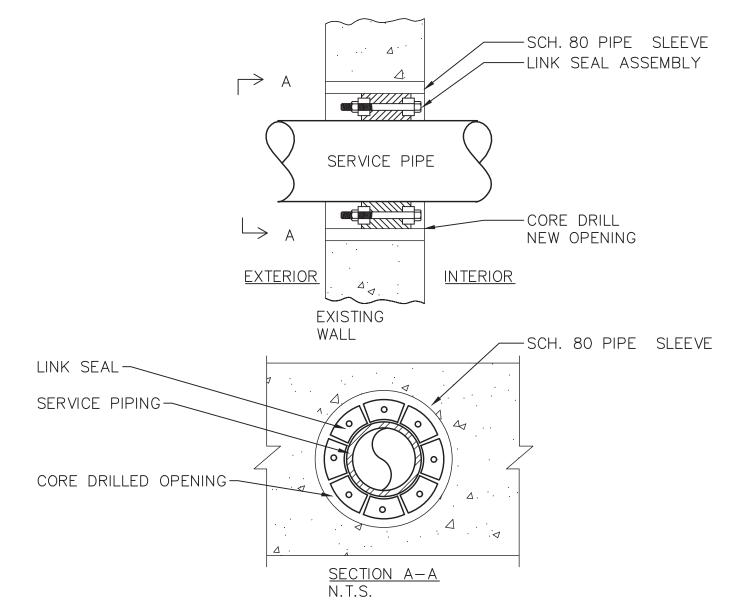

1.) SEAL ASSEMBLY BASED ON THUNDERLINE MODEL "C" LINK-SEAL MODULAR SEAL, WITH EPDM SEAL ELEMENT, COMPOSITE PRESSURE PLATES, STEEL WITH 2-PART ZINC DICHROMATE & ORGANIC COATED NUTS AND BOLTS RATED FOR AN OPERATING TEMPERATURE RANGE OF -40°F TO +250°F

2.) USE LINK SEAL AT ALL LOCATIONS WHERE PIPES PENETRATE EXTERIOR WALLS,

ABOVE GRADE OR BELOW GRADE. PIPE LINK SEAL DETAIL FOR EXTERIOR WALLS

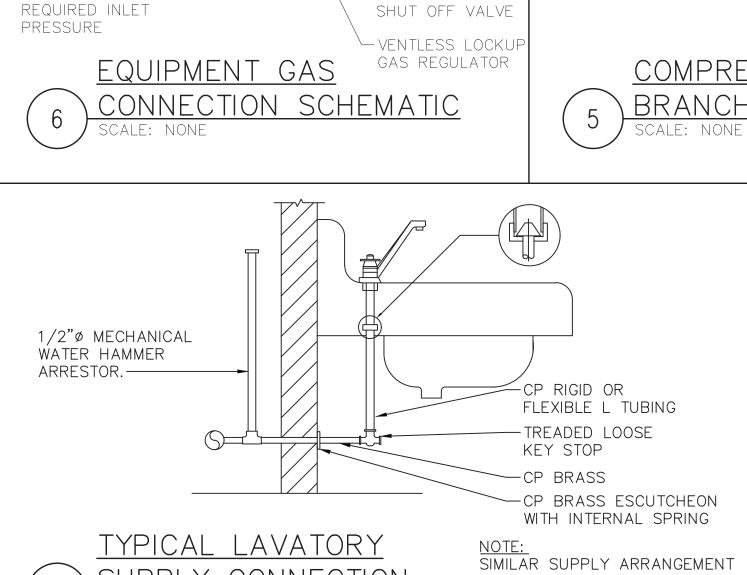

OIL WATER SEPARATOR SCHEMATIC

-UNION

<u>EQUIPMENT</u>

REFER TO EQUIPMENT -


MANUFACTURER FOR

-GAS SUPPLY


√DIRT LEG


-APPROVED GAS


TO OTHER FIXTURES

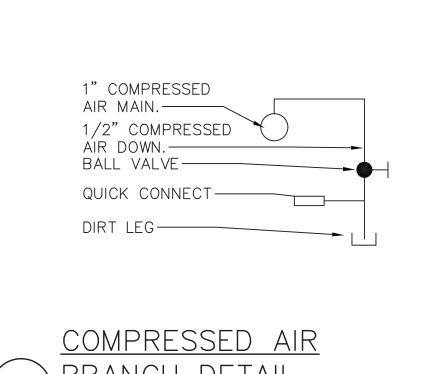



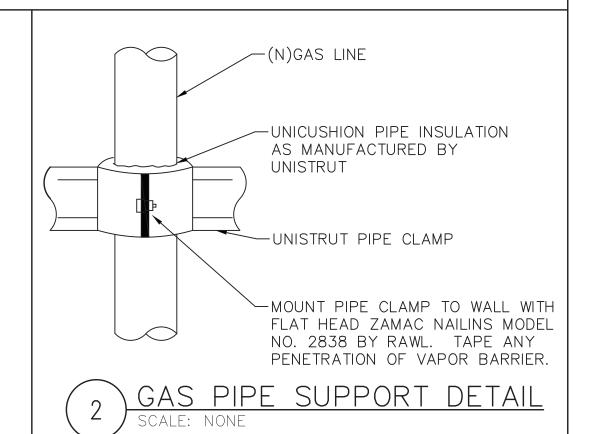

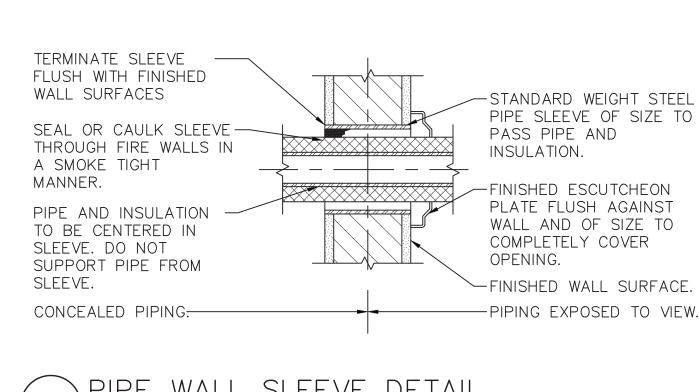

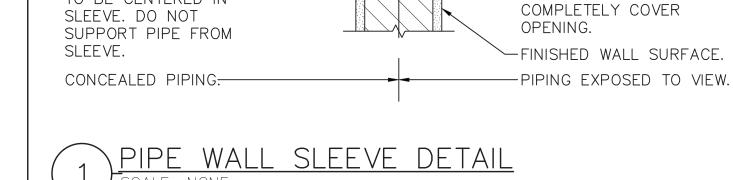



NYACK, NEW YORK 10960

www.DCAK-MSA.com

Email: info@DCAK-MSA.com

Fax 845-353-1614

RCM Technologies USA, Inc. Consulting Engineers 99 Bauer Drive Suite 101 Oakland, NJ 07436 TEL:(201) 249-8700 EMAIL:bruce.goldman@rcmt.com



	OLA Consulting Engi 50 Broadway, Hawtho New York 10532 914.747.2800 8 West 38th Street, N York, NY 10018 646.849.4110 olace.com OLA P/N: NDCA001
ONSULTING NGINEERS	OLA P/N: NDCA001

								_
							RECORD DRAWING CERTIFICATI	ON
ers e,						_	BUILT — CHANGES AS NOTED BUILT — NO CHANGES	
7						NAME	CONTRACTOR PROJECT	T COORDINATOR
						SIGNATURE		D.175
	REVISION NUMBER	DATE	MADE BY	APP'D BY	REVISION	TITLE —	DATE TITLE	DATE

SUPPLY CONNECTION

SCALE: NONE

#### WESTCHESTER COUNTY, NEW YORK DEPARTMENT OF PUBLIC WORKS AND TRANSPORTATION DIVISION OF ENGINEERING

NEW EQUIPMENT STORAGE BUILDING RICHARD A. FLYNN, SR. FIRE TRAINING CENTER VALHALLA CAMPUS, VALHALLA, NEW YORK PLUMBING DETAILS

17-521	P-7	01
SHEET NO. 3	6 of 5	3
SCALE: AS S DATE: 11/	SHOWN 16/202	1
DPW FILE NO.		REV. NO.
38-47-P-	718-0	0