NO.	ISSUANCE	DATE	REVISION
1	ISSUED FOR BID	03/01/2022	

YONKERS PUBLIC SCHOOLS


One Larkin Center, Yonkers, New York 10701

ROOF RENOVATIONS ROBERT C. DODSON SCHOOL

LIST OF DRAWINGS

ROOF A1

ROOF PLAN ROOF DETAILS

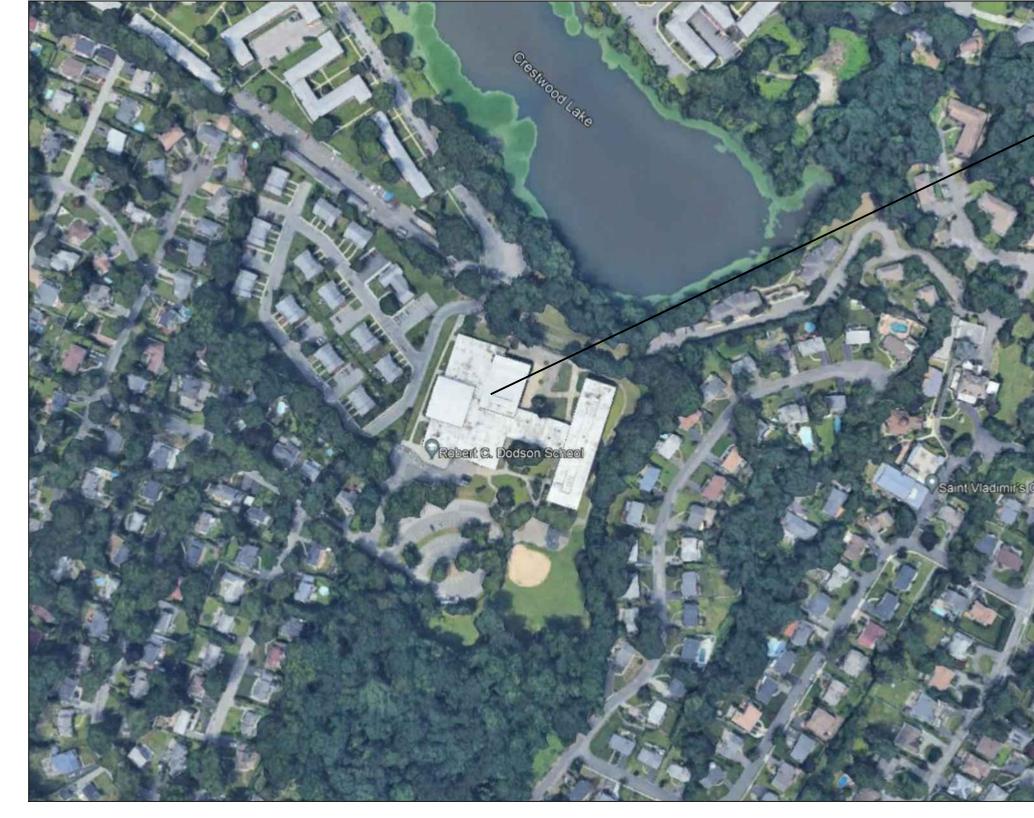

PROJECT LOCATION MAP SCALE: N.T.S.

DESIGN TEAM:

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YPS JOB # 10944

03-01-2022

BID SET



- 1. DIMENSIONS AND CONDITIONS ON THE ROOF PLAN AND DETAILS ARE APPROXIMATE AND MUST BE CONFIRMED BY THE CONTRACTOR. ONLY CERTAIN FASTENERS ARE SHOWN ON THE DRAWINGS, REFER TO THE SPECIFICATIONS FOR ADDITIONAL FASTENER REQUIREMENTS.
- 2. TEST ALL DRAIN LINES WITH A RUNNING HOSE FOR AT LEAST ONE HOUR PRIOR TO STARTING ANY WORK. PROVIDE A WRITTEN REPORT OF ANY CLOGGED LINES TO THE ARCHITECT & OWNER. CLOGGED DRAIN LINES WILL BE CLEANED SEE UNIT PRICES.

COVER & PROTECT ALL DRAIN OPENINGS AT THE BEGINNING OF EACH WORK DAY. REMOVE THE COVERS AT THE END OF EACH DAY AND BEFORE PRECIPITATION OCCURS.

PERFORM WHATEVER WORK IS REQUIRED TO RESTORE THE DRAIN LINES TO CLEAN, CLEAR, FREE FLOWING CONDITION AT THE COMPLETION OF THE PROJECT.

- 3. POWER WASH ALL ROOF AREAS TO REMOVE DIRT AND ALGAE GROWTH. CAREFULLY INSPECT THE PVC ROOFING AND RESTORE OPEN SEAMS, FAILED STRIPPING, HOLES, CUTS AND OTHER DAMAGES. REPLACE PREVIOUSLY MADE PATCHES USING NON PVC PRODUCTS. INCLUDE 2,000 LINEAL FEET OF NEW PVC STRIPPING AND 30 TARGET PATCHES IN THE BASE BID.
- 4. INSTALL NEW DRAIN LINE PIPING IN THE CEILING TO CONNECT THE NEW DRAINS TO THE EXISTING STORM SEWER LINES. REMOVE AND RESTORE PLASTER CEILINGS AS NEEDED TO INSTALL NEW PIPING. PRIME AND PAINT THE RESTORED CEILING AREAS TO MATCH THE ADJOINING SURFACE.
- 5. PREPARE AND REFILL ALL RAILING / SCREEN WALL POST PITCH POCKETS ON ROOF AREA 'E' WITH NEW POURABLE SEALER.
- 6. REMOVE TAR AND OTHER FOREIGN SUBSTANCES, AND THEN WIRE BRUSH, SCRAPE, PRIME AND PAINT THE EXISTING RAILING / SCREEN WALL ASSEMBLY AND EXHAUST FAN TRANSITION CURBS ON ROOF AREA 'E'. REMOVE LOOSE SCREEN WALL FRAMES.
- 7. INSTALL A CONCRETE SPLASH BLOCK OVER A WALKWAY PAD AT THE BOTTOMS OF THE EXISTING
- 8. RENOVATE ALL EXISTING EXHAUST FAN/VENTILATOR HOUSINGS TO BE WATERTIGHT.
- 9. RAKE-OUT ALL CROSS JOINTS IN THE PRECAST BAND UNDER THE GRAVEL STOP ON THE PERIMETER OF ROOF AREA 'C', AND INSTALL NEW BACKER ROD AND SEALANT.
- 10. RAKE-OUT THE VERTICAL MASONRY EXPANSION JOINT AND INSTALL NEW BACKER ROD AND SEALANT. 11. REMOVE EXISTING SEALANT FROM THE JOINT BETWEEN THE TWO SEPARATE DOOR SILL FLASHINGS AND COVER THE JOINT WITH 5" WIDE EPDM STRIPPING.
- 12. DRESS DOWN THE EXISTING CAP FLASHING ALONG THE ENTIRE WALL SO IT SHEDS WATER. FASTEN CAP FLASHING WITH STAINLESS STEEL ZAMAC NAIL-IN SPACED 24" O.C. REMOVE SEALANT & ASPHALT CEMENT AND COVER ALL JOINTS IN THE CAP FLASHING WITH 5" WIDE EPDM STRIPPING.
- 13. COVER SPLIT GRAVEL STOP JOINT COVER PLATE STRIPS WITH NEW PVC STRIPPING. INCLUDE 200 NEW
- PVC COVER PLATE STRIPS IN THE BASE BID.
- 15. SECURE LOOSE CAP FLASHINGS AT THE ROOF TRANSITION AND RIVET OPEN JOINTS.

14. RESTORE THE EXISTING WINDOW SO THAT IT PROPERLY CLOSES AND REMAINS CLOSED.

- 16. REMOVE AND REPLACE BRIDGING PVC BASE FLASHING WITH NEW PVC FLASHING.
- 17. REMOVE SEALANT FROM WEEP HOLES.
- 18. OVERLAY EXISTING STRIPPING ALONG THE ENTIRE GUTTER EAVE ON ROOF AREA 'B' AND IN THE
- 19. INSTALL NEW TWO PIPE SNOW GUARDS ON ROOF AREA 'B' (SEE DETAIL 2/A-2).

VALLEY AT THE ROOF DRAINS ON ROOF AREA 'C', WITH 9 INCH WIDE PVC STRIPPING.

- 20. COVER FAILED PVC FLASHING AT EXISTING ROOF DRAIN WITH NEW PVC TARGET PATCH.
- 21. REMOVE SEALANT BETWEEN THE EXISTING CAP FLASHING AND CONCRETE PANEL AND INSTALL NEW
- BACKER ROD AND SEALANT. 22. REPLACE A CRACKED SKYLIGHT DOME WITH A NEW CLEAR DOUBLE POLYCARBONATE DOME.
- 23. REMOVE LOOSE INSULATION FASTENERS AND PLATES, INSTALL NEW #14 SCREWS WITH 3" INSULATION PLATES AND PVC TARGET PATCHES.
- 24. REMOVE AND REPLACE BRICKS AT THE CRACK IN THE WALL.
- 25. REMOVE ASPHALT CEMENT FROM FACADE...
- 26. REMOVE ASPHALT CEMENT AND SEALANT FROM JOINTS, RAKE OUT JOINTS AND INSTALL BACKER ROD AND SEALANT.
- 27. CLEAN, WIRE BRUSH, SCRAPE, PRIME AND PAINT THE EXISTING EXHAUST FAN TRANSITION CURBS ON ROOF AREA 'A'.
- 28. AT CONCRETE PANEL-POWER WASH AND INSTALL WATERPROOFING COATING.
- 29. POWER WASH AND INSTALL WATERPROOFING COATING FROM GROUND LEVEL TO GRAVEL STOP.
- 30. LOUVERS-RAKE OUT SEALANT JOINTS AND INSTALL BACKER ROD AND SEALANT ALL AROUND LOUVERS'
- 31. REMOVE AND INSTALL NEW ROOF DRAINS AT ABANDONED ROOF DRAINS. REPLACE DAMAGED PIPES, SUPPORTS & FITTING. REMOVE AND RESTORE PLASTER CEILINGS AND WALLS TO MAKE THE RESTORATION. PRIME AND PAINT THE RESTORED CEILING AND WALL AREAS TO MATCH THE ADJOINING SURFACE. INSULATE THE DRAIN BOWL, THE NEW PIPE AND EXISTING PIPE THAT IS CURRENTLY NOT INSULATED (APPROXIMATELY 6'-0" OF NEW INSULATION AT EACH ROOF DRAIN). SEE DETAIL 1/A-2
- 32. BASE BID INCLUDES 50 TARGET PATCHES-(12 INCHES x 12 INCHES) AND 6 TARGET PATCHES AT ROOF DRAINS- 5FT X 5 FT.

<u>LEGEND</u>

- ROOF AREA DESIGNATION
- EXISTING GUTTER DRAIN (SEE NOTE 2)
- EXISTING ROOF DRAIN (SEE NOTE 2)

(SEE NOTE 4)

- NEW ROOF DRAIN
- (SEE DETAIL 1/A-2) NEW DRAIN LINE
- P P EXISTING RAILING / SCREEN WALL
- _____ (SEE NOTES 5 AND 6)
- **NEW SNOW GUARDS** =:=:=:=:=(SEE DET. 2/A-2)
 - (SEE NOTE 7)

EXISTING SCUPPER & LEADER HEAD

- EXISTING EXHAUST FAN (SEE NOTE 8)
- AC UNIT
- ■P SEALANT POCKET
- o ∨ EXISTING VENT PIPE
- EXISTING SKYLIGHT
- EXISTING ROOF ACCESS DOOR
- NEW ROOF LADDER (SEE DETAIL 4/A-2)

EXISTING CHIMNEY
(SEE DETAIL 5/A-2)

NEW WALKWAY PADS

ROOF PROTECTION NOTES:

1. AVOID WALKING OR TRAFFICKING OVER ROOF AREAS UNLESS PERFORMING THE SPECIFIED CORRECTIVE WORK. 2. AT ROOF STAGING AREAS AND AREAS WHERE NEW BUILT IN CAP FLASHINGS ARE BEING INSTALLED INSTALL 1" THICK EXTRUDED POLYSTYRENE INSULATION, 6 MIL FIRE RETARDANT POLYETHYLENE AND 2x10 WOOD PLANKS TO PROTECT THE EXISTING PVC ROOFING WHEN CONSTRUCTION WORK OCCURS.

3. NEATLY CUT AND POSITION ROOF PROTECTION COMPONENTS TO FIT WITHIN 1/2" OF ROOF PENETRATIONS, EAVES AND CHANGE IN ELEVATION WALLS.

4. DO NOT COVER THE ROOF DRAINS. MAINTAIN THE ROOF DRAIN STRAINERS VISIBLE AND CLEAR AT ALL TIMES.

ENGINEER: <u>Ph: 315-735-1916 Fax: 315-735-6365</u> www.erengpc.com

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E&R PROJECT NO.

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03.01.2022 REVISION DATE 03.01.2022 DRAWN BY CHECKED BY SHEET SIZE

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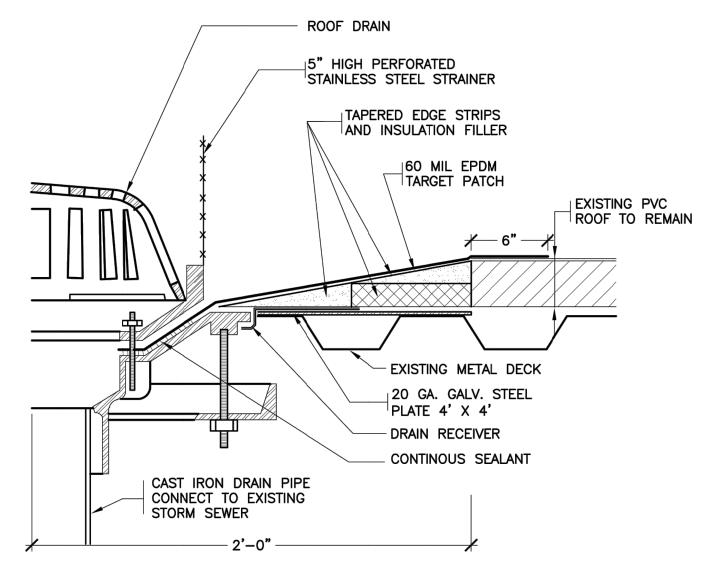
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AS SHOWN

SHEET TITLE

SCALE

SHEET NO. **A-** J




1. REMOVE 4 FOOT SQUARE AREA OF EXISTING ROOFING TO INSTALL NEW ROOF DRAIN AND DRAIN SUMP.


2. INSTALL TAPERED EDGE STRIPS & INSULATION FILLERS TO CREATE A 4 FT \times 4 FT. SQUARE SUMP AT EACH DRAIN.

3. SEE ROOF PLAN FOR LOCATION OF NEW ROOF DRAINS. AT NEW DRAIN LOCATIONS CUT THE EXISTING DECK AND REINFORCE THE DECK OPENING WITH (2) 2 1/2" X 2 1/2" X 1/4" STEEL ANGLES BOLTED TO THE EXISTING STEEL FRAMING.

4. INSULATE THE BOTTOM OF BOWL AND NEW PIPE.

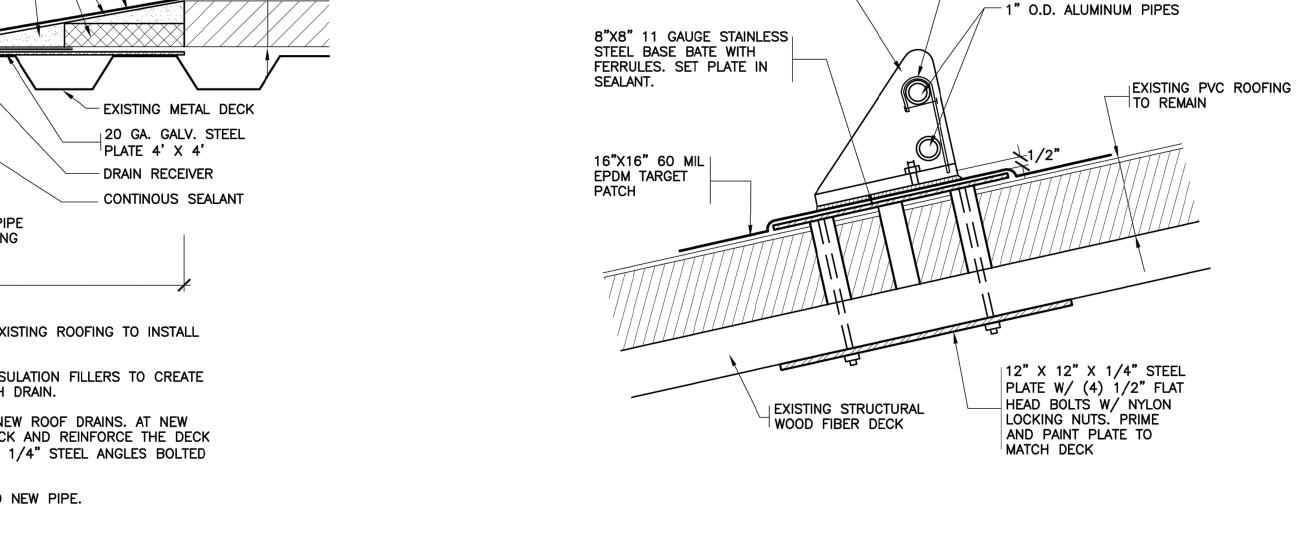



ALPINE SNOW GUARDS #115R BRACKET 4'-0" O.C. SET IN FULL BED OF SEALANT

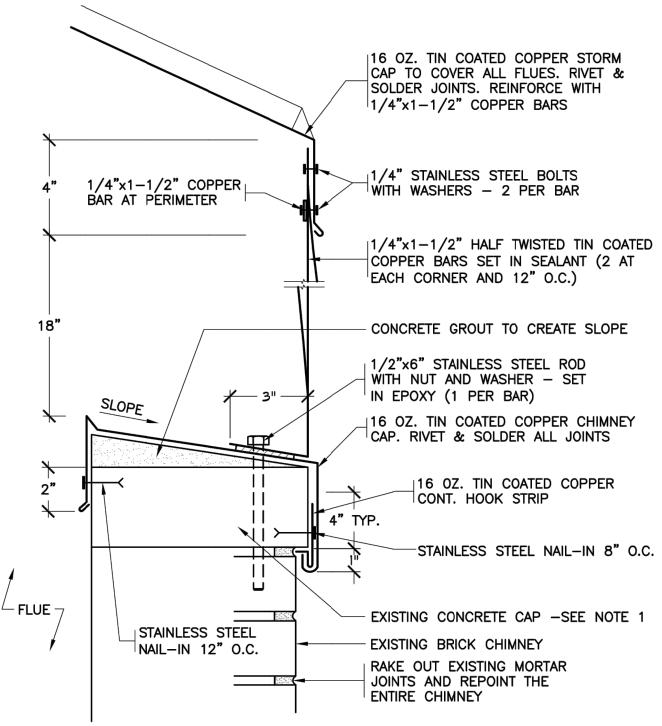

1. REPOSITION DISPLACED CONCRETE CAP ON LARGE CHIMNEY ON AREA 'A' TO IT'S ORIGINAL POSITION. PIN THE CONCRETE CAP TO THE CHIMNEY WITH 12" LONG EPOXY COATED REBARS, SET IN EPOXY, SPACED 12" O.C. 2. REPLACE ALL DAMAGED AND CRACKED BRICKS. RAKE OUT AND REPOINT THE ENTIRE CHIMNEY.

3. COVER THE ENTIRE CHIMNEY TOP WITH 16 OZ. TIN COATED COPPER CHIMNEY CAP. RIVET AND SOLDER ALL JOINTS. SEE NEW CHIMNEY CAP AXON DET. 5A/A-2.

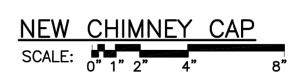


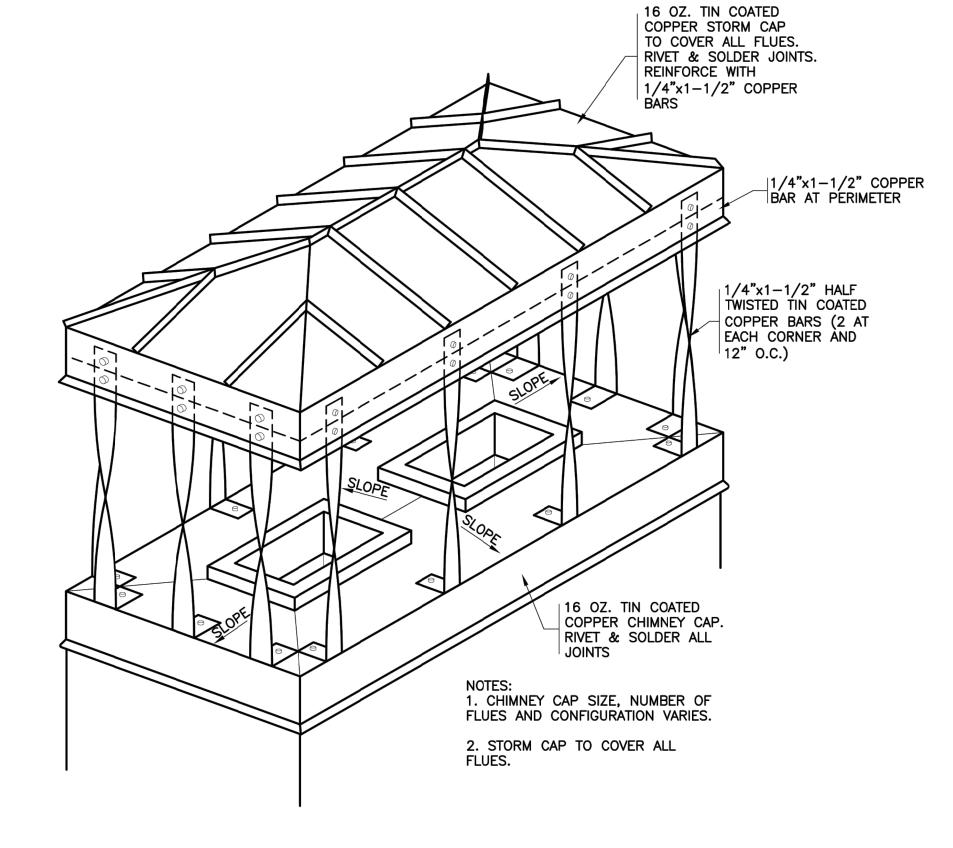


ALPINE SNOW GUARDS


#95 ICE FLAG - 8" O.C.
POSITIONED 1/2" ABOVE
ROOF SURFACE

NEW CHIMNEY STROM CAP AXON SCHEMATIC: N.T.S.

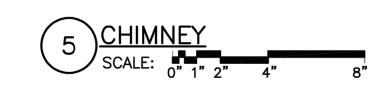

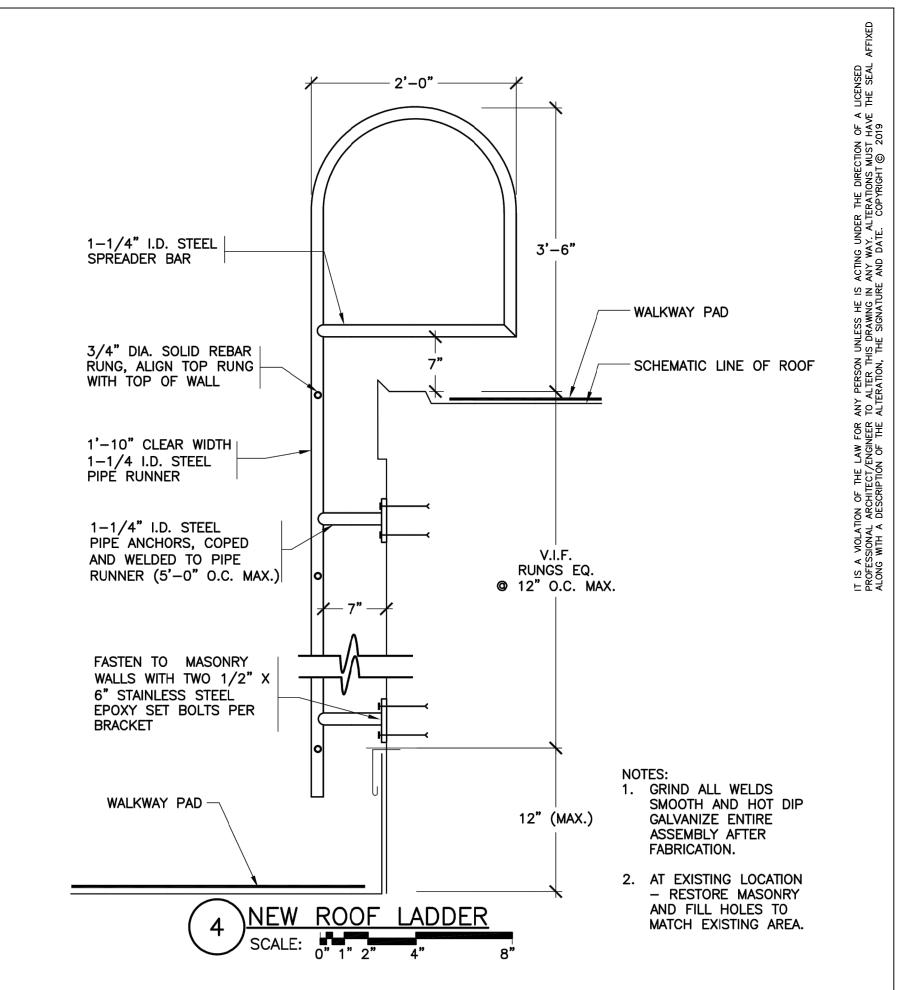



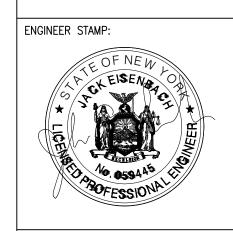

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