NO.	ISSUANCE	DATE	REVISION	
1	DESIGN DRAWING SET	10-11-2019		
2	BID	02-16-2022		

YONKERS PUBLIC SCHOOLS

One Larkin Center, Yonkers, New York 10701

MULTIPLE BUILDING ENVELOPE RENOVATIONS & RELATED WORK GROUP B AT SCHOOL 29 & PEARLS HAWTHORNE SCHOOL

LIST OF DRAWINGS

GENERAL:

LOCATION MAP, ABBREVIATIONS, LEGENDS, GENERAL NOTES, GENERAL WINDOW NOTES & GENERAL


PS29-A628

PHS-A110

PHS-A626 ROOF DETAILS PHS-A628 DOOR SCHEDULE

PARTIAL BASEMENT PLAN & DETAILS

PARTIAL BASEMENT PLAN, PARTIAL FIRST FLOOR PLAN, PARTIAL SECOND FLOOR PLAN &

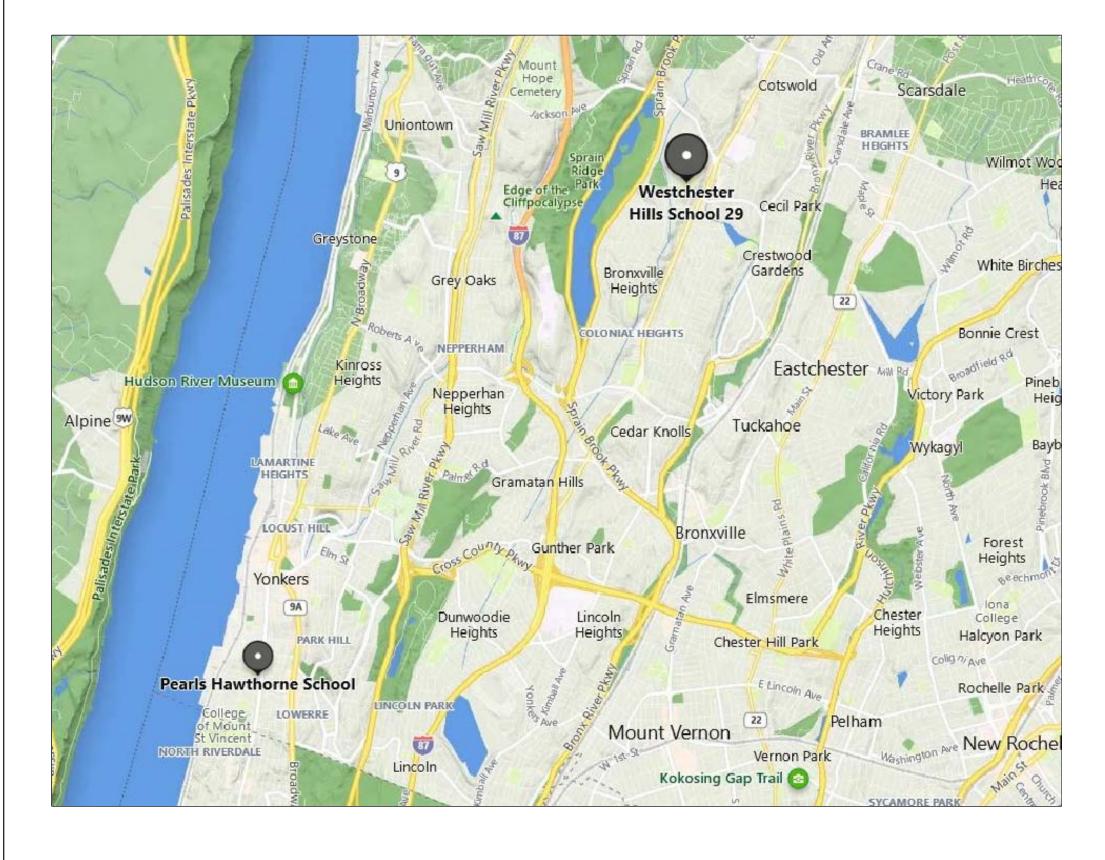

PROJECT LOCATION MAP

SCALE: N.T.S.

PS 29 - 47 CROYDON ROAD YONKERS, NY 10710 PEARLS HAWTHORNE - 350 HAWTHORNE AVENUE YONKERS, NY 10705

DESIGN TEAM:

ARCHITECT FULLER AND D'ANGELO P.C.

45 KNOLLWOOD ROAD ELMSFORD, NY 10523 phone: 914.592.4444 fax: 914.592.1717

ENVIRONMENTAL CONSULTANTS WARREN & PANZER

228 EAST 45TH STREET NEW YORK, NY 10017 phone: 212.922.0077 fax: 212.922.0630

ROOF WATSKY ASSOCIATES

20 MADISON AVENUE VALHALLA, NY 10595 phone: 914.948.3450

SED#

PS 29 PEARLS HAWTHORNE

#66-23-00-01-0-029-011 #66-23-00-01-0-101-008

YPS JOB

10867 10869

YONKERS PUBLIC SCHOOLS

BOARD OF EDUCATION

Rev. Steve Lopez, President Dr. Rosalba Corrado Del Vecchio, Vice President

Sheila Greenwald

Andrea Brown

Kevin Cacace

Dr. John Castanaro

Rosemarie P. Linton


Amjed I. Kuri


Gail Burns

Dr. Edwin M. Quezada Superintendent of Schools


John P. Carr **Executive Director** School Facilities Management

FEBRUARY 16, 2022

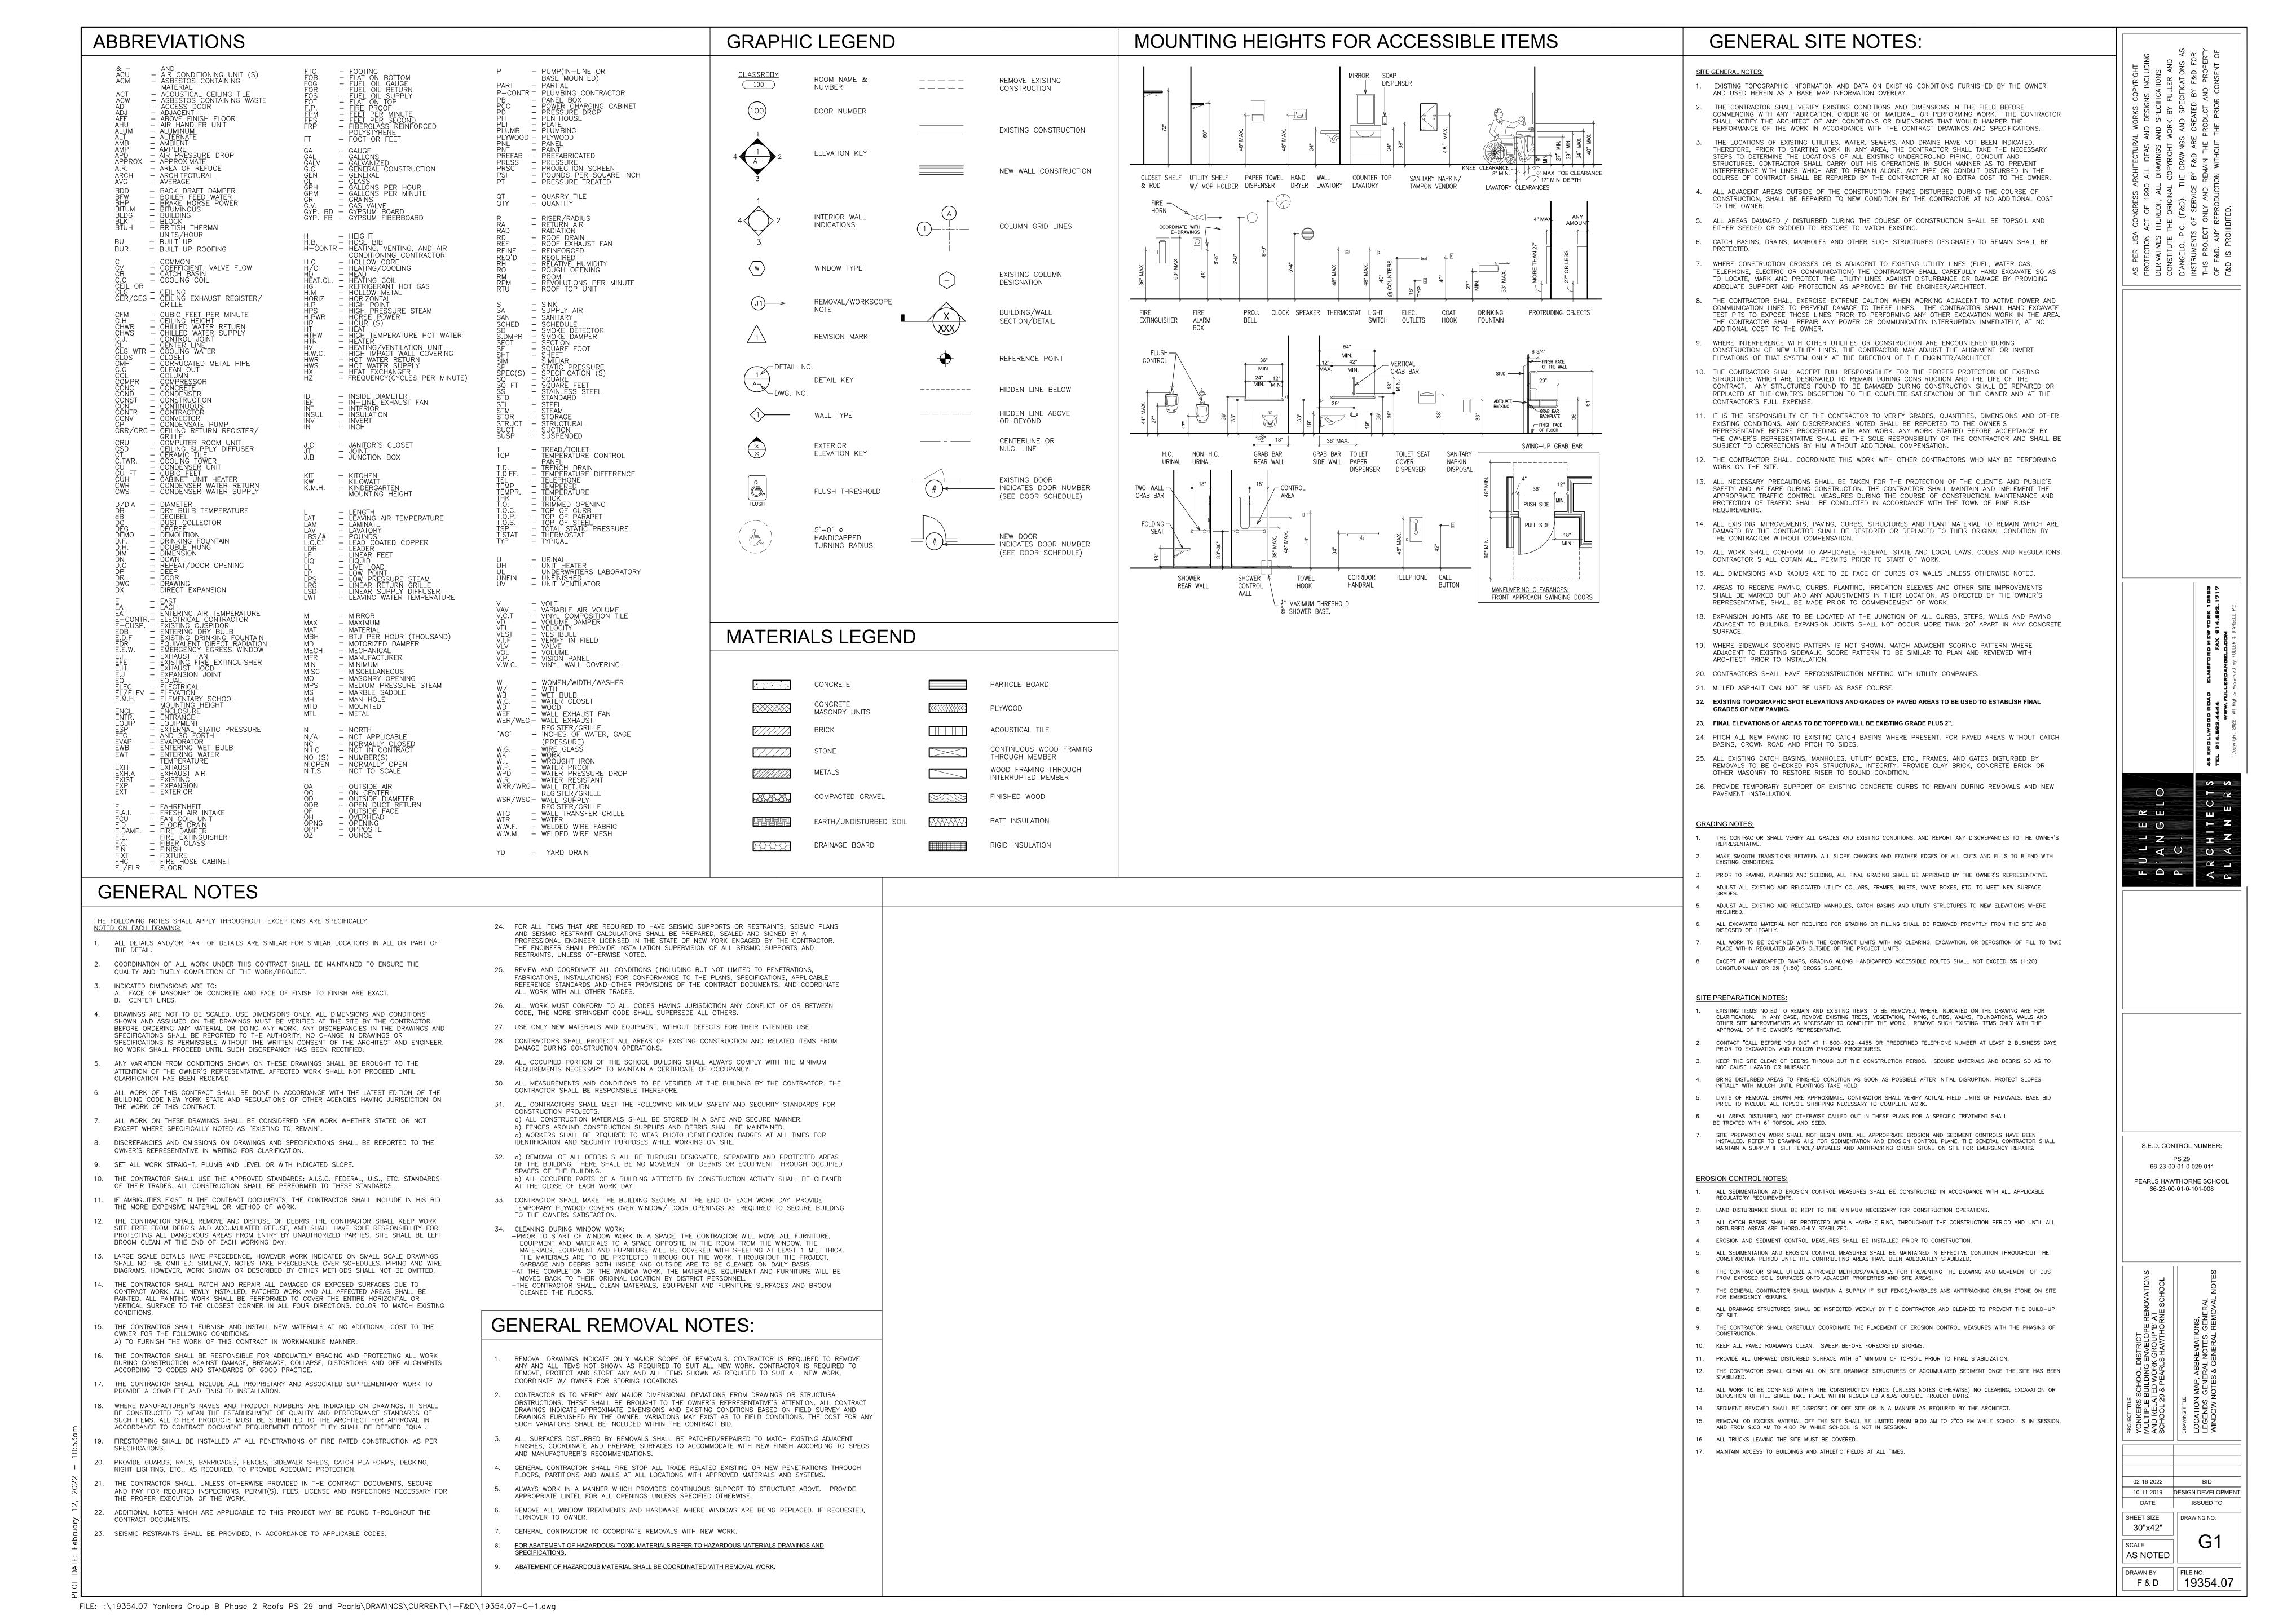

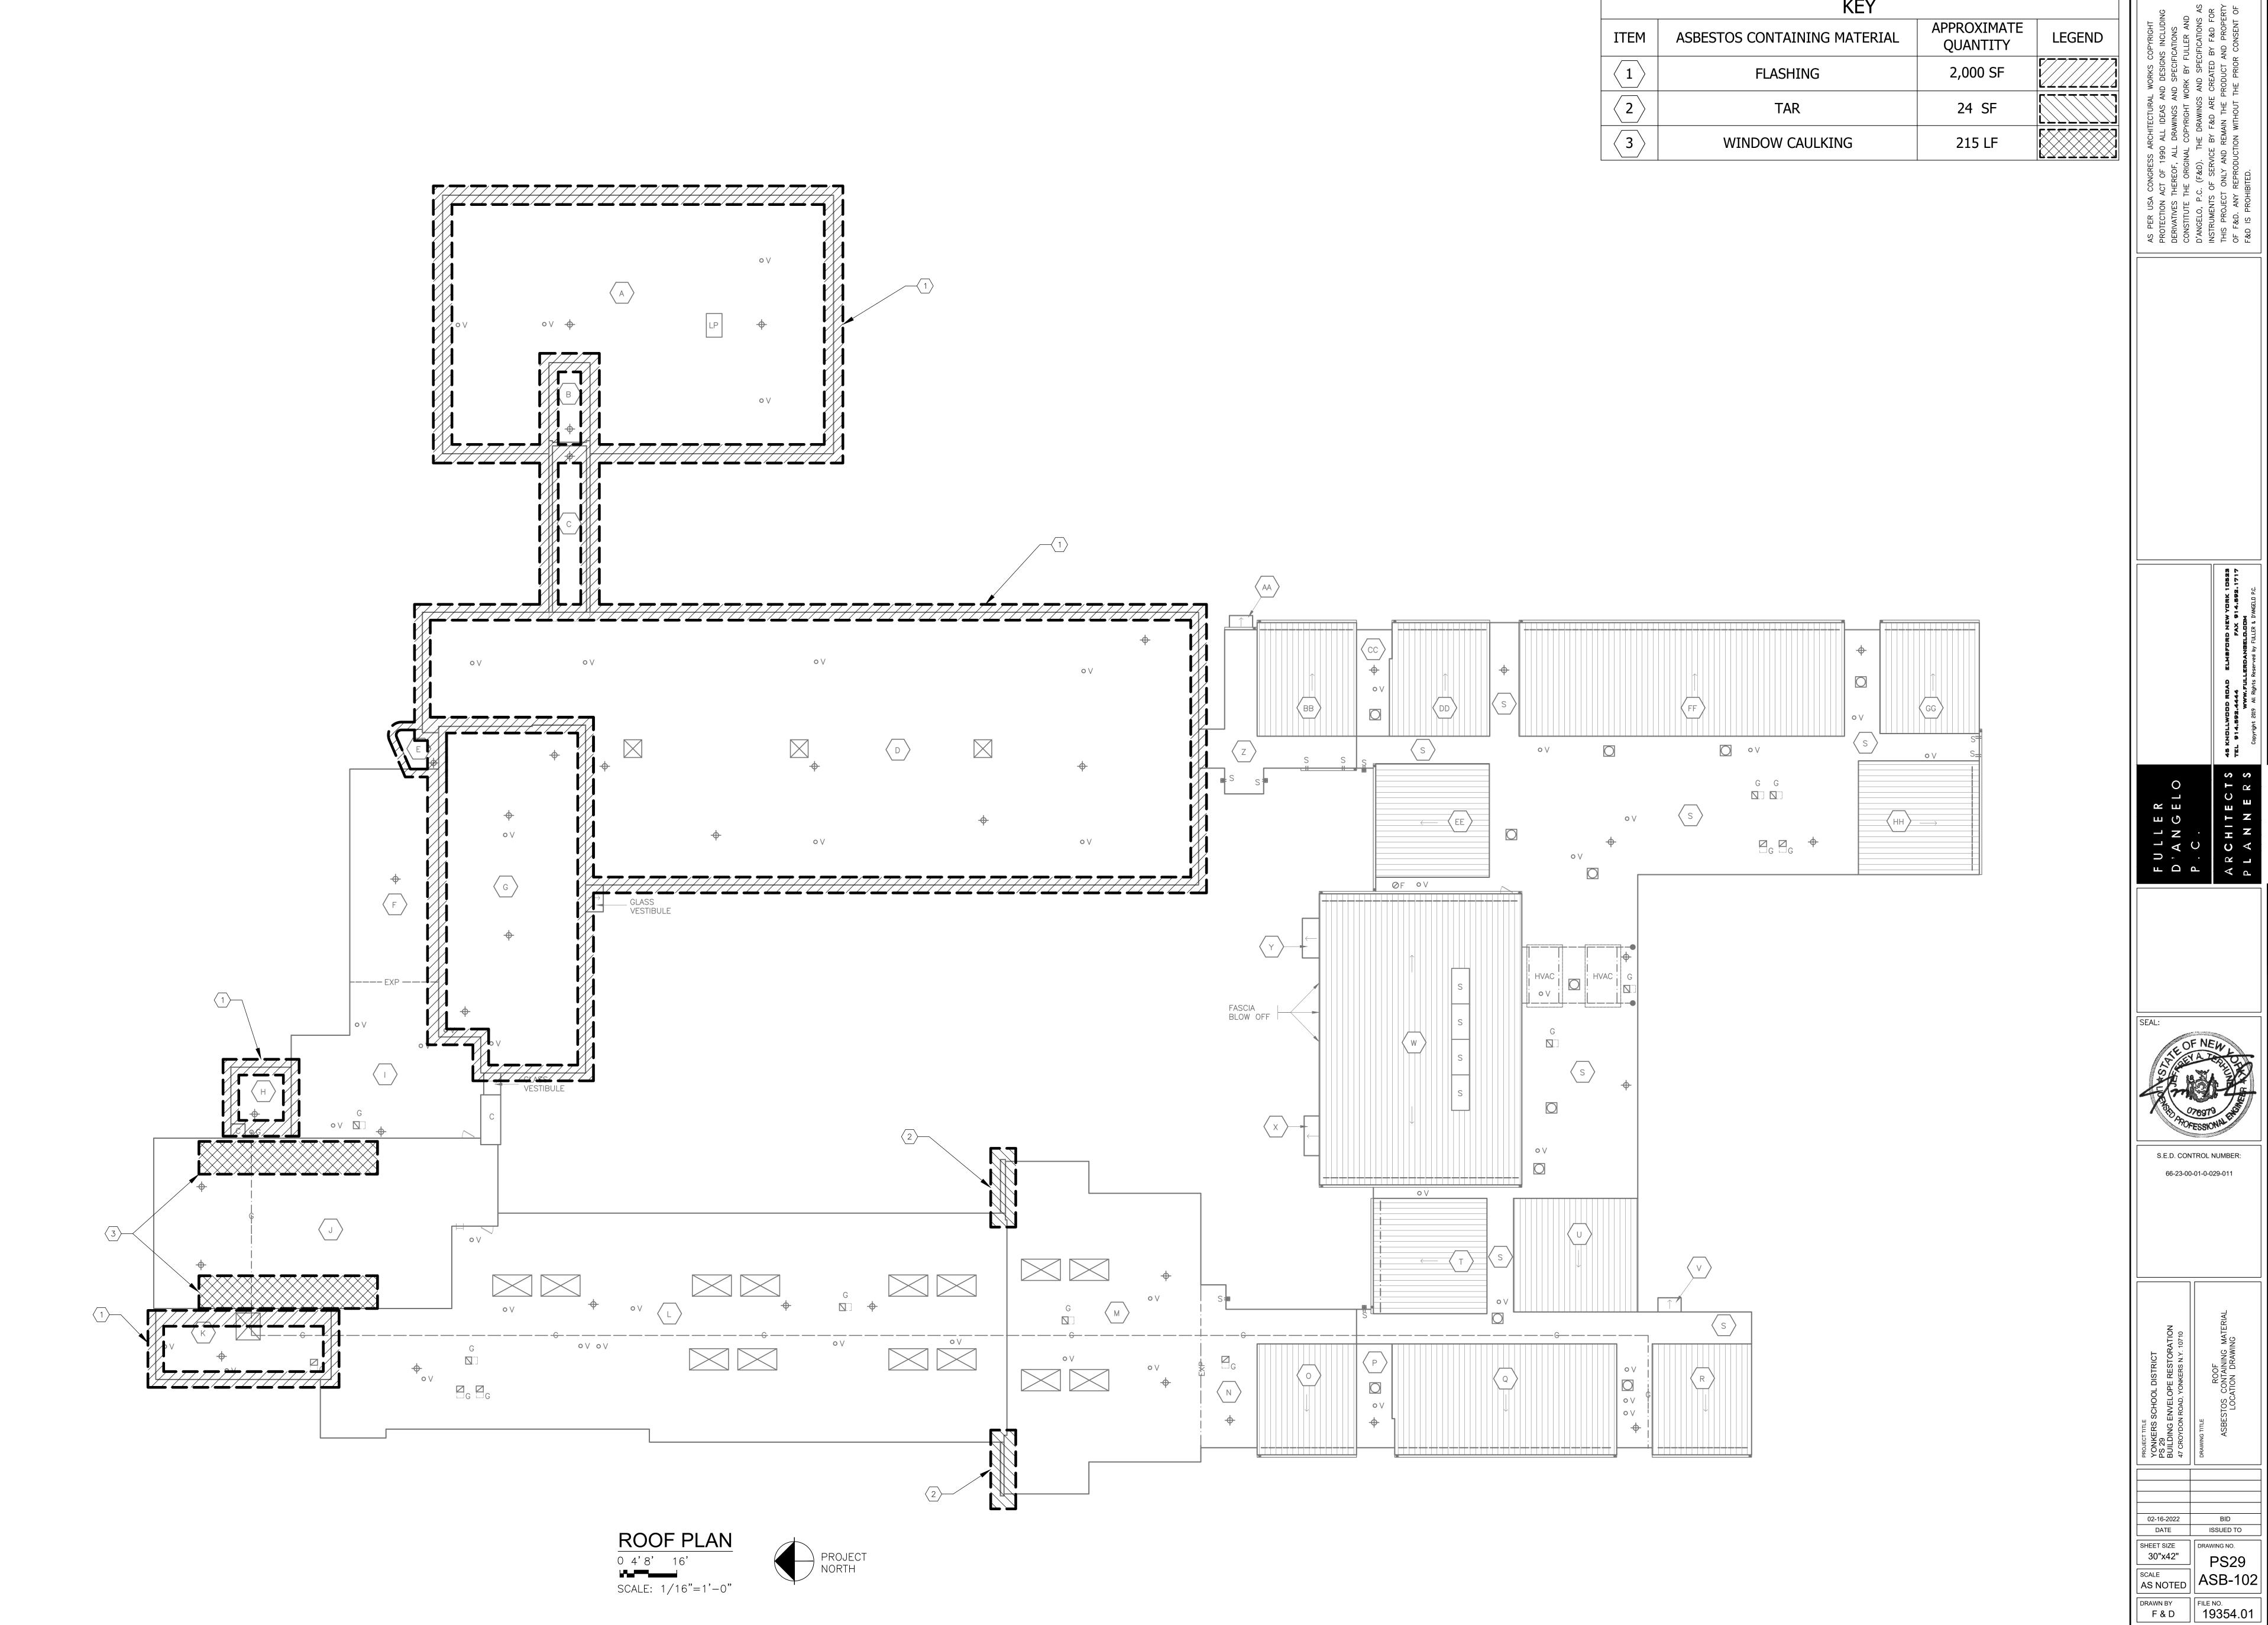

KEY

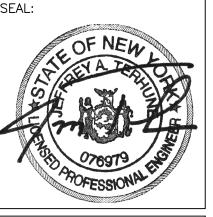



|| ASB-102|

FILE: C:\Users\AV\Warren and Panzer Engineers, P.C\CAD — Documents\258 Fuller DAngelo\19 — Yonkers Public Schools\07 — PS 29\258.19.07 WP ACM Drawing 30X42.dwg

	KEY		
ITEM	ASBESTOS CONTAINING MATERIAL	APPROXIMATE QUANTITY	LEGEND
	ROOFING MEMBRANE	29,601 SF	
2	CAULKING	42 LF	
3	TAR	27 SF	
4	LENTIL WATERPROOFING	48 LF	
5	FLASHING	2,090 SF	

S PER USA CONGRESS ARCHITECTURAL WORKS COPYRIGHT ROTECTION ACT OF 1990 ALL IDEAS AND DESIGNS INCLUDING ERIVATIVES THEREOF, ALL DRAWINGS AND SPECIFICATIONS ONSTITUTE THE ORIGINAL COPYRIGHT WORK BY FULLER AND ANGELO, P.C. (F&D). THE DRAWINGS AND SPECIFICATIONS AS STRUMENTS OF SERVICE BY F&D ARE CREATED BY F&D FOR IIS PROJECT ONLY AND REMAIN THE PRODUCT AND PROPERTY F&D. ANY REPRODUCTION WITHOUT THE PRIOR CONSENT OF IS PROHIBITED.

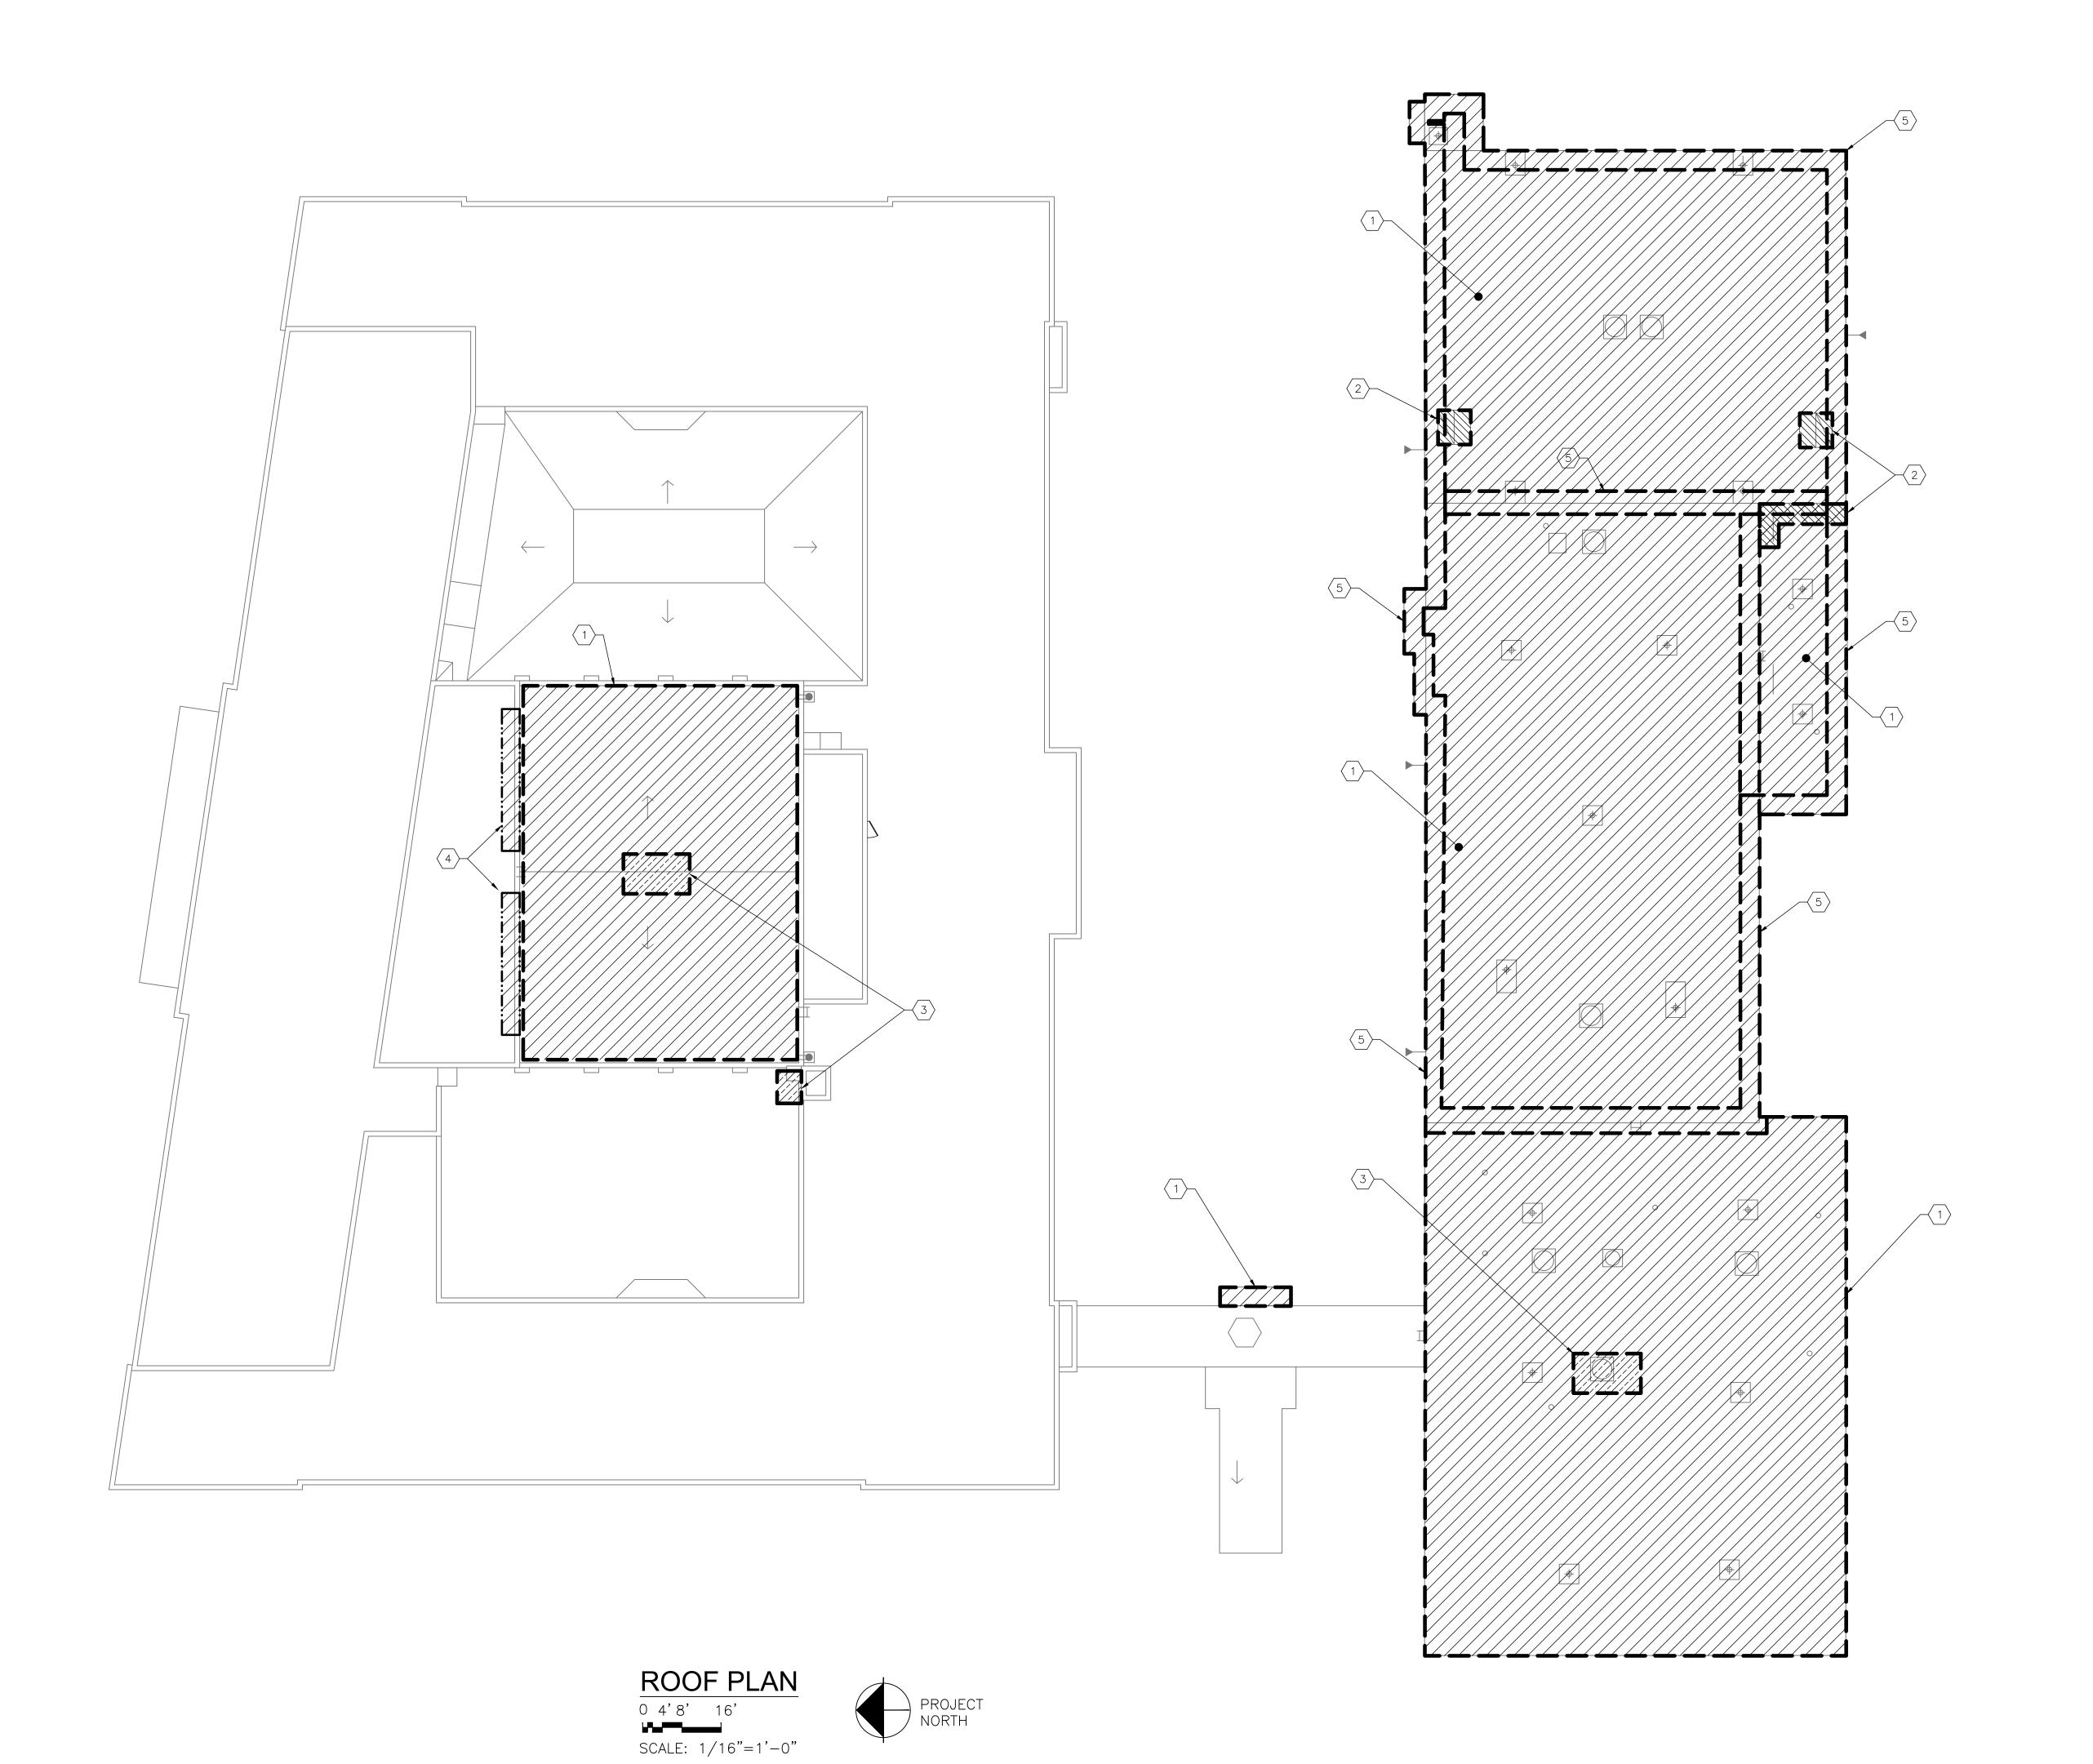

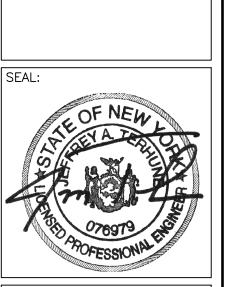

S.E.D. CONTROL NUMBER: 66-23-00-01-0-101-008

YONKERS SCHOOL DISTRICT
PEARLS HAWTHORNE
BUILDING ENVELOPE RESTORATION
350 HAWTHORNE AVENUE, YONKERS N.Y.10705

DRAWING TITLE
ROOF
ASBESTOS CONTAINING MATERIAL
LOCATION DRAWING

02-16-2022	BID
DATE	ISSUED TO
HEET SIZE	DRAWING NO.
20",42"	

SHEET SIZE
30"x42"


PHS
AS NOTED

DRAWN BY
F & D


SOCIE
AS D


DRAWN BY
F & D

FILE: C:\Users\AV\Warren and Panzer Engineers, P.C\CAD — Documents\258 Fuller DAngelo\19 — Yonkers Public Schools\08 — Perls Hawthorne\258.19.08 WP ACM Drawing 30X42.dwg

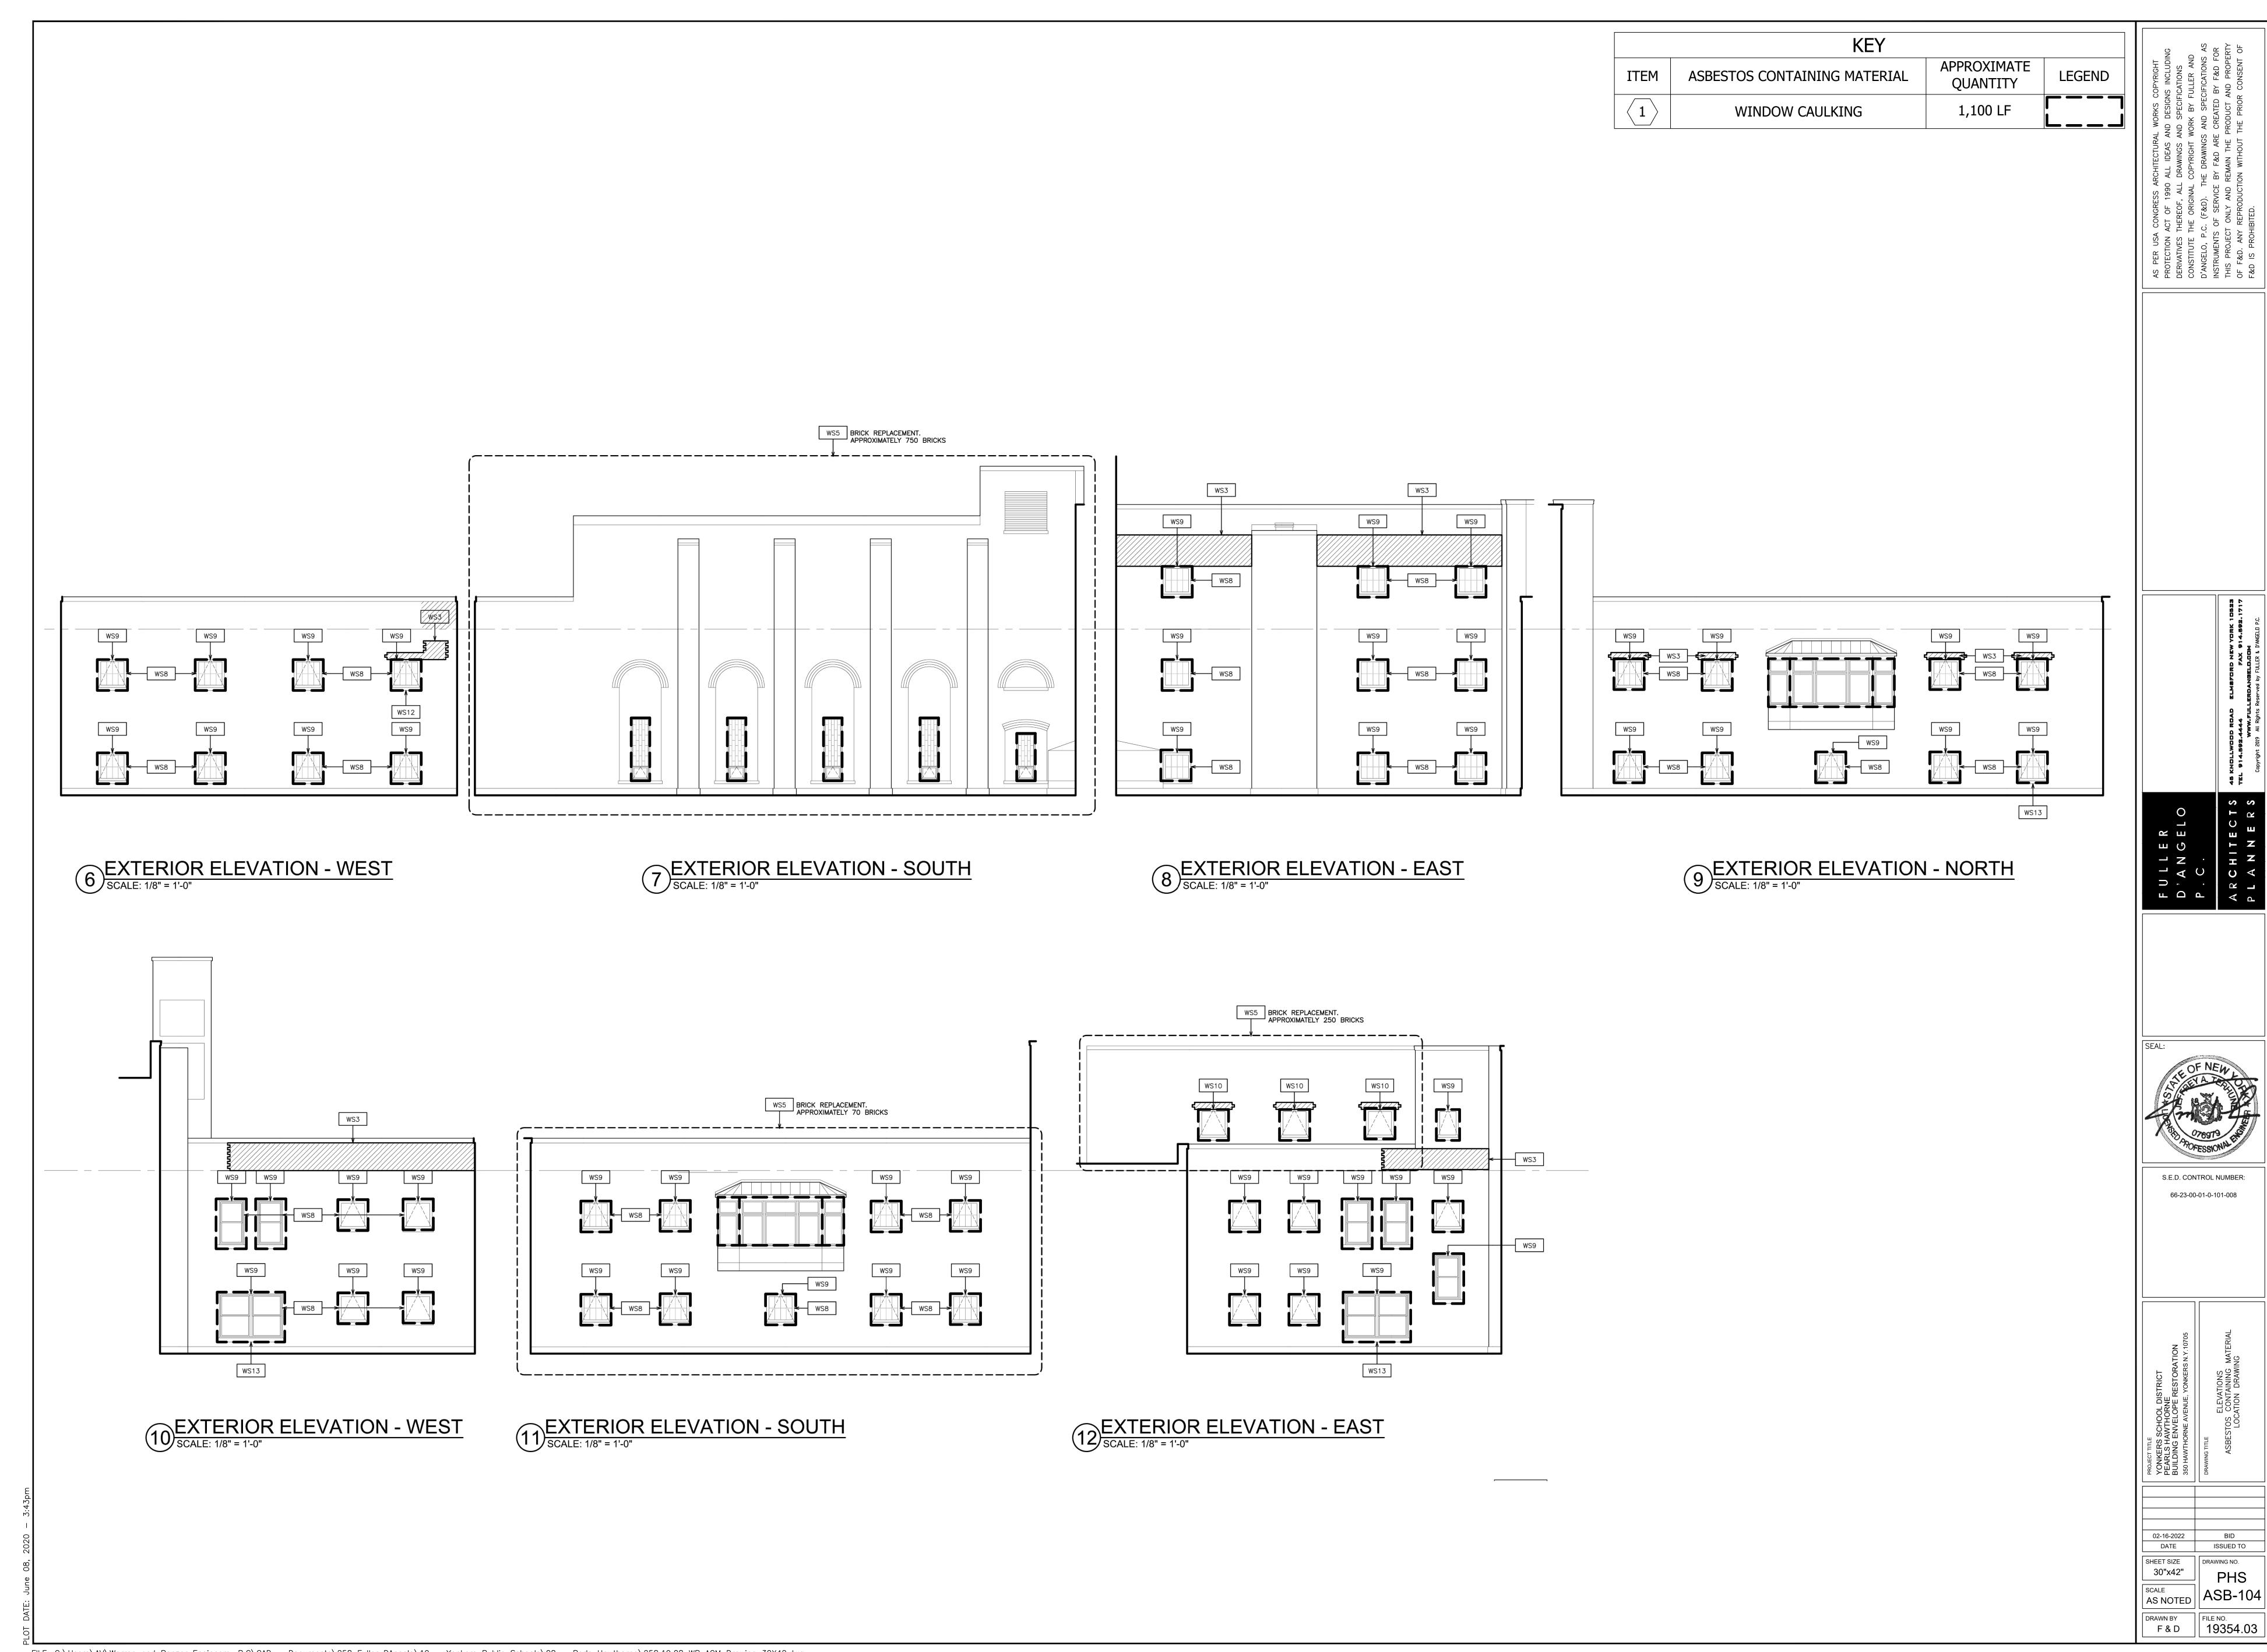


FILE: C:\Users\AV\Warren and Panzer Engineers, P.C\CAD — Documents\258 Fuller DAngelo\19 — Yonkers Public Schools\08 — Perls Hawthorne\258.19.08 WP ACM Drawing 30X42.dwg

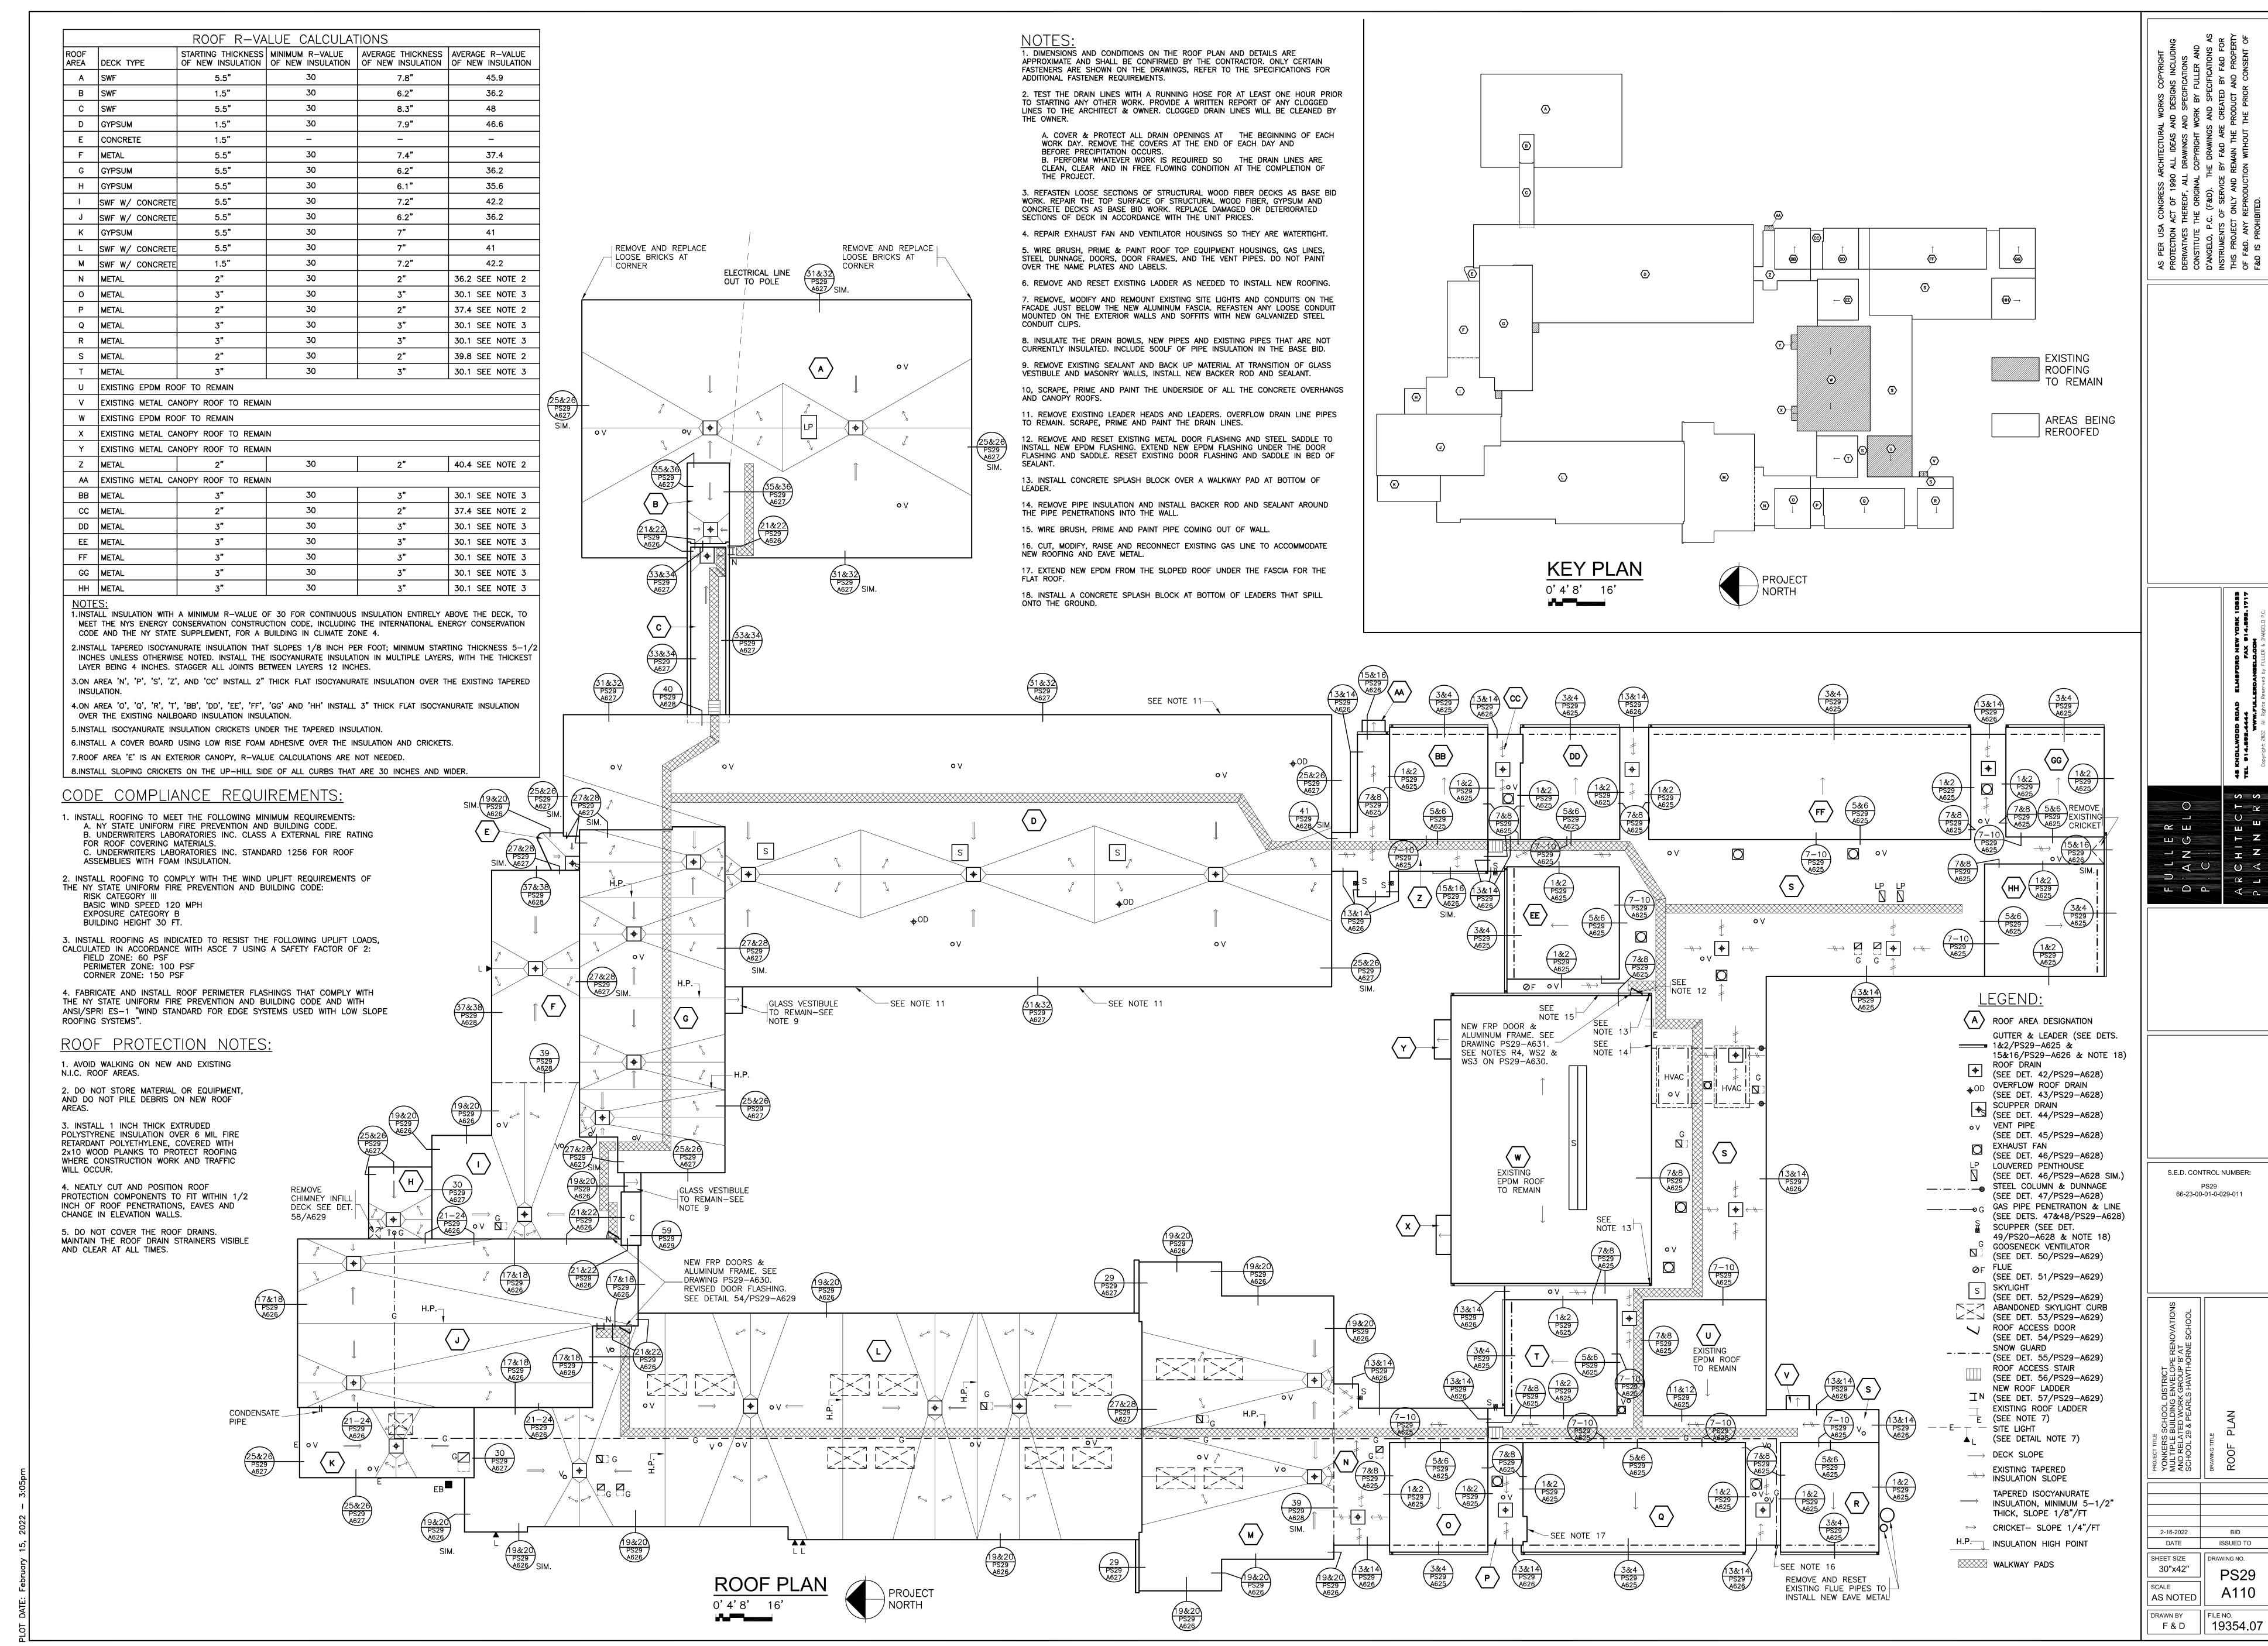


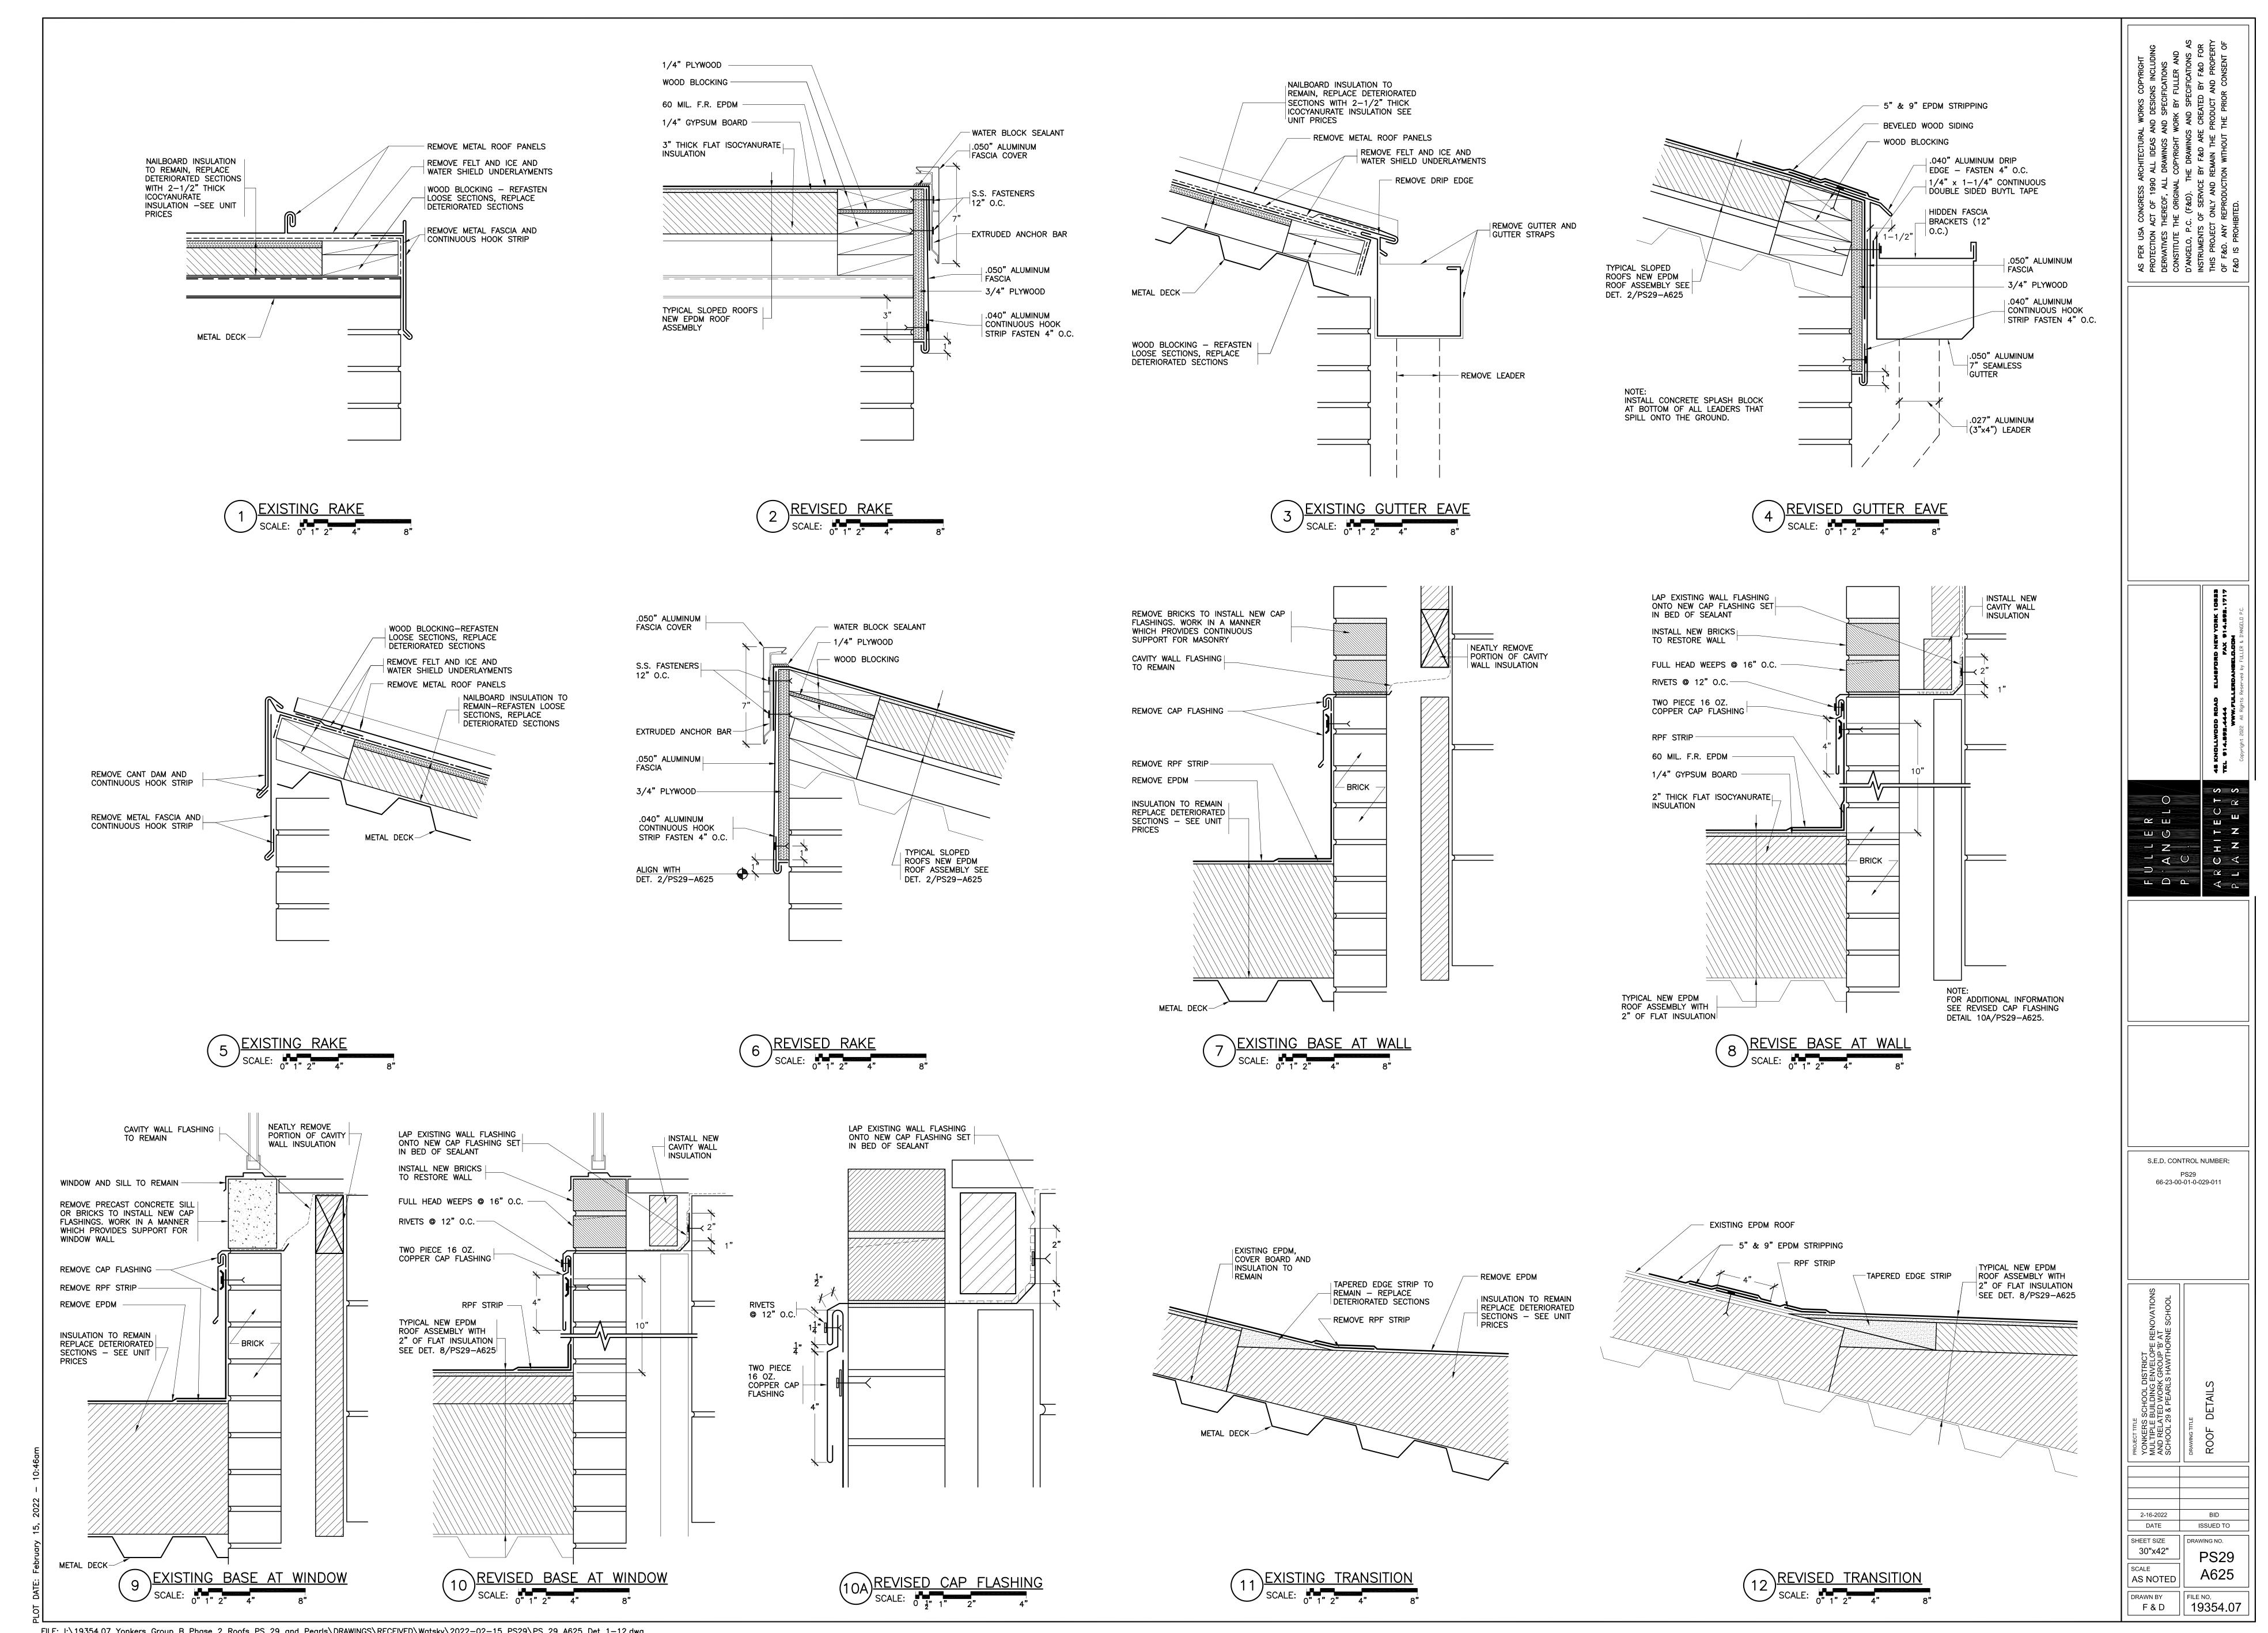


FILE: I:\19354.07 Yonkers Group B Phase 2 Roofs PS 29 and Pearls\DRAWINGS\RECEIVED\Watsky\2022-02-15 PS29\PS 29 A625 Det 1-12.dwg

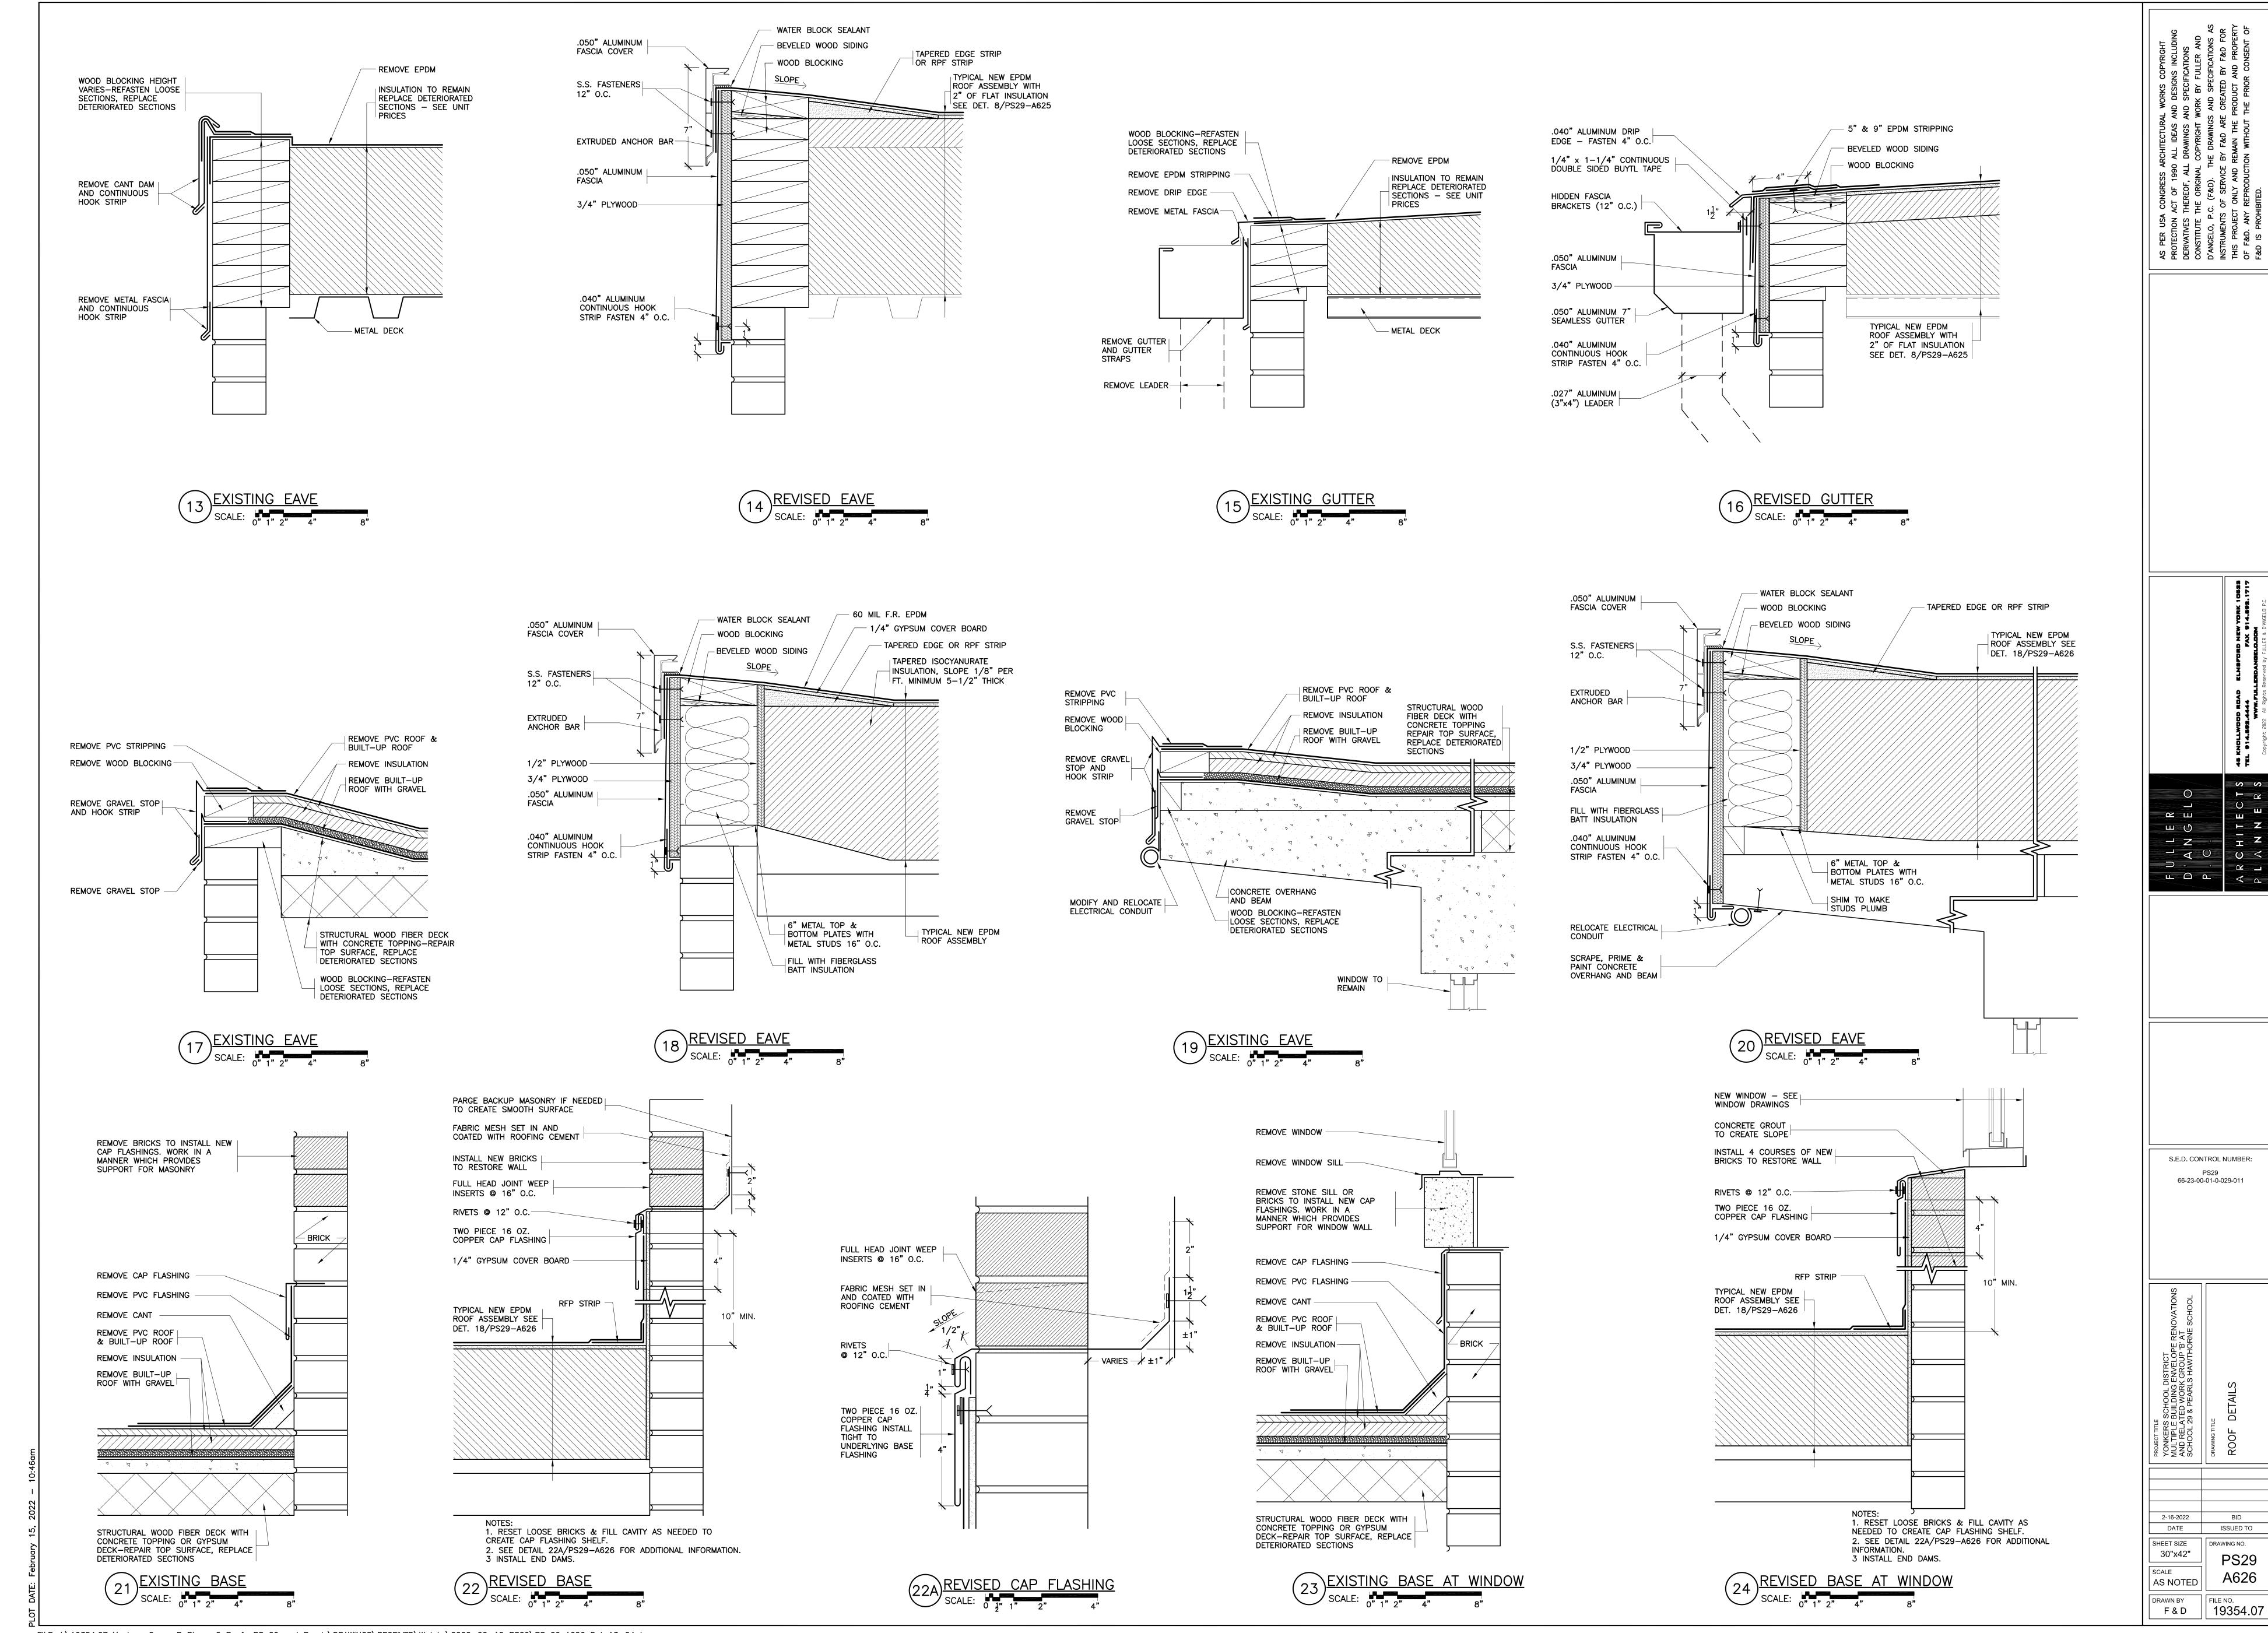



FILE: I:\19354.07 Yonkers Group B Phase 2 Roofs PS 29 and Pearls\DRAWINGS\RECEIVED\Watsky\2022-02-15 PS29\PS 29 A626 Det 13-24.dwg

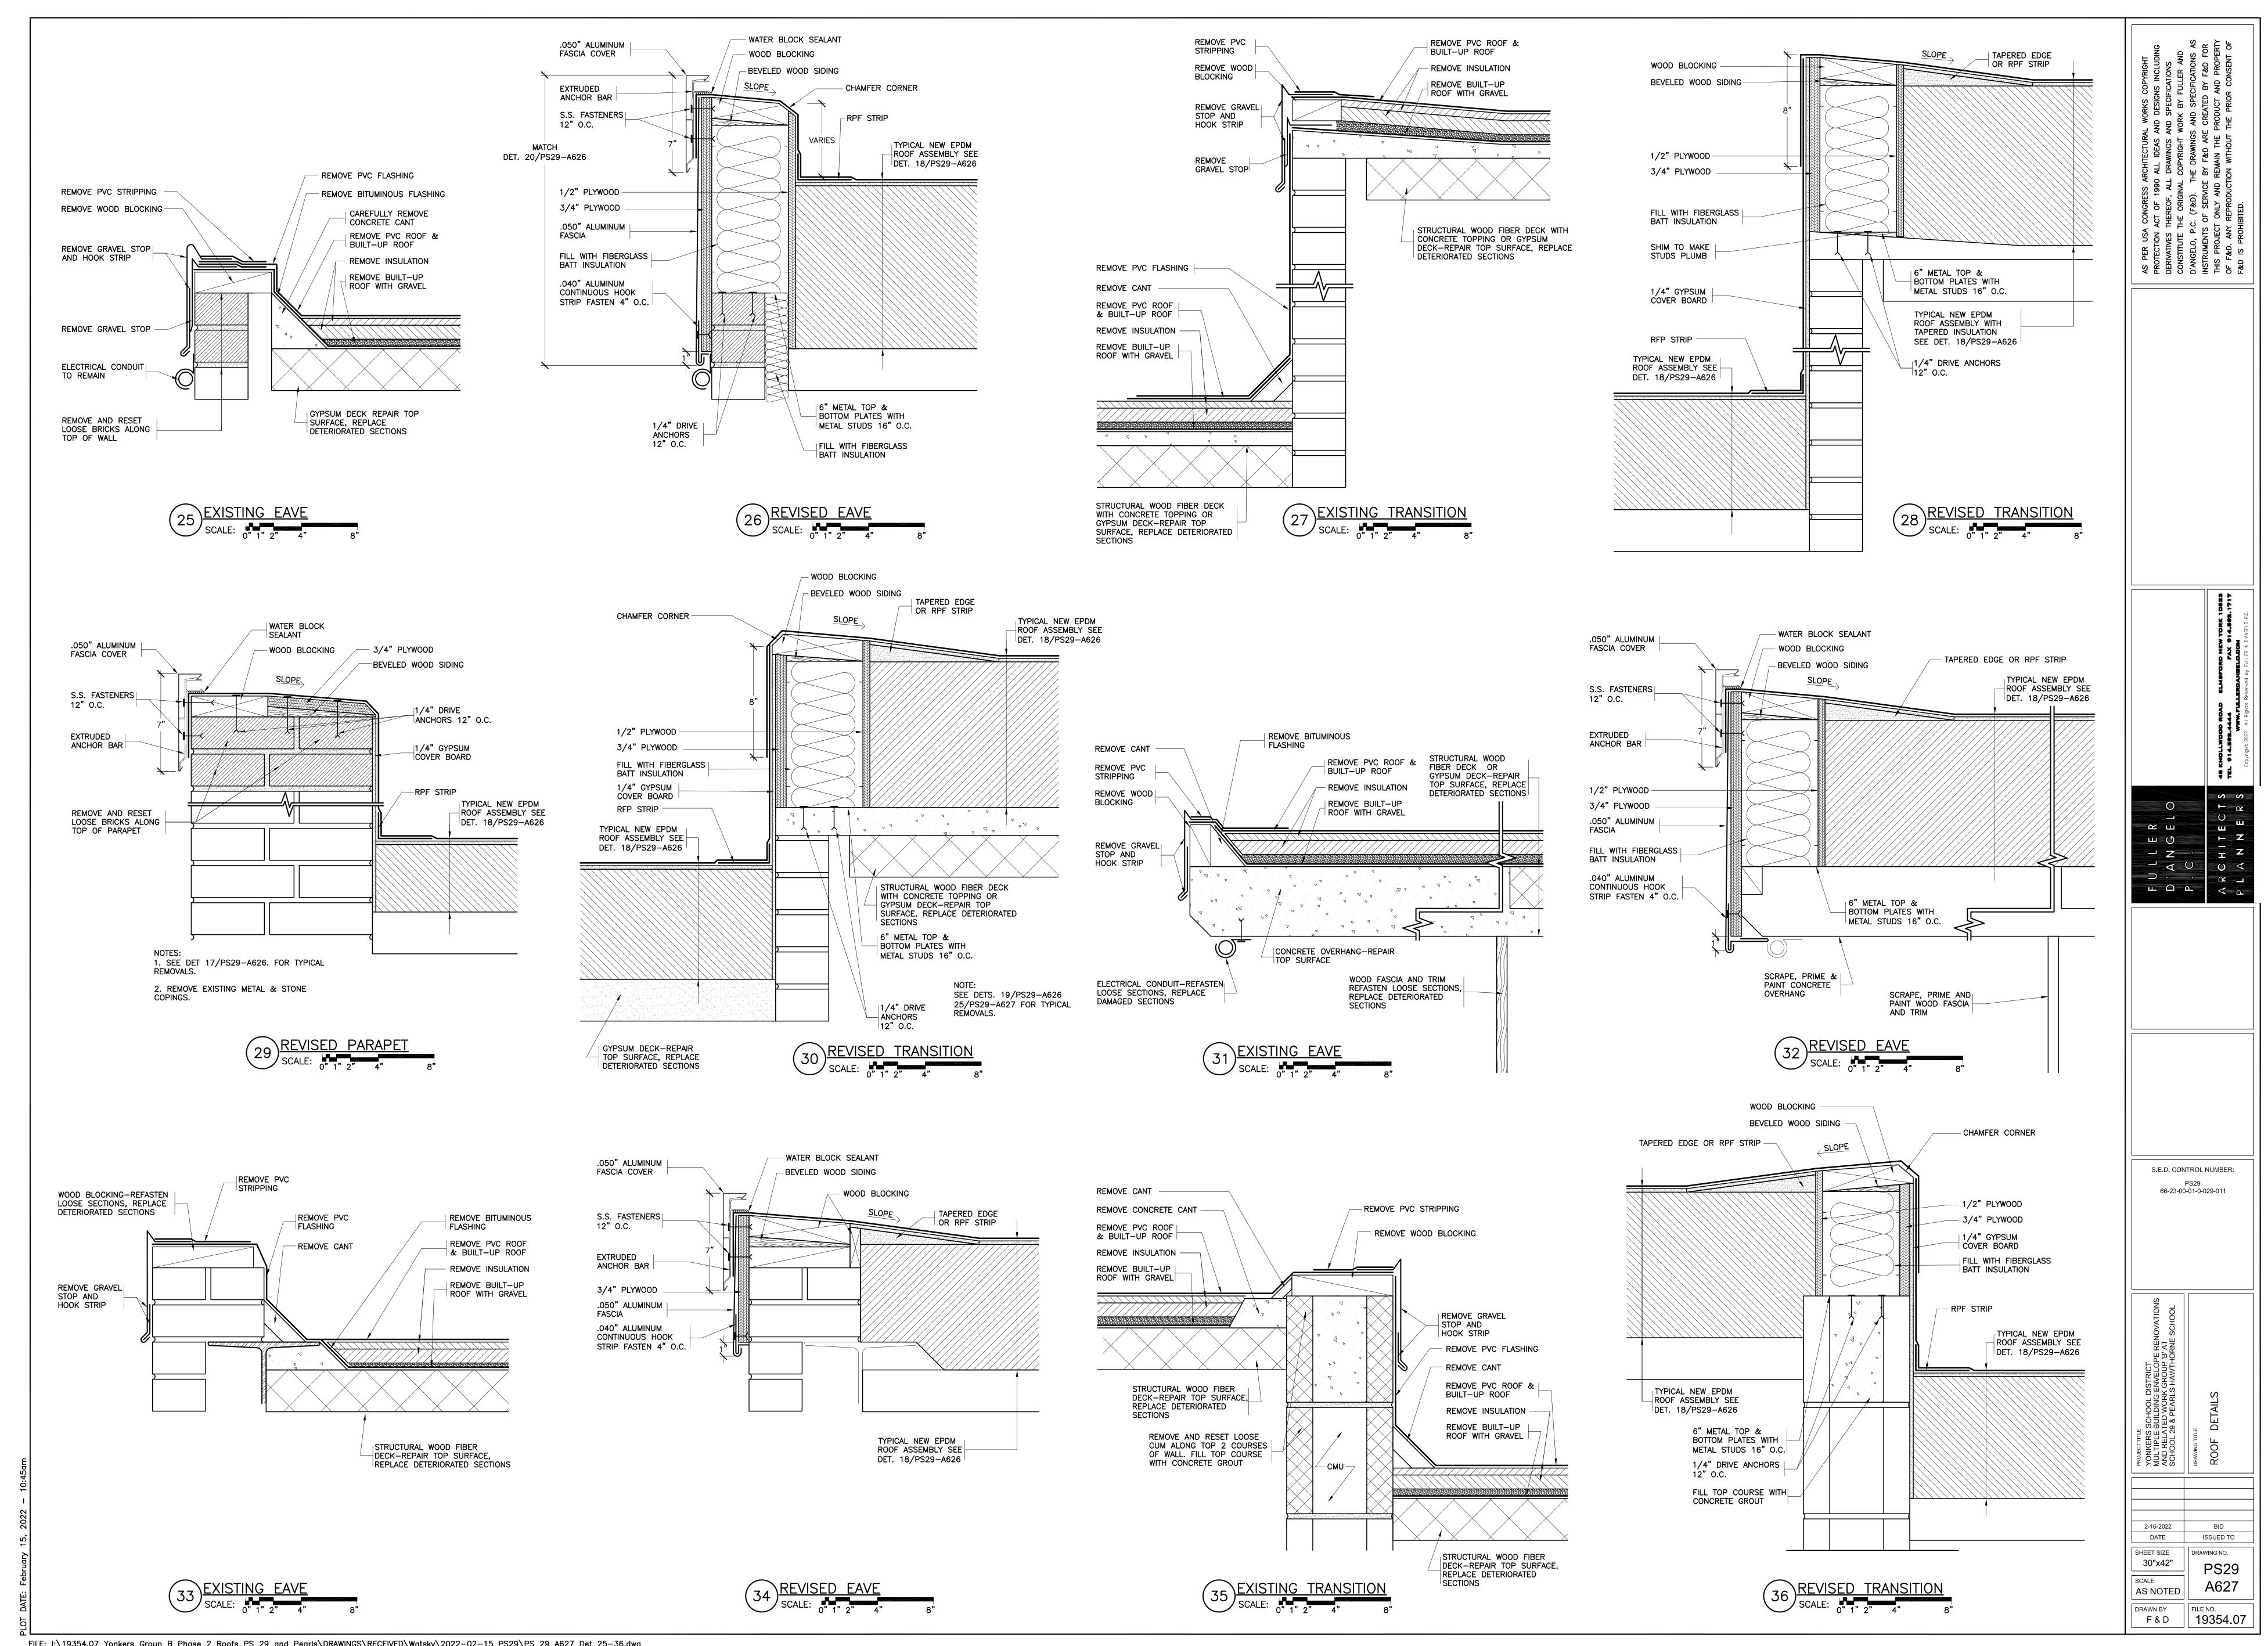


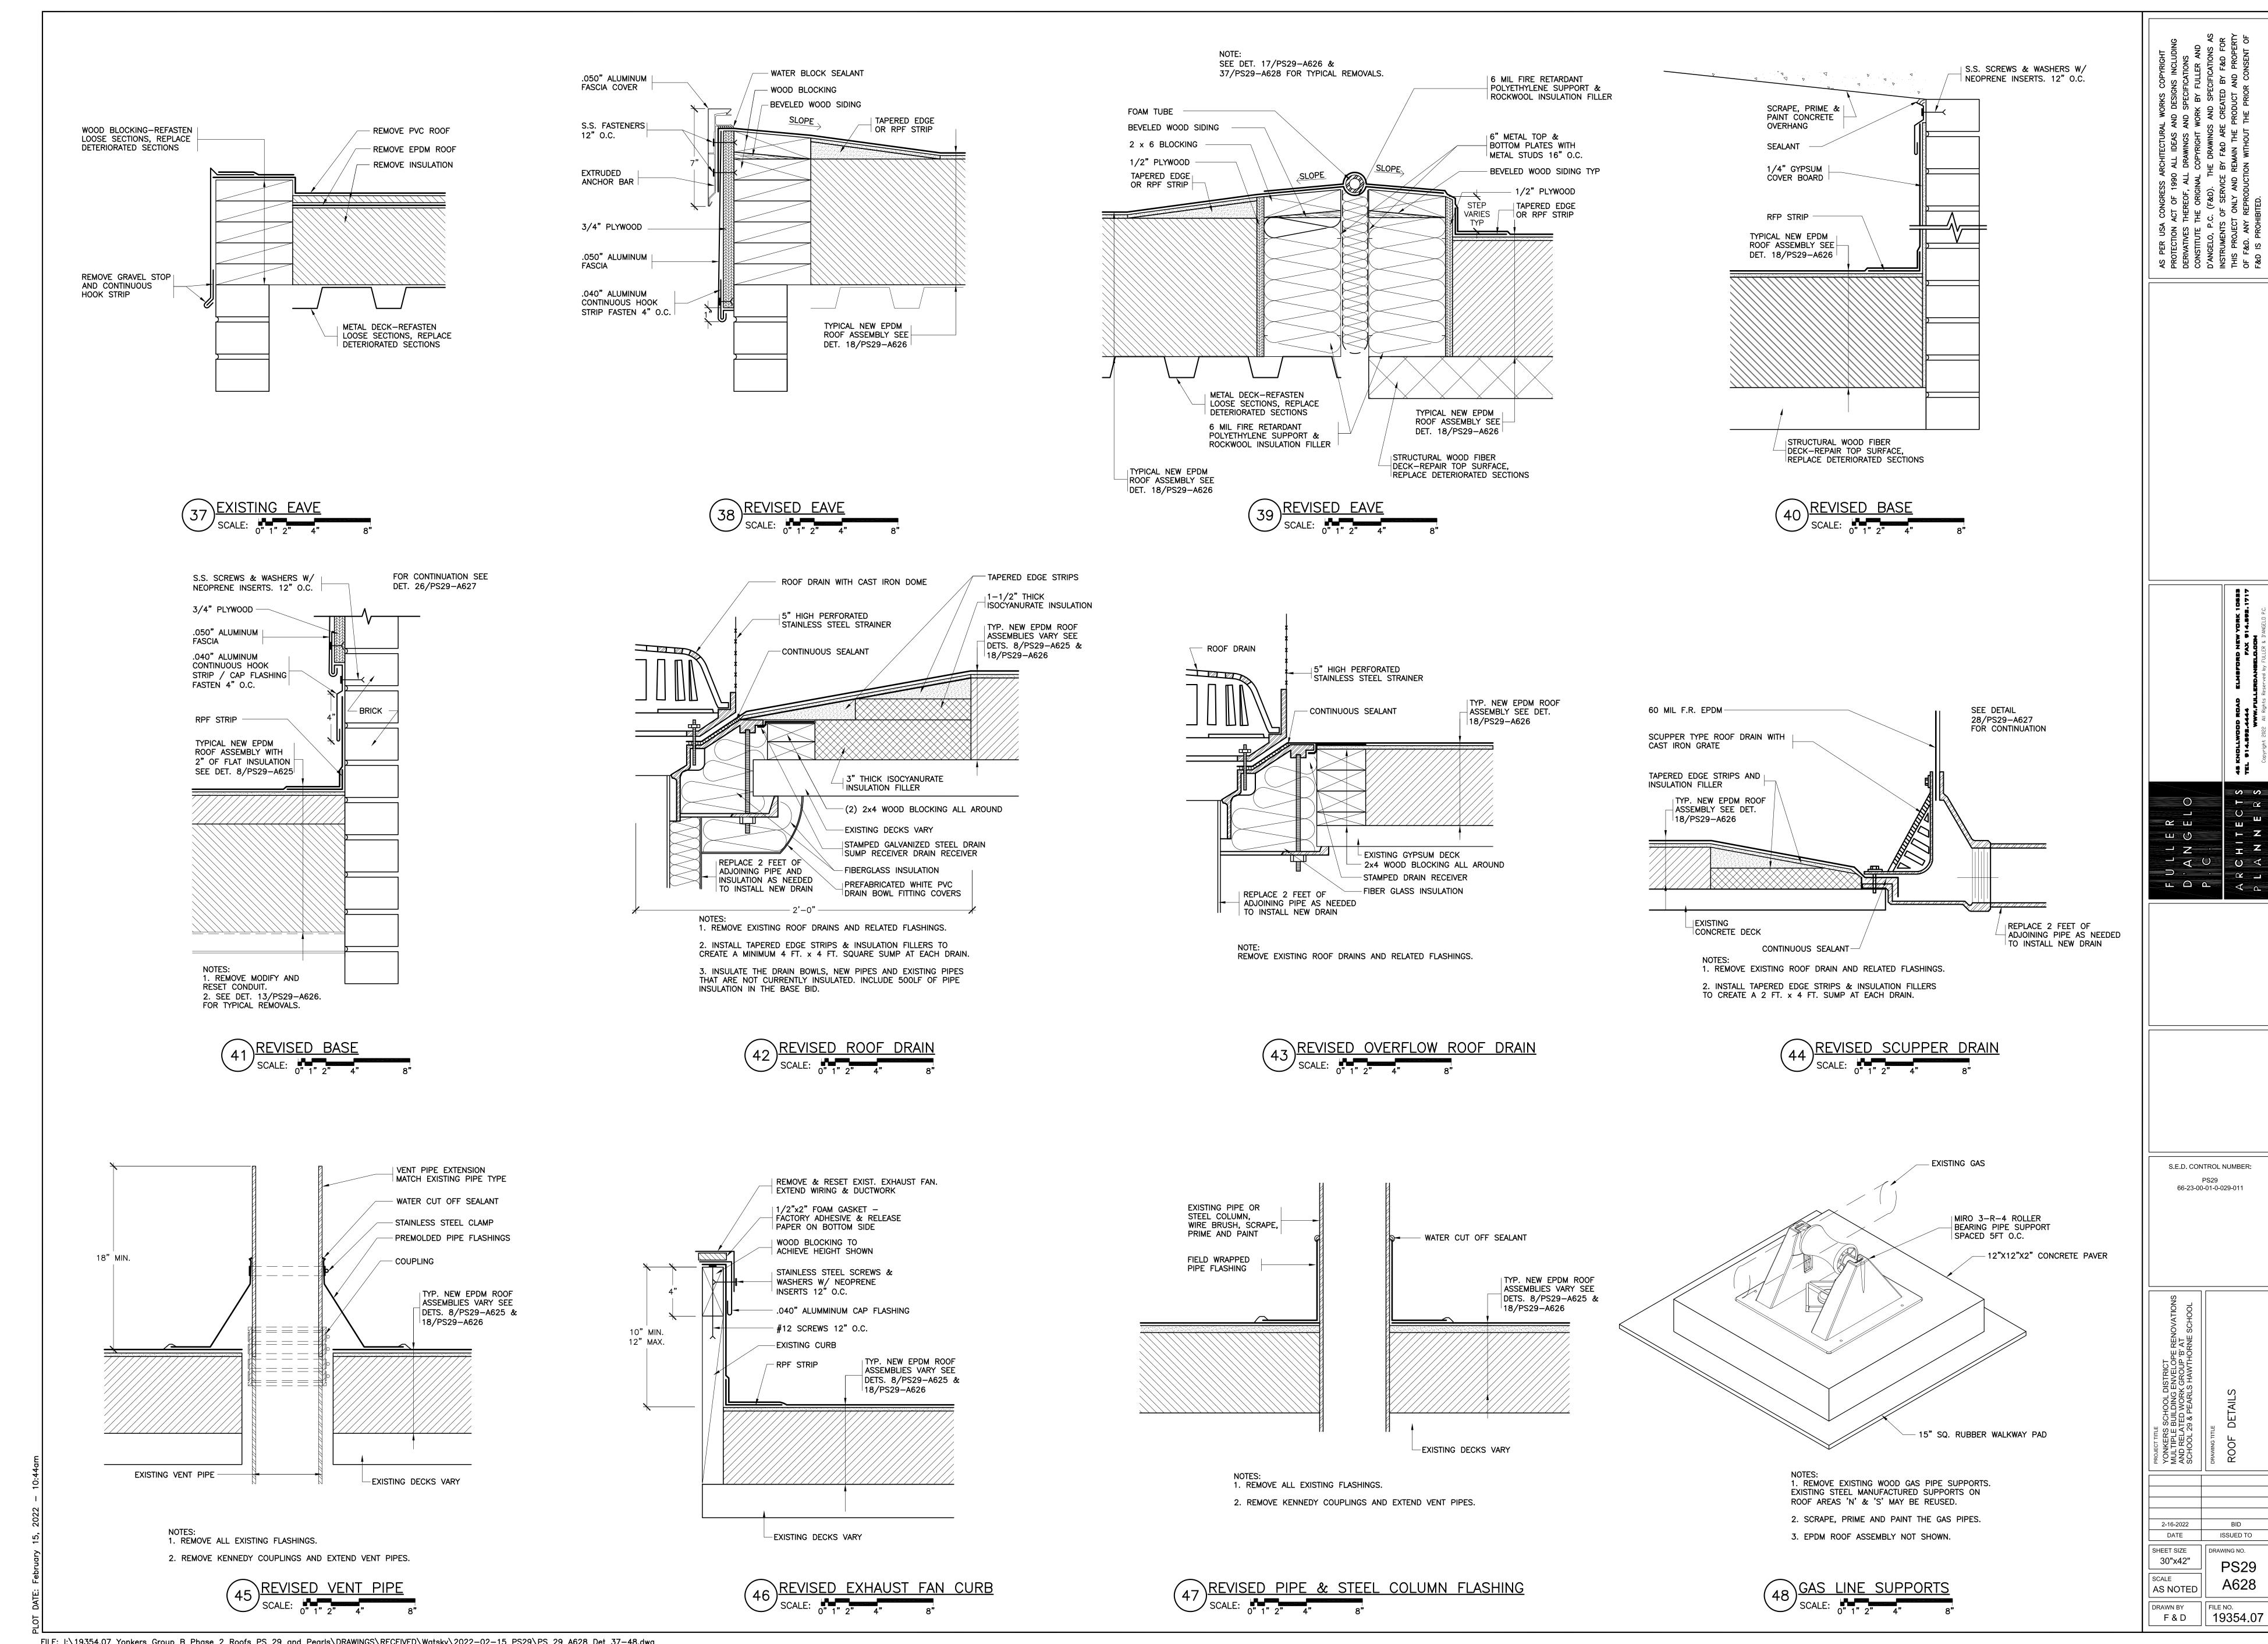


FILE: I:\19354.07 Yonkers Group B Phase 2 Roofs PS 29 and Pearls\DRAWINGS\RECEIVED\Watsky\2022-02-15 PS29\PS 29 A628 Det 37-48.dwg

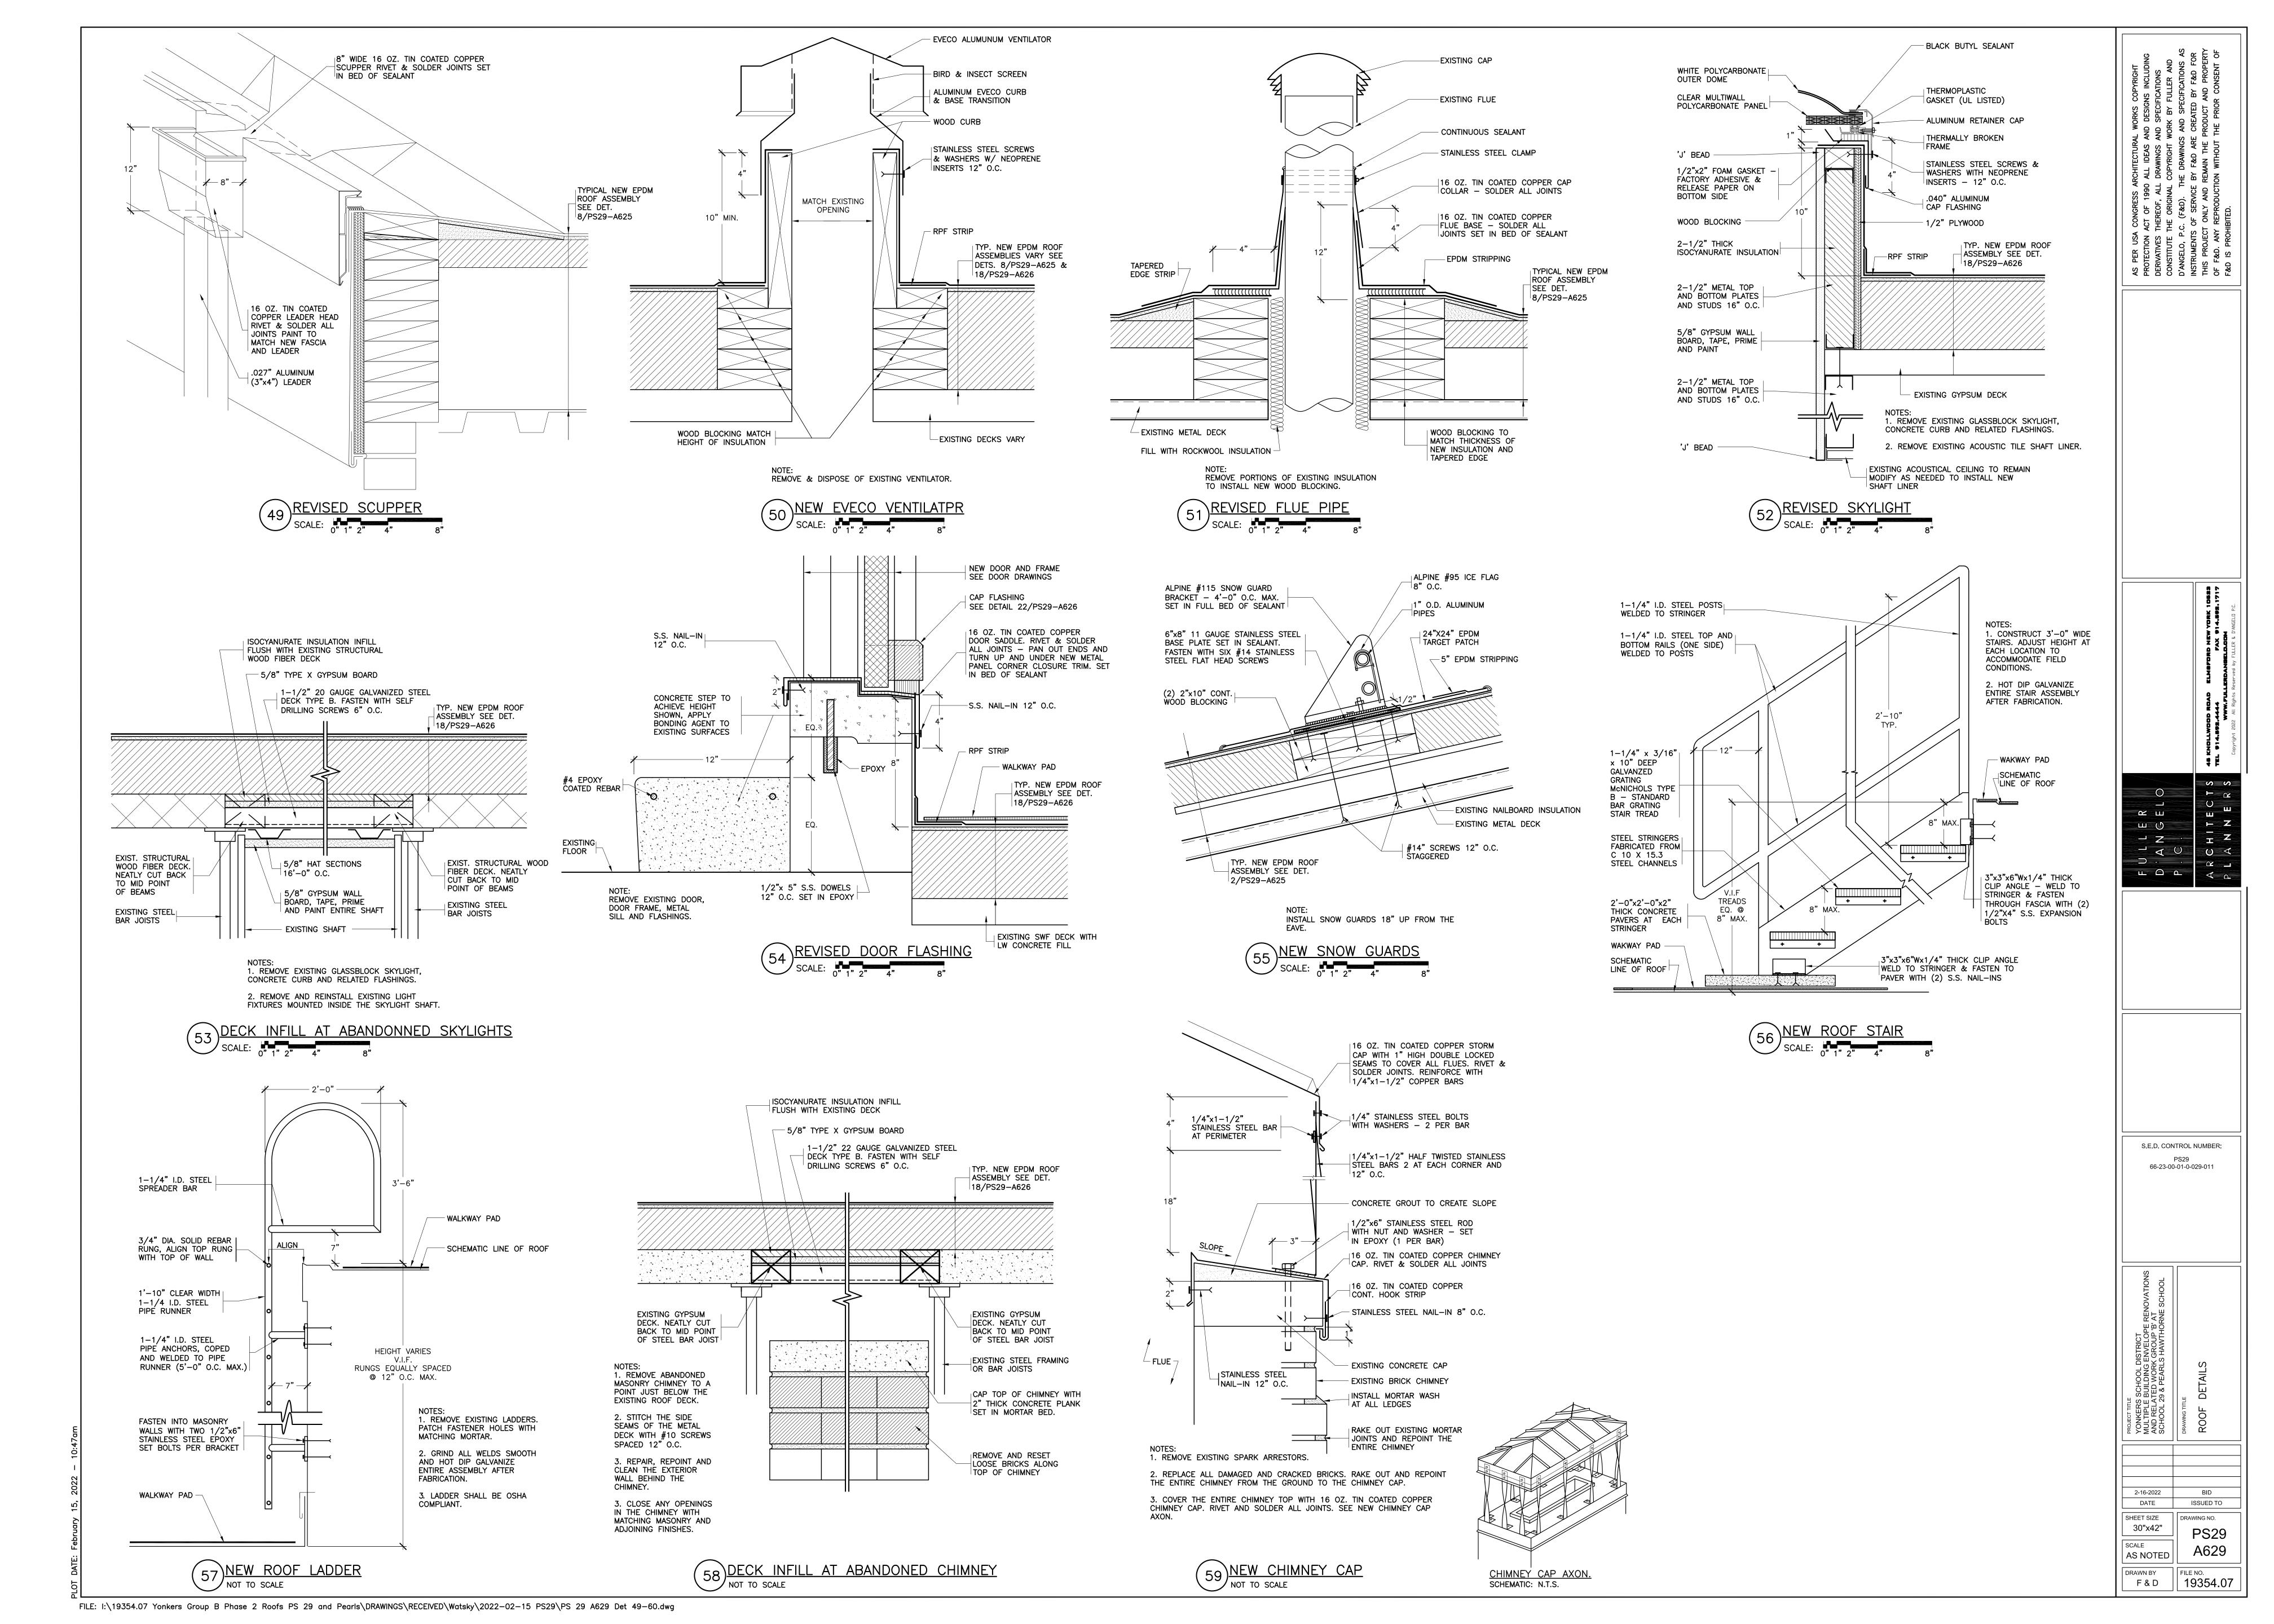

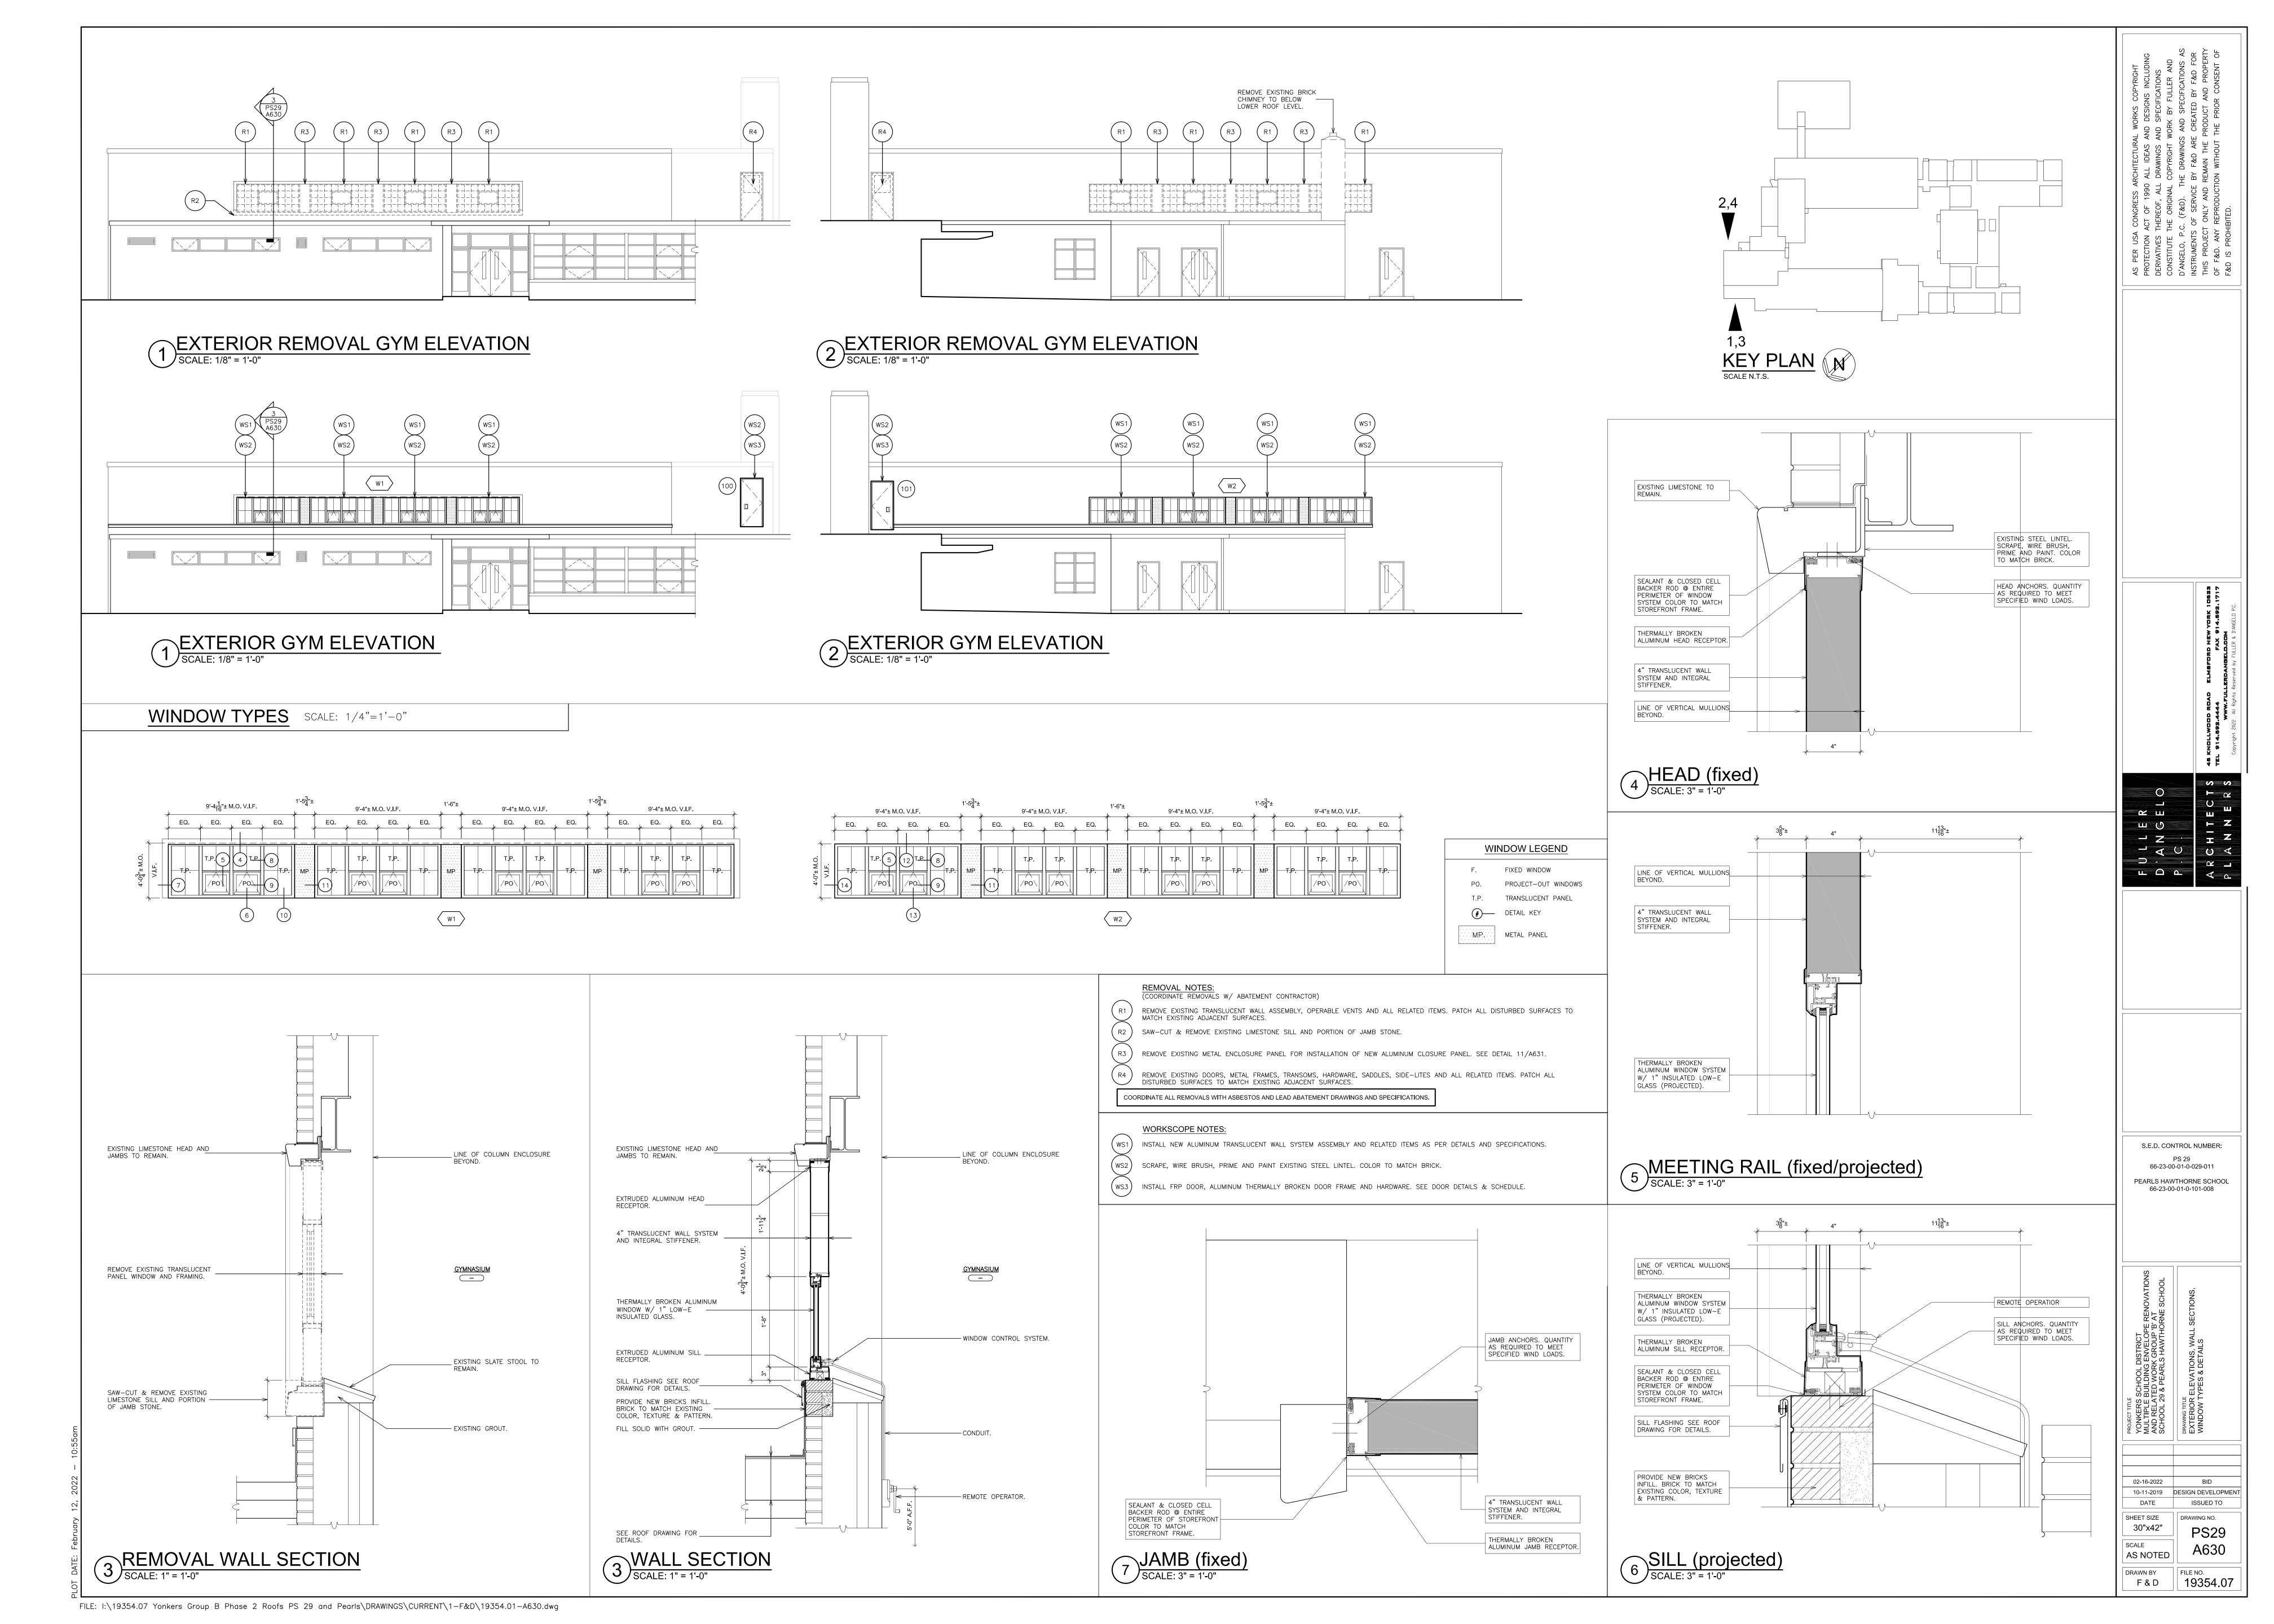


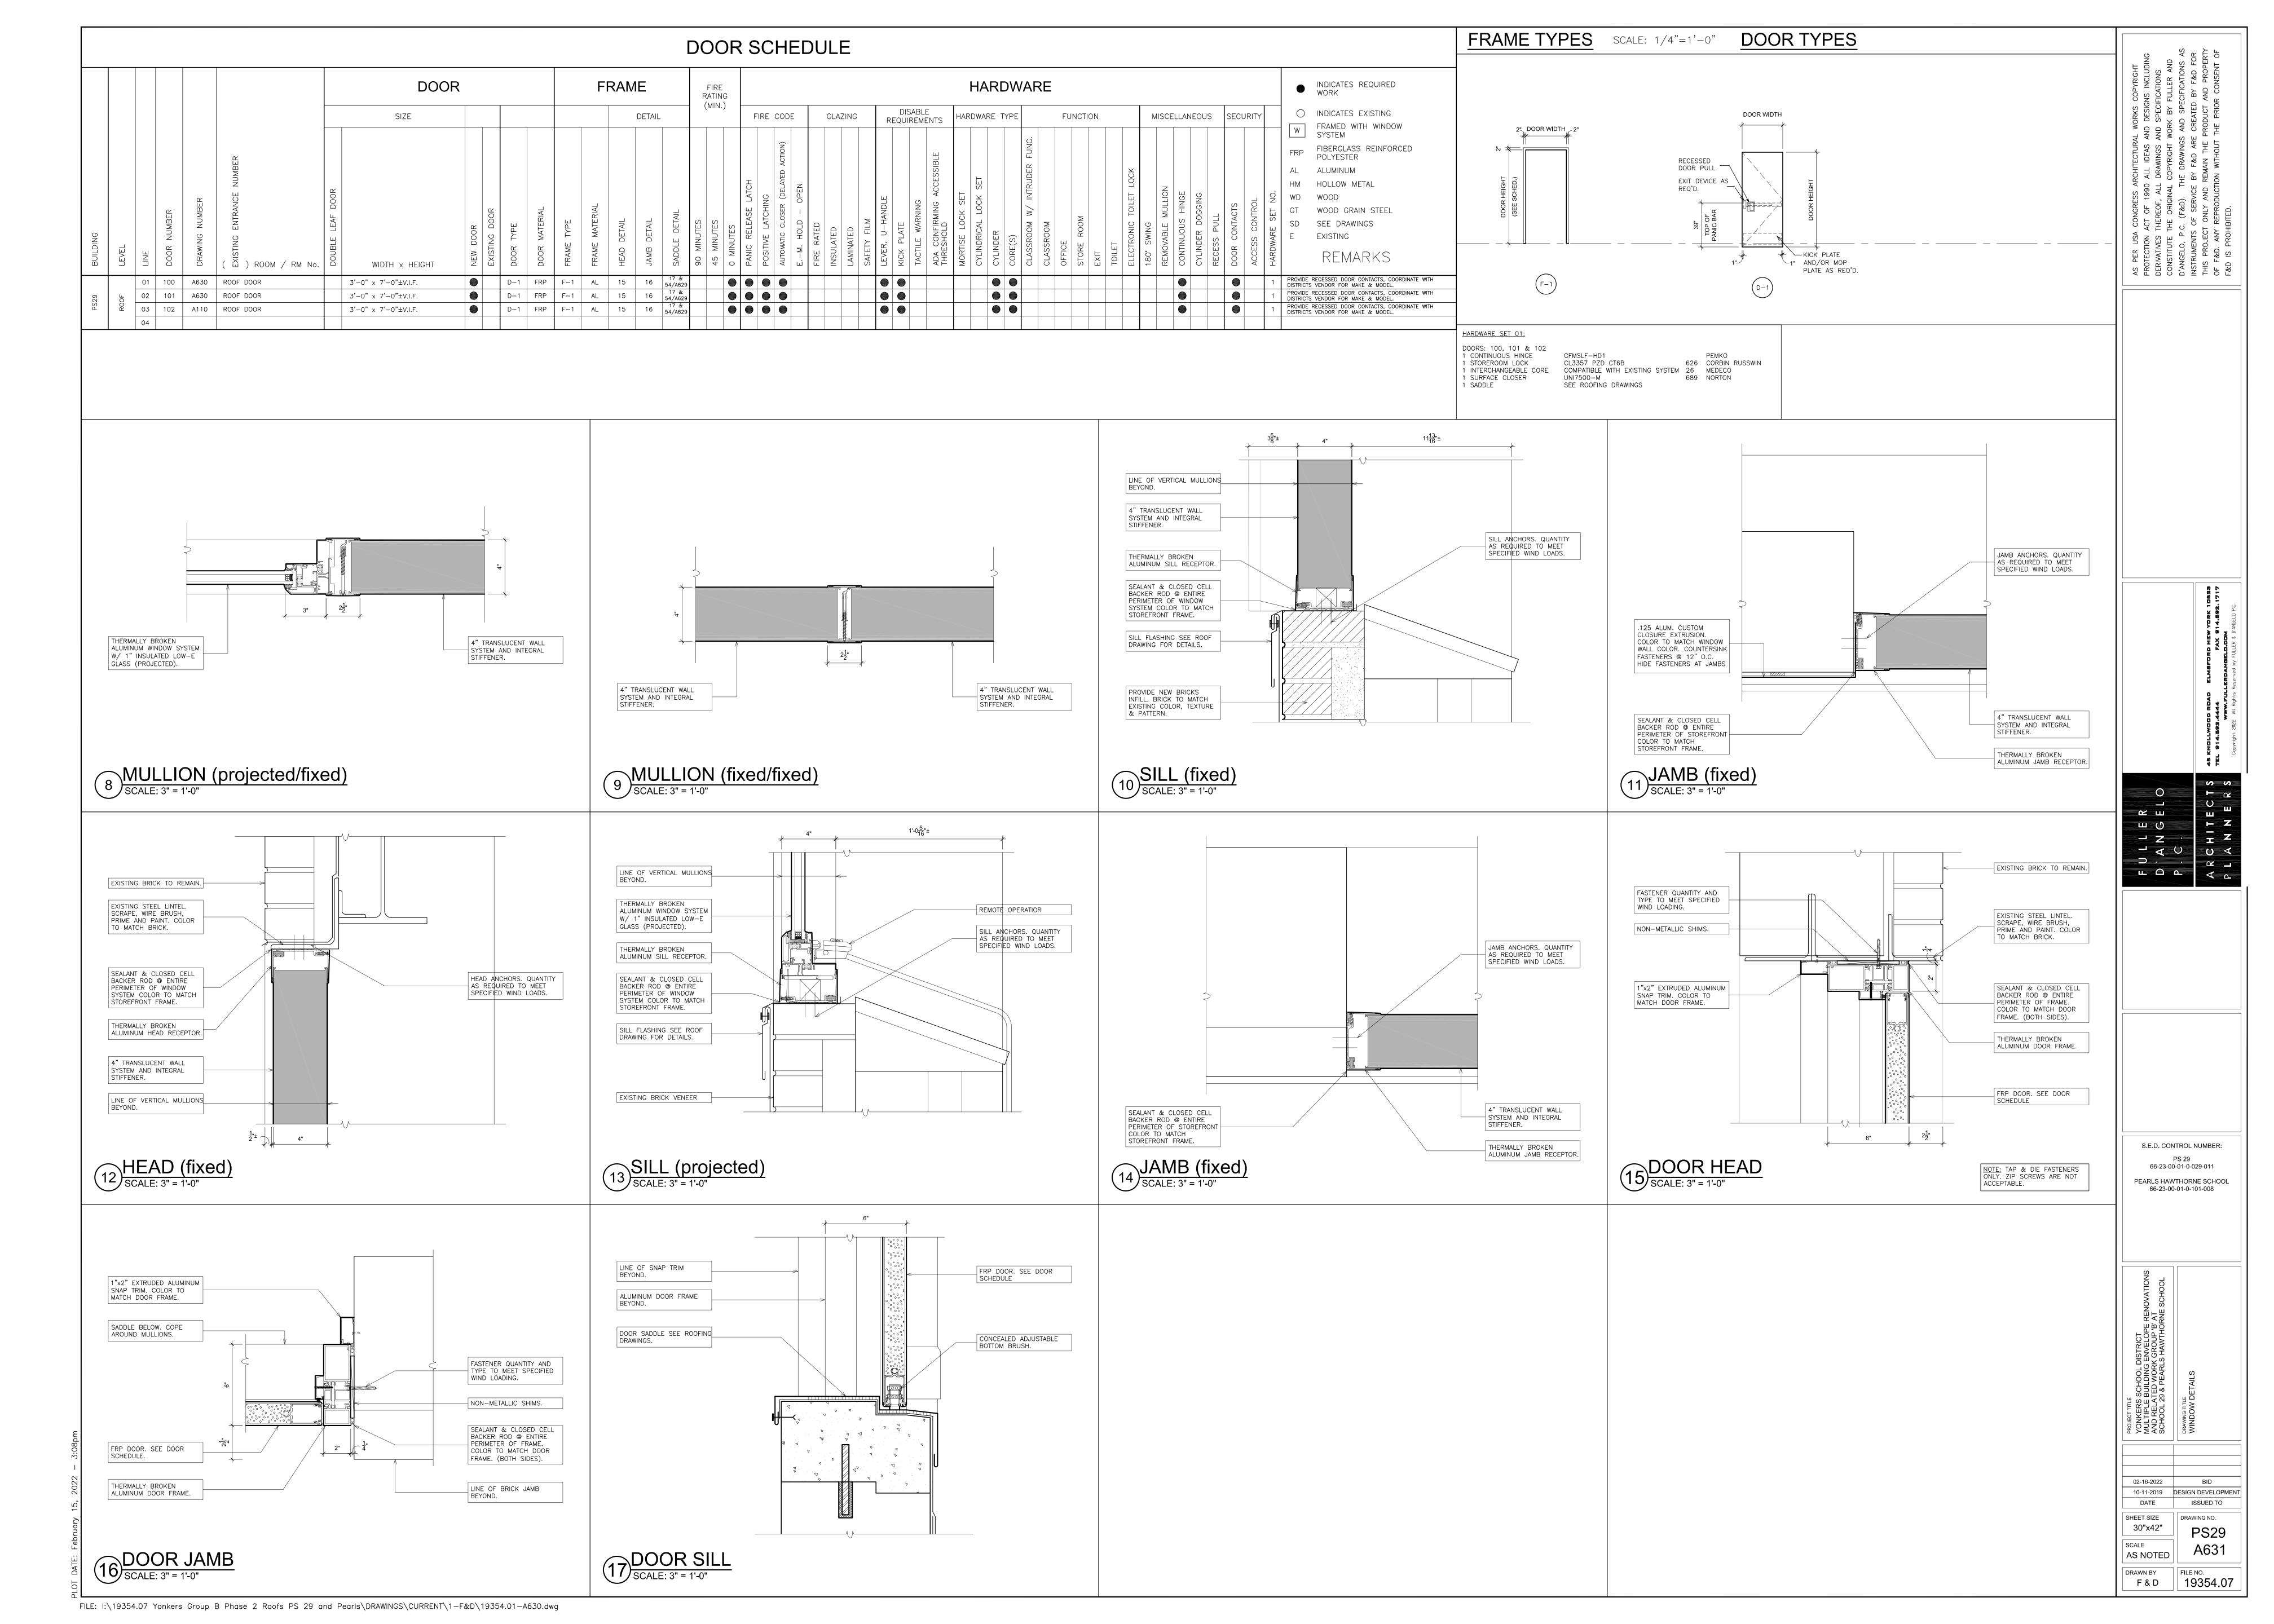

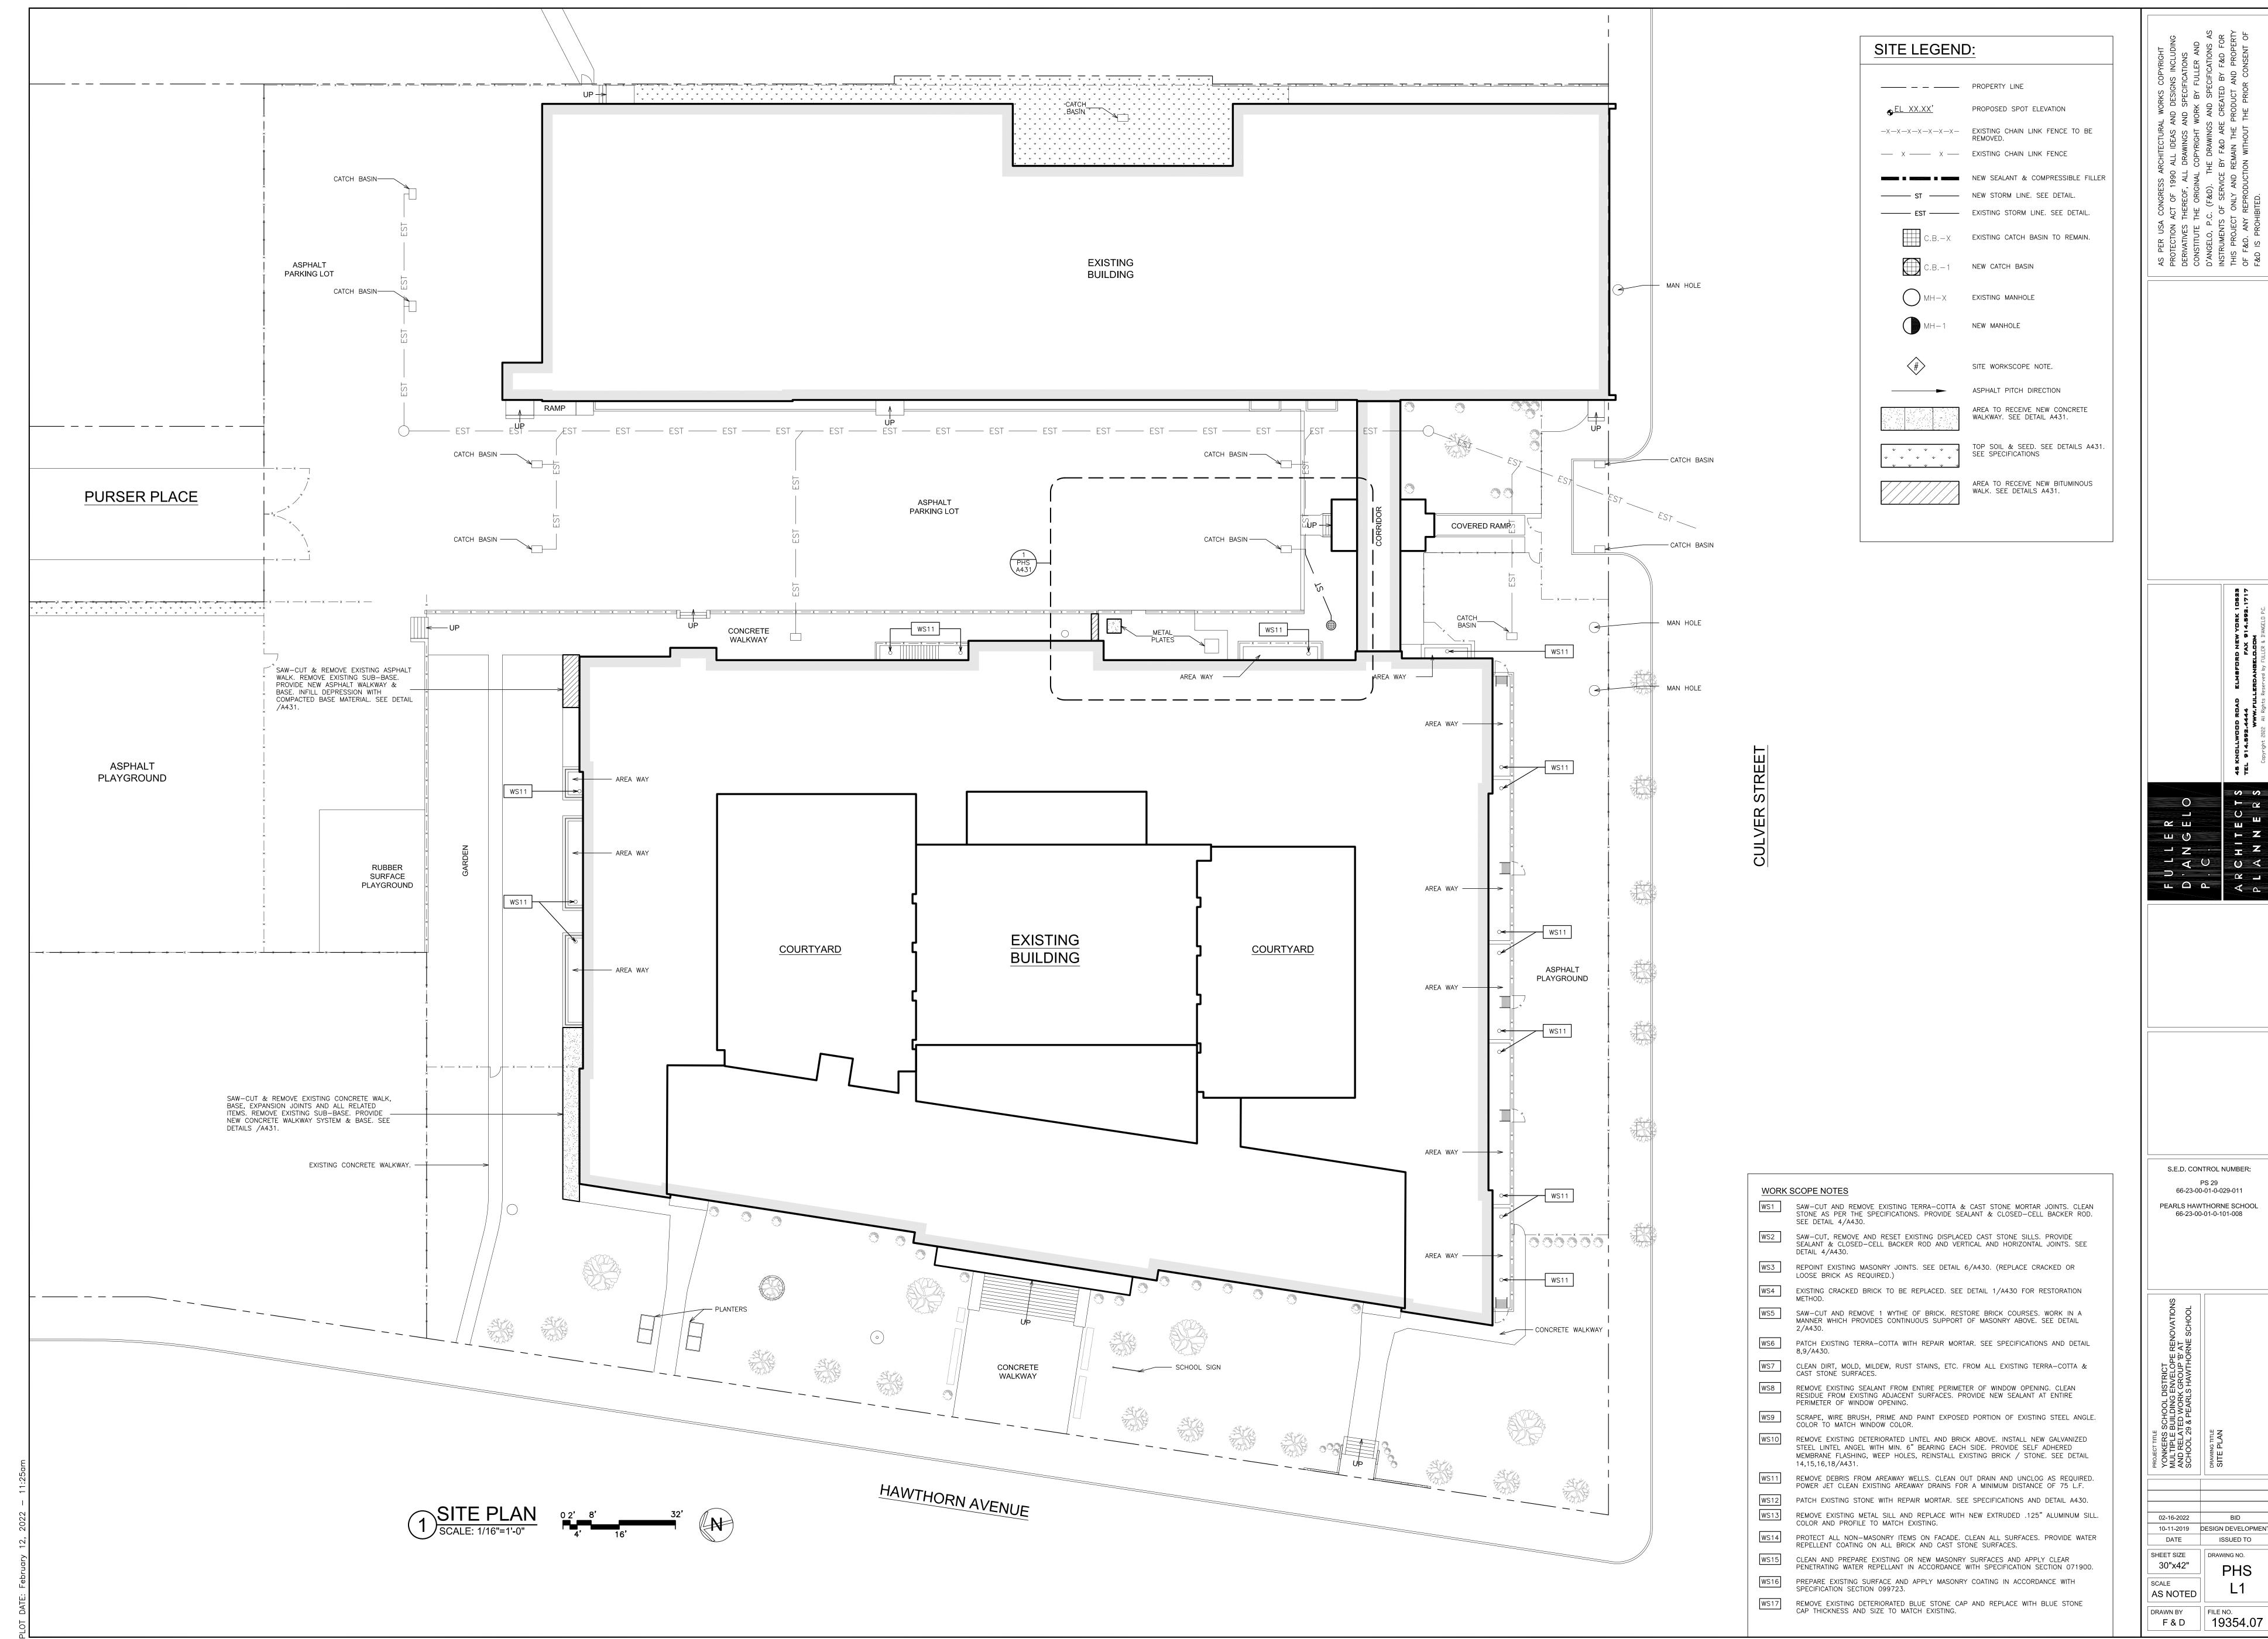



FILE: I:\19354.07 Yonkers Group B Phase 2 Roofs PS 29 and Pearls\DRAWINGS\CURRENT\1-F&D\19354.03-L1.dwg

10-11-2019 DESIGN DEVELOPMENT

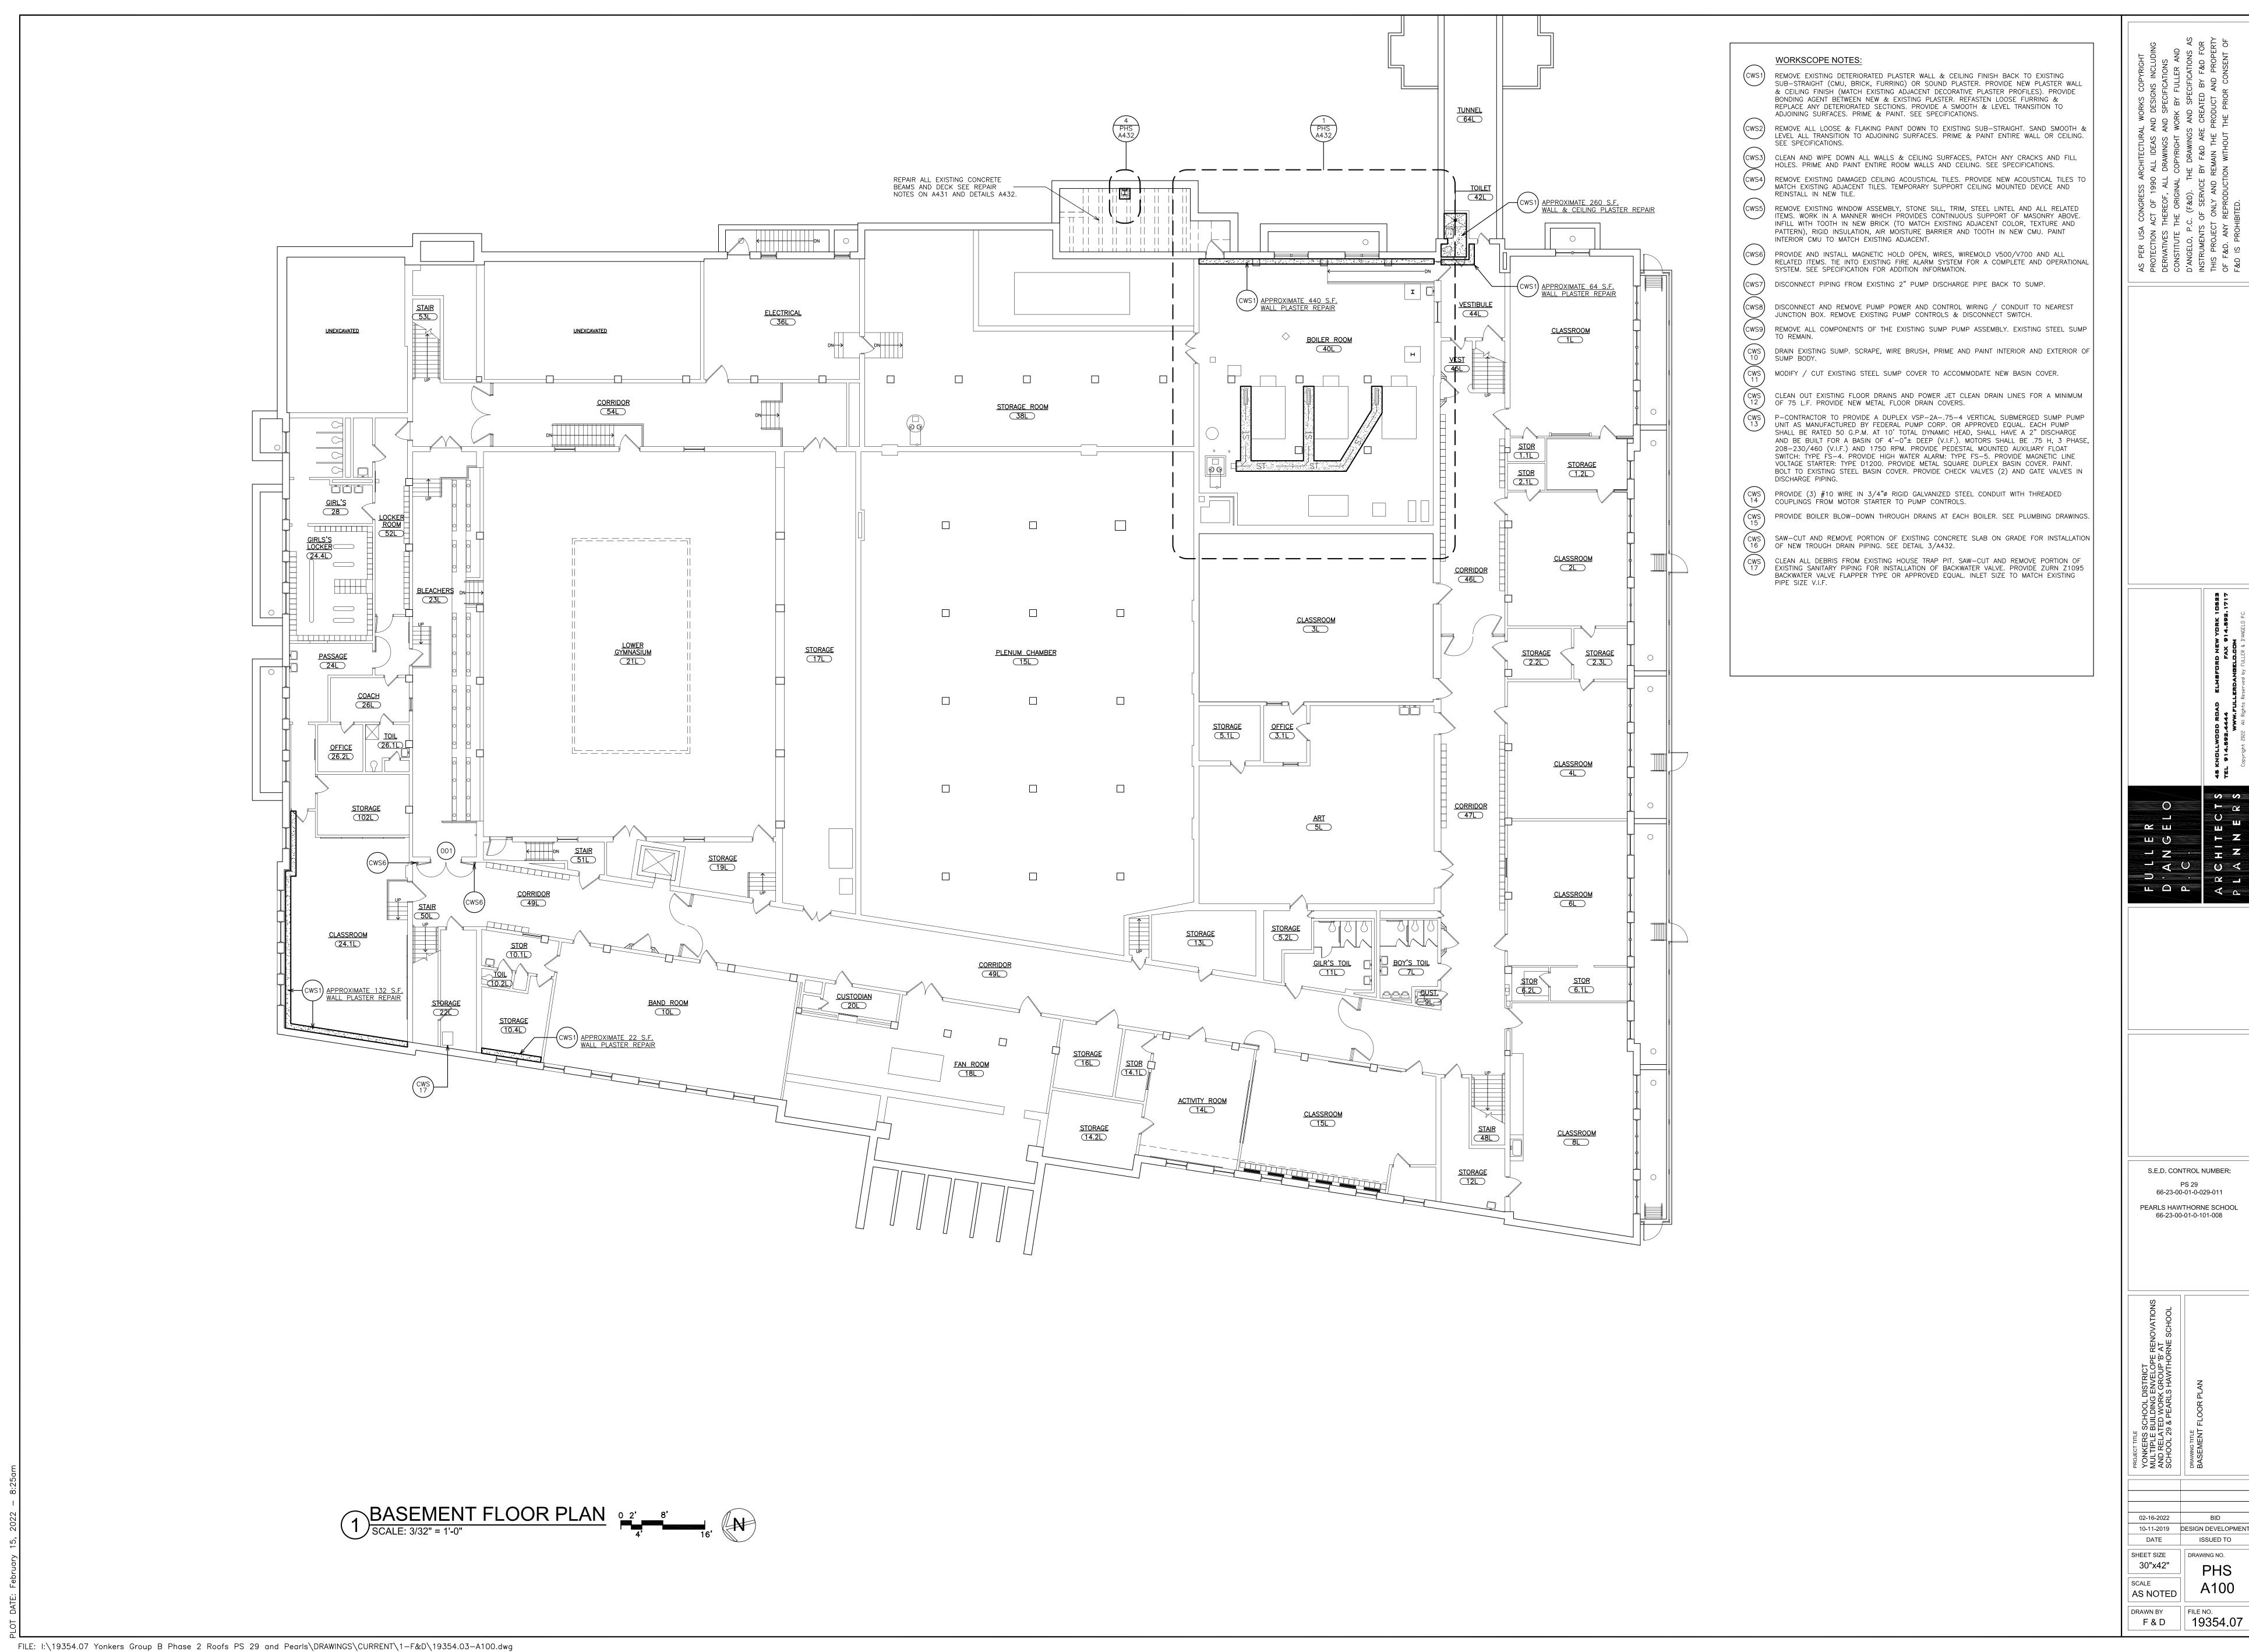


BID
DESIGN DEVELOPMENT
ISSUED TO
DRAWING NO.
PHS
1110
A100

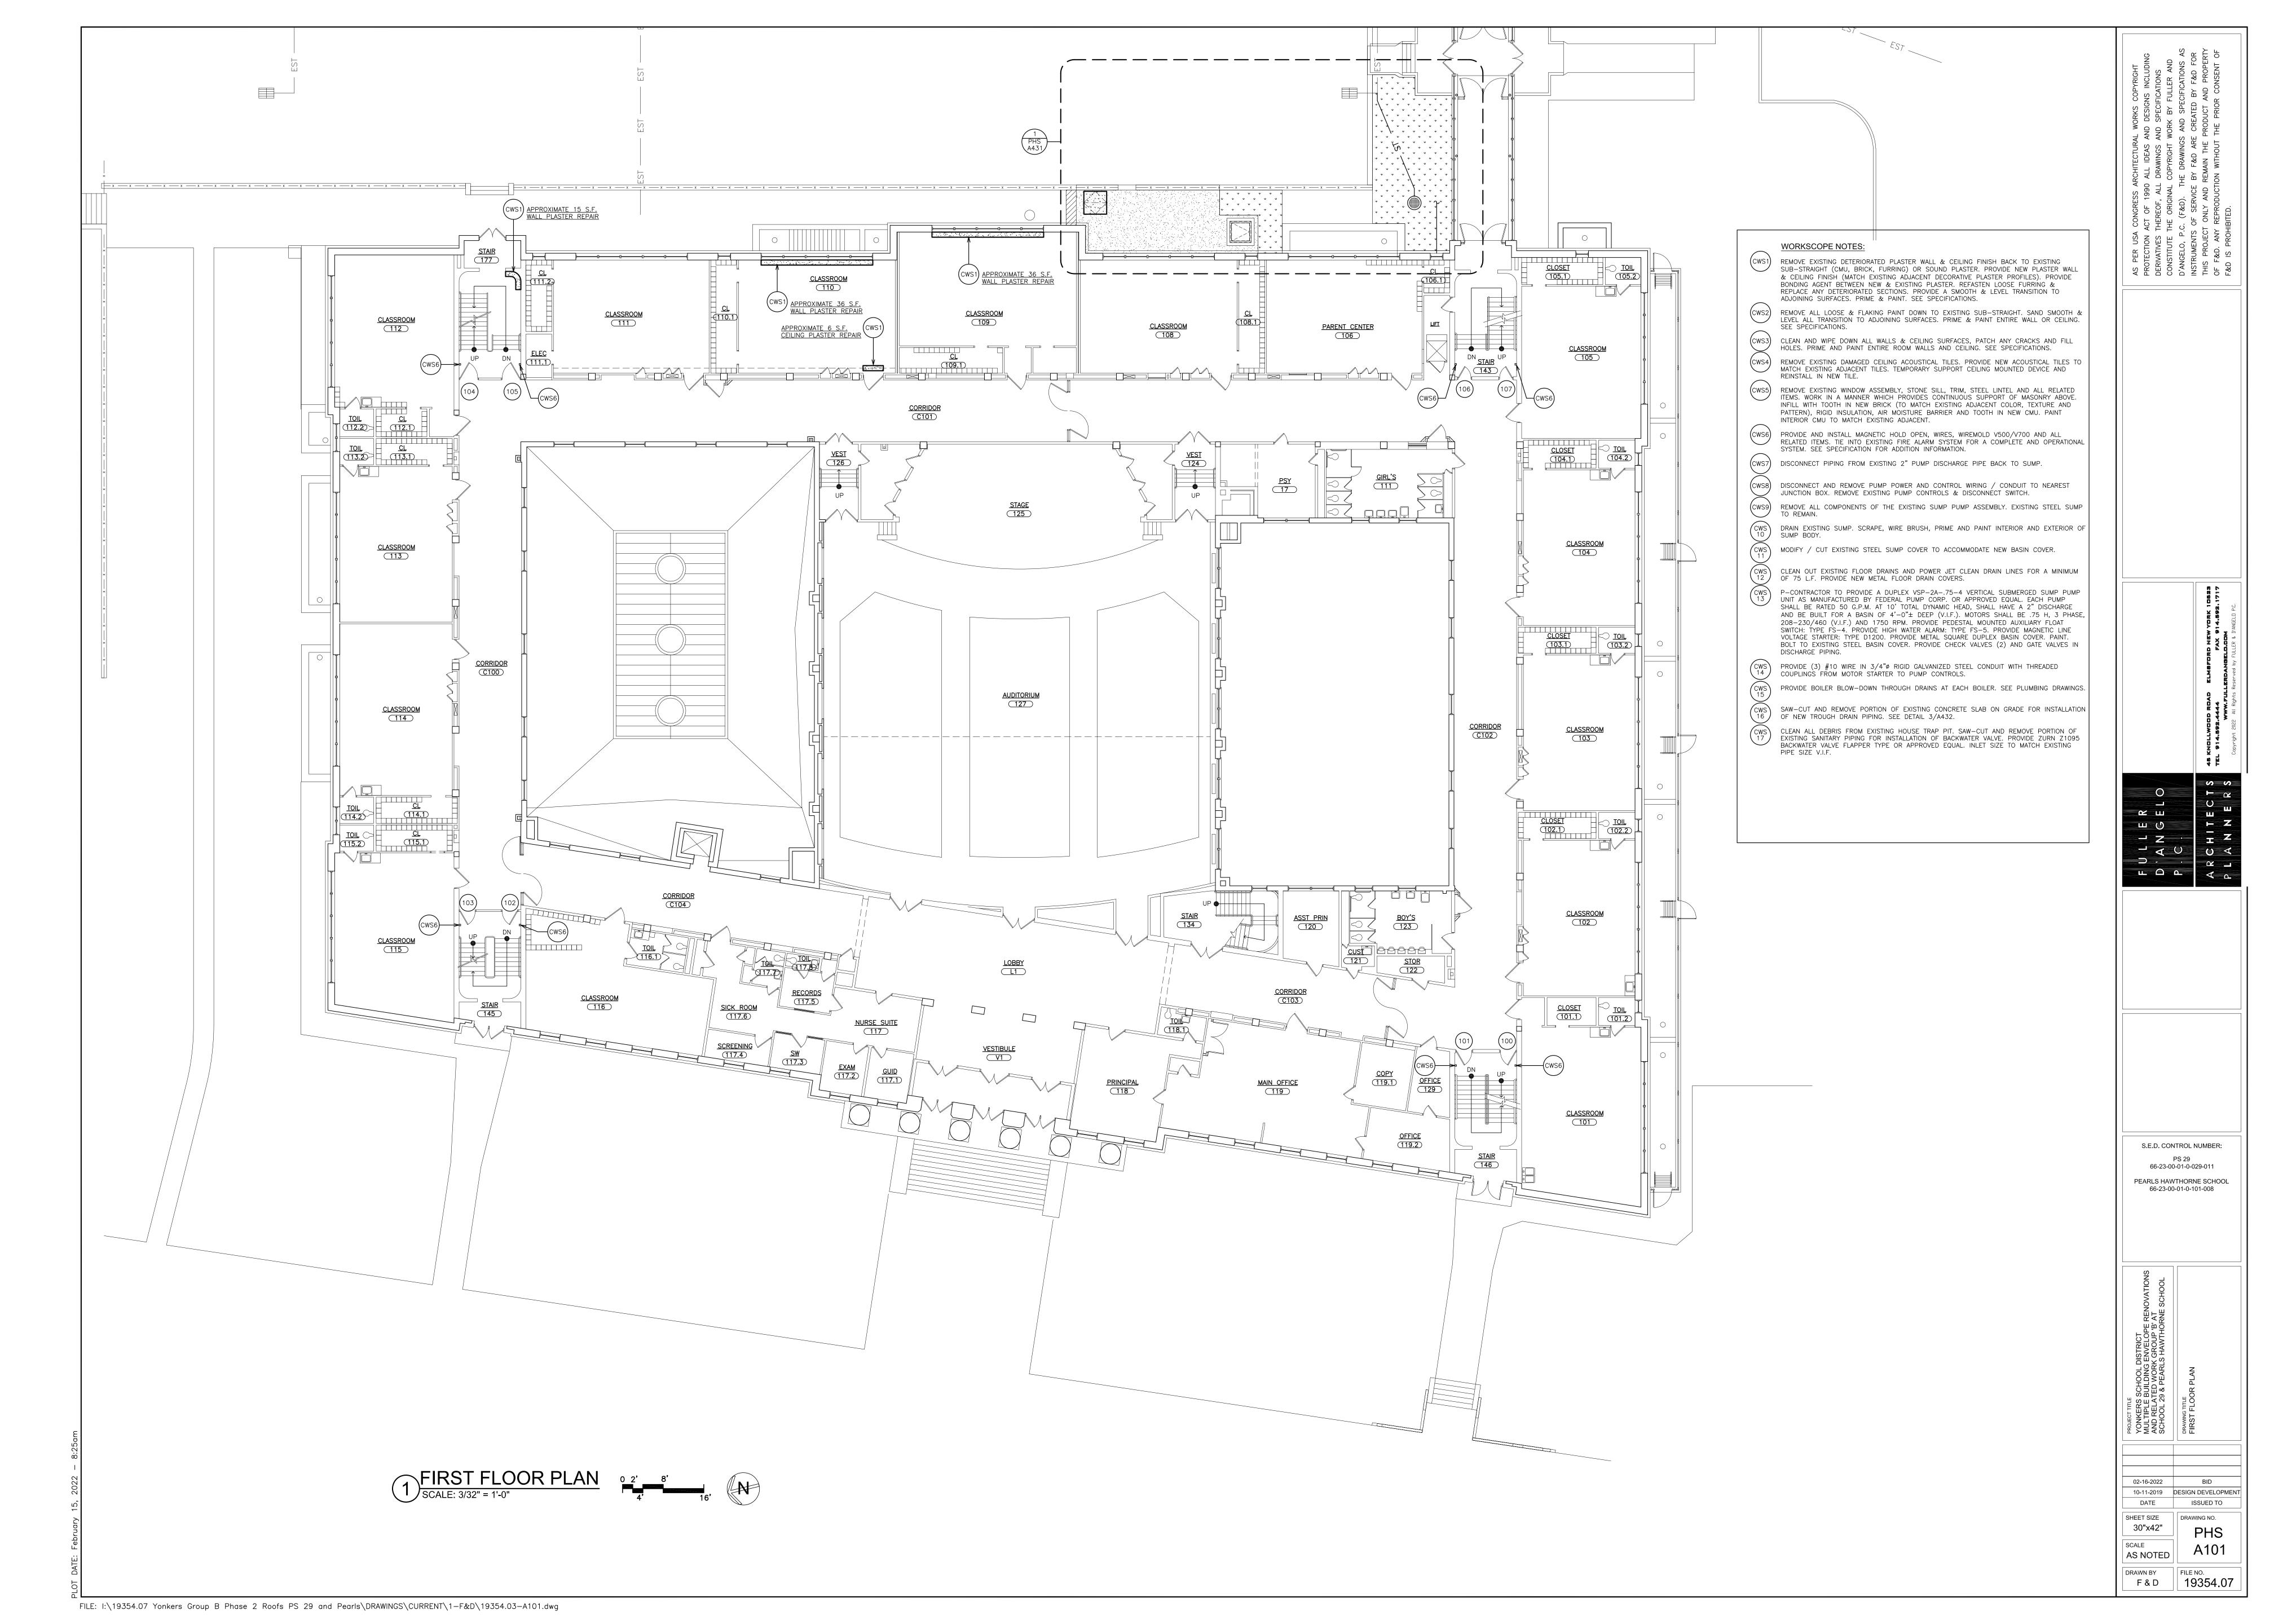

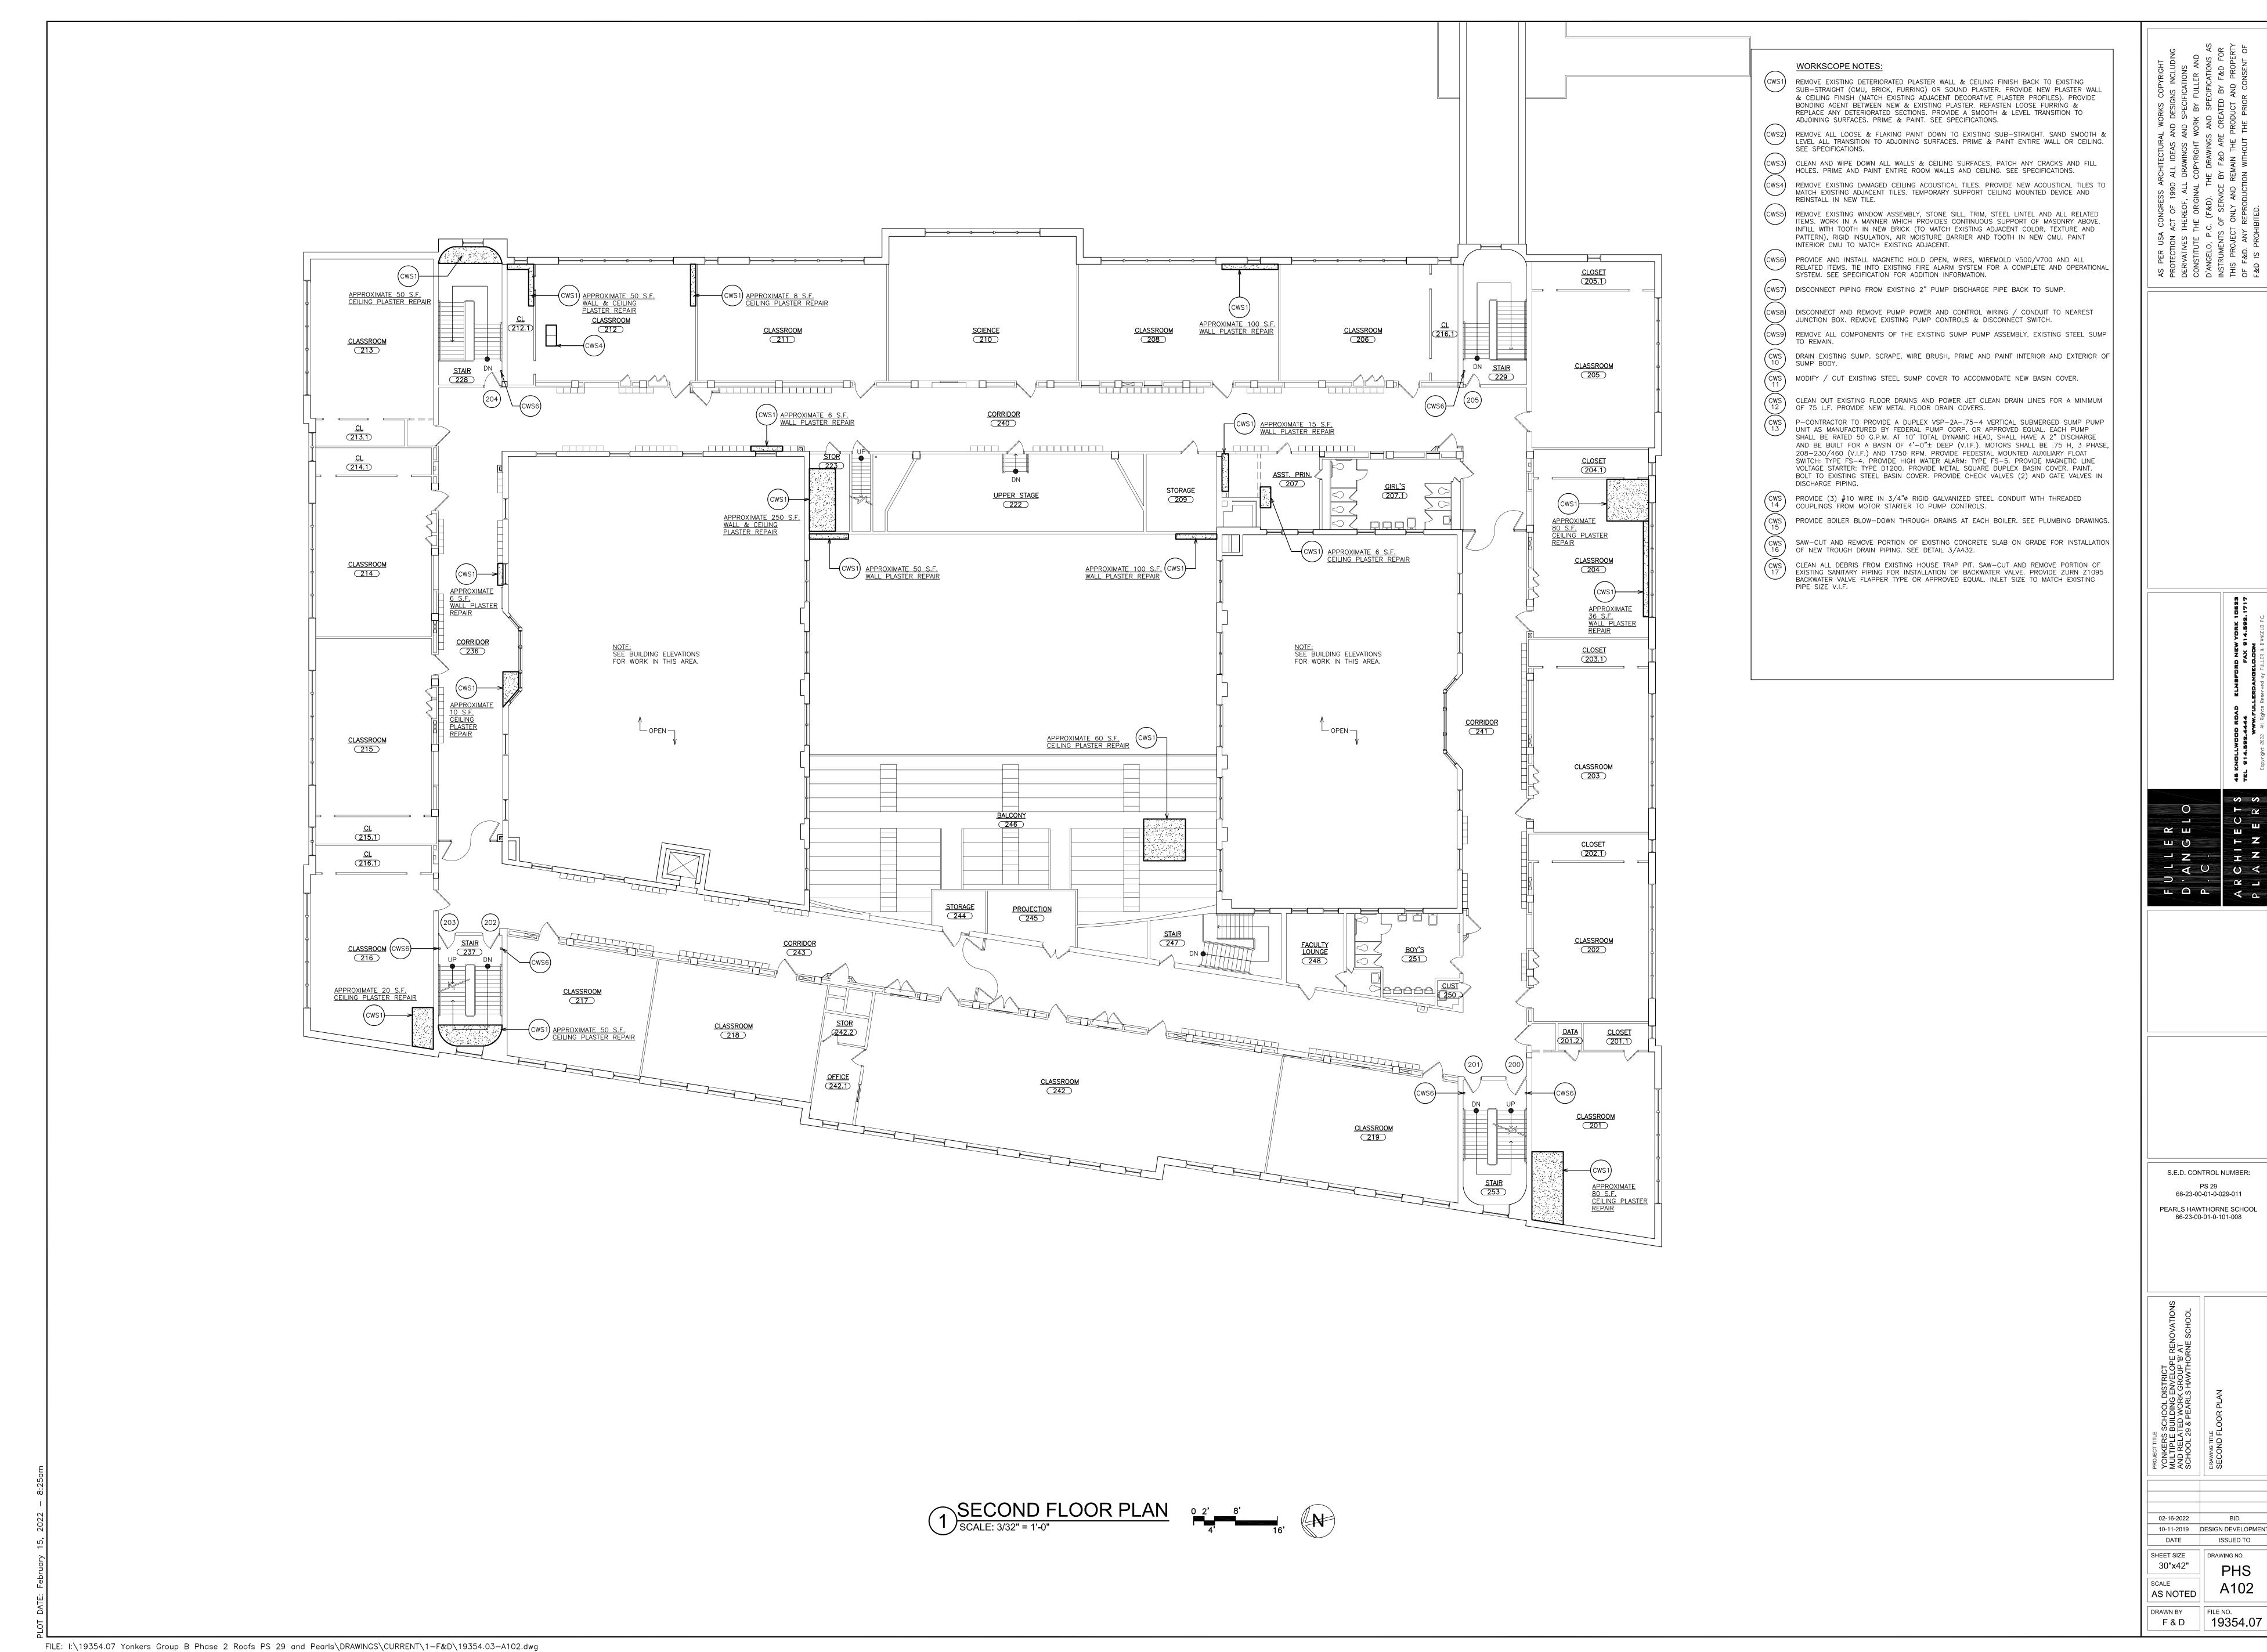

10-11-2019 DESIGN DEVELOPMENT

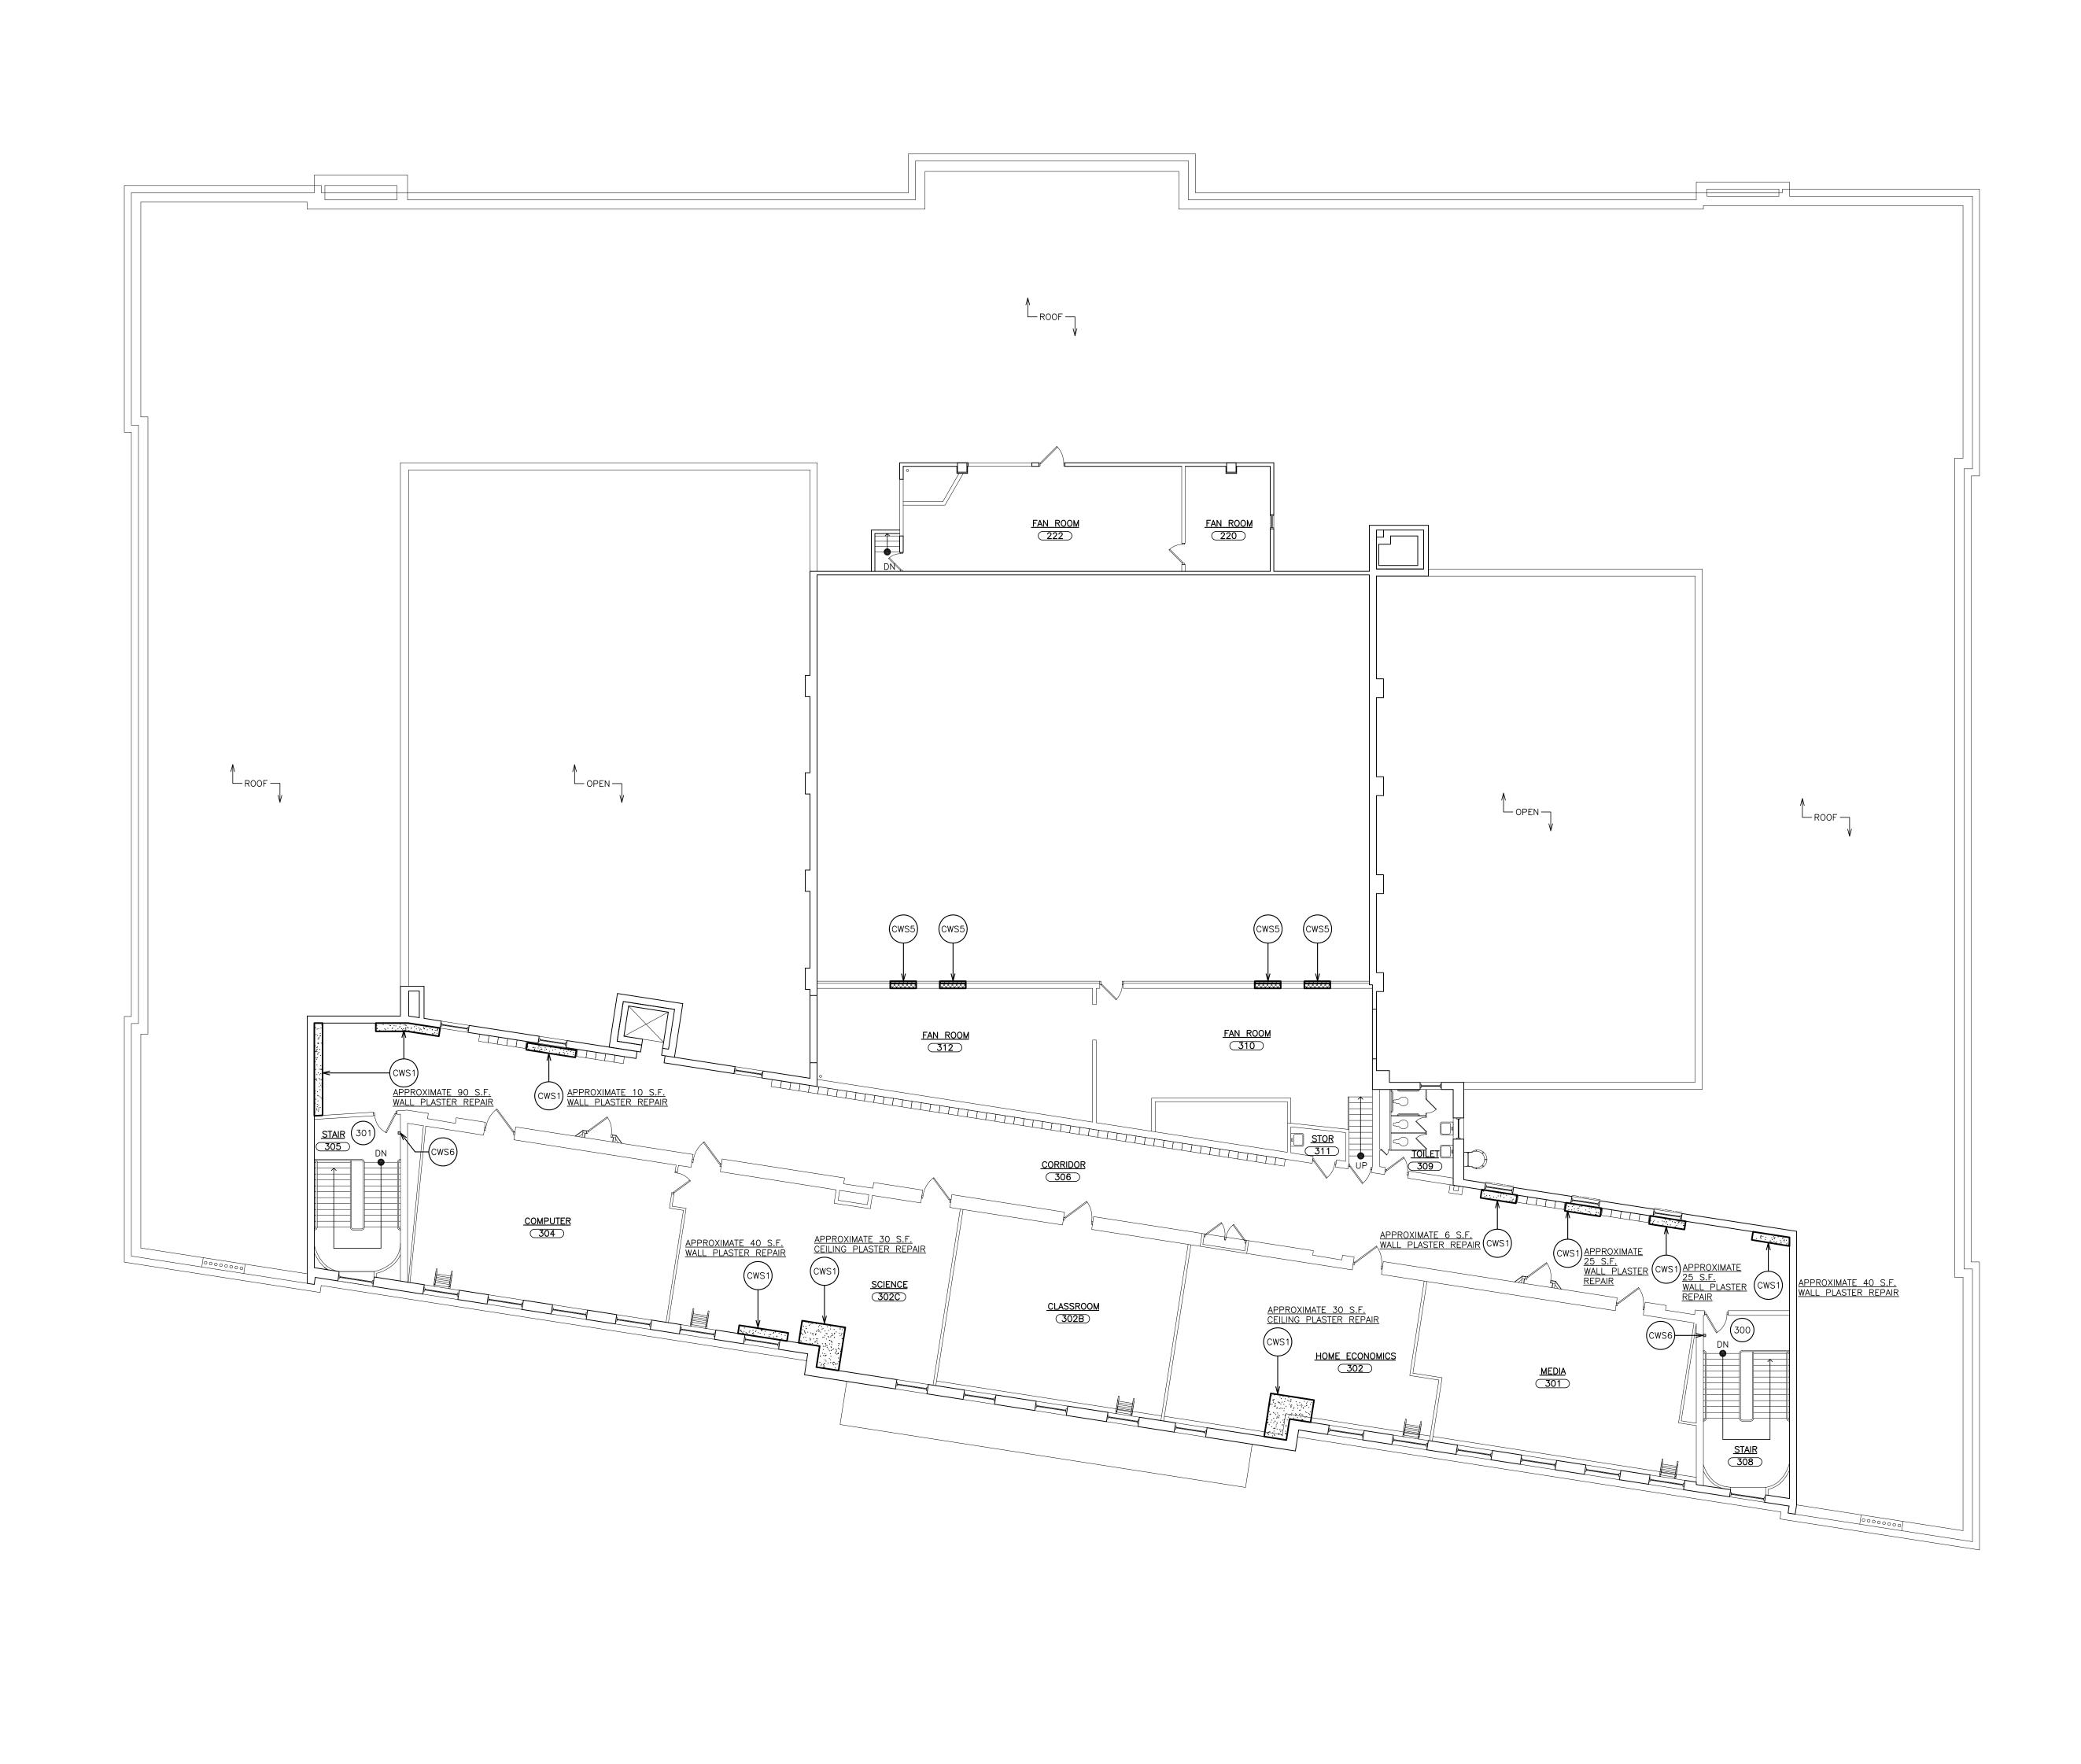

WORKSCOPE NOTES:

CWS1)

REMOVE EXISTING DETERIORATED PLASTER WALL & CEILING FINISH BACK TO EXISTING SUB-STRAIGHT (CMU, BRICK, FURRING) OR SOUND PLASTER. PROVIDE NEW PLASTER WALL & CEILING FINISH (MATCH EXISTING ADJACENT DECORATIVE PLASTER PROFILES). PROVIDE BONDING AGENT BETWEEN NEW & EXISTING PLASTER. REFASTEN LOOSE FURRING & REPLACE ANY DETERIORATED SECTIONS. PROVIDE A SMOOTH & LEVEL TRANSITION TO ADJOINING SURFACES. PRIME & PAINT. SEE SPECIFICATIONS.

CWS2) REMOVE ALL LOOSE & FLAKING PAINT DOWN TO EXISTING SUB-STRAIGHT. SAND SMOOTH & LEVEL ALL TRANSITION TO ADJOINING SURFACES. PRIME & PAINT ENTIRE WALL OR CEILING. SEE SPECIFICATIONS.

CWS3

CLEAN AND WIPE DOWN ALL WALLS & CEILING SURFACES, PATCH ANY CRACKS AND FILL HOLES. PRIME AND PAINT ENTIRE ROOM WALLS AND CEILING. SEE SPECIFICATIONS.

REMOVE EXISTING DAMAGED CEILING ACOUSTICAL TILES. PROVIDE NEW ACOUSTICAL TILES TO MATCH EXISTING ADJACENT TILES. TEMPORARY SUPPORT CEILING MOUNTED DEVICE AND REINSTALL IN NEW TILE.

CWS5

REMOVE EXISTING WINDOW ASSEMBLY, STONE SILL, TRIM, STEEL LINTEL AND ALL RELATED ITEMS. WORK IN A MANNER WHICH PROVIDES CONTINUOUS SUPPORT OF MASONRY ABOVE. INFILL WITH TOOTH IN NEW BRICK (TO MATCH EXISTING ADJACENT COLOR, TEXTURE AND PATTERN), RIGID INSULATION, AIR MOISTURE BARRIER AND TOOTH IN NEW CMU. PAINT INTERIOR CMU TO MATCH EXISTING ADJACENT.

CWS6) PROVIDE AND INSTALL MAGNETIC HOLD OPEN, WIRES, WIREMOLD V500/V700 AND ALL RELATED ITEMS. TIE INTO EXISTING FIRE ALARM SYSTEM FOR A COMPLETE AND OPERATIONAL SYSTEM. SEE SPECIFICATION FOR ADDITION INFORMATION.

(CWS7) DISCONNECT PIPING FROM EXISTING 2" PUMP DISCHARGE PIPE BACK TO SUMP.

CWS8) DISCONNECT AND REMOVE PUMP POWER AND CONTROL WIRING / CONDUIT TO NEAREST JUNCTION BOX. REMOVE EXISTING PUMP CONTROLS & DISCONNECT SWITCH.

(CWS9) REMOVE ALL COMPONENTS OF THE EXISTING SUMP PUMP ASSEMBLY. EXISTING STEEL SUMP

TO REMAIN.

CWS DRAIN EXISTING SUMP. SCRAPE, WIRE BRUSH, PRIME AND PAINT INTERIOR AND EXTERIOR OF SUMP BODY.

CWS MODIFY / CUT EXISTING STEEL SUMP COVER TO ACCOMMODATE NEW BASIN COVER.

CWS
12
CUEAN OUT EXISTING FLOOR DRAINS AND POWER JET CLEAN DRAIN LINES FOR A MINIMUM OF 75 L.F. PROVIDE NEW METAL FLOOR DRAIN COVERS.

P-CONTRACTOR TO PROVIDE A DUPLEX VSP-2A-.75-4 VERTICAL SUBMERGED SUMP PUMP UNIT AS MANUFACTURED BY FEDERAL PUMP CORP. OR APPROVED EQUAL. EACH PUMP SHALL BE RATED 50 G.P.M. AT 10' TOTAL DYNAMIC HEAD, SHALL HAVE A 2" DISCHARGE AND BE BUILT FOR A BASIN OF 4'-0"± DEEP (V.I.F.). MOTORS SHALL BE .75 H, 3 PHASE, 208-230/460 (V.I.F.) AND 1750 RPM. PROVIDE PEDESTAL MOUNTED AUXILIARY FLOAT SWITCH: TYPE FS-4. PROVIDE HIGH WATER ALARM: TYPE FS-5. PROVIDE MAGNETIC LINE VOLTAGE STARTER: TYPE D1200. PROVIDE METAL SQUARE DUPLEX BASIN COVER. PAINT. BOLT TO EXISTING STEEL BASIN COVER. PROVIDE CHECK VALVES (2) AND GATE VALVES IN

CWS PROVIDE (3) #10 WIRE IN 3/4" RIGID GALVANIZED STEEL CONDUIT WITH THREADED COUPLINGS FROM MOTOR STARTER TO PUMP CONTROLS.

CWS PROVIDE BOILER BLOW-DOWN THROUGH DRAINS AT EACH BOILER. SEE PLUMBING DRAWINGS.

CWS SAW-CUT AND REMOVE PORTION OF EXISTING CONCRETE SLAB ON GRADE FOR INSTALLATION OF NEW TROUGH DRAIN PIPING. SEE DETAIL 3/A432.

CWS CLEAN ALL DEBRIS FROM EXISTING HOUSE TRAP PIT. SAW-CUT AND REMOVE PORTION OF EXISTING SANITARY PIPING FOR INSTALLATION OF BACKWATER VALVE, PROVIDE 7URN 71095

EXISTING SANITARY PIPING FOR INSTALLATION OF BACKWATER VALVE. PROVIDE ZURN Z1095 BACKWATER VALVE FLAPPER TYPE OR APPROVED EQUAL. INLET SIZE TO MATCH EXISTING PIPE SIZE V.I.F. AS PER USA CONGRESS ARCHITECTURAL WORKS COPYIPROTECTION ACT OF 1990 ALL IDEAS AND DESIGNS IN DERIVATIVES THEREOF, ALL DRAWINGS AND SPECIFICATICONSTITUTE THE ORIGINAL COPYRIGHT WORK BY FULLED'ANGELO, P.C. (F&D). THE DRAWINGS AND SPECIFICAINSTRUMENTS OF SERVICE BY F&D ARE CREATED BY FINS PROJECT ONLY AND REMAIN THE PRODUCT AND OF F&D. ANY REPRODUCTION WITHOUT THE PRIOR CONFIRED IS PROHIBITED.

45 KNOLLWOOD ROAD ELMSFORD NEW YORK 10523
TEL 914.592.4444

WWW.FULLERDANGELO.COM

Copyright 2022 All Rights Reserved by FULLER & D'ANGELO P.C.

S.E.D. CONTROL NUMBER:

PS 29
66-23-00-01-0-029-011

PEARLS HAWTHORNE SCHOOL
66-23-00-01-0-101-008

DNKERS SCHOOL DISTRICT
JUTIPLE BUILDING ENVELOPE RENOVATIONS
AD RELATED WORK GROUP 'B' AT
CHOOL 29 & PEARLS HAWTHORNE SCHOOL

AWAING TITLE
HIRD FLOOR PLAN

02-16-2022 BID

10-11-2019 DESIGN DEVELOPMENT

DATE ISSUED TO

SHEET SIZE
30"x42" PHS

SCALE
AS NOTED

A103

FILE NO.

19354.07

DRAWN BY

F & D

리 L FILE: I:\19354.07 Yonkers Group B Phase 2 Roofs PS 29 and Pearls\DRAWINGS\CURRENT\1-F&D\19354.03-A103.dwg

SCALE: 3/32" = 1'-0"

4'
16'

		ROOF R-VA	LUE CALCULAT	TIONS	
ROOF AREA	DECK TYPE	STARTING THICKNESS OF NEW INSULATION	MINIMUM R-VALUE OF NEW INSULATION	AVERAGE THICKNESS OF NEW INSULATION	AVERAGE R-VALUE OF NEW INSULATION
К	CONCRETE	5.5"	30	5.5"	32.2
N	METAL	1.5"	_	_	SEE NOTE 3
0	EXISTING EPDM RO	OOF TO REMAIN			
Р	CONCRETE	1.5"	_	_	_
Q	SWF	5.5"	30	6.6"	38.6
R	SWF	5.5"	30	6.8"	39.8
S	SWF	5.5"	30	7.7"	45.3
Т	SWF	5.5"	30	6.5"	38
U	CONCRETE	1.5"	_	_	_
V	CONCRETE	1.5"	_	-	_
W	SWF	5.5"	30	5.9"	34.4

REPLACE VENTILATOR

 $\langle B \rangle$

INSTALL NEW CAP FLASHING THIS AREA — SEE DETAIL

41/PHS-A628

SEE DETAIL

REPLACE LOOSE EPDM | FLASHING WITH NEW 9"

WIDE EPDM FLASHING

42/PHS-A-628

- 1.INSTALL INSULATION WITH A MINIMUM R-VALUE OF 30 FOR CONTINUOUS INSULATION ENTIRELY ABOVE THE DECK, TO MEET THE NYS ENERGY CONSERVATION CONSTRUCTION CODE, INCLUDING THE INTERNATIONAL ENERGY CONSERVATION CODE AND THE NY STATE SUPPLEMENT, FOR A BUILDING IN CLIMATE ZONE 4.
- 2.INSTALL TAPERED ISOCYANURATE INSULATION THAT SLOPES 1/8 INCH PER FOOT; MINIMUM STARTING THICKNESS 5-1/2 INCHES UNLESS OTHERWISE NOTED. INSTALL THE ISOCYANURATE INSULATION IN MULTIPLE LAYERS, WITH THE THICKEST LAYER BEING 4 INCHES. STAGGER ALL JOINTS BETWEEN LAYERS 12 INCHES.
- 3.ON AREA 'K' INSTALL 3" THICK FLAT ISOCYANURATE INSULATION OVER 2-1/2" THICK FLAT ISOCYANURATE
- 4.0N THE THE SLOPED PORTIONS OF AREA 'N' INSTALL 1-1/2" THICK FLAT ISOCYANURATE INSULATION OVER 2-1/2" THICK FLAT ISOCYANURATE NAILBOARD INSULATION.

INSTALL NEW CAP FLASHING

REPLACE LOOSE EPDM

EPDM FLASHING

REPLACE EPDM DRAIN FLASHING

REPLACE LOOSE EPDM

EPDM FLASHING

REPAIR HOLES/CUTS IN

EPDM WITH 8" SQUARE

EPDM TARGET PATCH

FLASHING WITH NEW 9" WIDE

21&22 PHS A626

21&22 PHS A626

REPLACE VENTILATOR SEE DETAIL

ROOF PLAN

42/PHS-A-628

REMOVE SCAFFOLDING

SCRAPE, PRIME AND PAINT ENTIRE CHIMNEY. INSTALL NEW CAP FLASHING AT BASE OF CHIMNEY (3 SIDES)

SEE DETAIL 41/PHS-A628

REPLACE LOOSE EPDM

FLASHING WITH NEW 9"

WIDE EPDM FLASHING

REPLACE TURBINE

42/PHS-A-628

VENTILATOR SEE DETAIL

17&18 PHS A626

MATERIAL FROM THE ROOF

 $\overline{}$ FLASHING WITH NEW 9" WIDE

THIS AREA — SEE DETAIL

41/PHS-A628

(c)

- 5.INSTALL ISOCYANURATE INSULATION CRICKETS UNDER THE TAPERED INSULATION.
- 6.INSTALL A COVER BOARD USING LOW RISE FOAM ADHESIVE OVER THE INSULATION AND CRICKETS.
- 7.ROOF AREAS 'N', 'P', 'U' AND 'W' ARE EXTERIOR CANOPIES, R-VALUE CALCULATIONS ARE NOT NEEDED. $^{
 m I}$ 8.Install sloping crickets on the up-Hill side of all curbs that are 30 inches and wider.


- **ROOF PROTECTION NOTES:**
- 1. AVOID WALKING ON NEW AND EXISTING N.I.C. ROOF AREAS. 2. DO NOT STORE MATERIAL OR EQUIPMENT, AND DO NOT PILE DEBRIS ON NEW ROOF AREAS.
- 3. INSTALL 1 INCH THICK EXTRUDED POLYSTYRENE INSULATION OVER 6 MIL FIRE RETARDANT POLYETHYLENE, COVERED WITH 2x10 WOOD PLANKS TO PROTECT ROOFING WHERE CONSTRUCTION WORK AND TRAFFIC WILL OCCUR.
- 4. NEATLY CUT AND POSITION ROOF PROTECTION COMPONENTS TO FIT WITHIN 1/2 INCH OF ROOF PENETRATIONS, EAVES AND CHANGE IN ELEVATION WALLS.
- 5. DO NOT COVER THE ROOF DRAINS. MAINTAIN THE ROOF DRAIN STRAINERS VISIBLE AND CLEAR AT ALL TIMES.

CODE COMPLIANCE REQUIREMENTS:

- 1. INSTALL ROOFING TO MEET THE FOLLOWING MINIMUM REQUIREMENTS: A. NY STATE UNIFORM FIRE PREVENTION AND BUILDING CODE. B. UNDERWRITERS LABORATORIES INC. CLASS A EXTERNAL FIRE RATING FOR ROOF COVERING MATERIALS. C. UNDERWRITERS LABORATORIES INC. STANDARD 1256 FOR ROOF ASSEMBLIES WITH FOAM INSULATION.
- 2. INSTALL ROOFING TO COMPLY WITH THE WIND UPLIFT REQUIREMENTS OF THE NY STATE UNIFORM FIRE PREVENTION AND BUILDING CODE: RISK CATEGORY III BASIC WIND SPEED 120 MPH EXPOSURE CATEGORY B

BUILDING HEIGHT 30 FT

- 3. INSTALL ROOFING AS INDICATED TO RESIST THE FOLLOWING UPLIFT LOADS, CALCULATED IN ACCORDANCE WITH ASCE 7 USING A SAFETY FACTOR OF 2: FIELD ZONE: 60 PSF PERIMETER ZONE: 100 PSF CORNER ZONE: 150 PSF
- 4. FABRICATE AND INSTALL ROOF PERIMETER FLASHINGS THAT COMPLY WITH THE NY STATE UNIFORM FIRE PREVENTION AND BUILDING CODE AND WITH ANSI/SPRI ES-1 "WIND STANDARD FOR EDGE SYSTEMS USED WITH LOW SLOPE ROOFING SYSTEMS".

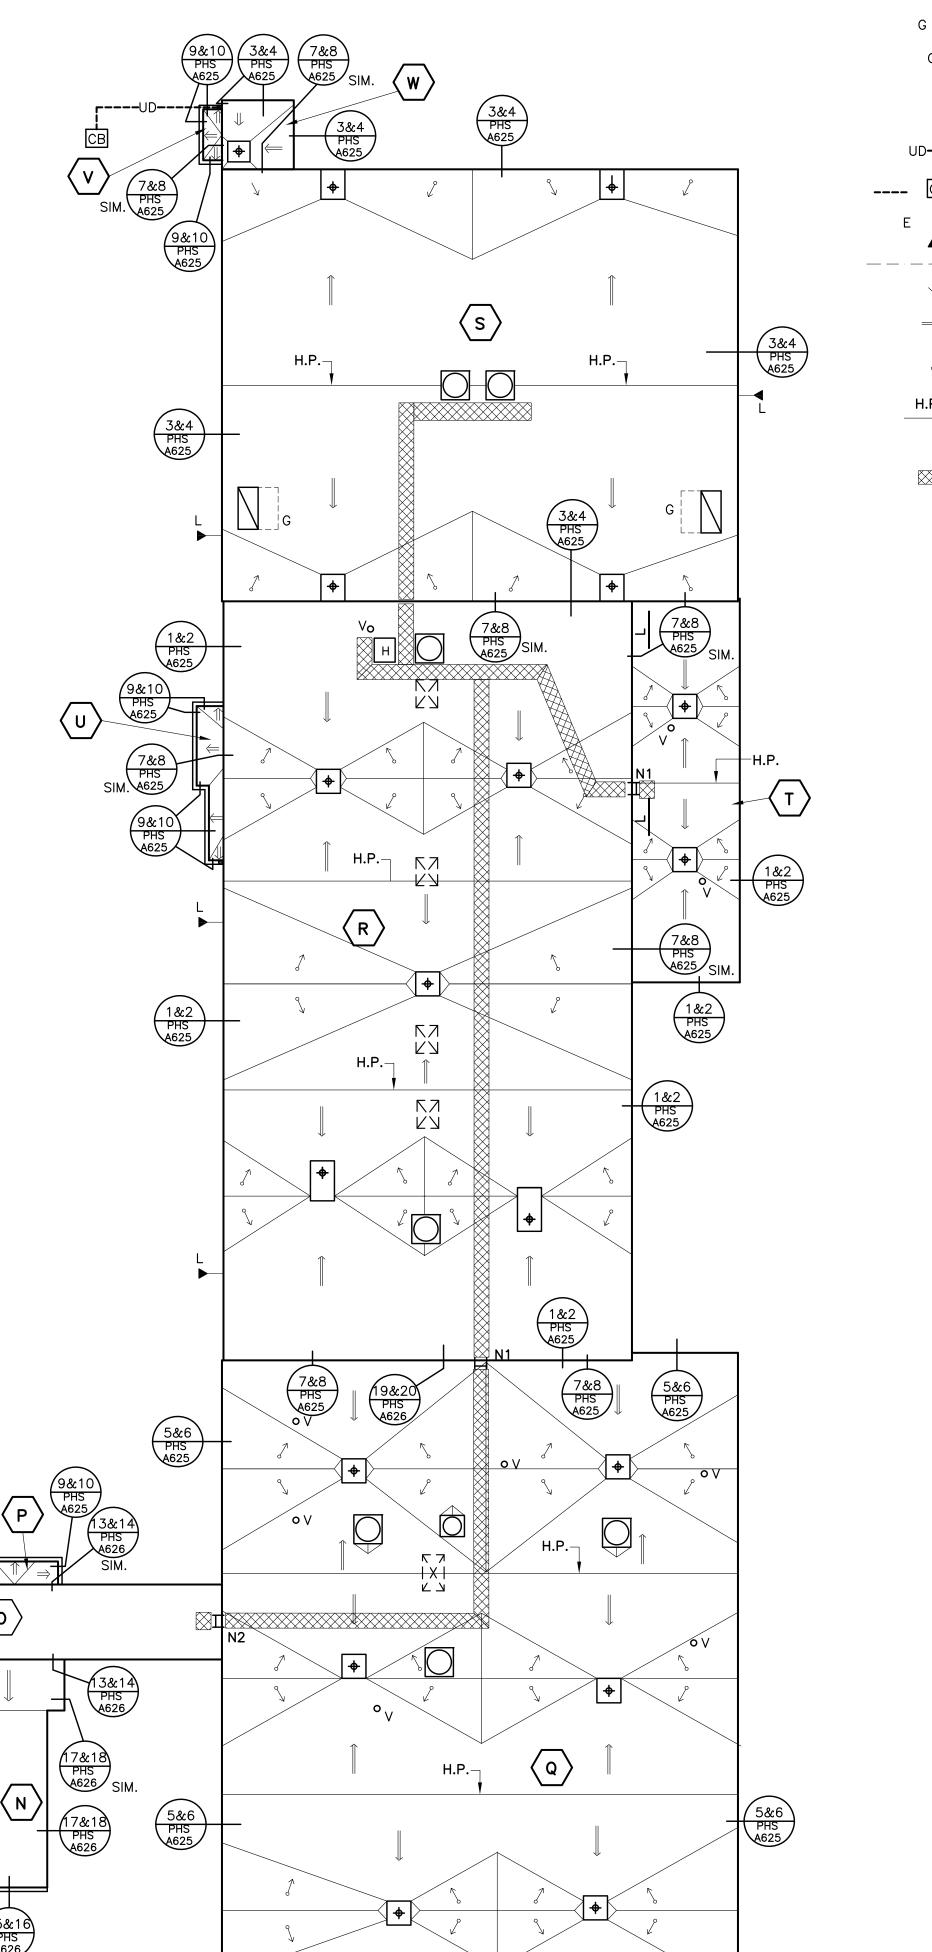

LEGEND:

A ROOF AREA DESIGNATION

- (SEE DETAIL 27/PHS-A627)
- o V VENT PIPE
- (SEE DETAIL 28/PHS-A627) EXHAUST FAN
 (SEE DETAIL 29/PHS-A627)
- ROOF HATCH (SEE DETAIL 30/PHS-A627)
- P. SEALANT POCKET
- (SEE DETAIL 31/PHS-A627) WALL LOUVER
- ___ (SEE DETAIL 32/PHS-A627)

SCUPPER

- S = (SEE DETAIL 33/PHS-A627) CURB (SEE DETAIL 34/PHS-A627)
- ABANDONED SKYLIGHT OR CAPPED \checkmark $^{\prime}$ CURB (SEE DETAIL 35/PHS-A627)
- NEW ROOF LADDER N1 (SEE DETAIL 37/PHS-A628)
- N2 NEW ROOF LADDER
- (SEE DETAIL 38/PHS-A628) LOUVERED PENTHOUSE
- V (SEE DETAIL 39/PHS−A628) OS___ NEW OVERFLOW SCUPPER ON EXISTING THE ROOFS (SEE DETAIL 40/PHS-A628)
- EXISTING ROOF LADDER E (SEE NOTE 6)
- NEW UNDERGROUND DRAIN LINE (SEE NOTE 7)
- EXISTING CATCH BASIN
- SITE LIGHT (SEE DETAIL NOTE 8)
- DECK SLOPE TAPERED ISOCYANURATE
- \implies INSULATION, MINIMUM 5-1/2" THICK, SLOPE 1/8"PER FT
- H.P. INSULATION HIGH POINT → DECK SLOPE
- WALKWAY PADS

1. DIMENSIONS AND CONDITIONS ON THE ROOF PLAN AND DETAILS ARE APPROXIMATE AND SHALL BE CONFIRMED BY THE CONTRACTOR. ONLY CERTAIN FASTENERS ARE SHOWN ON THE DRAWINGS, REFER TO THE SPECIFICATIONS FOR ADDITIONAL FASTENER REQUIREMENTS. 2. TEST THE DRAIN LINES WITH A RUNNING HOSE FOR AT LEAST ONE HOUR PRIOR TO

STARTING ANY OTHER WORK. PROVIDE A WRITTEN REPORT OF ANY CLOGGED LINES TO THE ARCHITECT & OWNER. CLOGGED DRAIN LINES WILL BE CLEANED BY THE OWNER. A. COVER & PROTECT ALL DRAIN OPENINGS AT THE BEGINNING OF EACH WORK DAY. REMOVE THE COVERS AT THE END OF EACH DAY AND BEFORE PRECIPITATION OCCURS. B. PERFORM WHATEVER WORK IS REQUIRED SO THE DRAIN LINES ARE CLEAN, CLEAR AND IN FREE FLOWING CONDITION AT THE COMPLETION OF THE PROJECT.

3. REFASTEN LOOSE SECTIONS OF STRUCTURAL WOOD FIBER DECKS AS BASE BID WORK. REPAIR THE TOP SURFACE OF STRUCTURAL WOOD FIBER AND CONCRETE DECKS AS BASE BID WORK. REPLACE DAMAGED OR DETERIORATED SECTIONS OF DECK IN ACCORDANCE WITH

4. REPAIR EXHAUST FAN AND VENTILATOR HOUSINGS SO THEY ARE WATERTIGHT.


DO NOT PAINT OVER THE NAME PLATES AND LABELS. 6. REMOVE MODIFY AND REMOUNT EXISTING LADDER. REMOVE PORTION OF EIFS TO INSTALL NEW SOLID WOOD BLOCKING TO FASTEN LADDER. COVER WOOD BLOCKING WITH EIFS. SCRAPE, PRIME AND PAINT LADDER.

5. WIRE BRUSH, PRIME & PAINT ROOF TOP EQUIPMENT HOUSINGS, AND THE VENT PIPES.

7. NSTALL NEW 4" DIAMETER SCHEDULE 80 PVC UNDERGROUND DRAIN LINE TO CONNECTED THE NEW LEADERS TO THE EXISTING CATCH BASIN AND STORM DRAIN PIPE. REMOVE AND RESTORE CONCRETE SIDEWALKS, ASPHALT PAVEMENT AND GRASS AREAS TO INSTALL THE NEW DRAIN LINES. SET THE PIPE ON A 4" BED OF PEA GRAVEL AND

SURROUND THE PIPE WITH 4" OF PEA GRAVEL. 8. REMOVE, MODIFY AND REMOUNT EXISTING SITE LIGHTS ONTO THE FACADED JUST BELOW THE NEW ALUMINUM FASCIA.

9. PERFORM ISOLATED WORK ON THE EXISTING EPDM ROOFS TO REHABILITATE THE EXISTING ROOFS AND CORRECT LEAKS. INCLUDE 250 LINEAL FEET OF 9" WIDE EPDM FLASHINGS IN THE BASE BID IN ADDITION TO WHAT IS SHOWN ON THE ROOF PLAN. ALL WORK SHALL BE PERFORMED BY AN AUTHORIZED VERSICO ROOFING SYSTEM APPLICATOR TO MAINTAIN THE EXISTING WARRANTY.

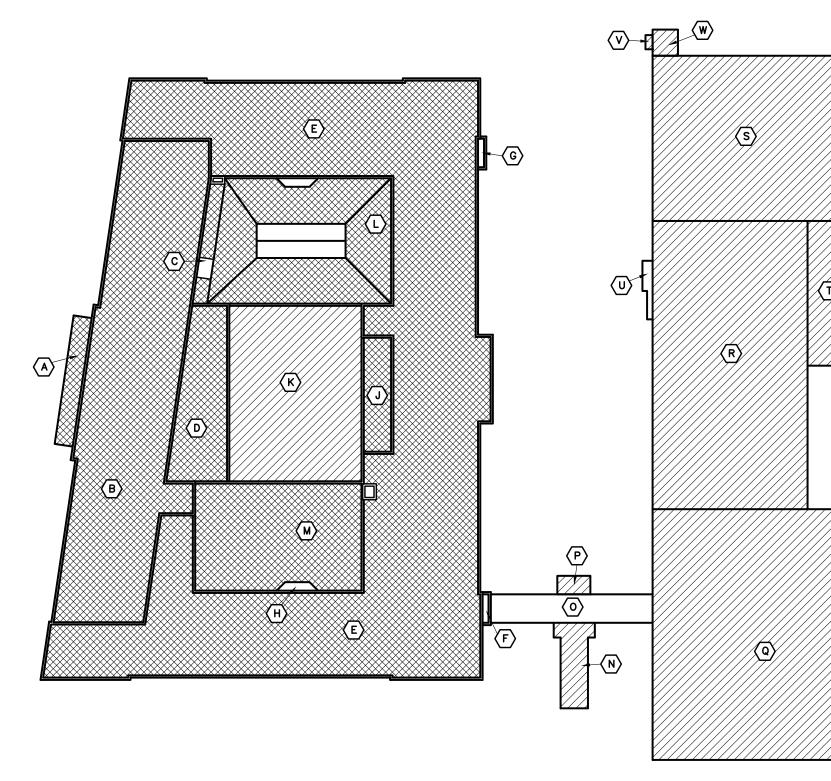

KEY PLAN

NTS

LEGEND: AREAS BEING REPLACED EXISTING ROOFING TO BE REHABILITATED EXISTING ROOFING TO REMAIN

S.E.D. CONTROL NUMBER: 66-23-00-01-0-101-008

02-16-2022 DATE ISSUED TO SHEET SIZE 30"x42" PHS AS NOTED


FILE NO.


19354.07


DRAWN BY


F & D


FILE: I:\19354.07 Yonkers Group B Phase 2 Roofs PS 29 and Pearls\DRAWINGS\RECEIVED\Watsky\2022-02-14\PHSA110 Pearls Hawthorne Roof Plan.dwg

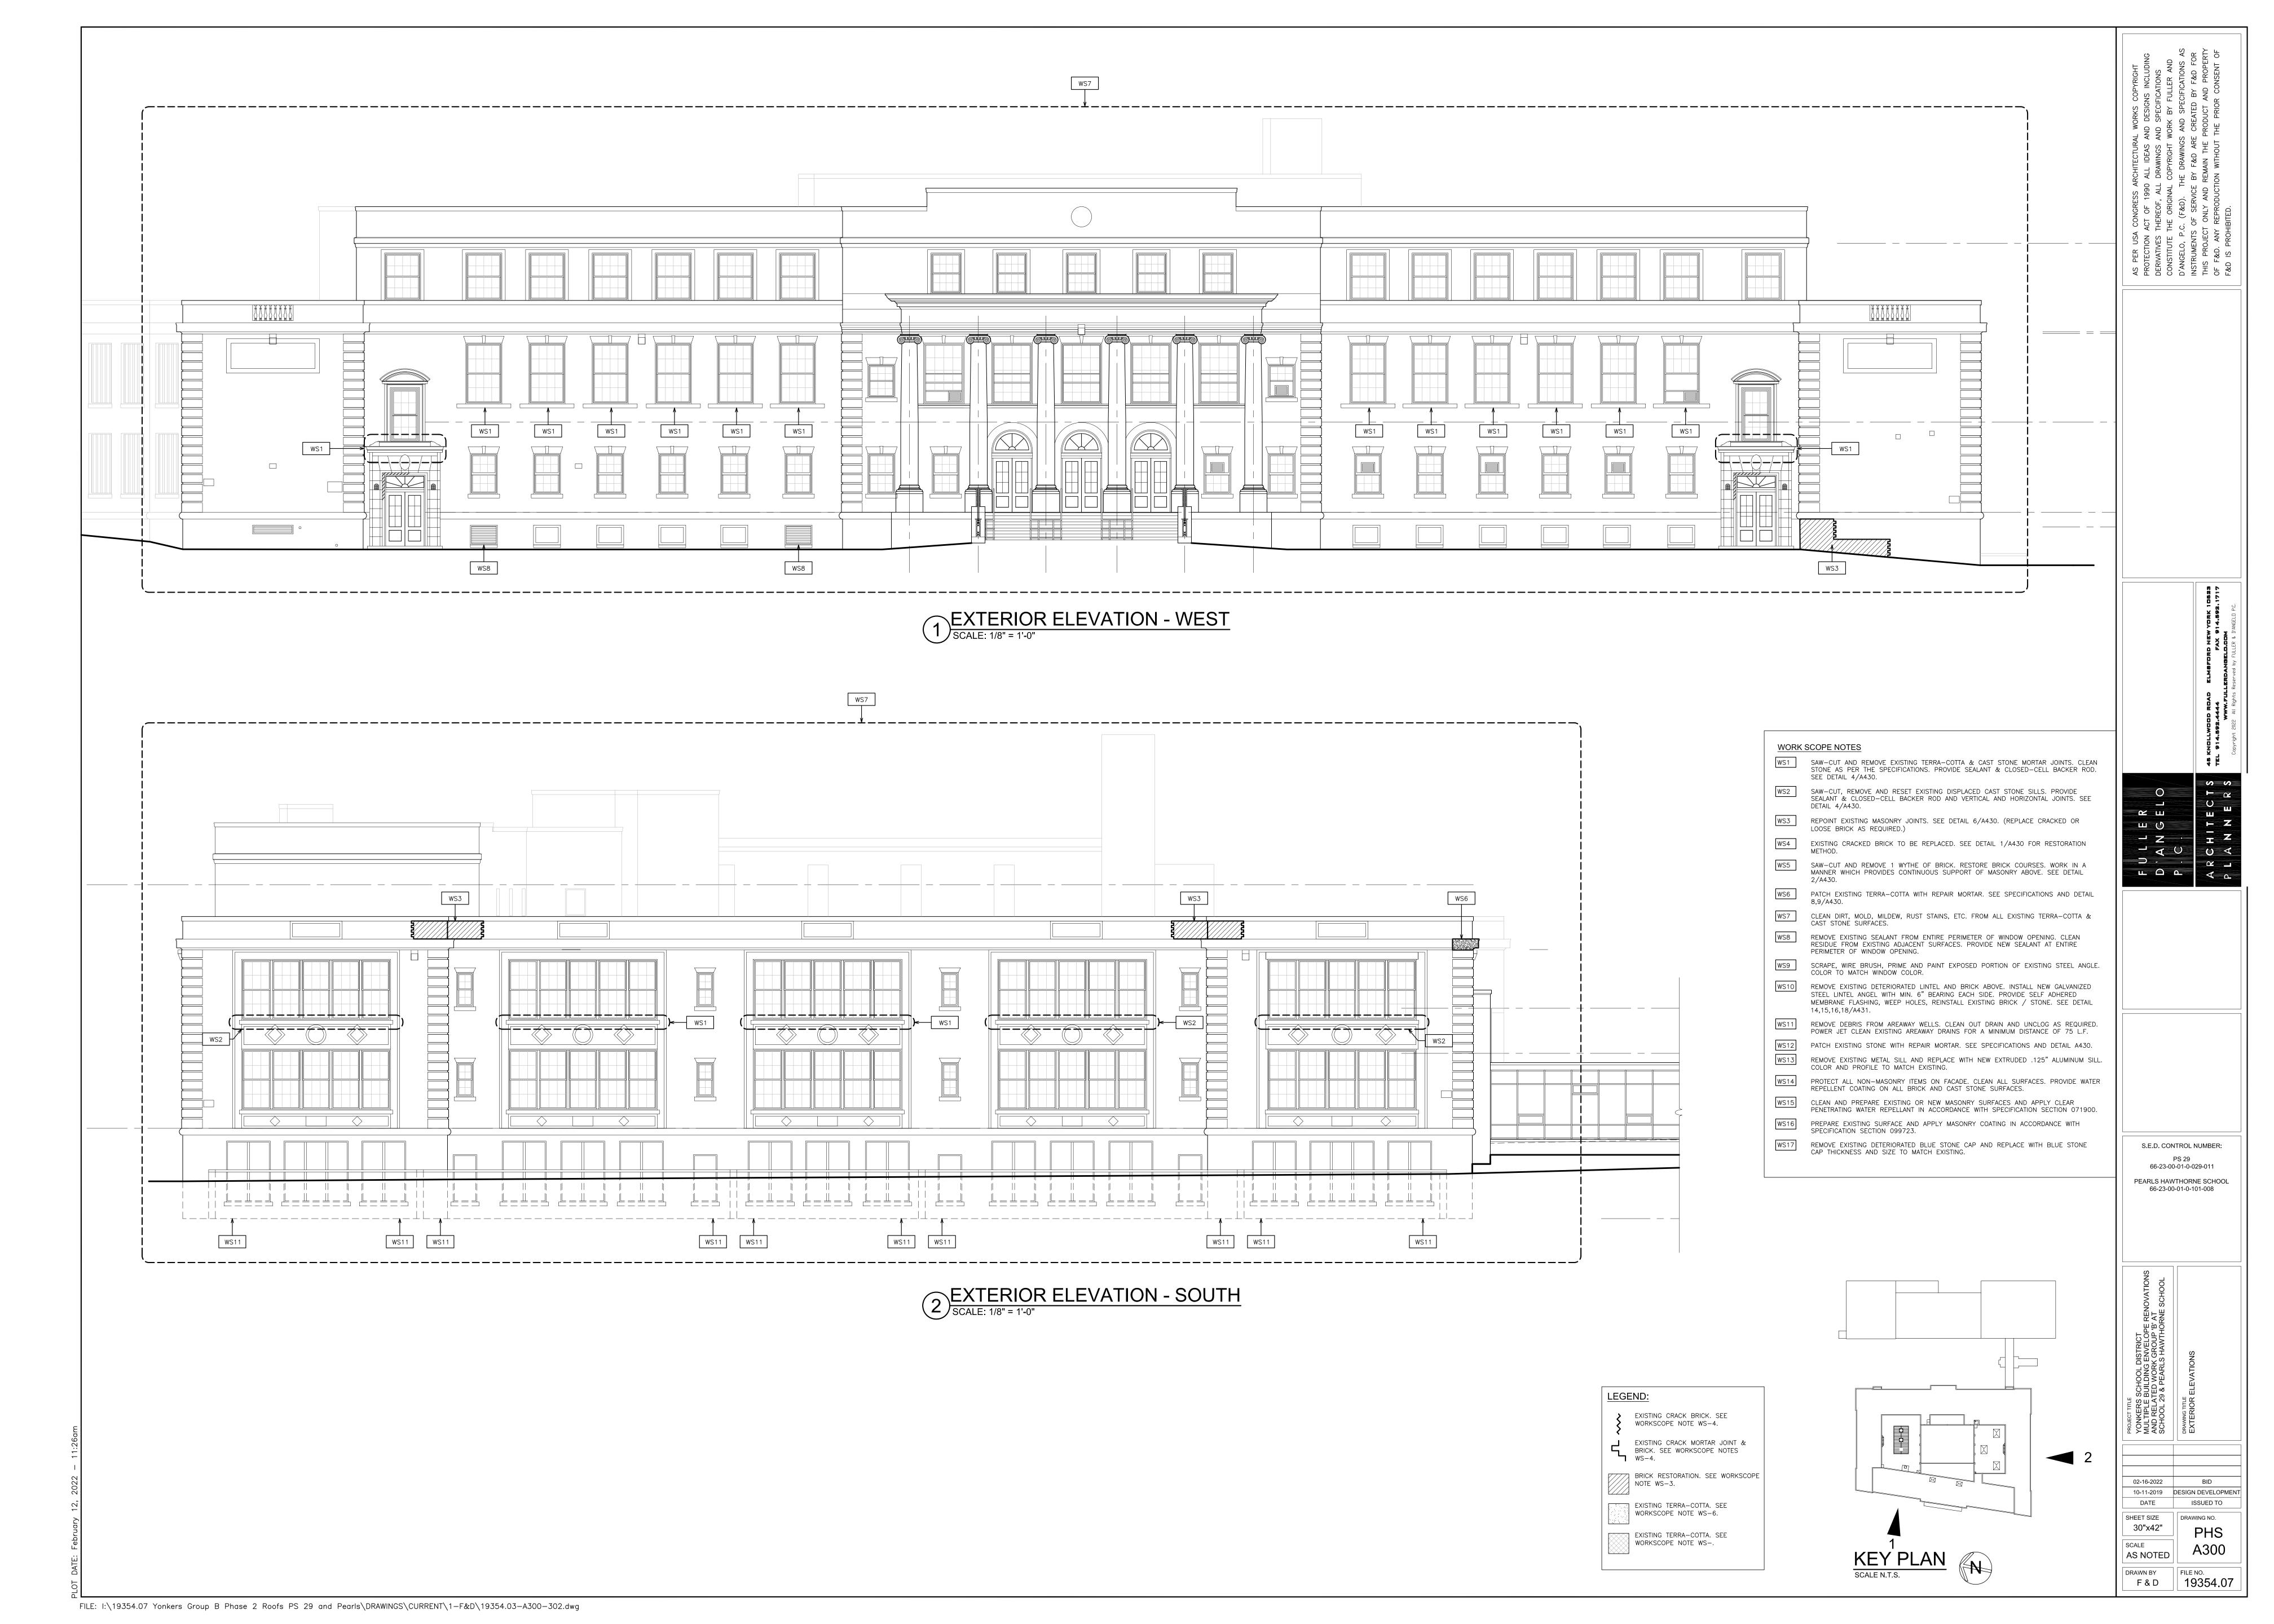


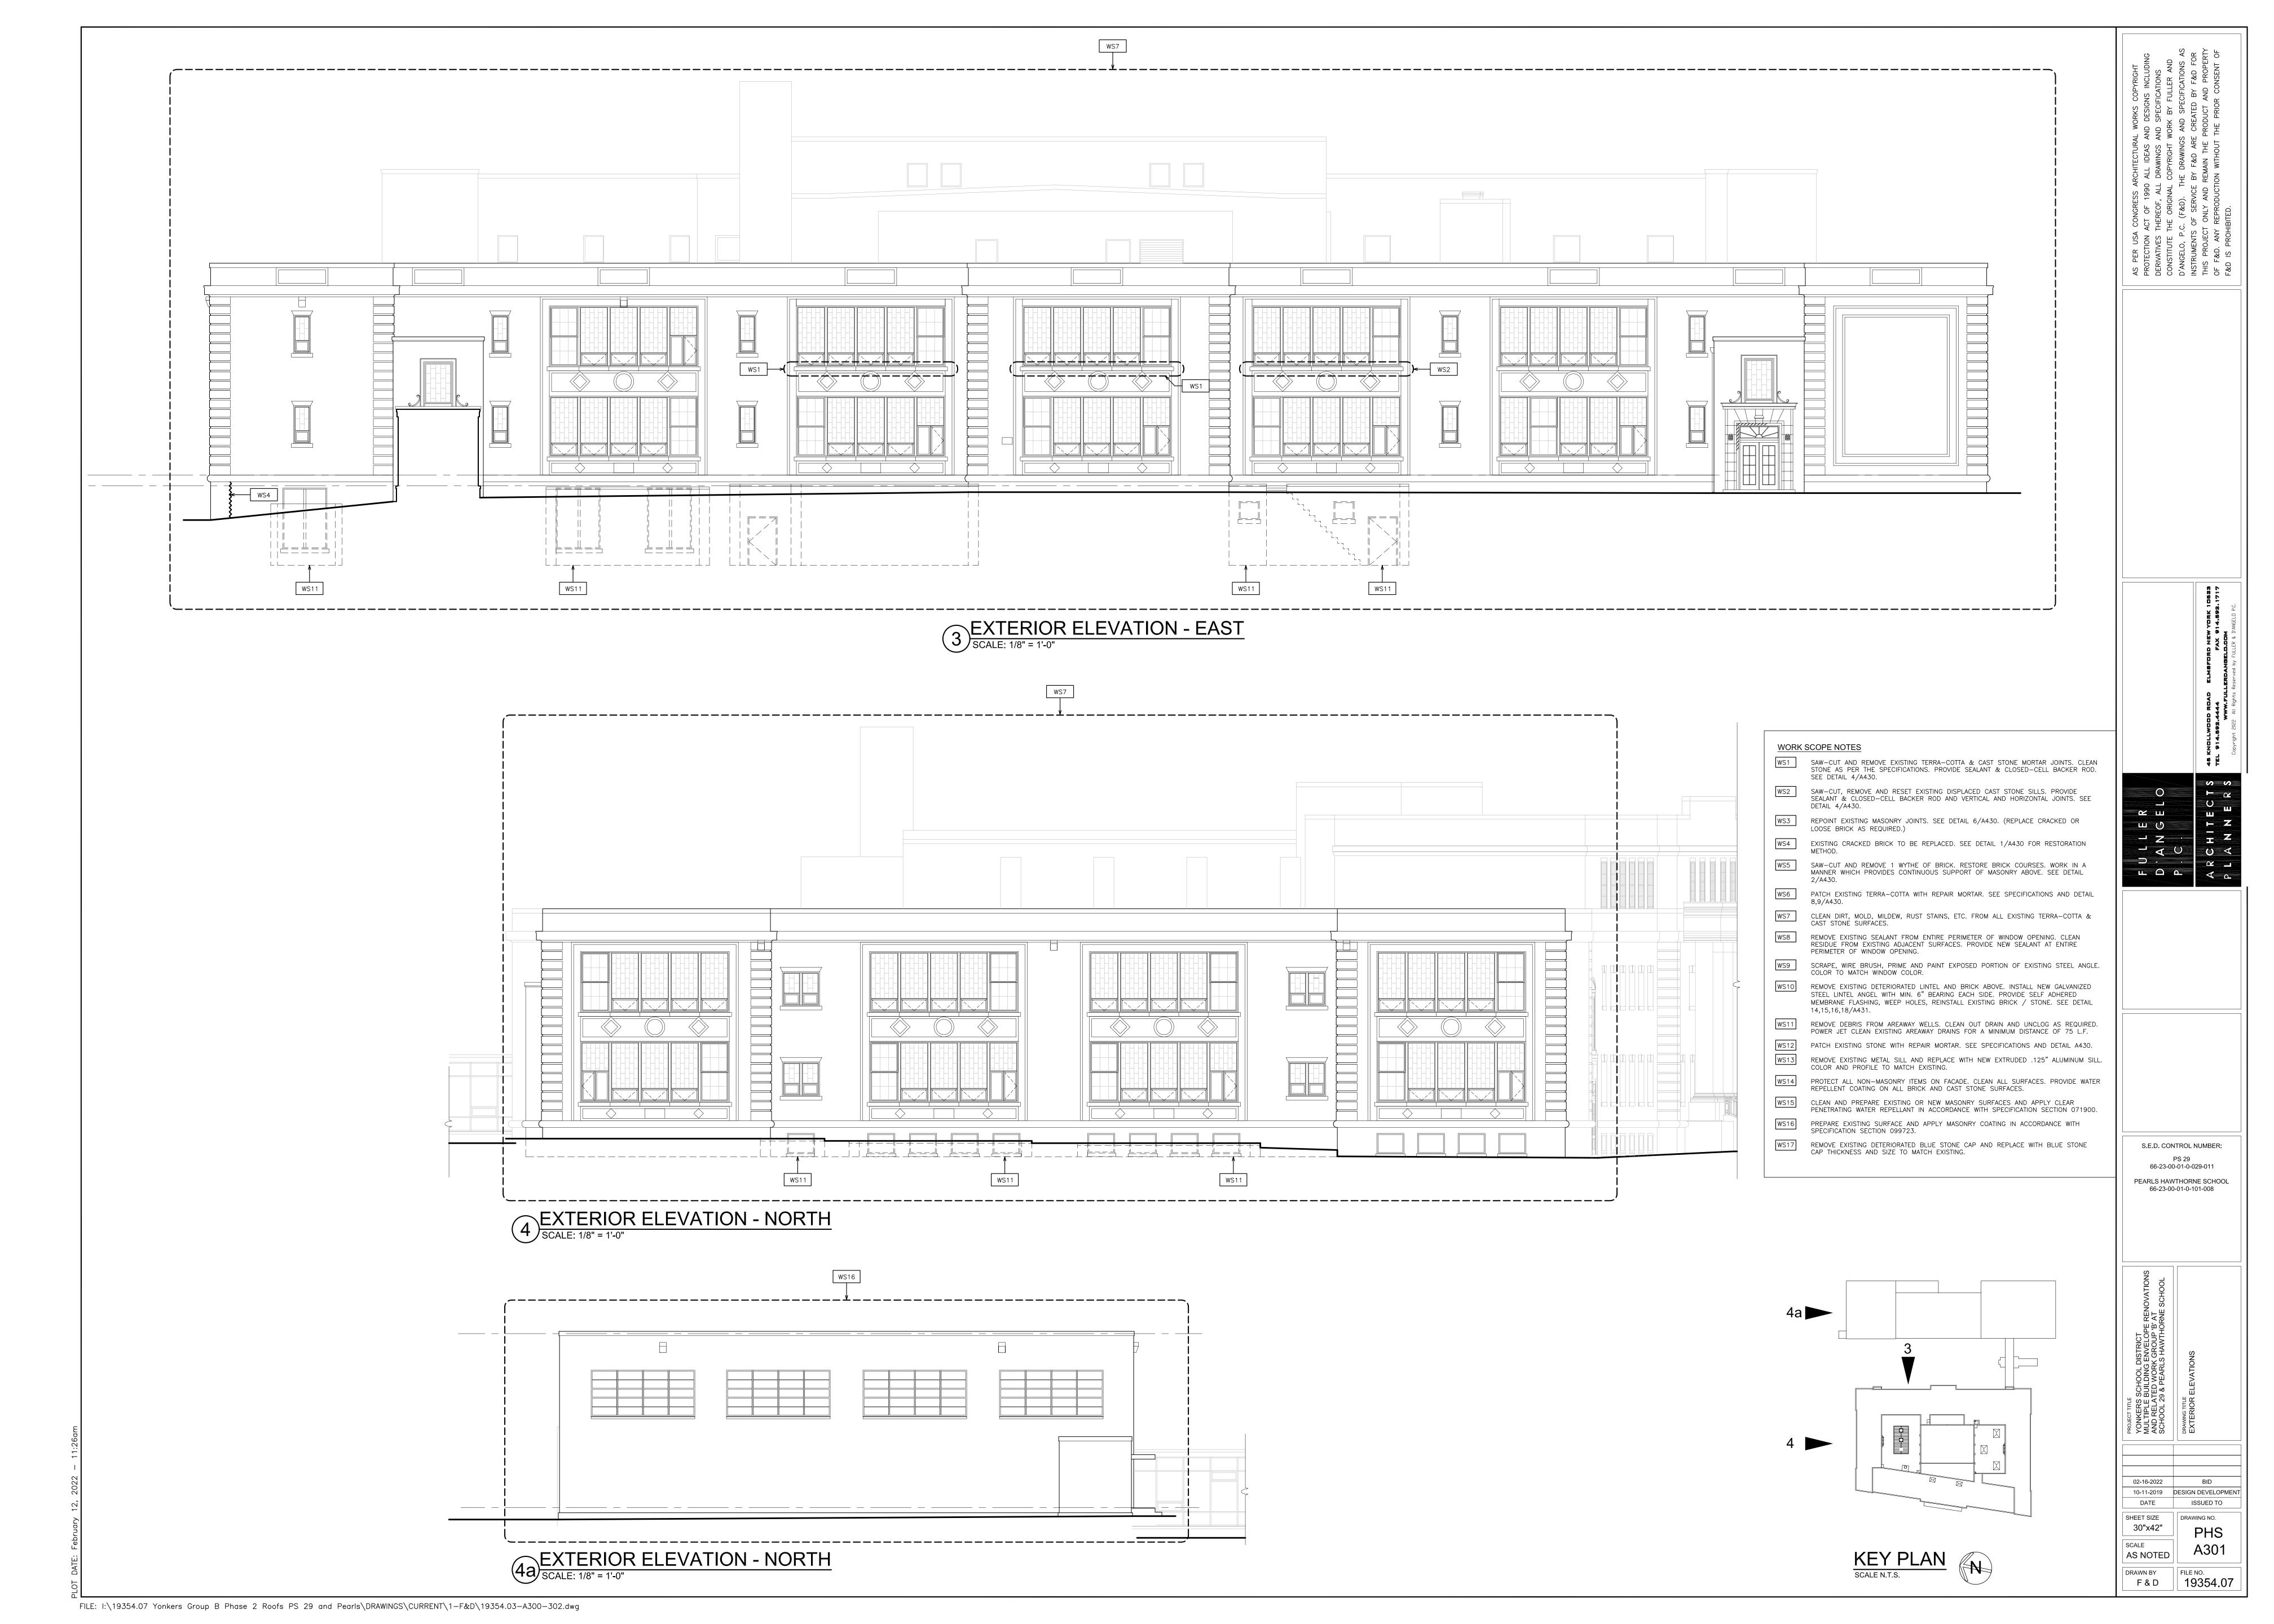


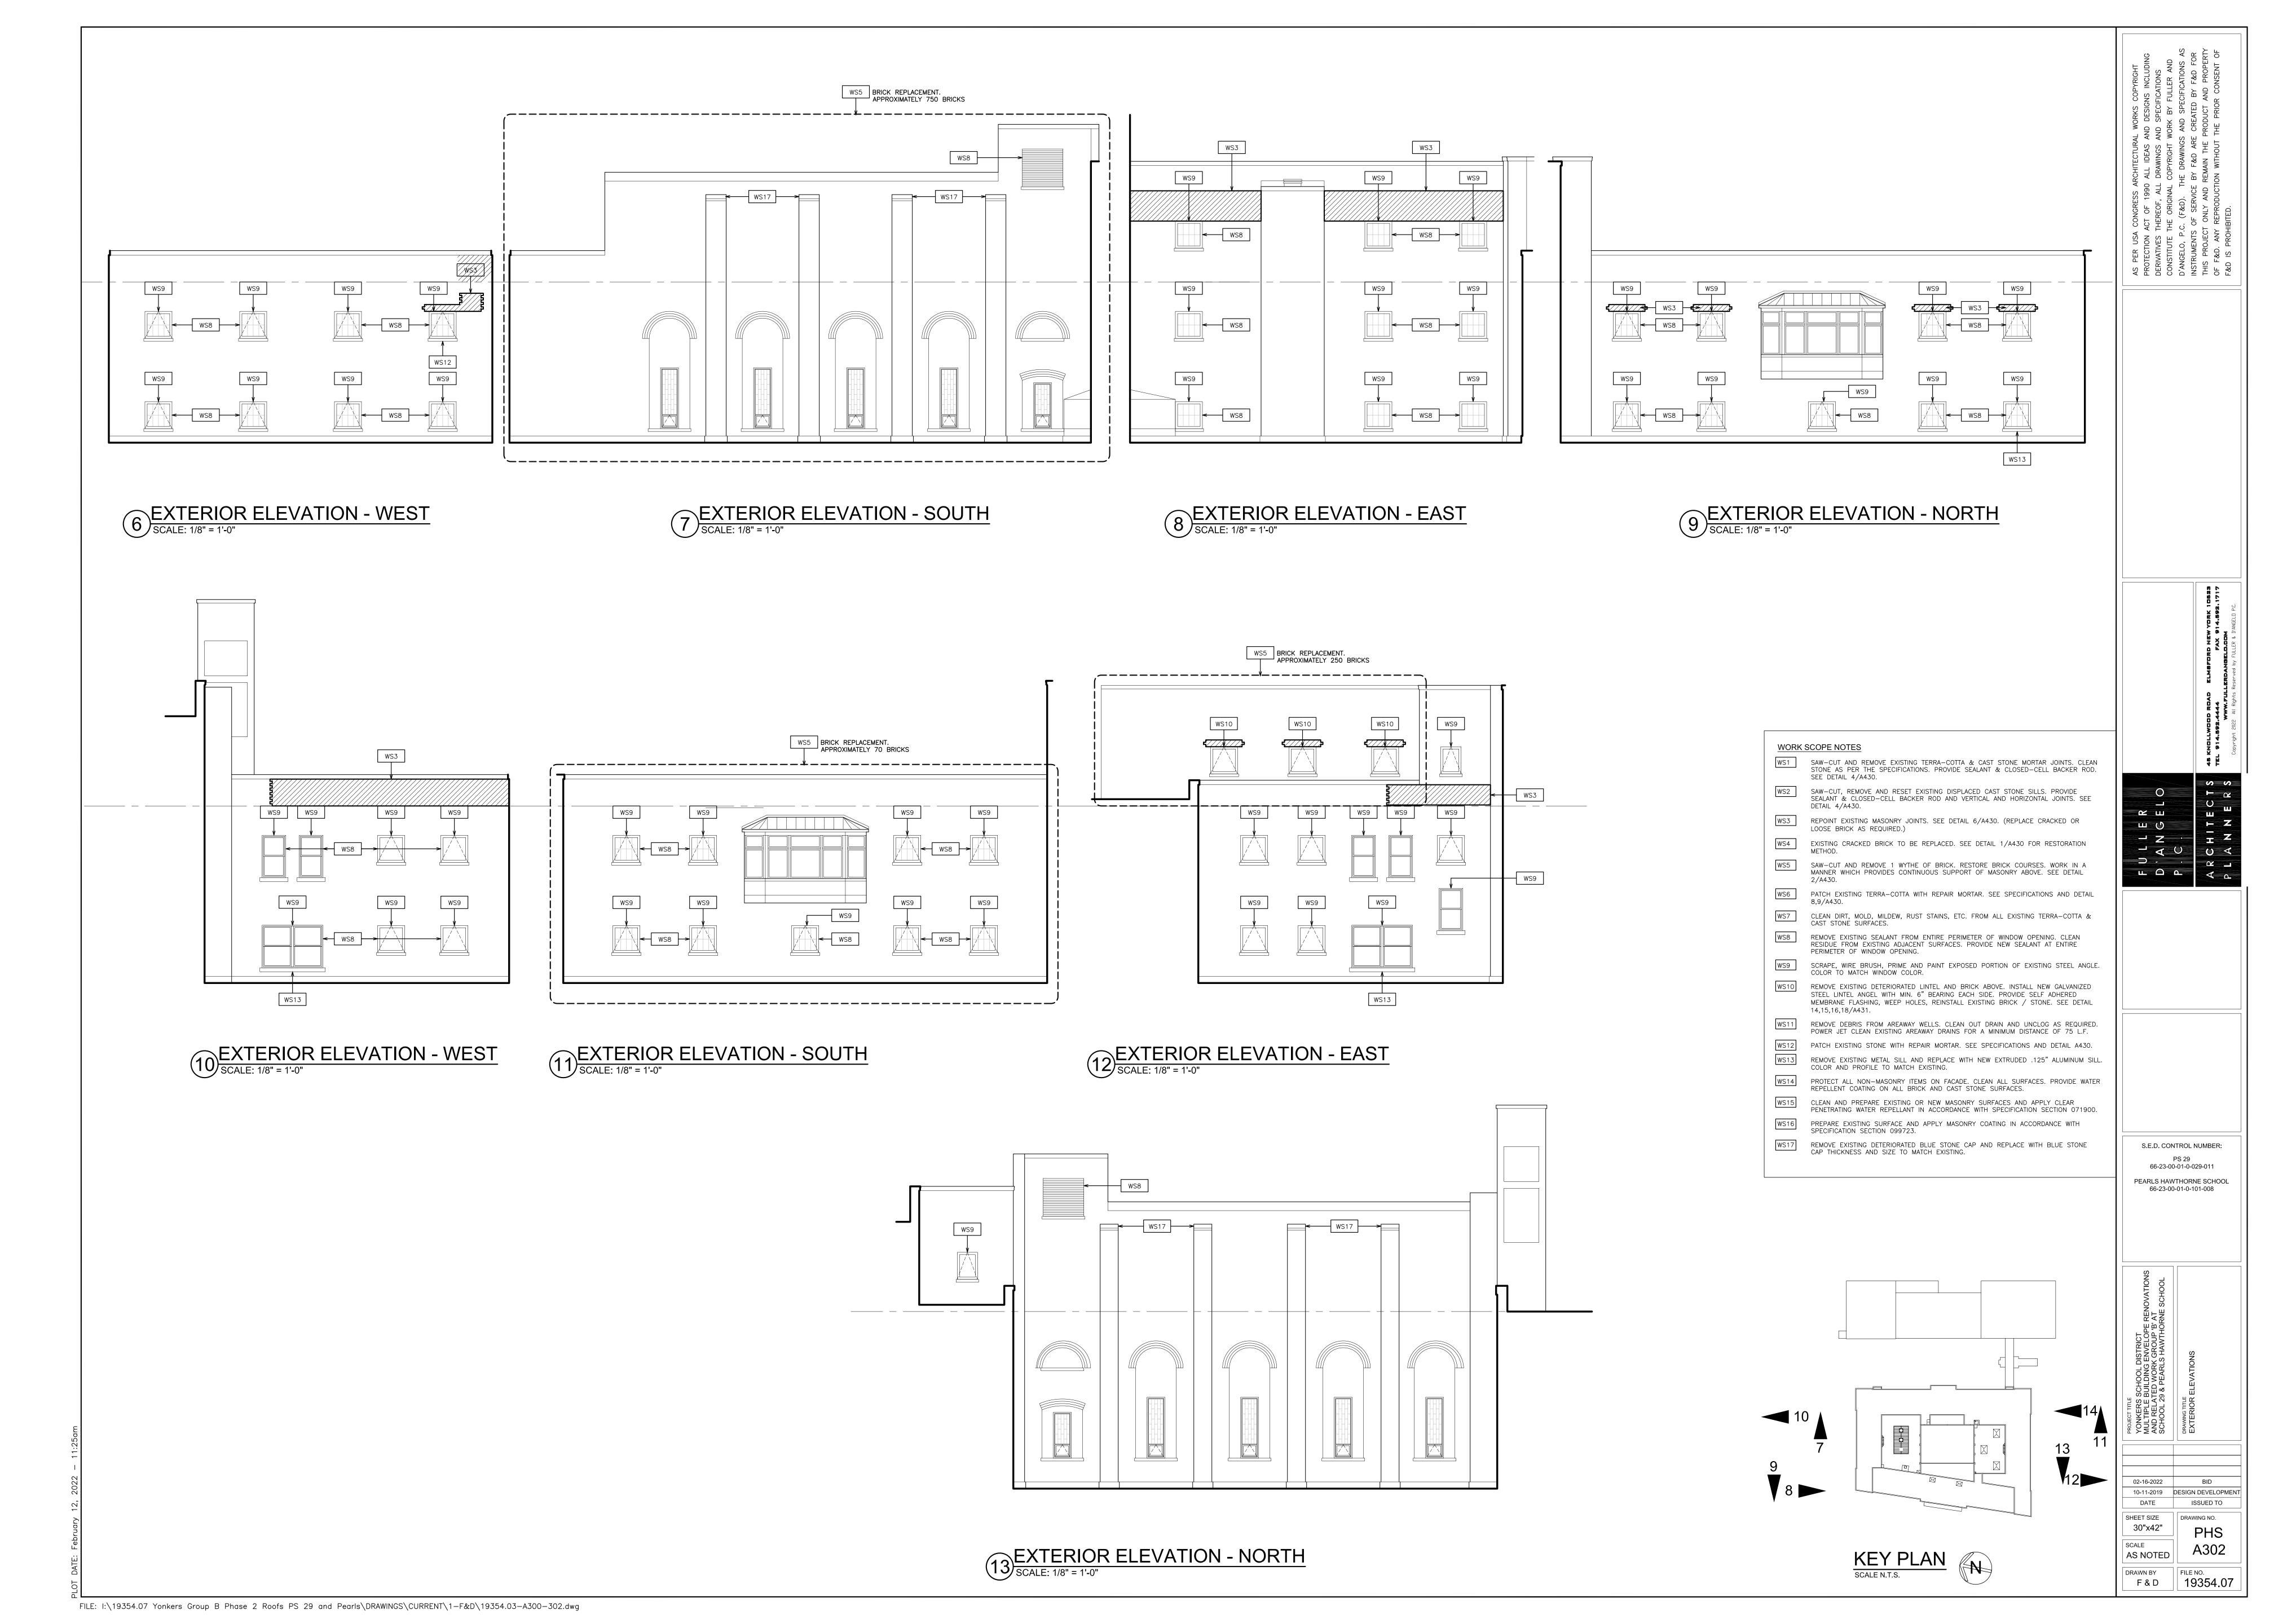

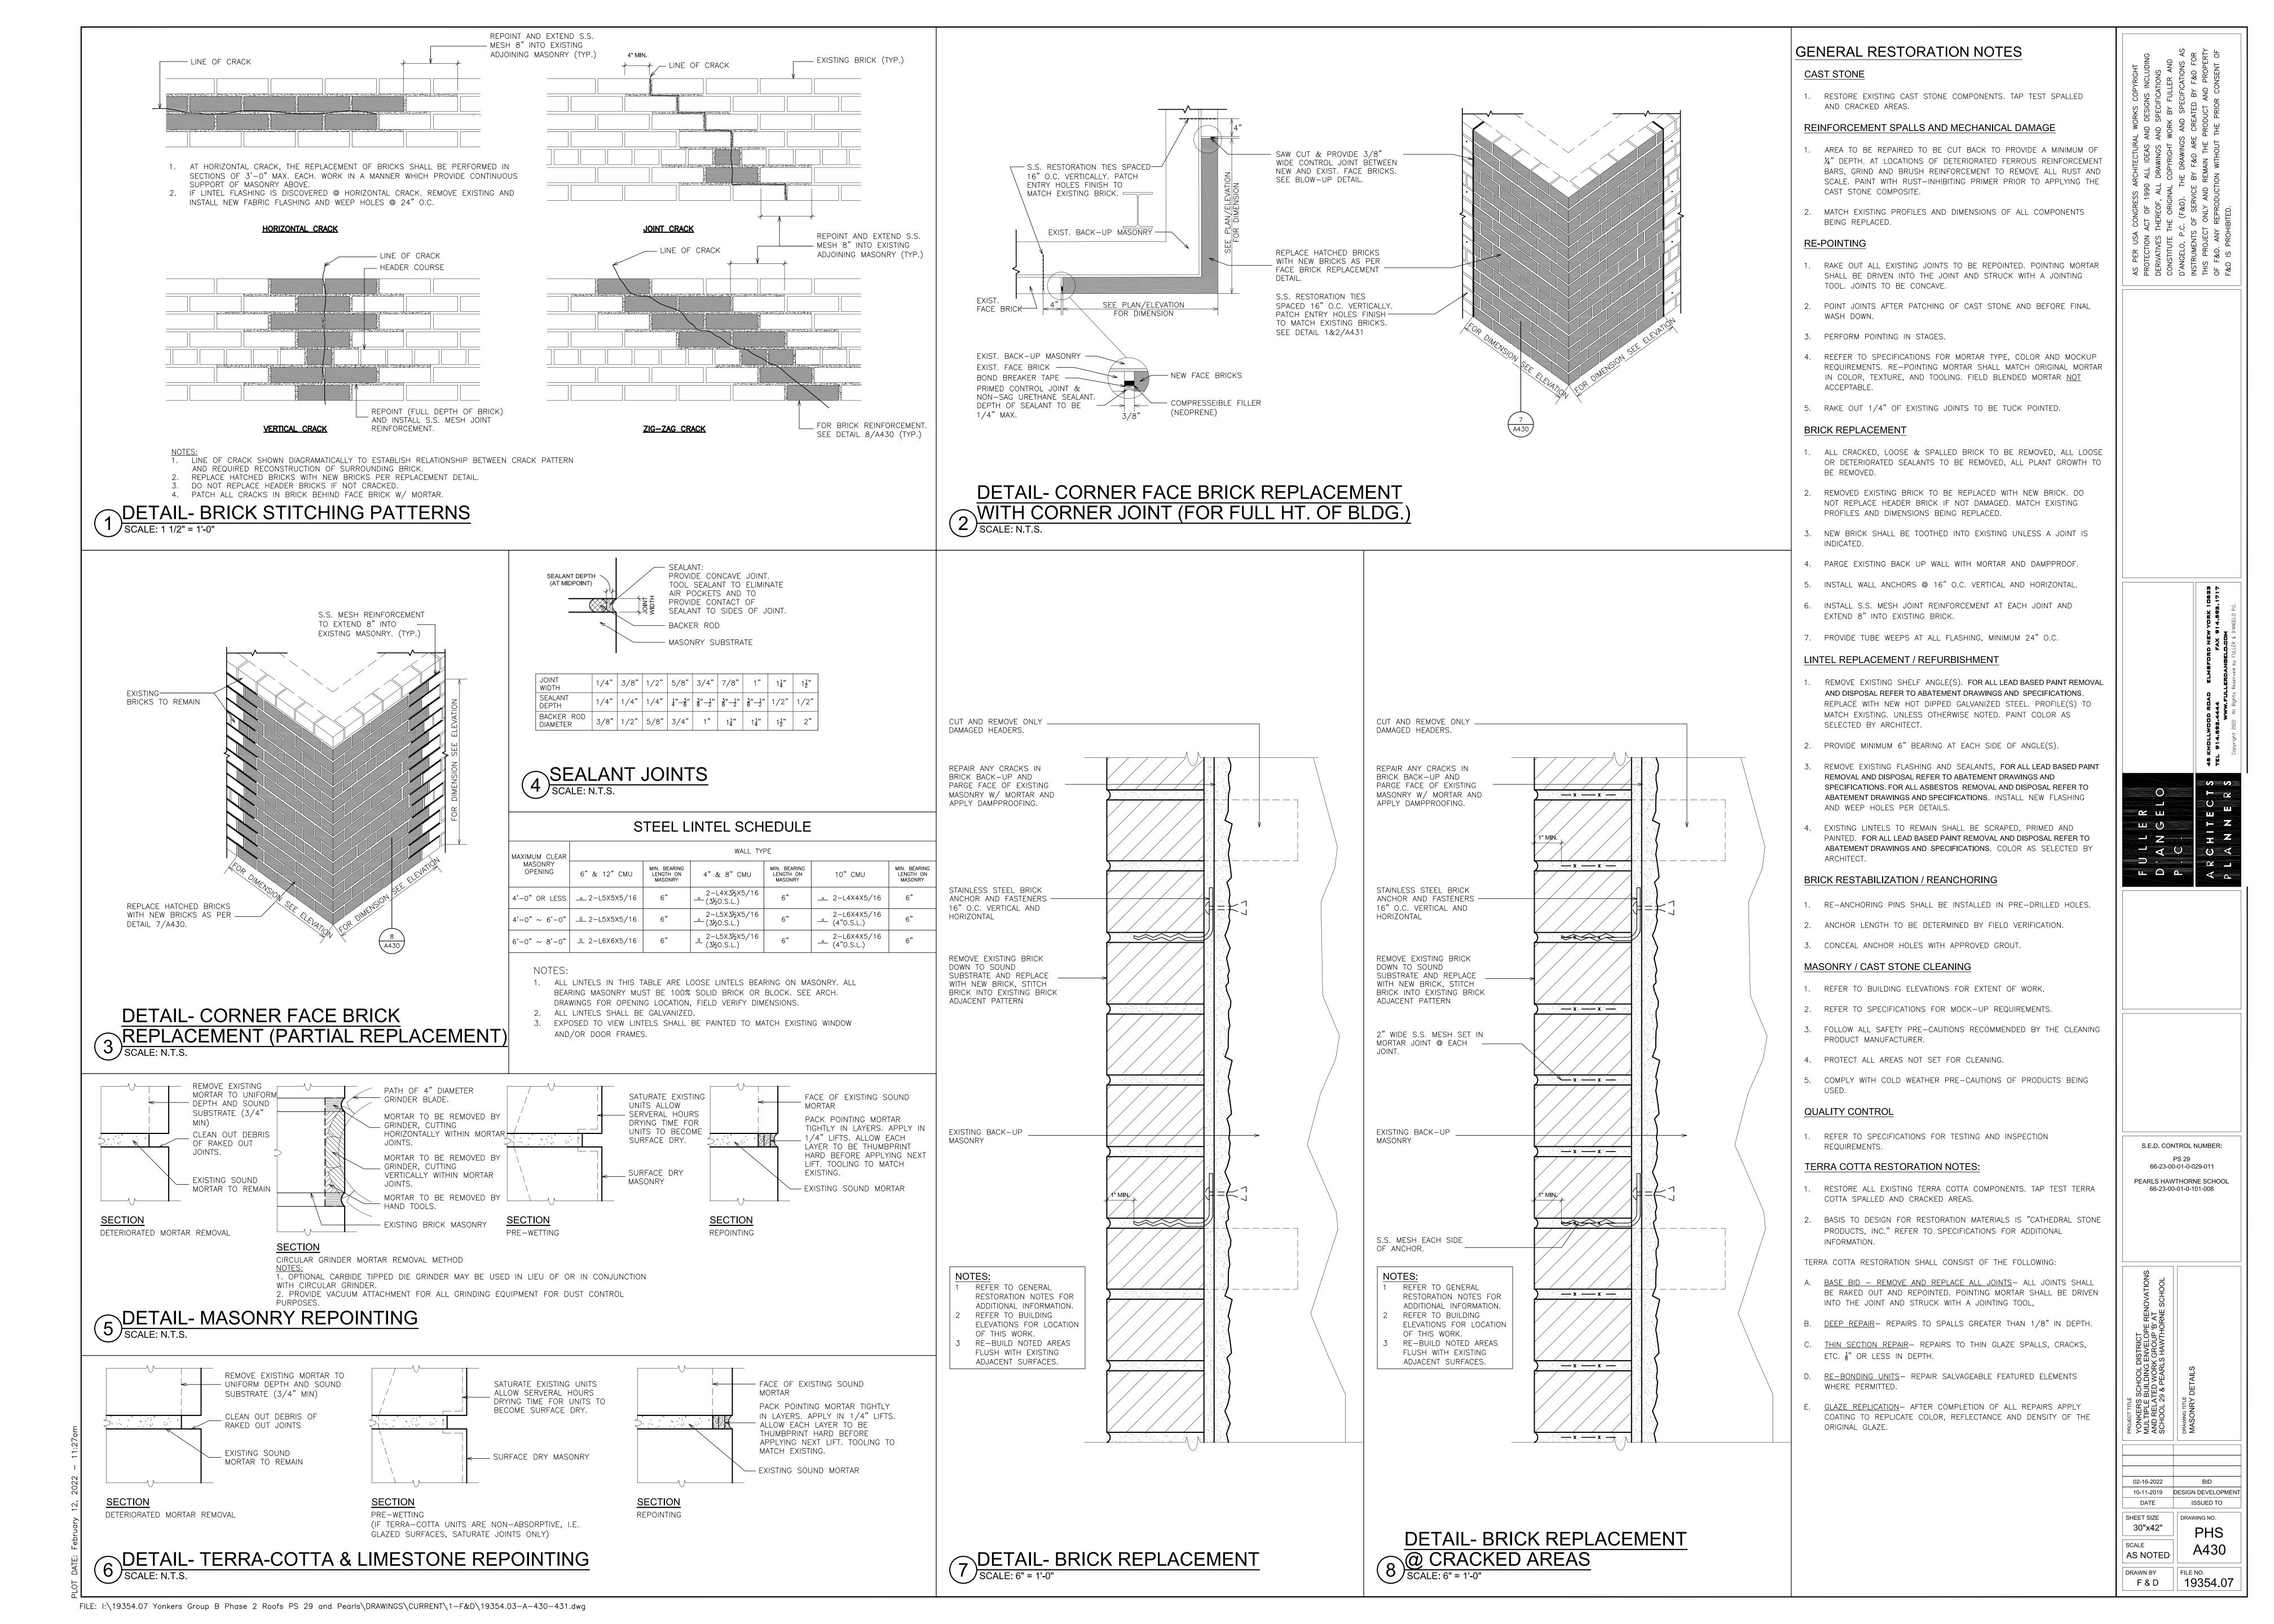


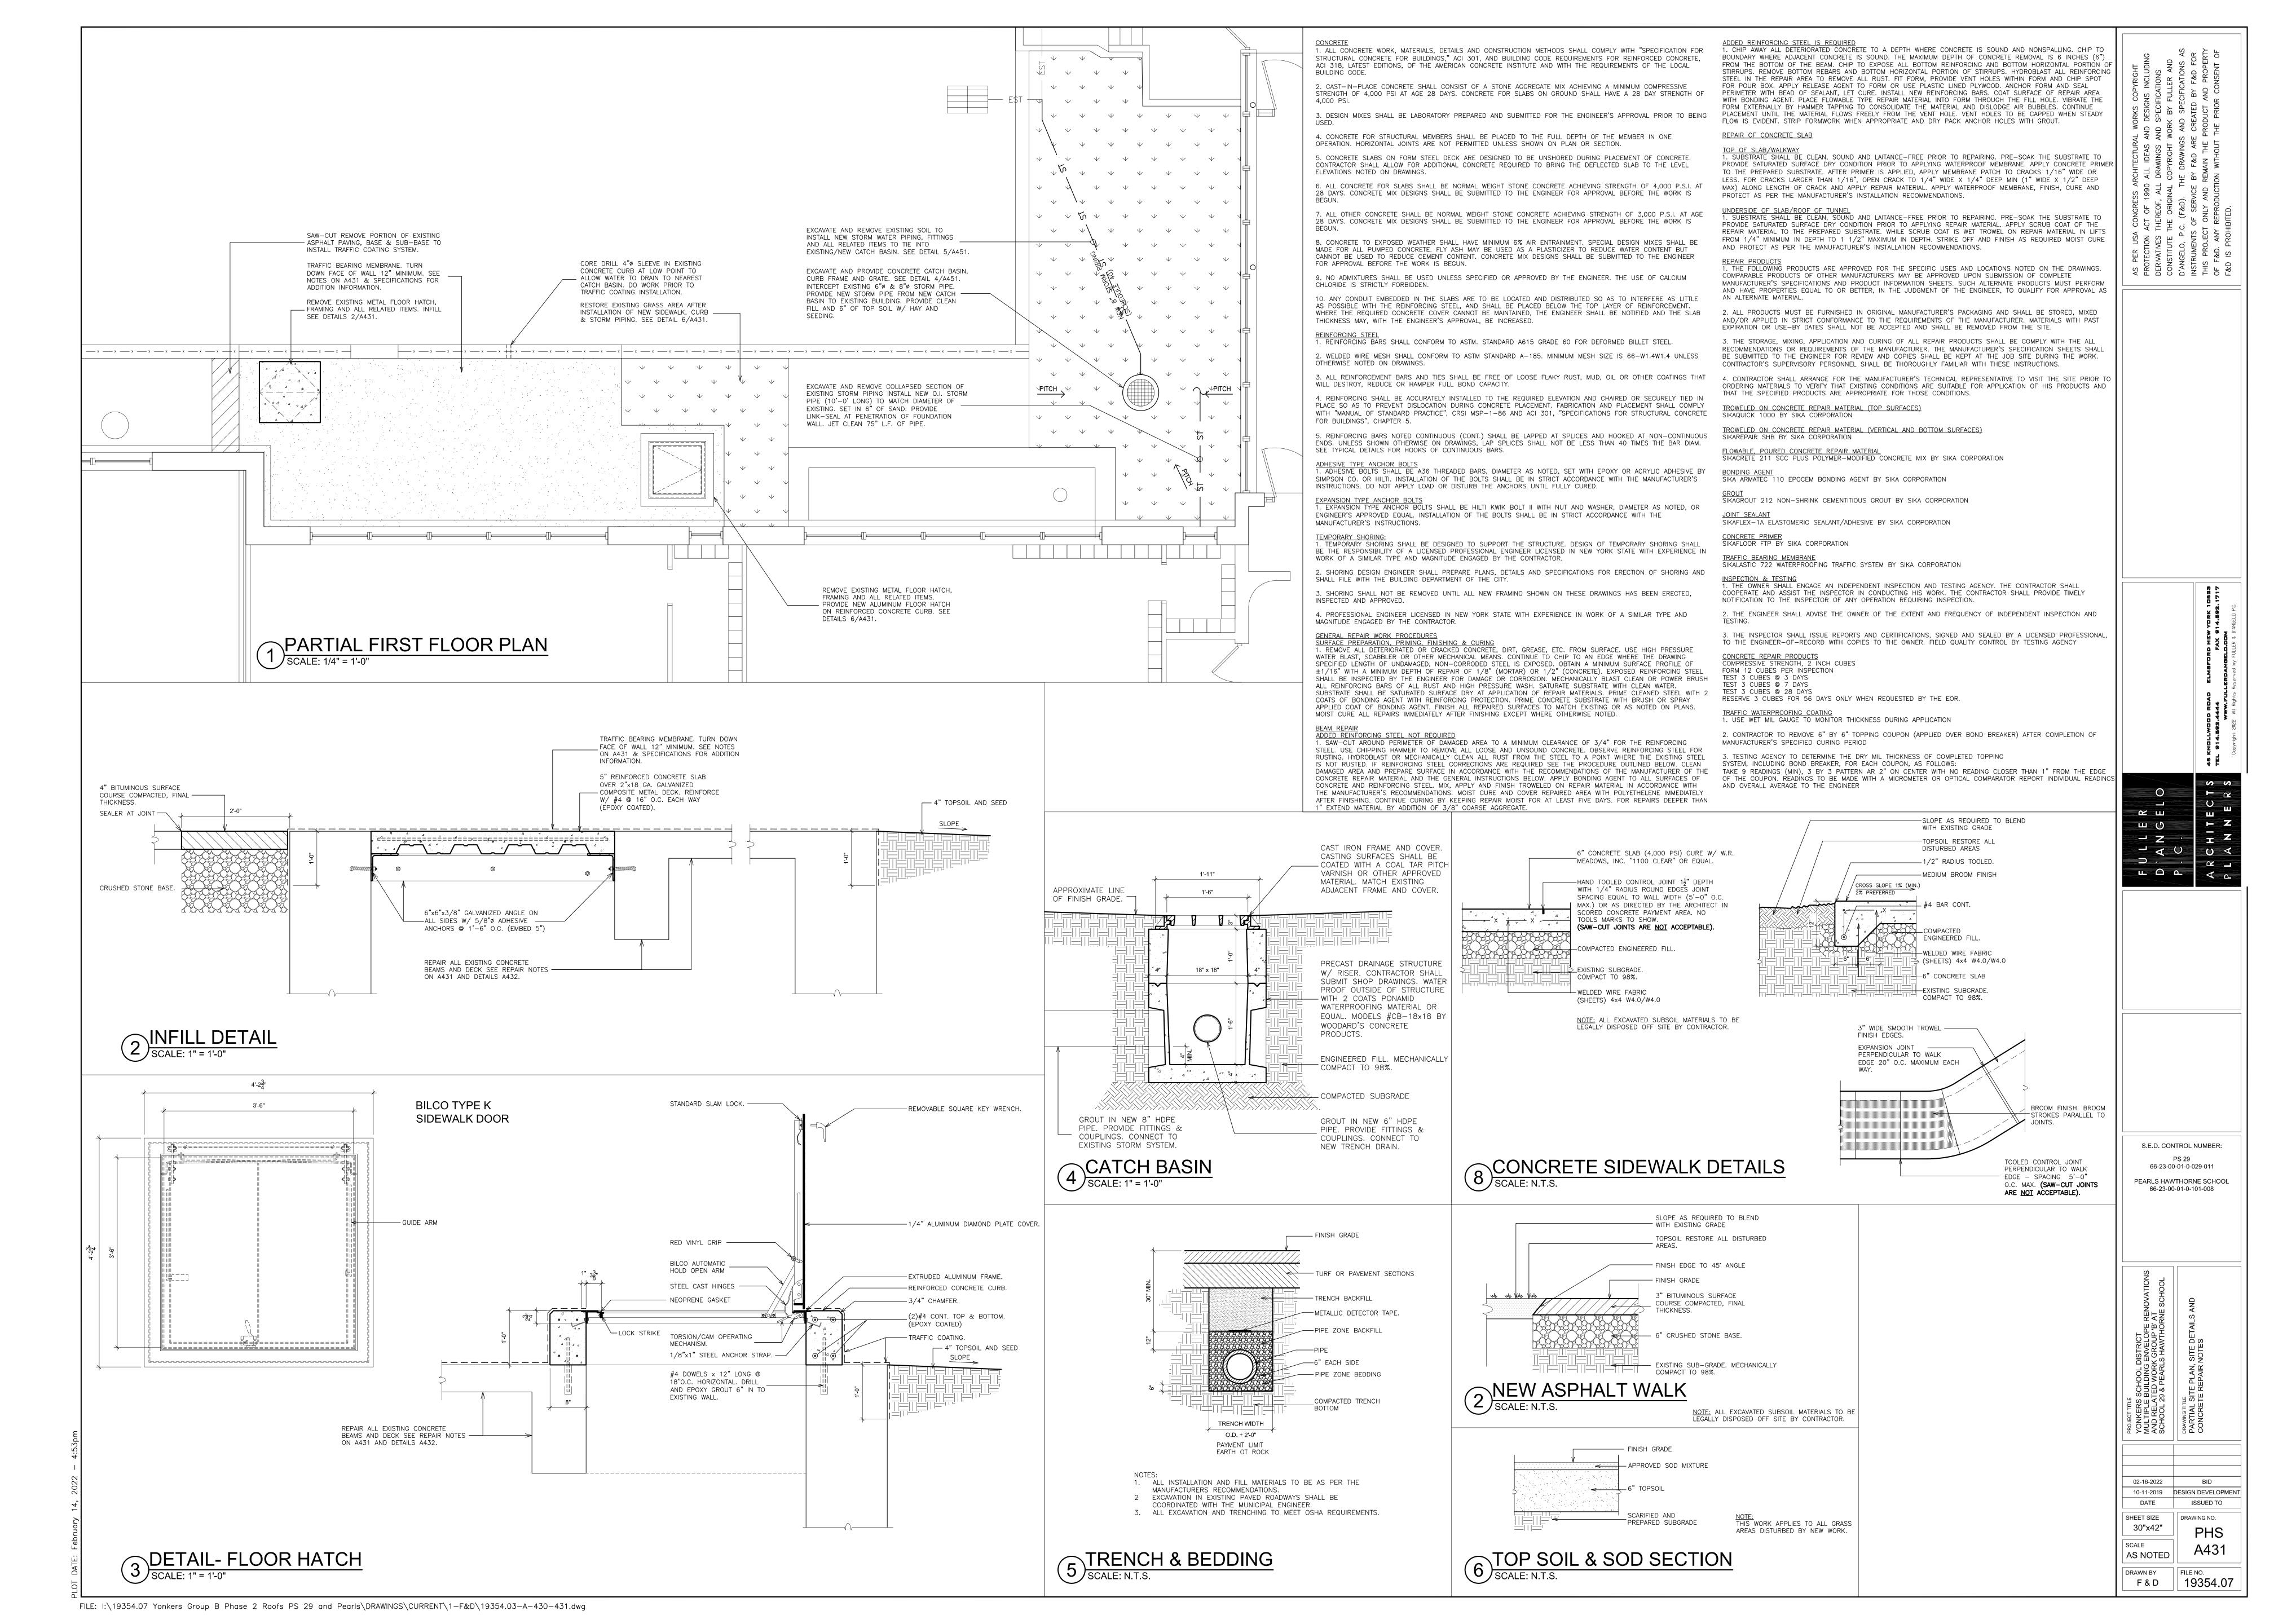


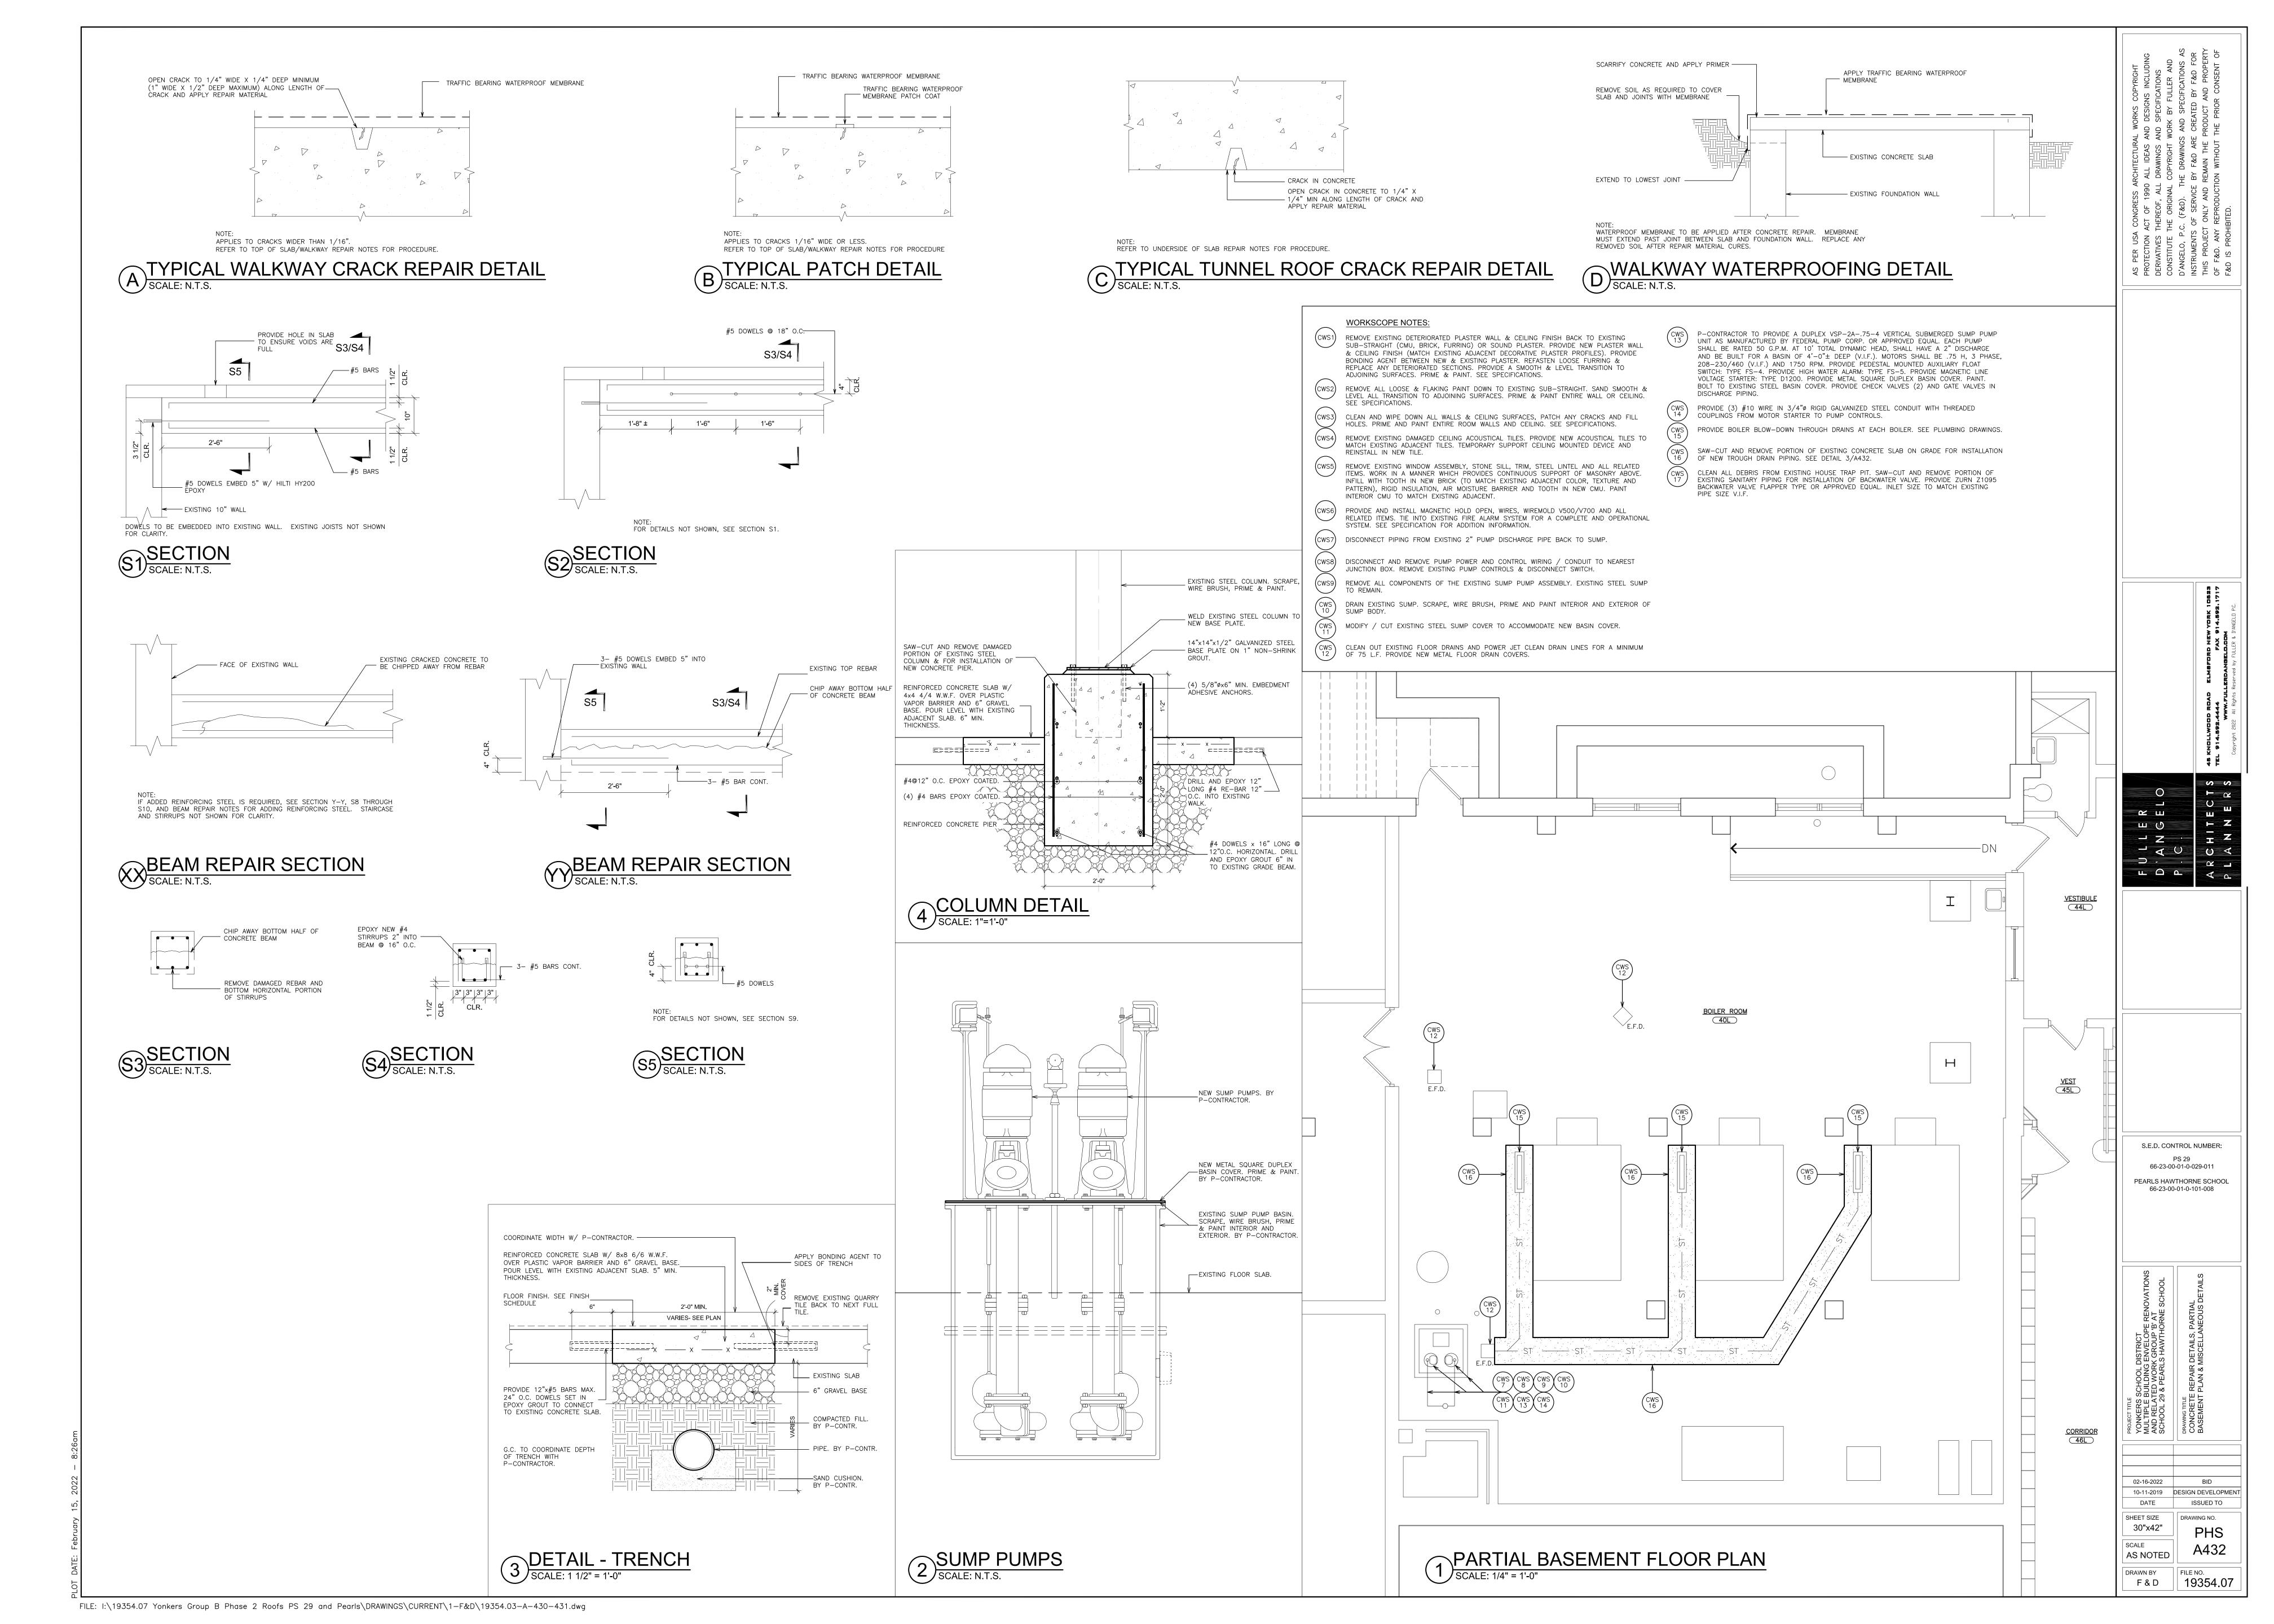


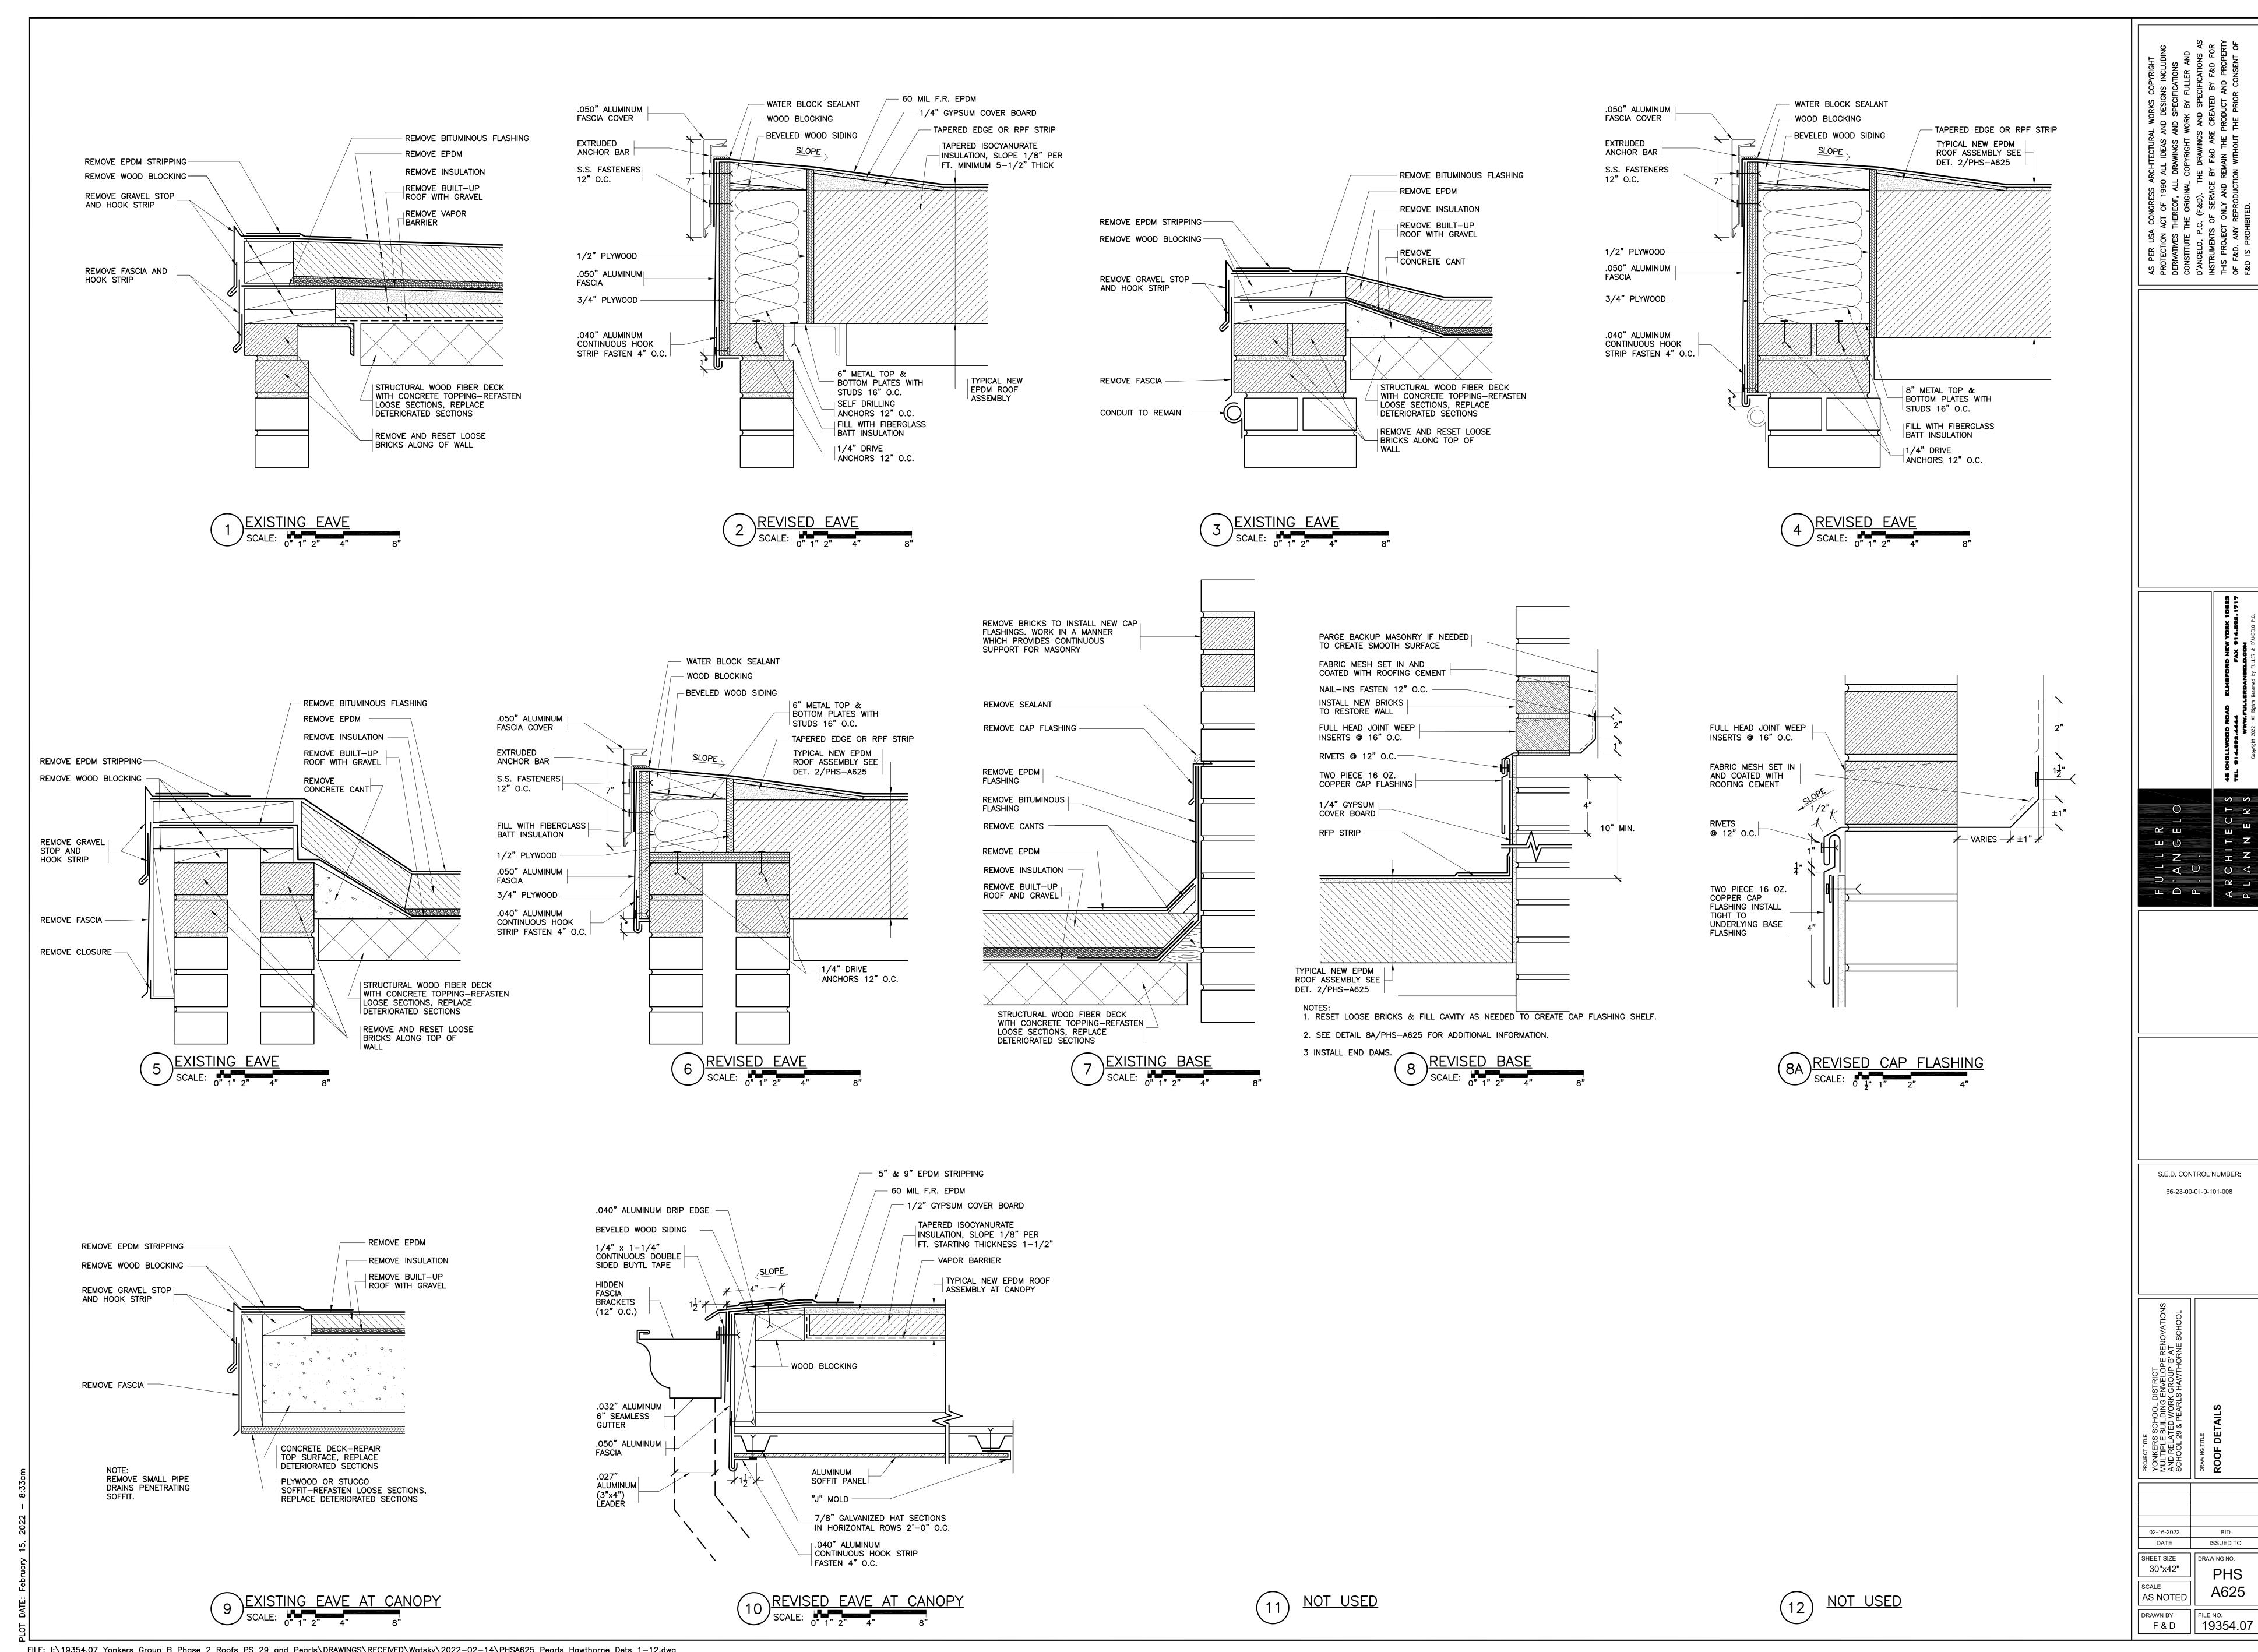



FILE: I:\19354.07 Yonkers Group B Phase 2 Roofs PS 29 and Pearls\DRAWINGS\RECEIVED\Watsky\2022-02-14\PHSA625 Pearls Hawthorne Dets 1-12.dwg

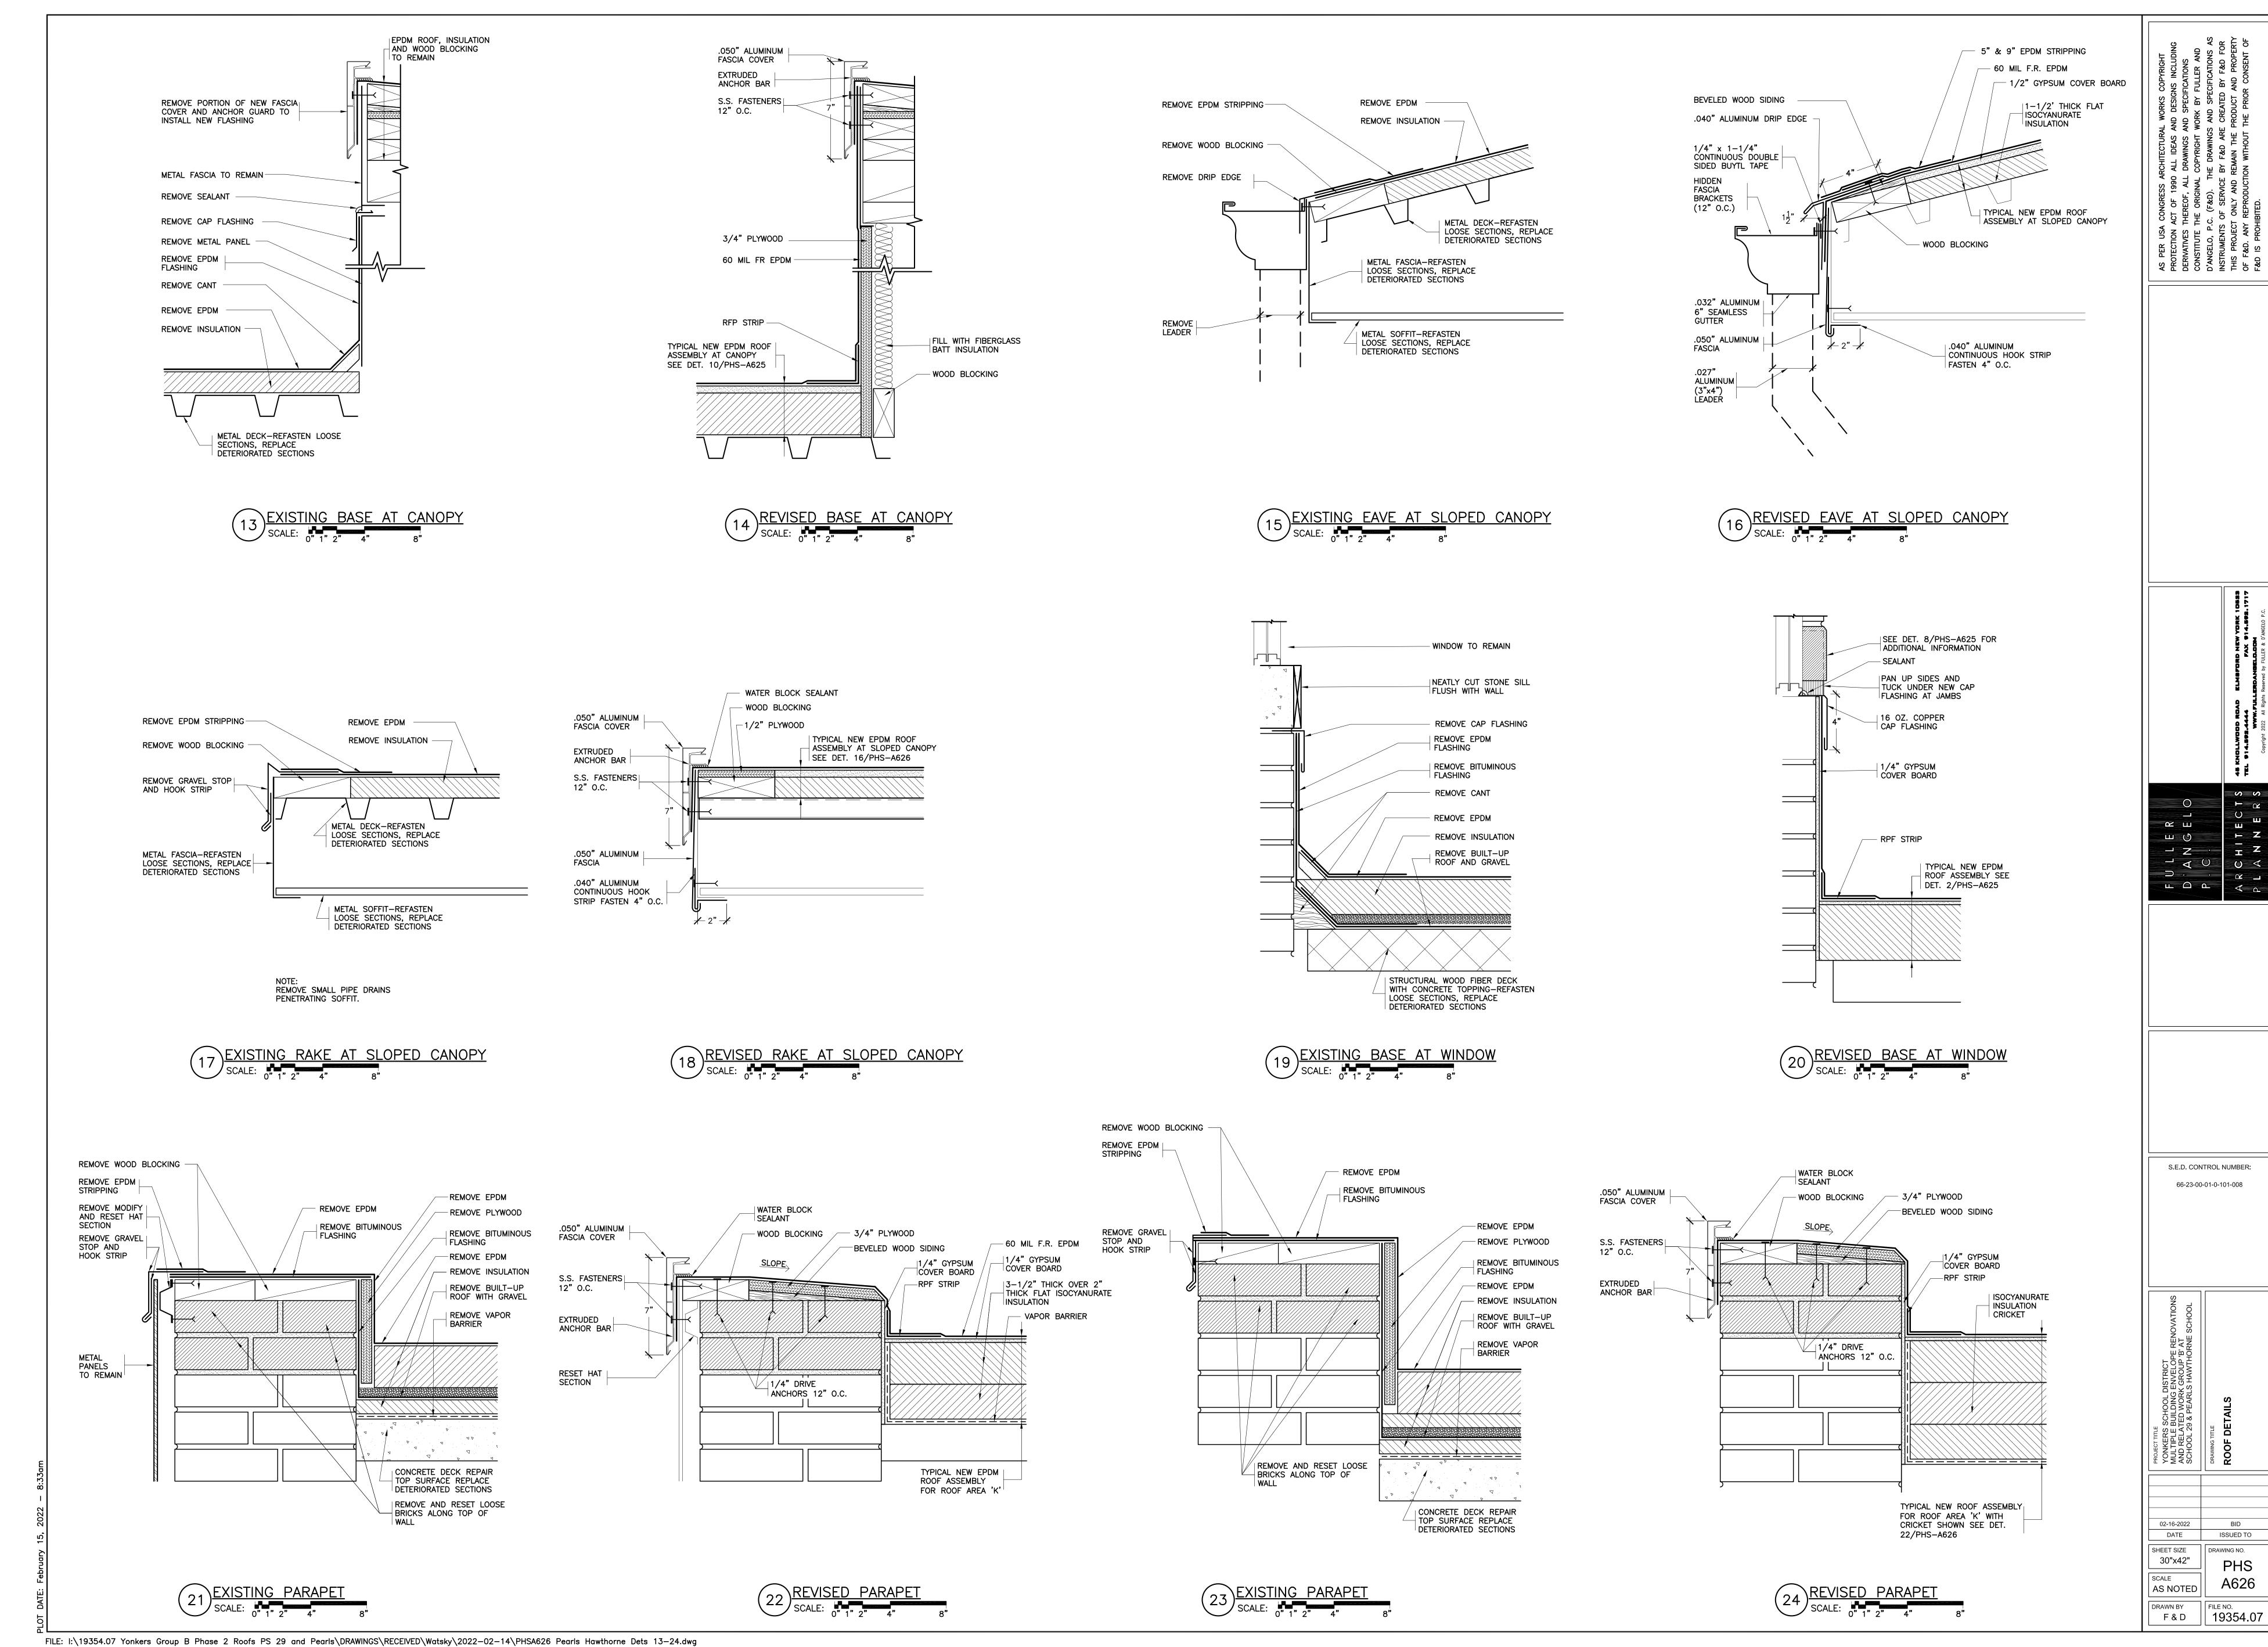

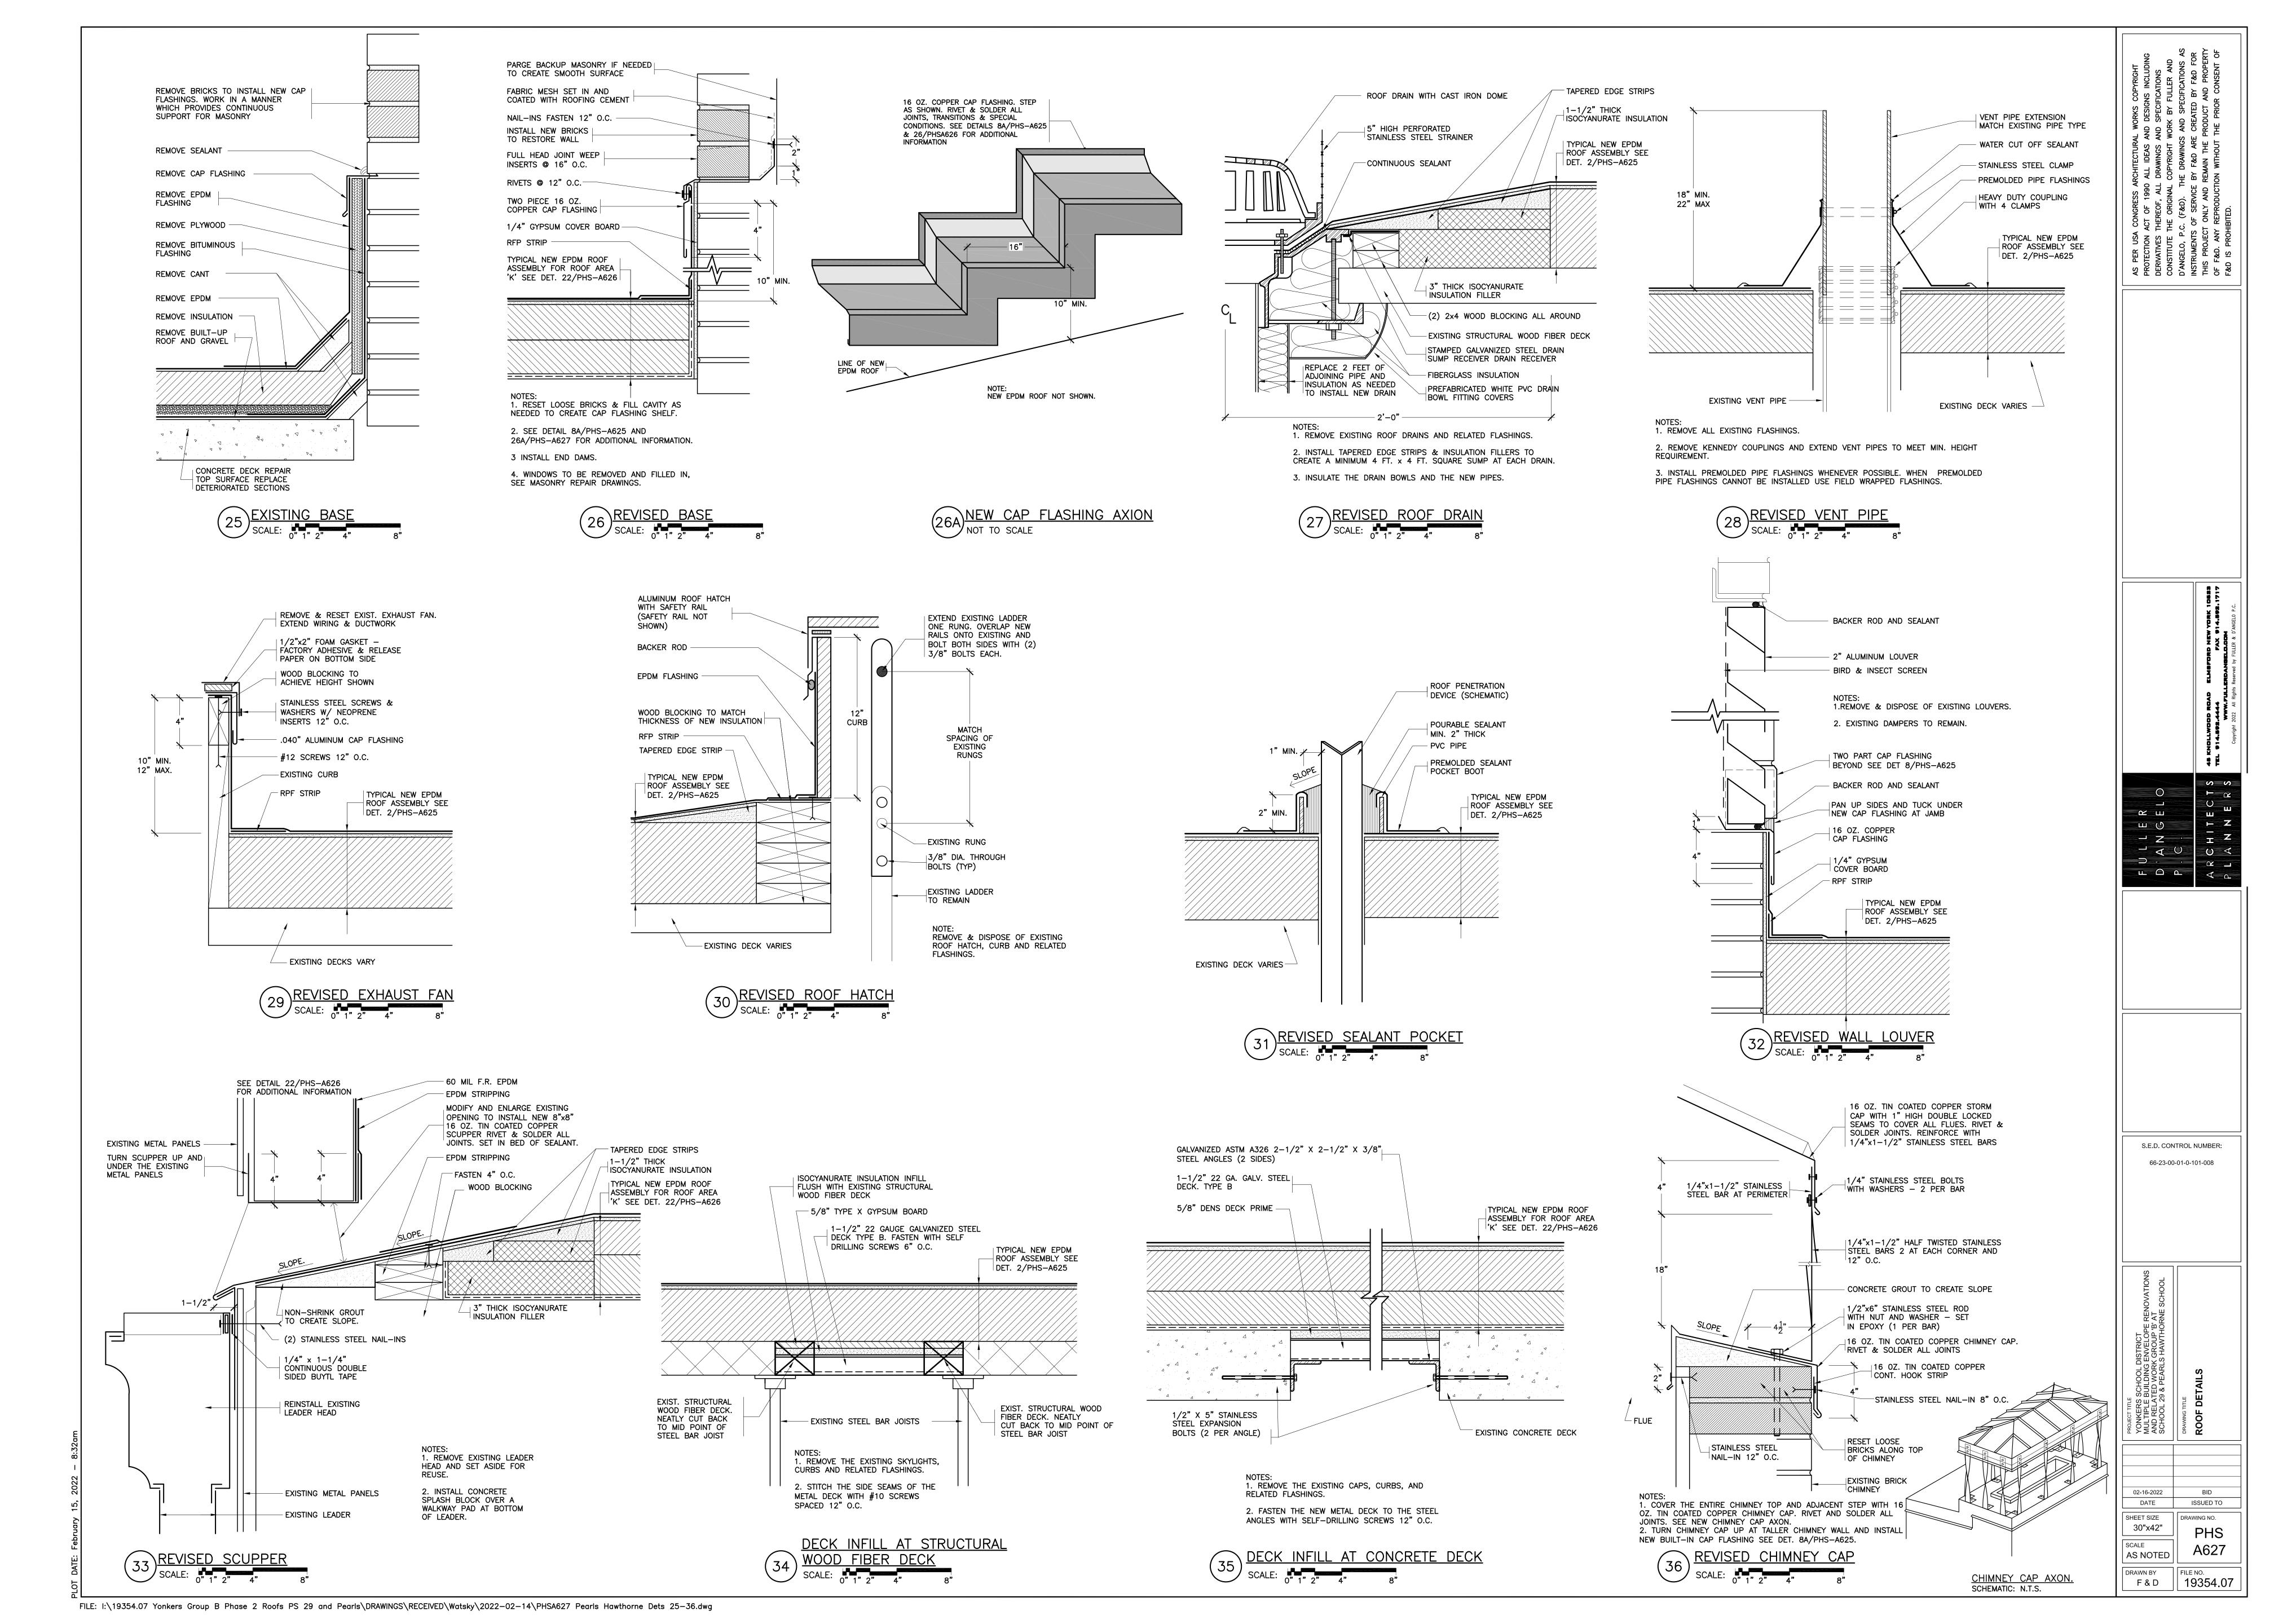

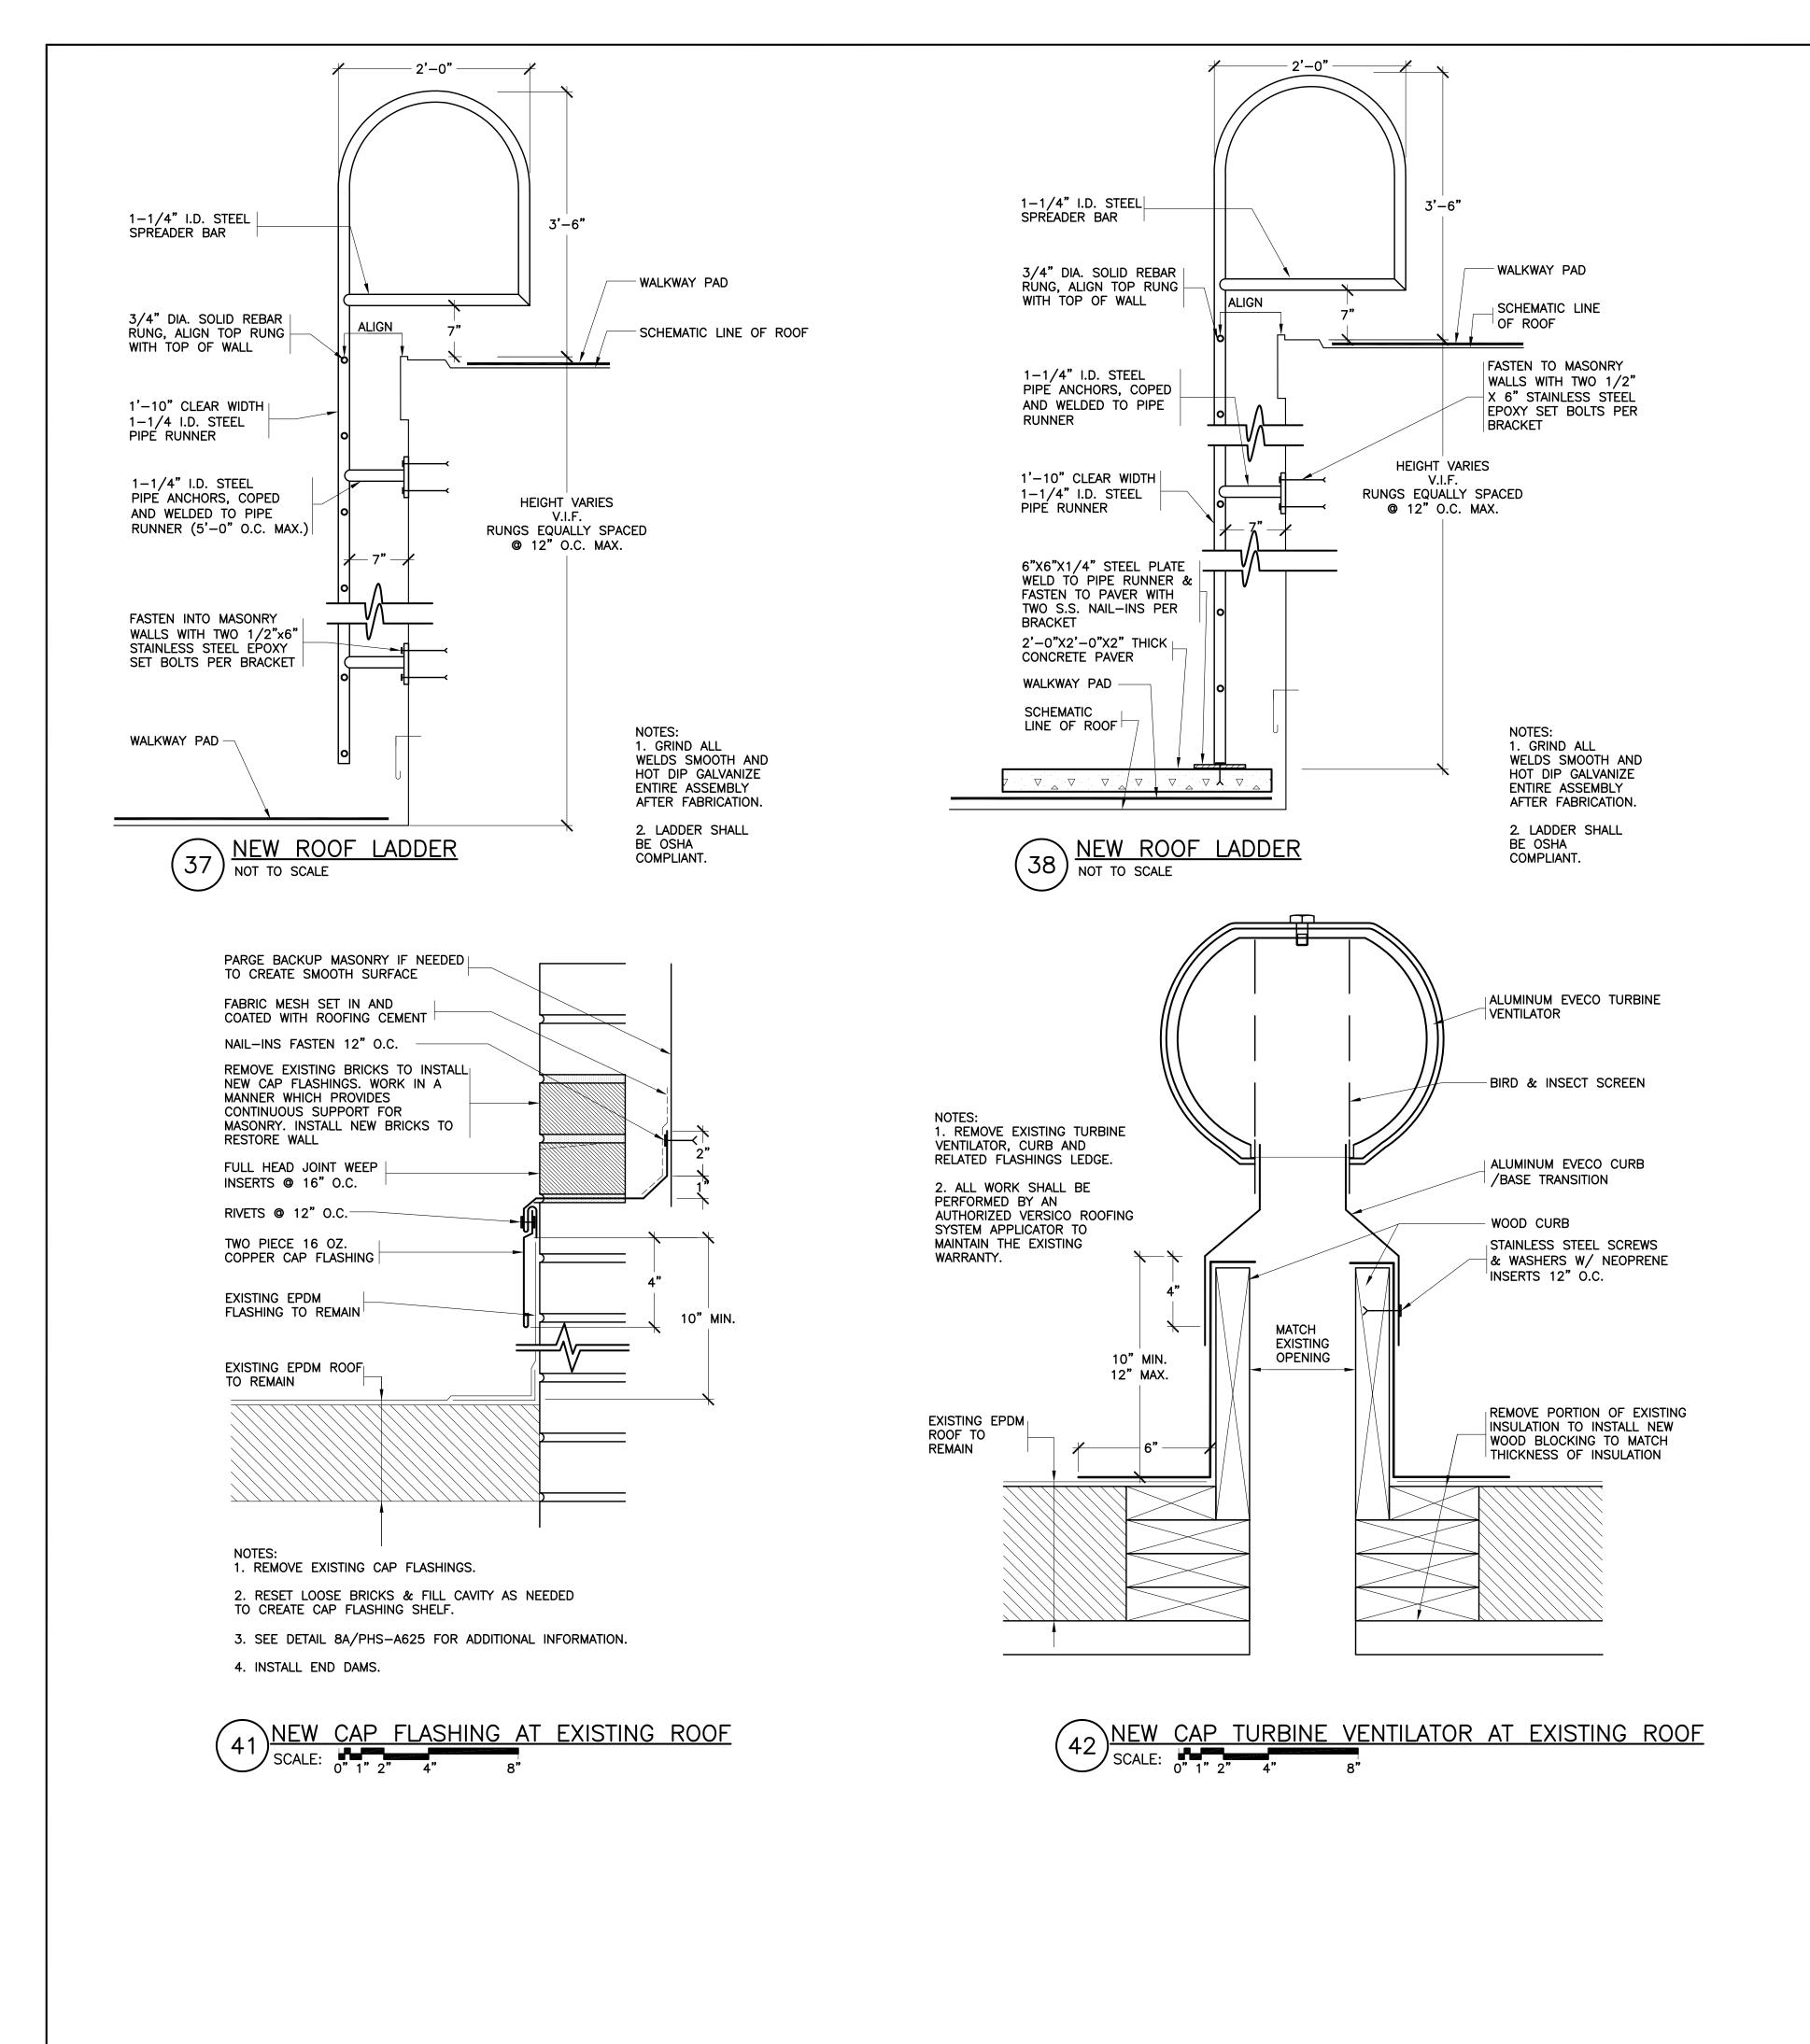

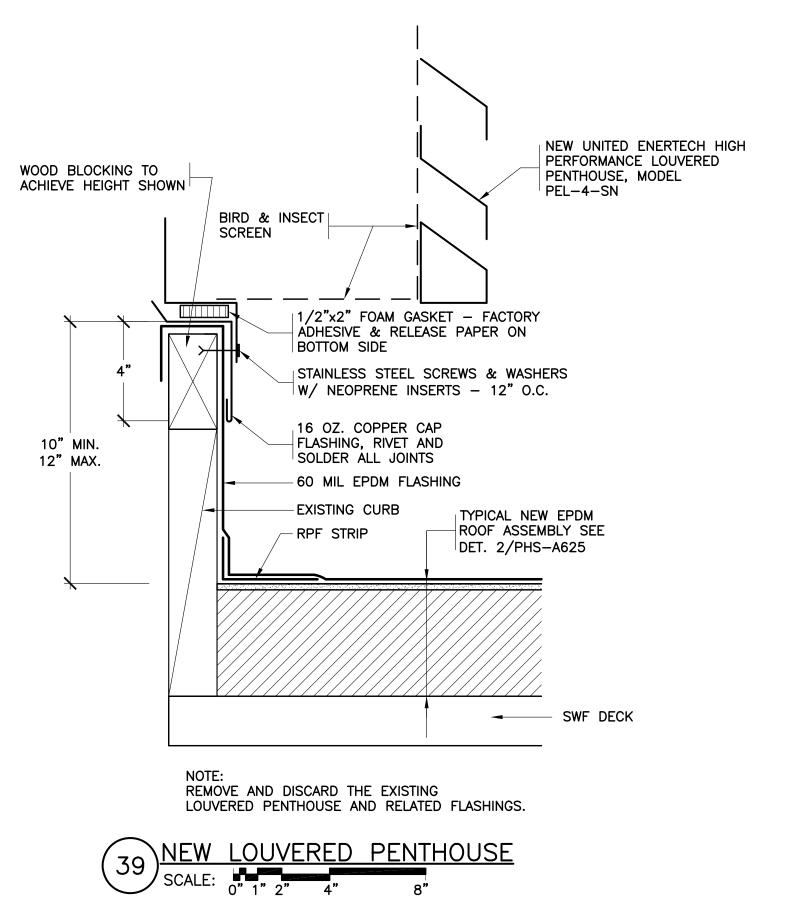

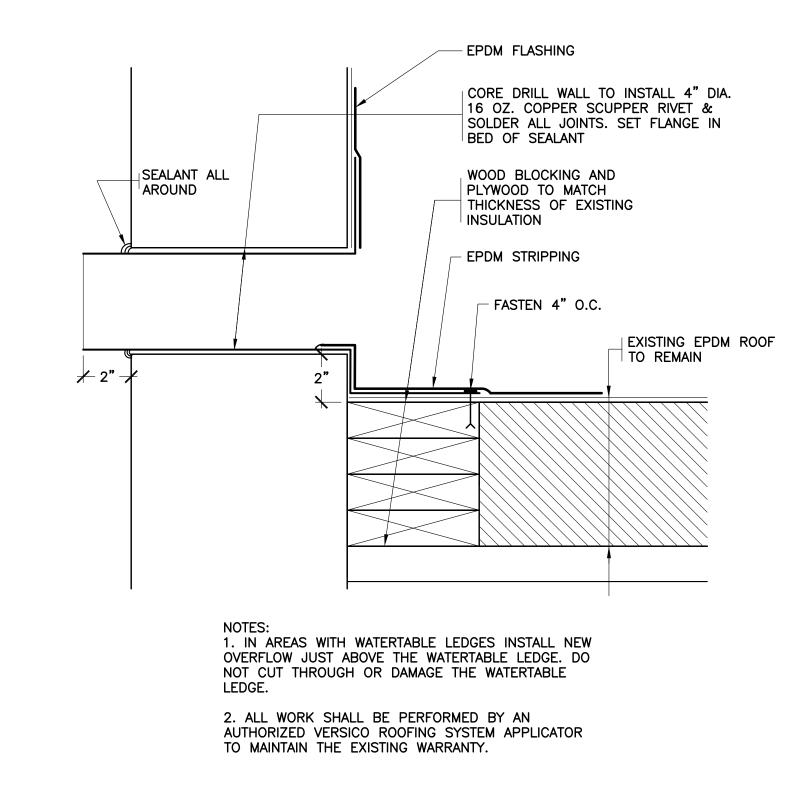

NEW OVERFLOW SCUPPER ON EXISTING ROOFS

SCALE: 0" 1" 2" 4" 8"

S E D CONTROL NUMBER:

章章

S.E.D. CONTROL NUMBER: 66-23-00-01-0-101-008

YONKERS SCHOOL DISTRICT
MULTIPLE BUILDING ENVELOPE RENOVATIONS
AND RELATED WORK GROUP 'B' AT
SCHOOL 29 & PEARLS HAWTHORNE SCHOOL

DRAWING TITLE

ROOF DETAILS

02-16-2022 BID
DATE ISSUED TO

SHEET SIZE
30"x42"

PHS
A628

DRAWN BY
F & D

F & D

F & D

DRAWN BID
DRAWING NO.
PHS
A628

											DO	OOR	SC	HED	ULE																
			DOOR					FR	RAME			FIRE RATING							H	IARD\	VAR	Ε									INDICATES REQUIRED WORK
			SIZE			1			DETAIL			(MIN.)	FIR	CODE	GLAZINO	G	DISABLE REQUIREME	E ENTS	HARDWA	RE TYPE		FUN	CTION		MISC	CELLAN	EOUS	SECU	JRITY		INDICATES EXISTING FRAMED WITH WINDOW
BUILDING	LEVEL	DOOR NUMBER DRAWING NUMBER (EXISTING ENTRANCE NUMBER (WA WA OO	DOUBLE LEAF DOOR MIDTH × HEIGHT	NEW DOOR EXISTING DOOR	DOOR TYPE	DOOR MATERIAL	FRAME TYPE	FRAME MATERIAL		JAMB DEIAIL		90 MINUTES 45 MINUTES 0 MINUTES	$I \triangleleft I \cup Q$	OMATIC CLOSER (FIRE RATED INSULATED LAMINATED		LEVER, U—HANDLE KICK PLATE TACTILE WARNING	ADA CONFIRMING ACCESSIBLE THRESHOLD	MORTISE LOCK SET CYLINDRICAL LOCK SET	CYLINDER CORE(S)	CLASSROOM W/ INTRUDER FUNC.	OFFICE	STORE ROOM EXIT	TOILET ELECTRONIC TOILET LOCK		US HING	CYLINDER DOGGING RECESS PULL	DOOR CONTACTS	ACCESS CONTROL HARDWARF SFT NO	FF AI HI	
		01 001 A100 CORRIDOR 49L	6'-0"± x 7'-0"±		EXIST.	НМ	EXIST.	НМ		_ _	-		0					0													
	EMENT	02																													
	BASE	03																													
)OL		04																													
SCH		05 100 A101 STAIR 146	3'-0"± x 7'-0"±		EXIST.		 			- -	-			0			0	0													
HOH		06 101 A101 STAIR 146	3'-0"± x 7'-0"±				EXIST.			_	-			0			0	0													
T 및		07 102 A101 STAIR 145	3'-0"± x 7'-0"±				EXIST.		_ -	- -			0	0			0	0												_	
HORI	Ğ	08 103 A101 STAIR 145	3'-0"± x 7'-0"±			НМ	EXIST.	НМ	- -	- -	-			0			0	0													
HAWT	FLOC	09 104 A101 STAIR 177	3'-0"± x 7'-0"±				EXIST.	НМ		- -				0	1		0	0													
STS 1	ZST	10 105 A101 STAIR 177 11 106 A101 STAIR 143	$3'-0"\pm \times 7'-0"\pm$				EXIST.						0	0 0	+ + + -		0	0												-	
PEAF	Ē	11 106 A101 STAIR 143 12 107 A101 STAIR 143	$3'-0"\pm \times 7'-0"\pm$ $3'-0"\pm \times 7'-0"\pm$				EXIST.						0		1		0	0												_	
		13 STAIR 143						. 1111			\dashv					+														+	
		14									\dashv																		-	\dashv	
		15 200 A102 STAIR 253	3'-0"± x 7'-0"±		EXIST.	НМ	EXIST.	НМ	_ -	_ _	.			0			0	0												\top	
		16 201 A102 STAIR 253	3'-0"± x 7'-0"±		EXIST.	НМ	EXIST.	НМ		- -			0				0	0													
		17 202 A102 STAIR 237	3'-0"± x 7'-0"±										0	0			0	0													
	.00R	18 203 A102 STAIR 237	3'-0"± x 7'-0"±				EXIST.			_	·		0		1		0	0													
	D FL	19 204 A102 STAIR 228	3'-0"± x 7'-0"±				EXIST.			_			0	0	1		0	0													
	CON	20 205 A102 STAIR 229	3'-0"± x 7'-0"±		EXIST.	HM	EXIST.	НМ	_ -	- -	·						0	0												\perp	
	SE	21									\perp					+														+	
		22 23									+					-														+	
		24									+					+ +														+	
		25 300 A103 STAIR 308	3'-0"± x 7'-0"±		EXIST.	НМ	EXIST.	НМ	_ -	_	_	+						0											+	+	
	χ.	26 301 A103 STAIR 305	3'-0"± x 7'-0"±		EXIST.		EXIST.			_	.			0	+ + -		0	0												\top	
	FLOC	27																													
	IRD	28																													
	臣	29																													
		30																											, I		

GENERAL DOOR NOTES:

- DOOR HARDWARE SHALL COMPLY TO ALL APPLICABLE
 HANDICAPPED CODES. CLOSERS SHALL COMPLY TO STANDARDS
 REGARDING CLOSING SPEED AND OPENING FORCE.
 ALL DOOR AND FRAME SIZES SHALL BE FIELD VERIFIED.
- REGARDING CLOSING SPEED AND OPENING FORCE.

 2. ALL DOOR AND FRAME SIZES SHALL BE FIELD VERIFIED.

 3. THERE SHALL BE NO PROJECTIONS BETWEEN 34" AND 80"

 ABOVE THE FLOOR OR GROUND. PROJECTIONS BETWEEN 34"

 AND 80" ABOVE THE FLOOR OR GROUND SHALL NOT EXCEED
- 4. REFER TO SPECIFICATIONS FOR DOOR HARDWARE SETS.
 5. THE BOTTOM OF ALL DOOR VISION LITES SHALL BE A MAXIMUM OF 43" ABOVE THE FINISHED FLOOR.
 6. THE DOOR SURFACE WITHIN 10" OF THE FLOOR MEASURED VERTICALLY SHALL BE A SMOOTH SURFACE ON THE PUSH SIDE
- EXTENDING FULL WIDTH OF DOOR.

 7. ALL EXTERIOR DOORS AND AREAS ADJACENT TO DOORS TO HAVE 1" INSULATING SAFETY LAMINATED GLASS. (UNLESS NOTED OTHERWISE)
- IN EXISTING FRAMES THAT WILL NO LONGER BE USED WITH NEW HARDWARE. WELDED FILLER PLATES, HOLE PLATES, ETC. BY DON-JO MFG. OR EQUAL. CONTRACTOR IS RESPONSIBLE FOR ANY NEW MORTISES/HARDWARE PREPARATION TO EXISTING FRAME TO ACCOMMODATE NEW DOOR AND HARDWARE.

8. CONTRACTOR TO FILL/PATCH ANY OLD HARDWARE PREPARATIONS

- 10. REFER TO SPECIFICATIONS FOR GLAZING TYPE FOR VISION
- PANELS.
 11. ALL GLAZING IN FIRE RATED DOOR SHALL BE LABELED GLASS.

9. FIRE RATED DOORS SHALL COMPLY WITH NFPA 80, PROVIDE UL

- REFER TO SPECIFICATIONS.

 12. PROVIDE SILICONE SEALANT AROUND ALL NEW DOOR LIGHTS.

 13. NEW H.M. DOOR FRAMES TO BE PAINTED (BOTH SIDES).
- 14. NEW H.M. DOOR FRAMES TO RECEIVE RESILIENT RUBBER SILENCERS. PROVIDE NEW SILENCERS ON EXISTING H.M. DOOR
- FRAMES RECEIVING NEW DOORS. DRILL—IN IF REQUIRED.

 15. COORDINATE ALL REMOVALS WITH ABATEMENT DOCUMENTS.

AS PER USA CONGRESS ARCHITECTURAL WORKS COPYRIGHT PROTECTION ACT OF 1990 ALL IDEAS AND DESIGNS INCLUDING DERIVATIVES THEREOF, ALL DRAWINGS AND SPECIFICATIONS CONSTITUTE THE ORIGINAL COPYRIGHT WORK BY FULLER AND D'ANGELO, P.C. (F&D). THE DRAWINGS AND SPECIFICATIONS AS INSTRUMENTS OF SERVICE BY F&D ARE CREATED BY F&D FOR THIS PROJECT ONLY AND REMAIN THE PRODUCT AND PROPERTY OF F&D. ANY REPRODUCTION WITHOUT THE PRIOR CONSENT OF F&D IS PROHIBITED.

45 KNOLLWOOD ROAD ELMSFORD NEW YORK 10523
TEL 914.592.4444 FAX 914.592.1717
WWW.FULLERDANGELO.GOM
Copyright 2022 All Rights Reserved by FULLER & D'ANGELD P.C.

S.E.D. CONTROL NUMBER:

PS 29
66-23-00-01-0-029-011

PEARLS HAWTHORNE SCHOOL
66-23-00-01-0-101-008

YONKERS SCHOOL DISTRICT
MULTIPLE BUILDING ENVELOPE RENOVATIONS
AND RELATED WORK GROUP 'B' AT
SCHOOL 29 & PEARLS HAWTHORNE SCHOOL

DRAWING TITLE

DOOR SCHEDULE, TYPES AND DETAILS

02-16-2022 BID
10-11-2019 DESIGN DEVELOPMENT
DATE ISSUED TO


SHEET SIZE
30"x42"

SCALE
AS NOTED

DRAWN BY
F & D

FILE NO.
19354.07

FILE: I:\19354.07 Yonkers Group B Phase 2 Roofs PS 29 and Pearls\DRAWINGS\CURRENT\1-F&D\19354.03-A700.dwg

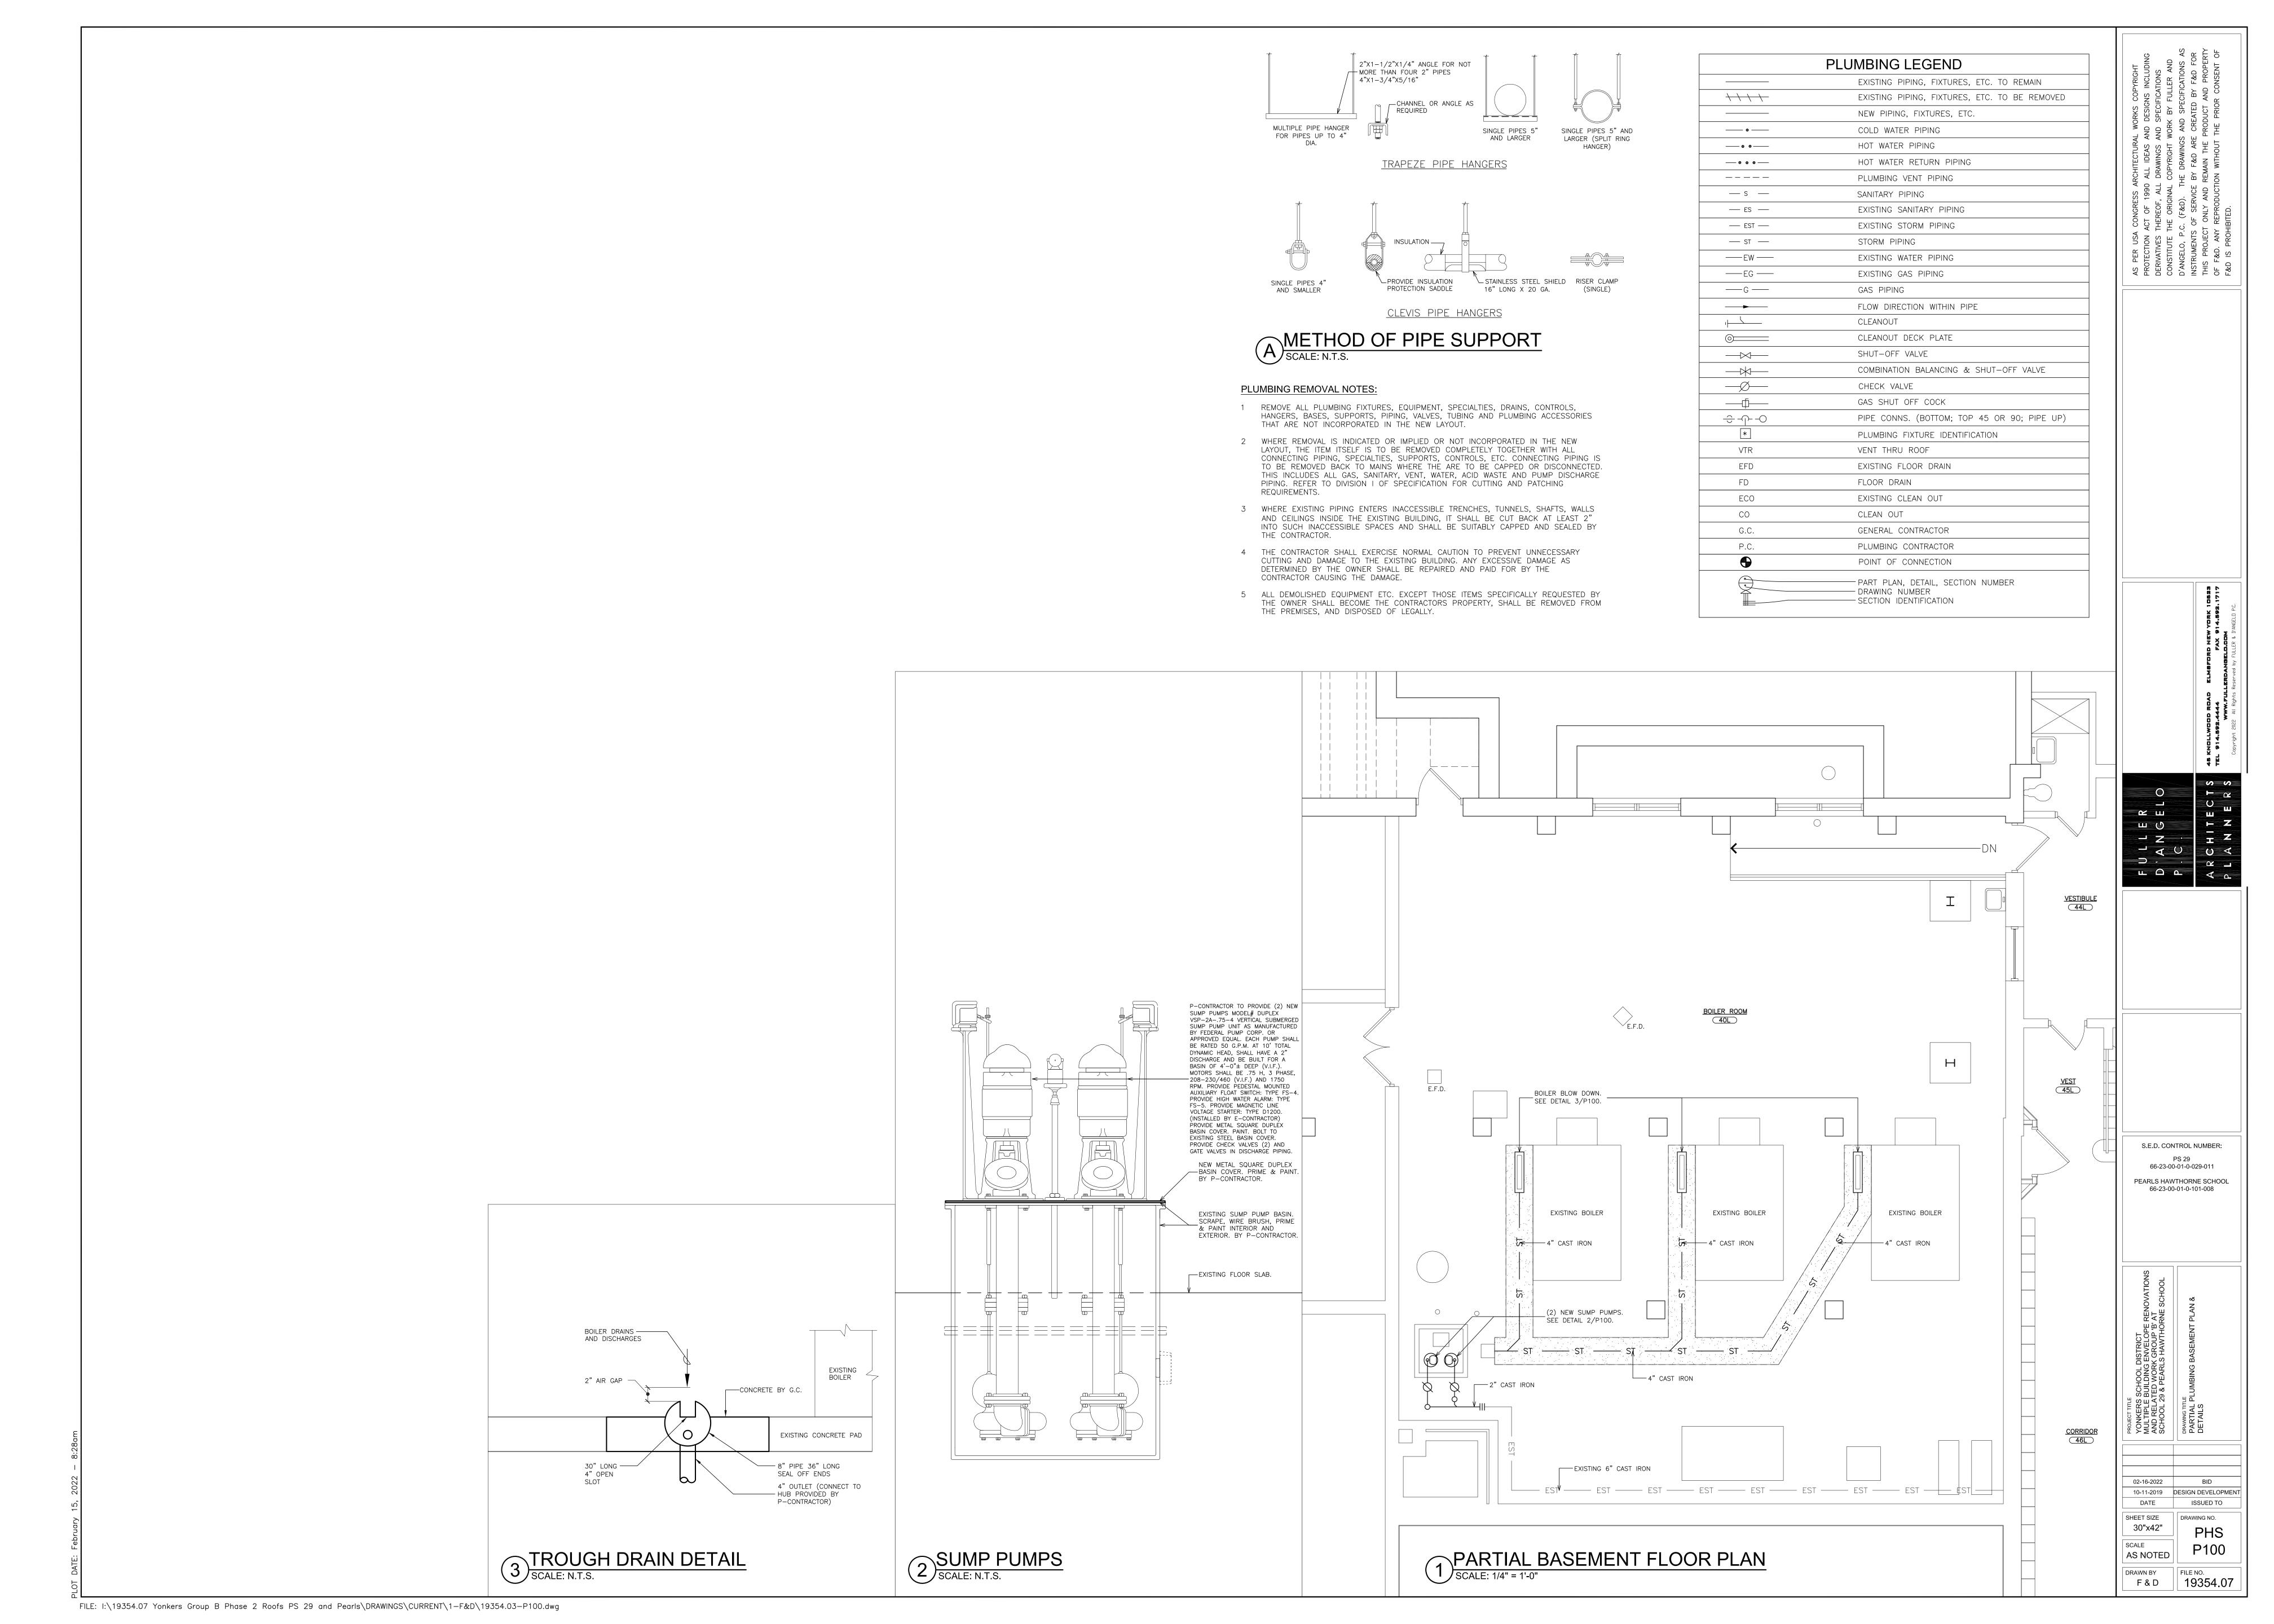

ELECTRICAL SYMBOL LIST \neg $^{ extsf{C}}$ 2'x4' FLUORESCENT RECESSED FIXTURE. CAPITAL LETTER INDICATES TYPE, ____a LOWER CASE LETTER INDICATES SWITCH CONTROL. FIXTURE SCHEDULE DENOTES 2'x4' RECESSED FLUORESCENT LIGHT FIXTURE FOR EMERGENCY OPERATION WITH INTEGRAL BATTERY BACK-UP, TEST BUTTON AND L.E.D. WALL MOUNTED OUTDOOR WALL PACK LIGHT FIXTURE WITH INTEGRAL PHOTOCELL TC AUTOMATIC TIME CLOCK FOR LIGHTING CONTROL. TORK 120v 7100 SERIES. Sa FLUSH WALL MOUNTED LIGHTING CONTROL SWITCH CONTROLLING OUTLET "a". g of Flush wall mounted switch. '3' where used indicates 5 3 3 -WAY, 'a' INDICATES SWITCH CONTROL. WALL MOUNTED FIRE ALARM HORN/STROBE DEVICE. WALL MOUNTED FIRE ALARM STROBE LIGHT. MATCH EXISTING TYPE. PROVIDE CONDUIT & WIRING BACK TO EXISTING FIRE PANEL. CHANNEL CUT AND RUN WIRING IN WALLS. CEILING MOUNTED SMOKE DETECTOR. MACH EXISTING TYPE. (U)/(U) CEILING/WALL MOUNTED JUNCTION BOX. J FLUSH FLOOR MOUNTED JUNCTION BOX. — CONDUCTORS IN CONDUIT CONCEILED IN WALL OR CEILING. – - CONDUIT/WIRING CHASED IN CONCRETE SLAB. — O CONDUIT TURNING UP. — CONDUIT TURNING DOWN. FLEXIBLE LIQUIDTIGHT FINAL EQUIPMENT CONNECTION. 3 HOMERUN TO DESIGNATED PANEL, ARROWHEAD INDICATES SINGLE POLE CIRCUIT. HOMERUN SHALL CONSIST OF MINIMUM 2#12-3/4"C U.O.N. 2,(4,6) HOMERUN TO DESIGNATED PANEL, NUMBERS IN PARENTHESIS INDICATE MULTIPOLE CIRCUIT, I.E. 3-HOTS, IN AND 1-GROUND U.O.N. 125V-2P-3W-20A GROUNDED TYPE, SPECIFICATION GRADE FLUSH WALL MOUNTED DUPLEX RECEPTACLE HUBBELL #5362. 125V-2P-3W-20A FLUSH WALL MOUNTED GROUND FAULT INTERRUPTING TYPE DUPLEX RECEPTACLE HUBBELL #GF5362. WP 125V-2P-3W-20A WEATHER PROOF FLUSH WALL MOUNTED GROUND FAULT INTERRUPTING TYPE DUPLEX RECEPTACLE HUBBELL #GF5362.

SURFACE MOUNTED ELECTRICAL PANELBOARD.

AND SWING.

WALL MOUNTED EMERGENCY LIGHT FIXTURE W/ EXIT SIGN

ELECTROMAGNETIC DOOR HOLDER FURNISHED AND INSTALLED BY ELECTRICAL

CONTRACTOR. RIXSON 998M, OR EQUAL. VERIFY COMPATIBILITY WITH EXISTING

FIRE ALARM SYSTEM. PROVIDE ALL MOUNTING ACCESSORIES REQUIRED. PROVIDE

SOLID MOUNTING TO WALL SURFACE. COORDINATE LOCATION WITH DOOR SIZE

	BBREVIATIONS
ABBV.	DESCRIPTION
Α	AMP/AMPERE
A.F.F.	ABOVE FINISHED FLOOR
AWG	AMERICAN WIRE GAUGE
С	CONDUIT
C.F.	CEILING FAN
CU	CONDENSING UNIT
(E)	EXISTING TO REMAIN
E.C.	ELECTRICAL CONTRACTOR
EF	EXHAUST FAN
(ER)	EXISTING RELOCATED
EXIST.	EXISTING
F.A.	FIRE ALARM
F.A.C.P.	FIRE ALARM CONTROL PANEL
F.B.O	FURNISHED BY OTHERS
G,GRD	GROUND
GFI	GROUND FAULT INTERRUPTER
kcmil	THOUSAND CIRCULAR MILLS
KVA	KILOVOLT AMPERE
KW	KILOWATT
МСВ	MAIN CIRCUIT BREAKER
MSB	MAIN SWITCH BOARD
M.L.O.	MAIN LUGS ONLY
N.T.S.	NOT TO SCALE
PNL	ELECTICAL PANELBOARD
(R)	REMOVE EXISTING
RECPT	RECEPTACLE
(RN)	REPLACE EXISTING W/NEW
TYP.	TYPICAL
U.O.N.	UNLESS OTHERWISE NOTED
UVAC	UNIT VENTILATOR
W	WATT
WG	WHERE INDICATED E.C. SHALL PROVIDE WIRE GUARD AS REQUIRED
WP	WEATHERPROOF

GENERAL REMOVAL ELECTRICAL NOTES:

1. BEFORE COMMENCING WORK, EXAMINE ALL ADJOINING AREAS THAT MAY BE AFFECTED BY REMOVAL. REPORT TO THE GENERAL CONTRACTOR ANY CONDITION THAT PREVENTS PERFORMANCE OF THE

2. BECOME THOROUGHLY FAMILIAR WITH EXISTING CONDITIONS WHERE CONNECTIONS MUST BE MADE, CHANGED OR ALTERED. THE INTENT OF THE WORK IS SHOWN ON THE DRAWINGS AND DESCRIBED HEREINAFTER AND NO CONSIDERATION WILL BE GRANTED BY REASON OF LACK OF FAMILIARITY ON THE PART OF THE CONTRACTOR WITH ACTUAL PHYSICAL CONDITIONS AT THE SITE. INSPECT EACH AND EVERY AREA AFFECTED BY THE ALTERATION OF THE SPACE BEFORE SUBMITTAL OF BID.

3. ALL ELECTRICAL EQUIPMENT IS EXISTING TO BE REMOVED UNLESS OTHERWISE NOTED. THIS SHALL INCLUDE BUT NOT BE LIMITED TO THE FOLLOWING: PANEL BOARDS. PUBLIC ADDRESS DEVICES. LIGHTING FIXTURES AND SWITCHES.

CIRCUIT BREAKERS AND DISCONNECT SWITCHES. RECEPTACLES, OUTLETS AND DEVICES. FIRE ALARM DEVICES.

4. ALL CONDUCTORS AND CONDUIT ASSOCIATED WITH THE ELECTRICAL EQUIPMENT SHALL BE REMOVED COMPLETELY BACK TO ITS SOURCE OF POWER AND DISCONNECTED. 5. ALL POWER CONDUCTORS, CONTROL WIRING AND CONDUIT ASSOCIATED WITH MECHANICAL EQUIPMENT SUCH AS FANS, AIR CONDITIONING UNITS, PUMPS, ETC. DESIGNATED FOR REMOVAL ON THE HVAC

AND PLUMBING REMOVAL DRAWINGS SHALL BE REMOVED CLEAR BACK TO THE SOURCE OF POWER

AND DISCONNECTED. ALL MOTOR STARTERS, DISCONNECT SWITCHES, CONTROL DEVICES, ETC. SHALL

BE REMOVED. REFER TO MECHANICAL AND PLUMBING DRAWINGS FOR ADDITIONAL INFORMATION. 6. CIRCUIT BREAKERS AND/OR SWITCHES IN PANEL BOARD(S) OR DISTRIBUTION BOARD(S) MADE SPARE DUE TO REMOVAL SHALL BE DESIGNATED AS SUCH ON THE EQUIPMENT SCHEDULE.

7. THE ELECTRICAL CONTRACTOR SHALL BE RESPONSIBLE TO TRACE AND RELOCATE ALL EXISTING FEEDERS AND BRANCH CIRCUIT WIRING WHICH PASSES THROUGH THE REMOVAL AREA THAT SERVE EXISTING OCCUPIED SPACES TO REMAIN. COORDINATE WITH BUILDING MANAGER PRIOR TO ANY

8. DISPOSE OF ALL REMOVED EQUIPMENT, WHICH IS NOT INTENDED TO BE REUSED. PRIOR TO DISPOSAL, CONTACT BUILDING MANAGER TO DETERMINE IF ANY REMOVED EQUIPMENT IS DESIRED FOR

9. EXISTING CIRCUIT BREAKERS IN PANEL(S) ARE TO BE RE-USED. ELECTRICAL CONTRACTOR TO DISCONNECT PANEL AND CIRCUIT BREAKÉRS WITH GREAT CARE TO ENSURE AGAINST DAMAGE. THIS

CONTRACTOR SHALL PROVIDE NEW CIRCUIT BREAKERS AS REQUIRED. 10. ALL FIRE ALARM DEVICES ARE EXISTING TO BE REUSED UNLESS OTHERWISE NOTED.

SHUTDOWNS OR DISRUPTIONS THAT MAY BE REQUIRED TO ACCOMPLISH THIS WORK.

11. EXISTING EQUIPMENT DESIGNATED FOR REUSE SHALL BE CLEANED, REFURBISHED AND RESTORED TO OPTIMUM PERFORMANCE. THIS SHALL INCLUDE BUT NOT LIMITED TO CLEANING OF LIGHT FIXTURES, REPLACEMENT OF INOPERABLE BALLASTS AND LAMPS, RESISTANCE TESTING OF BRANCH CIRCUITRY

AND SIZE. RELOCATION OF EXISTING EQUIPMENT SHALL BE PERFORMED ONLY UPON OWNERS ACCEPTANCE OF EXISTING EQUIPMENT.

12. EXTEND EXISTING CIRCUITRY TO THOSE DEVICES THAT ARE TO BE RELOCATED. MATCH EXISTING TYPE

GENERAL NOTES:

DRAWINGS ARE DIAGRAMMATIC AND INDICATE THE GENERAL ARRANGEMENT OF SYSTEMS AND WORK. CONTRACTOR SHALL FURNISH ALL NECESSARY OUTLETS, SUPPORTS, FITTINGS AND ACCESSORIES TO FULFILL APPLICABLE CODES, REGULATIONS, BUILDING STANDARDS AND THE BEST PRACTICES OF THE TRADE FOR FIRST CLASS ELECTRICAL INSTALLATION.

2. THE DRAWINGS INDICATE SIZE AND GENERAL LOCATION OF WORK. SCALED DIMENSIONS SHALL NOT BE USED. THE EXACT LOCATION AND ELEVATION OF ALL ELECTRICAL EQUIPMENT SHALL BE COORDINATED IN FIELD WITH RESPECTIVE CONTRACTOR/OWNER.

3. THE CONTRACTOR SHALL COORDINATE WITH THE OWNER PRIOR TO SUBMISSION OF BID TO DETERMINE WHAT WORK MUST BE PERFORMED AFTER NORMAL BUSINESS HOURS. UNLESS OTHERWISE DIRECTED ANY NOISY WORK (CHOPPING, CORE DRILLING, HAMMERING, ETC.) AND BUILDING POWER INTERRUPTIONS SHALL BE PERFORMED OUTSIDE OF NORMAL BUSINESS HOURS. CONFIRM NORMAL BUSINESS HOURS WITH BUILDING OWNER. NO ADDITIONAL COST WILL BE CHARGED TO OWNER FOR WORK PERFORMED OUTSIDE NORMAL BUSINESS HOURS.

FEEDERS AND BRANCH CIRCUITRY SHALL BE RUN IN CONDUIT MINIMUM $^3\!4$ " CONDUIT UNLESS OTHERWISE NOTED. FINAL CONNECTIONS TO MOTORS MAY BE DONE WITH FLEXIBLE METALLIC CONDUIT (NO LONGER THAN 18"). IN UNFINISHED AREA CONDUIT SHALL BE RUN EXPOSED AND IN FINISHED AREAS CONDUIT SHALL BE RUN CONCEALED.

5. PROVIDE PANEL NAME PLATE MADE OF BLACK LAMINATED PLASTIC WITH WHITE ENGRAVED LETTERING AND TYPE WRITTEN DIRECTORY FOR ALL NEW AND EXISTING PANEL BEING USED FOR THIS PROJECT.

6. ALL CONDUCTORS SHALL BE COPPER, TYPE THHN/THWN INSULATED. ALL CONDUCTORS SHALL HAVE 600 VOLT RATED INSULATION UNLESS OTHERWISE NOTED.

7. PROVIDE LOCK-ON CIRCUIT BREAKERS FOR CIRCUITS SERVING EXIT SIGN FIXTURES AND EMERGENCY BATTERY PACK FIXTURES.

8. REFER TO ARCHITECT'S REFLECTED CEILING PLAN FOR EXACT LOCATION OF ALL CEILING MOUNTED LIGHTING FIXTURES AND OTHER CEILING INSTALLED ITEMS.

9. THE USE OF FLEXIBLE CONDUIT FROM LIGHTING FIXTURES TO JUNCTION BOX IS PERMITTED ONLY WHEN A SEPARATE GROUND WIRE IS INSTALLED WITH THE CONDUCTORS INSIDE FLEXIBLE CONDUIT. THE GROUND WIRE MUST BOND THE FIXTURE HOUSING TO THE JUNCTION BOX. MAXIMUM LENGTH

10. EXACT LOCATION AND MOUNTING HEIGHTS OF ALL WIRING DEVICES SHALL BE COORDINATED WITH THE ARCHITECT PRIOR TO THE INSTALLATION.

11. WALL MOUNTED EQUIPMENT (SWITCHES, RECEPTACLES, ETC.,) SHALL BE SURFACE MOUNTED IN

12. CONDUIT RUNS SHALL BE PARALLEL WITH OR AT RIGHT ANGLES TO WALLS AND CEILINGS. CONDUIT SHALL BE SUPPORTED BY APPROVED MEANS. SUPPORTS FOR HORIZONTAL RUNS OF CONDUIT SHALL NOT EXCEED SEVEN FEET ON CENTERS.

13. PROVIDE PULL BOXES, JUNCTION BOXES, CONDUIT ELBOWS AND OFFSETS TO SUIT FIELD CONDITIONS

AND THE NATIONAL ELECTRICAL CODE. 14. CONTRACTOR SHALL COORDINATE WITH THE FIRE DEPARTMENT AND F.A. VENDOR BEFORE

PROCEEDING WITH WORK INVOLVING FIRE ALARM SYSTEM. 15. ALL EMPTY CONDUIT SHALL BE PROVIDED WITH A DRAGWIRE.

16. THE MINIMUM WIRE SIZE FOR 120 VOLT BRANCH CIRCUITS SHALL BE NO. 12 AWG, EXCEPT OVER 100' IN LENGTH SHALL BE NO. 10 AWG.

17. PROVIDE ALL REQUIRED AND NECESSARY ACCESSORIES (EX. CONNECTORS, ADAPTERS, BUSHINGS, CLAMPS, ETC.) TO FACILITATE COMPLETE INSTALLATION.

18. COORDINATE LOCATION OF ALL MECHANICAL EQUIPMENT WITH HVAC CONTRACTOR IN FIELD. FUSES FOR ALL MOTOR LOADS SHALL BE DUAL ELEMENT TIME DELAY TYPE.

19. ALL JUNCTION OR OUTLET BOXES SHALL BE INSTALLED SO AS TO ALLOW ACCESS TO COVER. PROVIDE ARCHITECT APPROVED ACCESS DOORS OR PLATES AS REQUIRED IN AREAS WHERE UNOBSTRUCTED ACCESS TO BOX OR OUTLET IS NOT POSSIBLE.

20. PRIOR TO ORDERING LIGHTING FIXTURES, COORDINATE WITH ARCHITECTURAL DRAWINGS AND SPECIFICATIONS. IF DISCREPANCIES EXIST BETWEEN ARCHITECTURAL AND ENGINEERING INFORMATION OBTAIN CLARIFICATION PRIOR TO PROCEEDING.

21. MULTIPLE SWITCHES SHOWN IN SAME LOCATION SHALL BE GANGED TOGETHER WITH A COMMON

22. ALL LIGHTING FIXTURES UTILIZING ELECTRONIC BALLASTS SHALL BE PROVIDED WITH A DEDICATED NEUTRAL OR AN OVERSIZED NEUTRAL WHEN SHARED.


23. PRIOR TO ANY CHASING, CHOPPING OR CORE DRILLING IS PERFORMED, THE CONTRACTOR SHALL FIELD INVESTIGATE CONDITIONS AND COORDINATE ALL WORK TO ENSURE THAT IT WILL BE IN HARMONY AND NOT AFFECT ANY EXISTING BUILDING SYSTEMS. THIS WORK MUST BE APPROVED BY BUILDING OWNER PRIOR TO PROCEEDING.

24. OPENINGS AROUND ELECTRICAL PENETRATIONS THROUGH FIRE RESISTANCE RATED WALLS, PARTITIONS, FLOORS OR CEILINGS SHALL BE FIRE STOPPED USING APPROVED METHODS. ALL SLEEVES MUST HAVE BUSHINGS. SEALANT SHALL BE 3 HOUR FIRE BARRIER #CP-25 (NO LESS THAN 3" THICK BACKED UP WITH MINERAL WOOL).

25. ALL PANELBOARD COVERS SHALL BE INSTALLED IN PLACE AT THE COMPLETION OF EACH DAYS

26. PREPARE 'AS-BUILT' DRAWINGS SHOWING ALL CHANGES IN WIRE SIZE, CIRCUIT NUMBERING, CIRCUIT ROUTING, EQUIPMENT LOCATIONS AND ALL ELECTRICAL WORK AS ACTUALLY INSTALLED.

27. LIGHT FIXTURES SHALL BE CONSTRUCTED TO SUIT PARTICULAR TYPE OF CEILING AND WALL CONSTRUCTION AND SHALL BE PROVIDED WITH APPROPRIATE TRIMS, MOUNTING FRAMES AND

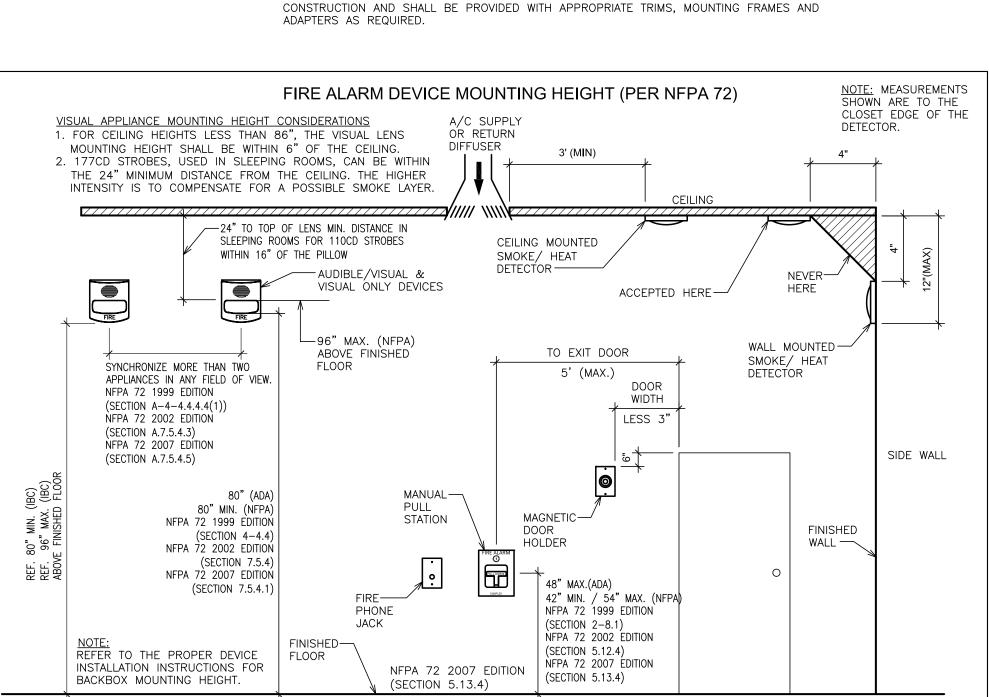

ELECTRICAL WORK NOTES

DEVICES AND OUTLETS.

1. CONNECT NEW RECEPTACLES TO EXISTING INDICATED PANEL BOARD. PROVIDE NEW 1P-20AMP BREAKER IN EXISTING SPACE AND CIRCUIT WITH 2#12+1#12G IN ₹"C. PROVIDE ALL ACCESSORIES FOR COMPLETE INSTALLATION. CIRCUIT NUMBERS ARE SHOWN FOR CONTRACTORS GUIDANCE ONLY.

EXISTING ELECTRICAL PANELS WHICH CURRENTLY HAVE NO IDENTIFICATION TAGS HAVE BEEN

ARBITRARILY LABELED IN THESE DOCUMENTS FOR IDENTIFICATION PURPOSES. CONNECT NEW RECEPTACLE TO EXISTING PANEL BOARD LOCATED IN EXISTING ELECTRICAL ROOM. PROVIDE NEW 1P-20AMP BREAKER IN EXISTING SPACE AND CIRCUIT WITH 2#12+1#12G IN 3. C. PROVIDE ALL ACCESSORIES FOR COMPLETE INSTALLATION. CIRCUIT NUMBERS ARE SHOWN FOR CONTRACTORS GUIDANCE ONLY.

ELECTRICAL CONTRACTOR SHALL REPLACE EXISTING PANEL BOARD COVER WITH NEW LOCKABLE TYPE PANEL COVER TO MATCH EXISTING. NEW PANEL BOARD COVERS SHALL ALL BE KEYED THE SAME AND PROVIDE THE OWNER WITH 2 KEYS FOR EACH PANEL BOARD.

GENERAL POWER NOTES: REFER TO ARCHITECTURAL DRAWINGS FOR THE EXACT LOCATION AND MOUNTING HEIGHTS OF ALL

B. RECEPTACLES SHALL BE CIRCUITED IN ACCORDANCE WITH CIRCUIT NUMBER INDICATED ADJACENT TO EACH DEVICE. CIRCUITRY MAY BE SHOWN IN CERTAIN INSTANCES.

ALL RECEPTACLES SPECIFIED FOR PERSONAL COMPUTERS, LASER PRINTERS AND SIMILAR TYPES OF EQUIPMENT SHALL BE PROVIDED WITH A SEPARATE NEUTRAL AND GROUND CONDUCTOR. SHARED NEUTRAL CONDUCTORS FOR THESE HOMERUNS ARE NOT PERMITTED

THE ELECTRICAL CONTRACTOR SHALL CONFIRM THE CONFIGURATION TYPE FOR ALL SPECIAL RECEPTACLES FOR COPIERS, DATA PROCESSING EQUIPMENT. ETC. WITH OWNER AND ENGINEER PRIOR


CIRCUIT NUMBERS ARE INDICATED FOR INTENT ONLY. THE ELECTRICAL CONTRACTOR SHALL ADJUST ACCORDINGLY IN THE FIELD, TO BALANCE THE CIRCUITS EVENLY ON ALL PHASES.

F. EXACT LOCATION OF MECHANICAL EQUIPMENT SHALL BE COORDINATED IN THE FIELD.

G. ALL WIRING SHALL BE RUN IN EMT CONDUIT. FLEXIBLE CABLE IS NOT ALLOWED. H. MECHANICAL EQUIPMENT IS LOCATED ABOVE THE HUNG CEILING UNLESS OTHERWISE NOTED. EXACT

I. ALL RECEPTACLES SHALL BE GROUND FAULT INTERRUPTING TYPE.

LOCATION SHALL BE DETERMINED FROM MECHANICAL DRAWINGS.

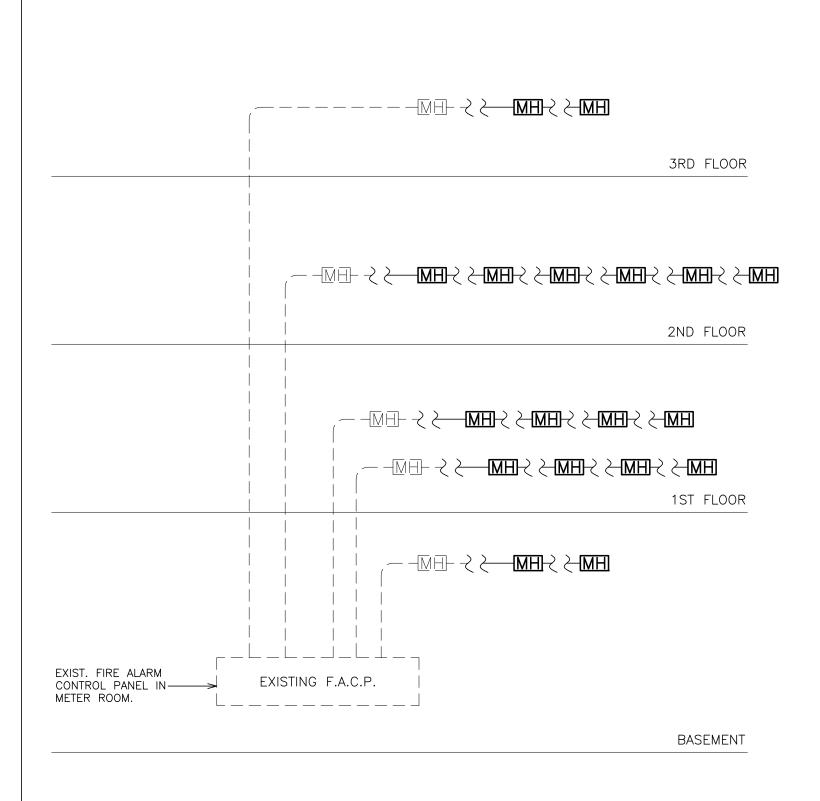

FIRE ALARM RISER NOTES:

FIRE ALARM WIRING DIAGRAMS SHOWN ARE FOR GENERAL ARRANGEMENT ONLY. ELECTRICAL CONTRACTOR SHALL VERIFY AND OBTAIN POINT TO POINT WIRING DIAGRAM PRIOR TO INSTALLATION FROM MANUFACTURER.

PERMITS AND APPROVALS NECESSARY FOR INSTALLATION OF THE WORK SHALL BE OBTAINED PRIOR TO THE COMMENCEMENT OF THE WORK. ALL PERMIT COSTS AND INSPECTION FEES SHALL BE INCLUDED AS PART OF THIS CONTRACT. 5. IN AREAS WHERE DUST AND DIRT WILL BE AIRBORNE DURING DEMOLITION AND CONSTRUCTION THE CONTRACTOR SHALL PROVIDE

PLASTIC WRAP OVER SMOKE DETECTORS AND THEN REMOVE ONCE SPACE IS CLEAN. 4. UNLESS DIRECTED OTHERWISE BY FIRE ALARM SYSTEM MANUFACTURER FIRE ALARM DEVICE WIRING SHALL BE AS FOLLOWS (FOR BIDDING PURPOSES ONLY):

HORN WIRING - #16 AWG TWISTED APPROVED TEFLON CABLE STROBE WIRING - #14 AWG TWISTED APPROVED TEFLON CABLE SIGNAL WIRING - #14 AWG TWISTED/SHIELDED APPROVED TEFLON CABLE

THE WIRING SHALL HAVE THE FOLLOWING CHARACTERISTICS: A. A MINIMUM TEMPERATURE RATING OF 150 C B. A MINIMUM AVERAGE INSULATION THICKNESS OF 15 MILS . A MINIMUM AVERAGE JACKET THICKNESS OF 25 MILS . THE COLOR OF THE CABLE SHALL BE RED

THE CABLE SHALL BE A TYPE FPLP (PLENUM TYPE) THE CABLE SHALL BE VISIBLY MARKED EXTERNALLY THAT IT MEETS THE ABOVE REQUIREMENTS AND IS LISTED BY UL. CONFIRM WIRING TYPE AND QUANTITY WITH FIRE ALARM SYSTEM MANUFACTURER PRIOR TO PURCHASING.

PROVIDE MC FIRE ALARM CABLE WITH RED STRIPE AS MANUFACTURED BY AFC SERIES 1800 WHEN CABLE IS CONCEALED OR ABOVE HUNG CEILING. WHEN FIRE ALARM CABLE IS RUN EXPOSED IN FINISHED AREAS, CABLE SHALL RUN IN WIREMOLD V-700. WHEN FIRE ALARM CABLE IS RUN EXPOSED IN UNFINISHED AREAS, PROVIDE PLENUM RATED CABLE IN MIN. 3/4" CONDUIT. 6. STROBES SHALL HAVE A MINIMUM LIGHT OUTPUT OF 75 CANDELA AND A FLASH RATE OF 1-3 HZ.

. WALL MOUNTED HORN/STROBE UNITS SHALL NOT HAVE ANY OTHER DEVICES OR APPURTENANCES WITHIN 5 FEET OF THE DEVICE. THEY SHALL BE A MAXIMUM OF 80 INCHES ABOVE FLOOR OR 6" BELOW THE CEILING, WHICHEVER IS LOWER. DEVICES SHALL BE FLUSH MOUNTED IN ALL FINISHED AREAS. PROVIDE DOUBLE DEEP DEVICE BOX IN WALL.

8. AFTER THE SYSTEM IS COMPLETE, TEST ALL COMPONENTS IN ACCORDANCE WITH SEQUENCE OF OPERATION PRIOR TO FIRE 9. ALL PULL STATIONS SHALL BE PROVIDED WITH CLEAR PROTECTIVE LEXAN COVER. COVER SHALL BE AS MANUFACTURED BY SAFETY TECHNOLOGY INTERNATIONAL INC. CAT.#STI 1100 STOPPER II.

10. IF CAPACITY EXISTS ON EXISTING CIRCUITS E.C. MAY CONNECT NEW DEVICES TO EXISTING CIRCUITS. IN LIEU OF PROVIDING NEW CIRCUIT. COORDINATE WITH SYSTEM MANUFACTURE / VENDOR PRIOR TO TIE-IN.

11. FIRE ALARM SEQUENCE OF OPERATION SEE SPECIFICATIONS. 12. ELECTRICAL CONTRACTOR SHALL VERIFY AND COORDINATE WITH THE BUILDING FIRE ALARM MAINTENANCE VENDOR FOR TYPE OF FIRE ALARM DEVICES TO BE USED. CONTACT BUILDING MANAGEMENT FOR CONTACT INFORMATION. ALL NEW DEVICES INSTALLED SHALL BE COMPATIBLE AND CONSISTENT WITH THE EXISTING BUILDING FIRE ALARM SYSTEM INSTALLATION.

13. ELECTRICAL CONTRACTOR SHALL BE RESPONSIBLE TO RETAIN AND COORDINATE WITH THE BUILDING FIRE ALARM MAINTENANCE. VENDOR FOR PROGRAMMING AND FINAL CONNECTIONS TO THE FIRE ALARM SYSTEM. ELECTRICAL CONTRACTOR SHALL INCLUDE PROGRAMMING AND FINAL CONNECTION COSTS IN THEIR BID. 14. THE FIRE ALARM INSTALLATION SHALL COMPLY WITH NEW YORK STATE EDUCATION DEPT, NEC, THE AMERICANS WITH DISABILITIES

15. ELECTRICAL CONTRACTOR SHALL BE RESPONSIBLE TO MAINTAIN AND PROTECT EXISTING FIRE ALARM SPEAKERS, SMOKE DETECTORS, STATIONS AND OTHER FIRE ALARM SAFETY DEVICES IN OPERATION AT ALL TIMES. IF ANY PORTION OF FIRE ALARM SYSTEM IS DISABLED, NOTIFY BUILDING MANAGER IMMEDIATELY.

PART F.A. RISER DIAGRAM

ACT (ADA) AND ALL AUTHORITIES HAVING JURISDICTION.

щОС

S.E.D. CONTROL NUMBER: 66-23-00-01-0-029-011 PEARLS HAWTHORNE SCHOOL 66-23-00-01-0-101-008

10-11-2019 DESIGN DEVELOPMENT DATE ISSUED TO SHEET SIZE 30"x42" AS NOTED

FILE NO.

19354.07

DRAWN BY

F & D

FILE: I:\19354.07 Yonkers Group B Phase 2 Roofs PS 29 and Pearls\DRAWINGS\CURRENT\1-F&D\19354.03-E100.dwg

