

BUILDING PLAN  
SCALE: 1/2" = 1'-0"

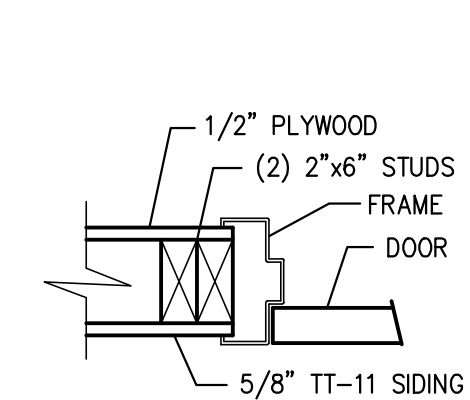
HARDWARE SCHEDULE

- HARDWARE SET 1
- 6 4 1/2x4 1/2 HAGER BB 1279 NRP HINGE - 26D
  - 1 5-0 HAGER 412SA THRESHOLD
  - 1 5070 HAGER PERIMETER WEATHERSTRIP
  - 2 2-6 HAGER 756SAV DOOR BOTTOM
  - 1 7-0 NRP 115NA MEETING STYLE WEATHERSTRIP
  - 2 HAGER 275D 8" SURFACE BOLTS
  - 1 DORMA 641 BC PA CLOSER
  - 1 3 1/2x15 ALUMINUM PUSH PLATE
  - 1 3 1/2x15 ALUMINUM PULL PLATE
  - 1 SCHLAGE B 462 DOUBLE CYLINDER DEADBOLT - 626


- HARDWARE SET 2
- 1.5 PAIR 4 1/2 X 4 1/2 HAGER 1279BB HINGE US26D
  - 3 HAGER 307D DOOR SILENCER
  - 1 DORMA 641BC PA CLOSER
  - 1 DORMA 8300B RIM EXIT DEVICE WITH R23 LEVER TRIM BE X 626
  - 1 8X34 HAGER 190S KICKPLATE US32D

DOOR SCHEDULE											
DOOR No.	DOOR DESCRIPTION			FINISH	FRAME			THRESHOLD MATERIAL	HARDWARE SET	REMARKS	
	WIDTH	HEIGHT	THICK		MATERIAL	FINISH	JAMB DETAIL				
D1	5'-0"	7'-0"	1 3/4"	P	18 GAUGE FLUSH H.M.	H.M.	P	2	ALUMINUM	1	2 - 2'-6" LEAFS (DOUBLE DOOR)
D2	2'-6"	6'-8"	1 3/4"	P	FRP	WOOD	P	3	N/A	2	PANIC HARDWARE USE 22"x 24" LOUVER IN TYPE L DOOR
D3	2'-6"	6'-8"	1 3/4"	P	18 GAUGE FLUSH H.M.	H.M.	P	1	N/A	2	


\* WARMINSTER FIBERGLASS WFD 1000




JAMB DETAIL 1  
NOT TO SCALE

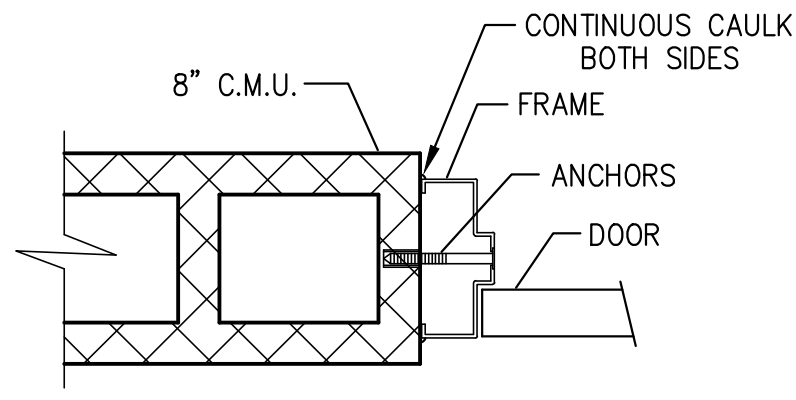

JAMB DETAIL 2  
NOT TO SCALE

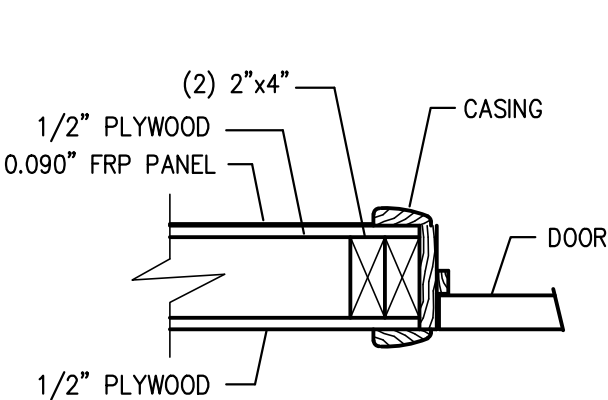

JAMB DETAIL 3  
NOT TO SCALE

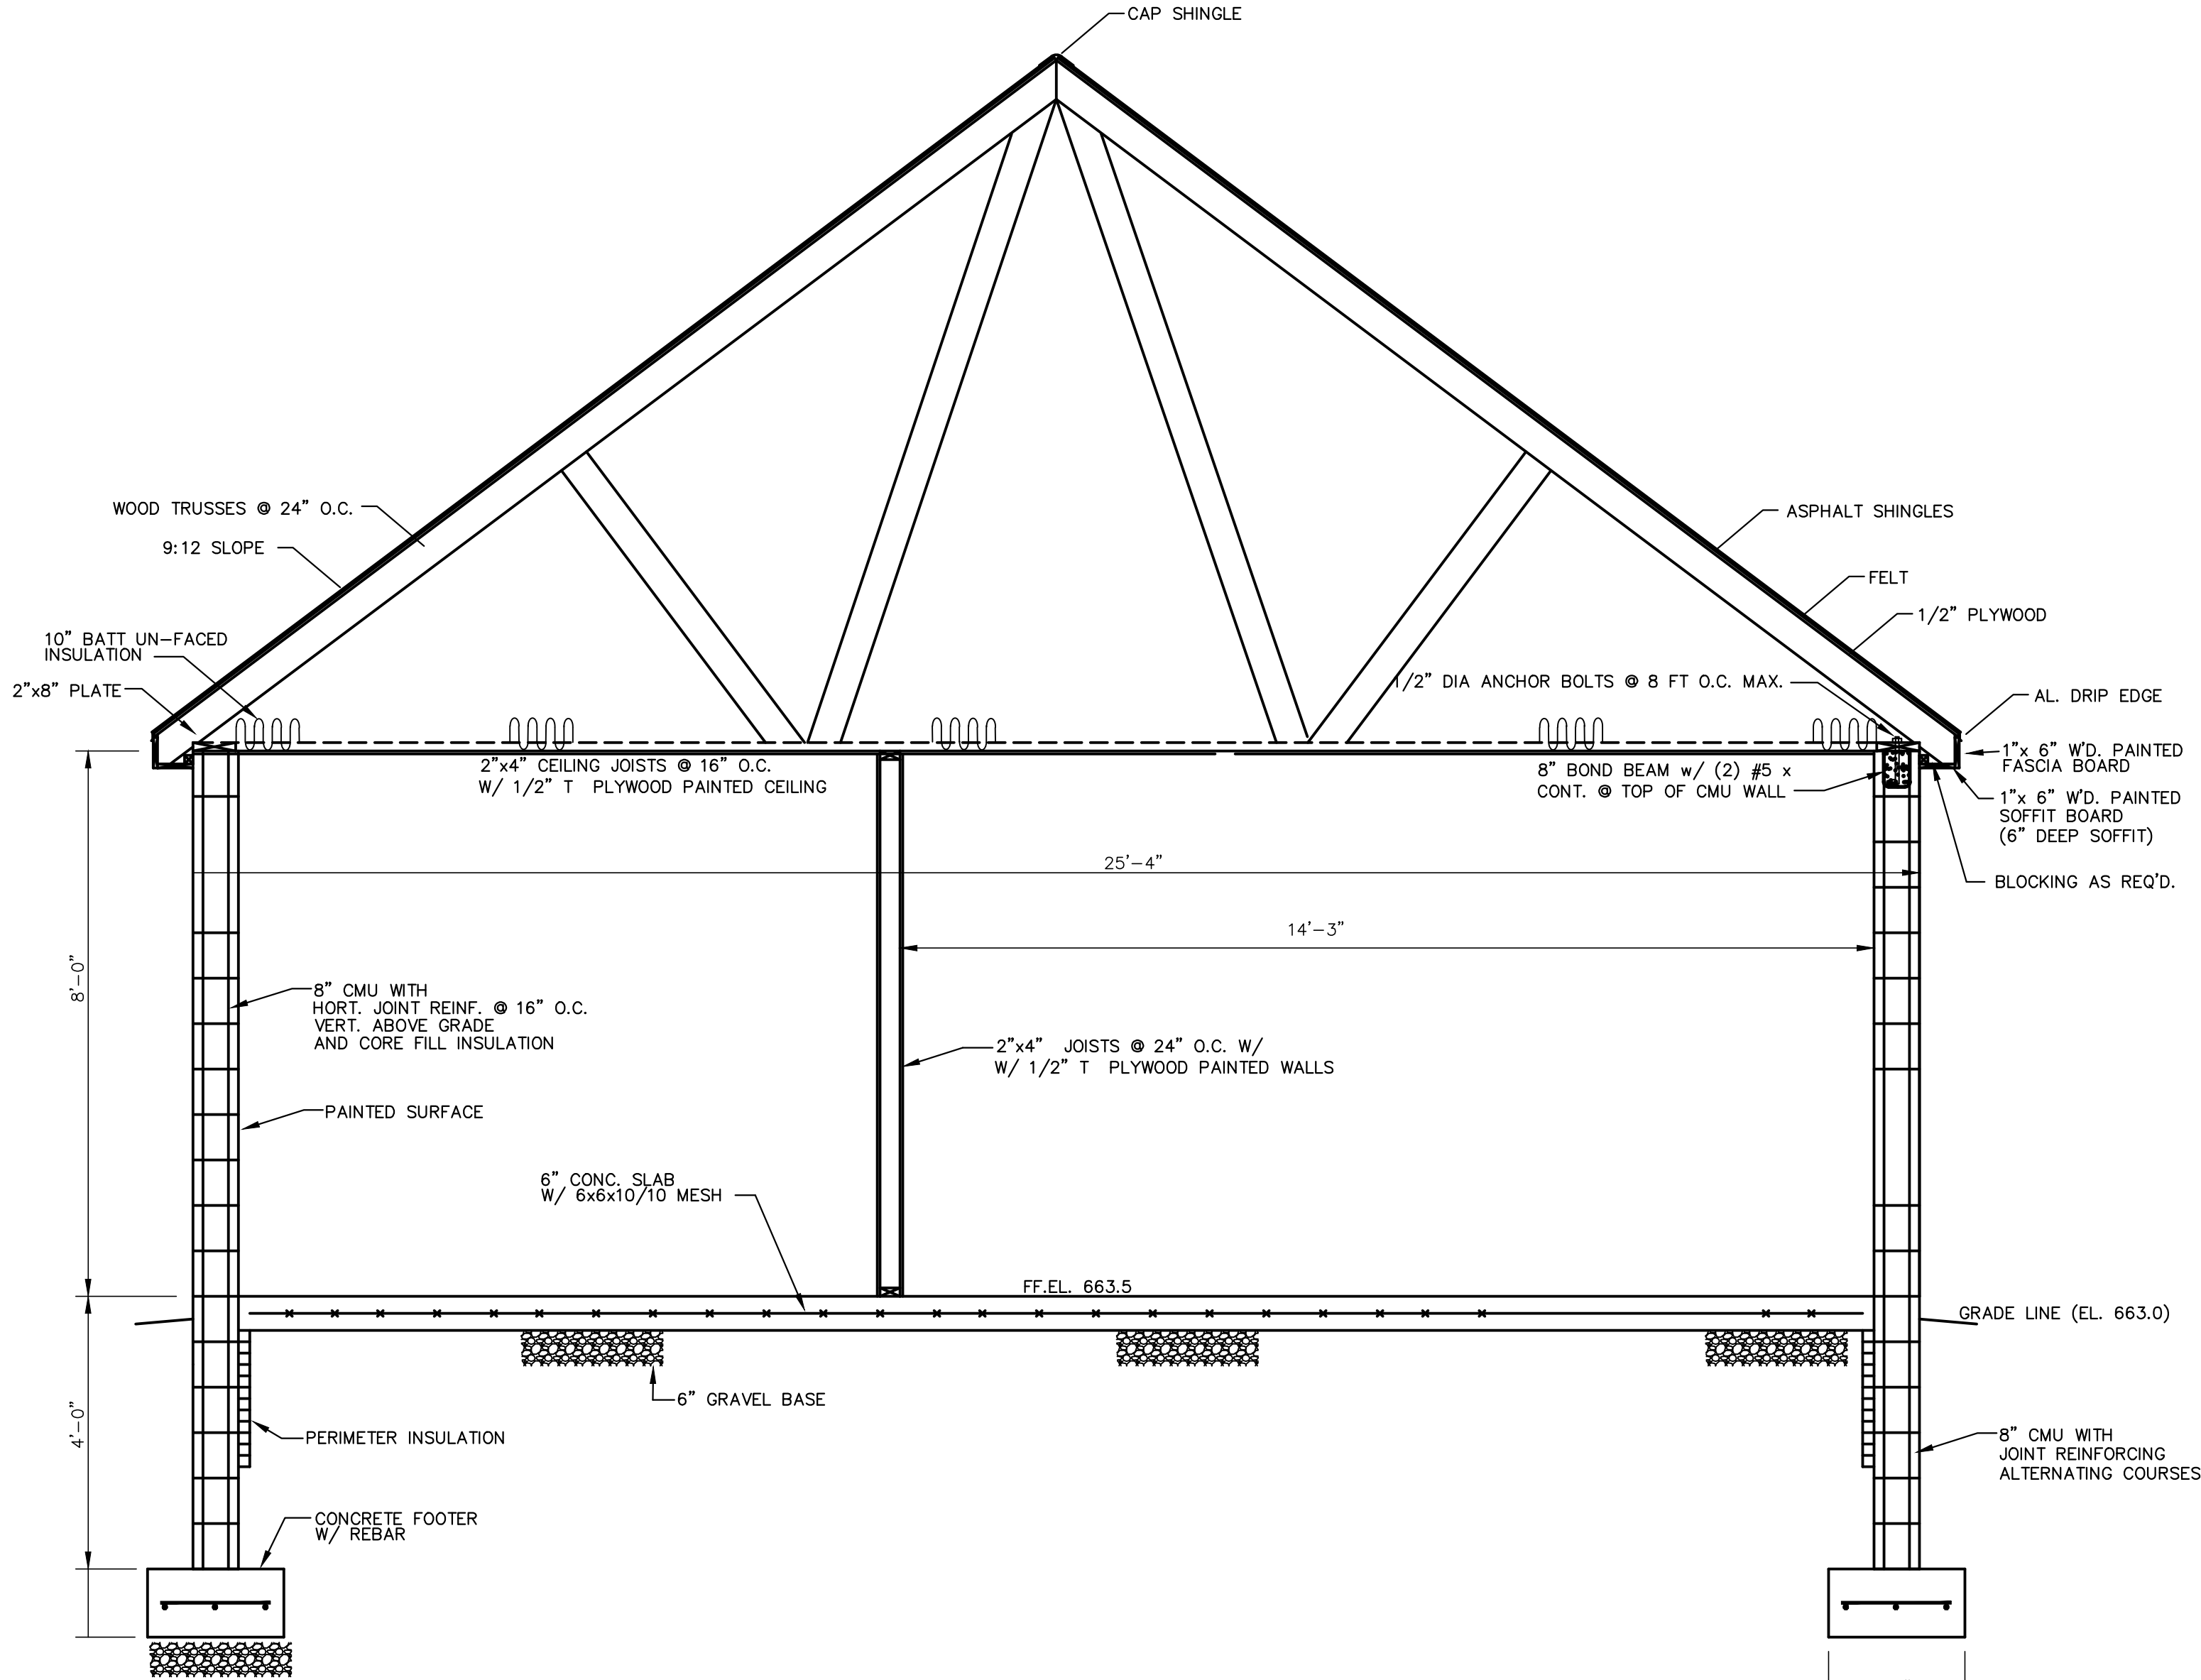

PROPOSED BUILDING CROSS SECTION  
SCALE: 1/2" = 1'-0"


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**PRELIMINARY-  
NOT FOR  
CONSTRUCTION**

REV.	DESCRIPTION	BY	DATE	APP'D.
2	PER NYSDOH 10/21/21 COMMENTS	MPG	11/15/21	
1	PER NYSDOH 7/14/21 COMMENTS	MPG	8/3/21	



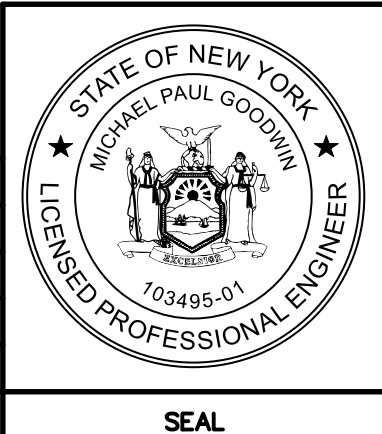**MILNES ENGINEERING INC.**  
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TITLE: BUILDING PLAN AND DETAILS COMMERCIAL CAMPUS AT FIELDS CORNER PUBLIC WATER SUPPLY PERMIT TOWN OF SOUTHEAST, PUTNAM COUNTY, NY			
DRAWN: MPG	DATE: 4/2021	CHK'D:	DATE:
SCALE: AS SHOWN	APP'D:	DATE:	
AUTOCAD FILE G:/E-2121/CAMPUS	DRAWING NUMBER B-1	NUMBER	REV. 1
PROJECT NUMBER E-2121			