
GENERAL NOTES:

- A. GENERAL NOTES, SYMBOLS LIST AND DETAILS ARE APPLICABLE TO ALL DRAWINGS WITHIN DIVISION 23.
- B. COORDINATE WORK OF DIVISION 23 WITH THAT OF OTHER SECTIONS.
- C. READ SPECIFICATIONS FOR REQUIREMENTS PERTAINING TO THESE DOCUMENTS.
- D. FITTINGS SHOWN ARE TO BE PROVIDED. NO SUBSTITUTES SHALL BE ALLOWED WITHOUT PRIOR CONSENT FROM ARCHITECT/ENGINEER.
- E. INSTALL DUCTWORK AND PIPING CONCEALED, UNLESS SPECIFIED OTHERWISE.
- F. ALL WORK SHALL BE COORDINATED WITH ALL TRADES INVOLVED. OFFSETS IN PIPING AND DUCTS (INCLUDING DIVIDED DUCTS) AND TRANSITIONS AROUND OBSTRUCTIONS SHALL BE PROVIDED AT NO ADDITIONAL COST TO THE OWNER.
- G. VERIFY ALL EQUIPMENT CONNECTIONS WITH MANUFACTURER'S CERTIFIED DRAWINGS. VERIFY AND PROVIDE DUCT TRANSITIONS TO FURNISHED EQUIPMENT. FIELD VERIFY AND ALL DIMENSIONS BEFORE FABRICATION.
- H. ALL MATERIAL AND EQUIPMENT SHALL BE NEW.
- I. INSTALL ALL EQUIPMENT PER MANUFACTURER'S INSTRUCTIONS AND LOCAL, STATE, AND NATIONAL CODES.
- MECHANICAL CONTRACTOR SHALL PROVIDE ALL PENETRATIONS THROUGH WALLS, FLOORS AND ROOFS NECESSARY FOR INSTALLATION OF MECHANICAL SYSTEMS. DO NOT DRILL, CORE OR CUT ANY PORTION OF COLUMNS, BEAMS, JOISTS OR BRIDGING RIBS.
- K. MECHANICAL CONTRACTOR TO PROVIDE CUSTOM COLOR SELECTION FOR WALL CAPS, ROOF JACKS, VENT TERMINATIONS & LOUVERS. ARCHITECT TO SELECT COLOR OF EQUIPMENT.
- L. PROVIDE INSULATED REFRIGERANT PIPING BETWEEN EACH FAN COIL UNIT & HEAT PUMP UNIT. PIPING SHALL BE SIZED AND INSTALLED PER MANUFACTURER'S INSTRUCTIONS. CAULK & SEAL REFRIGERANT PIPE PENETRATION THRU EXTERIOR WALL, WEATHER-TIGHT.
- M. COORDINATE FINAL DUCTWORK ROUTING & FITTINGS WITH APPROVED TRUSS DESIGN. MODIFY LAYOUT AS NECESSARY TO ROUTE DUCTWORK THRU TRUSS WEBS.
- N. REFER TO MANUFACTURER'S INSTRUCTIONS FOR SIZING & INSTALLATION OF REFRIGERANT PIPING IN "LONG LINE" APPLICATIONS.
- O. PROVIDE MASTIC SEALANT ON ALL JOINTS, LONGITUDINAL & TRANSVERSE SEAMS AND CONNECTIONS IN DUCTWORK. MASTIC SEALANT SHALL BE LISTED & LABELED IN ACCORDANCE WITH UL 181A OR UL 181B. DUCTWORK SHALL BE INSPECTED BY OWNER'S REPRESENTATIVE PRIOR TO INSTALLATION OF INSULATION. SEALANT SHALL BE LOW VOC.
- P. WALL CAPS & ROOF JACKS SHALL BE CORROSION RESISTANT GALVANIZED STEEL WITH BIRD SCREEN AND BACK DRAFT DAMPER. CUSTOM COLOR SELECTION BY ARCHITECT.
- Q. MOUNTING HEIGHT FOR THERMOSTATS SHALL BE 48" TO TOP OF COVER, ABOVE FINISHED FLOOR.
- R. MAINTAIN A MINIMUM 36" CLEARANCE BETWEEN SUPPLY DIFFUSERS/ REGISTERS AND SMOKE DETECTORS.
- S. COORDINATE DUCTWORK ROUTING AND INSTALLATION WITH OTHER TRADES.
- T. OR IN-UNIT DEVICES (THERMOSTATS), REFER TO ARCHITECTURAL & ELEVATION PLANS FOR EXACT LOCATIONS & HEIGHTS. COORDINATE 1' DISTANCE FROM EDGE OF WALL.
- U. CONTRACTOR SHALL PROVIDE REFRIGERANT CHARGE TEST CERTIFICATION. CHARGE TEST TO BE PREFORMED BY A
 QUALIFIED TECHNITION.

	HVAC SYI	MBOL LIST	
SYMBOL	DESCRIPTION	SYMBOL	DESCRIPTION
	EXISTING WORK TO BE REMOVED	——A——	COMPRESSED AIR
	POINT OF CONNECTION	V	VENT BOILER BLOW DOWN
		CS	CONDENSER WATER SUPPLY
	POINT OF DISCONNECTION	——CR——	CONDENSER WATER RETURN
(X)	DRAWING KEYNOTE	CWS	CHILLED WATER SUPPLY
		——CWR——	CHILLED WATER RETURN DRAIN
X	DEMOLITION KEYNOTE	—— FOF ——	FUEL OIL FILL
MBH	THOUSAND BTU/HOUR	——FOG——	FUEL OIL GAUGE
NTS	NOT TO SCALE	——FOS——	FUEL OIL SUPPLY
(E)	EXISTING	—— FOR ——	FUEL OIL RETURN
(L) (2L)	ACOUSTIC THERMAL LINING - 1-1/2" THICK ACOUSTIC THERMAL LINING - 2" THICK	—— FOV —————————————————————————————————	FUEL OIL TANK VENT GAS
(DBL)	DOUBLE WALL LINED DUCT	GS	GLYCOL SUPPLY
FPM	FEET PER MINUTE	——GR——	GLYCOL RETURN
CFM	CUBIC FEET PER MINUTE	——HPWS——	HEAT PUMP WATER SUPPLY
AFF AD	ABOVE FINISHED FLOOR ACCESS DOOR	— HPWR——	HEAT PUMP WATER RETURN HOT WATER SUPPLY
W/W	WALL TO WALL	HWR—	HOT WATER RETURN
G.C.	GENERAL CONTRACTOR	—— LPS ——	LOW PRESSURE STEAM
M.C.	MECHANICAL CONTRACTOR	—— LPC ——	LOW PRESSURE CONDENSATE
P.C.	PLUMBING CONTRACTOR	MPS	MEDIUM PRESSURE STEAM
E.C. N.O.	ELECTRICAL CONTRACTOR NORMALLY OPEN	—— MPC —— —— HPS ——	MEDIUM PRESSURE CONDENSATE HIGH PRESSURE STEAM
N.C.	NORMALLY CLOSED	—— HPC ——	HIGH PRESSURE CONDENSATE
+++++++++++++++++++++++++++++++++++++++	FLEXIBLE DUCTWORK	——PC ——	PUMPED CONDENSATE
AxB	DUCT SECTION - FLAT OVAL (FO)	RD	REFRIGERANT DISCHARGE
FO		——RL——	REFRIGERANT SUCTION
12"	ROUND DUCT - IN INCHES		REFRIGERANT SUCTION HOT GAS
	DUOT GEOTIES STEELS	—— VAC ——	VACUUM
	DUCT SECTION - SUPPLY	CW	DOMESTIC COLD WATER
	DUCT SECTION - RETURN	TD	TRIPLE DUTY VALVE
^			GLOBE VALVE
AB	WIDTH A x DEPTH B		BALL VALVE GATE VALVE
		\$	CONTROL VALVE
	TRANSITION SQUARE TO ROUND	\$	THREE WAY CONTROL VALVE
- R	RISE IN DUCT - IN DIRECTION OF AIRFLOW	T	THREE WAY CONTROL VALVE
	TRISE IN DOCT - IN DIRECTION OF AIRT LOW	<u> </u>	CHECK VALVE
- D	DROP IN DUCT - IN DIRECTION OF AIRFLOW		BALANCING VALVE
		-	BUTTERFLY VALVE
N 24x12 UP	SUPPLY DUCT TURNING UP OR DOWN	₹	RELIEF VALVE
0N 24x12 UP	RETURN DUCT TURNING UP OR DOWN	PRV	PRESSURE REDUCING VALVE
	TRETOTIVE BOOT TOTALING OF GREGOVIA	— <u>[</u>	PRESSURE/TEMPERATURE TEST PLUG
-V-	SUPPLY/RETURN		SINGLE LINE PIPE CONTINUED
TAP 14x8 <	RECTANGULAR MAIN		DOUBLE LINE PIPE OR ROUND DUCT CONTINUED
11 1470 2	RECTANGULAR BRANCH	7	DOUBLE LINE RECTANGULAR
6" BOOT	CLIDDI VIDETLIDA		DUCT CONTINUED
TAP 14"	SUPPLY/RETURN RECTANGULAR MAIN		AIR FLOW
7 14"	ROUND BRANCH		PIPE ANCHOR PIPE GUIDE
CONICAL			EXPANSION COMPENSATOR WITH GUIDES
TEE TEE	SUPPLY/RETURN		
14"	ROUND MAIN ROUND BRANCH		PRE-FAB EXPANSION LOOP
CO LATERAL			STRAINER
LATERAL	SUPPLY/RETURN	<u></u>	PRESSURE GAUGE THERMOMETER
	ROUND MAIN		UNION
14"	ROUND BRANCH	† V	AIR VENT
		■ TT	THERMOSTATIC TRAP
	MITERED ELBOW WITH TURNING VANES	■ FT	FLOAT & THERMOSTATIC TRAP
		■ TD ■ BT	THERMODYNAMIC TRAP BUCKET TRAP
	OLIDDI V DIEFLIGED, DECICE - C. C. C.		DIRECTION OF FLOW
	SUPPLY DIFFUSER, REGISTER OR GRILLE		REDUCER
	RETURN REGISTER		CAP OR PLUG
			ELBOW DOWN
	EXHAUST GRILLE		ELBOW UP BOTTOM TAP
	FIN TUBE RADIATION	AAD	
	VALANCE	FD	FIRE DAMPER
	REGISTER, GRILLE OR DIFFUSER TAG	SD	SMOKE DAMPER
A B	A = TYPE	BDD	BACK DRAFT DAMPER FLEX CONNECTOR - DUCTWORK
C	B = NECK SIZE C = CFM	M	MOTORIZED DAMPER
FT-A	FIN TUBE RADIATION TAG	─ BG	BLAST GATE
В	FT-A = TYPE B = FIN TUBE LENGTH		VOLUME DAMPER
D	C = ENCLOSURE LENGTH	SD	SUCTION DIFFUSER FLEXIBLE CONNECTOR - PIPING
A	D = GPM RADIANT CEILING PANEL TAG		DRAIN VALVE WITH HOSE CONNECTION,
В	A = TYPE	- <u>•</u> ∃	CAP AND CHAIN
С	B = LENGTH C = GPM	FS	WATER FLOW SENSOR
Α	VALANCE TAG	TS	WATER TEMPERATURE SENSOR
ВС	A = TYPE B = COIL SIZE	SP-•	STATIC PRESSURE SENSOR
D	C = COOLING GPM	(H) (S)	HUMIDISTAT TEMPERATURE SENSOR
	D = HEATING GPM	©	CARBON DIOXIDE SENSOR
	AIR TERMINAL UNIT AND TAG (OPTION 1)	60	CARBON DIOXIDE SENSOR
В	AIR TERMINAL UNIT TAG (OPTION 2) A = UNIT NO.	G	GAS SENSOR
		① ① E	PNEUMATIC/ELECTRIC THERMOSTAT
A C	B = MAXIMUM CFM	A A A	THEDMOOTAT/OCKLOOD WITH OUACE
A	B = MAXIMUM CFM C = MINIMUM CFM	T G S G	THERMOSTAT/SENSOR WITH GUARD

Issued for Bidding 9/12/2023 ISSUES AND REVISIONS

© THIS DRAWING AND THE CONTENTS
THEREOF ARE THE SOLE AND
COPYRIGHTED PROPERTY OF BUTLER
ROWLAND MAYS ARCHITECTS, LLP AND
MAY NOT BE ALTERED, COPIED OR
REPRODUCED BY ANY METHOD FOR ANY
PURPOSE WITHOUT THE EXPRESS
WRITTEN CONSENT OF BUTLER ROWLAND
MAYS ARCHITECTS, LLP.

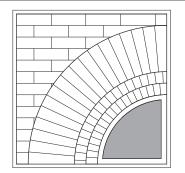

BUTLER ROWLAND MAYS ARCHITECTS, LLP

57 West High Street Ballston Spa New York 12020

P: 518•885•1255 F: 518•885•1266 www.brmarchitects.com

Phase 1 Interior Improvements to the Lower Level

for the

The

Beekman Library

11 Town Center Boulevard Hopewell Junction, NY 12533

PROJECT



CONSULTANT

ONSULTANT OF NEW SULTANT OF NEW SULT


CALLED NORTH

DWN. BY: HSK SCALE: 1/8" = 1'-0" JOB NO.: 22-46-09 DATE: 09/01/2023

GENERAL
NOTES,
SYMBOL LIST
&
ABBREVIATIONS

M001


DWC NO

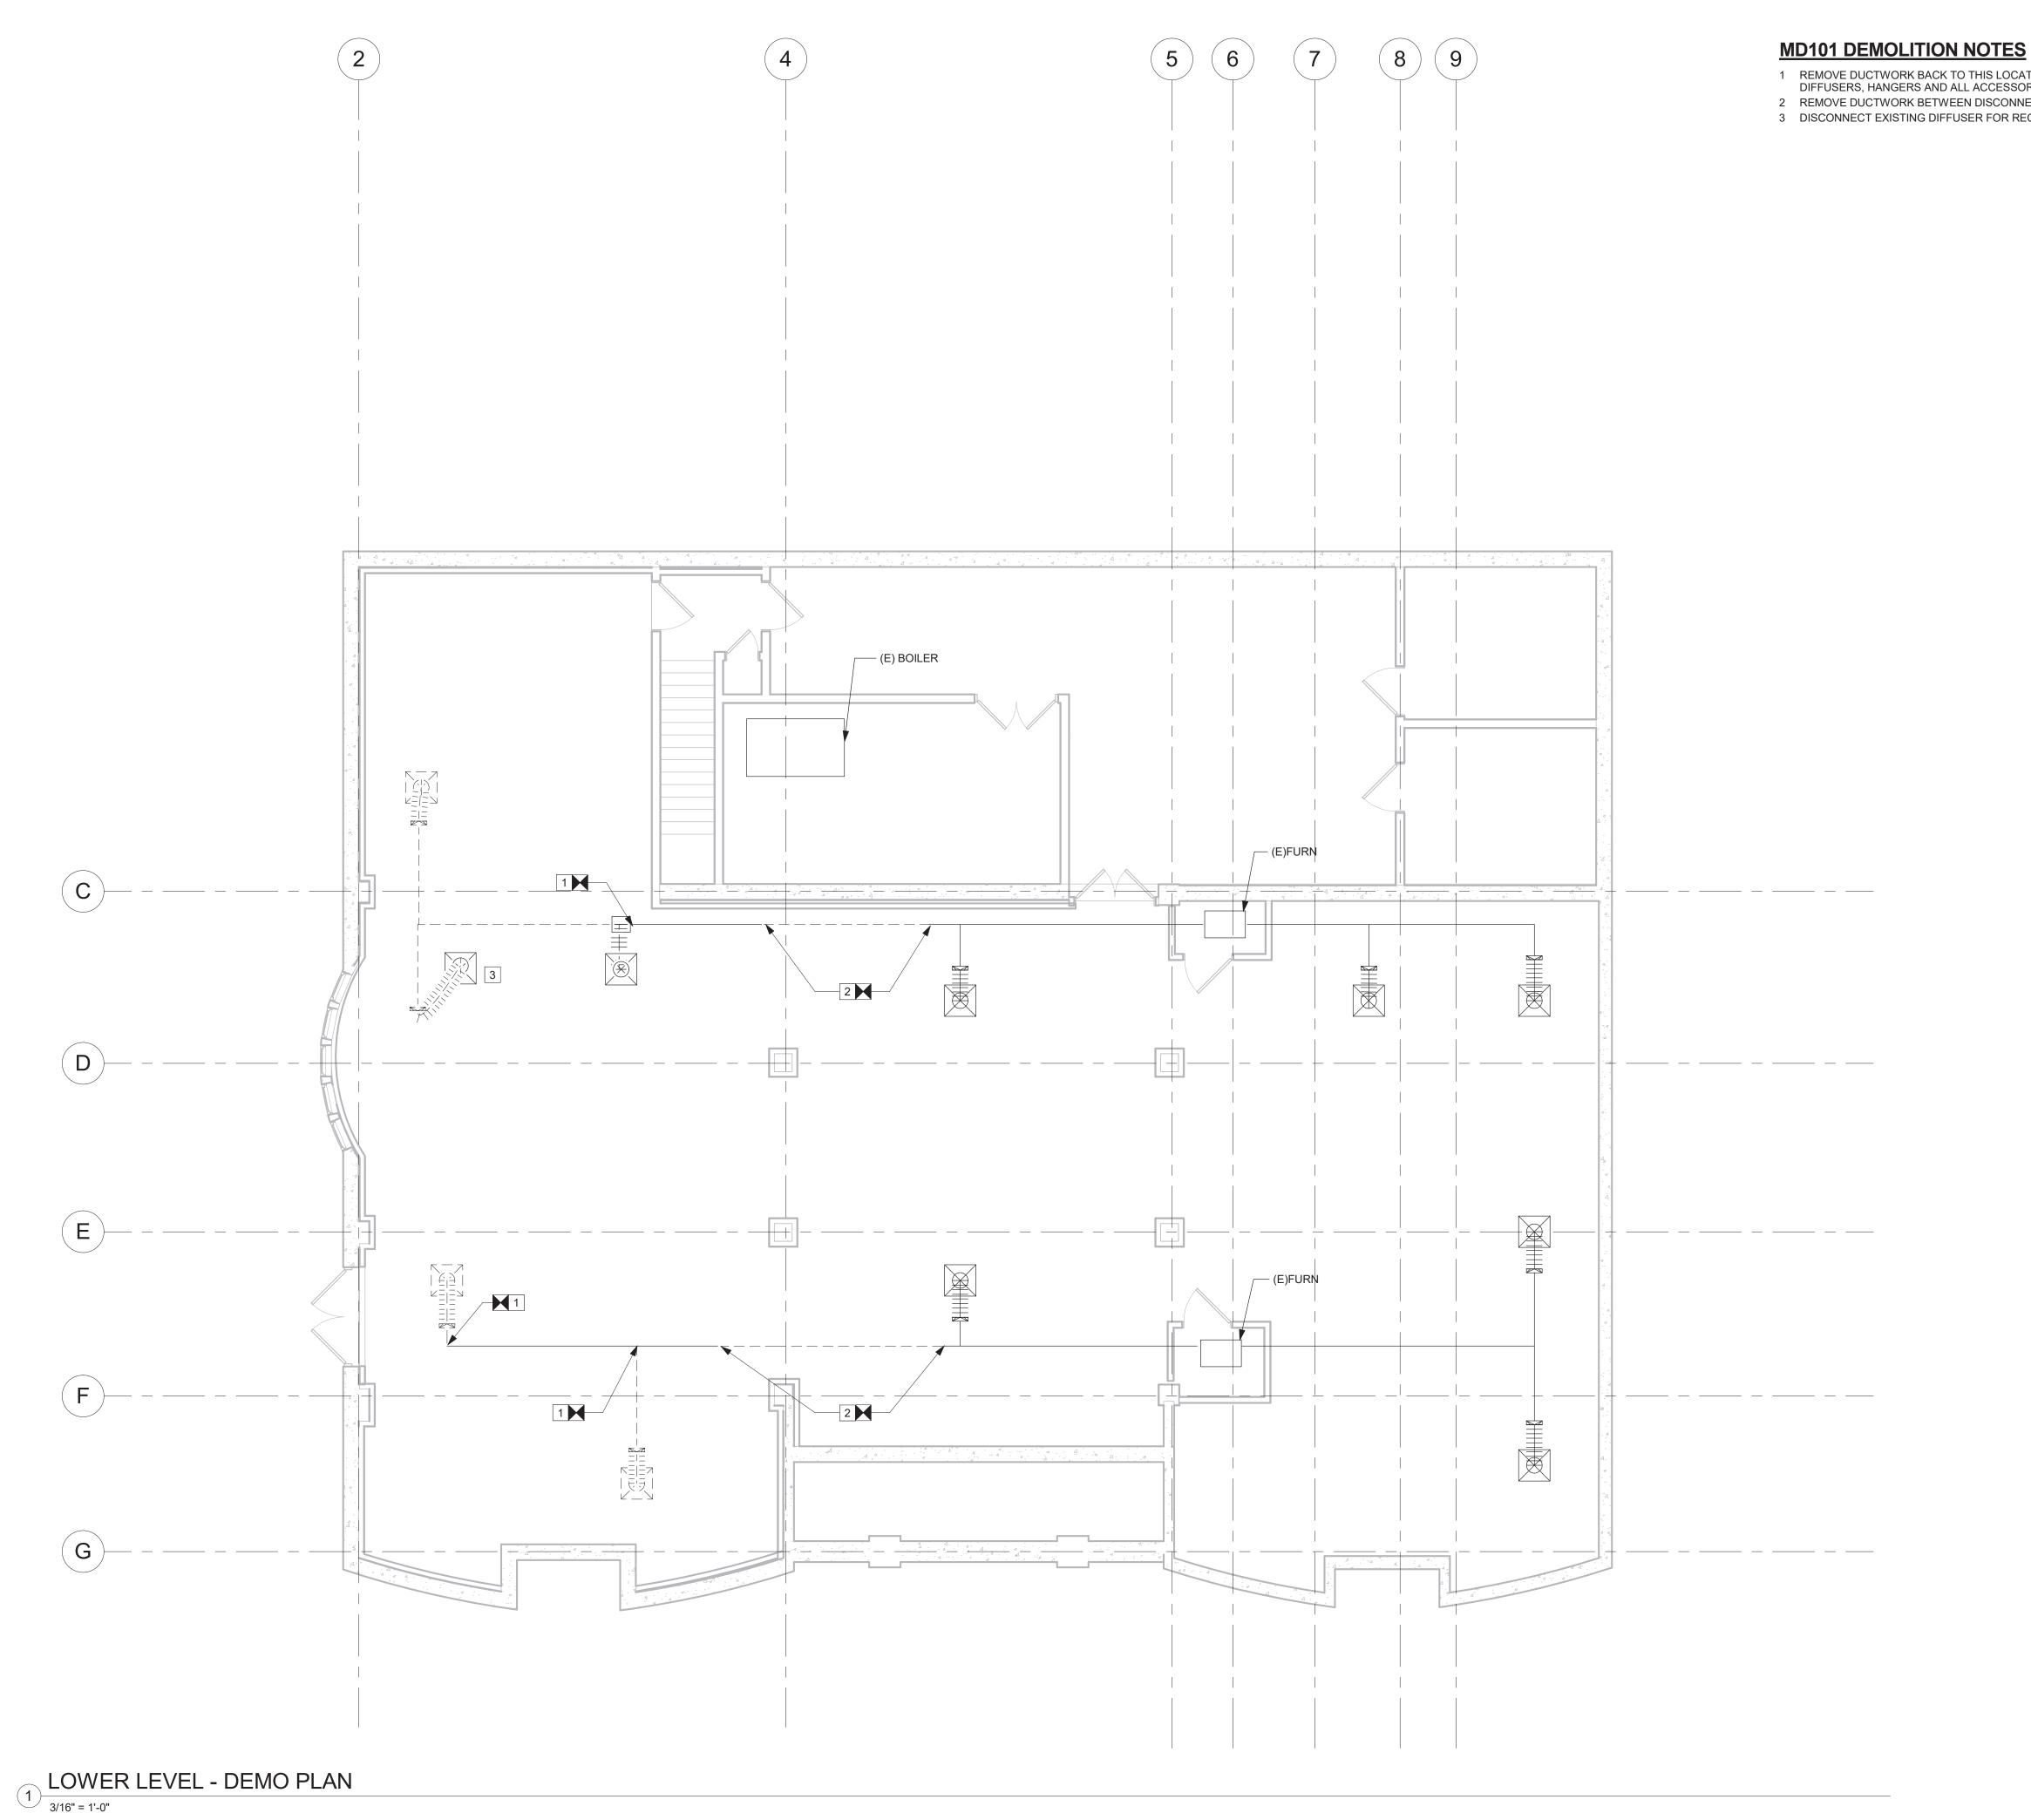

- 1 REMOVE DUCTWORK BACK TO THIS LOCATION AND CAP AIR TIGHT. INCLUDING DIFFUSERS, HANGERS AND ALL ACCESSORIES.
- 2 REMOVE DUCTWORK BETWEEN DISCONNECT SYMBOLS. CAP DUCTWORK AIR TIGHT.
- 3 DISCONNECT EXISTING DIFFUSER FOR RECONNECTION.

Issued for Bidding 9/12/2023 ISSUES AND REVISIONS

© THIS DRAWING AND THE CONTENTS
THEREOF ARE THE SOLE AND
COPYRIGHTED PROPERTY OF BUTLER
ROWLAND MAYS ARCHITECTS, LLP AND
MAY NOT BE ALTERED, COPIED OR
REPRODUCED BY ANY METHOD FOR ANY
PURPOSE WITHOUT THE EXPRESS
WRITTEN CONSENT OF BUTLER ROWLAND
MAYS ARCHITECTS, LLP.

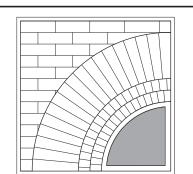

BUTLER ROWLAND MAYS

57 West High Street Ballston Spa New York 12020

ARCHITECTS, LLP

P: 518•885•1255 F: 518•885•1266 www.brmarchitects.com

Phase 1 Interior Improvements to the **Lower Level** for the

> The Beekman Library

11 Town Center Boulevard Hopewell Junction, NY 12533

PROJECT



Mechanical/Electrical Engineering Consultants

Capital District | Rochester | Buffalo | Syracuse

CONSULTANT




CALLED NORTH

DWN. BY: HSK SCALE: 3/16" = 1'-0" JOB NO.: 22-46-09 DATE: 09/01/2023

HVAC -**BASEMENT DEMOLITION PLAN**

MD101

DWG. NO.

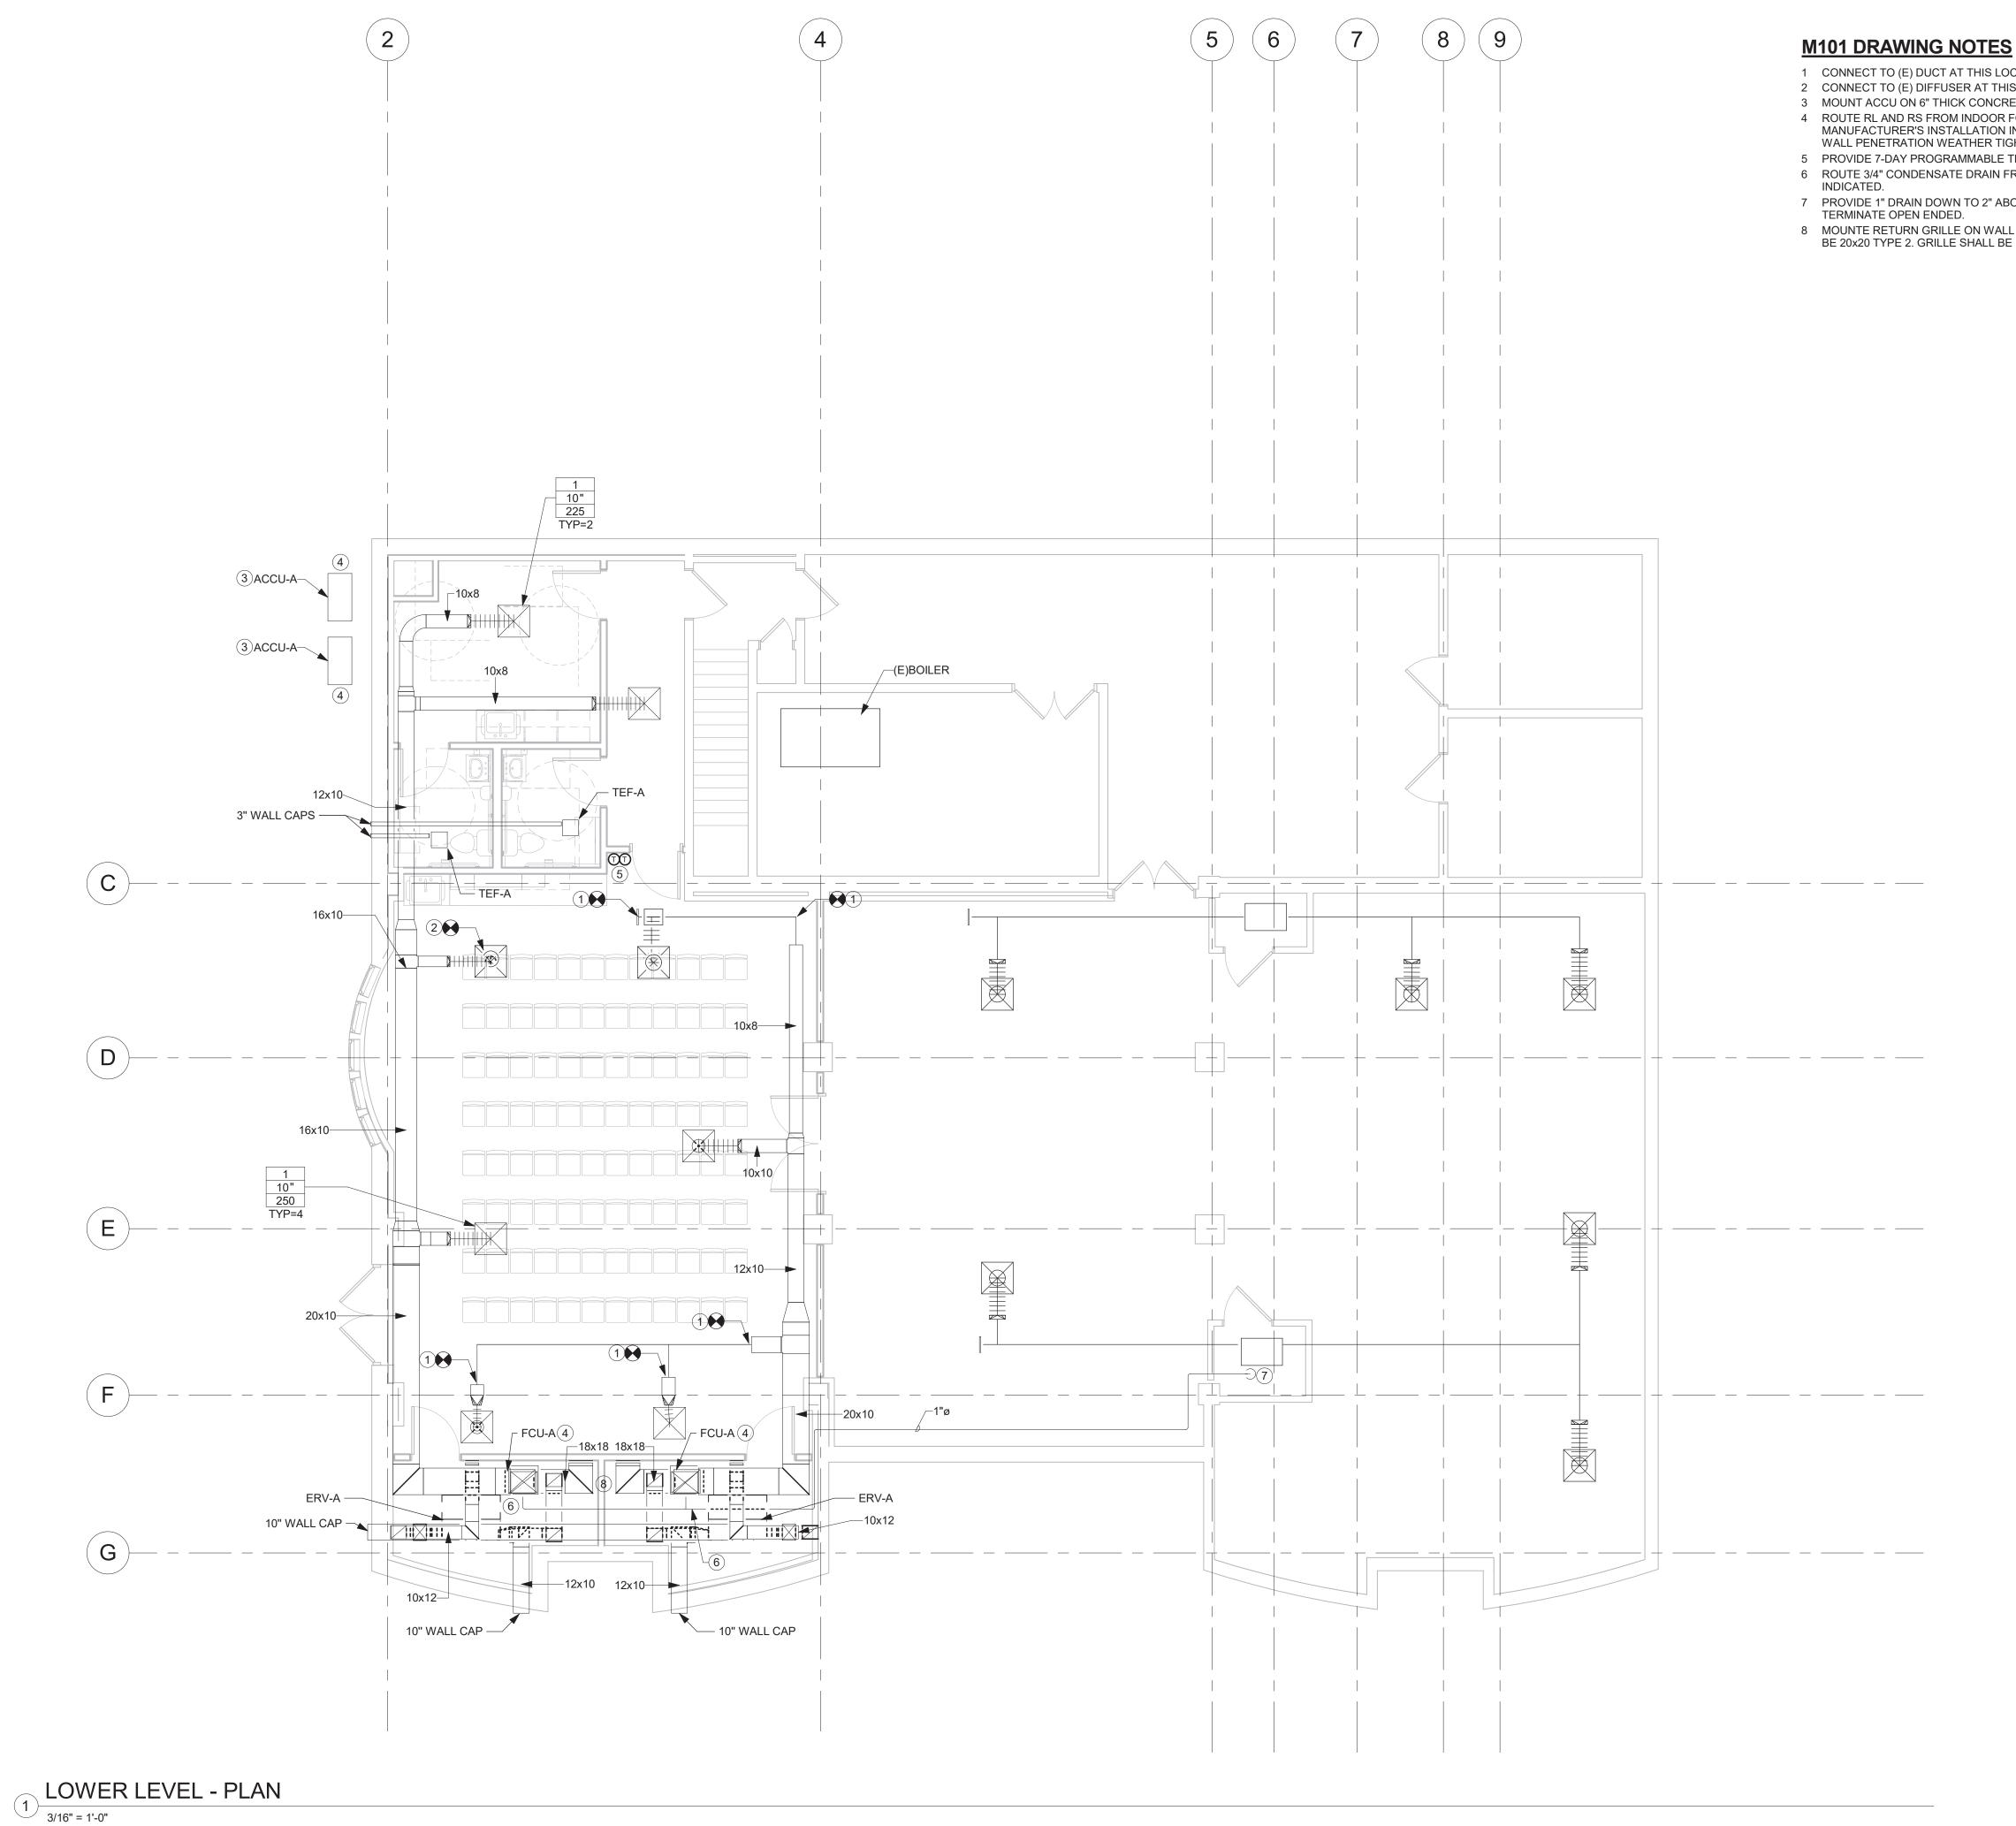

1 CONNECT TO (E) DUCT AT THIS LOCATION.

2 CONNECT TO (E) DIFFUSER AT THIS LOCATION. BALANCE TO 250 CFM.

3 MOUNT ACCU ON 6" THICK CONCRETE PAD PER DETAIL 3/M501.

4 ROUTE RL AND RS FROM INDOOR FCU TO OUTDOOR ACCU. SIZE PIPING PER MANUFACTURER'S INSTALLATION INSTRUCTIONS. ROUTE PIPING ABOVE CEILING. SEAL WALL PENETRATION WEATHER TIGHT.

5 PROVIDE 7-DAY PROGRAMMABLE THERMOSTAT AT THIS LOCATION. WIRE BACK TO FCU. 6 ROUTE 3/4" CONDENSATE DRAIN FROM FCU CONDENSATE PUMP TO LOCATION

7 PROVIDE 1" DRAIN DOWN TO 2" ABOVE FLOOR AND ROUTE TO ABOVE FLOOR DRAIN. TERMINATE OPEN ENDED.

8 MOUNTE RETURN GRILLE ON WALL 6" ABOVE FINISHED FLOOR. RETURN GRILLE SHALL BE 20x20 TYPE 2. GRILLE SHALL BE DUCTED BACK TO FCU-A INTAKE.

Issued for Bidding 9/12/2023

ISSUES AND REVISIONS

© THIS DRAWING AND THE CONTENTS
THEREOF ARE THE SOLE AND
COPYRIGHTED PROPERTY OF BUTLER
ROWLAND MAYS ARCHITECTS, LLP AND
MAY NOT BE ALTERED, COPIED OR
REPRODUCED BY ANY METHOD FOR ANY
PURPOSE WITHOUT THE EXPRESS
WRITTEN CONSENT OF BUTLER ROWLAND
MAYS ARCHITECTS, LLP.

BUTLER ROWLAND MAYS

57 West High Street Ballston Spa New York 12020

ARCHITECTS, LLP

P: 518•885•1255 F: 518•885•1266 www.brmarchitects.com

Phase 1 Interior Improvements to the **Lower Level** for the

> The Beekman Library

11 Town Center Boulevard Hopewell Junction, NY 12533

PROJECT

ME ENGINEERING

Mechanical/Electrical Engineering Consultants

Capital District | Rochester | Buffalo | Syracuse

CONSULTANT


CALLED NORTH

DWN. BY: Author SCALE: 3/16" = 1'-0" JOB NO.: 22-46-09 DATE: 09/01/2023

HVAC -**BASEMENT PLAN**


TITLE

M101

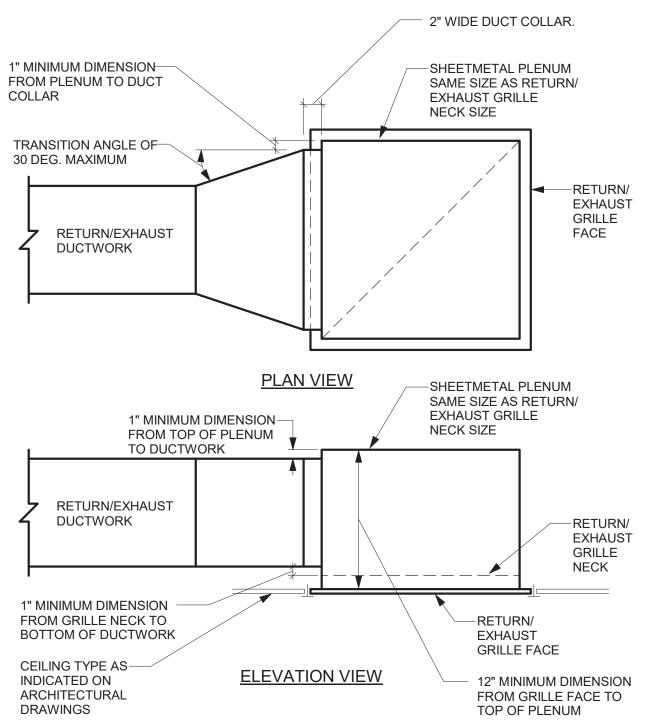

- DETAIL NOTES:
- A. PAINT INSIDE OF PLENUM BOX FLAT BLACK IF INTERNAL SOUND LINING IS NOT SPECIFIED.
- B. ALSO APPLICABLE TO REGISTERS.


RETURN/EXHAUST GRILLE PLENUM DETAIL - DUCTED

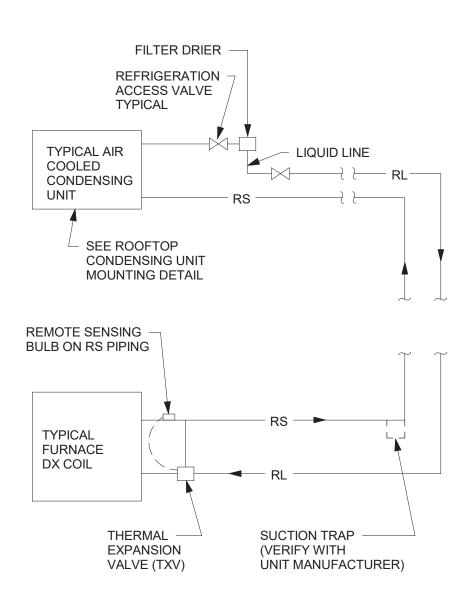

DETAIL NOTES:


- A. CONFIRM REFRIGERANT LINE LENGTHS WITH MANUFACTURER FOR EACH SYSTEM.
- B. VERIFY THE REQUIREMENT FOR A SUCTION LINE TRAP AT THE BASE OF THE REFRIGERANT SUCTION (RS) LINE WITH THE MANUFACTURER.
- C. THIS DETAIL IS INTENDED TO SHOW THE GENERAL SYSTEM COMPONENTS. THE SYSTEM SHALL BE PIPED IN ACCORDANCE WITH THE MANUFACTURERS RECOMMENDATIONS.

DX PIPING CONNECTIONS DETAIL - CONDENSING UNIT ABOVE EVAPORATOR COIL NOT TO SCALE

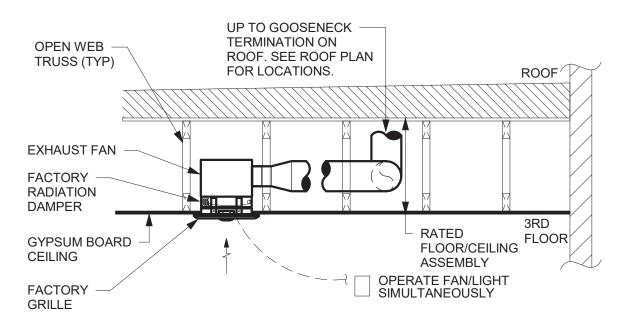

NOTE: PROVIDE SHEETMETAL DUCTWORK. NO FLEXIBLE DUCTWORK PERMITTED.


EXHAUST FAN MOUNTED IN RATED ASSEMBLY - THIRD FLOOR

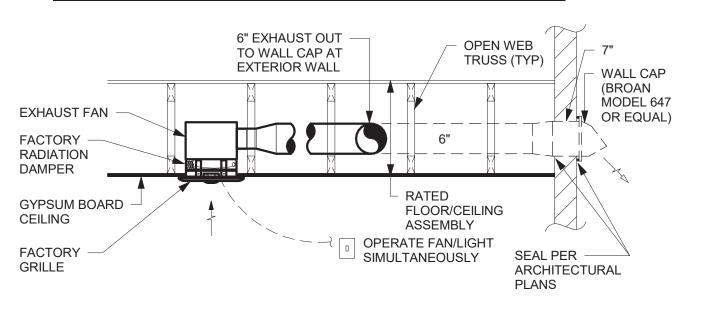

NOTE: PROVIDE SHEETMETAL DUCTWORK. NO FLEXIBLE DUCTWORK PERMITTED.

EXHAUST FAN MOUNTED IN RATED ASSEMBLY - LOWER FLOORS

2 TYPICAL EXHAUST FAN MOUNTING DETAIL NOT TO SCALF

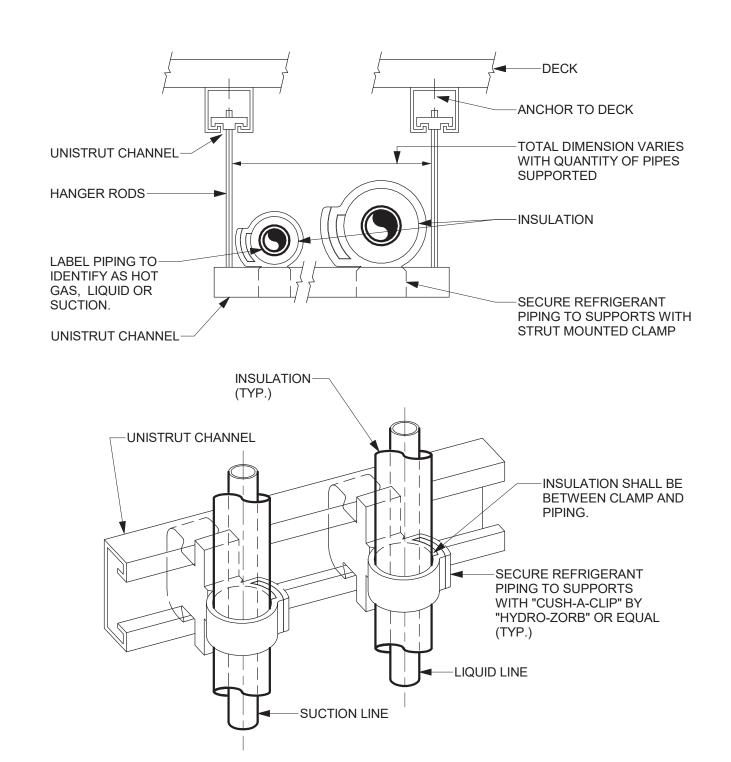


REFRIGERANT PIPE SUPPORT DETAIL

 $\stackrel{\cdot}{\smile}$ NOT TO SCALE

Issued for Bidding 9/12/2023 ISSUES AND REVISIONS

© THIS DRAWING AND THE CONTENTS
THEREOF ARE THE SOLE AND
COPYRIGHTED PROPERTY OF BUTLER
ROWLAND MAYS ARCHITECTS, LLP AND
MAY NOT BE ALTERED, COPIED OR
REPRODUCED BY ANY METHOD FOR ANY
PURPOSE WITHOUT THE EXPRESS
WRITTEN CONSENT OF BUTLER ROWLAND
MAYS ARCHITECTS, LLP.

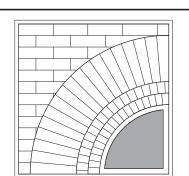

BUTLER ROWLAND MAYS ARCHITECTS, LLP

57 West High Street Ballston Spa New York 12020

P: 518•885•1255 F: 518•885•1266 www.brmarchitects.com

Phase 1 Interior Improvements to the Lower Level

> Beekman Library

for the

The

11 Town Center Boulevard Hopewell Junction, NY 12533

PROJECT



Capital District | Rochester | Buffalo | Syracuse

CONSULTANT

133 STATE STREET, 4TH FLOOR SCHENECTADY, NY 12305

CONSULTANT

STAMP Reg. Exp: 05/31/2024 Cert. of Auth: 0018443

CALLED NORTH

DWN. BY: HSK SCALE: NOT TO SCALE JOB NO.: 22-46-09 DATE: 09/01/2023

MECHANICAL DETAILS

TITLE

M501

DWG. NO.

SPLIT S	PLIT SYSTEM AIR CONDITIONING UNIT SCHEDULE - HEAT PUMP TYPE																												
UNIT NO.		LOCATION		INDOOR UNIT										OUTDOOR UNIT								HEATING (5	DEG F)	EFFICIEN	ICY	FILTER	MANUFACTURER & MODEL No.		REMARKS
INDOOR	OUTDOOR	INDOOR	OUTDOOR	UNIT	AIR	COOLING	MINIMUM	EAT (DEG	. F)	VOLTS PHA	E MCA	FAN	SOUND	REFRIGERANT	VOLTS PHASE	MCA	FAN	BREAKER	EAT (DEG	G. F)	SOUND	RATED	MAXIMUM	MINMUM	MINMUM	MERV	INDOOR UNIT	OUTDOOR UNIT	1
				TYPE	FLOW	CAPACITY	CAPACITY	DB	WB			FLA	PRESSURE				FLA	SIZE	DB	WB	PRESSURE	CAPACITY	CAPACITY	(COP)	(SEER)	RATING			
					(CFM)	(BTUH)	(BTUH)						(dBA)					(AMPS)			(dBA)	(MBTUH)	(MBTUH)	, ,					
FCU-A	ACCU-A	GRADE	ROOF	VERTICAL AHU	1040	42000	17000	80	67	208 1	5.5	4.5	44	R-410A	208 1	36	0.4		95.0	75.0	51	48	38.4	1.9	15.4	-	MITSUBISHI PVAA42AA7	MITSUBISHI PUZHA42NKA1	1, 2

REMARKS:
1. CONDENSATE PUMP.
2. PROVIDE 7 DAY PROGRAMMABLE THERMOSTAT.

PA	ACKAGED ENERGY RECOVERY VENTILATION UNIT SCHEDULE - STATIC PLATE CORE HEAT EXCHANGER																							
UN	IT NO.	LOCATION	SERVICE	MODE	SUPP	LY FAN EXHAUST FAN ELECTRICAL CHARACTERISTICS TOTAL PERFORMANCE CONDITIONS						FILTER		REMARKS										
ı					AIR	E.S.P.	AIR	E.S.P.	VOLTS	PHASE	MCA	MOP	EFF.	O.A.	O.A. R.A. S.A.		S.A. E.A.		.A.	MERV	MANUFACTURER & MODEL No.			
ı					FLOW	(In. WC)	FLOW	(In. WC)					(%)	DB	WB	DB	WB	DB	WB	DB	WB	RATING		
					(CFM)	`	(CFM)																	
	55//4	\/ADIOLIC	MULTIPLIPROCE	SUMMER	85	0.75	75 85	0.75	120	1	10.1	15	54.4	91.4	73.8	75.0	62.5 79.5	68			0/0	DENEWALDE EV DDENHUNA O	4	
	RV-A	VARIOUS	MULTIPURPOSE	WINTER	85	0.75	85	0.75	120	1	10.1	15	71.3	1.7	0.4	70.0	51.4	51.4	40.2			8/8	RENEWAIRE EV PREMIUM S	1

REMARKS:
1. INTERLOCK WITH FCU-A OPERATION.

FAN SCH	AN SCHEDULE UNIT NO. LOCATION SERVICE FAN CHARACTERISTICS MOTOR CHARACTERISTICS MANUFACTURER & MODEL NO. REMARKS																
UNIT NO.	NIT NO. LOCATION SERVICE FAN CHARAC				ICS					MANUFACTURER & MODEL NO.	REMARKS						
			TYPE	BLADE	CFM	S.P.	FAN	SONES	DRIVE	WATTS	HP	VOLTS	HZ	PHASE	STARTER		
				TYPE		(In. WC)	RPM										
TEF-A	VARIOUS	EXHAUST	CLG	FC	80	0.1		0.3	DIRECT	(7.0)		120	60	1	INCLUDED	PANASONIC WHISPERGREEN SELECT FV-05-11VKSL1	2,3,4,5,6,7

REMARKS:

TWO SPEED, CONTINUOUS OPERATION. SET LOW SPEED FOR 35 CFM.
 TWO SPEED, CONTINUOUS OPERATION. SET LOW SPEED FOR 25 CFM.

3. DC BRUSHLESS MOTOR

4. BACKDRAFT DAMPER


5. PROVIDE WITH FACTORY LED LIGHT KIT 6. PROVIDE WITH A MOTION SENSOR

7. PROVIDE WITH FACTORY RADIATION DAMPERS

KEGIS I	ER GRILLE AND	DIFFUSER S	CHEDULE		
TYPE	APPLICATION	MATERIAL	FINISH	MANUFACTURER & MODEL NO.	REMARKS
1	SUPPLY	STEEL	WHITE	TITUS MODEL OMNI	
2	SUPPLY	STEEL	WHITE	TITUS MODEL 272-RL/RS	
3	SUPPLY	STEEL	WHITE	CONTINENTAL 32	
Α	RETURN/EXHAUST	STEEL	WHITE	TITUS MODEL 350/355-RL/RS	
В	RETURN/EXHAUST	ALUMINUM	ANODIZED	CONTINENTAL G35	
С	TRANSFER	ALUMINUM	ANODIZED	LIMA MODEL 700	

Issued for Bidding 9/12/2023 **ISSUES AND REVISIONS**

© THIS DRAWING AND THE CONTENTS
THEREOF ARE THE SOLE AND
COPYRIGHTED PROPERTY OF BUTLER
ROWLAND MAYS ARCHITECTS, LLP AND
MAY NOT BE ALTERED, COPIED OR
REPRODUCED BY ANY METHOD FOR ANY
PURPOSE WITHOUT THE EXPRESS
WRITTEN CONSENT OF BUTLER ROWLAND
MAYS ARCHITECTS, LLP.

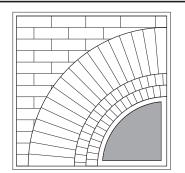

BUTLER ROWLAND MAYS ARCHITECTS, LLP

57 West High Street Ballston Spa New York 12020

P: 518•885•1255 F: 518•885•1266 www.brmarchitects.com

Phase 1 Interior Improvements to the Lower Level for the


> The Beekman Library

11 Town Center Boulevard Hopewell Junction, NY 12533

PROJECT



CONSULTANT

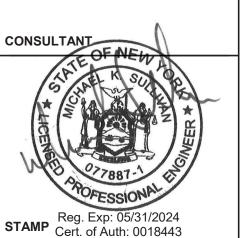

CALLED NORTH

DWN. BY: HSK SCALE: JOB NO.: 22-46-09 DATE: 09/01/2023

HVAC SCHEDUELS

M601