

MAP NOTES:

13


- 1. Topographic information shown hereon was compiled from an actual field survey conducted during the month of December, 2021, by CT Male Associates, PC of Latham, NY.
- 2. Vertical datum shown hereon is NAVD 88 (Geoid 12A) and was obtained from RTK GPS observations.
- 3. North orientation is referenced to Grid North and are based on the New York State Plane Coordinate System, East Zone,
- NAD 83/2011 epoch 2010.00. 4. Underground facilities, structures, and utilities have been plotted from data obtained from previous maps and record drawings. Surface features such as catch basin rims, manhole covers, water valves, gas valves, etc. are the result of

field survey unless noted otherwise. There may be other underground utilities, the existence of which is not known to the undersigned. Size and location of all underground utilities and structures must be verified by the appropriate authorities. Dig Safely New York must be notified prior to conducting test borings, excavation and construction.

☐ CB Catch Basin o co Cleanout **ОТМН** Telephone Manhole ☐ TPED Telephone Pedestal Оимн Unknown Manhole Type Finished Floor Elevation High Density Polyethylene Pipe Polyvinyl Chloride Pipe —— ST — Storm Sewer Line Top of Curb Elevation Bottom of Curb Elevation N.H.O.A. Nut Head of Arrow

LEGEND

S.E.D. Control No. 13-02-00-01-0-004-023 Rev. No.: Date: Description:

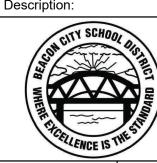

complex world CLEAR SOLUTIONS

Tetra Tech Engineers, Architects & Landscape Architects, P.C.




- Beacon City School District Beacon, New York
- Reconstruction to: Rombout Middle School

Topographic Survey of Portions of Lands of Rombout Middle School

Date: Drawing No.: Drawn by: JMR 10/28/2022

EV001 Project No.: 279180-22004

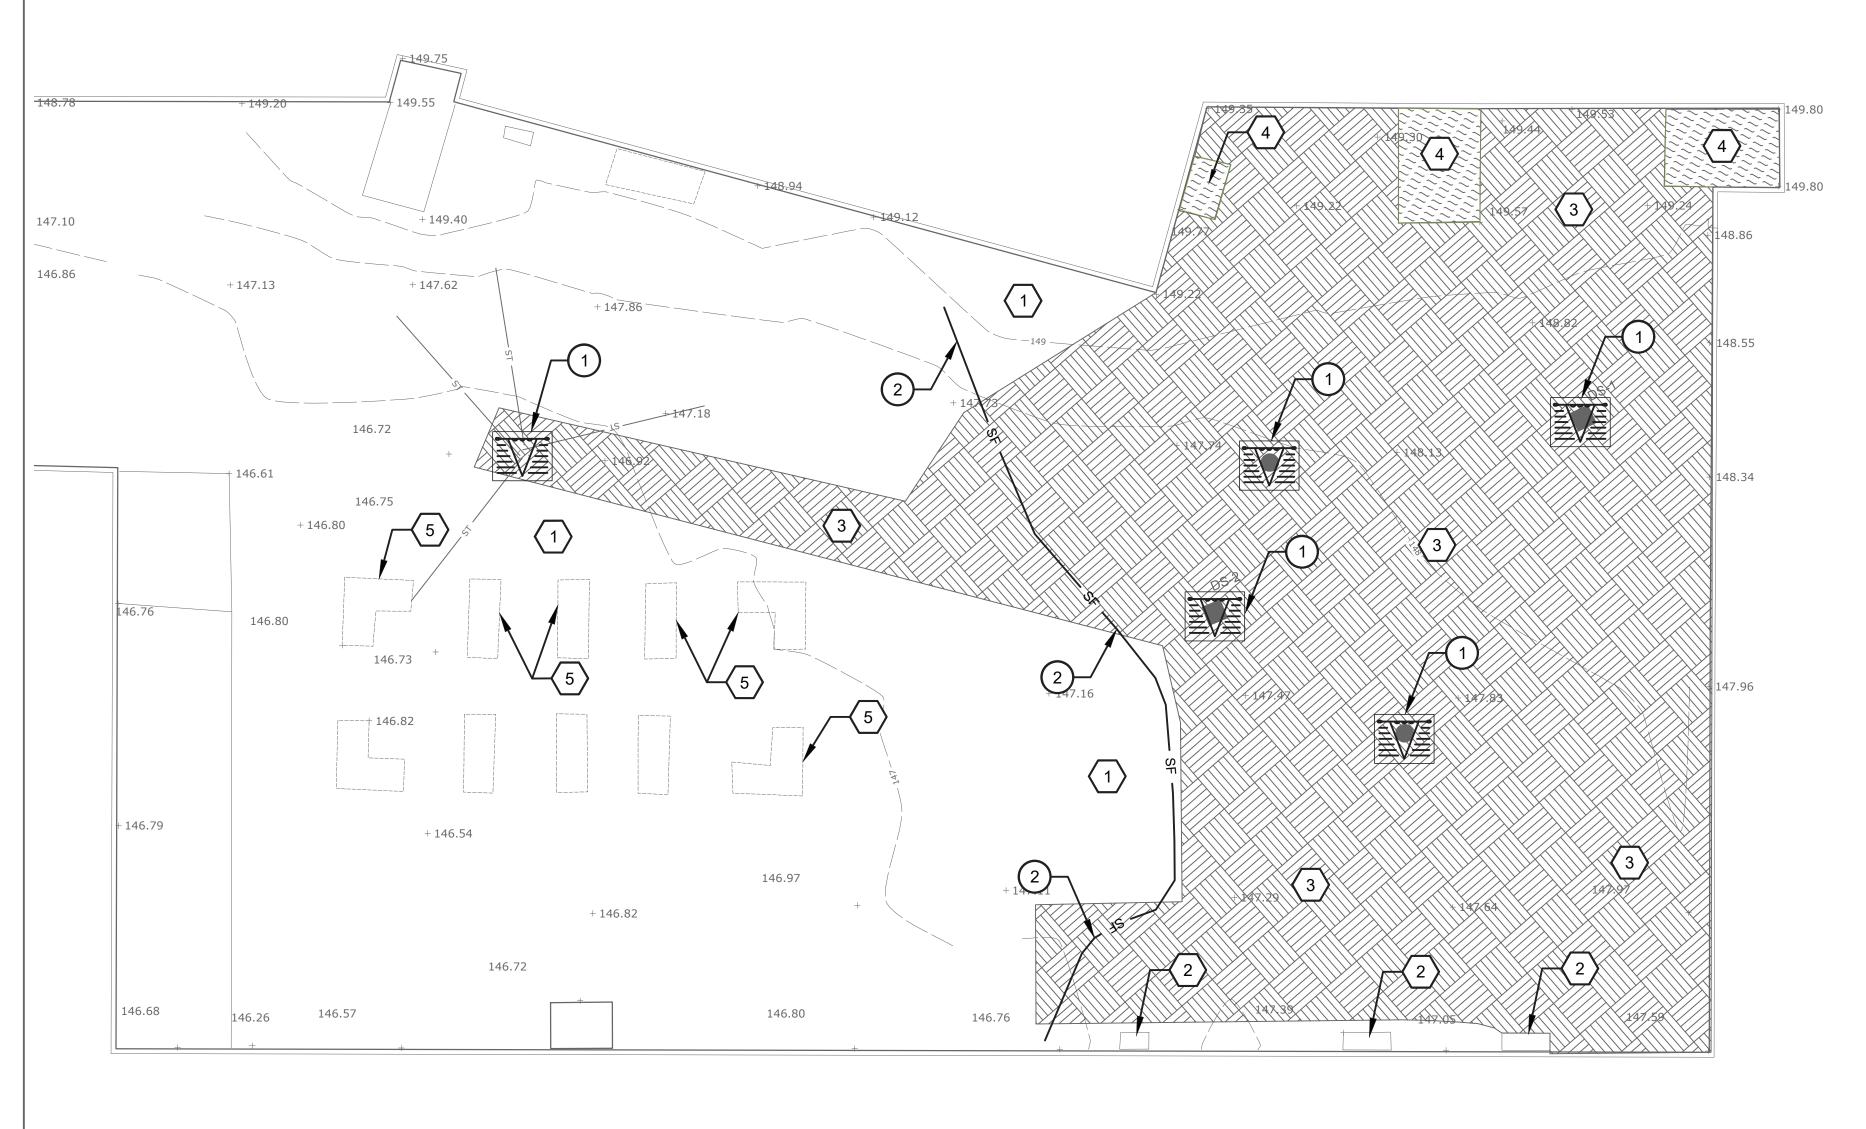

Site Erosion and Sediment Control Notes

- 1. ALL SOIL EROSION AND SEDIMENT CONTROL PRACTICES WILL BE INSTALLED IN ACCORDANCE WITH THE STANDARDS SPECIFIED IN THE NEW YORK STATE STANDARDS AND SPECIFICATIONS FOR EROSION AND SEDIMENT CONTROL (BLUE BOOK), LATEST EDITION, AND WILL BE INSTALLED IN PROPER SEQUENCE AND MAINTAINED UNTIL PERMANENT PROTECTION IS ESTABLISHED.
- 2. ANY DISTURBED AREA THAT WILL BE LEFT EXPOSED FOR MORE THAN THIRTY DAYS AND NOT SUBJECT TO CONSTRUCTION TRAFFIC SHALL IMMEDIATELY RECEIVE A TEMPORARY SEEDING. IF THE SEASON PROHIBITS TEMP. SEEDING, THE DISTURBED AREA WILL BE MULCHED WITH SALT HAY OR EQUIVALENT AND BOUND IN ACCORDANCE WITH NYS DEC STANDARDS.
- 3. IMMEDIATELY FOLLOWING INITIAL DISTURBANCE OR ROUGH GRADING, ALL CRITICAL AREAS SUBJECT TO EROSION WILL RECEIVE A TEMPORARY SEEDING IN COMBINATION WITH STRAW MULCH OR A SUITABLE EQUIVALENT ACCORDING TO THE NY STANDARDS

4. STABILIZATION SPECIFICATIONS:

- A. SOIL AMENDMENTS:
- <u>LIME</u> PROVIDE GROUND LIMESTONE TO PH OF 6.0.
- FERTILIZER 14 LBS/1,000 S.F., 5-10-10 OR EQUIVALENT WORKED INTO SOIL A
- B. TEMPORARY SEEDING AND MULCHING:
- SEED ANNUAL RYEGRASS 30 LBS/ACRE; PLANT BETWEEN MARCH 1 AND MAY 15 OR BETWEEN AUGUST 15 AND OCTOBER 1. USE WINTER RYE IF SEEDING IN OCT./NOV.
- MULCH SALT HAY OR SMALL GRAIN STRAW AT A RATE OF 90 LBS/1,000 S.F., TO BE APPLIED ACCORDING TO THE NY STANDARDS. MULCH SHALL BE SECURED BY WOOD FIBER MULCH (HYDROMULCH) AT 11-17 LBS./1,000 S.F. WOOD FIBER MULCH MUST BE APPLIED THROUGH A HYDROSEEDER IMMEDIATELY AFTER MULCHING.
- C. PERMANENT SEEDING AND MULCHING:
- SEED REFER TO PROJECT MANUAL SPECIFICATIONS FOR SEED TYPE, RATE OF SEEDING AND SEASON OF SEEDING. RATE AND SEED TYPE ARE TO MEET THE MINIMUM REQUIREMENTS OF THE NY STANDARDS.
- MULCH REFER TO PROJECT MANUAL SPECIFICATIONS FOR MULCH TYPE, RATE OF APPLICATION, ETC. RATE AND MULCH TYPE ARE TO MEET THE MINIMUM REQUIREMENTS OF THE NY STANDARDS.
- STORMWATER RUN-OFF IS DIVERTED TO SOIL EROSION AND SEDIMENT CONTROL FACILITIES.
- 6. ALL SEDIMENTATION STRUCTURES WILL BE INSPECTED AND MAINTAINED ON A REGULAR BASIS.

5. THE SITE SHALL AT ALL TIMES BE GRADED AND MAINTAINED SUCH THAT ALL

- 7. ALL CATCH BASIN INLETS WILL BE PROTECTED WITH A FABRIC FILTER CRUSHED STONE OR FABRIC FILTER (FILTER DETAILS APPEAR ON THE PLAN).
- 8. ALL STORM DRAINAGE OUTLETS WILL BE STABILIZED, AS REQUIRED, BEFORE THE DISCHARGE POINTS BECOME OPERATIONAL.
- 9. ALL DEWATERING OPERATIONS MUST DISCHARGE DIRECTLY INTO A SEDIMENT TRAP OR APPROVED AFTERMARKET PRODUCT IN ACCORDANCE WITH SECTION 5A OF THE NY STANDARDS.

Site Preparation/Demolition General Notes

- 1. THESE GENERAL SITE / PREPARATION / DEMOLITION NOTES REFER TO EC-SERIES
- 2. THE INTENT OF THIS DRAWING IS TO INDICATE PREPARATORY WORK, REMOVALS AND DEMOLITION NECESSARY TO CONSTRUCT THE PROJECT AS SHOWN ON THE REST OF THE CONTRACT DRAWINGS. SOME NOTES ARE GENERAL IN NATURE AND IT SHALL BE UNDERSTOOD THAT IT IS NOT FEASIBLE TO INDICATE EACH AND EVERY SPECIFIC REMOVAL. SITE PREPARATION / DEMOLITION DRAWINGS SHALL NOT BE USED ALONE, BUT SHALL BE USED IN CONJUNCTION WITH THE OTHER DRAWINGS FOR WORK TO BE REMOVED, REUSED, AND / OR REVISED NOT INDICATED HERE.
- 3. CONTRACTOR TO MAINTAIN UTILITY SERVICES TO BUILDINGS TO REMAIN. IF UTILITY SERVICES MUST BE INTERRUPTED THE CONTRACTOR SHALL COORDINATE THAT SHUTDOWN TO MINIMIZE IMPACT TO BUILDINGS. SEE PROJECT MANUAL REGARDING COORDINATION OF DEMOLITION WORK WITH UTILITY COMPANIES.
- 4. THE CONTRACTOR IS RESPONSIBLE TO MAINTAIN SAFE SITE ACCESS TO PEDESTRIAN, VEHICULAR TRAFFIC, EMERGENCY AND HEALTH SAFETY AGENCIES. IF ACCESS WILL BE COMPROMISED IT WILL BE THE RESPONSIBILITY OF THE CONTRACTOR TO COORDINATE AT LEAST ONE WEEK IN ADVANCE WITH THE OWNER'S REPRESENTATIVE AND HEALTH SAFETY AGENCIES, UNLESS OTHERWISE NOTED IN PROJECT MANUAL.
- 5. UTILITIES, SIDEWALKS, PAVEMENT, SLABS, FOUNDATIONS, AND MISCELLANEOUS FEATURES NOTED TO BE DEMOLISHED SHALL BE SPOILED OFF-SITE IN A LEGAL MANNER UNLESS OTHERWISE DIRECTED BY THE OWNER'S REPRESENTATIVE. NO BURNING OF DEBRIS SHALL BE ALLOWED. IMMEDIATELY BACKFILL VOIDS WITH COMPACTED GRANULAR MATERIAL AS SPECIFIED.
- WHEN A SITE FEATURE IS INDICATED TO BE REMOVED, THE SITE FEATURE, INCLUDING APPURTENANCES AND FOOTINGS, SHALL BE DISPOSED OF LEGALLY OFF SITE, UNLESS OTHERWISE INDICATED. IMMEDIATELY BACKFILL VOIDS WITH COMPACTED GRANULAR MATERIALS AS SPECIFIED.
- WHEN A SITE FEATURE IS INDICATED TO REMAIN, IT SHALL BE PROTECTED AS INDICATED AND / OR SPECIFIED. WHEN DISTURBANCE OCCURS AROUND AN EXISTING FEATURE, THE CONTRACTOR SHALL USE ADDITIONAL PRECAUTIONS INCLUDING, BUT NOT LIMITED TO HAND DIGGING TO PROTECT THE FEATURE.
- EXISTING ON-SITE UTILITIES SHALL REMAIN UNLESS DESIGNATED FOR REMOVAL. PROTECT ALL EXISTING UTILITIES TO REMAIN.
- MANHOLES, CATCH BASINS, CLEAN OUTS, VALVE BOXES, FRAMES, COVERS AND GRATES REMAINING IN USE SHALL BE PROTECTED AND ADJUSTED TO FINAL GRADES. CONTRACTOR SHALL MAINTAIN POSITIVE DRAINAGE AT ALL TIMES.
- 10. CONTRACTOR IS RESPONSIBLE TO VERIFY GRADES AND UTILITIES SHOWN ON EXISTING CONDITIONS PLAN PRIOR TO START OF WORK. DISCREPANCIES ARE TO BE DOCUMENTED AND SUBMITTED TO THE OWNER'S REPRESENTATIVE AT THE TIME OF DISCOVERY.
- 11. CONTRACTOR SHALL BE RESPONSIBLE FOR RELOCATIONS, INCLUDING, BUT NOT LIMITED TO, UTILITIES, STORM DRAINAGE, SIGNS, ETC. AS INDICATED ON DESIGN DOCUMENTS.
- 12. IF EXISTING SITE FEATURES TO REMAIN ARE DAMAGED DURING CONSTRUCTION BY CONTRACTOR, SITE FEATURES SHALL BE REPAIRED IN-KIND, TYPICAL.
- 13. CONTRACTOR TO REMOVE OR RELOCATE, WHEN APPLICABLE, ALL CONNECTING IMPROVEMENTS, DRAIN PIPES, SANITARY SEWER PIPES, POWER POLES, AND GUY WIRES, WATER METERS AND WATER LINES, WELLS, SIDEWALKS, SIGN POLES, UNDERGROUND GAS, SEPTIC TANKS, AND ASPHALT, SHOWN AND NOT SHOWN. WITHIN CONSTRUCTION LIMITS AND WHERE NEEDED, TO ALLOW FOR NEW CONSTRUCTION AS SHOWN.
- 14. CONTRACTOR TO NOTIFY OWNERS REPRESENTATIVE IF UNIDENTIFIED UTILITIES ARE ENCOUNTERED INCLUDING, BUT NOT LIMITED TO, STORM SEWER, SANITARY SEWER, TELECOMMUNICATIONS SERVICE, ELECTRICAL SERVICE, GAS SERVICE, WATER SERVICE, IRRIGATION LINES. UTILITIES LINES TO REMAIN UNDISTURBED UNTIL DIRECTED BY OWNERS REPRESENTATIVE.
- 15. CONTRACTOR SHALL REQUEST UFPO PRIOR TO START OF ANY WORK. "DIG SAFELY NEW YORK - CALL 811 - BEFORE YOU DIG".

Site Demolition & SESC Plan

Site Preparation/Demolition Key Notes

1 EXISTING LAWN AREA TO REMAIN - REPAIR AS REQUIRED

2 EXISTING CONCRETE PAD TO REMAIN. PROTECT.

3 STRIP, SCREEN, AND STOCKPILE TOPSOIL. STOCKPILE LOCATION TO BE APPROVED BY OWNER'S REPRESENTATIVE. REMOVE SUBGRADE AS REQUIRED TO MEET DESIGN GRADES AND ACCOMMODATE NEW WORK. HAND DIG IN VICINITY OF EXISTING BURIED UTILITIES TO AVOID DAMAGE (TYPICAL).

SCALE: 1" = 10'

- 4 REMOVE EXISTING CONCRETE SLAB AND SUBBASE NECESSARY TO ALLOW INSTALLATION OF PROPOSED IMPROVEMENTS (TYPICAL).
- 5 EXISTING RAISED PLANTING BEDS TO REMAIN, PROTECT.

Soil Erosion and Sediment Contol Key Notes

- 1 PROVIDE DROP-IN INLET PROTECTION, TYPICAL. SEE DETAIL 1 / EC500.
- 2 PROVIDE SILT FENCE, TYPICAL. SEE DETAIL 15 / EC500.

Site Erosion & Sediment Control Sequence

- 1. INSTALL TEMPORARY STORM SEWER INLET PROTECTION AT ALL EXISTING DRAINAGE INLETS THAT WILL BE RECEIVING STORM DRAINAGE FROM CONSTRUCTION ACTIVITIES.
- 2. PREPARE CONTRACTOR ACCESS DRIVES, PARKING AND STAGING AREAS WITH TYPE 2 FILL OR OTHER SURFACING THAT WILL PREVENT EROSION OF THESE AREAS. STRIP TOPSOIL AND STOCKPILE IN LOCATION SHOWN.
- 3. SURROUND ALL STOCKPILES WITH SILT FENCE OR HAY BALE BARRIER. THROUGHOUT GRADING OPERATIONS,
- 4. PROVIDE TEMPORARY AND PERMANENT SEEDING PER SOIL EROSION AND SEDIMENT CONTROL NOTES NOS. 2 & 3.
- 5. DURING EXCAVATION FOR FOOTINGS, TRENCHES, ETC., WHEN DEWATERING IS REQUIRED, PROVIDE MEANS TO REMOVE SEDIMENT IN ACCORDANCE WITH SOIL EROSION AND SEDIMENT CONTROL NOTE #9 THIS DRAWING.
- 6. AS STORM STRUCTURES ARE BEING INSTALLED, PROVIDE TEMPORARY STORM SEWER INLET PROTECTION PER DETAIL AT ALL GRATED STORM SEWER INLETS PRIOR TO CONNECTING BASINS TO NEW STORM PIPING. MAINTAIN EROSION CONTROL DEVICES IN FULLY FUNCTIONAL CONDITION THROUGHOUT CONTRACT PERIOD.
- 7. PROVIDE ADDITIONAL EROSION CONTROL MEASURES AS REQUIRED TO MEET NEW YORK STANDARDS OR AS REQUIRED BY SOIL CONSERVATION DISTRICT.
- 8. UPON OWNER APPROVAL, REMOVE TEMPORARY SOIL & EROSION CONTROL MEASURES AFTER PERMANENT MEASURES ARE IN PLACE AND FUNCTIONING EFFECTIVELY.

SOIL EROSION AND SEDIMENT CONTROL LEGEND SYMBOL DESCRIPTION DROP-IN INLET PROTECTION SILT FENCE

General Site Notes

THE CONTRACTOR.

- THESE GENERAL SITE NOTES APPLY TO EC-SERIES DRAWINGS.
- REFER TO SURVEY FOR INFORMATION ON EXISTING FEATURES. I EXISTING FEATURES ARE MISSING, MODIFIED, OBSCURED, OR THERE IS A CONFLICT BETWEEN HOW AN EXISTING FEATURE IS PORTRAYED ON THIS SHEET AND THE SURVEY, THE SURVEY SHALL GOVERN.
- THE SURVEY(S) INCLUDED IN THESE DOCUMENTS ARE PROVIDED FOR INFORMATION ONLY AND ARE THE BASE INFORMATION USED TO PREPARE THE WORK INDICATED ON THESE DRAWINGS. THE DATA INDICATED REGARDING EXISTING CONDITIONS IS NOT INTENDED AS REPRESENTATIONS OR WARRANTIES OF THEIR ACCURACY, BY INCLUSION OF THE SURVEY(S) IN THIS SET OF DOCUMENTS, TETRA TECH AND THE OWNER DO NOT ASSUME RESPONSIBILITY FOR ACCURACY OF THE SURVEY, NOR FOR INTERPRETATIONS OR CONCLUSIONS DRAWN THEREFROM BY
- THE CONTRACTOR SHALL FIELD VERIFY EXISTING FEATURES, CONDITIONS, UTILITIES, PROPERTY LINES AND TOPOGRAPHY PRIOR TO COMMENCEMENT OF WORK. ANY DISCREPANCIES WHICH WILL AFFECT THE WORK REQUIRED AS PART OF THE CONTRACT DOCUMENTS SHALL BE IMMEDIATELY REPORTED IN WRITING TO THE ARCHITECT. COMMENCEMENT OF WORK WITHOUT THIS WRITTEN NOTIFICATION SHALL CONSTITUTE CONTRACTOR ACCEPTANCE OF THE EXISTING INFORMATION
- INDICATED ON THE DRAWINGS AS ACCURATE. NO ADJUSTMENTS TO THE CONTRACT WILL BE MADE FOR THE DISCREPANCIES BROUGHT TO THE OWNER'S ATTENTION AFTER WORK HAS BEGUN NO ATTEMPT HAS BEEN MADE TO SHOW ALL UNDERGROUND

UTILITIES ON THIS DRAWING. CONTACT UNDERGROUND UTILITY

LOCATION ORGANIZATION AND LOCAL UTILITY COMPANIES TO

VERIFY THE LOCATION OF UTILITIES PRIOR TO EARTHWORK, TRENCHING OR EXCAVATION OPERATIONS. CONTRACTOR SHALL PROVIDE CONSTRUCTION / PROTECTIVE FENCING OR OTHER MEANS NECESSARY TO PROTECT WORK AND

TO ENSURE SAFETY OF THE PUBLIC, PEDESTRIANS AND

VEHICULAR TRAFFIC DURING CONSTRUCTION. FOR INFORMATION REGARDING SUBSURFACE CONDITIONS AND TEST LOCATIONS, COORDINATE WITH OWNER REGARDING THE AVAILABILITY OF GEOTECHNICAL INFORMATION.

Site Phasing Notes


- INSTALL SOIL EROSION AND SEDIMENT CONTROL MEASURES BEFORE SOIL DISTURBANCE AND INSTALLATION OF OTHER TEMPORARY CONSTRUCTION FEATURES.
- CONTRACTOR PARKING IS RESTRICTED TO STAGING OR DESIGNATED TEMPORARY PARKING AREAS.
- AT STAGING AND OTHER TEMPORARY AREAS TO BE RESTORED TO LAWN: THOROUGHLY REMOVE GRAVEL. STONES, DEBRIS, VEGETATION, ETC. FROM EXISTING TOPSOIL AND SCARIFY TO A MINIMUM DEPTH OF 6". AMEND TOPSOIL WITH COMPOST AND NUTRITIONAL AMENDMENTS AND FINE GRADE, FERTILIZE AND SEED OR SOD.
- AT STAGING AND OTHER TEMPORARY AREAS ON EXISTING PAVING: CONTRACTOR TO REMOVE AND REPLACE EXISTING PAVING IN ACCORDANCE WITH DRAWINGS AND SPECIFICATIONS.
- LAWN THAT IS DAMAGED DUE TO CONSTRUCTION ACTIVITIES IS TO BE REMOVED AND THE AREA SCARIFIED. PROVIDE NEW TOPSOIL AS REQUIRED TO BRING THE AREA TO MATCH SURROUNDING GRADE. FERTILIZE AND SEED OR

SITE DEMOLITION AND DREDARATION I EGEND

PINEPARATION LEGEND					
	REMOVE EXISTING CONCRETE PAVEMENT SECTION AND SUBBASE AS REQUIRED				
	REMOVE EXISTING LAWN AND SOIL AS REQUIRED				

S.E.D. Control No. 13-02-00-01-0-004-023

Rev. No.: Date: Description:

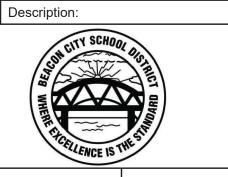

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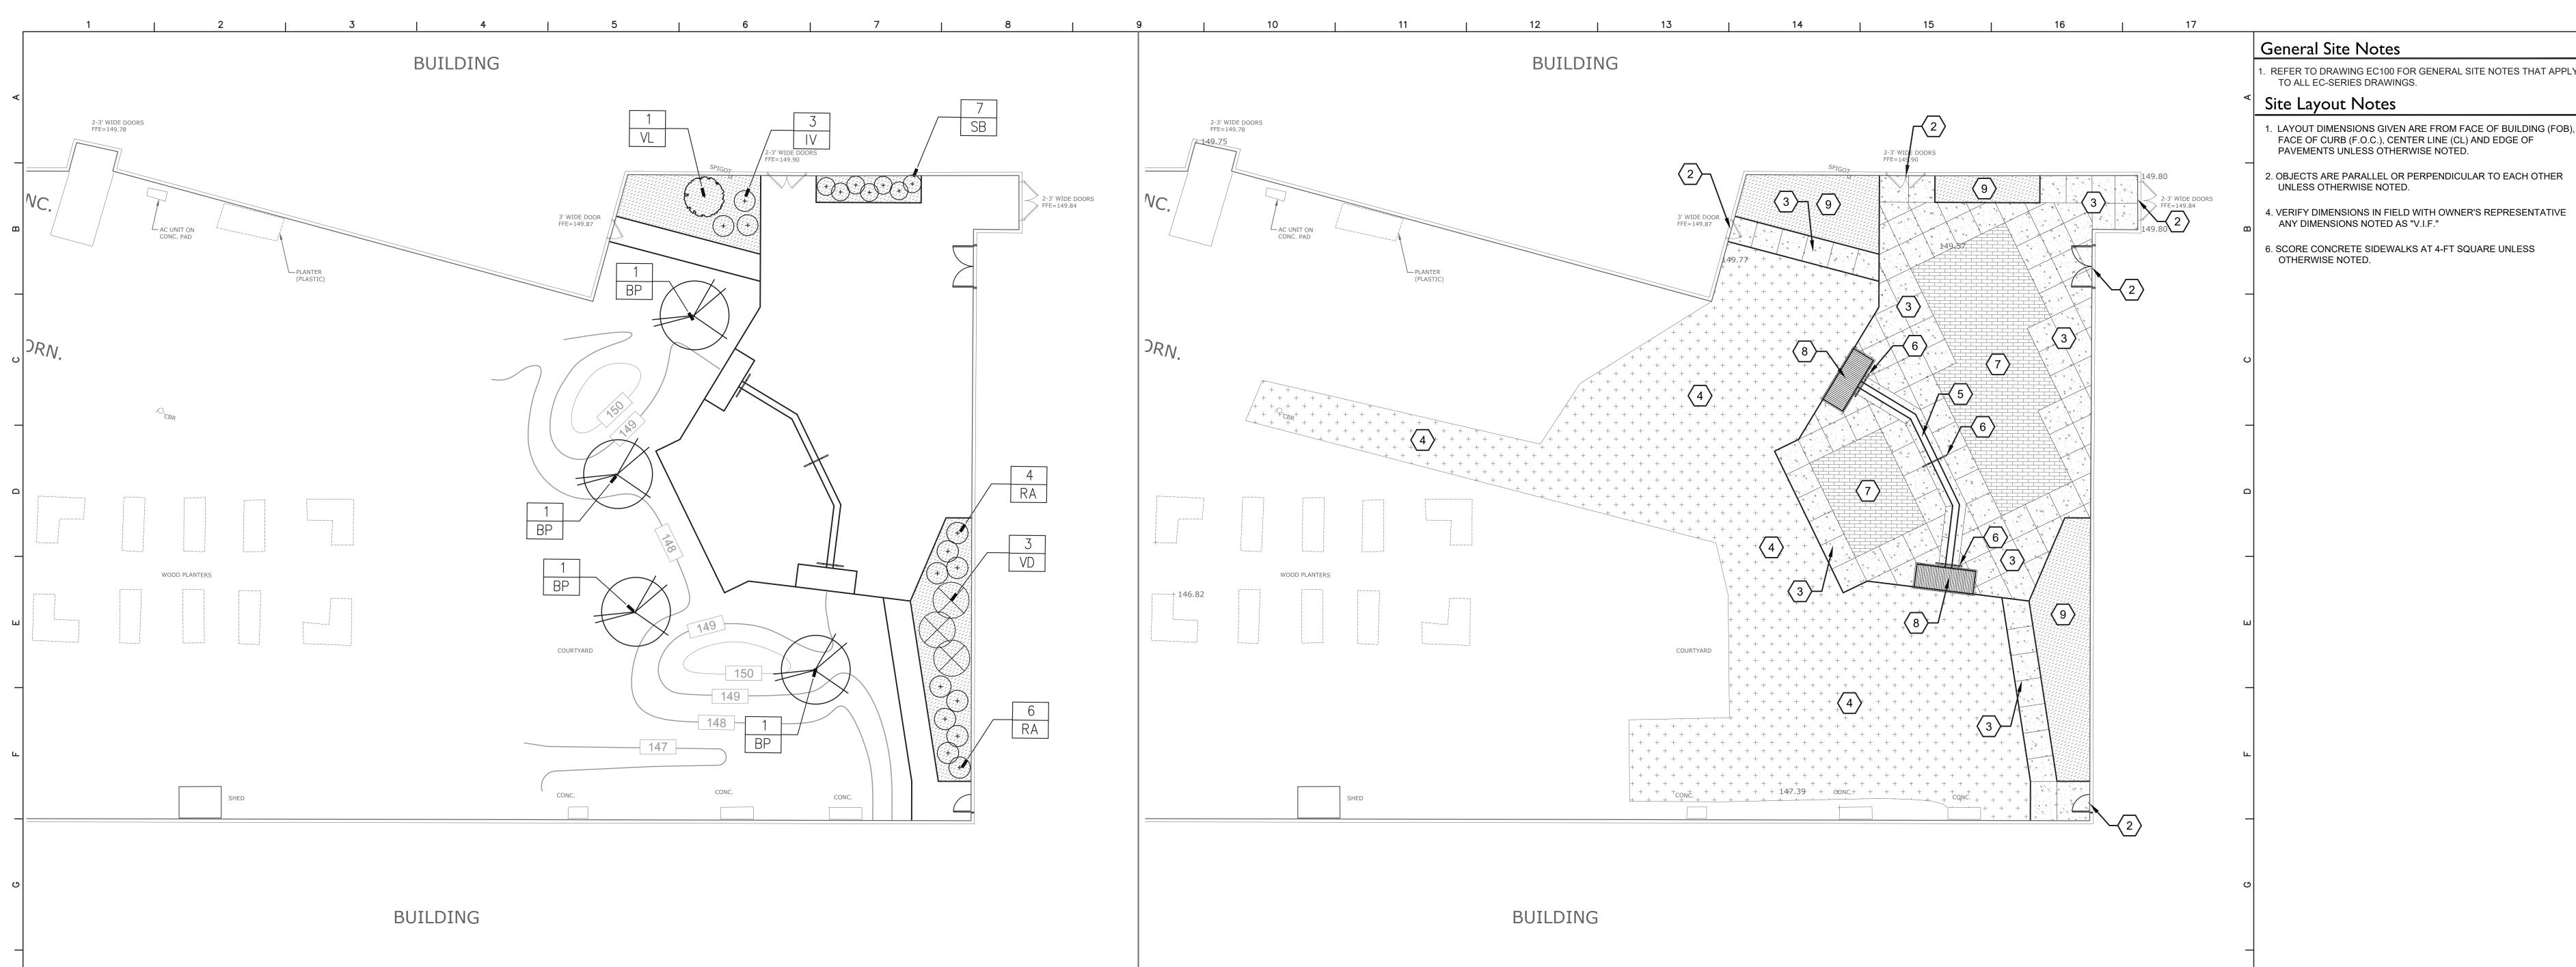
Beacon City School District Beacon, New York

Reconstruction to: Rombout Middle School

Site Demolition and Soil Erosion and Sediment Control Plan

Date: Drawing No.: Drawn by: JMR 10/28/2022 Project No.:

EC100 279180-22004



Lawn Preparation and Lawn Planting Notes

- 1. AVOID RUNNING HEAVY CONSTRUCTION EQUIPMENT IN PROPOSED PLANTING
- 2. TOPSOIL MOVED DURING THE COURSE OF CONSTRUCTION SHALL BE RETAINED AND DISTRIBUTED WITHIN THE SITE IN ACCORDANCE WITH THE PLANTING PLAN. STOCKPILED TOPSOIL/LOAM SHALL NOT BE MIXED WITH SUBSOIL OR OTHER UNSUITABLE MATERIALS.
- 3. LAWN PREPARATION IN NEWLY GRADED AREAS: REMOVE DEBRIS AND INORGANIC MATERIALS ON THE PREPARED SUBGRADE. SCARIFY SUBGRADE TO A MINIMUM OF 6". CORRECT ANY EROSION PRIOR TO SPREADING LOAM. SPREAD PLANTING SOIL TO A MINIMUM DEPTH OF 6" AND FINE GRADE TO PRODUCE A SMOOTH AND UNBROKEN FINISH SURFACE AT THE PROPOSED GRADES.
- 4. DISTURBED EXISTING LAWN AREAS: LAWN AREAS DISTURBED BUT NOT REMOVED DURING CONSTRUCTION ARE TO BE YORK RAKED TO REMOVE STONES, CORE AERATED TO A MINIMUM DEPTH OF 4", TOPDRESSED AND OVERSEEDED WITH APPROVED SEED BLEND. CUT A NEAT LINE BETWEEN NEWLY GRADED AREAS AND EXISTING LAWN. LAWN TO BE RESTORED TO ORIGINAL OR BETTER CONDITION BEFORE COMPLETION OF THE PROJECT.
- 5. TOPSOIL IMPORTED AND FROM ON SITE, SHALL MEET THE REQUIREMENTS OF THE TURFS AND GRASSES SPECIFICATION.
- 6. AN APPLICATION OF COMPOST IS TO BE BLENDED WITH TOPSOIL. REFER TO TURFS AND GRASSES SPECIFICATION FOR INFORMATION REGARDING QUANTITY AND TYPE OF ORGANIC COMPOST REQUIRED.
- 7. AFTER FINE GRADING IS COMPLETED, INFORM THE ENGINEER SO THAT AN INSPECTION OF THE FINE GRADING CAN TAKE PLACE BEFORE SEEDING IS BEGUN.

Plant Mulching Notes

- 1. TREES ARE TO HAVE A 6' DIAMETER SAUCER WITH 3" LAYER OF MULCH CENTERED ON BOLE OF TREE (TYPICAL). SEE DETAILS 8 AND 12 / EC500
- 2. PLANTING BEDS ARE TO HAVE A CONTINUOUS 3" LAYER OF SHREDDED BARK MULCH THROUGHOUT THE BED (TYPICAL). SEE DETAILS 8 AND 11 /


	PLANT LIST							
NO.	SYMBOL	BOTANICAL NAME	COMMON NAME	SIZE	ROOT	REMARKS	DETAIL NO	
		DECIDUOUS TREES						
4	BP	Betula populifolia 'Whitespire Senior'	Whitespire Senior Birch	10-12' Ht.	B&B	Clump form	12/EC500	
		DECIDUOUS SHRUBS						
7	SB	Spirea bumalda	Anthony Waterer	12-18" Ht.			11/EC500	
3	VD	Viburnum detantum 'Christom'	'Blue Muffin' Arrowood Viburnum	18-24" Ht.			11/EC500	
1	VL	Viburnum letana	Nannyberry	4-5' Ht.	B&B		11/EC500	
3	VL	Itea virginaica	Virginia Sweetspire	18-24" Ht.			11/EC500	
10	RA	Rhus aromatica 'Grow—low'	Grow-low Fragrant Sumac	12-18" Spread			11/EC500	

NOTE: PLANTS ARE TO COMPLY WITH ANSI Z60.1 STANDARDS WITH EXCEPTION OF MINIMUM SIZE REQUIREMENTS NOTED BELOW: DECIDUOUS SHRUBS - MIN. 12" HEIGHT OR SPREAD (WHICHEVER IS GREATER) EVERGREEN SHRUBS - MIN. 15" SPREAD

Planting Notes

- 1. CONTRACTOR IS RESPONSIBLE FOR COMPLETE COVERAGE OF PLANTING BEDS
- 2. PROPOSED PLANTING MATERIALS ARE SUBJECT TO THE APPROVAL OF THE ARCHITECT BEFORE, DURING AND AFTER INSTALLATION.
- 3. PLANT MATERIALS TO BE COMMERCIALLY GROWN AND BUD HARDY WITHIN USDA HARDINESS ZONE OF THE PROJECT.
- 4. PLANTING AREAS MUST BE NEATLY CUT OR EDGED AT BED LINE AND COMPLETELY MULCHED WITHIN BEDLINE WITH 3" CONTINUOUS SETTLED DEPTH OF MULCH SPECIFIED.
- 5. STAKE LOCATIONS OF INDIVIDUAL TREES, SHRUBS AND PLANT BEDLINES. NOTIFY ARCHITECT A MINIMUM OF ONE WEEK PRIOR TO PLANTING. STAKED LOCATIONS TO BE APPROVED BY ARCHITECT PRIOR TO INSTALLATION, EXCAVATION OF PITS OR PREPARATION OF BEDS.
- 6. IF LOCATION OF TREES ARE SHOWN WITH ROOT BALL WITHIN FIVE FEET OF UNDERGROUND UTILITIES, TREES ARE WITHIN TWENTY FEET OF OVERHEAD WIRES OR OTHER OBSTRUCTION IS ENCOUNTERED, INFORM ARCHITECT AND DO NOT PROCEED WITH PLANTING UNTIL ARCHITECT APPROVES LOCATION ADJUSTMENTS.
- 7. LEGIBLY TAG PLANTS WITH NOMENCLATURE FROM "STANDARDIZED PLANT NAMES" LISTING BY AMERICAN JOINT COMMITTEE OF HORTICULTURE. RETAIN TAGS ON PLANT MATERIALS AND SHIPPING RECEIPTS FOR ARCHITECT REVIEW. TAGS TO BE REMOVED ONLY AFTER ARCHITECT'S FINAL REVIEW OF PLANT MATERIALS. PLANT MATERIALS TO BE TRUE TO NAME, FORM, SIZE AND LOCATION INDICATED ON DRAWINGS AND SPECIFIED.
- 8. FULLY MAINTAIN PLANTING AND LAWN AREAS INCLUDING, BUT NOT LIMITED TO: STAKING, WATERING, SPRAYING, PRUNING, MULCHING AND FERTILIZING UNTIL THE PROJECT IS FINAL REVIEWED AND ACCEPTED BY ARCHITECT.
- 9. PLANT MATERIAL WHICH DIES, TURNS BROWN, DEFOLIATES OR IS DEEMED UNSATISFACTORY BY ARCHITECT PRIOR TO ACCEPTANCE OF THE WORK SHALL BE PROMPTLY REMOVED FROM THE SITE AND REPLACED WITH MATERIAL OF THE SAME SPECIES, QUANTITY AND SIZE UNLESS A SUBSTITUTION IS APPROVED BY THE ARCHITECT.
- 10. B&B AND CONTAINER PLANTS WITH LOOSE OR CRACKED ROOTBALLS WILL NOT BE ACCEPTED.
- 11. REFER TO PLANTS SPECIFICATION FOR INFORMATION REGARDING PLANT SOIL REQUIREMENTS.
- 12. CONTRACTOR SHALL CAREFULLY ROOT PRUNE, BALL AND BURLAP AND TEMPORARILY HEEL-IN PLANT MATERIAL TO BE RELOCATED USING GOOD HORTICULTURAL PRACTICES. PLANTS MUST BE PLACED IN A PROTECTED AREA APPROVED BY THE ARCHITECT, WATERED DAILY DURING SUMMER MONTHS AND INSTALLED AT NEW LOCATIONS SHOWN ON DRAWINGS AS SOON AS CONSTRUCTION WILL PERMIT.




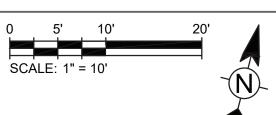

$\langle \# \rangle$ Site Layout Keynotes

- 1 SMOOTH TRANSITION FROM PROPOSED SURFACE TO ADJACENT EXISTING SURFACE, TYPICAL.
- 2 EXPANSION JOINT AT EXISTING SLAB. SEE DETAIL 9 / EC500.
- 3 CONCRETE SIDEWALK. SCORE JOINTS IN LOCATIONS SHOWN WHERE POSSIBLE. ALIGN WITH CORNERS WHEN POSSIBLE. SEE DETAILS 4 AND 5 / EC500.
- 4 SEEDED AREA PROVIDE 6-INCHES OF AMENDED TOPSOIL, FINE GRADE, SEED, FERTILIZE AND MULCH. LEAVE NEAT SMOOTH EDGE, TYPICAL.
- 5 CONCRETE STAIR. SEE DETAIL 7 / EC500.
- 6 STAINLESS STEEL HANDRAIL. SEE DETAIL 16 / EC500.
- 7 STAMPED CONCRETE PAVING. SEE DETAILS 5 / EC500 AND AND PROJECT MANUAL SECTIONS 03 30 00 - CAST-IN-PLACE CONCRETE AND 32 13 13 -CONCRETE PAVING.
- 8 SOLID PODIUM ISLAND. SEE DETAIL 10 / EC500.
- 9 MULCH PLANTING BED. SEE DETAILS 8 AND 11 / EC500.

Site Layout Leg	gend
4	CONCRETE PAVING
	STAMPED CONCRETE PAVING
	CONCRETE WALK
+ + + + + + + + + + + + + + + + + + + +	TOPSOIL, LAWN SEEDING & MULCHING
	MULCH BED

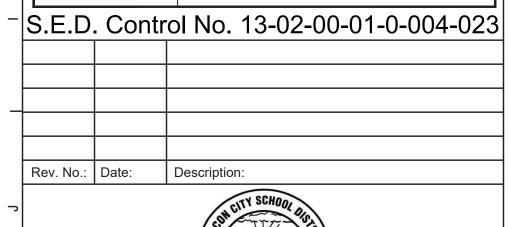



CLEAR SOLUTIONS

Tetra Tech Engineers, Architects & Landscape Architects, P.C.



Beacon City School District Beacon, New York


Reconstruction to: Rombout Middle School

Site Layout and Landscape Plans

Date: Drawing No.: Drawn by: JMR 10/28/2022 Project No.:


EC120 279180-22004

BUILDING

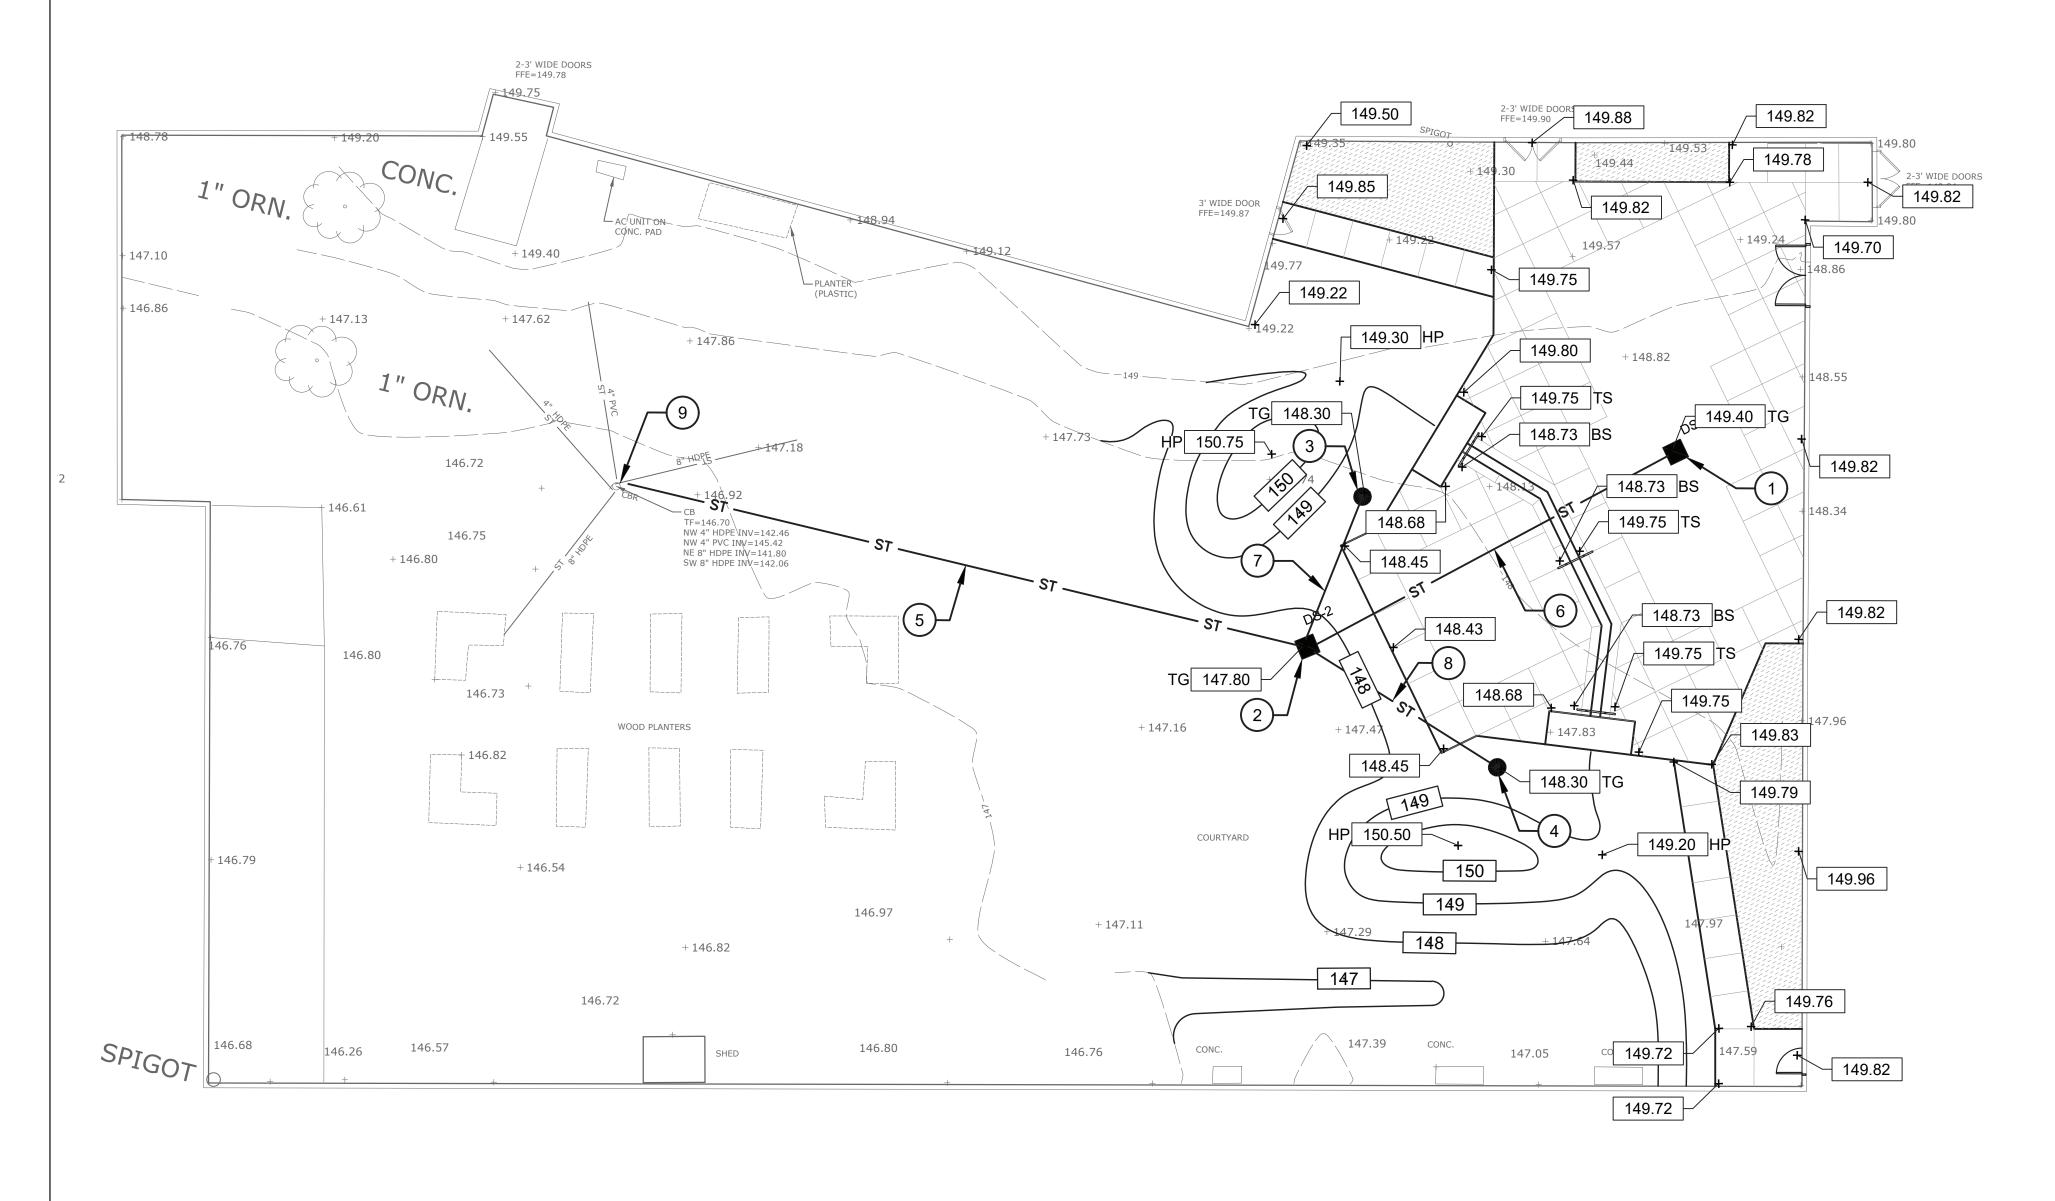

Site Utility, Grading and Drainage Plan

1" = 10'

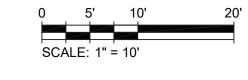

General Utility Plan Notes

1. CONTRACTOR IS RESPONSIBLE FOR REPAIRS OR DAMAGE TO ANY EXISTING UTILITY DURING CONSTRUCTION AT NO COST TO THE OWNER.

- 2. SEE PROJECT MANUAL FOR BACKFILLING AND COMPACTION REQUIREMENTS FOR UTILITY TRENCHES.
- 3. FILL MATERIAL IS TO BE IN PLACE AND COMPACTED BEFORE INSTALLATION OF PROPOSED UTILITIES.
- 4. ALL WATER AND OTHER UTILITIES SHOULD BE KEPT TEN-FEET 10-FT)APART(PARALLEL)OR WITH 18 INCH CLEARANCE WHEN CROSSING VERTICALLY(OUTSIDE EDGE OF PIPE TO OUTSIDE EDGE OF PIPE.)
- 5. LINES UNDERGROUND SHALL BE INSTALLED, INSPECTED AND APPROVED BEFORE BACKFILLING.
- 6. TOPS OF EXISTING MANHOLES, DRAINAGE INLETS, HYDRANTS AND WATER LINE VALVE BOXES SHALL BE RAISED AS NECESSARY TO BE FLUSH WITH PROPOSED PAVEMENT ELEVATIONS.
- 7. DRAWINGS DO NOT PURPORT TO SHOW ALL EXISTING UTILITIES.
- 8. EXISTING UTILITIES SHALL BE VERIFIED IN FIELD PRIOR TO INSTALLATION OF ANY NEW LINES.
- 9. THE CONTRACTOR IS SPECIFICALLY CAUTIONED THAT THE LOCATION AND/OR ELEVATION OF EXISTING UTILITIES AS SHOWN ON THESE PLANS IS BASED ON RECORDS OF THE VARIOUS UTILITY COMPANIES AND/OR MEASUREMENTS TAKEN IN THE FIELD. THE INFORMATION IS NOT TO BE RELIED ON AS BEING EXACT OR COMPLETE. SEE PROJECT MANUAL REGARDING COORDINATION WITH UTILITY COMPANIES BEFORE ANY EXCAVATION TO REQUEST EXACT FIELD LOCATION OF
- 10. THE CONTRACTOR SHALL CONDUCT REQUIRED TESTS TO THE SATISFACTION OF THE RESPECTIVE UTILITY COMPANIES AND THE OWNER'S INSPECTING AUTHORITIES.
- 11. CONTRACTOR SHALL COMPLY TO THE FULLEST EXTENT WITH THE LATEST STANDARDS OF OSHA DIRECTIVES OR ANY OTHER AGENCY HAVING JURISDICTION FOR EXCAVATION AND TRENCHING PROCEDURES. THE CONTRACTOR SHALL USE SUPPORT SYSTEMS, SLOPING, BENCHING, AND OTHER MEANS OF PROTECTION. THIS TO INCLUDE BUT IS NOT LIMITED TO ACCESS AND EGRESS FROM ALL EXCAVATION AND TRENCHING. CONTRACTOR IS RESPONSIBLE TO COMPLY WITH PERFORMANCE CRITERIA FOR OSHA.
- 12. THE CONTRACTOR SHALL BE RESPONSIBLE FOR ALL DEWATERING, PUMPING AND TREATMENT OF WATER. NO WATER FROM ANY CONSTRUCTION WORK, PROCESS OR AREA SHALL BE RELEASED DOWN STREAM OR INTO STORM SYSTEMS WITH OUT FIRST BEING TREATED TO REMOVE SEDIMENT, OILS, OR OTHER POLLUTANTS.

Site Utility, Grading and Drainage Keynotes

- 1 PROVIDE PRECAST CONCRETE 24-IN BY24-IN CATCH BASIN (DS-1). SEE DETAIL 3 / EC500. TOP OF GRATE = 149.45.
- INVERT OUT (DP-2) = 145.45. 2 PROVIDE PRECAST CONCRETE 24-IN BY24-IN CATCH BASIN (DS-2). SEE DETAIL 3 / EC500.
 - TOP OF GRATE = 147.80. INVERT IN (DP-1) = 143.83. INVERT IN (DP-3)= 144.34. INVERT IN (DP-4) = 144.20. INVERT OUT (DP-1) = 143.63.
- 3 PROVIDE 12 INCH DIAMETER PVC INLINE DRAIN (DS-3). SEE DETAIL 14 / EC500. TOP OF GRATE = 148.30. INVERT OUT (DP-3) = 145.30.
- 4 PROVIDE 12 INCH DIAMETER PVC INLINE DRAIN (DS-4). SEE DETAIL 14 / EC500. TOP OF GRATE = 148.30. INVERT OUT (DP-4) = 145.30.
- 5 PROVIDE 74 LF 8-INCH HDPE STORM PIPING (DP-1) AT 2.20% SLOPE. SEE DETAIL 2 / EC500.
- 6 PROVIDE 44 LF 8-INCH HDPE STORM PIPING (DP-2) AT 3.68% SLOPE. SEE DETAIL 2 / EC500.
- 7 PROVIDE 17 LF 8-INCH HDPE STORM PIPING (DP-3) AT 4.00% SLOPE. SEE DETAIL 2 / EC500.
- 8 PROVIDE 24 LF 8-INCH HDPE STORM PIPING (DP-4) AT 4.50% SLOPE. SEE DETAIL 2 / EC500.
- 5 CONNECT STORM PIPING DP-1 TO EXISTING STORM LINE / STRUCTURE AT (ESTIMATED) INVERT 142.0+/-. VERIFY LOCATION AND DEPTH OF EXISTING STRUCTURE PRIOR TO CONSTRUCTION.

General Site Notes

- . REFER TO DRAWING EC100 FOR GENERAL SITE NOTES THAT APPLY TO ALL C-SERIES DRAWINGS.
- General Grading Plan Notes
- ALL FILL MATERIALS, INCLUDING ON-SITE MATERIALS, ARE TO BE SUBMITTED FOR ARCHITECT APPROVAL BEFORE PLACEMENT. REFER TO EARTH MOVING SPECIFICATION FOR REQUIREMENTS.
- ALL CUT OR FILL SLOPES SHALL BE 3:1 OR FLATTER UNLESS

DISPOSED OF PER THE PROJECT MANUAL.

- OTHERWISE NOTED. . EXCESS MATERIAL CUT FROM THE SITE (WITH THE EXCEPTION OF TOPSOIL) SHALL BE REMOVED FROM THE SITE AND LEGALLY
- OWNER'S GEOTECHNICAL ENGINEER TO BE PRESENT FOR ALL FILL AND COMPACTION OPERATIONS, INCLUDING TRENCHES AND STORMWATER STRUCTURES. REFER TO EARTH MOVING
- CONTRACTOR SHALL ASSURE POSITIVE DRAINAGE AWAY FROM BUILDINGS AND STRUCTURES FOR NATURAL AND PAVED AREAS.

SPECIFICATION FOR GEOTECHNICAL TESTING REQUIREMENTS.

- SPREAD TOPSOIL TO A MINIMUM DEPTH OF 6-INCHES CONTINUOUS SETTLED DEPTH OVER AREAS OF THE SITE WHERE EARTH HAS BEEN DISTURBED, EXCEPT WHERE BUILDING OR PAVING IS PROPOSED.
- DISTURBED AREAS THAT ARE NOT RECEIVING PAVEMENT SHALL BE FINE GRADED, SEEDED OR SODDED, FERTILIZED AND MULCHED AS PER THE PROJECT MANUAL.
- AFTER FINE GRADING IS COMPLETED, INFORM THE OWNER AND A/E SO THAT AN INSPECTION OF THE FINE GRADING CAN TAKE PLACE BEFORE SEEDING IS BEGUN. IF INSPECTION DOES NOT TAKE PLACE, APPROVAL OF LAWN MAY BE DELAYED OR DENIED.
- EXISTING AND PROPOSED GRADE CONTOUR INTERVALS SHOWN AT 1-FOOT INTERVALS.
- 10. ALL STORM SEWER MANHOLES IN PAVED AREAS SHALL BE FLUSH WITH PAVEMENT, AND SHALL HAVE TRAFFIC BEARING LIDS.
- 11. CONTRACTOR SHALL ADJUST AND / OR CUT EXISTING PAVEMENT AS NECESSARY TO ASSURE A SMOOTH FIT AND CONTINUOUS GRADE.
- 12. CONSTRUCTION SHALL COMPLY WITH ALL APPLICABLE GOVERNING CODES AND BE CONSTRUCTED TO SAME.


GRADING KEY				
TS	TOP OF STEP			
BS	BOTTOM OF STEP			
+	SPOT ELEVATION			
HP	HIGH POINT			
MATCH	MATCH EXISTING GRADE			

ADA Site Notes

- THE MAXIMUM SLOPE OF ACCESSIBLE PARKING STALLS AND ASSOCIATED ACCESS AISLE SHALL BE 2% (1V:50H).
- THE MAXIMUM SLOPE IN THE DIRECTION OF TRAVEL ON ACCESSIBLE PATHS SHALL BE 5% (1V:20H).
- 2% (1V:50H).
- THE MAXIMUM SLOPE IN THE DIRECTION OF TRAVEL ON ACCESSIBLE RAMPS AND CURB RAMPS SHALL BE 8.33% (1V:12H), AS INDICATED ON THE DETAILS.

THE MAXIMUM CROSS SLOPE ON ACCESSIBLE PATHS SHALL BE

GROUND SURFACES ON ACCESSIBLE PATHS SHALL BE STABLE, FIRM, AND SLIP RESISTANT.

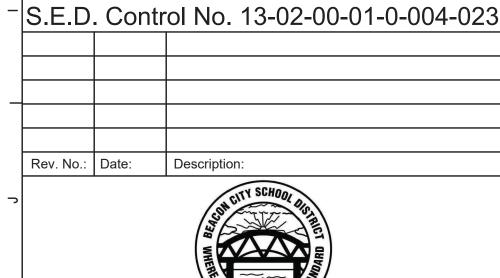



complex world **CLEAR SOLUTIONS**

Tetra Tech Engineers, Architects & Landscape Architects, P.C.



- Beacon City School District Beacon, New York
- Reconstruction to: Rombout Middle School

Site Grading, Drainage and Utility Plans

Drawn by: Drawing No.: 10/28/2022 Project No.: 279180-22004

EC130

