BEDFORD CENTRAL SCHOOL DISTRICT

DISTRICT ADMINISTRATION OFFICES

632 S BEDFORD RD, BEDFORD, NY 10506

PHASE 1A - BOND IMPROVEMENTS

AT

FOX LANE HIGH SCHOOL

632 S BEDFORD RD BEDFORD, NY 10506 SED No.:66-01-02-06-0-003-021 BBS No.:22-225A

FOX LANE MIDDLE SCHOOL

632 S BEDFORD RD BEDFORD, NY 10506 SED No.:66-01-02-06-0-007-011 BBS No.:22-225B

MOUNT KISCO ELEMENTARY SCHOOL

47 W HYATT AVE MT KISCO, NY 10549 SED No.:66-01-02-06-0-006-015 BBS No.:22-225C

BEDFORD VILLAGE ELEMENTARY SCHOOL

45 COURT RD BEDFORD, NY 10506 SED No.:66-01-02-06-0-002-016 BBS No.:22-225D

BEDFORD HILLS ELEMENTARY SCHOOL

123 BABBITT RD BEDFORD HILLS, NY 10507 SED No.:66-01-02-06-0-004-020 BBS No.:22-225E

WEST PATENT ELEMENTARY SCHOOL

80 W PATENT RD BEDFORD HILLS, NY 10507 SED No.:66-01-02-06-0-009-014 BBS No.:22-225F

POUND RIDGE **ELEMENTARY SCHOOL**

7 POUND RIDGE RD POUND RIDGE, NY 10576 SED No.:66-01-02-06-0-001-016 BBS No.:22-225G

FOX LANE HIGH SCHOOL

T0.01 TITLE SHEET

A0.01 BASEMENT KEY PLAN

A0.03 SECOND FLOOR KEY PLAN

A0.04 THIRD FLOOR KEY PLAN

A2.02 ENLARGED PLANS - AREA C A4.01 BRICKWORK ELEVATIONS & SECTIONS

A8.01 DOOR SCHEDULE, ELEVATIONS, AND DETAILS

A8.02 DOOR DETAILS

MECHANICAL M0.01 GENERAL NOTES

M2.01 NEW EXHAUST PLAN

ELECTRICAL

E0.01 GENERAL NOTES, LEGENDS AND ABBREVIATIONS E0.02 HS MULTIPURPOSE FIELD DEMOLITION PLAN

E0.03 HS MULTIPURPOSE FIELD PLAN E0.04 HS SITE PLAN - FIELD #4

E2.00 BASEMENT FLOOR PLAN

E2.01 FIRST FLOOR PLAN E3.01 ROOF PLAN E4.01 ELECTRICAL DETAILS

FOX LANE MIDDLE SCHOOL

A0.01 FIRST FLOOR KEY & CODE COMPLIANCE PLAN A0.02 SECOND FLOOR KEY & CODE COMPLIANCE PLAN

A0.03 THIRD & FOURTH FLOOR KEY & CODE COMPLIANCE PLAN

A1.01 DEMOLITION PLAN

A2.01 PROPOSED PLAN

A10.01 REFLECTED CEILING PLAN

A2.02 PROPOSED PLAN - ADD ALTERNATES A4.01 ELEVATIONS

A6.01 WALL SECTIONS A8.01 DOOR SCHEDULE AND DETAILS A9.01 FINISH PLAN AND SCHEDULE

E0.01 GENERAL NOTES, SYMBOLS AND ABBREVIATIONS E0.02 MS SOFTBALL FIELD SITE PLAN

E1.01 GYM LIGHTING PLAN E4.01 ELECTRICAL DETAILS E4.02 ELECTRICAL SITE DETAILS

MOUNT KISCO ELEMENTARY SCHOOL

A0.01 GROUND FLOOR AND FIRST FLOOR KEY PLAN

M2.01 SECURITY VESTIBULE NEW MECHANICAL PLAN

E0.01 GENERAL NOTES, SYMBOLS AND ABBREVIATIONS E1.01 PARTIAL FIRST FL ELECTRICAL PLAN - MAIN LOBBY

BEDFORD VILLAGE ELEMENTARY **SCHOOL**

A0.01 FIRST FLOOR KEY PLAN A1.01 DEMOLITION PLANS AND SECTION A2.01 PROPOSED PLAN AND DETAILS

E0.01 GENERAL NOTES, SYMBOLS AND ABBREVIATIONS

E1.01 FIRST FLOOR FA & SYSTEMS DEMOLITION PLAN 1.02 FIRST FLOOR FA & SYSTEMS PROPOSED PLAN E6.01 TECHNOLOGY DETAILS - VOIP

BEDFORD HILLS ELEMENTARY SCHOOL

A0.01 BASEMENT, FIRST AND SECOND FLOOR KEY PLANS

A1.01 DEMOLITION PLANS AND SECTION A2.01 SECURITY VESTIBULE ENLARGED FLOOR PLAN

A4.01 BUILDING ELEVATIONS, SECTION AND ROOF PLAN

80.02 SPECIAL INSPECTIONS NOTES AND SCHEDULES \$1.00 FOUNDATION AND FRAMING PLANS

S3.00 SECTIONS AND DETAILS S5.00 CFMF SECTIONS AND DETAILS

M0.01 GENERAL NOTES

M2.01 DEMO AND NEW WORK PLAN

60.01 GENERAL NOTES, SYMBOLS AND ABBREVIATIONS

E1.00 PARTIAL BASEMENT AND FIRST FLOOR PLAN E1.01 PARTIAL MAIN LOBBY PLAN

WEST PATENT ELEMENTARY SCHOOL

A0.01 FIRST FLOOR KEY PLAN A2.01 DEMO AND PROPOSED PLAN AND DETAILS


E0.01 GENERAL NOTES, SYMBOLS, ABBREVIATIONS AND SECURITY VESTIBULE PLAN

POUND RIDGE ELEMENTARY SCHOOL

A0.01 GROUND FLOOR AND LOWER FLOOR KEY PLANS A2.01 PROPOSED PLAN, ELEVATIONS AND DETAILS

0.01 GENERAL NOTES, SYMBOLS AND ABBREVIATIONS E2.01 PROPOSED FIRST FL PLAN E6.01 TECHNOLOGY DETAILS

LOCATION MAP

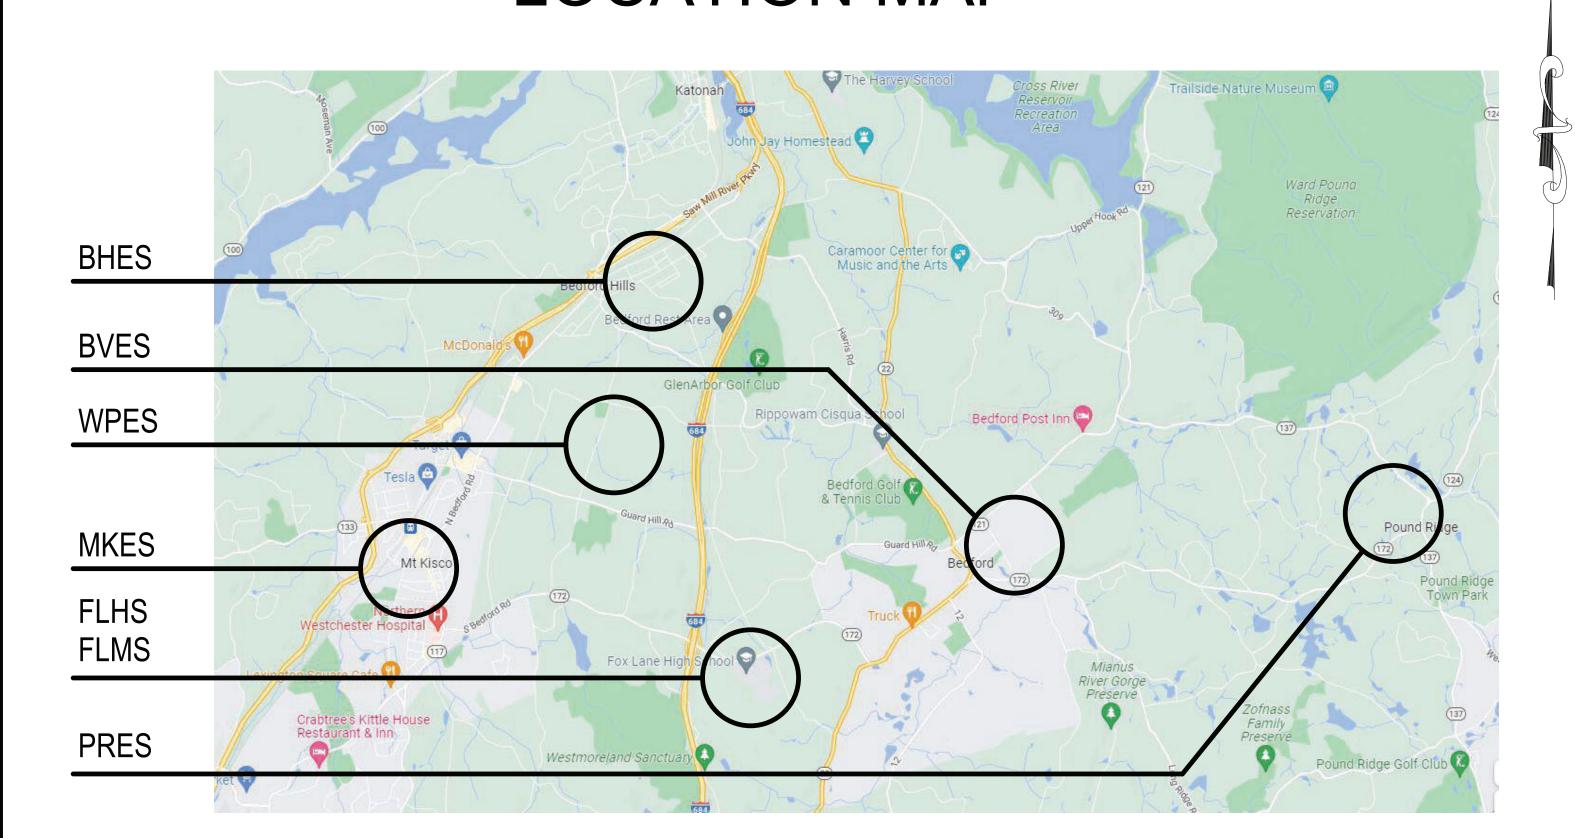

ARCHITECTS LANDSCAPE ARCHITECTS **ENGINEERS**

BRANCH PROJECT CONTACT: 187 WOLF ROAD, SUITE 205 | ALBANY | NEW YORK 12205 | T. 518.621.7650 244 EAST MAIN STREET | PATCHOGUE | NEW YORK 11772 | T. 631.475.0349 | F. 631.475.0361

WWW.BBSARCHITECTURE.COM

T0.01 22-225B FLHS

THE UNDERSIGNED CERTIFIES THAT TO THE BEST OF HIS KNOWLEDGE, INFORMATION, AND BELIEF, THI PLANS AND SPECIFICATIONS ARE IN ACCORDANCE WITH APPLICABLE REQUIREMENTS OF THE NEW YORK STATE UNIFORM FIRE PREVENTION AND BUILDING CODE, THE NEW YORK STATE ENERGY CONSERVATION

CONSTRUCTION CODE, AND THE CONSTRUCTION STANDARDS OF THE EDUCATION DEPARTMENT.

22-225B FLMS 22-225C MKES 22-225D BVES 22-225E BHES


22-225F WPES

BBS FILE No. 22-225G PRES

ISSUED FOR BID: FEBRUARY 2, 2022

LAWRENCE SALVESEN, A.I.A.

LIC. No. 020623

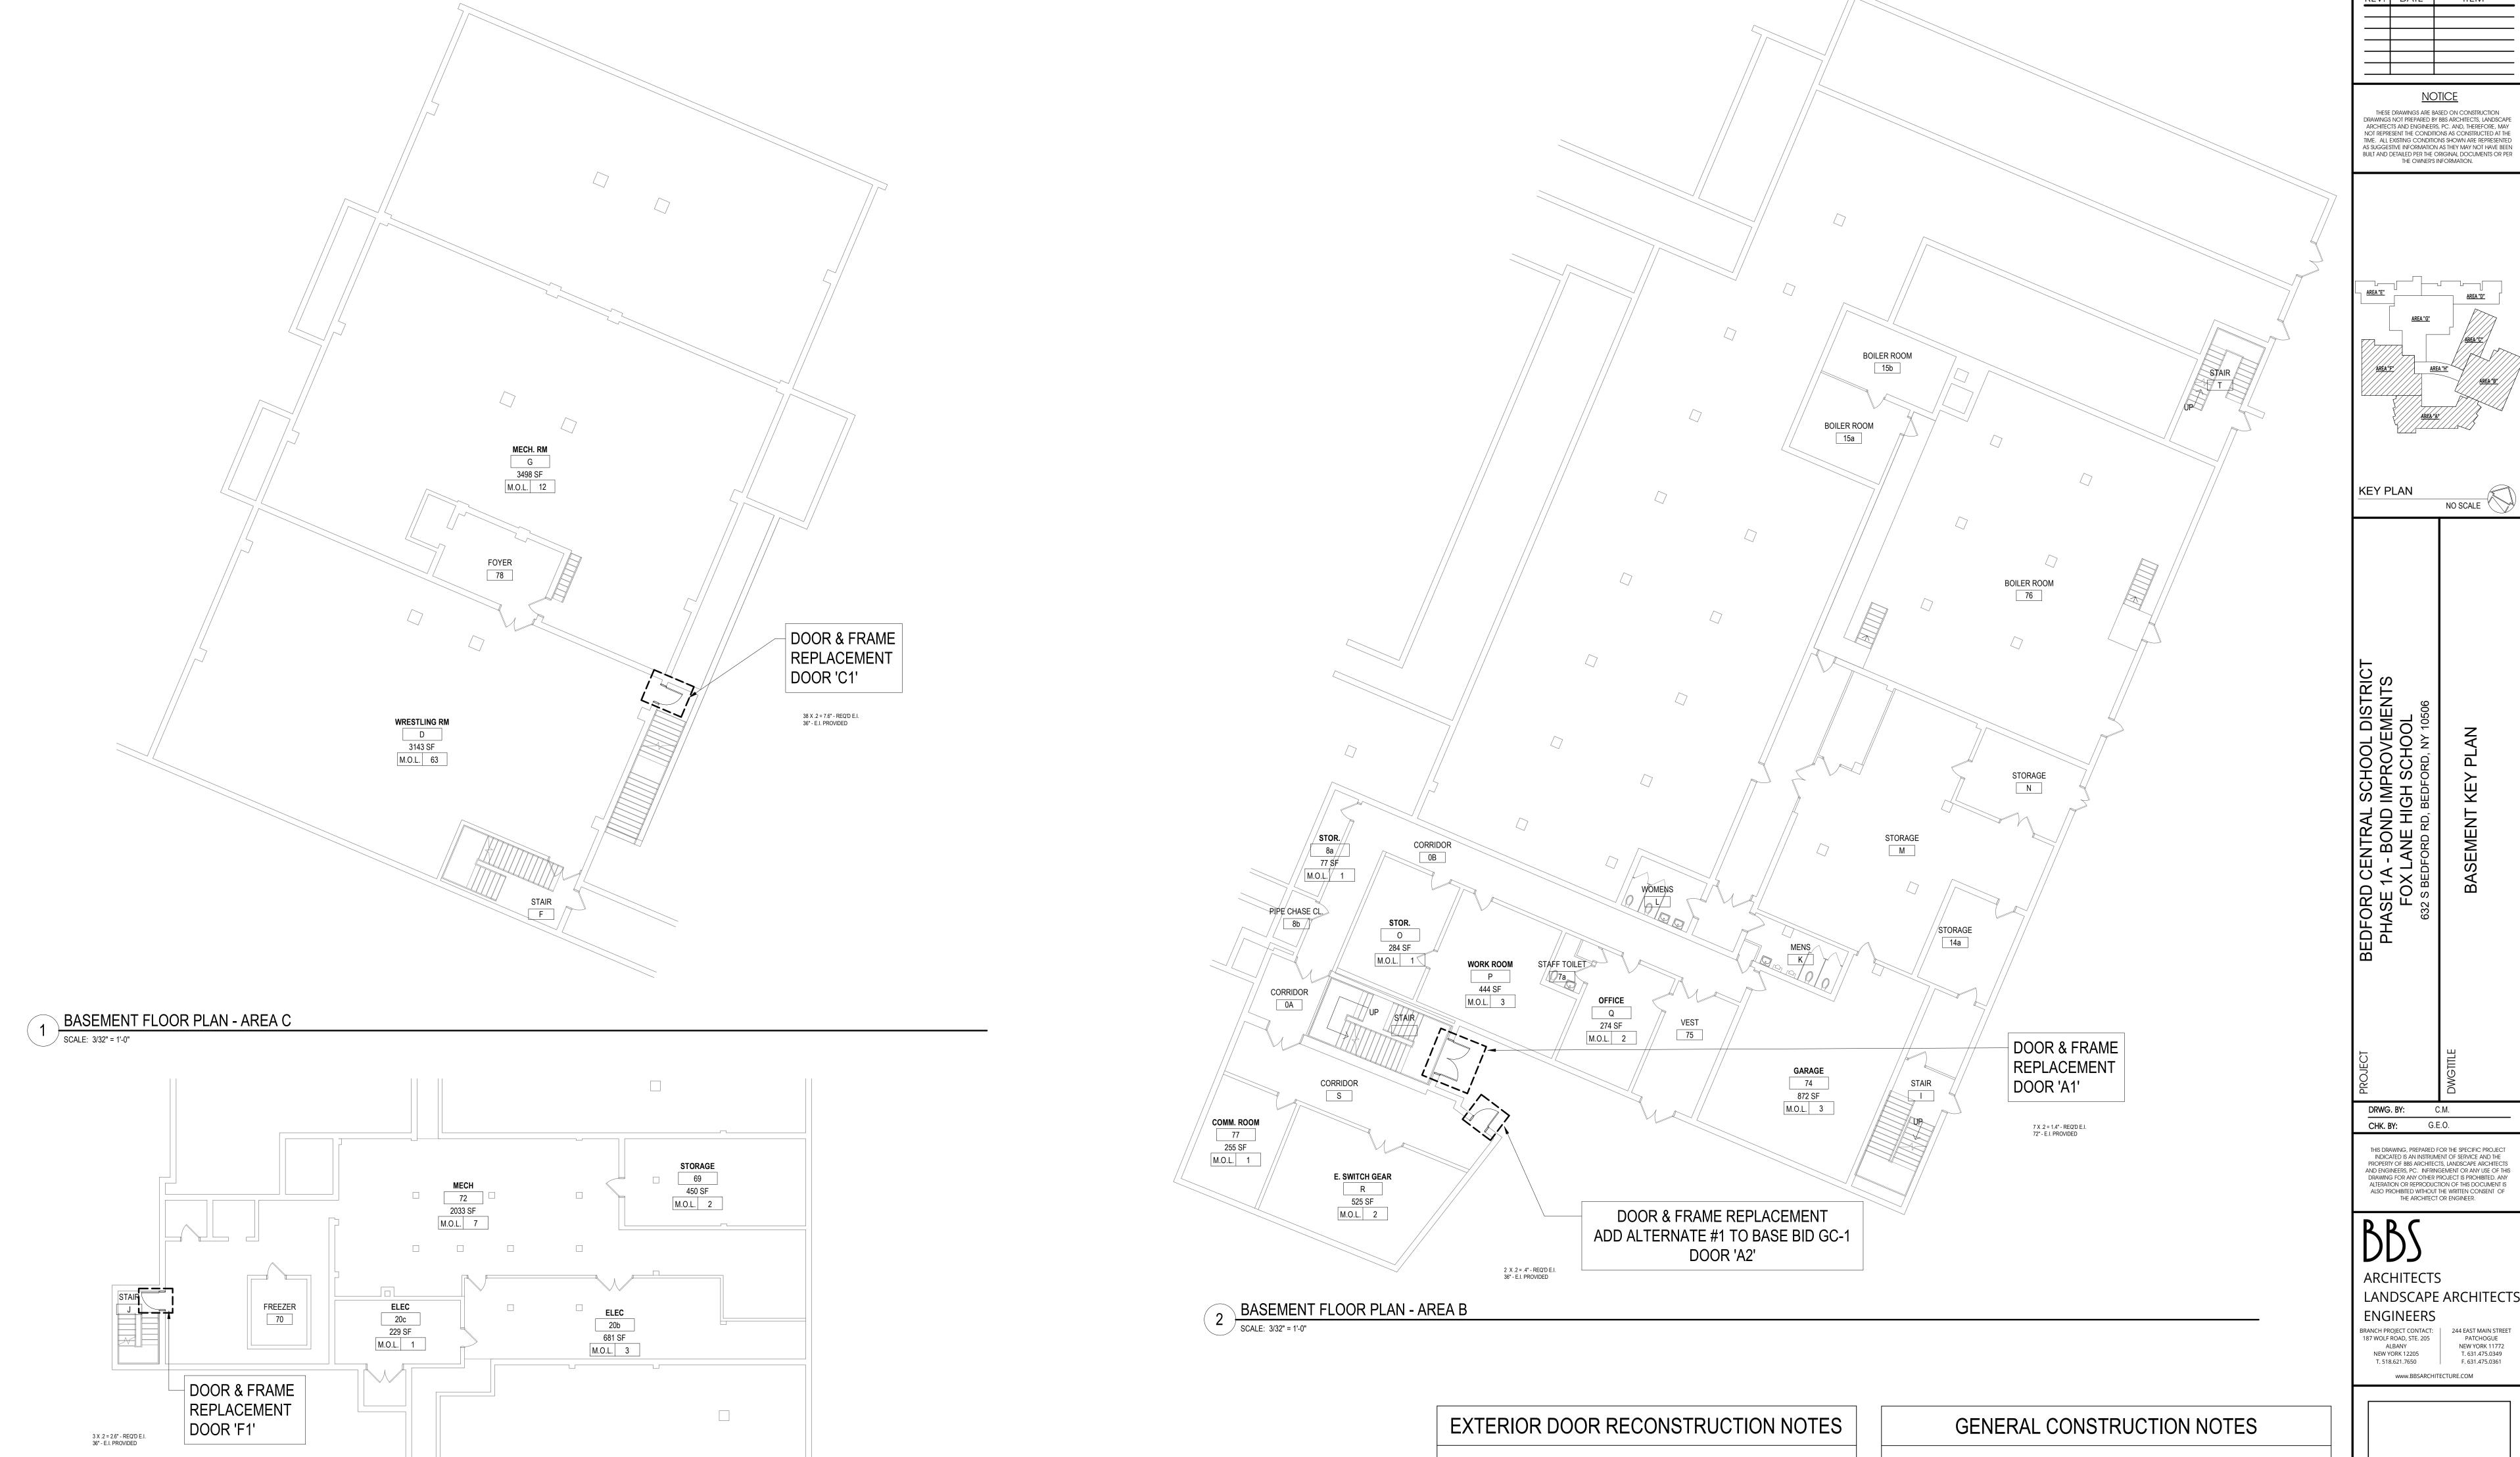

BASEMENT FLOOR PLAN - AREA F

SCALE: 3/32" = 1'-0"

- . AT ALL AREAS NOTED FOR REPLACEMENT, G.C. SHALL REMOVE AND DISPOSE OF EXISTING DOORS, FRAMES, AND GLAZING. G.C. SHALL TURN OVER EXISTING DOOR HARDWARE AND SIGNAGE TO OWNER.
- 2. G.C. SHALL PATCH/ REPAIR EXISTING INTERIOR/ EXTERIOR FINISHES CAUSED BY FRAME DEMOLITION.
- 3. G.C. SHALL PROVIDE KILN DRIED BLOCKING & SHIMS AS REQ'D FOR NEW FRAME INSTALLATION.
- 4. G.C. SHALL COORD. W/ E.C. FOR REMOVAL AND REINSTALLATION OF EXISTING DOOR CONTACT & ACCESS CONTROL DEVICES AND/OR MOTION DEVICES AS REQ'D FOR DEMOLITION & PROPOSED FRAME. COORDINATE W/ E.C. FOR REINSTALLATION INTEGRAL WITH FRAME & DOOR. G.C. SHALL PAINT EXPOSED CONDUIT TO MATCH DOOR, FRAME, & EXISTING FINISHES.
- 5. G.C. SHALL PROVIDE BACKER RODS AND SEALANT FULL PERIMETER, EACH SIDE OF NEW FRAME. SUBMIT COLOR SAMPLES FOR REVIEW, (TYP).
- 6. G.C. SHALL SCRAPE AND PAINT EXISTING EXPOSED DOOR LINTELS AFTER NEW FRAME INSTALLATION, (TYP).
- 1. GENERAL CONTRACTOR SHALL VERIFY ALL EXISTING CONDITIONS PRIOR TO BIDDING & PROCEEDING WITH WORK. NOTIFY ARCHITECT OF ANY DISCREPANCIES IN WRITING PRIOR TO START OF WORK.
- 2. IN ACCORDANCE WITH STATE AND LOCAL CODES, THE REQUIRED EXITS IN THE EXISTING BUILDING MUST BE KEPT CLEAR, MAINTAINED AND PROTECTED DURING THE CONSTRUCTION PERIOD.

3. CONTRACTOR SHALL BE RESPONSIBLE FOR VERIFICATION OF ALL DIMENSIONS REQUIRED FOR ESTIMATING.

- 4. ALL WORK AND MATERIAL OF THIS PROJECT AND ADJACENT SURFACES SHALL BE PROTECTED FROM DAMAGE. IN THE EVENT OF DAMAGE, THE CONTRACTOR SHALL IMMEDIATELY MAKE ALL REPAIRS AND REPLACEMENT NECESSARY TO THE APPROVAL OF THE ARCHITECT AND OWNER AND AT NO ADDITIONAL COST TO OWNER.
- 5. CONTRACTOR SHALL PROTECT ALL AREAS OF WORK FROM INCLEMENT WEATHER DURING AND AT THE END OF DAILY
- WORK OPERATIONS. 6. ALL PROJECT WASTE MATERIAL AND RUBBISH SHALL BE DISPOSED IN CONTAINERS PROVIDED BY THE CONTRACTOR
- FOR SUBSEQUENT LEGAL OFF-SITE DISPOSAL. CONTAINER LOCATION TO BE COORDINATED WITH THE OWNER & CONSTRUCTION MANAGER. OFF-SITE DISPOSAL TO BE ON A REGULAR BASIS.
- 7. ALL INTERIOR SURFACES DISTURBED DURING CONSTRUCTION SHALL BE REPAIRED AND/OR REPLACED TO MATCH EXISTING CONDITIONS TO THE APPROVAL OF THE ARCHITECT AND OWNER.
- 8. ALL DEBRIS, DUST AND DIRT CAUSED BY WORK OF THIS CONTRACT SHALL BE REMOVED FROM SITE BY APPROPRIATE MEANS. RESTORE ALL CONDITIONS TO THE STATE OF CLEANLINESS THAT EXISTED PRIOR TO COMMENCEMENT OF
- 9. ALL DEMOLITION AND CONSTRUCTION WORK TO BE PERFORMED WITHOUT INTERRUPTION OF OWNER OPERATIONS. IF INTERRUPTION IS NECESSARY, WORK MUST NOT PROCEED UNTIL WRITTEN APPROVAL HAS BEEN OBTAINED FROM
- 10. ALL CONTRACTORS ARE TO COORDINATE INSTALLATION OF THEIR WORK WITH EACH OTHER AND WITH THE WORK BEING PERFORMED UNDER SEPARATE CONTRACTS BY OTHERS.

L CONSTRUCTION NOTES		

<u>SED No.</u> 66-01-02-06-0-003-021 **DISTRICT** BEDFORD CENTRAL SCHOOL

244 EAST MAIN STREET PATCHOGUE NEW YORK 11772


T. 631.475.0349

NO SCALE

PHASE 1A - BOND IMPROVEMENTS DWG TITLE BASEMENT KEY PLAN SCALE: AS NOTED

BID P/U DATE: 2/2/2023 9:45:06 AM FILE NO. 22-225A

DATE:

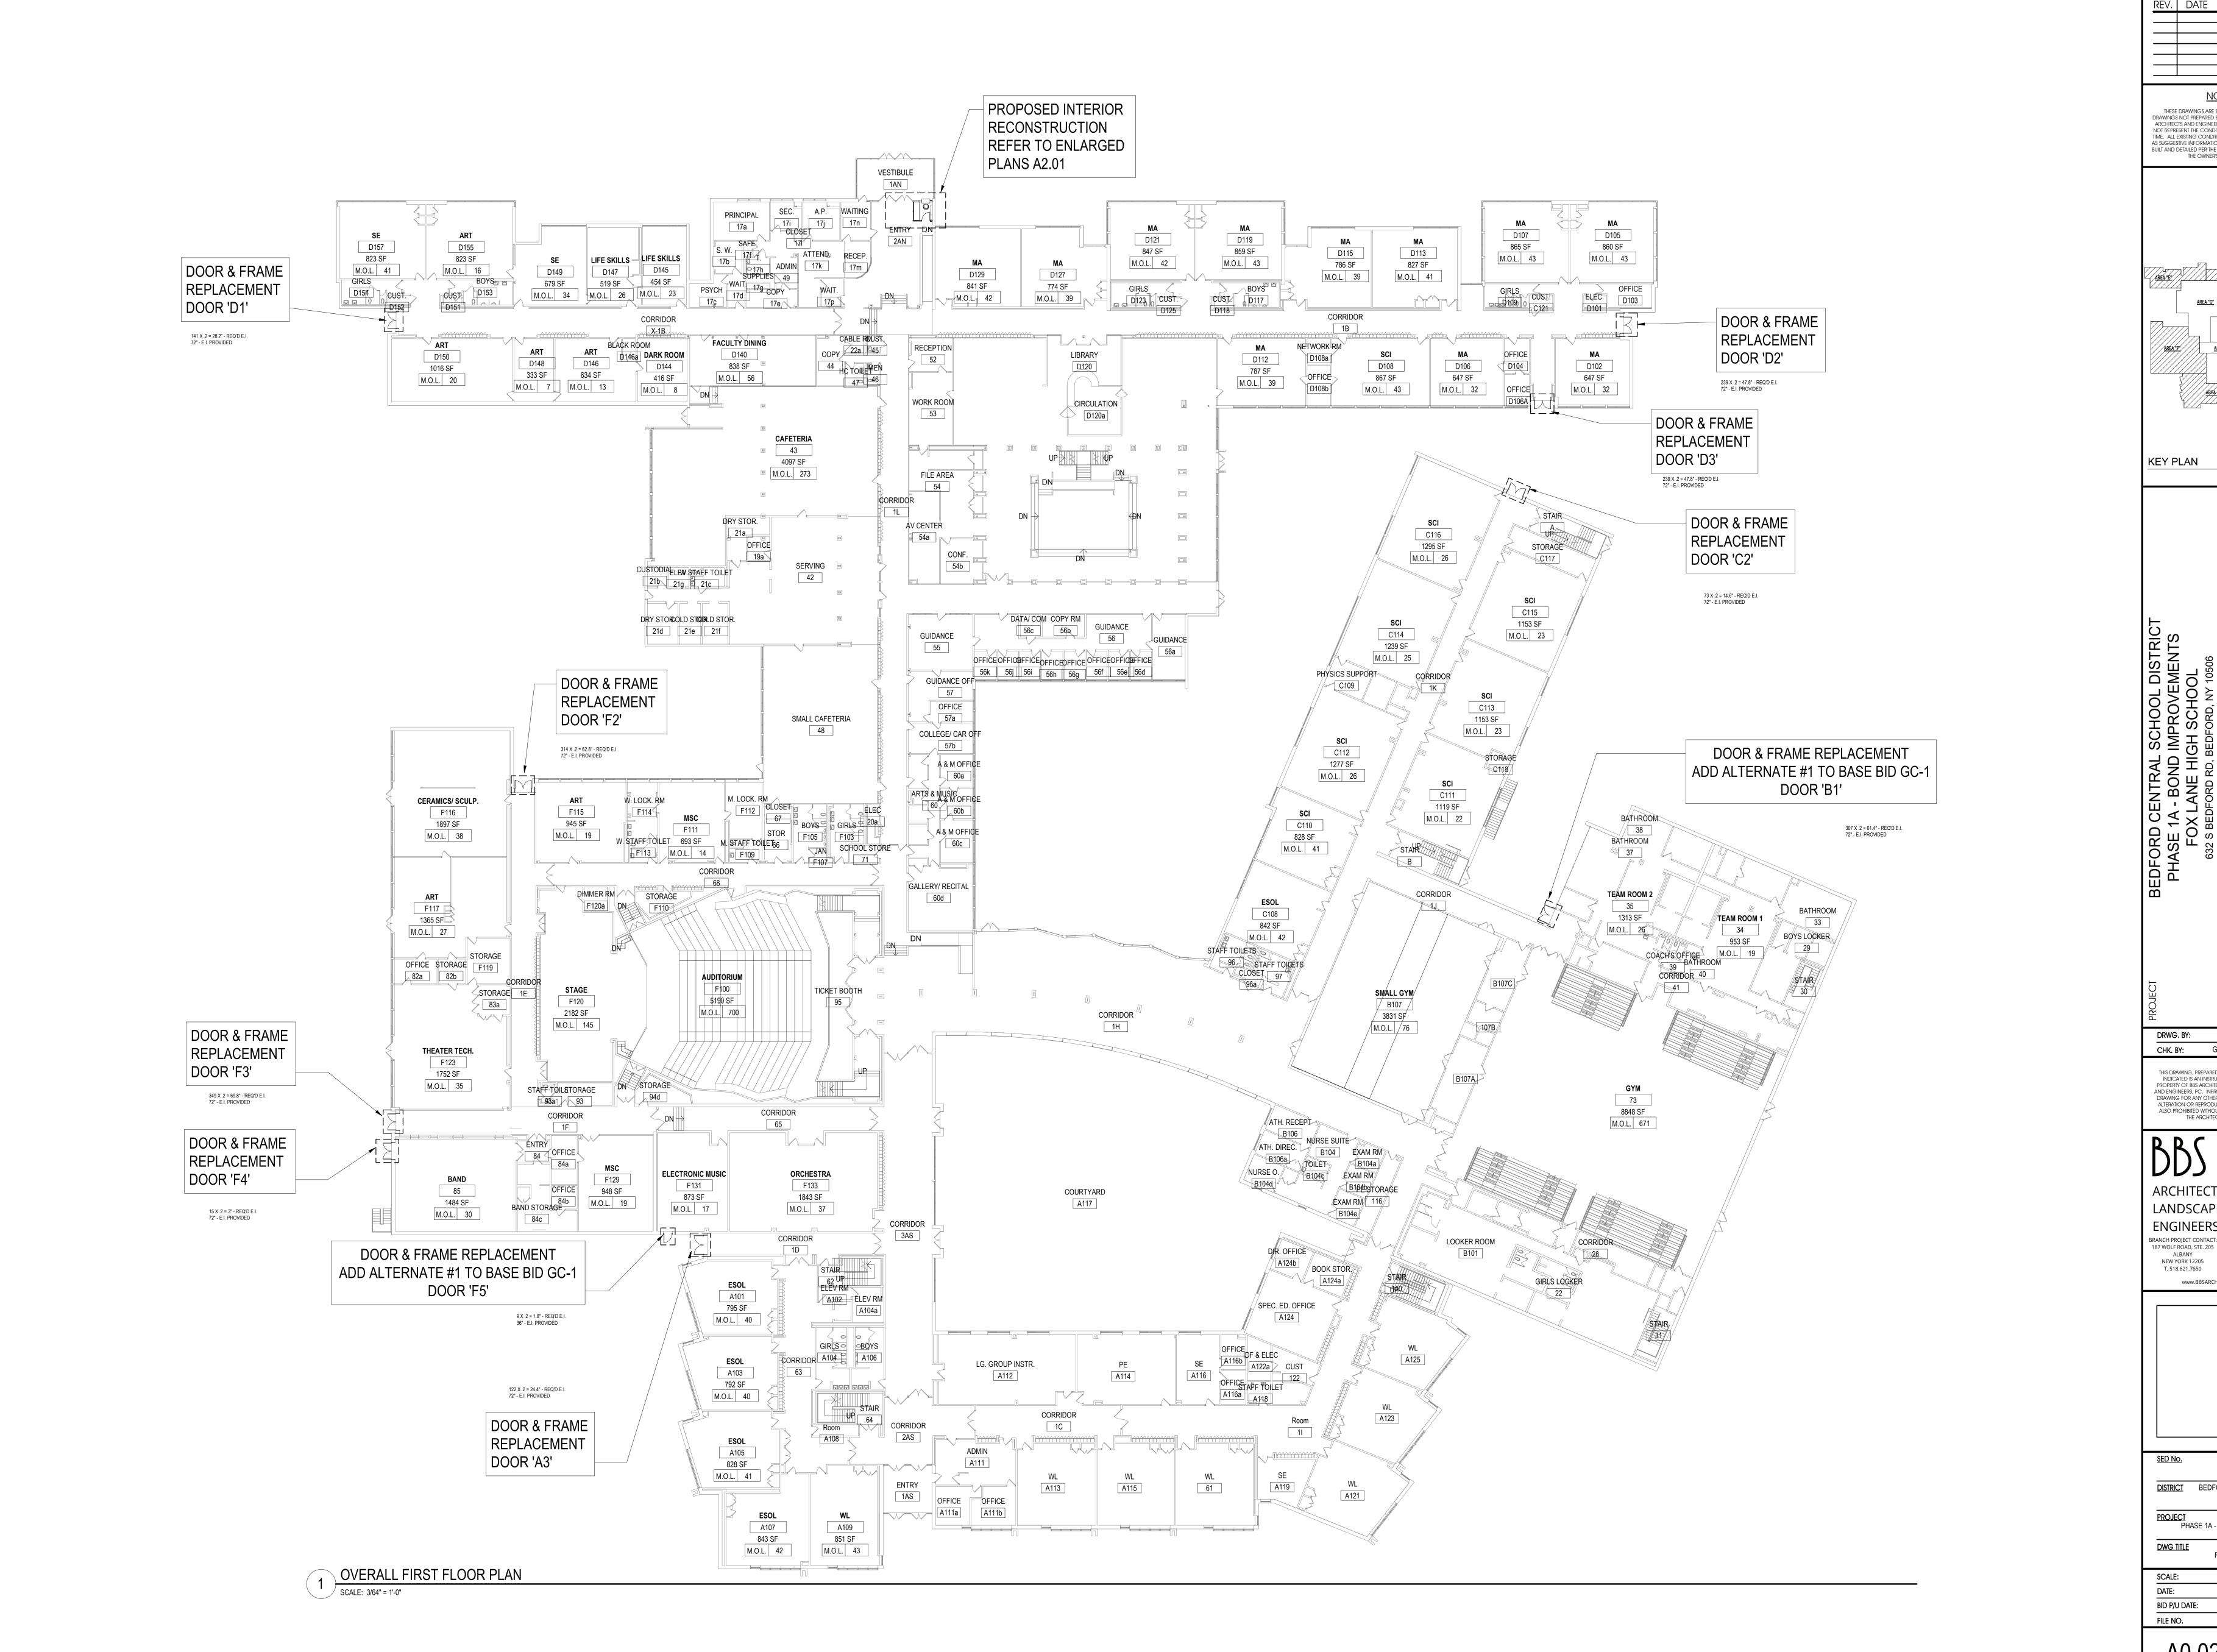

REV. DATE <u>NOTICE</u> THESE DRAWINGS ARE BASED ON CONSTRUCTION DRAWINGS NOT PREPARED BY BBS ARCHITECTS, LANDSCAPE ARCHITECTS AND ENGINEERS, PC. AND, THEREFORE, MAY NOT REPRESENT THE CONDITIONS AS CONSTRUCTED AT THE TIME. ALL EXISTING CONDITIONS SHOWN ARE REPRESENTED AS SUGGESTIVE INFORMATION AS THEY MAY NOT HAVE BEEN BUILT AND DETAILED PER THE ORIGINAL DOCUMENTS OR PER THE OWNER'S INFORMATION. AREA "B" AREA "A" NO SCALE C.M. CHK. BY: G.E.O. THIS DRAWING, PREPARED FOR THE SPECIFIC PROJECT INDICATED IS AN INSTRUMENT OF SERVICE AND THE PROPERTY OF BBS ARCHITECTS, LANDSCAPE ARCHITECTS AND ENGINEERS, PC. INFRINGEMENT OR ANY USE OF THIS


ALTERATION OR REPRODUCTION OF THIS DOCUMENT IS ALSO PROHIBITED WITHOUT THE WRITTEN CONSENT OF THE ARCHITECT OR ENGINEER.

ARCHITECTS LANDSCAPE ARCHITECTS **ENGINEERS** BRANCH PROJECT CONTACT: 244 EAST MAIN STREET 187 WOLF ROAD, STE. 205 PATCHOGUE NEW YORK 11772 T. 631.475.0349 F. 631.475.0361 www.BBSARCHITECTURE.COM

66-01-02-06-0-003-021 DISTRICT BEDFORD CENTRAL SCHOOL

PROJECT
PHASE 1A - BOND IMPROVEMENTS FIRST FLOOR KEY PLAN AS NOTED 2/2/2023 9:45:12 AM

A0.02 FLHS

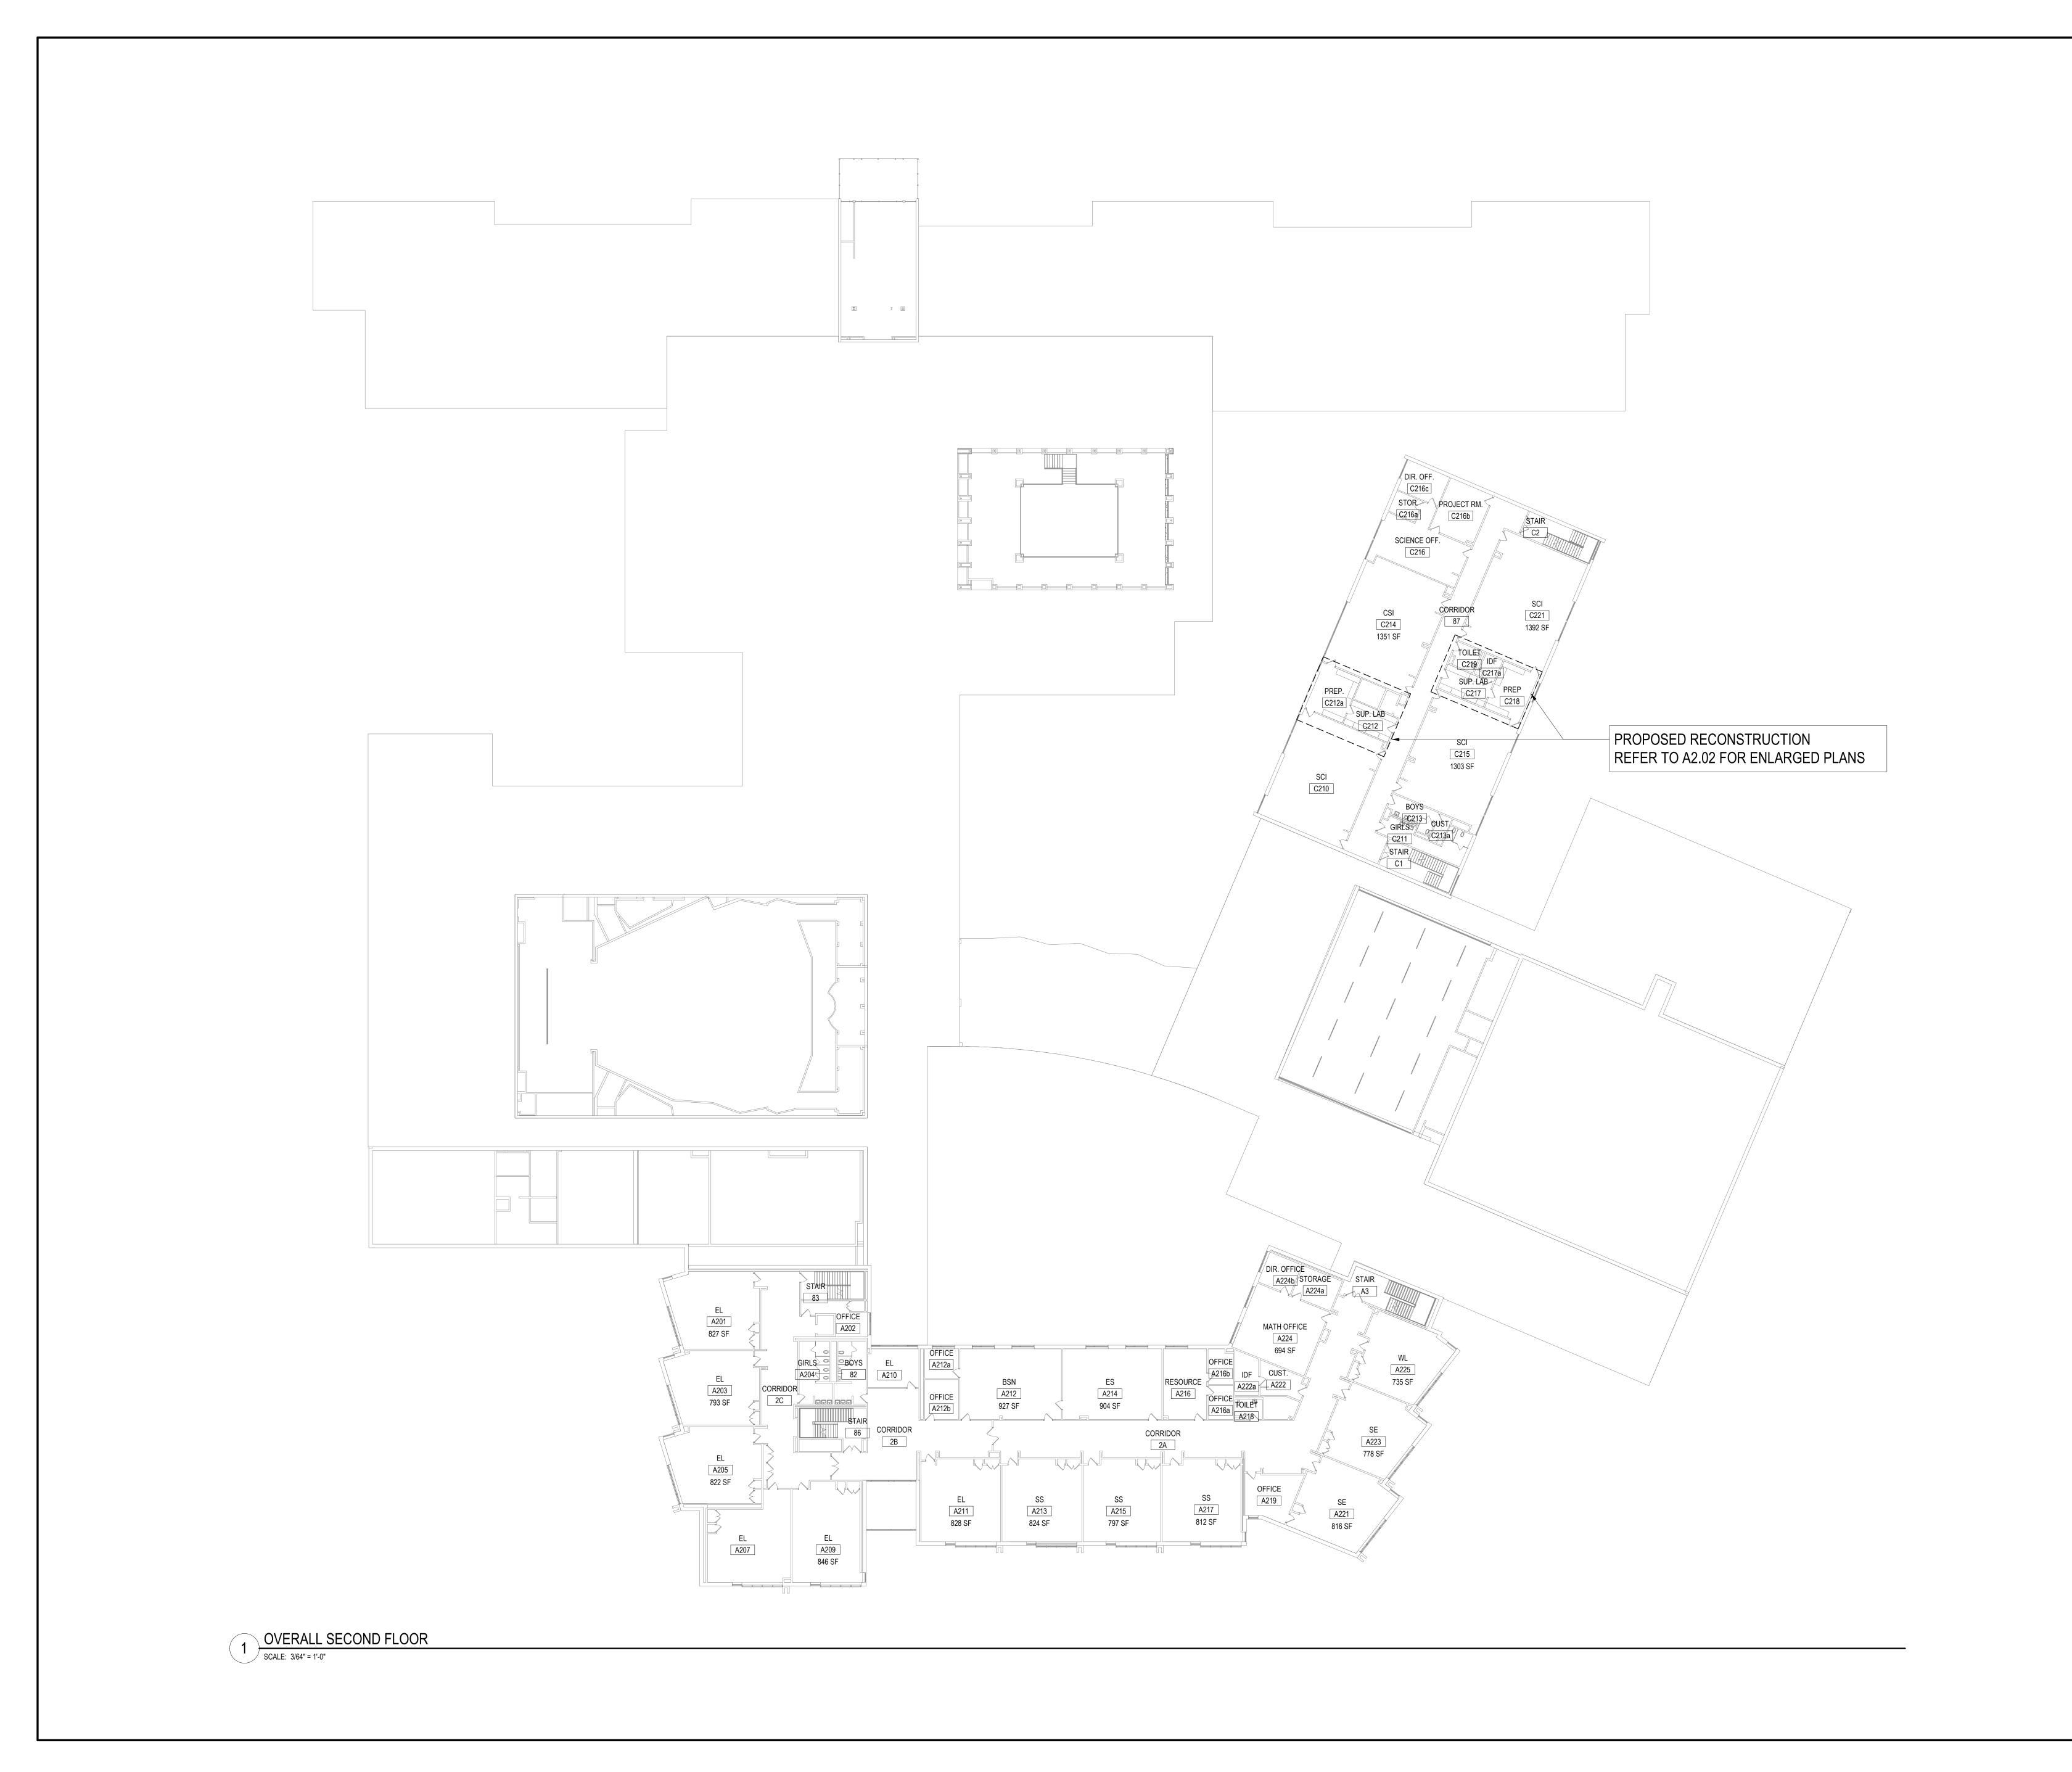

REV. DATE <u>NOTICE</u> THESE DRAWINGS ARE BASED ON CONSTRUCTION DRAWINGS NOT PREPARED BY BBS ARCHITECTS, LANDSCAPE ARCHITECTS AND ENGINEERS, PC. AND, THEREFORE, MAY NOT REPRESENT THE CONDITIONS AS CONSTRUCTED AT THE TIME. ALL EXISTING CONDITIONS SHOWN ARE REPRESENTED AS SUGGESTIVE INFORMATION AS THEY MAY NOT HAVE BEEN BUILT AND DETAILED PER THE ORIGINAL DOCUMENTS OR PER THE OWNER'S INFORMATION. DRWG. BY: C.M.
CHK. BY: G.E.O.

CHK. BY: G.E.O.

THIS DRAWING, PREPARED FOR THE SPECIFIC PROJECT INDICATED IS AN INSTRUMENT OF SERVICE AND THE PROPERTY OF BBS ARCHITECTS, LANDSCAPE ARCHITECTS AND ENGINEERS, PC. INFRINGEMENT OR ANY USE OF THIS DRAWING FOR ANY OTHER PROJECT IS PROHIBITED. ANY ALTERATION OR REPRODUCTION OF THIS DOCUMENT IS ALSO PROHIBITED WITHOUT THE WRITTEN CONSENT OF THE ARCHITECT OR ENGINEER.

ARCHITECTS
LANDSCAPE ARCHITECTS
ENGINEERS

BRANCH PROJECT CONTACT:
187 WOLF ROAD, STE. 205
ALBANY
NEW YORK 12205

ALBANY
NEW YORK 12205

ALBANY
1. 631.475.0349

www.BBSARCHITECTURE.COM

F. 631.475.0361

T. 518.621.7650

SED No.

66-01-02-06-0-003-021

DISTRICT BEDFORD CENTRAL SCHOOL DISTRICT

PROJECT
PHASE 1A - BOND IMPROVEMENTS


DWG TITLE
SECOND FLOOR KEY PLAN

 SCALE:
 AS NOTED

 DATE:
 BID P/U DATE:
 2/2/2023 9:45:14 AM

 FILE NO.
 22-225A

A0.03 FLHS

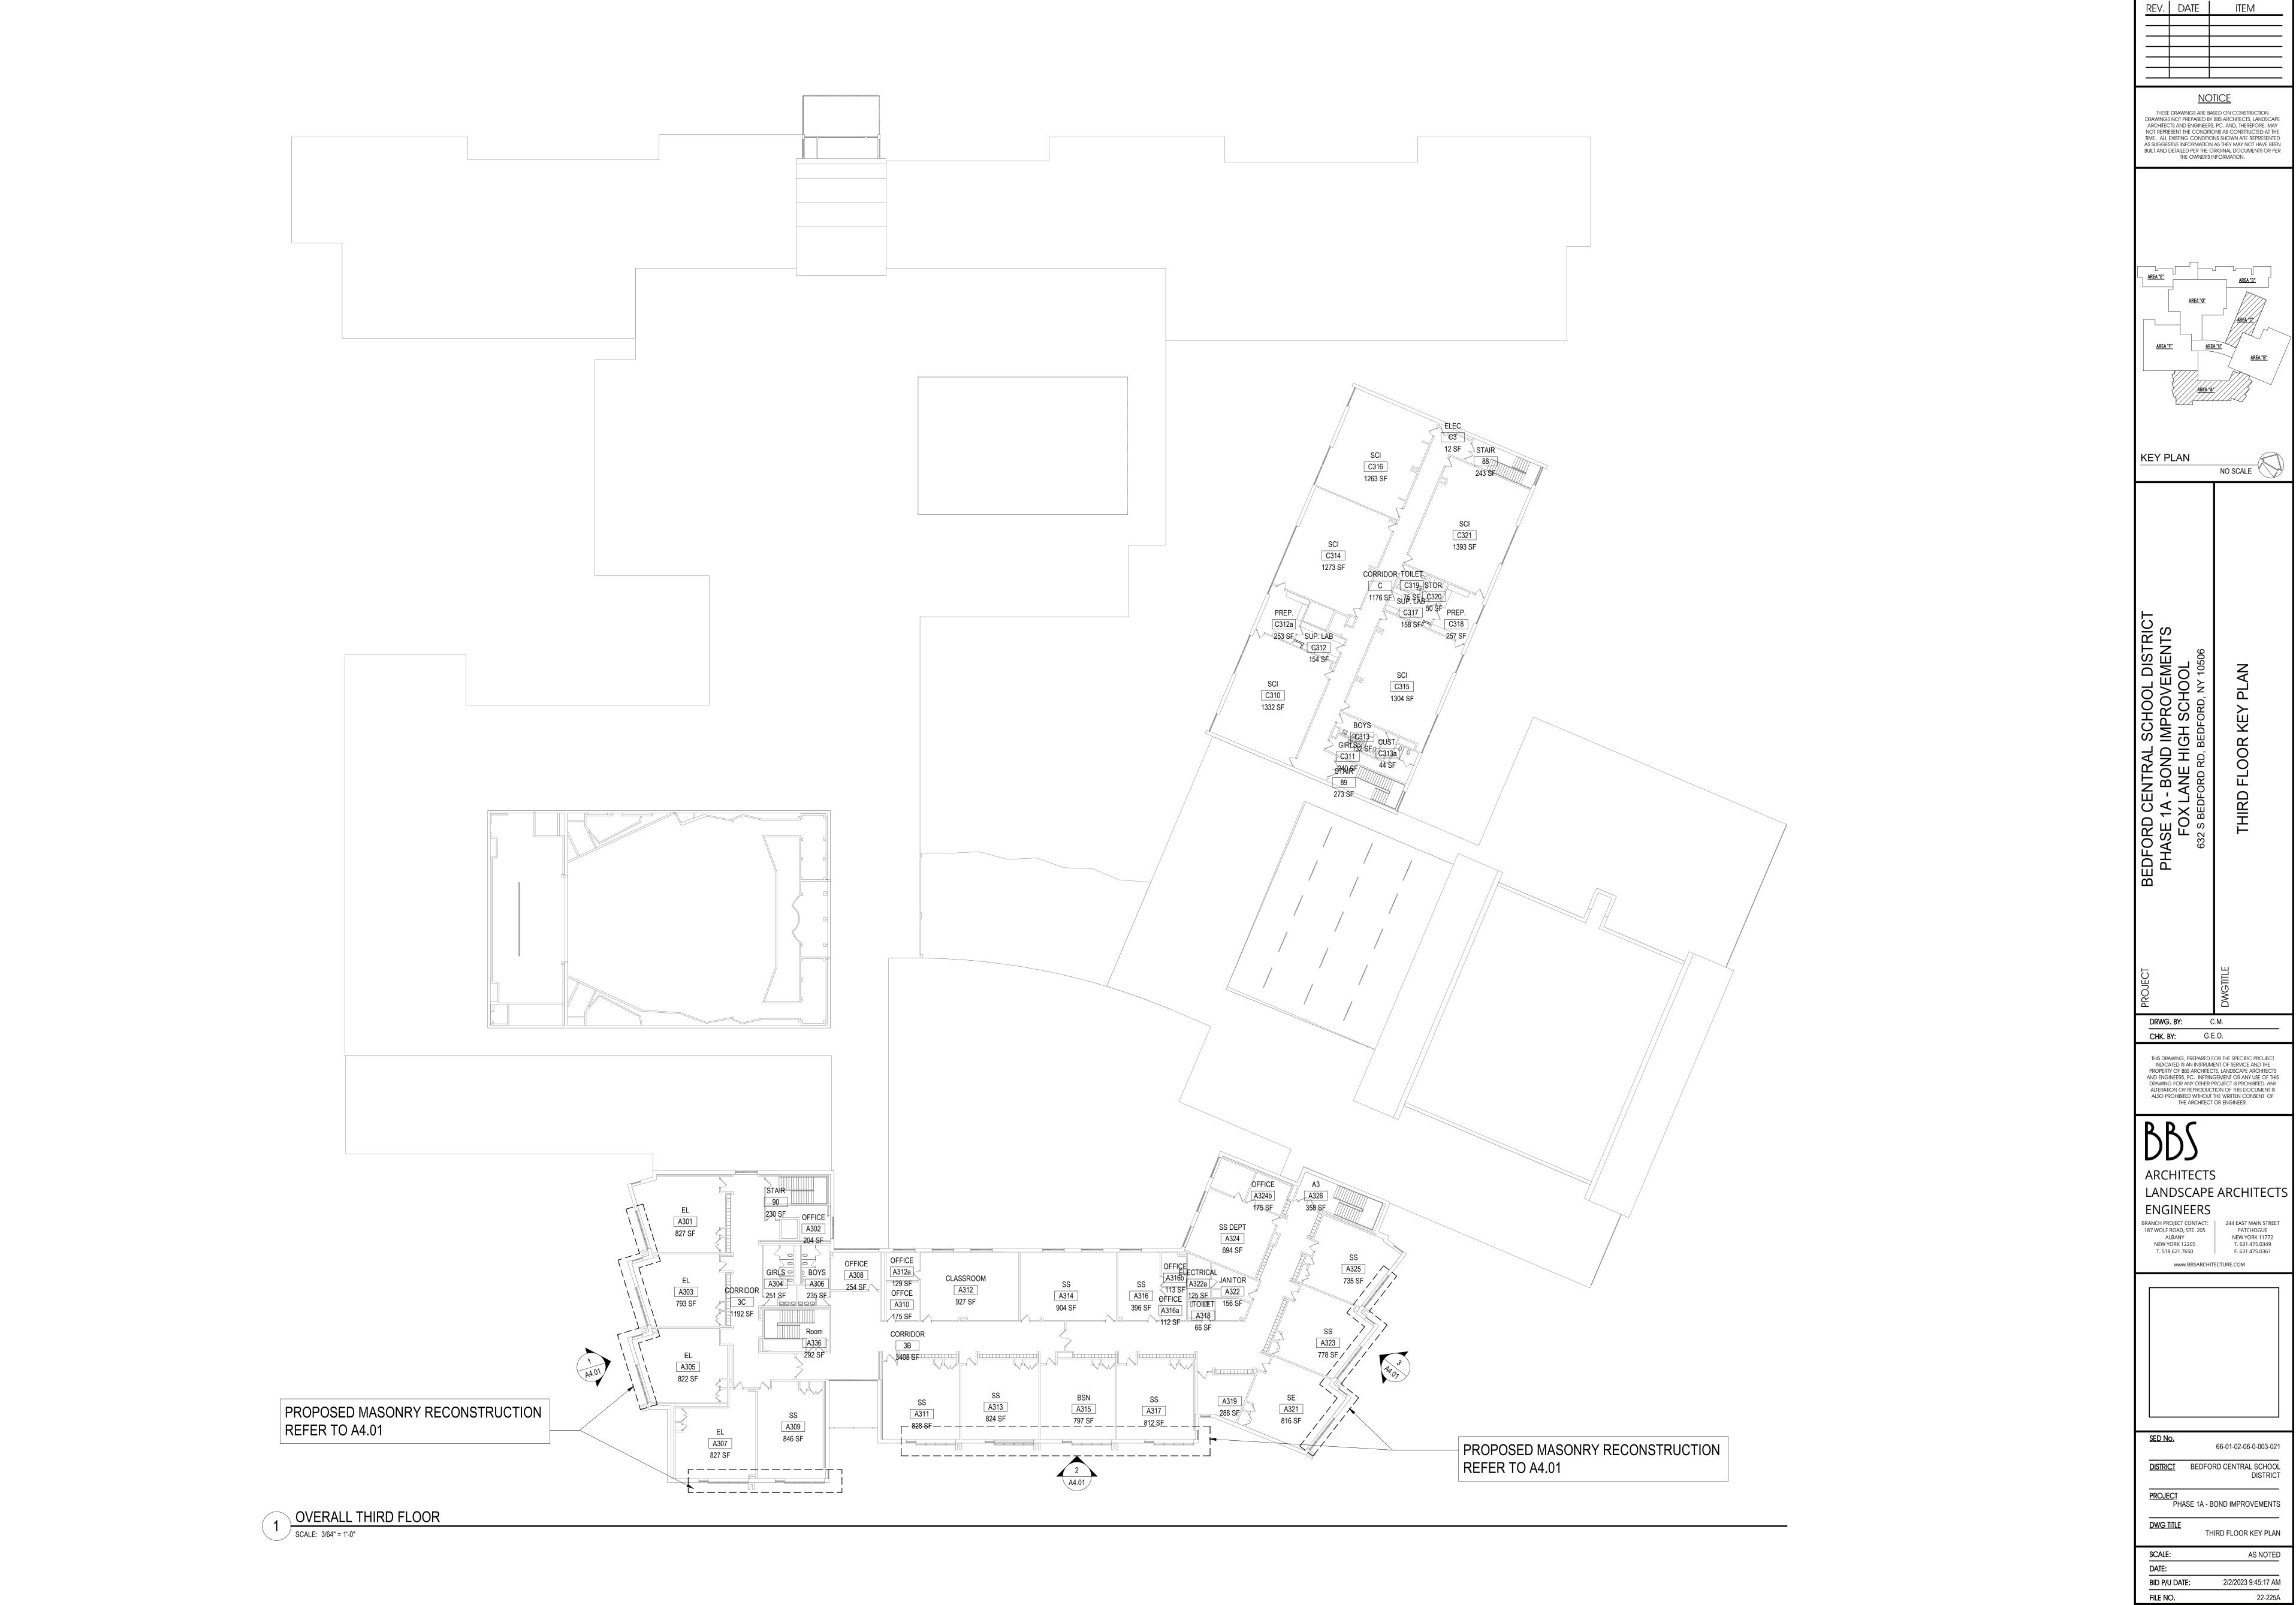

REV. DATE <u>NOTICE</u> THESE DRAWINGS ARE BASED ON CONSTRUCTION DRAWINGS NOT PREPARED BY BBS ARCHITECTS, LANDSCAPE ARCHITECTS AND ENGINEERS, PC. AND, THEREFORE, MAY NOT REPRESENT THE CONDITIONS AS CONSTRUCTED AT THE TIME. ALL EXISTING CONDITIONS SHOWN ARE REPRESENTED AS SUGGESTIVE INFORMATION AS THEY MAY NOT HAVE BEEN BUILT AND DETAILED PER THE ORIGINAL DOCUMENTS OR PER THE OWNER'S INFORMATION. NO SCALE

THIS DRAWING, PREPARED FOR THE SPECIFIC PROJECT INDICATED IS AN INSTRUMENT OF SERVICE AND THE PROPERTY OF BBS ARCHITECTS, LANDSCAPE ARCHITECTS AND ENGINEERS, PC. INFRINGEMENT OR ANY USE OF THIS DRAWING FOR ANY OTHER PROJECT IS PROHIBITED. ANY ALTERATION OR REPRODUCTION OF THIS DOCUMENT IS ALSO PROHIBITED WITHOUT THE WRITTEN CONSENT OF THE ARCHITECT OR ENGINEER.


ARCHITECTS LANDSCAPE ARCHITECTS BRANCH PROJECT CONTACT: 244 EAST MAIN STREET
187 WOLF ROAD, STE. 205 PATCHOGUE
ALBANY NEW YORK 11772
NEW YORK 12205 T. 631.475.0349 F. 631.475.0361


66-01-02-06-0-003-021 DISTRICT BEDFORD CENTRAL SCHOOL DISTRICT


THIRD FLOOR KEY PLAN AS NOTED

2/2/2023 9:45:17 AM

A0.04 FLHS

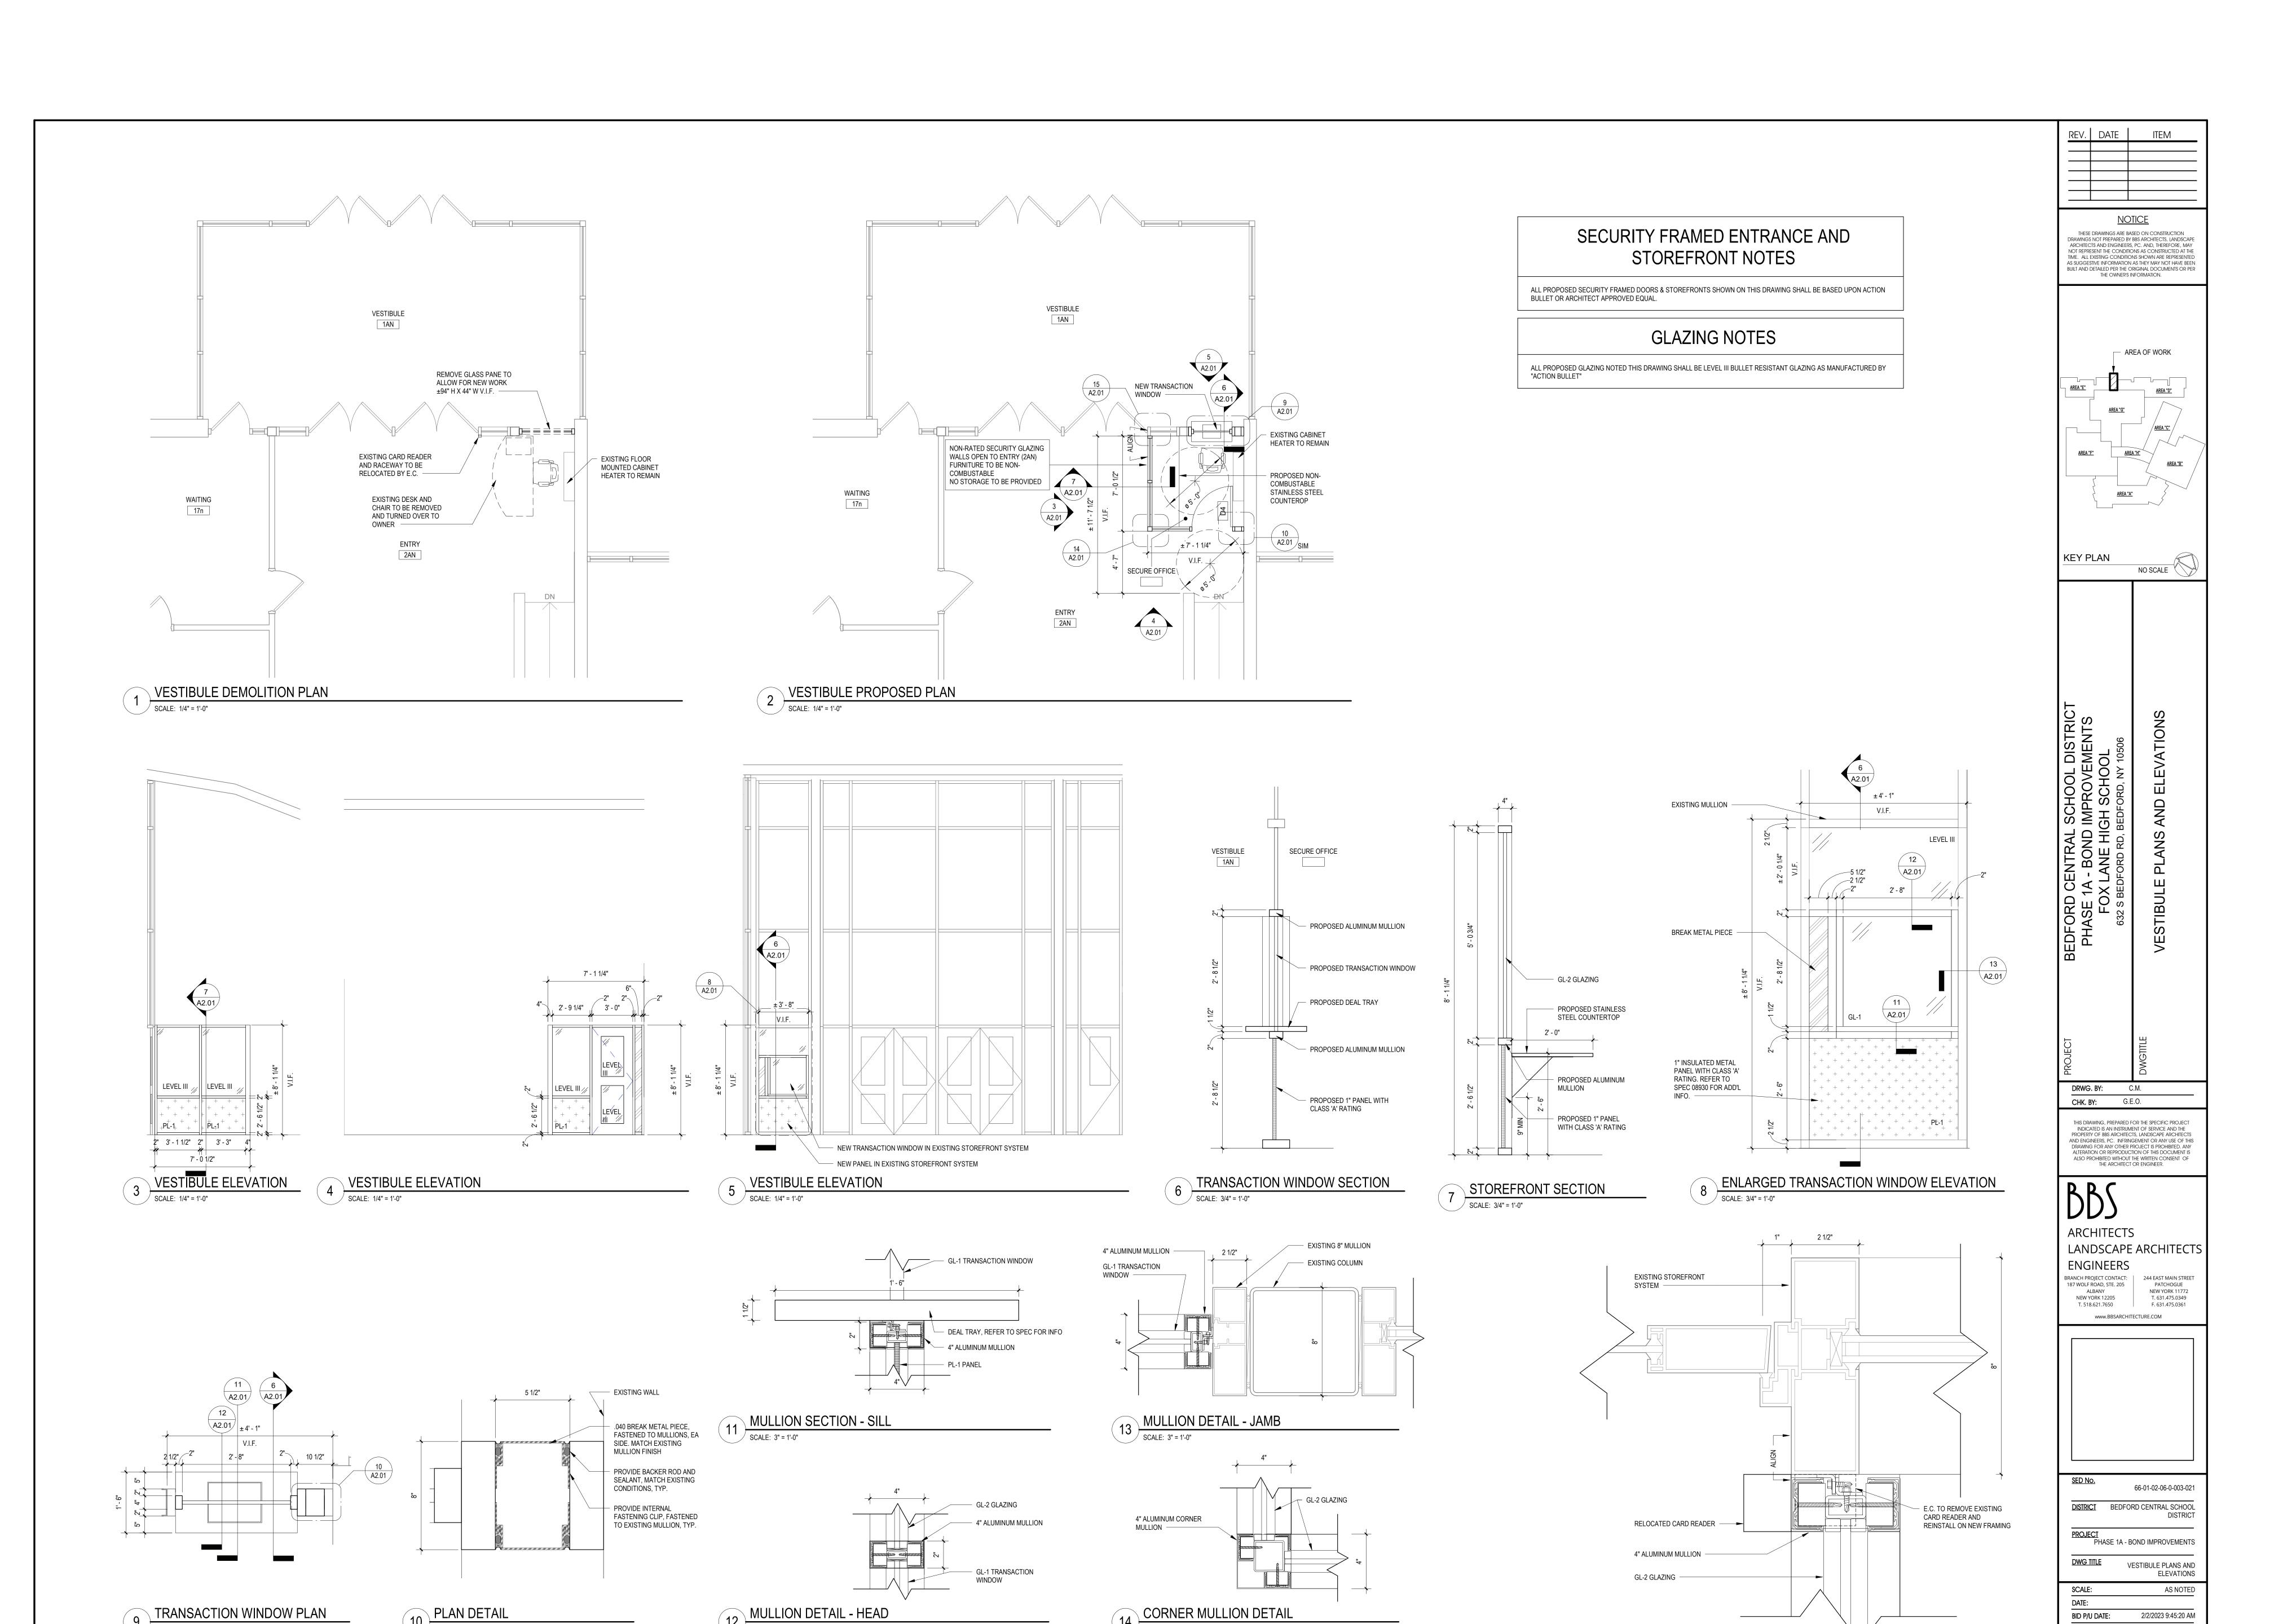

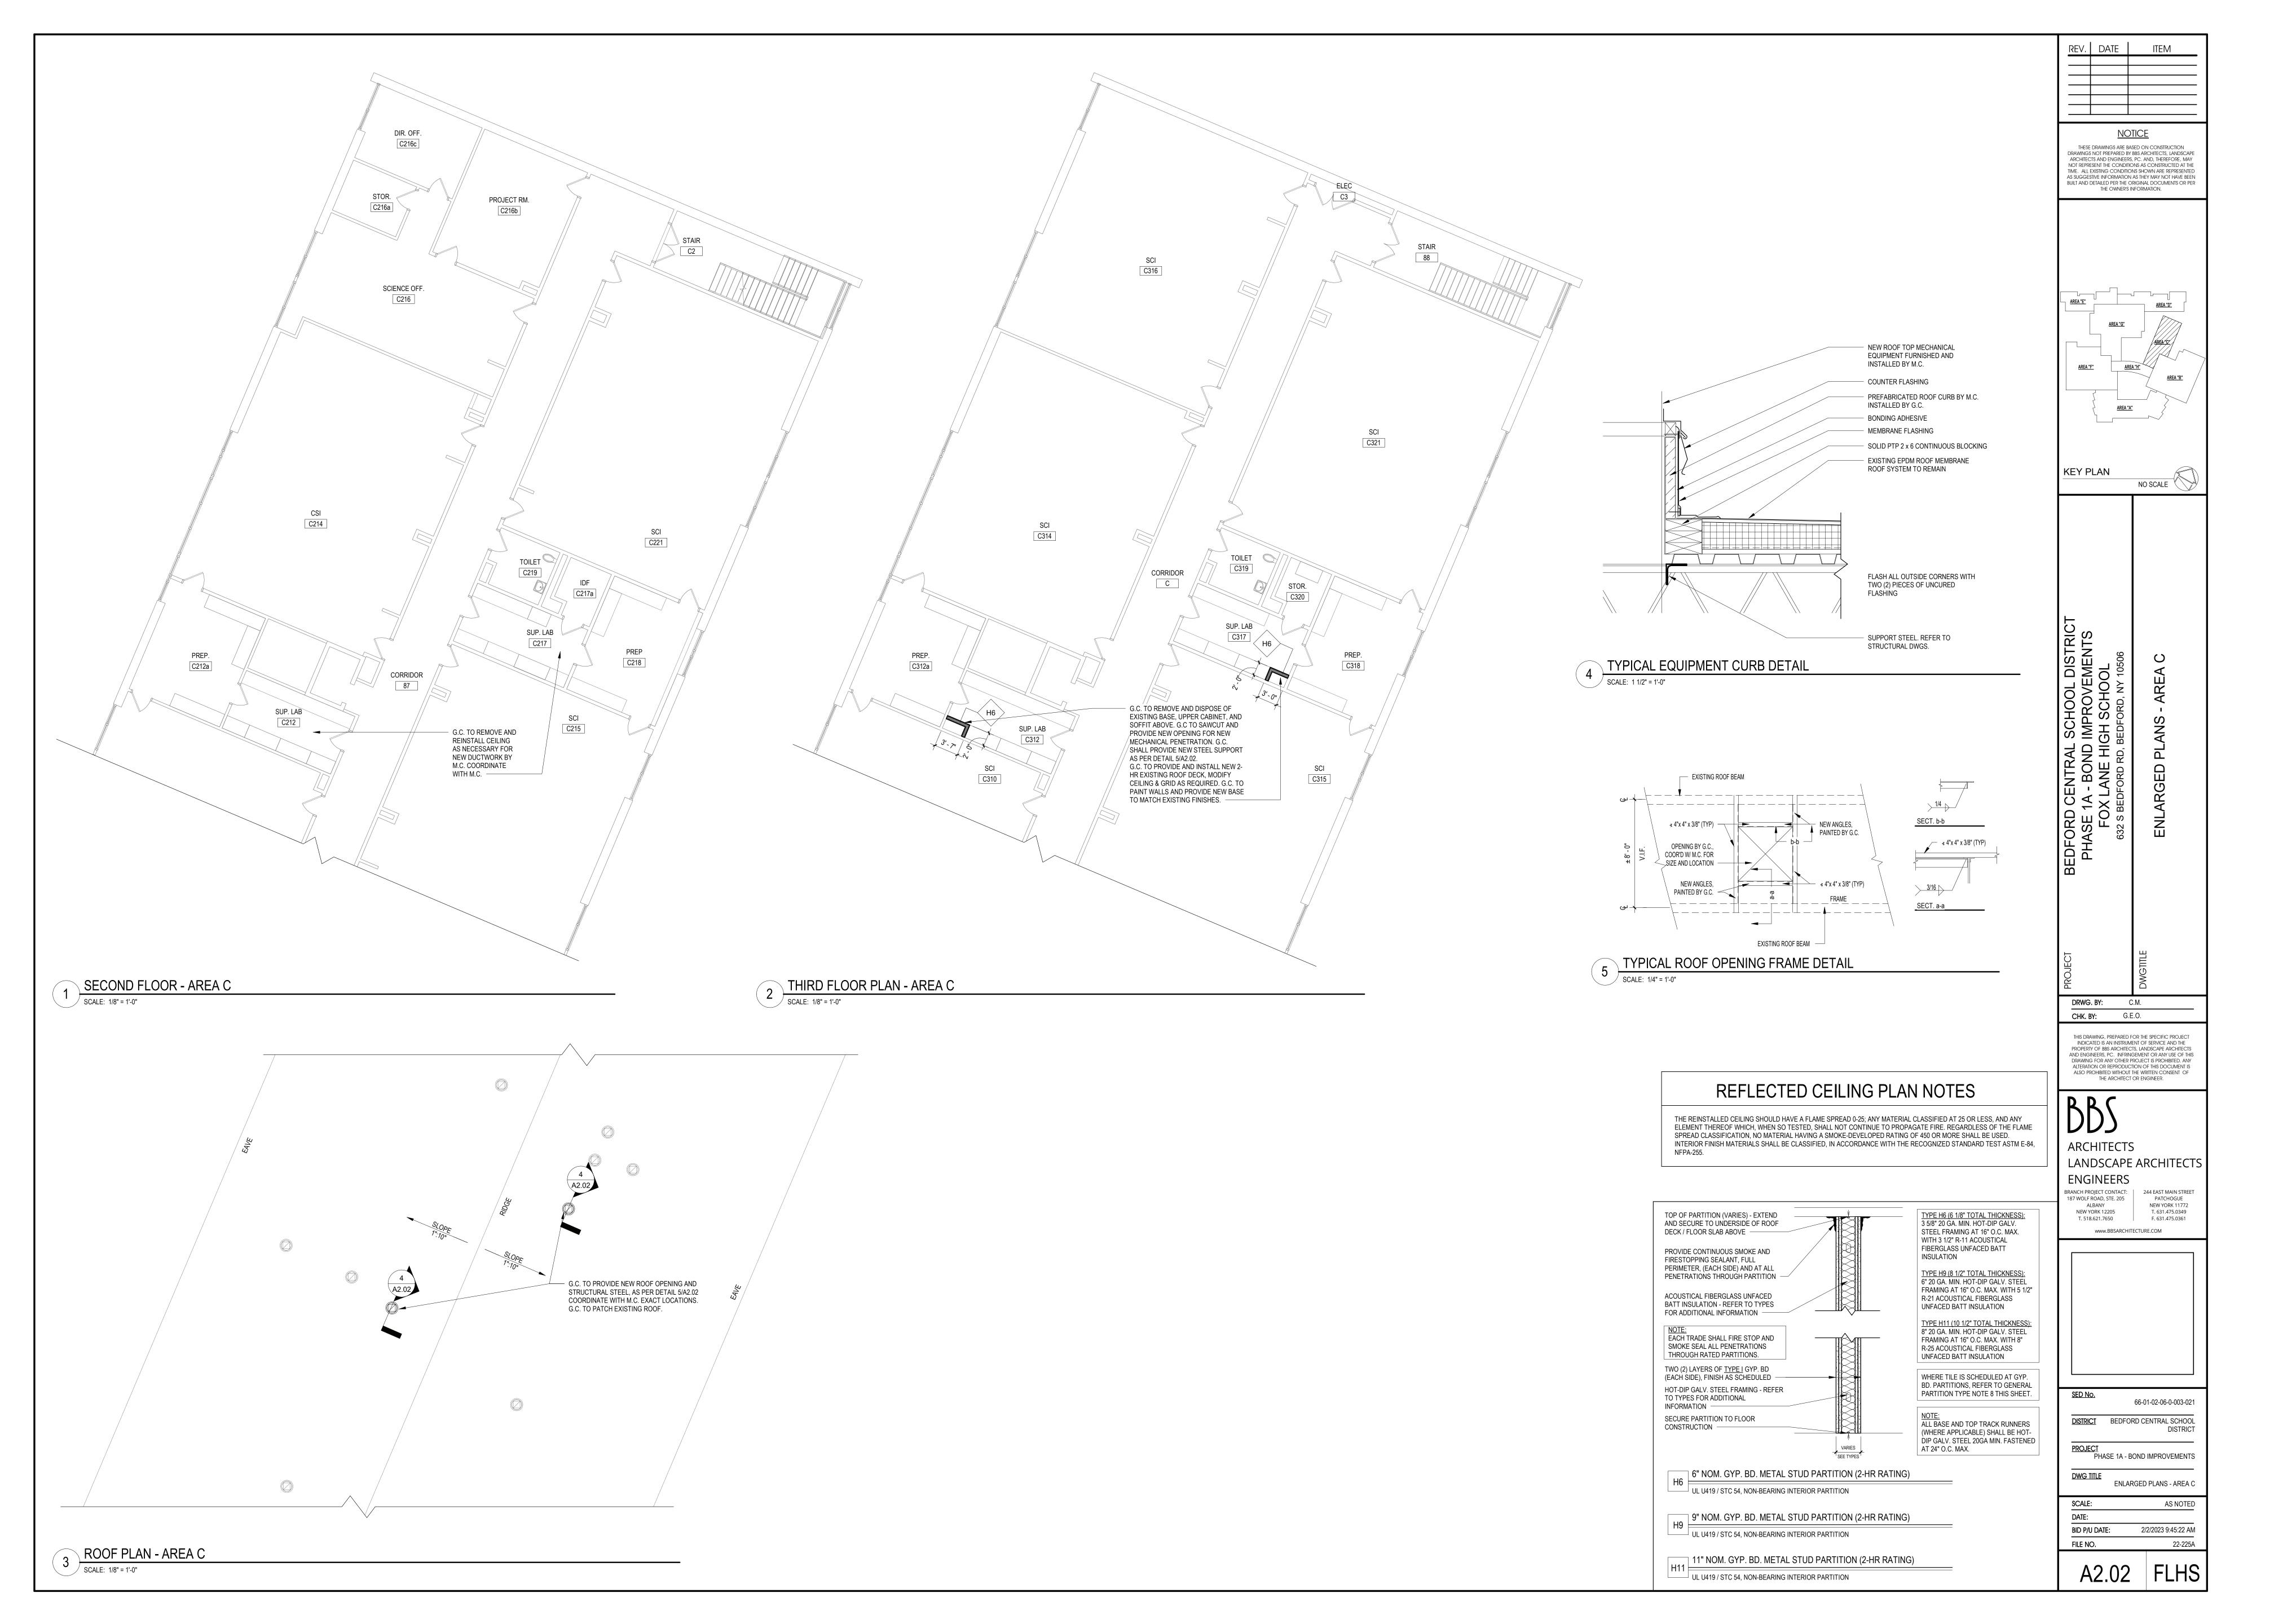


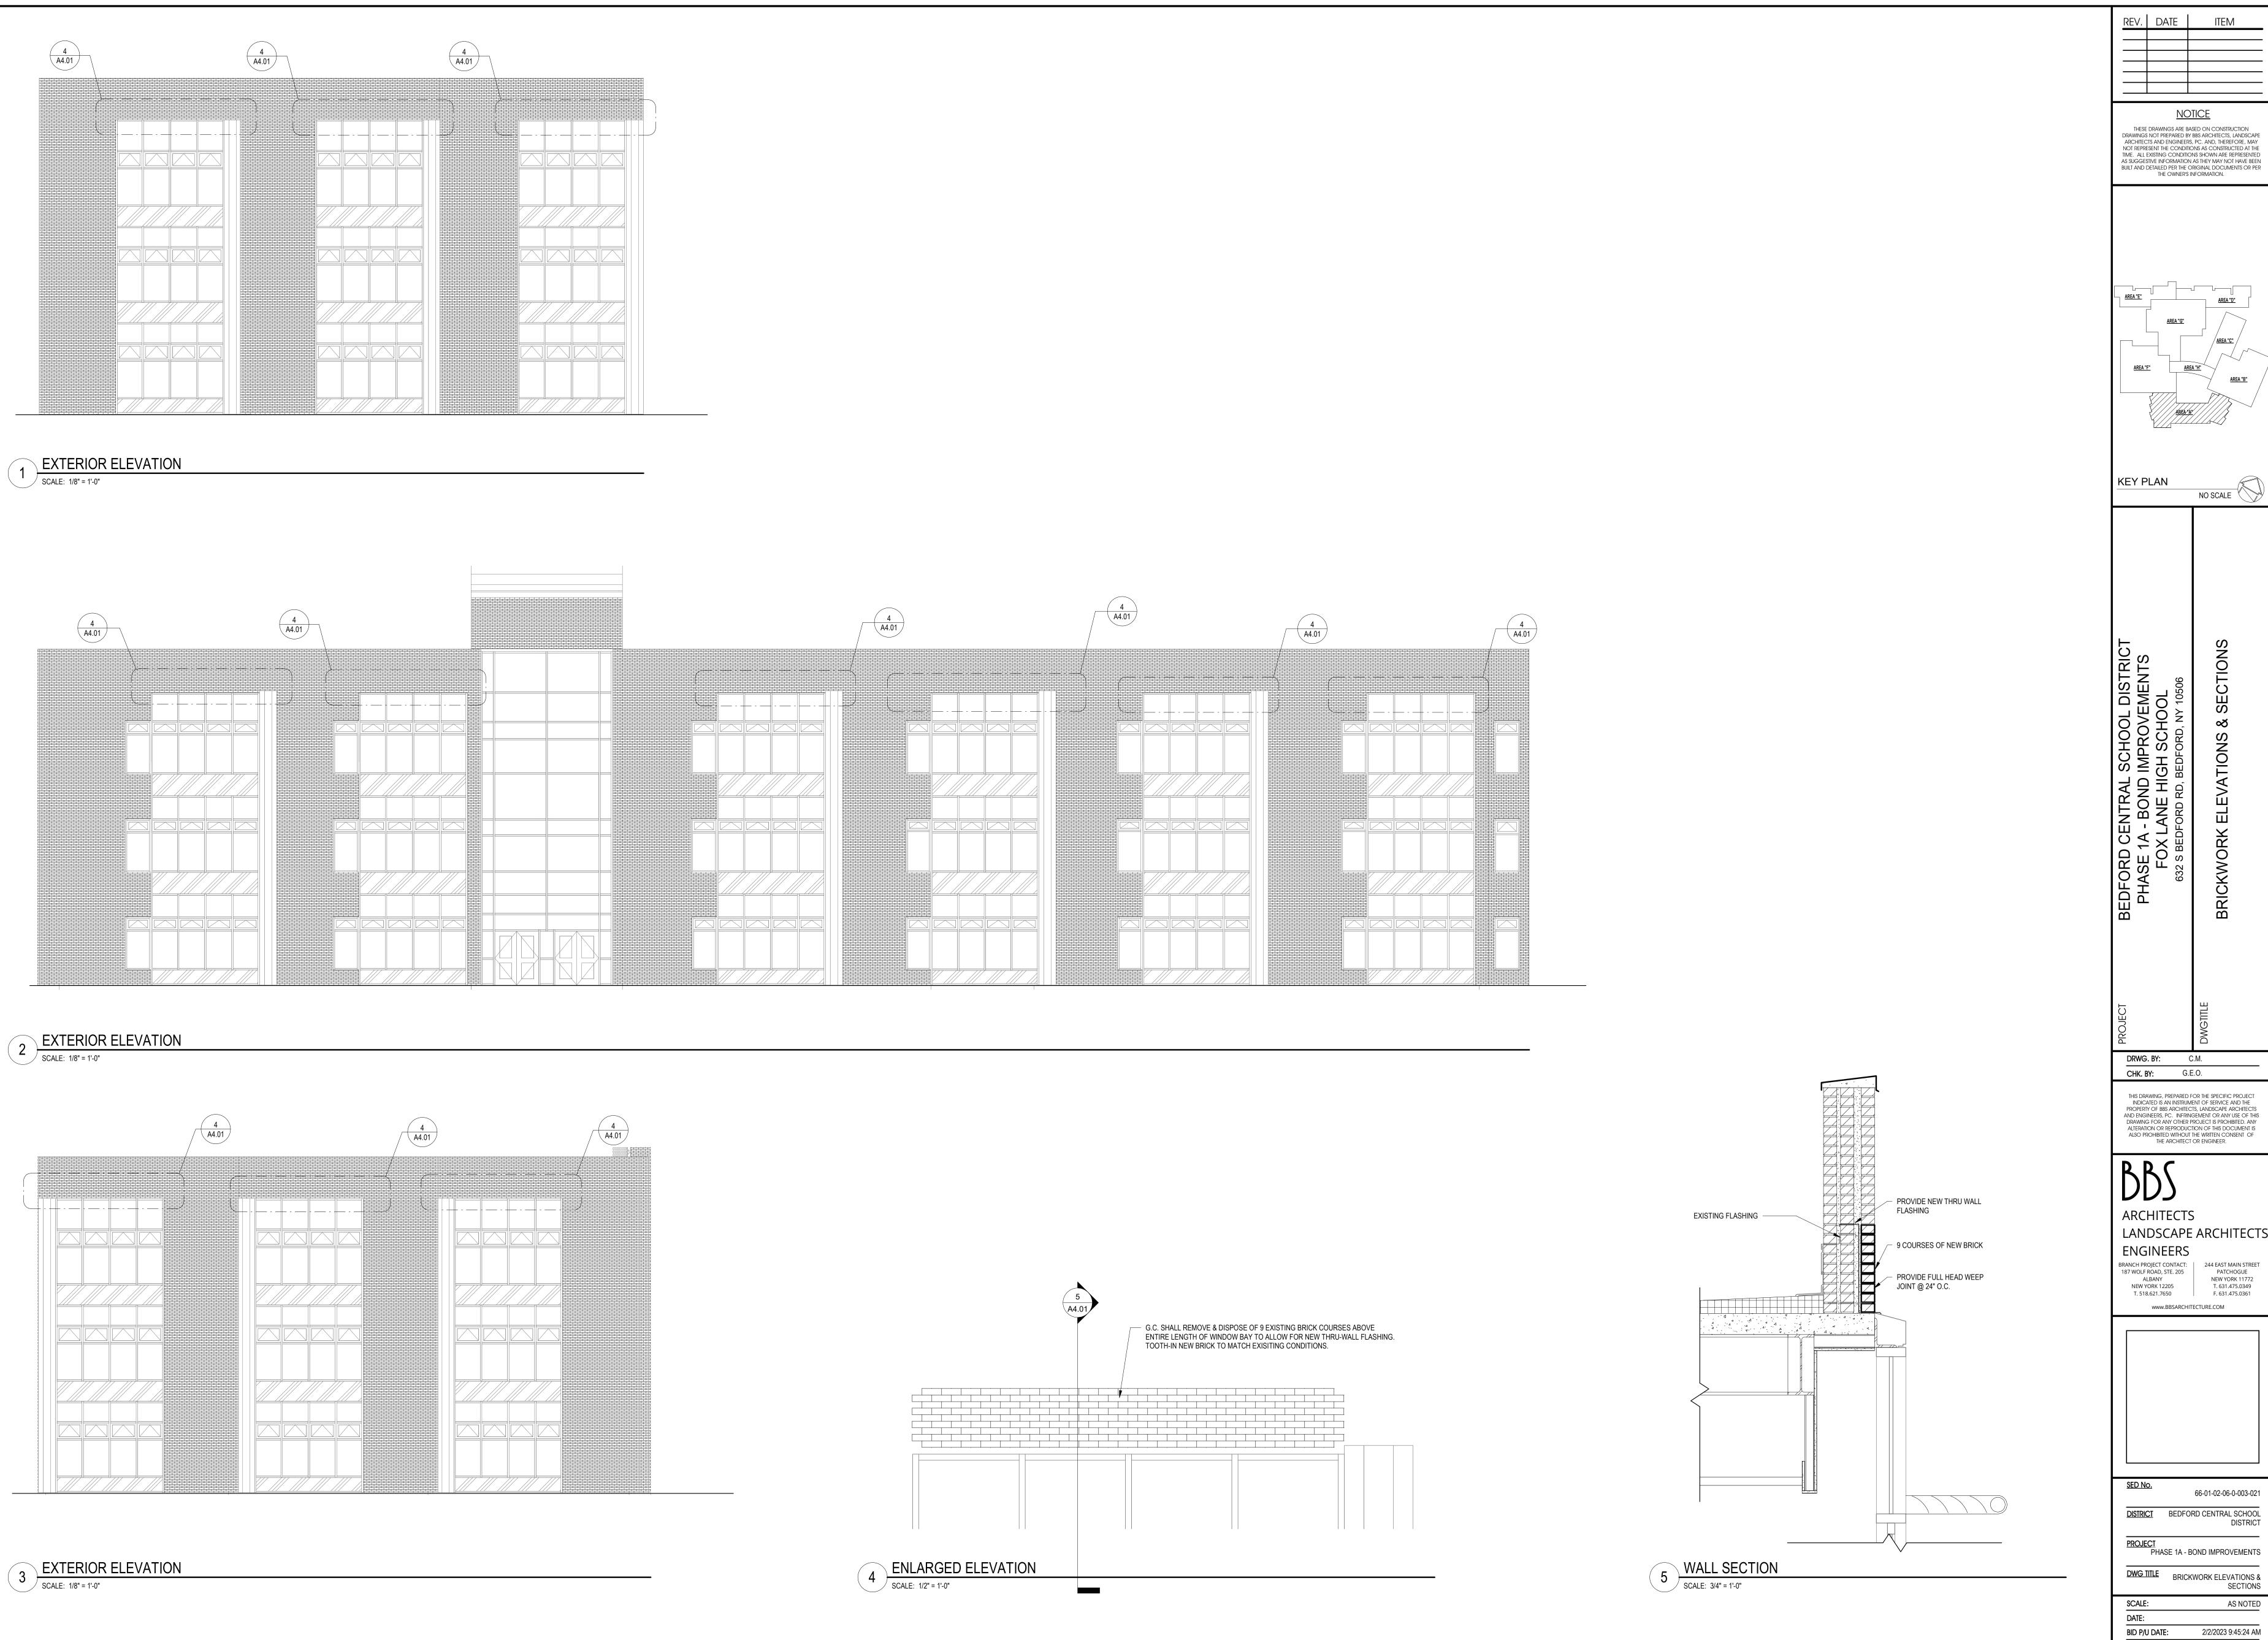


THESE DRAWINGS ARE BASED ON CONSTRUCTION DRAWINGS NOT PREPARED BY BBS ARCHITECTS, LANDSCAPE ARCHITECTS AND ENGINEERS, PC. AND, THEREFORE, MAY NOT REPRESENT THE CONDITIONS AS CONSTRUCTED AT THE TIME. ALL EXISTING CONDITIONS SHOWN ARE REPRESENTED AS SUGGESTIVE INFORMATION AS THEY MAY NOT HAVE BEEN BUILT AND DETAILED PER THE ORIGINAL DOCUMENTS OR PER THE OWNERS INFORMATION. THIS DRAWING, PREPARED FOR THE SPECIFIC PROJECT INDICATED IS AN INSTRUMENT OF SERVICE AND THE PROPERTY OF BBS ARCHITECTS, LANDSCAPE ARCHITECTS AND ENGINEERS, PC. INFRINGEMENT OR ANY USE OF THIS DRAWING FOR ANY OTHER PROJECT IS PROHIBITED. ANY ALTERATION OR REPRODUCTION OF THIS DOCUMENT IS ALSO PROHIBITED WITHOUT THE WRITTEN CONSENT OF LANDSCAPE ARCHITECTS BRANCH PROJECT CONTACT: | 244 EAST MAIN STREET 66-01-02-06-0-003-021 DISTRICT BEDFORD CENTRAL SCHOOL DISTRICT PROJECT
PHASE 1A - BOND IMPROVEMENTS DWG TITLE BRICKWORK ELEVATIONS & SECTIONS

FILE NO.

A4.01 FLHS

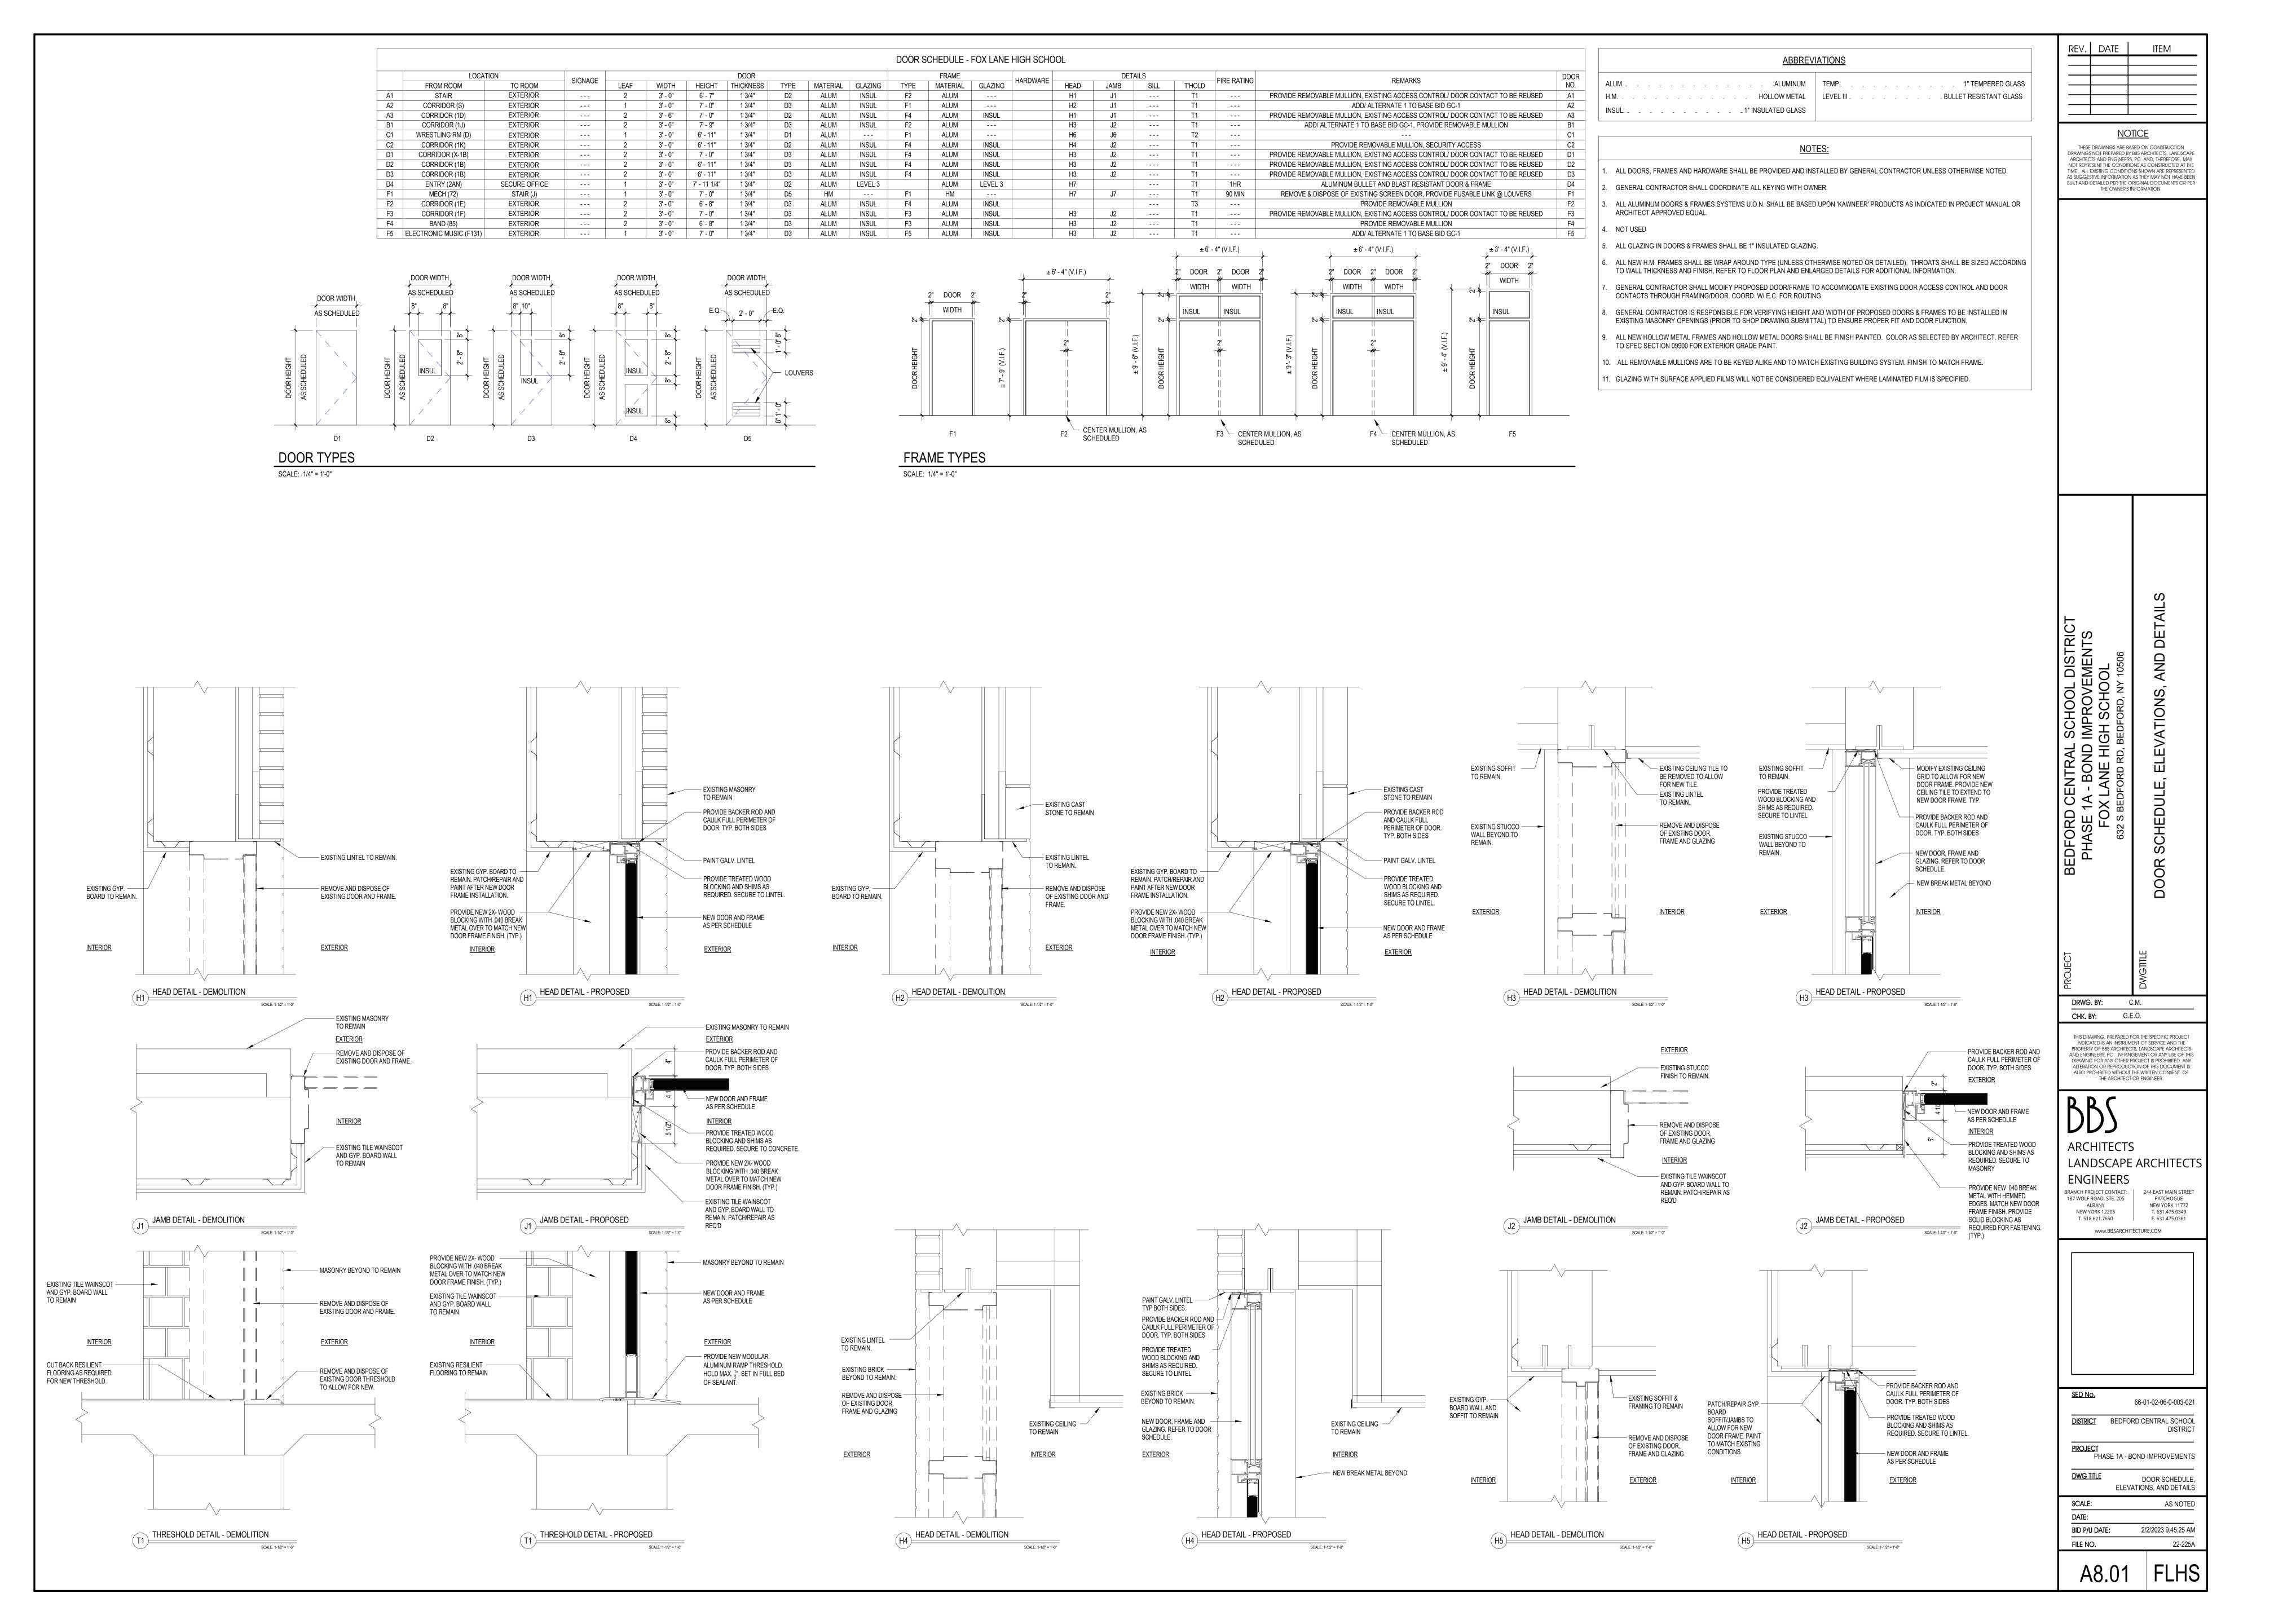

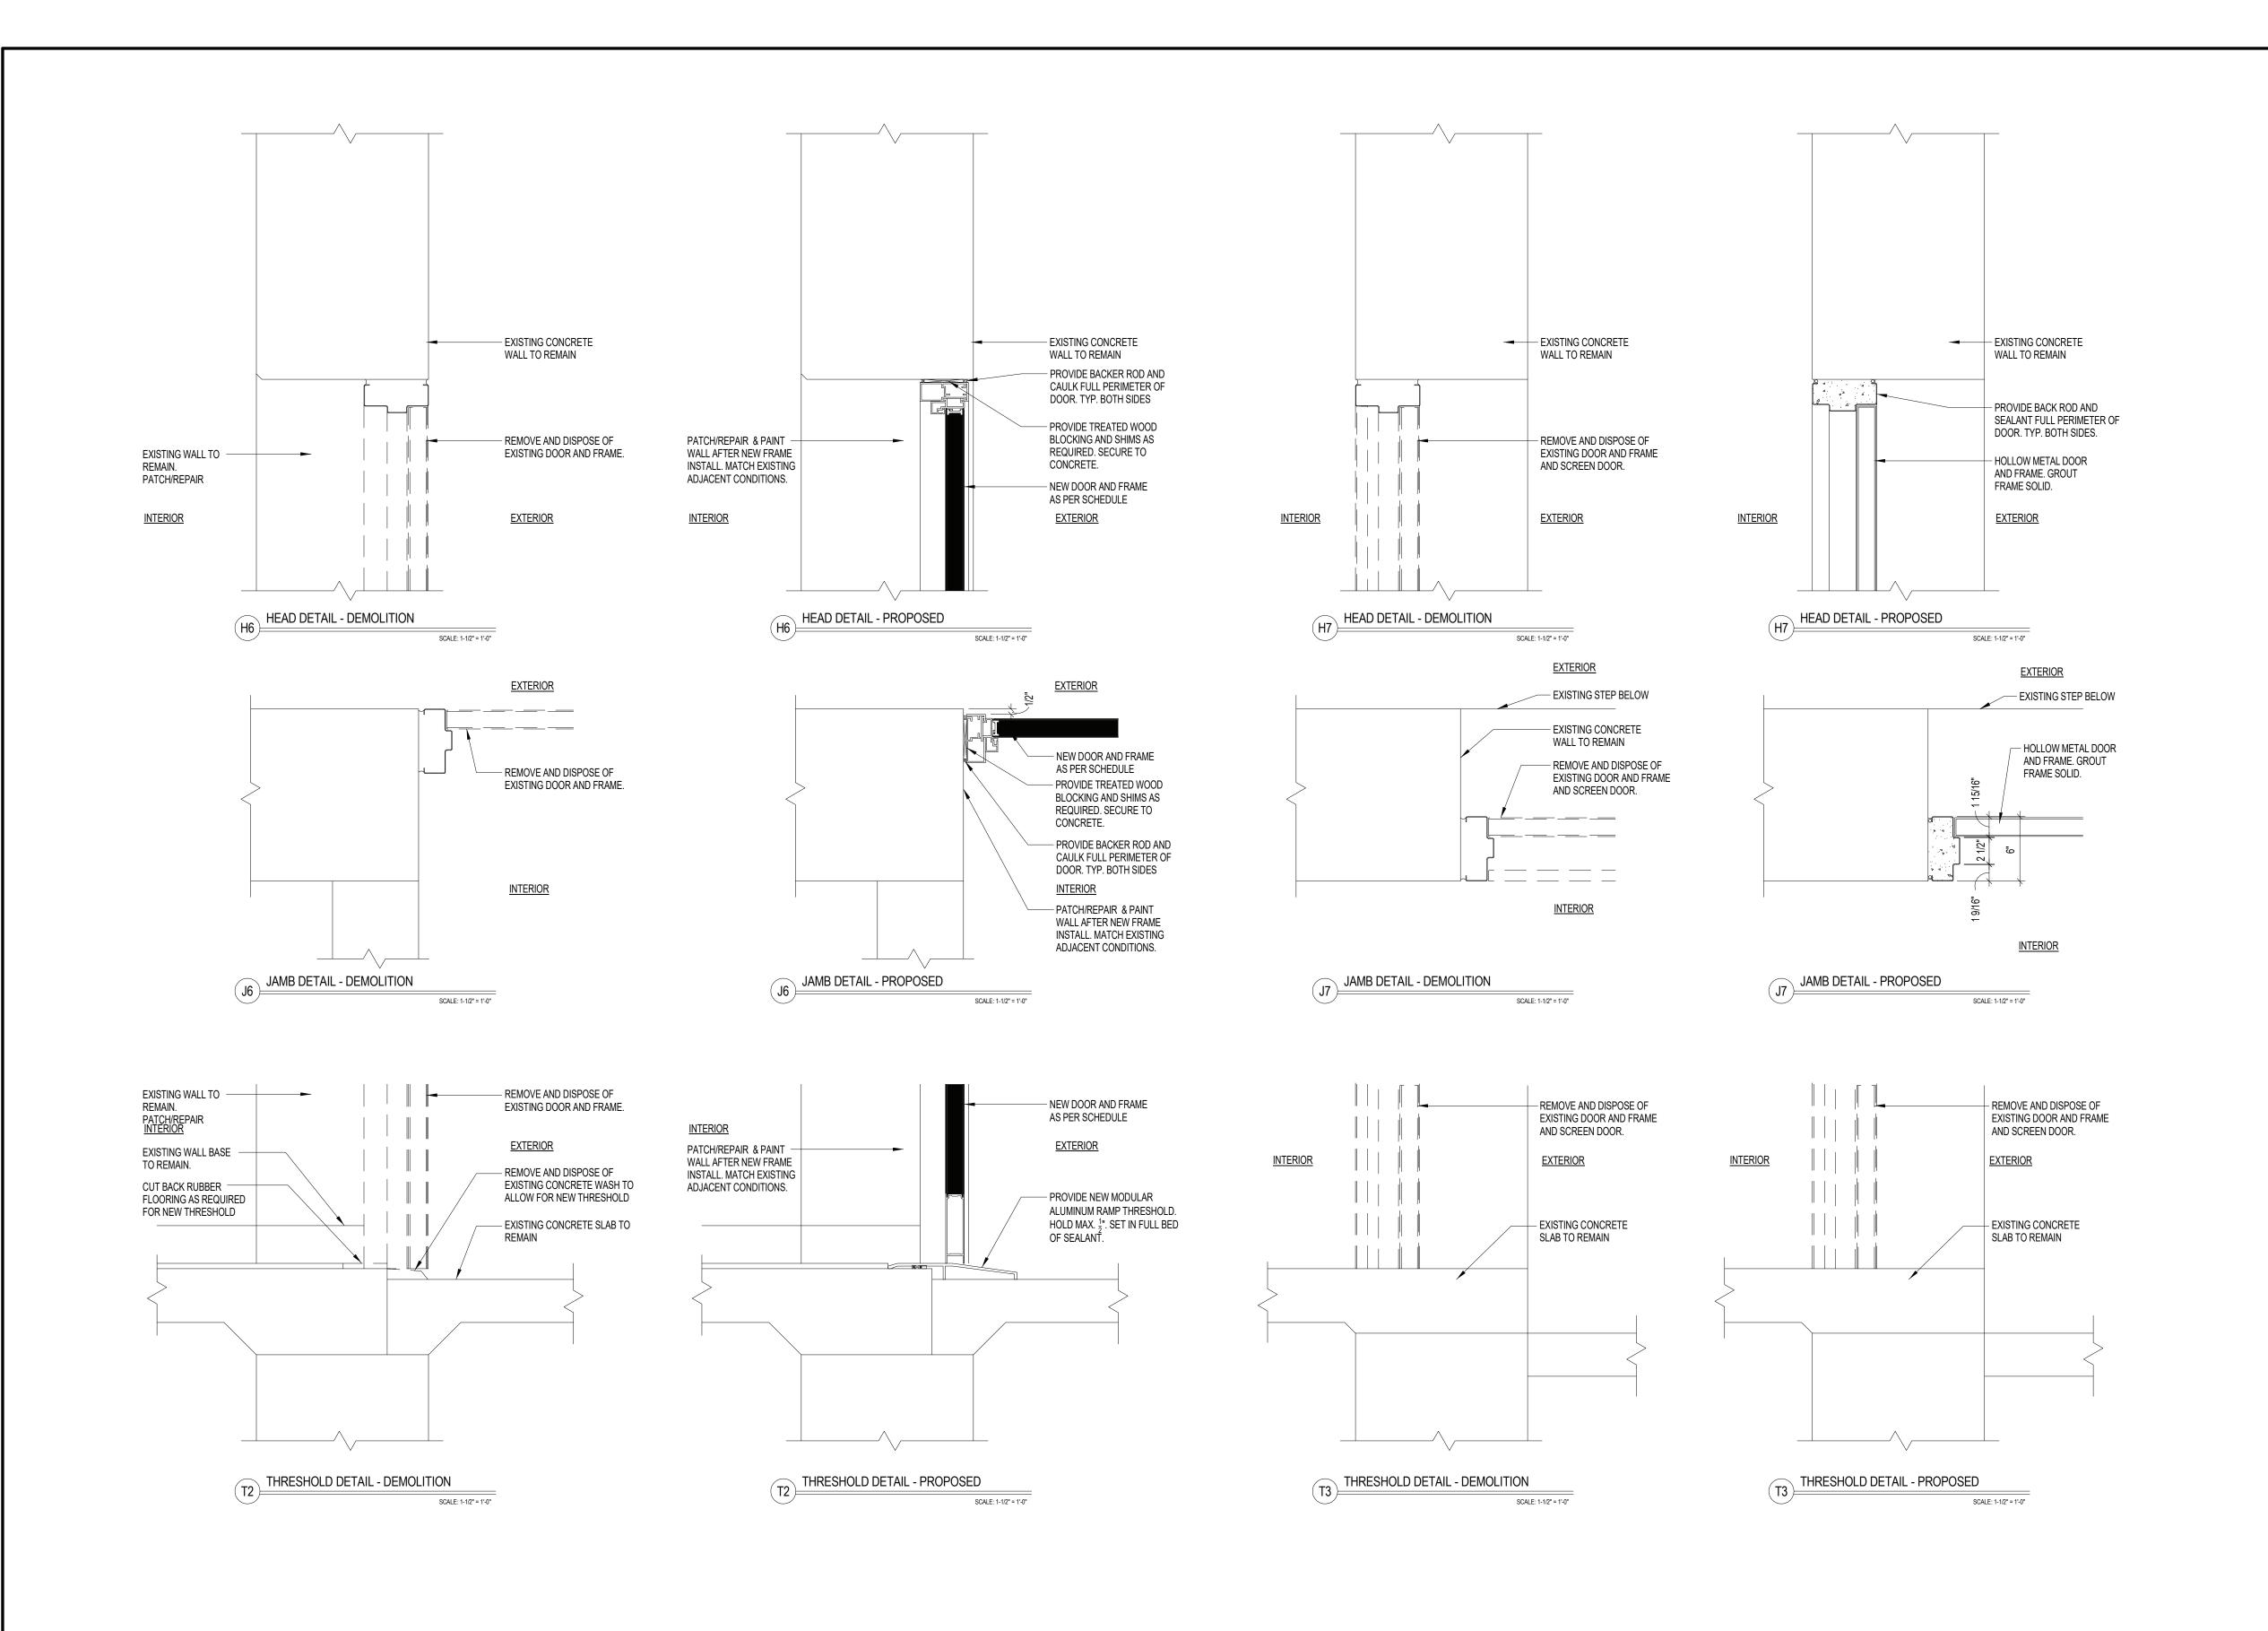

REV.	DATE		ITEM
DRAWINGS ARCHITEC NOT REPRI TIME. ALL AS SUGGES	DRAWINGS ARE IS NOT PREPARED IS TO PREPARED IS TO SENT THE CONDITION OF THE CONDITION OF THE PROPARED INFORMATION	BY BBS ARCH RS, PC. AND TIONS AS CO IONS SHOW ON AS THEY I ORIGINAL I	HITECTS, LANDSCAPE D, THEREFORE, MAY ONSTRUCTED AT THE /N ARE REPRESENTED MAY NOT HAVE BEEN DOCUMENTS OR PER
BEDFORD CENTRAL SCHOOL DISTRICT PHASE 1A - BOND IMPROVEMENTS	FOX LANE HIGH SCHOOL 632 S BEDFORD RD, BEDFORD, NY 10506		DOOR DETAILS
PROJECT	DV.	DWGTITLE	

THIS DRAWING, PREPARED FOR THE SPECIFIC PROJECT INDICATED IS AN INSTRUMENT OF SERVICE AND THE PROPERTY OF BBS ARCHITECTS, LANDSCAPE ARCHITECTS AND ENGINEERS, PC. INFRINGEMENT OR ANY USE OF THIS DRAWING FOR ANY OTHER PROJECT IS PROHIBITED. ANY ALTERATION OR REPRODUCTION OF THIS DOCUMENT IS ALSO PROHIBITED WITHOUT THE WRITTEN CONSENT OF THE ARCHITECT OR ENGINEER.

CHK. BY: G.E.O.

ARCHITECTS

LANDSCAPE ARCHITECTS

ENGINEERS

BRANCH PROJECT CONTACT: | 244 EAST MAIN STREET

187 WOLF ROAD, STE. 205 PATCHOGUE

NEW YORK 11772

T. 631.475.0349

F. 631.475.0361

ALBANY

NEW YORK 12205

T. 518.621.7650

www.BBSARCHITECTURE.COM

SED No.

66-01-02-06-0-003-021

DISTRICT BEDFORD CENTRAL SCHOOL
DISTRICT

PROJECT
PHASE 1A - BOND IMPROVEMENTS

DWG TITLE
DOOR DETAILS

 SCALE:
 AS NOTED

 DATE:
 BID P/U DATE:
 2/2/2023 9:45:25 AM

 FILE NO.
 22-225A

Δ8 02 FI HS

GENERAL NOTES

- REMOVAL & RELOCATION OF CERTAIN EXISTING WORK SHALL BE NECESSARY FOR THE PERFORMANCE OF THE NEW WORK SHOWN HEREIN. ALL EXISTING CONDITIONS ARE NOT COMPLETELY DETAILED ON THI DRAWINGS. THE CONTRACTOR SHALL SURVEY THE SITE & MAKE ALL NECESSARY CHANGES BASED ON EXISTING CONDITIONS AS REQUIRED FOR PROPER DEMOLITION OF EXISTING WORK & SHALL INCLUDE ALL MATERIALS & LABOR FOR SAME IN HIS BID PRICE. NO ALLOWANCE WILL BE MADE FOR FAILURE TO DO SO.
- PRIOR TO SUBMITTING A BID, THE CONTRACTOR SHALL VISIT THE PREMISES OF THE PROPOSED WORK & SHALL CAREFULLY EXAMINE THE ENGINEERING DRAWINGS, EXISTING CONDITIONS & LIMITATIONS THEREOF. VERIFY ACTUAL LOCATIONS WHERE THE NEW PIPING WILL BE ROUTED, COORDINATE WITH NEW & EXISTING WORK & PROVIDE CLEARANCE W/ BUILDING STRUCTURE, OTHER SERVICES, ETC., THE CONTRACTOR SHALL INCLUDE ALL COSTS WHATSOEVER WHICH ARE INCURRED AS A RESULT OF LIMITATIONS OF THE EXISTING & NEW CONDITIONS. LATER CLAIMS FOR EXTRA LABOR, EQUIPMENT MATERIALS, ETC. REQUIRED DUE TO DIFFICULTIES WHICH COULD HAVE BEEN FORESEEN WILL NOT BE CONSIDERED AS EXTRA WORK.
- INSTALL WORK SO AS TO BE READILY ACCESSIBLE FOR OPERATING, MAINTENANCE & REPAIR. MINOR DEVIATIONS FROM DRAWINGS MAY BE MADE TO ACCOMPLISH THIS, BUT CHANGES OF MAGNITUDE WHICH INVOLVE EXTRA COST SHALL NOT BE MADE WITHOUT APPROVAL.
- INVESTIGATE EACH SPACE THROUGH WHICH EQUIPMENT MUST BE MOVED. WHEN NECESSARY, EQUIPMENT SHALL BE SHIPPED FROM MANUFACTURER IN CRATED SECTIONS OF SIZE SUITABLE FOR MOVING THROUGH AREAS AVAILABLE. ASCERTAIN FROM BUILDING OWNER AT WHAT TIMES OF DAY EQUIPMENT MAY BE MOVED THROUGH THE BUILDING.
- COORDINATE THE EXACT SIZE & LOCATION OF NEW OPENINGS WITH EXISTING STRUCTURE. PATCH / INSULATE AS REQUIRED. CONTRACTOR SHALL FIRESTOP ALL PENETRATIONS FROM NEW PIPING, CONDUIT, DUCTWORK, ETC. THROUGH EXISTING OR NEW FIRE/ SMOKE BARRIERS. REFER TO SPECIFICATION SECTION 15511 FOR FURTHER DETAILS.
- IT IS THE INTENT OF THIS CONTRACT FOR REMAINING SYSTEMS TO BE LEFT IN GOOD WORKING ORDER, READY FOR OPERATION. COORDINATE ANY REQUIRED SYSTEM SHUTDOWNS WITH OWNER 48 HOURS IN ADVANCE. EXISTING SYSTEM SHUTDOWNS WILL NOT BE PERMITTED IF THEY INTERFERE WITH THE DAILY OPERATIONS OF THE BUILDING. CONTRACTOR WILL BE REQUIRED TO TAKE PROPER PRECAUTIONS AGAINST DAMAGING OR DISRUPTING BUILDING SYSTEMS, WIRING, PIPING OR CONTROL TUBING. ANY DAMAGE TO THESE ITEMS SHALL BE REPAIRED AT THE CONTRACTOR'S COST AS A PART OF THIS
- THE CONTRACTOR SHALL REPAIR / RESTORE TO ORIGINAL CONDITION ANY EXISTING EQUIPMENT OF MATERIALS DAMAGED IN THE PROCESS OF INSTALLATION, OR DEMOLITION TO THE SATISFACTION OF THI OWNER'S REPRESENTATIVE. CONTRACTOR SHALL MAKE REPAIRS USING THE SAME OR EQUIVALENT MATERIALS. WORK WILL BE PERFORMED AT THE CONTRACTOR'S COST.
- CONTRACTOR SHALL INCUR ANY COSTS OR BURDENS ASSOCIATED WITH LOST OR STOLEN EQUIPMENT / MATERIALS.
- MATERIAL ACCUMULATED AS A RESULT OF HIS OPERATIONS ON A DAILY BASIS. ALL AREAS / EQUIPMENT AFFECTED UNDER THIS CONTRACT SHALL BE KEPT CLEAN OF DUST / DEBRIS. ALL AREAS SHALL RECEIVE A FINAL CLEANING PRIOR TO FINAL ACCEPTANCE BY THE OWNER.

DURING THE LIFE OF THE CONTRACT PERIOD, CONTRACTOR SHALL REMOVE ALL RUBBISH / EXCESS

- PROVIDE FOR LEGAL REMOVAL / DISPOSAL OF ALL RUBBISH / DEBRIS FROM THE BUILDING & SITE. PROTECT ALL WORK NOT SLATED FOR DEMOLITION.
- THIS CONTRACTOR SHALL COORDINATE HIS WORK WITH ALL OTHER TRADES PRIOR TO SCHEDULING THE WORK. WORK SHALL BE PERFORMED IN PROPER SEQUENCE, AS AGREED TO BY ALL TRADES. ANY COSTS INCURRED BY THE OWNER DUE TO IMPROPER SEQUENCING OF WORK WILL BE PAID FOR BY THIS
- CONTRACTOR SHALL OBTAIN ALL PERMITS, PAY ALL FEES, CONNECTION CHARGES, ETC. ASSOCIATED WITH THE WORK UNDER THEIR CONTRACT.
- PAINT / TOUCH UP ALL SURFACES MARRED AS A RESULT OF THE PERFORMANCE OF THE CONTRACT
- THE MECHANICAL CONTRACTOR SHALL REFER TO / REVIEW ALL OTHER TRADE DRAWINGS IN THE BID PACKAGE & SHALL BE RESPONSIBLE FOR / PERFORM ALL WORK INDICATED AS (M.C.) MECHANICAL WORK AS A PART OF THE BASE BID UNLESS SPECIFICALLY NOTED OTHERWISE.
- SUBSTITUTED EQUIPMENT OF GREATER OR LARGER POWER. DIMENSIONS, CAPACITIES & RATINGS MAY BE FURNISHED PROVIDED THAT SAID EQUIPMENT IS APPROVED IN WRITING PRIOR TO ORDER. ANY CONNECTING MECHANICAL SERVICES, ELECTRICAL SERVICES, BASES, STRUCTURAL APPURTENANCES, ETC. REQUIRED TO BE INCREASED DUE TO THE USE OF SAID EQUIPMENT WILL BE PAID FOR IN FULL BY THE MECHANICAL CONTRACTOR, INCLUDING ANY ADDITIONAL REQUIRED ENGINEERING FEES.
- . EACH PIECE OF EQUIPMENT SHALL BE PROVIDED WITH A PERMANENT TYPE LAMINATED, BLACK FINISH WHITE CORE, PHENOLIC NAMEPLATE. NAMEPLATES SHOULD INDICATE THE NAME & NUMBER OF THE UNIT UNIT VOLTAGE, & ANY INTERLOCK REFERENCE. STARTERS / DISCONNECT SWITCHES SHOULD ALSO BE EQUIPPED WITH AN IDENTICAL NAMEPLATE WITH THE SAME INFORMATION.
- "ATTIC STOCK" UPON COMPLETION OF THE PROJECT, MECHANICAL CONTRACTOR SHALL COMPLETELY REMOVE / DISPOSE OF FILTERS USED DURING CONSTRUCTION & START-UP PROCEDURES. INSTALL NEW FILTERS IN ALL EQUIPMENT, MERV-8 OR BETTER UPON TURN OVER OF THE PROJECT TO THE OWNER. IN ADDITION, PROVIDE (2) COMPLETE SETS OF FILTERS FOR EACH PEICE OF EQUIPMENT & TURN OVER TO
- . MECHANICAL CONTRACTOR SHALL PROVIDE (1) SPARE MOTOR FOR EACH SIZE MOTOR USED ON THE PROJECT. IN INSTANCES WHERE MORE THAN TEN OF THE SAME MOTOR ARE USED, MECHANICAL CONTRACTOR SHALL PROVIDE (1) SPARE MOTOR FOR EVERY TEN MOTORS OF A GIVEN SIZE USED ON THE
- MAINTENANCE MANUAL: UPON COMPLETION OF THE PROJECT, THE MECHANICAL CONTRACTOR SHALL PROVIDE A BINDER CONTAINING THE OPERATIONS & MAINTENANCE MANUALS FOR EACH NEW PEICE OF EQUIPMENT INSTALLED UNDER THIS PROJECT. THE FIRST SECTION OF THE MAINTENANCE MANUAL SHALL CONTAIN A LIST OF EACH PEICE OF EQUIPMENT, COMPLETE WITH INFORMATION SHOWING APPROPRIATE REPLACEMENT FILTER SIZES / TYPES, APPROPRIATE REPLACEMENT BELT SPECIFICATIONS, REPLACEMENT MOTOR SPECIFICATIONS, REPLACEMENT BEARING SPECIFICATIONS, VOLTAGES OF UNIT, ETC. THIS SHALL SERVE AS A WRITTEN DATABASE DESCRIBING ALL MAINTENANCE INFORMATION FOR EACH NEW PEICE OF EQUIPMENT USED.

BOILER ROOM and PIPING NOTES

- THE DRAWINGS SHOW THE GENERAL ARRANGEMENT OF ALL PIPING & EQUIPMENT, & INDICATE THI REQUIRED SIZE / POINTS OF TERMINATION OF THE PIPING & SUGGEST PROPER ROUTING OF SAME. IT IS NOT THE INTENTION OF THE DRAWINGS TO SHOW ALL NECESSARY OFFSETS, RISES, DROPS, OBSTRUCTIONS OR STRUCTURAL CONDITIONS. IT SHALL BE THE RESPONSIBILITY OF THIS CONTRACTOR TO INSTALL HIS WORK IN SUCH A MANNER THAT IT WILL CONFORM TO THE STRUCTURE, AVOID OBSTRUCTIONS, PRESERVE HEADROOM & KEEP OPENINGS / PASSAGEWAYS CLEAR WITHOUT FURTHER CONSTRUCTION OR COST.
- ALL FLOOR MOUNTED BOILER ROOM EQUIPMENT SHALL BE INSTALLED ON A LEVEL, REINFORCED CONCRETE HOUSEKEEPING PAD, 4" THICK MIN. UNLESS OTHERWISE NOTED. ALL HOUSEKEEPING PADS SHALL BE INSTALLED BY THE MECHANICAL CONTRACTOR. PADS SHALL BE REINFORCED W/ WELDED WIRE MESH & SHALL BE POURED USING 3,000 PSI CONCRETE.
- MECHANICAL CONTRACTOR SHALL PROVIDE & INSTALL ALL REQUIRED STRUCTURAL SUPPORTS FOR ALL PIPING SYSTEMS & EQUIPMENT AS REQUIRED. PIPING SYSTEMS SHALL BE EQUIPPED WITH EXPANSION COMPENSATORS AT THE INTERVALS REQUIRED. PROVIDE PIPING GUIDES / ANCHORS AS REQUIRED.
- MECHANICAL CONTRACTOR SHALL PROPERLY INSULATE ALL NEW PIPING SYSTEMS & EQUIPMENT. REFER TO SPECIFICATION SECTION 15250 FOR FURTHER DETAILS REGARDING INSULATION REQUIREMENTS UPON COMPLETION OF INSULATION WORK, MECHANICAL CONTRACTOR SHALL PROPERLY LABEL EACH PIPING RUN SHOWING THE TYPE OF FLUID CARRIED & DIRECTION OF FLOW. PIPE IDENTIFICATION MARKERS SHALL BE INSTALLED EVERY 20 FEET IN THE PIPING RUNS.
- LEGEND LISTING VALVE #, TYPE OF VALVE, SERVICE TYPE, & LOCATION OF VALVE. KEY VALVE #S TO AS-BUILT DRAWINGS UPON COMPLETION OF PROJECT.

ALL VALVES WITHIN PIPING SYSTEMS SHALL BE TAGGED USING A 1-1/2" DIA. BRASS TAG. PROVIDE A

- MECHANICAL CONTRACTOR SHALL SUBMIT (3) SETS OF OPERATING MANUALS FOR EACH PIECE / TYPE OF MECHANICAL EQUIPMENT.
- MECHANICAL CONTRACTOR SHALL PROVIDE & INSTALL ALL WIRING & DEVICES AS REQUIRED TO CONTROL THE BOILER ROOM EQUIPMENT AS DESCRIBED IN THE SEQUENCE OF OPERATIONS LISTED IN THE PROJECT MANUAL. REFER TO SPECIFICATION SECTION 15903 FOR FURTHER DETAILS.

FIRESTOPPING NOTES

- ALL PENETRATIONS RELATED TO MECHANICAL WORK THROUGH FIRE RATED WALLS, FLOORS OR OTHER STRUCTURES SHALL BE FIRE STOPPED AS REQUIRED TO MAINTAIN THE RATING OF THE WALL BY MECHANICAL CONTRACTOR. IT IS ASSUMED THAT ALL WALLS IN THE CONSTRUCTION CARRY A MINIMUM FIRE RATING OF 1 HR. IT SHOULD BE ASSUMED THAT ALL MACHINE ROOM WALLS / BOILER ROOM WALLS / ELECTRIC ROOM WALLS CARRY A RATING OF 2 HR. MECHANICAL CONTRACTOR SHALL BE RESPONSIBLE FOR A COMPLETE REVIEW OF THE ARCHITECTURAL DRAWINGS IN ORDER TO DETERMINE FIRE RATINGS OF ALL WALLS / PARTITIONS RELATED TO WORK UNDER THIS CONTRACT.
- MECHANICAL CONTRACTOR SHALL REVIEW THE COMPLETE ARCHITECTURAL SET OF DRAWINGS IN ORDER TO DETERMINE WHERE DUCT PENETRATIONS THROUGH RATED BARRIERS. DUCTS PENETRATING SAID RATED BARRIERS SHALL BE EQUIPPED WITH A UL LISTED FUSIBLE LINK TYPE FIRE DAMPER, RATED FOR SERVICE FOR WHICH IT IS BEING USED. FIRE DAMPERS SHALL BE PROVIDED & INSTALLED BY THE MECHANICAL CONTRACTOR, COMPLETE W/ DUCT ACCESS DOORS DIRECTLY ADJACENT TO THE DAMPER, POSITIONED FOR EASY REPLACEMENT OF THE LINK.
- MECHANICAL CONTRACTOR SHALL REVIEW THE COMPLETE ARCHITECTURAL SET OF DRAWINGS IN ORDER TO DETERMINE WHERE DUCT PENETRATIONS THROUGH RATED BARRIERS OCCUR BETWEEN SEPARATE SMOKE ZONES. DUCTS PENETRATING SAID FIRE / SMOKE BARRIERS SHALL BE EQUIPPED WITH A UL LISTED COMBINATION FIRE / SMOKE DAMPER, RATED FOR SERVICE FOR WHICH IT IS BEING USED. FIRE / SMOKE DAMPERS SHALL BE PROVIDED & INSTALLED BY THE MECHANICAL CONTRACTOR, COMPLETE W/ DUCT ACCESS DOORS DIRECTLY ADJACENT TO THE DAMPER. DAMPER ACTUATOR & RELATED WIRING SHALL BE PROVIDED & INSTALLED BY THE ELECTRICAL CONTRACTOR. COORDINATE DAMPER INSTALLATIONS W/ E.C. TO VERIFY PROPER CLEARANCES TO ASSURE PROPER DAMPER OPERATION.
- MECHANICAL CONTRACTOR SHALL PROVIDE A FULL SET OF AS-BUILT DRAWINGS, SHOWING EACH DAMPER LOCATION, TYPE OF DAMPER, ACCESS DOOR LOCATIONS, ETC. CONTRACTOR SHALL REFER TO SPECIFICATION SECTION 15511 FOR FURTHER DETAILS REGARDING FIRESTOPPING MATERIALS & METHODS.
- CONTRACTOR SHALL SUBMIT SHOP DRAWINGS OF PRODUCTS TO BE USED. FIRESTOP MATERIALS OTHER THAN THE PRODUCTS SPECIFIED SHALL INCLUDE FULL TECHNICAL DATA WITH SHOP DRAWINGS TO DEMONSTRATE EQUALITY WITH THE SPECIFIED FIRESTOPPING MATERIALS.

GENERAL INSTRUMENTATION NOTES

- AT A MINIMUM, PROVIDE THERMOMETERS / WELLS AT THE FOLLOWING LOCATIONS:
- AT INLETS & OUTLET OF EACH THREE WAY VALVE (UNIT VENTILATORS / CABINET UNIT HEATER
- INSTALLATIONS EXCEPTED). AT INLET & OUTLET OF EACH HYDRONIC BOILER, CHILLER OR COOLING TOWER. AT INLET & OUTLET OF EACH HYDRONIC COIL IN AIR HANDLING UNITS & BUILT-UP CENTRAL SYSTEMS.
- AT A MINIMUM, PROVIDE LIQUID FILLED PRESSURE GAUGES / WELLS AT THE FOLLOWING LOCATIONS:
- AT SUCTION & DISCHARGE OF EACH PUMP.
- FOR EACH MAKEUP WATER LINE. BEFORE & AFTER ALL PRESSURE REDUCING VALVES.
- AT ACCESSIBLE HIGH POINT OF ALL HYDRONIC PIPING SYSTEMS. AT ALL EXPANSION / COMPRESSION TANKS.

EQUIPMENT VENTING NOTES

- MECHANICAL CONTRACTOR WILL BE RESPONSIBLE FOR THE PROPER VENTING OF ALL NEWLY INSTALLED HYDRONIC PIPING SYSTEMS. AUTOMATIC AIR VENTS SHALL BE INSTALLED AT EVERY HIGH POINT IN THE PIPING SYSTEM WHERE AIR CAN COLLECT. PROVIDE COCK IN RISER PRIOR TO AUTOMATIC AIR VENT. NEW AIR VENTS SHALL BE "TACO" #HY-VENT OR EQUIVALENT.
- 2. MECHANICAL CONTRACTOR SHALL PROVIDE & INSTALL NEW AUTOMATIC AIR VENT FOR EACH AIR HANDLING UNIT COIL OR DUCT MOUNTED COIL. INSTALL SHUT-OFF COCK PRIOR TO VENT TIE-IN.
- MECHANICAL CONTRACTOR SHALL PROVIDE NEW MANUAL AIR VENTS FOR ALL UNIT VENTILATOR COILS, CONVECTORS, FAN COIL UNITS, FIN TUBE RADIATORS, ETC. MANUAL VENTS SHALL BE "TACO" #417 COIN VENT OR EQUIVALENT. PROVIDE SHUT-OFF COCK PRIOR TO VENT. AIM COIN VENT DISCHARGE IN AN APPROPRIATE MANNER AS TO FACILITATE THE CAPTURE OF BLEED WATER WHILE PERFORMING SYSTEM BLEEDING OPERATIONS.

ELECTRICAL WORK UNDER MECHANICAL CONTRACT

- MECHANICAL CONTRACTOR SHALL PROVIDE ALL STARTERS & DISCONNECT SWITCHES REQUIRED FOR ALL NEW MECHANICAL EQUIPMENT. STARTER / DISCONNECT SWITCH INSTALLATION TO BE PERFORMED UNDER THE ELECTRICAL CONTRACT. COORDINATE WORK W/ ELECTRICAL CONTRACTOR PRIOR TO START
- POWER WIRING REQUIRED FOR CONTROLS SHALL BE PERFORMED UNDER THE MECHANICAL CONTRACT UNLESS SPECIFICALLY NOTED OTHERWISE ON THE ELECTRICAL DRAWINGS. MECHANICAL CONTRACTOR SHALL OBTAIN THE SERVICES OF A LICENSED ELECTRICIAN (PER NEC REQUIREMENTS) TO PERFORM ALL ELECTRICAL WORK.

DUCTWORK NOTES

- PROVIDE ALL NEW DUCTWORK AS SHOWN AND SPECIFIED UNDER SPECIFICATION SECTION 015891, AND IN CONFORMANCE WITH 'SMACNA' SPECIFICATIONS.
- IF A DUCT ELBOW IS SHOWN TO BE RADIUSED, THEN RADIUSED ELBOWS SHALL BE INSTALLED. SQUARE ELBOWS MAY NOT BE SUBSTITUTED WHERE RADIUSED ELBOWS ARE SHOWN. WHERE SQUARE ELBOWS ARE SHOWN, TURNING VANES SHALL BE INSTALLED UPON APPROVAL BY THE ENGINEER.
- PROVIDE DUCT LINING IN ALL DUCTWORK THAT IS CONVEYING BELOW AMBIENT TEMPERATURE AIR & IS NOT INSULATED. PROVIDE LINING IN SUPPLY & RETURN AIR DUCTWORK FROM AIR HANDLING EQUIPMENT TO 20 FEET AWAY FROM THE UNIT(S). IN ADDITION, INCLUDE LINING IN ANY OTHER DUCT SPECIFICALLY SHOWN OR SPECIFIED TO BE EQUIPPED WITH LINING. REFER TO SPECIFICATION SECTION 15891 & 15290 FOR FURTHER INFORMATION.
- WHERE FLEXIBLE DUCTWORK IS USED, LENGTHS MAY NOT EXCEED 4 FEET TOTAL IN ANY ONE RUN OF FLEXIBLE DUCTWORK. FLEXIBLE DUCTWORK SHALL BE RATED IN ACCORDANCE WITH UL 181, CLASS 1. REFER TO SPECIFICATION SECTION 15891 FOR FURTHER INFORMATION.
- MECHANICAL CONTRACTOR SHALL PROVIDE A BUTTERFLY TYPE VOLUME DAMPER WITH LOCKING QUADRANT HANDLE PRIOR TO EACH AIR OUTLET SHOWN. INSTALL DAMPER AT LEAST 5 FEET AWAY FROM AIR OUTLET WHEREVER POSSIBLE.
- MECHANICAL CONTRACTOR SHALL PROVIDE FLEXIBLE DUCT CONNECTIONS WHERE DUCT SYSTEMS CONNECT TO EQUIPMENT. REFER TO SPECIFICATION SECTION 15891 FOR FURTHER INFORMATION.

TESTING and BALANCING NOTES

- MECHANICAL CONTRACTOR WILL BE REQUIRED TO PERFORM ALL EQUIPMENT & SYSTEM TESTING / BALANCING REQUIRED UNDER THIS CONTRACT. PROVIDE A FULL REPORT DETAILING ALL DESIGN & ACTUAL CONDITIONS FOR ALL AIR & HYDRONIC SYSTEMS SHOWN ON THE DRAWINGS. REFER TO SPECIFICATION SECTIONS 15990 & 15997 FOR FURTHER DETAILS.
- UPON NOTICE OF COMPLETION OF WORK BY THE CONTRACTOR, OWNER WILL OBTAIN THE SERVICES OF AN INDEPENDENT TESTING & BALANCING CONTRACTOR TO VERIFY THE RESULTS OF THE TESTING & BALANCING REPORT SUBMISSION. INDEPENDENT TESTING AGENCY SHALL SELECT A RANDOM NUMBER OF MEASUREMENTS TO BE CHECKED. MEASUREMENTS WILL BE CHECKED IN THE SAME MANNER AS ORIGINALLY MEASURED. NUMBER OF VERIFICATION MEASUREMENTS SHALL BE APPROXIMATELY 25% OF THE TOTAL MEASUREMENTS FOR THE PROJECT.
- IF MORE THAN 10% OF THE VERIFICATION TESTING SHOWS DEVIATIONS OF 10% OR MORE / SOUND LEVEL OF 2dB DIFFERENT THAN THAT ORIGINALLY MEASURED. THE ORIGINAL REPORT WILL BE REJECTED. A SYSTEMS WILL THEN BE REQUIRED TO BE COMPLETELY RE-TESTED, WITH A SECOND REPORT SUBMITTED IN THE EVENT THAT THE ORIGINAL REPORT IS REJECTED, ALL SYSTEMS SHALL BE READJUSTED & TESTED NEW CERTIFIED REPORTS SUBMITTED, AND NEW VERIFICATION TESTS MADE, AT NO ADDITIONAL COST TO THE OWNER. THE CONTRACTOR WILL BE RESPONSIBLE FOR ALL COSTS INVOLVED WITH THE VERIFICATION TESTS.


ABB	F	RE	- - -	/ /	۸٦	ΓΙ	0	N	S											
A.F,F. ,																				ABOVE FINISHED FLOOR
B.D.																				BACKDRAFT DAMPER
CWS .																				COLD WATER SUPPLY.
CFM																				CUBIC FEET OF AIR PER MINUTE
D																				DEEP / DEPTH
DIA./~ .																				DIAMETER
F&T																				FLOAT & THERMOSTATIC
FPM	·	·	·			·	·	·	•		·	·	·			·	·	·		FEET PER MINUTE
FSD	•	•	•	•		•	•	•	·	•	•	•	٠	•		•	٠	٠	·	FIRE DAMPER - DUCT MOUNTED
FLEX .	•	•	•	•	•	•	•	•	•	•	•	٠	•	•	•	•	•	•	•	FLEXIBLE
FO	•	•	•	•	•	•	•	•	•	•	•	٠	•	•	•	•	•	•	•	FLAT OVAL DUCTWORK
GAL.	•	•	•	•	•	•	•	•	•	•	•	٠	•	•	•	•	•	٠	•	GALLONS.
GPH .	٠	•	•	•	•	•	•	•	•	•	٠	٠	•	•	•	•	٠	•	•	GALLONS PER HOUR
GPM .	٠	•	•	•	•	•	•	•	•	•	٠	٠	٠	•	•	٠	•	٠	•	
	٠	٠	•	•	•	•	٠	•	٠	٠	•	٠	٠	•	•	•	٠	•	•	
H	٠	•	•	٠	٠		•	•	٠	٠	٠	٠	•	•	•	•	٠		٠	HIGH
H.C.			٠		•	•		٠			•	٠	•		٠		٠.	–		HANDICAPPED
HWS .			٠		٠	٠		٠		٠		•								ING SYSTEM HOT WATER SUPPLY
HWR .			٠		٠	٠		٠									, ŀ	ΗĘ/	ΑŢI	ING SYSTEM HOT WATER RETURN
HP			٠			٠										٠				HORSEPOWER
J.D., ,						٠														INSIDE DIAMETER
KW																				KILQWATT
L																				LONG
LAT																				LEAVING AIR TEMPERATURE
LWT .																				ĻEĄVIŅG WĄTĘR TEMPĘRĄTŲRĘ
MAX.																				MAXIMUM
MIN.																				MIŅIMUM
MBḤ .																				BŢU x 1,000
MFŖ.																				MANUFACTURER
M.H	·	•	•	·	·	·	•	•	•		•	٠	•		•	•	·	•	·	MANHOLE
MISC.	•	•	•	•	•	•	•	•	•	•	٠	٠	•	•	•	•	٠	•	•	
MTD.	٠	•	•	•	•	•	•	•	•	•	٠	٠	•	•	•	•	٠	•	•	MOUNTED
	٠	•	•	٠	•	٠	•	•	•	•	٠	٠	•		•	٠	٠	٠	•	
G	٠	٠	٠	٠	٠	٠		٠	•	٠	٠	٠	٠		•	٠	٠	٠		NATURAL GAS
N.I.C.	٠			٠	٠	٠	٠	٠	٠	٠	•	٠	٠		٠	٠	٠			NOT IN CONTRACT
No/#.	٠				٠					٠	•				٠					NUMBER
NOM	٠																			NOMIŅAL
N.T,S.																				NOT TO SCALE
O.A																				QUTSIDE AIR
O.C																				ON CENTER
O.D																				OUTSIDE DIAMETER
O.S. &.Y																				OUTSIDE ŞCREW & YOKE
O.C																				ON CENTER
PE																				PNEUMATIC / ELECTRIC
PREFAB	} .																			PREFABRIÇATED
PRV .	٠	•	•	•	•	•	•	•	•	•	•	٠	•	•	•	٠	٠	•	•	PRESSURE REDUCING VALVE
PSI	•	٠	•	•	•	•	•	•	•	•	٠	٠	•	•	•	•	•			POUNDS PER SQUARE INCH
R.A.	٠	•	٠	•	•	•	•	٠	•	٠	٠	٠	•		•	٠				
	٠	•	٠	٠	•	٠	•	٠	•	٠	٠	٠	•	٠	•	٠				
REQ'D.	٠	•	•	•	•			•	٠	٠	٠	٠								REQUIRED
RPM .																				REVOLUTIONS PER MINUTE
																				SUPPLY AIR
SCH.																				SCHEDULE
																				STATIC PRESSURE
STD.																				STANDARD
Τ																				TEMPERATURE
TXV .																				. THERMAL EXPANSION VALVE
TYP.																				
VOL.																				
V.D																				VOLUME DAMPER
VOL.	•																			VELOCITY.
	•																			VARIABLE FREQUENCY DRIVE
	٠																			
.W	٠																			
																				WET BULB TEMPERATURE
WTD .																				WATER TEMPERATURE DROP
WTR .																				WATER TEMPERATURE RISE
WPD																				WATER PRESSURE DROP

WATER PRESSURE DROP

SYMBOL	DESCRIPTION
24x12 / 20"~	RECTANGULAR GALVANIZED DUCTWORK - DIMENSIONS 'W' x 'H'
E	NEW SUPPLY DUCTWORK TO RISE UP
	NEW SUPPLY DUCTWORK TO DROP DOWN
\$	NEW RETURN DUCTWORK TO RISE UP
\$	NEW RETURN DUCTWORK TO DROP DOWN
	TRANSITION IN DUCTWORK
	FIRE DAMPER INSTALLED IN DUCTWORK
	VOLUME DAMPER IN DUCT (w/ LOCKING QUADRANT HANDLE)
5 0	ROUND DUCTWORK TO RISE UP
5 0	ROUND DUCTWORK TO DROP DOWN
42x18 FO	FLAT OVAL DUCT WORK
	RECTANGULAR TO ROUND DUCT TRANSITION
24 1200	ELBOW IN DUCTWORK w/ TURNING VANES
	ELBOW IN DUCTWORK (RADIUS + 1.5 x D)
	45 DEG. TAKEOFF FITTING
	90 DEG. TAKEOFF w/ BELLMOUTH FITTING
	FLEXIBLE DUCTWORK TO DIFFUSER (4 FT. MAX. RUN)
	4-WAY PATTERN CEILING DIFFUSER
	3-WAY PATTERN CEILING DIFFUSER
	2-WAY PATTERN CEILING DIFFUSER (90 DEG. / OPPOSING PATTE
	CEILING RETURN AIR REGISTER
	LINEAR SLOT DIFFUSER
	ROOF MOUNTED EXHAUST FAN

SYMBOL	DESCRIPTION
191	PIPING TO RISE UP
101	PIPING TO DROP DOWN
P.A.	PIPING ANCHOR
	PIPING GUIDE
	COLD WATER SUPPLY PIPING
HWS —	HEATING SYSTEM SUPPLY PIPING
— — HWR — —	HEATING SYSTEM RETURN PIPING
	CHILLED WATER SUPPLY PIPING
	CHILLED WATER RETURN PIPING
	CONDENSER WATER SUPPLY PIPING
	CONDENSER WATER RETURN PIPING
CD	CONDENSATE DRAINAGE PIPING
F.O.S. —	FUEL OIL SUPPLY PIPING
F.O.R. —	FUEL OIL RETURN PIPING
	LOW PRESSURE NATURAL GAS PIPING
EG	ELEVATED PRESSURE NATURAL GAS PIPING
<u>¥</u>	GAS COCK
+	DIRT LEG IN PIPING
LP	LIQUEFIED PETROLEUM GAS PIPING
	VENT PIPING
	LINEAR EXPANSION COMPENSATOR
	EXPANSION LOOP IN PIPING
	UNION IN PIPING
1	PIPING STRAINER (w/ BLOWDOWN VALVE)
	REDUCER / INCREASER FITTINGS IN PIPING
<u> </u>	ECCENTRIC REDUCER IN PIPING
Į	THERMOMETER
©	PRESSURE GAUGE
-	FULL PORT BALL VALVE
$\overline{\hspace{1cm}}$	GATE VALVE
<u> </u>	SWING CHECK VALVE
<u></u>	BALANCING VALVE
	3-WAY VALVE (w/ OPERATOR)
	CIRCUIT CETTER
3	TRIPLE DUTY VALVE
——————————————————————————————————————	WAFER VALVE
	PLUG / CAP IN PIPING
\leftarrow	PNEUMATIC CONTROL VALVE OPERATOR
	ELECTRIC CONTROL VALVE OPERATOR
	AUTOMATIC AIR VENT
	EXISTING PIPING

ING SYMBOL I	LEGEND
SYMBOL	DESCRIPTION
 	PIPING TO RISE UP
 •	PIPING TO DROP DOWN
P.A.	PIPING ANCHOR
	PIPING GUIDE
	COLD WATER SUPPLY PIPING
HWS ———	HEATING SYSTEM SUPPLY PIPING
—HWR — —	HEATING SYSTEM RETURN PIPING
	CHILLED WATER SUPPLY PIPING
	CHILLED WATER RETURN PIPING
· ·	CONDENSER WATER SUPPLY PIPING
•··	CONDENSER WATER RETURN PIPING
CD	CONDENSATE DRAINAGE PIPING
F.O.S. —	FUEL OIL SUPPLY PIPING
F.O.R. ———	FUEL OIL RETURN PIPING
G	LOW PRESSURE NATURAL GAS PIPING
EG	ELEVATED PRESSURE NATURAL GAS PIPING
<u> </u>	GAS COCK
	DIRT LEG IN PIPING
LP	LIQUEFIED PETROLEUM GAS PIPING
	VENT PIPING
	LINEAR EXPANSION COMPENSATOR
	EXPANSION LOOP IN PIPING
	UNION IN PIPING
	PIPING STRAINER (w/ BLOWDOWN VALVE)
	REDUCER / INCREASER FITTINGS IN PIPING
	ECCENTRIC REDUCER IN PIPING
Į	THERMOMETER
	PRESSURE GAUGE
<u> </u>	FULL PORT BALL VALVE
	GATE VALVE
<u> </u>	SWING CHECK VALVE
<u> </u>	BALANCING VALVE
	3-WAY VALVE (w/ OPERATOR)
	CIRCUIT CETTER
3	TRIPLE DUTY VALVE
	WAFER VALVE
'	PLUG / CAP IN PIPING
\sim	PNEUMATIC CONTROL VALVE OPERATOR
I	
	ELECTRIC CONTROL VALVE OPERATOR
	ELECTRIC CONTROL VALVE OPERATOR AUTOMATIC AIR VENT

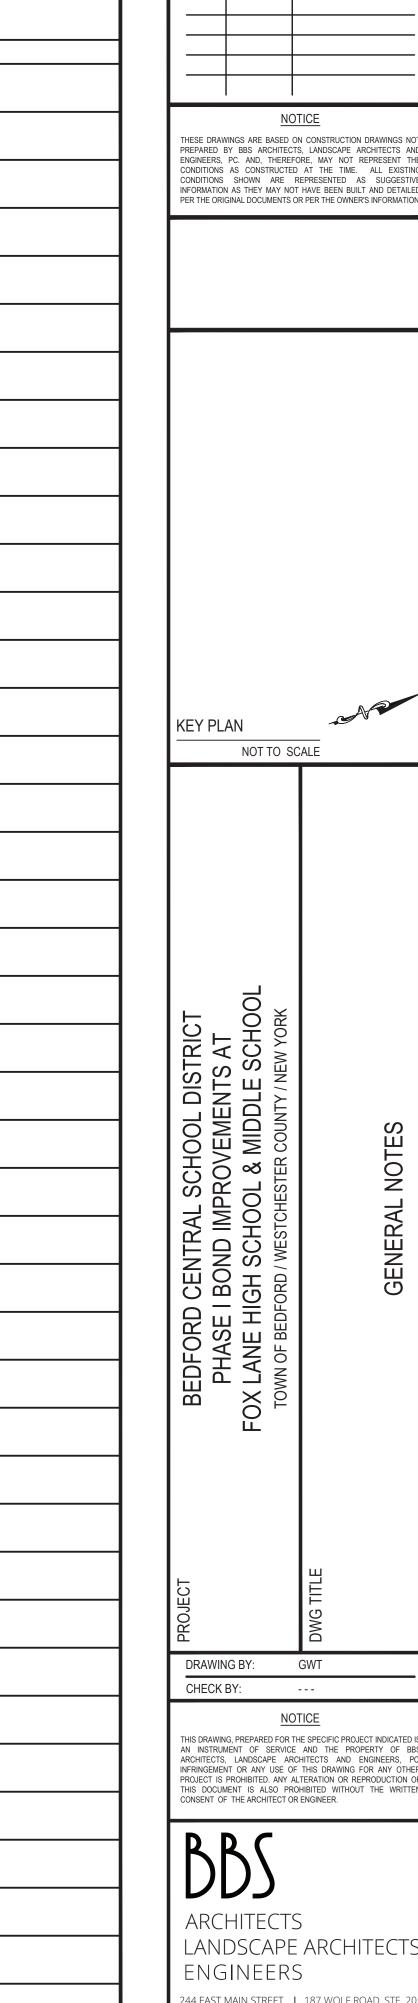

REV. DATE

NOTICE NOTICE

NOT TO SCALE

DRAWING BY: GWT CHECK BY: NOTICE

THIS DRAWING, PREPARED FOR THE SPECIFIC PROJECT INDICATED IS AN INSTRUMENT OF SERVICE AND THE PROPERTY OF BBS ARCHITECTS, LANDSCAPE ARCHITECTS AND ENGINEERS, INFRINGEMENT OR ANY USE OF THIS DRAWING FOR ANY OTH PROJECT IS PROHIBITED. ANY ALTERATION OR REPRODUCTION (
THIS DOCUMENT IS ALSO PROHIBITED WITHOUT THE WRITTE ONSENT OF THE ARCHITECT OR ENGINEER.

LANDSCAPE ARCHITECTS ENGINEERS 44 EAST MAIN STREET | 187 WOLF ROAD, STE. 20: PATCHOGUE NEW YORK 11772 NEW YORK 12205

T. 631.475.0349 F. 631.475.0361 F. 518.621.7655 www.BBSARCHITECTURE.com

66-01-02-06-0-003-021 DISTRICT BEDFORD CENTRAL SCHOOL DISTRICT PROJECT BOND PHASE I INTERIOR & EXTERIOR RECONS

SCALE: AS NOTED NOVEMBER 4, 2022 DATE: BID PICK-UP: FILE No: 22-225A

<u>DWG TITLE</u> GEN NOTES

M0.01

VENTILATION AND EXHAUST SCHEDULE

Room Number	Occupancy Classification	Occupancy Density (People Per 1000SF)	People Outdoor Airflow Rate in Breathing Zone, Rp (CFM/Person)	Area Outdoor Airflow Rate in Breathing Zone, Ra (CFM/SF)	Exhaust Airflow Rate (CFM/SF)	Area (SF)	Number of People (Pz)			CFM, Voz	
C212	Chemical Storage Room	0	0	0	1.5	138	0	0	1	0	
C217	Chemical Storage Room	0	0	0	1.5	142	0	0	1	0	

SYMBOL	'ANEMOSTAT' MODEL NO.	FACE SIZE	NECK SIZE	NC LEVEL	MAX. CFM RANGE	NOTES
E 1)	AC30-45	10x10	10x10	25	UP TO 150	T-BAR LAY IN, 45^ DEFLECTION

SYMBOL	'ANEMOSTAT' MODEL NO.	FACE SIZE	NECK SIZE	NC LEVEL	MAX. CFM RANGE	NOTES
R1)	AC30-45	12x12	12x12	25	240	SURFACE MOUNTED, 45^ DEFLECTION

TYP. FOR NEW EXHAUST FAN(S) - EF-1 14" HIGH 14 GA. GALVANIZED ROOF CURB (BY M.C.) NEW ROOF FLASHING FOR CURB (BY G.C.) EXISTING ROOF DECK - G.C. TO CUT OPENING FOR FAN AS REQ'D. —— WELDED SUPPORT FRAMING AROUND ROOF OPENING (BY G.C.) BUILDING ROOF SUPPORT STRUCTURE - G.C. TO MODIFY AS REQ'D. FOR FAN INSTALLATION NEW .081 T. EXTRUDED ALUM. GASKETED DAMPER W/ LINKAGE FOR USE W/ DAMPER MOTOR ————— - ELECTRIC DAMPER MOTOR POWERED & WIRED BY M.C. -TIE INTO FAN OPERATION SUCH THAT DAMPER OPENS TYP. FOR NEW DUCTWORK FROM FAN WHEN FAN STARTS (WHERE APPLICABLE) ——

SCALE: N.T.S.

|--|

SED No.	

GWT

THIS DRAWING, PREPARED FOR THE SPECIFIC PROJECT INDICATED IS AN INSTRUMENT OF SERVICE AND THE PROPERTY OF BBS ARCHITECTS, LANDSCAPE ARCHITECTS AND ENGINEERS, PC. INFRINGEMENT OR ANY USE OF THIS DRAWING FOR ANY OTHER

PROJECT IS PROHIBITED. ANY ALTERATION OR REPRODUCTION OF THIS DOCUMENT IS ALSO PROHIBITED WITHOUT THE WRITTEN CONSENT OF THE ARCHITECT OR ENGINEER.

LANDSCAPE ARCHITECTS

244 EAST MAIN STREET | 187 WOLF ROAD, STE. 20:

www.BBSARCHITECTURE.com

ALBANY

NEW YORK 12205

T. 518.621.7650

F. 518.621.7655

ENGINEERS

PATCHOGUE

NEW YORK 11772

T. 631.475.0349

F. 631.475.0361

CHECK BY:

REV. DATE

KEY PLAN

NOT TO SCALE

V MECHANICAL WORK PL. CAL STORAGE EXHAUST

NOTICE

THESE DRAWINGS ARE BASED ON CONSTRUCTION DRAWINGS NOT PREPARED BY BBS ARCHITECTS, LANDSCAPE ARCHITECTS AND ENGINEERS, PC. AND, THEREFORE, MAY NOT REPRESENT THE

CONDITIONS AS CONSTRUCTED AT THE TIME. ALL EXISTING CONDITIONS SHOWN ARE REPRESENTED AS SUGGESTIVE INFORMATION AS THEY MAY NOT HAVE BEEN BUILT AND DETAILED PER THE ORIGINAL DOCUMENTS OR PER THE OWNER'S INFORMATION.

	66-01-02-06-0-003-021
DISTRICT	BEDFORD CENTRAL SCHOOL DISTRICT
PROJECT	BOND PHASE I INTERIOR & EXTERIOR RECO
DWC TITLE	

<u>DWG TITLE</u>	NEW MECH CHEM STORAGE PLAN
SCALE:	AS NOTED

DATE: NOVEMBER 4, 2022

BID PICK-UP: FILE No: 22-225A

M2.01

NOTE:ROOMS C212 & C217		SCALE: 1/8" = 1'-0"
EF-1	EF-1	
ROOF CHEMICAL STORAGE EXHAUST FANS		

Model: CUBE-100-4

28.25

16.50 40.25

(12.00)

→ 19.00 SQ →

OVERALL HEIGHT MAY BE GREATER DEPENDING ON MOTOR, ADAPTER, AND/OR HINGE BASE.

0 40 80 120 160 200 240 280 320 360 400

Volume (CFM)

Operating Bhp point
Operating point at Total External SP
Fan curve

System curve
---- Brake horsepower curve

Min. Circuit Ampacity (MCA) 7.25

Max. Overcurrent Protection (MOP) 15

Short Circuit Current Rtg (SCCR) 5 kA

Sound Power by Octave Band

Sound 62.5 125 250 500 1000 2000 4000 8000 LwA dBA Sones Inlet 48 48 48 48 45 41 41 36 30 48 36 1.8

Significant Sound Power by Octave Band

F:VENGINFERING/Protects/Andv Siegelson/BBS/Bedford HS - Phase 1 - GT/Bedford HS Phase 1 - BBS-GT.gfcj

F:\ENGINEERING\Projects\Andy Siegelson\BBS\Bedford HS - Phase 1 - GT\Bedford HS Phase 1 - BBS-GT.gfcj Generated by: asiegelson@adehvac.com

CHEMICAL STORAGE EXHAUST FANS EF-1

0.30

SCI C215 1369 SF

Min/Max Fan Curve

Actual Volume (CFM) Total External SP (in. wg) RPM Power (hp)

0 1 2 3 4 5 6 7 8

Volume (CFM) x 100

1821 FRPM

1408 FRPM

²⁸⁹³ FRPM

749 FRPM

Operating Bhp point
Operating point at Total External SP

Construction Limit

Motor/System Limit

— Min FRPM ---- System curve ·-- Brake horsepower curve

SCI C214 1369 SF

80 CFM (TYP. 3) ---

12" X 12" TRANSFER GRILLE FURNISH WITH R1

CHASE BY GC UP THRU 3RD FLOOR TO NEW EXHAUST FAN EF-1 ON -ROOF SEE ARCH SET FOR DETAILS

8" X 8" DUCTWORK

Model: CUBE-100-4

Weight w/ Acc's (lb) Weight w/ Acc's and Curb (lb) Max T Motor Frame Size 56

Requested Volume (CFM)

Actual Volume (CFM)

Total External SP (in. wg)

Quantity Weight w/o Acc's (lb)

Standard Curb Cap Size (in.) 19 x 19 Roof Opening (in.) 15.5 x 15.5

> Fan RPM Operating Power (hp)

Elevation (ft)

Drive Loss (%)

Outlet Velocity (ft/min) 195

Motor Mounted

Size (hp) Voltage/Cycle/Phase 115/60/1

Motor RPM

NEC FLA* (Amps)

Min. Circuit Ampacity (MCA)

Efficiency Rating Standard

NOTE: FURNISH WITH ROOF CURB MODEL GPI-19

Tip Speed (ft/min) 2,601

Static Eff. (%) 24
Misc Fan Data

Enclosure EXP

Airstream Temp.(F)

Air Density (lb/ft3)

Fan Eff. Index (FEI)

Belt Drive Upblast Centrifugal Roof Exhaust

SECOND FLOOR CHEMICAL STORAGE ROOM VENTILATION PLAN

- 80 CFM (TYP. 3)

MC TO CONFIRM WITH DISTRICT LOCATION OF CHEMICAL SHELVING

PRIOR TO INSTALLATION OF DUCTWORK AND EXHAUST GRILLES

SEE ARCH SET FOR DETAILS

12.00 Standard Construction Features:

Method (in.) (lb) Assembled Union Label

Nominal 1.5 16 Yes No Preference

 Dimensions

 Nominal Curb
 Nominal Outside
 Outside Outside
 Outside Outside
 Outside Outside
 Outside Inside I

Height Width Length Width Length Width Length Width Length Width Length Width*
 (in.)
 <th

 Accessories

 Security
 Insulation (in.)
 Insulation R Value

 Galvanized
 No
 No
 1
 R4.3

Read Construction Features:

- Roof Curb fits between the building roof and the fan mounted directly to the roof support structure - Constructed of either 18 ga galvanized steel or 0.064 in. aluminum - Straighl Sided without a cant - 2 in. mounting flange - 3 lb density insulation - Height - Available from 12 in. to 42 in. as specified in 0.5 in. increments. Notes: - The maximum roof opening dimension should not be greater than the "Actual" top outside dimension minus 2 in.. - The minimum roof opening dimension should be at least 2.5 in. more than the damper dimension or recommended duct size. - The Roof Opening Dimension may or may not be the same as the Structural Opening Dimension. - Damper Tray is optional and must be specified. Tray size is same as damper size. - Security bars are optional and must be specified. Frames and gridwork are all 12 ga steel. Gridwork is welded to the frame and the frame is welded to the curb.

SCALE: 1/8" = 1'-0"

CHASE BY GC UP THRU 3RD FLOOR TO NEW EXHAUST FAN EF-1 ON ROOF

ELECTRICAL CONSTRUCTION NOTES (NOT ALL APPLY):

- 1. ALL WORK SHALL BE DONE IN ACCORDANCE WITH THE LATEST EDITIONS OF THE NEC, APPLICABLE LOCAL CODES, STATE CODES,
- SCHOOL WORKING RULES AND SCHEDULE DIRECTIVES, AND THE ENGINEER'S SPECIFICATIONS.

 THE VOLTAGE CHARACTERISTIC OF EXISTING BUILDING IS 208Y/120V, 3-PASE, 4-WIRE. THE VOLTAGE CHARACTERISTIC OF THE PROPOSED ADDITION SHALL BE 480/277V, 3-PHASE 4-WIRE WITH 208/120V DERIVED FROM STEP DOWN TRANSFORMERS., ALL
- EQUIPMENT SHALL BE COMPATIBLE WITH THESE CHARACTERISTICS.

 THE DRAWINGS SHOW SCHEMATICALLY, THE APPROXIMATE LOCATION OF ALL EQUIPMENT, CONDUITS, DEVICES, ETC. THE EXACT LOCATION OF WHICH SHALL BE SUBJECT TO APPROVAL BY THE ARCHITECT/OWNER WHO RESERVES THE RIGHT TO MAKE PRIOR TO INSTALLATION, ANY REASONABLE CHANGES IN LOCATION INDICATED WITHOUT EXTRA COST TO THE OWNER. CONTRACTOR SHALL VERIFY ALL INDICATED OR APPROXIMATED DIMENSIONS DRAWN OR DENOTED.
- 4. DIVISION 16 CONTRACTOR SHALL EXAMINE THE SITE TO VERIFY WORK TO BE PERFORMED AS SHOWN ON DRAWINGS AND SPECIFICATIONS BEFORE SUBMITTING HIS BID. ANY DISCREPANCY BETWEEN DRAWINGS/SPECIFICATIONS AND ACTUAL FIELD
- CONDITIONS SHALL BE BROUGHT TO ARCHITECT/ENGINEERS ATTENTION BEFORE BID SUBMITTAL.

 5. DIVISION 16 CONTRACTOR SHALL PROVIDE ALL LABOR SERVICE MATERIALS, EQUIPMENT, AND RELATED ITEMS TO COMPLETE THE WORK OF THIS DIVISION, AS REQUIRED BY THE NATIONAL ELECTRIC CODE, AND ALL STATE AND LOCAL AUTHORITIES HAVING
- JURISDICTION.
 6. DIVISION 16 CONTRACTOR SHALL PROVIDE ALL ELECTRICAL HARDWARE SHOWN ON THESE DRAWINGS AND RELATED DETAIL
- MATERIALS NOT SPECIFICALLY SHOWN OR SPECIFIED.

 7. DIVISION 16 CONTRACTOR SHALL PAY ANY FEES APPLICABLE TO ELECTRICAL WORK, SUCH AS, BUT NOT LIMITED TO, THE POWER COMPANY. TELEPHONE COMPANY. CATV. CERTIFIED ELECTRICAL INSPECTORS. ALARM AND FIRE PROTECTION COMPANIES.
- 8. THE DIVISION 16 CONTRACTOR SHALL REFER TO ALL OTHER DRAWINGS IN BID PACKAGE AND PERFORM THE WORK (INCLUDE IN HIS BID) INDICATED AS ELECTRICAL CONTRACTOR (E.C.) WORK.

 ALL WORK SHALL BE IN ACCORDANCE WITH MANUFACTURER'S RECOMMENDATIONS AND DIRECTIVES OF THE SCHOOL DISTRICT
- 9. ALL WORK SHALL BE IN ACCORDANCE WITH MANUFACTURER'S RECOMMENDATIONS AND DIRECTIVES OF THE SCHOOL DISTRICT
 BUILDINGS AND GROUNDS DEPARTMENT.

 10. ALL WORK SHALL BE PERFORMED BY A LICENSED ELECTRICAL CONTRACTOR WHO SHALL OBTAIN AN INSPECTION CERTIFICATE AND
- PAY ASSOCIATED FEE. SUBMIT A PHOTOCOPY OF THIS CERTIFICATE TO THE ENGINEER WITH FINAL PAYMENT APPLICATION.

 11. DIVISION 16 CONTRACTOR SHALL GUARANTEE ALL MATERIALS AND THEIR INSTALLATION TO BE FREE OF DEFECTS FOR A PERIOD AS DEFINED IN SECTION 1700 OF THE PROJECT MANUAL.
- 12. A COMPLETE SYSTEM OF WIRING, WITH ALL FEEDERS, MAINS, AND BRANCHES AS SHOWN ON THE DRAWINGS, SHALL BE FURNISHED AND INSTALLED FROM THE MAIN DISTRIBUTION BOARD TO THE PANELS OUTLETS, MOTORS, AND APPURTENANCES.
 13. PROVIDE IDENTIFICATION FOR ALL PANEL AND MOTOR FEEDER CABLES IN PULL BOXES AND AT TERMINATIONS. ANY CONDUCTOR
- VOLTAGES HIGHER THAN 240 VOLTS SHALL BE MARKED ON DEVICES AND JUNCTION BOXES.

 14. FURNISH AND INSTALL ALL WIRING OF ANY VOLTAGE OR PURPOSE AS SHOWN ON THE DRAWINGS.
- 15. ALL BRANCH CIRCUITS SHALL HAVE INDIVIDUAL NEUTRALS. SHARING COMMON NEUTRALS AMONG BUNDLED CIRCUITS IS SPECIFICALLY DISALLOWED UNLESS OTHERWISE NOTED.
- INSTALLATION OF WIRES AND CABLES. CONDUITS MAY BE INCREASED IN SIZE FOR CONSTRUCTION CONVENIENCE.

 17. FURNISH AND INSTALL ALL DISCONNECT DEVICES AND SAFETY SWITCHES AS SHOWN ON THE DRAWINGS AND/OR AS REQUIRED TO

PULL/JUNCTION BOXES SHALL BE PROVIDED WHERE INDICATED OR AS OTHERWISE REQUIRED TO FACILITATE THE PROPER

- CONFORM WITH REQUIREMENTS.

 18. FURNISH AND INSTALL ALL INDICATED LIGHTING FIXTURES AND MOUNTING HARDWARE AS REQUIRED FOR A COMPLETE
- INSTALLATION.
 19. DIVISION 16 CONTRACTOR SHALL PROVIDE TO SCHOOL 5 PERCENT SPARE LAMPS (MINIMUM QUANTITY 1) OF EACH TYPE SPECIFIED
- WITH NEW FIXTURES.

 20. PROVIDE ALL WIRING, PANEL BOARDS, SWITCHES, FUSES, EQUIPMENT, AND ALL INCIDENTAL MATERIALS REQUIRED TO SUPPLY
- TEMPORARY AND PERMANENT ELECTRICAL NEEDS FOR THE WORK INVOLVED, ALL IN ACCORDANCE WITH OSHA, LOCAL, STATE AND UNDERWRITERS REQUIREMENTS.

 21. ALL WIRING TO BE 1#12+1#12(N)+1#12(G)-3/4"C., OR STEEL JACKETED MC CABLE (WHERE CODE PERMITTED), UNLESS OTHERWISE SPECIFIED ON DRAWINGS. RUN BRANCH CIRCUITS IN DROPPED CEILINGS, VOIDS, & CHASES. CONDUITS MAY BE SURFACE MOUNTED
- CABLE IS NOT ACCEPTABLE.

 22. ALL CONNECTIONS AND/OR SPLICES SHALL BE MADE ONLY IN ACCESSIBLE JUNCTION BOXES.

 23. ALL COUPLINGS AND CONNECTORS FOR USE WITH EMT SHALL BE COMPRESSION TYPE. SET SCREW TYPE OR INDENT TYPE FITTINGS

IN MECHANICAL SPACES UNLESS OTHERWISE NOTED. CONDUITS IN PUBLIC AREAS SHALL BE CONCEALED IN HUNG CEILINGS,

EMBEDDED IN SLAB OR MASONRY WALLS, EXCEPT WHERE SURFACE MOUNTED RACEWAY IS SPECIFIED. ALUMINUM JACKETED MC

- WILL NOT BE ACCEPTED.

 24. ALL CONNECTIONS TO CONDUIT RUN UNDERGROUND SHALL BE MADE WATERTIGHT. ALL METALLIC CONDUIT INSTALLED IN EARTH
- FILL, AS WELL AS UNDERGROUND, SHALL BE PAINTED WITH (2) COATS OF ASPHALTUM PAINT OR EQUAL.

 25. WIRING INSTALLED IN CEILINGS SHALL BE HUNG INDEPENDENT OF CEILING SYSTEM AND SECURELY TIED TO BUILDING STEEL.

 26. ALL LOW VOLTAGE (FIRE ALARM, PA INTERCOM, PHONE, DATA, ETC.) WIRING INSTALLED IN OPEN AREAS SHALL BE IN METALLIC RACEWAY IN MECHANICAL AREAS, GYMNASIUMS, ART ROOMS, STOREROOMS, ETC., AND IN SURFACE MOUNTED RACEWAY IN PUBLIC AREAS. LOW VOLTAGE WIRE INSTALLED IN DROPPED CEILINGS SHALL BE BUNDLED TOGETHER AND SUPPORTED BY BUILDING STEEL. LOW VOLTAGE WIRE SHALL NOT BE SUPPORTED WITH BRANCH CIRCUITS OR FEEDER CIRCUITS AND SHALL NOT BE SUPPORTED BY
- CONDUIT, PIPES, ETC.. LOW VOLTAGE WIRING NOT INSTALLED IN CONDUITS, SHALL BE PLENUM RATED.

 27. CONDUITS SHALL BE SECURED IN PLACE AND PROTECTED WHERE NECESSARY TO PREVENT DAMAGE DURING CONSTRUCTION.

 28. FURNISH AND INSTALL ALL HARDWARE TO PROPERLY SUPPORT ALL CONDUITS NOT INSTALLED IN CONCRETE SLABS OR
- UNDERGROUND.
 29. ALL CONDUITS OR MC CABLE SHALL BE EQUIPPED WITH AN INSULATING/CHAFE GUARD GROMMET AT WIRE EXIT/ENTRANCE. MC

CABLE SHALL USE MC STYLE BUSHINGS. BX OR OTHER BUSHINGS ARE SPECIFICALLY DISALLOWEI

- 30. WHERE AN EXISTING CONDUIT OR CABLE IS REQUIRED TO BE REMOVED BUT SERVES AND EXISTING PIECE OF EQUIPMENT WHICH IS TO REMAIN OPERABLE, THE DIVISION 16 CONTRACTOR SHALL REROUTE SAID CONDUIT OR CABLE OR PROVIDE A NEW SOURCE OF POWER (APPROVED BY ENGINEERING) TO THIS EQUIPMENT AS A PART OF THIS CONTRACT.
- 31. ALL PANÈLS, SWITCHES, DISCONNECT STARTERS, OR OTHER ELECTRIC SYSTEM CONTROLS SHALL BE STENCILED WITH THEIR APPROPRIATE DESIGNATION/FUNCTION. ALL CIRCUIT BREAKERS SHALL BE IDENTIFIED BY A PANEL SCHEDULE OR STENCIL ADJACENT TO THE CIRCUIT BREAKER.

 32. ALL CIRCUIT BREAKERS POSITIONS IN ALL PANELS ARE SHOWN FOR ESTIMATE PURPOSES ONLY. EC IS RESPONSIBLE FOR LOAD
- BALANCING.

 33. ALL DEVICES SHALL BE FASTENED IN PLACE SECURELY. GRID MOUNTING LIGHTING FIXTURES SHALL BE SECURED TO GRID WITH
- CLIPS LISTED FOR THE PURPOSE OR SUSPENDED FROM STRUCTURE PER NEC.

 34. WORK WHICH MUST BE DONE IN OCCUPIED AREAS SHALL BE DONE AT SUCH TIMES AS INDICATED IN THE PHASING OF
- CONSTRUCTION AND AS APPROVED BY THE SCHOOL.

 35. WHERE THE DIVISION 16 CONTRACTOR IS INSTRUCTED TO PROVIDE, INSTALL AND WIRE CIRCUIT BREAKER(S) TO AN EXISTING PANEL AND THAT PANEL DOES NOT HAVE THE ROOM TO INSTALL REQUIRED CIRCUIT BREAKERS, THE DIVISION 16 CONTRACTOR SHALL REMOVE (3) ADJACENT 1P CIRCUIT BREAKERS AND PROVIDE A 3P, 60A BREAKER IN THEIR PLACE FOR SUB FEED TO A SURFACE
- MOUNTED 100A,3~,4W,24 POLE SUB PANEL AND ESTABLISH OVERFLOW CIRCUITS IN NEW SUB PANEL, EACH WITH REQUIRED CIRCUIT BREAKERS. PROVIDE (3) 1P, AMPERAGE AS BEFORE CIRCUIT BREAKERS FOR DISCONNECTED CIRCUITS IN MAIN PANEL AND RECONNECT THEM IN SUB PANEL. SUB PANEL FEED TO BE 3#6+1#6(N)+1#10(G)-1"C.

 36. SELECTED RECEPTACLES AS SHOWN ON DRAWINGS MAY BE GFI PROTECTED BY CONNECTING TO GFCI RECEPTACLE FIRST IN

CIRCUIT, ALL RECEPTACLES THAT ARE PROTECTED FROM AN UPSTREAM GFCI UNIT SHALL BE VISABLY LABELED AS SUCH, GFCI

- RECEPTACLE SHALL BE SPEC GRADE AND RATED 20A, WITH OPERATING NOTIFICATION INDICATING LIGHT.

 ALL DEVICES ADDRESSED BY ADA REGULATIONS SHALL BE INSTALLED AT ADA COMPLIANT HEIGHT AND LOCATIONS.

 ALL NEW LIGHTING OR EXISTING LIGHTING HAVING SWITCHING REARRANGEMENT SHALL BE EQUIPPED WITH CODE COMPLIANT ENERGY CONSERVATION CONTROLS. SUCH CONTROL SHALL BE SUBMITTED TO THE ENGINEER FOR APPROVAL PRIOR TO
- 39. REMOVAL OF ELECTRICAL ITEMS INCLUDES THEIR DISPOSAL. THE EXCEPTION WILL BE TO TURN OVER TO THE OWNER ITEMS, IF ANY, THEY SPECIFY TO BE RETAINED IN THEIR INVENTORY. PCB OR ASBESTOS BEARING MATERIAL SHALL BE DISPOSED OF IN
- ACCORDANCE WITH LAWS AND REGULATIONS.

 40. EC SHALL PROVIDE & WIRE WEATHERPROOF GFCI RECEPTACLES ON ALL APPLICABLE ROOFTOP UNITS AS PART OF HIS BID. SEE
- MECHANICAL EQUIPMENT SCHEDULES FOR UNITS WITH SERVICE RECEPTACLES FACTORY INSTALLED.

 41. UNLESS OTHERWISE NOTED, STARTERS AND DISCONNECTS FOR MECHANICAL EQUIPMENT SHALL BE FURNISHED BY THE MECHANICAL CONTRACTOR.. COORDINATE WITH THE MECHANICAL CONTRACTOR FOR ALL POWERED MECHANICAL EQUIPMENT. THE DIVISION 16 CONTRACTOR IS RESPONSIBLE TO INSTALL ALL MOTOR STARTERS AND ASSOCIATED POWER WIRING FROM SOURCE TO UNIT VIA STARTERS AND DISCONNECTS. THE LOCATIONS OF MOTOR STARTERS SHALL BE DETERMINED BY THE MECHANICAL CONTRACTOR IN THE FIELD AND SUBMITTED TO THE ENGINEER FOR APPROVAL UNLESS IT IS SPECIFIED ON THE DRAWINGS. THE DIVISION 16 CONTRACTOR SHALL REFER TO THE MECHANICAL DRAWINGS, EQUIPMENT SCHEDULES & NOTES AND INCLUDE IN HIS BID PRICE ALL ELECTRICAL WORK ASSOCIATED WITH THEIR INSTALLATION, .AND THE REMOVAL OF ANY STARTERS/DISCONNECTS NO LONGER REQUIRED.

DEMOLITION NOTES (NOT ALL APPLY):

- THE ITEMS SPECIFICALLY SHOWN ON DEMOLITION DRAWING/S ARE TO BE ADDRESSED BY THE ELECTRICAL CONTRACTOR. THE ITEMS ARE TO BE TREATED AS NOTED AND RANGE FROM DIRECT REMOVAL AND DISPOSAL, OR REMOVAL, STORAGE, AND
- REINSTALLATION/RELOCATION, OR TEMPORARY REMOVE/STORAGE, AND REINSTALLATION IN SAME LOCATION.

 2. MANY OTHER ELECTRIC ITEMS EXIST THAT ARE NOT SHOWN INCLUDE, BUT ARE NOT LIMITED TO, SWITCHES, RECEPTACLE, FLOOR OUTLETS, LOW VOLTAGE JACKS, LOW VOLTAGE DEVICES AND WIRING, TELEPHONE PUNCH DOWN BLOCKS, AND OUT OF SERVICE ITEMS. ALL SUCH ITEMS SHALL BE PERMANENTLY DE-ENERGIZED, DISCONNECTED, AND OTHERWISE MADE SAFE FOR DEMOLITION BY NON-ELECTRIC DEMOLITION WORKERS. THE ELECTRICAL CONTRACTOR IS RESPONSIBLE FOR ASSURING THAT ALL ELECTRIC DEVICES, OF ANY VOLTAGE OR FUNCTION, THAT ARE TO BE DEMOLISHED ARE SAFE AND ADVISE THE DEMOLITION
- AFTER THE ELECTRICAL CONTRACTOR HAS DISCONNECTED ELECTRIC SUPPLIES TO ITEMS TO BE DEMOLISHED, HE SHALL ADVISE
 THE GENERAL CONTRACTOR OF ANY ELECTRIC ITEMS TO BE RETAINED FOR FUTURE USE AND THEREFOR NOT TO BE
 DEMOLISHED. THE GENERAL CONTRACTOR SHALL THEN PERFORM ALL WORK ZONE DEMOLITION. THIS MATTER APPLIES TO ALL
 ELECTRIC ITEMS, OF ANY VOLTAGE OR PURPOSE.
 THE SPECIAL/SPECIFIC ITEMS SHOWN ON THE DRAWING FOR ELECTRICAL CONTRACTOR TO ACT ON WERE FOUND BY SURVEY.
- NUMEROUS LOCATIONS WERE BLOCKED BY FURNITURE, ETC. AND ADDITIONAL EQUAL TYPE ITEMS MAY BE PRESENT. THE ELECTRICAL CONTRACTOR SHALL ALLOW FOR THIS IN HIS BID PRICE AND ATTEND TO THOSE EQUAL OR SIMILAR DEVICES AS MAY BE DISCOVERED.

 5. REMOVAL ITEMS THAT ARE LISTED AS TO BE TURNED OVER TO OWNER'S INVENTORY SHALL BE DISCUSSED WITH THE DISTRICT
- BUILDINGS AND GROUNDS MANAGER. THOSE ITEMS THAT THE OWNER DECLINES SHALL THEN BE DISPOSED OF BY THE CONTRACTOR IN THE MANOR OF OTHER PERMANENT REMOVALS. ANY PCB BEARING FLUORESCENT FIXTURES SHALL BE DISPOSED OF PER REGULATIONS.

 6. RETAIN EXISTING RECEPTACLES IN WALLS THAT WILL NOT BE IN CONFLICT WITH NEW CONSTRUCTION. RETAIN LIGHT SWITCH
- LOCATIONS THAT WILL NOT BE IN CONFLICT WITH NEW CONSTRUCTION. INSTALL BLANKING PLATE COVERS OVER THE UNUSED PORTION OF GANG BOXES HAVING MORE GANG POSITIONS THAN NEEDED FOR NEW SWITCHES.

 7. LIGHT FIXTURES ARE TO BE REMOVED AS GENERAL, NON ELECTRIC, CONTRACTOR DEMOLITION. DIVISION 16 CONTRACTOR RESPONSIBLE TO SAFE OFF LIGHTUING CIRCUITS FOR REMOVAL BY OTHERS. NO SPECIFIC QUANTITIES OR LOCATIONS ARE SHOWN. RETURN WHATEVER QUANTITY, IF ANY, OF THESE TO OWNER'S INVENTORY IF HE SO SPECIFIES OR THEY ARE
- DISPOSAL.

 THE ELECTRICAL CONTRACTOR SHALL COVER ALL BACK BOXES IN THE WALL THAT BECOME EXPOSED DUE TO DEVICE REMOVALS. THIS INSTRUCTION ALSO APPLIES TO EXPOSED ELECTRICAL BACK BOXES AS MAY EXIST AT THE SITE PRIOR TO THIS PROJECT. THE COVER SHALL BE BRUSHED ALUMINUM WITH CHAMFERED EDGES AND COVER THE HOLE COMPLETELY WITH AT LEAST 3/4" EXTRA MARGIN ON ALL SIDES. MOUNT THE COVER WITH SCREWS TO MATCH THE ORIGINAL PATTERN.

OTHERWISE TO BE DISPOSED OF. ELECTRICAL CONTRACTOR SHALL EXAMINE FIXTURES FOR PRESENCE OF PCB'S AND SPECIAL

- 9. IT IS EXPECTED THAT STRUCTURAL DEMOLITION BY THE GENERAL CONTRACTOR WILL CAUSE VARIOUS ELECTRIC SUPPLIES, OF VARIOUS VOLTAGES AND PURPOSES, TO BE CUT AND RENDER SOME DEVICES TEMPORARILY INACTIVE. IT IS THE ELECTRICAL CONTRACTOR'S RESPONSIBILITY TO RECONSTRUCT AND RECONNECT SUCH ELECTRIC SOURCES WHEN THE NEW STRUCTURE IS BUILT. NOTE THAT MOST REINSTALLED ITEMS WILL BE IN DIFFERENT LOCATIONS FROM THE REMOVAL LOCATION. THE ELECTRICAL CONTRACTOR SHALL MAKE ALL REQUIRED CIRCUIT EXTENSIONS OR MODIFICATIONS TO PROVIDE SERVICE TO A REINSTALLED ITEM AS RELOCATED. PROVIDE ALL REQUIRED CIRCUIT EXTENSIONS AS REQUIRED TO RESTORE SERVICE TO DEVICES. NOTE THAT THIS REQUIREMENT ALSO APPLIES TO THE ROOMS AND ELECTRICAL ITEMS WITHIN THAT ARE NOMINALLY NOT IN CONTRACT. SUCH RESTORATION OF SERVICE, IF NEEDED, IS SPECIFICALLY IN THE ELECTRICAL CONTRACTOR'S
- 10. IT SHALL BE THE ELECTRICAL CONTRACTOR'S RESPONSIBILITY TO PROTECT ALL ELECTRICAL DEVICES, FROM DAMAGES DURING CONSTRUCTION, WHICH ARE EITHER INDICATED TO REMAIN, AND/OR TO BE REMOVED AND REINSTALLED THROUGHOUT ALL CONSTRUCTION AREAS. DEVICES SHALL INCLUDE BUT WILL NOT BE LIMITED TO: SMOKE DETECTORS, EMERGENCY LIGHTS, EXIT SIGNS, OCCUPANCY SENSORS, SPEAKERS, LIGHT FIXTURES, SWITCHES, RECEPTACLE, ETC. IN THE EVENT OF DAMAGES INCURRED DUE TO CONSTRUCTION ACTIVITIES, THE ELECTRICAL CONTRACTOR SHALL BE RESPONSIBLE TO REPLACE ANY
- DAMAGED DEVICES AT NO ADDITIONAL COST TO OWNER.

 ALL SYSTEM ASSOCIATED WITH THE DEVICES SCHEDULED TO BE REMOVED, STORED AND PROTECTED SHALL BE TESTED BY THE MANUFACTURER'S CERTIFIED TESTING VENDOR PRIOR TO ANY DEMOLITION ACTIVITY. ANY DEVICE WHICH FAILS THE TEST SHALL BE REPLACED WITH A FORM, FIT AND FUNCTION COMPONENT PER UNIT PRICES, AND SUCH DEVICES ARE NOT INCLUDED IN THIS RESPONSIBILITY STATEMENT, BUT ALSO SUCH INSTALLATION SHALL BE IN THE ELECTRICAL CONTRACTOR'S BASE BID. THE ELECTRICAL CONTRACTOR SHALL RE-TEST ALL SUCH SYSTEM COMPONENTS BY A MANUFACTURER CERTIFIED TESTING VENDOR OF SUCH SYSTEM OF ALL PREVIOUSLY TESTED SYSTEM COMPONENTS AFTER ALL WORK BY ALL TRADES HAS BEEN COMPLETED, AND ALL SYSTEM COMPONENTS HAVE BEEN INSTALLED. ANY COMPONENT WHICH FAILS SHALL BE REPLACED, AND PROGRAMMED IF NECESSARY BY THE ELECTRICAL CONTRACTOR. ALL SUCH REPLACEMENT AND PROGRAMMING COSTS SHALL BE ELECTRICAL CONTRACTOR'S RESPONSIBILITY. ALL COSTS ASSOCIATED WITH THE TESTING OF AFFECTED SYSTEM SUCH AS BUT NOT LIMITED TO FIRE ALARM, PUBLIC ADDRESS, INTERCOM, TELEPHONE, AND SECURITY SYSTEMS SHALL BE THE RESPONSIBILITY OF THE ELECTRICAL CONTRACTOR. ALL EQUIPMENT, DEVICES, WIRING AND THEIR ASSOCIATED MATERIAL SPECIFIED TO REMAIN, WHICH IS NOT STORED AND PROTECTED, SHALL BE PROTECTED DURING THE DEMOLITION ACTIVITIES, AND ALL TRADES SHALL BE INFORMED OF SUCH COMPONENTS. ANY OF SUCH COMPONENTS WHICH BECOME DAMAGED DURING DEMOLITION SHALL BE REPLACED FORM, FIT AND FUNCTION BY THE ELECTRICAL CONTRACTOR AT HIS EXPENSE.

ABBREVIATIONS

E, EX EXISTING

ETR EXISTING TO REMAIN

PSEGLI PSE&G LONG ISLAND (UTILITY CO.)

SM, S.M. SURFACE MOUNTED

U.O.N. UNLESS OTHERWISE NOTED

EC, E.C. ELECTRICAL CONTRACTOR

GC, G.C. GENERAL CONTRACTOR

MC, M.C. MECHANICAL CONTRACTOR

PC, P.C. PLUMBING CONTRACTOR

TYP. TYPICAL

REQ'D REQUIRED

D.C. ON CENTER

KT CIRCUIT

AFF AWAY FROM FLOOR

CB CIRCUIT BREAKER

ABOVE COUNTERTOR

REC. RECEPTACLE

TEMPORARY POWER CONSTRUCTION NOTES: (NOT ALL APPLY)

RECONSTRUCTED AREAS OF THE EXISTING BUILDING.

- 1. THE DIVISION 16 CONTRACTOR SHALL PROVIDE TEMPORARY POWER AND LIGHT IN THE NEW AREAS 'D', AND 'E' AND THE
- ALL TEMPORARY POWER PANELS AND FUSED SWITCHES OUTSIDE SHALL BE NEMA 3R CONSTRUCTION AND LOCKABLE. ALL
 OUTSIDE RECEPTACLES SHALL BE WATERPROOF AND HAVE A COVER THAT ENCLOSES THE PLUGGED IN CORDS WHILE IN
 SERVICE AS INTERMATIC WP120C. NON-WATERPROOF GEAR IN A HOUSING IS NOT ACCEPTABLE.
- ALL RECEPTACLES SHALL BE GFCI PROTECTED AND MOUNTED 3'-0" ABOVE FINISHED FLOOR. PROVIDE WORK BLOCKING AS REQUIRED. ALL RECEPTACLES OUTLETS SHALL BE 2 GANG DOUBLE DUPLEX.
 TEMPORARY LIGHTING SHALL BE CONSTRUCTED OF SINGLE AND DOUBLE 100 WATT CLEAR INCANDESCENT LAMPS, OR
- EQUIVALENT, AND WATERPROOF RUBBER SOCKETS, SPLICED WITH WATERPROOF CONNECTORS ON FESTOONED ROMEX-TYPE WIRE. ADEQUACY OF ALL TEMPORARY LIGHTING CONFIGURATIONS SHALL BE AS DETERMINED BY THE CONSTRUCTION MANAGER. PRE ASSEMBLED TEMPORARY LIGHTING IS DISALLOWED. TAPS AND SPLICES SHALL BE MADE WITH SCOTCH LOCK CONNECTORS, RUBBER TAPE, AND THEM PVC COATED. THE CONNECTORS SHALL BE FILLED WITH PENETROX. A PLASTIC SHAPE ON CAGE/GUARD SHALL PROTECT EACH SOCKET AND LAMP. NOMINAL SPACING BETWEEN LAMP CLUSTER IS 16 FEET. MOUNT LIGHTS EIGHT FEET ABOVE FINISHED FLOOR IN TYPICAL LOCATIONS AND 10 FEET ABOVE FINISHED FLOOR IN CORRIDOR. PROVIDE NIGHT LIGHTING CIRCUIT, WHICH SHALL OPERATE CONTINUOUSLY. ALL LAMPS SHALL BE 130 VOLT, ROUGH SERVICE RATED. TEMPORARY LIGHTS SHALL BE TO OSHA STANDARDS. ALTERNATE FIXTURES SHALL BE 400W CONSTRUCTION SITE STYLE PROVIDE HOOK UPS TO JOB TRAILER FOR ALL TRADES. USE SITE POWER AS SOURCE. OWNER PAYS FOR POWER CONSUMPTION.
- 6. WIRING SHALL BE 1#12+1#12(N)+1#12(G) ROMEX STYLE. CIRCUITS SHALL BE OPERATED A MAXIMUM OF 15 AMPS OR 1800 WATTS (18 100 WATT LAMPS), SWITCHING SHALL BE DONE VIA THE SWITCH RATED 20A, 10 CIRCUIT BREAKERS. SEGREGATE THE NIGHT LIGHTS AND RECEPTACLES IN THE LOWER PART OF THE POWER PANELS AND LABEL THESE "DO NOT TURN OFF". CIRCUIT HOME RUNS CONDUCTORS SHALL INCREASE ONE WIRE SIZE EVERY 100 FEET I.E. #10 CONDUCTORS.
- <u>TURN OFF".</u> CIRCUIT HOME RUNS CONDUCTORS SHALL INCREASE ONE WIRE SIZE EVERY 100 FEET I.E. #10 CONDUCTORS.
 WIRING WITHIN THE ROOM AREA SHALL BE MADE WITH #12 CONDUCTORS.
 THE DIVISION 16 CONTRACTOR SHALL PREPARE EACH PANEL SCHEDULE.
- A LENGTH OF GREENFIELD FLEX CONDUIT AT PINCH POINTS SHALL PROTECT ALL WIRE, SUCH AS WHERE WIRING PASSED THROUGH A DOORWAY. WIRING SHALL BE SUPPORTED FROM ANCHORS INSTALLED BY THE DIVISION 16 CONTRACTOR FOR THE PURPOSE OF ATTACHMENT TO PROJECT. ALL ELECTRICAL HARDWARE SHALL BE NEW FOR THIS PROJECT.
- 10. ALL WIRING SHALL BE INSTALLED SO AS NOT TO CAUSE TRIPPING HAZARD OR SIMILAR OBSTRUCTION.
 11. POWER PANELS SHALL BE EQUIPPED WITH 42 1P, 20A CIRCUIT BREAKERS AND ALL CIRCUIT BREAKERS NOT IN SERVICE SHALL BE LABELED SPARE. AT THE OWNERS OPTION PANEL AND CIRCUIT BREAKERS SHALL BE TURNED OVER TO OWNERS INVENTORY AT CONCLUSION OF THE PROJECT. ALL ELECTRICAL HARDWARE SHALL BE NEW FOR THIS PROJECT.
 12. THE DIVISION 16 CONTRACTOR SHALL BE RESPONSIBLE FOR ALL MAINTENANCE OF TEMPORARY LIGHTING AND POWER SYSTEMS
- DURING, AND AFTER INSTALLATION, UP TO THE TIME OF BENEFICIAL OCCUPANCY, AND TIME OF REMOVAL. REPAIRS SHALL BE MADE WITHIN 24 HOURS OF THE REPORTED OUTAGE, OR AS DIRECTED BY THE CONSTRUCTION MANAGER. DIVISION 16 CONTRACTOR SHALL COMMENCE WORK ON THIS PROJECT WITH A GROSS OF SPARE CONSTRUCTION BULBS AT HIS IMMEDIATE DISPOSAL.

 13. REMOVAL OF THE TEMPORARY POWER AND LIGHTING SHALL BE THE RESPONSIBILITY OF THE DIVISION 16 CONTRACTOR WHEN THE PROJECT IS COMPLETE. ALL EQUIPMENT, WIRING SUPPORTS, CONNECTORS, ETC. SHALL BE REMOVED FROM OWNER'S
- PROPERTY AFTER PROJECT IS COMPLETE. INCLUDE STATEMENT OF REMOVAL WITHIN CLOSE OUT DOCUMENTS, REQUIRED FOR FINAL PAYMENT.

 14. PROVIDE THE TEMPORARY ELECTRICAL SERVICE TO THE CONSTRUCTION TRAILERS SHALL BE AS PER USERS REQUIREMENTS OF THE TRADES. TEMPORARY SERVICES ARE REQUIRED PER SPECIAL CONDITIONS OF THE PROJECT.
- 15. ALL TEMPORARY POWER WORK SHALL BE COORDINATED WITH THE CONSTRUCTION MANAGER SPECIAL EMPHASIS SHALL BE EXERCISED FOR TERRAZZO MACHINES AND ITS ELECTRICAL REQUIREMENT.

FIRE STOP NOTES:

- 1. ALL CONDUIT AND CABLE PENETRATIONS THROUGH FIRE RATED WALLS, FLOORS OR OTHER STRUCTURES SHALL BE FIRE STOPPED.

 2. THE FIRE STOP MATERIALS SHALL BE HILTI TYPE FS-657 FIRE BLOCK, FS-ONE SEALANT, CP-672 JOINT SPRAY, CP-601S ELASTOMERIC SEALANT, 6P-606 FLEXIBLE SEALANT, CP-643 OR CP-642 COLLAR, CP-618 PUTTY STICK, OR FS-635 TROWEL ABLE COMPOUND, AS SUITABLE
- 3. CONTRACTOR SHALL SUBMIT SHOP DRAWINGS OF PRODUCTS SPECIFIED OR EQUAL.
- 4. FIRE STOP MATERIALS OTHER THAN HILTI SHALL INCLUDE FULL TECHNICAL DATA WITH SHOP DRAWINGS TO DEMONSTRATE EQUALITY WITH THE SPECIFIED FIRE STOPS AND STATEMENT FROM MANUFACTURER THAT THEY MEET OR EXCEED THE PRODUCTS SPECIFIED HERE.

5. ALL SYSTEMS SHALL HAVE THEIR OWN SLEEVE THROUGH FIRE RATED WALLS. IE FIRE ALARM, PUBLIC ADDRESS, TELEPHONE, DATA, POWER AND LIGHTING.

ELECTRICAL SYMBOL LEGEND						
НН	UNDERGROUND HAND HOLE					
J	JUNCTION BOX					
	HIGH BAY LIGHTING					
	POLE MOUNTED LIGHTING					
\$ _{xx}	LIGHTING SWITCH. 'xx' DENOTES SWITCH LEG					
\$	EXIT SIGN					
⊕WP GEI	RECEPTACLE. WP DESIGNATES WEATHER PROOF. GFI DESIGNATES GROUND FAULT INTERRUPTER.					

SIMILAR SYMBOLS USED ON DEMO PLANS. ALL ITEMS SHOWN ON DEMO PLAN TO BE REMOVED ENTIRELY UNLESS OTHERWISE NOTED.

LINE DESIGNATIONS

EXISTING TO REMAIN DEVICES

DEVICES TO BE REMOVED. PULL
BACK ALL ASSOCIATED CONDUIT
AND WIRING AND REMOVE UNLESS
OTHERWISE NOTED ON THE PLANS.
(UNDERGROUND ELEC CONDUIT ON SITE PLAN)
NEW DEVICES

THESE DRAWINGS ARE BASED ON CONSTRUCTION DRAWINGS NOT PREPARED BY BBS ARCHITECTS, LANDSCAPE ARCHITECTS AND ENGINEERS, PC. AND, THEREFORE, MAY NOT REPRESENT THE CONDITIONS AS CONSTRUCTED AT THE TIME. ALL EXISTING CONDITIONS SHOWN ARE REPRESENTED AS SUGGESTIVE INFORMATION AS THEY MAY NOT HAVE BEEN BUILT AND DETAILED PER THE ORIGINAL DOCUMENTS OR PER THE OWNERS INFORMATION.

REV. DATE

632 S BEDFORD RD, BEDFORD, NY 10506

:RAL NOTES, LEGENDS AND ABBREVIATIONS

DRWG. BY: EEA

CHK. BY: EEA

THIS DRAWING, PREPARED FOR THE SPECIFIC PROJECT INDICATED IS AN INSTRUMENT OF SERVICE AND THE PROPERTY OF BBS ARCHITECTS, LANDSCAPE ARCHITECTS AND ENGINEERS, PC. INFRINGEMENT OR ANY USE OF THIS DRAWING FOR ANY OTHER PROJECT IS PROHIBITED, ANY ALTERATION OR REPRODUCTION OF THIS DOCUMENT IS

ALSO PROHIBITED WITHOUT THE WRITTEN CONSENT OF THE ARCHITECT OR ENGINEER.

DD)
ARCHITECTS

ENGINEERS

BRANCH PROJECT CONTACT:

187 WOLF ROAD, STE. 205

ALBANY
NEW YORK 12205

NEW YORK 12205 T. 631.475.0349 T. 518.621.7650 F. 631.475.0361 www.BBSARCHITECTURE.COM

LANDSCAPE ARCHITECTS

SED No.

66-01-02-06-0-003-021

DISTRICT BEDFORD CENTRAL SCHOOL
DISTRICT

PHASE 1A - BOND IMPROVEMENTS

DWG TITLE

GENERAL NOTES, LEGENDS

AND ABBREVIATIONS


SCALE:


 DATE:
 2/2/2023


 BID P/U DATE:
 XX-XX-XX


 FILE NO.
 22-225A


EN N1 FI HS

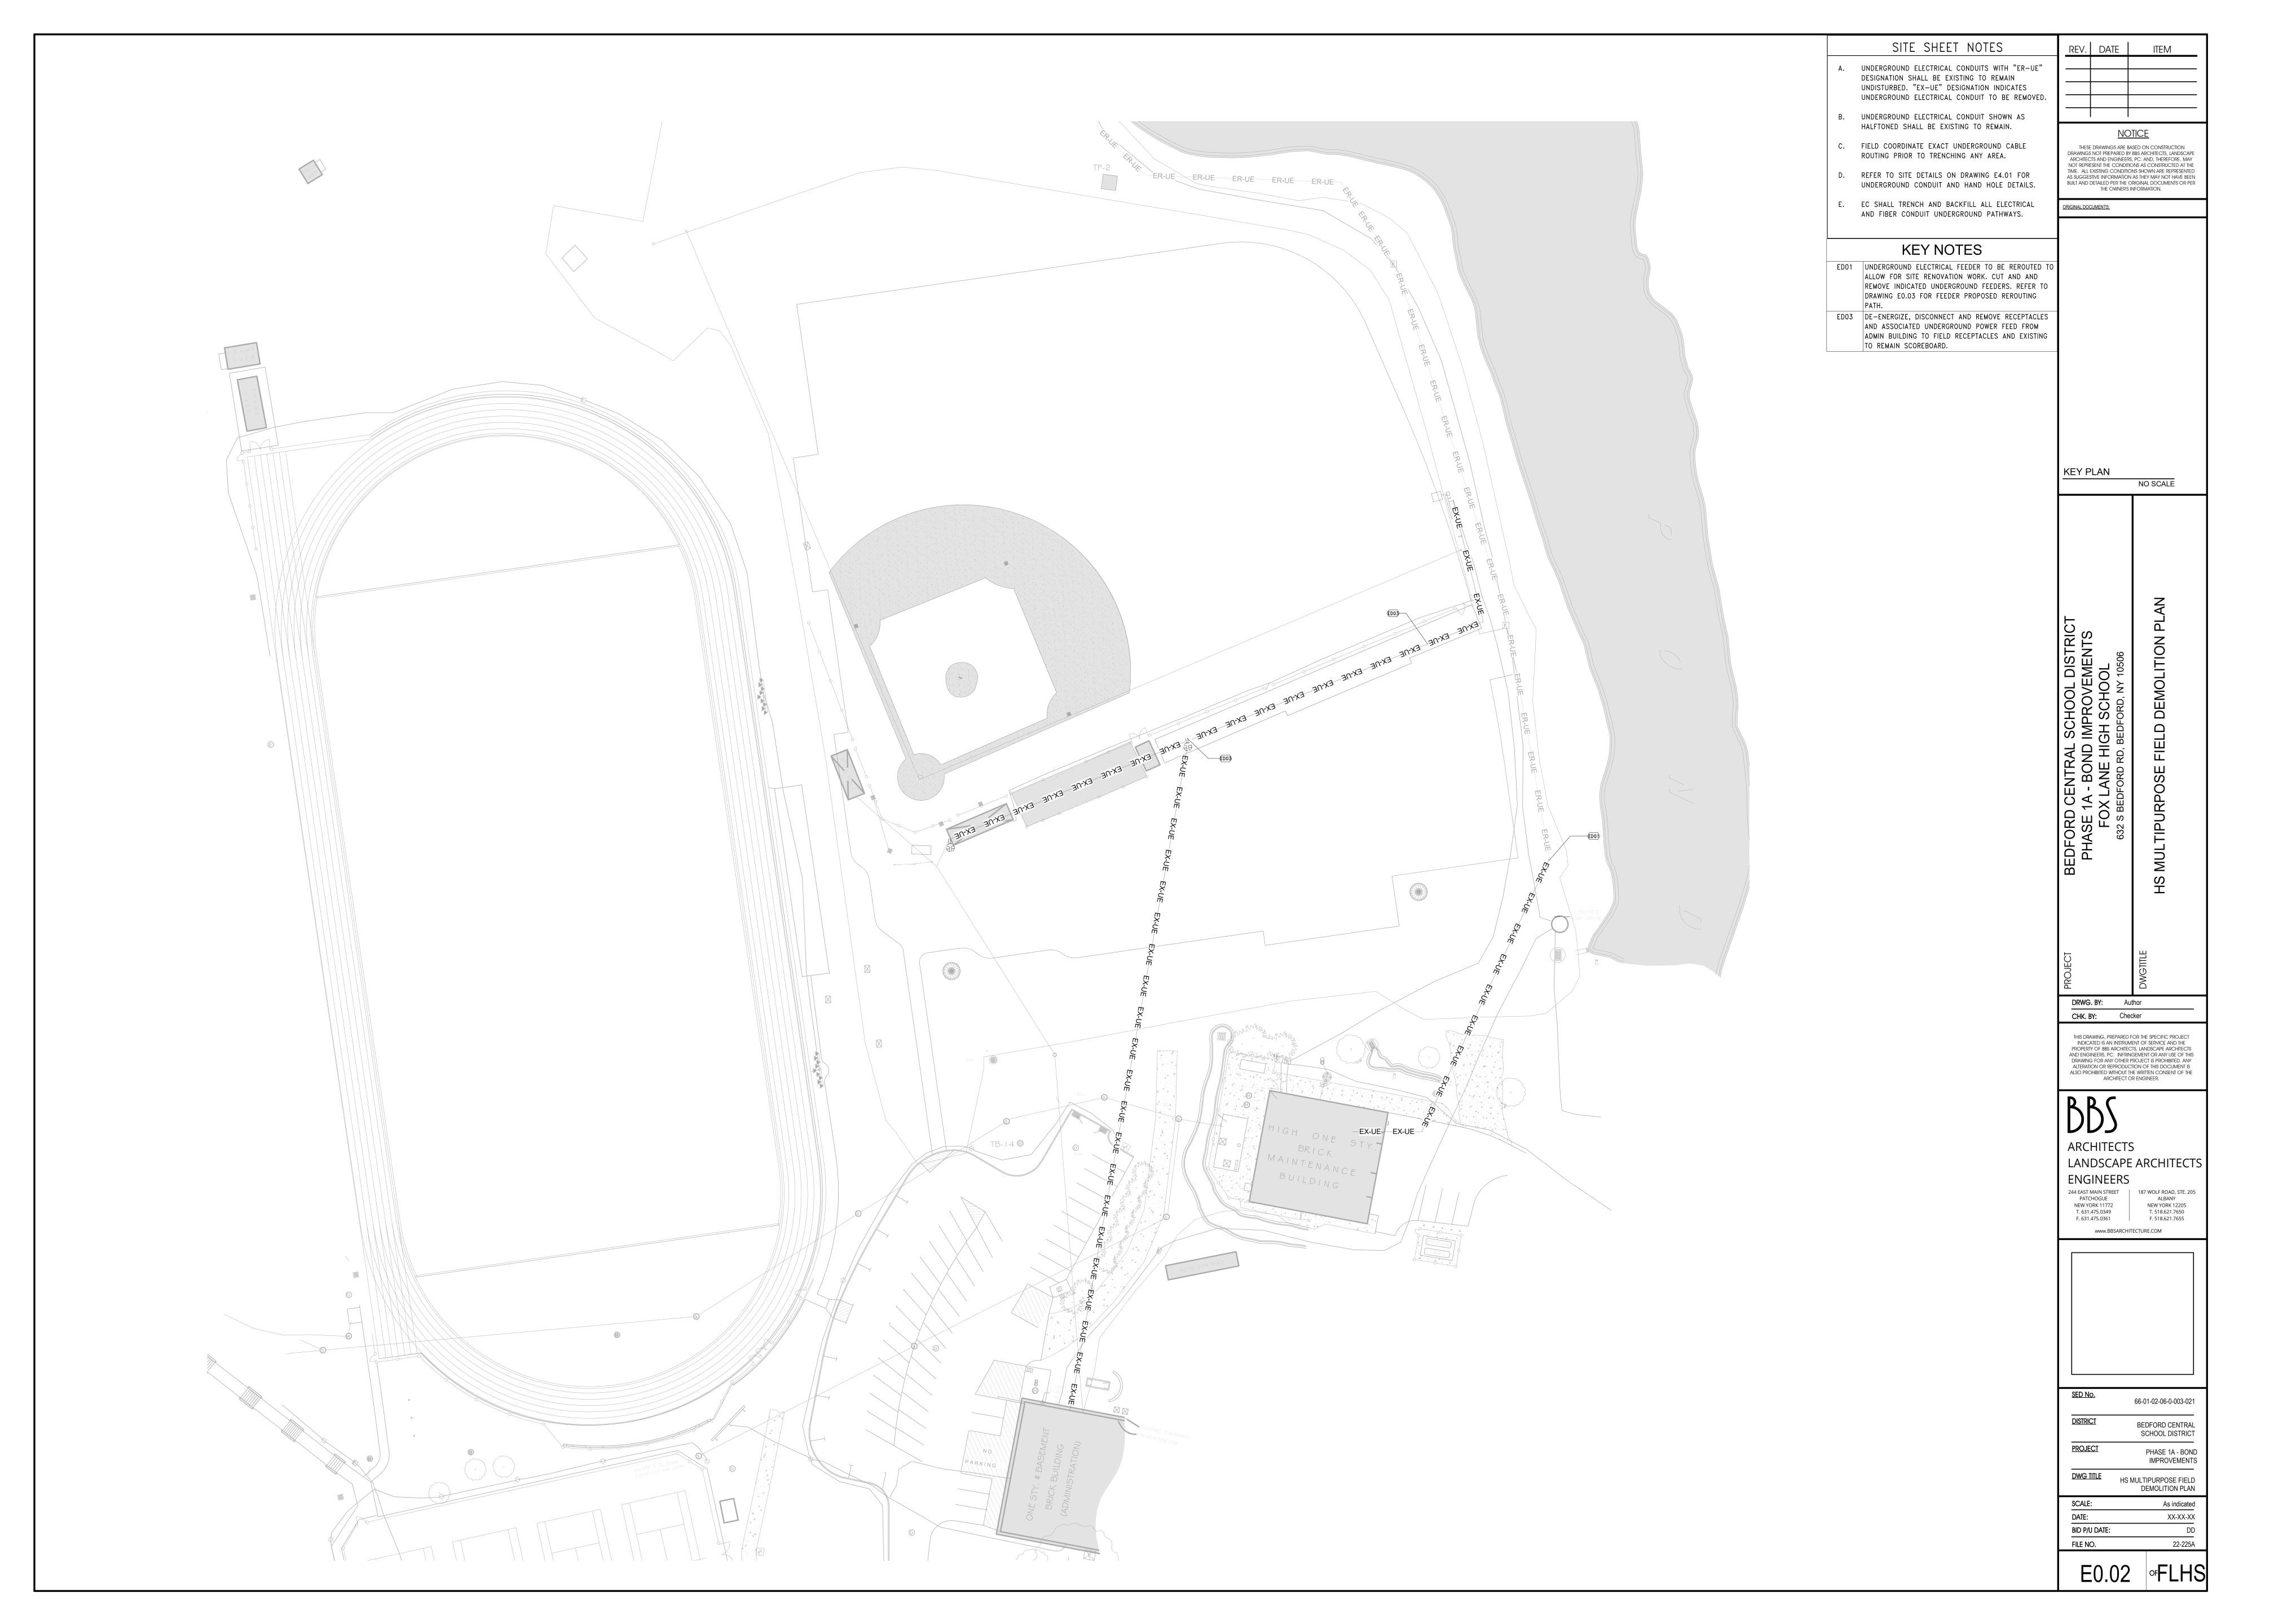

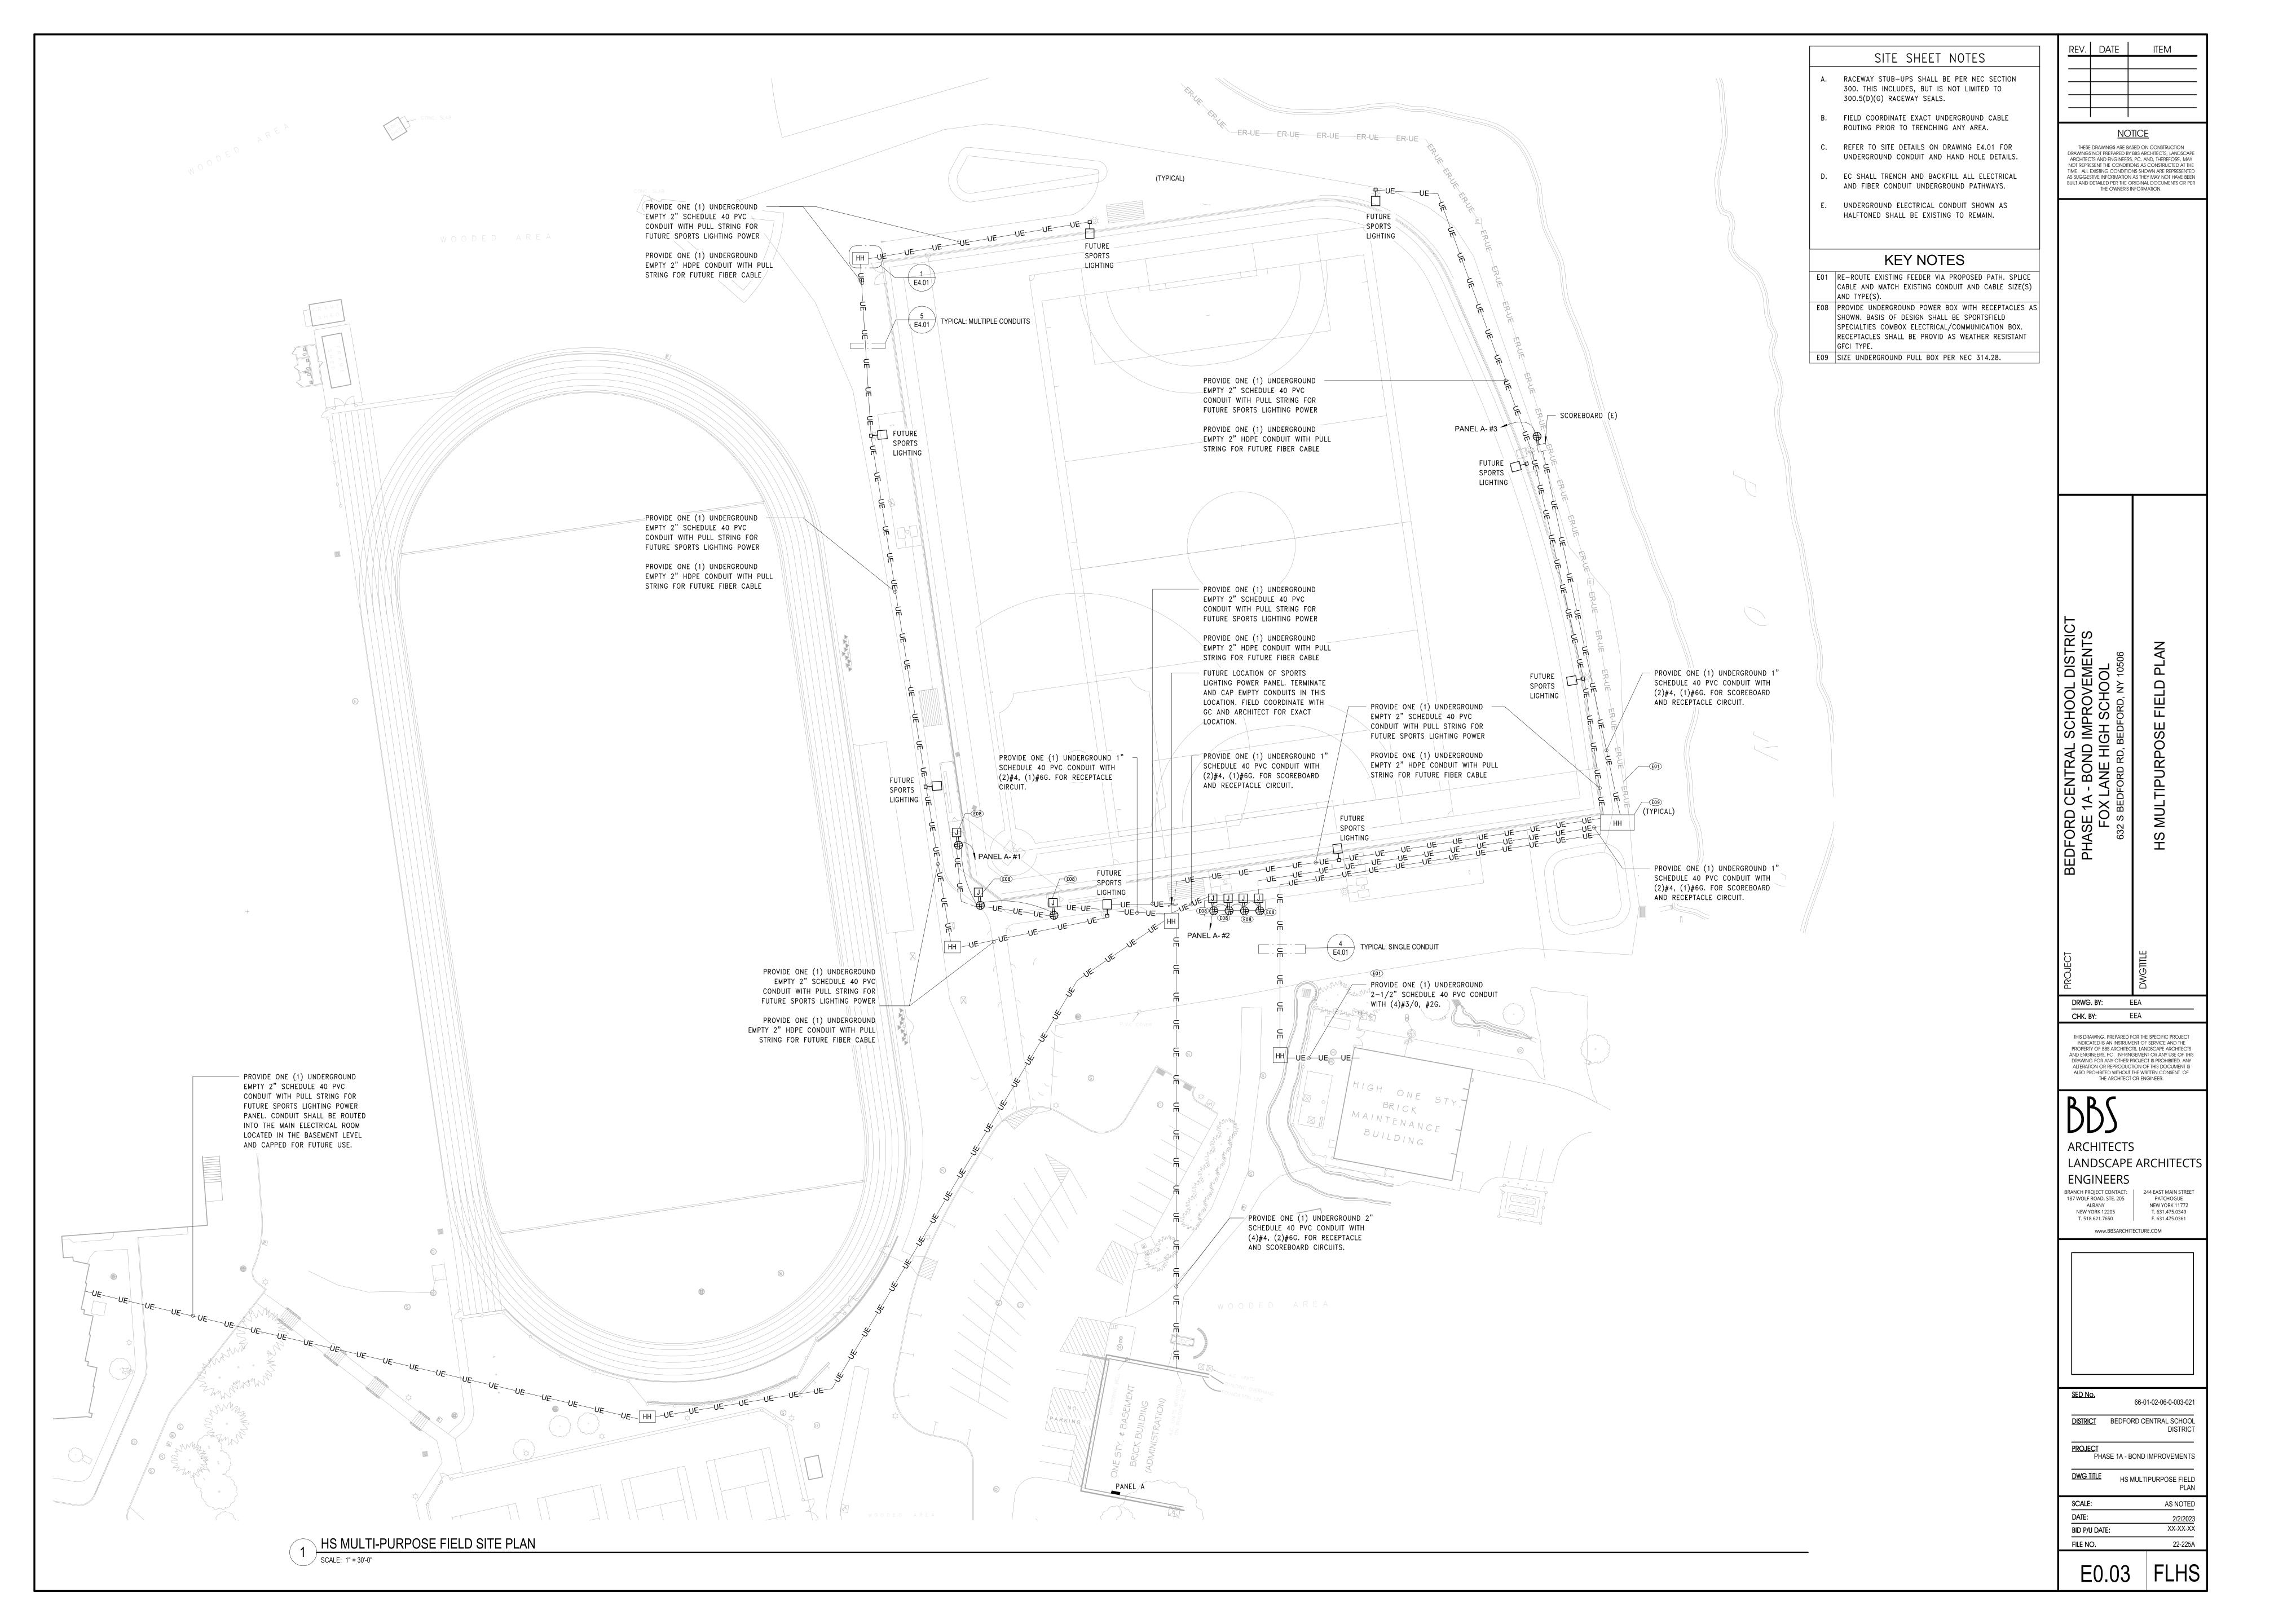

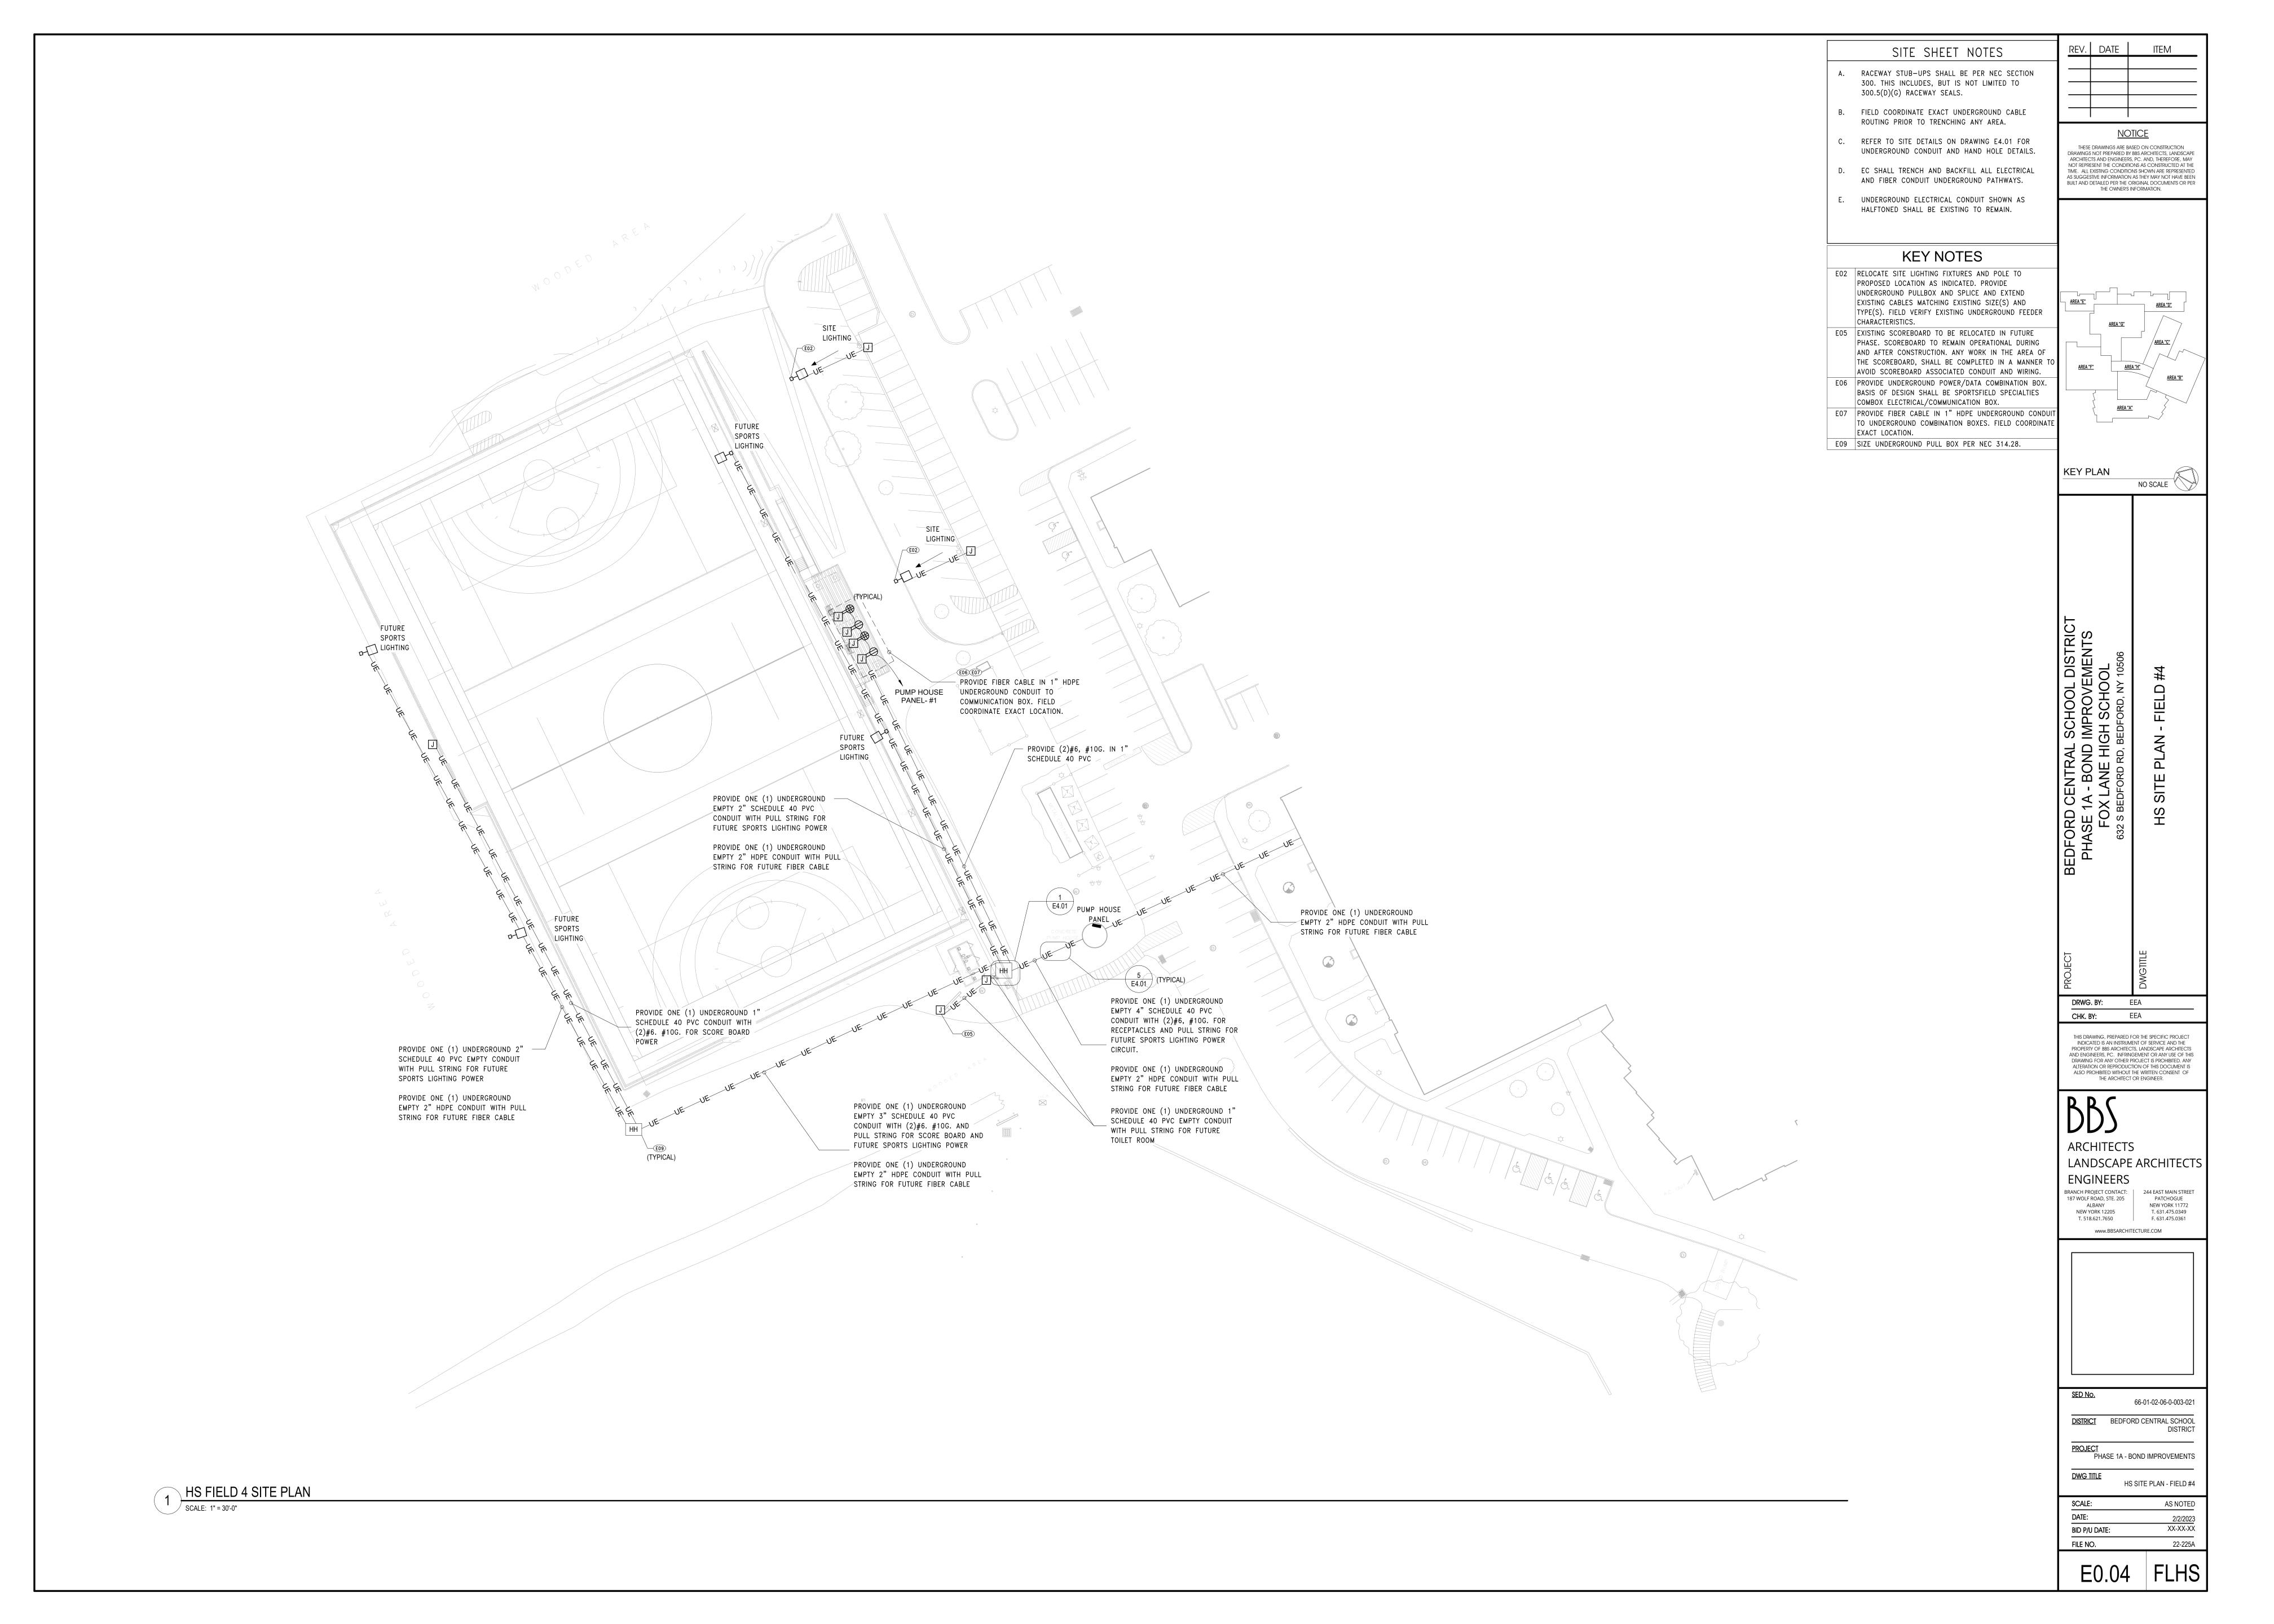

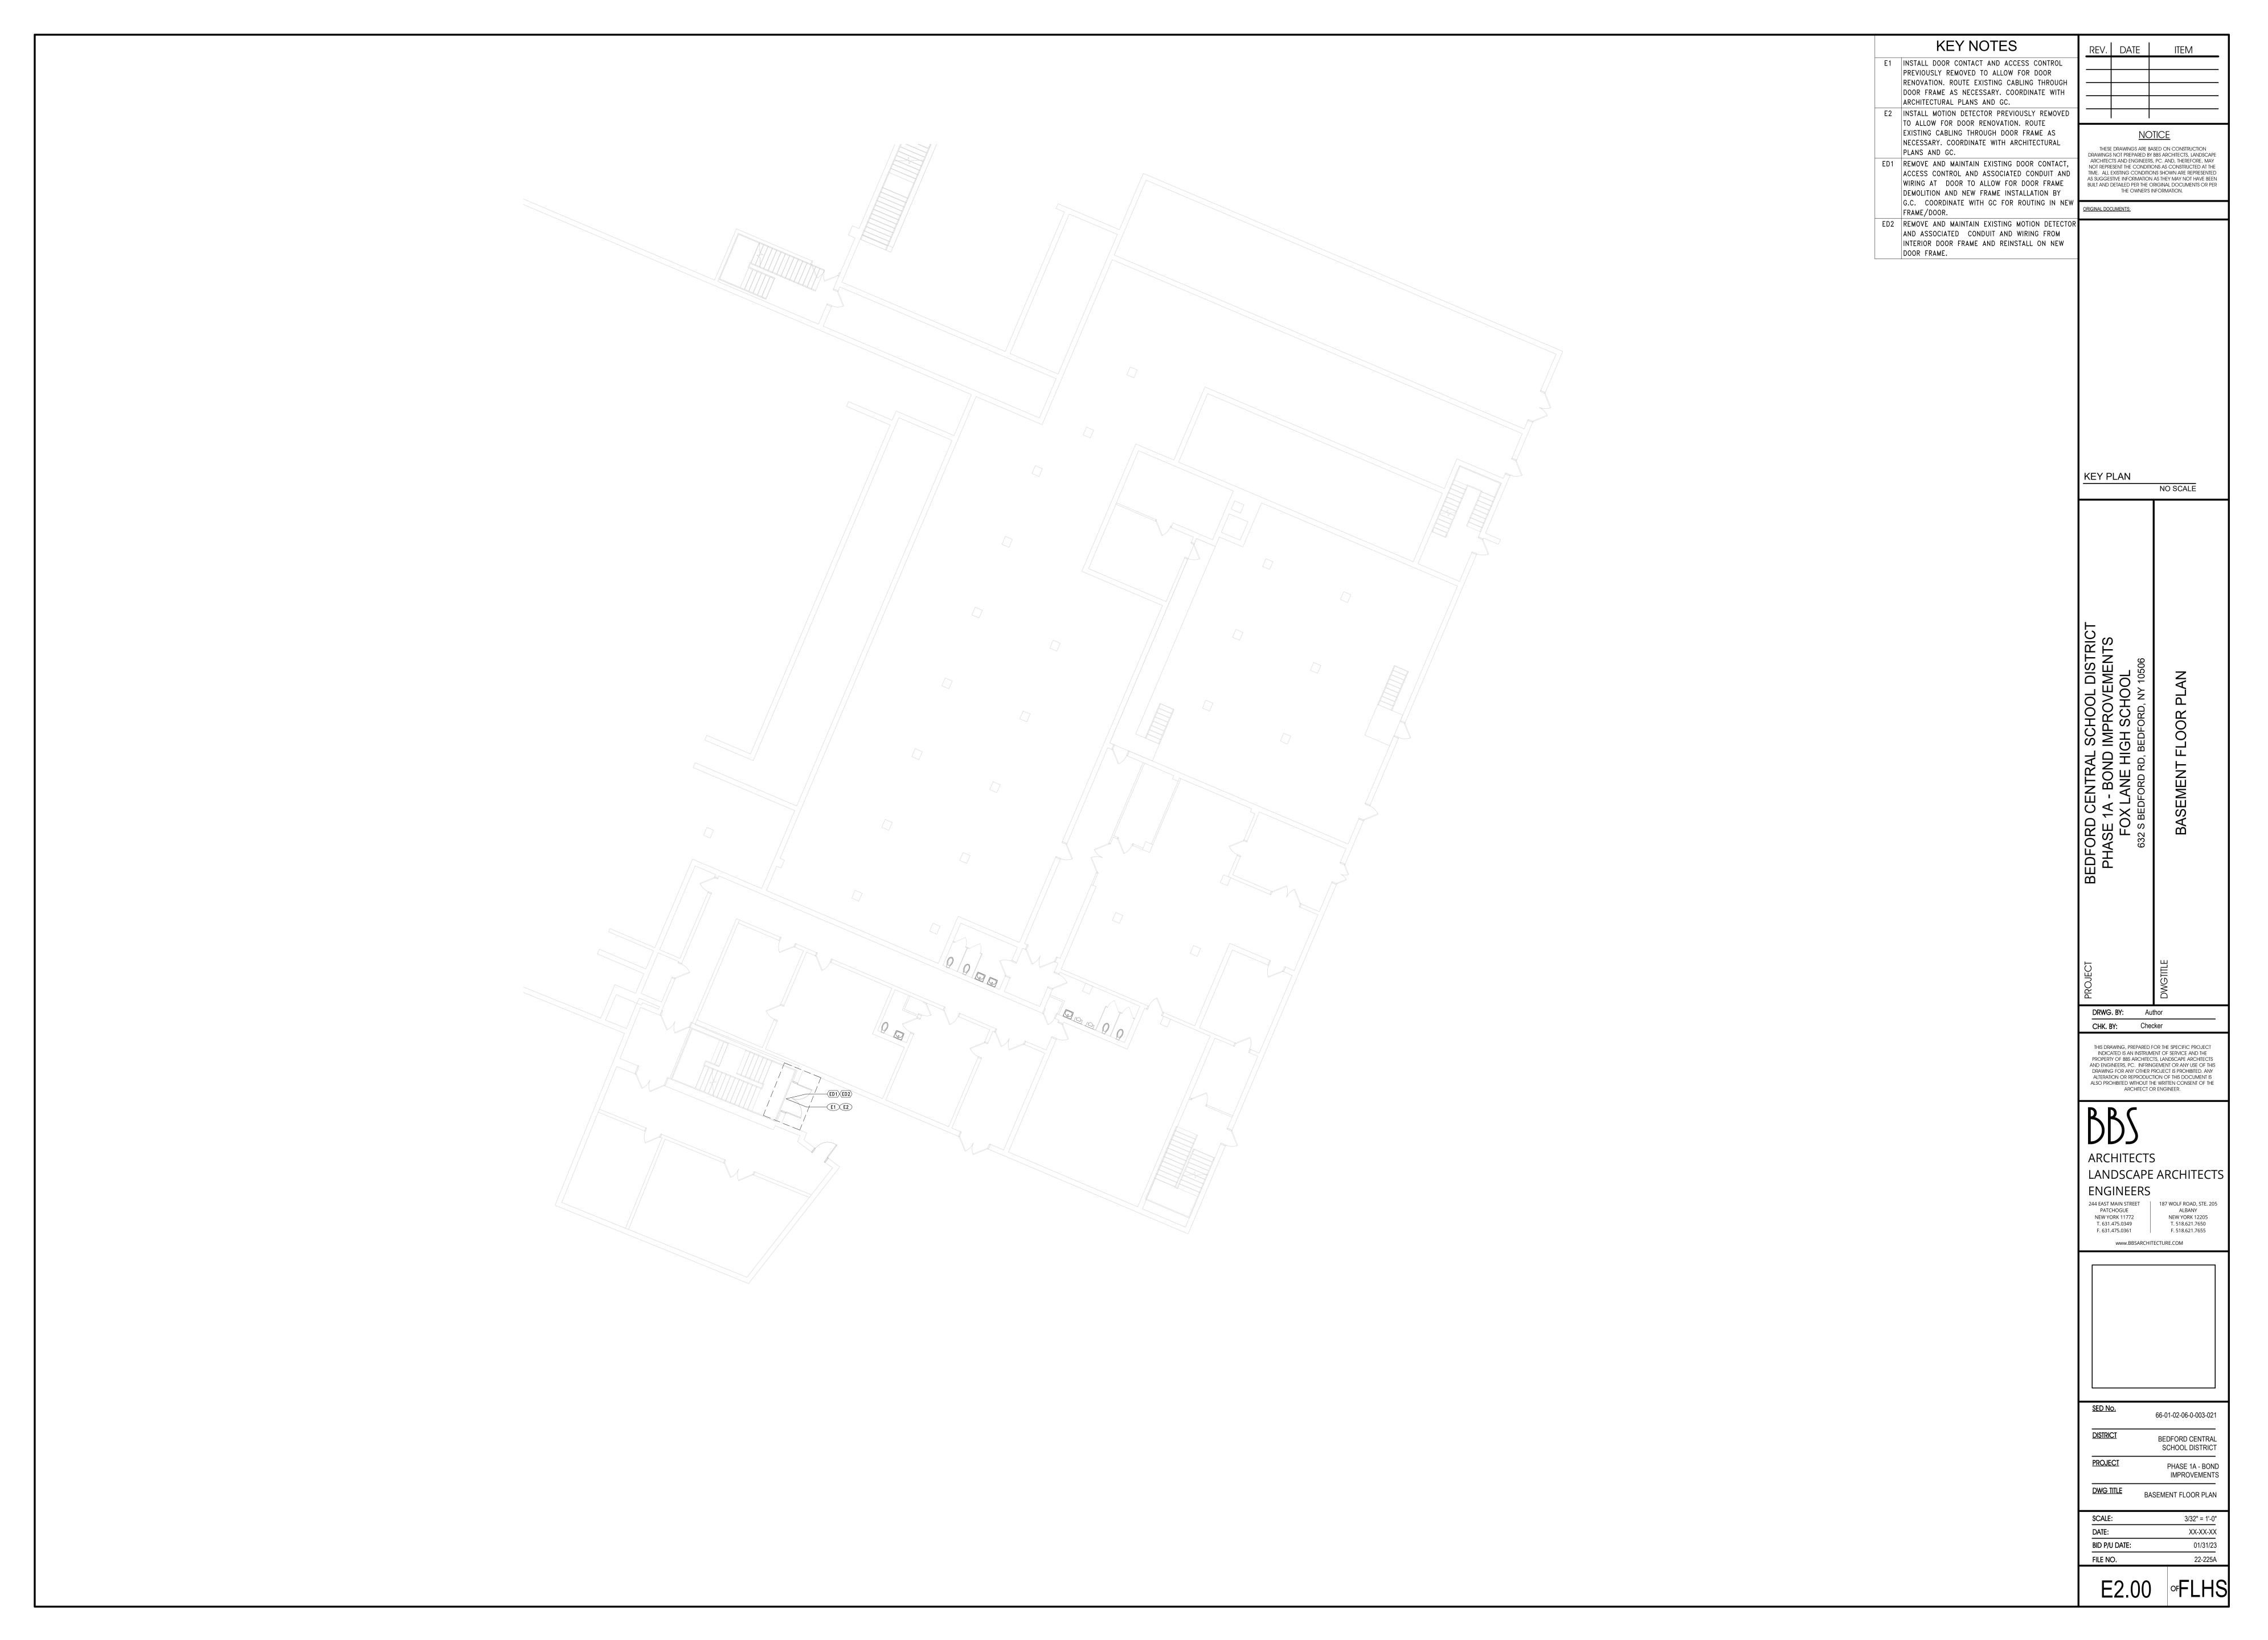

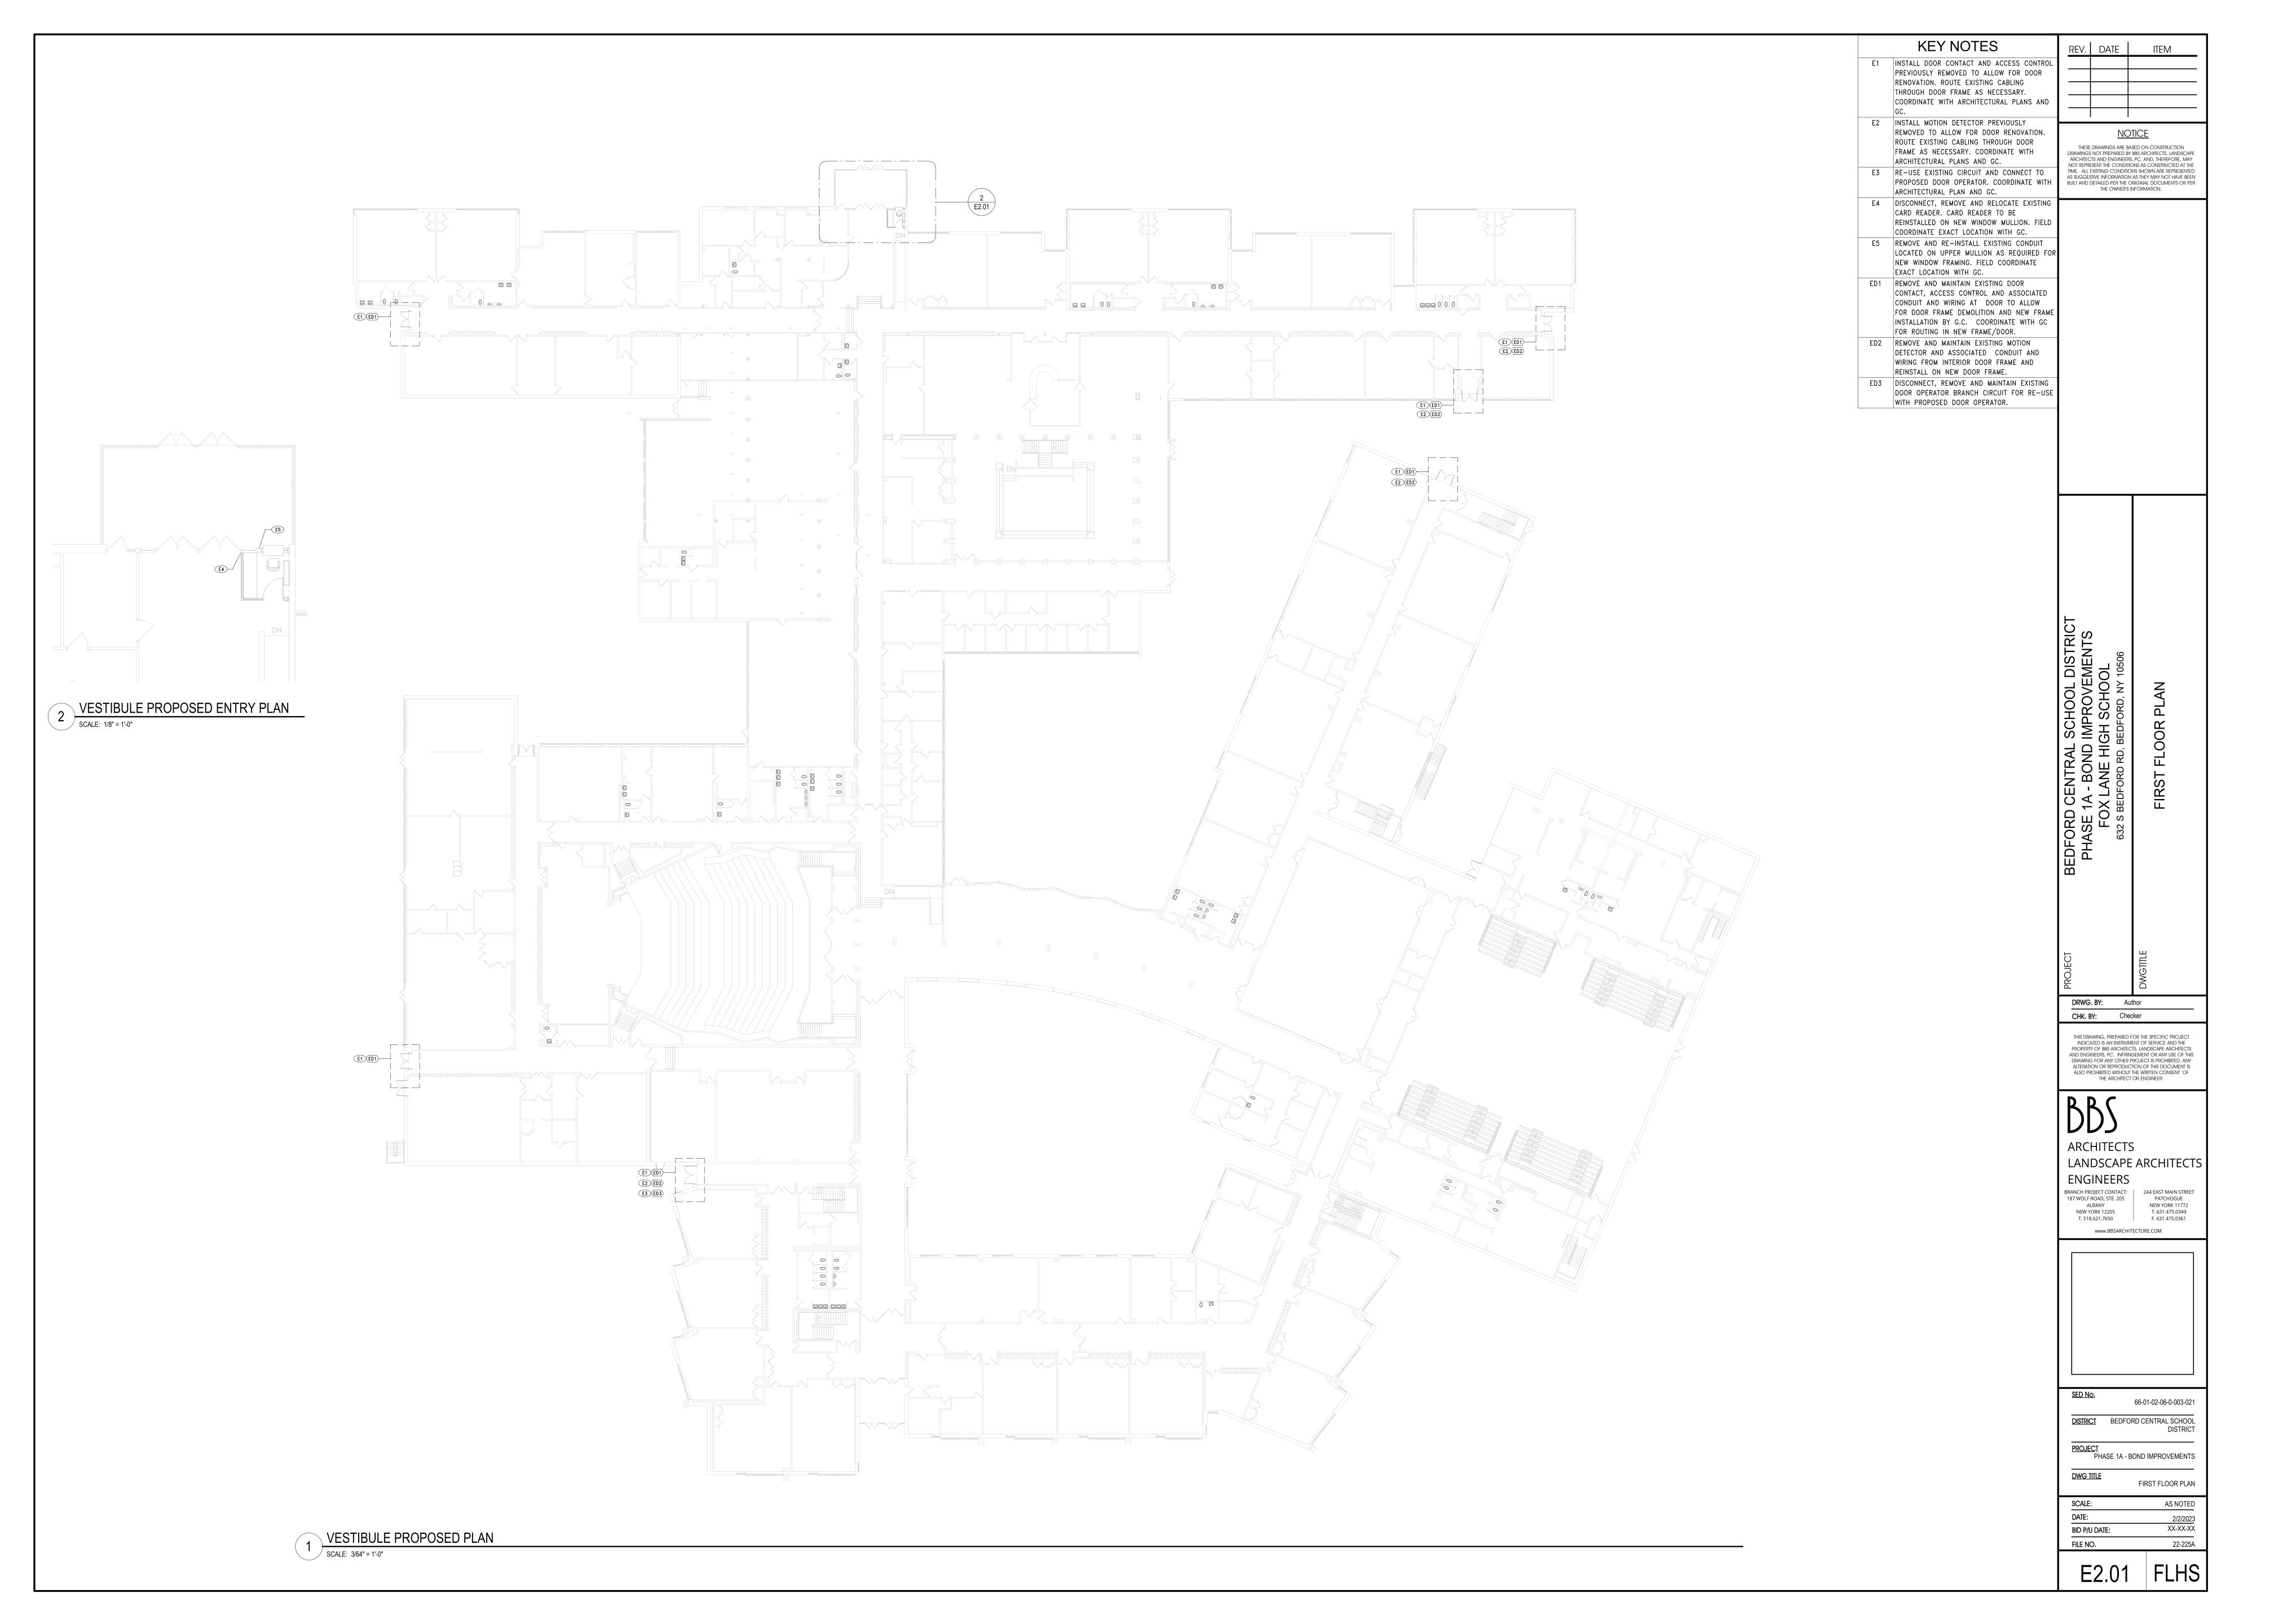



	Electrical Equipment Schedule													
TAG	DESCRIPTION	VOLTAGE	PHASE	AMPS - (FLA/MCA)	POWER PANEL	CIRCUIT NUMBER	BREAKER RATING	WIRE	PROVIDE DISCONNECT	DISCONNECT	VFD	PROVIDE DUCT SMOKE	FSD	Notes
EF-1	EXHAUST FAN	120 V	1	5.8 FLA	L3G	38	20A-1P	(2)#12, #12G. IN 3/4"C.	Yes	MC FURNISHED/EC INSTALLED				
EF-2	EXHAUST FAN	120 V	1	5.8 FLA	L3G	34	20A-1P	(2)#12, #12G. IN 3/4"C.	Yes	MC FURNISHED/EC INSTALLED				

Location: Supply From: Mounting: SURFACE					Volts: 120/208 Wye Phases: 3 Wires: 4					A.I.C. Rating: Mains Type: MLO Mains Rating: 200 A			
СКТ	Circuit Description	Trip	Poles		A		В		С	Poles	Trip	Circuit Description	СКТ
1	EXISTING CKT	20 A	1	0 VA	0 VA					1	20 A	EXISTING CKT	2
3	EXISTING CKT	20 A	1			0 VA	0 VA			1	20 A	EXISTING CKT	4
5	Spare	20 A	1					0 VA	0 VA	1	20 A	EXISTING CKT	6
7	Spare	20 A	1	0 VA	0 VA					1	20 A	EXISTING CKT	8
9	EXISTING CKT	20 A	1			0 VA	0 VA			1	20 A	EXISTING CKT	10
11	EXISTING CKT	20 A	1					0 VA	0 VA	1	20 A	EXISTING CKT	12
13	EXISTING CKT	20 A	1	0 VA	0 VA					1	20 A	EXISTING CKT	14
15	Spare	20 A	1			0 VA	0 VA			1	20 A	EXISTING CKT	16
17	Spare	20 A	1					0 VA	0 VA	1	20 A	EXISTING CKT	18
19	EXISTING CKT	20 A	1	0 VA	0 VA					1	20 A	EXISTING CKT	20
21	EXISTING CKT	20 A	1			0 VA	0 VA			1	20 A	EXISTING CKT	22
23	EXISTING CKT	20 A	1					0 VA	0 VA	1	20 A	EXISTING CKT	24
25	EXISTING CKT	20 A	1	0 VA	0 VA					1	20 A	EXISTING CKT	26
27	EXISTING CKT	20 A	1			0 VA	0 VA			1	20 A	EXISTING CKT	28
29	EXISTING CKT	20 A	1					0 VA	0 VA	1	20 A	EXISTING CKT	30
31	EXISTING CKT	20 A	1	0 VA	0 VA					1	20 A	EXISTING CKT	32
33	Spare	20 A	1			0 VA	696 VA			1	20 A	EF-2 (NOTE 1)	34
35	EXISTING CKT	20 A	1					0 VA	0 VA	1	20 A	EXISTING CKT	36
37	EXISTING CKT	70 A	3	0 VA	696 VA					1	20 A	EF-1 (NOTE 1)	38
39						0 VA	360 VA			1	20 A	ROOFTOP CONV RECEPT (NOTE 1)	40
41								0 VA	0 VA	1	20 A	EXISTING CKT	42
	1	Tota	l Load:	696	3 VA	105	66 VA	0	VA			1	

NOTE 1: PROPOSED BREAKER SHALL MATCH EXISTING PANEL TYPE AND AIC RATING.



PARTIAL THIRD FLOOR

SCALE: 3/64" = 1'-0"

BEDFORD CENTRAL SCHOOL DISTRICT PHASE 1A - BOND IMPROVEMENTS FOX LANE HIGH SCHOOL 632 S BEDFORD RD, BEDFORD, NY 10506	ROOF PLAN
PROJECT	DWGTITLE
	EEA
CHK. BY:	EEA

REV. DATE ITEM

THESE DRAWINGS ARE BASED ON CONSTRUCTION DRAWINGS NOT PREPARED BY BBS ARCHITECTS, LANDSCAPE ARCHITECTS AND ENGINEERS, PC. AND, THEREFORE, MAY NOT REPRESENT THE CONDITIONS AS CONSTRUCTED AT THE TIME. ALL EXISTING CONDITIONS SHOWN ARE REPRESENTED AS SUGGESTIVE INFORMATION AS THEY MAY NOT HAVE BEEN BUILT AND DETAILED PER THE ORIGINAL DOCUMENTS OR PER THE OWNER'S INFORMATION.


ARCHITECTS LANDSCAPE ARCHITECTS ENGINEERS BRANCH PROJECT CONTACT: 244 EAST MAIN STREET

187 WOLF ROAD, STE. 205 PATCHOGUE

ALBANY NEW YORK 11772

NEW YORK 12205 T. 631.475.0349 T. 518.621.7650 F. 631.475.0361 www.BBSARCHITECTURE.COM

THIS DRAWING, PREPARED FOR THE SPECIFIC PROJECT INDICATED IS AN INSTRUMENT OF SERVICE AND THE PROPERTY OF BBS ARCHITECTS, LANDSCAPE ARCHITECTS AND ENGINEERS, PC. INFRINGEMENT OR ANY USE OF THIS DRAWING FOR ANY OTHER PROJECT IS PROHIBITED. ANY ALTERATION OR REPRODUCTION OF THIS DOCUMENT IS ALSO PROHIBITED WITHOUT THE WRITTEN CONSENT OF THE ARCHITECT OR ENGINEER.

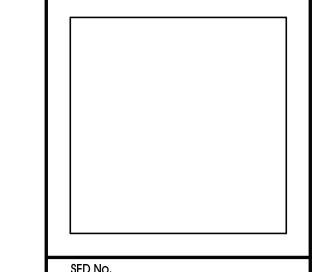

66-01-02-06-0-003-021 DISTRICT BEDFORD CENTRAL SCHOOL DISTRICT PROJECT
PHASE 1A - BOND IMPROVEMENTS DWG TITLE


ROOF PLAN SCALE:

DATE:

BID P/U DATE:

FILE NO. AS NOTED 2/2/2023 XX-XX-XX

E3.01 FLHS

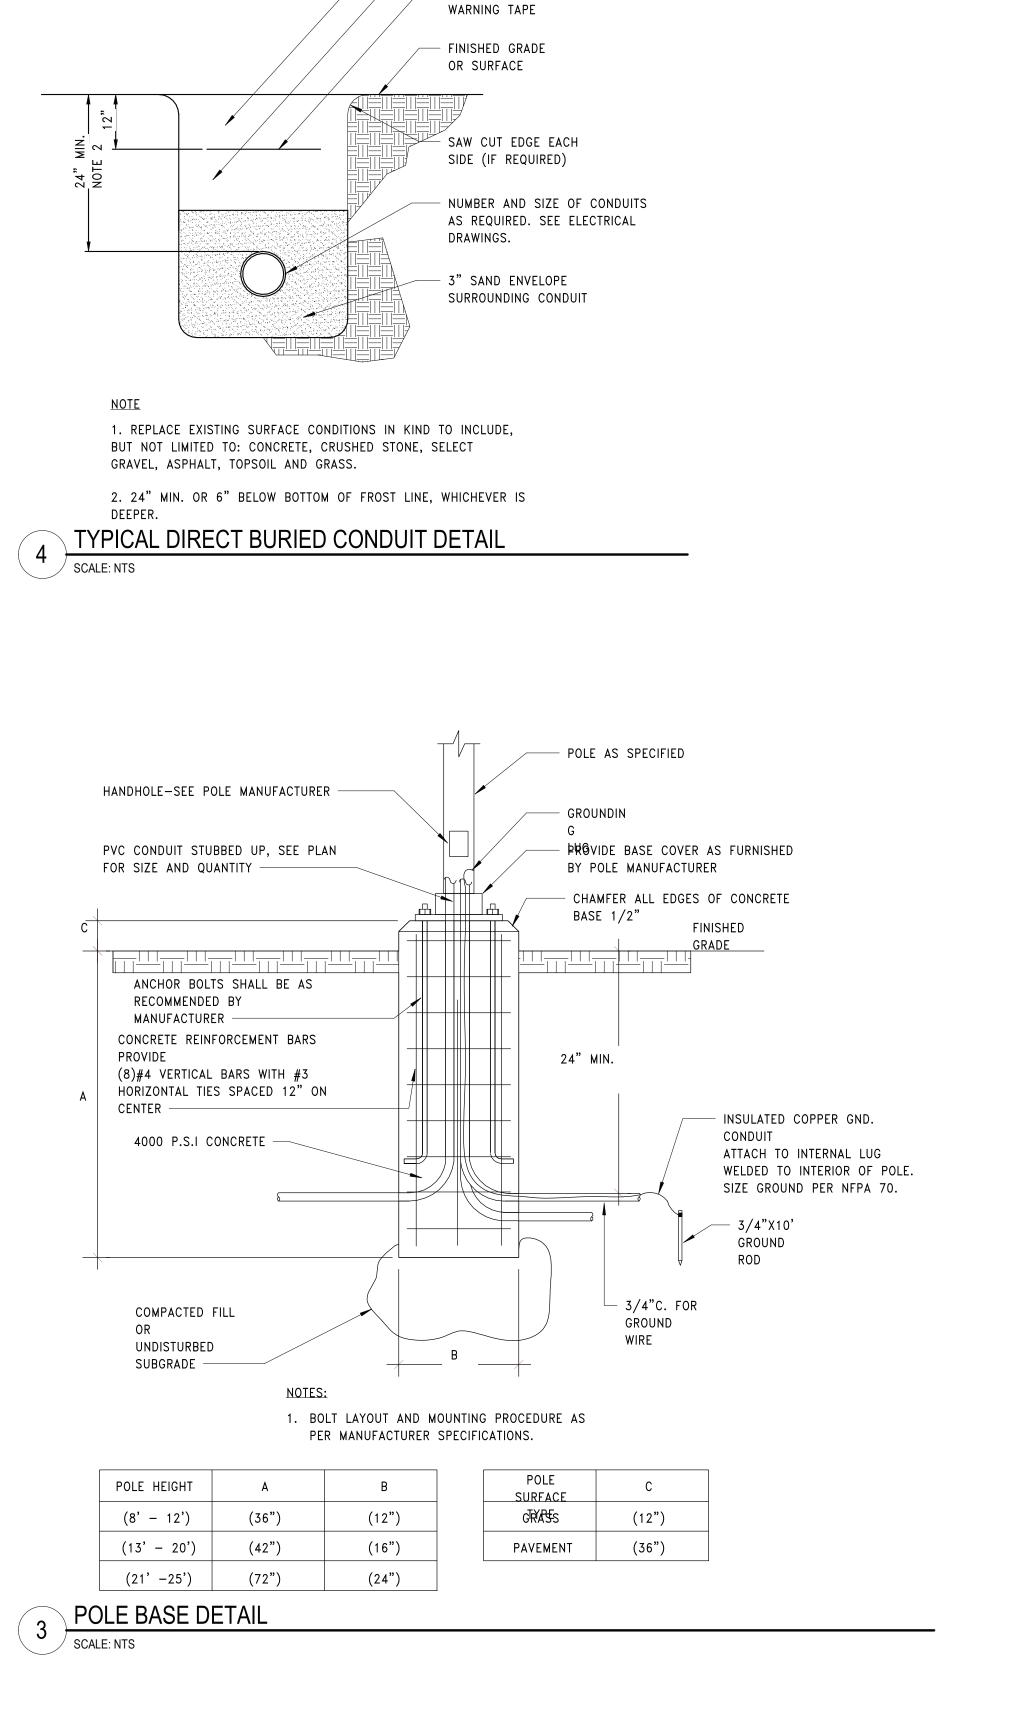

— DRILL WALL AND INSERT REBARS. USE NON-SHRINK GROUT. REFER TO DUCTBANK SECTIONS FOR

PVC CONDUIT

WRAP ALL JOINTS 100% WATER TIGHT

— #4 REBARS, 5'-0"

VAPOR

ON TOP AND BOTTOM OF DUCTBANK — TYPICAL – SEAL

BARRIER TO CONDUIT

COMPACTED BACKFILL

- METAL DETECTABLE

QUANTITY OF REBARS

WALL -

PULLBOX ----

SEE NOTE _____

A. NAMEPLATE,

NYLON


SCALE: NTS

CABLE TIE.

DETAIL NOTES:
AI EACH CONDUIT, PROVIDE AN ENGRAVED PLASTIC

INDICATING CONDUIT NO., AND ATTACH TO CONDUIT WITH

CONDUIT PENETRATION INTO BUILDING DETAIL

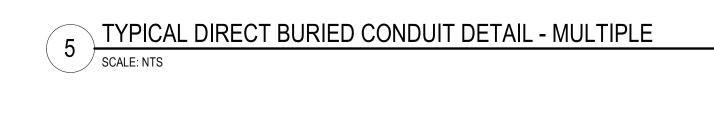

1. REPLACE EXISTING SURFACE CONDITIONS IN KIND TO INCLUDE,

2. 24" MIN. OR 6" BELOW BOTTOM OF FROST LINE, WHICHEVER IS

BUT NOT LIMITED TO: CONCRETE, CRUSHED STONE, SELECT

GRAVEL, ASPHALT, TOPSOIL AND GRASS.

<u>NOTE</u>

DEEPER.

7" MINIMUM SPACING - NOTE 1

- COMPACTED BACKFILL

- METAL DETECTABLE

WARNING TAPE

FINISHED GRADE OR SURFACE

SAW CUT EDGE EACH

NUMBER AND SIZE OF CONDUITS


AS REQUIRED. SEE ELECTRICAL


SIDE (IF REQUIRED)


3" SAND ENVELOPE


SURROUNDING CONDUIT

DRAWINGS.

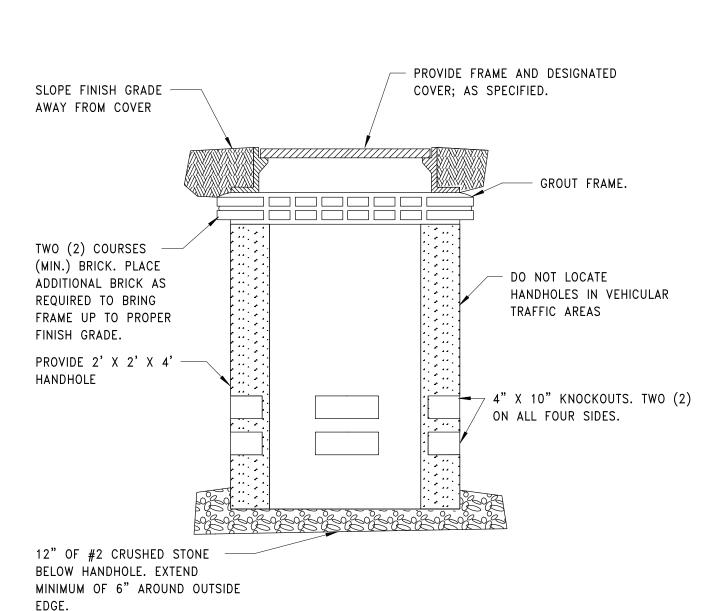

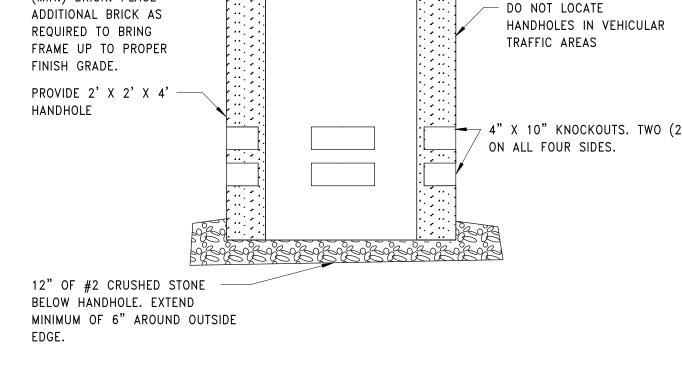


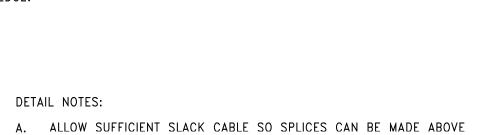


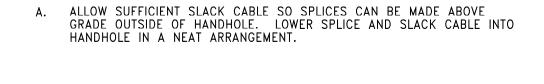


HAND HOLE DETAIL SCALE: NTS



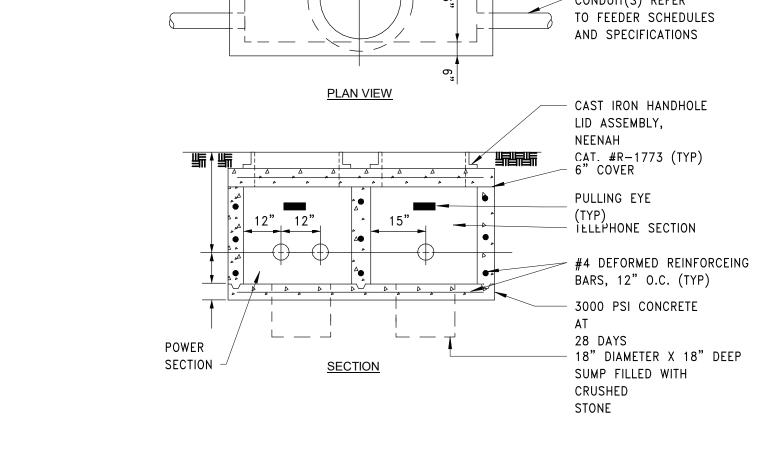

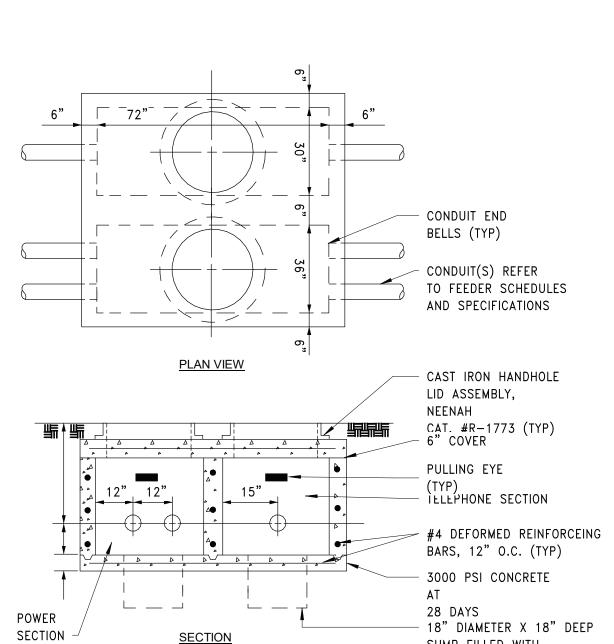


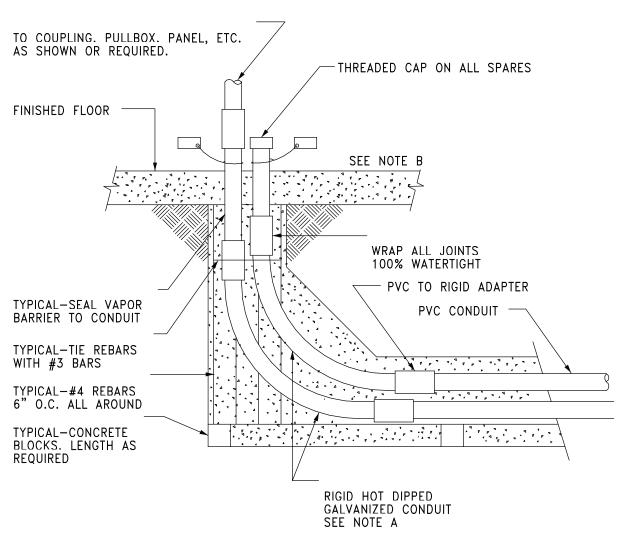

B. AT EACH CONDUIT STUB-UP. AFFIX ENGRAVED PLASTIC NAMEPLATE INDICATING CONDUIT NO. OR CIRCUIT IDENTIFICATION. ATTACH WITH NYLON CABLE TIE.

SWITCHGEAR, PROVIDE PVC ELBOWS IN LIEU OF RIGID SHOWN.

CONDUIT STUB UP INSIDE BUILDING DETAIL SCALE: NTS

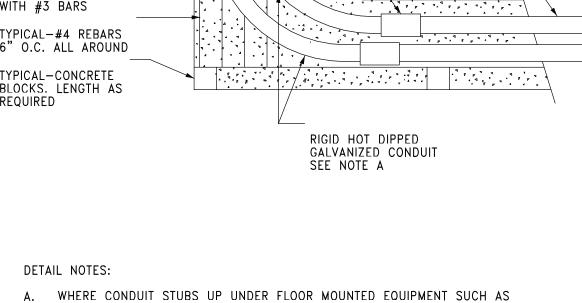

DRWG. BY: Author

REV. DATE

ITEM

THESE DRAWINGS ARE BASED ON CONSTRUCTION

ARCHITECTS AND ENGINEERS, PC. AND, THEREFORE, MAY NOT REPRESENT THE CONDITIONS AS CONSTRUCTED AT THE TIME. ALL EXISTING CONDITIONS SHOWN ARE REPRESENTED AS SUGGESTIVE INFORMATION AS THEY MAY NOT HAVE BEEN

BUILT AND DETAILED PER THE ORIGINAL DOCUMENTS OR PER THE OWNER'S INFORMATION.

DRAWINGS NOT PREPARED BY BBS ARCHITECTS, LANDSCAPE

ARCHITECTS LANDSCAPE ARCHITECTS **ENGINEERS** BRANCH PROJECT CONTACT: 244 EAST MAIN STREET 187 WOLF ROAD, STE. 205 PATCHOGUE NEW YORK 11772 ALBANY NEW YORK 12205 T. 631.475.0349 F. 631.475.0361 T. 518.621.7650 www.BBSARCHITECTURE.COM

CHK. BY: Checker

THIS DRAWING, PREPARED FOR THE SPECIFIC PROJECT INDICATED IS AN INSTRUMENT OF SERVICE AND THE PROPERTY OF BBS ARCHITECTS, LANDSCAPE ARCHITECTS AND ENGINEERS, PC. INFRINGEMENT OR ANY USE OF THIS

DRAWING FOR ANY OTHER PROJECT IS PROHIBITED. ANY ALTERATION OR REPRODUCTION OF THIS DOCUMENT IS ALSO PROHIBITED WITHOUT THE WRITTEN CONSENT OF

THE ARCHITECT OR ENGINEER.

SED No. 66-01-02-06-0-003-021 <u>DISTRICT</u> BEDFORD CENTRAL SCHOOL <u>PROJECT</u> PHASE 1A - BOND IMPROVEMENTS DWG TITLE **ELECTRICAL DETAILS** SCALE: AS NOTED DATE:

XX-XX-XX BID P/U DATE: FILE NO. 22-225A

E4.01 FLHS