


ABATEMENT PLAN - FIRST FLOOR CENTRAL HOUSE

SCALE: 3/32" = 1'-0"

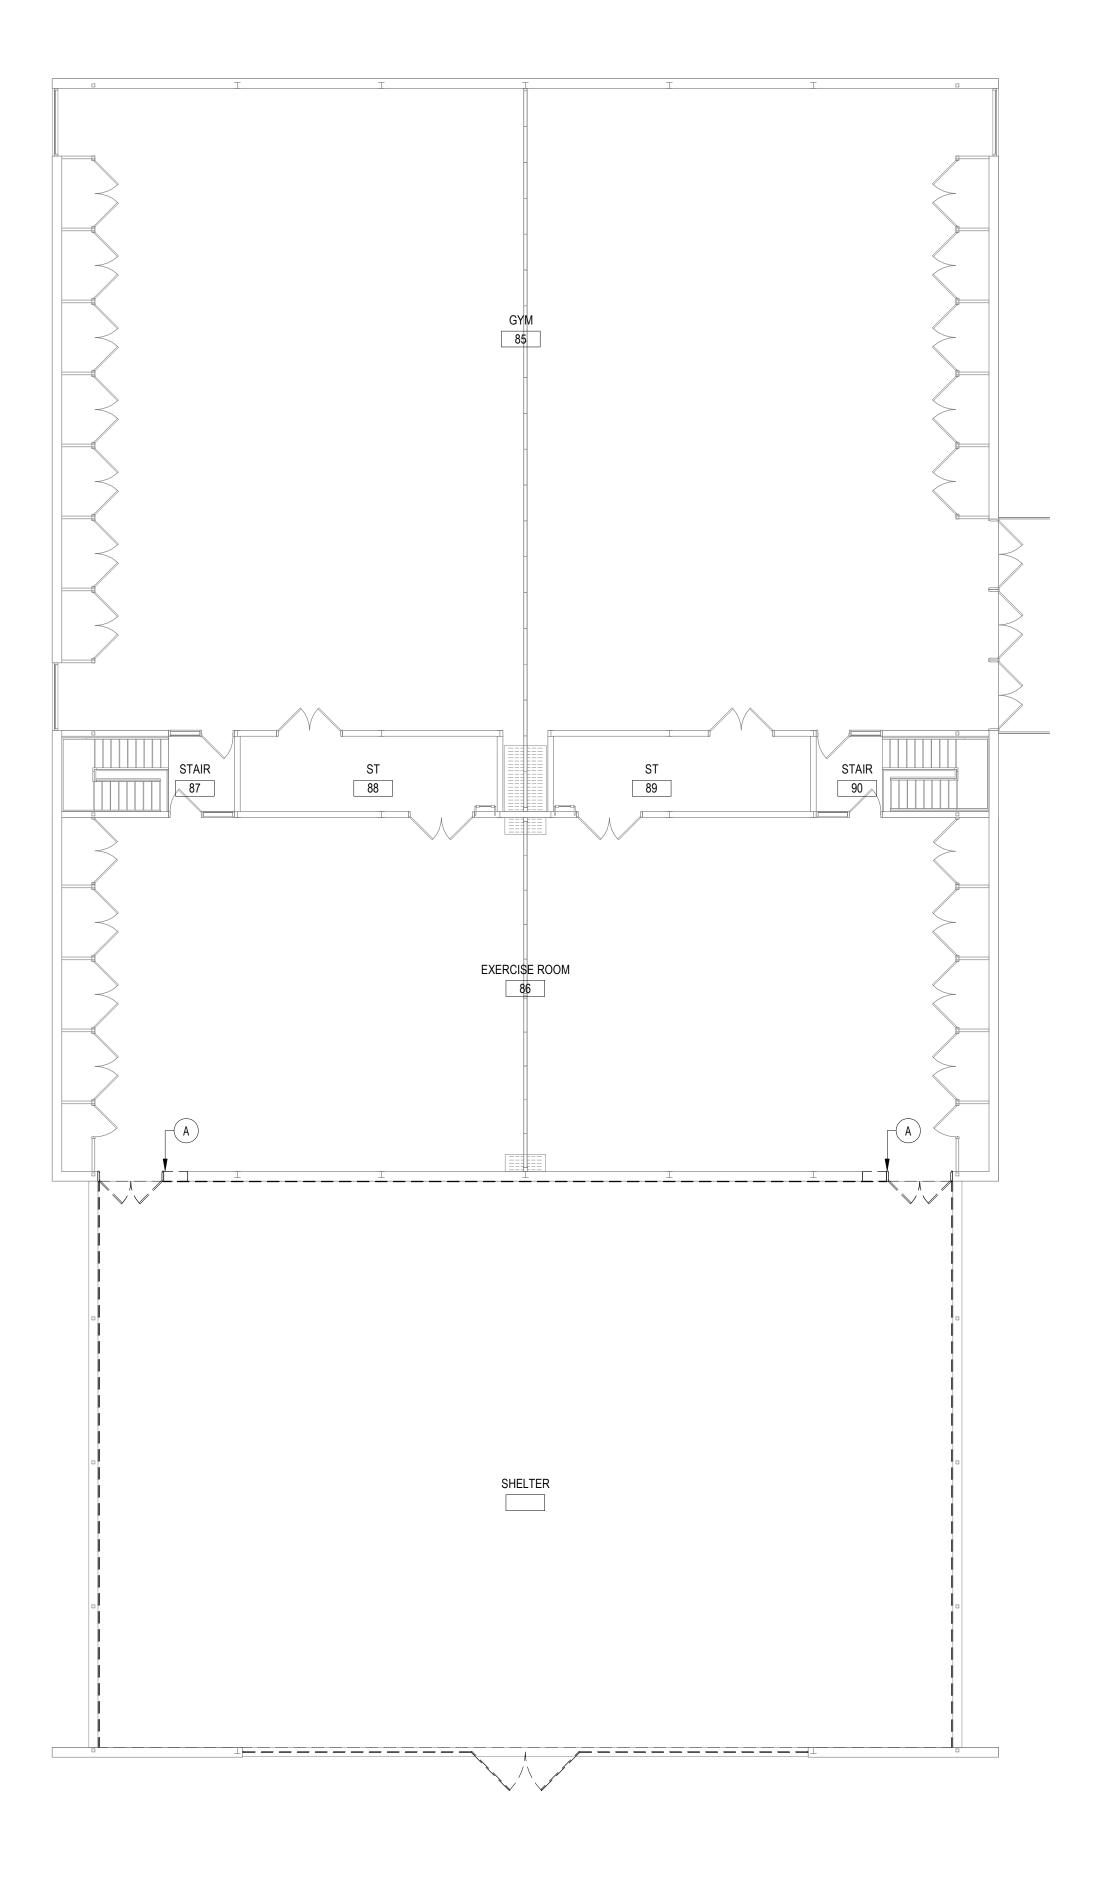

ABATEMENT PLAN - GYMNASIUM

GENERAL ABATEMENT NOTES

- ALL LEAD, ASBESTOS AND/OR PCB REMOVAL BY G.C. THE CONTRACTOR SHALL PERFORM A SITE INSPECTION PRIOR TO SUBMITTING A BID TO REVIEW AND QUANTIFY ALL ASBESTOS, LEAD and/or PCB CONTAINING CONSTRUCTION MATERIALS TO BE REMOVED OR AFFECTED BY THE PROPOSED SCOPE OF WORK.
- 2. REFER TO ASBESTOS, LEAD AND PCB CONSTRUCTION NOTES THIS DRAWING FOR ADDITIONAL INFORMATION.
- 3. REFER TO SPECIFICATIONS INFORMATION TO BIDDERS FOR LEAD / ASBESTOS INSPECTION AND TESTING REPORTS FOR ADDITIONAL INFORMATION.
- 4. EACH CONTRACTOR PERFORMING WORK WITHIN OR ADJACENT TO ASBESTOS CONTAINING CONSTRUCTION MATERIALS SHALL EXERCISE EXTREME CAUTION TO NOT DAMAGE OR DISTURB EXISTING MATERIALS TO REMAIN. EACH CONTRACTOR SHALL BE / OBTAIN OSHA ASBESTOS TRAINING CERTIFIED TO PERFORM SPECIFIED WORK IN OR ADJACENT TO

CONTAMINATED SPECIFICATIONS. EACH CONTRACTOR IS RESPONSIBLE FOR PROPER DISPOSABLE CLOTHING AND/OR MASKS IF REQUIRED

ASBESTOS, LEAD, AND PCB NOTES

- 1. ALL CONTRACTORS SHALL BE ADVISED THAT THE SCHOOL DISTRICT HAS SOLICITED AN INDEPENDENT TESTING COMPANY TO INSPECT AND TEST ALL AREAS OF THE EXISTING BUILDING WHICH ARE SCHEDULED TO BE DISTURBED DURING CONSTRUCTION FOR THE PRESENCE OF ASBESTOS, LEAD AND /OR PCB CONTAINING CONSTRUCTION MATERIALS.
- 2. RESULTS OF THE INSPECTIONS AND TESTING INDICATE THAT THE EXISTING BUILDING HAS TESTED POSITIVE FOR THE PRESENCE OF ASBESTOS, LEAD AND/OR PCB CONTAINING CONSTRUCTION MATERIALS. REFER TO SPECIFICATIONS FOR DESCRIPTION OF LOCATION,

MATERIALS AND SAMPLE NUMBERS.

ALL DISTURBANCE, REMOVAL OR DEMOLITION WORK TO THESE IDENTIFIED AREAS MUST BE PERFORMED IN CONFORMANCE WITH THE GUIDELINES AS OUTLINED IN THE PROJECT MANUAL AND APPLICABLE LOCAL, STATE AND/OR FEDERAL REGULATIONS

FLUORESCENT BULB NOTES

ALL EXISTING FLUORESCENT BULBS TO BE REMOVED SHALL BE CONSIDERED HAZARDOUS WASTE AND SHOULD BE HANDLED AND DISPOSED OF IN ACCORDANCE WITH THE NEW YORK STATE DEPARTMENT OF ENVIRONMENTAL CONSERVATION (DEC) & UNITED STATES ENVIRONMENTAL PROTECTION AGENCY (EPA) RULES, REGULATIONS & GUIDELINES.

REV. DATE

THESE DRAWINGS ARE BASED ON CONSTRUCTION RAWINGS NOT PREPARED BY BBS ARCHITECTS, LANDSCAPE

ARCHITECTS AND ENGINEERS, PC. AND, THEREFORE, MAY NOT REPRESENT THE CONDITIONS AS CONSTRUCTED AT THE

TIME. ALL EXISTING CONDITIONS SHOWN ARE REPRESENTED AS SUGGESTIVE INFORMATION AS THEY MAY NOT HAVE BEEN

BUILT AND DETAILED PER THE ORIGINAL DOCUMENTS OR PER THE OWNER'S INFORMATION.

$\left(f{A} ight)$ AREAS INDICATED: ASBESTOS CONTAINING DOOR FRAME TAR.

ASBESTOS KEY NOTES

(B) AREAS INDICATED: ASBESTOS CONTAINING FLOOR (APPROX 6 SQFT)

REFER TO PRE CONSTRUCTION SURVEY, BULK SAMPLING AND ANALYSIS OF SUSPECT

ASBESTOS CONTAINING MATERIALS (INFORMATION AVAILABLE TO BIDDERS) FOR ASSUMED ASBESTOS CONTAINING CONSTRUCTION MATERIALS NOT IDENTIFIED BY KEYNOTES WHICH MAYBE SHOWN AS DEMOLITION OR POTENTIALLY DISTURBED AS A RESULT OF THE PROPOSED RENOVATIONS.

PRE-ABATEMENT WORK NOTES:

THE CONTRACTOR SHALL DETERMINE EXACT FINAL LOCATIONS OF PERSONAL AND WASTE DECONTAMINATION ENCLOSURES, PICK UP AREA FOR REFUSE AND ASSESTOS DEBRIS. THESE LOCATIONS OF PERSONAL AIM WAS IE DECONTAMINATION ENCLOSURES, PICK UP AREA FOR REFUSE AND ASSESTOS DEBRIS. THESE LOCATIONS SHALL BE REVIEWED AND PROPERLY APPROVED BY THE DISTRICT PRIOR TO THE COMMENCEMENT OF WORK. THIS CONTRACTOR SHALL ESTABLISH, LABEL, AND MAINTAIN PROPER EXITS AND WAYS OF DEPARTURE WITHIN EACH WORK AREA FOR NORMAL AND EMERGENCY USE BY WORKERS DURING ALL ABATEMENT.

POST-ABATEMENT WORK NOTES:

THE CONTRACTOR SHALL, UPON COMPLETION OF REMOVALS, PROVIDE WRITTEN DOCUMENTATION THAT THE PROJECT WORK AREAS ARE COMPLETELY FREE OF ALL HAZARDOUS MATERIALS.

THE CONTRACTOR SHALL PROVIDE RECORDS OF ALL HAZARDOUS MATERIALS REMOVED FROM THE SITE

KEY PLAN

NO SCALE √


DRWG. BY: Author

CHK. BY: Checker THIS DRAWING, PREPARED FOR THE SPECIFIC PROJECT INDICATED IS AN INSTRUMENT OF SERVICE AND THE PROPERTY OF BBS ARCHITECTS, LANDSCAPE ARCHITECTS AND ENGINEERS, PC. INFRINGEMENT OR ANY USE OF THIS DRAWING FOR ANY OTHER PROJECT IS PROHIBITED. ANY ALTERATION OR REPRODUCTION OF THIS DOCUMENT IS ALSO PROHIBITED WITHOUT THE WRITTEN CONSENT OF THE ARCHITECT OR ENGINEER.



ENGINEERS BRANCH PROJECT CONTACT: 244 EAST MAIN STREET 187 WOLF ROAD, STE. 205 PATCHOGUE 187 WOLF ROAD, STE. 205 ALBANY NEW YORK 11772 NEW YORK 12205 T. 631.475.0349

T. 518.621.7650 F. 631.475.0361 www.BBSARCHITECTURE.COM

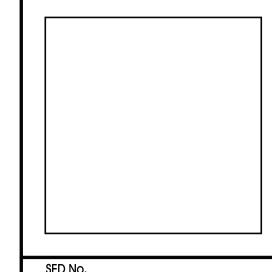


66-01-02-06-0-007-011 DISTRICT BEDFORD CENTRAL SCHOOL DISTRICT

PROJECT
PHASE 1A - BOND IMPROVEMENTS DWG TITLE ABATEMENT PLANS

 SCALE:
 AS NOTED

 DATE:
 BID P/U DATE:
 2/2/2023 9:46:31 AM

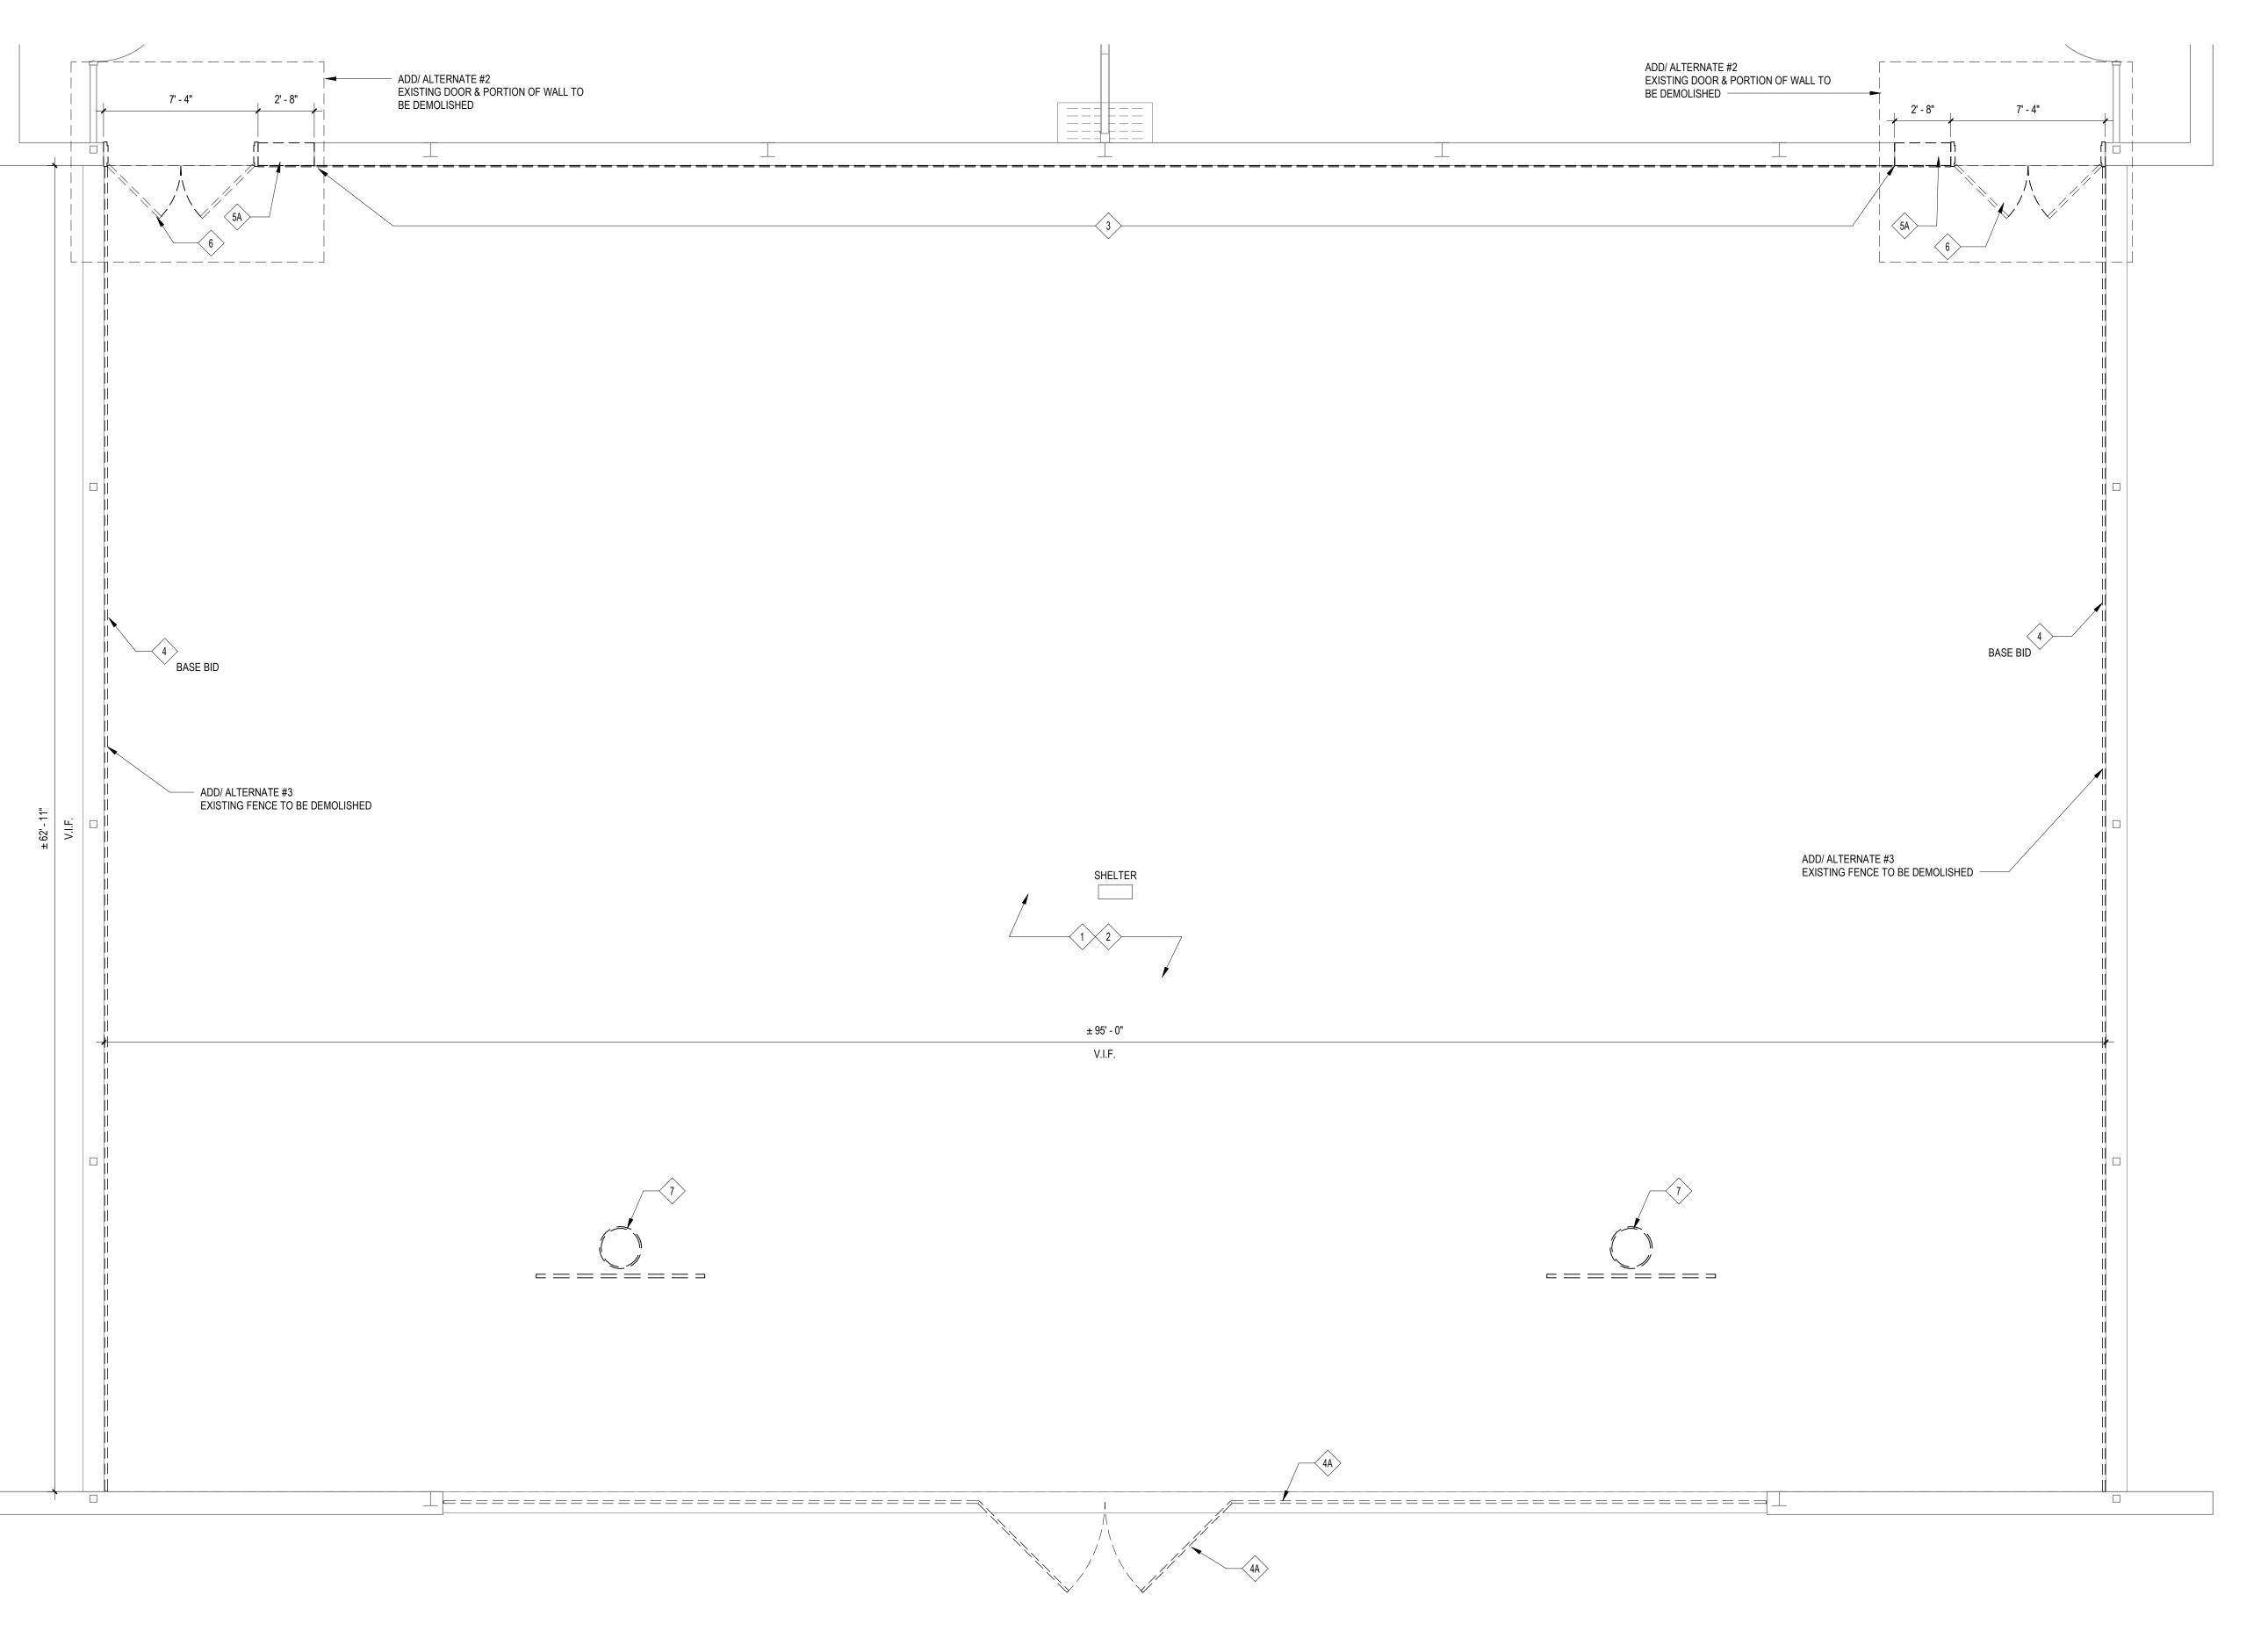

DEMOLITION PLAN - GYMNASIUM

GENERAL REMOVAL NOTES:

1. THE GENERAL CONTRACTOR IS RESPONSIBLE FOR ALL DEMOLITION AND REMOVAL, UNLESS NOTED OTHERWISE. MECHANICAL, PLUMBING AND ELECTRICAL CONTRACTORS SHALL BE RESPONSIBLE FOR ALL DISCONNECTS. G.C. TO COORDINATE DEMOLITION WITH M.C., P.C. AND E.C. REFER TO M.E.P. SERIES DEMOLITION DRAWINGS FOR ADDITIONAL INFORMATION AND DEMOLITION SCOPE BY GENERAL CONTRACTOR NOT SHOWN THIS DWG. TYPICAL FOR ALL AREAS OF INTERIOR DEMOLITION AND/OR RECONSTRUCTION.

2. IT SHALL BE NOTED THAT G.C. SHALL BE RESPONSIBLE TO OPEN UP ALL WALLS (CMU OR FRAME) AND ALL FLOORS (CONCRETE) AS MAY BE REQUIRED FOR THE P.C. TO PERFORM THEIR WORK. THE G.C. SHALL BE RESPONSIBLE TO TEMPORARILY SHORE-UP THE WALLS AND CLOSE UP ALL WALLS AND FLOORS IN SIZE/COURSE THICKNESS AND TYPES TO MATCH EXIST.

THEIR WORK. THE G.C. SHALL BE RESPONSIBLE TO TEMPORARILY SHORE-UP THE WALLS AND CLOSE UP ALL WALLS AND FLOORS IN SIZE/COURSE THICKNESS AND TYPES TO MATCH EXIST. ADJACENT.

3. NOTED CASEWORK AND FURNITURE REMOVALS MAY BE BASE CABINETS, COUNTERS, WALL

CABINETS, SHELVING, BUILT IN CASEWORK, INSTRUMENT STORAGE CABINETS OR
APPLIANCES. OWNER TO REMOVE ALL LOOSE FURNISHINGS AND STORED MATERIALS PRIOR
TO START OF WORK.

4. C.C. SHALL DEMOVE ALL MAIT, MASTIC AND WALL BASE, AND YOR LEAD CONTAINING.

 G.C. SHALL REMOVE ALL V.A.T., MASTIC AND WALL BASE, AND/OR LEAD CONTAINING CONSTRUCTION MATERIALS. REFER TO ASBESTOS/LEAD ABATEMENT PLAN AND INSPECTION/TEST RESULTS FOR ADDITIONAL INFORMATION.

 ALL REMOVALS OF EXISTING FIXTURES WHICH ARE AFFIXED TO V.A.T. SHALL BE TREATED AS AN ASBESTOS ABATEMENT ITEM AND SHALL CONFORM TO REMOVAL PROCEDURES AND REQUIREMENTS.

6. G.C. SHALL SAWCUT WALLS, FLOORS, ROOF, ETC. UNLESS OTHERWISE NOTED. REFER TO M.E.P. DRAWINGS FOR LOCATIONS, DESCRIPTIONS AND RESPONSIBILITIES.

7. G.C. SHALL PATCH, REPLACE, OR REPAIR DAMAGE CAUSED TO EXIST. FLOOR, WALLS, ROOF, ETC. SHOWN TO REMAIN AS A RESULT OF DEMOLITION TO PRIOR CONDITION OR MATCH ADJACENT NEW CONSTRUCTION.

8. G.C. SHALL VERIFY ALL REMOVALS W/ OWNERS REPRESENTATIVE/OWNER, AND M.C., P.C., OR E.C. PRIOR TO COMMENCEMENT.

9. NOTED FLOORING REMOVALS MAY BE V.C.T., CARPET OR TERRAZZO. NOTED CEILING REMOVALS MAY BE CONCEALED SPLINE SYSTEM, ACOUSTICAL TILE/GRID SYSTEM, SOFFITS AND FRAMING, OR PLASTER W. SUPPORT FRAMING. NOTED WALL REMOVALS MAY BE GYP. BD. W/ FRAMING, CMU, CMU W/ APPLIED FINISHES, BRICK, OPERABLE PARTITIONS W/ TRACK/ SUPPORTS AND SHALL INCLUDE ALL DOORS AND FRAMES WHERE SHOWN. UNLESS OTHERWISE NOTED, ALL EXISTING WALL MOUNTED CHALK BD., WHITE BD. OR TACK BD. AND MASTIC/ADHESIVE SHALL BE REMOVED.

10. IN ALL AREAS OF FLOORING REMOVALS - THE G.C. SHALL BE RESPONSIBLE TO COMPLETELY FLASH PATCH THE ENTIRE FLOOR SURFACE. IN PREPARATION OF INSTALLATION OF NEW FINISHED FLOORING. G.C. SHALL FLASH PATCH THE SURFACE WITH "ARDEX" SD-F FEATHER FINISH OR APPROVED EQUAL. FLOOR SURFACES SHALL BE SMOOTH, FREE OF DEPRESSION, BUMPS, UNEVENNESS - LEVEL TO A TOLERANCE OF A MINIMUM OF +/- 1/8" AND OR AS SPECIFIED BY THE FLOORING MANUFACTURERS FLOORING INSTALLATION SPECIFICATIONS. THE G.C. SHALL BE RESPONSIBLE TO MAKE ANY NECESSARY CORRECTIONS TO THE FLOOR SUBSTRATE AS MAY BE DEEMED NECESSARY BY THE ARCHITECT, AT NO ADDITIONAL COST TO THE OWNER.

DEMOLITION LEGEND:

EXISTING CONSTRUCTION TO BE REMOVED
(PATCH ALL SURFACES)

ROOM

222

ROOM NAME AND NUMBER

DEMOLITION KEY NOTES:

(COORDINATE WITH ASBESTOS, LEAD AND PCB ABATEMENT TESTING REPORTS, ATTACHED TO THE PROJECT MANUAL, PRIOR TO COMMENCE ANY REMOVALS)

1 REMOVE EXISTING ASPHALT PAVING IN IT'S ENTIRETY - PREP SUBBASE TO ACCEPT ASPHALT BASE & NEW COATING.

2 SCRAPE EXISTING WOOD CEILING, AND PREP FOR NEW FINISH
REMOVE EXISTING PLYWOOD BOARDS ON WALL, AND PREP SUBSTRATE FOR NEW

4 EXISTING FENCE TO BE SALVAGED AND REUSED.

4A EXISTING FENCE & GATE TO BE DEMOLISHED

REMOVE EXISTING SELECTED WALL IN THEIR ENTIRETY - PATCH/REPAIR/RESTORE REMAINING WALL TO ACCEPT NEW FINISHES - COORDINATE W/MEP CONTRACTORS FOR

REMOVE EXISTING PORTION OF SELECTED WALL AS REQUIRED FOR NEW DOOR OR WINDOW AND APPLICABLE FRAME SYSTEM - PATCH/REPAIR/RESTORE REMAINING WALL TO ACCEPT NEW FINISHES - COORDINATE W/MEP CONTRACTORS FOR DISCONNECTS


6 REMOVE EXISTING DOOR & FRAMES IN THEIR ENTIRETY - PATCH/REPAIR/RESTORE WALL TO ACCEPT NEW FINISHES.

REMOVE EXISTING BASKETBALL BLACKSTOP IN ITS ENTIRITY - PATCH/REPAIR/RESTORE CEILING & STRUCTURE TO ACCEPT NEW FINISHES.

REV. DATE ITEM

NOTIC

THESE DRAWINGS ARE BASED ON CONSTRUCTION DRAWINGS NOT PREPARED BY BBS ARCHITECTS, LANDSCAPE ARCHITECTS AND ENGINEERS, PC. AND, THEREFORE, MAY NOT REPRESENT THE CONDITIONS AS CONSTRUCTED AT THE TIME. ALL EXISTING CONDITIONS SHOWN ARE REPRESENTED AS SUGGESTIVE INFORMATION AS THEY MAY NOT HAVE BEEN BUILT AND DETAILED PER THE ORIGINAL DOCUMENTS OR PER THE OWNER'S INFORMATION.

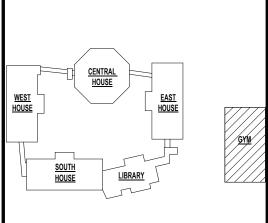

KEY PLAN

NO SCALE

DISTRICT MENTS JOL 10506

PROJECT
BEDFORD CENTRAL SCHOOL DISTF
PHASE 1A - BOND IMPROVEMENT
FOX LANE MIDDLE SCHOOL
632 S BEDFORD RD, BEDFORD, NY 10506
DEMOLITION PLAN


CHK. BY: G.E.O.

THIS DRAWING, PREPARED FOR THE SPECIFIC PROJECT INDICATED IS AN INSTRUMENT OF SERVICE AND THE PROPERTY OF BBS ARCHITECTS, LANDSCAPE ARCHITECTS AND ENGINEERS, PC. INFRINGEMENT OR ANY USE OF THIS DRAWING FOR ANY OTHER PROJECT IS PROHIBITED. ANY ALTERATION OR REPRODUCTION OF THIS DOCUMENT IS ALSO PROHIBITED WITHOUT THE WRITTEN CONSENT OF THE ARCHITECT OR ENGINEER.

ARCHITECTS
LANDSCAPE ARCHITECTS

ENGINEERS

BRANCH PROJECT CONTACT: | 244 EAST MAIN STREET | PATCHOGUE | NEW YORK 11772 | T. 631.475.0349 | F. 631.475.0361

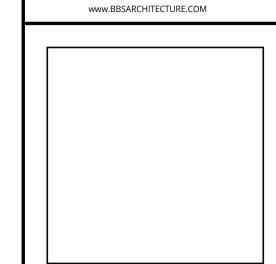

SED No.

66-01-02-06-0-007-011

DISTRICT

BEDFORD CENTRAL SCHOOL
DISTRICT

PROJECT
PHASE 1A - BOND IMPROVEMENTS

DWG TITLE

DEMOLITION PLAN


SCALE: AS NOTED


DATE:

BID P/U DATE: 2/2/2023 9:46:32 AM

FILE NO. 22-225B

A1.01 | FLMS |

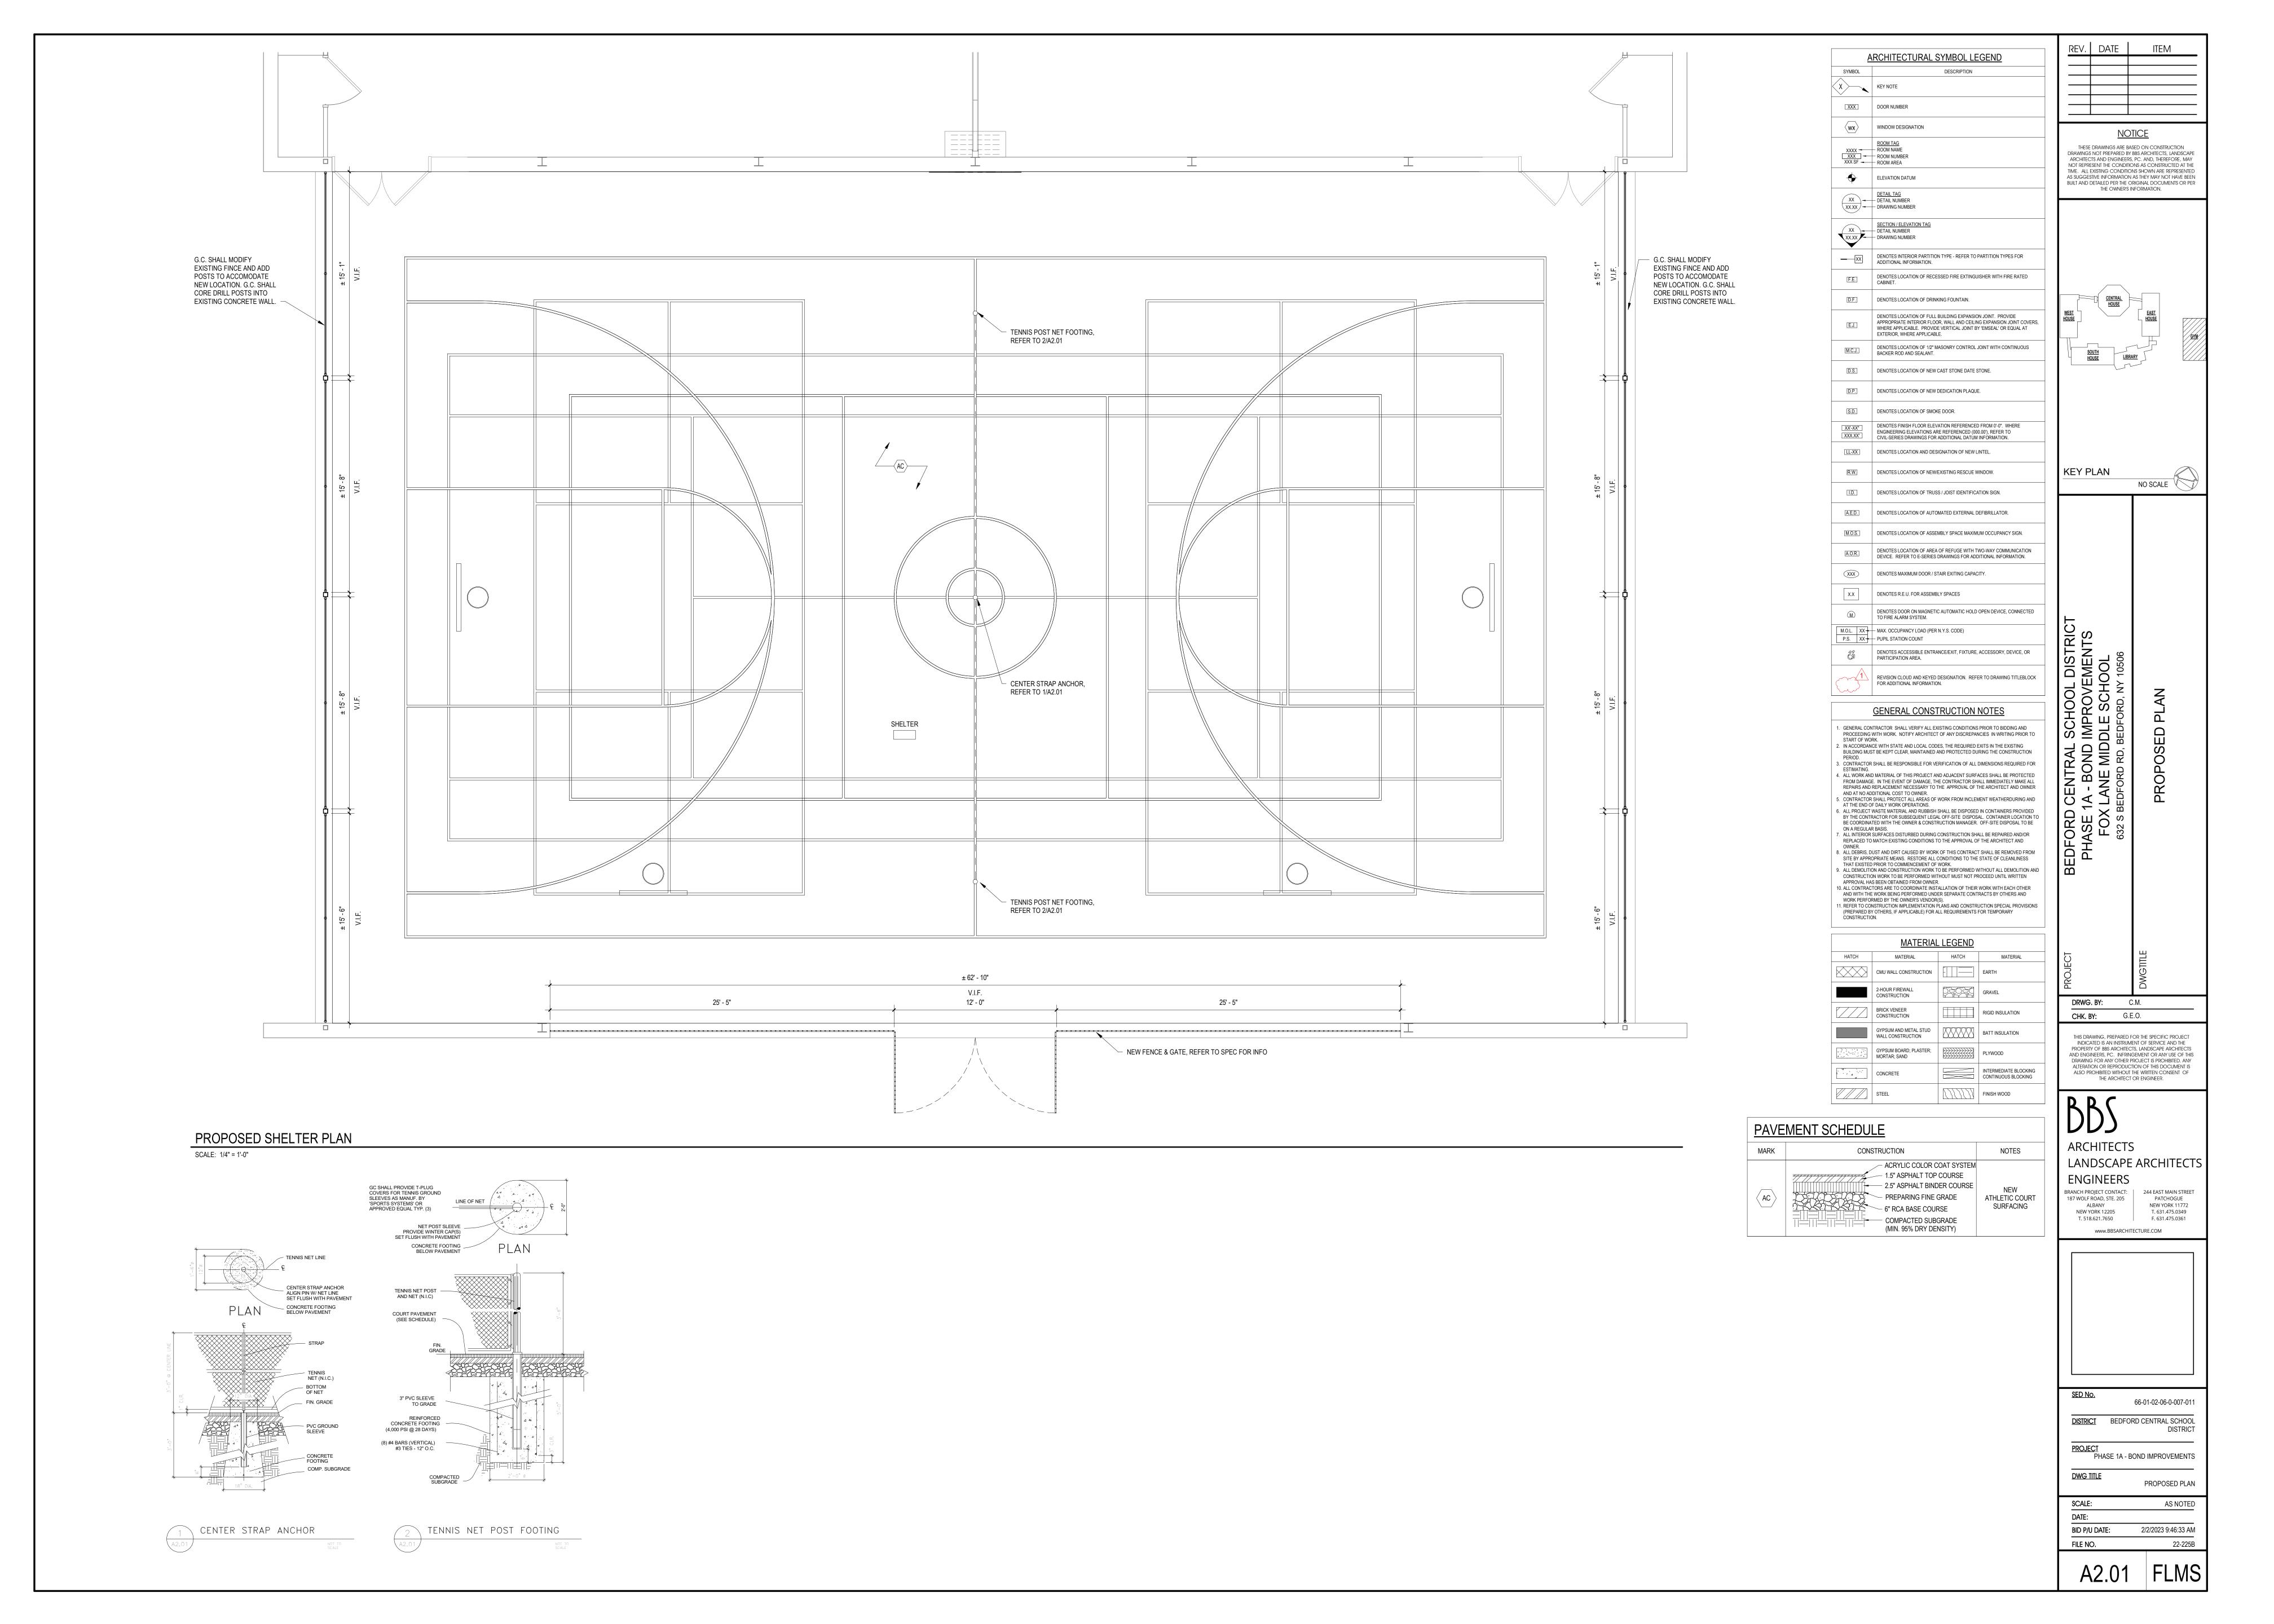

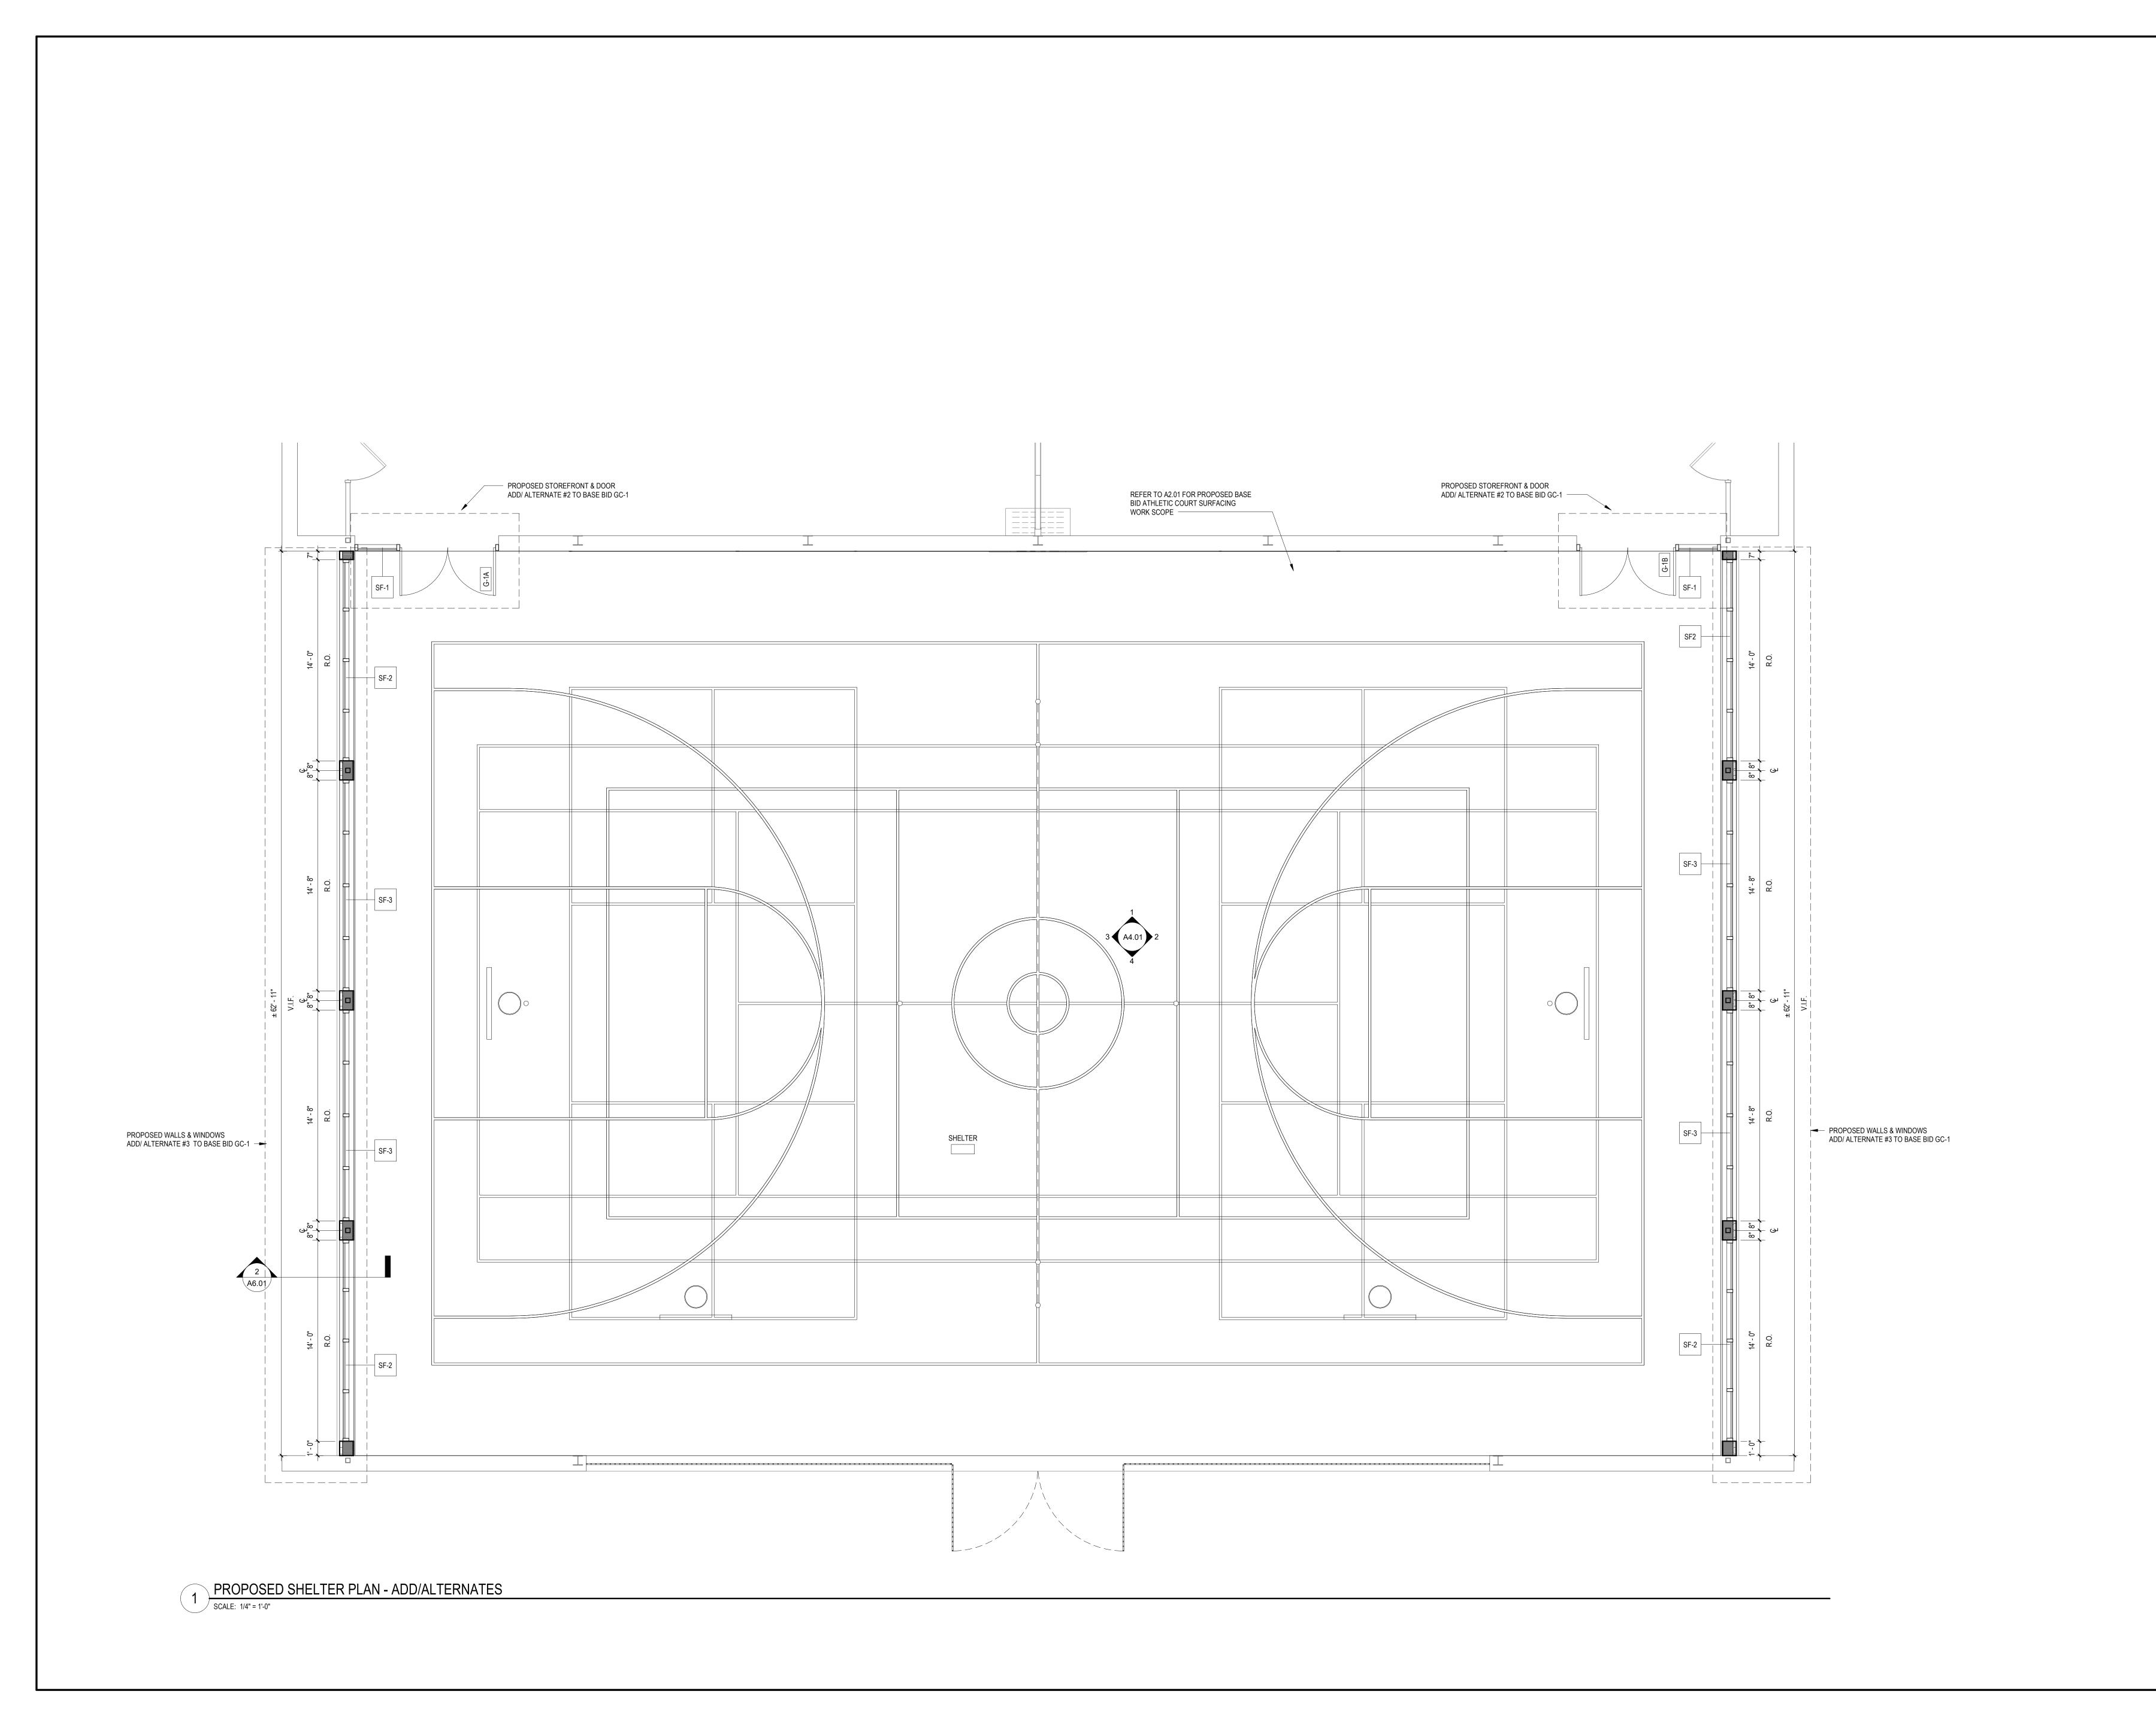

rev. | date | THESE DRAWINGS ARE BASED ON CONSTRUCTION DRAWINGS NOT PREPARED BY BBS ARCHITECTS, LANDSCAPE ARCHITECTS AND ENGINEERS, PC. AND, THEREFORE, MAY NOT REPRESENT THE CONDITIONS AS CONSTRUCTED AT THE TIME. ALL EXISTING CONDITIONS SHOWN ARE REPRESENTED AS SUGGESTIVE INFORMATION AS THEY MAY NOT HAVE BEEN BUILT AND DETAILED PER THE ORIGINAL DOCUMENTS OR PER THE OWNER'S INFORMATION.

DRWG. BY: C.M.

CHK. BY: G.E.O.

THIS DRAWING, PREPARED FOR THE SPECIFIC PROJECT INDICATED IS AN INSTRUMENT OF SERVICE AND THE PROPERTY OF BBS ARCHITECTS, LANDSCAPE ARCHITECTS AND ENGINEERS, PC. INFRINGEMENT OR ANY USE OF THIS DRAWING FOR ANY OTHER PROJECT IS PROHIBITED. ANY ALTERATION OR REPRODUCTION OF THIS DOCUMENT IS ALSO PROHIBITED WITHOUT THE WRITTEN CONSENT OF THE ARCHITECT OR ENGINEER.


ARCHITECTS
LANDSCAPE ARCHITECTS
ENGINEERS

BRANCH PROJECT CONTACT: 187 WOLF ROAD, STE. 205
ALBANY
NEW YORK 12205
T. 518.621.7650

ALBANY
NEW YORK 12305
T. 518.621.7650

ALBANY
NEW YORK 12305
F. 631.475.0361

www.BBSARCHITECTURE.COM

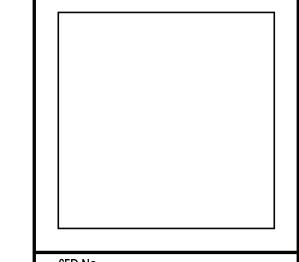

SED No.

66-01-02-06-0-007-011

DISTRICT


BEDFORD CENTRAL SCHOOL
DISTRICT


PROJECT
PHASE 1A - BOND IMPROVEMENTS

DWG TITLE
PROPOSED PLAN - ADD/ALTERNATES

SCALE:
AS NOTED
DATE:
BID P/U DATE: 2/2/2023 9:46:33 AM
FILE NO. 22-225B

FILE NO. 22-225B

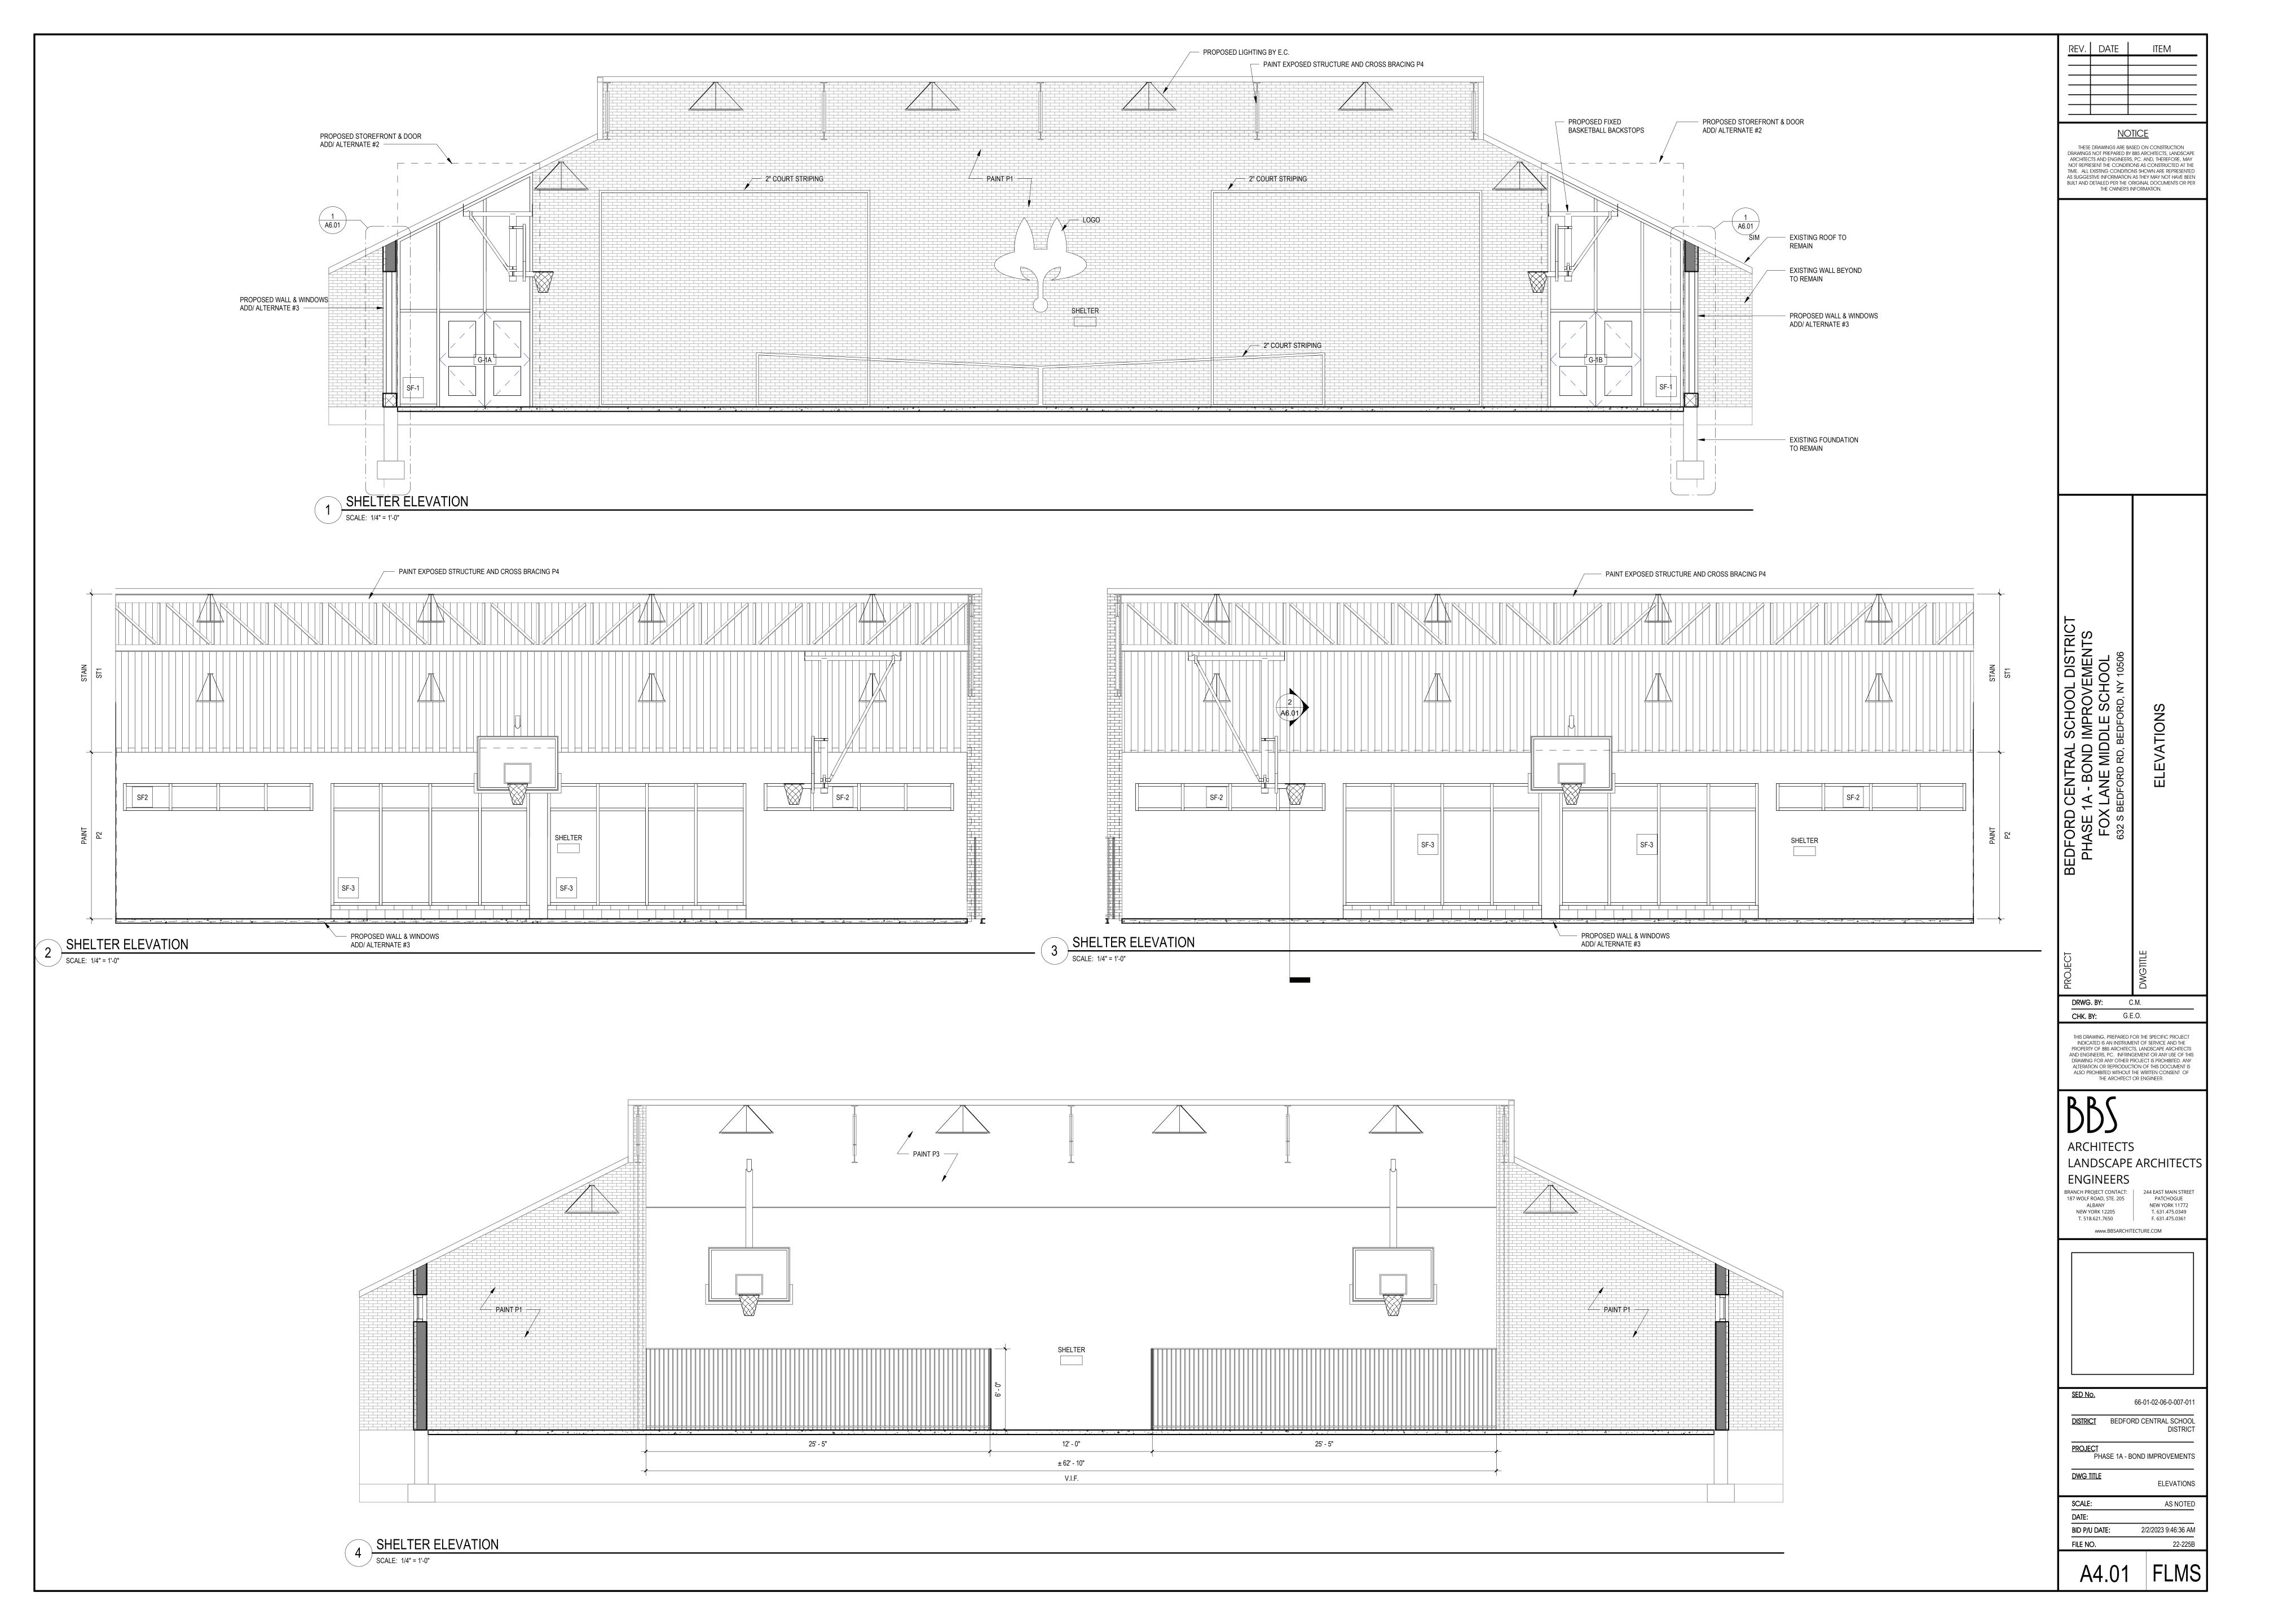


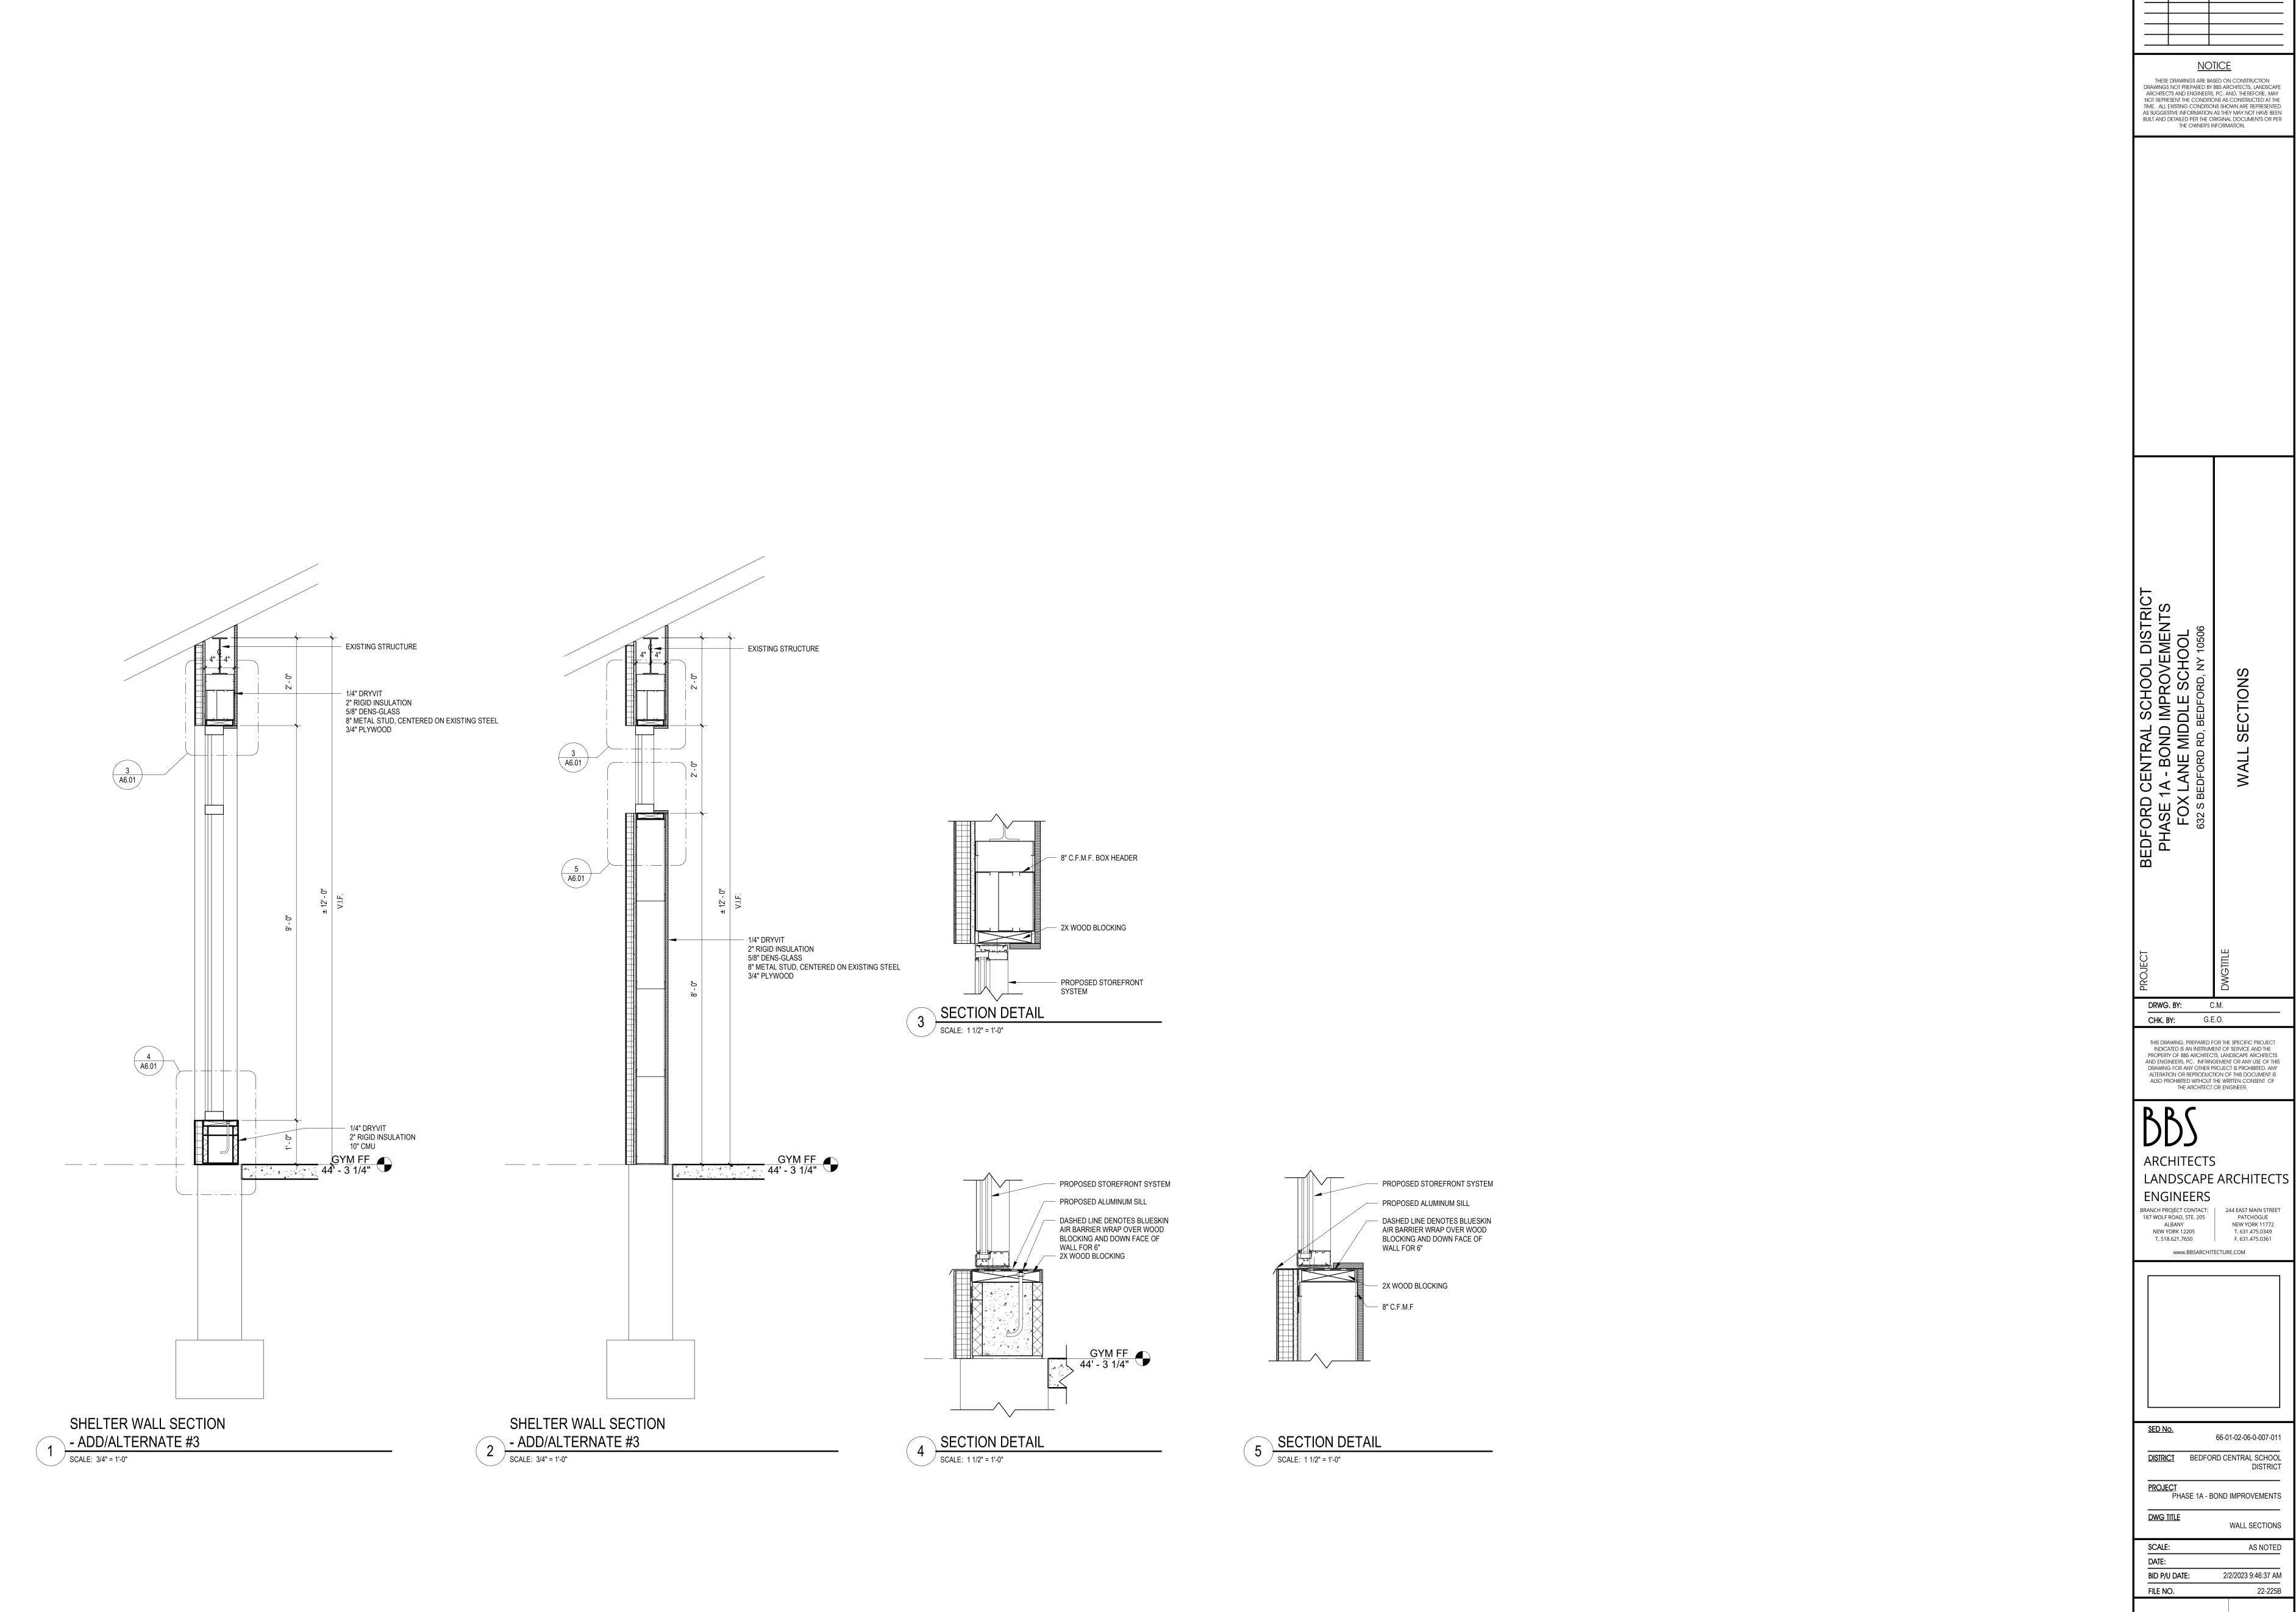

REV. DATE THESE DRAWINGS ARE BASED ON CONSTRUCTION DRAWINGS NOT PREPARED BY BBS ARCHITECTS, LANDSCAPE ARCHITECTS AND ENGINEERS, PC. AND, THEREFORE, MAY NOT REPRESENT THE CONDITIONS AS CONSTRUCTED AT THE TIME. ALL EXISTING CONDITIONS SHOWN ARE REPRESENTED AS SUGGESTIVE INFORMATION AS THEY MAY NOT HAVE BEEN BUILT AND DETAILED PER THE ORIGINAL DOCUMENTS OR PER THE OWNER'S INFORMATION.

THIS DRAWING, PREPARED FOR THE SPECIFIC PROJECT INDICATED IS AN INSTRUMENT OF SERVICE AND THE PROPERTY OF BBS ARCHITECTS, LANDSCAPE ARCHITECTS AND ENGINEERS, PC. INFRINGEMENT OR ANY USE OF THIS DRAWING FOR ANY OTHER PROJECT IS PROHIBITED. ANY ALTERATION OR REPRODUCTION OF THIS DOCUMENT IS ALSO PROHIBITED WITHOUT THE WRITTEN CONSENT OF THE ARCHITECT OR ENGINEER.

LANDSCAPE ARCHITECTS BRANCH PROJECT CONTACT: 244 EAST MAIN STREET
187 WOLF ROAD, STE. 205 PATCHOGUE
ALBANY NEW YORK 11772
NEW YORK 12205 T. 631.475.0349

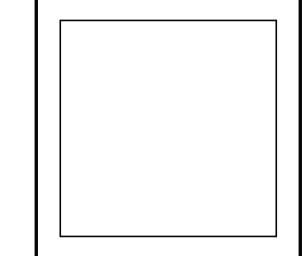



66-01-02-06-0-007-011 DISTRICT BEDFORD CENTRAL SCHOOL DISTRICT


WALL SECTIONS

AS NOTED 2/2/2023 9:46:37 AM

A6.01 FLMS

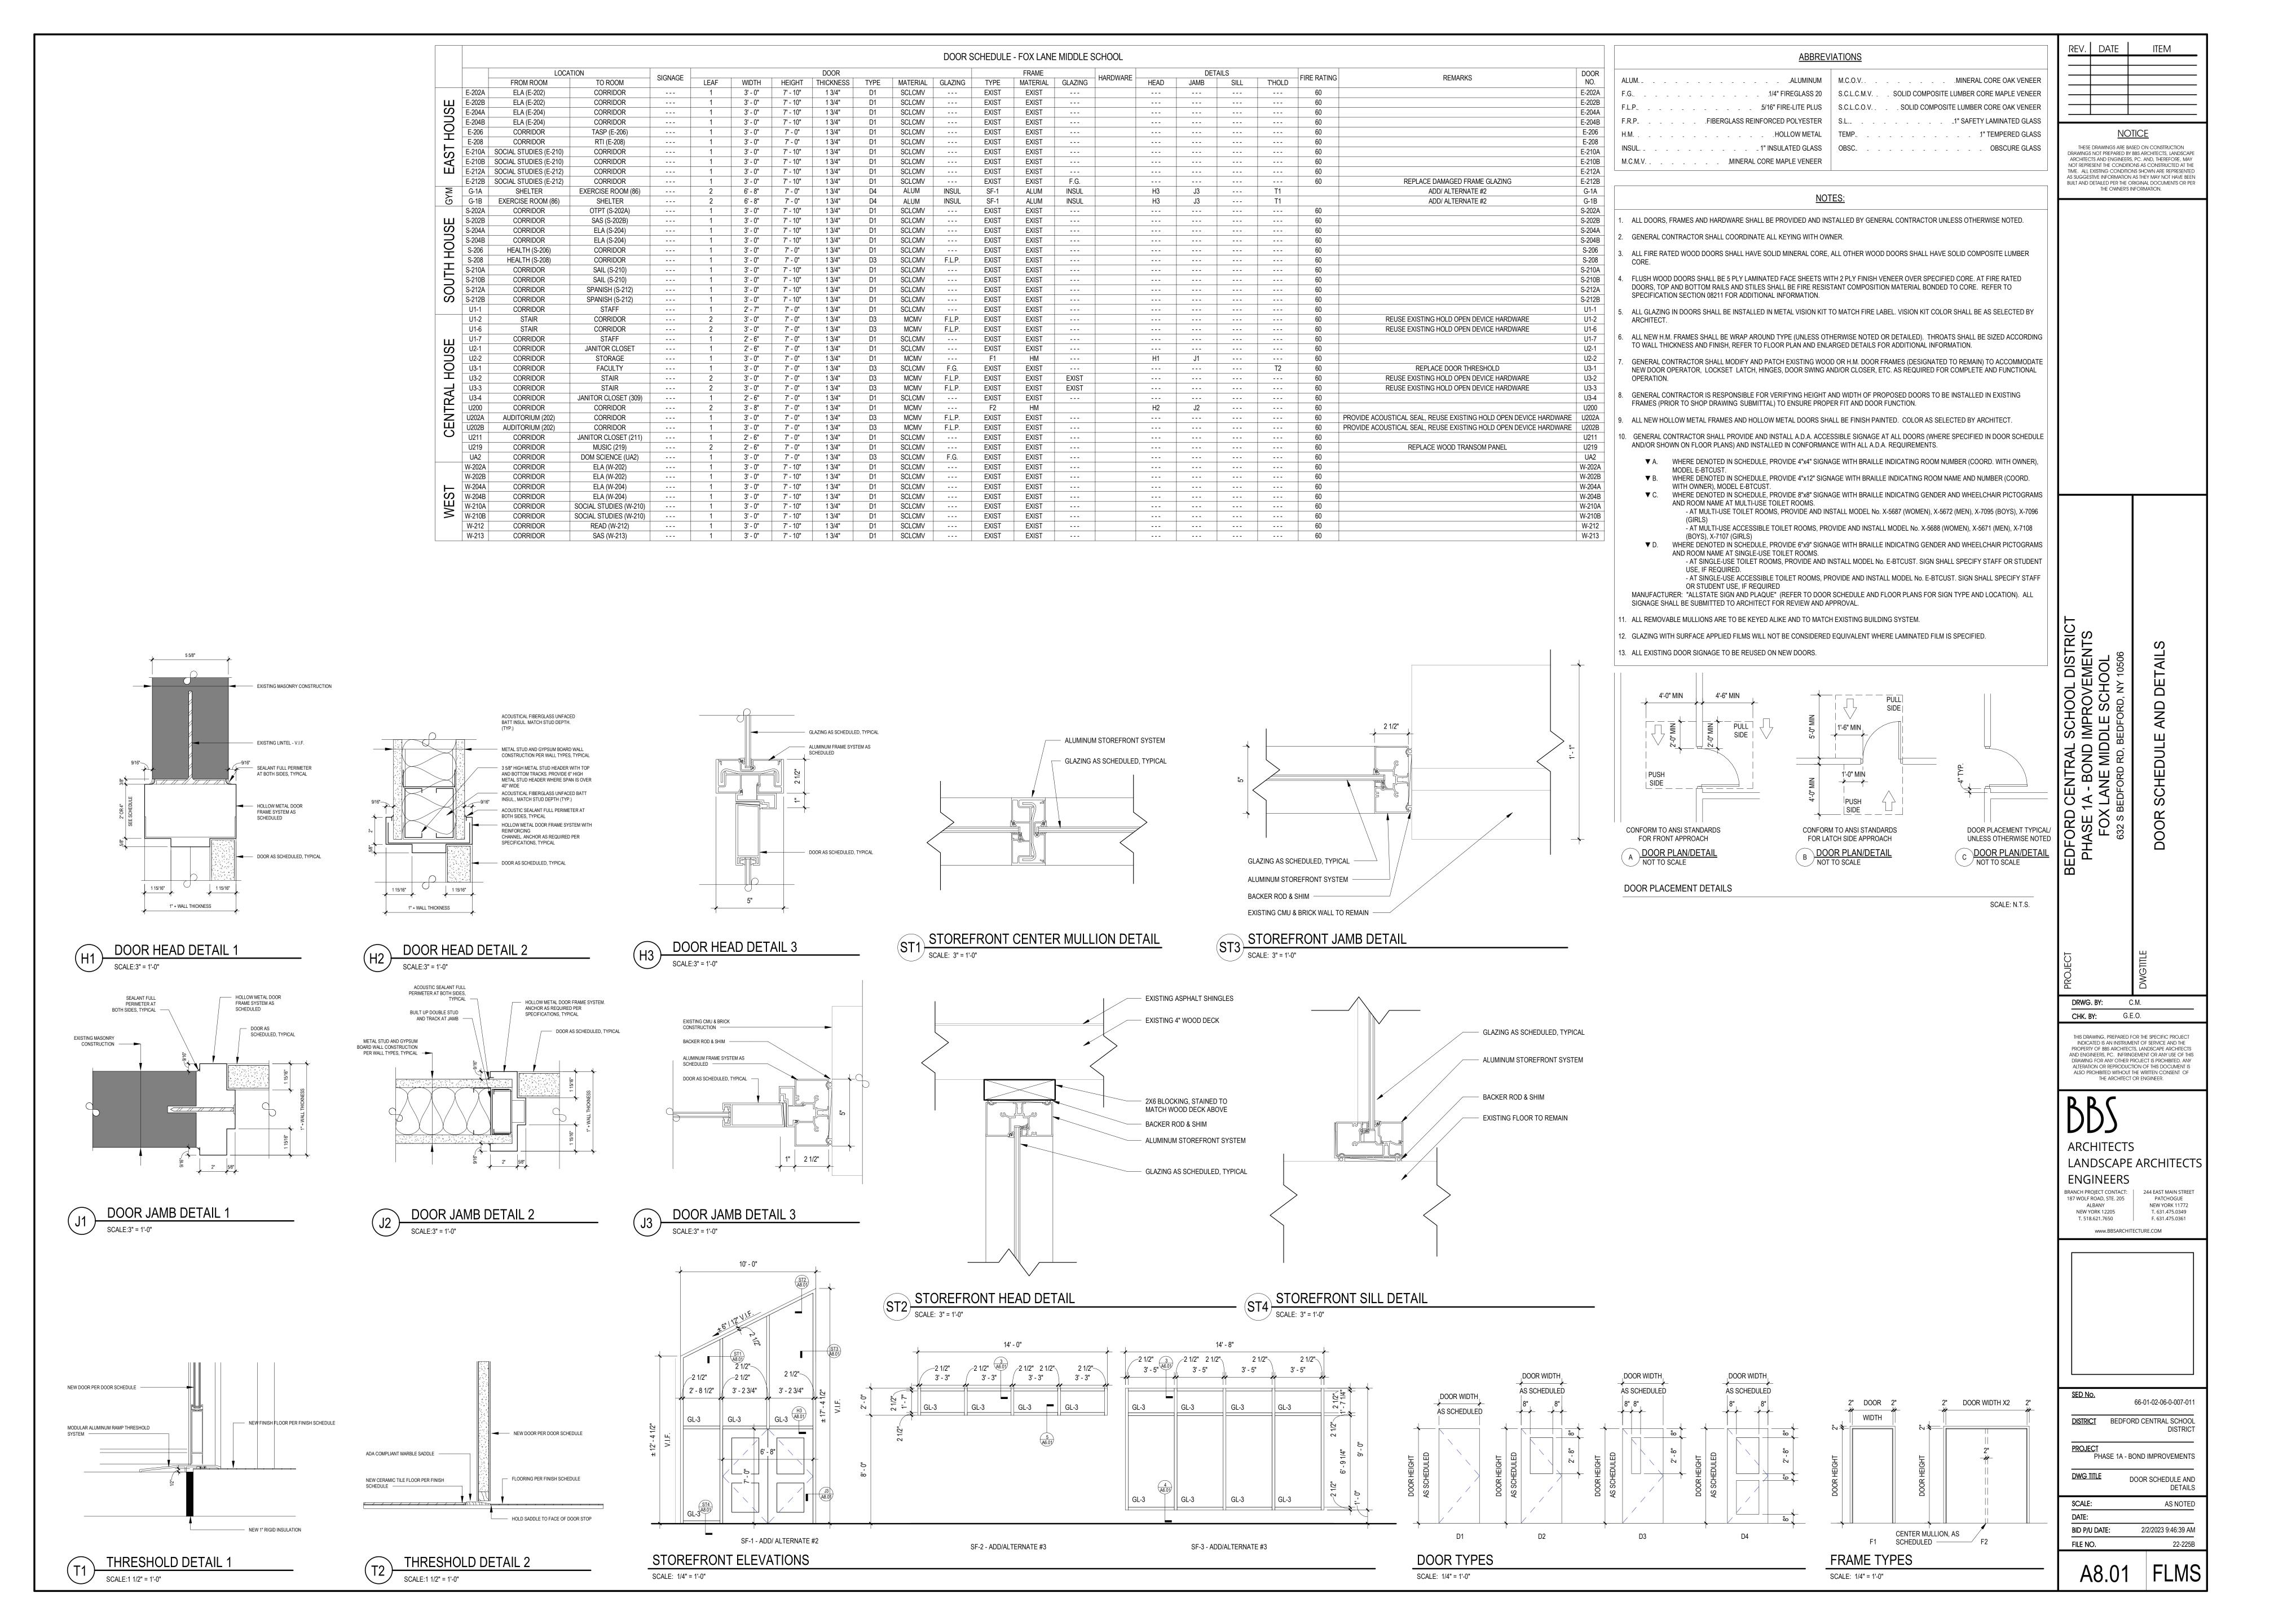

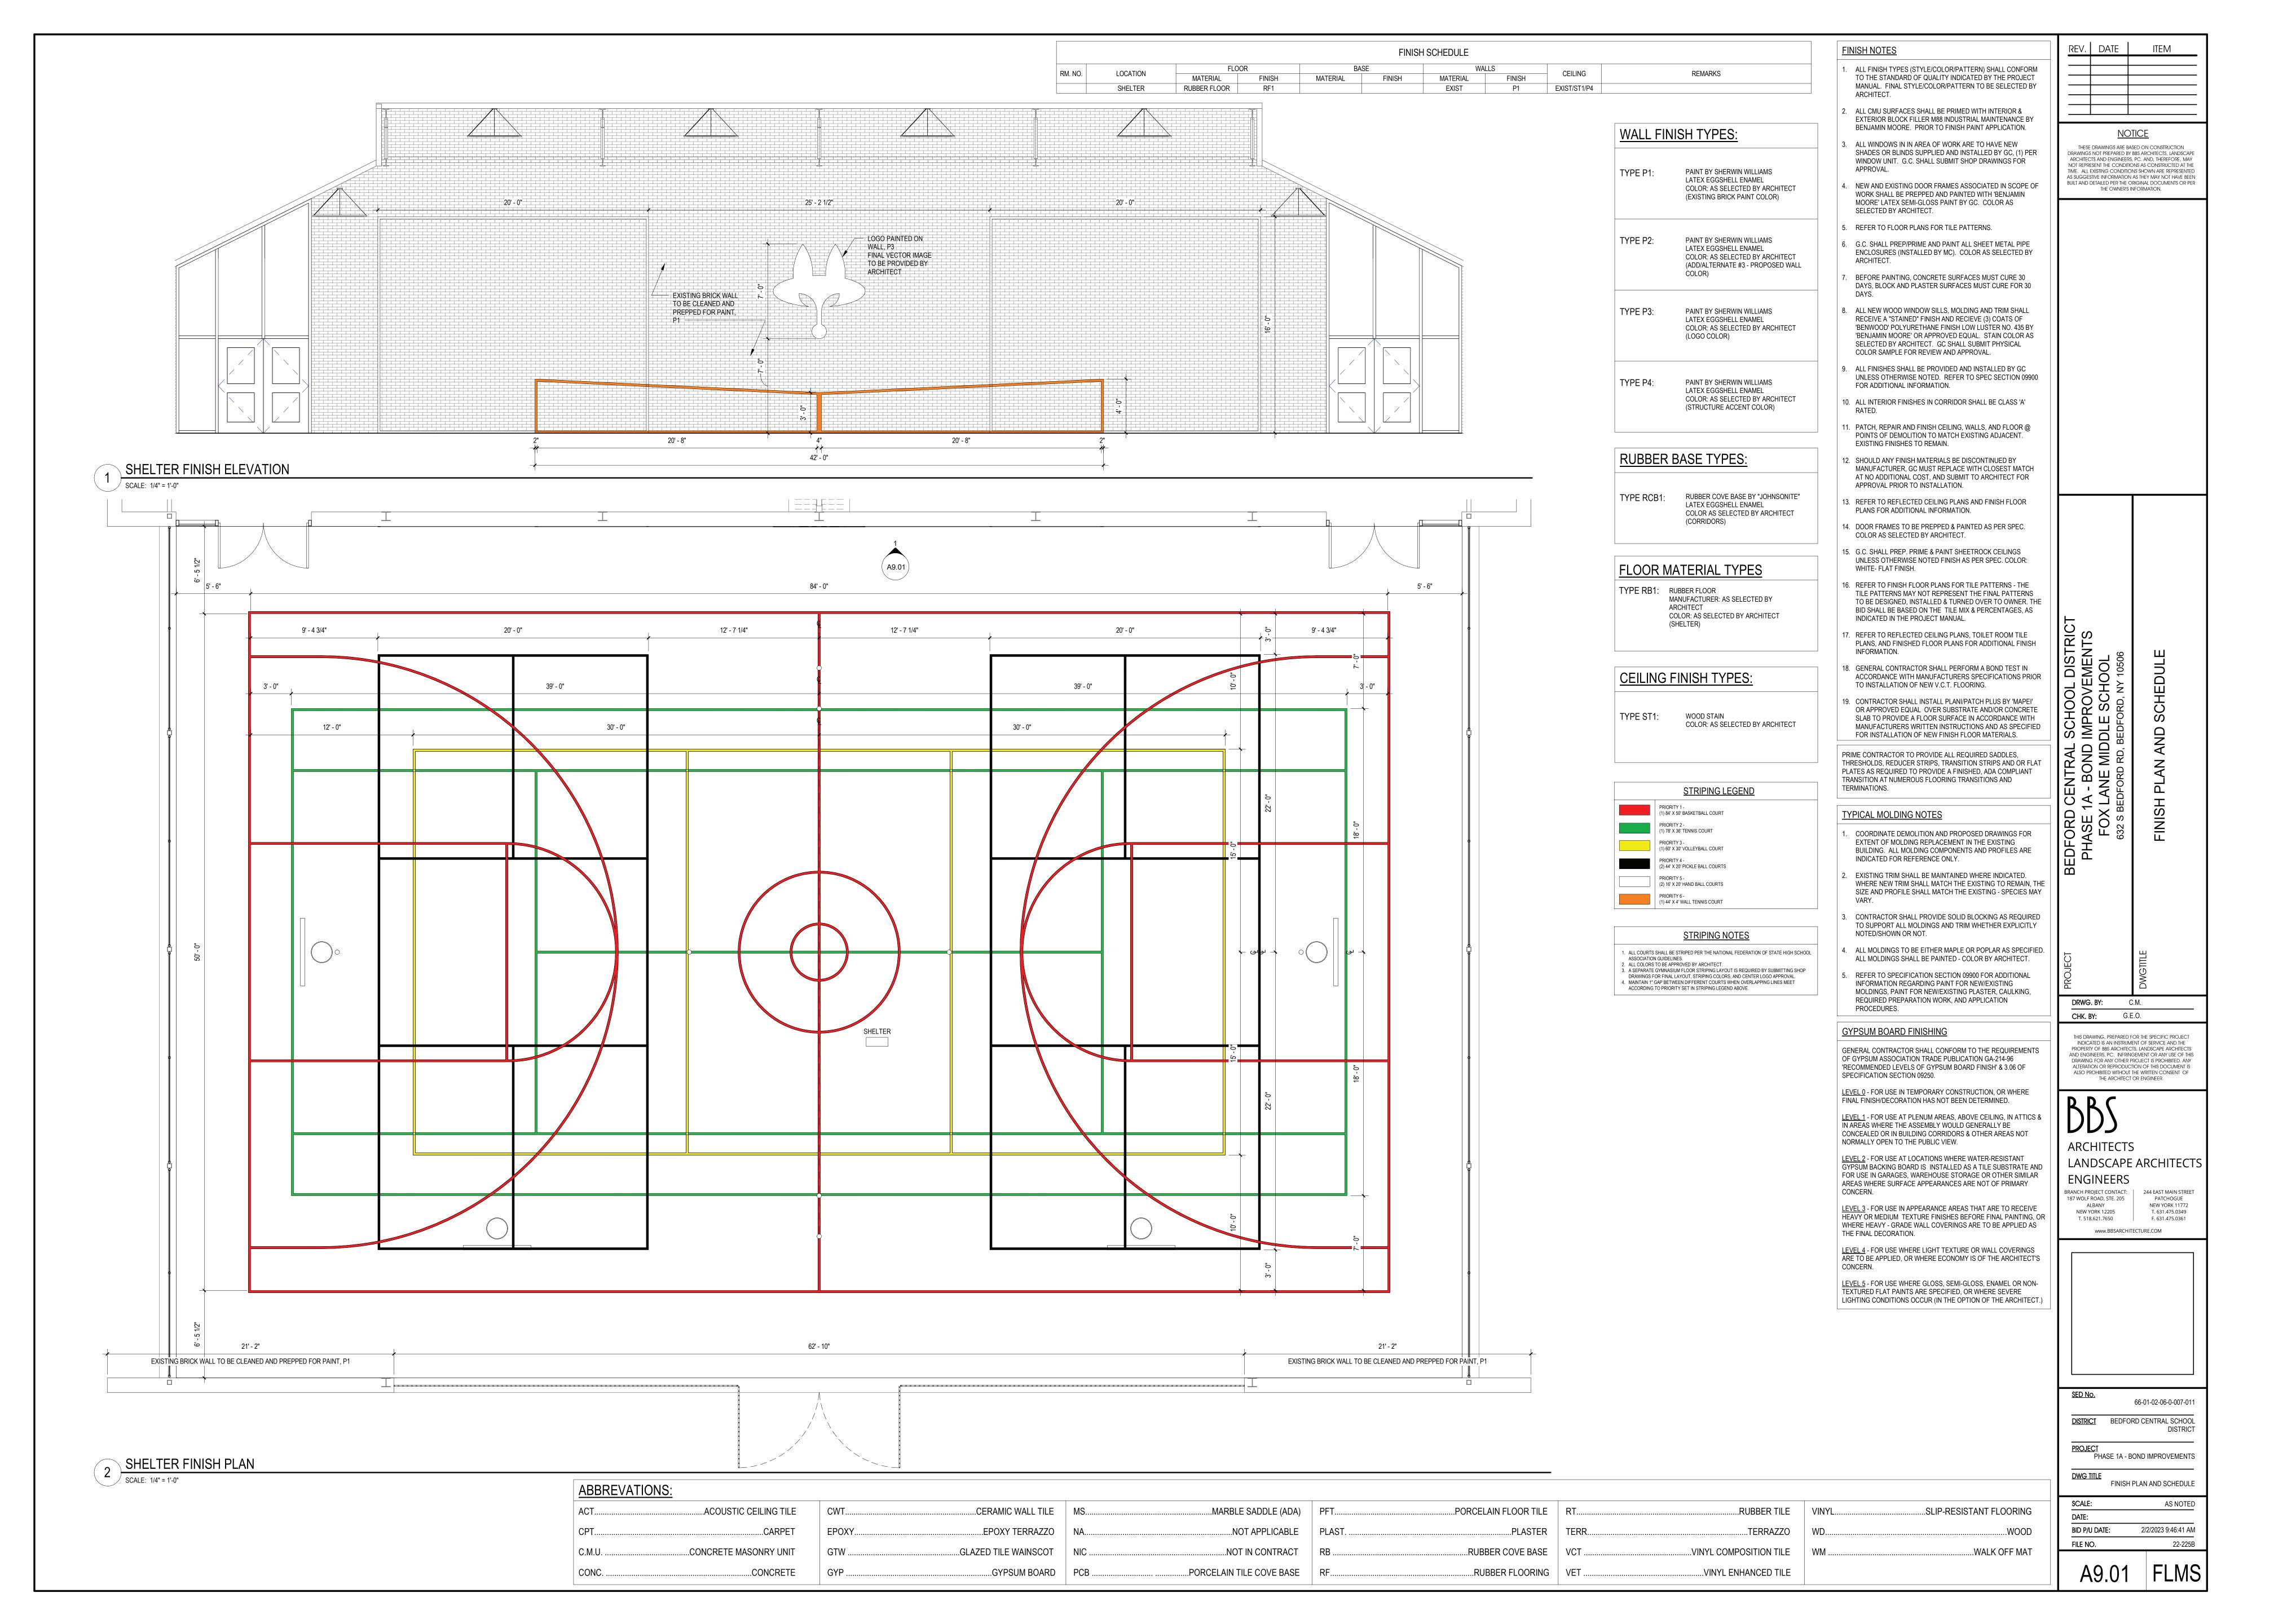

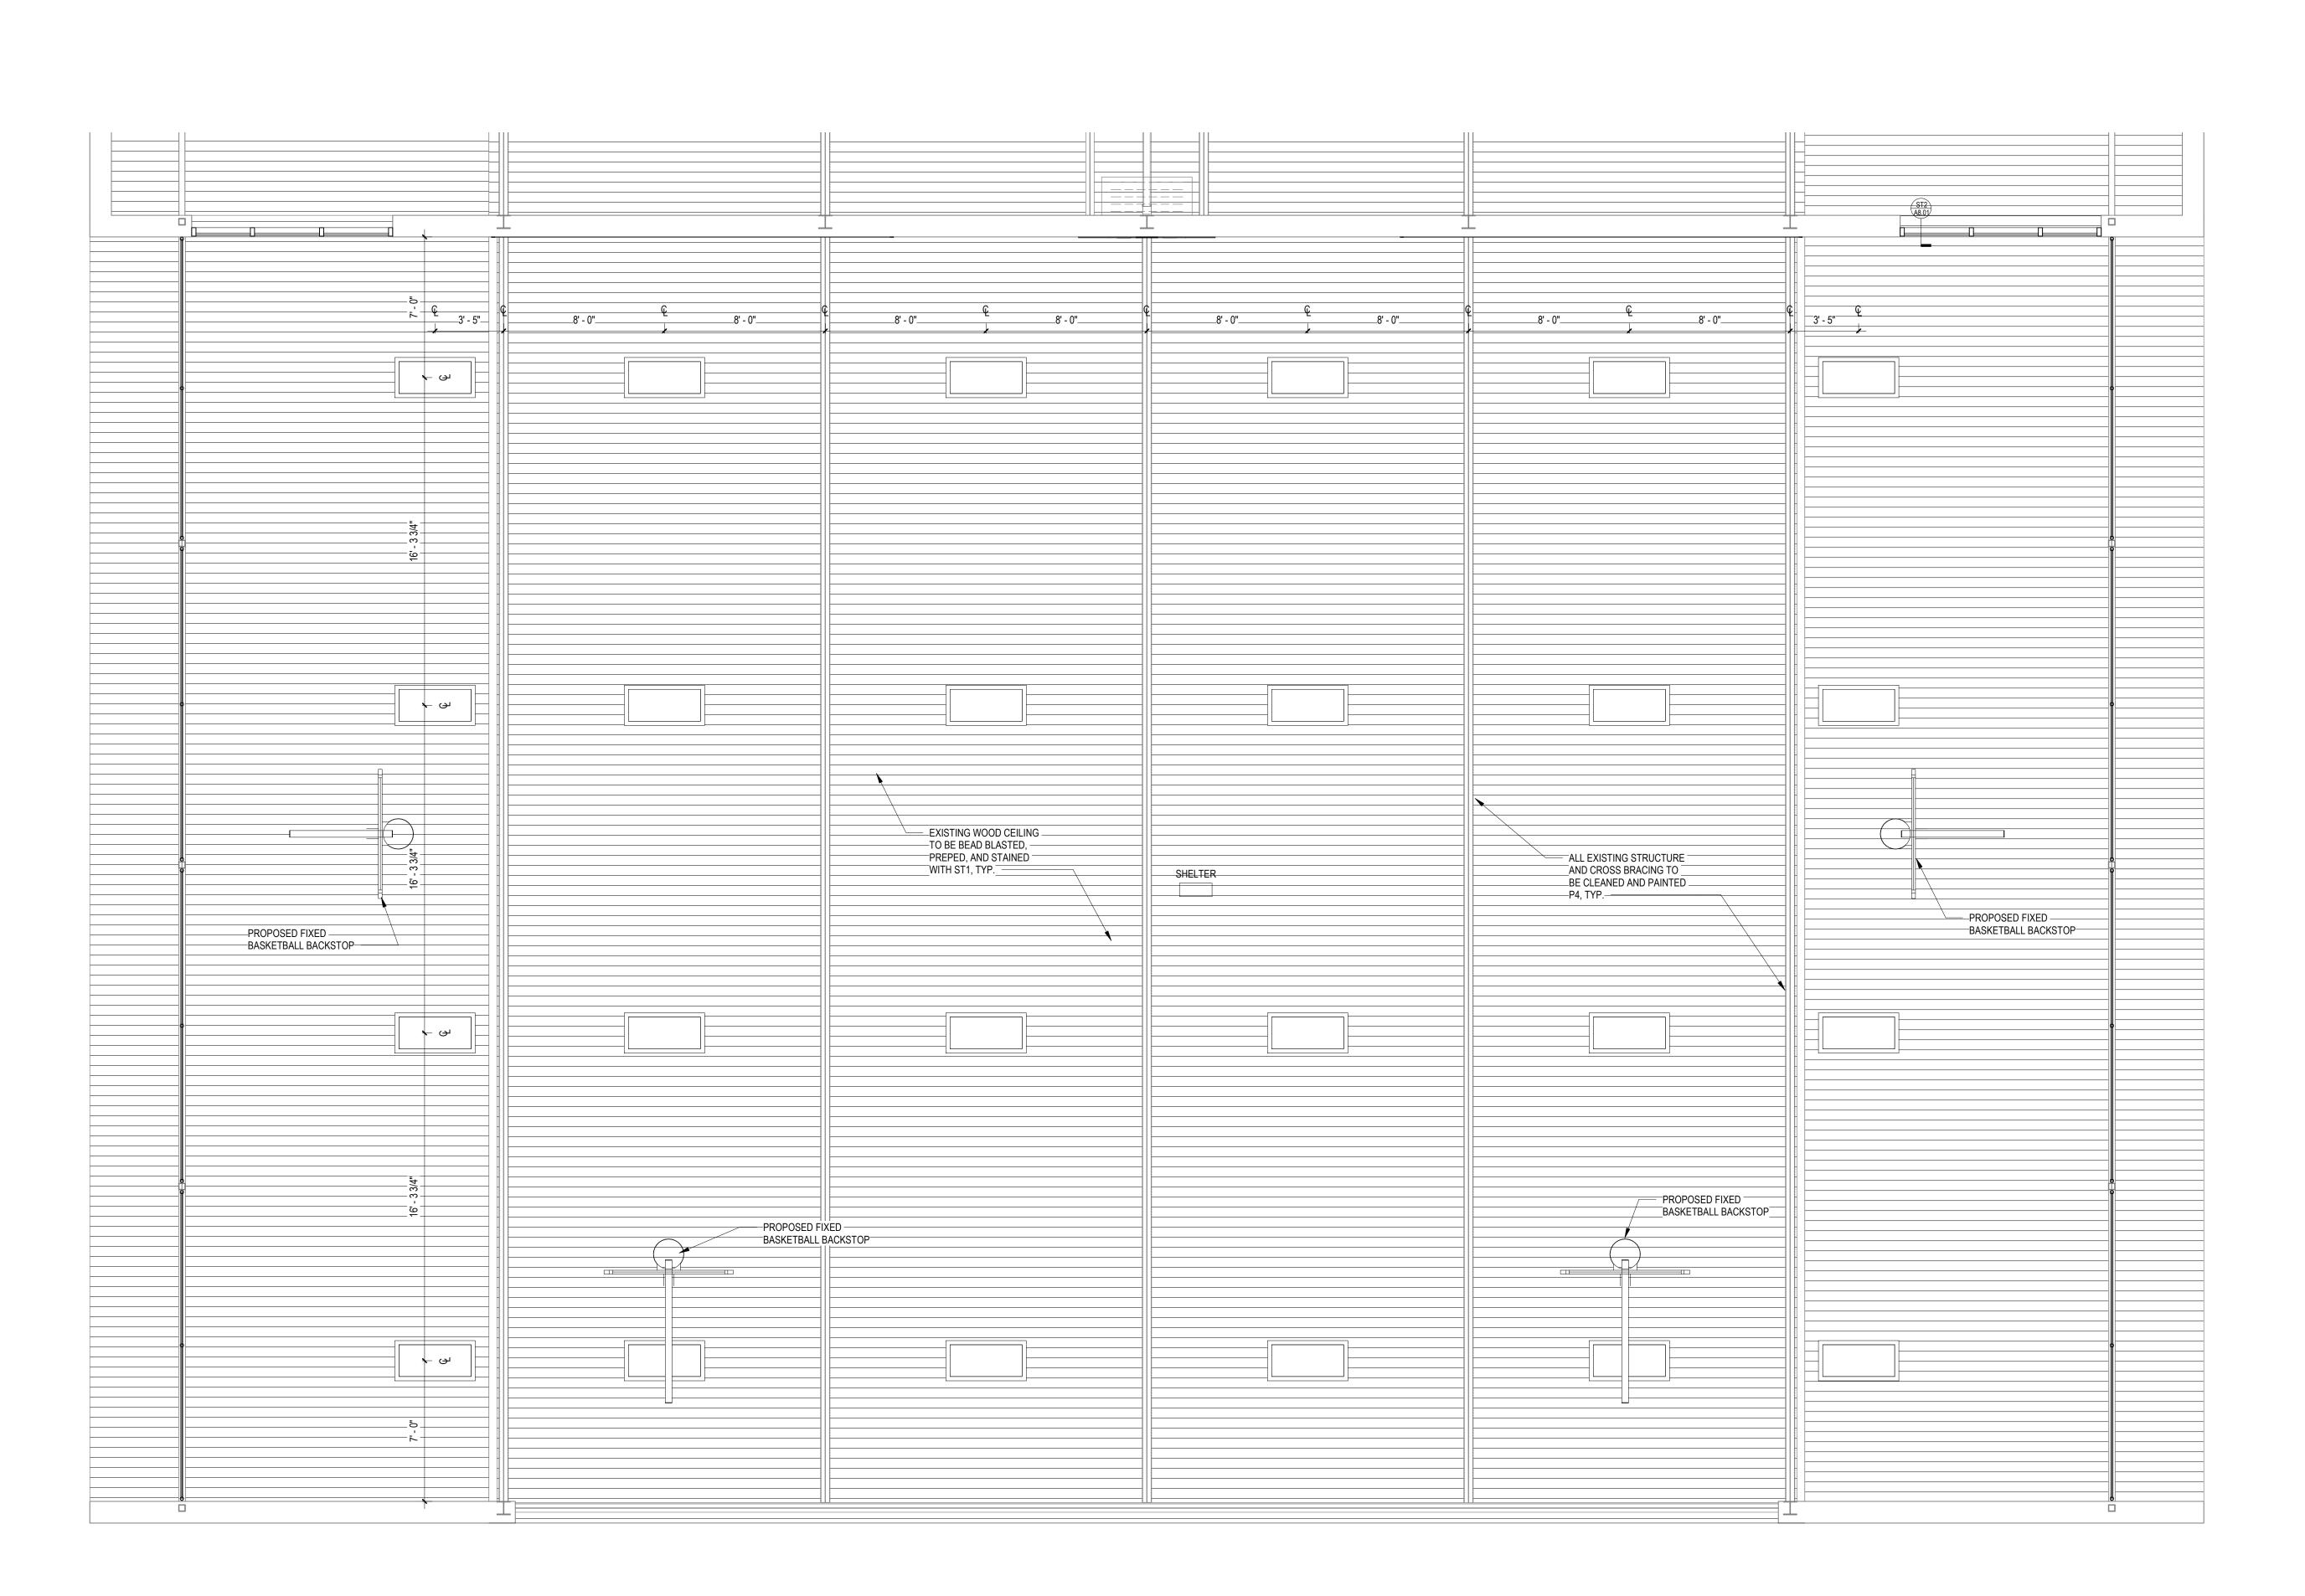

PROPOSED REFLECTED CEILIN GPLAN - AREA F

SCALE: 1/4" = 1'-0"

SYMBOL LEGEND

NAME No. x'-x"/ATx

ROOM TAG, CEILING TILE TYPE and FINISH CEILING ELEVATION (ABOVE FINISH FLOOR)

LIGHT FIXTURE. REFER TO ELECTRICAL DWGS. FOR ADDITIONAL INFO. (E.C.)

TYPICAL REFLECTED CEILING NOTES

- 1. ALL CEILING TILES TO BE AT-1, U.O.N. REFER TO FINISH SCHEDULE FOR ADD'L INFO.
- 2. ALL CEILING GRID TO BE 15/16" PRELUDE BY "ARMSTRONG", U.O.N.
- 3. CEILING PLANS MAY NOT INDICATE ALL MECHANICAL AND/OR ELECTRICAL CEILING ITEMS, REFER TO ELECTRICAL & MECHANICAL DRAWINGS FOR ADD'L INFO.
- 4. ALL FIXTURES SHALL BE CENTERED WITHIN THE GRID, U.O.N.

OTHERWISE REQUIRED.


- 5. SUPPORT OF ALL ARCHITECTURAL COMPONENTS (I,E, HUNG CEILING SYSTEMS, GRIDS, ETC.) SHALL BE INSTALLED TO WITHSTAND SEISMIC LOADS IN ACCORDANCE WITH THE IBC SECTION 1621, FOR SEISMIC DESIGN CATEGORY 'B' AND IMPORTANCE FACTOR 1.0. BASED UPON THE ABOVE, NO SPECIFIC SEISMIC RESTRAINTS ARE REQUIRED.
- 6. ALL ACOUSTICAL HUNG CEILING GRID SYSTEMS SHALL BE INSTALLED IN CONFORMANCE WITH ASTM, C636
 "STANDARD PRACTICE FOR INSTALLATION OF METAL CEILING SUSPENSION SYSTEMS FOR ACOUSTICAL TILE AND
 LAY-IN PANELS" REQUIREMENTS.
- 7. ALL LIGHTING FIXTURES REMAIN EXCEPT WHERE NOTED. ELECTRICAL CONTRACTOR TO DE-ENERGIZE DURING DEMOLITION AND INSTALLATION OF NEW CEILING. ELECTRICAL CONTRACTOR TO RE-INSTALL ALL OTHER ELECTRICAL DEVICES (SPEAKERS, SMOKE DETECTORS, FIRE ALARM STROBES, ETC.) WHETHER NOTED ON PLAN OR NOT. REFER TO ELECTRICAL DRAWINGS FOR ADD'L INFO.
- OR NOT. REFER TO ELECTRICAL DRAWINGS FOR ADD'L INFO.

 8. CEILING GRID SHALL BE ARRANGED TO BE SPACED EQUALLY IN EACH DIRECTION W/ NO TILE LESS THAN 6" UNLESS
- 9. PROVIDE CEILING EXPANSION JOINT AT ALL NEW TO EXISTING INTERACTIONS AND WHERE INDICATED ON PLAN. REFER TO WALL SECTIONS AND SPECIFICATIONS.
- 10. ALL AREAS NOTED AS 'OPEN' AND/OR 'NO CEILING (CLG)' SHALL BE PAINTED. (INCLUDING DECK, STRUCTURE, DUCTWORK, ETC.)

/ .	DATE	ITEM	

THESE DRAWINGS ARE BASED ON CONSTRUCTION DRAWINGS NOT PREPARED BY BBS ARCHITECTS, LANDSCAPE ARCHITECTS AND ENGINEERS, PC. AND, THEREFORE, MAY NOT REPRESENT THE CONDITIONS AS CONSTRUCTED AT THE

TIME. ALL EXISTING CONDITIONS AS CONSTRUCTED AT THE TIME. ALL EXISTING CONDITIONS SHOWN ARE REPRESENTED AS SUGGESTIVE INFORMATION AS THEY MAY NOT HAVE BEEN BUILT AND DETAILED PER THE ORIGINAL DOCUMENTS OR PER THE OWNER'S INFORMATION.

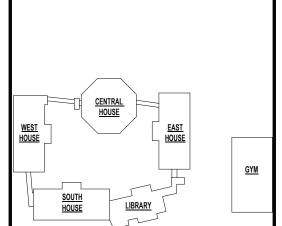

KEY PLAN

NO SCALE

PROJECT

PROJECT

PROJECT

PHASE 1A - BOND IMPROVEMENTS

FOX LANE MIDDLE SCHOOL

632 S BEDFORD RD, BEDFORD, NY 10506

BY THE STRICT

BY THE STRICT

REFLECTED CEILING PLAN

THIS DRAWING, PREPARED FOR THE SPECIFIC PROJECT INDICATED IS AN INSTRUMENT OF SERVICE AND THE PROPERTY OF BBS ARCHITECTS, LANDSCAPE ARCHITECTS AND ENGINEERS, PC. INFRINGEMENT OR ANY USE OF THIS DRAWING FOR ANY OTHER PROJECT IS PROHIBITED. ANY ALTERATION OR REPRODUCTION OF THIS DOCUMENT IS ALSO PROHIBITED WITHOUT THE WRITTEN CONSENT OF THE ARCHITECT OR ENGINEER.

ARCHITECTS
LANDSCAPE ARCHITECTS
ENGINEERS
BRANCH PROJECT CONTACT: | 244 EAST MAIN STREET

187 WOLF ROAD, STE. 205 PATCHOGUE

NEW YORK 11772


T. 631.475.0349

F. 631.475.0361

ALBANY

NEW YORK 12205

T. 518.621.7650

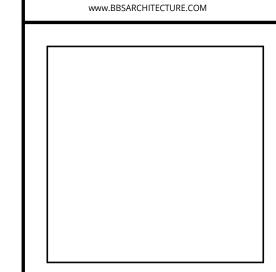

SED No.

66-01-02-06-0-007-011

DISTRICT BEDFORD CENTRAL SCHOOL DISTRICT

PROJECT
PHASE 1A - BOND IMPROVEMENTS

DWG TITLE
REFLECTED CEILING PLAN

SCALE: AS NOTED

DATE:

BID P/U DATE: 2/2/2023 9:46:42 AM

EILE NO. 22-225B

A10.01 | FLMS

ELECTRICAL CONSTRUCTION NOTES (NOT ALL APPLY):

- ALL WORK SHALL BE DONE IN ACCORDANCE WITH THE LATEST EDITIONS OF THE NEC, APPLICABLE LOCAL CODES, STATE CODES, SCHOOL WORKING RULES AND SCHEDULE DIRECTIVES, AND THE ENGINEER'S SPECIFICATIONS.
 THE VOLTAGE CHARACTERISTIC OF EXISTING BUILDING IS 208Y/120V, 3-PASE, 4-WIRE. THE VOLTAGE CHARACTERISTIC OF THE PROPOSED ADDITION SHALL BE 480/277V, 3-PHASE 4-WIRE WITH 208/120V DERIVED FROM STEP DOWN TRANSFORMERS., ALL EQUIPMENT SHALL BE COMPATIBLE WITH THESE CHARACTERISTICS
- EQUIPMENT SHALL BE COMPATIBLE WITH THESE CHARACTERISTICS.

 3. THE DRAWINGS SHOW SCHEMATICALLY, THE APPROXIMATE LOCATION OF ALL EQUIPMENT, CONDUITS, DEVICES, ETC. THE EXACT LOCATION OF WHICH SHALL BE SUBJECT TO APPROVAL BY THE ARCHITECT/OWNER WHO RESERVES THE RIGHT TO MAKE PRIOR TO INSTALLATION, ANY REASONABLE CHANGES IN LOCATION INDICATED WITHOUT EXTRA COST TO THE OWNER. CONTRACTOR SHALL VERIFY ALL INDICATED OR APPROXIMATED DIMENSIONS DRAWN OR DENOTED.
- 4. DIVISION 16 CONTRACTOR SHALL EXAMINE THE SITE TO VERIFY WORK TO BE PERFORMED AS SHOWN ON DRAWINGS AND SPECIFICATIONS BEFORE SUBMITTING HIS BID. ANY DISCREPANCY BETWEEN DRAWINGS/SPECIFICATIONS AND ACTUAL FIELD
- 5. DIVISION 16 CONTRACTOR SHALL PROVIDE ALL LABOR SERVICE MATERIALS, EQUIPMENT, AND RELATED ITEMS TO COMPLETE THE WORK OF THIS DIVISION, AS REQUIRED BY THE NATIONAL ELECTRIC CODE, AND ALL STATE AND LOCAL AUTHORITIES HAVING
- JURISDICTION.
 6. DIVISION 16 CONTRACTOR SHALL PROVIDE ALL ELECTRICAL HARDWARE SHOWN ON THESE DRAWINGS AND RELATED DETAIL MATERIALS NOT SPECIFICALLY SHOWN OR SPECIFIED.

CONDITIONS SHALL BE BROUGHT TO ARCHITECT/ENGINEERS ATTENTION BEFORE BID SUBMITTAL.

- DIVISION 16 CONTRACTOR SHALL PAY ANY FEES APPLICABLE TO ELECTRICAL WORK, SUCH AS, BUT NOT LIMITED TO, THE POWER COMPANY, TELEPHONE COMPANY, CATV, CERTIFIED ELECTRICAL INSPECTORS, ALARM AND FIRE PROTECTION COMPANIES.
 THE DIVISION 16 CONTRACTOR SHALL REFER TO ALL OTHER DRAWINGS IN BID PACKAGE AND PERFORM THE WORK (INCLUDE IN HIS
- BID) INDICATED AS ELECTRICAL CONTRACTOR (E.C.) WORK.

 9. ALL WORK SHALL BE IN ACCORDANCE WITH MANUFACTURER'S RECOMMENDATIONS AND DIRECTIVES OF THE SCHOOL DISTRICT BUILDINGS AND GROUNDS DEPARTMENT.
- 10. ALL WORK SHALL BE PERFORMED BY A LICENSED ELECTRICAL CONTRACTOR WHO SHALL OBTAIN AN INSPECTION CERTIFICATE AND PAY ASSOCIATED FEE. SUBMIT A PHOTOCOPY OF THIS CERTIFICATE TO THE ENGINEER WITH FINAL PAYMENT APPLICATION.
 11. DIVISION 16 CONTRACTOR SHALL GUARANTEE ALL MATERIALS AND THEIR INSTALLATION TO BE FREE OF DEFECTS FOR A PERIOD AS DEFINED IN SECTION 1700 OF THE PROJECT MANUAL.
- 12. A COMPLETE SYSTEM OF WIRING, WITH ALL FEEDERS, MAINS, AND BRANCHES AS SHOWN ON THE DRAWINGS, SHALL BE FURNISHED AND INSTALLED FROM THE MAIN DISTRIBUTION BOARD TO THE PANELS OUTLETS, MOTORS, AND APPURTENANCES.
 13. PROVIDE IDENTIFICATION FOR ALL PANEL AND MOTOR FEEDER CABLES IN PULL BOXES AND AT TERMINATIONS. ANY CONDUCTOR VOLTAGES HIGHER THAN 240 VOLTS SHALL BE MARKED ON DEVICES AND JUNCTION BOXES.
- FURNISH AND INSTALL ALL WIRING OF ANY VOLTAGE OR PURPOSE AS SHOWN ON THE DRAWINGS.
 ALL BRANCH CIRCUITS SHALL HAVE INDIVIDUAL NEUTRALS. SHARING COMMON NEUTRALS AMONG BUNDLED CIRCUITS IS SPECIFICALLY DISALLOWED UNLESS OTHERWISE NOTED.
- 16. PULL/JUNCTION BOXES SHALL BE PROVIDED WHERE INDICATED OR AS OTHERWISE REQUIRED TO FACILITATE THE PROPER INSTALLATION OF WIRES AND CABLES. CONDUITS MAY BE INCREASED IN SIZE FOR CONSTRUCTION CONVENIENCE.
 17. FURNISH AND INSTALL ALL DISCONNECT DEVICES AND SAFETY SWITCHES AS SHOWN ON THE DRAWINGS AND/OR AS REQUIRED TO
- CONFORM WITH REQUIREMENTS.

 18. FURNISH AND INSTALL ALL INDICATED LIGHTING FIXTURES AND MOUNTING HARDWARE AS REQUIRED FOR A COMPLETE
- INSTALLATION.

 19. DIVISION 16 CONTRACTOR SHALL PROVIDE TO SCHOOL 5 PERCENT SPARE LAMPS (MINIMUM QUANTITY 1) OF EACH TYPE SPECIFIED
- WITH NEW FIXTURES.

 20. PROVIDE ALL WIRING, PANEL BOARDS, SWITCHES, FUSES, EQUIPMENT, AND ALL INCIDENTAL MATERIALS REQUIRED TO SUPPLY TEMPORARY AND PERMANENT ELECTRICAL NEEDS FOR THE WORK INVOLVED, ALL IN ACCORDANCE WITH OSHA, LOCAL, STATE AND UNDERWRITERS REQUIREMENTS.
- 21. ALL WIRING TO BE 1#12+1#12(N)+1#12(G)-3/4"C., OR STEEL JACKETED MC CABLE (WHERE CODE PERMITTED), UNLESS OTHERWISE SPECIFIED ON DRAWINGS. RUN BRANCH CIRCUITS IN DROPPED CEILINGS, VOIDS, & CHASES. CONDUITS MAY BE SURFACE MOUNTED IN MECHANICAL SPACES UNLESS OTHERWISE NOTED. CONDUITS IN PUBLIC AREAS SHALL BE CONCEALED IN HUNG CEILINGS, EMBEDDED IN SLAB OR MASONRY WALLS, EXCEPT WHERE SURFACE MOUNTED RACEWAY IS SPECIFIED. ALUMINUM JACKETED MC CABLE IS NOT ACCEPTABLE.
- 22. ALL CONNECTIONS AND/OR SPLICES SHALL BE MADE ONLY IN ACCESSIBLE JUNCTION BOXES.
 23. ALL COUPLINGS AND CONNECTORS FOR USE WITH EMT SHALL BE COMPRESSION TYPE. SET SCREW TYPE OR INDENT TYPE FITTINGS WILL NOT BE ACCEPTED.
 24. ALL CONNECTIONS TO CONDUIT RUN UNDERGROUND SHALL BE MADE WATERTIGHT. ALL METALLIC CONDUIT INSTALLED IN EARTH
- FILL, AS WELL AS UNDERGROUND, SHALL BE PAINTED WITH (2) COATS OF ASPHALTUM PAINT OR EQUAL.

 25. WIRING INSTALLED IN CEILINGS SHALL BE HUNG INDEPENDENT OF CEILING SYSTEM AND SECURELY TIED TO BUILDING STEEL.

 26. ALL LOW VOLTAGE (FIRE ALARM, PA INTERCOM, PHONE, DATA, ETC.) WIRING INSTALLED IN OPEN AREAS SHALL BE IN METALLIC RACEWAY IN MECHANICAL AREAS, GYMNASIUMS, ART ROOMS, STOREROOMS, ETC., AND IN SURFACE MOUNTED RACEWAY IN PUBLIC
- AREAS. LOW VOLTAGE WIRE INSTALLED IN DROPPED CEILINGS SHALL BE BUNDLED TOGETHER AND SUPPORTED BY BUILDING STEEL.

 LOW VOLTAGE WIRE SHALL NOT BE SUPPORTED WITH BRANCH CIRCUITS OR FEEDER CIRCUITS AND SHALL NOT BE SUPPORTED BY
 CONDUIT, PIPES, ETC.. LOW VOLTAGE WIRING NOT INSTALLED IN CONDUITS, SHALL BE PLENUM RATED.

 27. CONDUITS SHALL BE SECURED IN PLACE AND PROTECTED WHERE NECESSARY TO PREVENT DAMAGE DURING CONSTRUCTION.
- 28. FURNISH AND INSTALL ALL HARDWARE TO PROPERLY SUPPORT ALL CONDUITS NOT INSTALLED IN CONCRETE SLABS OR UNDERGROUND.
 29. ALL CONDUITS OR MC CABLE SHALL BE EQUIPPED WITH AN INSULATING/CHAFE GUARD GROMMET AT WIRE EXIT/ENTRANCE. MC
- CABLE SHALL USE MC STYLE BUSHINGS. BX OR OTHER BUSHINGS ARE SPECIFICALLY DISALLOWED.

 30. WHERE AN EXISTING CONDUIT OR CABLE IS REQUIRED TO BE REMOVED BUT SERVES AND EXISTING PIECE OF EQUIPMENT WHICH IS

 TO REMAIN OPERABLE. THE DIVISION 46 CONTRACTOR SHALL REPOUTE SAID CONDUIT OR CABLE OR PROVIDE A NEW SOURCE OF
- TO REMAIN OPERABLE, THE DIVISION 16 CONTRACTOR SHALL REROUTE SAID CONDUIT OR CABLE OR PROVIDE A NEW SOURCE OF POWER (APPROVED BY ENGINEERING) TO THIS EQUIPMENT AS A PART OF THIS CONTRACT.

 31. ALL PANELS, SWITCHES, DISCONNECT STARTERS, OR OTHER ELECTRIC SYSTEM CONTROLS SHALL BE STENCILED WITH THEIR
- APPROPRIATE DESIGNATION/FUNCTION. ALL CIRCUIT BREAKERS SHALL BE IDENTIFIED BY A PANEL SCHEDULE OR STENCIL ADJACENT TO THE CIRCUIT BREAKER.
- 32. ALL CIRCUIT BREAKERS POSITIONS IN ALL PANELS ARE SHOWN FOR ESTIMATE PURPOSES ONLY. EC IS RESPONSIBLE FOR LOAD BALANCING
- 33. ALL DEVICES SHALL BE FASTENED IN PLACE SECURELY. GRID MOUNTING LIGHTING FIXTURES SHALL BE SECURED TO GRID WITH CLIPS LISTED FOR THE PURPOSE OR SUSPENDED FROM STRUCTURE PER NEC.
 34. WORK WHICH MUST BE DONE IN OCCUPIED AREAS SHALL BE DONE AT SUCH TIMES AS INDICATED IN THE PHASING OF
- CONSTRUCTION AND AS APPROVED BY THE SCHOOL.

 35. WHERE THE DIVISION 16 CONTRACTOR IS INSTRUCTED TO PROVIDE, INSTALL AND WIRE CIRCUIT BREAKER(S) TO AN EXISTING PANEL AND THAT PANEL DOES NOT HAVE THE ROOM TO INSTALL REQUIRED CIRCUIT BREAKERS, THE DIVISION 16 CONTRACTOR SHALL REMOVE (3) ADJACENT 1P CIRCUIT BREAKERS AND PROVIDE A 3P, 60A BREAKER IN THEIR PLACE FOR SUB FEED TO A SURFACE
- MOUNTED 100A,3~,4W,24 POLE SUB PANEL AND ESTABLISH OVERFLOW CIRCUITS IN NEW SUB PANEL, EACH WITH REQUIRED CIRCUIT BREAKERS. PROVIDE (3) 1P, AMPERAGE AS BEFORE CIRCUIT BREAKERS FOR DISCONNECTED CIRCUITS IN MAIN PANEL AND RECONNECT THEM IN SUB PANEL. SUB PANEL FEED TO BE 3#6+1#6(N)+1#10(G)-1"C.

 36. SELECTED RECEPTACLES AS SHOWN ON DRAWINGS MAY BE GFI PROTECTED BY CONNECTING TO GFCI RECEPTACLE FIRST IN CIRCUIT. ALL RECEPTACLES THAT ARE PROTECTED FROM AN UPSTREAM GFCI UNIT SHALL BE VISABLY LABELED AS SUCH. GFCI
- RECEPTACLE SHALL BE SPEC GRADE AND RATED 20A, WITH OPERATING NOTIFICATION INDICATING LIGHT.

 37. ALL DEVICES ADDRESSED BY ADA REGULATIONS SHALL BE INSTALLED AT ADA COMPLIANT HEIGHT AND LOCATIONS.

 38. ALL NEW LIGHTING OR EXISTING LIGHTING HAVING SWITCHING REARRANGEMENT SHALL BE EQUIPPED WITH CODE COMPLIANT
- ENERGY CONSERVATION CONTROLS. SUCH CONTROL SHALL BE SUBMITTED TO THE ENGINEER FOR APPROVAL PRIOR TO INSTALLATION.

 39. REMOVAL OF ELECTRICAL ITEMS INCLUDES THEIR DISPOSAL. THE EXCEPTION WILL BE TO TURN OVER TO THE OWNER ITEMS, IF ANY,
- THEY SPECIFY TO BE RETAINED IN THEIR INVENTORY. PCB OR ASBESTOS BEARING MATERIAL SHALL BE DISPOSED OF IN ACCORDANCE WITH LAWS AND REGULATIONS.

 40. EC SHALL PROVIDE & WIRE WEATHERPROOF GFCI RECEPTACLES ON ALL APPLICABLE ROOFTOP UNITS AS PART OF HIS BID. SEE

LONGER REQUIRED

MECHANICAL EQUIPMENT SCHEDULES FOR UNITS WITH SERVICE RECEPTACLES FACTORY INSTALLED.

41. UNLESS OTHERWISE NOTED, STARTERS AND DISCONNECTS FOR MECHANICAL EQUIPMENT SHALL BE FURNISHED BY THE MECHANICAL CONTRACTOR.. COORDINATE WITH THE MECHANICAL CONTRACTOR FOR ALL POWERED MECHANICAL EQUIPMENT. THE DIVISION 16 CONTRACTOR IS RESPONSIBLE TO INSTALL ALL MOTOR STARTERS AND ASSOCIATED POWER WIRING FROM SOURCE TO UNIT VIA STARTERS AND DISCONNECTS. THE LOCATIONS OF MOTOR STARTERS SHALL BE DETERMINED BY THE MECHANICAL CONTRACTOR IN THE FIELD AND SUBMITTED TO THE ENGINEER FOR APPROVAL UNLESS IT IS SPECIFIED ON THE DRAWINGS. THE DIVISION 16 CONTRACTOR SHALL REFER TO THE MECHANICAL DRAWINGS, EQUIPMENT SCHEDULES & NOTES AND INCLUDE IN HIS BID PRICE ALL ELECTRICAL WORK ASSOCIATED WITH THEIR INSTALLATION, AND THE REMOVAL OF ANY STARTERS/DISCONNECTS NO

DEMOLITION NOTES (NOT ALL APPLY):

- 1. THE ITEMS SPECIFICALLY SHOWN ON DEMOLITION DRAWING/S ARE TO BE ADDRESSED BY THE ELECTRICAL CONTRACTOR. THE ITEMS ARE TO BE TREATED AS NOTED AND RANGE FROM DIRECT REMOVAL AND DISPOSAL, OR REMOVAL, STORAGE, AND REINSTALLATION/RELOCATION, OR TEMPORARY REMOVE/STORAGE, AND REINSTALLATION IN SAME LOCATION.
- 2. MANY OTHER ELECTRIC ITEMS EXIST THAT ARE NOT SHOWN INCLUDE, BUT ARE NOT LIMITED TO, SWITCHES, RECEPTACLE, FLOOR OUTLETS, LOW VOLTAGE JACKS, LOW VOLTAGE DEVICES AND WIRING, TELEPHONE PUNCH DOWN BLOCKS, AND OUT OF SERVICE ITEMS. ALL SUCH ITEMS SHALL BE PERMANENTLY DE-ENERGIZED, DISCONNECTED, AND OTHERWISE MADE SAFE FOR DEMOLITION BY NON-ELECTRIC DEMOLITION WORKERS. THE ELECTRICAL CONTRACTOR IS RESPONSIBLE FOR ASSURING THAT ALL ELECTRIC DEVICES, OF ANY VOLTAGE OR FUNCTION, THAT ARE TO BE DEMOLISHED ARE SAFE AND ADVISE THE DEMOLITION CONTRACTOR WHEN THIS IS SO.
- 3. AFTER THE ELECTRICAL CONTRACTOR HAS DISCONNECTED ELECTRIC SUPPLIES TO ITEMS TO BE DEMOLISHED, HE SHALL ADVISE THE GENERAL CONTRACTOR OF ANY ELECTRIC ITEMS TO BE RETAINED FOR FUTURE USE AND THEREFOR NOT TO BE DEMOLISHED. THE GENERAL CONTRACTOR SHALL THEN PERFORM ALL WORK ZONE DEMOLITION. THIS MATTER APPLIES TO ALL ELECTRIC ITEMS, OF ANY VOLTAGE OR PURPOSE.
- THE SPECIAL/SPECIFIC ITEMS SHOWN ON THE DRAWING FOR ELECTRICAL CONTRACTOR TO ACT ON WERE FOUND BY SURVEY.
 NUMEROUS LOCATIONS WERE BLOCKED BY FURNITURE, ETC. AND ADDITIONAL EQUAL TYPE ITEMS MAY BE PRESENT. THE
 ELECTRICAL CONTRACTOR SHALL ALLOW FOR THIS IN HIS BID PRICE AND ATTEND TO THOSE EQUAL OR SIMILAR DEVICES AS MAY
 BE DISCOVERED.
 REMOVAL ITEMS THAT ARE LISTED AS TO BE TURNED OVER TO OWNER'S INVENTORY SHALL BE DISCUSSED WITH THE DISTRICT
- 5. REMOVAL ITEMS THAT ARE LISTED AS TO BE TURNED OVER TO OWNER'S INVENTORY SHALL BE DISCUSSED WITH THE DISTRICT BUILDINGS AND GROUNDS MANAGER. THOSE ITEMS THAT THE OWNER DECLINES SHALL THEN BE DISPOSED OF BY THE CONTRACTOR IN THE MANOR OF OTHER PERMANENT REMOVALS. ANY PCB BEARING FLUORESCENT FIXTURES SHALL BE DISPOSED OF PER REGULATIONS.
- LOCATIONS THAT WILL NOT BE IN CONFLICT WITH NEW CONSTRUCTION. INSTALL BLANKING PLATE COVERS OVER THE UNUSED PORTION OF GANG BOXES HAVING MORE GANG POSITIONS THAN NEEDED FOR NEW SWITCHES.

 7. LIGHT FIXTURES ARE TO BE REMOVED AS GENERAL, NON ELECTRIC, CONTRACTOR DEMOLITION. DIVISION 16 CONTRACTOR RESPONSIBLE TO SAFE OFF LIGHTUING CIRCUITS FOR REMOVAL BY OTHERS. NO SPECIFIC QUANTITIES OR LOCATIONS ARE SHOWN. RETURN WHATEVER QUANTITY, IF ANY, OF THESE TO OWNER'S INVENTORY IF HE SO SPECIFIES OR THEY ARE OTHERWISE TO BE DISPOSED OF. ELECTRICAL CONTRACTOR SHALL EXAMINE FIXTURES FOR PRESENCE OF PCB'S AND SPECIAL
- DISPOSAL.

 8. THE ELECTRICAL CONTRACTOR SHALL COVER ALL BACK BOXES IN THE WALL THAT BECOME EXPOSED DUE TO DEVICE REMOVALS.
 THIS INSTRUCTION ALSO APPLIES TO EXPOSED ELECTRICAL BACK BOXES AS MAY EXIST AT THE SITE PRIOR TO THIS PROJECT.
 THE COVER SHALL BE BRUSHED ALUMINUM WITH CHAMFERED EDGES AND COVER THE HOLE COMPLETELY WITH AT LEAST 3/4"
 EXTRA MARGIN ON ALL SIDES. MOUNT THE COVER WITH SCREWS TO MATCH THE ORIGINAL PATTERN.

RETAIN EXISTING RECEPTACLES IN WALLS THAT WILL NOT BE IN CONFLICT WITH NEW CONSTRUCTION. RETAIN LIGHT SWITCH

- 9. IT IS EXPECTED THAT STRUCTURAL DEMOLITION BY THE GENERAL CONTRACTOR WILL CAUSE VARIOUS ELECTRIC SUPPLIES, OF VARIOUS VOLTAGES AND PURPOSES, TO BE CUT AND RENDER SOME DEVICES TEMPORARILY INACTIVE. IT IS THE ELECTRICAL CONTRACTOR'S RESPONSIBILITY TO RECONSTRUCT AND RECONNECT SUCH ELECTRIC SOURCES WHEN THE NEW STRUCTURE IS BUILT. NOTE THAT MOST REINSTALLED ITEMS WILL BE IN DIFFERENT LOCATIONS FROM THE REMOVAL LOCATION. THE ELECTRICAL CONTRACTOR SHALL MAKE ALL REQUIRED CIRCUIT EXTENSIONS OR MODIFICATIONS TO PROVIDE SERVICE TO A REINSTALLED ITEM AS RELOCATED. PROVIDE ALL REQUIRED CIRCUIT EXTENSIONS AS REQUIRED TO RESTORE SERVICE TO DEVICES. NOTE THAT THIS REQUIREMENT ALSO APPLIES TO THE ROOMS AND ELECTRICAL ITEMS WITHIN THAT ARE NOMINALLY NOT IN CONTRACT. SUCH RESTORATION OF SERVICE, IF NEEDED, IS SPECIFICALLY IN THE ELECTRICAL CONTRACTOR'S
- 10. IT SHALL BE THE ELECTRICAL CONTRACTOR'S RESPONSIBILITY TO PROTECT ALL ELECTRICAL DEVICES, FROM DAMAGES DURING CONSTRUCTION, WHICH ARE EITHER INDICATED TO REMAIN, AND/OR TO BE REMOVED AND REINSTALLED THROUGHOUT ALL CONSTRUCTION AREAS. DEVICES SHALL INCLUDE BUT WILL NOT BE LIMITED TO: SMOKE DETECTORS, EMERGENCY LIGHTS, EXIT SIGNS, OCCUPANCY SENSORS, SPEAKERS, LIGHT FIXTURES, SWITCHES, RECEPTACLE, ETC. IN THE EVENT OF DAMAGES INCURRED DUE TO CONSTRUCTION ACTIVITIES, THE ELECTRICAL CONTRACTOR SHALL BE RESPONSIBLE TO REPLACE ANY DAMAGED DEVICES AT NO ADDITIONAL COST TO OWNER.
- 11. ALL SYSTEM ASSOCIATED WITH THE DEVICES SCHEDULED TO BE REMOVED, STORED AND PROTECTED SHALL BE TESTED BY THE MANUFACTURER'S CERTIFIED TESTING VENDOR PRIOR TO ANY DEMOLITION ACTIVITY. ANY DEVICE WHICH FAILS THE TEST SHALL BE REPLACED WITH A FORM, FIT AND FUNCTION COMPONENT PER UNIT PRICES, AND SUCH DEVICES ARE NOT INCLUDED IN THIS RESPONSIBILITY STATEMENT, BUT ALSO SUCH INSTALLATION SHALL BE IN THE ELECTRICAL CONTRACTOR'S BASE BID. THE ELECTRICAL CONTRACTOR SHALL RE-TEST ALL SUCH SYSTEM COMPONENTS BY A MANUFACTURER CERTIFIED TESTING VENDOR OF SUCH SYSTEM OF ALL PREVIOUSLY TESTED SYSTEM COMPONENTS AFTER ALL WORK BY ALL TRADES HAS BEEN COMPLETED, AND ALL SYSTEM COMPONENTS HAVE BEEN INSTALLED. ANY COMPONENT WHICH FAILS SHALL BE REPLACED, AND PROGRAMMED IF NECESSARY BY THE ELECTRICAL CONTRACTOR. ALL SUCH REPLACEMENT AND PROGRAMMING COSTS SHALL BE ELECTRICAL CONTRACTOR'S RESPONSIBILITY. ALL COSTS ASSOCIATED WITH THE TESTING OF AFFECTED SYSTEM SUCH AS BUT NOT LIMITED TO FIRE ALARM, PUBLIC ADDRESS, INTERCOM, TELEPHONE, AND SECURITY SYSTEMS SHALL BE THE RESPONSIBILITY OF THE ELECTRICAL CONTRACTOR. ALL EQUIPMENT, DEVICES, WIRING AND THEIR ASSOCIATED MATERIAL SPECIFIED TO REMAIN, WHICH IS NOT STORED AND PROTECTED, SHALL BE PROTECTED DURING THE DEMOLITION ACTIVITIES, AND ALL TRADES SHALL BE INFORMED OF SUCH COMPONENTS. ANY OF SUCH COMPONENTS WHICH BECOME DAMAGED DURING DEMOLITION SHALL BE REPLACED FORM. FIT AND FUNCTION BY THE ELECTRICAL CONTRACTOR AT HIS EXPENSE.

ABBREVIATIONS

E, EX	EXISTING
ETR	EXISTING TO REMAIN
PSEGLI	PSE&G LONG ISLAND (UTILITY CO
SM, S.M.	SURFACE MOUNTED
U.O.N.	UNLESS OTHERWISE NOTED
EC, E.C.	ELECTRICAL CONTRACTOR
GC, G.C.	GENERAL CONTRACTOR
MC, M.C.	MECHANICAL CONTRACTOR
PC, P.C.	PLUMBING CONTRACTOR
TYP.	TYPICAL
REQ'D	REQUIRED
O.C.	ON CENTER
CKT	CIRCUIT

AWAY FROM FLOOR

ABOVE COUNTERTOP

RECEPTACLE

TEMPORARY POWER CONSTRUCTION NOTES: (NOT ALL APPLY)

- . THE DIVISION 16 CONTRACTOR SHALL PROVIDE TEMPORARY POWER AND LIGHT IN THE NEW AREAS 'D', AND 'E' AND THE
- RECONSTRUCTED AREAS OF THE EXISTING BUILDING.

 2. ALL TEMPORARY POWER PANELS AND FUSED SWITCHES OUTSIDE SHALL BE NEMA 3R CONSTRUCTION AND LOCKABLE. ALL OUTSIDE RECEPTACLES SHALL BE WATERPROOF AND HAVE A COVER THAT ENCLOSES THE PLUGGED IN CORDS WHILE IN SERVICE AS INTERMATIC WP120C. NON-WATERPROOF GEAR IN A HOUSING IS NOT ACCEPTABLE.
- REQUIRED. ALL RECEPTACLES OUTLETS SHALL BE 2 GANG DOUBLE DUPLEX.

 4. TEMPORARY LIGHTING SHALL BE CONSTRUCTED OF SINGLE AND DOUBLE 100 WATT CLEAR INCANDESCENT LAMPS, OR EQUIVALENT, AND WATERPROOF RUBBER SOCKETS, SPLICED WITH WATERPROOF CONNECTORS ON FESTOONED ROMEX-TYPE WIRE. ADEQUACY OF ALL TEMPORARY LIGHTING CONFIGURATIONS SHALL BE AS DETERMINED BY THE CONSTRUCTION MANAGER. PRE ASSEMBLED TEMPORARY LIGHTING IS DISALLOWED. TAPS AND SPLICES SHALL BE MADE WITH SCOTCH LOCK CONNECTORS, RUBBER TAPE, AND THEM PVC COATED. THE CONNECTORS SHALL BE FILLED WITH PENETROX. A PLASTIC SHAPE ON CAGE/GUARD SHALL PROTECT EACH SOCKET AND LAMP. NOMINAL SPACING BETWEEN LAMP CLUSTER IS 16 FEET. MOUNT LIGHTS EIGHT FEET ABOVE FINISHED FLOOR IN TYPICAL LOCATIONS AND 10 FEET ABOVE FINISHED FLOOR IN CORRIDOR. PROVIDE NIGHT LIGHTING CIRCUIT, WHICH SHALL OPERATE CONTINUOUSLY. ALL LAMPS SHALL BE 130 VOLT, ROUGH SERVICE

ALL RECEPTACLES SHALL BE GFCI PROTECTED AND MOUNTED 3'-0" ABOVE FINISHED FLOOR. PROVIDE WORK BLOCKING AS

- RATED. TEMPORARY LIGHTS SHALL BE TO OSHA STANDARDS. ALTERNATE FIXTURES SHALL BE 400W CONSTRUCTION SITE STYLE
 5. PROVIDE HOOK UPS TO JOB TRAILER FOR ALL TRADES. USE SITE POWER AS SOURCE. OWNER PAYS FOR POWER CONSUMPTION.
 6. WIRING SHALL BE 1#12+1#12(N)+1#12(G) ROMEX STYLE. CIRCUITS SHALL BE OPERATED A MAXIMUM OF 15 AMPS OR 1800 WATTS
 (18 100 WATT LAMPS), SWITCHING SHALL BE DONE VIA THE SWITCH RATED 20A, 10 CIRCUIT BREAKERS. SEGREGATE THE NIGHT
- LIGHTS AND RECEPTACLES IN THE LOWER PART OF THE POWER PANELS AND LABEL THESE "DO NOT TURN OFF". CIRCUIT HOME RUNS CONDUCTORS SHALL INCREASE ONE WIRE SIZE EVERY 100 FEET I.E. #10 CONDUCTORS. WIRING WITHIN THE ROOM AREA SHALL BE MADE WITH #12 CONDUCTORS.
- THE DIVISION 16 CONTRACTOR SHALL PREPARE EACH PANEL SCHEDULE.
 A LENGTH OF GREENFIELD FLEX CONDUIT AT PINCH POINTS SHALL PROTECT ALL WIRE, SUCH AS WHERE WIRING PASSED
 THROUGH A DOORWAY. WIRING SHALL BE SUPPORTED FROM ANCHORS INSTALLED BY THE DIVISION 16 CONTRACTOR FOR THE
- THROUGH A DOORWAY. WIRING SHALL BE SUPPORTED FROM ANCHORS INSTALLED BY THE DIVISION 16 CONTRACTOR FOR THE PURPOSE OF ATTACHMENT TO PROJECT. ALL ELECTRICAL HARDWARE SHALL BE NEW FOR THIS PROJECT.

 10. ALL WIRING SHALL BE INSTALLED SO AS NOT TO CAUSE TRIPPING HAZARD OR SIMILAR OBSTRUCTION.
- POWER PANELS SHALL BE EQUIPPED WITH 42 1P, 20A CIRCUIT BREAKERS AND ALL CIRCUIT BREAKERS NOT IN SERVICE SHALL BE LABELED SPARE. AT THE OWNERS OPTION PANEL AND CIRCUIT BREAKERS SHALL BE TURNED OVER TO OWNERS INVENTORY AT CONCLUSION OF THE PROJECT. ALL ELECTRICAL HARDWARE SHALL BE NEW FOR THIS PROJECT.
 THE DIVISION 16 CONTRACTOR SHALL BE RESPONSIBLE FOR ALL MAINTENANCE OF TEMPORARY LIGHTING AND POWER SYSTEMS DURING, AND AFTER INSTALLATION, UP TO THE TIME OF BENEFICIAL OCCUPANCY, AND TIME OF REMOVAL. REPAIRS SHALL BE MADE WITHIN 24 HOURS OF THE REPORTED OUTAGE, OR AS DIRECTED BY THE CONSTRUCTION MANAGER. DIVISION 16
- DISPOSAL.

 13. REMOVAL OF THE TEMPORARY POWER AND LIGHTING SHALL BE THE RESPONSIBILITY OF THE DIVISION 16 CONTRACTOR WHEN THE PROJECT IS COMPLETE. ALL EQUIPMENT, WIRING SUPPORTS, CONNECTORS, ETC. SHALL BE REMOVED FROM OWNER'S PROPERTY AFTER PROJECT IS COMPLETE. INCLUDE STATEMENT OF REMOVAL WITHIN CLOSE OUT DOCUMENTS, REQUIRED FOR

CONTRACTOR SHALL COMMENCE WORK ON THIS PROJECT WITH A GROSS OF SPARE CONSTRUCTION BULBS AT HIS IMMEDIATE

FINAL PAYMENT.

14. PROVIDE THE TEMPORARY ELECTRICAL SERVICE TO THE CONSTRUCTION TRAILERS SHALL BE AS PER USERS REQUIREMENTS OF THE TRADES. TEMPORARY SERVICES ARE REQUIRED PER SPECIAL CONDITIONS OF THE PROJECT.

15. ALL TEMPORARY POWER WORK SHALL BE COORDINATED WITH THE CONSTRUCTION MANAGER SPECIAL EMPHASIS SHALL BE

1. ALL CONDUIT AND CABLE PENETRATIONS THROUGH FIRE RATED WALLS, FLOORS OR OTHER STRUCTURES SHALL BE FIRE STOPPED. 2. THE FIRE STOP MATERIALS SHALL BE HILTI TYPE FS-657 FIRE BLOCK, FS-ONE SEALANT, CP-672 JOINT SPRAY, CP-601S ELASTOMERIC SEALANT, 6P-606 FLEXIBLE SEALANT, CP-643 OR CP-642 COLLAR, CP-618 PUTTY STICK, OR FS-635 TROWEL ABLE COMPOUND, AS SUITARI F.

3. CONTRACTOR SHALL SUBMIT SHOP DRAWINGS OF PRODUCTS SPECIFIED OR <u>EQUAL</u>.

4. FIRE STOP MATERIALS OTHER THAN HILTI SHALL INCLUDE FULL TECHNICAL DATA WITH SHOP DRAWINGS TO DEMONSTRATE EQUALITY

EXERCISED FOR TERRAZZO MACHINES AND ITS ELECTRICAL REQUIREMENT.

FIRE STOP NOTES:

5. ALL SYSTEMS SHALL HAVE THEIR OWN SLEEVE THROUGH FIRE RATED WALLS. IE FIRE ALARM, PUBLIC ADDRESS, TELEPHONE, DATA, POWER AND LIGHTING.

WITH THE SPECIFIED FIRE STOPS AND STATEMENT FROM MANUFACTURER THAT THEY MEET OR EXCEED THE PRODUCTS SPECIFIED

ELECTRICAL SYMBOL LEGEND		
HIGH BAY LIGHTING		
WALL MOUNTED LIGHTING		
LIGHTING SWITCH. 'xx' DENOTES SWITCH LEG		
EXIT SIGN		
FIRE ALARM HORN STROBE		
FIRE ALARM PULL STATION		
ELECTRICAL POWER PANEL		
DISCONNECT - NEMA 3R		
OUTDOOR RATED PHOTOCELL		
VACANCY SENSOR		
SITE SYMBOL LEGEND		
UNDERGROUND HAND HOLE		
PULL BOX		

SIMILAR SYMBOLS USED ON DEMO PLANS. ALL ITEMS SHOWN ON DEMO PLAN TO BE REMOVED ENTIRELY UNLESS OTHERWISE NOTED.

OUTDOOR RECEPTACLE

POLE MOUNTED LIGHTING

LINE DESIGNATIONS

EXISTING TO REMAIN DEVICES

DEVICES TO BE REMOVED. PULL BACK ALL ASSOCIATED CONDUIT AND WIRING AND REMOVE UNLESS OTHERWISE NOTED ON THE PLANS (UNDERGROUND ELEC CONDUIT ON SITE PLAN).

NEW DEVICES

UNDERGROUND ELECTRICAL CONDUIT

PROJECT BEDFORD CENTRAL SCHOOL DISTRICT
PHASE 1A - BOND IMPROVEMENTS
FOX LANE MIDDLE SCHOOL
632 S BEDFORD RD, BEDFORD, NY 10506

DWGTILLE

GENERAL NOTES, SYMBOLS AND ABBREVIATIONS

REV. DATE

THESE DRAWINGS ARE BASED ON CONSTRUCTION DRAWINGS NOT PREPARED BY BBS ARCHITECTS, LANDSCAPE ARCHITECTS AND ENGINEERS, PC. AND, THEREFORE, MAY NOT REPRESENT THE CONDITIONS AS CONSTRUCTED AT THE TIME. ALL EXISTING CONDITIONS SHOWN ARE REPRESENTED AS SUGGESTIVE INFORMATION AS THEY MAY NOT HAVE BEEN BUILT AND DETAILED PER THE ORIGINAL DOCUMENTS OR PER THE OWNER'S INFORMATION.

THIS DRAWING, PREPARED FOR THE SPECIFIC PROJECT INDICATED IS AN INSTRUMENT OF SERVICE AND THE PROPERTY OF BBS ARCHITECTS, LANDSCAPE ARCHITECTS AND ENGINEERS, PC. INFRINGEMENT OR ANY USE OF THIS DRAWING FOR ANY OTHER PROJECT IS PROHIBITED. ANY ALTERATION OR REPRODUCTION OF THIS DOCUMENT IS ALSO PROHIBITED WITHOUT THE WRITTEN CONSENT OF THE ARCHITECT OR ENGINEER.

ARCHITECTS
LANDSCAPE ARCHITECTS
ENGINEERS

www.BBSARCHITECTURE.COM

SED NO


DISTRICT BEDFORD CENTRAL SCHOOL
DISTRICT
PROJECT
PHASE 1A - BOND IMPROVEMENTS

DWG TITLE
GENERAL NOTES, SYMBOLS
AND ABBREVIATIONS

SCALE: AS NOTED

DATE: 2/2/2023

BID P/U DATE:

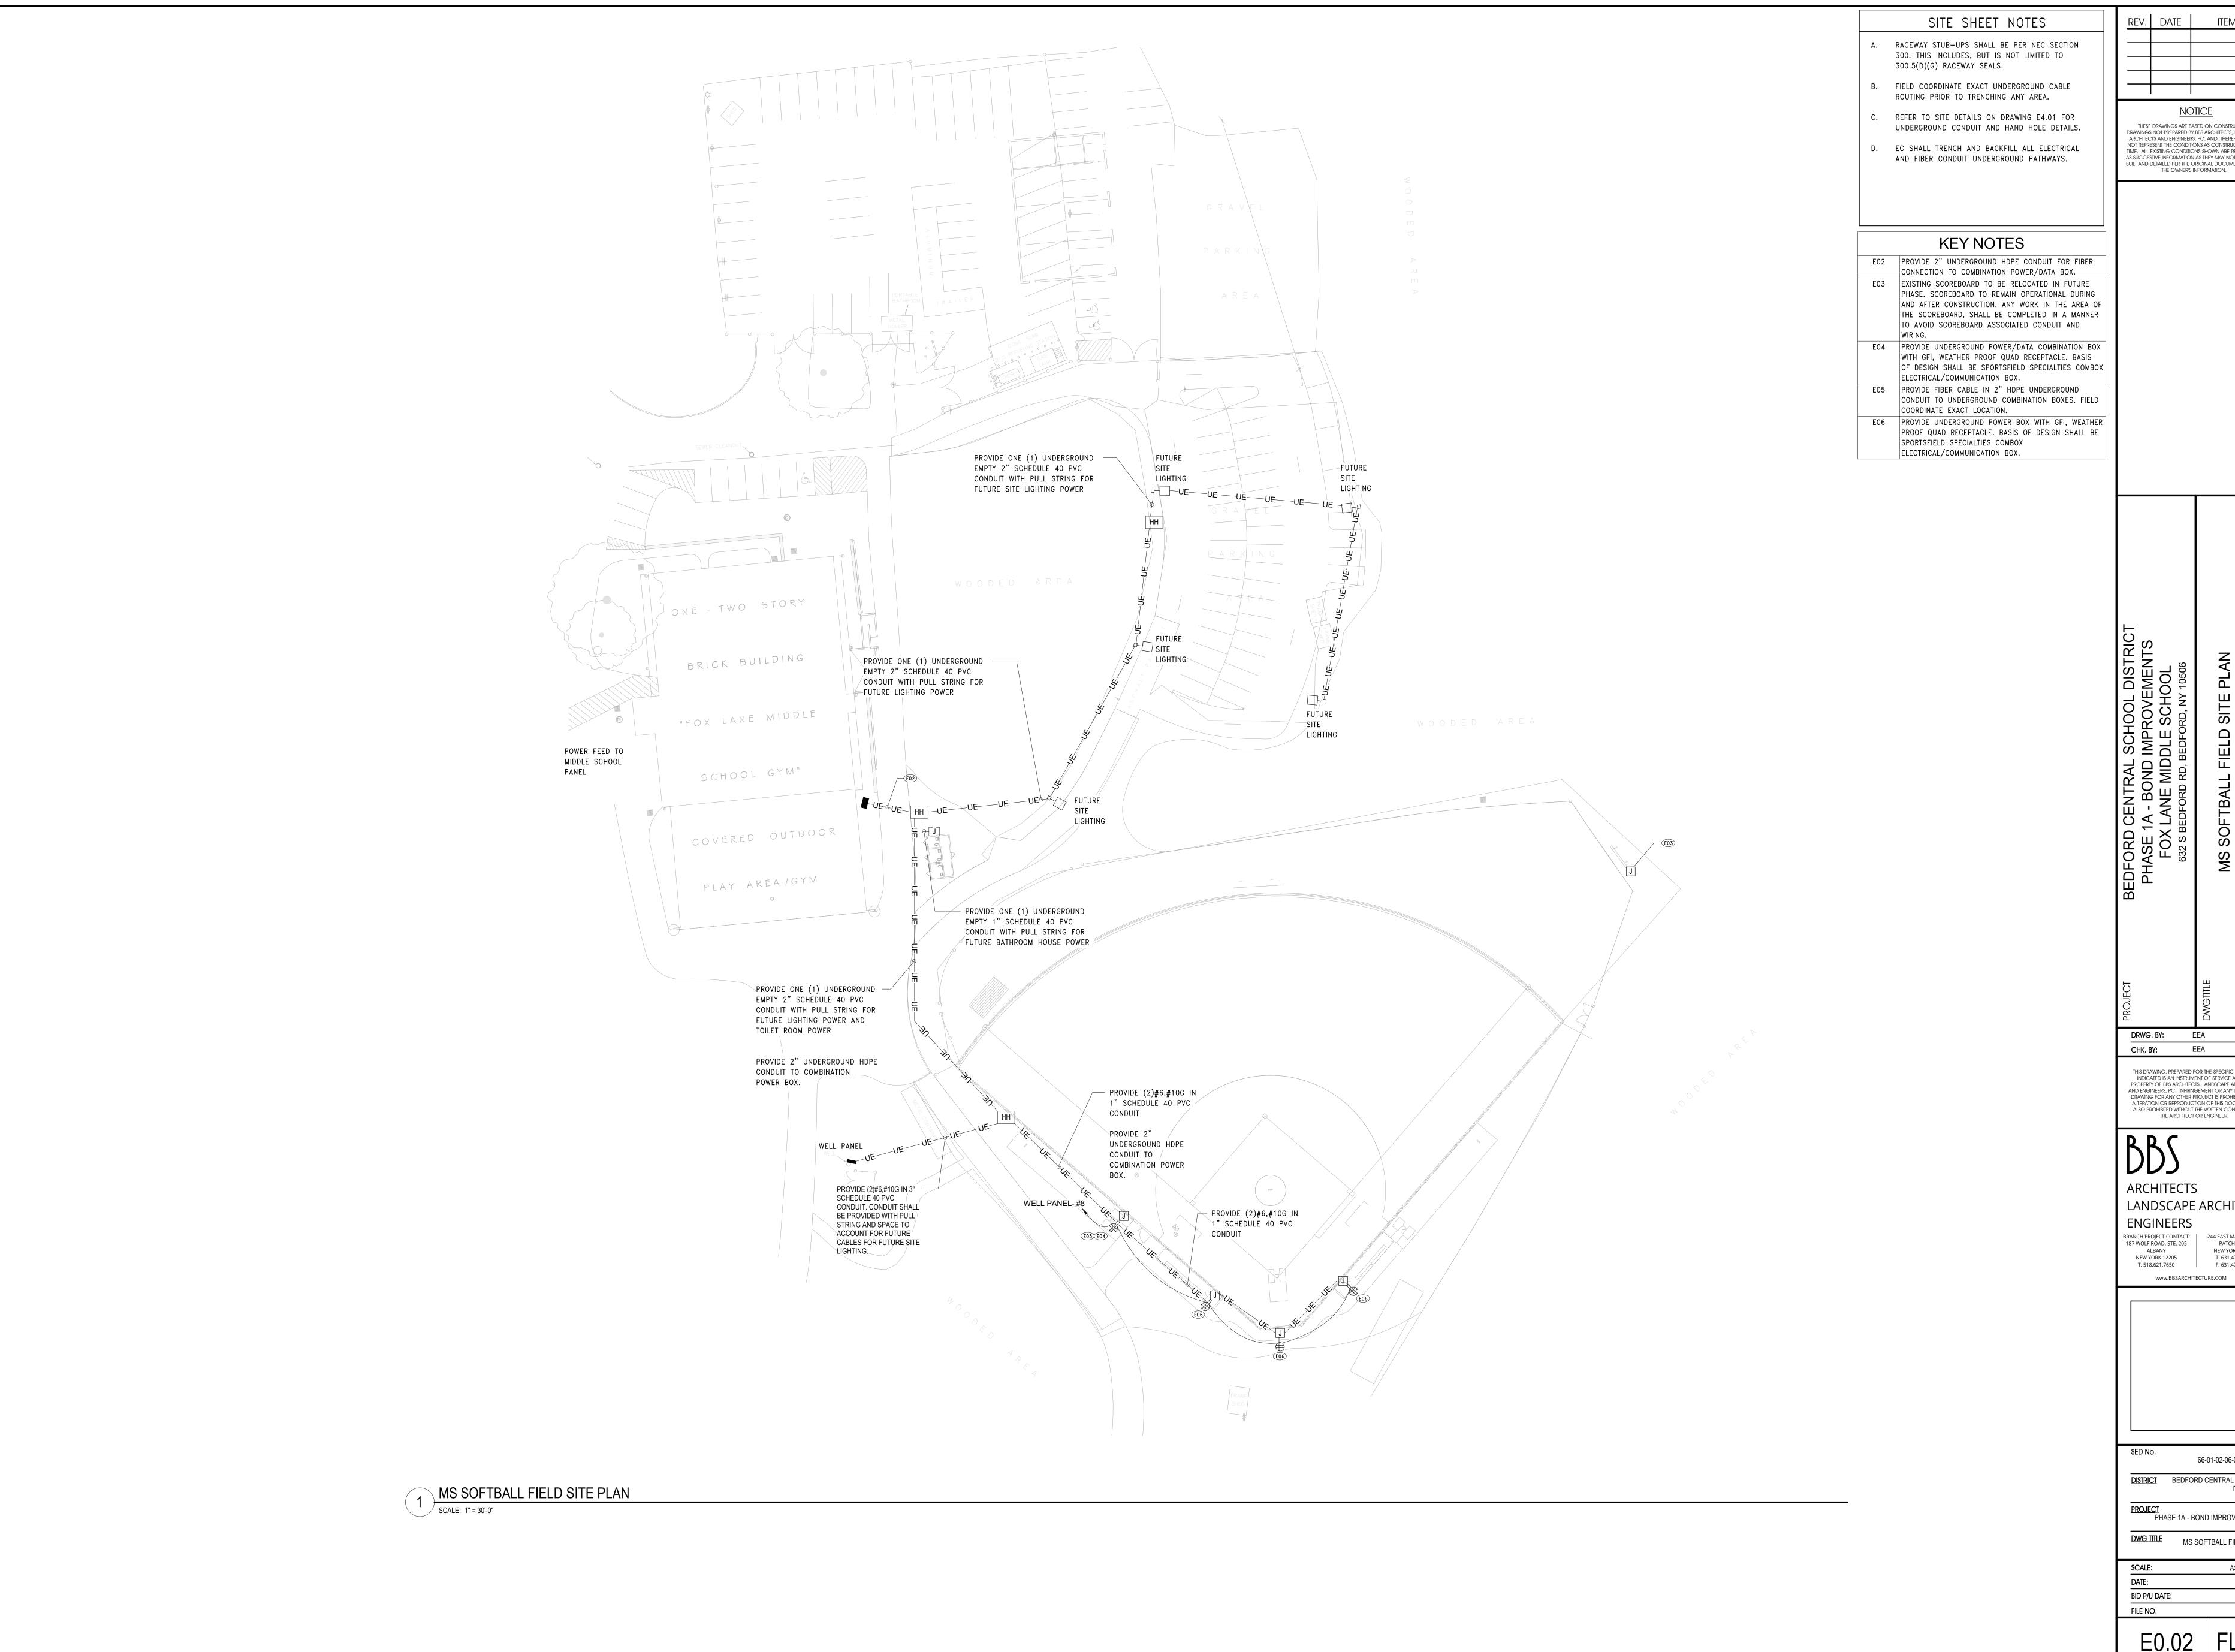

REV. DATE ITEM

<u>NOTICE</u>

THESE DRAWINGS ARE BASED ON CONSTRUCTION DRAWINGS NOT PREPARED BY BBS ARCHITECTS, LANDSCAPE ARCHITECTS AND ENGINEERS, PC. AND, THEREFORE, MAY NOT REPRESENT THE CONDITIONS AS CONSTRUCTED AT THE TIME. ALL EXISTING CONDITIONS SHOWN ARE REPRESENTED AS SUGGESTIVE INFORMATION AS THEY MAY NOT HAVE BEEN BUILT AND DETAILED PER THE ORIGINAL DOCUMENTS OR PER THE OWNER'S INFORMATION.

THIS DRAWING, PREPARED FOR THE SPECIFIC PROJECT INDICATED IS AN INSTRUMENT OF SERVICE AND THE PROPERTY OF BBS ARCHITECTS, LANDSCAPE ARCHITECTS AND ENGINEERS, PC. INFRINGEMENT OR ANY USE OF THIS DRAWING FOR ANY OTHER PROJECT IS PROHIBITED. ANY ALTERATION OR REPRODUCTION OF THIS DOCUMENT IS ALSO PROHIBITED WITHOUT THE WRITTEN CONSENT OF THE ARCHITECT OR ENGINEER.


ARCHITECTS LANDSCAPE ARCHITECTS

BRANCH PROJECT CONTACT: 244 EAST MAIN STREET 187 WOLF ROAD, STE. 205 PATCHOGUE NEW YORK 11772 NEW YORK 12205 T. 631.475.0349 F. 631.475.0361

66-01-02-06-0-007-011 DISTRICT BEDFORD CENTRAL SCHOOL DISTRICT

PROJECT
PHASE 1A - BOND IMPROVEMENTS

AS NOTED

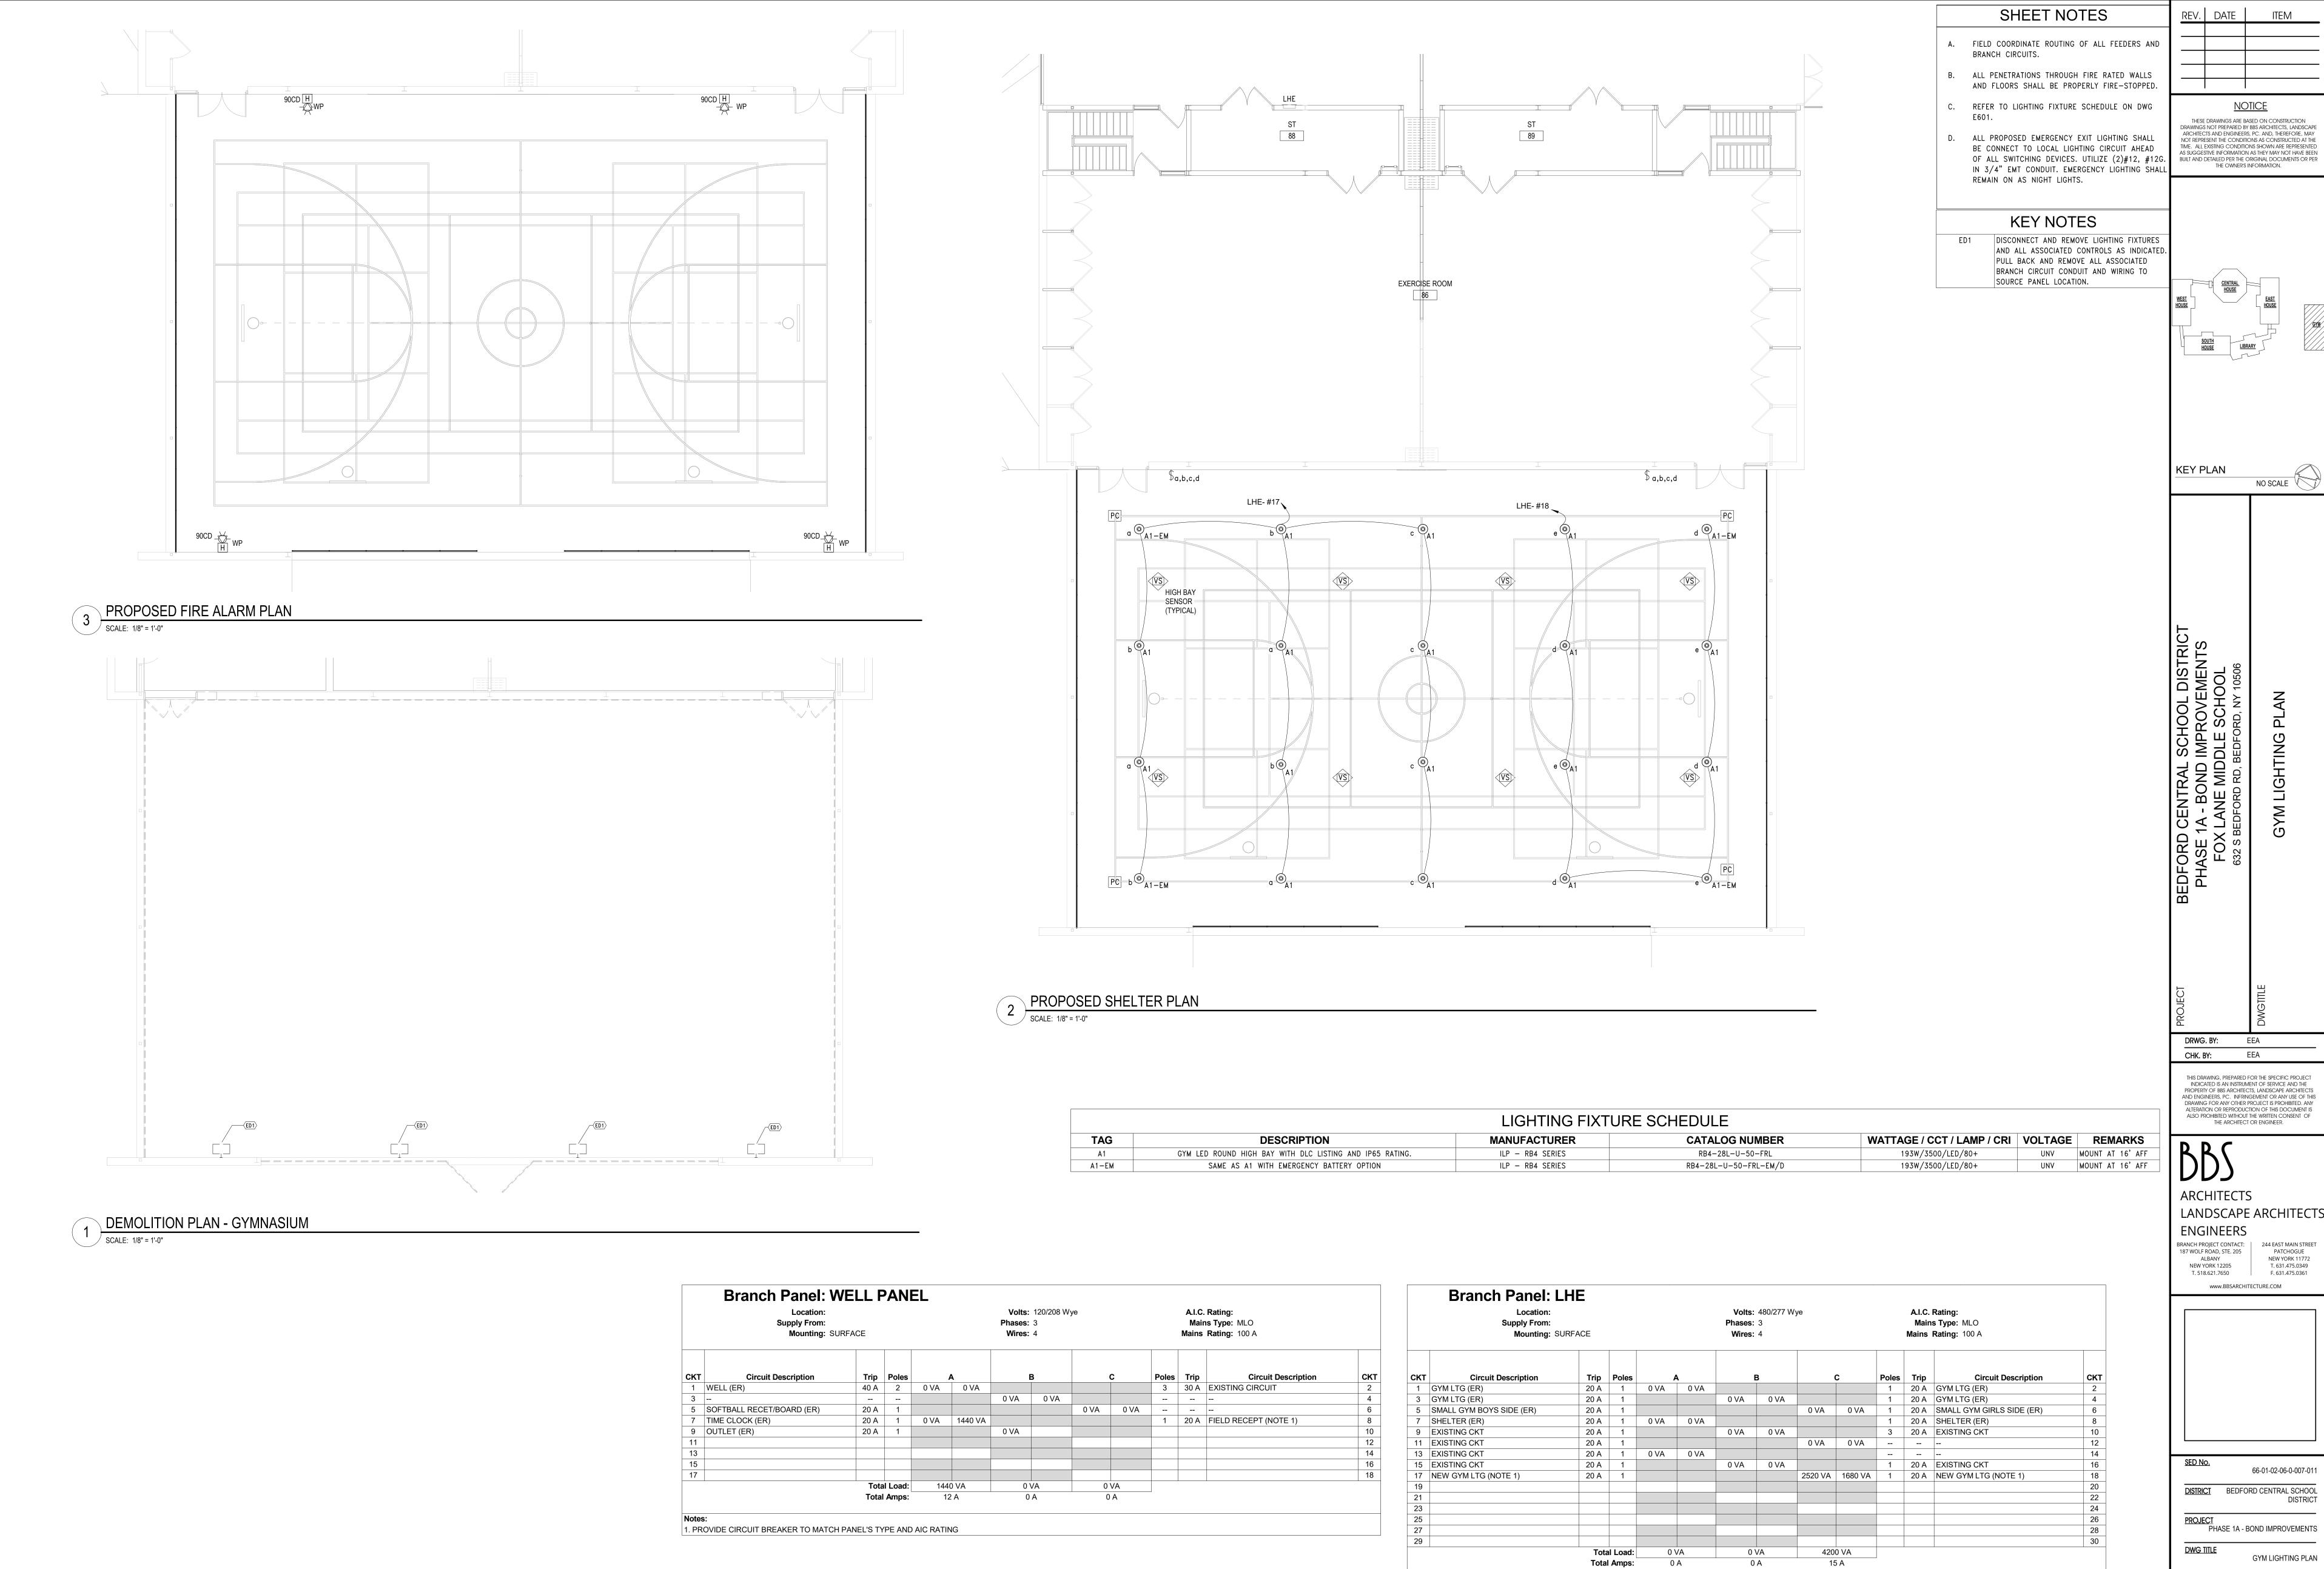

1. PROVIDE CIRCUIT BREAKER TO MATCH PANEL'S TYPE AND AIC RATING

REV. DATE ITEM THESE DRAWINGS ARE BASED ON CONSTRUCTION DRAWINGS NOT PREPARED BY BBS ARCHITECTS, LANDSCAPE ARCHITECTS AND ENGINEERS, PC. AND, THEREFORE, MAY NOT REPRESENT THE CONDITIONS AS CONSTRUCTED AT THE NO SCALE √


> THIS DRAWING, PREPARED FOR THE SPECIFIC PROJECT INDICATED IS AN INSTRUMENT OF SERVICE AND THE PROPERTY OF BBS ARCHITECTS, LANDSCAPE ARCHITECTS AND ENGINEERS, PC. INFRINGEMENT OR ANY USE OF THIS ALTERATION OR REPRODUCTION OF THIS DOCUMENT IS
> ALSO PROHIBITED WITHOUT THE WRITTEN CONSENT OF
> THE ARCHITECT OR ENGINEER.

LANDSCAPE ARCHITECTS


244 EAST MAIN STREET PATCHOGUE NEW YORK 11772 T. 631.475.0349 www.BBSARCHITECTURE.COM

66-01-02-06-0-007-011 <u>DISTRICT</u> BEDFORD CENTRAL SCHOOL PROJECT
PHASE 1A - BOND IMPROVEMENTS GYM LIGHTING PLAN

SCALE: AS NOTED DATE: BID P/U DATE: FILE NO.

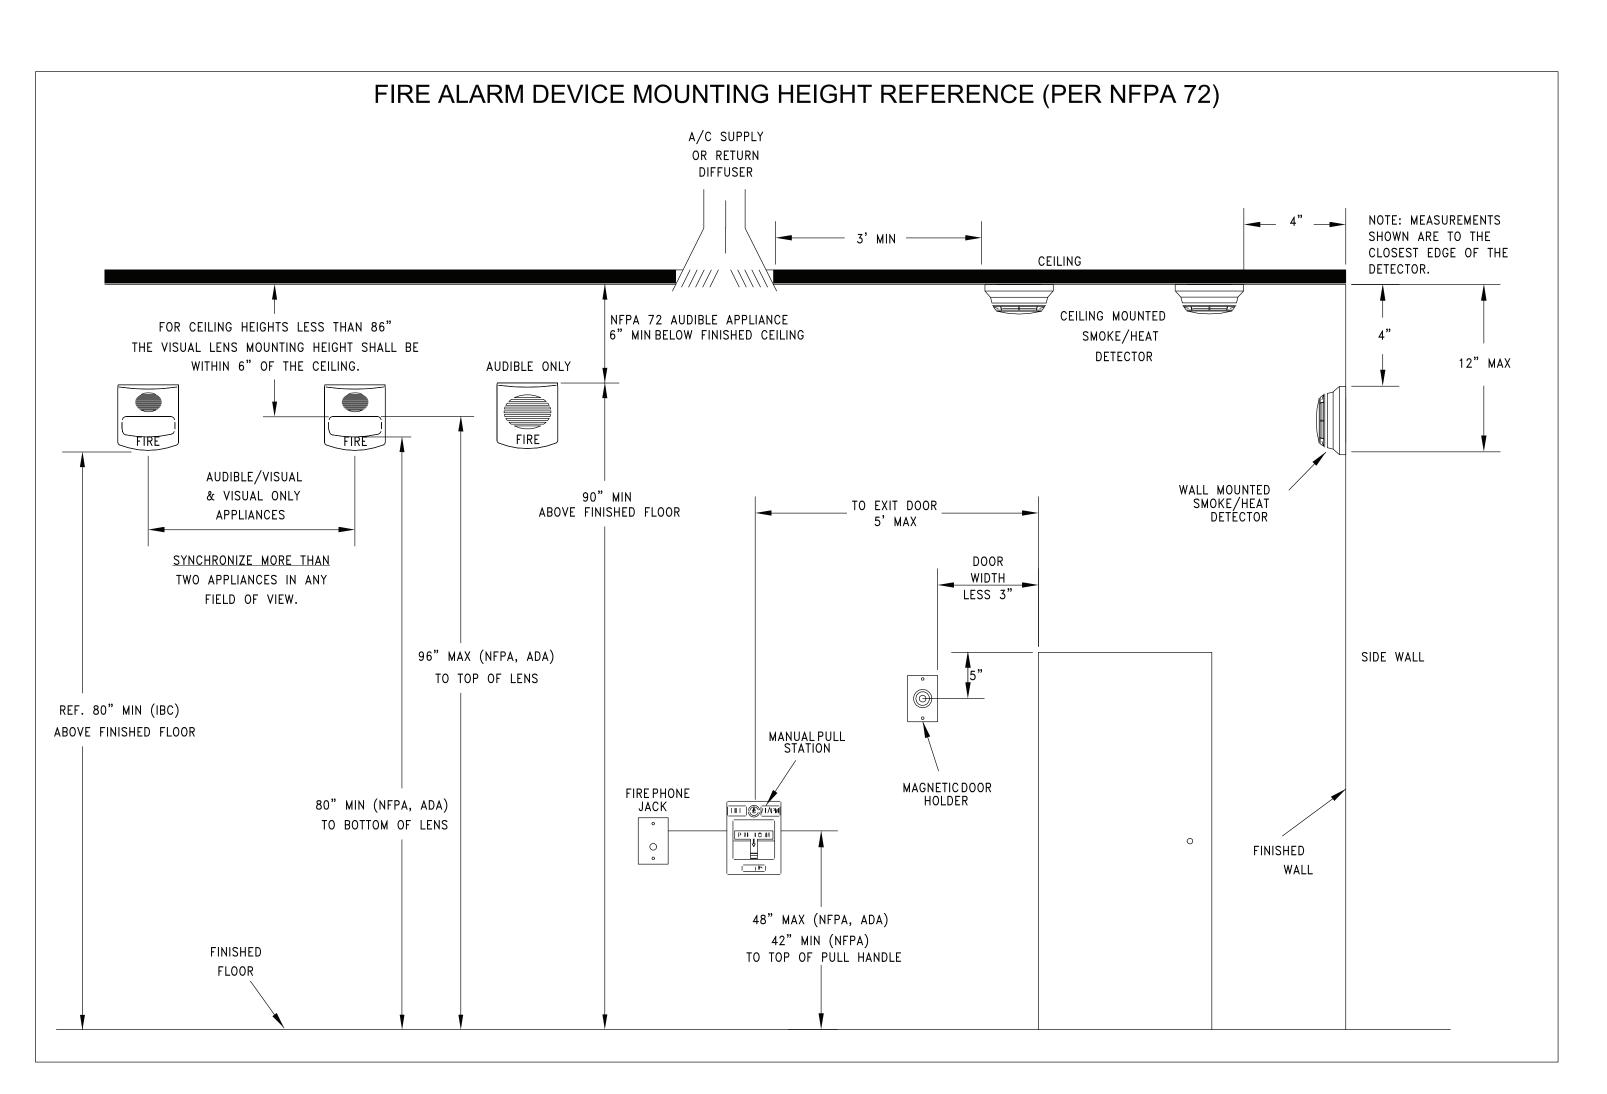

2 TYPICAL FIRE ALARM HEIGHT
SCALE: NTS

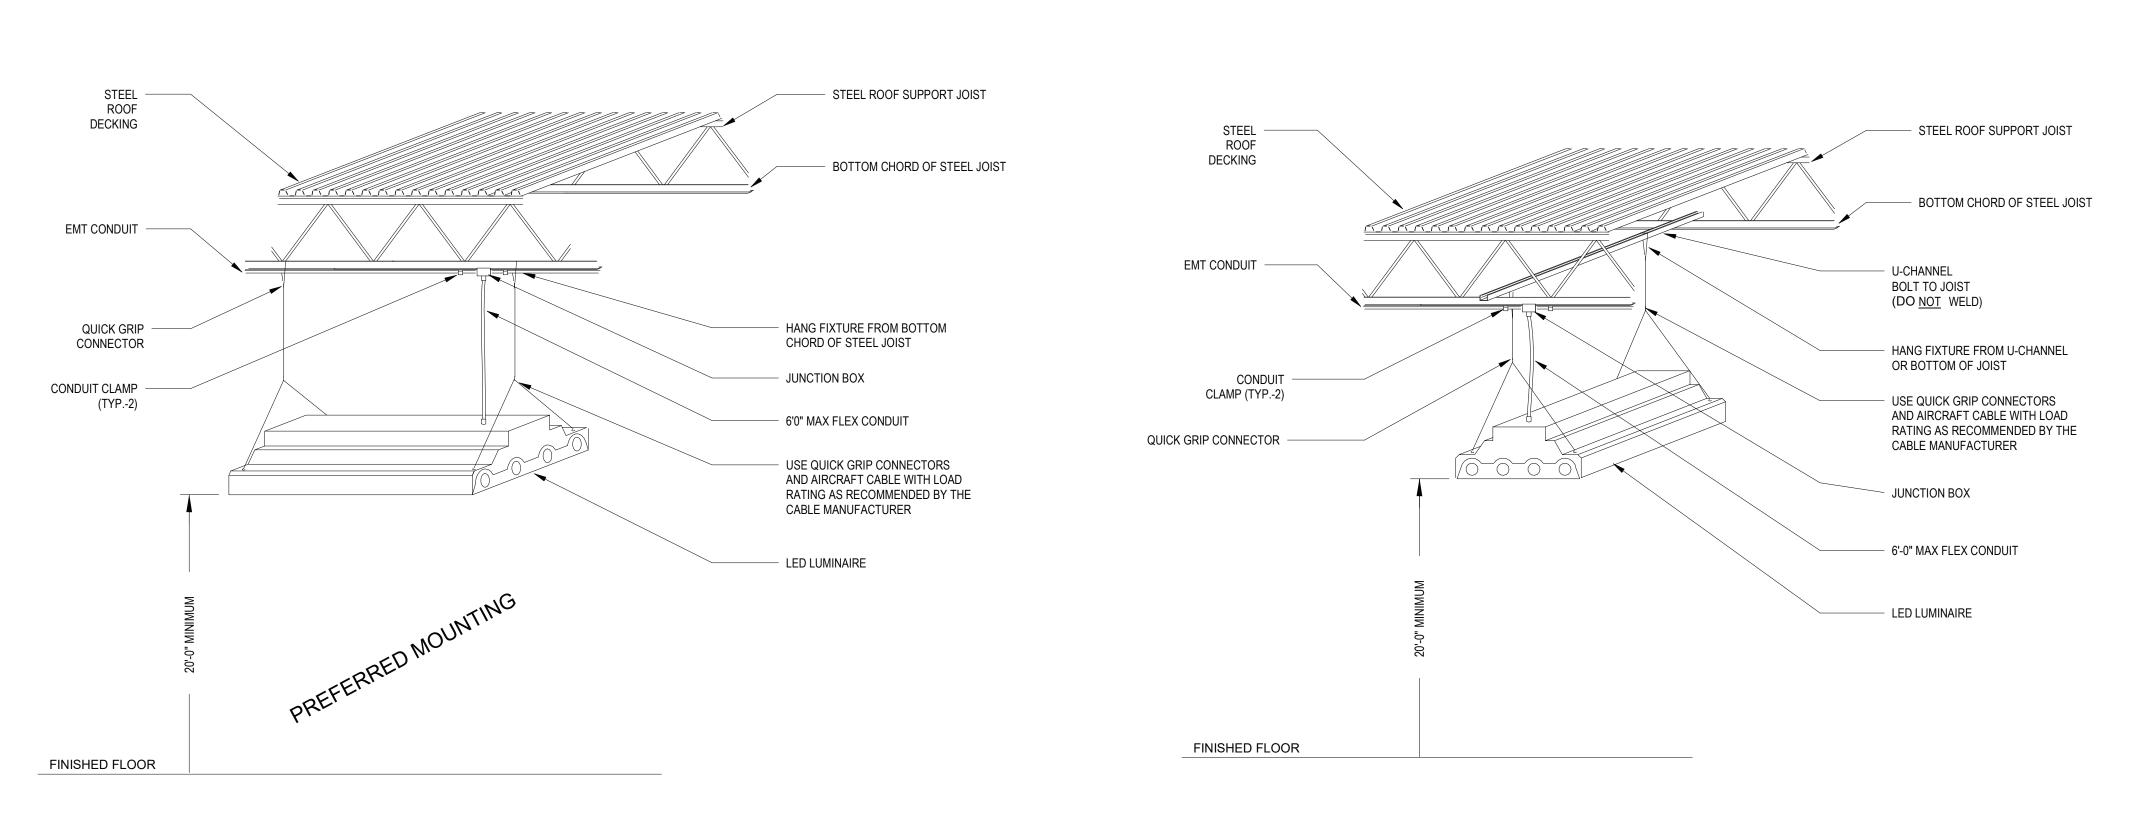


1 TYPICAL HIGHBAY LIGHTING FIXTURE MOUNTING DETAIL SCALE: N.T.S.

REV.	DATE	ITEM
DRAWINGS ARCHITEC' NOT REPRE TIME. ALL E AS SUGGES	DRAWINGS ARE B. NOT PREPARED B' IS AND ENGINEER SENT THE CONDIT XISTING CONDITION INFORMATION DETAILED PER THE (ASED ON CONSTRUCTION / BBS ARCHITECTS, LANDSOS, PC. AND, THEREFORE, NONS AS CONSTRUCTED AT SOME AS THEY MAY NOT HAVE DRIGINAL DOCUMENTS OF INFORMATION.
ISTRICT MENTS		
L DIST	100L	S
CHOOL	E SCH)ETAII
RAL SON	MIDDL RD, BED	ICAL [
SENTF A - BO	FOX LANE MIDDLE SCHOOL 632 S BEDFORD RD, BEDFORD, NY 10506	ELECTRICAL DETAILS
BEDFORD CENTRAL SCHOOL DI PHASE 1A - BOND IMPROVEMI	FOX I	🗇
BEDF PH		
PROJECT		OWGTITLE


	DWGTITLE		
DRWG. BY: Aut	thor		
CHK. BY: Chec	cker		
THIS DRAWING, PREPARED FOR THE SPECIFIC PROJECT INDICATED IS AN INSTRUMENT OF SERVICE AND THE PROPERTY OF BBS ARCHITECTS, LANDSCAPE ARCHITECTS AND ENGINEERS, PC. INFRINGEMENT OR ANY USE OF THIS DRAWING FOR ANY OTHER PROJECT IS PROHIBITED. ANY ALTERATION OR REPRODUCTION OF THIS DOCUMENT IS ALSO PROHIBITED WITHOUT THE WRITTEN CONSENT OF THE ARCHITECT OR ENGINEER.			

BBS	
ARCHITECTS	
LANDSCAPE	ARCHITECTS
ENGINEERS	
BRANCH PROJECT CONTACT: 187 WOLF ROAD, STE. 205 ALBANY NEW YORK 12205 T. 518.621.7650	244 EAST MAIN STREET PATCHOGUE NEW YORK 11772 T. 631.475.0349 F. 631.475.0361
MARADA, DDCADCLITI	ECTUBE COM

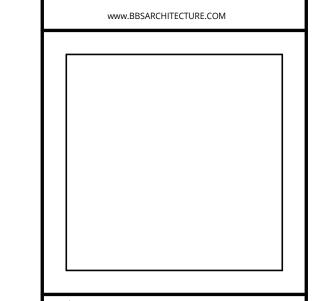

<u>SED No.</u> 66-01-02-06-0-007-011
DISTRICT BEDFORD CENTRAL SCHOOL DISTRICT
PROJECT PHASE 1A - BOND IMPROVEMENTS
<u>DWG TITLE</u> ELECTRICAL DETAILS

SCALE:	AS NOTED
DATE:	2/2/2023
BID P/U DATE:	
FILE NO.	22-225B

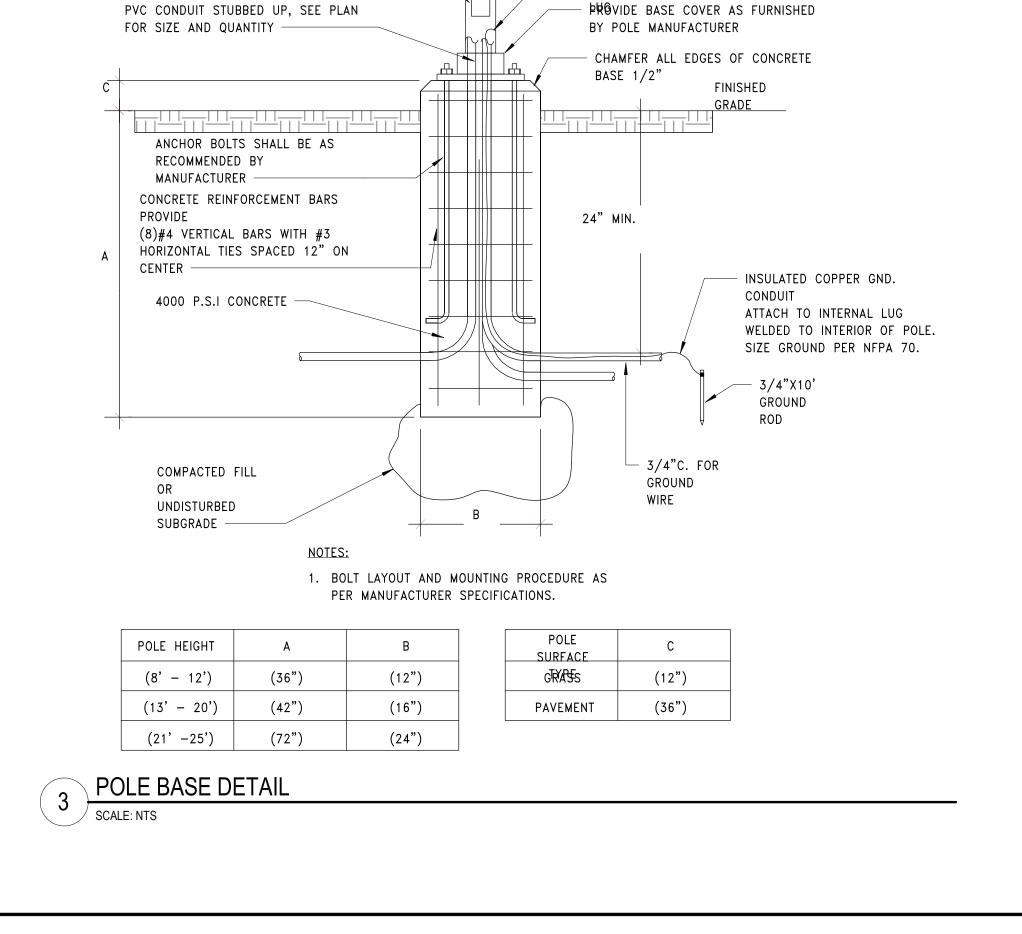


- POLE AS SPECIFIED

GROUNDIN




HANDHOLE-SEE POLE MANUFACTURER

1. REPLACE EXISTING SURFACE CONDITIONS IN KIND TO INCLUDE, BUT NOT LIMITED TO: CONCRETE, CRUSHED STONE, SELECT GRAVEL, ASPHALT, TOPSOIL AND GRASS. 2. 24" MIN. OR 6" BELOW BOTTOM OF FROST LINE, WHICHEVER IS

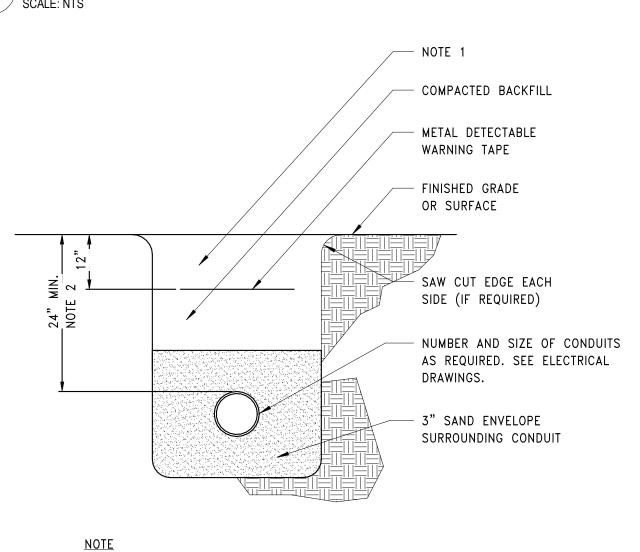

CONDUIT PENETRATION INTO BUILDING DETAIL SCALE: NTS


DETAIL NOTES:
AI EACH CONDUIT, PROVIDE AN ENGRAVED PLASTIC ^{A.} NAMEPLATE, INDICATING CONDUIT NO., AND ATTACH TO CONDUIT WITH NYLON CABLE TIE.

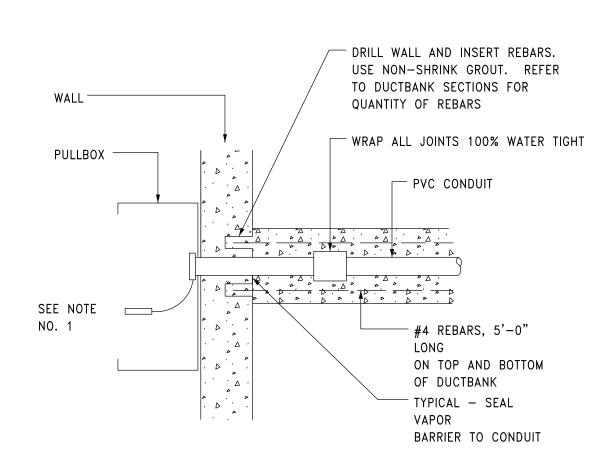


HAND HOLE DETAIL 2 SCALE: NTS

DETAIL NOTES:

A. ALLOW SUFFICIENT SLACK CABLE SO SPLICES CAN BE MADE ABOVE GRADE OUTSIDE OF HANDHOLE. LOWER SPLICE AND SLACK CABLE INTO HANDHOLE IN A NEAT ARRANGEMENT.

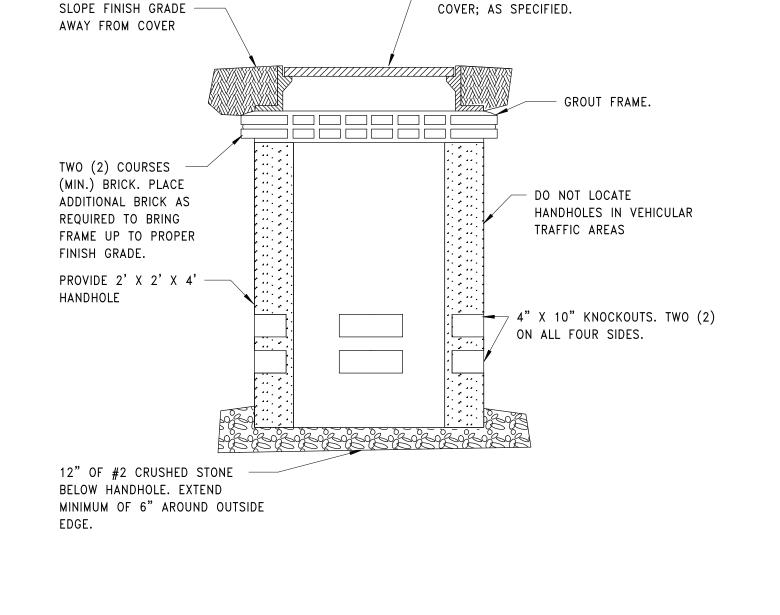


PROVIDE FRAME AND DESIGNATED

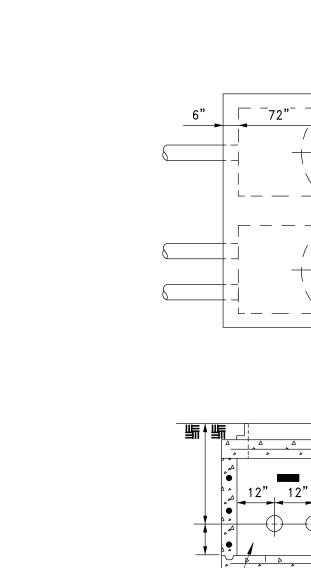

SCALE: NTS

DETAIL NOTES:

SCALE: NTS

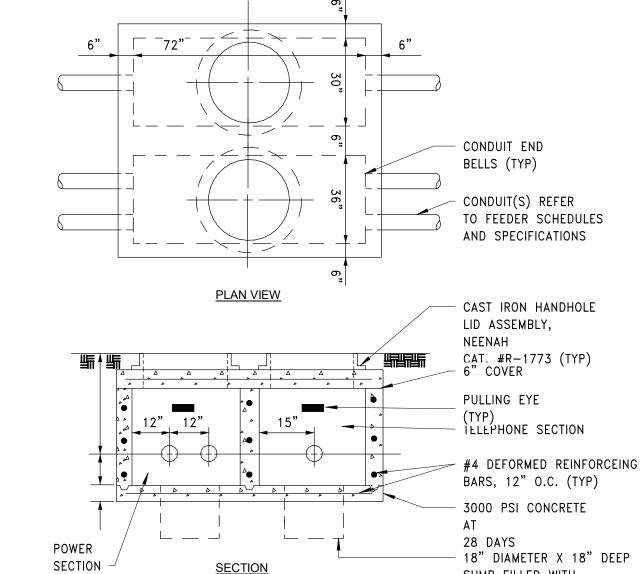

COMBINATION POWER AND DATA HH DETAIL

SUMP FILLED WITH


CRUSHED


STONE

TYPICAL DIRECT BURIED CONDUIT DETAIL - MULTIPLE SCALE: NTS

<u>NOTE</u> 1. REPLACE EXISTING SURFACE CONDITIONS IN KIND TO INCLUDE, BUT NOT LIMITED TO: CONCRETE, CRUSHED STONE, SELECT GRAVEL, ASPHALT, TOPSOIL AND GRASS. 2. 24" MIN. OR 6" BELOW BOTTOM OF FROST LINE, WHICHEVER IS

DEEPER.

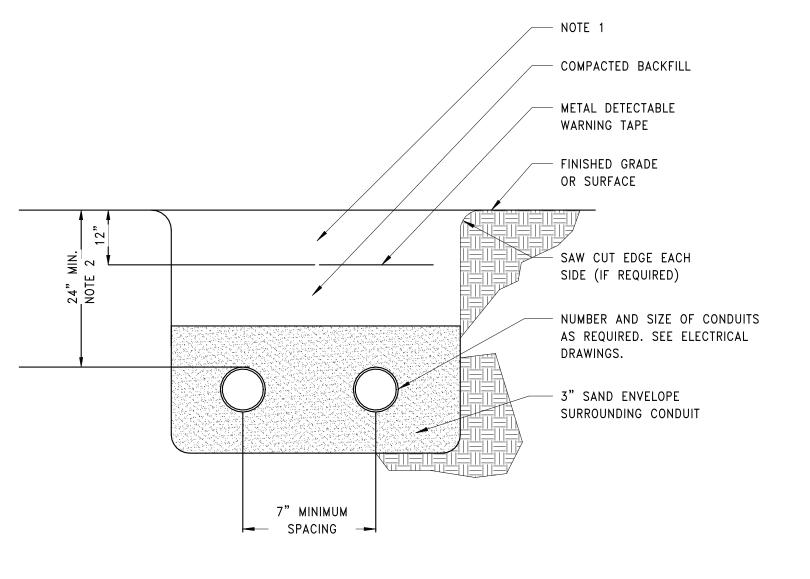


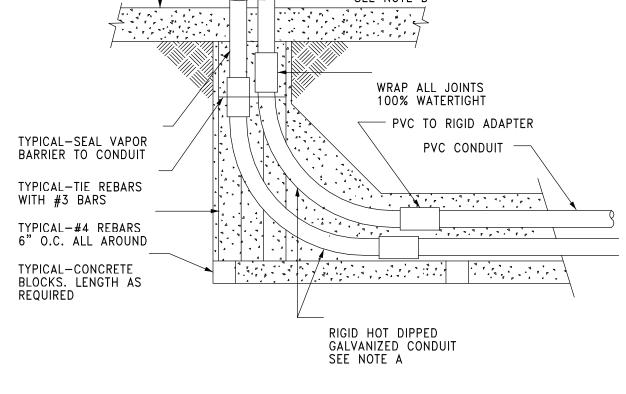

A. WHERE CONDUIT STUBS UP UNDER FLOOR MOUNTED EQUIPMENT SUCH AS SWITCHGEAR, PROVIDE PVC ELBOWS IN LIEU OF RIGID SHOWN.

B. AT EACH CONDUIT STUB-UP. AFFIX ENGRAVED PLASTIC NAMEPLATE INDICATING CONDUIT NO. OR CIRCUIT IDENTIFICATION. ATTACH WITH NYLON CABLE TIE.

CONDUIT STUB UP INSIDE BUILDING DETAIL

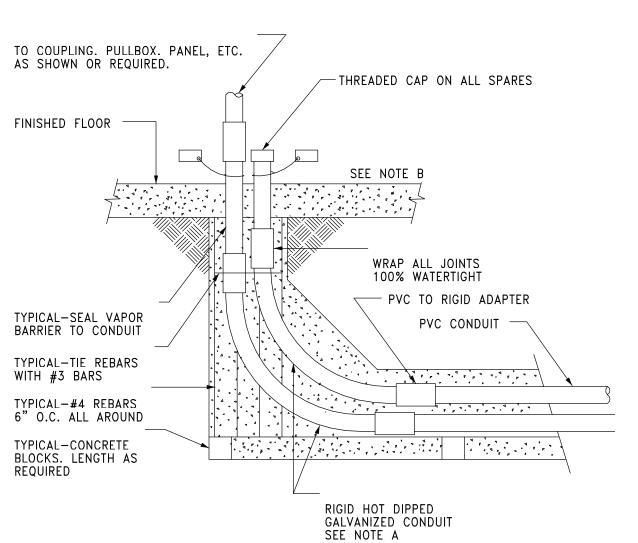

<u>NC</u>	OTICE
DRAWINGS NOT PREPARED B ARCHITECTS AND ENGINEER NOT REPRESENT THE CONDIT IIME. ALL EXISTING CONDITION AS SUGGESTIVE INFORMATIOD BUILT AND DETAILED PER THE	ASED ON CONSTRUCTION Y BBS ARCHITECTS, LANDSCAPE 18, PC. AND, THEREFORE, MAY IONS AS CONSTRUCTED AT THE ONS SHOWN ARE REPRESENTED N AS THEY MAY NOT HAVE BEEN ORIGINAL DOCUMENTS OR PER INFORMATION.

DRWG. BY: Author CHK. BY: Checker

ARCHITECTS

ENGINEERS

BRANCH PROJECT CONTACT:

187 WOLF ROAD, STE. 205

ALBANY

SED No.

DWG TITLE

SCALE:

DATE:

FILE NO.

BID P/U DATE:

NEW YORK 12205

T. 518.621.7650

THIS DRAWING, PREPARED FOR THE SPECIFIC PROJECT INDICATED IS AN INSTRUMENT OF SERVICE AND THE PROPERTY OF BBS ARCHITECTS, LANDSCAPE ARCHITECTS AND ENGINEERS, PC. INFRINGEMENT OR ANY USE OF THIS

DRAWING FOR ANY OTHER PROJECT IS PROHIBITED. ANY ALTERATION OR REPRODUCTION OF THIS DOCUMENT IS ALSO PROHIBITED WITHOUT THE WRITTEN CONSENT OF THE ARCHITECT OR ENGINEER.

LANDSCAPE ARCHITECTS

www.BBSARCHITECTURE.COM

244 EAST MAIN STREET

PATCHOGUE

NEW YORK 11772

T. 631.475.0349

F. 631.475.0361

66-01-02-06-0-007-011

ELECTRICAL SITE DETAILS

AS NOTED

22-225B

DISTRICT BEDFORD CENTRAL SCHOOL

PROJECT
PHASE 1A - BOND IMPROVEMENTS

E4.02 FLMS

REV. DATE

<u>NOTICE</u>	
GS ARE BASED ON CONSTRUCTION PARED BY BBS ARCHITECTS, LANDSCAPE INGINEERS, PC. AND, THEREFORE, MAY CONDITIONS AS CONSTRUCTED AT THE CONDITIONS SHOWN ARE REPRESENTED DRMATION AS THEY MAY NOT HAVE BEEN PER THE ORIGINAL DOCUMENTS OR PER OWNER'S INFORMATION.	

ITEM