OSSINING UNION FREE SCHOOL DISTRICT

ROOSEVELT ELEMENTARY SCHOOL TOILET ROOM RENOVATIONS & HVAC UPGRADES

SED NO. 66-14-01-03-0-005-022

OWNER

OSSINING UNION FREE SCHOOL DISTRICT 400 EXECUTIVE BOULEVARD OSSINING, NEW YORK 10562 PHONE: 914-941-7700

ARCHITECT / ENGINEER

50 FRONT STREET, SUITE 202 NEWBURGH, NEW YORK 12550 PHONE: 800-274-9000

DRAWINGS LIST

T-001 **ABATEMENT**: AA000 AA100 AA200 AA300

A901

1201

1250

INTERIORS:

ELECTRICAL

E000

E001

E100

E101

E102

E103

E200

E201

E202

E203

E300

E301

E302 E900

GENERAL:

ASBESTOS ABATEMENT NOTES FIRST FLOOR- ASBESTOS ABATEMENT PLANS

OVERALL FLOOR PLANS GROUND FLOOR- EXISTING/ DEMOLITION PLAN FIRST FLOOR- EXISTING/ DEMOLITION PLAN SECOND FLOOR- EXISTING/ DEMOLITION PLAN GROUND FLOOR- NEW WORK PLANS & ELEVATIONS FIRST FLOOR- NEW WORK PLANS & ELEVATIONS SECOND FLOOR- NEW WORK PLANS & ELEVATIONS PARTITION TYPES TYPICAL FIXTURE MOUNTING HEIGHTS REFLECTED CEILING PLANS

TOILET ROOM FINISH PLANS FINISH SCHEDULE & TYPICAL PATTERN DETAILS

H000 H100 H104 H200 H202 H203 H204 DETAIL SCHEDULE

> **ELECTRICAL LEGEND AND NOTES** OVERALL ELECTRICAL PLANS

GROUND FLOOR-POWER & SYSTEMS PLAN FIRST FLOOR- POWER & SYSTEMS PLAN SECOND FLOOR- POWER & SYSTEMS PLAN GYMNASIUM- POWER & SYSTEMS PLAN GROUND FLOOR- LIGHTING PLAN FIRST FLOOR-LIGHTING PLAN

PLUMBING DEMOLITION PLANS GROUND FLOOR- SANITARY AND VENT PIPING FIRST & SECOND FLOOR- SANITARY AND VENT PIPING FIRST & SECOND FLOOR- DOMESTIC WATER PIPING PLUMBING RISER DIAGRAMS PLUMBING SCHEDULES & DETAILS

DISTRICT

PROJECT INFORMATION

Newburgh, NY 12550

2021-2022 CIF

14428.18

400 EXECUTIVE BLVD OSSINING, NY 10562


ROOSEVELT ES SED# 66-14-01-03-0-005-022

PROJECT ISSUE & REVISION SCHEDULE

AS INDICATED

Issued 11/15/2021 Project Status BID SET

Drawn By ΑW Drawing Title TITLE SHEET

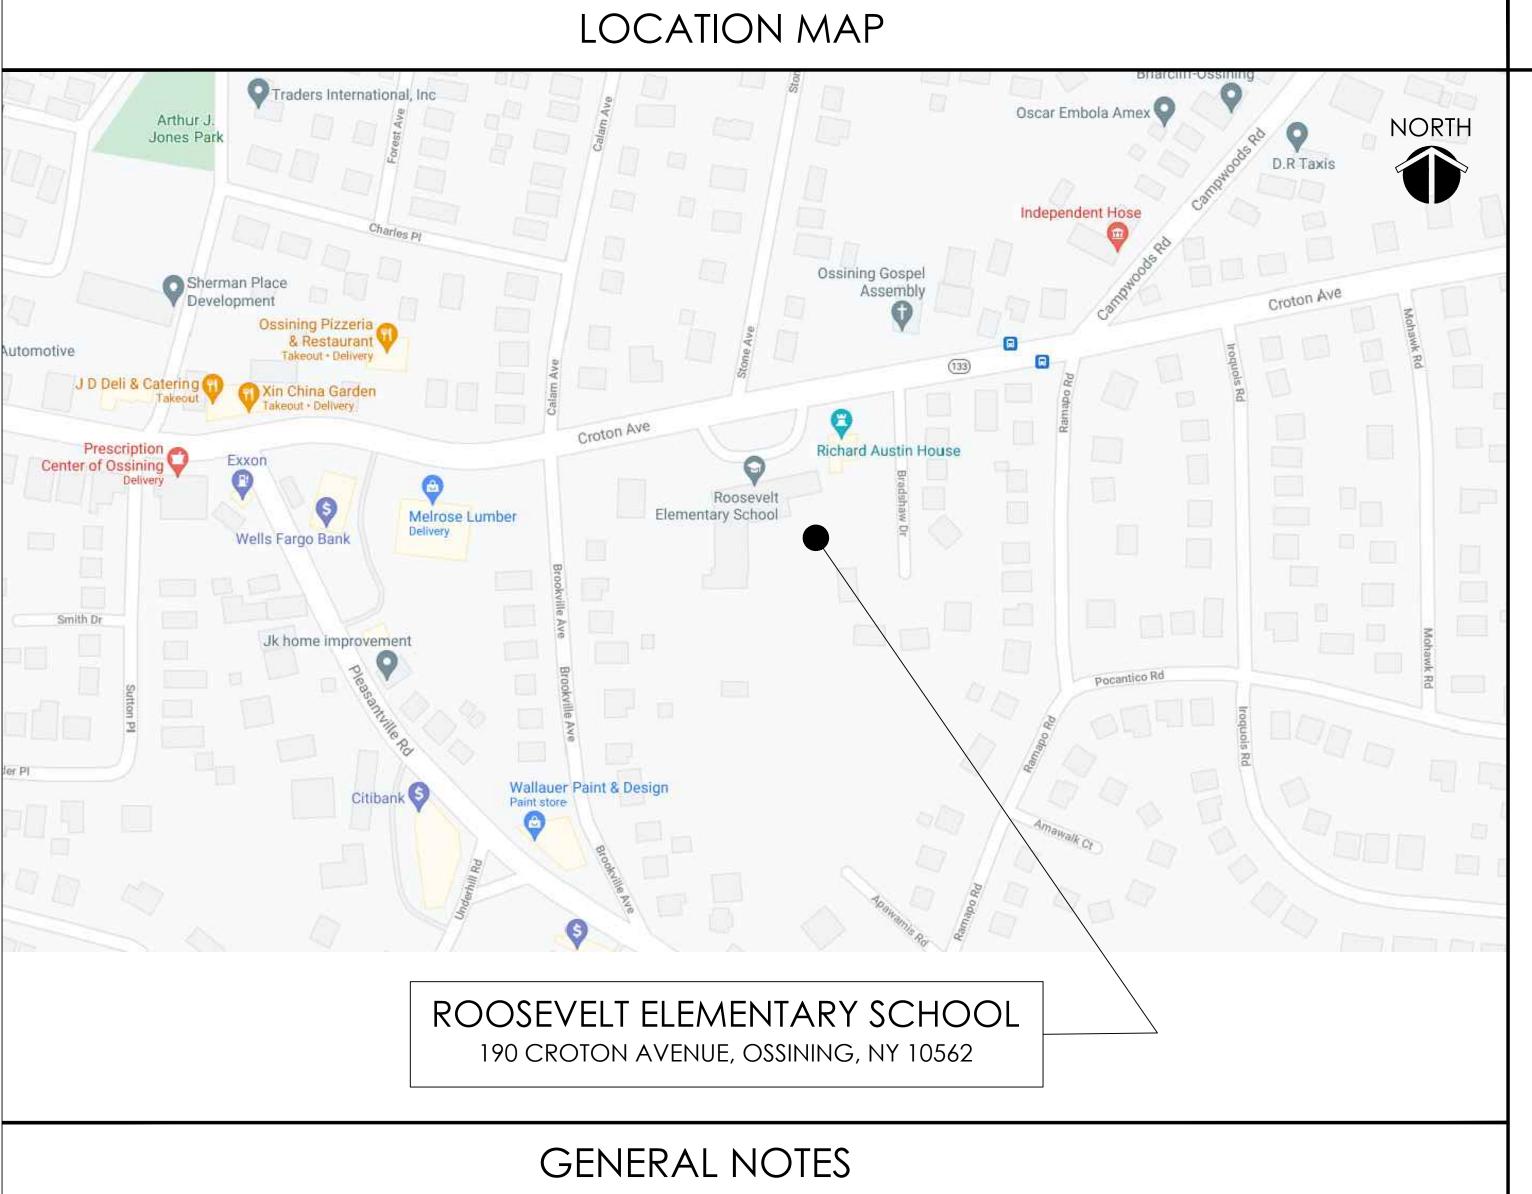

THE DESIGN OF THIS PROJECT CONFORMS TO ALL APPLICABLE PROVISIONS OF NEW YORK STATE UNIFORM FIRE PREVENTION AND BUILDING CODE, THE NEW YORK STATE ENERGY CONSERVATION CODE, AND THE BUILDING STANDARDS OF THE NEW YORK STATE EDUCATION DEPARTMENT.

A202 A203 A401 A601

TITLE SHEET

DOOR SCHEDULE, DOOR TYPES & DOOR FRAME TYPES

HVAC SYMBOLS LIST BASEMENT- HVAC DEMOLITION PLAN GROUND FLOOR- HVAC DEMOLITION PLAN FIRST FLOOR- HVAC DEMOLITION PLAN SECOND FLOOR- HVAC DEMOLITION PLAN ROOF PLAN- HVAC DEMOLITION PLAN BASEMENT LEVEL- HVAC DEMOLITION PLAN GROUND FLOOR- HVAC NEW PLAN FIRST FLOOR- HVAC NEW PLAN SECOND FLOOR- HVAC NEW PLAN ROOF PLAN- HVAC NEW PLAN MECHANICAL CONTROLS AND SCHEMATICS DETAIL PLAN DETAIL PLAN

GROUND FLOOR- ELECTRICAL DEMOLITION PLAN FIRST FLOOR- ELECTRICAL DEMOLITION PLAN SECOND FLOOR- ELECTRICAL DEMOLITION PLAN GYMNASIUM- ELECTRICAL DEMOLITION PLAN SECOND FLOOR- LIGHTING PLAN **ELECTRICAL SCHEDULES**

PRE-ABATEMENT WORK NOTES:


- 1. THESE DRAWINGS HAVE BEEN PREPARED BY UTILIZING THE OWNERS ORIGINAL CONSTRUCTION DOCUMENTS IN ORDER TO ILLUSTRATE THE EXISTING CONDITIONS OF THE SITE AND STRUCTURES THEREIN. THE CONTRACTOR SHALL BEE RESPONSIBLE FOR ACTUAL VERIFICATION OF ALL EXISTING CONDITIONS IN THE FIELD.
- 2. THE ASBESTOS CONTAINING MATERIALS, CONFIGURATIONS AND LOCATIONS SHOWN IN THESE DRAWINGS ARE BASED ON THE ASBESTOS CONTAINING MATERIALS TESTING REPORT. REFER TO THE ASBESTOS CONTAINING MATERIALS REPORT FOR FURTHER INFORMATION.
- 3. THE CONTRACTOR SHALL DETERMINE EXACT FINAL LOCATIONS OF PERSONAL AND WASTE DECONTAMINATION ENCLOSURES, PICK UP AREA FOR REFUSE AND ASBESTOS DEBRIS, THESE LOCATIONS SHALL BE REVIEWED AND PROPERLY APPROVED BY THE DISTRICT PRIOR TO COMMENCEMENT OF WORK. THIS CONTRACTOR SHALL ESTABLISH, LABEL AND MAINTAIN PROPER EXITS AND WAYS OF DEPARTURE WITHIN EACH WORK AREA FOR NORMAL AND EMERGENCY USE BY WORKERS DURING ALL ABATEMENT.
- 4. THE CONTRACTOR, PRIOR TO BIDDING, SHALL BE RESPONSIBLE TO BECOME COMPLETELY FAMILIAR WITH ALL ASPECTS OF THE PROJECT, INCLUDING, BUT NOT LIMITED TO, ALL DEMOLITION AND CONSTRUCTION WORK AS SHOWN IN THE COMPLETE SET OF DRAWINGS AND IN THE PROJECT MANUAL/SPECIFICATIONS, IN ORDER THAT THE FULL SCOPE OF WORK WHICH MAY ENCOUNTER ASBESTOS CONTAINING MATERIALS IS UNDERSTOOD AND ACCOUNTED FOR BY THE CONTRACTOR IN HIS PROJECT WHETHER OR NOT SHOWN IN THESE DOCUMENTS.

ASBESTOS REMOVAL GENERAL NOTES:

- ASBESTOS ABATEMENT INDICATED ON THIS DRAWING SHALL BE PERFORMED BY A NYS DEPARTMENT OF LABOR LICENSED ASBESTOS CONTRACTOR, SHALL VERIFY ALL EXISTING CONDITIONS, DIMENSIONS AND QUANTITIES PRIOR TO BID
- 2. THE CONTRACTOR SHALL PERFORM ALL CONTRACT WORK IN ACCORDANCE WITH CONTRACT SPECIFICATIONS, NEW YORK STATE DEPARTMENT OF LABOR (NYSDOL) INDUSTRIAL CODE RULE 56, OSHA, NESHAPS, AHEA, NYSDEC AND ALL OTHER APPLICABLE CODES.
- 3. THE CONTRACTOR SHALL MAINTAIN THE SITE AS NEAT AS POSSIBLE AND ORDERLY DURING THE WORK. ALL LOOSE DEBRIS WHICH MAY BLOW OFF THE SITE SHALL BE COLLECTED AND DISPOSED OF PROPERLY BY THE CONTRACTOR ON A DAILY BASIS AS PART OF THE PROJECT.
- 4. THE CONTRACTOR SHALL PROVIDE BARRIERS AROUND THE WORK AREAS IN ORDER TO ENSURE SAFE PASSAGE BY ANY PERSON. THESE BARRIERS SHALL ALSO SERVE TO KEEP ALL UNAUTHORIZED PERSONS OUT THE PROJECT AREA FOR THE DURATION OF THE WORK.
- 5. VARIANCES: CONTRACTOR SHALL PAY FOR AND OBTAIN ANY NECESSARY SITE SPECIFIC VARIANCES.
- 6. THE CONTRACTOR SHALL MAINTAIN SECURITY IN THE BUILDING AND THE WORK AREAS AT ALL TIMES.
- 7. PROJECT STAGING, STORAGE, SCHEDULING AND ACCESS SHALL BE COORDINATED WITH AND APPROVED BY THE ARCHITECT AND OWNER PRIOR TO PROCEEDING WITH WORK.
- 8. SHOULD IT BE NECESSARY, CONTRACTOR SHALL COORDINATE SHUT DOWN AND LOCK OUT OF THE ELECTRICAL POWER WITH OWNER'S POWER WITH OWNER'S REPRESENTATIVE PRIOR TO THE COMMENCEMENT OF WORK.
- 9. ALL TEMPORARY POWER TO THE WORK AREA SHALL BE BROUGHT IN FROM OUTSIDE THE WORK AREA THROUGH A GROUND—FAULT CIRCUIT INTERRUPTER AT THE SOURCE.
- 10.CONTRACTOR SHALL COORDINATE HOOKUP OF WATER SERVICE FOR DECONTAMINATION PURPOSED WITH OWNERS REPRESENTATIVE. WATER FOR THE DECONTAMINATION UNITS IS AVAILABLE FROM THE OWNER.
- 11.THE OWNER OR OWNER'S REPRESENTATIVE IS RESPONSIBLE TO CONTRACT FOR NYSDOL PROJECTS MONITORING/AIR SAMPLING TECHNICIAN SERVICES AS REQUIRED.
- 12.CONTRACTOR TO PROVED A COPY OF MSD'S FOR ANY CHEMICAL AGENTS TO BE USED DURING THE ASBESTOS ABATEMENT TO THE PROJECT MONITOR AD THE OWNER'S REPRESENTATIVE.
- 13.CONTRACTOR SHALL REQUEST AND RECEIVE PROJECT MONITOR AND OWNER'S REPRESENTATIVE APPROVAL OF ALL WORK BEFORE ANY ABATEMENT IS UNDERTAKEN.
- 14.UNDER NO CIRCUMSTANCES SHALL CONTAMINATED WASTE WATER BE FILTERED THOUGH A SYSTEM WITH AT LEAST A 5.0 MICRON PARTICLE SIZE COLLECTION CAPABILITY.
- 15.DRAWINGS ATTEMPT TO INDICATE THE GENERAL SCOPE OF EXISTING CONDITIONS AND ITEMS EFFECTED BY THE ABATEMENT WORK. CONTRACTOR SHALL EXAMINE THE WORK AREA PRIOR TO BID AND SHALL INCLUDE FIELD VARIATIONS FROM THOSE SHOWN WITH IN THE GENERAL INTENT OF THE WORK
- 16.THE CONTRACTOR SHALL REMOVE AND DISPOSE OF ALL ASBESTOS CONTAINING MATERIALS CONTAINED WITHIN THE PROJECT AND ASSOCIATED WITH ALL PROJECT WORK, IN COMPLIANCE WITH ALL APPLICABLE LAWS, RULES, REGULATIONS AND ALL REQUIREMENTS OF ALL AUTHORITIES HAVING JURISDICTION.
- 17.THE CONTRACTOR SHALL REMOVE AND DISPOSE OF ALL ASBESTOS CONTAINING MATERIALS CONTAINED WITHIN THE PROJECT AND ASSOCIATED WITH ALL PROJECT WORK, IN THE MOST EFFICIENT AND COST EFFECTIVE METHOD POSSIBLE, WHICH ALSO COMPLIES WITH THE REQUIREMENTS LISTED ABOVE.

POST-ABATEMENT WORK NOTES:

- PROVIDE ALL APPLICABLE CODE RULE 56 PROCEDURES, CLEAN UP, AND ADDITIONAL TESTING AS REQUIRED.
- 2. PRIOR TO ABATEMENT, ALL CONTRACTORS WILL SURVEY EXISTING CONDITIONS IN THE ABATEMENT AND GENERAL WORK AREAS. ITEMS/MATERIALS/ETC. DAMAGED, OR NON-FUNCTIONAL SHALL BE LISTED, NOTED, PHOTOGRAPHED AND REVIEWED WITH THE PROJECT INSPECTOR. ALL OTHER ITEMS/MATERIALS SHALL BE REVIEWED WITH THE PROJECT INSPECTOR. ALL OTHER ITEMS/MATERIALS SHALL BE ASSUMED TO BE IN GOD CONDITION AND GOOD WORKING ORDER. IT SHALL BE THE RESPONSIBILITY OF THE ABETMENT CONTRACTOR TO MAINTAIN ALL MATERIALS, ITEMS, EQUIPMENT, SYSTEMS, ETC. IN ITS ORIGINAL CONDITION AND RETURN TO OWNER/GC, ETC. IN SAME CONDITION AT THE END OF THIS CONTRACT.
- 3. REMOVE ALL TEMPORARY ENCLOSURES, BARRIERS, ETC. REINSTALL ITEMS/WORK PREVIOUSLY REMOVE, ALL TAPE AND ADHESIVE RESIDUALS TO BE REMOVED. TEST AND REPAIR.
- 4. THE CONTRACTOR SHALL TAKE ALL NECESSARY PRECAUTIONS TO INSURE AGAINST DAMAGE TO THE EXISTING WORK TO REMAIN IN PLACE. ANY DAMAGE TO SUCH WORK SHALL BE REPAIRED OR REPLACED TO THE SATISFACTION OF THE ARCHITECT AND OWNER AT NO ADDITIONAL COST TO THE CONTRACT.
- 5. AT COMPLETION OF THE ABATEMENT WORK, A CONDITION SURVEY SHALL BE DON BY ALL CONTRACTORS AND PROJECT INSPECTOR (SEE NOTE #2). ANY VARIATION (I.E. DAMAGE BY THE CONTRACTOR), AND OTHERWISE NOT INCLUDED AS PART OF THE RECONSTRUCTION WORK, SHALL BE REPAIRED/RESTORED BY THE ABATEMENT CONTRACTOR.
- 6. THE CONTRACTOR SHALL, UPON COMPLETION OF THE REMOVAL, PROVIDE WRITTEN DOCUMENTATION (INCLUDING ALL APPROPRIATE THIRD PARTY TESTING RESULTS) THAT THE PROJECT WORK AREAS ARE COMPLETELY FREE OF ALL ASBESTOS CONTAINING MATERIALS.
- 7. THE CONTRACTOR SHALL PROVIDE RECORDS OF ALL ASBESTOS CONTAINING MATERIALS REMOVED FROM THE SITE, INCLUDING THE COMPOSITION AND VOLUMES OF DISPOSED MATERIALS AND THE FINAL DISPOSAL SITE(S).

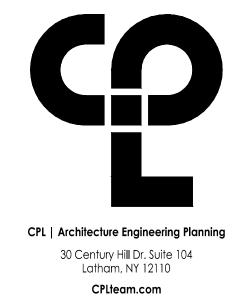



PROJECT INFORMATION

Project Number

14428.20 Client Name

OSSINING UNION FREE SCHOOL DISTRICT


2022-2023 CIP

Project Address
400 EXECUTIVE BLVD OSSINING, NY 10562

OSSINING ROOSEVELT ELE

ROOSEVELT ELEMENTARY SCHOOL

PROJECT ISSUE & REVISION SCHEDULE

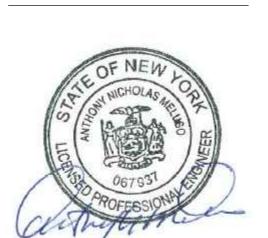

NEW YORK STATE EDUCATION STATEMENT
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ENGINEER OR SURVEYOR IS ALTERED, THE ALTERING PARTY SHALL AFFIX TO THE
ITEM THEIR SEAL AND THE NOTATION "ALTERED BY" FOLLOWED BY THEIR
SIGNATURE AND THE DATE OF SUCH ALTERATION, AND A SPECIFIC
DESCRIPTION OF THE ALTERATION.

SHEET INFORMATION

Issued Scale
10-31-22 N.T.S.
Project Status
BID SET

Drawn By

Checked By

JP


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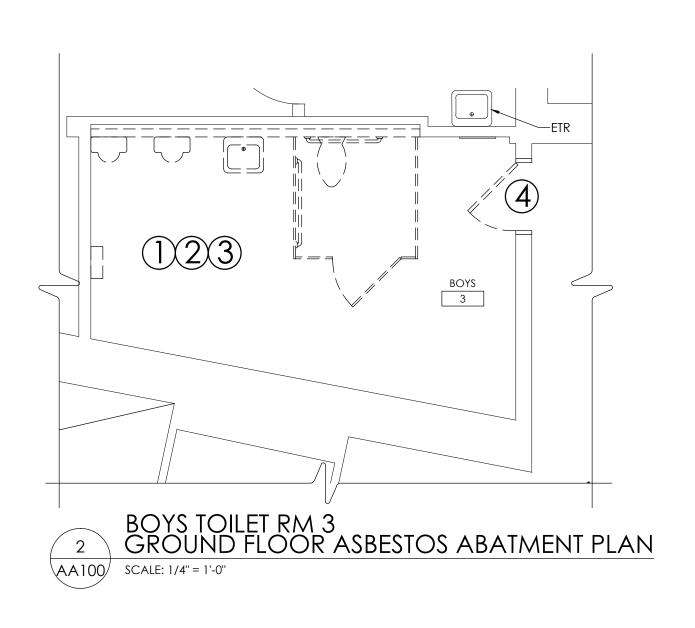
Drawing Title

Drawing Number

ASBESTOS ABATEMENT NOTES

RES AA000



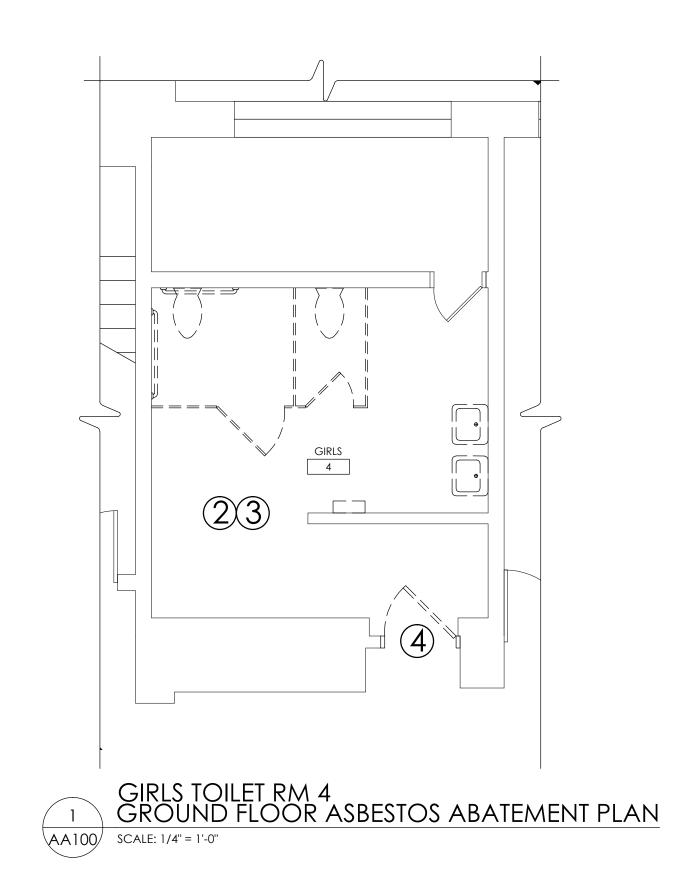

ACM LEGEND:

- REMOVE AND DISPOSE OF ASBESTOS CONTAINING PIPE INSULATION AND MUDDED JOINT PACKING (EXPOSED).
- REMOVE AND DISPOSE OF ASBESTOS CONTAINING PIPE INSULATION AND MUDDED JOINT PACKING (CONCEALED).
- REMOVE AND DISPOSE OF PRESUMED ASBESTOS CONTAINING MIRROR GLUE DABS.
- REMOVE AND DISPOSE OF PRESUMED ASBESTOS CONTAINING BATHROOM DOOR INSULATION.
- FEMOVE AND DISPOSE OF PRESUMED ASBESTOS CONTAINING UNIT VENT INSULATING MATERIALS.





PROJECT INFORMATION

Project Number 14428.20

OSSINING UNION FREE SCHOOL
DISTRICT

Project Name


2022-2023 CIP

Project Address
400 EXECUTIVE BLVD OSSINING, NY 10562

PROJECT ISSUE & REVISION SCHEDULE

No. Date Description



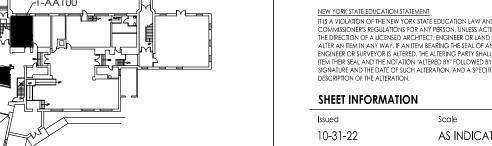

Roosevelt Ed Ctr GROUND FLOOR


KEY PLAN


10-31-22 AS INDICATED
Project Status
BID SET
Drawn By Checked By
JP RL
Drawing Title
GROUND FLOOR ASBESTOS

Prawing Number

ABATEMENT PLAN

RES A 100

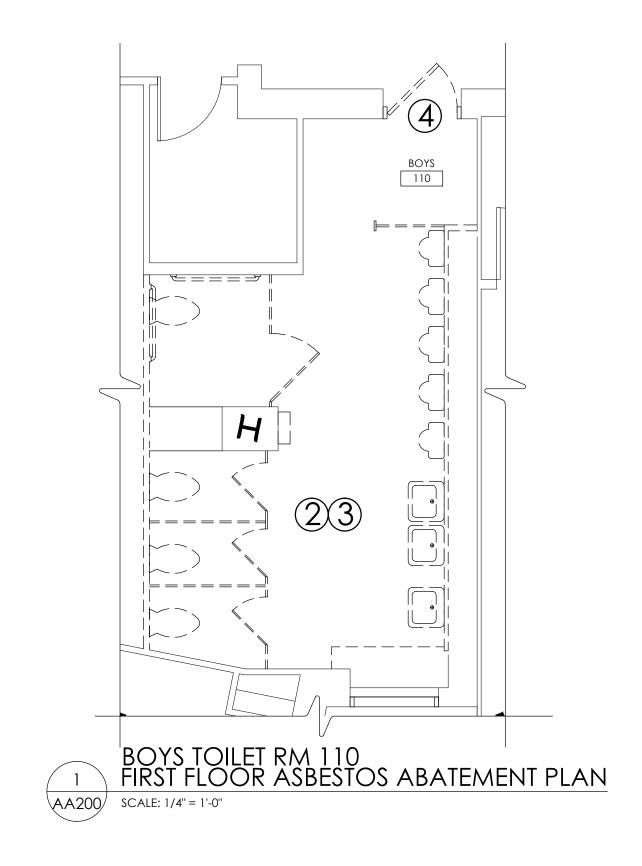

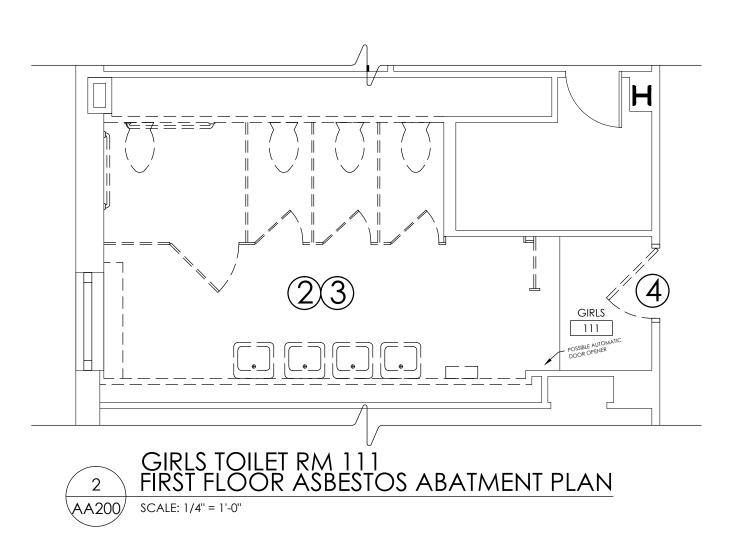

ACM LEGEND:

- REMOVE AND DISPOSE OF ASBESTOS CONTAINING PIPE INSULATION AND MUDDED JOINT PACKING (EXPOSED).
- REMOVE AND DISPOSE OF ASBESTOS CONTAINING PIPE INSULATION AND MUDDED JOINT PACKING (CONCEALED).
- REMOVE AND DISPOSE OF PRESUMED ASBESTOS CONTAINING MIRROR GLUE DABS.
- REMOVE AND DISPOSE OF PRESUMED ASBESTOS CONTAINING BATHROOM DOOR INSULATION.
- FEMOVE AND DISPOSE OF PRESUMED ASBESTOS CONTAINING UNIT VENT INSULATING MATERIALS.





PROJECT INFORMATION

Project Number 14428.20

OSSINING UNION FREE SCHOOL

DISTRICT
Project Name
2022-2023 CIP

Project Address
400 EXECUTIVE BLVD OSSINING, NY 10562

OSSINING





Issued Scale
10-31-22 AS INDICATED
Project Status
BID SET


Drawn By Checked By
JP RL

Drawing Title

FIRST FLOOR ASBESTOS


ABATEMENT PLAN

RES AA200

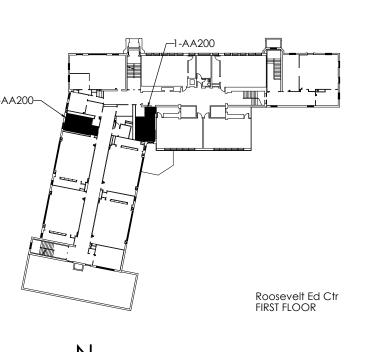

KEY PLAN



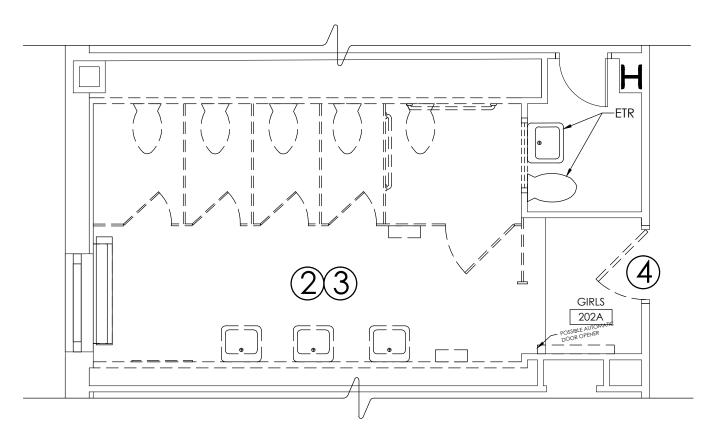

GIRLS TOILET RM
2 SECOND FLOOR ASBESTOS ABATEMENT PLAN AA300 SCALE: 1/4" = 1'-0"

ACM LEGEND:

- REMOVE AND DISPOSE OF ASBESTOS CONTAINING PIPE INSULATION AND MUDDED JOINT PACKING (EXPOSED).
- REMOVE AND DISPOSE OF ASBESTOS CONTAINING PIPE INSULATION AND MUDDED JOINT PACKING (CONCEALED).
- REMOVE AND DISPOSE OF PRESUMED ASBESTOS CONTAINING MIRROR GLUE DABS.
- REMOVE AND DISPOSE OF PRESUMED ASBESTOS CONTAINING BATHROOM DOOR INSULATION.
- FEMOVE AND DISPOSE OF PRESUMED ASBESTOS CONTAINING UNIT VENT INSULATING MATERIALS.





PROJECT INFORMATION Project Number

14428.20

OSSINING UNION FREE SCHOOL **DISTRICT**

2022-2023 CIP


Project Address 400 EXECUTIVE BLVD OSSINING, NY 10562

OSSINING

PROJECT ISSUE & REVISION SCHEDULE

No. Date Description




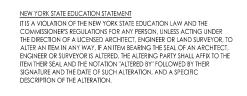


SHEET INFORMATION Issued 10-31-22 AS INDICATED Project Status BID SET Drawn By Checked By

SECOND FLOOR ASBESTOS ABATEMENT PLAN

Drawing Title

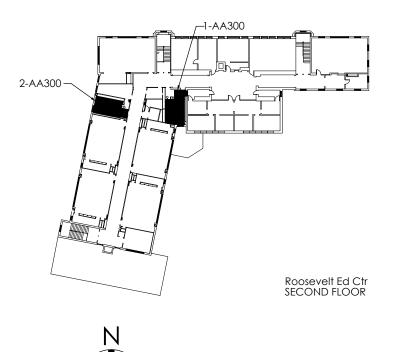

KEY PLAN

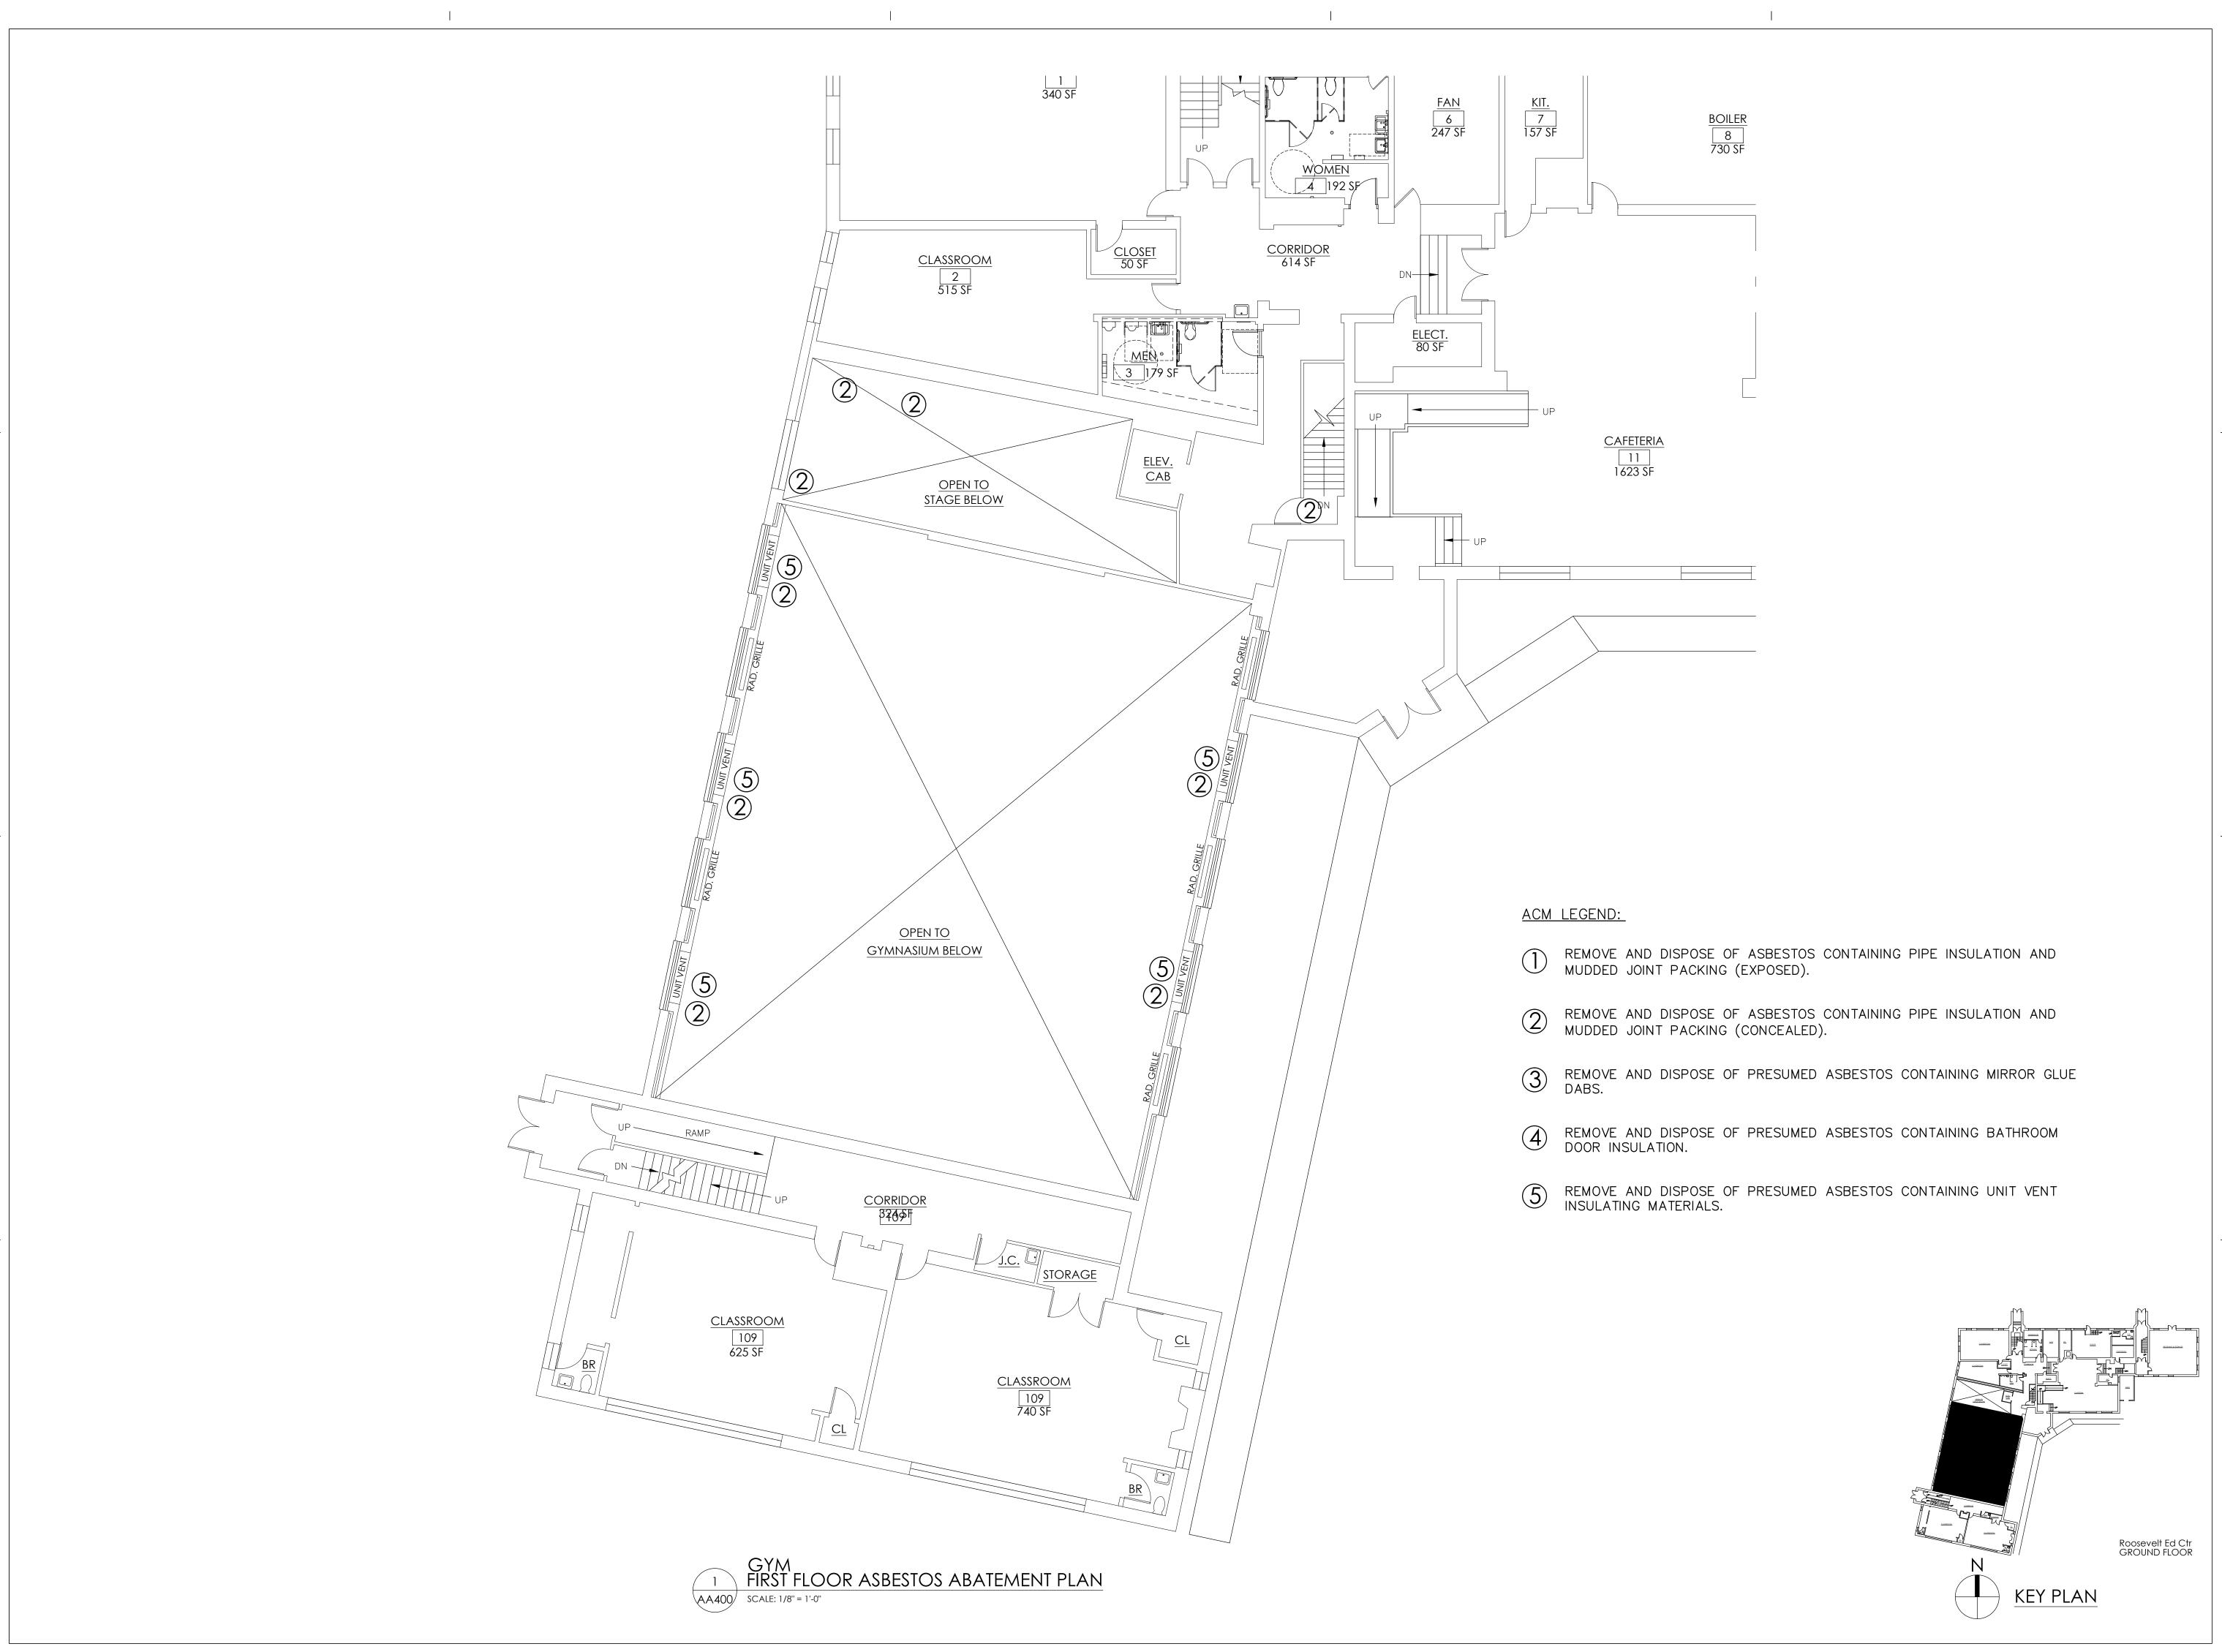





PROJECT INFORMATION

Project Number

OSSINING UNION FREE SCHOOL DISTRICT

Project Name

2022-2023 CIP

Project Address
400 EXECUTIVE BLVD OSSINING, NY 10562

PROJECT ISSUE & REVISION SCHEDULE

No. Date Description



NEW YORK STATE EDUCATION STATEMENT
IT IS A VIOLATION OF THE NEW YORK STATE EDUCATION LAW AND THE
COMMISSIONER'S REGULATIONS FOR ANY PERSON, UNLESS ACTING UNDER
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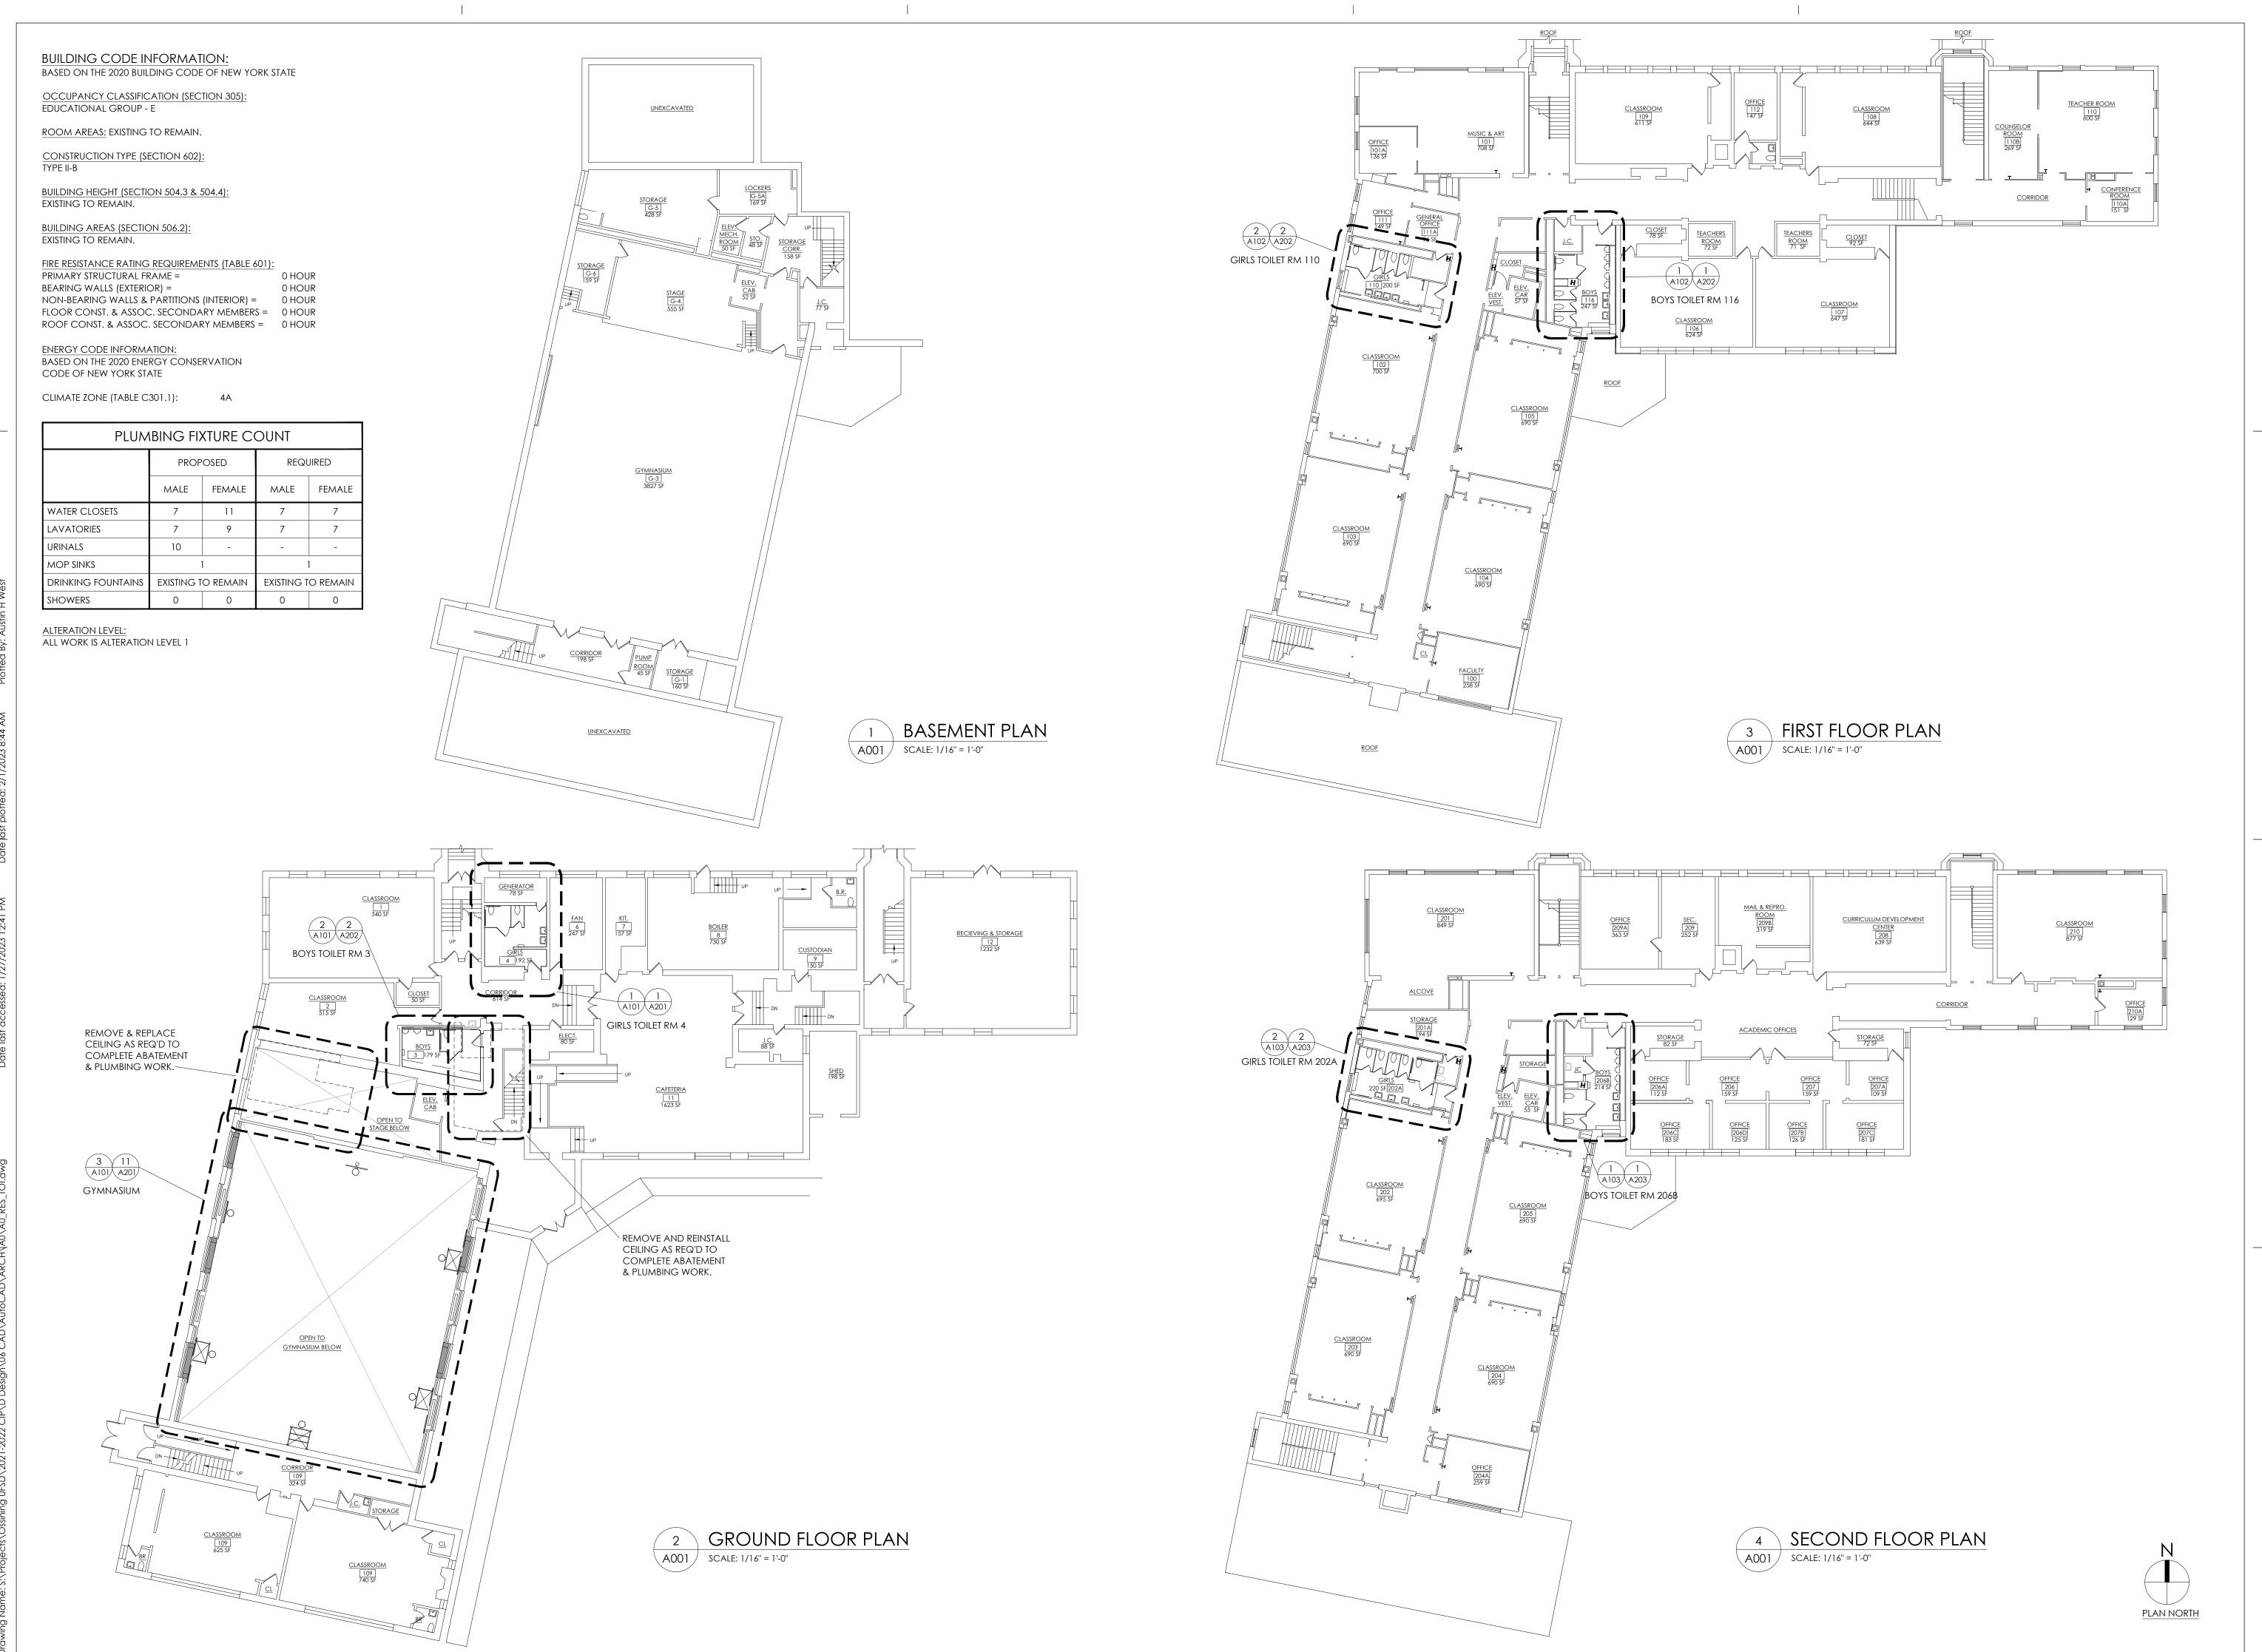
DESCRIPTION OF THE ALTERATION.

SHEET INFORMATION

Issued Scale
10-31-22 AS INDICATED
Project Status
BID SET
Drawn By Checked By
JP RL

GYM AREA ASBESTOS ABATEMENT PLAN

> RES AA400





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PROJECT INFORMATION

14428.18

Project Number

OSSINING UNION FREE SCHOOL **DISTRICT**

2021-2022 CIP

District Office Address

400 EXECUTIVE BLVD OSSINING, NY 10562

Multiple Building Names

ANNE M. DORNER MS SED# 66-14-01-03-0-008-028 ROOSEVELT ES SED# 66-14-01-03-0-005-022 OSSINING HS SED# 66-14-01-03-0-003-043

PROJECT ISSUE & REVISION SCHEDULE

No. Date Description

SHEET INFORMATION Issued


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AS INDICATED 11/15/2021 Project Status

BID SET Drawn By

Drawing Title OVERALL FLOOR PLANS

Drawing Number

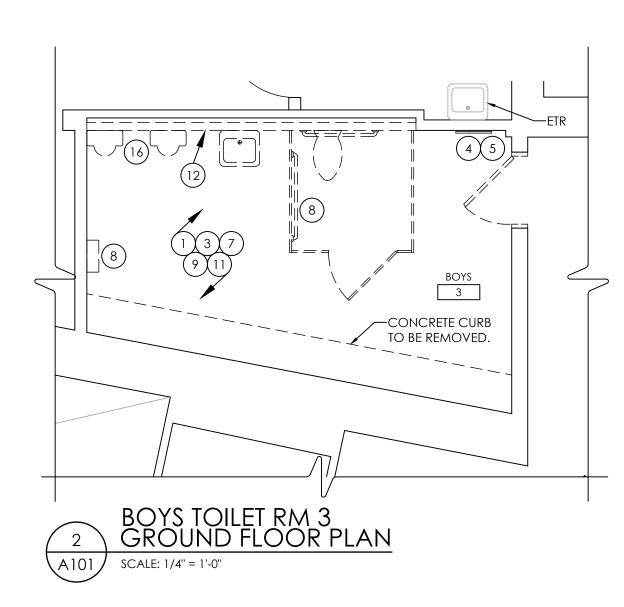


DEMOLITION KEYNOTES:

- REMOVE EXISTING FLOOR TILE, BASE TILE & ADHESIVE COMPLETE TO STRUCTURAL FLOOR SLAB AS REQ'D FOR INSTALLATION OF NEW WORK.
- GC SHALL TRENCH & /BACKFILL/ REINSTALL PORTIONS OF EXISTING CONCRETE FLOOR SLAB AS REQ'D FOR INSTALLATION OF NEW WORK. COORDINATE WITH PC.
- (3) REMOVE MUDSET DOWN TO STRUCTURAL FLOOR SLAB.
- REMOVE EXISTING DOOR, DOOR HARDWARE & FRAME COMPLETE AS REQ'D FOR INSTALLATION OF NEW WORK.
- (5) REMOVE EXISTING DOOR FRAME AS REQ'D FOR INSTALLATION OF NEW WORK.
- MC SHALL REMOVE EXISTING PANEL RADIATOR AS REQ'D FOR INSTALLATION OF NEW WORK. SEE HVAC DRAWINGS FOR ADDITIONAL INFORMATION. HC & GC SHALL COORDINATE WORK.
- 7) REMOVE EXISTING TOILET PARTITION SYSTEM COMPLETELY AS REQ'D FOR NEW WORK.
- 8 REMOVE ALL DISPENSERS, ALL DISPOSALS, GRAB BARS, MIRRORS & COAT HOOKS
- COMPLETE AS REQ'D FOR NEW WORK.
- 9 PC SHALL REMOVE & DISCONNECT EXISTING PLUMBING FIXTURE(S) & RELATED PIPING AS REQ'D FOR NEW WORK.
- REMOVE EXISTING CEILING & SUPPORT SYSTEM IN ITS ENTIRETY FOR INSTALLATION OF NEW WORK. SEE REFLECTED CEILING PLANS FOR ADDITIONAL INFORMATION.

 11 MC & EC SHALL REMOVE EXISTING LIGHT FIXTURES, DIFFUSERS, GRILLES, SPEAKERS, ACCESS PLANTICS & LINKAGE FOR INSTALLATION OF NEW WORK SEE
- PANELS & HVAC EQUIPMENT AS REQ'D FOR INSTALLATION OF NEW WORK. SEE MECHANICAL & ELECTRICAL DRAWINGS.
- REMOVE EXISTING WALL CONSTRUCTION & PATCH/REPAIR FLOOR, WALL & CEILING AS NEEDED TO ACCOMMODATE NEW WORK.
- (13) SCRAPE/ SAND EXISTING DOOR 7 FRAME TO PREP TO BE REFINISHED.
- CAREFULLY REMOVE AND PROTECT WALL PADDING AS NEEDED TO ACCOMMODATE NEW WORK. REINSTALL AFTER COMPLETION OF NEW WORK. COORDINATE WORK WITH ALL APPLICABLE TRADES
- DEMO EXISTING WALL CONSTRUCTION AS REQ'D TO REMOVE UNIT VENT FOR NEW WORK.
 ALL BASKETBALL BACKBOARDS AND SUPPORTING HARDWARE ON THE WALLS WITH
 WINDOWS SHOULD BE REMOVED AND WALLS PATCHED AND PAINT ENTIRE WALL WHERE
 BACKBOARDS WERE REMOVED. FOUR IN TOTAL. THE OWNER WILL ARRANGE FOR
 REPLACEMENT OF THOSE BACKBOARD/ HOOP SYSTEMS THAT ARE REMOVED.
- (16) FILL EXISTING HOLES FROM FLOOR MOUNTED URINALS ,AS REG'D, WITH CONCRETE AND LAY (2) #3 REBAR, EQUALLY SPACED, ACROSS TOP OF HOLES AND EXTEND REBAR PAST END HOLES BY 6" MIN.



- 1. REFER TO MECHANICAL, ELECTRICAL, PLUMBING & ASBESTOS DRAWINGS FOR ADDITIONAL INFORMATION. COORDINATE REMOVALS WITH ALL OTHER CONTRACTS.
- 2. MAINTAIN INTEGRITY OF ITEMS THAT ARE TO REMAIN. PATCH ALL REMAINING SURFACES DISTURBED BY DEMOLITION AND/OR NEW CONSTRUCTION TO MATCH EXISTING ADJACENT
- 3. COORDINATE EXTENT OF SELECTIVE DEMOLITION WITH NEW WORK.
- 4. PROVIDE TEMPORARY SHORING & BRACING AS REQ'D PRIOR TO COMMENCING DEMOLITION. DO NOT DAMAGE OR DISTURB EXISTING STRUCTURAL ELEMENTS THAT ARE TO REMAIN. WHERE WALLS ARE TO BE REMOVED, DO NOT REMOVE EXISTING COLUMNS, UNLESS NOTED OTHERWISE.
- 5. REMOVE ALL CASEWORK, BOARDS, ACCESSORIES, PROJECTION SCREENS & ITEMS BUILT IN OR LOCATED ON WALLS SHOWN TO BE DEMOLISHED OR AS REQ'D BY NEW CONSTRUCTION.
- 6. PRIOR TO START OF PROJECT, OWNER SHALL REMOVE LOOSE EQUIPMENT SUCH AS FURNITURE, DESKS, CHAIRS, SHELVING, WINDOW AIR CONDITIONERS, ETC., U.N.O. FURNITURE & EQUIPMENT REMAINING SHALL BE COVERED & PROTECTED.
- 7. DEMOLITION TO INCLUDE COMPLETE REMOVAL OF ALL FASTENERS, ADHESIVES & RELATED ITEMS COMPLETELY DOWN TO SUBSTRATE. PATCH SUBSTRATE AS REQ'D FOR NEW FINISHES. PATCH ALL REMAINING SURFACES DISTURBED BY DEMOLITION AND/OR NEW CONSTRUCTION TO BLEND WITH & MATCH EXISTING ADJACENT SURFACES, OR PROVIDE NEW CONSTRUCTION AS SHOWN.

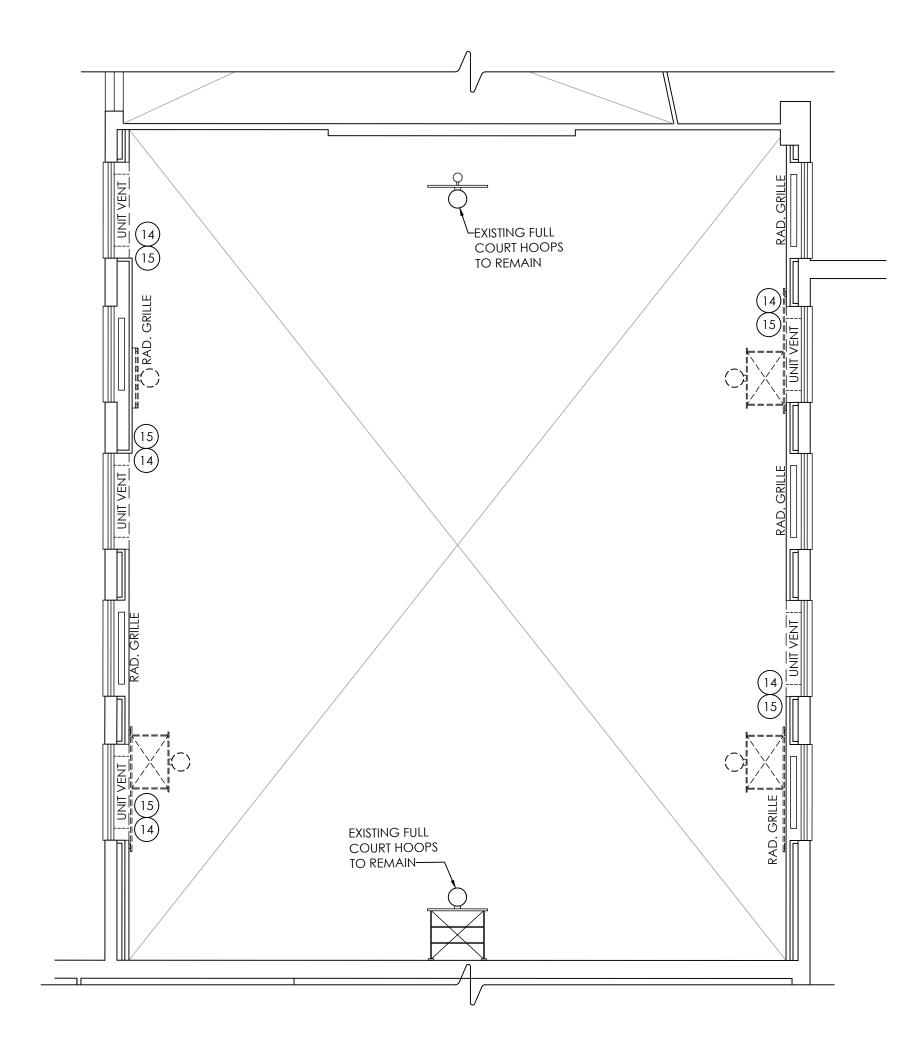





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PROJECT INFORMATION

Project Number 14428.18

OSSINING UNION FREE SCHOOL

DISTRICT
Project Name
2021-2022 CIP

District Office Address

400 EXECUTIVE BLVD OSSINING, NY 10562

Multiple Building Names

ANNE M. DORNER MS SED# 66-14-01-03-0-0

ROOSEVELT ES SED# 66-14-01-03-0-005-022

OSSINING HS SED# 66-14-01-03-0-003-043

PROJECT ISSUE & REVISION SCHEDULE

2-A101

Roosevelt ES
GROUND FLOOR KEY PLAN



NEW YORK STATE EDUCATION STATEMENT

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COMMISSIONER'S REGULATION'S FOR ANY PERSON, UNLESS ACTING UNDER
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DESCRIPTION OF THE ALTERATION.

SHEET INFORMATION

Issued Scale
11/15/2021 AS INDICATED
Project Status

Project Status
BID SET
Drawn By Checked By
AW BP
Drawing Title

GROUND FLOOR EXISTING/ DEMOLTION PLAN

> RES A101

DEMOLITION KEYNOTES:

REQ'D FOR NEW WORK.

- 1) REMOVE EXISTING FLOOR TILE, BASE TILE & ADHESIVE COMPLETE TO STRUCTURAL FLOOR SLAB AS REQ'D FOR INSTALLATION OF NEW WORK.
- GC SHALL TRENCH & /BACKFILL/ REINSTALL PORTIONS OF EXISTING CONCRETE FLOOR SLAB AS REQ'D FOR INSTALLATION OF NEW WORK. COORDINATE WITH PC.
- (3) REMOVE MUDSET DOWN TO STRUCTURAL FLOOR SLAB.
- REMOVE EXISTING DOOR, DOOR HARDWARE & FRAME COMPLETE AS REQ'D FOR INSTALLATION OF NEW WORK.
- (5) REMOVE EXISTING DOOR FRAME AS REQ'D FOR INSTALLATION OF NEW WORK.
- 6 MC SHALL REMOVE EXISTING PANEL RADIATOR AS REQ'D FOR INSTALLATION OF NEW WORK. SEE HVAC DRAWINGS FOR ADDITIONAL INFORMATION. HC & GC SHALL COORDINATE WORK.
- 7) REMOVE EXISTING TOILET PARTITION SYSTEM COMPLETELY AS REQ'D FOR NEW WORK.
- 8 REMOVE ALL DISPENSERS, ALL DISPOSALS, GRAB BARS, MIRRORS & COAT HOOKS COMPLETE AS REQ'D FOR NEW WORK.

WORK. SEE REFLECTED CEILING PLANS FOR ADDITIONAL INFORMATION.

- 9 PC SHALL REMOVE & DISCONNECT EXISTING PLUMBING FIXTURE(S) & RELATED PIPING AS
- 10 REMOVE EXISTING CEILING & SUPPORT SYSTEM IN ITS ENTIRETY FOR INSTALLATION OF NEW
- MC & EC SHALL REMOVE EXISTING LIGHT FIXTURES, DIFFUSERS, GRILLES, SPEAKERS, ACCESS PANELS & HVAC EQUIPMENT AS REQ'D FOR INSTALLATION OF NEW WORK. SEE MECHANICAL & ELECTRICAL DRAWINGS.
- REMOVE EXISTING WALL CONSTRUCTION & PATCH/REPAIR FLOOR, WALL & CEILING AS NEEDED TO ACCOMMODATE NEW WORK.
- (13) SCRAPE/ SAND EXISTING DOOR 7 FRAME TO PREP TO BE REFINISHED.
- CAREFULLY REMOVE AND PROTECT WALL PADDING AS NEEDED TO ACCOMMODATE NEW WORK. REINSTALL AFTER COMPLETION OF NEW WORK. COORDINATE WORK WITH ALL APPLICABLE TRADES
- DEMO EXISTING WALL CONSTRUCTION AS REQ'D TO REMOVE UNIT VENT FOR NEW WORK.
 ALL BASKETBALL BACKBOARDS AND SUPPORTING HARDWARE ON THE WALLS WITH
 WINDOWS SHOULD BE REMOVED AND WALLS PATCHED AND PAINT ENTIRE WALL WHERE
 BACKBOARDS WERE REMOVED. FOUR IN TOTAL. THE OWNER WILL ARRANGE FOR
 REPLACEMENT OF THOSE BACKBOARD/ HOOP SYSTEMS THAT ARE REMOVED.
- (16) FILL EXISTING HOLES FROM FLOOR MOUNTED URINALS ,AS REG'D, WITH CONCRETE AND LAY (2) #3 REBAR, EQUALLY SPACED, ACROSS TOP OF HOLES AND EXTEND REBAR PAST END HOLES BY 6" MIN.

GENERAL DEMOLITION NOTES:

NEW CONSTRUCTION AS SHOWN.

- 1. REFER TO MECHANICAL, ELECTRICAL, PLUMBING & ASBESTOS DRAWINGS FOR ADDITIONAL INFORMATION. COORDINATE REMOVALS WITH ALL OTHER CONTRACTS.
- 2. MAINTAIN INTEGRITY OF ITEMS THAT ARE TO REMAIN. PATCH ALL REMAINING SURFACES DISTURBED BY DEMOLITION AND/OR NEW CONSTRUCTION TO MATCH EXISTING ADJACENT
- 3. COORDINATE EXTENT OF SELECTIVE DEMOLITION WITH NEW WORK.
- 4. PROVIDE TEMPORARY SHORING & BRACING AS REQ'D PRIOR TO COMMENCING DEMOLITION. DO NOT DAMAGE OR DISTURB EXISTING STRUCTURAL ELEMENTS THAT ARE TO REMAIN. WHERE WALLS ARE TO BE REMOVED, DO NOT REMOVE EXISTING COLUMNS, UNLESS NOTED OTHERWISE.
- 5. REMOVE ALL CASEWORK, BOARDS, ACCESSORIES, PROJECTION SCREENS & ITEMS BUILT IN OR LOCATED ON WALLS SHOWN TO BE DEMOLISHED OR AS REQ'D BY NEW CONSTRUCTION.
- 6. PRIOR TO START OF PROJECT, OWNER SHALL REMOVE LOOSE EQUIPMENT SUCH AS FURNITURE, DESKS, CHAIRS, SHELVING, WINDOW AIR CONDITIONERS, ETC., U.N.O. FURNITURE & EQUIPMENT REMAINING SHALL BE COVERED & PROTECTED.
- 7. DEMOLITION TO INCLUDE COMPLETE REMOVAL OF ALL FASTENERS, ADHESIVES & RELATED ITEMS COMPLETELY DOWN TO SUBSTRATE. PATCH SUBSTRATE AS REQ'D FOR NEW FINISHES. PATCH ALL REMAINING SURFACES DISTURBED BY DEMOLITION AND/OR NEW CONSTRUCTION TO BLEND WITH & MATCH EXISTING ADJACENT SURFACES, OR PROVIDE



PROJECT INFORMATION

Project Number 14428.18

OSSINING UNION FREE SCHOOL DISTRICT

Project Name **2021 - 2022 CIP**

District Office Address
400 EXECUTIVE BLVD OSSINING, NY 10562


Multiple Building Names

ANNE M. DORNER MS SED# 66-14-01-03-0-008


ROOSEVELT ES SED# 66-14-01-03-0-005-022

OSSINING HS SED# 66-14-01-03-0-003-043

No. Date Description

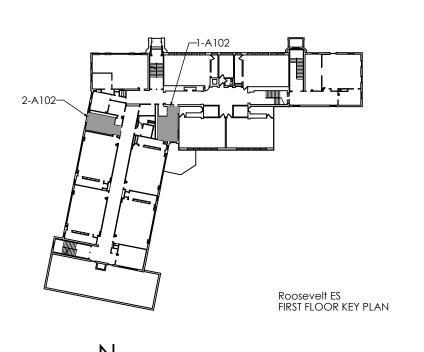



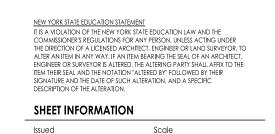

11/15/2021 AS INDICATED
Project Status
BID SET
Drawn By Checked By
AW BP
Drawing Title

Proving Title
FIRST FLOOR EXISTING/
DEMOLITION PLAN

RES A102

DEMOLITION KEYNOTES:

- REMOVE EXISTING FLOOR TILE, BASE TILE & ADHESIVE COMPLETE TO STRUCTURAL FLOOR SLAB AS REQ'D FOR INSTALLATION OF NEW WORK.
- GC SHALL TRENCH & /BACKFILL/ REINSTALL PORTIONS OF EXISTING CONCRETE FLOOR SLAB AS REQ'D FOR INSTALLATION OF NEW WORK. COORDINATE WITH PC.
- (3) REMOVE MUDSET DOWN TO STRUCTURAL FLOOR SLAB.
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- (13) SCRAPE/ SAND EXISTING DOOR 7 FRAME TO PREP TO BE REFINISHED.

MECHANICAL & ELECTRICAL DRAWINGS.

- CAREFULLY REMOVE AND PROTECT WALL PADDING AS NEEDED TO ACCOMMODATE NEW WORK. REINSTALL AFTER COMPLETION OF NEW WORK. COORDINATE WORK WITH ALL APPLICABLE TRADES.
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GENERAL DEMOLITION NOTES:

- I. REFER TO MECHANICAL, ELECTRICAL, PLUMBING & ASBESTOS DRAWINGS FOR ADDITIONAL INFORMATION. COORDINATE REMOVALS WITH ALL OTHER CONTRACTS.
- 2. MAINTAIN INTEGRITY OF ITEMS THAT ARE TO REMAIN. PATCH ALL REMAINING SURFACES DISTURBED BY DEMOLITION AND/OR NEW CONSTRUCTION TO MATCH EXISTING ADJACENT
- 3. COORDINATE EXTENT OF SELECTIVE DEMOLITION WITH NEW WORK.
- 4. PROVIDE TEMPORARY SHORING & BRACING AS REQ'D PRIOR TO COMMENCING DEMOLITION. DO NOT DAMAGE OR DISTURB EXISTING STRUCTURAL ELEMENTS THAT ARE TO REMAIN. WHERE WALLS ARE TO BE REMOVED, DO NOT REMOVE EXISTING COLUMNS, UNLESS NOTED OTHERWISE.
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Project Name **2021-2022 CIP**

District Office Address
400 EXECUTIVE BLVD OSSINING, NY 10562

400 EXECUTIVE BLVD OSSINING, NY 10.

Multiple Building Names

ANNE M. DORNER MS SED# 66-14-01-03-0

ROOSEVELT ES SED# 66-14-01-03-0-005-022

OSSINING HS SED# 66-14-01-03-0-003-043

PROJECT ISSUE & REVISION SCHEDULE

2-A103

Roosevelt ES
SECOND FLOOR KEY PLAN

KEY PLAN

NEW YORK STATE EDUCATION STATEMENT

IT IS A VIOLATION OF THE NEW YORK STATE EDUCATION LAW AND THE
COMMISSIONER'S REGULATIONS FOR ANY PERSON, JUNESS ACTING UNDER
THE DIRECTION OF A LICENSED ARCHITECT, ENGINEER OR LAND SURVEYOR, TO
ALTER AN ITEM IN ANY WAY, IF AN ITEM BEARING THE SEAL OF AN ARCHITECT,
ENGINEER OR SURVEYOR IS ALTERED, THE ALTERING PARTY SHALL AFFIX TO THE
ITEM THEIR SEAL AND THE NOTATION "ALTERED BY FOLLOWED BY THEIR
SIGNATURE AND THE DATE OF SUCH ALTERATION, AND A SPECIFIC
DESCRIPTION OF THE ALTERATION.

SHEFT INFORMATION


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11/15/2021
Project Status


Project Status
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Drawn By Checked By
AW BP
Drawing Title


AS INDICATED

SECOND FLOOR EXISTING / DEMOLITION PLAN



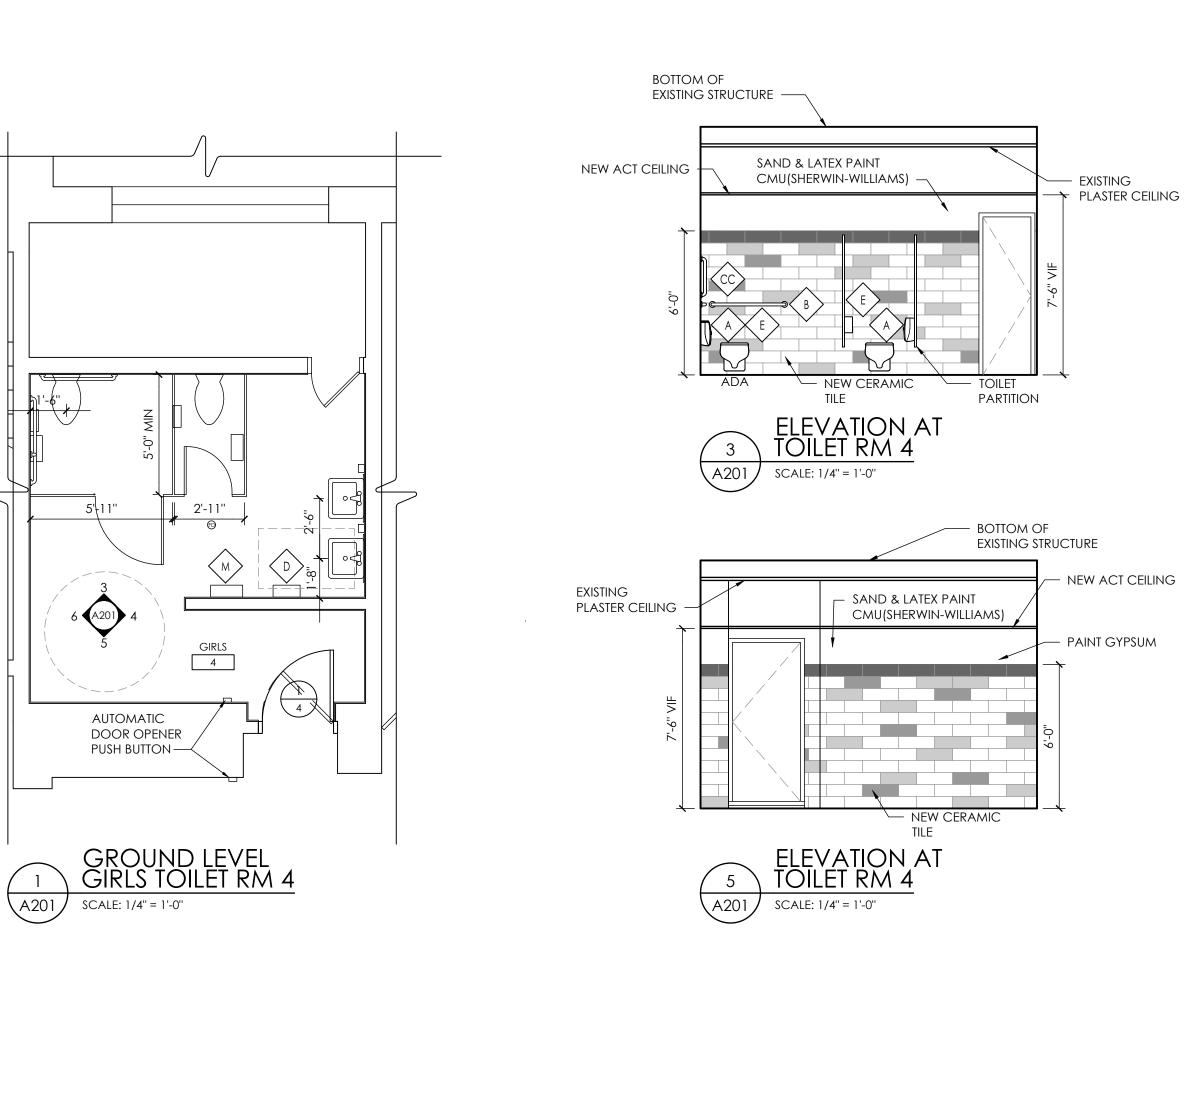

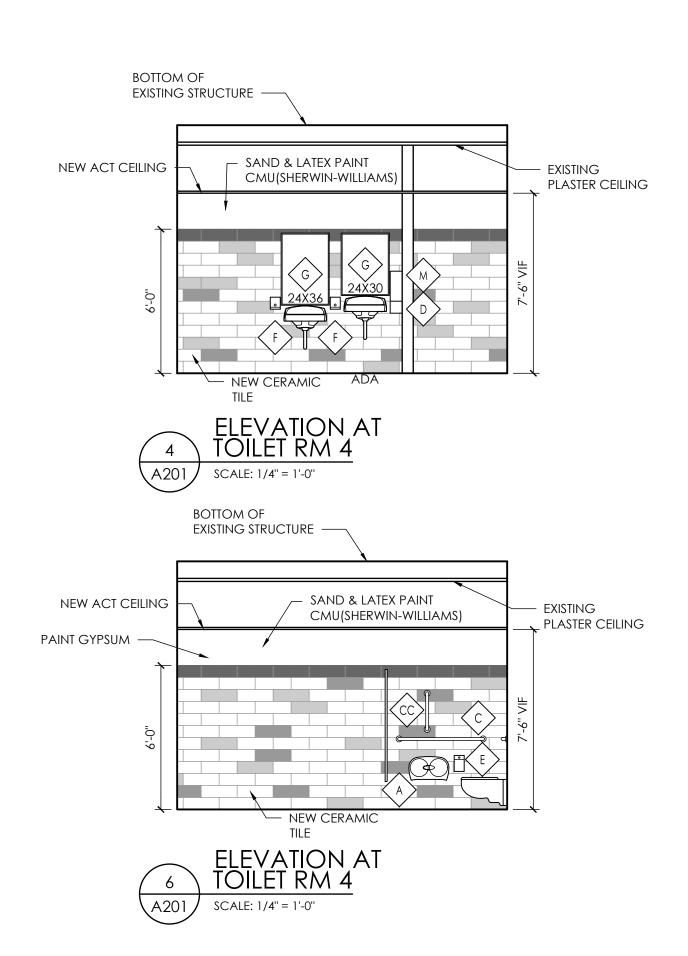

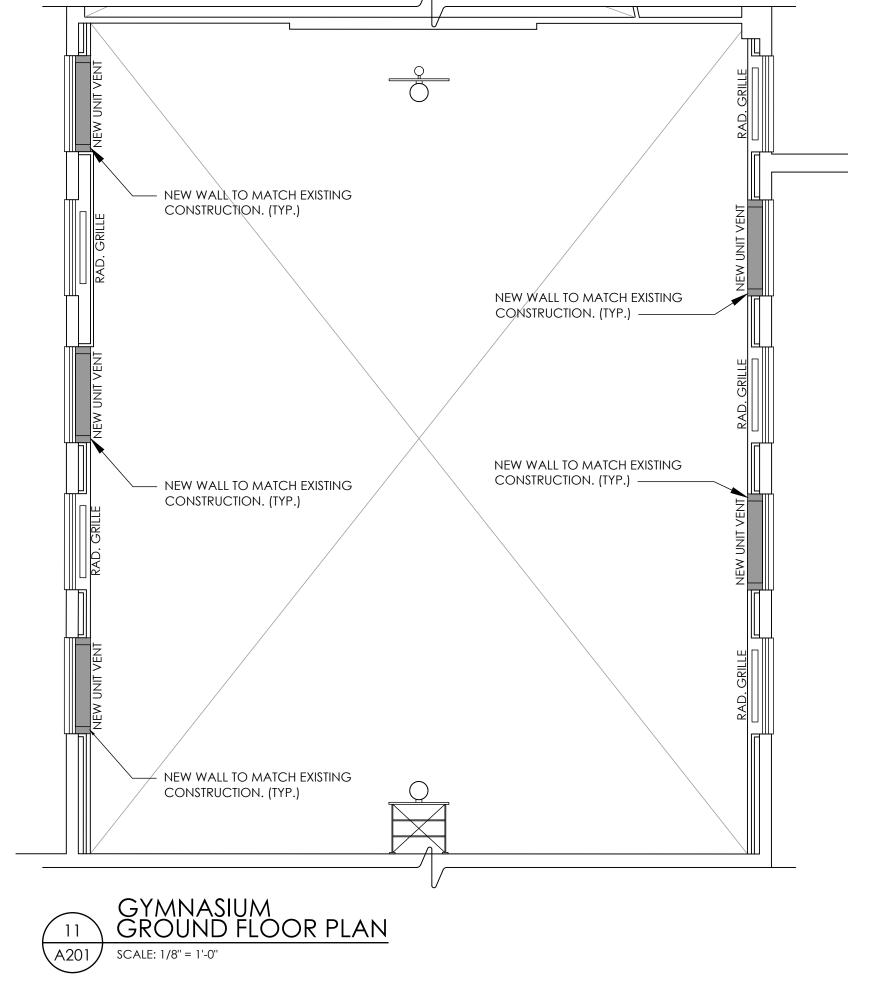



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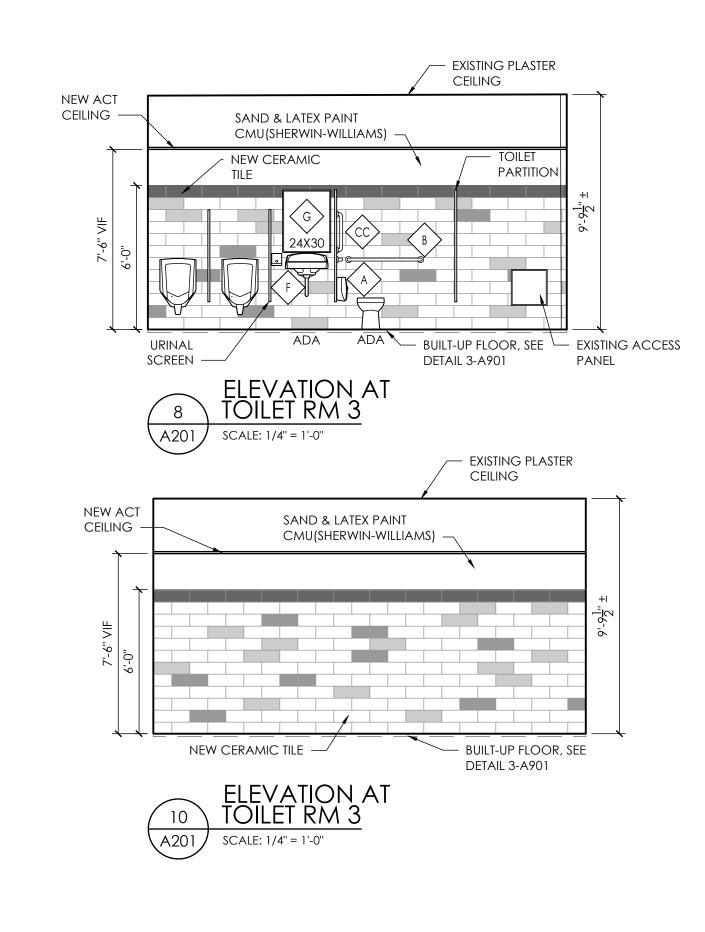
■ NEW WALL CONSTRUCTION


construction.

Contractor to field verify ALL dimensions and notify architect of any discrepancies prior to



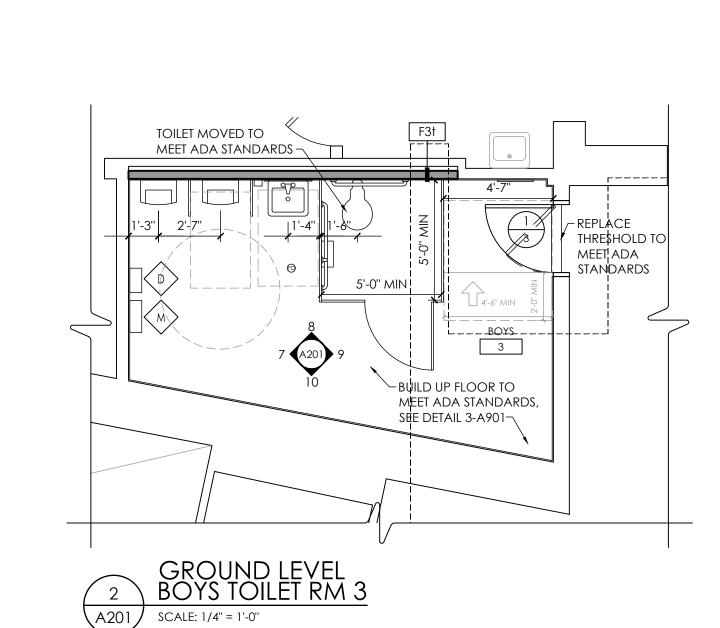

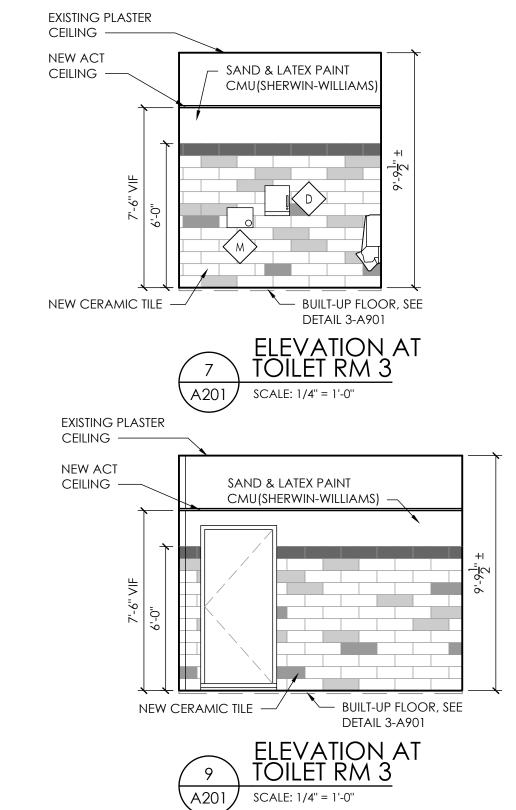

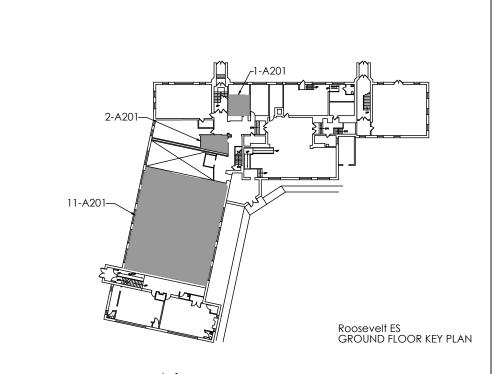



CPL | Architecture Engineering Planning
50 Front St. Suite 202

Newburgh, NY 12550

CPLteam.com

PROJECT INFORMATION
Project Number

14428.18

OSSINING UNION FREE SCHOOL DISTRICT

2021-2022 CIP

District Office Address
400 EXECUTIVE BLVD OSSINING, NY 10562

Multiple Building Names


PROJECT ISSUE & REVISION SCHEDULE

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Issued Scale
11/15/2021 AS INDICATED
Project Status
BID SET
Drawn By Checked By
AW BP


GROUND FLOOR NEW WORK PLANS & ELEVATIONS


RES A201



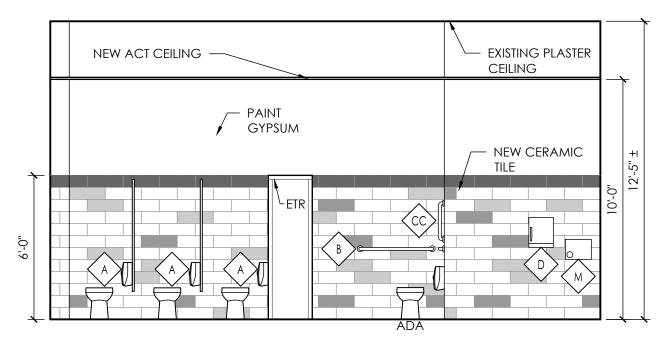

SCALE: 1/4" = 1'-0"

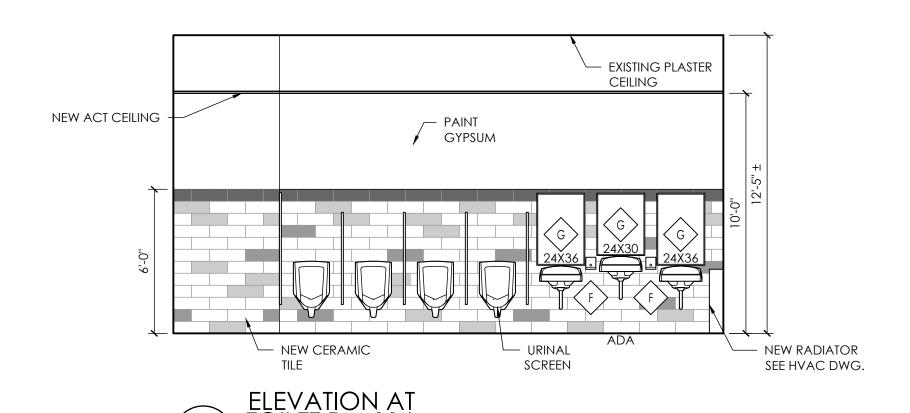

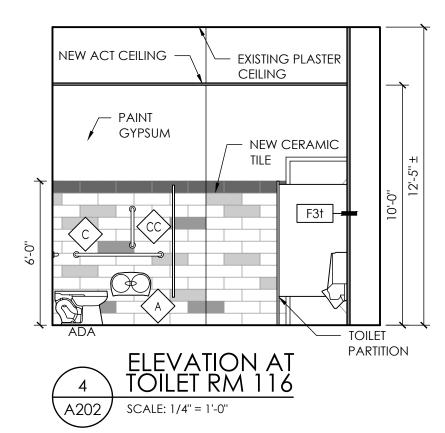


GENERAL NOTE:

NEW WALL CONSTRUCTION

construction.

Contractor to field verify ALL dimensions and notify architect of any discrepancies prior to

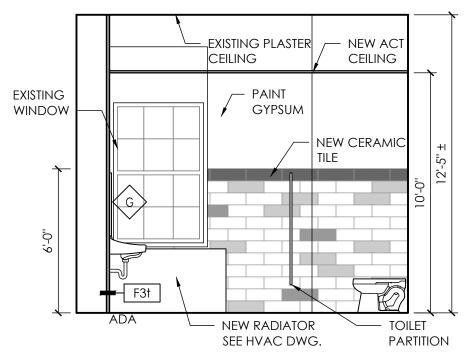



CPL | Architecture Engineering Planning 50 Front St. Suite 202

Newburgh, NY 12550

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PROJECT INFORMATION
Project Number

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OSSINING UNION FREE SCHOOL DISTRICT

Project Name

2021 - 2022 CIP

District Office Address
400 EXECUTIVE BLVD OSSINING, NY 10562

Multiple Building Names


ANNE M. DORNER MS SED# 66-14-01-03-0-008

ROOSEVELT ES SED# 66-14-01-03-0-005-022


OSSINING HS SED# 66-14-01-03-0-003-043

PROJECT ISSUE & REVISION SCHEDULE


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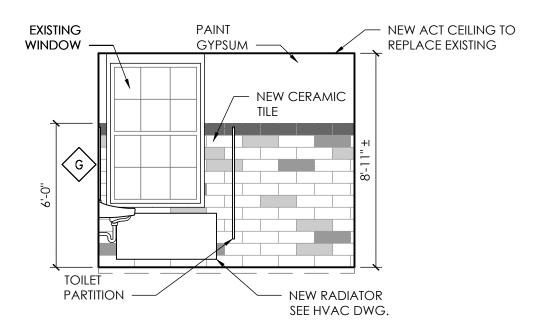


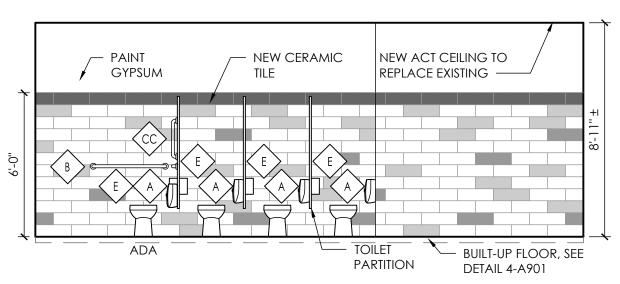

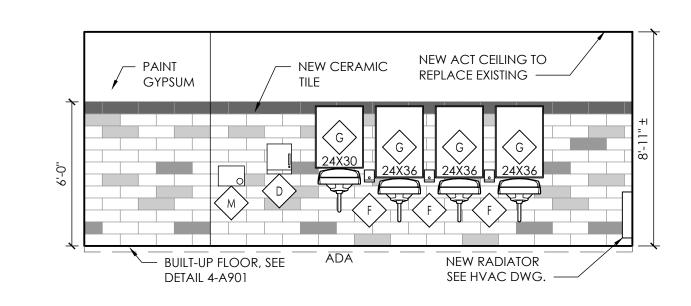


A202

SCALE: 1/4" = 1'-0"

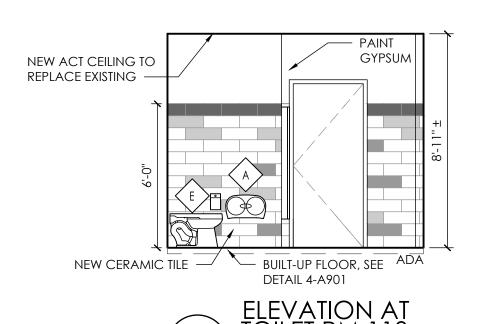

ELEVATION AT TOILET RM 110

A202 SCALE: 1/4" = 1'-0"

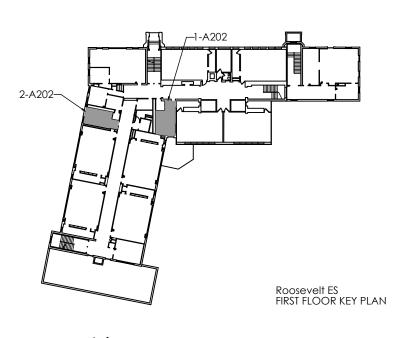



KEY PLAN




& ELEVATIONS




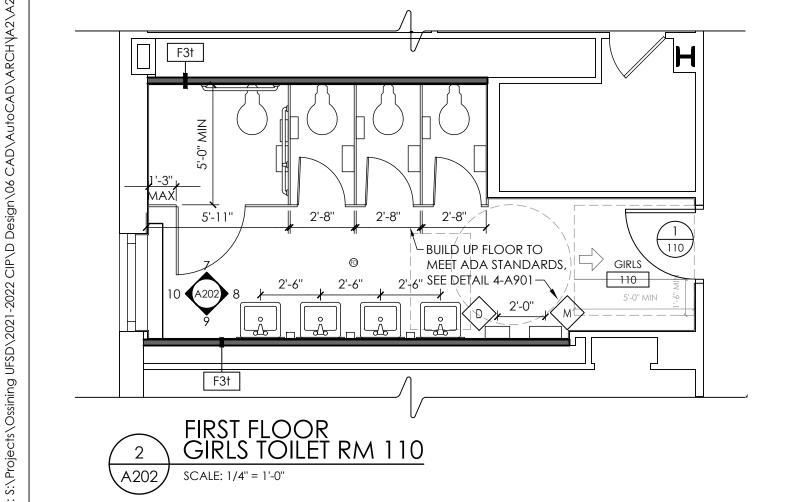


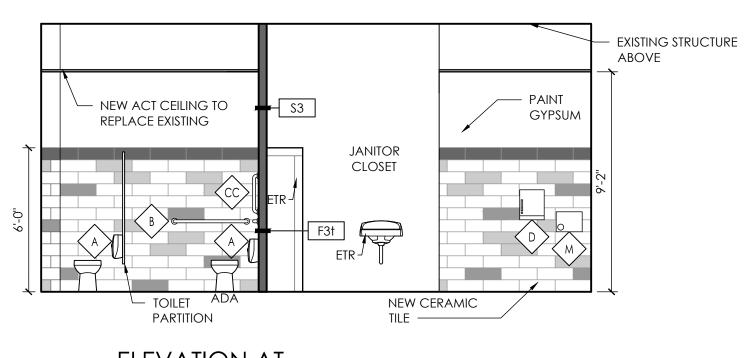




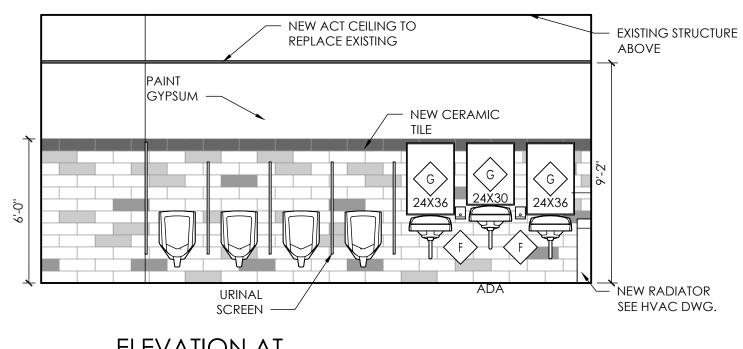


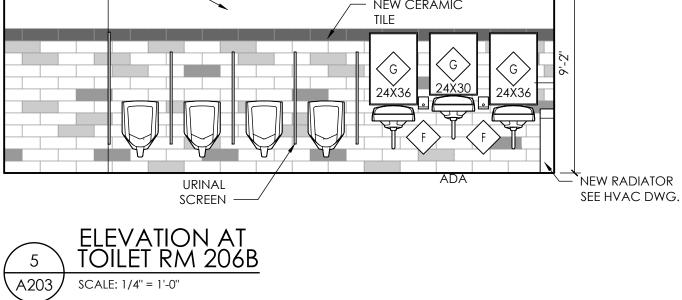

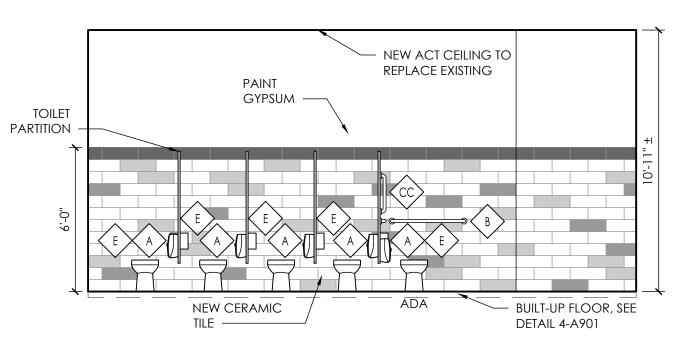




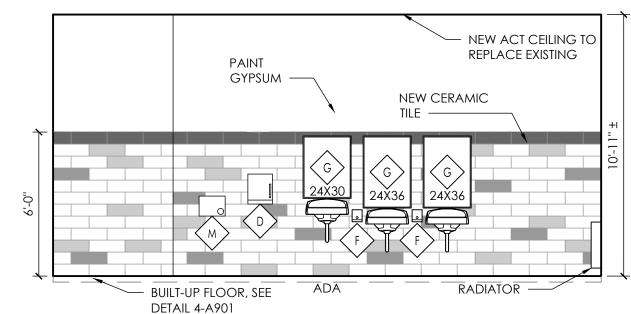

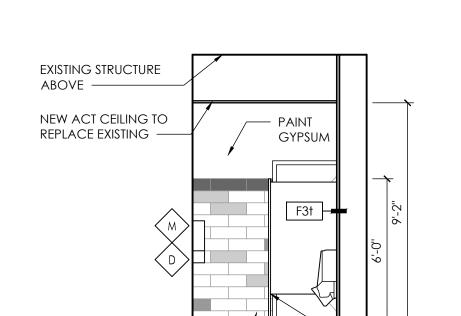

NEW CERAMIC



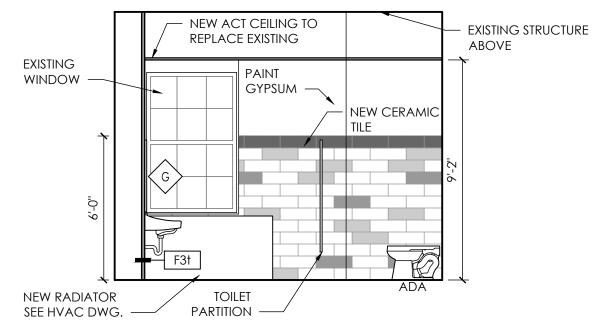

— TOILET


GENERAL NOTE:

NEW WALL CONSTRUCTION


construction.

Contractor to field verify ALL dimensions and notify architect of any discrepancies prior to




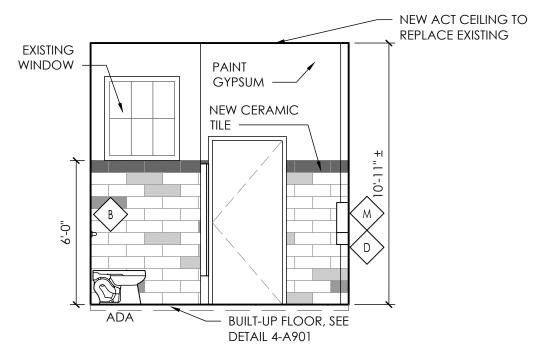




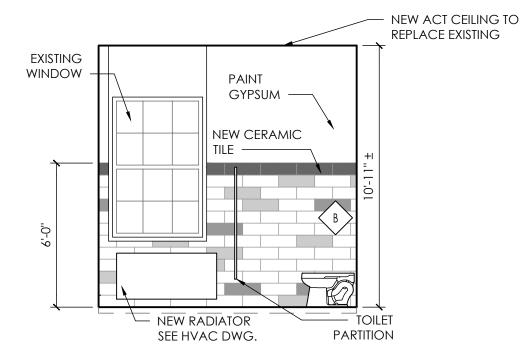



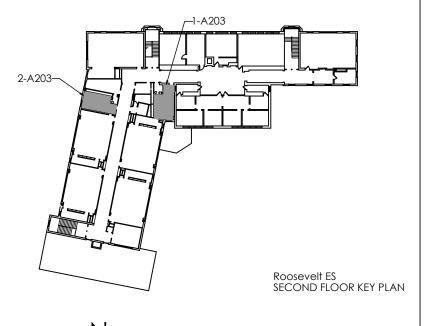



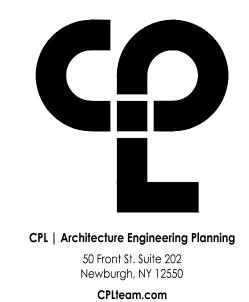

PROJECT INFORMATION

14428.18

Project Number

OSSINING UNION FREE SCHOOL DISTRICT

2021-2022 CIP

District Office Address

400 EXECUTIVE BLVD OSSINING, NY 10562

Multiple Building Names

ANNE M. DORNER MS SED# 66-14-01-03-0-008-028 ROOSEVELT ES SED# 66-14-01-03-0-005-022 OSSINING HS SED# 66-14-01-03-0-003-043

PROJECT ISSUE & REVISION SCHEDULE


No. Date Description

SHEET INFORMATION

Issued Scale AS INDICATED 11/15/2021 Project Status BID SET Drawn By Checked By

AW SECOND FLOOR NEW WORK PLANS & ELEVATIONS


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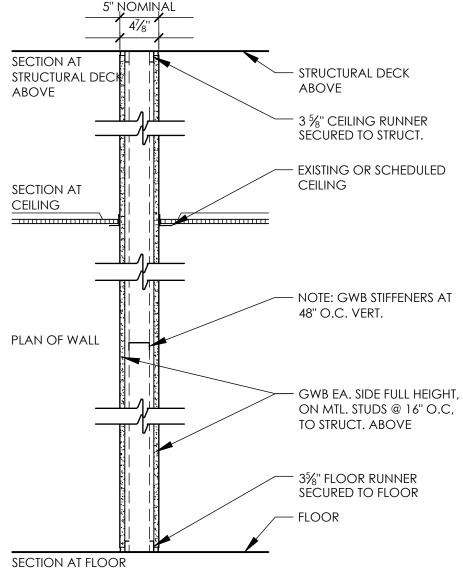
SCALE: 1/4" = 1'-0"

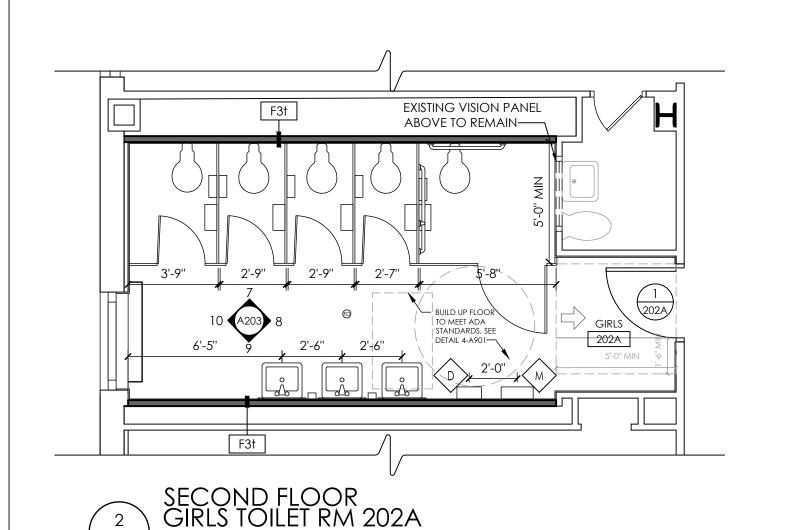SCALE: 1/4" = 1'-0"


DETAIL 4-A901 ELEVATION AT TOILET RM 202A SCALE: 1/4" = 1'-0"



TYPE	FIRE TEST LAB & DESIGN	FIRE RATING	STC
F3t	NA	NR	NA

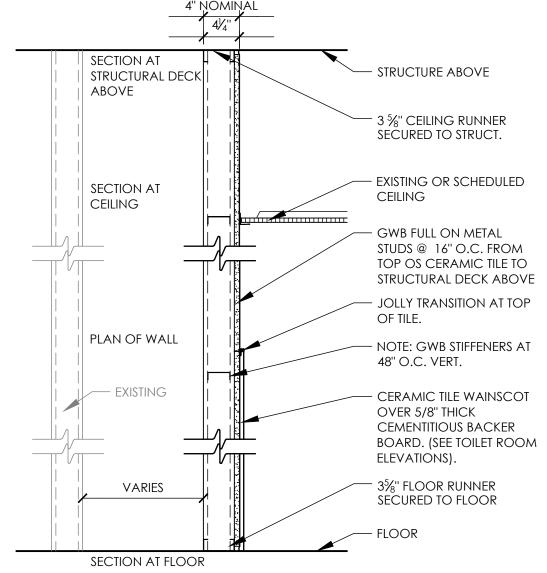

TYPE	FIRE TEST LAB & DESIGN	FIRE RATING	STC
6 3	NA	NR	42

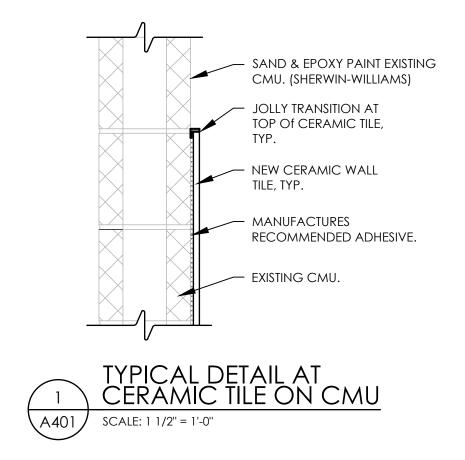

PARTITION TYPE LEGEND:

MATERIAL DESIGNATION

CONSTRUCTION BARRIER 3}" STEEL STUDS x 20 GA.

F FURRED ASSEMBLY

CONCRETE MASONRY UNIT (CMU)

STEEL STUDS x 20 GA.

SHAFT WALL ASSEMBLY, STEEL STUD

SIZE SUFFIX:

1 - $1\frac{5}{8}$ " STUD OR 7/8" FURRING

 $2 - 2\frac{1}{2}$ " STUD OR 2" Z FURRING

3 - 3 %" STUD OR 3" Z FURRING

4 - 4" CONCRETE MASONRY UNIT (CMU) OR 4" STUD

6 - 6" CONCRETE MASONRY UNIT (CMU) OR 6" STUD 8 - 8" CONCRETE MASONRY UNIT (CMU) OR 8" STUD

9 - (2) 3 %" CHASE WALL

10 - 10" CONCRETE MASONRY UNIT (CMU)

12 - 12" CONCRETE MASONRY UNIT (CMU)

RATING SUFFIX:

r - (1) HOUR RATED (CMU) OR (1) HOUR RATED PARTITION, SINGLE LAYER OF %" TYPE "X" GWB EACH SIDE OF PARTITION, FULL HEIGHT.

d - (2) HOUR RATED (CMU) OR (2) HOUR RATED PARTITION-DOUBLE LAYER OF %" TYPE "X"

GWB EACH SIDE OF PARTITION, FULL HEIGHT.

ACCESSORIES SUFFIX:

a - $\frac{5}{8}$ " GWB ADHERED TO SUBSTRATE (EXISTING OR NEW)

c - GWB TO 6" ABOVE CEILING ON ONE SIDE OF PARTITION AND FULL HEIGHT OPPOSITE

e - LAYER OF GWB MOVED TO OPPOSITE SIDE OF ASSEMBLY

f - FURRING - GWB ONE SIDE ONLY.

i - SOUND ATTENUATING BATT INSULATION.

I - LEADED GWB

p - ON TAG SIDE OF PARTITION, USE 1 LAYER OF 5/8" GWB FULL HEIGHT PLUS AN ADDITIONAL OUTER LAYER OF 5/8" GWB TO 4" ABOVE FINISHED CEILING SYSTEM (STAGGER SEAMS). OPPOSITE SIDE OF PARTITION TO BE 1 LAYER OF 5/8" GWB FULL HEIGHT UNLESS "d" RATING SUFFIX IS ALSO INDICATED.

s - SOUND SEAL

† - CERAMIC WALL TILE (CWT) OR CEMENTITIOUS BACKER BOARD AND TILE AT STUD

v - Plaster Veneer.

w - CONTINUE EXISTING WALL TO UNDERSIDE OF STRUCTURAL DECK ABOVE.

z - FURRING CHANNEL WITH 1 LAYER GWB TO 6" ABOVE CEILING, INSTALLED ON TAG SIDE OF PARTITION (REFER TO WALL TYPE DETAIL FOR CHANNEL SIZE).

GENERAL NOTES:

1. FULL HEIGHT PARTITIONS SHALL EXTEND TO THE BOTTOM OF CONCRETE, METAL, OR OTHER STRUCTURAL DECK ABOVE.

2. FLUTES IN METAL DECK ABOVE RATED PARTITIONS SHALL BE FILLED WITH FIRE SAFING INSULATION. FIRE STOP ENTIRE PERIMETER OF RATED PARTITIONS, INCLUDING EXTERIOR WALLS, WITH A UL LISTED JOINT SYSTEM FIRESTOP ASSEMBLY.

3. PROVIDE DEFLECTION TRACKS AT METAL STUD PARTTITIONS THAT TERMINATE AT THE UNDERSIDE OF STRUCTURAL DECK ABOVE.

4. ALL PENETRATIONS IN FIRE RATED PARTITIONS SHALL BE FIRE STOPPED AND SEALED.

5. PROVIDE ABUSE RESISTANT 5/8" TYPE 'X' GYPSUM WALL BOARD AT ALL FIRE RATED

6. PROVIDE 5/8" MOISTURE RESISTANT GYPSUM WALL BOARD AT TOILET ROOM, LAVATORY, CUSTODIAL CLOSET OR OTHER WET LOCATIONS.

7. PARTITION TYPES WITH ONE SIDE OF DOUBLE DRYWALL SHALL BE PLACED SO THAT THE DOUBLE SIDE IS ON CORRIDOR AND/OR HIGH TRAFFIC SIDE OF THE WALL.

8. REFER TO THE STRUCTURAL SERIES DRAWINGS FOR MASONRY WALL REINFORCEMENT.

9. ALL PARTITIONS SHALL BE SEALED TO PREVENT THE PASSAGE OF SMOKE.

10. PROVIDE BULL-NOSED EDGES AT ALL EXPOSED MASONRY CORNERS.

11. PROVIDE DOUBLE STUDS AT PERIMETER OF ALL OPENINGS.

12. REFER TO THE INTERIOR SERIES DRAWINGS FOR WALL FINISH INFORMATION.

CPL | Architecture Engineering Planning 50 Front St. Suite 202 Newburgh, NY 12550 CPLteam.com

PROJECT INFORMATION

Project Number 14428.18

OSSINING UNION FREE SCHOOL DISTRICT

2021-2022 CIP

District Office Address

400 EXECUTIVE BLVD OSSINING, NY 10562

Multiple Building Names ROOSEVELT ES SED# 66-14-01-03-0-005-022

OSSINING HS SED# 66-14-01-03-0-003-043

PROJECT ISSUE & REVISION SCHEDULE


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ITEM THEIR SEAL AND THE NOTATION "ALTERED BY" FOLLOWED BY THEIR
SIGNATURE AND THE DATE OF SUCH ALTERATION, AND A SPECIFIC
DESCRIPTION OF THE ALTERATION.

AS INDICATED

SHEET INFORMATION Issued

11/15/2021 Project Status BID SET Drawn By

AW Drawing Title PARTITION TYPES

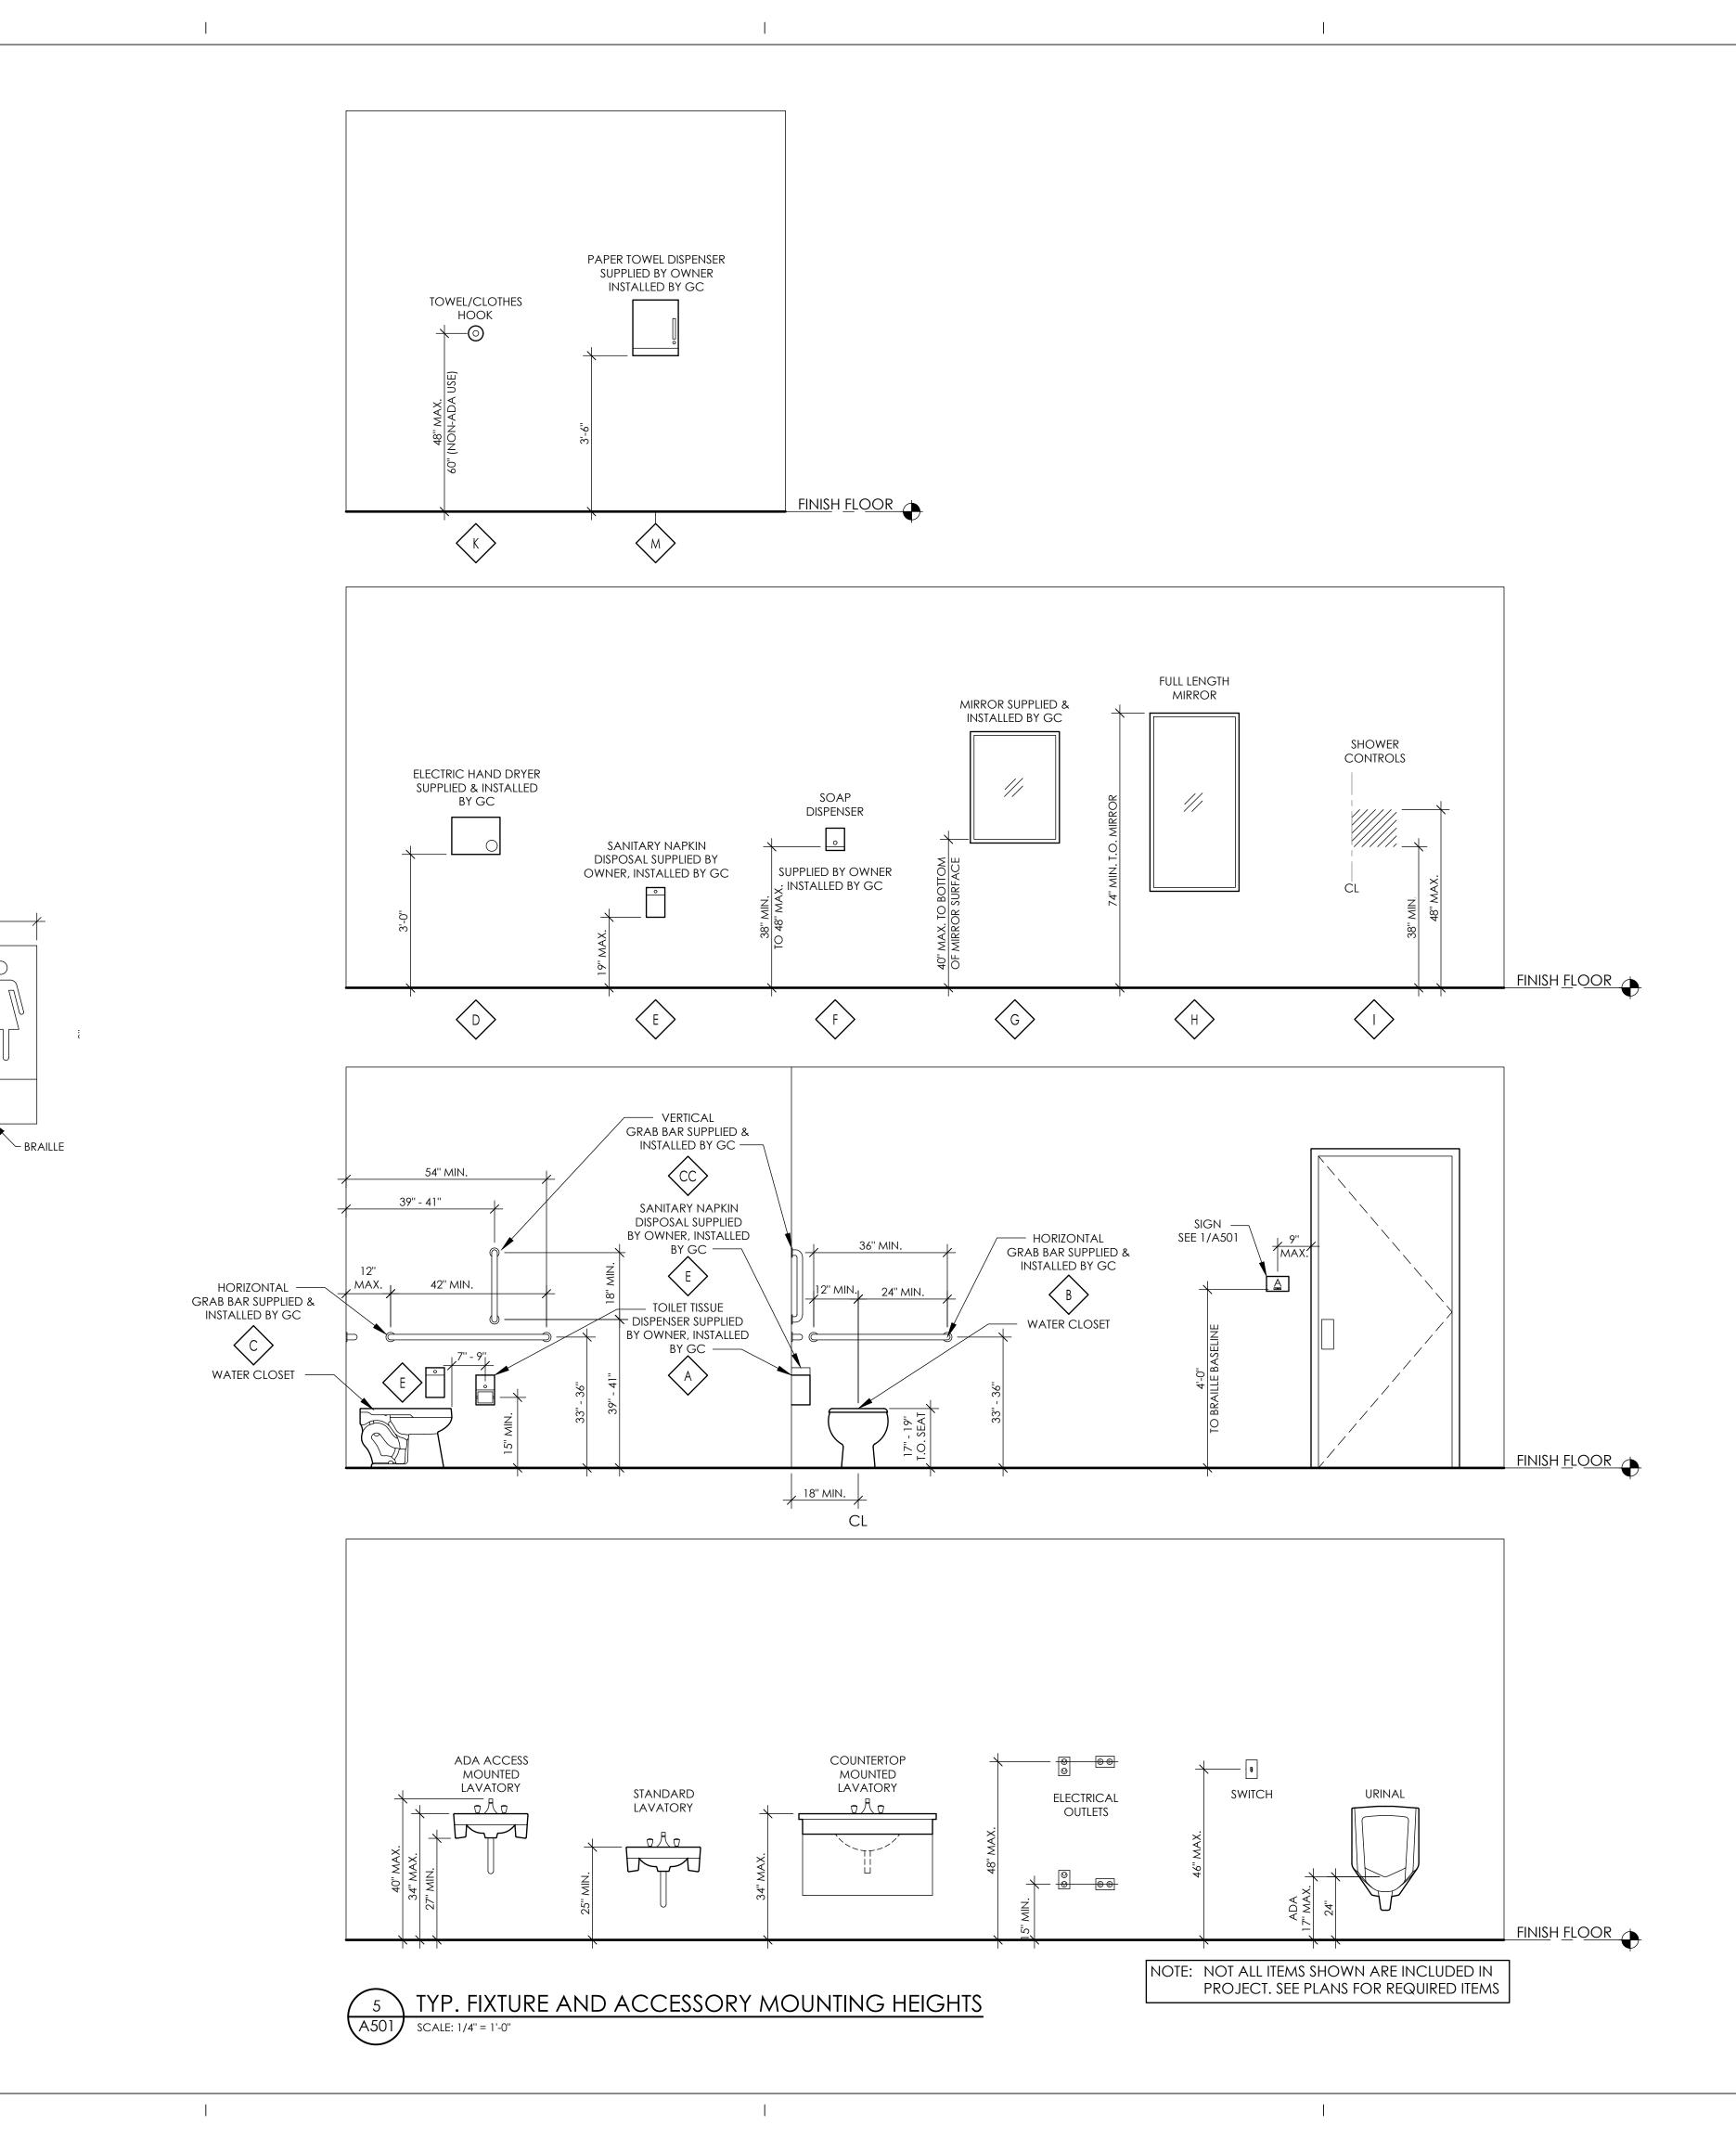

BOYS

NOTE: FOR REFERENCE ONLY SIGNAGE BY OWNER

ROOM NAME

A501 SCALE: 3" = 1'-0"

SIGNAGE TYPES

GIRLS

CPL | Architecture Engineering Planning

50 Front St. Suite 202

Newburgh, NY 12550

CPLteam.com

PROJECT INFORMATION

14428.18

Project Number

OSSINING UNION FREE SCHOOL DISTRICT

Project Name
2021 - 2022 CIP

District Office Address
400 EXECUTIVE BLVD OSSINING, NY 10562

Multiple Building Names

ANNE M. DORNER MS SED# 66-14-01-03-0-00

ROOSEVELT ES SED# 66-14-01-03-0-005-022

OSSINING HS SED# 66-14-01-03-0-003-04

PROJECT ISSUE & REVISION SCHEDULE

No. Date Description

NEW YORK STATE EDUCATION STATEMENT
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Issued Scale
11/15/2021 AS INDICATED

11/15/2021 AS INDICA
Project Status
BID SET
Drawn By Checked By

Drawn By Checked By
AW BP

Drawing Title

TYPICAL FIXTURE MOUNTING HEIGHTS

> RES A501

LEGEND


X'-X" CEILING HEIGHT


ACT - ACOUSTICAL CEILING TILE


HVAC RETURN


HVAC DIFFUSER


SQUARE LIGHT FIXTURE

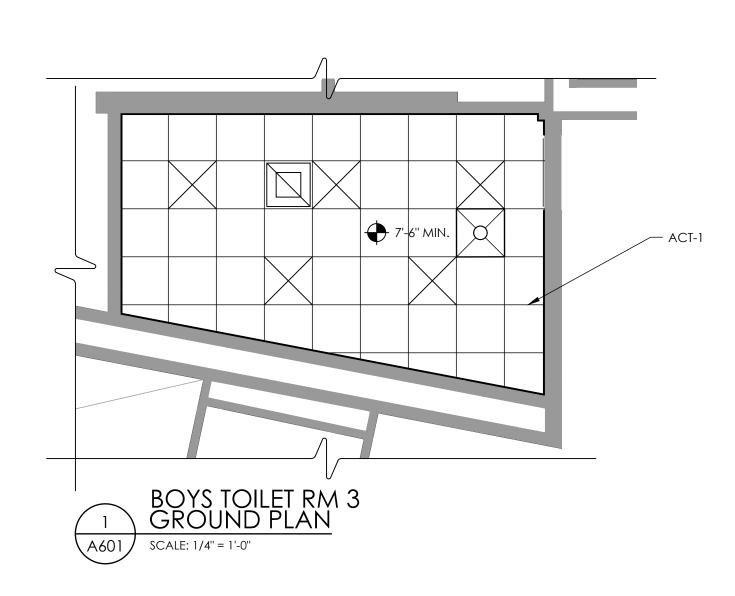


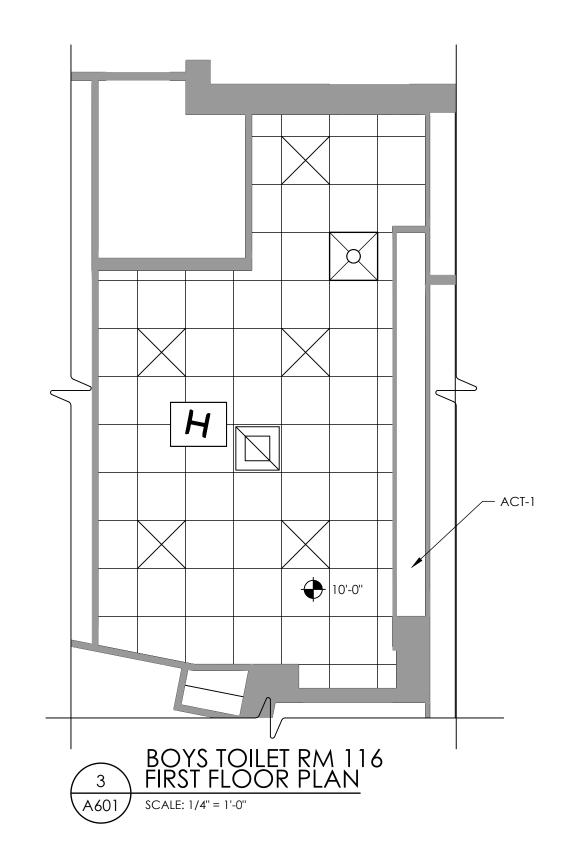

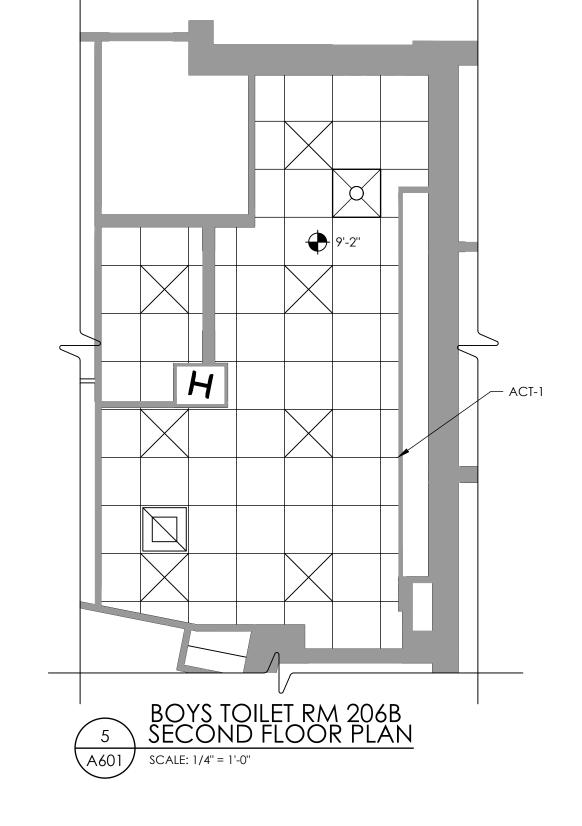

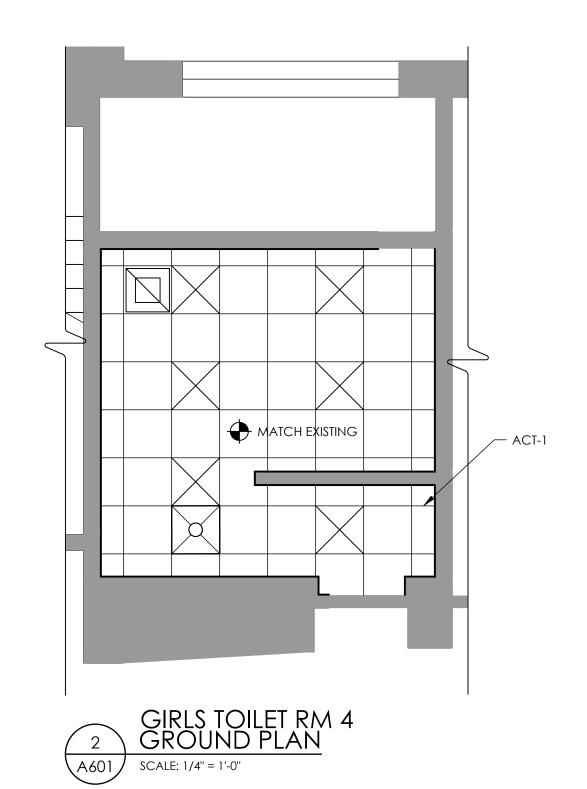

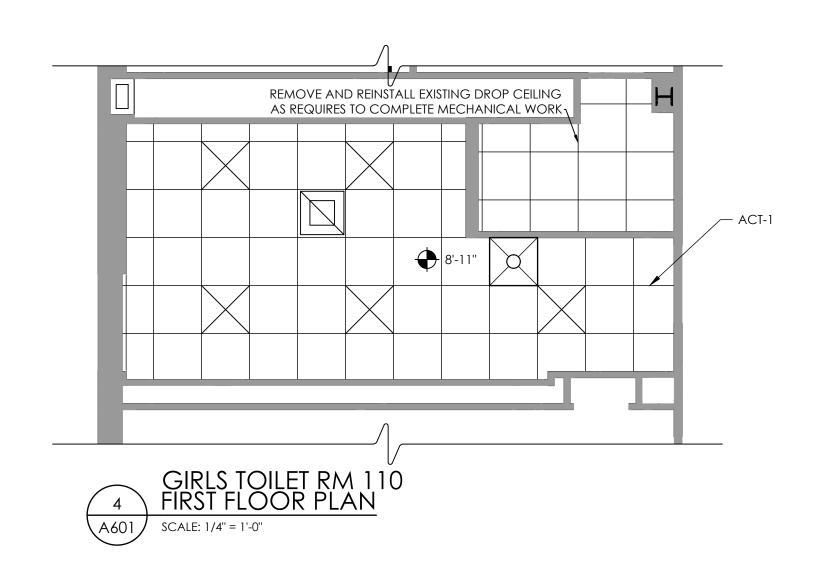

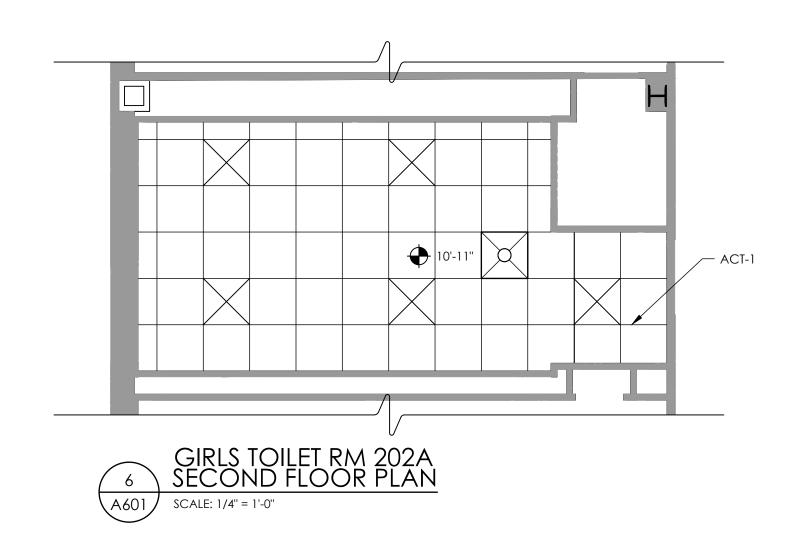



PROJECT INFORMATION

Project Number 14428.18

OSSINING UNION FREE SCHOOL
DISTRICT

2021-2022 CIP

District Office Address
400 EXECUTIVE BLVD OSSINING, NY 10562

Multiple Building Names

☐ ANNE M. DORNER MS SED# 66-14-01-03-0-008-028

■ ROOSEVELT ES SED# 66-14-01-03-0-005-022

ROOSEVELT ES SED# 66-14-01-03-0-005-022

OSSINING HS SED# 66-14-01-03-0-003-043

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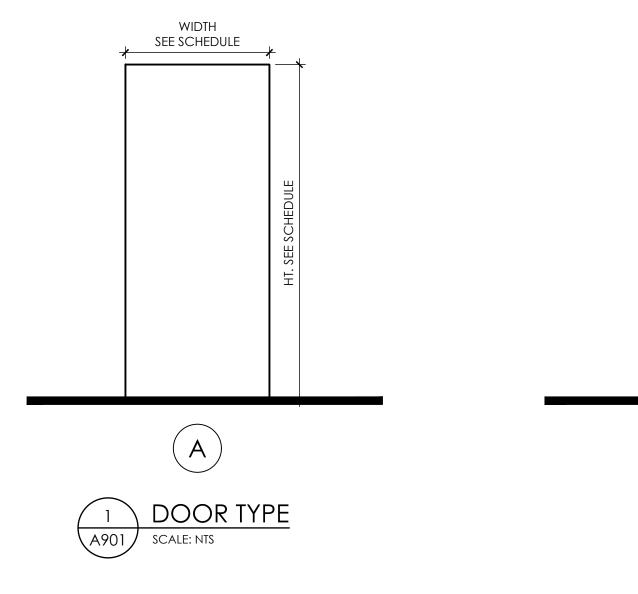
SHEET INFORMATION Issued

AW BP

Drawing Title


REFLECTED CEILING PLANS

RES A601




2"	AS PER SCHEDULE	2"																	
*	11 11	*													DOOR SC	CHEDULE			
[2]					DOO	O R S				Ď					FRAM	ES			
ı			DOOR	N	DMINAL SIZ	E		MATERIAL	RCUI	SATIIN		OVERA	ALL SIZE	"	MATERIAL	JAMB	HEAD	SILL	HARDWARE
			NO.	WIDTH	HEIGHT	TH.		/ FINISH	UNDE	HRE I	WIDTH	HEIGHT	DEPTH	TH.	/ FINISH	DETAIL	DETAIL	DETAIL	SET NO.
			1 - 3	3'-0"	6'-10"	1 3/4"	Α	WD/ST	-	¾ HR	3'-4"	7'-0''	6''	2" 1	HM/PT	MATCH E	XISTING	3-A901	SEE SPECS. (SECTION 08 71 00)
		<u> </u>	1 - 4	3'-0"	7'-0''	1 3/4"	Α	WD/ST	_	¾ HR	3'-4"	7'-2''	6"	2" 1	HM/PT	MA	ATCH EXISTIN	İG	SEE SPECS. (SECTION 08 71 00)
			1 - 110	3'-0''	6'-10"	1 3/4"	Α	WD/ST	-	¾ HR	3'-4"	7'-0''	6"	2" 1	HM/PT	MATCH E	XISTING	4-A901	SEE SPECS. (SECTION 08 71 00)
		罢	1 - 116	3'-0''	6'-10"	1 3/4"	Α	WD/ST	-	¾ HR	3'-4"	7'-0''	6"	2" 1	HM/PT	5-A901	6-A901	4-A901 SIMILAR	SEE SPECS. (SECTION 08 71 00)
			1 - 202A	3'-0"	6'-10"	1 3/4"	Α	WD/ST	-	¾ HR	3'-4"	7'-0''	6"	2" 1	HM/PT	MATCH E	XISTING	4-A901	SEE SPECS. (SECTION 08 71 00)
			1 - 206B	3'-0"	6'-10"	1 3/4"	А	WD/ST	-	¾ HR	3'-4"	7'-0''	6"	2" 1	HM/PT	5-A901	6-A901	4-A901 SIMILAR	SEE SPECS. (SECTION 08 71 00)
		SS SS	HM H EX E PT P MFR M ALUM A SIM S FRP F	OOD OLLOW ME (ISTING AINTED ANUFACTU LUMINUM MILAR BERGLASS F		D POLYES HANED		2.NEW DO U.N.O. 3.PATCH SCREW	SIONS IN OORS SH ("BOND(THE FIELD. HALL MATCH F O", ETC.) EXIST AT REMOVED	TRE-RATING	of existing i	DOORS THAT	MINE ACTUAL THEY REPLACE /EXPOSED DOOR FRAMES					

EXISTING WALL CONSTRUCTION. —

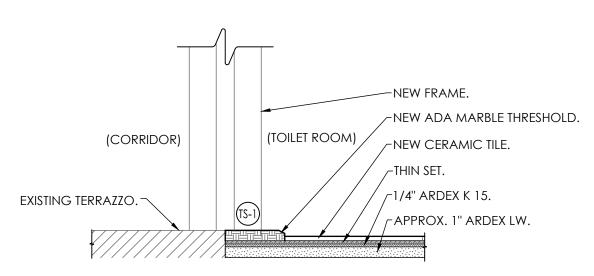




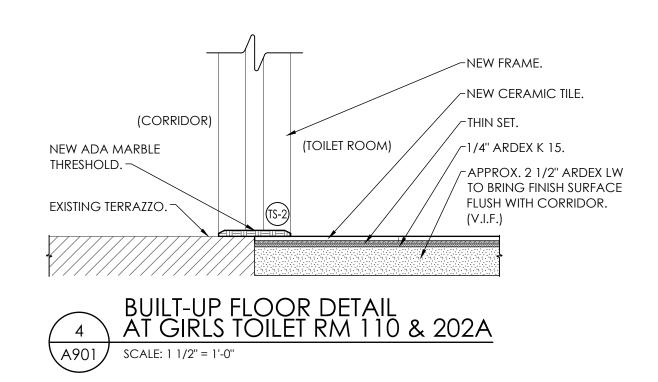


AS PER SCHEDULE

2 DOOR FRAME TYPES

 \backslash A901 / SCALE: N.T.S.

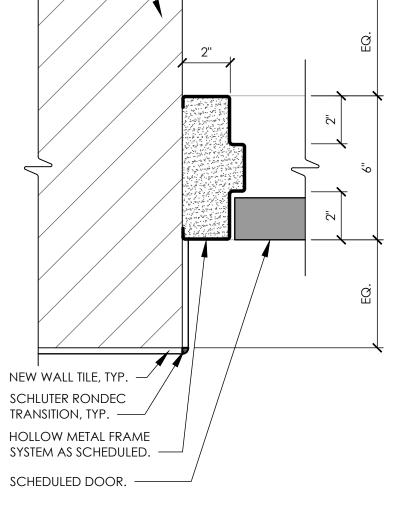



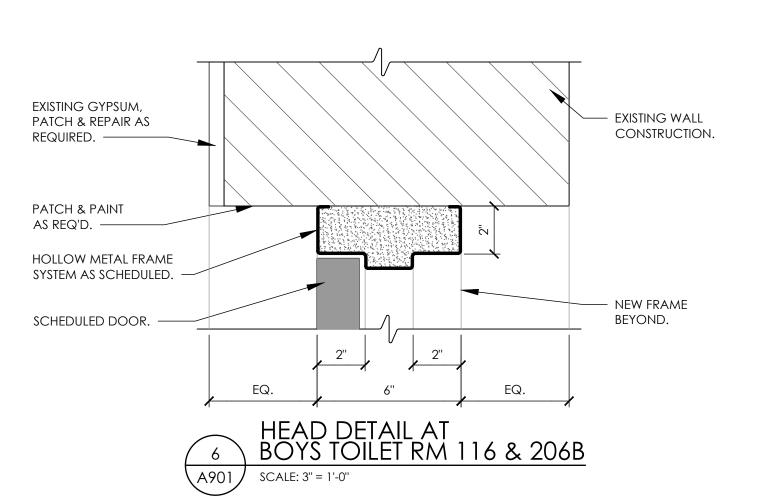

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PROJECT INFORMATION

OSSINING UNION FREE SCHOOL

400 EXECUTIVE BLVD OSSINING, NY 10562

Project Number 14428.18

DISTRICT Project Name

2021-2022 CIP

District Office Address

Multiple Building Names

ROOSEVELT ES SED# 66-14-01-03-0-005-022

PROJECT ISSUE & REVISION SCHEDULE

No. Date Description

SHEET INFORMATION Issued

Scale 11/15/2021 AS INDICATED Project Status BID SET Drawn By Checked By AW Drawing Title

DOOR SCHEDULE, DOOR TYPES & DOOR FRAME TYPES

Drawing Number

1. ALL FLOOR FINISHES SHALL TRANSITION AT CENTERLINE OF DOOR, UNLESS OTHERWISE NOTED.

2. ALL LOUVERS, VENTS, GRILLES AND OTHER MISC. MECHANICAL & ELECTRICAL DEVICES ARE TO BE PAINTED TO MATCH SURFACE ON WHICH THEY APPEAR, UNLESS OTHERWISE NOTED.

3. ALL HOLLOW METAL DOORS AND DOOR FRAMES WITHIN SCOPE OF WORK TO BE PAINTED AS NOTED ON FINISH SCHEDULE. WHERE ONLY ONE SIDE OF DOOR IS WITHIN SCOPE, PAINT FRAME TO CENTER OF

4. REFER TO ARCHITECTURAL ELEVATIONS FOR CERAMIC WALL TILE PATTERNING.

5. PROVIDE MARBLE THRESHOLD TS-2 AT ALL TOILET ROOM DOORS UNLESS NOTED OTHERWISE.

6. WHERE KICKSPACES OCCUR AT MILLWORK, FLOOR FINISH SHOWN ON PLANS SHALL RUN UNDERNEATH KICKSPACE UNLESS OTHERWISE

7. REFER TO A600 SERIES DRAWINGS FOR CEILING TYPES AND SOFFIT FINISHES. UNDERSIDE OF SOFFITS TO MATCH FACE OF SOFFIT. PAINT ALL GWB CEILINGS AS NOTED ON FINISH SCHEDULE.

8. ALL OUTSIDE CORNERS OF WALL TILE TO RECEIVE METAL TRIM TR-3 BY SCHLUTER SYSTEMS OR EQUAL, AS NOTED ON FINISH SCHEDULE. 9. WALL TILE TO BE APPLIED OVER EXISTING CMU TO HEIGHTS NOTED


ON ELEVATIONS. USE MANUFACTURER'S RECOMMENDED SPECIALTY

CT--|X--ETR

ADHESIVE FOR THESE APPLICATIONS. 10. WHERE NEW WALL TILE ENDS OR DOES NOT EXTEND TO CEILING, USE TR-1 AT EDGE UNLESS OTHERWISE NOTED.

11. WHERE NEW WALL TILE TRANSITIONS TO NEW FLOOR TILE USE TR-2 COVE TRANSITION.

FINISH SYMBOLS LEGEND & ABBREVIATIONS

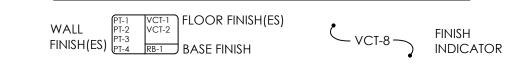


ACOUSTICAL CEILING TILE PT AFF ABOVE FINISHED FLOOR RB AWP ACOUSTIC WALL PANEL SGT CMU CONCRETE MASONRY UNIT SSM CERAMIC TILE **EPOXY PAINT** EPX **EPOXY FLOORING** GRT GROUT GWB GYPSUM WALL BOARD VCT HPL INT HIGH PRESSURE LAMINATE WF **INTEGRAL BASE** LVT LUXURY VINYL TILE WG

CT

EPT

RESILIENT BASE STRUCTURAL GLAZED TILE SOLID SURFACE MATERIAL SHEET VINYL **TOILET PARTITION** TRIM PIECE TRANSITION VINYL COMPOSITION TILE WINDOW FILM WINDOW TREATMENT WALL GRAPHIC

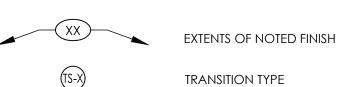

1201 SCALE: 1/4" = 1'-0"

FLOORING DIRECTION

FLOORING TRANSITION

FINISH PLAN KEYED NOTES

(1) LATEX PAINT CMU WALL TO MATCH NEW.

COORDINATING 2X2 MOSAIC TILE CT-2 TO BE USED

AROUND FLOOR DRAIN SEE TYPICAL DETAIL 2/1250 AROUND FLOOR DRAIN. SEE TYPICAL DETAIL 2/1250

3 INSTALL (4) COLOR WALL TILE PATTERN 6' HIGH THROUGHOUT ALL TOILET ROOM WALLS & WINDOW SILLS UNLESS OTHERWISE NOTED. SEE TYPICAL PATTERN 1/I250 FOR MORE INFORMATION. PAINT REMAINING GYP. ABOVE WITH EPT-1.

 $\langle 4 \rangle$ PAINT/ STAIN EXISTING DOOR & FRAME.



PROJECT INFORMATION Project Number

14428.18

OSSINING UNION FREE SCHOOL DISTRICT

2021-2022 CIP


District Office Address 400 EXECUTIVE BLVD OSSINING, NY 10562


ANNE M. DORNER MS SED# 66-14-01-03-0-008-028 ROOSEVELT ES SED# 66-14-01-03-0-005-022 OSSINING HS SED# 66-14-01-03-0-003-043


Multiple Building Names


PROJECT ISSUE & REVISION SCHEDULE

No. Date Description

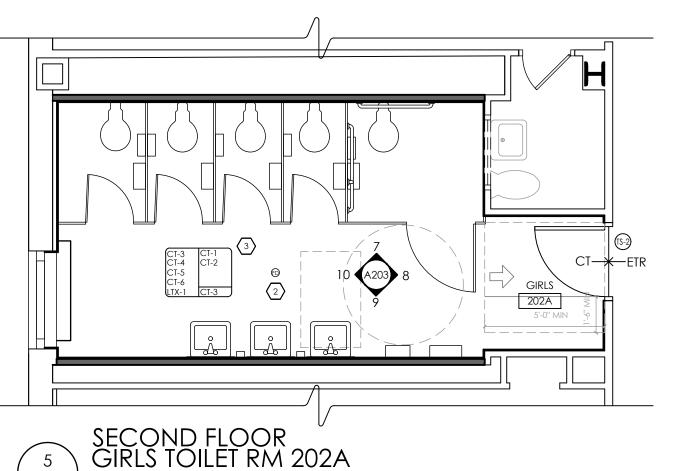

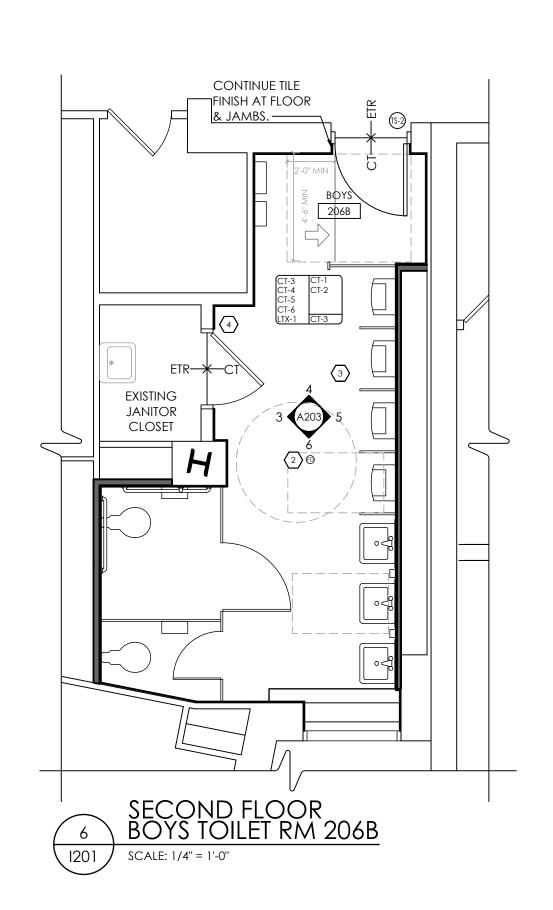


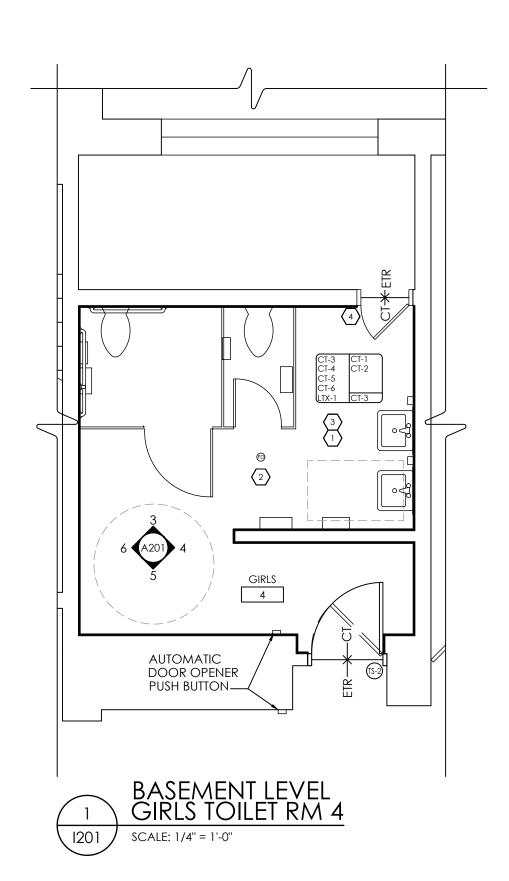

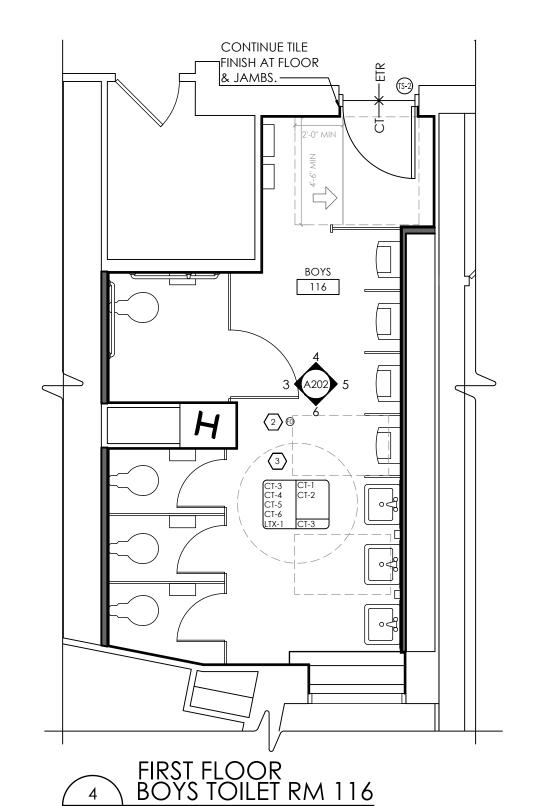

FIRST FLOOR
GIRLS TOILET RM 110

1201 SCALE: 1/4" = 1'-0"

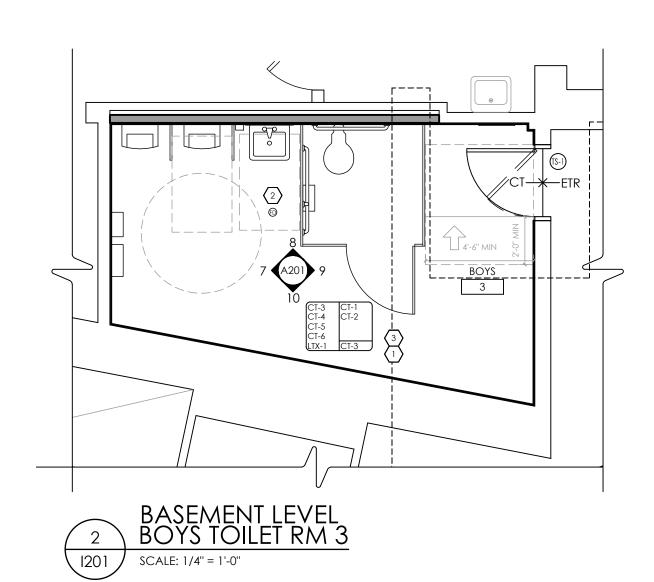

TOILET ROOM FINISH PLANS

AS INDICATED


SHEET INFORMATION

Issued

11/15/2021 Project Status BID SET Drawn By AW

Drawing Title



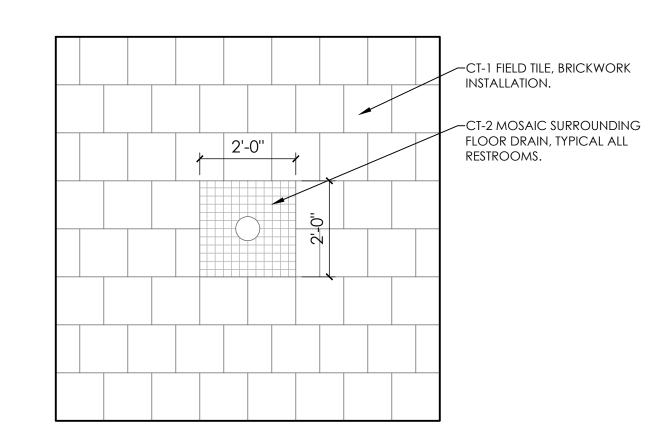

2 TYPICAL TOILET ROOM FLOOR TILE DETAIL AT DRAIN
SCALE: 1/2" = 1'-0"

				FINISH S	CHEDULE	
FINISH CODE	MANUFACTURER	STYLE/PATTERN	COLOR	SIZE	ADDITIONAL REQUIREMENTS	REMARKS
ACOUSTICAL CEILIN	G TILE	1				
ACT-1	ARMSTRONG	FINE FISSURED, SQUARE LAY-IN	WHITE	24" X 24"	REFER TO SPECIFICATIONS	TYPICAL CEILING TILE
CERAMIC TILE						
CT-1	MILESTONE / FLORIM	BASALTILE	COORDINATE WITH OWNER	12" x 12"	STAGGERED BRICK PATTERN INSTALL; 10MM THICK; RECTIFIED EDGES; 3/16" GROUT JOINT; DCOF > 0.42	FLOOR TILE - ALL TOILET ROOMS TYPICAL
CT-2	MILESTONE / FLORIM	BASALTINE	COORDINATE WITH OWNER	2" × 2"		FLOOR TILE - ALL TOILET ROOMS NEAR FLOOR DRAINS TYPICAL
CT-3	DALTILE	COLOR WHEEL LINEAR	SEMI-GLOSS COORDINATE WITH OWNER	6" x 18"	3/8" THICK 1/8" GROUT JOINT	FIELD WALL TILE - TOILET ROOMS TYPICAL
CT-4	DALTILE	COLOR WHEEL LINEAR	MATTE COORDINATE WITH OWNER	6" x 18"	3/8" THICK 1/8" GROUT JOINT	ACCENT WALL TILE - TOILET ROOMS TYPICAL
CT-5	DALTILE	COLOR WHEEL LINEAR	MATTE COORDINATE WITH OWNER	6" x 18"	3/8" THICK 1/8" GROUT JOINT	ACCENT WALL TILE - TOILET ROOMS TYPICAL
CT-6	DALTILE	COLOR WHEEL LINEAR	MATTE COORDINATE WITH OWNER	6" x 18"	3/8" THICK 1/8" GROUT JOINT	ACCENT WALL CAP TILE - TOILET ROOMS TYPICAL
LATEX PAINT						
LTX-1	SHERWIN WILLIAMS	PRO INDUSTRIAL WATERBASED CATALYZED EPOXY	COORDINATE WITH OWNER	-	PREP WITH 1CT EXTREME BOND PRIMER AND 2CTS PAINT	GENERAL WALL COLOR - ALL TOILET ROOMS
GROUT						
GRT-1	LATICRETE	TBD	COORDINATE WITH OWNER	-		TYPICAL AT TOILET ROOM FLOOR TILE (CT-1, CT-2)
GRT-2	LATICRETE	TBD	COORDINATE WITH OWNER	-		TYPICAL AT TOILET ROOM WALL TILE (CT-3, CT-4, CT-5, CT-6)
TRANSITIONS						
TS-1	N/A	ADA COMPLIANT MARBLE THRESHOLD		N/A	REFER TO SPECIFICATIONS	USED AT BOYS TOILET RM 3
TS-2	N/A	ADA COMPLIANT MARBLE THRESHOLD		N/A	REFER TO SPECIFICATIONS	TYPICAL AT ALL FLOOR TILE LOCATIONS
TR-1	SCHLUTER	JOLLY	AGTB	N/A		TYPICAL AT ALL PLACES NEW TILE TERMINATES
TR-2	SCHLUTER	DILEX-AHK	AGTB	N/A		TYPICAL AT NEW WALL TILE TO NEW FLOOR TILE
TR-3	SCHLUTER	RONDEC	AGTB	N/A		TYPICAL AT ALL OUTSIDE CORNER OF WALL TILE
TR-4	SCHLUTER	DILEX-AKHA	AGTB	N/A		TYPICAL AT NEW TILE TO EXISTING FLOOR

CPL | Architecture Engineering Planning 50 Front St. Suite 202 Newburgh, NY 12550

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PROJECT INFORMATION

14428.18

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OSSINING UNION FREE SCHOOL DISTRICT

Project Name 2021-2022 CIP

District Office Address

400 EXECUTIVE BLVD OSSINING, NY 10562

Multiple Building Names ANNE M. DORNER MS SED# 66-14-01-03-0-008-028

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Scale 11/15/2021 AS INDICATED Project Status BID SET

Drawn By Checked By AW Drawing Title FINISH SCHEDULE & TYPICAL

PATTERN DETAILS

Drawing Number

					HVAC SYMBOLS LIST					
SYMBOL	DESCRIPTION	SYMBOL	DESCRIPTION	SYMBOL	DESCRIPTION	SYMBOL	DESCRIPTION		SYMBOL	DESCRIPTION
AAD	AUTOMATIC AIR DAMPER	<u>пр</u> -	CONNECTION - TOP	STWBOL (DBL)	DOUBLE WALL LINED DUCT	STMBOL	DESCRIPTION	——————————————————————————————————————	STANBOL ☑	ELECTRIC/PNEUMATIC SWITCH OR RELAY
ACC	AIR-COOLED CONDENSING UNIT	- 				24X12 —12X10		1-1/2 TIMES BRANCH SIZE		
AD	ACCESS DOOR	- ' + '	CONNECTION - BOTTOM	20/10	DUCT SECTION - SUPPLY		SUPPLY / RETURN / EXHAUST AIR	12X10 7		PNEUMATIC/ELECTRIC SWITCH OR RELAY
AFF	ABOVE FINISHED FLOOR		DIRECTION OF FLOW	20/10	DUCT SECTION - RETURN/EXHAUST	VD VD	TAKEOFFS	VD VD		CURRENT TRANSDUCER
AHU	AIR HANDLING UNIT		REDUCER	S A"	DUCT SECTION - ROUND DUCT IN INCHES	<u></u>			<u> </u>	OPEN/CLOSED
BBD	BOILER BLOW DOWN		CAP OR PLUG	АХВ ГО	DUCT SECTION - FLAT OVAL DUCT IN INCHES	24X12		1-1/2 TIMES BRANCH SIZE	8	START/STOP
BD	BACKDRAFT DAMPER	 	ELBOW DOWN		ACOUSTIC THERMAL LINING		SUPPLY / RETURN / EXHAUST AIR	8,8 × × × × × × × × × × × × × × × × × ×	S	ENABLE/DISABLE
CA	COMPRESSED AIR	Ю	ELBOW UP		FLEXIBLE DUCTWORK		TAKEOFFS	VD VD	\overline{V}	TEMPERATURE SENSOR (DUCT OR PIPE MOUNTED)
CFM	COOLING COIL CONDENSATE DRAIN CUBIC FEET PER MINUTE		TEE OUTLET - UP			<u> </u>			\forall	HUMIDITY SENSOR (DUCT MOUNTED)
CHWR	CHILLED WATER RETURN	131	TEE OUTLET - DOWN	FC	FLEXIBLE CONNECTION	14"Ø		CONICAL TEE	F	FLOW TRANSMITTER
CHWS	CHILLED WATER SUPPLY	I	UNION			10"Ø	SUPPLY AIR	S CONICAL ILL	P	PRESSURE TRANSMITTER
CR	CONDENSER WATER RETURN	│	GATE VALVE	\dashv	FIRE DAMPER		TAKEOFFS	10'Ø	\\\\\\\\\\\\\\\\\\\\\\\\\\\\\\\\\\\\\\	DIFFERENTIAL PRESSURE TRANSMITTER
CS	CONDENSER WATER SUPPLY	δ	BALL VALVE		<u> </u>					ELECTRIC/PNEUMATIC TRANSDUCER
CW	DOMESTIC COLD WATER		BALANCING VALVE		SMOKE DAMPER	<u> </u>		\sim		ELECTRIC/ELECTRONIC TRANSDUCER
D	DRAIN	<u> </u>				14"Ø		LATERAL	h	
(E)	EXISTING	<u> </u>	STRAINER		COMPINATION FIRE AND SMOVE DAMPER		SUPPLY AIR TAKEOFFS	- 10.\\ \\ \\ \\ \\ \\ \\ \\ \\ \\ \\ \\ \\	(<u>\$</u>)	DUCT SMOKE DETECTOR
EA	EXHAUST AIR		STRAINER WITH BLOW-DOWN	3	COMBINATION FIRE AND SMOKE DAMPER	VD		VD VD	1	SPACE THERMOSTAT
EC	ELECTRICAL CONTRACTOR	₹		_	VOLUME DAMPER			<u> </u>	∇	SPACE TEMPERATURE SENSOR
ERHC	EXHAUST FAN ELECTRIC REHEAT COIL		BUTTERFLY VALVE	L _{VD}	VOLUME DAMFER	24X12		24X12	△ _{CO2}	SPACE CARBON DIOXIDE SENSOR
ETR	EXISTING TO REMAIN		BUTTERFLY CONTROL VALVE, PNEUMATIC 2-WAY		DAMPER CONTROL, PARALLEL BLADE	6X12 - 12X10	SUPPLY AIR	18X12 12X10	△ _{CH4}	SPACE NATURAL GAS SENSOR
EUH	ELECTRIC UNIT HEATER	0.1450	BUTTERFLY CONTROL VALVE, ELECTRIC ACTUATOR		DAMPER CONTROL, OPPOSED BLADE	18X12	TAKEOFFS	20X12	△ _{co}	SPACE CARBON MONOXIDE SENSOR
F&T	FLOAT AND THERMOSTATIC TRAP	———	GLOBE VALVE	1		20X12			$\nabla_{\!$	SPACE SENSOR WITH GUARD
FCU	FAN-COIL UNIT	<u> </u>	CHECK VALVE	 	AUTOMATIC AIR DAMPER	24X12	alibaly (alice)	1000	Н	SPACE HUMIDISTAT
FPM	FEET PER MINUTE	<u> </u>	TRIPLE DUTY VALVE	AAD	AAD	12X10	SUPPLY/RETURN EXHAUST AIR	24X12	FS	WATER FLOW SENSOR
FT	FIN-TUBE	\ \ \ \ \	GAS COCK, PLUG VALVE			· VD	TAKEOFFS W/ REGISTER/GRILLE/	VD VD		PNEUMATIC ACTUATOR
GC	GENERAL CONTRACTOR	- U/C	UNDERCUT DOOR 1"	BDD	BACK DRAFT DAMPER	3	DIFFUSER			ELECTRIC ACTUATOR
GR	GLYCOL SURDLY		LOUVERED DOOR W/ SQ. FT. OF FREE AREA					<u></u>	VSD VFD	VARIABLE SPEED / FREQUENCY DRIVE
GS HC	GLYCOL SUPPLY HVAC CONTRACTOR	<u></u>	AIR VENT - MANUAL		BLAST GATE	T VD	SUPPLY/RETURN	VD	C\\\\\\\\\\\\\\\\\\\\\\\\\\\\\\\\\\\\\	
HHWR	HEATING HOT WATER RETURN	 		l _{BG}	BG	<u> </u>	EXHAUST AIR END OF MAIN		<u> </u>	COOLING COIL
HHWS	HEATING HOT WATER SUPPLY	<u></u> Ŷ^A	AIR VENT - AUTOMATIC	20/10	12X10	T VD	BRANCH TAKEOFFS		<u>/</u> c	HEATING COIL
НР	HEAT PUMP		FLANGE	12X10	AIR DUCT (FIRST FIGURE IS DUCT WIDTH/TOP,			VD	Z _F	GAS FURNACE
HPC	HIGH PRESSURE CONDENSATE	B	CONTROL/SOLENOIND VALVE, ELECTRIC 2-WAY		SECOND FIGURE IS DUCT DEPTH)	T VD	CUPPLY (PETUPL)	I IVD	Н	HUMIDIFIER
HPS	HIGH PRESSURE STEAM		CONTROL VALVE, ELECTRIC 3-WAY		10/20 7		SUPPLY/RETURN (EXHAUST AIR	ke k	А	ALARM
LF	LINEAR FOOTAGE OF FIN-TUBE RADIATION	\$	CONTROL VALVE, PNEUMATIC 2-WAY	10/20 7		VD	END OF MAIN BRANCH TAKEOFFS	ND	S	STATUS
LPC	LOW PRESSURE CONDENSATE	<u> </u>	CONTROL VALVE, PNEUMATIC 3-WAY	**	MULTI-BLADE AIR EXTRACTOR	<u> </u>	BRANCH PARLOTTS	VD	FS	FLOW SWITCH
LPG	LIQUEFIED PROPANE GAS	学	CONTROL VALVE, I NEUMATIC 3-WAT		TURNING VANES			→	ΔΡ	DIFFERENTIAL STATIC PRESSURE SWITCH
LPS MBH	1,000 BTU/HR	*	RELIEF / SAFETY VALVE	-//////	EXISTING WORK TO BE REMOVED (HATCHED)	$\overline{}$	LONG RADIUS	W R	R	RELAY
MC	MECHANICAL CONTRACTOR		PRESSURE REDUCING VALVE	•	POINT OF CONNECTION		90° ELBOW R/W=1.5		\bigcirc	PRESSURE GAUGE
MPC	MEDIUM PRESSURE CONDENSATE		VACUUM BREAKER	O —	POINT OF DISCONNECTION				FZ	FREEZE-STAT
MPS	MEDIUM PRESSURE STEAM		FLEXIBLE PIPE CONNECTOR	E	AIR FLOW SENSOR					DIGITAL INPUT (TO BUILDING MANAGEMENT SYSTEM)
MRD	MONOFLO FITTING DOWN – HHWR			<u> </u>			LONG RADIUS	W R		· · · · · · · · · · · · · · · · · · ·
MSD	MONOFLO FITTING DOWN – HHWS		EXPANSION COMPENSATOR W/ GUIDES	N N	FILTER		45° ELBOW R/W=1.5		<u>□</u> □ □ □ □ □ □ □ □ □ □ □ □ □ □ □ □ □ □	DIGITAL OUTPUT (FROM BUILDING MANAGEMENT SYSTEM)
MUW	MAKE-UP WATER		EXPANSION JOINT		TRANSITION SQUARE TO ROUND		R/W-1.5	,	<u></u>	ANALOG OUTPUT (FROM BUILDING MANAGEMENT SYSTEM)
NC	NORMALLY CLOSED	×	PIPE ANCHOR							ANALOG INPUT (TO BUILDING MANAGEMENT SYSTEM)
NG	NATURAL GAS		PIPE GUIDE	_	HUMIDIFIER DISPERSION TUBE		000 512 5111	₼		
NO NTS	NORMALLY OPEN NOT TO SCALE		THERMOSTATIC TRAP	K			90° ELBOW WITH TURNING			ELECTRICAL INTERFACE
OA	OUTSIDE AIR	FT	FLOAT & THERMOSTATIC TRAP	RISE	RISE IN DUCT		VANES	7 *\frac{1}{2}	SF	SPEED FEED BACK
PC	PLUMBING CONTRACTOR	BT	BUCKET TRAP		NISE III DUCI				ES	END SWITCH
PD	PUMP DISCHARGE		THERMODYNAMIC TRAP	DRÔP		Y			PF	POSITION FEEDBACK
PHWR	PRIMARY HEATING HOT WATER RETURN		THERMOMETER	D	DROP IN DUCT	18X16 — 18X8	90 VERTICAL SPLIT OFF	18X8 -	~	TRAVERSE AVERAGING SENSOR
PHWS	PRIMARY HEATING HOT WATER SUPPLY	<u> </u>	WELL		SQUARE CEILING DIFFUSER (4 WAY)	\ \ \ \ \ \ \ \ \ \ \ \ \ \ \ \ \ \ \	(PLAN VIEW)	18X16 18X8	•—	PROBE SENSOR
RA	RETURN AIR		PRESSURE GAUGE	<u> </u>	ROUND CEILING DIFFUSER	18X8				FREEZE STAT SENSOR
RD	REFRIGERANT DISCHARGE	\bigcirc			SQUARE OR RECTANGULAR CEILING GRILLE	20X10 20X10				<u> </u>
RHC	HOT WATER REHEAT COIL	}	STEAM PRESSURE GAUGE WITH 1/4" NEEDLE VALVE	/ 1		20X10 20X10	DUCT TURNING UP OR DOWN	20X10		
RLL	REFRIGERANT LIQUID PIPE		<u> </u>		SUPPLY REGISTER, RETURN OR EXHAUST GRILLE		AIR TERMINAL UNIT-DUC			
RSL	REFRIGERANT SUCTION PIPE ROOFTOP UNIT		PRESSURE GAUGE WITH 1/4" NEEDLE VALVE		SUPPLY DIFFUSER, 1-WAY, 2-WAY, 3-WAY	U MAX MIN	U - UNIT TYPE MAX = MAXIMUM CFM			
RV	ROOF VENT	<u> </u>	WITH 1/4 NEEDLE VALVE	1-WAY 2-WAY 3-WAY			MIN = MINIMUM CFM			
SA	SUPPLY AIR		PNEUMATIC (CONTROL) TUBING	8"Ø, D-3	CEILING DIFFUSER WITH NECK SIZE, TYPE, & CFM	U GPM MAX	AIR TERMINAL UNIT-DUC			
SHWR	SECONDARY HEATING HOT WATER RETURN	 	BUTTERFLY VALVE WITH PNEUMATIC AND MANUAL OPERATORS	300 CFM	, , , , , , , , , , , , , , , , , , ,	[MAX]	GPM = GALLONS PER MI MAX = MAXIMUM GPM	N		
SHWS	SECONDARY HEATING HOT WATER SUPPLY	xx	PIPING		CEILING RETURN OR EXHAUST GRILLE	- Live	FAN POWERED AIR TERMINAL UNIT			
SSI	SPLIT SYSTEM INDOOR SECTION (EVAPORATOR SECTION)	xx	PIPING BELOW GRADE	10"x10", G-3 300 CFM	WITH SIZE, TYPE, & CFM	U MAX U MIN FAN	U - UNIT TYPE MAX = PRIMARY MAX C			
\$\$0	SPLIT SYSTEM OUTDOOR SECTION (CONDENSING UNIT)	.——	BASE MOUNTED PUMP	10"x8", R-2	SUPPLY REGISTER		MIN = PRIMARY MIN CFA FAN = FAN CFM			
-	TEMPERATURE CONTROLS CONTRACTOR		IN-LINE PUMP	300 CFM	WITH SIZE, TYPE, & CFM	TURE				
TC		 		-	1	TYPE COIL SIZE	TYPE = VALANCE TYPE COIL SIZE = COIL LENGTH	н		
UH	UNIT HEATER		AIR TERMINAL UNIT WITH		RETURN OR EXHAUST CRULE					
UH	UNIT HEATER UNIT VENTILATOR		AIR TERMINAL UNIT WITH REHEAT COIL AND SOUND	10"x8", G-2 300 CFM	RETURN OR EXHAUST GRILLE WITH SIZE, TYPE, & CFM	CLNG GPM HTNG GPM	CLNG GPM = COOLING HTNG GPM = HEATING G	GPM		
UH UV V	UNIT HEATER UNIT VENTILATOR VENT		AIR TERMINAL UNIT WITH REHEAT COIL AND SOUND ATTENUATOR	300 CFM '	WITH SIZE, TYPE, & CFM	CLNG GPM HTNG GPM	CLNG GPM = COOLING HTNG GPM = HEATING G	GPM GPM	_	
UH	UNIT HEATER UNIT VENTILATOR		AIR TERMINAL UNIT WITH REHEAT COIL AND SOUND	300 CFM	AIR FLOW	CLNG GPM HTNG GPM	CLNG GPM = COOLING	GPM GPM TYPE		
UH UV V WAHP	UNIT HEATER UNIT VENTILATOR VENT WATER-TO-AIR HEAT PUMP		AIR TERMINAL UNIT WITH REHEAT COIL AND SOUND ATTENUATOR AIR TERMINAL UNIT WITH SOUND ATTENUATOR AIR TERMINAL UNIT WITH	300 CFM 1	AIR FLOW ACOUSTIC/THERMAL DUCTWORK LINING - 1 INCH THICK	CLNG GPM	CLNG GPM = COOLING HTNG GPM = HEATING G X = DIFFUSER OR GRILL	GPM GPM TYPE		
UH UV V WAHP	UNIT HEATER UNIT VENTILATOR VENT WATER-TO-AIR HEAT PUMP		AIR TERMINAL UNIT WITH REHEAT COIL AND SOUND ATTENUATOR AIR TERMINAL UNIT WITH SOUND ATTENUATOR	300 CFM	AIR FLOW ACOUSTIC/THERMAL DUCTWORK LINING -	CLNG GPM HTNG GPM	CLNG GPM = COOLING HTNG GPM = HEATING G X = DIFFUSER OR GRILL	GPM GPM TYPE		

LINING - 2 INCH THICK

WALL TO WALL FIN TUBE ENCLOSURE


ACOUSTIC/THERMAL DUCTWORK PLENUM

SYMBOLS GENERAL NOTES:

1) VALVE AND DAMPER ACTUATOR TYPES (ELECTRIC OR PNEUMATIC) WHICH ARE INDICATED IN HVAC TEMPERATURE CONTROL DRAWINGS SHALL SUPERSEDE TYPE INDICATED ON ALL OTHER HVAC DRAWINGS.

HVAC CONTRACTOR GENERAL NOTES:

- A. IT IS THE RESPONSIBILITY OF THE CONTRACTOR TO FIELD VERIFY EXISTING CONDITIONS WITHIN THE BUILDING PRIOR TO COMMENCEMENT OF ALL DEMOLITION AND NEW WORK.
- B. IT IS THE RESPONSIBILITY OF THE CONTRACTOR TO REMOVE AND REPLACE EXISTING CEILINGS, UNLESS OTHERWISE NOTED ON THE ARCHITECTURAL DRAWINGS, FOR PERFORMING DEMOLITION OR NEW WORK WITHIN THE BUILDING. THE EXISTING CEILINGS SHALL BE REMOVED IN A MANNER TO AVOID DAMAGE TO THE CEILING SYSTEMS. STORAGE OF CEILING SYSTEM COMPONENTS FOR REINSTALLATION IS THE RESPONSIBILITY OF THE CONTRACTOR. THE STORAGE OF ALL MATERIAL SHALL BE IN AREAS OR LOCATIONS APPROVED BY THE OWNER. THE OWNER WILL NOT COMPENSATE FOR ANY DAMAGED OR LOST MATERIAL WHILE IN STORAGE. AFTER COMPLETION OF ALL DEMOLITION OR NEW WORK, THE CONTRACTOR SHALL REINSTALL THE CEILING SYSTEMS TO MATCH THE ORIGINAL INSTALLATION.
- C. DEMOLITION DRAWINGS SHOW MAJOR EQUIPMENT, PIPING, AND DUCTWORK REMOVALS. THE INTENT IS NOT TO IDENTIFY ALL MISCELLANEOUS PIPING, PIPING ACCESSORIES, DUCTWORK, DUCTWORK ACCESSORIES, SUPPORTS, CONTROLS, CONTROL ACCESSORIES, CONTROL WIRING, CONDUIT, AND PNEUMATIC CONTROL TUBING TO BE DISCONNECTED AND REMOVED, BUT IS THE REQUIREMENT UNDER THIS CONTRACT. NO EQUIPMENT, PIPING, OR DUCTWORK SHALL BE ABANDONED IN PLACE, UNLESS OTHERWISE NOTED ON THE DRAWINGS.
- D. ALL EQUIPMENT INDICATED TO BE TURNED OVER TO THE OWNER SHALL BE DISCONNECTED AND REMOVED FROM THE EXISTING SYSTEMS AND DELIVERED (INCLUDING LOADING AND UNLOADING) TO A STORAGE AREA WITHIN THE BUILDING AS SELECTED BY THE OWNER. IT WILL BE THE RESPONSIBILITY OF THE CONTRACTOR TO REPAIR ANY EQUIPMENT DAMAGED DURING REMOVAL AND DELIVERY. ANY DAMAGE TO EQUIPMENT PRIOR TO DISCONNECTING SHOULD BE REPORTED TO THE OWNER'S REPRESENTATIVE. IF NOT REPORTED, THE CONTRACTOR TAKES FULL RESPONSIBILITY FOR REPAIRS TO THE EQUIPMENT.
- E. BEFORE DISCONNECTING, REMOVING, OR SERVICING ANY AIR CONDITIONING EQUIPMENT OR SYSTEMS CONTAINING REFRIGERANTS, THE EQUIPMENT OR SYSTEMS SHALL BE EVACUATED OF ALL REFRIGERANT PER THE LATEST ADOPTED RULES AND REGULATIONS BY THE UNITED STATES ENVIRONMENTAL PROTECTION AGENCY (EPA). THE CONTRACTOR OR TECHNICIAN PERFORMING THE WORK SHALL BE CERTIFIED BY AN EPA APPROVED CERTIFYING AGENCY OR ORGANIZATION.
- F. ALL DUCTWORK, PIPING, AND CONDUIT PENETRATIONS THROUGH RATED WALLS OR FLOORS SHALL BE PROVIDED WITH FIRE/SMOKE STOPPINGS PER SPECIFICATION. REFER TO CODE ANALYSIS DRAWING FOR ALL RATED WALL LOCATIONS. ALL FLOORS SHALL BE CONSIDERED RATED.
- G. UNLESS SHOWN ON THE ARCHITECTURAL DRAWINGS, IT IS THE RESPONSIBILITY OF THIS CONTRACT TO PATCH AND FINISH ALL EXISTING DUCTWORK OR PIPE PENETRATIONS THROUGH FLOORS, ROOFS, INTERIOR WALLS, AND EXTERIOR WALLS AFTER DEMOLITION WORK. IN ADDITION, ALL NEW PENETRATIONS SHALL BE PROVIDED FOR INSTALLATION OF MECHANICAL SYSTEMS INCLUDING, BUT NOT LIMITED TO, EQUIPMENT, CURBING, DUCTWORK, PIPING, CONTROLS, ETC. PATCHING AND FINISHING SHALL MATCH EXISTING CONSTRUCTION INCLUDING FIRE RATINGS. PROVIDE LINTELS PER LINTEL SCHEDULE.
- H. IT IS NOT THE INTENT OF THE DRAWINGS TO SHOW ALL AIR VENTS AND DRAINS IN THE PIPING SYSTEMS. IT IS THE RESPONSIBILITY OF THE CONTRACTOR TO PROVIDE AIR VENTS AT ALL SYSTEM HIGH POINTS AND AT AREAS WITHIN THE PIPING SYSTEMS THAT COULD ACCUMULATE OR TRAP AIR WHICH WOULD PREVENT PROPER VENTING OR OPERATION OF THE SYSTEMS. DRAINS SHALL BE PROVIDED AT ALL LOW POINTS WITHIN THE PIPING SYSTEM TO FACILITATE COMPLETE DRAINING OF THE SYSTEM.
- I. PROVIDE THERMAL EXPANSION COMPENSATORS AND THERMAL EXPANSION LOOPS IN PIPING SYSTEM PER INDUSTRY STANDARDS.

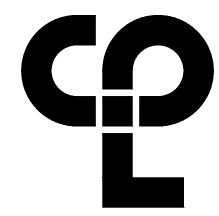

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PROJECT INFORMATION

Project Number 14428.18

OSSINING UNION FREE SCHOOL DISTRICT

2021-2022 CIP

District Office Address
400 EXECUTIVE BLVD OSSINING, NY 10562

OSSINING UNION FREE SCHOOL DISTRICT

ANNE M. DORNER MS SED# 66-14-01-03-0-008-028

ROOSEVELT ES SED# 66-14-01-03-0-005-022

OSSINING HS SED# 66-14-01-03-0-003-043

PROJECT ISSUE & REVISION SCHEDULE

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ENGINEER OR SURVEYOR IS ALTERED, THE ALTERING PARTY SHALL AFFIX TO THE
ITEM THEIR SEAL AND THE NOTATION" ALTERED BY FOLLOWED BY THEIR
SIGNATURE AND THE DATE OF SUCH ALTERATION, AND A SPECIFIC
DESCRIPTION OF THE ALTERATION.

Issued 11/15/2021

Project Status
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Drawn By
DJB

Drawn By Checked By
DJB AJS
Drawing Title
HVAC SYMBOLS LIST

Scale

AS NOTED

Drawing Number


<u>RES</u> H000

GENERAL NOTES:

1. MAINTAIN AND CLEAN EXISTING FIN TUBES IN GYMNASIUM.

- 1) REMOVE PIPE BACK TO MAIN AND PREP FOR NEW WORK.
- 2) REMOVE EXISTING FAN IN ITS ENTIRETY INCLUDING ASSOCIATED WIRING AND CONTROLS. REMOVE DUCT WORK TO POINT INDICATED. PREPARE FOR NEW WORK.

KEY PLAN

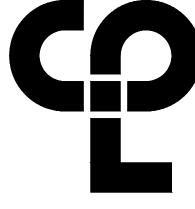

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PROJECT INFORMATION

14428.18

Project Number

OSSINING UNION FREE SCHOOL DISTRICT

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District Office Address 400 EXECUTIVE BLVD OSSINING, NY 10562

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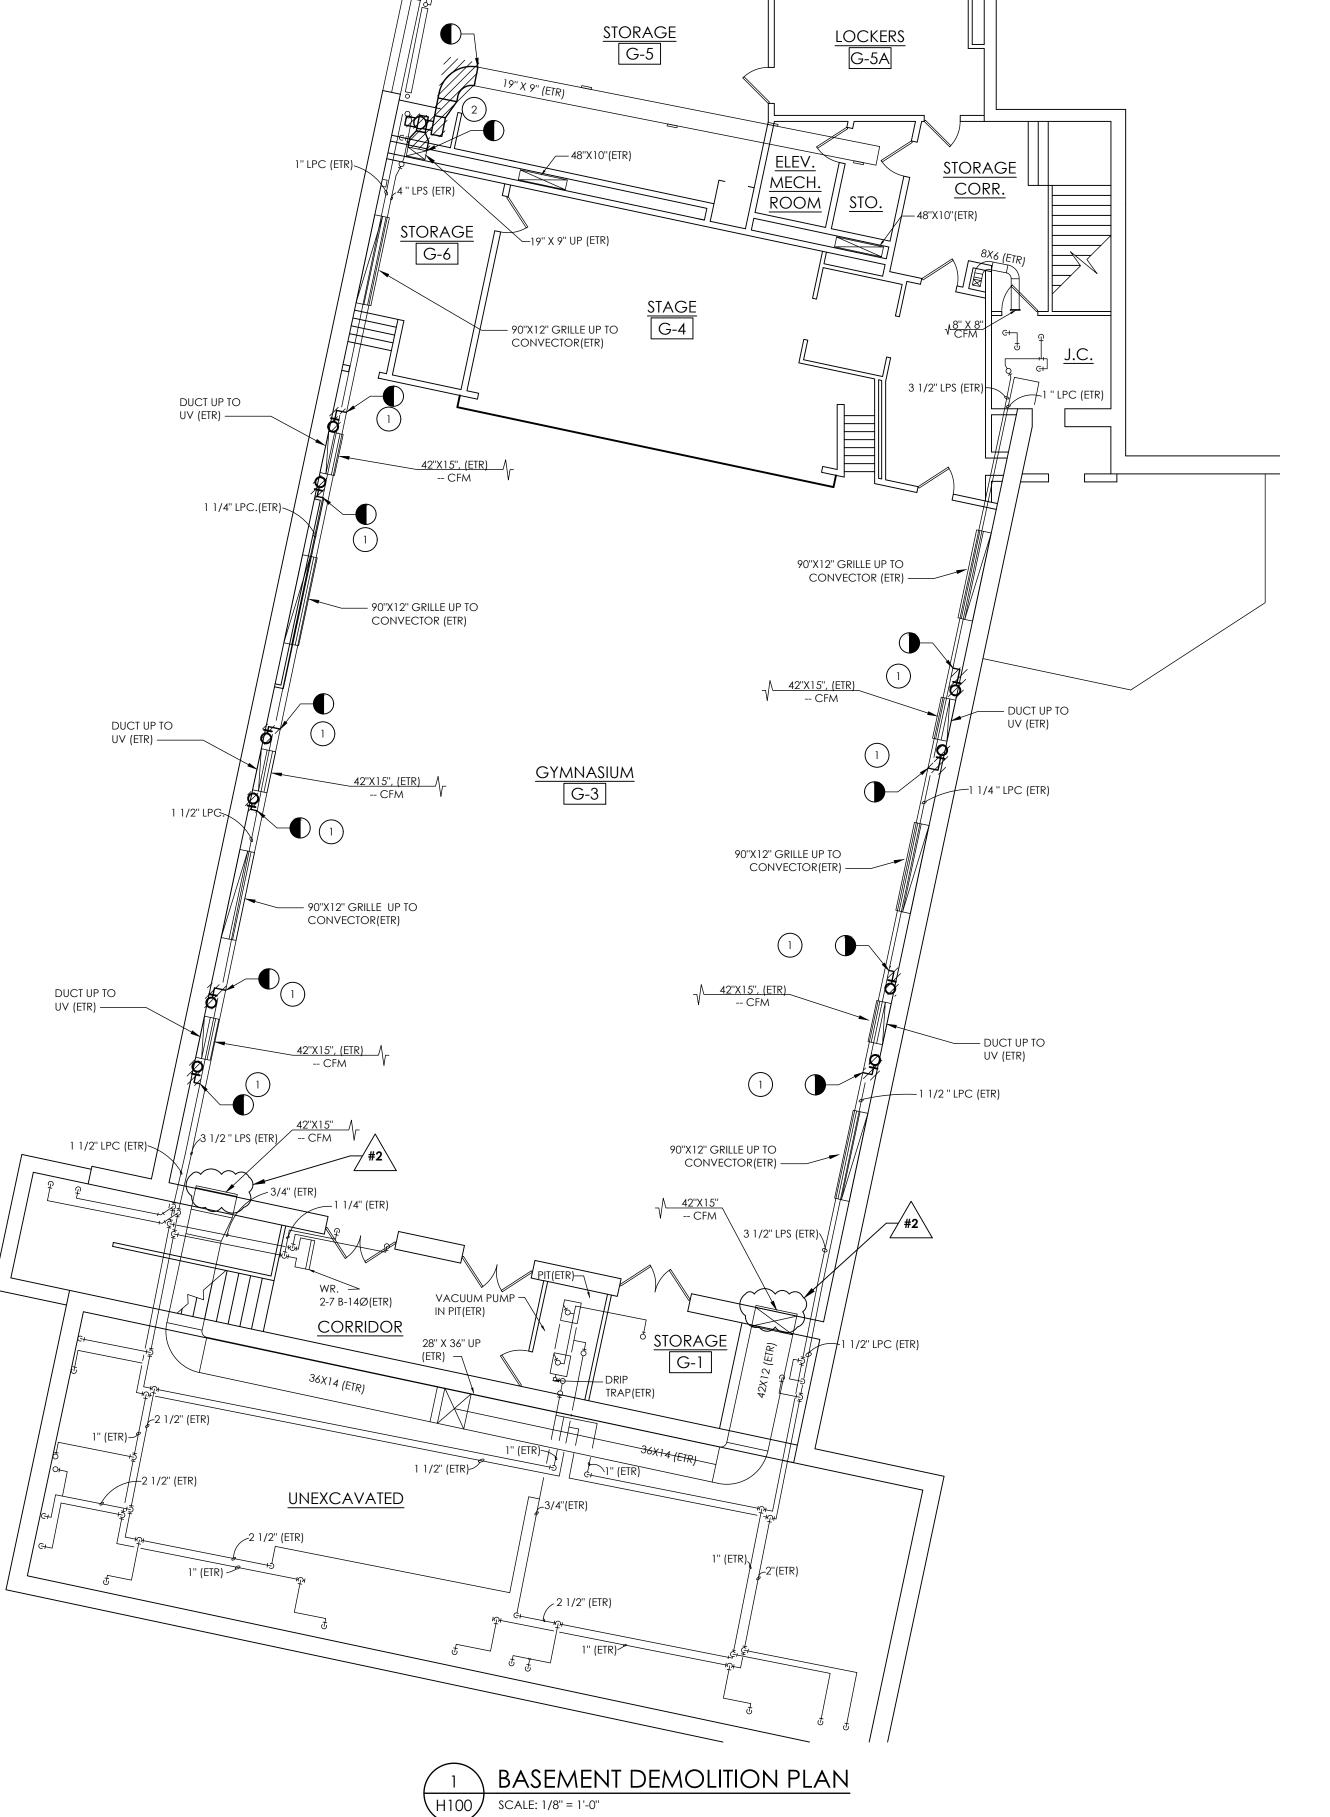
SHEET INFORMATION Issued

11/15/2021 1/8" - 1'-0" Project Status **BID SET** Drawn By Checked By

DJB AJS Drawing Title


BASEMENT FLOOR HVAC DEMOLITION PLAN

Drawing Number




- 1) REMOVE PIPE BACK TO MAIN BELOW AND PREP FOR NEW WORK. REMOVE WALL SECTIONS AS REQUIRED AND FILL WITH LIKE CONSTRUCTION.
- REMOVE ABANDONED DUCTWORK, CAP AT WALLS AND FLOORS, PREP FOR NEW WORK. FILL IN WALLS WITH LIKE CONSTRUCTION
- 3 REMOVE EXISTING FAN IN ITS ENTIRETY INCLUDING CONTROLS, WIRING AND DUCTWORK. PREPARE FOR NEW WORK.
- 4 REMOVE EXISTING U.V, SLEEVES, CONTROLS AND PREPARE FOR NEW WORK. EXISTING O.A LOUVER TO BE CLEANED AND REUSED.


STAGE BELOW 1 1/4" LPC (ETR) EXISTING CAPPED AND ABANDONED DUCT 1 1/2" LPS(ETR)

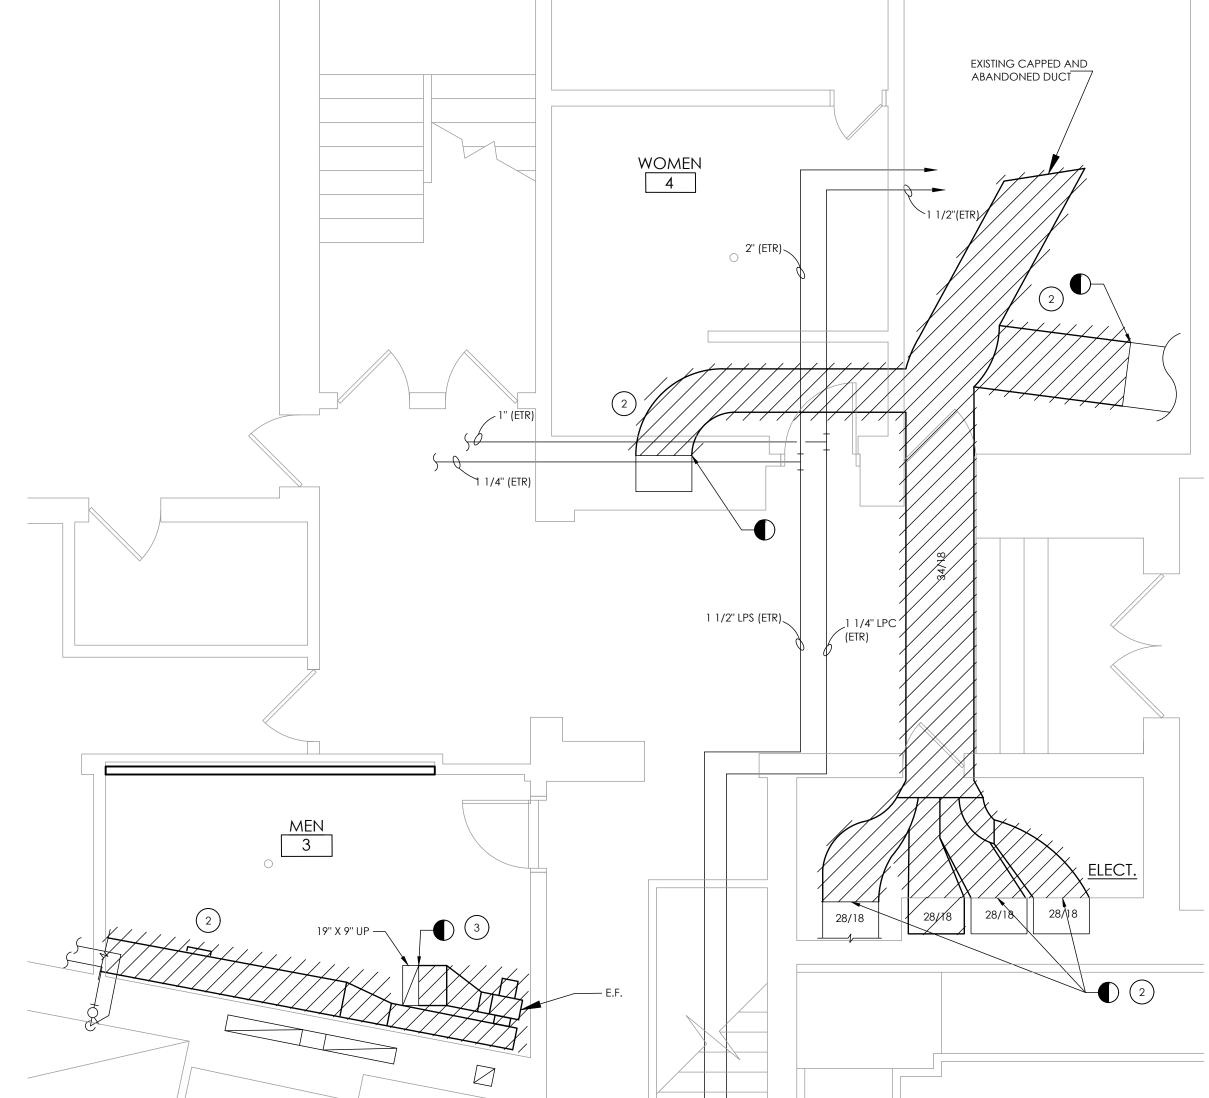

RES GROUND FLOOR TOILET ROOMS DEMOLITION PLAN H101 SCALE: 1/4" = 1'-0"

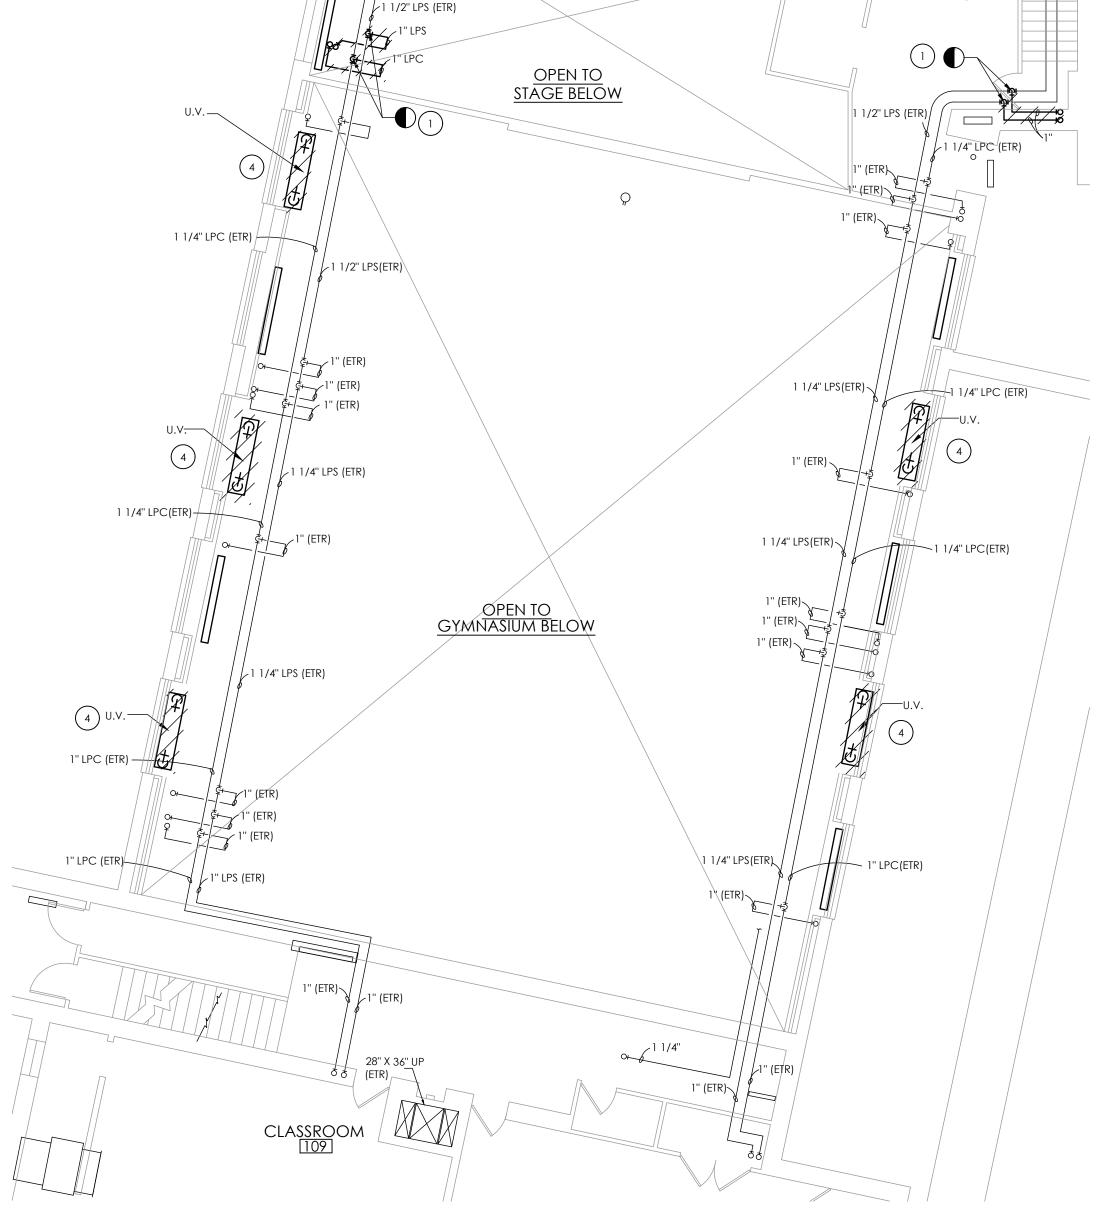

SCALE: 1/8" = 1'-0"

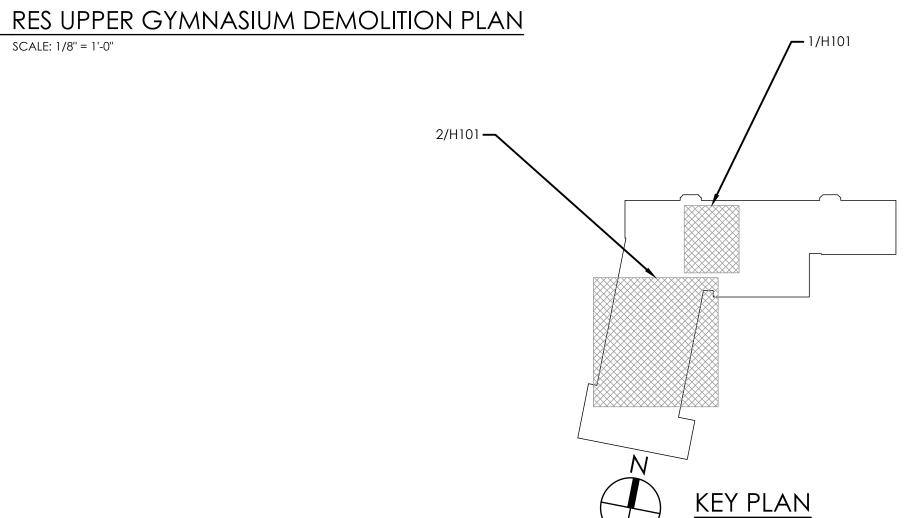

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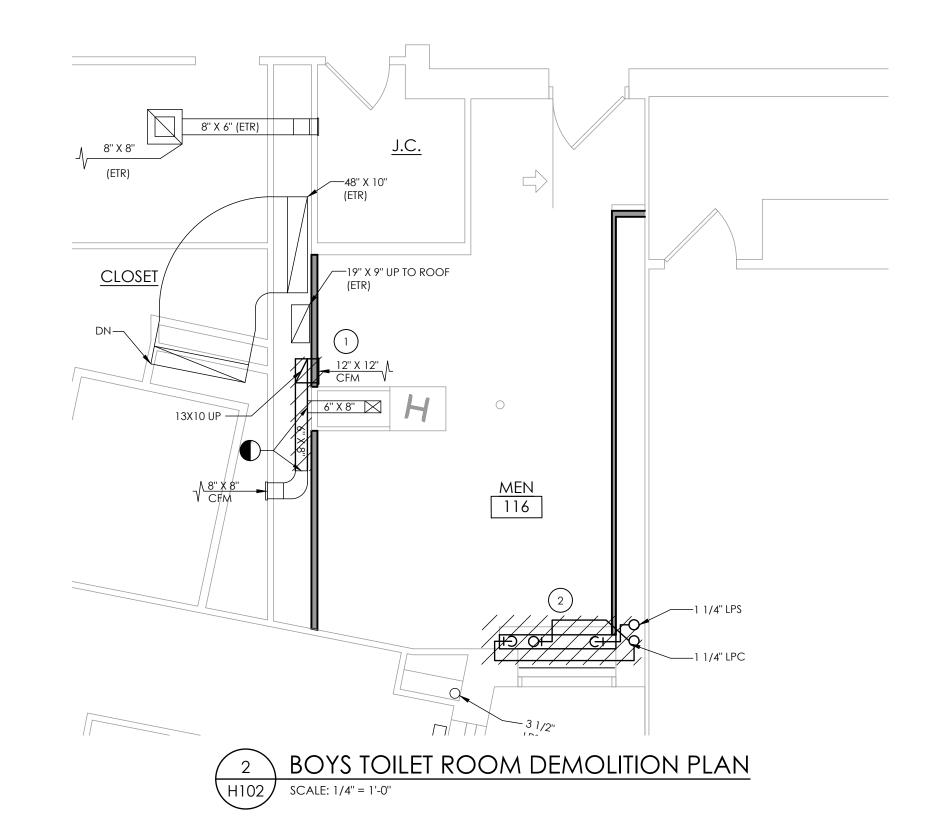
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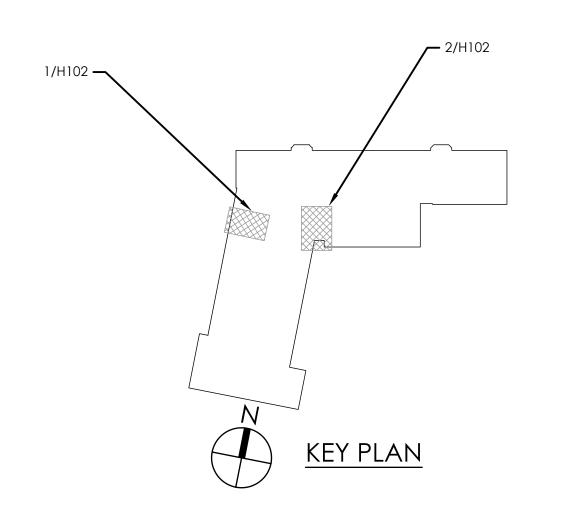
11/15/2021 AS NOTED Project Status **BID SET** Drawn By DJB

GROUND FLOOR HVAC DEMOLITION PLAN

REMOVE EXISTING RADIATOR IN ITS ENTIRETY INCLUDING ALL PIPING, CONTROLS AND THERMOSTAT. REMOVE PIPING BACK TO MAINS AND PREPARE FOR NEW WORK.

3 REMOVE EXISTING EXHAUST FAN IN IT ENTIRETY.







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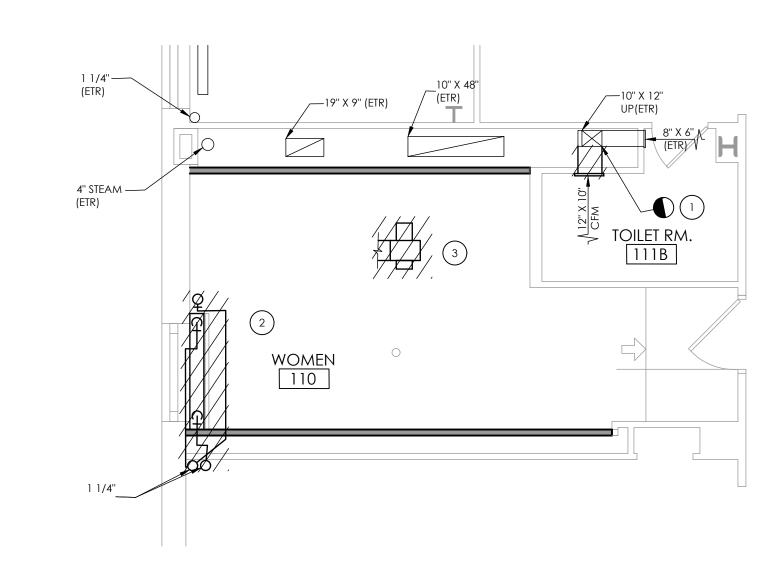
PROJECT ISSUE & REVISION SCHEDULE

No. Date Description

SHEET INFORMATION Issued

11/15/2021 1/4'' = 1'-0'' Project Status **BID SET** Drawn By DJB AJS Drawing Title

FIRST FLOOR HVAC DEMOLITION PLAN



H102 | SCALE: 1/4" = 1'-0"

GIRLS TOILET ROOM DEMOLITION PLAN

1) REMOVE EXISTING GRILLE, PREPARE FOR NEW WORK.


REMOVE EXISTING RADIATOR IN ITS ENTIRETY INCLUDING ALL PIPING, CONTROLS AND THERMOSTAT. REMOVE PIPING BACK TO MAINS AND PREPARE FOR NEW WORK.

REMOVE EXISTING DUCTWORK TO POINTS INDICATED. PREPARE FOR NEW WORK.

1 1/4" (ETR) 5" (ETR) 5" (ETR) ___ 9" X 8" DN STORAGE RM. 201A 4" (ETR) √ WOMEN 202A 16" X 7" UP — 17" X 10" UP TO EXH. ——— FAN IN MECHANICAL 206B ROOM

SECOND FLOOR TOILET ROOMS DEMOLITION PLAN

SCALE: 1/4" = 1'-0"

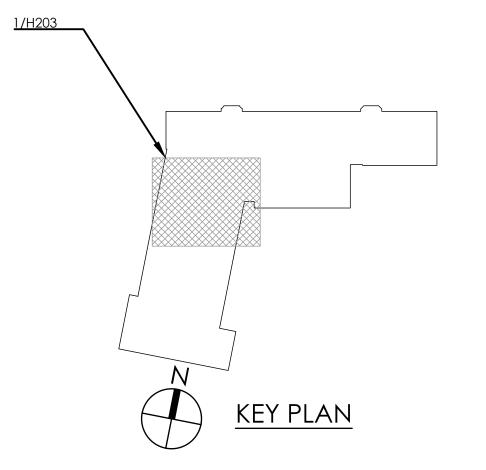

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PROJECT ISSUE & REVISION SCHEDULE

No. Date Description


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SHEET INFORMATION

Issued Scale
11/15/2021 AS NOTED
Project Status
BID SET
Drawn By Checked By
DJB AJS

Drawing Title
SECOND FLOOR HVAC
DEMOLITION PLAN




KEY NOTES:

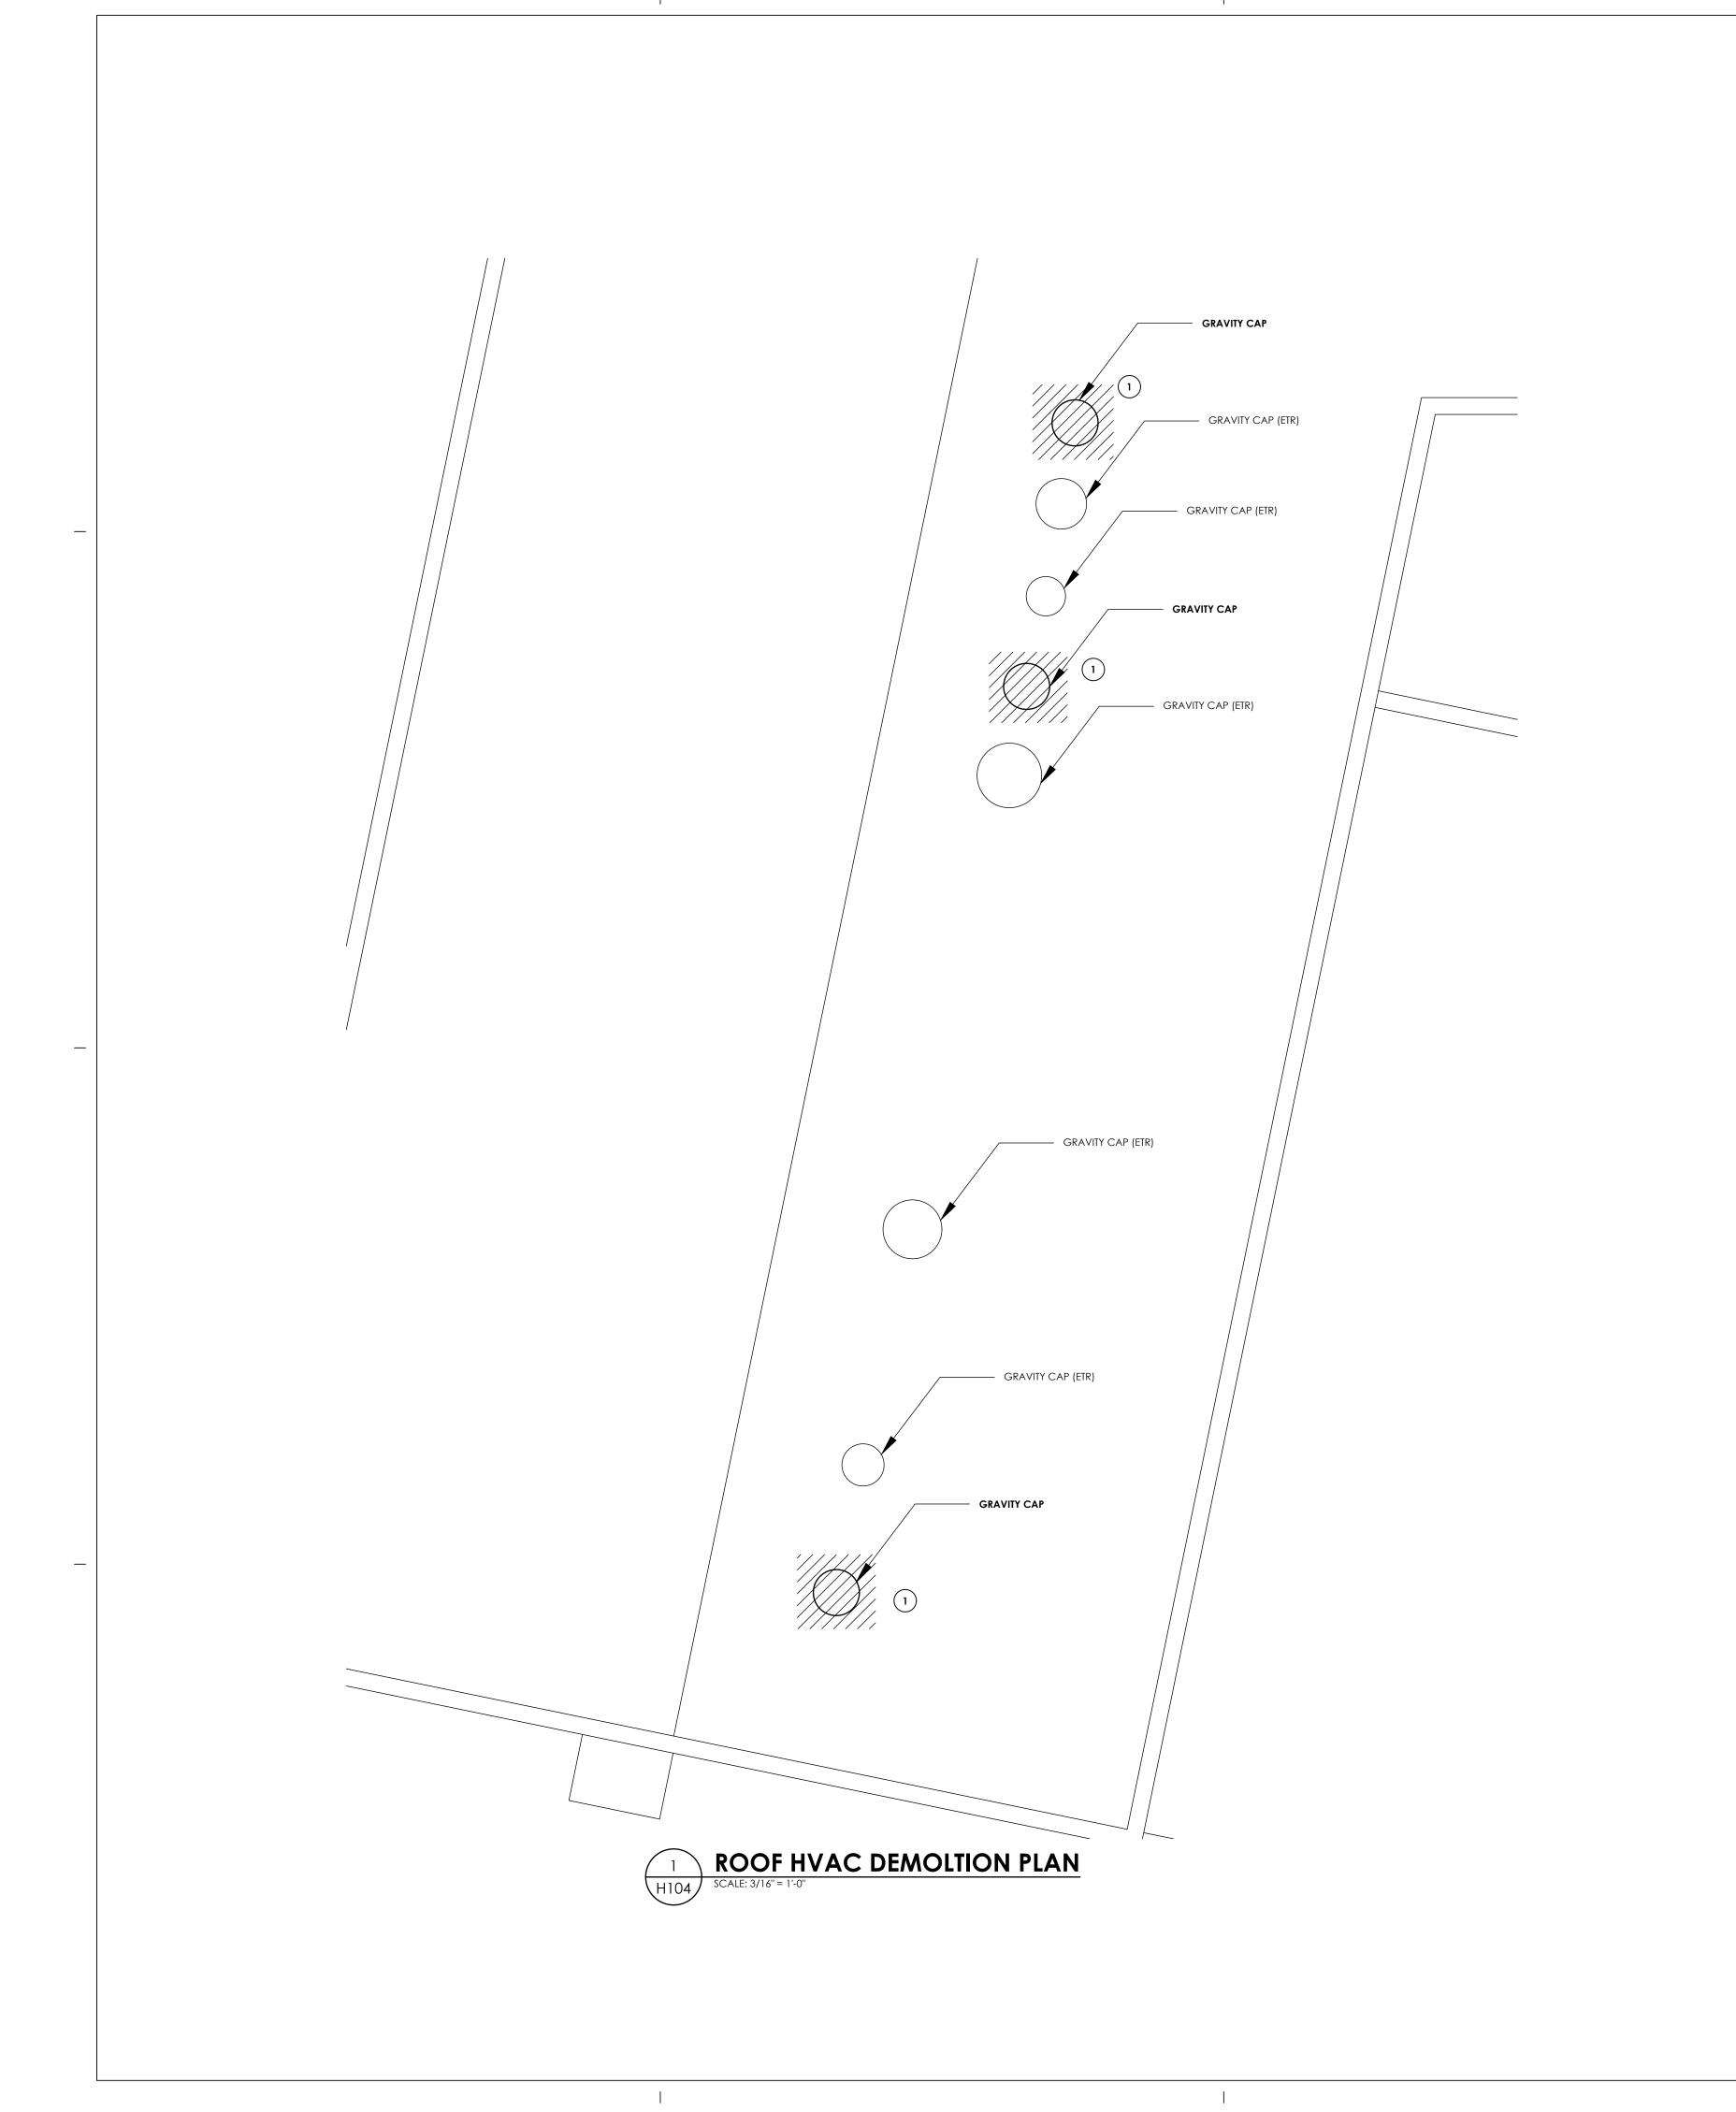
1) REMOVE EXISTING GRAVITY CAP AND PREPARE FOR NEW WORK.


2 REMOVE EXISTING DUCT WORK. PREPARE FOR NEW WORK.

3 REMOVE EXISTING EXHAUST FAN IN ITS ENTIRETY, PREPARE FOR NEW WORK.

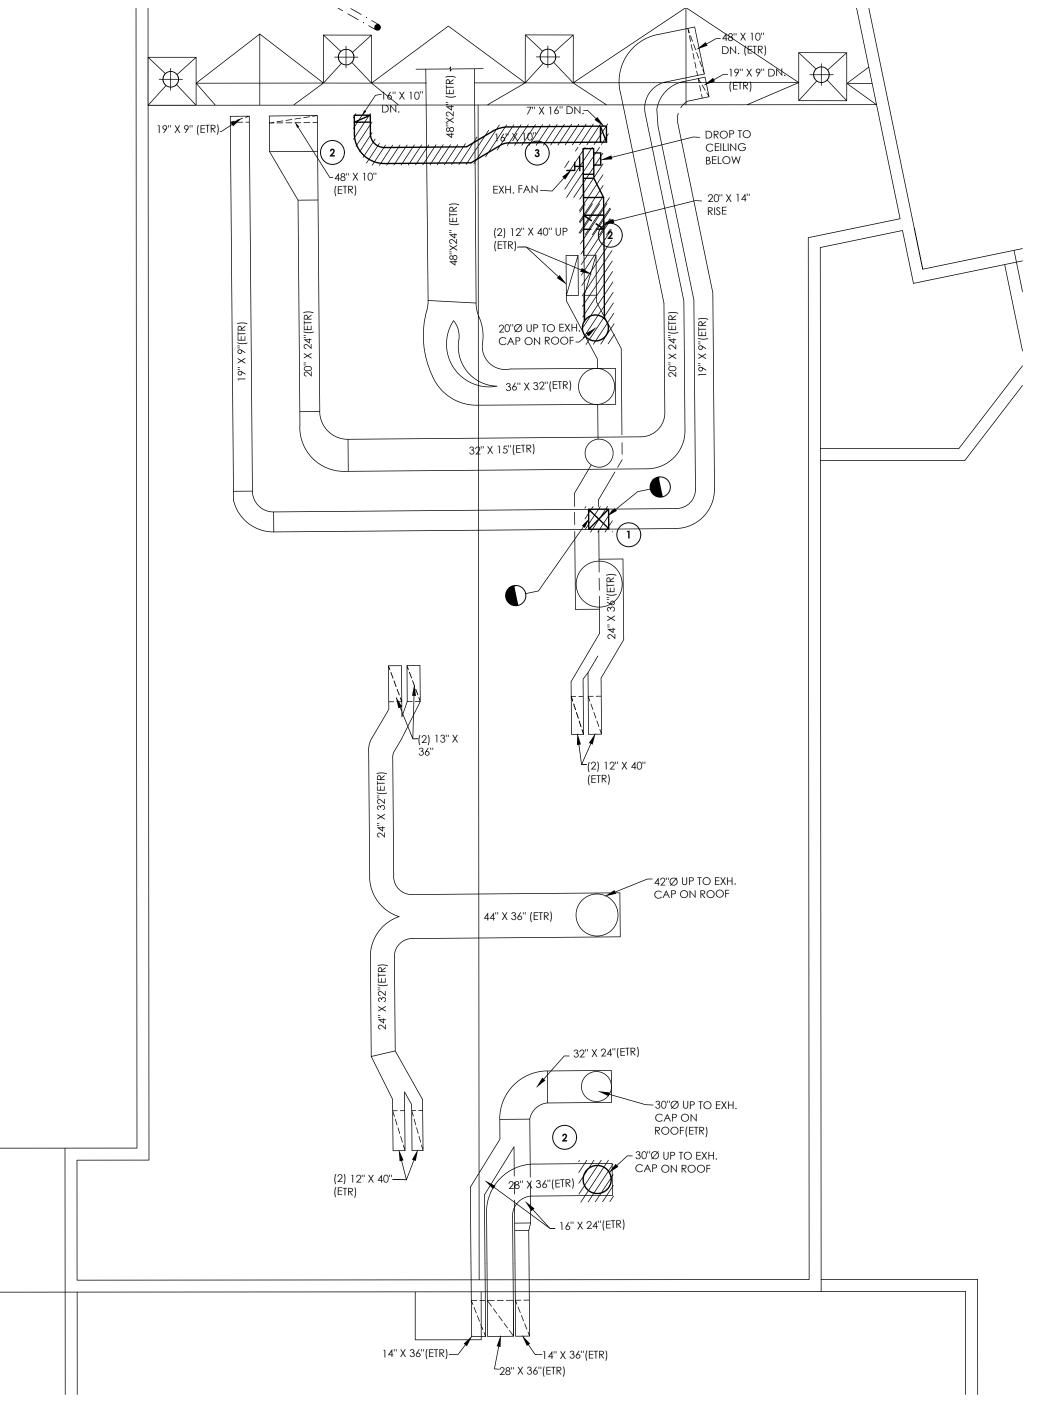



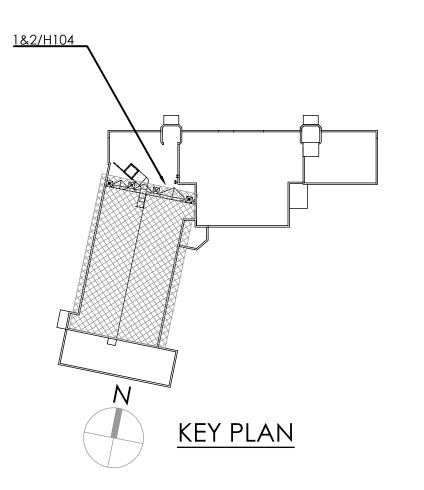

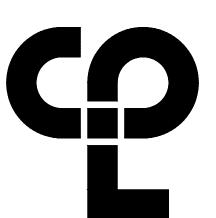

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SIGNATURE AND THE DATE OF SUCH ALTERATION, AND A SPECIFIC

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Issued Scale

11/15/2021 AS NOTED

Project Status

BID SET

Drawn By Checked By

DJB AJS

Drawing Title

ROOF HVAC DEMOLITION PLAN

Drawing Number

H200 SCALE: 1/8" = 1'-0"

GENERAL NOTES:

 MAINTAIN AND CLEAN EXISTING FIN TUBES AND DUCT SPACE TO UVS IN GYMNASIUM.

KEY NOTES:

- PROVIDE NEW DUCTWORK AS SHOWN AND RE-BALANCE.
 CONNECT TO EXISTING WHERE INDICATED.
- 2 CONNECT STEAM AND RETURN BRANCHES BACK TO MAINS WHERE INDICATED.
- 3 BALANCE EXISTING EXHAUST GRILLE.



PROJECT INFORMATION

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DESCRIPTION OF THE ALTERATION.

SHEET INFORMATION

BASEMENT LEVEL HVAC NEW PLAN


1 PROVIDE NEW GRILLE AND DUCTWORK.

2 CONNECT NEW DUCT WORK TO EXISTING DUCTS WHERE INDICATED.


3 PROVIDE NEW DIFFUSERS WITH SMOKE AND FIRE DAMPERS. DUCT TO BE PLACED ABOVE CEILING.


(4) CAP ABANDONED DUCT BRANCH.

5 PROVIDE NEW UNIT VENTILATORS. CONNECT STEAM AND CONDENSATE BACK TO MAIN. SEE DETAIL 6/H801.

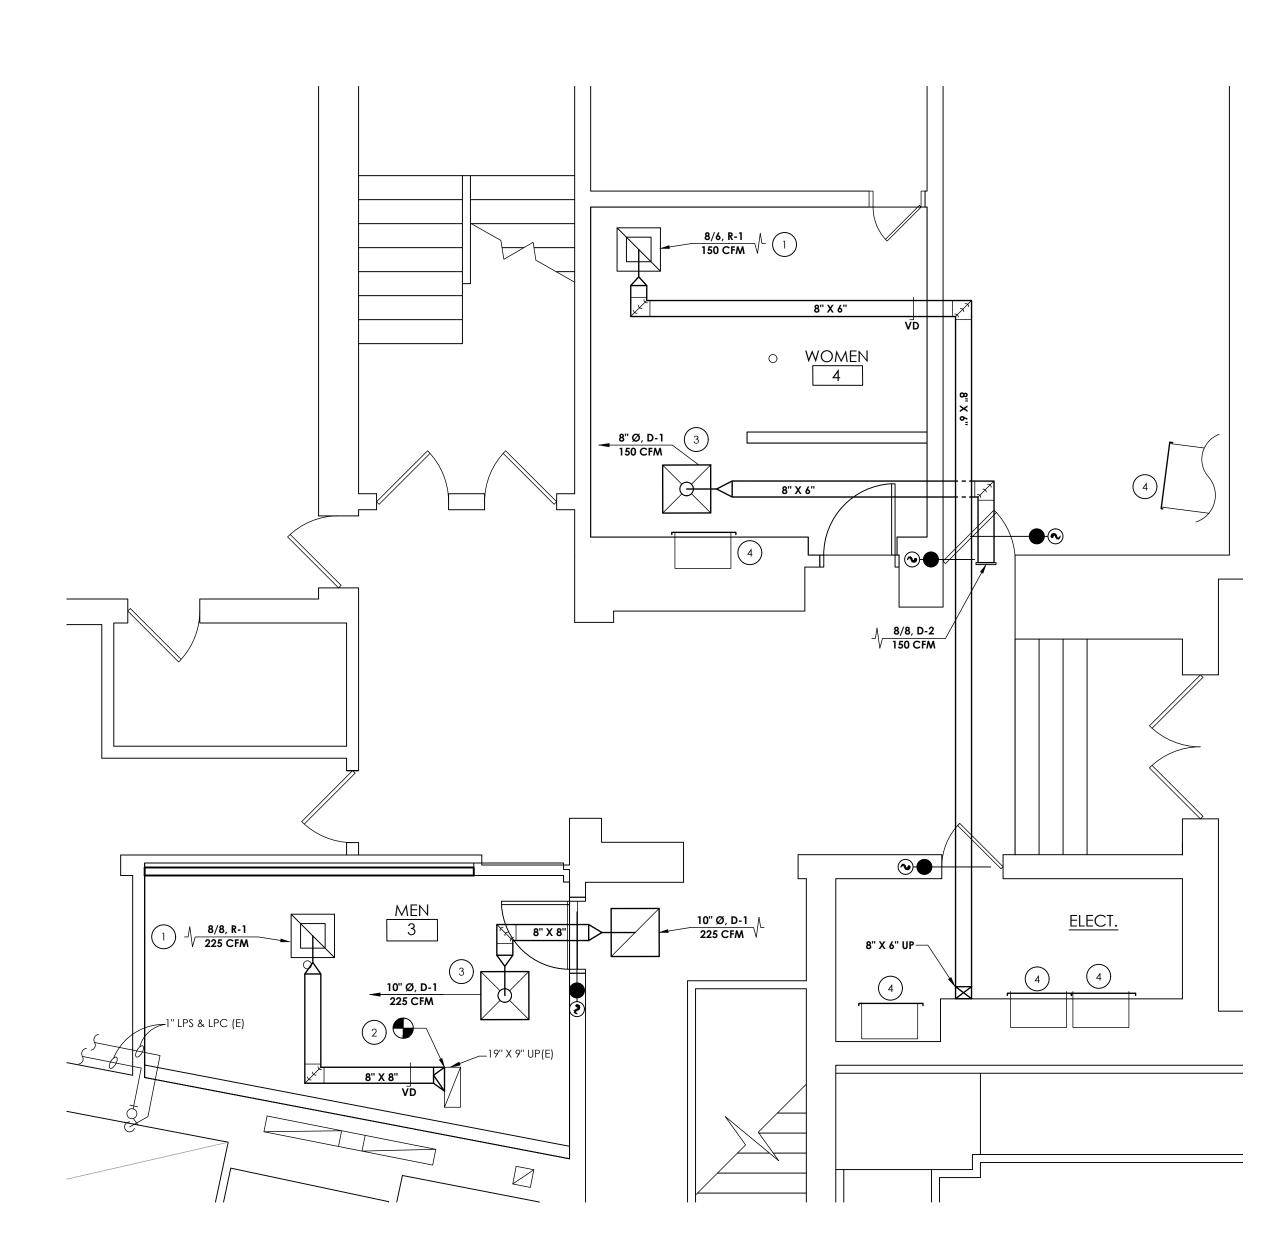

GROUND FLOOR TOILET ROOMS NEW PLAN
SCALE: 1/4" = 1'-0"

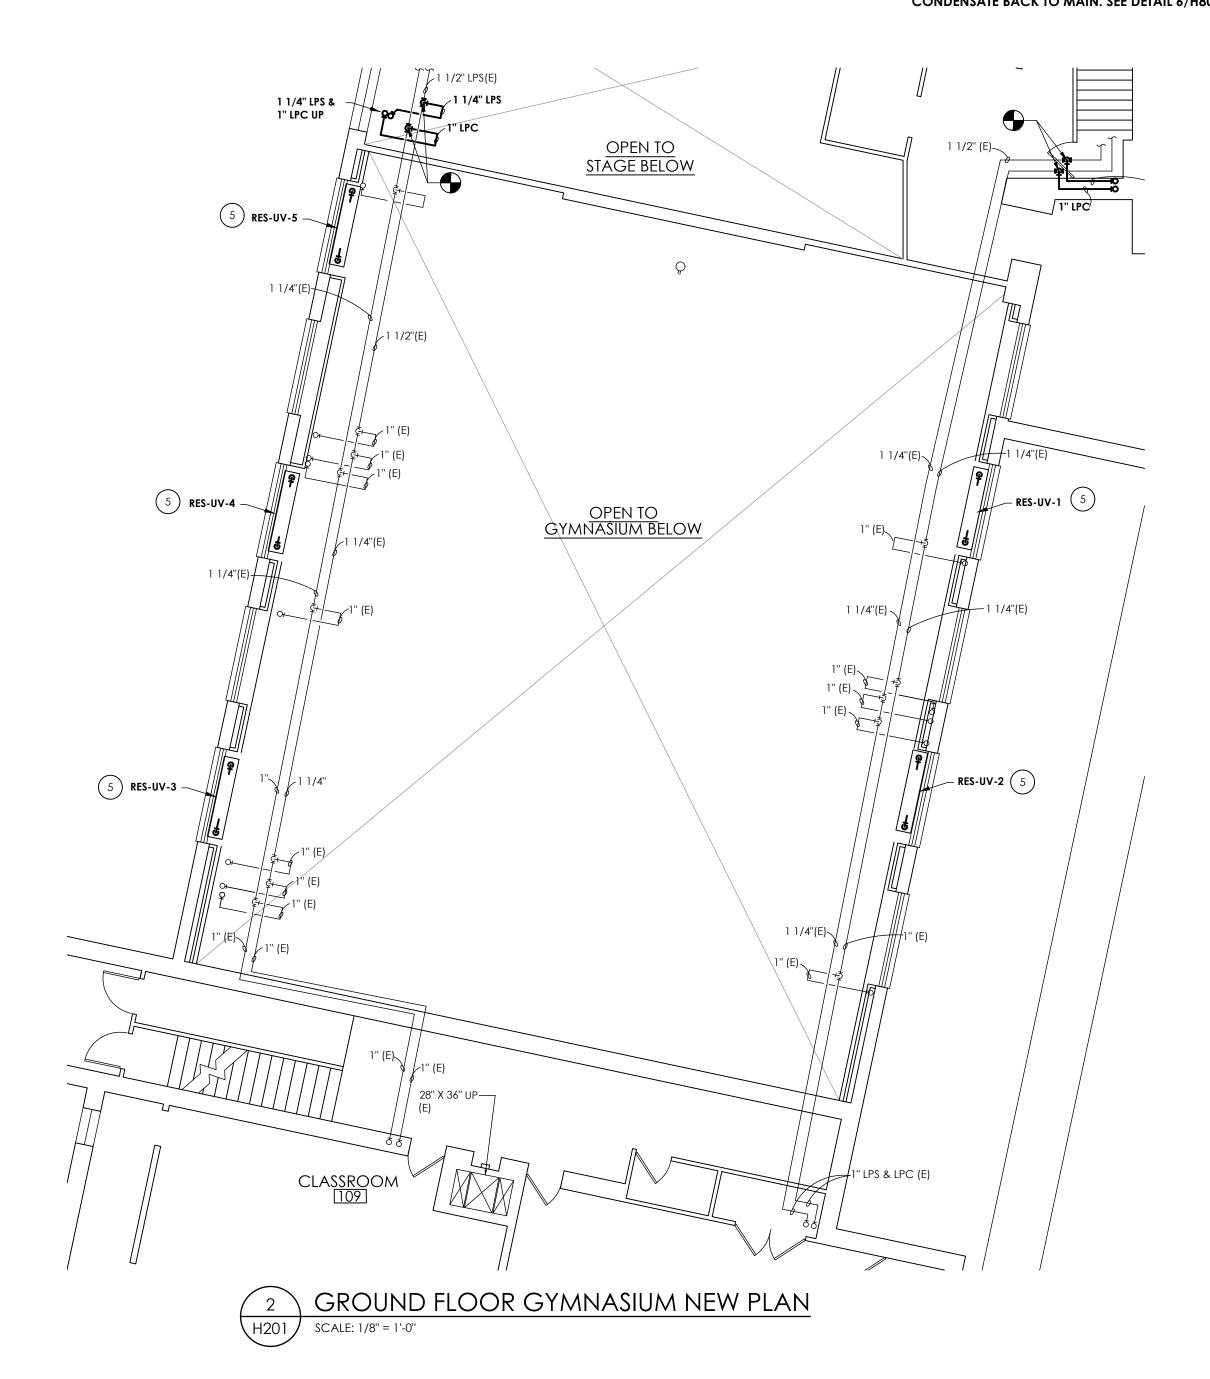

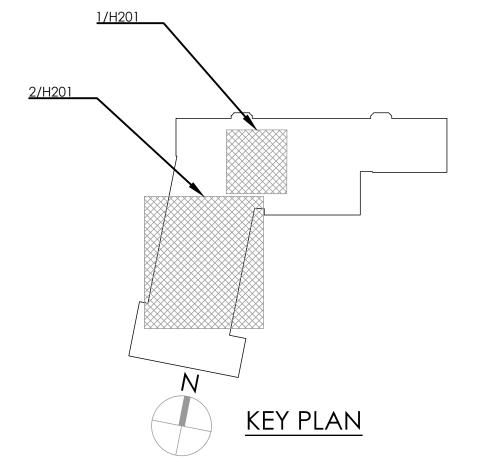

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PROJECT INFORMATION

14428.18

Project Number

OSSINING UNION FREE SCHOOL DISTRICT

2021-2022 CIP

District Office Address
400 EXECUTIVE BLVD OSSINING, NY 10562

OSSINING UNION FREE SCHOOL DISTRICT

ANNE M. DORNER MS SED# 66-14-01-03-0-008-028

ROOSEVELT ES SED# 66-14-01-03-0-005-022

OSSINING HS SED# 66-14-01-03-0-003-043

PROJECT ISSUE & REVISION SCHEDULE

No. Date Description

NEW YORK STATE EDUCATION STATEMENT
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SIGNATURE AND THE DATE OF SUCH ALTERETO BY AND A SPECIFIC

SHEET INFORMATION

Issued Scale

11/15/2021 AS NOTED

Project Status

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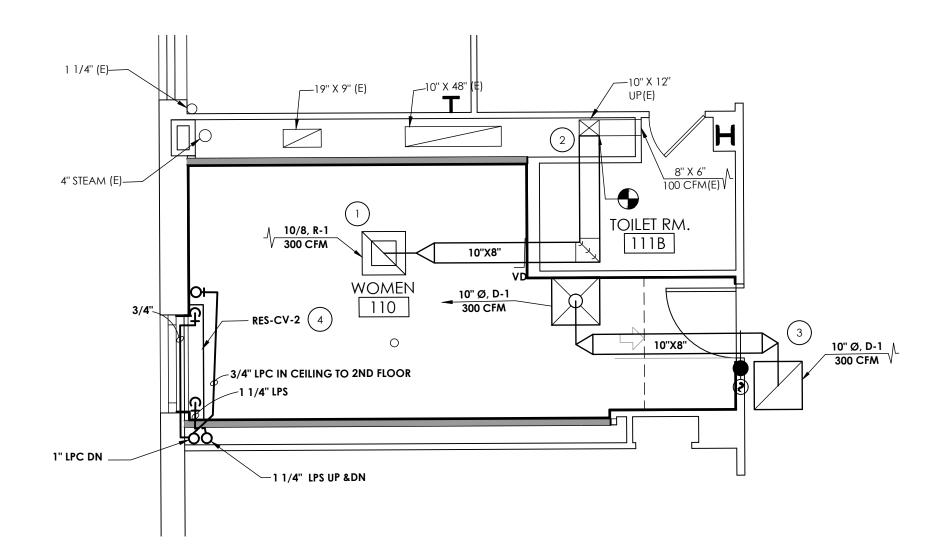
Drawn By Checked By
DJB AJS

Drawing Title


GROUND FLOOR HVAC NEW

Drawing Number


- PROVIDE NEW GRILLE AND DUCTWORK. BALANCE NEW EXHAUST FAN.
- 2 CONNECT NEW DUCTWORK TO EXISTING DUCTS WHERE INDICATED.
- PROVIDE NEW DIFFUSERS WITH SMOKE AND FIRE DAMPERS. PLACE DUCTWORK ABOVE FINISHED CEILING.
- 4 PROVIDE NEW CONVECTORS, INCLUDING CONTROLS. CONNECT BACK TO MAIN.



1 GIRLS TOILET ROOM NEW PLAN
H202 SCALE: 1/4" = 1'-0"

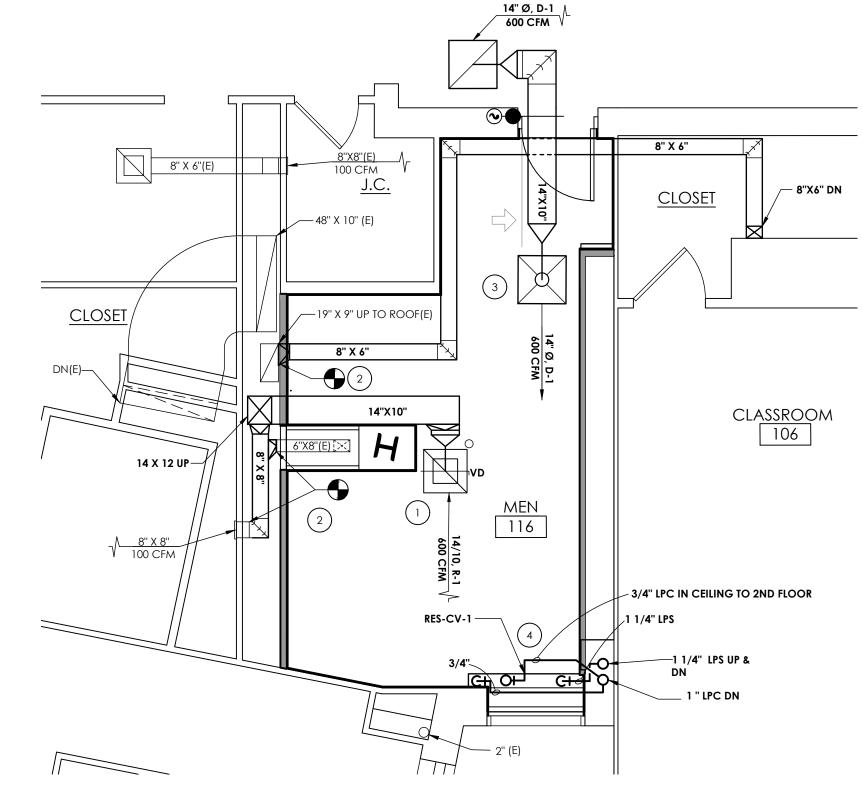

BOYS TOILET ROOM NEW PLAN
H202 SCALE: 1/4" = 1'-0"

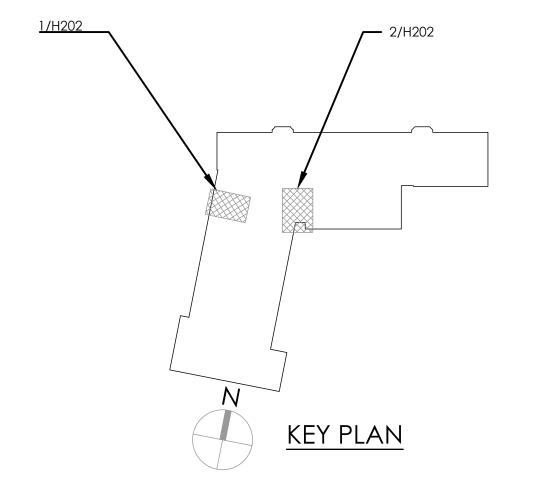

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DJB AJS

Drawing Title

FIRST FLOOR HVAC NEW PLAN

RES

SECOND FLOOR TOILET ROOMS NEW PLAN H203 | SCALE: 1/4" = 1'-0"



2 CONNECT NEW DUCTWORK TO EXISTING DUCTS WHERE INDICATED.

PROVIDE NEW DIFFUSERS WITH SMOKE AND FIRE DAMPERS. PLACE DUCTWORK ABOVE FINISHED CEILING.

4) PROVIDE NEW GRILLE WITH BUILT IN VOLUME DAMPER.

5 PROVIDE NEW CONVECTORS. PROVIDE NEW PIPING AS NECESSARY TO CONNECT BACK TO MAINS.

1) PROVIDE NEW GRILLE AND DUCTWORK.

PROJECT INFORMATION

14428.18

Project Number

OSSINING UNION FREE SCHOOL DISTRICT

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PROJECT ISSUE & REVISION SCHEDULE

No. Date Description


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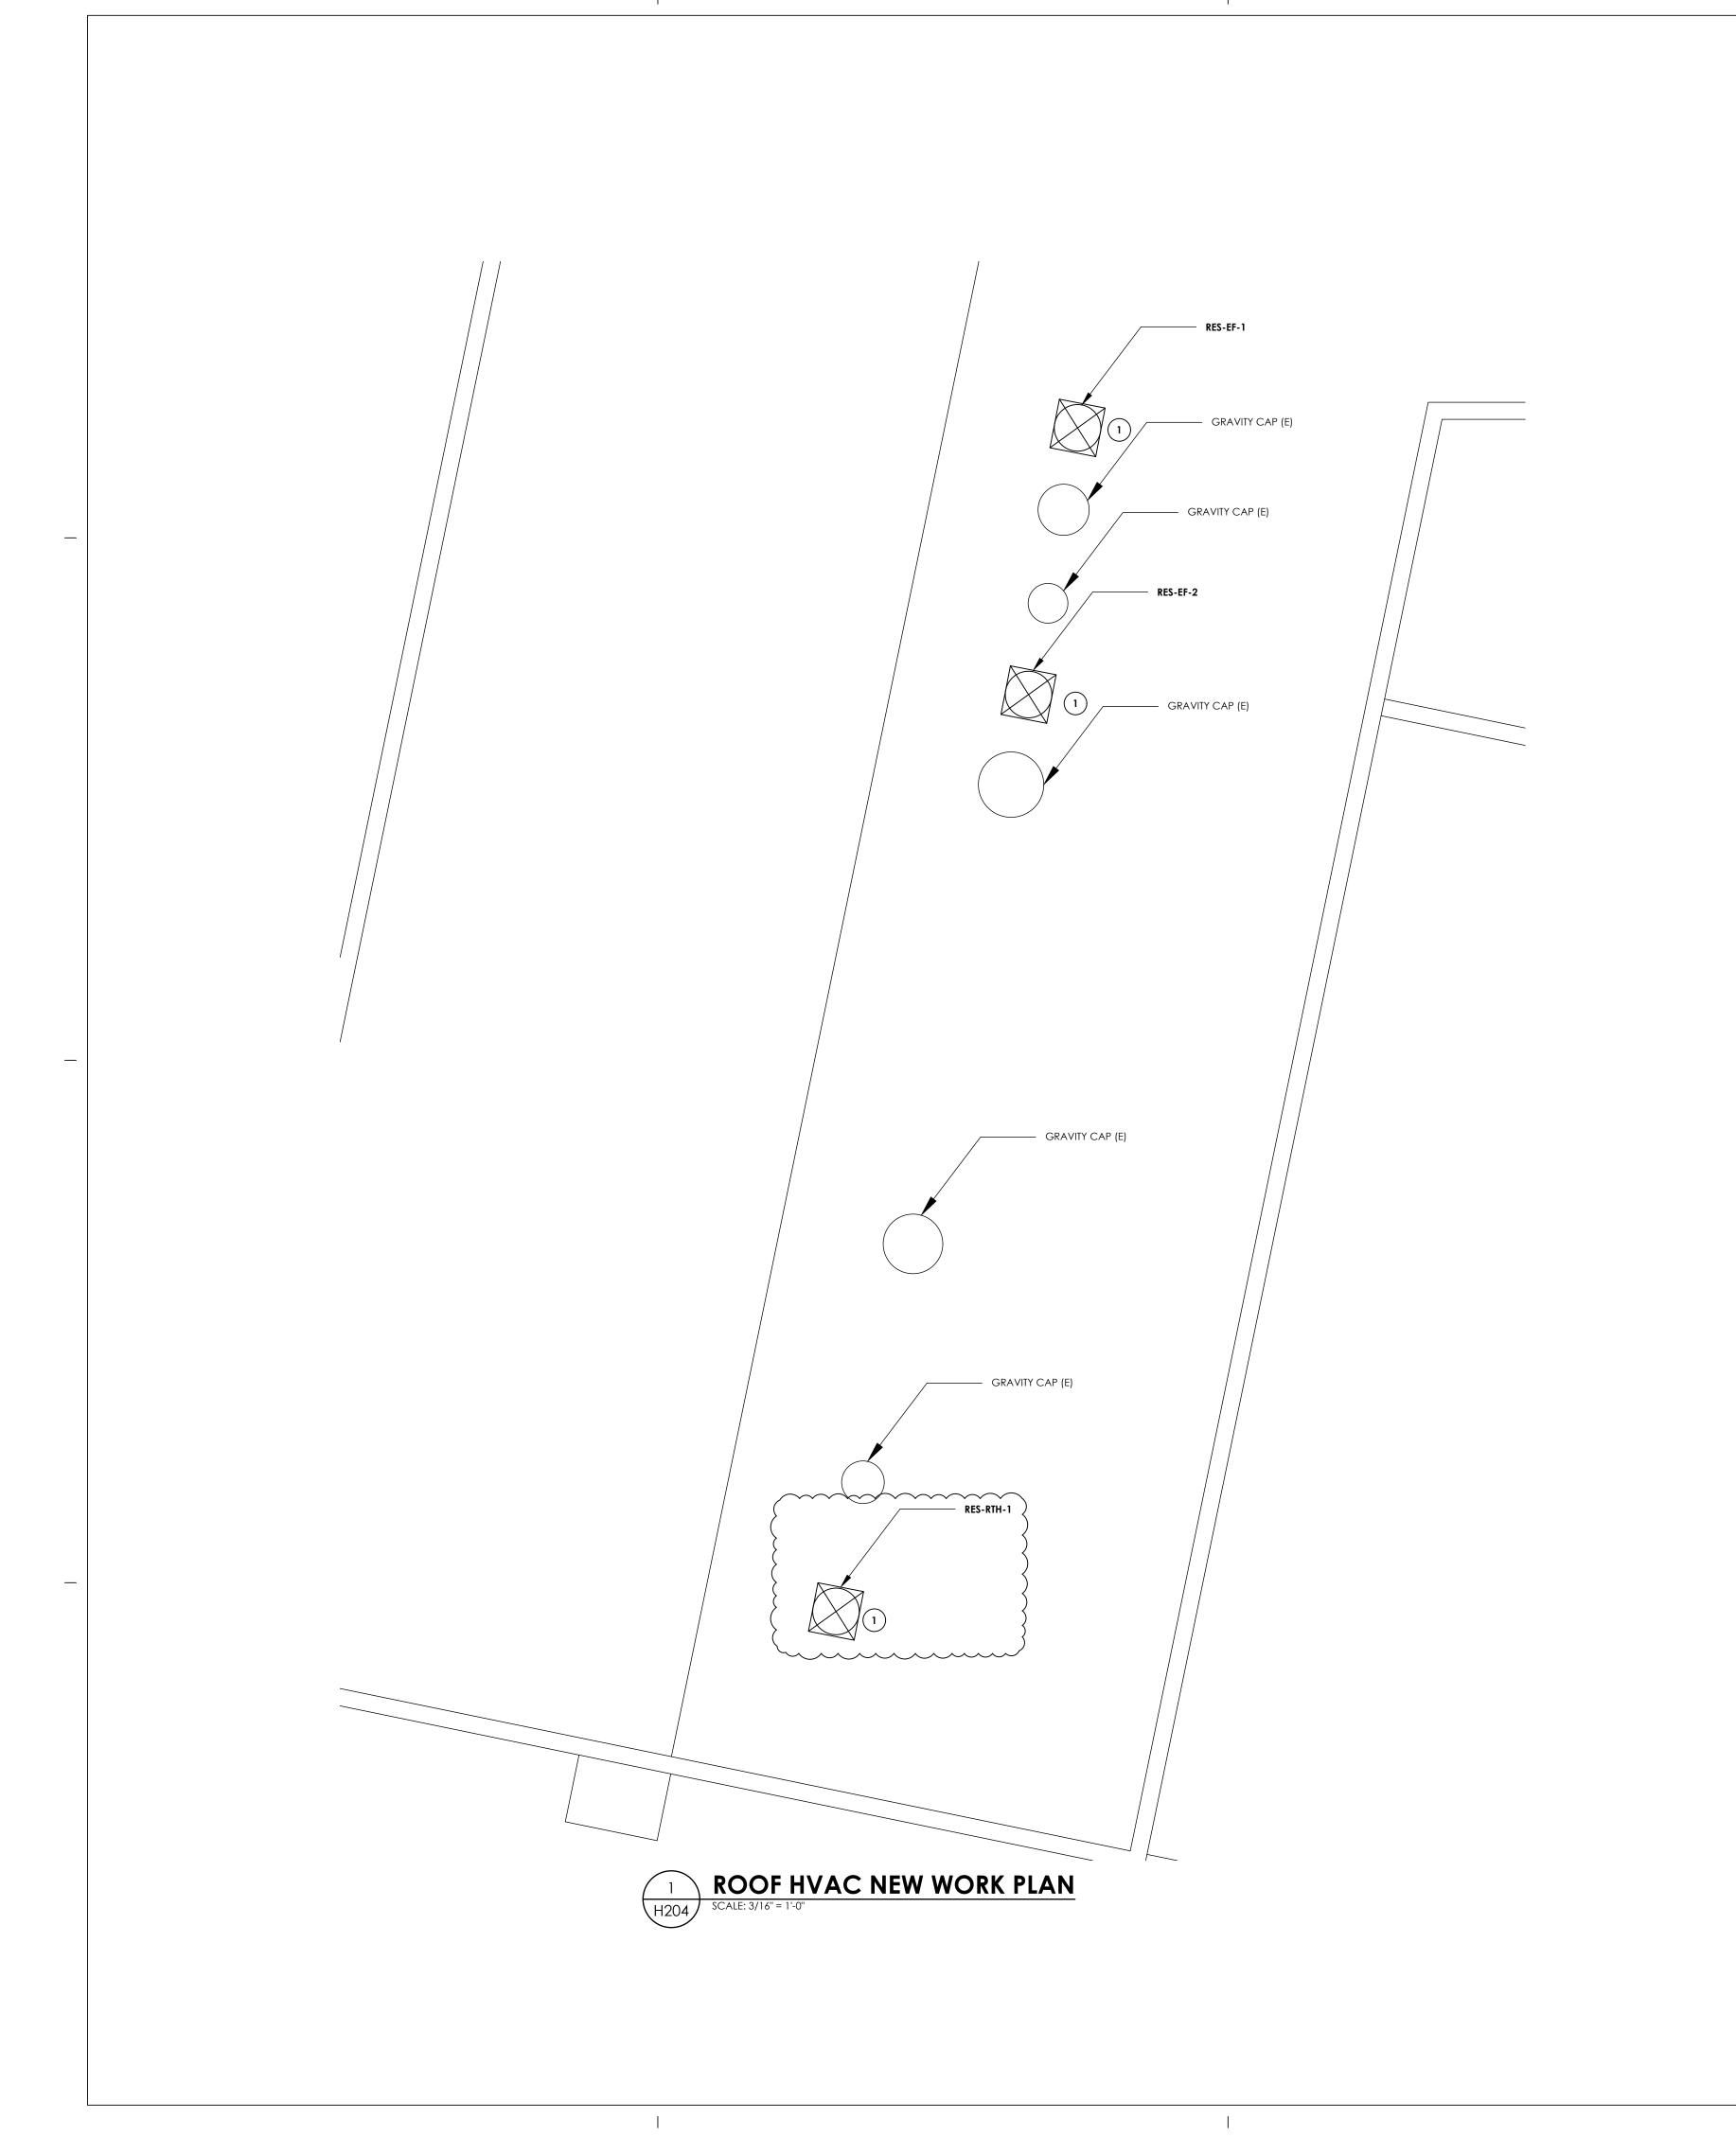
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Issued 1/4" - 1'-0" 11/15/2021 Project Status **BID SET** Drawn By Checked By DJB AJS

SECOND FLOOR HVAC NEW






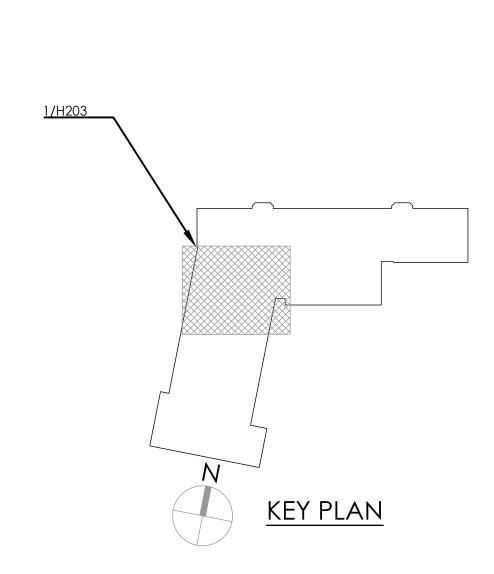



KEY NOTES:

- 1 PROVIDE NEW EXHAUST FAN IN LOCATION OF REMOVED GRAVITY EXHAUST CAP. COORDINATE CUTTING AND PATCHING WITH G.C. MAINTAIN ALL EXISTING ROOF WARRANTIES.
- 2 PROVIDE NEW DUCTWORK.
- 3 PROVIDE NEW DUCTWORK UP TO GRAVITY RELIEF HOOD ON ROOF.

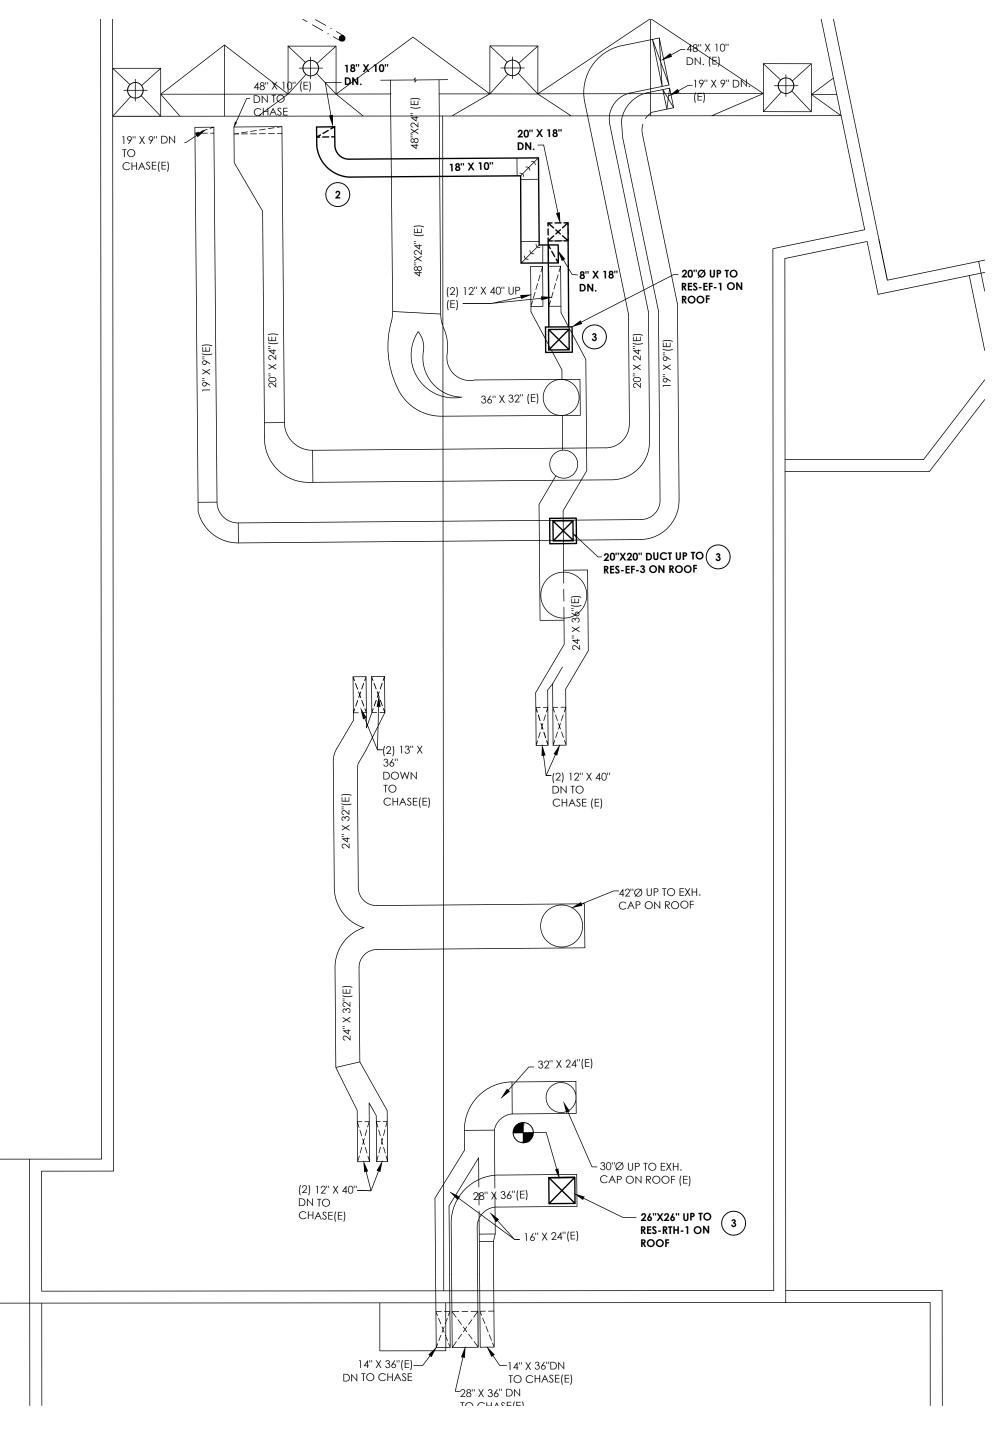

FAN ROOM HVAC NEW WORK PLAN SCALE: 1/8" = 1'-0"

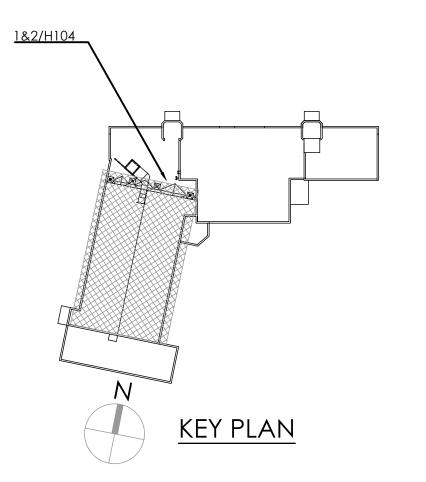

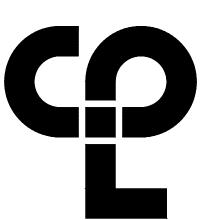

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11/15/2021 AS NOTED

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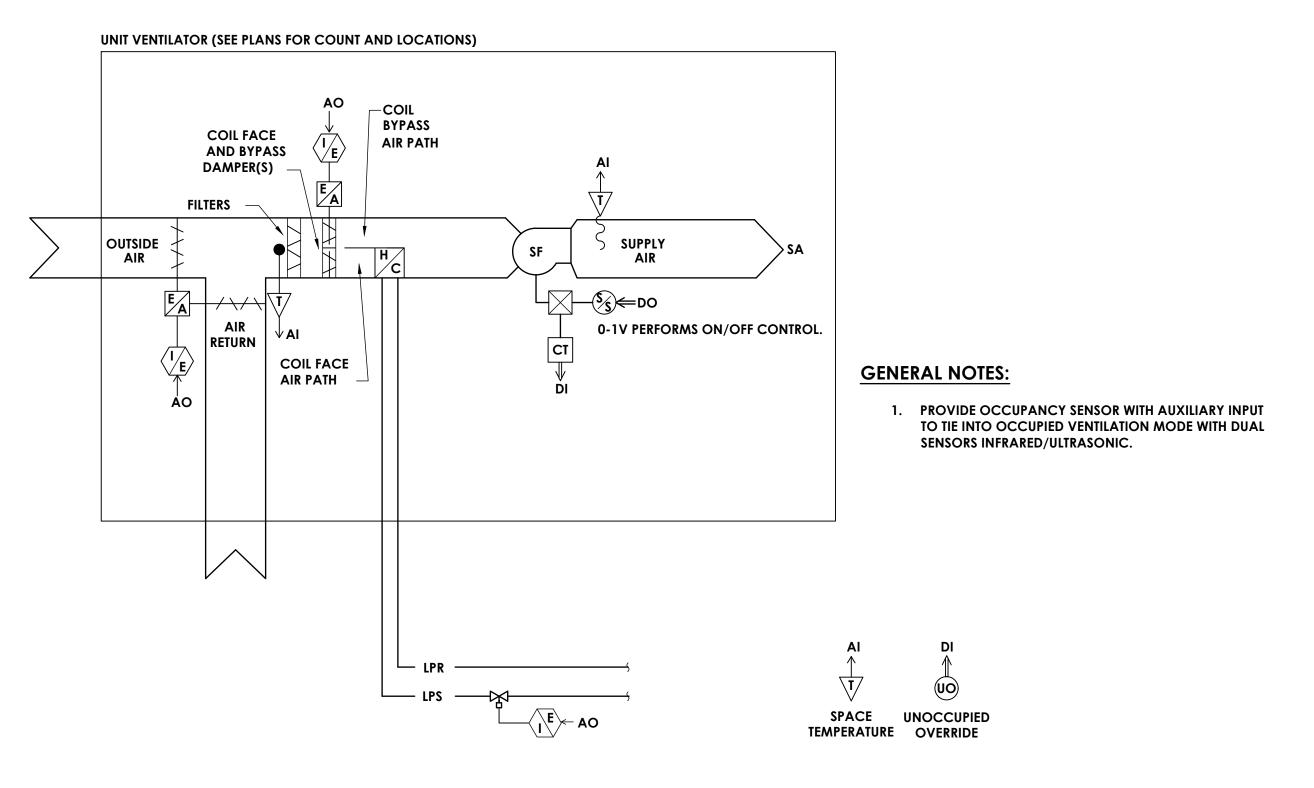
Drawn By Checked By

DJB AJS

Drawing Title


ROOF NEW PLAN


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GYMNASIUM HORIZONTAL UV-RES-1,2,3,4,5


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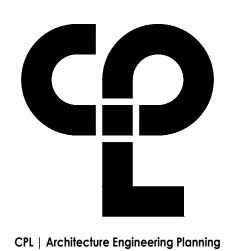






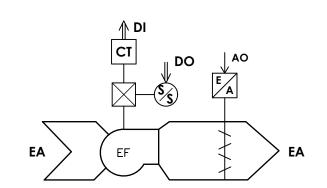

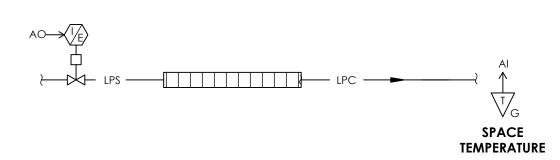

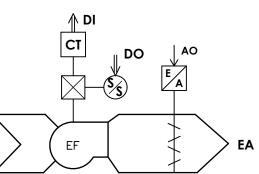

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PROJECT INFORMATION

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OSSINING UNION FREE SCHOOL DISTRICT ANNE M. DORNER MS SED# 66-14-01-03-0-008-028 ROOSEVELT ES SED# 66-14-01-03-0-005-022 OSSINING HS SED# 66-14-01-03-0-003-043


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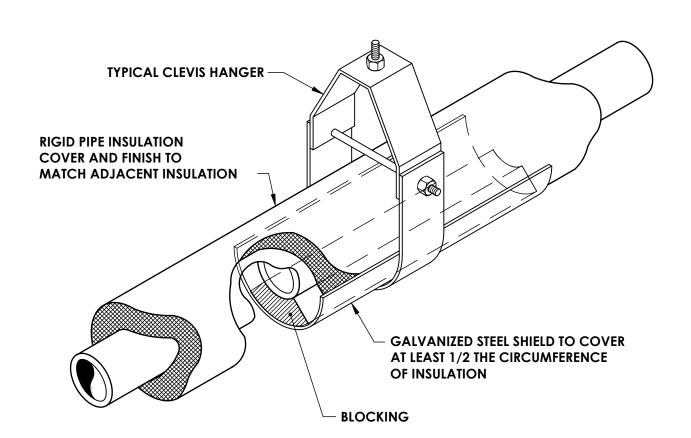
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Issued 11/15/2021 AS NOTED Project Status **BID SET** Drawn By Checked By DJB Drawing Title


MECHANICAL CONTROLS AND SCHEMATICS









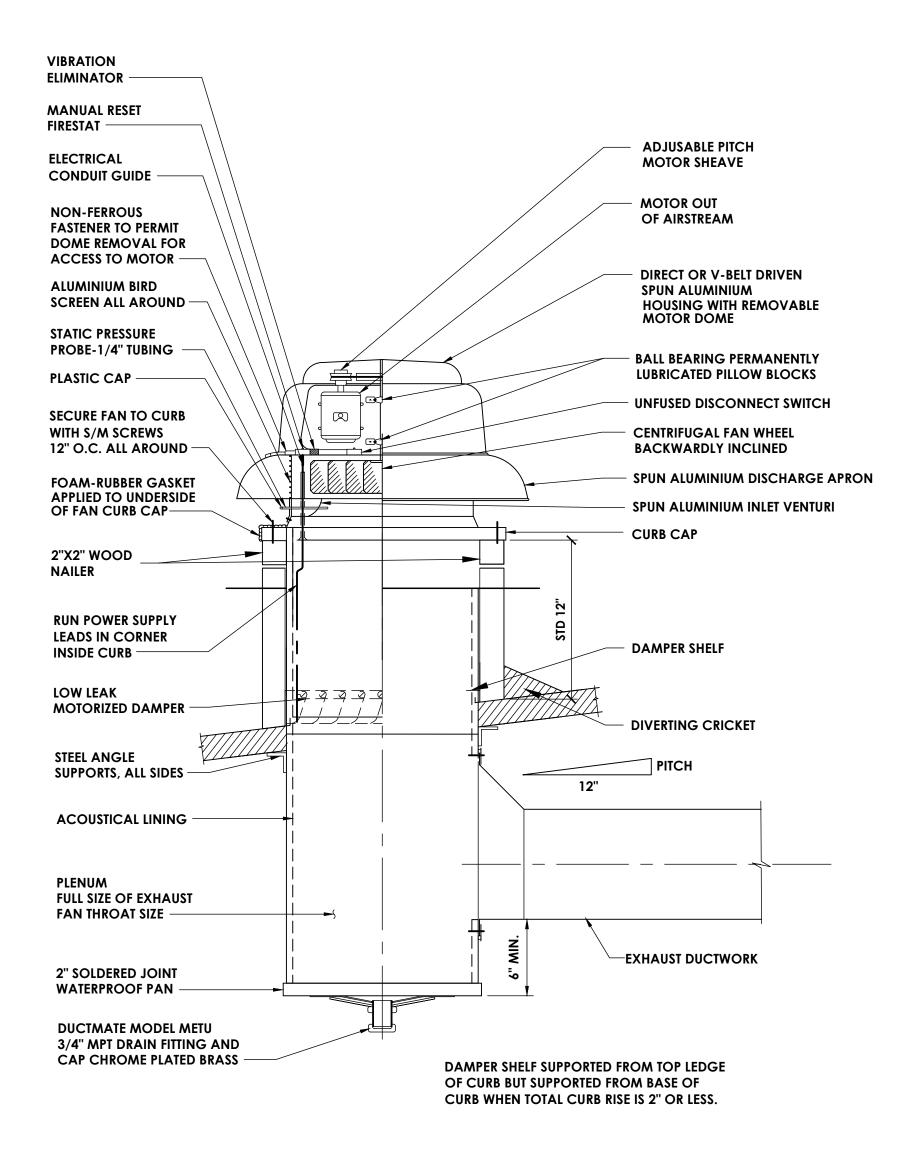

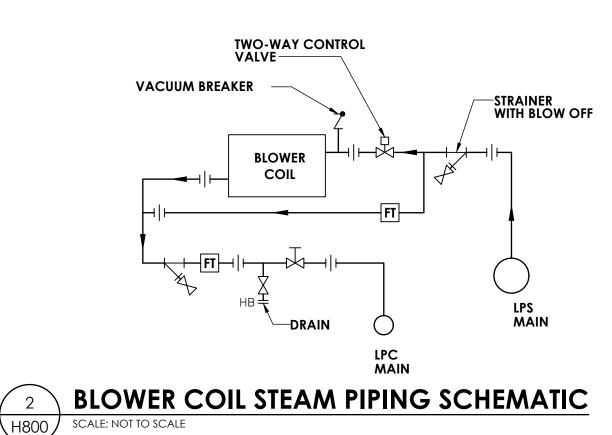


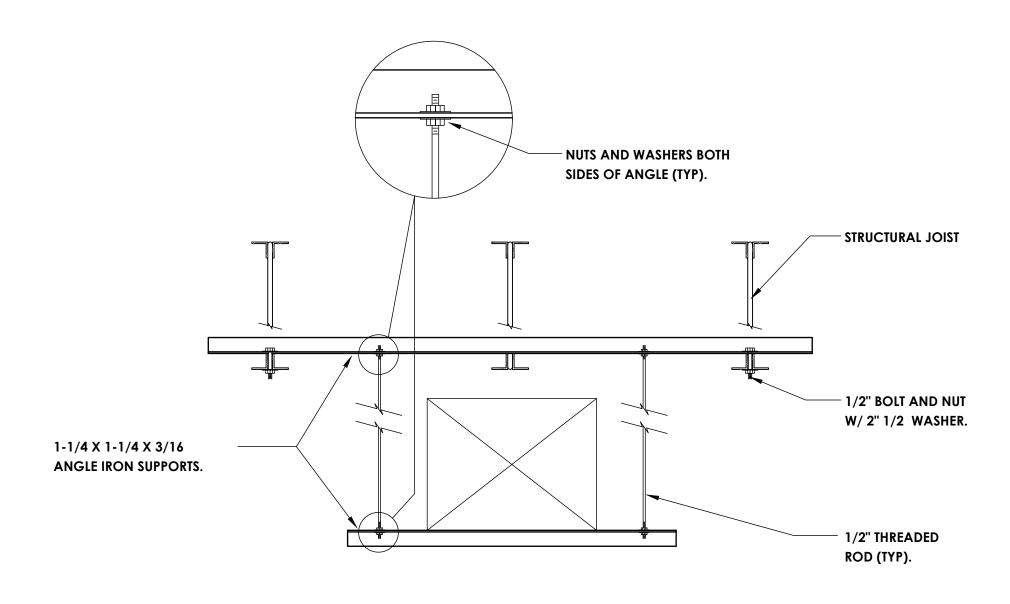



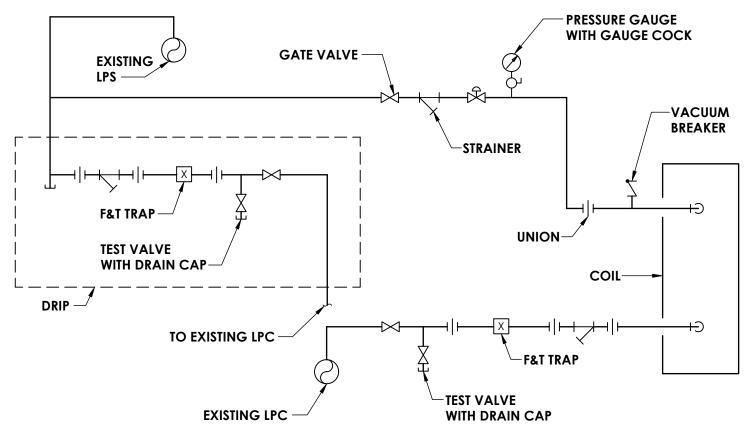



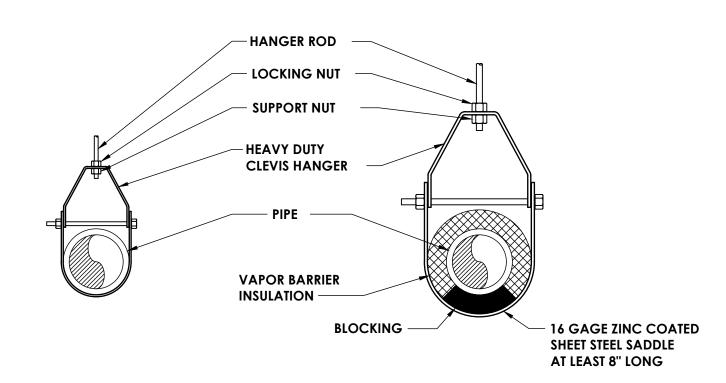

CLEVIS HANGER

SINGLE HORIZONTAL RUNS


NO VAPOR BARRIER INSULATION

CLEVIS HANGER


SINGLE HORIZONTAL RUNS

WITH VAPOR BARRIER INSULATION




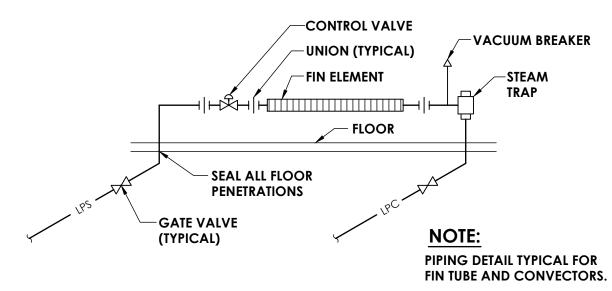

5 STEAM RADIATION PIPING DETAIL
NOT TO SCALE

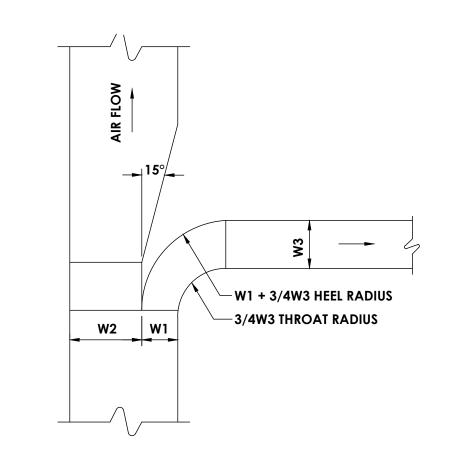

8 MAIN BRANCH TAKE-OFF DETAIL
NOT TO SCALE

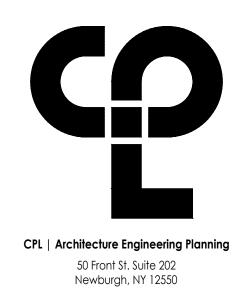

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PROJECT INFORMATION

Project Number 14428.18
Client Name

OSSINING UNION FREE SCHOOL DISTRICT
Project Name

2021-2022 CIP

District Office Address
400 EXECUTIVE BLVD OSSINING, NY 10562

OSSINING UNION FREE SCHOOL DISTRICT

ANNE M. DORNER MS SED# 66-14-01-03-0-008-028
ROOSEVELI ES SED# 66-14-01-03-0-003-043

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SHEET INFORMATION

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11/15/2021 NOT TO SCALE

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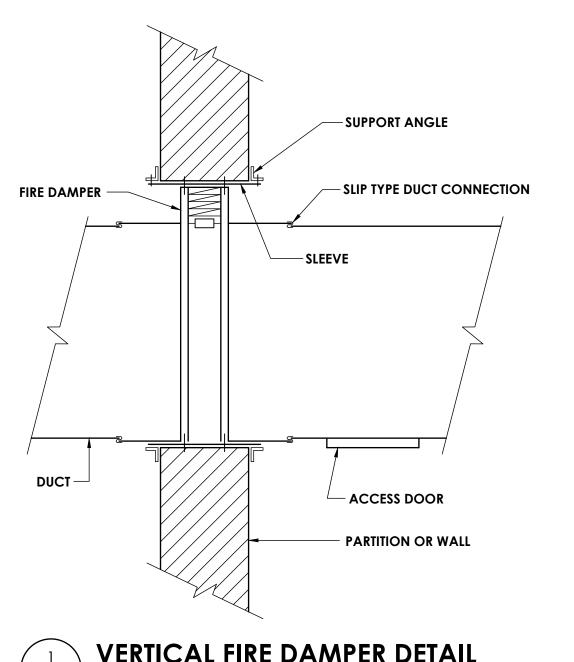
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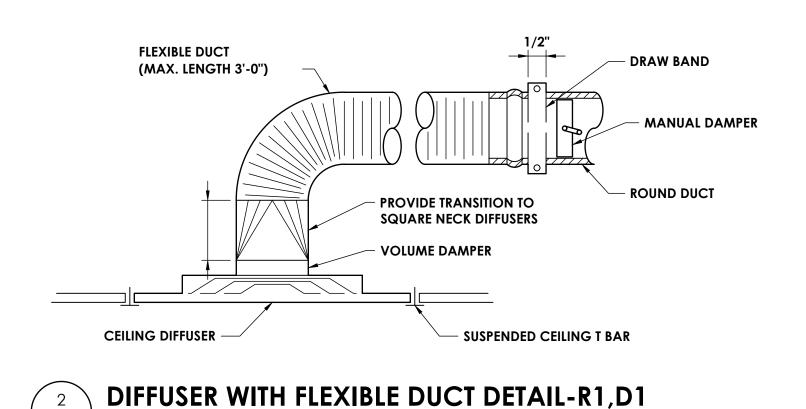
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Drawing Title

DETAIL PLAN


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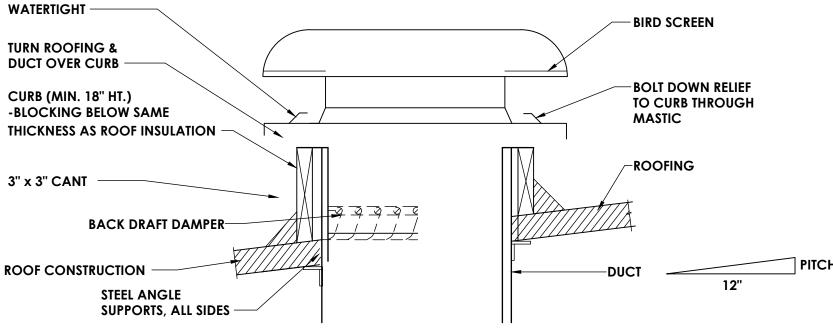
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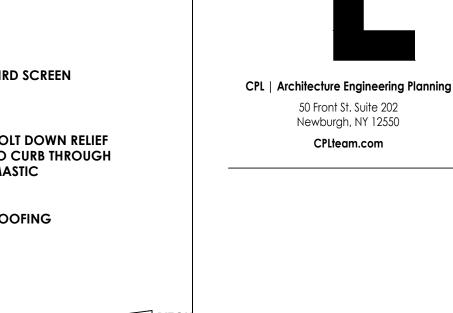
\H801,



FLASH &

COUNTERFLASH



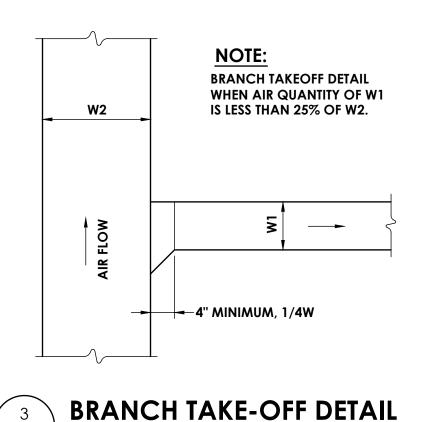

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PROJECT INFORMATION

OSSINING UNION FREE SCHOOL

400 EXECUTIVE BLVD OSSINING, NY 10562

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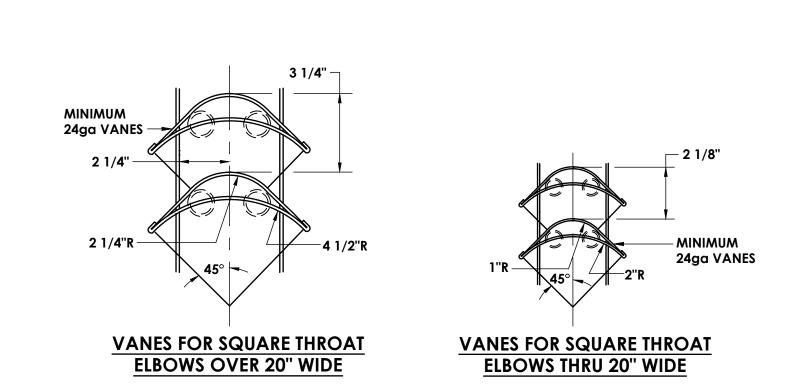
Project Number 14428.18

DISTRICT


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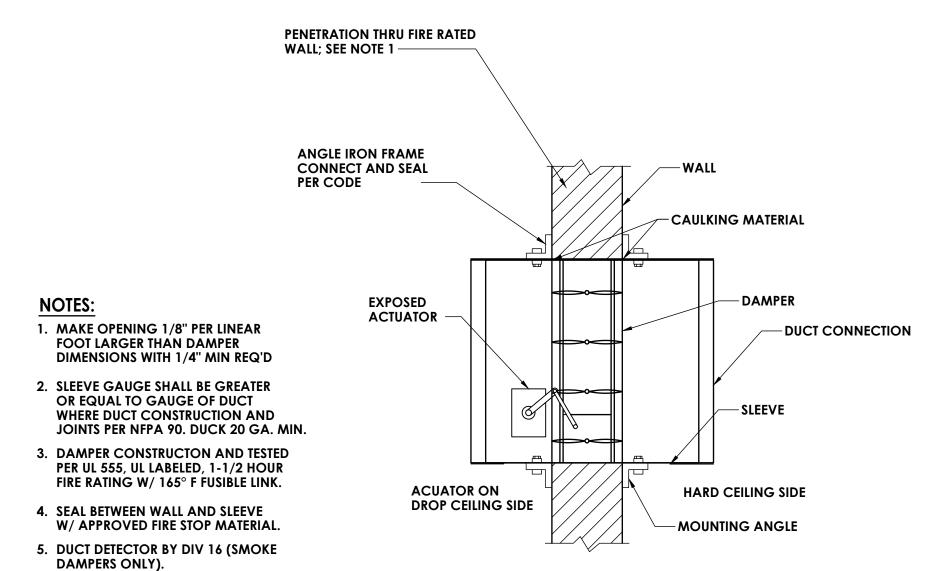


TYPICAL TURNING VANE DETAIL









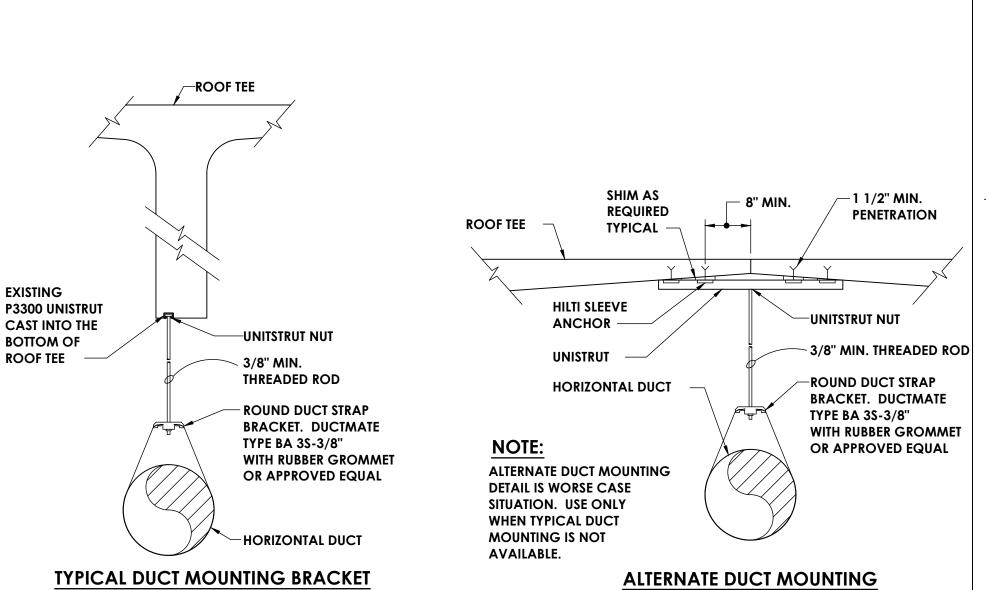




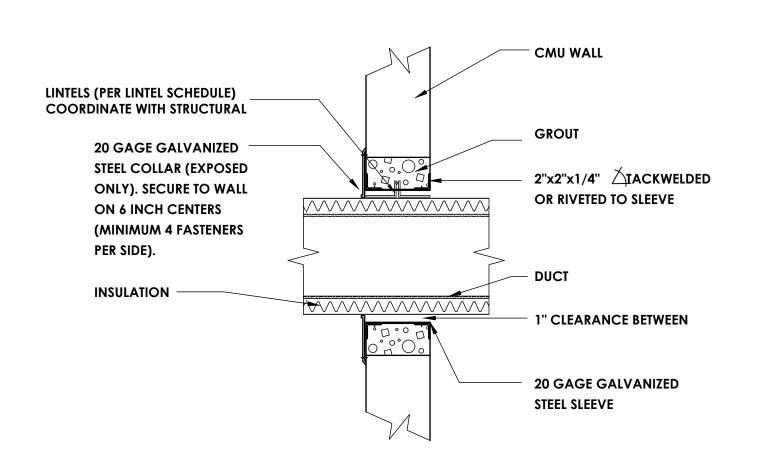



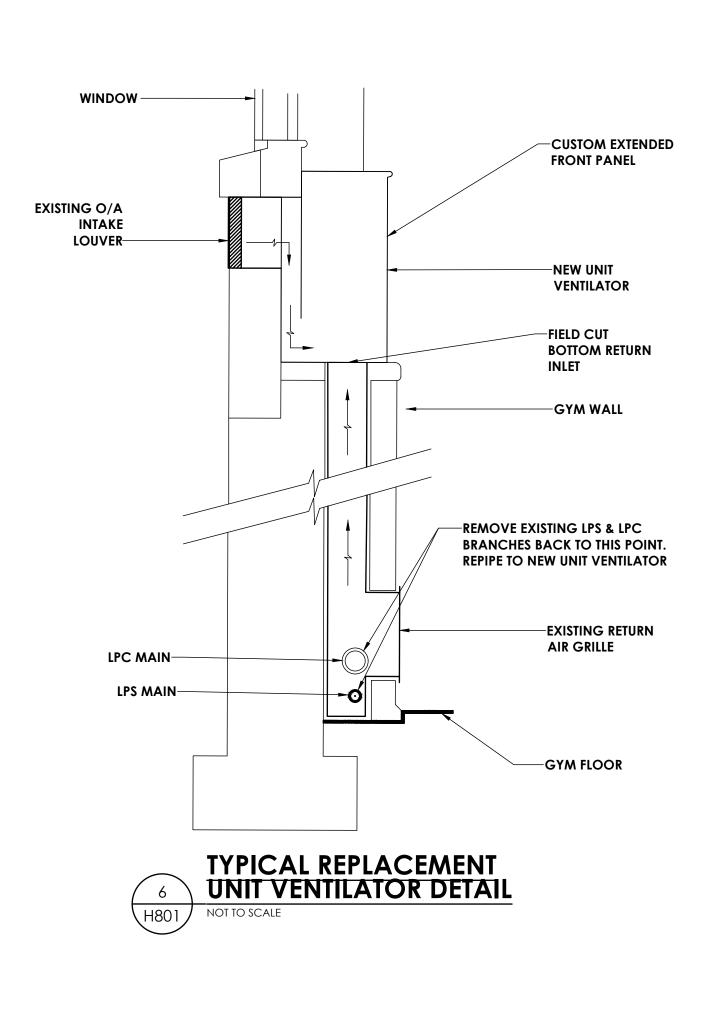

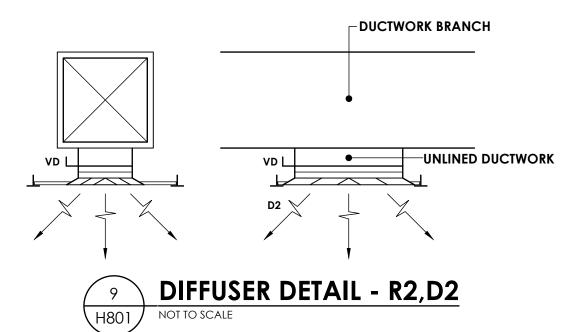

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BID SET Drawn By Checked By DJB AJS Drawing Title DETAIL PLAN

Drawing Number

ROOS	EVELT ELEMENTARY	SCHOOL EXH	IAUST CALO	CS .
SPACE	OCCUPANCY CLASSIFICATION	TOTAL TOILET FIXTURES	SERVICE FAN	REQUIRED EXHAUST (CFM)
ROOSEVELT ELEMENTARY SCHOOL	TOILET ROOM 3- BOYS	3	RES-EF-3	225
ROOSEVELT ELEMENTARY SCHOOL	TOILET ROOM 4- GIRLS	2	RES-EF-3	150
ROOSEVELT ELEMENTARY SCHOOL	TOLET ROOM 110 - BOYS	8	RES-EF-1	600
ROOSEVELT ELEMENTARY SCHOOL	TOILET ROOM 111 - GIRLS	4	RES-EF-1	300
ROOSEVELT ELEMENTARY SCHOOL	TOILET ROOM 202A - GIRLS	5	RES-EF-1	375
ROOSEVELT ELEMENTARY SCHOOL	TOILET ROOM 206B - BOYS	6	RES-EF-1	450
ROOSEVELT ELEMENTARY SCHOOL	S.S. CLOSET (GYM FLOOR)	1	RES-EF-1	100
ROOSEVELT ELEMENTARY SCHOOL	JANITORS CLOSET - 116	-	RES-EF-1	100
ROOSEVELT ELEMENTARY SCHOOL	STORAGE ROOM G5 - GYM FLOOR	-	RES-EF-3	214
ROOSEVELT ELEMENTARY SCHOOL	LOCKERS-G-5A	-	RES-EF-3	42
ROOSEVELT ELEMENTARY SCHOOL	ELEV. MECH ROOM	-	RES-EF-3	50
ROOSEVELT ELEMENTARY SCHOOL	STORAGE-G-5B	-	RES-EF-3	24
ROOSEVELT ELEMENTARY SCHOOL	GYM	-	RES-EF-2	3100
ROOSEVELT ELEMENTARY SCHOOL	STAGE	-	RES-EF-2	422
ROOSEVELT ELEMENTARY SCHOOL	STORAGE ROOM-G6	-	RES-EF-2	24
ROOSEVELT ELEMENTARY SCHOOL	JANITORS CLOSET - 206A	1	RES-EF-1	100
ROOSEVELT ELEMENTARY SCHOOL	GENERAL OFFICE BATHROOM - 111A	1	RES-EF-1	100
ROOSEVELT ELEMENTARY SCHOOL	MECH. ROOM 1ST FLOOR	1	RES-EF-1	100
ROOSEVELT ELEMENTARY SCHOOL	TOILET ROOM 206	1	RES-EF-1	100
ROOSEVELT ELEMENTARY SCHOOL	STORAGE ROOM - 201B	1	RES-EF-1	100

					F	AN SC	HEDULE							
MARK	LOCATION	SERVICE	TYPE	ROOF	CFM	SP	DIAMETER	RPM		ELECTRICA	L DATA		TYPICAL UNIT MFG	REMARKS:
IVIARK	LOCATION	SERVICE	ITPE	OPENING (IN.)	CFIVI	IN W.G.	(IN.)	RPIVI	BHP / HP	VOLTS	HZ	VFD	& MODEL NO.	REIVIARNO.
RES-EF-1	ROOF	T-110,T-111, T-202A, T-206B	BELT	20.5 X 20.5	2425	0.24	35.5	568	.25/.33	115	60	1	GREENHECK-GB-200	1,2,3,4
RES-EF-2	ROOF	STORAGE 5G. LOCKERS,MECH ROOM, STOR. T-3,T-4	DIRECT	12.5 X 12.5	705	0.06	21.8	1120	.04/.16	115	60	1	GREENHECK-G-095-VG	1,2,3,4
REMARKS:	1. PROVIDE FACT	ORY MOUNTED DISCONNEC	T SWITCH											
	2. BIRD SCREEN													
	3. PROVIDE MANU	JFACTURE CURB												
	4. BACKDRAFT DA	AMPER, GRAVITY OPERATED	1											

		CON	/ECTO	R SCHE	DULE	
MARK	МВН	LENGTH	HEIGHT	DEPTH	TYPICAL UNIT MFG & MODEL NO.	REMARKS:
RES-CV-1	13.7	44	32	6	STERLING SF-A	1,2,3
RES-CV-2	8	44	24	4	STERLING SF-A	1,2,3
RES-CV-3	12	40	32	6	STERLING SF-A	1,2,3
RES-CV-4	11	40	24	6	STERLING SF-A	1,2,3
REMARKS:	1.COLOR SELE	ECTED BY ARC	HITECT, BASED	ON MANUFAC	TUER'S STANDARD COLORS	
	2. SLOPED OU	JTLET, STAMPE	D LOUVERS, P	ENCIL PROOF,	STEAM COIL	

3. PROVIDE WITH ACCESS DOOR

								STE	AM UN	IIT VENI	ILATOR	SCHED	ULE								
MARK	ROOM	FAFANI	LINIT TYPE	CEN 4	ELEC.	TRICAL		MIN. OA	1IW	NTER		STE	AM COIL CAPA	CITY			DX COIL (CAPACITY		TYPICAL UNIT	DELLA DICC.
MARK	SERVES	EA FAN	UNIT TYPE	CFM	MCA	VOLT/Ø	- RETURN AIR	CFM	OA °F	RA °F	EWT °F	EAT °F	LAT °F	МВН	PSI	EWT °F	EAT °F	LAT °F	МВН	MFG & MODEL NO.	REMARKS:
RES-UV-1	GYM	RES-EF-2	VERTICAL	1474	6.3	115/1	759	715	0	69	180	35.8	88.9	84.6	2.0	67	80.0	54.8	53.7	DAIKEN-UAVS 9H15	1,2,3,4,5,6,7,8 ,9
RES-UV-2	GYM	RES-EF-2	VERTICAL	1474	6.3	115/1	759	715	0	69	180	35.8	88.9	84.6	2.0	67	80.0	54.8	53.7	DAIKEN-UAVS 9H15	1,2,3,4,5,6,7,8 ,9
RES-UV-3	GYM	RES-EF-2	VERTICAL	1474	6.3	115/1	765	709	0	69	180	35.8	88.9	84.6	2.0	67	80.0	54.8	53.7	DAIKEN-UAVS 9H15	1,2,3,4,5,6,7,8 ,9
RES-UV-4	GYM	RES-EF-2	VERTICAL	1474	6.3	115/1	765	709	0	69	180	35.8	88.9	84.6	2.0	67	80.0	54.8	53.7	DAIKEN-UAVS 9H15	1,2,3,4,5,6,7,8 ,9
RES-UV-5	GYM	RES-EF-2	VERTICAL	1474	6.3	115/1	765	709	0	69	180	35.8	88.9	84.6	2.0	67	80.0	54.8	53.7	DAIKEN-UAVS 9H15	1,2,3,4,5,6,7,8

REMARKS: 1. FACTORY MOUNTED AND WIRED DISCONNECT.

- 2. CONDENSATE PUMP, DRAIN PAN ALARM FOR FUTURE DX CONNECTION.
- 3. FULL ADAPTER WITH ENCLOSED PIPE TUNNEL, FINISHED ENDS, CUSTOM EXTENDED FRONT PANEL.
- 4. ECM MOTORS.
- 5. FEILD CUT RETURN AIR INLET AT BOTTOM OF UNIT.
- 6. 2-POSITION END-OF-CYCLE VALVES TO BE EMPLOYED TO PREVENT OVER-HEATING DURING MILD WEATHER.
- 7. COLOR OF U.V. TO BE DETERMINED BY ARCHITECT USING STANDARD COLORS AVAILABLE.
- 8. FIELD MOUNTED CONTROLS.
- 9. PROVIDE WITH FACE AND BY-PASS.

RELIEF AIR VENTILATOR SCHEDULE													
MARK	TYPE	MANUFACTURER	LOCATION	SERVICE	MODEL	THROAT DIMENSION (IN)	CAPACITTY (CFM)	NOTES:					
RTH-1	RELIEF	GREENHECK	ROOF	G-3, G-4, G-6	GRSR-24	24	1430-3600	1,2,3					
NOTES:													
	2. PROVIDE R	ELEIF GRAVITY BACKDRAFT	DAMPER.										
	3. PROVIDE 18	-INCH HIGH ROOF CURB. CO	MPLY WITH THE WIND REST	RAINT REQUIREMENTS OF TH	HIS PROJECT.								

MARK	APPLICATION	MATERIAL	TYPE	FINISH	DESIGN EQUIP.	REMARKS
R-1	RETURN/EA	STEEL	LAY-IN	WHITE	PRICE 530	1, 2,3
R-2	RETURN/EA	STEEL	SIDEWALL	WHITE	PRICE 530	2
D-1	SUPPLY	STEEL	LAY-IN	WHITE	PRICE SCD	1, 2,3
D-2	SUPPLY	STEEL	SIDEWALL	WHITE	PRICE SCD	2

	ROOSEVELT ELEMENTARY SCHOOL OUTSIDE AIR CALCULATIONS													
EQUIPMENT TAG	SPACE	OCCUPANCY CLASSIFICATION	TOTAL SQ. FT.	OCCUPANT DENSITY #/1000 SQ. FT.	TOTAL OCCUPANCY FOR VENTILATION	O.A. PER PERSON (CFM)	O.A. PER SQ. FT. (CFM)	Vbz (CFM)	AIR DISTRIBUTION EFFECTIVENESS	Voz=Vot (CFM)				
UV-1,2,	RES-Gymnasium & Stage	Gym	4382	7	31	20	0.18	1402	1	1402				
UV-1,2,	RES-Storage-G6	Storage	159	0	0	0	0.12	19.08	0.8	24				

ROOSEVELT ELEMENTARY SCHOOL EVENT DVC OUTSIDE AIR CALCULATIONS										
EQUIPMENT TAG	SPACE	OCCUPANCY CLASSIFICATION	TOTAL SQ. FT.	OCCUPANT DENSITY #/1000 SQ. FT.	TOTAL OCCUPANCY FOR VENTILATION	O.A. PER PERSON (CFM)	O.A. PER SQ. FT. (CFM)	Vbz (CFM)	AIR DISTRIBUTION EFFECTIVENESS	Voz=Vot (CFM)
UV-1,2,3,4,5	RES-Gymnasium	Multiuse Space	3827	100	383	7.5	0.06	3100	1	3100
UV-1,2,3,4,5	RES-Stage	Stages	555	70	39	10	0.06	422	1	422
UV-1,2,3,4,5	RES-Storage-G6	Storage	159	0	0	0	0.12	19.08	0.8	24

3. REFER TO PLANS FOR NECK SIZE

DEMAND CONTROL VENTILATION CALCS OUTDOOR AIR FLOW CO2 STANDARD OCCUPANCY MIN RATE CFM/PERSON DIFFERNTIAL OA (PPM) (CFM)

1828

710

5.8

CPL | Architecture Engineering Planning

Newburgh, NY 12550 CPLteam.com

PROJECT INFORMATION

Project Number

14428.18

DISTRICT

2021-2022 CIP

District Office Address 400 EXECUTIVE BLVD OSSINING, NY 10562

OSSINING UNION FREE SCHOOL

OSSINING UNION FREE SCHOOL DISTRICT

ANNE M. DORNER MS SED# 66-14-01-03-0-008-028 ROOSEVELT ES SED# 66-14-01-03-0-005-022 OSSINING HS SED# 66-14-01-03-0-003-043

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Scale

NOT TO SCALE

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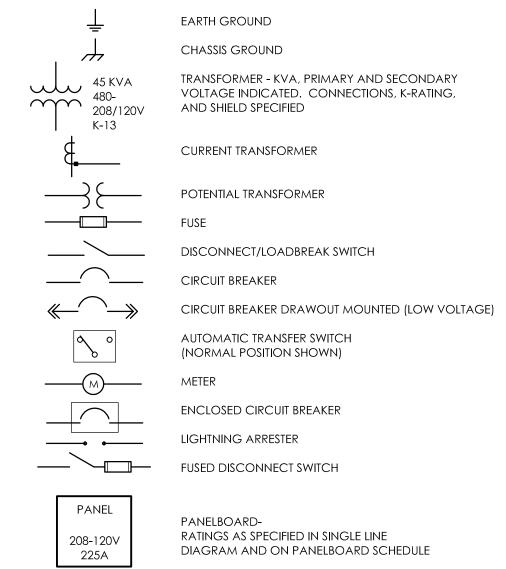
11/15/2021 Project Status **BID SET** Drawn By

Checked By DJB AJS Drawing Title

DETAIL SCHEDULE



SINGLE LINE DIAGRAM LEGEND:



COMMUNICATIONS LEGEND:

TELEPHONE (1) CAT3 - TELEPHONE JACK & CABLE

> (NONE) STANDARD MODULAR JACK FOR TELEPHONE W WALL MOUNTED TELEPHONE MODULAR JACK P PUBLIC TELEPHONE MODULAR JACK C COUNTER HEIGHT MODULAR JACK

TELEPHONE FLOOR OUTLET (1) CAT3 - TELEPHONE JACK & CABLE

> DATA OUTLET WITH FLUSH BOX AND FACEPLATE (1) CAT5e - DATA JACK & CABLE

COMPUTER FLOOR OUTLET (1) CAT5e - DATA JACK & CABLE

COMBINATION TELEPHONE CABLE AND DATA OUTLETS IN DOUBLE GANG FLUSH MOUNTED BOX WITH FACEPLATE

WIRELESS TRANSMITTER (PROVIDED BY OWNER) CONTRACTOR TO PROVIDE (2) CAT5e DATA JACKS & CABLING

BACK BOX FOR OWNER PROVIDED TEL/COM WIRING & DEVICES

COAX CABLE (TYPE F CONNECTOR)

CEILING MOUNT LCD PROJECTOR

SPEAKER (PUBLIC ADDRESS)

(NONE) CEILING MOUNTED

W WALL MOUNTED

SPEAKER (LOCAL SOUND SYSTEM)

SPEAKER HORN

MICROPHONE JACK

SPEAKER JACK

VOLUME CONTROL

CLOCK

DOUBLE FACE CLOCK

COMBINATION CLOCK AND SPEAKER

INTERCOM STATION

REMOTE PRE-AMPLIFIER AND PAGING MICROPHONE

HOUSE LIGHT CONTROL STATION

CONSOLE JACK

WALL BOX AS SPECIFIED

FLOOR BOX

NOTE:

SYMBOLS SHOWN ON THIS ELECTRICAL SYMBOLS LIST ARE FOR REFERENCE PURPOSES ONLY. ALL OF THESE SYMBOLS MAY NOT BE USED FOR THIS PROJECT.

FIRE/LIFE SAFETY LEGEND:

FIRE ALARM PULL STATION

FIRE ALARM HORN - WALL MOUNTED

FIRE ALARM HORN - CEILING MOUNTED

FIRE ALARM HORN AND STROBE COMBINATION

XXcd = STROBE CANDELA RATING

FIRE ALARM STROBE XXcd = STROBE CANDELA RATING

FIRE ALARM STROBE - CEILING MOUNTED

XXcd = STROBE CANDELA RATING

SMOKE DETECTOR SMOKE DETECTOR WITH GUARD

CARBON MONOXIDE DETECTOR

NATURAL GAS SENSOR

HEAT DETECTOR - 160° RATE OF RISE

COMBINATION SMOKE/HEAT DETECTOR

HEAT DETECTOR - 190° FIXED TEMPERATURE

HEAT DETECTOR - EXPLOSION PROOF

BEAM SMOKE DETECTOR TRANSMITTER BEAM SMOKE DETECTOR RECEIVER

DUCT DETECTOR

SA INDICATES INSTALLATION IN SUPPLY AIR RA INDICATES INSTALLATION IN RETURN AIR

SD COMBINATION FIRE/SMOKE DAMPER

REMOTE TEST STATION FOR DUCT DETECTOR FIRE ALARM SHUT DOWN RELAY

FIRE DOOR HOLD OPEN

TAMPER SWITCH

FLOW SWITCH

FIRE SUPRESSION ANSUL SYSTEM CONNECTION

SMOKE DAMPER RELAY CONNECTION SD/FD SMOKE DAMPER AND FIRE DAMPER

SD SMOKE DAMPER CONTROL MODULE, ADDRESSABLE

AREA OF RESCUE CALL STATION

AREA OF RESCUE MASTER TELEPHONE STATION

FIRE ALARM AS-BUILT DOCUMENT CABINET. LOCATE ADJACENT TO FIRE ALARM CONTROL PANEL

SECURITY LEGEND:

SECURITY KEY PAD

VIDEO CAMERA

CCTV VIDEO MONITOR

PASSIVE INFRARED MOTION DETECTOR

PROXIMITY CARD READER

CALL SWITCH

DOOR CONTACT

WINDOW CONTACT

ELECTRIC STRIKE DOOR RELEASE

MAGNETIC DOOR RELEASE

DOOR ACTUATOR

NURSE CALL LEGEND:

CB NURSE CALL BUTTON

NURSE CALL PATIENT BED STATION

CODE CALL BUTTON

NURSE CALL STAFF ASSIST STATION

NURSE CALL STAFF STATION

NURSE CALL DUTY/STAFF STATION

NURSE CALL DUTY STATION

NURSE CALL LIGHT

NURSE CALL CODE LIGHT

NURSE CALL ZONE LIGHT


NURSE CALL MASTER STATION

NURSE CALL EMERGENCY PULL STATION

NURSE CALL INFRARED SENSOR

LIGHT FIXTURE LEGEND:

LIGHTING FIXTURE (SEE LIGHTING FIXTURE SCHEDULE FOR LETTER DESIGNATION AND DESCRIPTION OF FIXTURES)

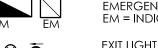

EMERGENCY AND/OR NIGHT LIGHT LIGHTING FIXTURE EM = INDICATES EMERGENCY 90 MINUTE BATTERY REQUIRED

EXIT LIGHTING FIXTURE UNIVERSAL MOUNT, SINGLE/DOUBLE FACE **⊗ ⊗** (WHERE USED, ARROW INDICATES CHEVRON DIRECTION)

BATTERY POWERED EMERGENCY LIGHT WITH 90 MINUTE BATTERY TRACK LIGHTING

POLE MOUNTED LIGHTING (QUANTITY AND ORIENTATION OF HEADS AS SHOWN)

<u>(S)</u> OCCUPANCY SENSOR - CEILING MOUNTED **OSW** OCCUPANCY SENSOR - WALL MOUNTED

LIGHTING CONTACTOR

PHOTOCELL

SWITCH

LV LOW VOLTAGE 4-BUTTON DIMMING STATION (WITH ON/OFF AND RAISE/LOWER BUTTONS)

LV1 LOW VOLTAGE 4-BUTTON DIMMING STATION (WITH ON/OFF AND RAISE/LOWER BUTTONS AND PROTECTIVE HOUSING)

LOW VOLTAGE OCCUPANCY SENSOR DIMMING SWITCH (WITH OCCUPANCY SENSOR, ON/OFF AND RAISE/LOWER BUTTONS)

PANEL LEGEND:

EXISTING ELECTRICAL PANEL

NEW ELECTRICAL PANEL

MDP MAIN DISTRIBUTION PANEL LVP LOW VOLTAGE PANEL

HVP HIGH VOLTAGE PANEL LP LIGHTING CONTROL PANEL

IG ISOLATED GROUND PANEL MSB MAIN SWITCH BOARD MCC MOTOR CONTROL CENTER

AUTOMATIC TRANSFER SWITCH

TVSS TRANSIENT VOLTAGE SURGE SUPPRESSION

ELECTRICAL SYSTEMS PANEL

SACP SECURITY ALARM CONTROL PANEL

FACP FIRE ALARM CONTROL PANEL PA PUBLIC ADDRESS CONTROL PANEL

FAAP FIRE ALARM ANNUNCIATOR PANEL FACP FIRE ALARM CONTROL PANEL

ELECTRICAL PANELBOARD LABELING PLACARD

LINE 1 - PANELBOARD NAME: PP1 (EXAMPLE)

LINE 2 - VOLTAGE AND PHASE: 208/120V-3PH-4W (EXAMPLE) LINE 3 - WHERE PANELBOARD IS FED FROM: FF MSB BREAKER #14 (EXAMPLE)

GENERAL ELECTRICAL NOTES:

1) HATCHED AREAS //// DESIGNATE EXISTING EQUIPMENT TO BE REMOVED, UNLESS OTHERWISE NOTED.

2) ALL WORK TO BE DONE IN ACCORDANCE WITH THE 2017 EDITION OF THE NATIONAL ELECTRIC CODE (NFPA 70).

3) CONTRACTOR SHALL FIELD VERIFY ALL CONDITIONS AND COORDINATE WITH EXISTING EQUIPMENT PRIOR TO BIDDING.

4) INSTALLATION HEIGHT TO CENTER OF EQUIPMENT ABOVE FINISHED FLOOR UNLESS OTHERWISE NOTED TO BE: RECEPTACLE = 18"

SWITCH = 44" MODULAR JACK FOR WALL MOUNTED TELEPHONE = 52"

MODULAR TELEPHONE JACK = 18"

AUDIO/VISUAL FIRE ALARM INDICATORS = 88" FIRE ALARM PULL STATIONS = 48"

TELEVISION OUTLET = 7'-0" COMPUTER OUTLET = 18"

CALL SWITCH = 44''REMOTE TEST STATION FOR DUCT DETECTOR = 52"

C = ABOVE COUNTER BACKSPLASH, COORDINATE WITH ARCHITECTURAL ELEVATIONS AND MILLWORK.

5) INSTALL DATA JACKS FOR CEILING MOUNTED WIRELESS TRANSMITTERS ABOVE CEILING IN ALL AREAS WHERE THERE IS AN ACCESSIBLE CEILING. PROVIDE FLUSH MOUNTED JACKS IN ALL HARD CEILINGS.

6) ALL CONDUIT AND WIRING TO BE CONCEALED IN WALLS, FLOOR, OR ABOVE CEILINGS UNLESS OTHERWISE NOTED OR APPROVED BY THE ARCHITECT/ENGINEER. ALL DEVICE OUTLET BOXES SHALL BE RECESSED UNLESS OTHERWISE NOTED OR APPROVED BY THE ARCHITECT/ENGINEER. WHERE APPROVED OR NOTED, SURFACE METAL RACEWAY AND DEVICE BOXES SHALL BE USED IN-LIEU OF CONDUIT AND CONCEALED BOXES AT NO EXTRA COST TO THE OWNER.


7) ALL CONDUIT ROUTES SHOWN ARE APPROXIMATE ONLY. CONTRACTOR SHALL FIELD VERIFY FINAL ROUTE.

8) CONDUIT RUNS SHOWN ARE SCHEMATICAL AND DO NOT INDICATE THE NECESSARY FITTINGS AND JUNCTION BOXES THAT ARE INCLUDED IN THE SCOPE OF THE WORK.

GROUNDING:

9) ALL METAL RACEWAYS, INCLUDING CONDUIT, WIRE TROUGHS, WIREMOLD, ETC., SHALL BE GROUNDED. ALL CONNECTIONS IN METAL RACEWAYS SHALL BE COMPLETED IN SUCH A MANNER AS TO MAINTAIN A CONTINUOUS PATH TO GROUND THROUGHOUT THE ENTIRE LENGTH OF THE RACEWAY.

10) UNLESS NOTED OTHERWISE ON THE DRAWINGS OR ON THE EQUIPMENT WIRING SCHEDULE, EACH BRANCH CIRCUIT SHALL BE THREE (3) #12 AWG THHN/THWN (1 HOT, 1 NEUTRAL & 1 EQUIPMENT GROUND) IN 3/4" EMT CONDUIT, UNLESS OTHERWISE NOTED. PROTECT EACH CIRCUIT WITH A 20 AMPERE, 1-POLE OVERCURRENT DEVICE UNLESS OTHERWISE NOTED. PROVIDE #10 AWG FOR 120V BRANCH CIRCUITS LONGER THAN 100 FEET. COMBINED NEUTRALS ARE NOT PERMITTED.

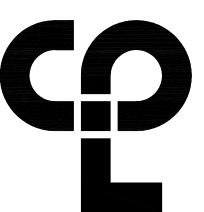

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PROJECT INFORMATION

Project Number 14428.18

DISTRICT

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2021-2022 CIP

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PROJECT ISSUE & REVISION SCHEDULE

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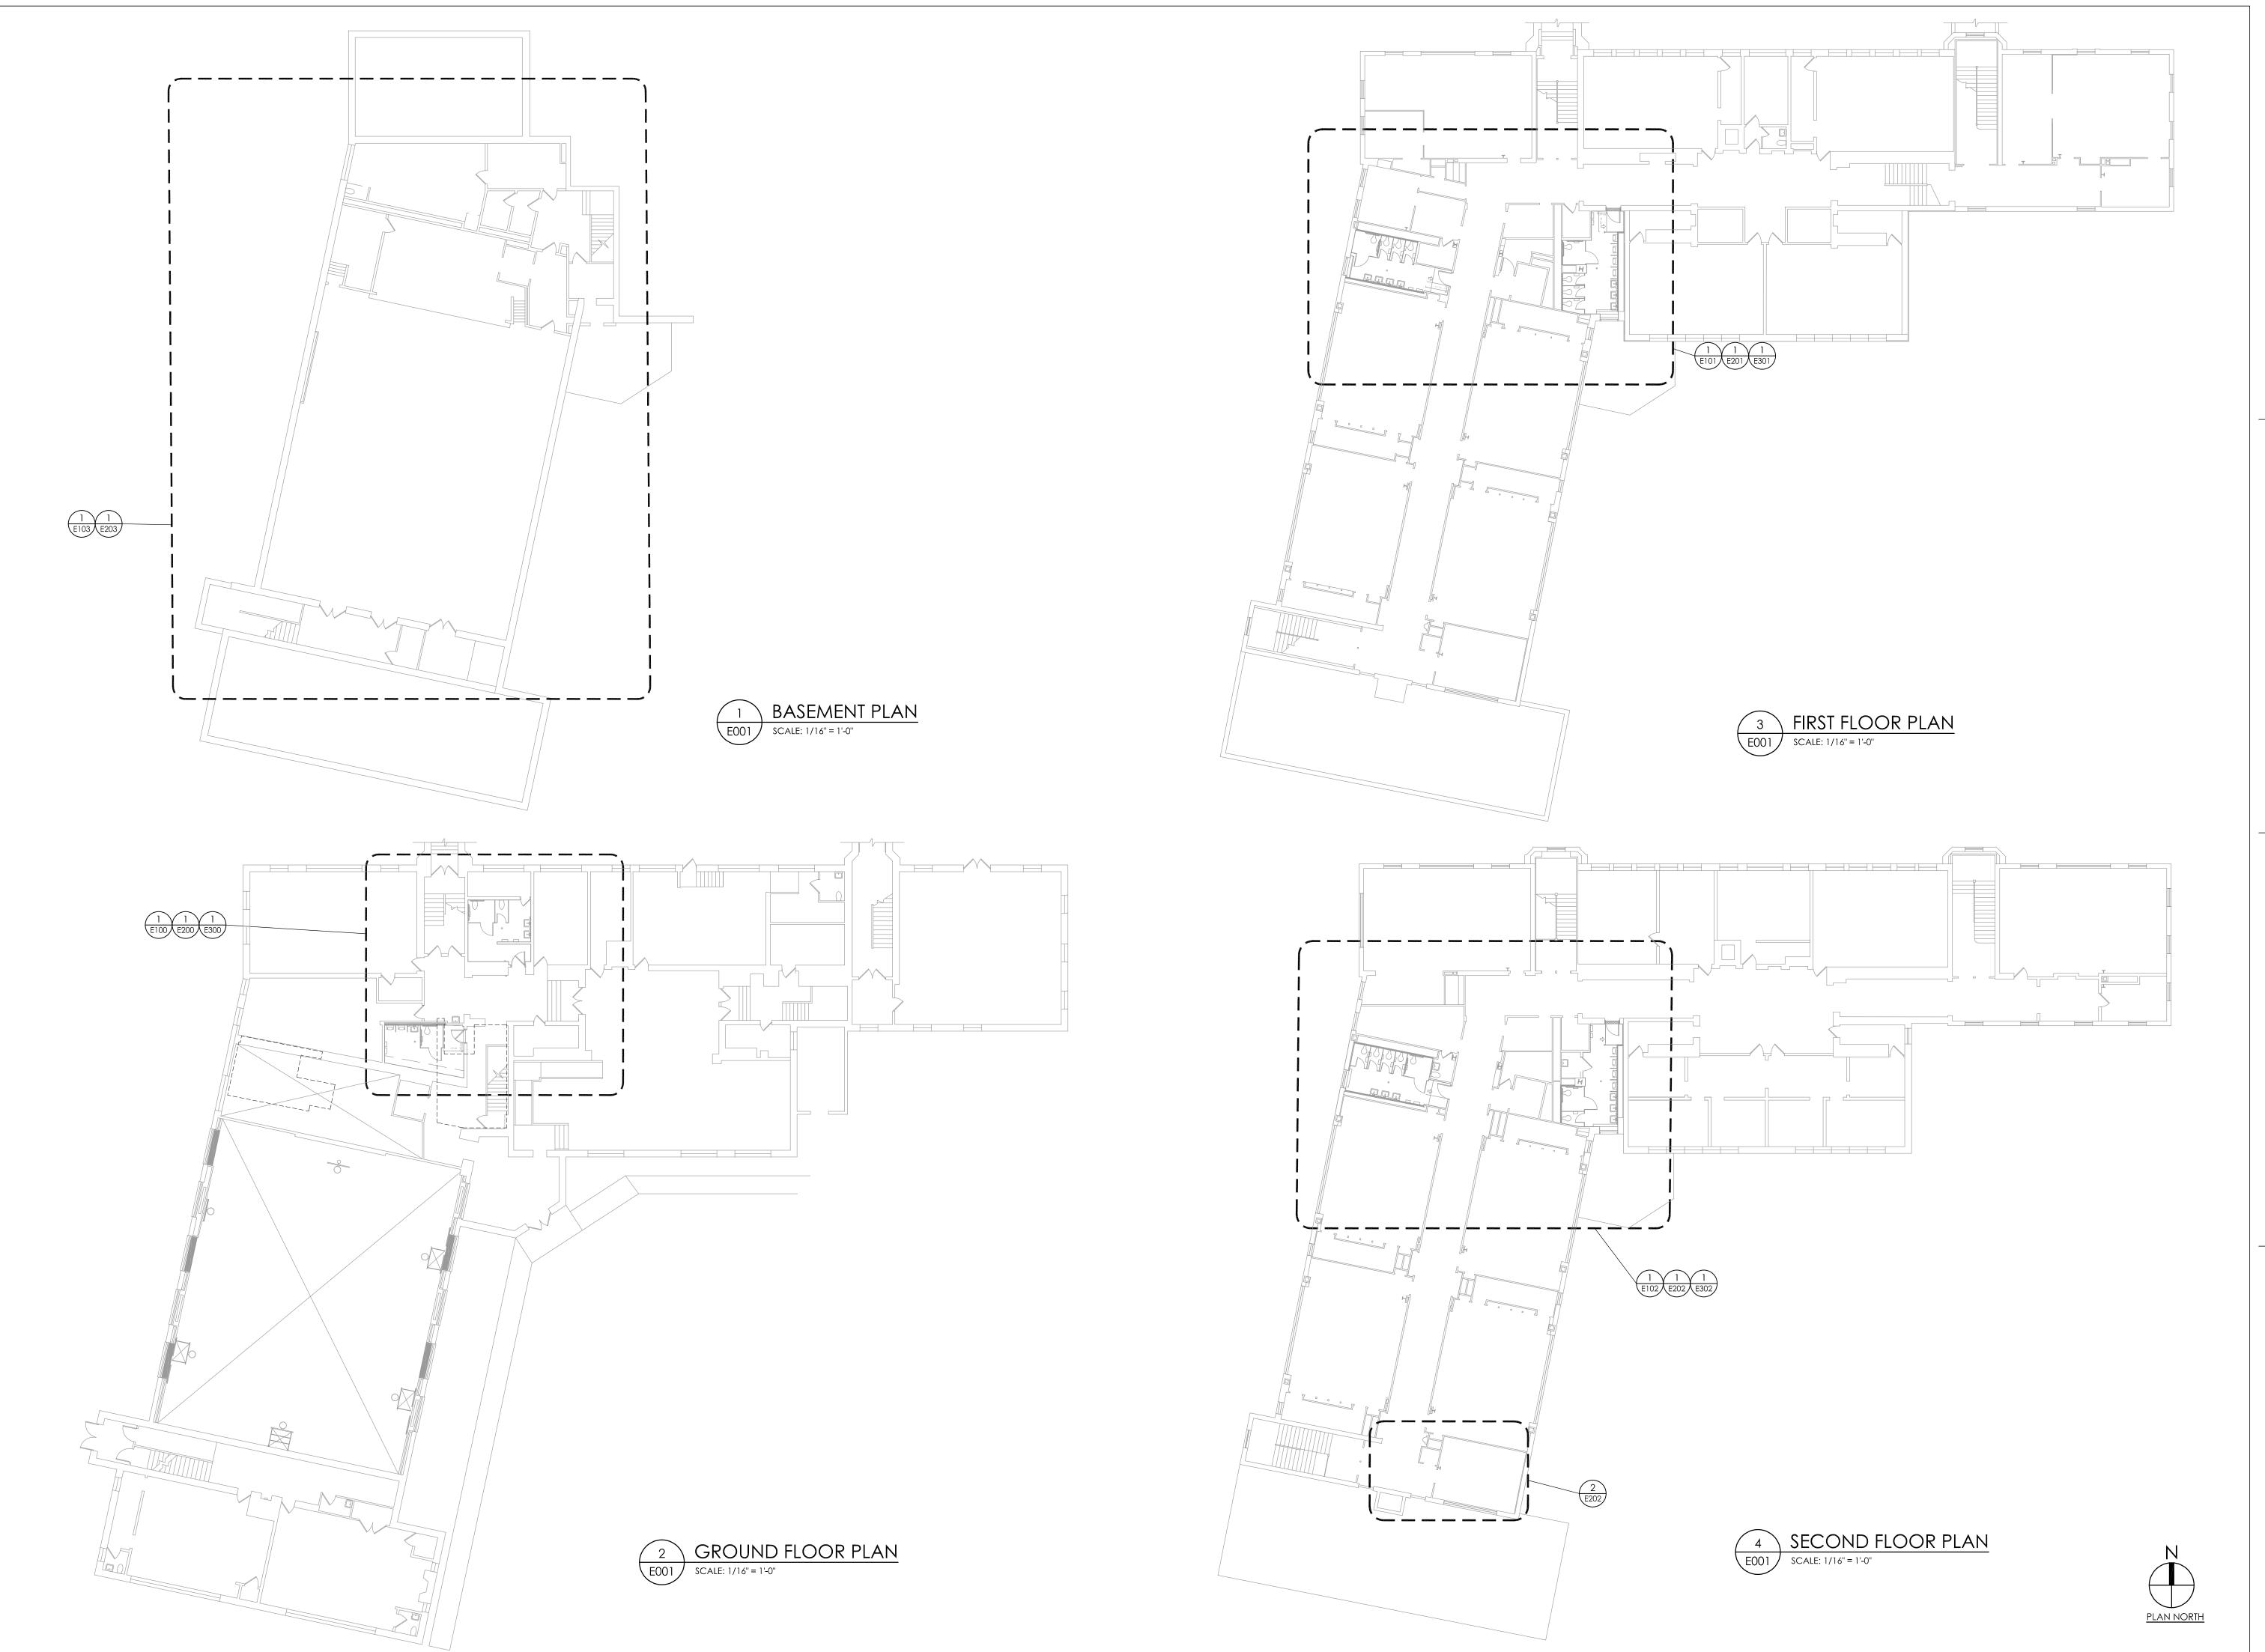
Drawing Title

11/15/2021 AS INDICATED Project Status

BID SET Drawn By Checked By MAY JAS

Drawing Number

ELECTRICAL LEGEND AND NOTES





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PROJECT INFORMATION

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No. Date Description


SHEET INFORMATION Issued

11/15/2021 AS INDICATED Project Status

BID SET Drawn By Checked By MAY

Drawing Title OVERALL ELECTRICAL PLANS

Drawing Number

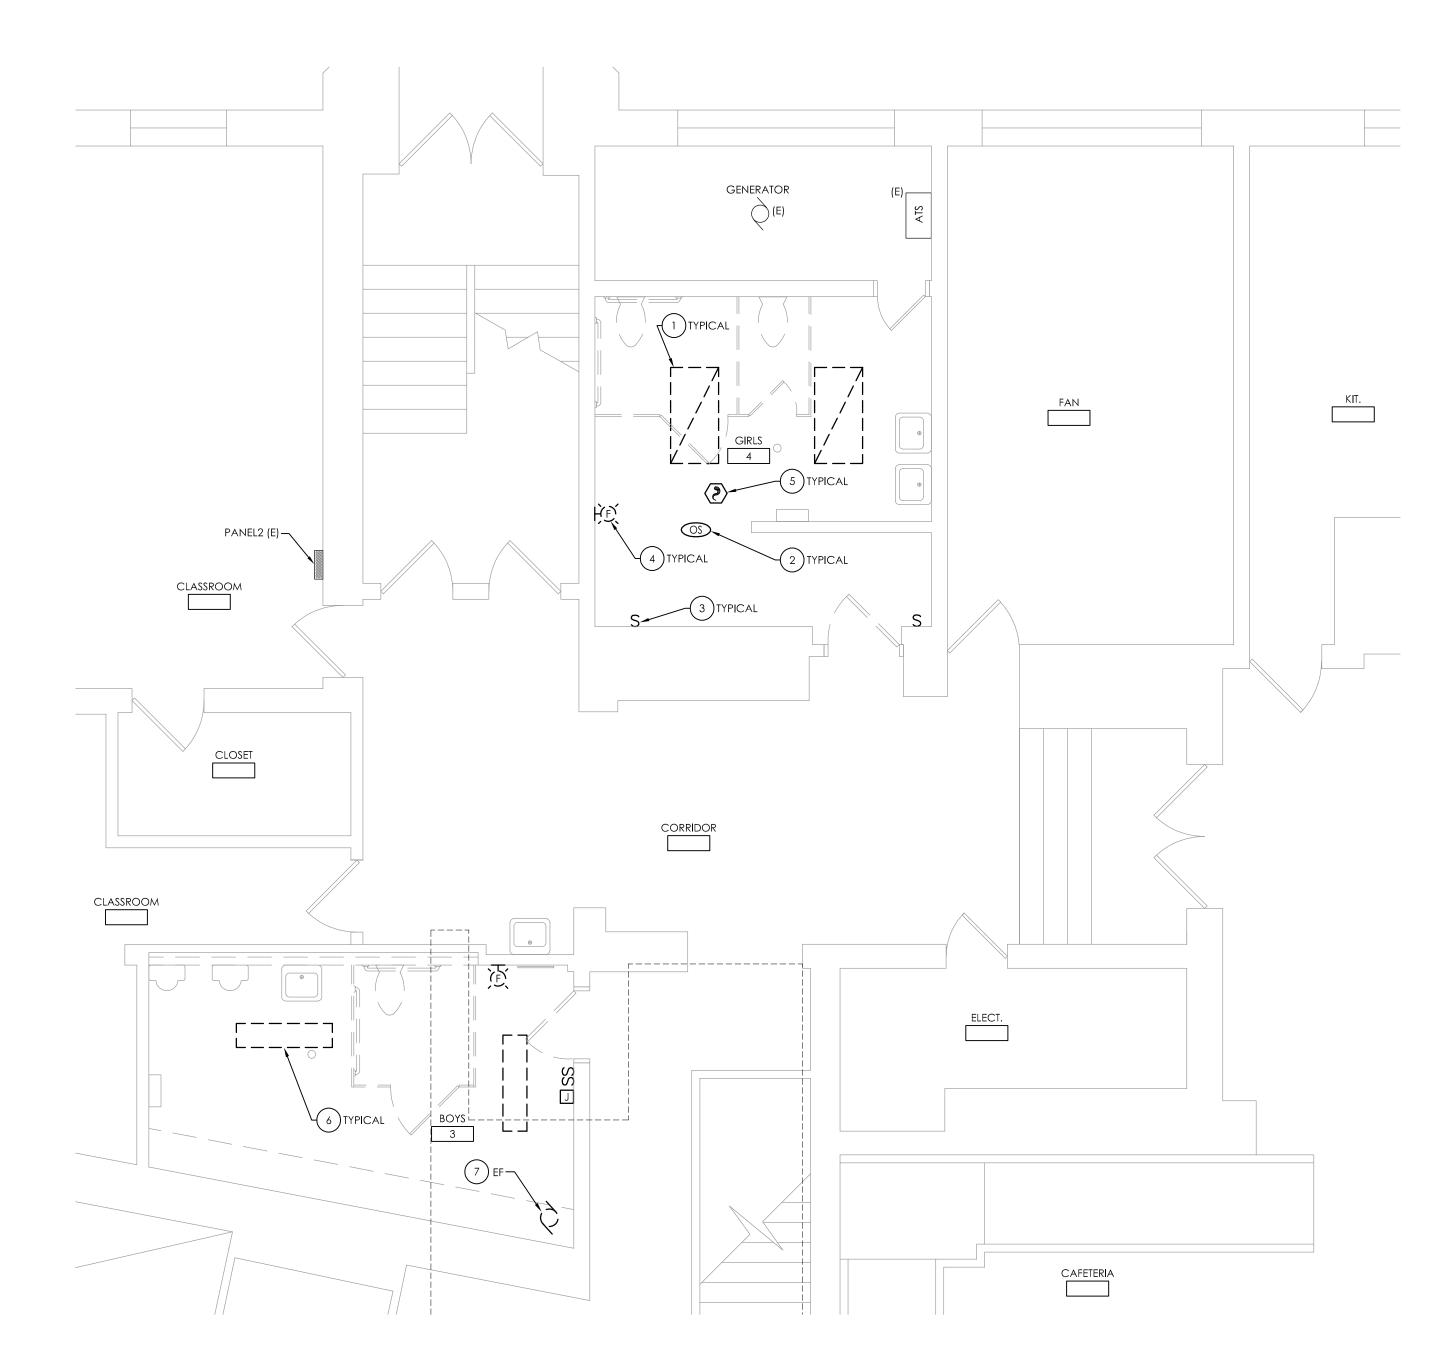

GROUND FLOOR ELECTRICAL DEMOLITION PLAN

SCALE: 1/4" = 1'-0"

GENERAL NOTES:

- A. ALL ITEMS SHOWN ARE TO BE REMOVED UNLESS LABELED AS (E) EXISTING TO REMAIN. ANY DEVICE, AS WELL AS ITS ASSOCIATED CIRCUITING, AND CONDUIT, LABELED "(E)" SHALL REMAIN, UNLESS OTHERWISE NOTED.
- B. INFORMATION ON DRAWINGS WAS OBTAINED THROUGH FIELD OBSERVATION AND AS-BUILT DOCUMENTATION. THE CONTRACTOR IS RESPONSIBLE FOR THE REMOVAL AND REPLACEMENT OF ANY DEVICES AND CABLING THAT MAY NOT BE SHOWN ON DRAWING AT NO ADDITIONAL COST TO OWNER.
- C. DRAWINGS ARE GRAPHICAL REPRESENTATIONS OF APPROXIMATE EQUIPMENT AND DEVICE LOCATIONS. CONTRACTOR SHALL VISIT THE SITE TO DETERMINE THE EXACT EXTENT OF ELECTRICAL WORK REQUIRED TO COMPLETE THE PROJECT. EXISTING CONDITIONS ARE TAKEN FROM FIELD OBSERVATION AND EXISTING BUILDING DOCUMENTS. OTHER ELECTRICAL ITEMS MAY EXIST FOR WHICH THE CONTRACTOR IS RESPONSIBLE AT NO ADDITIONAL COST.
- D. THE CONTRACTOR SHALL REMOVE THE EXISTING ELECTRIC IN AREAS OF NEW RENOVATIONS TO ACCOMMODATE NEW CONSTRUCTION. REROUTING OF EXISTING MAY BE REQUIRED AT NEW OPENINGS IN EXISTING CONSTRUCTION OR INTERFERENCE WITH OTHER NEW WORK AS NOTED IN THE FOLLOWING NOTES.
- E. DRAWINGS INDICATE SPECIFIC ITEMS TO BE REMOVED AND/OR RELOCATED IN ORDER TO INDICATE GENERAL SCOPE. ADDITIONAL ITEMS NOT INDICATED, BUT NECESSARY FOR PROJECT RENOVATIONS, SHALL BE REMOVED, RELOCATED AND/OR REROUTED AS REQUIRED TO ACCOMMODATE THE NEW CONSTRUCTION.
- F. COORDINATE DEMOLITION OF EQUIPMENT, DEVICES, ETC. WITH OTHER DISCIPLINES AS APPLICABLE. REFER TO ARCHITECTURAL DEMOLITION DRAWINGS AND NOTES FOR COORDINATION.
- G. ALL ITEMS (DEVICES, FIXTURES, ETC.) SHOWN ARE TO BE REMOVED UNLESS Labeled as existing to remain - (e). These items and their related WIRING/CONDUIT SHALL BE REMOVED BACK TO THE SOURCE CONTROL PANEL/PANELBOARD UNLESS OTHERWISE NOTED. ON CIRCUITS WHERE OTHER DEVICES, FIXTURES, ETC. ARE FOUND THAT MUST REMAIN, MAINTAIN CIRCUIT CONTINUITY BY PROVIDING ADDITIONAL WIRING, TO FEED THROUGH TO THESE REMAINING ITEMS. RELOCATE ANY CIRCUITS THAT REMAIN, TO AVOID CONFLICT WITH NEW CONSTRUCTION AS REQUIRED. PROPERLY TERMINATE ALL WIRING.
- H. CONTRACTOR SHALL PROPERLY DISPOSE OF ALL ITEMS AND/OR EQUIPMENT BEING REMOVED AS PART OF THE PROJECT. THE OWNER SHALL HAVE THE RIGHT OF RETAINING ANY ITEMS BEING REMOVED.
- I. CONTRACTOR SHALL PROVIDE NEW COVERPLATES ON ALL UNUSED FLUSH MOUNT DEVICE BOXES UPON COMPLETION OF PROJECT.
- J. FIREPROOFING AND/OR FIRE STOP MATERIALS REMOVED FROM FIRE RATED WALLS AND CEILINGS AS A RESULT OF DEMOLITION SHALL BE RE-INSTALLED USING AN APPROVED METHOD AS DESCRIBED IN ASSOCIATED PROJECT SPECIFICATIONS.

KEY NOTES:

- (1) DISCONNECT AND REMOVE 2'X4' RECESSED LIGHT FIXTURE AND ALL INTERCONNECTING BRANCH CIRCUIT WIRING. MAINTAIN EXISTING LIGHTING BRANCH CIRCUIT HOMERUN FROM SOURCE TO REMAIN FOR
- (2) DISCONNECT AND REMOVE OCCUPANCY SENSOR AND ALL ASSOCIATED WIRING AND POWER PACKS.
- (3) DISCONNECT AND REMOVE ALL LIGHT SWITCHES AND WIRING UP TO CEILING AREA. CONDUIT AND BACKBOX TO REMAIN TO ACCOMMODATE NEW SWITCHING. TYPICAL OF ALL SWITCHING BUILDING WIDE.
- (4) DISCONNECT AND REMOVE FIRE ALARM STROBE DEVICE AND STORE FOR REUSE. REMOVE SURFACE RACEWAY UP TO ABOVE CEILING AND MAINTAIN WIRING FOR REUSE AND EXTENSION TO RELOCATED DEVICE.
- (5) DISCONNECT AND REMOVE FIRE ALARM SMOKE DETECTOR DEVICE AND STORE FOR REUSE. MAINTAIN WIRING FOR REUSE AND EXTENSION TO RELOCATED DEVICE.
- (6) DISCONNECT AND REMOVE 1'X4' SURFACE MOUNTED LIGHT FIXTURE AND ALL INTERCONNECTING BRANCH CIRCUIT WIRING. MAINTAIN EXISTING LIGHTING BRANCH CIRCUIT HOMERUN FROM SOURCE TO REMAIN FOR
- (7) DISCONNECT AND REMOVE POWER CONDUCTORS AND CONDUIT FROM EXHAUST FAN BACK TO SOURCE. REMOVE EXISTING MOTOR CONTROLLER IN ITS ENTIRETY.

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SHEET INFORMATION Issued

> 11/15/2021 AS INDICATED Project Status **BID SET** Drawn By Checked By MAY

Drawing Title GROUND FLOOR ELECTRICAL DEMOLITION PLAN



FIRST FLOOR ELECTRICAL DEMOLITION PLAN


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KEY NOTES:

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- 2) DISCONNECT AND REMOVE POWER BRANCH CIRCUIT WIRING AND CONDUIT SERVING EXHAUST FAN BACK TO SOURCE.
- 3 DISCONNECT AND REMOVE ALL LIGHT SWITCHES AND WIRING UP TO CEILING AREA. CONDUIT AND BACKBOX TO REMAIN TO ACCOMMODATE NEW SWITCHING. TYPICAL OF ALL SWITCHING BUILDING WIDE.
- 4) DISCONNECT AND REMOVE FIRE ALARM STROBE DEVICE AND STORE FOR REUSE. REMOVE SURFACE RACEWAY UP TO ABOVE CEILING AND MAINTAIN WIRING FOR REUSE AND EXTENSION TO RELOCATED DEVICE.
- 5 DISCONNECT AND REMOVE 1'X4' SURFACE MOUNTED LIGHT FIXTURE AND ALL INTERCONNECTING BRANCH CIRCUIT WIRING. MAINTAIN EXISTING LIGHTING BRANCH CIRCUIT HOMERUN FROM SOURCE TO REMAIN FOR RE-USE.



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Issued

MAY
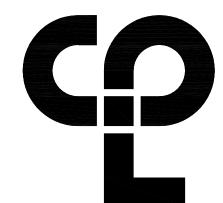
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Project Status

BID SET


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FIRST FLOOR ELECTRICAL
DEMOLITION PLAN

RES F101

KEY NOTES:


- DISCONNECT AND REMOVE 2'X4' RECESSED LIGHT FIXTURE AND ALL INTERCONNECTING BRANCH CIRCUIT WIRING. MAINTAIN EXISTING LIGHTING BRANCH CIRCUIT HOMERUN FROM SOURCE TO REMAIN FOR REUSE.
- 2 DISCONNECT AND REMOVE OCCUPANCY SENSOR AND ALL ASSOCIATED WIRING AND POWER PACKS.
- 3 DISCONNECT AND REMOVE ALL LIGHT SWITCHES AND WIRING UP TO CEILING AREA. CONDUIT AND BACKBOX TO REMAIN TO ACCOMMODATE NEW SWITCHING. TYPICAL OF ALL SWITCHING BUILDING WIDE.
- 4) DISCONNECT AND REMOVE FIRE ALARM STROBE DEVICE AND STORE FOR REUSE. REMOVE SURFACE RACEWAY UP TO ABOVE CEILING AND MAINTAIN WIRING FOR REUSE AND EXTENSION TO RELOCATED DEVICE.
- 5 DISCONNECT EXISTING POWER BRANCH CIRCUIT FROM EXHAUST FAN AND MAINTAIN FOR RECONNECTION TO REPLACEMENT EXHAUST FAN. REMOVE EXISTING MOTOR CONTROLLER IN ITS ENTIRETY.

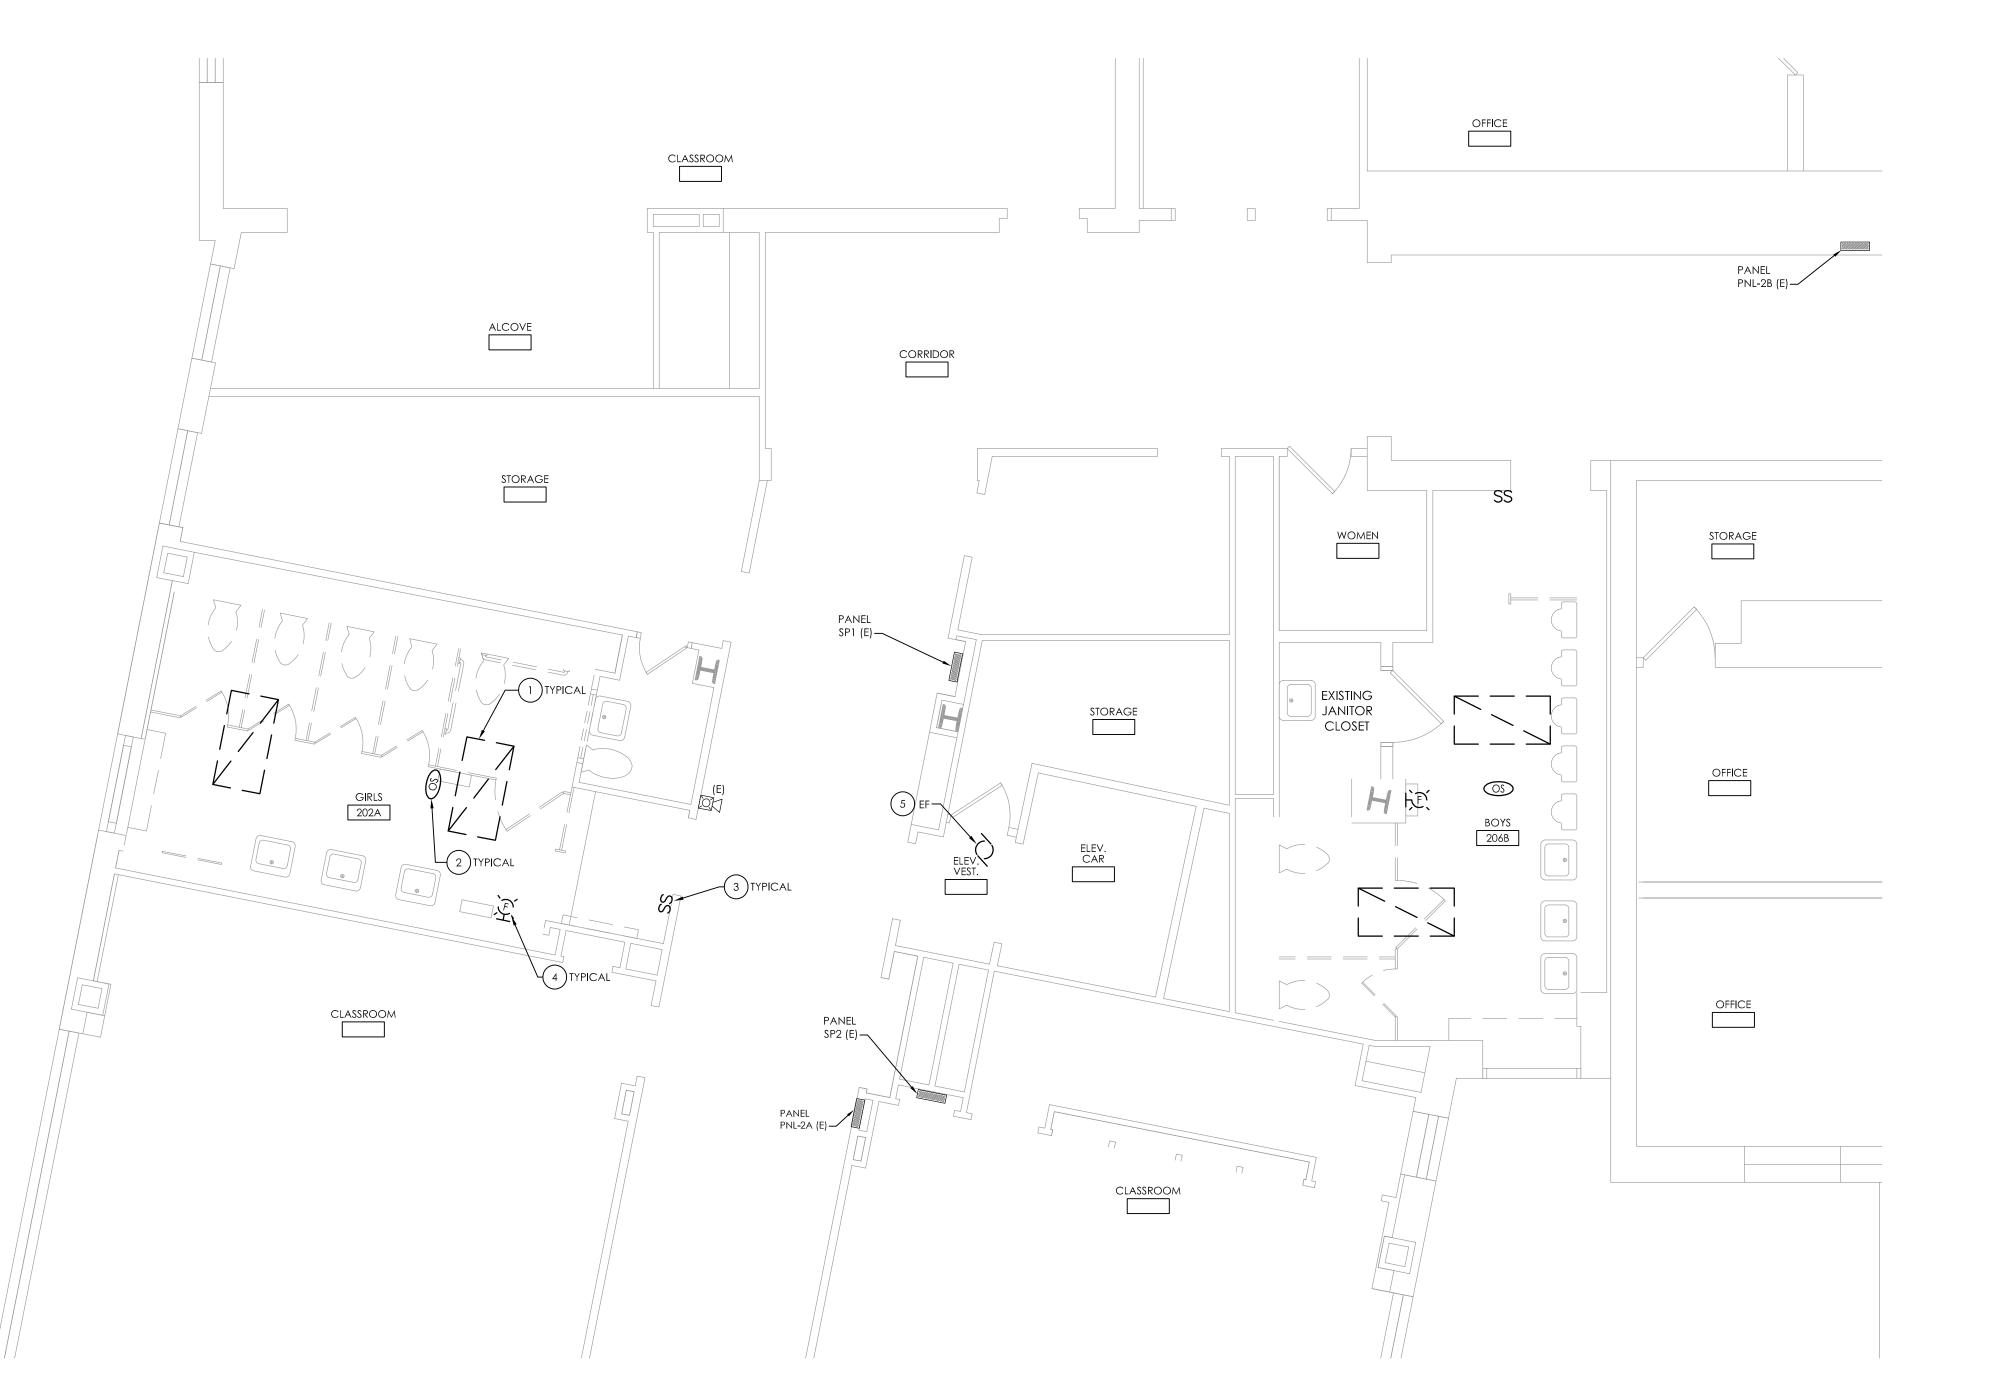

1 SECOND FLOOR ELECTRICAL DEMOLITION PLAN SCALE: 1/4" = 1'-0"

GENERAL NOTES:

- A. ALL ITEMS SHOWN ARE TO BE REMOVED UNLESS LABELED AS (E) EXISTING TO REMAIN. ANY DEVICE, AS WELL AS ITS ASSOCIATED CIRCUITING, AND CONDUIT, LABELED "(E)" SHALL REMAIN, UNLESS OTHERWISE NOTED.
- B. INFORMATION ON DRAWINGS WAS OBTAINED THROUGH FIELD OBSERVATION AND AS-BUILT DOCUMENTATION. THE CONTRACTOR IS RESPONSIBLE FOR THE REMOVAL AND REPLACEMENT OF ANY DEVICES AND CABLING THAT MAY NOT BE SHOWN ON DRAWING AT NO ADDITIONAL COST TO OWNER.
- C. DRAWINGS ARE GRAPHICAL REPRESENTATIONS OF APPROXIMATE EQUIPMENT AND DEVICE LOCATIONS. CONTRACTOR SHALL VISIT THE SITE TO DETERMINE THE EXACT EXTENT OF ELECTRICAL WORK REQUIRED TO COMPLETE THE PROJECT. EXISTING CONDITIONS ARE TAKEN FROM FIELD OBSERVATION AND EXISTING BUILDING DOCUMENTS. OTHER ELECTRICAL ITEMS MAY EXIST FOR WHICH THE CONTRACTOR IS RESPONSIBLE AT NO ADDITIONAL COST.
- D. THE CONTRACTOR SHALL REMOVE THE EXISTING ELECTRIC IN AREAS OF NEW RENOVATIONS TO ACCOMMODATE NEW CONSTRUCTION.
 REROUTING OF EXISTING MAY BE REQUIRED AT NEW OPENINGS IN EXISTING CONSTRUCTION OR INTERFERENCE WITH OTHER NEW WORK AS NOTED IN THE FOLLOWING NOTES.
- E. DRAWINGS INDICATE SPECIFIC ITEMS TO BE REMOVED AND/OR RELOCATED IN ORDER TO INDICATE GENERAL SCOPE. ADDITIONAL ITEMS NOT INDICATED, BUT NECESSARY FOR PROJECT RENOVATIONS, SHALL BE REMOVED, RELOCATED AND/OR REROUTED AS REQUIRED TO ACCOMMODATE THE NEW CONSTRUCTION.
- F. COORDINATE DEMOLITION OF EQUIPMENT, DEVICES, ETC. WITH OTHER DISCIPLINES AS APPLICABLE. REFER TO ARCHITECTURAL DEMOLITION DRAWINGS AND NOTES FOR COORDINATION.
- G. ALL ITEMS (DEVICES, FIXTURES, ETC.) SHOWN ARE TO BE REMOVED UNLESS LABELED AS EXISTING TO REMAIN (E). THESE ITEMS AND THEIR RELATED WIRING/CONDUIT SHALL BE REMOVED BACK TO THE SOURCE CONTROL PANEL/PANELBOARD UNLESS OTHERWISE NOTED. ON CIRCUITS WHERE OTHER DEVICES, FIXTURES, ETC. ARE FOUND THAT MUST REMAIN, MAINTAIN CIRCUIT CONTINUITY BY PROVIDING ADDITIONAL WIRING, TO FEED THROUGH TO THESE REMAINING ITEMS. RELOCATE ANY CIRCUITS THAT REMAIN, TO AVOID CONFLICT WITH NEW CONSTRUCTION AS REQUIRED. PROPERLY TERMINATE ALL WIRING.
- H. CONTRACTOR SHALL PROPERLY DISPOSE OF ALL ITEMS AND/OR EQUIPMENT BEING REMOVED AS PART OF THE PROJECT. THE OWNER SHALL HAVE THE RIGHT OF RETAINING ANY ITEMS BEING REMOVED.
- I. CONTRACTOR SHALL PROVIDE NEW COVERPLATES ON ALL UNUSED FLUSH MOUNT DEVICE BOXES UPON COMPLETION OF PROJECT.
- J. FIREPROOFING AND/OR FIRE STOP MATERIALS REMOVED FROM FIRE RATED WALLS AND CEILINGS AS A RESULT OF DEMOLITION SHALL BE RE-INSTALLED USING AN APPROVED METHOD AS DESCRIBED IN ASSOCIATED PROJECT SPECIFICATIONS.

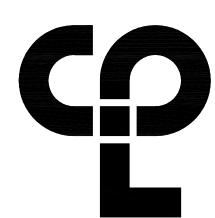

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PROJECT INFORMATION

14428.18

OSSINING UNION FREE SCHOOL DISTRICT

2021-2022 CIP

District Office Address
400 EXECUTIVE BLVD OSSINING, NY 10562

OSSINING UNION FREE SCHOOL DISTRICT

ANNE M. DORNER MS SED# 66-14-01-03-0-008-028

ROOSEVELT ES SED# 66-14-01-03-0-005-022

OSSINING HS SED# 66-14-01-03-0-003-043

PROJECT ISSUE & REVISION SCHEDULE

No. Date Description

NEW YORK STATE EDUCATION STATEMENT

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SHEET INFORMATION

Issued 11/15/2021 Project Status BID SET

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SECOND FLOOR ELECTRICAL DEMOLITION PLAN

AS INDICATED

RES

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KEY NOTES:

- (1) DISCONNECT AND REMOVE POWER BRANCH CIRCUIT FROM EXHAUST FAN BACK TO SOURCE. REMOVE EXISTING MOTOR CONTROLLER IN ITS ENTIRETY.
- (2) DISCONNECT POWER BRANCH CIRCUIT FROM UNIT VENTILATOR AND MAINTAIN FOR RECONNECTION TO REPLACEMENT UNIT VENTILATOR.

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OSSINING UNION FREE SCHOOL DISTRICT

2021-2022 CIP

400 EXECUTIVE BLVD OSSINING, NY 10562

OSSINING UNION FREE SCHOOL DISTRICT ANNE M. DORNER MS SED# 66-14-01-03-0-008-028

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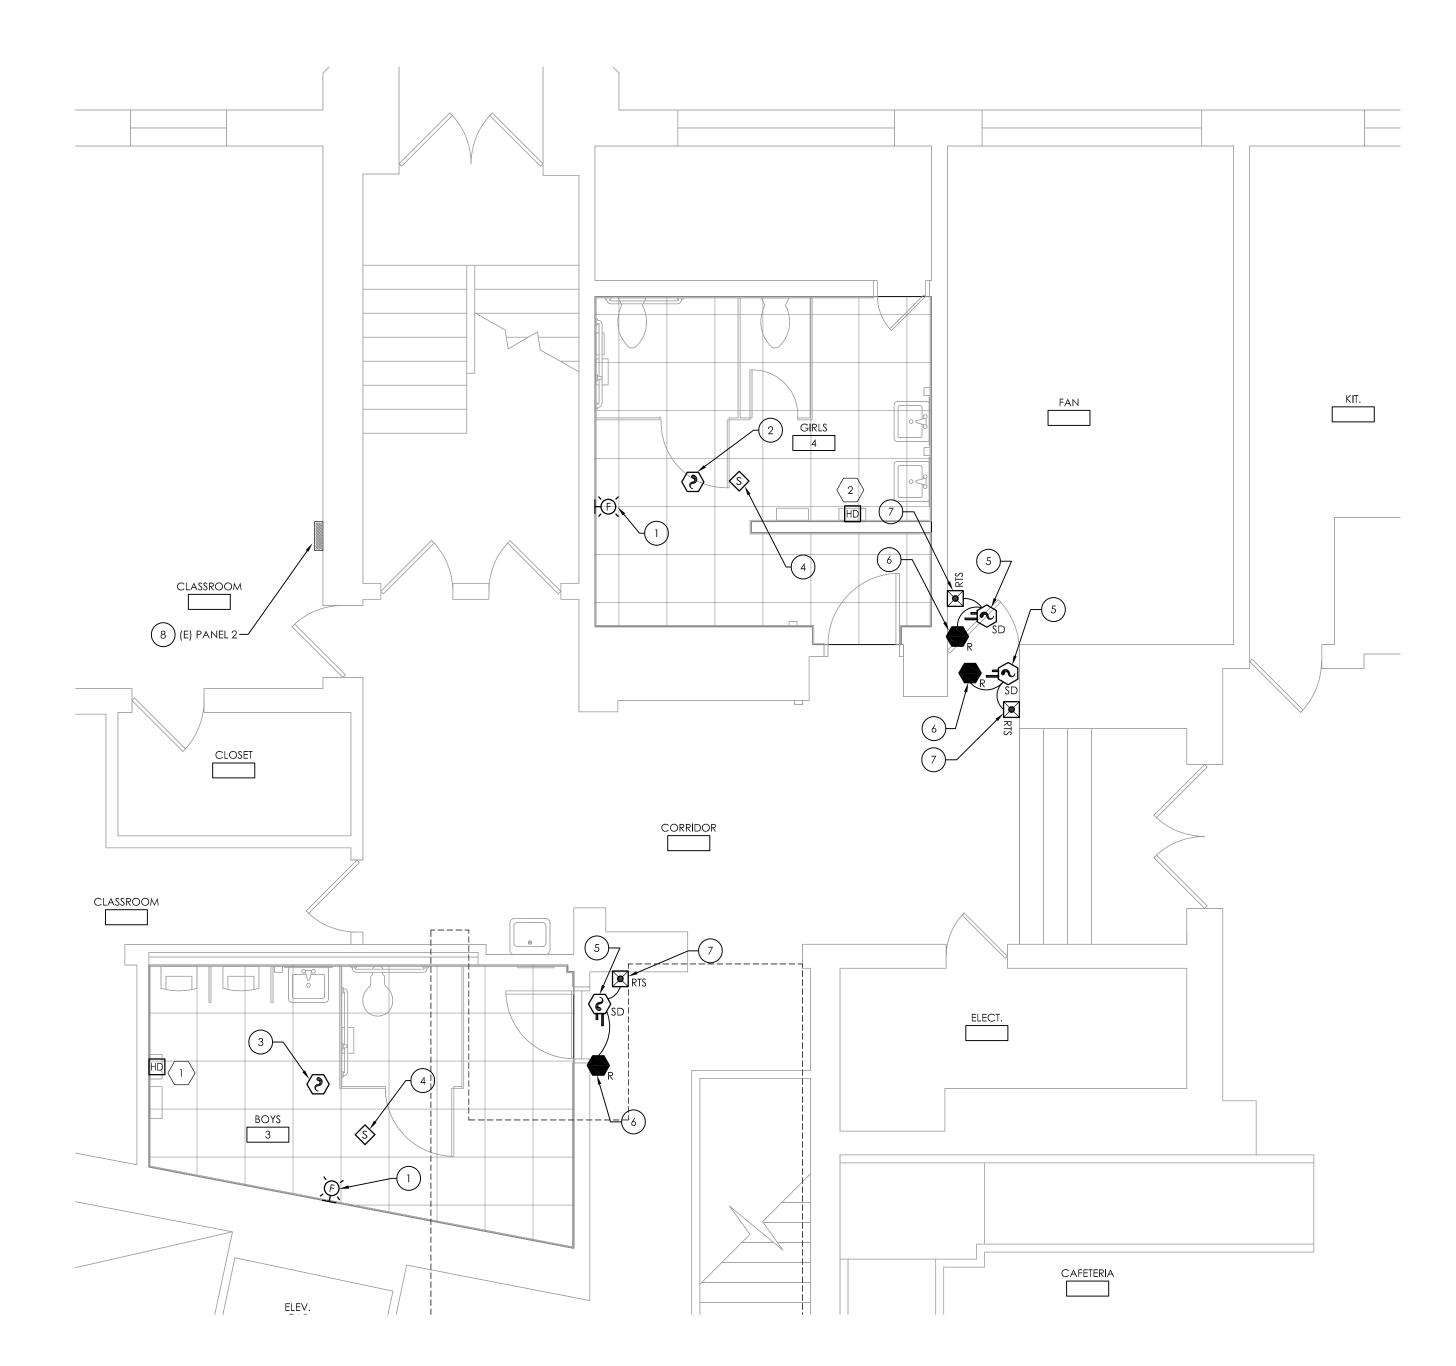
PROJECT ISSUE & REVISION SCHEDULE

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11/15/2021 AS INDICATED Project Status **BID SET** Drawn By

MAY GYMNASIUM ELECTRICAL

DEMOLITION PLAN




1 GROUND FLOOR POWER & SYSTEMS PLAN
E200 SCALE: 1/4" = 1'-0"

GENERAL NOTES:

- A. AT EACH $\langle x \rangle$ SYMBOL INDICATES, REFER TO ELECTRICAL EQUIPMENT WIRING SCHEDULE ON DRAWING RES E900.
- B. PROVIDE PUBLIC ADDRESS SYSTEM SPEAKER WIRING PER SYSTEM MANUFACTURER RECOMMENDATIONS. CIRCUIT TO NEAREST SPEAKER IN CORRIDOR.
- B. INFORMATION ON DRAWING WAS OBTAINED THROUGH FIELD
 OBSERVATION AND AS-BUILT DOCUMENTATION. AREAS WITHOUT NEW FIRE
 ALARM DEVICES ARE NOT PART OF PROJECT SCOPE AND HAVE BEEN FIELD
 VERIFIED AND DETERMINED TO MEET NEW YORK STATE SED REQUIREMENTS
 MANUAL PLANNING STANDARDS 2014 VERSION.
- C. DRAWINGS ARE GRAPHICAL REPRESENTATIONS OF APPROXIMATE EQUIPMENT AND DEVICE LOCATIONS. CONTRACTOR SHALL VISIT THE SITE TO DETERMINE THE EXACT EXTENT OF FIRE ALARM WORK REQUIRED TO COMPLETE THE PROJECT.
- D. FINAL TESTING OF FIRE ALARM SYSTEM SHALL COMPLY WITH ALL NFPA 72 REQUIREMENTS. ANY ALTERED CIRCUIT(S) SHALL HAVE ALL ASSOCIATED LOOP DEVICES TESTED IN THEIR ENTIRETY AND 10% OF NEIGHBORING ZONE/LOOP DEVICES ARE ALSO TO BE TESTED.
- E. ALL SYSTEMS CABLING SHALL BE RUN IN FREE-AIR AND SUPPORTED ABOVE CEILINGS VIA J-HOOKS. J-HOOKS NOT TO EXCEED 5-0" SPACING.
- F. FIRE ALARM CABLING RUN EXPOSED IN UNFINISHED AREAS SHALL BE INSTALLED IN EMT CONDUIT AND PAINTED TO MATCH EXISTING WALL/CEILING FINISH. HORIZONTAL RUNS THROUGH WALLS AND VERTICAL RUNS THROUGH FLOORS SHALL BE SLEEVED IN EMT CONDUIT AND FIRE CAULKED. ALL FIRE ALARM CABLING RUN EXPOSED IN FINISHED SPACES SHALL BE INSTALLED IN 500 SERIES STEEL WIREMOLD. IVORY IN COLOR.
- G. CABLE DUCT SMOKE DETECTOR INITIATING FIRE ALARM CIRCUIT IN RACEWAY TO EXISTING FIRE ALARM CONTROL PANEL LOCATED IN FRONT ENTRY VESTIBULE.
- H. REFER TO MANUFACTURER INSTALLATION GUIDELINES FOR DUCT SMOKE DETECTOR INSTALLATION.
- INSTALL DUCT SMOKE DETECTORS WITHIN DUCTWORK, COORDINATE WITH HVAC FOR INSTALLATION.

KEY NOTES:

- 1) REINSTALL EXISTING STORED FIRE ALARM STROBE DEVICE IN THIS LOCATION. EXTEND AND RECONNECT TO EXISTING MAINTAINED FIRE ALARM CIRCUIT.
- 2 REINSTALL EXISTING STORED FIRE SMOKE DETECTOR DEVICE IN THIS LOCATION. EXTEND AND RECONNECT TO EXISTING MAINTAINED FIRE ALARM CIRCUIT.
- 3 PROVIDE FIRE ALARM SMOKE DETECTOR AND FIRE ALARM CIRCUIT AND CONNECT TO NEAREST FIRE ALARM INITIATING CIRCUIT IN CORRIDOR.
- (4) PROVIDE PUBLIC ADDRESS SYSTEM SPEAKER AND SYSTEM CABLE.
 CONNECT TO NEAREST PUBLIC ADDRESS SYSTEM SPEAKER CIRCUIT IN
 CORRIDOR.
- 5 PROVIDE DUCT SMOKE DETECTOR TO INTERACT WITH FIRE/SMOKE DAMPER. DUCT SMOKE DETECTOR SHALL CLOSE DAMPER UPON ACTIVATION.
- 6 PROVIDE FAN SHUT DOWN RELAYS AT DAMPER HVAC CONTROLS.
 INTERCONNECT RELAYS TO BUILDING FIRE ALARM SYSTEM TO CLOSE
 SMOKE DAMPER WHEN THE FIRE ALARM SYSTEM IS ACTIVATED.
- 7 PROVIDE WALL MOUNTED REMOTE TEST SWITCHES MOUNTED HIGH UP NEAR CEILING. SWITCHES ARE ASSOCIATED WITH DUCT SMOKE DETECTOR FOR THE CLOSING OF SMOKE DAMPER WITHIN DUCTWORK. COORDINATE LOCATION AND MOUNTING WITH OWNER PRIOR TO INSTALLATION.
- 8 PROVIDE (2) 20 AMP, 2-POLE 208 VOLT, 10K AIC CIRCUIT BREAKERS (SERVE HAND DRYERS) INSTALLED WITHIN EXISTING PANELBOARD. CIRCUIT BREAKERS TO BE UL LISTED FOR INSTALLATION WITHIN EXISTING PANEL MANUFACTURER.

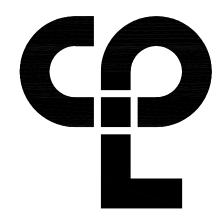

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OSSINING UNION FREE SCHOOL DISTRICT

ANNE M. DORNER MS SED# 66-14-01-03-0-008-028

ROOSEVELT ES SED# 66-14-01-03-0-005-022

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SHEET INFORMATION

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11/15/2021 AS INDICATED

Project Status

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GROUND FLOOR POWER & SYSTEMS PLAN

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Drawing Number

RES E200



FIRST FLOOR POWER & SYSTEMS PLAN


SCALE: 1/4" = 1'-0"

GENERAL NOTES:

- A. AT EACH (X) SYMBOL INDICATES, REFER TO ELECTRICAL EQUIPMENT WIRING SCHEDULE ON DRAWING RES E900.
- B. PROVIDE PUBLIC ADDRESS SYSTEM SPEAKER WIRING PER SYSTEM MANUFACTURER RECOMMENDATIONS. CIRCUIT TO NEAREST SPEAKER IN CORRIDOR.
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- E. ALL SYSTEMS CABLING SHALL BE RUN IN FREE-AIR AND SUPPORTED ABOVE CEILINGS VIA J-HOOKS. J-HOOKS NOT TO EXCEED 5-0" SPACING.
- F. FIRE ALARM CABLING RUN EXPOSED IN UNFINISHED AREAS SHALL BE INSTALLED IN EMT CONDUIT AND PAINTED TO MATCH EXISTING WALL/CEILING FINISH. HORIZONTAL RUNS THROUGH WALLS AND VERTICAL RUNS THROUGH FLOORS SHALL BE SLEEVED IN EMT CONDUIT AND FIRE CAULKED. ALL FIRE ALARM CABLING RUN EXPOSED IN FINISHED SPACES SHALL BE INSTALLED IN 500 SERIES STEEL WIREMOLD. IVORY IN COLOR.
- G. CABLE DUCT SMOKE DETECTOR INITIATING FIRE ALARM CIRCUIT IN RACEWAY TO EXISTING FIRE ALARM CONTROL PANEL LOCATED IN FRONT ENTRY VESTIBULE.
- H. REFER TO MANUFACTURER INSTALLATION GUIDELINES FOR DUCT SMOKE DETECTOR INSTALLATION.
- INSTALL DUCT SMOKE DETECTORS WITHIN DUCTWORK, COORDINATE WITH HVAC FOR INSTALLATION.

KEY NOTES:

- 1) REINSTALL EXISTING STORED FIRE ALARM STROBE DEVICE IN THIS LOCATION. EXTEND AND RECONNECT TO EXISTING MAINTAINED FIRE ALARM CIRCUIT.
- 2) PROVIDE FIRE ALARM SMOKE DETECTOR AND FIRE ALARM CIRCUIT AND CONNECT TO NEAREST FIRE ALARM INITIATING CIRCUIT IN CORRIDOR.
- 3 PROVIDE PUBLIC ADDRESS SYSTEM SPEAKER AND SYSTEM CABLE.
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Newburgh, NY 12550
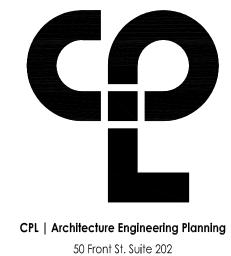
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OSSINING UNION FREE SCHOOL DISTRICT

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OSSINING HS SED# 66-14-01-03-0-003-043

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SHEET INFORMATION

Issued Scale
11/15/2021 AS INDICATED
Project Status
BID SET

Drawn By Checked By MAY JAS
Drawing Title

FIRST FLOOR POWER & SYSTEMS PLAN

RES

- A. AT EACH $\langle x \rangle$ SYMBOL INDICATES, REFER TO ELECTRICAL EQUIPMENT WIRING SCHEDULE ON DRAWING RES E900.
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PROJECT ISSUE & REVISION SCHEDULE

No. Date Description
1 5/17/22 SED Addendum No. 2


SHEET INFORMATION Issued

11/15/2021 AS INDICATED Project Status **BID SET**

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SECOND FLOOR POWER & Systems plan

Drawing Number

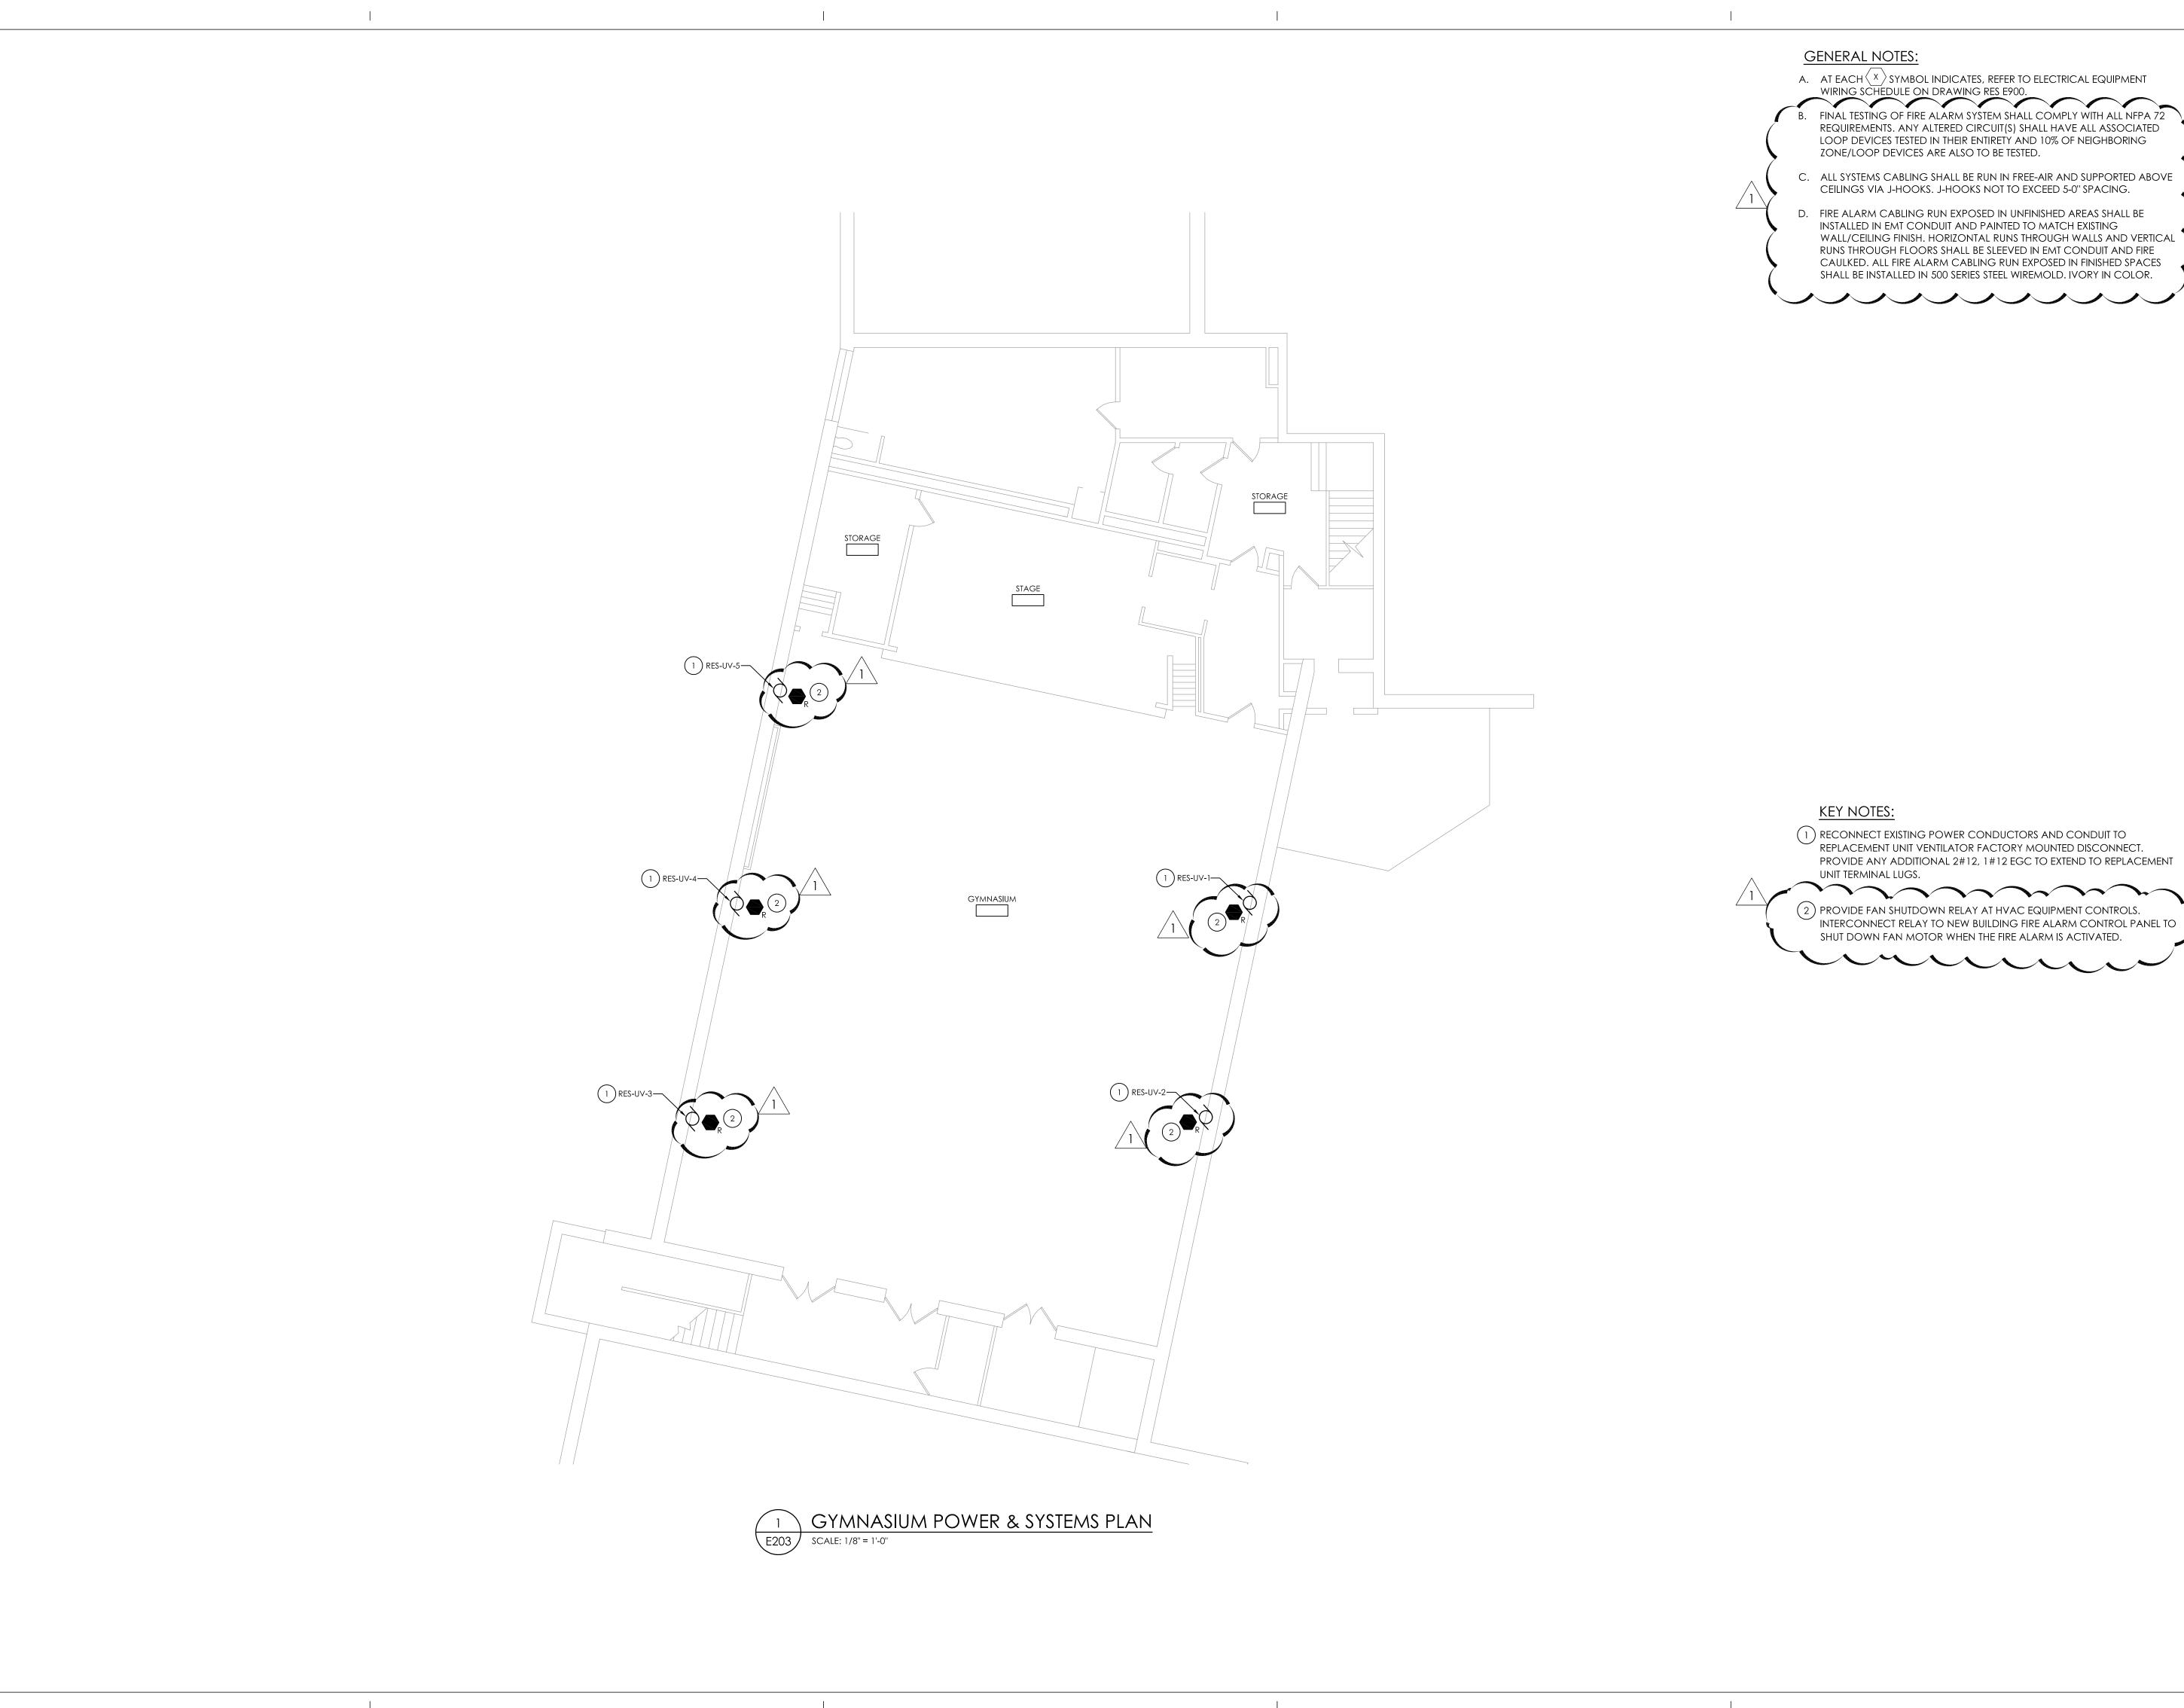

KEY NOTES:

UNIT TERMINAL LUGS.

(1) RECONNECT EXISTING POWER CONDUCTORS AND CONDUIT TO

2) PROVIDE FAN SHUTDOWN RELAY AT HVAC EQUIPMENT CONTROLS.

REPLACEMENT UNIT VENTILATOR FACTORY MOUNTED DISCONNECT.

PROVIDE ANY ADDITIONAL 2#12, 1#12 EGC TO EXTEND TO REPLACEMENT

INTERCONNECT RELAY TO NEW BUILDING FIRE ALARM CONTROL PANEL TO SHUT DOWN FAN MOTOR WHEN THE FIRE ALARM IS ACTIVATED.

A. AT EACH $\langle x \rangle$ SYMBOL INDICATES, REFER TO ELECTRICAL EQUIPMENT WIRING SCHEDULE ON DRAWING RES E900.

B. FINAL TESTING OF FIRE ALARM SYSTEM SHALL COMPLY WITH ALL NFPA 72 REQUIREMENTS. ANY ALTERED CIRCUIT(S) SHALL HAVE ALL ASSOCIATED LOOP DEVICES TESTED IN THEIR ENTIRETY AND 10% OF NEIGHBORING ZONE/LOOP DEVICES ARE ALSO TO BE TESTED.

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11/15/2021 Project Status **BID SET**

Drawn By Checked By MAY Drawing Title

GYMNASIUM POWER & SYSTEMS PLAN


AS INDICATED

GROUND FLOOR LIGHTING PLAN

SCALE: 1/4" = 1'-0"

GENERAL NOTES:

- A. FIXTURE TYPE MARK IS INDICATED ADJACENT TO NEW LIGHT FIXTURES. REFER TO LUMINAIRE SCHEDULE ON SHEET RES-E900 FOR FIXTURE DESCRIPTIONS, NOTES, AND SPECIFICATIONS.
- B. INSTALL SWITCHING AND LOW-VOLTAGE SENSORS AS SHOWN. PROVIDE ALL LOW-VOLTAGE WIRING BETWEEN SENSORS, SWITCHES, CONTROLLERS, AND LUMINAIRES.
- C. PROVIDE ANY ADDITIONAL POWER SUPPLIES OR OTHER MISCELLANEOUS COMPONENTS REQUIRED FOR A COMPLETE OPERATIONAL LIGHTING SYSTEM TO MEET INTENT OF LIGHTING SEQUENCE OF OPERATION AS
- D. ALL FIXTURES INDICATED WITH "EM" DESIGNATION SHALL HAVE EMERGENCY BATTERY BACKUP.

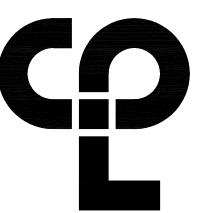

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KEY NOTES:

- 1) PROVIDE #12 AWG BRANCH CIRCUIT WIRING FOR ENTIRE CIRCUIT AND CONNECT TO EXISTING MAINTAINED BRANCH CIRCUIT HOMERUN BACK TO PANELBOARD.
- 2) PROVIDE NEW CEILING MOUNTED OCCUPANCY SENSORS AS NOTED. PROVIDE ALL LOW VOLTAGE WIRING FROM NEW OCCUPANCY SENSORS TO NEW LIGHT FIXTURES.
- 3 PROVIDE NEW DIMMING SWITCHING AS NOTED. PROVIDE ALL LOW VOLTAGE WIRING FROM NEW SWITCHING TO NEW LIGHT FIXTURES.
- 4 FIXTURE TO REMAIN ENERGIZED ON INDEPENDENT OF THE SWITCHING. WIRE CIRCUIT HOT LEG TO FIXTURE FOR CONTINUOUS POWER WHEN SWITCHING IS IN

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400 EXECUTIVE BLVD OSSINING, NY 10562

OSSINING UNION FREE SCHOOL DISTRICT ANNE M. DORNER MS SED# 66-14-01-03-0-008-028


ROOSEVELT ES SED# 66-14-01-03-0-005-022 OSSINING HS SED# 66-14-01-03-0-003-043

PROJECT ISSUE & REVISION SCHEDULE No. Date Description
1 5/17/22 SED Addendum No. 2

Issued 11/15/2021 AS INDICATED Project Status **BID SET**

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GROUND FLOOR LIGHTING PLAN

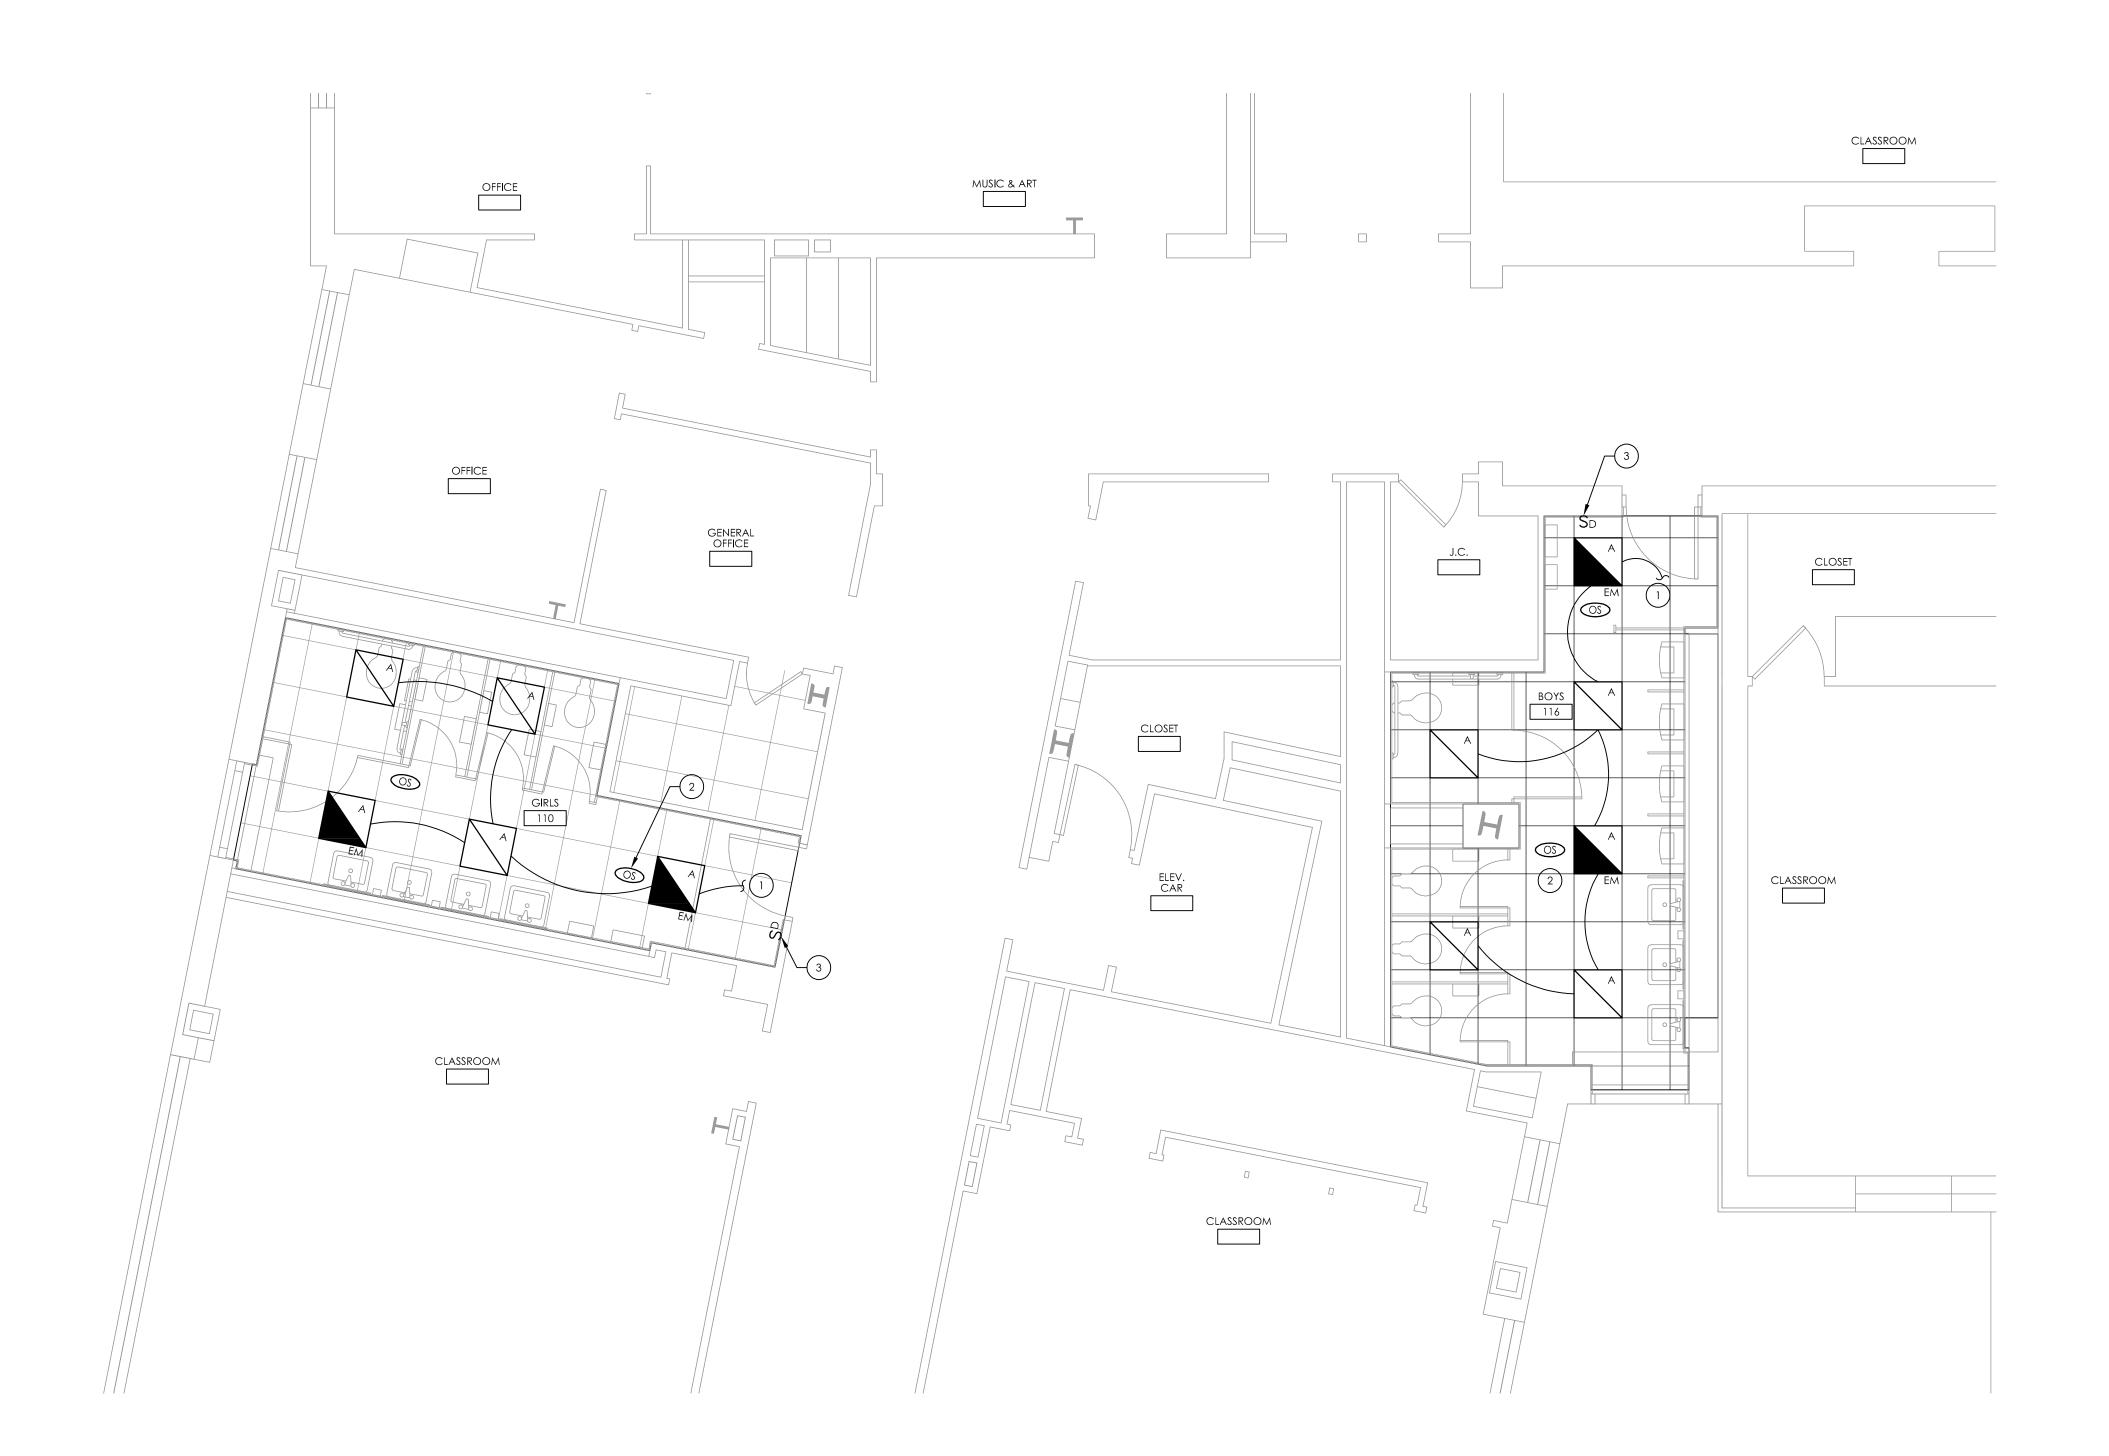


FIRST FLOOR LIGHTING PLAN

E301 | SCALE: 1/4" = 1'-0"

GENERAL NOTES:

- A. FIXTURE TYPE MARK IS INDICATED ADJACENT TO NEW LIGHT FIXTURES. REFER TO LUMINAIRE SCHEDULE ON SHEET RES-E900 FOR FIXTURE DESCRIPTIONS, notes, and specifications.
- B. INSTALL SWITCHING AND LOW-VOLTAGE SENSORS AS SHOWN. PROVIDE ALL LOW-VOLTAGE WIRING BETWEEN SENSORS, SWITCHES, CONTROLLERS, AND LUMINAIRES.
- C. PROVIDE ANY ADDITIONAL POWER SUPPLIES OR OTHER MISCELLANEOUS COMPONENTS REQUIRED FOR A COMPLETE OPERATIONAL LIGHTING SYSTEM TO MEET INTENT OF LIGHTING SEQUENCE OF OPERATION AS
- D. ALL FIXTURES INDICATED WITH "EM" DESIGNATION SHALL HAVE EMERGENCY BATTERY BACKUP.

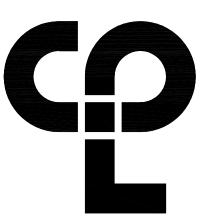

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KEY NOTES:

- 1) PROVIDE #12 AWG BRANCH CIRCUIT WIRING FOR ENTIRE CIRCUIT AND CONNECT TO EXISTING MAINTAINED BRANCH CIRCUIT HOMERUN BACK TO PANELBOARD.
- 2) PROVIDE NEW CEILING MOUNTED OCCUPANCY SENSORS AS NOTED. PROVIDE ALL LOW VOLTAGE WIRING FROM NEW OCCUPANCY SENSORS TO NEW LIGHT FIXTURES.
- 3 PROVIDE NEW DIMMING SWITCHING AS NOTED. PROVIDE ALL LOW VOLTAGE WIRING FROM NEW SWITCHING TO NEW LIGHT FIXTURES.

PROJECT INFORMATION

Project Number 14428.18

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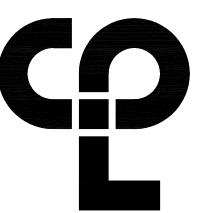
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Drawing Title

FIRST FLOOR LIGHTING PLAN

- A. FIXTURE TYPE MARK IS INDICATED ADJACENT TO NEW LIGHT FIXTURES. REFER TO LUMINAIRE SCHEDULE ON SHEET RES-E900 FOR FIXTURE DESCRIPTIONS, NOTES, AND SPECIFICATIONS.
- B. INSTALL SWITCHING AND LOW-VOLTAGE SENSORS AS SHOWN. PROVIDE ALL LOW-VOLTAGE WIRING BETWEEN SENSORS, SWITCHES, CONTROLLERS, AND LUMINAIRES.
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KEY NOTES:

- 1) PROVIDE #12 AWG BRANCH CIRCUIT WIRING FOR ENTIRE CIRCUIT AND CONNECT TO EXISTING MAINTAINED BRANCH CIRCUIT HOMERUN BACK TO PANELBOARD.
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- 3 PROVIDE NEW DIMMING SWITCHING AS NOTED. PROVIDE ALL LOW VOLTAGE WIRING FROM NEW SWITCHING TO NEW LIGHT FIXTURES.
- PROVIDE LOW VOLTAGE 4-BUTTON OCCUPANCY SENSOR DIMMING SWITCH WITH ON/OFF AND RAISE/LOWER BUTTONS. PROGRAM THE OCCUPANCY SENSOR TO TURN OFF AFTER 8 MINUTES OF NON MOTION.

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SECOND FLOOR LIGHTING PLAN

Drawing Number

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REMARKS:

1. ELECTRICAL CONTRACTOR IS RESPONSIBLE FOR THE MOUNTING, AND LINE/LOAD SIDE CONNECTIONS OF DISCONNECT AND/OR STARTER DEVICE ASSOCIATED WITH UNIT. MEANS OF DISCONNECT AND/OR STARTER ASSOCIATED WITH UNIT PROVIDED BY MECHANICAL CONTRACTOR. ELECTRICAL CONTRACTOR IS RESPONSIBLE FOR ALL FINAL CONNECTIONS TO EQUIPMENT.

2. PROVIDE FIRE ALARM FAN SHUT DOWN AT EACH UNIT INDICATED.

LUMINAIRE SCHEDULE												
MARK	DESCRIPTION	DESIGN MAKE	MODEL #	VOLTS		LAMP LUMEN WATTS KALVEN COLOR		REMARKS				
А	2X2 LED RECESSED FLAT PANEL FIXTURE	HUBBELL LIGHTING	CFP22-40/33/2835	UNV	2800	30	3500K					
A EM	2X2 LED RECESSED FLAT PANEL FIXTURE WITH EMERGENCY BATTERY BACKUP	HUBBELL LIGHTING	CFP22-40/33/2835-PLD10M	UNV	2800	30	3500K					



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JAS Drawing Title

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ELECTRICAL SCHEDULES

Drawing Number

KEY NOTES:

REMOVE FIXTURE AND ALL ASSOCIATED PIPING AND SUPPORTS. REMOVE SANITARY, VENT, AND WATER PIPING BACK TO NEAREST LIVE MAIN AND CAP. REMOVE ALL PIPING SUCH THAT LIMITED DEAD END PIPING REMAINS BUT ALL REMAINING BUILDING FIXTURES HAVE NECESSARY PIPING. PATCH ALL DISTURBED SURFACES TO MATCH EXISTING.



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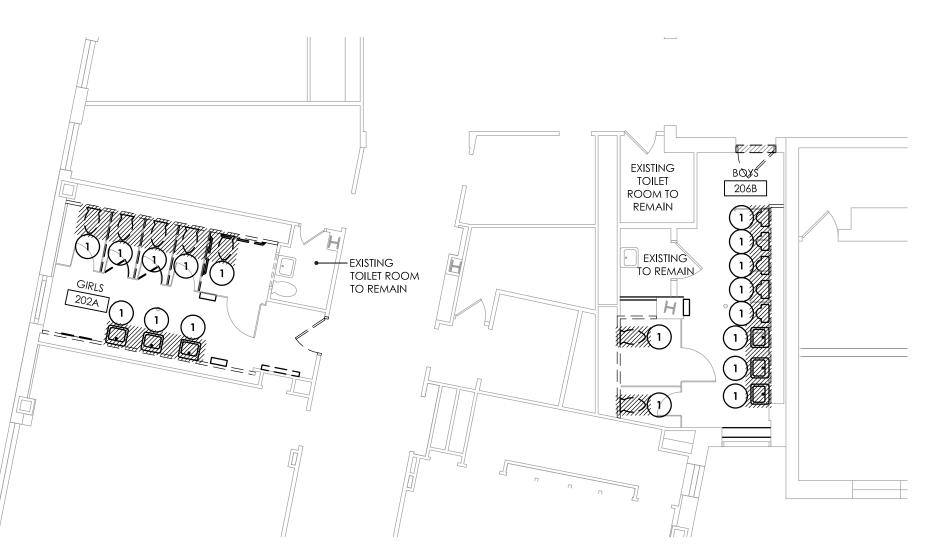
FIRST FLOOR PLAN - PLUMBING DEMOLITION

SCALE: 1/8" = 1'-0"

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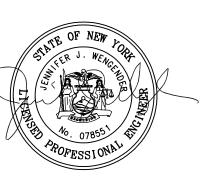
GROUND FLOOR PLAN - PLUMBING DEMOLITION

SCALE: 1/8" = 1'-0"



SECOND FLOOR PLAN - PLUMBING DEMOLITION

SCALE: 1/8" = 1'-0"



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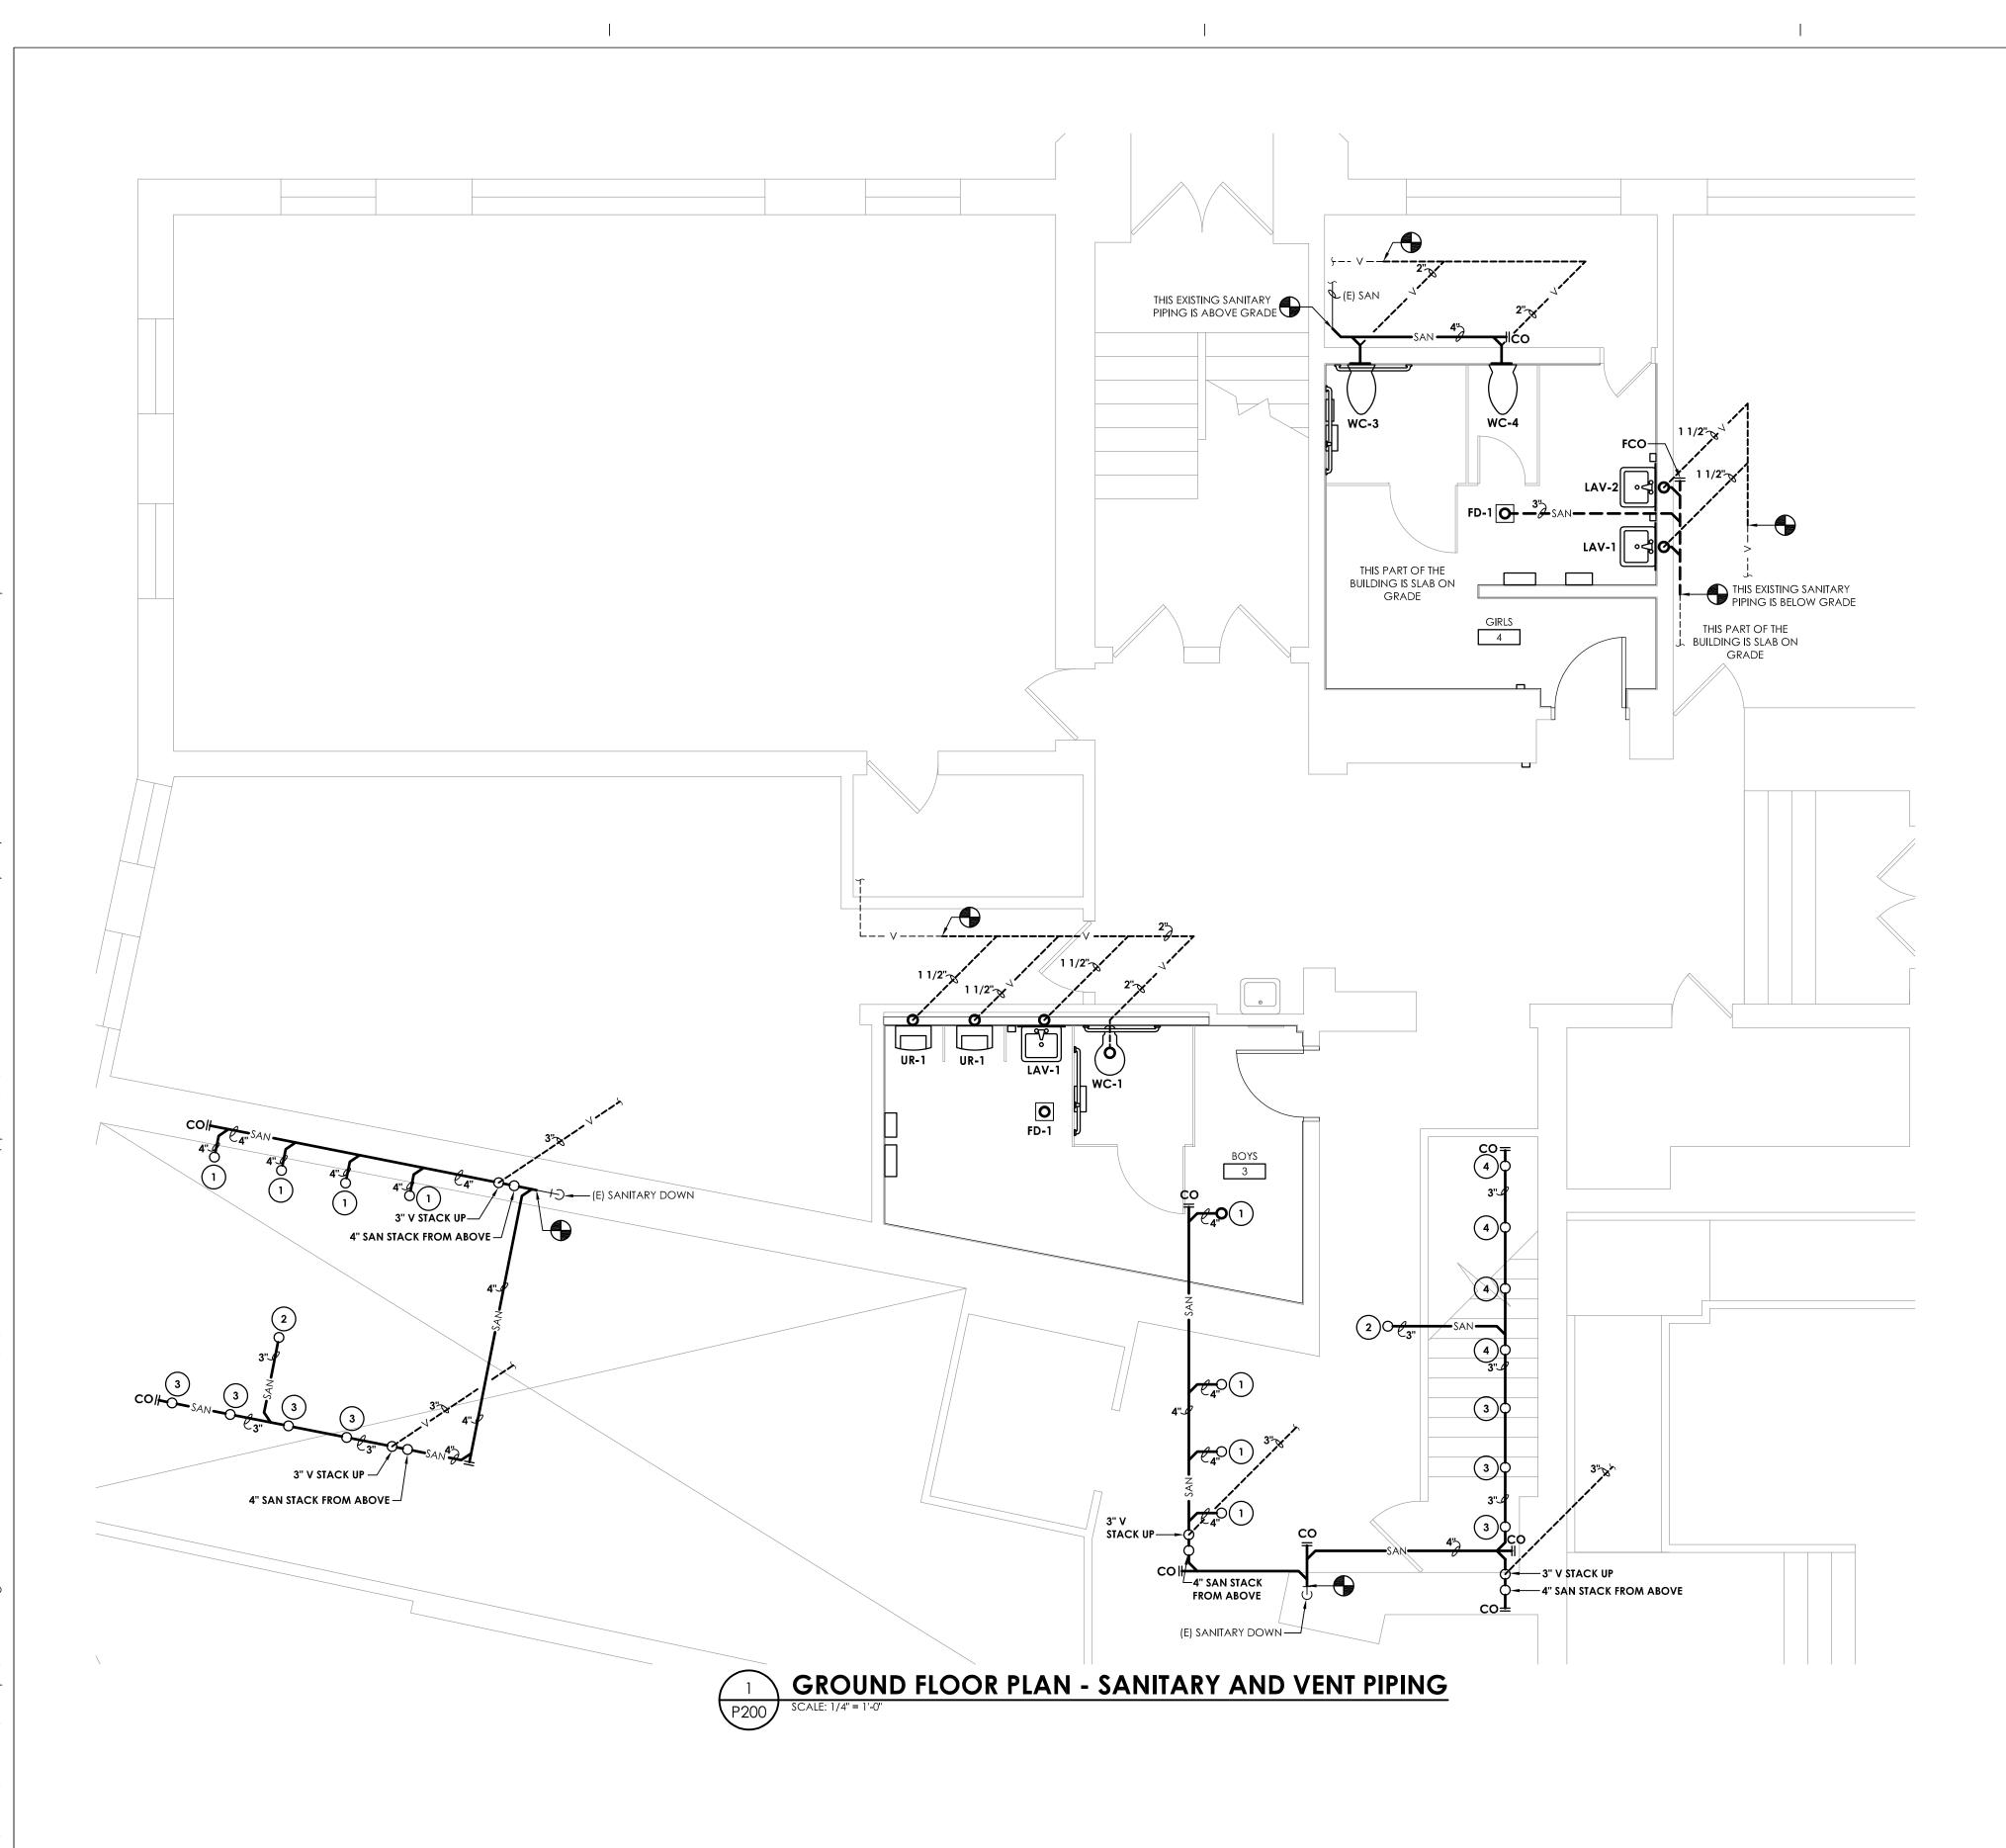
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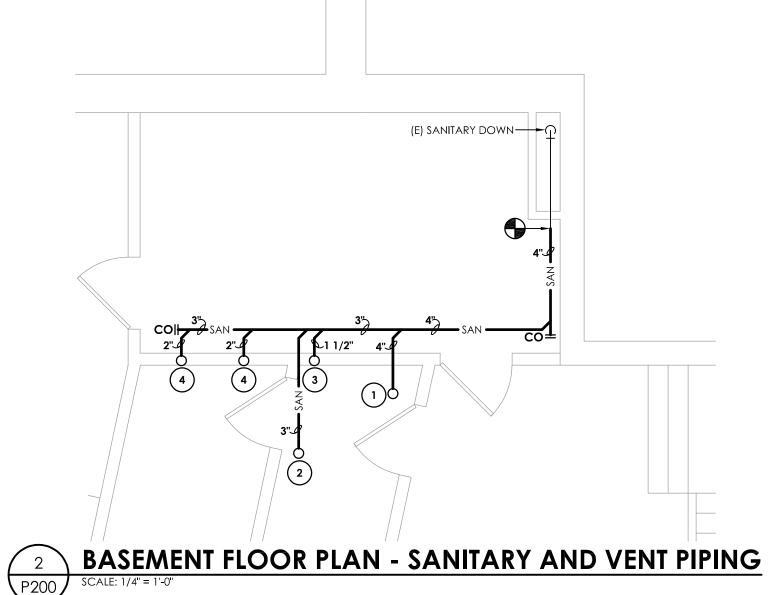
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Drawing Title
PLUMBING DEMOLITION PLANS

RES P101



KEY NOTES:

- 1) ROUTE 4" SANITARY PIPING UP TO WATER CLOSET ABOVE.
- 2 ROUTE 3" SANITARY PIPING UP TO FLOOR DRAIN ABOVE.
- 3 ROUTE 1 1/2" SANITARY PIPING UP TO LAVATORY ABOVE.
- 4 ROUTE 2" SANITARY PIPING UP TO URINAL ABOVE.



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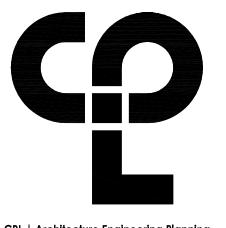
Drawing Title

GROUND FLOOR PLAN
SANITARY AND VENT PIPING

Drawing Number

RES 2200





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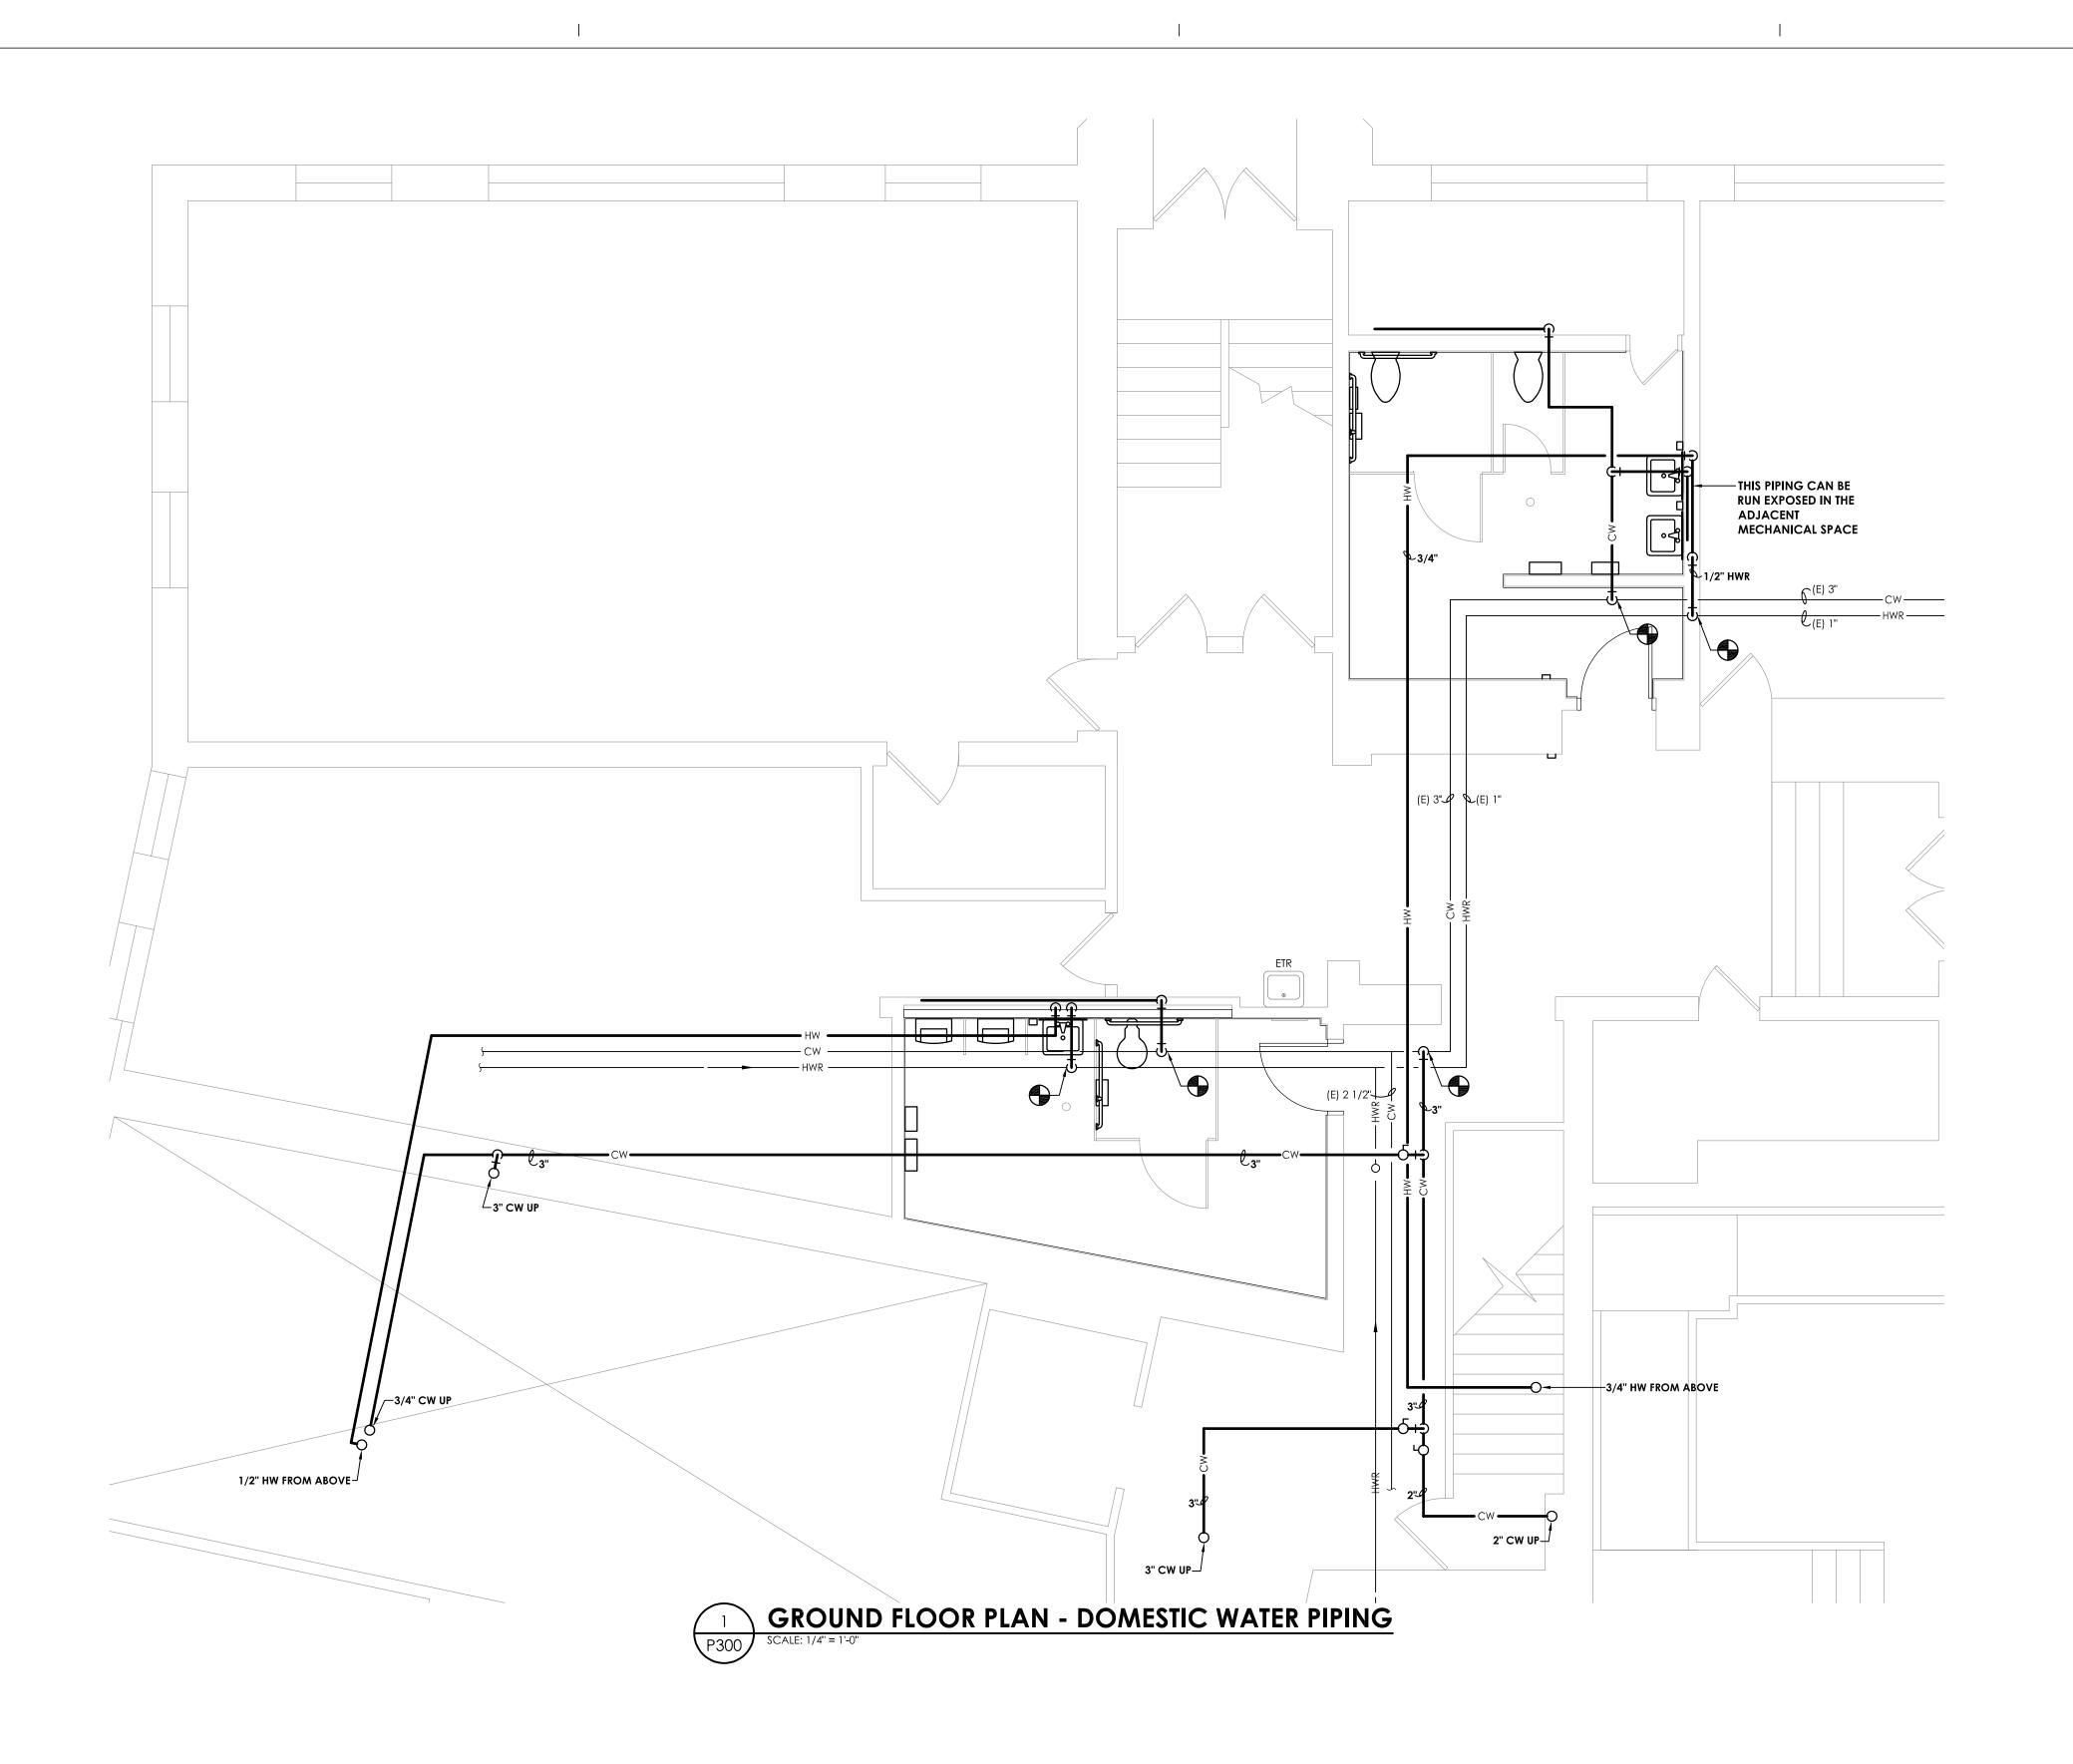
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FIRST AND SECOND FLOOR PLANS - SANITARY AND VENT PIPING

RES P201





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Drawing Title

GROUND FLOOR PLAN -DOMESTIC WATER PIPING

RES P300





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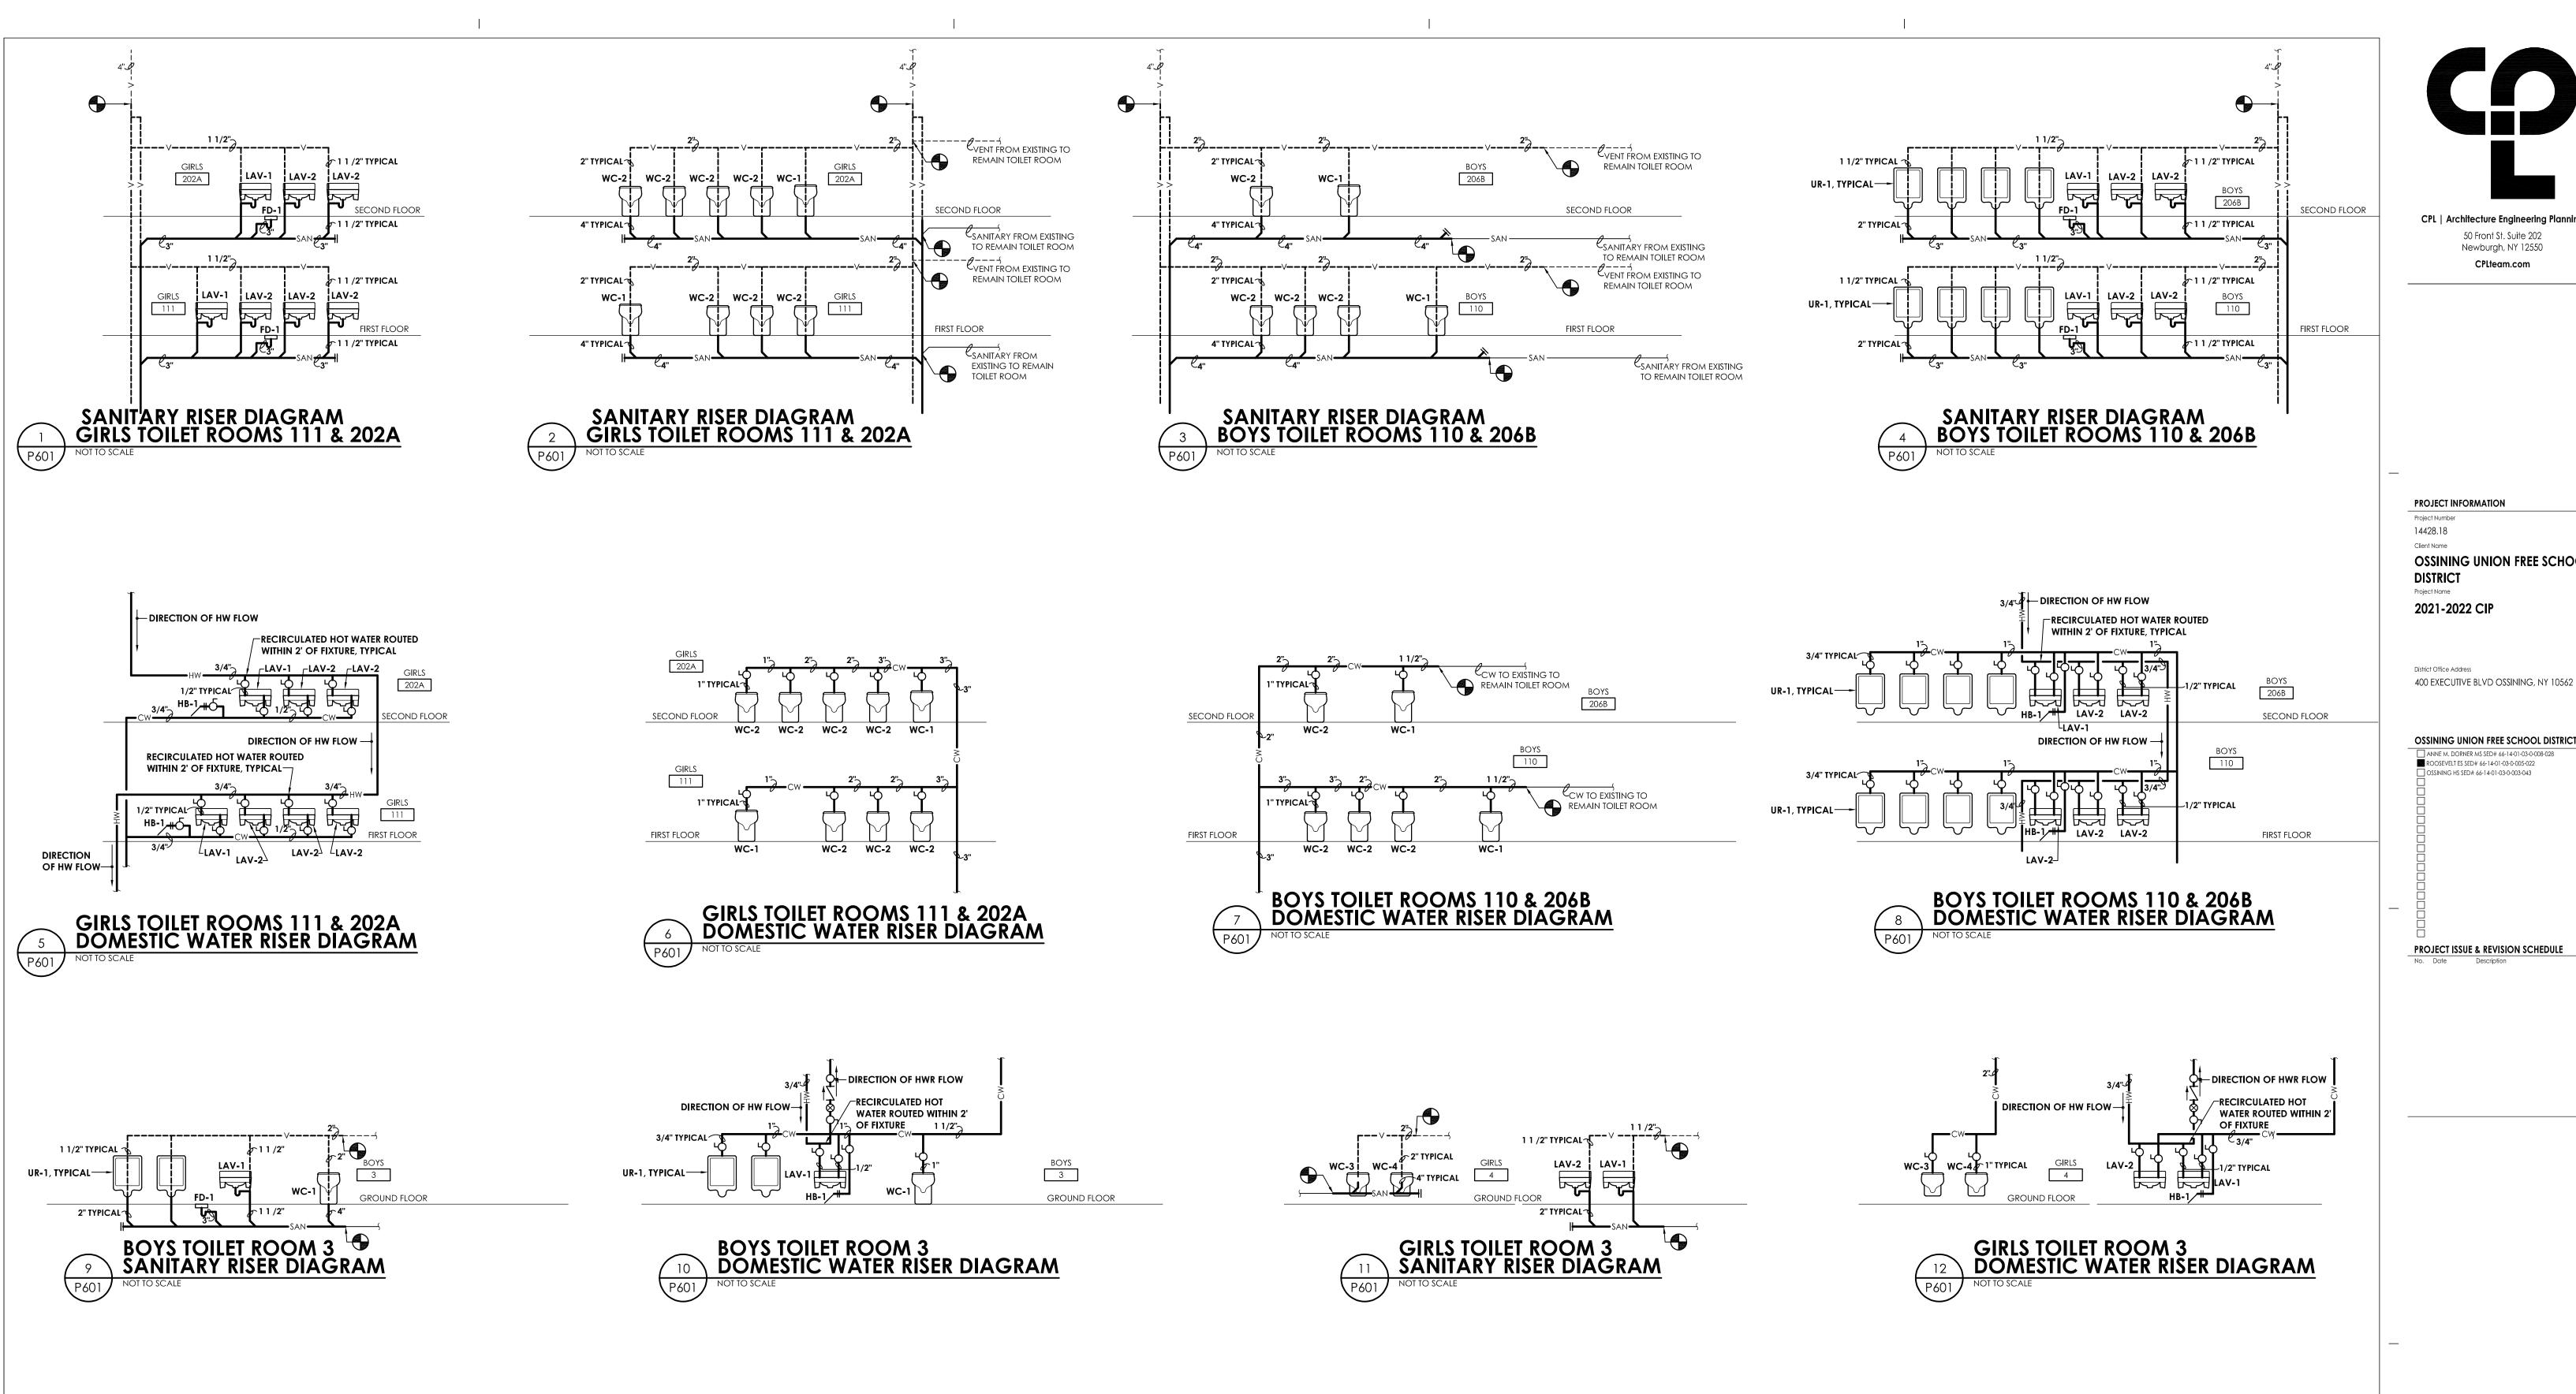
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Drawing Title

FIRST AND SECOND FLOCE

FIRST AND SECOND FLOOR PLANS - DOMESTIC WATER PIPING

> RES P301



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PROJECT ISSUE & REVISION SCHEDULE

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PLUMBING EQUIPMENT & FIXTURE SCHEDULE													
MARK	FIXTURE	CW	HW	SAN	V	DESCRIPTION	MODEL NUMBER	REMARKS					
WC-1	WATER CLOSET, ACCESSIBLE	1''	-	4"	2"	FLOOR MOUNT WATER CLOSET, ELONGATED BOWL SENSOR OPERATED FLUSH VALVE, ACCESSIBLE INSTALLATION, 1.28GPF	AMERICAN STANDARD - MADERA 3461.001 ZURN - AQUASENSE EXPOSED ZER6000-CPM	1,3					
WC-2	WATER CLOSET	1"	-	4"	2"	FLOOR MOUNT WATER CLOSET, ELONGATED BOWL SENSOR OPERATED FLUSH VALVE, 1.28GPF	AMERICAN STANDARD - MADERA 3451.001 ZURN - AQUASENSE EXPOSED ZER6000-CPM	3					
WC-3	WATER CLOSET, ACCESSIBLE	1"	-	4''	2"	WALL MOUNT WATER CLOSET, ELONGATED BOWL SENSOR OPERATED FLUSH VALVE, ACCESSIBLE INSTALLATION, 1.28GPF	AMERICAN STANDARD - AFWALL MILLENNIUM 2257101.020 ZURN - AQUASENSE EXPOSED ZER6000-CPM	1, 3					
WC-4	WATER CLOSET	1"	-	4"	2"	WALL MOUNT WATER CLOSET, ELONGATED BOWL SENSOR OPERATED FLUSH VALVE, 1.28GPF	AMERICAN STANDARD - AFWALL MILLENNIUM 2257101.020 ZURN - AQUASENSE EXPOSED ZER6000-CPM	3					
UR-1	URINAL, ACCESSIBLE	3/4"	-	2"	1 1/2"	WALL MOUNT URINAL, SENSOR OPERATED FLUSH VALVE .125GPF, ACCESSIBLE INSTALLATION	AMERICAN STANDARD - WASHBROOK 6590.001EC ZURN - AQUASENSE ZER6003AV-CPM-ULF	1, 3					
LAV-1	LAVATORY, ACCESSIBLE	1/2"	1/2"	1 1/2"	1 1/2"	WALL HUNG LAVATORY, CONCEALED ARM CARRIER, 18"x20 1/2", SENSOR OPERATED FAUCET, MOUNTED AT ACCESSIBLE HEIGHT, TRAPS AND SUPPLIES PROTECTED BY ADA COMPLIANT VANDAL GUARD SHIELD	AMERICAN STANDARD - LUCERNE 0355.012 ZURN - AQUASENSE Z6915-XL-TMV ZURN - Z6900-VG	1, 3					
LAV-2	LAVATORY	1/2"	1/2"	1 1/2"	1 1/2"	WALL HUNT LAVATORY, CONCEALED ARM CARRIER, 18"x20 1/2", SENSOR OPERATED FAUCET, SUPPLIES AND TRAPS PROTECTED BY VANDAL GUARD SHIELD	AMERICAN STANDARD - LUCERNE 0355.012 ZURN - AQUASENSE Z6915-XL-TMV ZURN - Z6900-VG	1, 3					
FD-1	FLOOR DRAIN	-			2''	FLOOR DRAIN, 8" ROUND NICKEL BRONZE STRAINER, CAST IRON BODY, DEEP SEAL P TRAP	ZURN - Z415B	2					
НВ-1	HOSE BIBB	3/4"	-	-	-	KEY OPERATED, MODERATE CLIMATE, CONCEALED OUTLET, FLUSH MOUNTING BOX WITH COVER, INTEGRAL VACUUM BREAKER WITH HOSE CONNECTION	ZURN - Z1330XL	-					


<u>REMARKS</u>

- 1. ALL ACCESSIBLE EQUIPMENT/FIXTURES TO BE INSTALLED PER ADA REQUIREMENTS.
- 2. SIZED PER PLAN.
- 3. SENSOR OPERATED VALVES TO BE BATTERY POWERED.

GENERAL PLUMBING EQUIPMENT & FIXTURE COMMENT

A. PLUMBING CONTRACTOR SHALL PROVIDE ALL RISERS, CARRIERS, P-TRAPS, STOPS, STRAINERS, TAIL PIECES, DRAINS, ETC. REQUIRED TO HAVE A COMPLETE INSTALLATION.

⊢BALL VALVE COLD WATER MAIN TRAP PRIMER VALVE-INTERNAL BACK FLOW PREVENTER AND VACUUM PRIMER 6" BREAKER REQUIRED 1. MOUNT PRIMER VALVE 1'-0" ABOVE DIMENSION— FINISHED FLOOR FOR EVERY 20'-0" OF PRIMER LINE. SUPPLY TUBE 2. PROVIDE ACCESS DOOR WHERE VALVE AND DISTRIBUTION UNIT IS INSTALLED BEHIND WALL IN PLUMBING CHASE. -DISTRIBUTION UNIT(S)-3. TYPICAL INSTALLATION: CONCEAL ALL REQUIRED FOR MORE COMPONENTS OF TRAP PRIMER SYSTEM THAN A SINGLE DRAIN WHEN INSTALLED IN FINISHED SPACES. COMPONENTS MAY BE EXPOSED IN MECHANICAL EQUIPMENT ROOMS AS APPROVED BY ENGINEER. 4. TRAP PRIMER REQUIRED ON ALL FLOOR DRAINS. 1/2" TYPE K SOFT COPPER LINE TO TRAP PRIMER CONNECTION— FLOOR DRAIN FINISHED FLOOR _ DEEP SEAL TRAP-TYPICAL TRAP PRIMER DETAIL

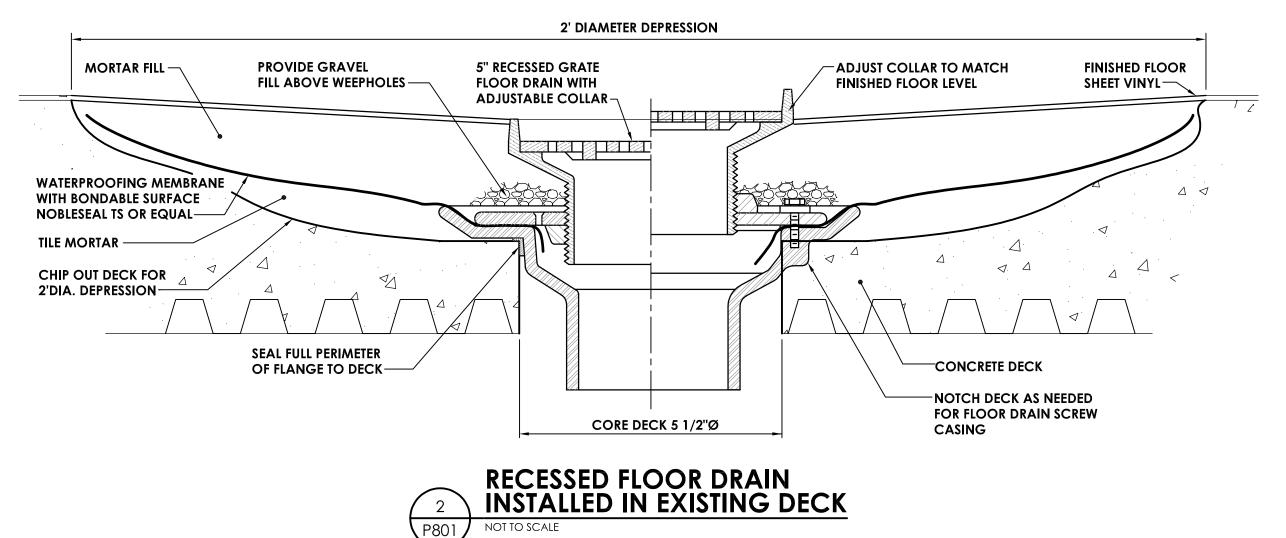

GENERAL SPECIFICATION NOTES:

FIRE/SMOKE STOPPING.

A. ALL WORK SHALL COMPLY WITH STATE AND LOCAL CODES.

DWV COPPER FITTINGS OR NO-HUB CAST IRON.

BE COVERED WITH PVC JACKET TO 7' ABOVE FINISHED FLOOR.

B. DOMESTIC WATER LINES SHALL BE TYPE L COPPER, LEAD FREE JOINTS. INSULATE ALL PIPING WITH PREFORMED FIBERGLASS PIPE INSULATION WITH ASJ COVER SIZED PER ENERGY CODE. ALL FITTINGS AND VALVES TO BE

COVERED WITH PREFORMED PVC FITTING COVERS. ALL EXPOSED VERTICAL FIXTURE SUPPLY LINES TO

C. UNDERGROUND SANITARY AND VENT PIPING SHALL BE SERVICE WEIGHT CAST IRON, HUB AND SPIGOT WITH

D. IT IS THE RESPONSIBILITY OF THE PLUMBING CONTRACTOR TO FIELD VERIFY EXISTING CONDITIONS WITHIN

E. IT IS THE RESPONSIBILITY OF THE PLUMBING CONTRACTOR TO REMOVE AND REPLACE EXISTING CEILINGS UNLESS OTHERWISE NOTED ON THE ARCHITECTURAL DRAWINGS, FOR PERFORMING DEMOLITION OR NEW

F. ALL PIPING AND CONDUIT PENETRATIONS THRU RATED WALLS OR FLOORS SHALL BE PROVIDED WITH

G. UNLESS SHOWN ON THE ARCHITECTURAL DRAWINGS, IT IS THE RESPONSIBILITY OF THE PLUMBING

WORK WITHIN THE BUILDING. THE CONTRACTOR SHALL REINSTALL THE CEILING SYSTEMS TO MATCH THE

ORIGINAL INSTALLATION. ANY CEILING SYSTEM COMPONENT DAMAGED DURING DEMOLITION, STORAGE, OR

CONTRACTOR TO PATCH AND FINISH ALL EXISTING PIPE PENETRATIONS AND TRENCHING THRU FLOOR AND WALLS AFTER DEMOLITION. IN ADDITION, ALL NEW PENETRATIONS AND TRENCHING SHALL BE PROVIDED


FOR INSTALLATION OF PLUMBING SYSTEMS INCLUDING, BUT NOT LIMITED TO, EQUIPMENT, PIPING, ETC.

H. UNLESS OTHERWISE INDICATED ON PLANS, PROVIDE WATER HAMMER ARRESTORS ON BRANCH PIPING TO EACH TOILET ROOM, LAUNDRY ROOM, SOLENOID VALVE, OR AS OTHERWISE REQUIRED BY CODE.

THE BUILDING PRIOR TO COMMENCEMENT OF ALL DEMOLITION AND NEW WORK.

RE-INSTALLATION SHALL BE REPLACED WITH A NEW AT NO EXPENSE TO THE OWNER.

RUBBER GASKET PUSH JOINTS. ABOVE GROUND SANITARY AND VET PIPING SHALL BE DWV COPPER WITH

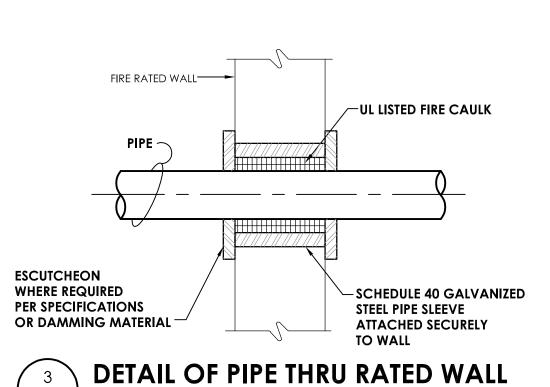

PLUMBING LEGEND

—— XX —— PIPING --- XX --- PIPING BELOW GRADE EXISTING PIPING CW COLD WATER HW **HOT WATER** HOT WATER RECIRCULATING SAN SANITARY SEWER PLUMBING TO BE REMOVED ELBOW - TURNED UP ELBOW - TURNED DOWN BALL VALVE BALANCING VALVE CHECK VALVE co ⊩—— CLEAN OUT FLOOR CLEAN OUT WALL CLEAN OUT wco ⊩----HOSE BIBB FD O FLOOR DRAIN WATER HAMMER ARRESTER

POINT OF CONNECTION

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Newburgh, NY 12550
CPLteam.com

PROJECT INFORMATION

14428.18

OSSINING UNION FREE SCHOOL

DISTRICT
Project Name
2021-2022 CIP

District Office Address
400 EXECUTIVE BLVD OSSINING, NY 10562

OSSINING HS SED# 66-14-01-03-0-003-043

OSSINING UNION FREE SCHOOL DISTRICT

ANNE M. DORNER MS SED# 66-14-01-03-0-008-028

ROOSEVELT ES SED# 66-14-01-03-0-005-022

PROJECT ISSUE & REVISION SCHEDULE

STATE OF NEW PORTER J. WENCE STATE J. WENCE J. WENCE STATE J. WENCE J.

NEW YORK STATE EDUCATION STATEMENT

If is a violation of the New York state education Law and the Commissioners Regulations for any person, unless acting under the direction of a licensed architect, engineer or land surveyor, to alter an item in any way. If an item bearing the seal of an architect, engineer or surveyor is altered. The alternog party shall affix to the item their seal and the notation "altered by" followed by their signature and the date of such alteration, and a specific description of the alteration.

SHEET INFORMATION
Issued

11/15/2021 AS NOTED
Project Status
BID SET
Drawn By Checked By
MEW JJW

PLUMBING SCHEDULES AND DETAILS

RES P801