GENERAL NOTES

- ALL WORK SHALL COMPLY WITH AND BE INSTALLED IN ACCORDANCE WITH THE SUPPLEMENTAL UNIFORM AND FIRE PREVENTION BUILDING CODE, INTERNATIONAL BUILDING CODE, INTERNATIONAL MECHANICAL CODE, AND ALL CODES LOCAL OR OTHERWISE HAVING JURISDICTION OVER THE WORK.
- DUCTWORK & PIPING IS DIAGRAMMATICALLY SHOWN. EXACT ROUTING OF NEW PIPING & DUCTWORK SHALL BE DETERMINED IN FIELD AND COORDINATION DRAWINGS SHALL BE SUBMITTED IN CONJUNCTION WITH THE GENERAL CONTRACTOR FOR ENGINEER APPROVAL. SEE SPECIFICATION 01010.
- THE WORDS PROVIDE OR INSTALL, SINGLY OR IN COMBINATION SHALL MEAN FURNISH AND INSTALL IN ACCORDANCE WITH THE PLANS AND SPECIFICATIONS.
- THE CONTRACTOR SHALL PROVIDE ALL CUTTING AND PATCHING TO MATCH EXISTING AS REQUIRED FOR THE INSTALLATION OF HIS WORK.
- THIS CONTRACTOR SHALL BE RESPONSIBLE FOR THE PROTECTION OF HIS WORK AND NEWLY INSTALLED WORK, INCLUDING PROTECTION OF BUILDING OCCUPANTS AND OWNERS EQUIPMENT, PUBLIC, AND PERSONNEL. PROVIDE APPROPRIATE BARRIERS, AND SAFETY GUARD RAILS AS REQUIRED.
- WHERE WELDING OR OPEN FLAME IS USED FOR CUTTING, SOLDERING, ETC., CONTRACTOR SHALL PROVIDE FIRE EXTINGUISHERS AND A FIRE WATCH IN PROXIMITY OF WORK AREA. CONTRACTOR SHALL PROVIDE HOT WORK PERMIT WHERE NECESSARY AND OBTAIN HOT WORK PERMIT FROM OWNER.
- 7. ALL WORK SHALL BE COORDINATED WITH ALL TRADES RELATED TO THE COMPLETION OF THIS PROJECT.
- THE CONTRACTOR SHALL FILE PLANS WITH THE GOVERNING AUTHORITIES HAVING JURISDICTION AND SHALL SECURE ALL PERMITS AND PAY ALL FEES REQUIRED FOR THE INSTALLATION OF HIS WORK.
- THE CONTRACTOR SHALL GUARANTEE ALL MATERIAL AND WORK INSTALLED TO BE FREE FROM DEFECTS IN MATERIAL AND WORKMANSHIP FOR A PERIOD OF ONE (1) YEAR, AFTER ACCEPTANCE OF THE INSTALLATION BY THE ENGINEER AND OWNER. THE CONTRACTOR SHALL SUBMIT IN WRITING TO OWNER STATING THE SAME. EQUIPMENT WARRANTEES OF A LONGER DURATION SHALL APPLY.
- 10. THE CONTRACTOR SHALL INDEMNIFY THE OWNER, HIS REPRESENTATIVES AND THE ENGINEER FROM ANY CLAIMS OR SUITS RESULTING IN NEGLIGENCE ON THE PART OF THE CONTRACTOR AND FOR FAILING TO EXECUTE HIS WORK IN ACCORDANCE WITH THE CONTRACT DOCUMENTS.
- 11. THE CONTRACTOR SHALL PROVIDE ALL RIGGING, HOISTING AND SCAFFOLDING AS REQUIRED FOR THE INSTALLATION OF HIS WORK.
- 12. ALL WORK SHALL BE PERFORMED BY LICENSED CONTRACTORS AND WORKMEN EXPERIENCED IN THE TRADE HAVING JURISDICTION. ALL WORK SHALL BE SUPERVISED AT ALL TIMES AND WORKMANSHIP SHALL BE FIRST CLASS IN ALL RESPECTS AND IN ACCORDANCE WITH BEST TRADE PRACTICES.
- 13. ANY DEVIATION OR CHANGE IN DESIGN SHALL NOT BE MADE WITHOUT WRITTEN APPROVAL OF THE ENGINEER AND SIGNED BY THE OWNER. ANY WORK INSTALLED WITHOUT PRIOR APPROVAL OF THE ENGINEER AND OWNER OR FOUND TO BE DEFECTIVE IN ANY WAY SHALL BE REPLACED BY THE CONTRACTOR AT HIS OWN
- 14. ALL CONSTRUCTION WORK SHALL BE CONFINED TO THE AREA INDICATED ON PLANS AND SHALL NOT BLOCK MEANS OF EGRESS FOR OCCUPANTS OF THE BUILDING.
- 15. PATCHING OF WALLS, FLOORS, ETC. SHALL BE BY TRADE WHO PERFORMED WORK UNLESS OTHERWISE NOTED AND SHALL MATCH EXISTING SURROUNDING AREA IN ALL RESPECTS. WORK AREA SHALL BE LEFT BROOM CLEAN AT THE END OF EACH DAY. ALL DISCARDED AND DEMOLISHED MATERIAL AND RUBBISH SHALL BE REMOVED FROM PREMISES DAILY IN A LEGAL AND APPROVED MANNER. FINAL PATCHING AND PAINTING SHALL BE PERFORMED BY GENERAL CONTRACTOR.
- THE CONTRACTOR SHALL SUBMIT DIGITAL COPIES OF SHOP DRAWINGS OF ALL EQUIPMENT, PIPING, DUCTWORK, AND MATERIALS TO THE ENGINEER FOR APPROVAL PRIOR TO FABRICATION AND INSTALLATION OF NEW WORK, WITHIN TWO WEEKS AFTER AWARD OF CONTRACT. SHOP DRAWINGS SHALL INDICATE ALL TECHNICAL DATA, STRUCTURAL MEMBERS, WALLS, FLOORS, DUCTWORK, ETC., WITH ELEVATIONS AT WHICH NEW WORK IS TO BE INSTALLED. ANY DEVIATION IN DESIGN SHALL NOT BE MADE WITHOUT WRITTEN APPROVAL OF THE ENGINEER AND OWNER. THE ENGINEER SHALL REVIEW AND TURN AROUND SHOP DWGS. WITHIN (7) DAYS OF RECEIPT OF SAME.
- 17. THE CONTRACTOR SHALL MAINTAIN ON THE JOB SITE A SET OF CONTRACT
- 18. THE CONTRACTOR SHALL MAINTAIN ON THE JOB SITE A SET OF SHOP DRAWINGS IN WHICH ANY DEVIATIONS FROM THE ORIGINAL DESIGN SHALL BE NOTED.
- 19. ALL WORK SHOWN ON ALL DRAWINGS IS TO BE PROVIDED UNLESS OTHERWISE
- 20. ALL PENETRATIONS THROUGH PARTITIONS, FLOORS, WALLS AND ROOF FOR ALL PIPING, CONDUIT AND DUCTWORK SHALL BE SEALED AND FIRE SAFED OFF TO MAINTAIN FIRE INTEGRITY OF EXISTING STRUCTURE.
- 21. THE CONTRACTOR SHALL MAINTAIN ON THE JOB SITE A SET OF SHOP DRAWINGS IN WHICH ANY DEVIATIONS FROM THE ORIGINAL DESIGN SHALL BE NOTED. UPON COMPLETION OF THE INSTALLATION OF NEW WORK THE CONTRACTOR SHALL TURN OVER TO THE OWNER AND ENGINEER (1) SET OF AS-BUILT REPRODUCIBLE DRAWINGS AND (1) SET OF PRINTS INCLUDING ALL APPROVED FIELD CHANGES AND DESIGN DEVIATIONS PRIOR TO RECEIPT OF FINAL PAYMENT BY OWNER.
- THE CONTRACTOR SHALL SUPERVISE AND DIRECT THE WORK, AS WELL AS BE SOLELY RESPONSIBLE FOR THE CONSTRUCTION MEANS, METHODS, TECHNIQUES, SEQUENCES AND PROCEDURES OF THE WORK.
- 23. THE CONTRACTOR SHALL BE RESPONSIBLE FOR TAKING REASONABLE PRECAUTIONS AND SHALL PROVIDE REASONABLE PROTECTION TO PREVENT INJURY OR DAMAGE TO PERSONS, THE WORK AND OTHER PROPERTY.

HVAC NOTES

- PROVIDE VOLUME DAMPERS AS INDICATED ON DRAWINGS AND AT ALL BRANCH DUCT TAKE OFFS FROM DUCT MAINS AND TO DIFFUSERS, REGISTERS AND GRILLES ONLY IN NON-CLASSIFIED SPACES. VOLUME DAMPERS SHALL BE OPPOSED BLADE OR BUTTERFLY TYPE, GALVANIZED STEEL THAT CAN BE MANUALLY ADJUSTED AND LOCKED IN PLACE EXTERNALLY OF THE DUCT. PROVIDE LOCKING QUADRANT. ALL CONCEALED DAMPERS SHALL BE PROVIDED WITH ACCESS DOORS
- PROVIDE SLEEVES FOR ALL DUCTS PENETRATING AND PASSING THROUGH ALL PARTITIONS, FLOORS, CEILINGS AND WALLS, ALLOW ROOM IN SLEEVE FOR INSULATION. SLEEVES SHALL BE MINIMUM OF 22 GAUGE SHEET METAL. PACK ANNULAR SPACE IN SLEEVE AROUND DUCT WITH FIRE RATED MATERIAL, SIMILAR TO THERMAFIBER. SEAL AND CAULK ALL WALL, FLOOR, CEILING AND SLAB OPENINGS WITH U.L. APPROVED FIRE RATED MATERIAL TO PREVENT TRANSMISSION OF ODORS AND SMOKE TO ADJACENT SPACES. ALL DUCT PENETRATIONS OF FIRE RATED WALLS AND SLABS SHALL BE EQUIPPED WITH FIRE/SMOKE RATED DAMPERS
- CONTRACTOR SHALL PROVIDE ACCESS DOORS IN ALL CEILINGS, DUCTS, CHASES AND WALLS AS REQUIRED FOR ACCESS TO ALL CONCEALED OPERATING DEVICES INCLUDING BUT NOT LIMITED TO FIRE DAMPERS, VOLUME DAMPERS, CONTROL DAMPERS AND BOXES, ETC.
- ALL HVAC WORK SHALL BE INSTALLED IN STRICT ACCORDANCE WITH THE INTERNATIONAL MECHANICAL CODE, STATE AND LOCAL BUILDING CODES, SMACNA AND ASHRAE STANDARDS, NFPA-90A, ALL CODES AND ORDINANCES HAVING JURISDICTION, AND IN ACCORDANCE WITH MANUFACTURERS RECOMMENDATIONS.
- UPON COMPLETION OF ALL WORK, ALL EQUIPMENT AND DUCTWORK SHALL BE THOROUGHLY CLEANED AND LEFT IN FIRST CLASS CONDITION.
- CONTRACTOR SHALL BE RESPONSIBLE FOR THE PROTECTION OF ALL EQUIPMENT UNDER THIS SECTION UNTIL FINAL ACCEPTANCE BY THE ENGINEER.
- ALL EQUIPMENT SHALL BE TESTED IN ACCORDANCE WITH ALL APPLICABLE CODES, MANUFACTURER SPECIFICATIONS, AND TO THE SATISFACTION OF THE ENGINEER.
- BALANCE AND ADJUST AIRFLOW TO REGISTERS AND GRILLES AS INDICATED ON DRAWINGS. ALL SYSTEMS SHALL BE BALANCED TO WITHIN 10% OF DESIGN FLOW WITH REPORT SUBMITTED TO OWNER. BALANCING WORK SHALL BE PERFORMED BY AN INDEPENDENT CERTIFIED BALANCING CONTRACTOR WHO IS CERTIFIED BY AABC OR NEBB. SUBMIT BALANCING REPORT TO ENGINEER FOR APPROVAL.
- ALL DUCTWORK SHALL BE STAINLESS STEEL SHEET METAL UNLESS OTHERWISE NOTED AND SHALL BE INSTALLED IN ACCORDANCE WITH SMACNA METAL AND FLEXIBLE DUCT CONSTRUCTION STANDARDS LATEST EDITION AND APPLICABLE CODES. ALL DUCTWORK SIZES SHOWN ARE SHEETMETAL SIZES, AND REDUCTIONS IN FREE AREA CREATED BY INTERNAL SOUND-LINING ARE ACCOUNTED FOR IN
- CONTRACTOR SHALL PROVIDE ALL CONTROLS, AND CONTROL WIRING AS REQUIRED FOR COMPLETE CONTROL OF EQUIPMENT FOR A COMPLETE FUNCTIONING SYSTEM. REFER TO ELECTRICAL DRAWINGS FOR ADDITIONAL INFORMATION.
- INSTALL ALL REQUIRED APPURTENANCES PER CODE WHETHER SPECIFIED OR NOT FOR COMPLETE FUNCTIONING SYSTEMS.
- HVAC INSULATION (AS MANUFACTURED BY OWENS CORNING, KNAUF, SCHULLER, OR ENGINEERED APPROVED EQUAL)
- ALL INSULATION TO BE APPLIED IN FULLY ACCORDANCE WITH THE MANUFACTURERS RECOMMENDATIONS AND COMPLY WITH 25/50 FLAME AND SMOKE HAZARD RATINGS PER ASTM E-84, NFPA 255 AND UL 723.
- INSULATE AIR CONDITIONING CONDENSATE DRAIN PIPING WITH 1" THICK MOLDED FIBER GLASS INSULATION.

DEMOLITION GENERAL NOTES

- THE DEMOLITION, MODIFICATION OR ALTERATION OF EXISTING BUILDINGS, EQUIPMENT, OR MATERIALS SHALL BE COMPLAINT TO ALL LOCAL REGULATIONS
- FOR MAINTENANCE OF EXISTING PLANT OPERATION AND FOR DEMOLITION SEQUENCE. REFER TO SPECIFICATIONS, CONTRACTOR SHALL PROVIDE TEMPORARY FACILITIES WHERE NECESSARY.
- INCORPORATE NYPA ENVIRONMENTAL SPECIFICATION AS NECESSARY FOR REMOVAL OF HAZARDOUS MATERIALS, INCLUDING OIL, MERCURY, PCBS, LEAD,

GENERAL ABBREVIATIONS

ABOVE FINISHED FLOOR

CD -	CONDENSATE DRAIN
D.P	DIFFERENTIAL PRESSURE
EA -	EXHAUST AIR
	ENTERING AIR TEMPURATURE
EF -	EXHAUST FAN
	EXHAUST GRILLE
EB -	ELECTRIC BASEBOARD HEATER
	ELECTRIC BASEBOARD HEATER
EUH - EL -	ELEVATION
	EXTERNAL STATIC PRESSURE
FC -	FLEXIBLE CONNECTION
	FULL LOAD AMPS
	LEAVING AIR TEMPURATURE
	MINIMUM CIRCUIT AMPACITY
	MOTORIZED DAMPER
MD -	
MOCP -	MAXIMUM OVER CURRENT PROTECTION
NTS -	NOT TO SCALE
OA -	OUTSIDE AIR
RA -	RETURN AIR
RAG -	RETURN AIR GRILLE
RS -	REFRIGERANT SUCTION
RL -	REFRIGERANT LIQUID
RTU -	ROOF TOP UNIT
SA -	SUPPLY AIR
SD -	SUPPLY DIFFUSER
SF -	SUPPLY FAN
SG -	SUPPLY GRILLE
STD -	STANDARD
TSP -	TOTAL STATIC PRESSURE
(TYP.) -	TYPICAL

SYMBOLS

SUPPLY DUCT RISER RETURN DUCT RISER

EXHAUST DUCT RISER

WORK TO BE PROVIDED

EXISTING CONDITIONS/WORK BY OTHER TRADES





Environmental Design & Research,


Landscape Architecture, Engineering & Environmental Services, D.P.C. 217 Montgomery Street, Suite 1100 Syracuse, New York 13202

UNION HILL AND TALLMAN AVE **PUMP STATION UPGRADE**

CLIENT: ROCKLAND COUNTY SEWER DISTRICT No. 1 DRAWING TITLE: PUMP STATION NOTES, LEGEND AND ABBREVIATIONS

PROJECT LOCATION: ROCKLAND COUNTY, NEW YORK

						_	
							CONTRACT:# RFB-RC-SWR-2022-06
	DR	AWINGS ISSU	JED FOR / REVISIONS				EDR JOB #:21213
	NO.	DATE	ISSUED FOR / REVISIONS	BY	СНК	APP	DATE: 06/2023
	1	04/22	60 PERCENT DESIGN REVIEW	MJL	JGD	GRL	SCALE:
	2	07/22	90 PERCENT DESIGN REVIEW	MJL	JGD	GRL	DRAWN BY: J. ROSS
	3	09/22	FOR REGULATORY REVIEW	MJL	JGD	GRL	CHECKED BY: G. LYNCH
CONTRACT	4	01/23	100 PERCENT DESIGN REVIEW	MJL	JGD	GRL	DRAWING NUMBER:
	5	03/23	100 PERCENT DESIGN REVIEW	MJL	JGD	GRL	H-001
	6	06/23	FOR BID	MJL	JGD	GRL	11 001

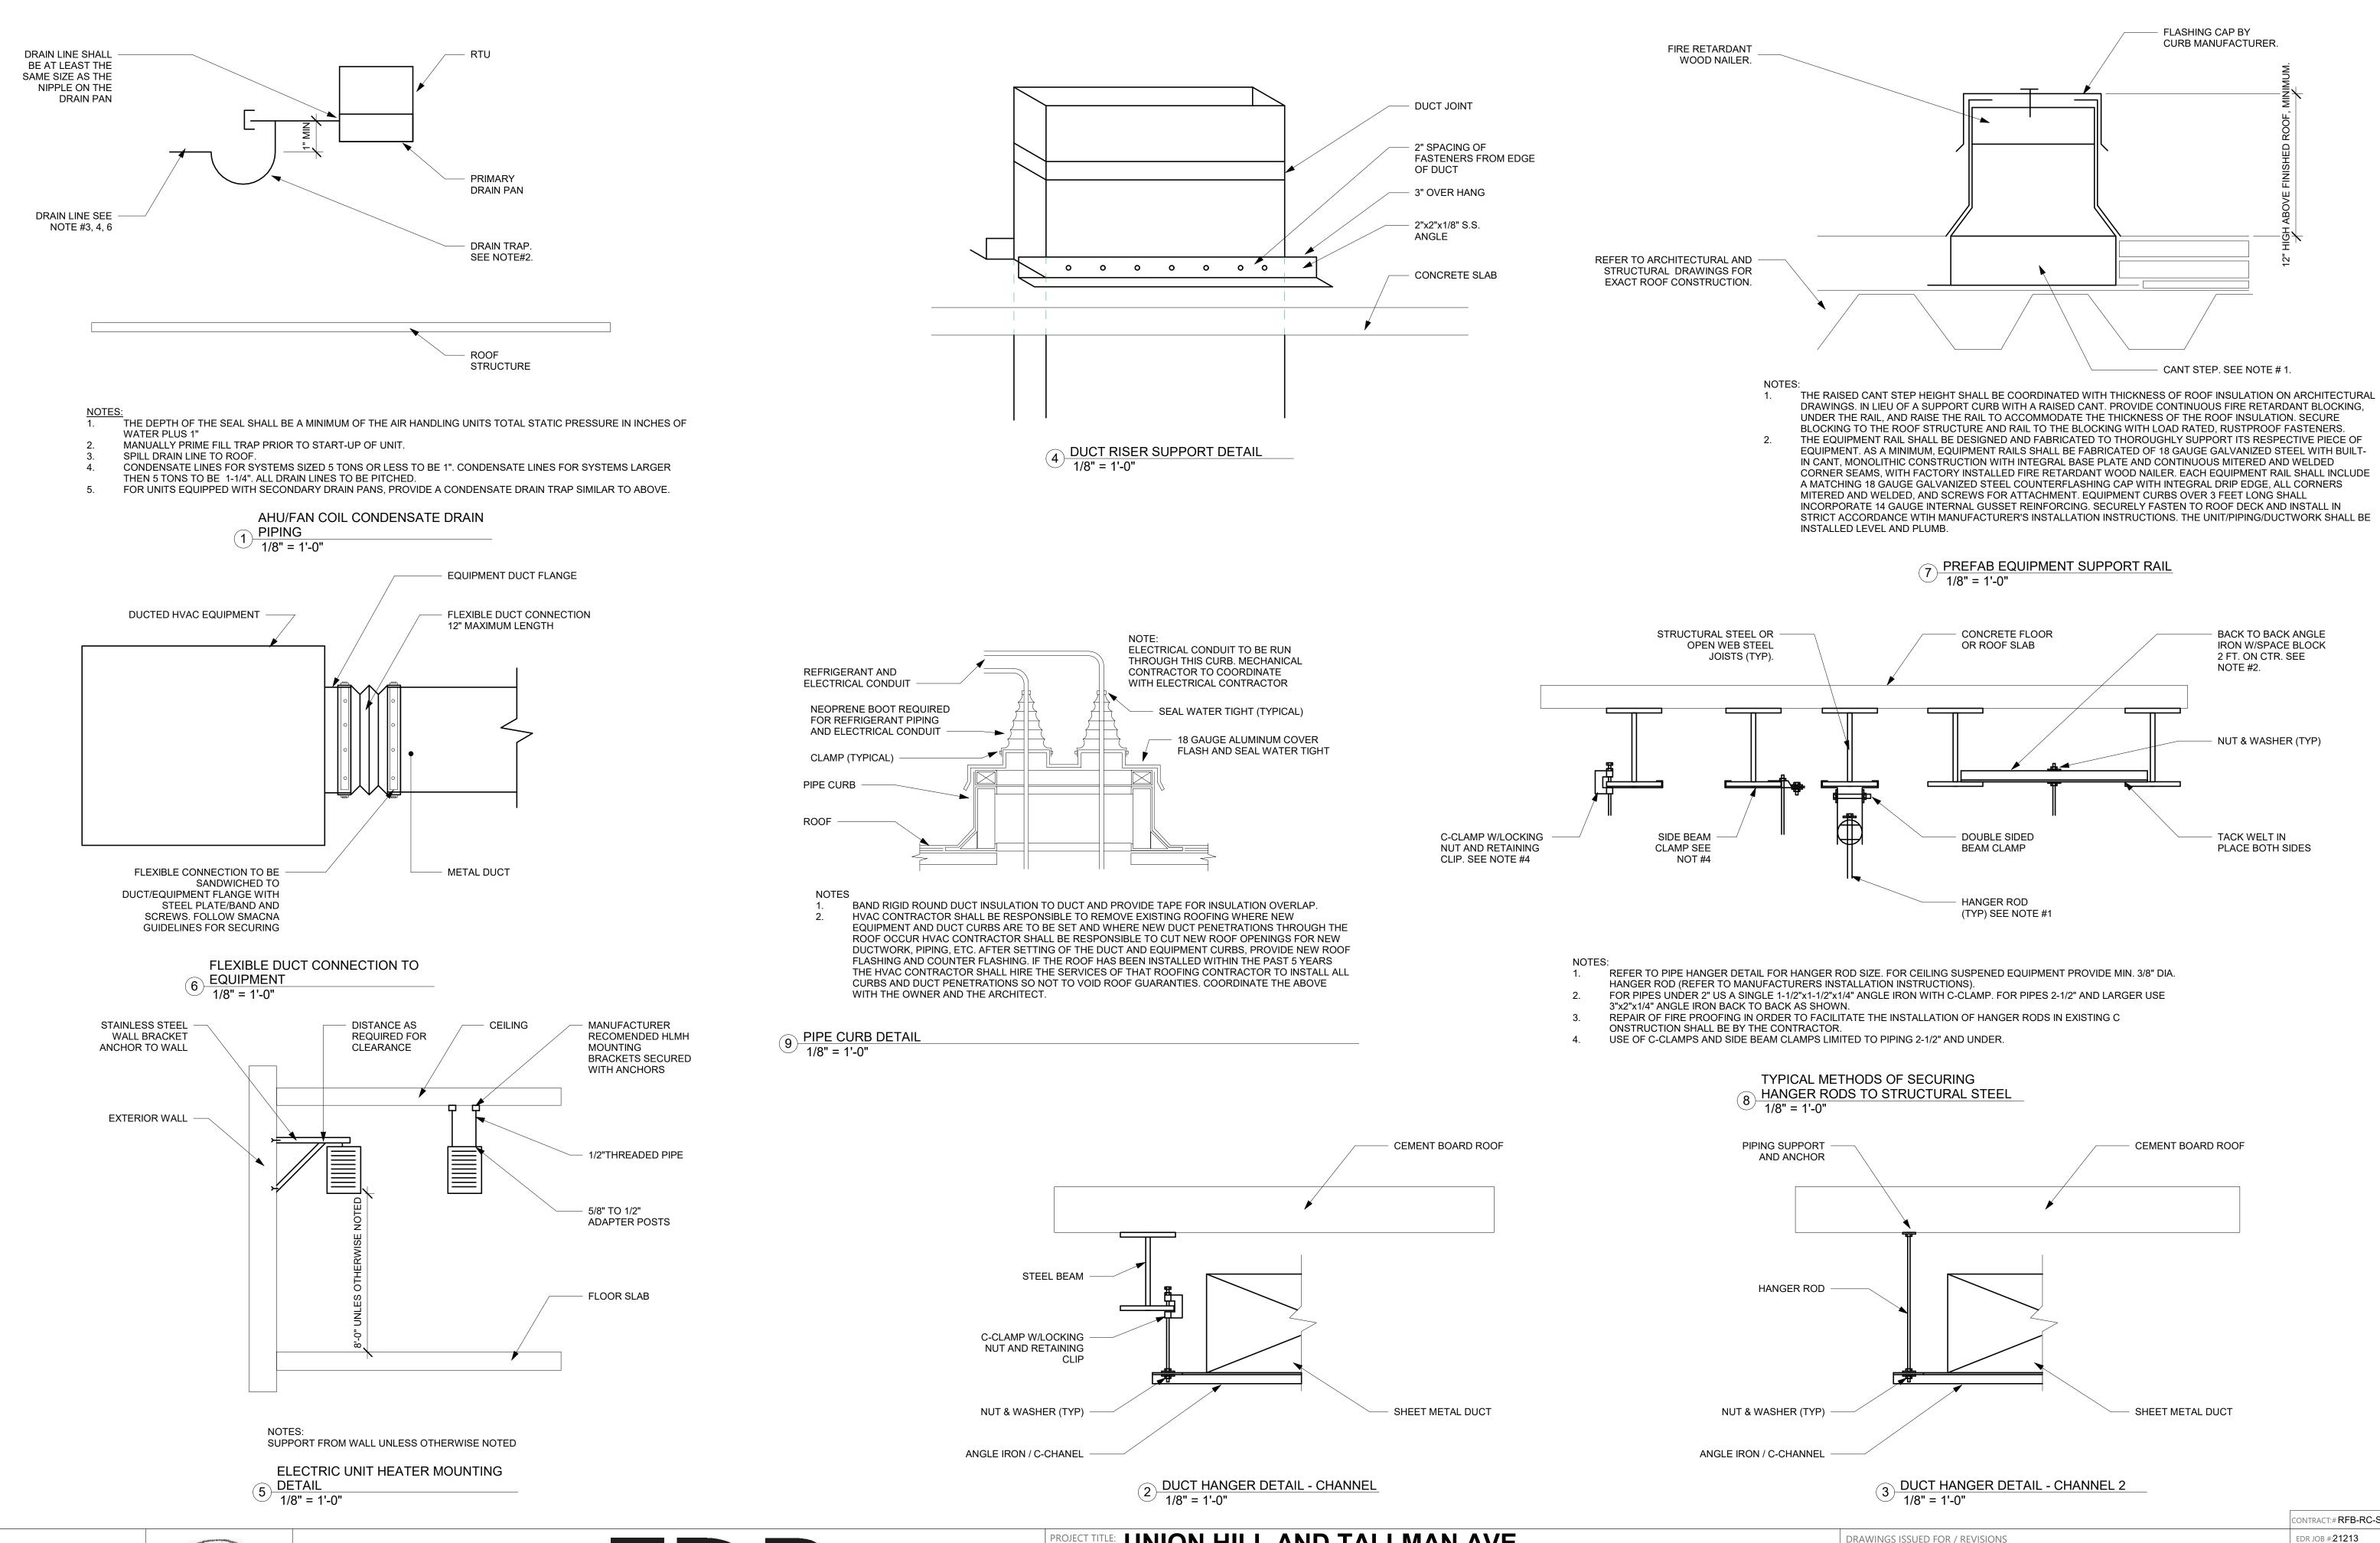





Environmental

Syracuse, New York 13202

Design & Research,

Landscape Architecture, Engineering & Environmental Services, D.P.C. 217 Montgomery Street, Suite 1100

					CONTRACT:# RFB-RC-SWR-2022-06
ROJECT TITLE: UNION HILL AND TALLMAN AVE		DRAWINGS ISS	SUED FOR / REVISIONS		EDR JOB #:21213
	N	NO. DATE	ISSUED FOR / REVISIONS	BY CHK APP	DATE: 06/2023
PUMP STATION UPGRADE		1 04/22	60 PERCENT DESIGN REVIEW	MJL JGD GRL	SCALE: 1/8" = 1'-0"
ROJECT LOCATION: ROCKLAND COUNTY, NEW YORK		2 07/22	90 PERCENT DESIGN REVIEW	MJL JGD GRL	DRAWN BY: J. ROSS
LIENT: ROCKLAND COUNTY SEWER DISTRICT No. 1		3 09/22	FOR REGULATORY REVIEW	MJL JGD GRL	CHECKED BY: G. LYNCH
RAWING TITLE: PUMP STATION DETAILS	CONTRACT	4 01/23	100 PERCENT DESIGN REVIEW	MJL JGD GRL	DRAWING NUMBER:
		5 03/23	100 PERCENT DESIGN REVIEW	MJL JGD GRL	H-002
		6 06/23	FOR BID	MJL JGD GRL	11-002

	ELECTRIC UNIT HEATER SCHEDULE													
NAME	AIRFLOW RATE (CFM)	HEATING CAPACITY KW	HEATING CAPACITY MBH	VOLTAGE	AMPS	WEIGHT (LBS)	MANUFACTURER	COMMENTS						
UH-1	350	5	85.3	460/3	6	27	QMARK MUH0541	-						
UH-2	840	10	34.1	460/3	12.7	140	QMARK GUX10004832	1						
UH-3	840	10	34.1	460/3	12.7	140	QMARK GUX10004832	1						

1. UNIT HEATER SHALL BE EXPLOSION PROOF AND UL AND CUL APPROVED FOR CLASS I, DIVISION 1 AND 2, GROUP C AND D; CLASS II, DIVSIONS 1 AND 2, GROUPS E, F, AND G.

	SPLIT SYSTEM AIR HANDLER SCHEDULE													
NAME	SUPPLY AIR (CFM)	COOLING CAPACITY (MBH)	V/PH/HZ	MCA (A)	MOCP (A)	WEIGHT (LBS)	MANUFACTURER							
AIR HANDLER 1	5500	152.5	460/3/60	5.1	15	770	JOHNSON CONTROLS J15NLC00D4CAA2							
AIR HANDLER 2	5500	152.5	460/3/60	5.1	15	770	JOHNSON CONTROLS J15NLC00D4CAA2							


1. AIR HANDLERS TO BE PROVIDED WITH 1 GPM CONDENSATE PUMP.

	SPLIT SYSTEM CONDENSER SCHEDULE													
NAME	COOLING CAPACITY (MBH)	V/PH/HZ	MCA (A)	MOCP (A)	SOUND (dBA)	WEIGHT (LBS)	MANUFACTURER							
CONDENSER 1	152.5	460/3/60	27.1	35	91	499	JOHNSON CONTROLS J12YCC00A4JLA4							
CONDENSER 2	152.5	460/3/60	27.1	35	91	499	JOHNSON CONTROLS J12YCC00A4JLA4							

1. SPLIT SYSTEMS TO BE PROVIDED WITH SUPERVISORY CONTROLLER FOR LEAD LAG OPERATION. SEE SPECIFICATIONS FOR ADDITIONAL REQUIREMENTS

	FAN SCHEDULE														
NAME	CONFIGURATION	AIRFLOW RATE (CFM)	ESP	TOTAL ESP	VOLTAGE	FEI	ВНР	MOTOR HP	SOUND (dBA)	MANUFACTURER	MODEL NUMBER	COMMENTS			
PUMP ROOM SUPPLY FAN	TUBULAR CENTRIFUGAL ROOF TOP	1,200	1"	-	460/3	-	.55	3/4	67	LOREN COOK	16CVR-S	1, 2			
PUMP ROOM EXHAUST FAN	TUBULAR CENTRIFUGAL ROOF TOP	1,300	1"	-	460/3	-	0.60	1	68	LOREN COOK	16CVR	1, 2			
SCREENINGS ROOM SUPPLY FAN	TUBULAR CENTRIFUGAL ROOF TOP	340	0.5"	-	460/3	-	0.11	1/4	53	LOREN COOK	16CVR-S	1, 2			
SCREENINGS ROOM EXHAUST FAN	TUBULAR CENTRIFUGAL ROOF TOP	380	0.5"	-	460/3	-	0.12	1/4	54	LOREN COOK	16CVR	1, 2			
BATHROOM EXHAUST FAN	CENTRIFUGAL UPBLAST	100	0.25"	-	120/1	-	0.02	1/15	42	GREENHECK	CUE-060-VG	1			

1. FANS TO BE PROVIDED WITH FACTORY OR FIELD DISCONNECT SWITCHES WITH LOCK OUT TAG OUT FEATURE. LOCK TO BE SUPPLIED BY CONTRACTOR. 2. FANS SHALL BE SPARK B RESISTANT CONSTRUCTION.

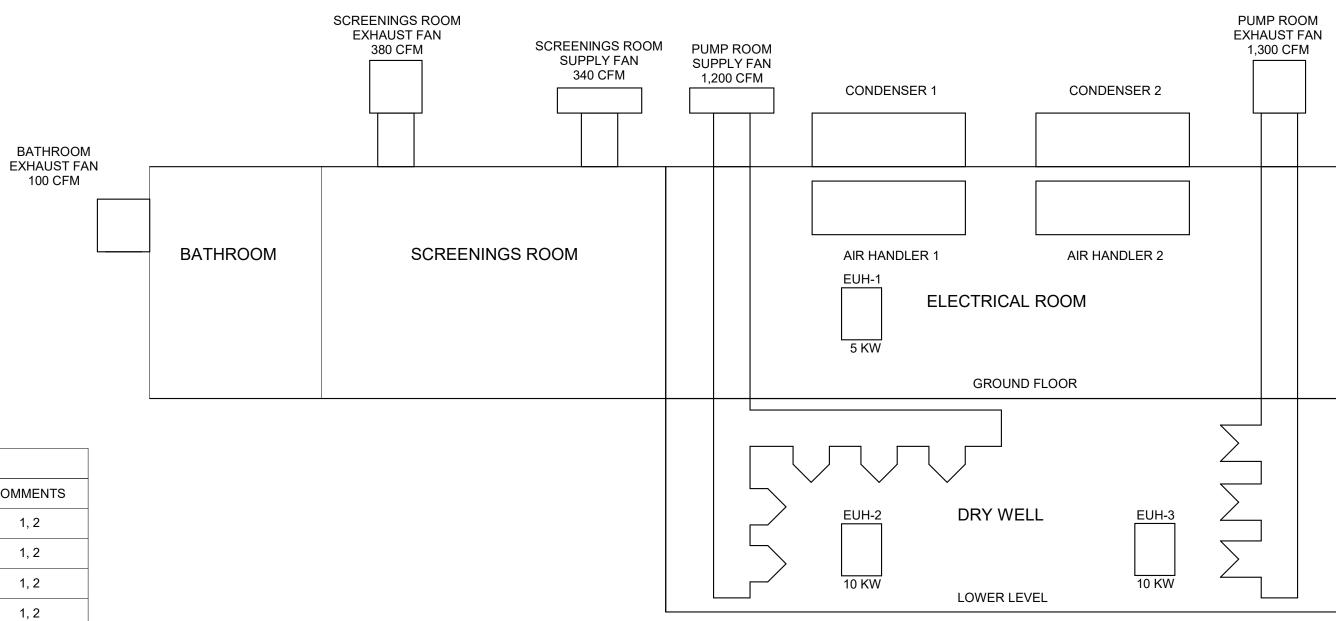

1 AIRFLOW DIAGRAM 1/2" = 1'-0"







Environmental Design & Research, Landscape Architecture, Engineering & Environmental Services, D.P.C. 217 Montgomery Street, Suite 1100 Syracuse, New York 13202

								CONTRACT #RFB-RC-SWR-2022-06
PROJECT TITLE: UNION HILL PUMP AND TALLMAN		DRAW	/INGS ISS	SUED FOR / REVISIONS				EDR JOB #: 21213
	1	NO. D	ATE	ISSUED FOR / REVISIONS	BY	СНК	APP	DATE: 06/2023
AVE PUMP STATION UPGRADE		1 04	4/22	60 PERCENT DESIGN REVIEW	LSE	JGD	GRL	SCALE: As indicated
PROJECT LOCATION: ROCKLAND COUNTY, NEW YORK		2 0	7/22	90 PERCENT DESIGN REVIEW	LSE	JGD	GRL	DRAWN BY: J. ROSS
CLIENT: ROCKLAND COUNTY SEWER DISTRCIT NO 1		3 09	9/22	FOR REGULATORY REVIEW	LSE	JGD	GRL	CHECKED BY: G. LYNCH
DRAWING TITLE: UNION HILL PUMP STATION AIRFLOW DIAGRAM, SCHEDULES CONT	TRACT	4 0	1/23	100 PERCENT DESIGN REVIEW	LSE	JGD	GRL	DRAWING NUMBER:
	1	5 03	3/23	100 PERCENT DESIGN REVIEW	LSE	JGD	GRL	H-101
	I	6 06	5/23	FOR BID	LSE	JGD	GRL	11 101



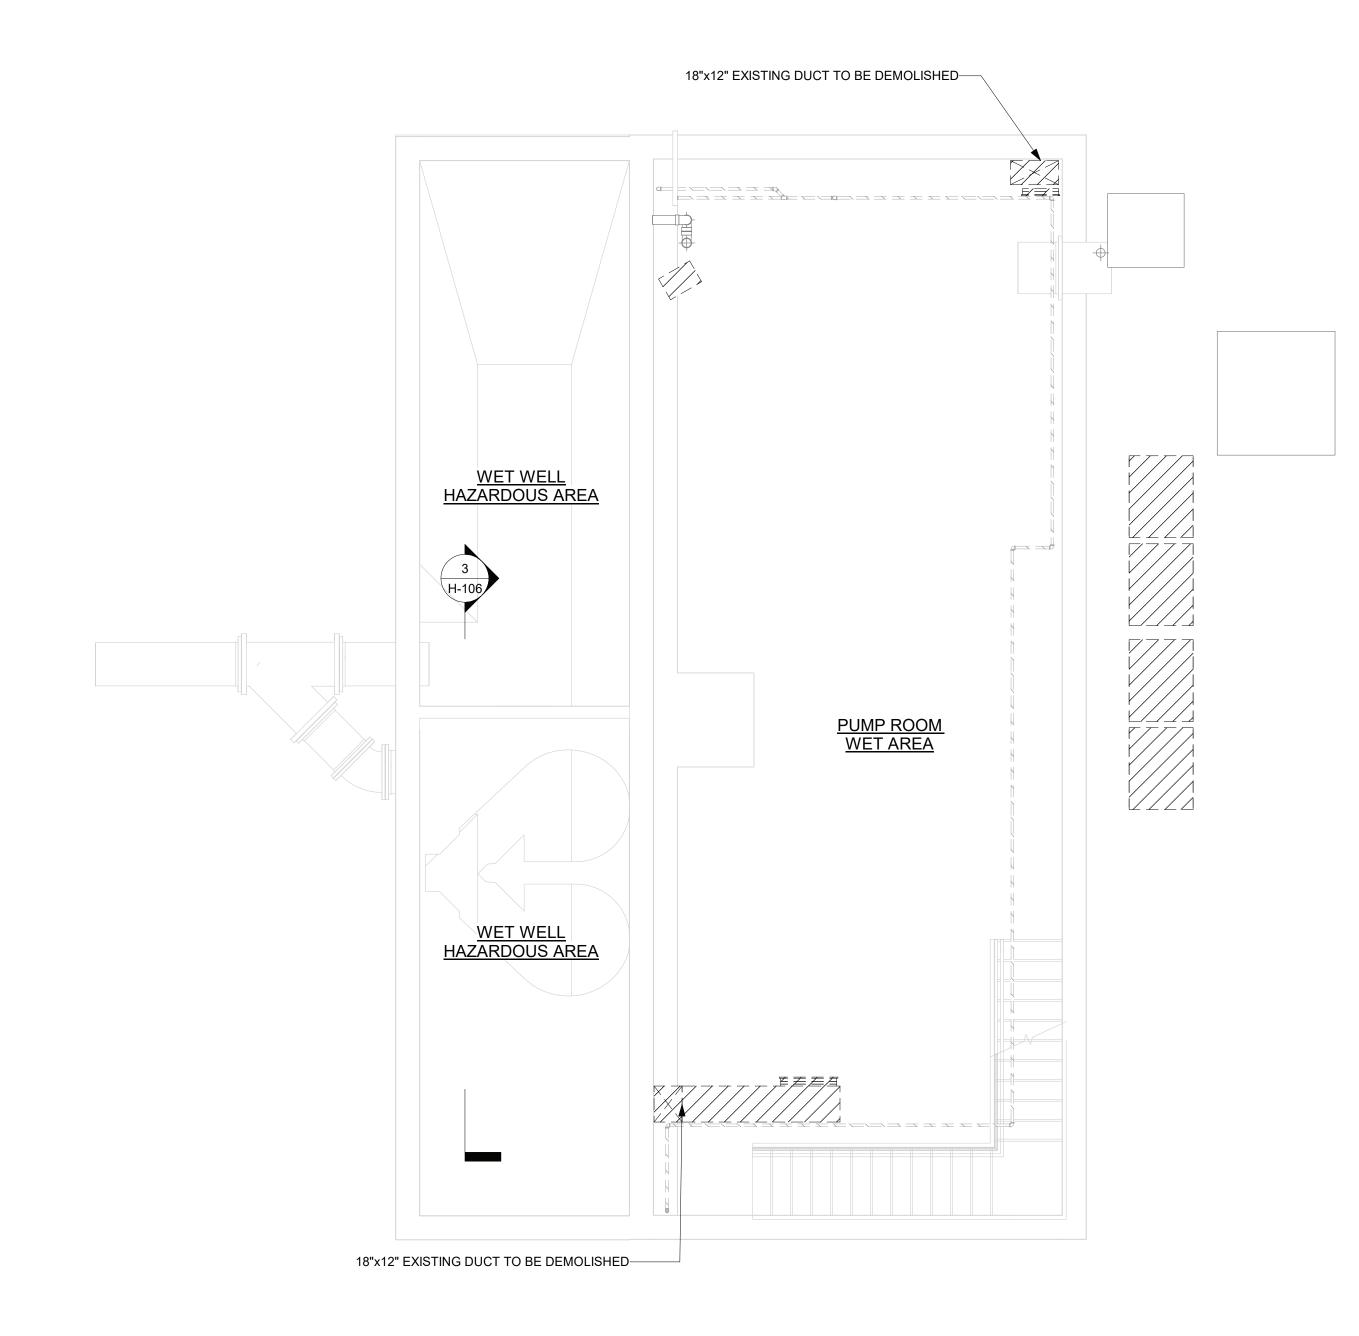

1 HVAC LOWER LEVEL DEMOLITION PLAN 1/4" = 1'-0"

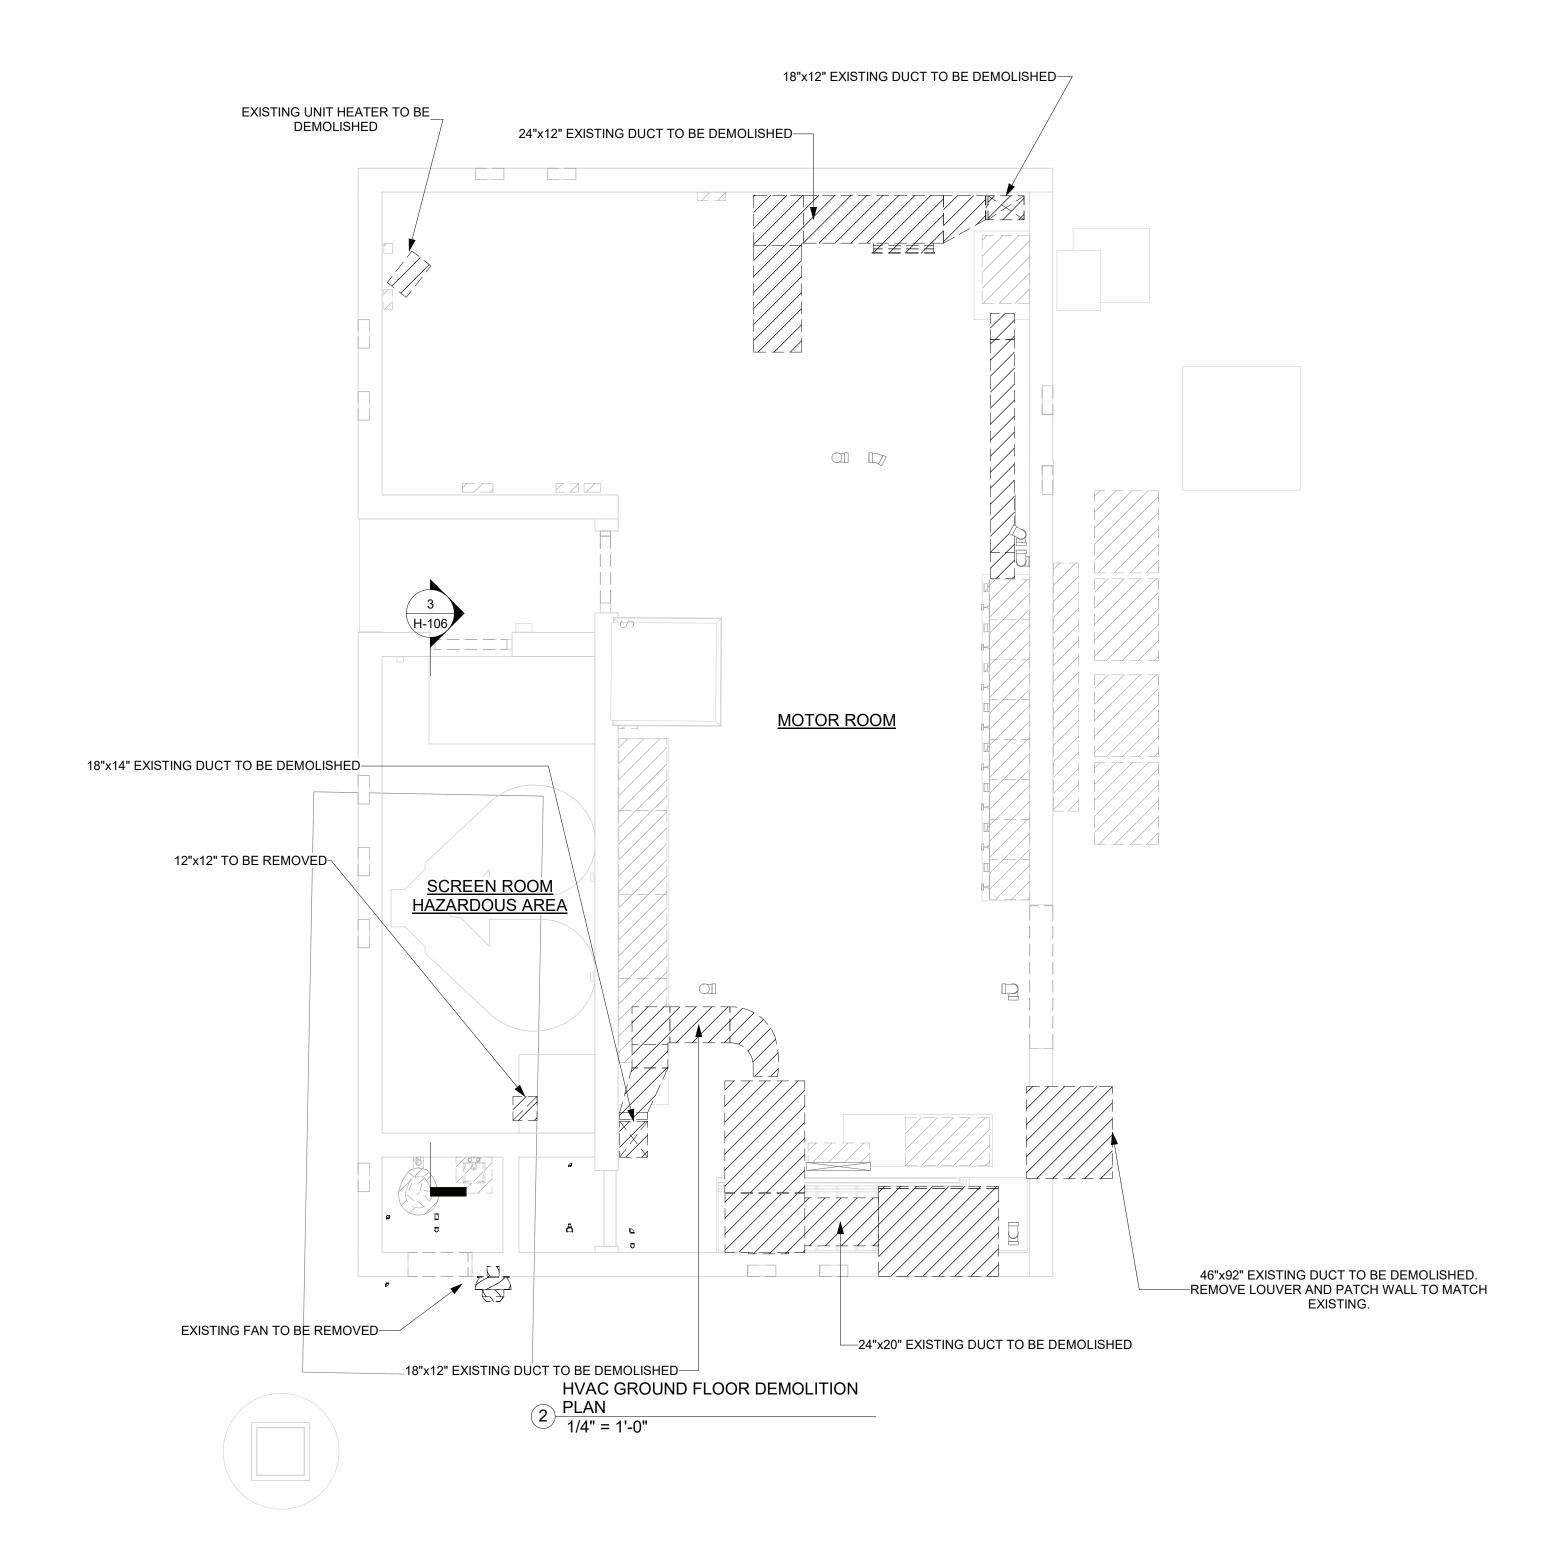






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		NO. DATE	ISSUED FOR / REVISIONS	BY	СНК	APP	DATE: 06/2023
AVE PUMP STATION UPGRADE		1 04/22	60 PERCENT DESIGN REVIEW	LSE	JGD	GRL	SCALE: 1/4" = 1'-0"
PROJECT LOCATION: ROCKLAND COUNTY, NEW YORK		2 07/22	90 PERCENT DESIGN REVIEW	LSE	JGD	GRL	DRAWN BY: J. ROSS
CLIENT: ROCKLAND COUNTY SEWER DISTRCIT NO 1		3 09/22	FOR REGULATORY REVIEW	LSE	JGD	GRL	CHECKED BY: G. LYNCH
DRAWING TITLE: UNION HILL PUMP STATION DEMOLITION LOWER AND GROUND FLOOR PLANS	CONTRACT	4 01/23	100 PERCENT DESIGN REVIEW	LSE	JGD	GRL	DRAWING NUMBER:
	1	5 03/23	100 PERCENT DESIGN REVIEW	LSE	JGD	GRL	H-102
		6 06/23	FOR BID	LSE	JGD	GRL	11 102







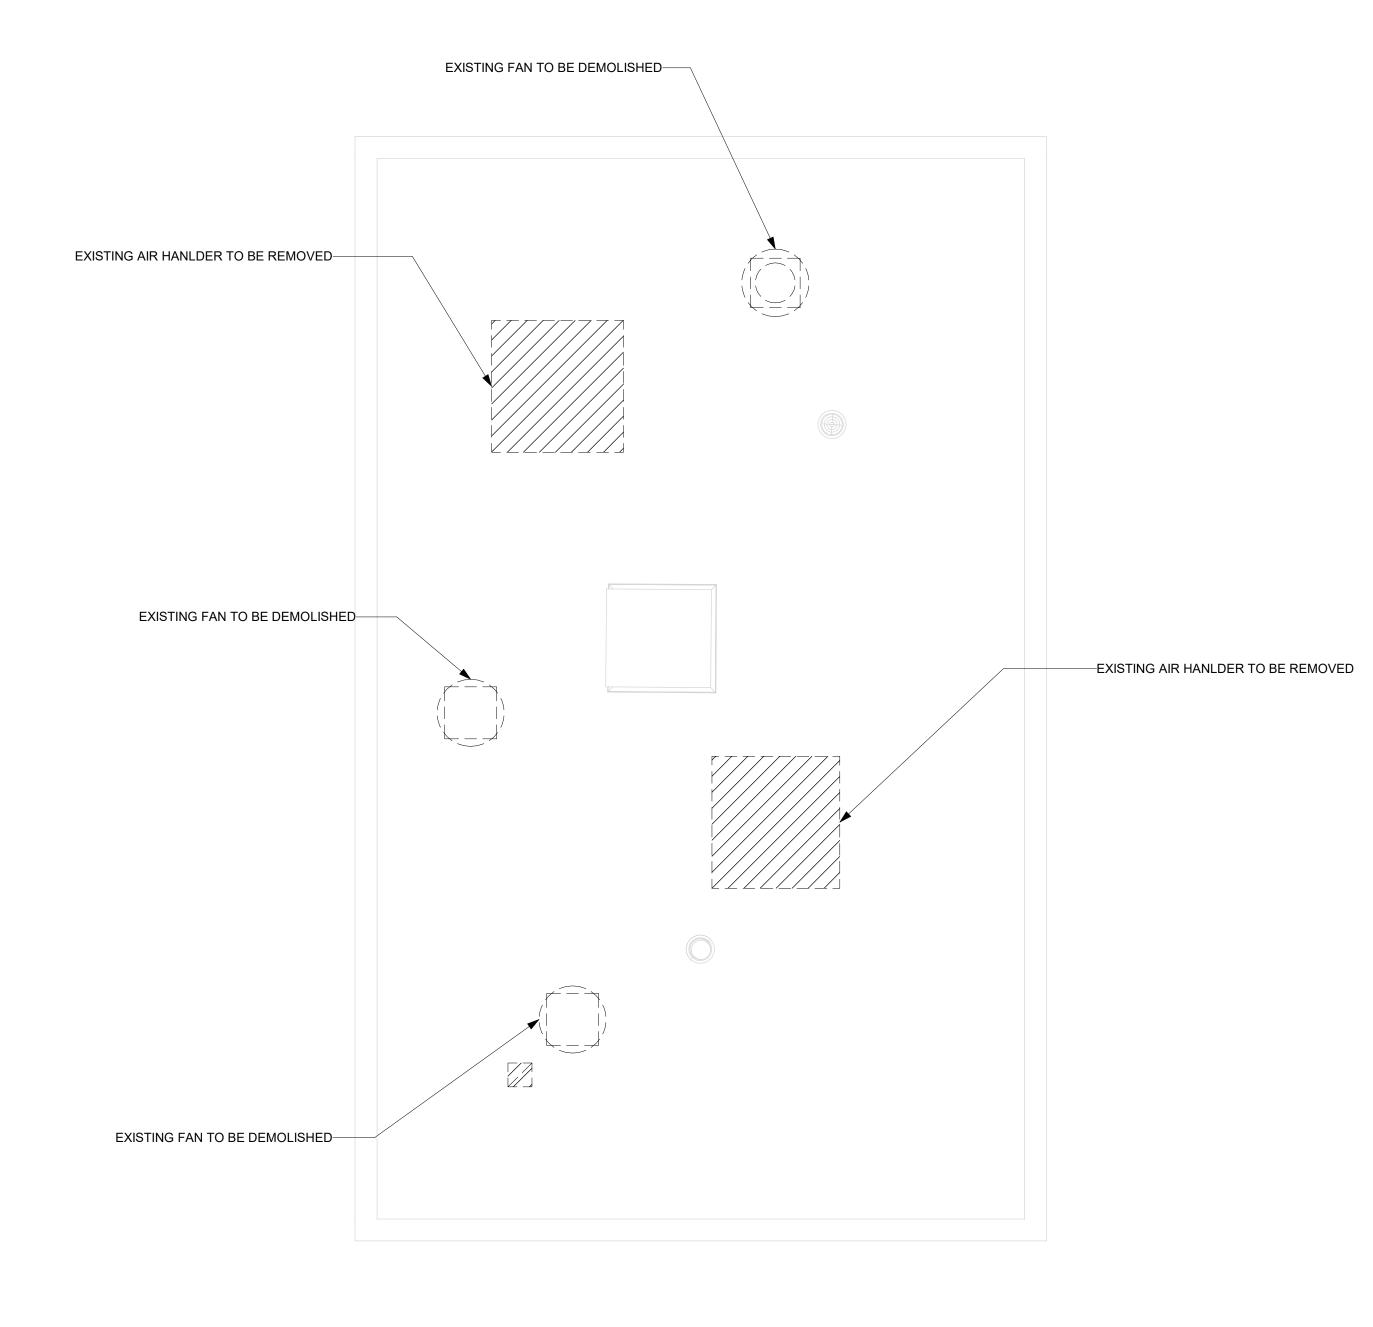









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	NO.	DATE	ISSUED FOR / REVISIONS	BY	CHK AI	PP DATE: 06/2023
AVE PUMP STATION UPGRADE	1	04/22	60 PERCENT DESIGN REVIEW	LSE	JGD G	GRL SCALE: 1/4" = 1'-0"
PROJECT LOCATION: ROCKLAND COUNTY, NEW YORK	2	07/22	90 PERCENT DESIGN REVIEW	LSE	JGD G	GRL DRAWN BY: J, ROSS
CLIENT: ROCKLAND COUNTY SEWER DISTRCIT NO 1	3	09/22	FOR REGULATORY REVIEW	LSE	JGD G	GRL CHECKED BY: G. LYNCH
DRAWING TITLE: UNION HILL PUMP STATION DEMOLITION ROOF PLAN CONTRACT	4	01/23	100 PERCENT DESIGN REVIEW	LSE	JGD G	GRL DRAWING NUMBER:
1	5	03/23	100 PERCENT DESIGN REVIEW	LSE	JGD G	H-103
lacksquare	6	06/23	FOR BID	LSE	JGD G	RL





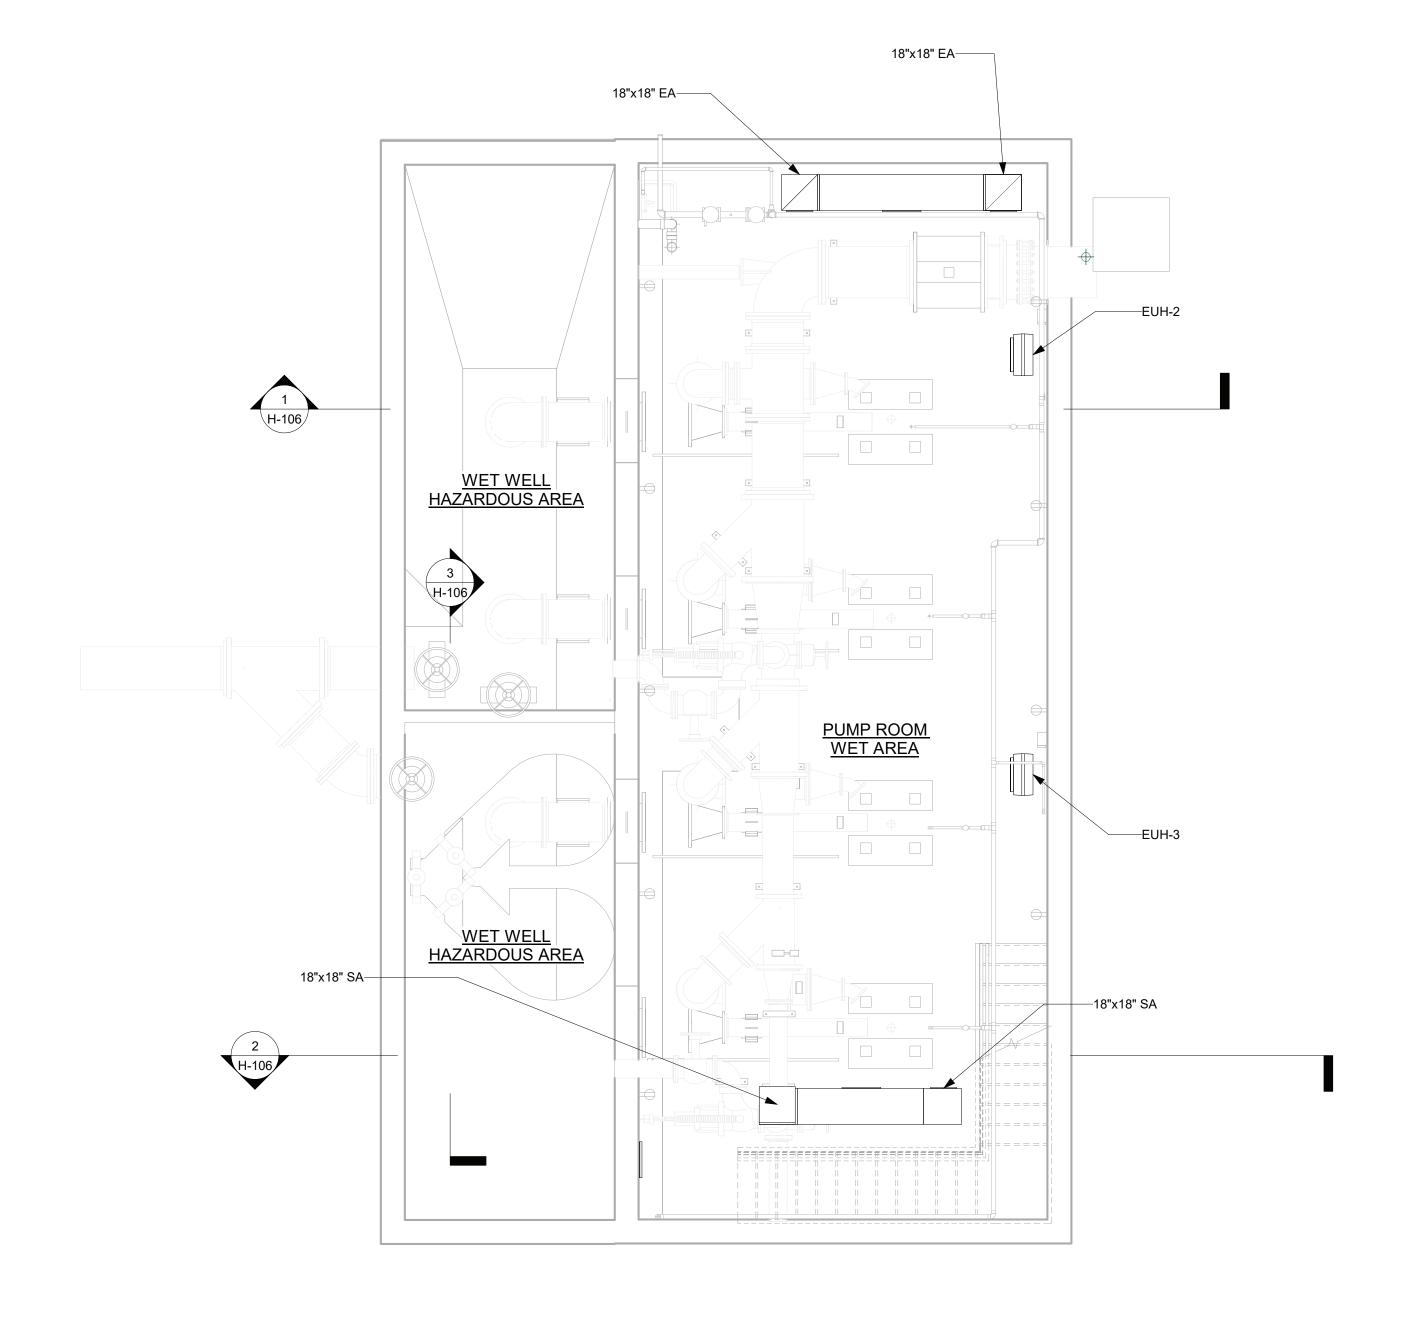

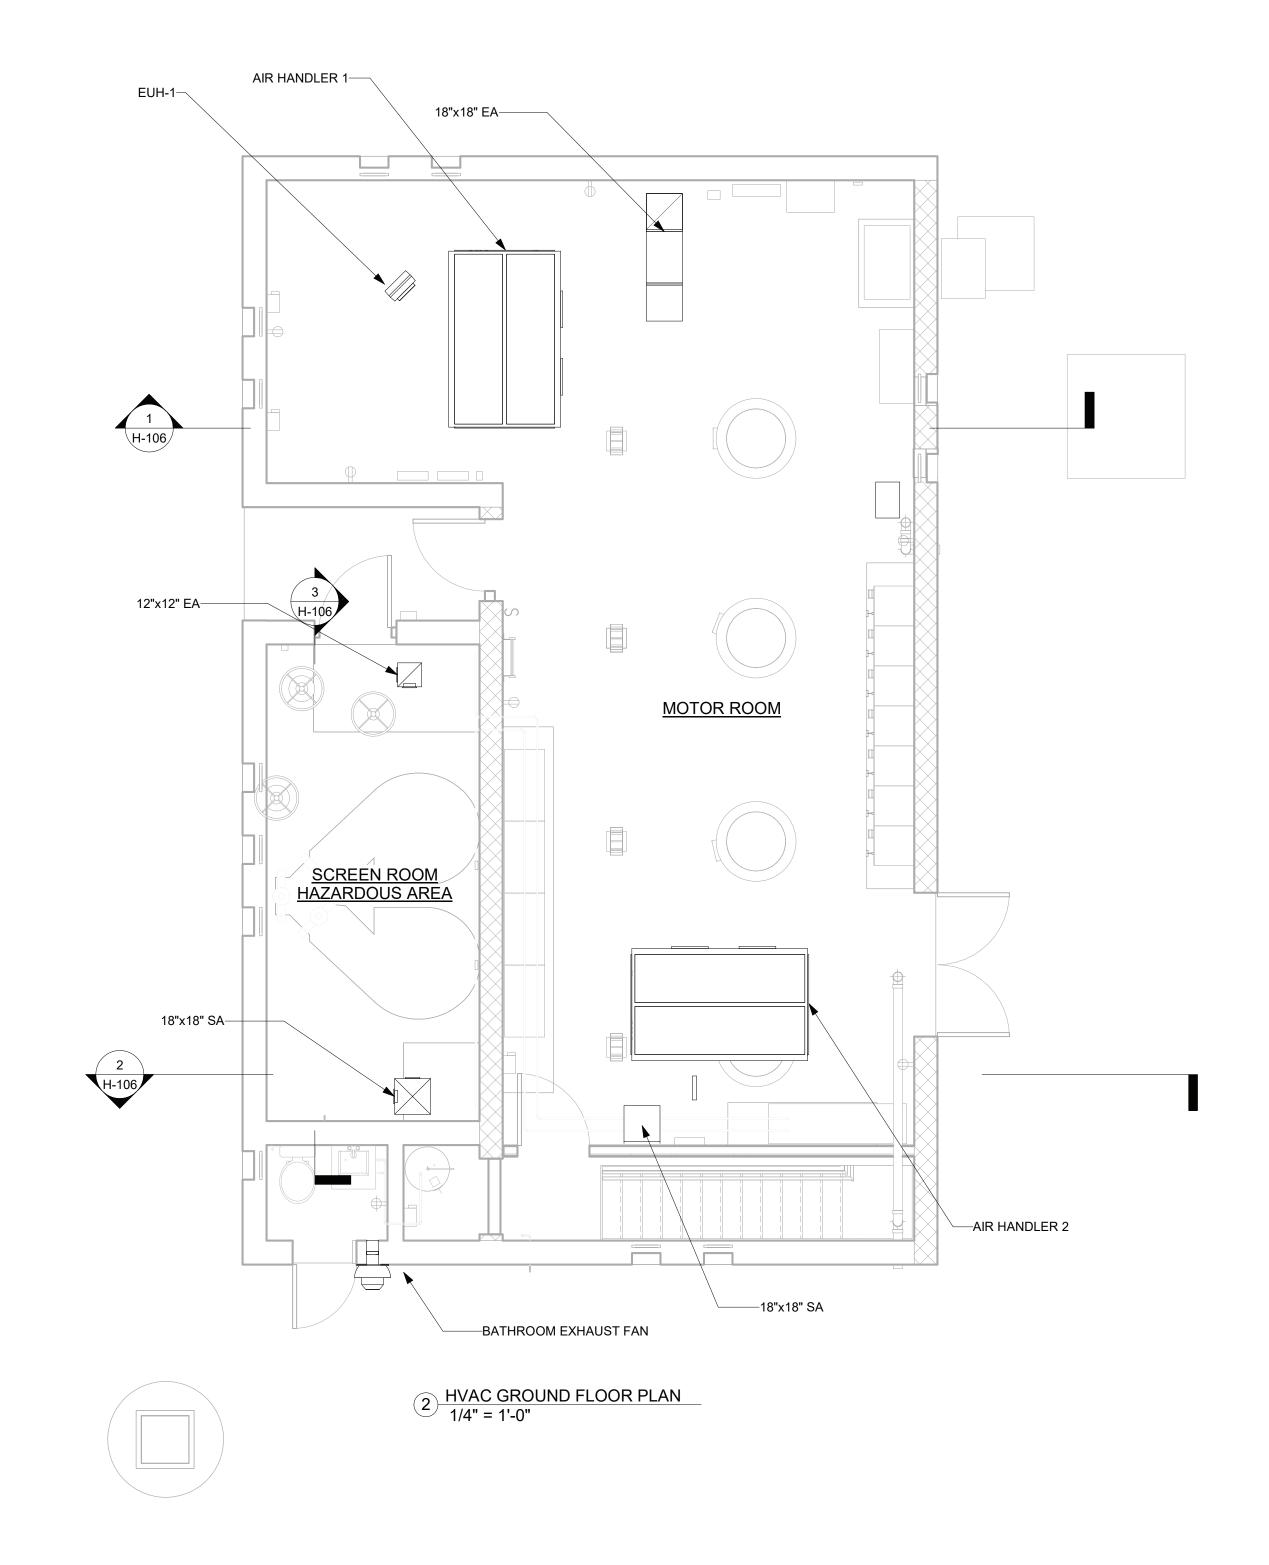








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PROJECT TITLE: UNION HILL PUMP AND TALLMAN		DRAWINGS	ISSUED FOR / REVISIONS				EDR JOB #: 21213
		NO. DATE	ISSUED FOR / REVISIONS	ВУ	СНК	APP	DATE: 06/2023
AVE PUMP STATION UPGRADE		1 04/22	60 PERCENT DESIGN REVIEW	LSE	JGD	GRL	SCALE: 1/4" = 1'-0"
PROJECT LOCATION: ROCKLAND COUNTY, NEW YORK		2 07/22	90 PERCENT DESIGN REVIEW	LSE	JGD	GRL	DRAWN BY: J. ROSS
CLIENT: ROCKLAND COUNTY SEWER DISTRCIT NO 1		3 09/22	FOR REGULATORY REVIEW	LSE	JGD	GRL	CHECKED BY: G. LYNCH
DRAWING TITLE: UNION HILL PUMP STATION LOWER AND GROUND FLOOR PLANS	CONTRACT	4 01/23	100 PERCENT DESIGN REVIEW	LSE	JGD	GRL	DRAWING NUMBER:
	1	5 03/23	100 PERCENT DESIGN REVIEW	LSE	JGD	GRL	H-104
		6 06/23	FOR BID	LSE	JGD	GRL	11 104



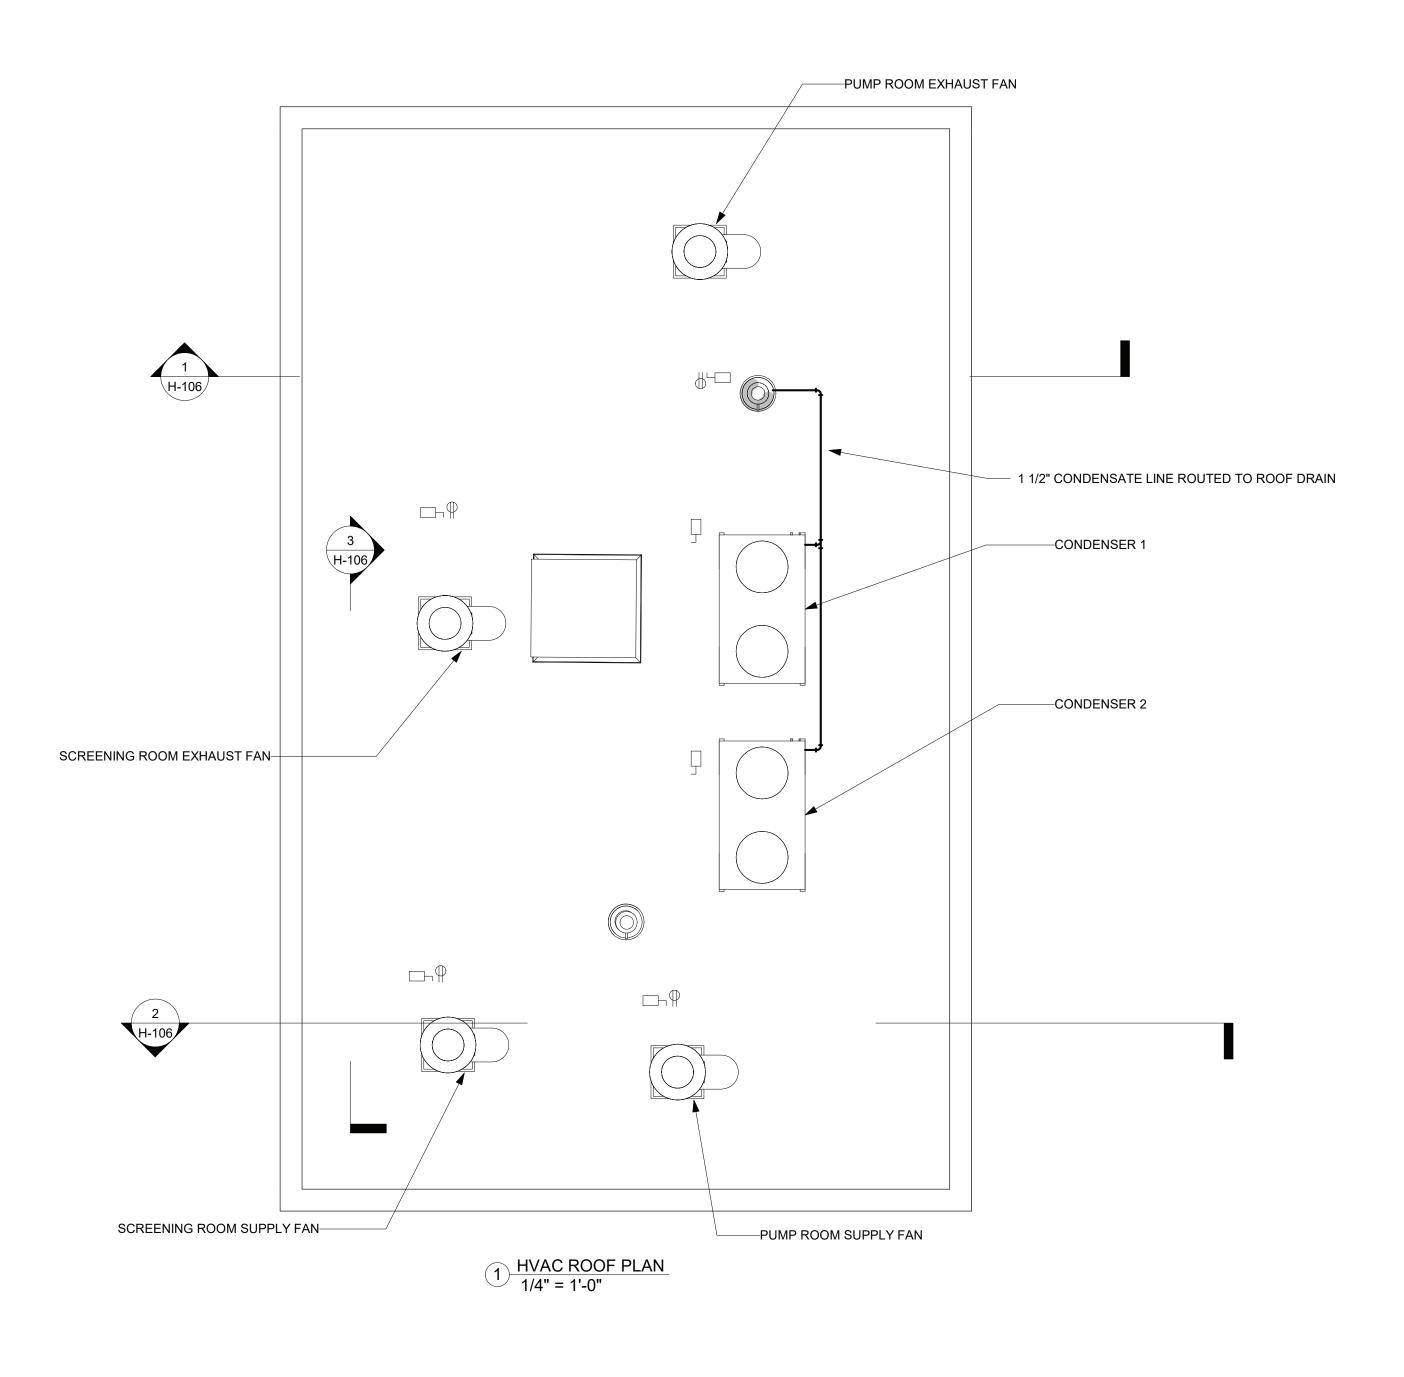










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		NO. DATE	ISSUED FOR / REVISIONS	BY CHK	APP	DATE: 06/2023
AVE PUMP STATION UPGRADE		1 04/22	60 PERCENT DESIGN REVIEW	LSE JGD	GRL	SCALE: 1/4" = 1'-0"
PROJECT LOCATION: ROCKLAND COUNTY, NEW YORK		2 07/22	90 PERCENT DESIGN REVIEW	LSE JGD	GRL	DRAWN BY: J. ROSS
CLIENT: ROCKLAND COUNTY SEWER DISTRCIT NO 1		3 09/22	FOR REGULATORY REVIEW	LSE JGD	GRL	CHECKED BY: G. LYNCH
DRAWING TITLE: UNION HILL PUMP STATION ROOF PLAN	ONTRACT	4 01/23	100 PERCENT DESIGN REVIEW	LSE JGD	GRL	DRAWING NUMBER:
	1	5 03/23	100 PERCENT DESIGN REVIEW	LSE JGD	GRL	H-105
	ı	6 06/23	FOR BID	LSE JGD	GRL	11 100

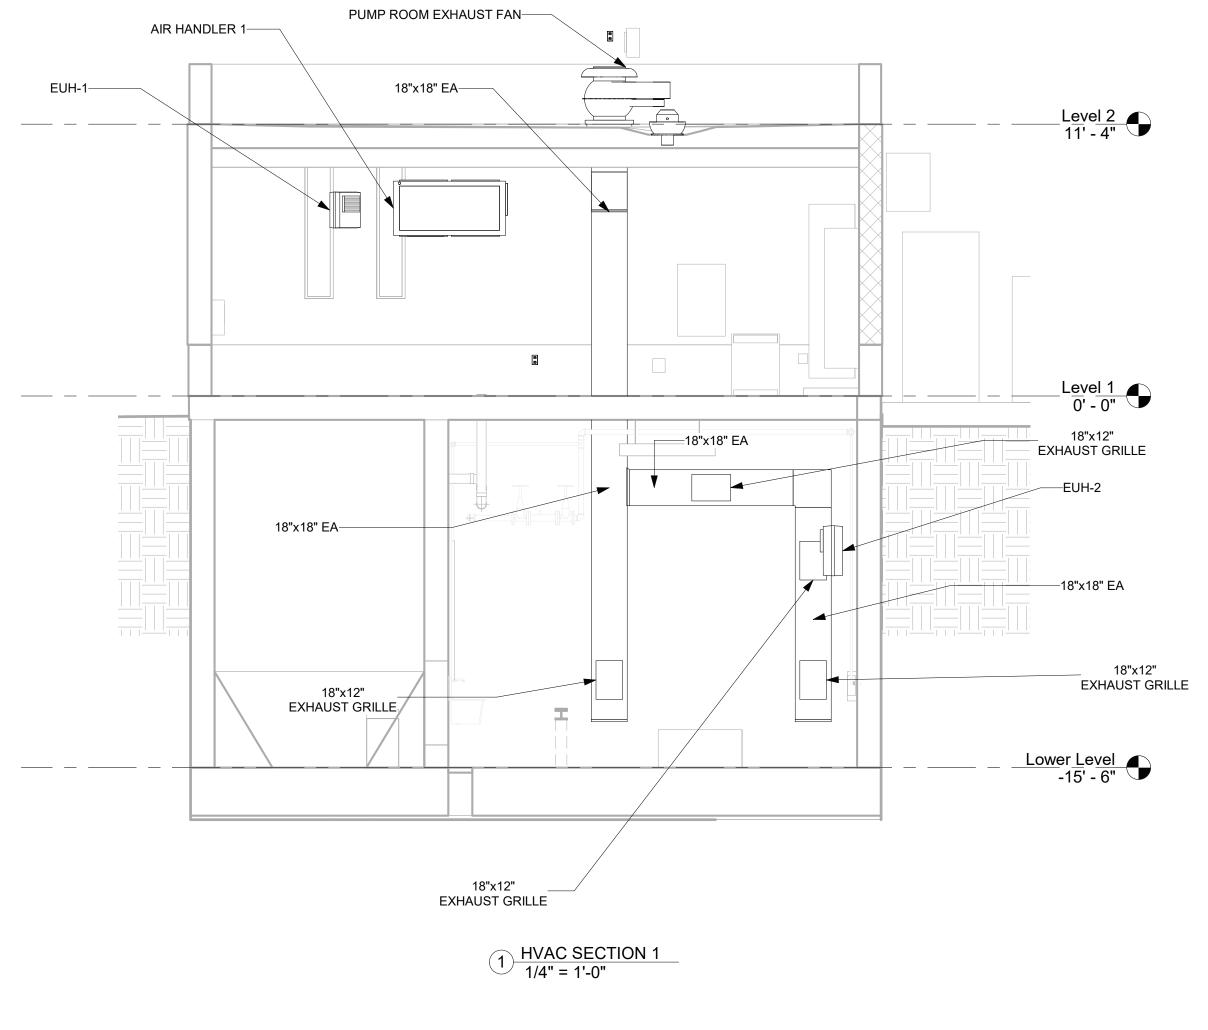

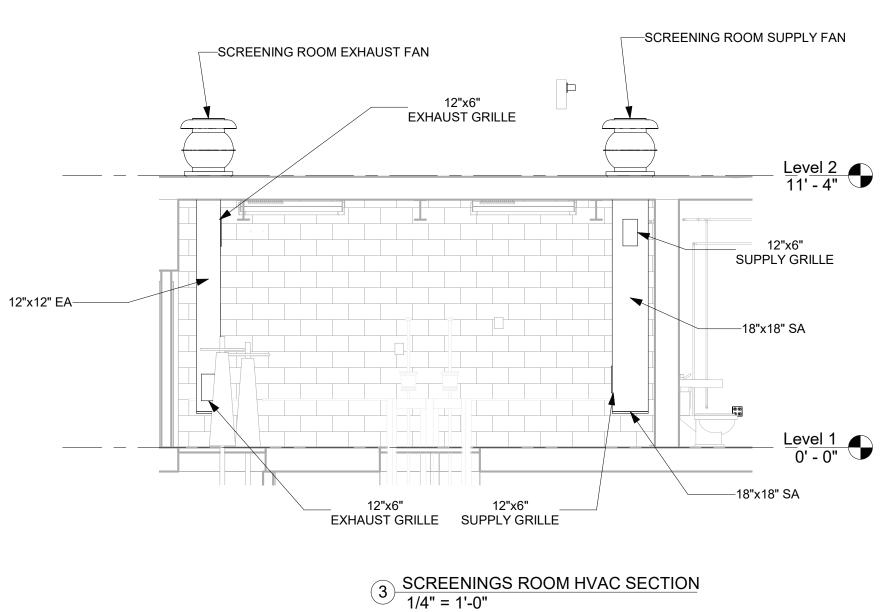

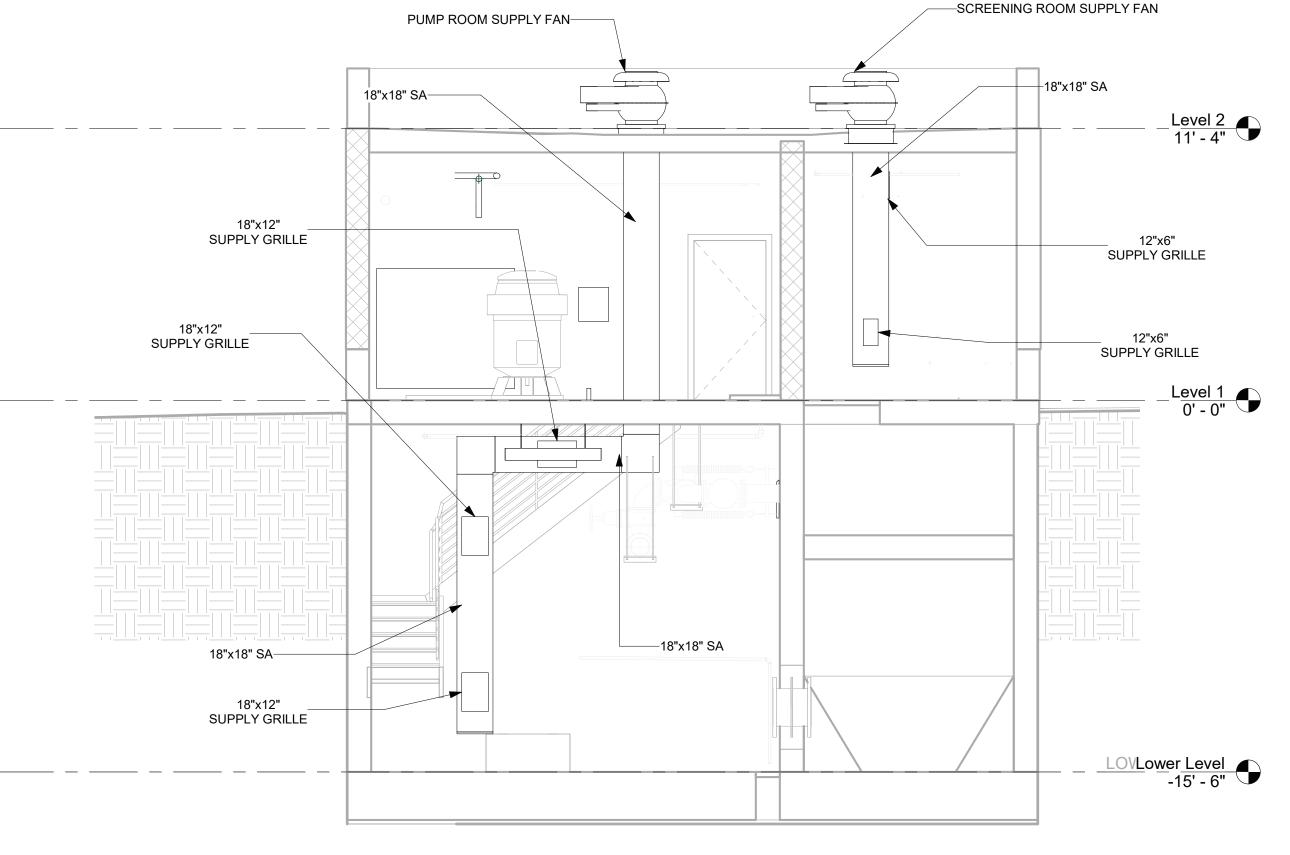

2 HVAC SECTION 2 1/4" = 1'-0"

H-106





CONTRACT #RFB-RC-SWR-2022-06 PROJECT TITLE: UNION HILL PUMP AND TALLMAN EDR JOB #: 21213 DRAWINGS ISSUED FOR / REVISIONS BY CHK APP DATE: **06/2023** ISSUED FOR / REVISIONS **AVE PUMP STATION UPGRADE** 60 PERCENT DESIGN REVIEW LSE | JGD | GRL | SCALE: 1/4" = 1'-0" 90 PERCENT DESIGN REVIEW LSE JGD GRL DRAWN BY: J. ROSS CLIENT: ROCKLAND COUNTY SEWER DISTRCIT NO 1 FOR REGULATORY REVIEW LSE JGD GRL CHECKED BY: G. LYNCH DRAWING TITLE: UNION HILL PUMP STATION SECTIONS LSE JGD GRL DRAWING NUMBER: 100 PERCENT DESIGN REVIEW LSE JGD GRL
LSE JGD GRL 100 PERCENT DESIGN REVIEW 06/23 FOR BID

	ELECTRIC UNIT HEATER SCHEDULE										
NAME	AIRFLOW RATE (CFM)	HEATING CAPACITY KW	HEATING CAPACITY MBH	VOLTAGE	AMPS	WEIGHT (LBS)	MANUFACTURER	COMMENTS			
UH-1	350	5	85.3	460/3	6	27	QMARK MUH0541	1			
UH-2	840	10	34.1	460/3	12.7	140	QMARK GUX10004832	1			
UH-3	840	10	34.1	460/3	12.7	140	QMARK GUX10004832	1			

1. UNIT HEATER SHALL BE EXPLOSION PROOF AND UL AND cUL APPROVED FOR CLASS I, DIVISION 1 AND 2, GROUP C AND D; CLASS II, DIVSIONS 1 AND 2, GROUPS E, F, AND G.

	SPLIT SYSTEM AIR HANDLER SCHEDULE												
NAME	SUPPLY AIR (CFM)	COOLING CAPACITY (MBH)	V/PH/HZ	MCA (A)	MOCP (A)	WEIGHT (LBS)	MANUFACTURER						
AIR HANDLER 1	5500	152.5	460/3/60	5.1	15	770	JOHNSON CONTROLS J15NLC00D4CAA2						
AIR HANDLER 2	5500	152.5	460/3/60	5.1	15	770	JOHNSON CONTROLS J15NLC00D4CAA2						


1. AIR HANDLERS TO BE PROVIDED WITH 1 GPM CONDENSATE PUMP.

	SPLIT SYSTEM	CONDEN	SER SCH	SPLIT SYSTEM CONDENSER SCHEDULE													
NAME	COOLING CAPACITY (MBH)	V/PH/HZ	MCA (A)	MOCP (A)	SOUND (dBA)	WEIGHT (LBS)	MANUFACTURER										
CONDENSER 1	152.5	460/3/60	27.1	35	91	499	JOHNSON CONTROLS J12YCC00A4JLA4										
CONDENSER 1	152.5	460/3/60	27.1	35	91	499	JOHNSON CONTROLS J12YCC00A4JLA4										

1. SPLIT SYSTEMS TO BE PROVIDED WITH SUPERVISORY CONTROLLER FOR LEAD LAG OPERATION. SEE SPECIFICATIONS FOR ADDITIONAL REQUIREMENTS

	FAN SCHEDULE													
NAME	CONFIGURATION	AIRFLOW RATE (CFM)	ESP	TOTAL ESP	VOLTAGE	FEI	BHP	MOTOR HP	SOUND (dBA)	MANUFACTURER	MODEL NUMBER	COMMENTS		
PUMP ROOM SUPPLY FAN	TUBULAR CENTRIFUGAL ROOF TOP	1,100	1"	-	460/3	-	0.55	3/4	67	LOREN COOK	16CVR-S	1, 2		
PUMP ROOM EXHAUST FAN	TUBULAR CENTRIFUGAL ROOF TOP	1,200	1"	-	460/3	-	0.55	3/4	67	LOREN COOK	16CVR	1, 2		
WET WELL SUPPLY FAN	TUBULAR CENTRIFUGAL ROOF TOP	600	0.5"	-	460/3	-	0.15	1/4	56	LOREN COOK	16CVR-S	1, 2		
WET WELL EXHAUST FAN	TUBULAR CENTRIFUGAL ROOF TOP	660	0.5"	-	460/3	-	0.14	1/4	56	LOREN COOK	16CVR	1, 2		

1. FANS TO BE PROVIDED WITH FACTORY OR FIELD DISCONNECT SWITCHES WITH LOCK OUT TAG OUT FEATURE. LOCK TO BE SUPPLIED BY CONTRACTOR.
2. FANS SHALL BE SPARK B RESISTANT CONSTRUCTION.

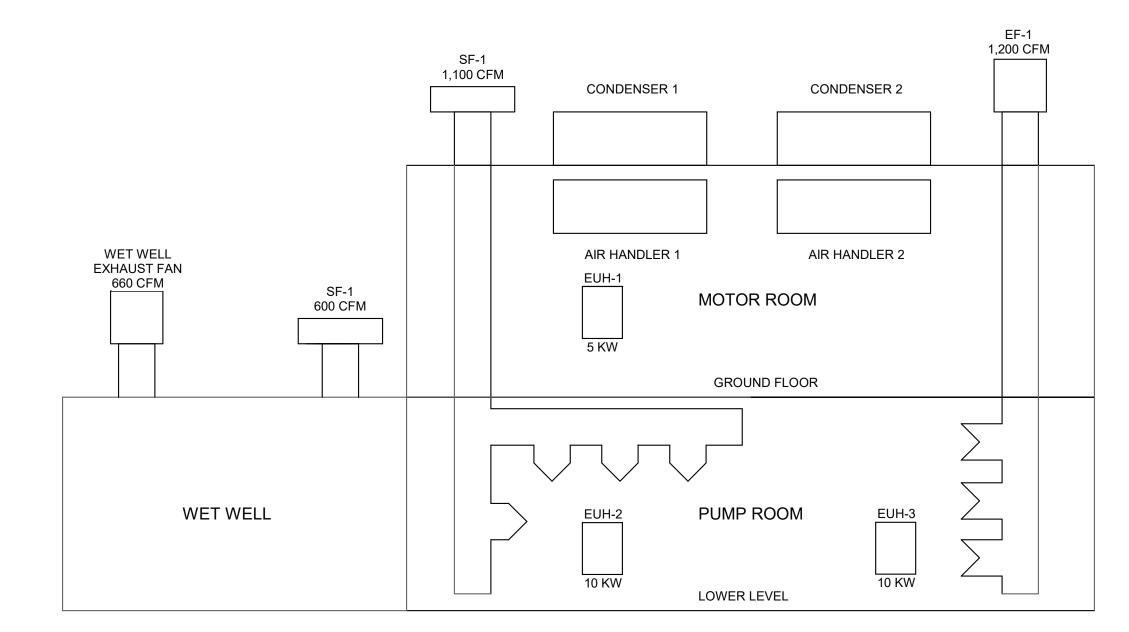







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								(CONTRACT:# RFB-RC-SWR-2022-06
PROJECT TITLE: UNION HILL AND TALLMAN AVE		DR	AWINGS I	SSUED FOR / REVISIONS					EDR JOB #:21213
		NO.	DATE	ISSUED FOR / REVISIONS	В	Υ	СНК	APP	DATE: 06/2023
PUMP STATION UPGRADE		1	04/22	60 PERCENT DESIGN REVIEW	M	JL .	JGD	GRL	SCALE: As indicated
PROJECT LOCATION: ROCKLAND COUNTY, NEW YORK		2	07/22	90 PERCENT DESIGN REVIEW	M	JL .	JGD	GRL	DRAWN BY: J. ROSS
CLIENT: ROCKLAND COUNTY SEWER DISTRICT No. 1		3	09/22	FOR REGULATORY REVIEW	M	JL .	JGD	GRL	CHECKED BY: G. LYNCH
DRAWING TITLE: TALLMAN PUMP STATION AIR FLOW DIAGRAMS, SCHEDULES	CONTRACT	4	01/23	100 PERCENT DESIGN REVIEW	M	JL .	JGD	GRL	DRAWING NUMBER:
		5	03/23	100 PERCENT DESIGN REVIEW	M	JL .	JGD	GRL	H-201
		6	06/23	FOR BID	M	JL .	JGD	GRL	11-201



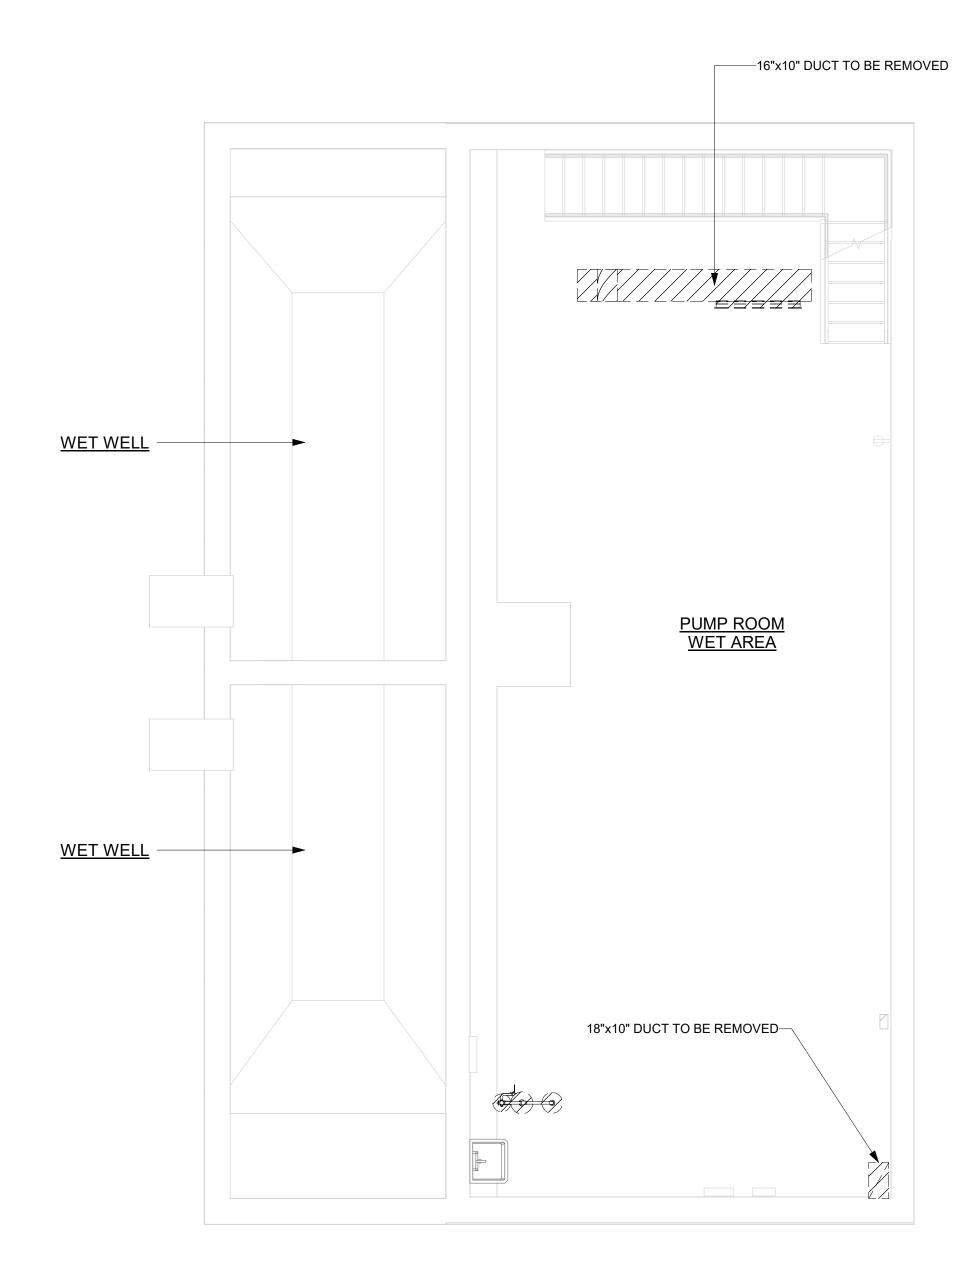

1) HVAC LOWER LEVEL PLAN DEMOLITION 1/4" = 1'-0"

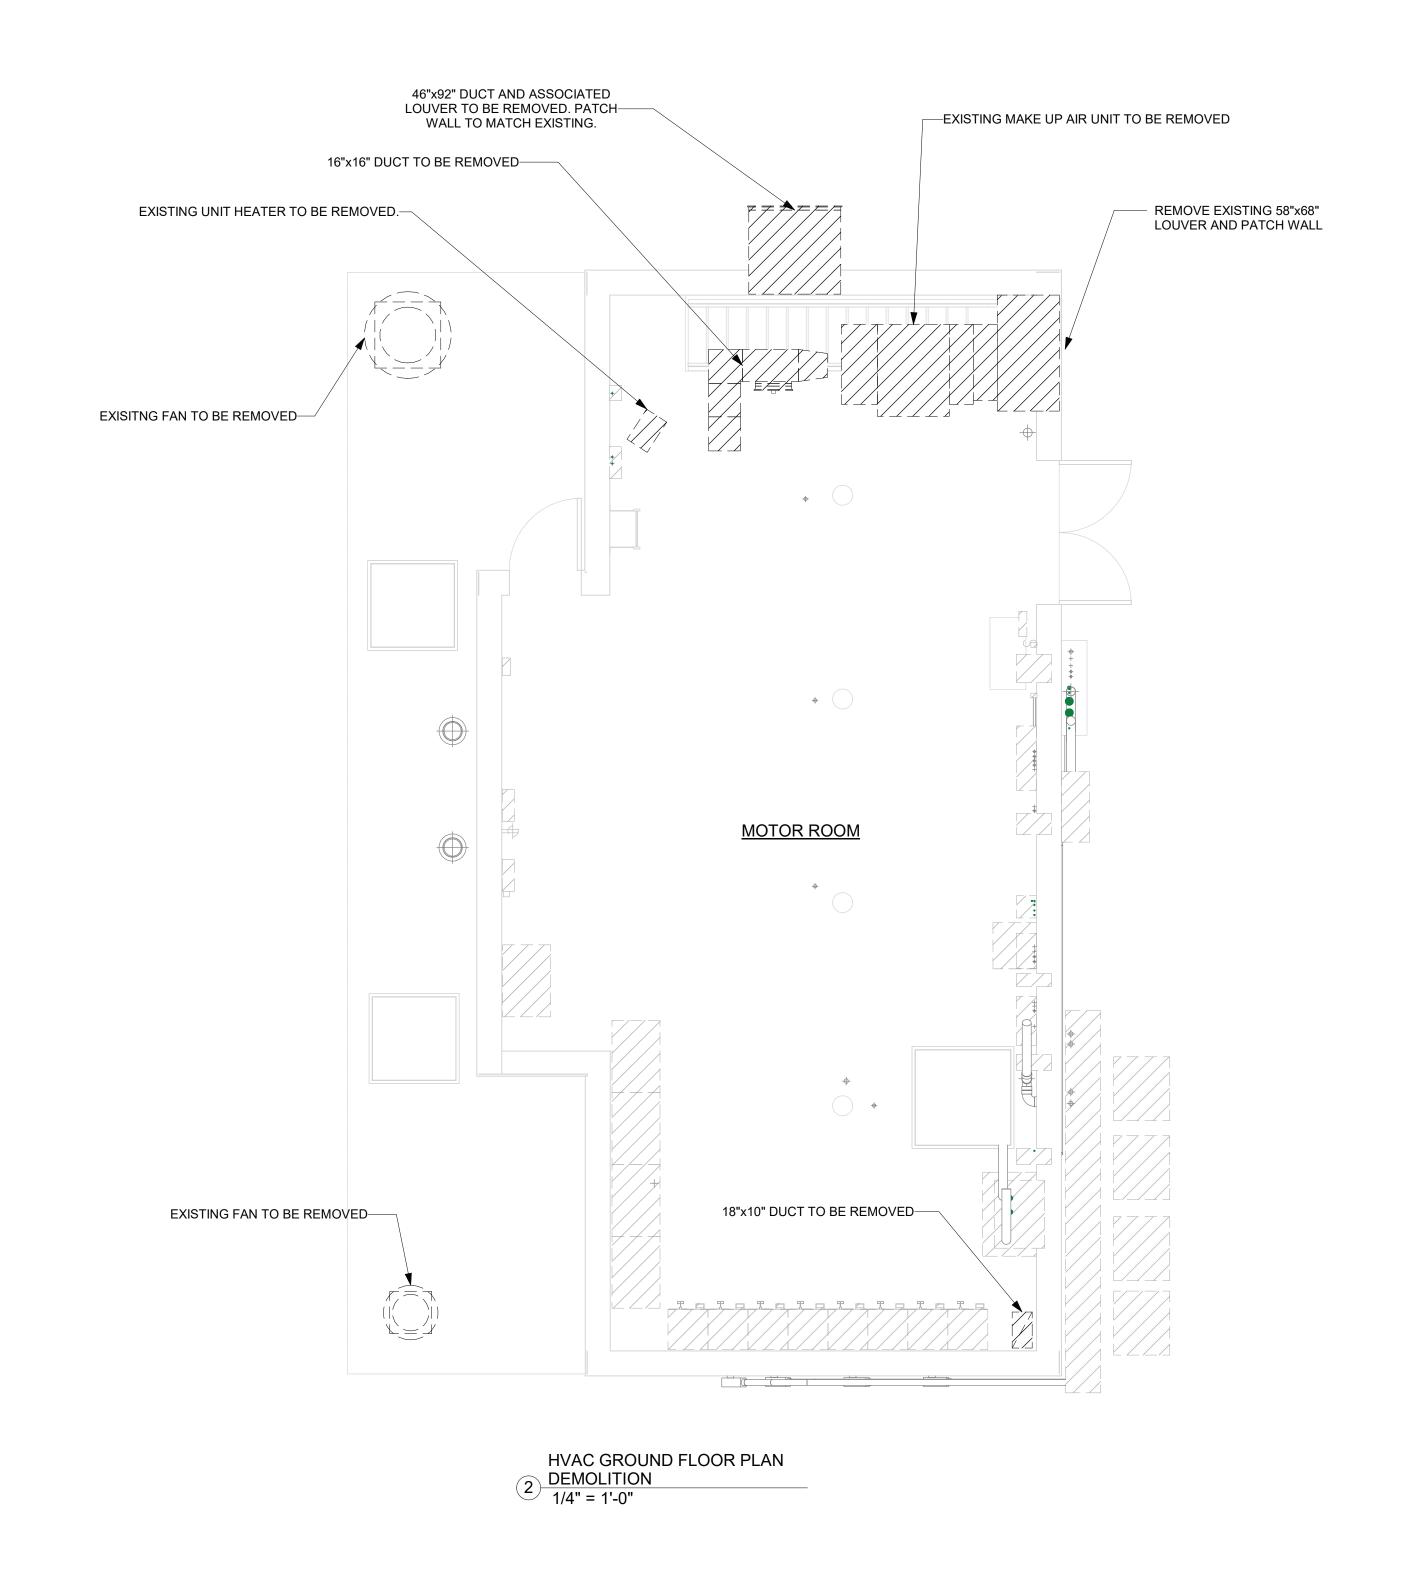









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		NO. DATE	ISSUED FOR / REVISIONS	BY CHK APP	DATE: 06/2023
PUMP STATION UPGRADE		1 04/22	60 PERCENT DESIGN REVIEW	MJL JGD GRL	SCALE: 1/4" = 1'-0"
PROJECT LOCATION: ROCKLAND COUNTY, NEW YORK		2 07/22	90 PERCENT DESIGN REVIEW	MJL JGD GRL	DRAWN BY: J. ROSS
CLIENT: ROCKLAND COUNTY SEWER DISTRICT No. 1		3 09/22	FOR REGULATORY REVIEW	MJL JGD GRL	CHECKED BY: G. LYNCH
DRAWING TITLE: TALLMAN PUMP STATION DEMOLITION LOWER AND GROUND FLOOR PLANS	CONTRACT	4 01/23	100 PERCENT DESIGN REVIEW	MJL JGD GRL	DRAWING NUMBER:
		5 03/23	100 PERCENT DESIGN REVIEW	MJL JGD GRL	H-202
		6 06/23	FOR BID	MJL JGD GRL	11-202

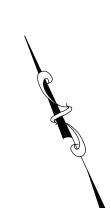

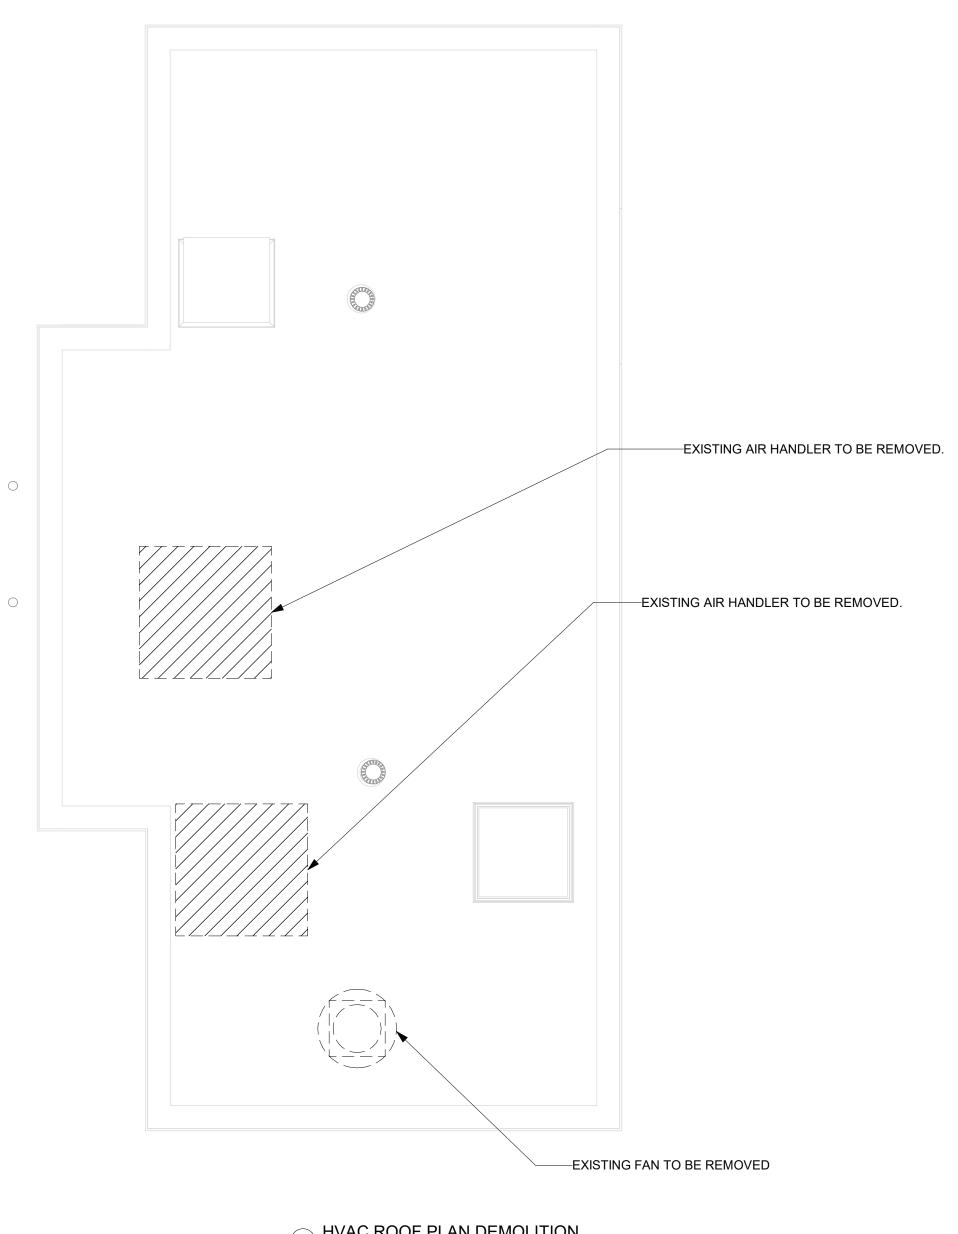











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PUMP STATION UPGRADE	1 04/22 60 PERCENT DESIGN REV	IEW MJL JGD GRL SCALE: 1/4" = 1'-0"
PROJECT LOCATION: ROCKLAND COUNTY, NEW YORK	2 07/22 90 PERCENT DESIGN REV	IEW MJL JGD GRL DRAWN BY: J. ROSS
CLIENT: ROCKLAND COUNTY SEWER DISTRICT No. 1	3 09/22 FOR REGULATORY REVIE	W MJL JGD GRL CHECKED BY: G. LYNCH
DRAWING TITLE: TALLMAN PUMP STATION DEMOLITION ROOF PLAN	CONTRACT 4 01/23 100 PERCENT DESIGN RE	VIEW MJL JGD GRL DRAWING NUMBER:
	5 03/23 100 PERCENT DESIGN RE	VIEW MJL JGD GRL H-203
	6 06/23 FOR BID	MJL JGD GRL



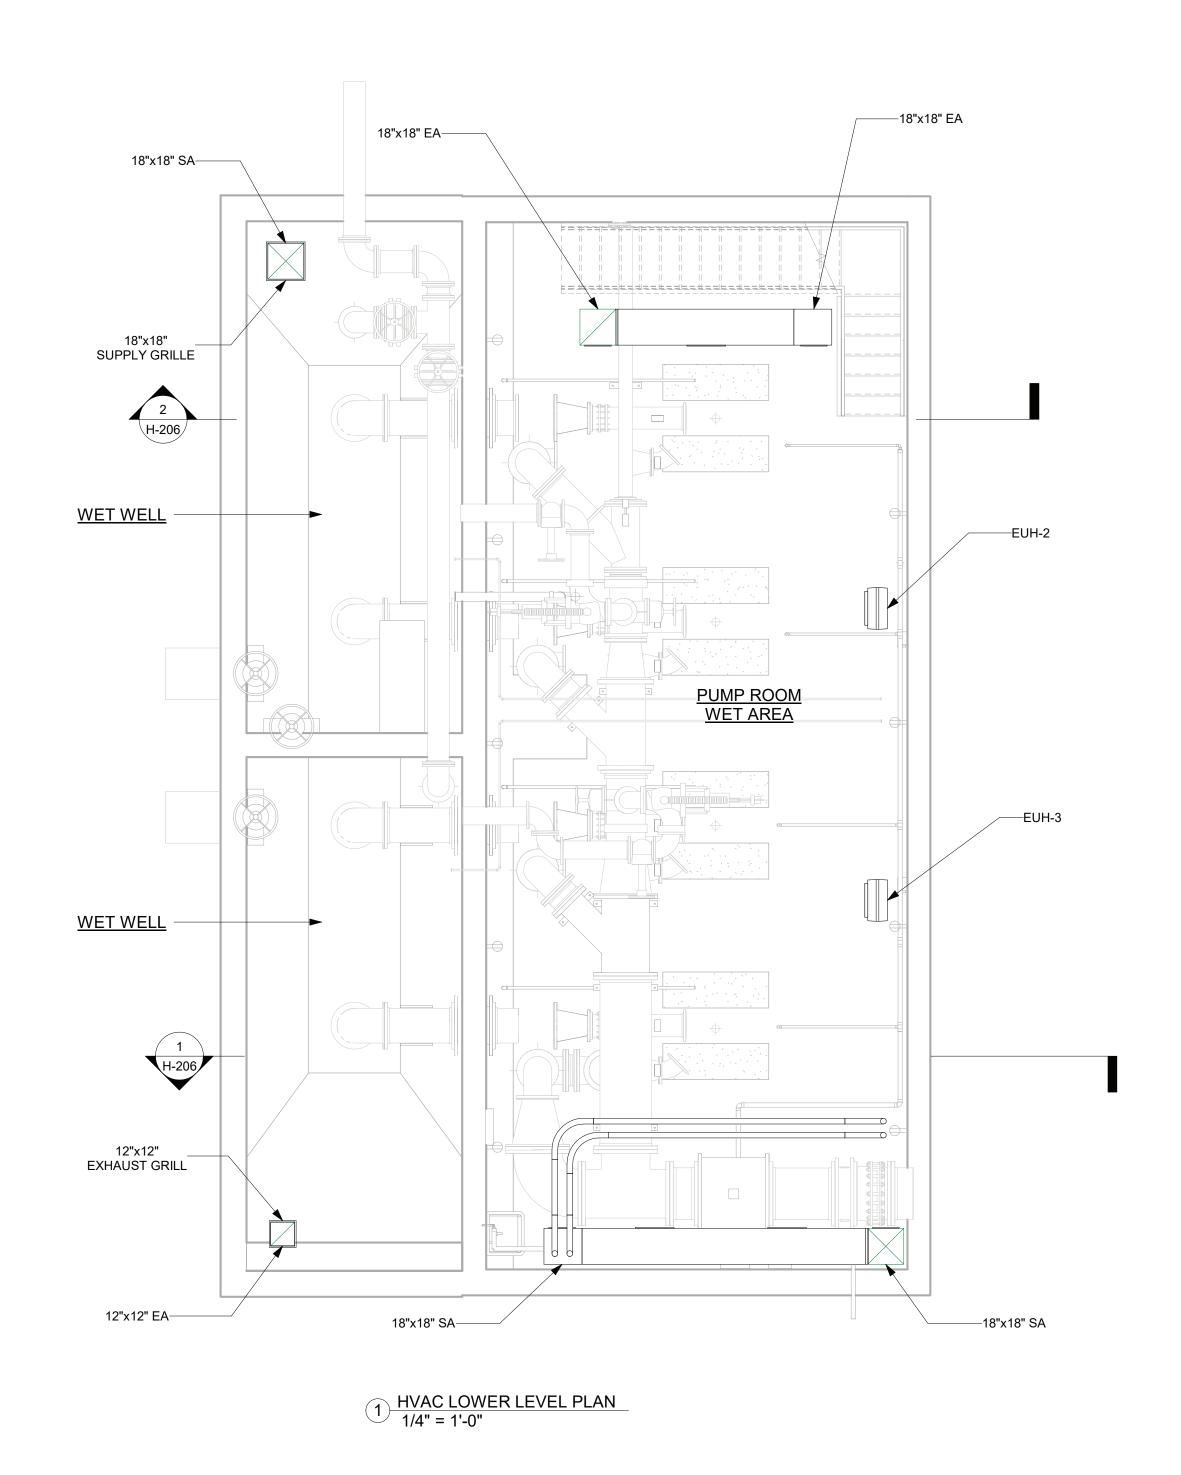

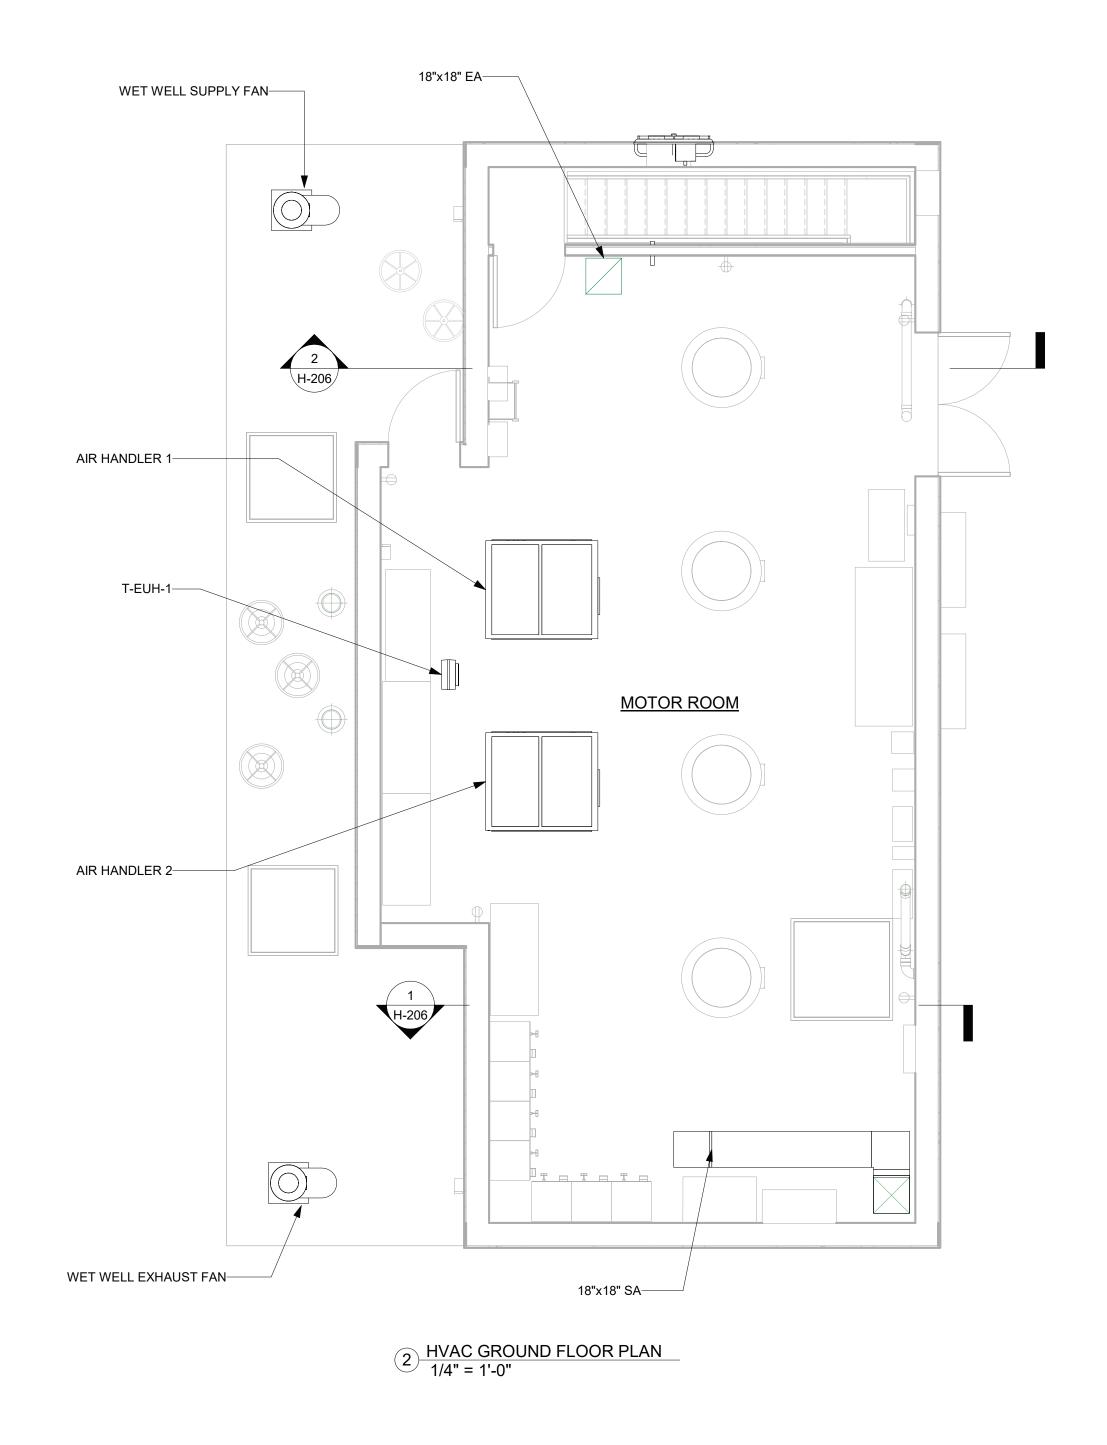








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PUMP STATION UPGRADE		1	04/22	60 PERCENT DESIGN REVIEW	MJL JGD GF	SCALE: 1/4" = 1'-0"
PROJECT LOCATION: ROCKLAND COUNTY, NEW YORK		2	07/22	90 PERCENT DESIGN REVIEW	MJL JGD GF	RL DRAWN BY: J. ROSS
CLIENT: ROCKLAND COUNTY SEWER DISTRICT No. 1		3	09/22	FOR REGULATORY REVIEW	MJL JGD GF	CHECKED BY: G. LYNCH
DRAWING TITLE: TALLMAN PUMP STATION LOWER AND GROUND FLOOR PLANS	CONTRACT	Г 4	01/23	100 PERCENT DESIGN REVIEW	MJL JGD GF	DRAWING NUMBER:
		5	03/23	100 PERCENT DESIGN REVIEW	MJL JGD GF	H-204
		6	06/23	FOR BID	MJL JGD GF	



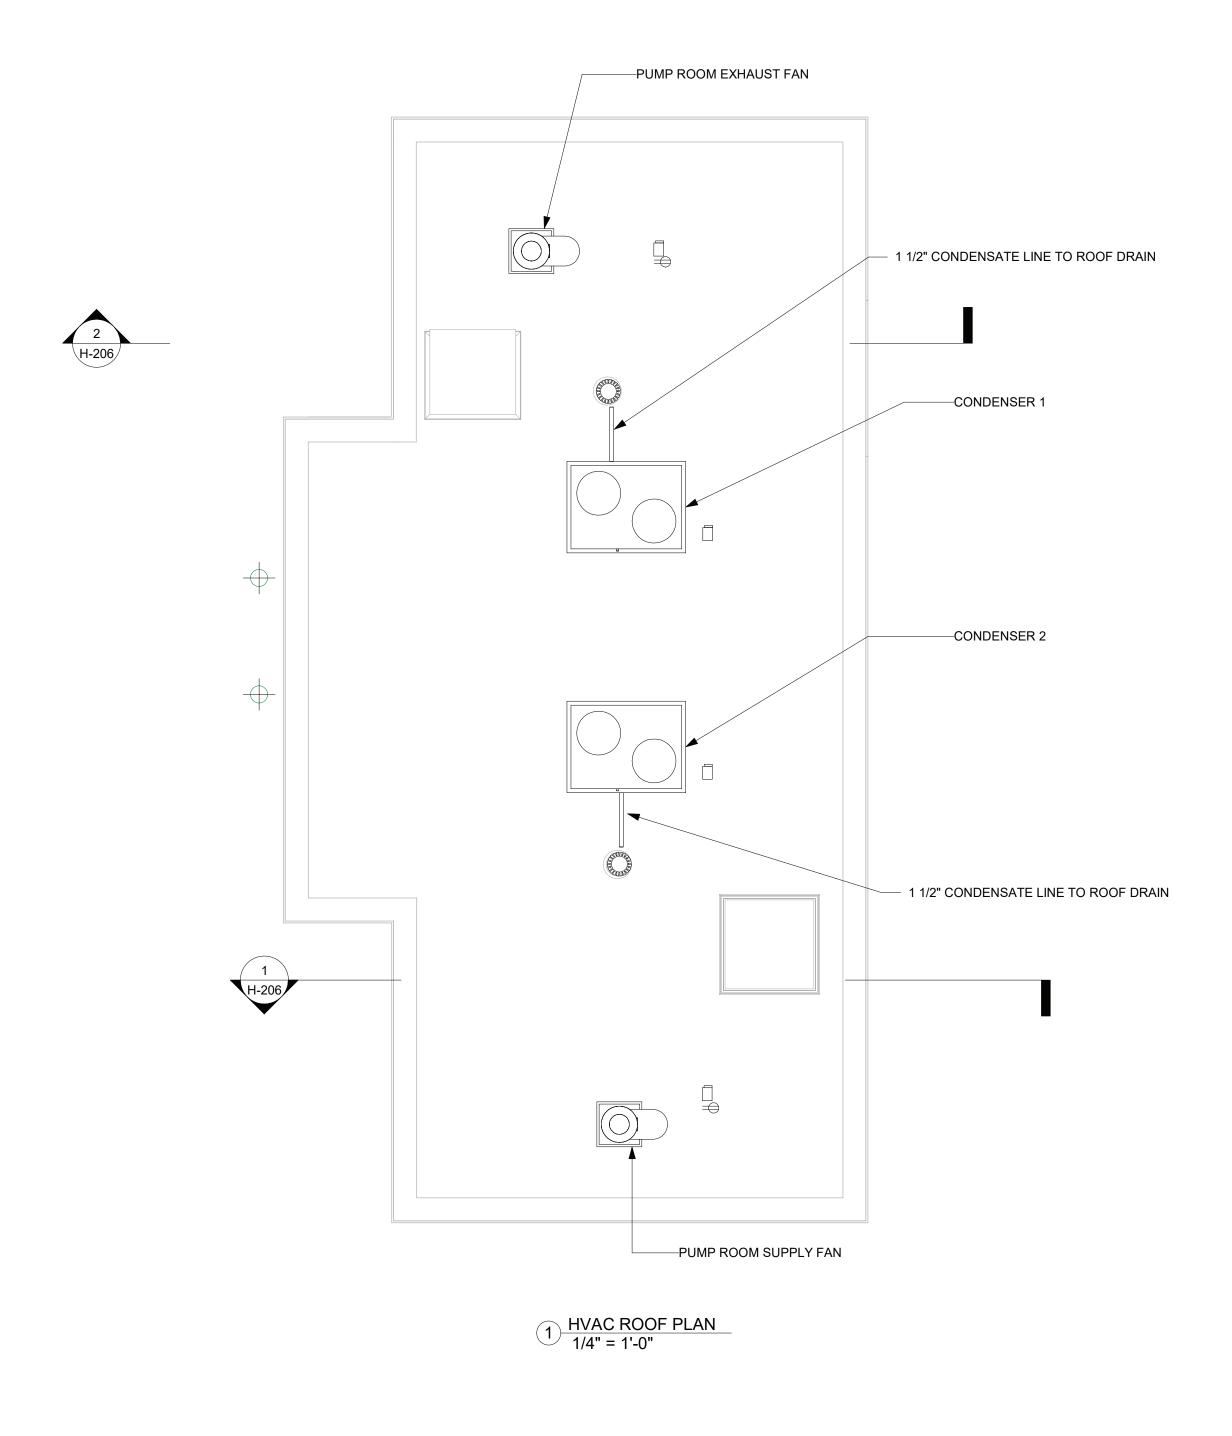









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CLIENT: ROCKLAND COUNTY SEWER DISTRICT No. 1	3	09/22	FOR REGULATORY REVIEW MJL JGD GRL	CHECKED BY: G. LYNCH
DRAWING TITLE: TALLMAN PUMP STATION ROOF PLAN	4	01/23	100 PERCENT DESIGN REVIEW MJL JGD GRL	DRAWING NUMBER:
	5	03/23	100 PERCENT DESIGN REVIEW MJL JGD GRL	H-205
	6	06/23	FOR BID MJL JGD GRL	

NOTE:
1. SCADA WILL BE INTEGRATED INTO STATION CONTROL PANEL

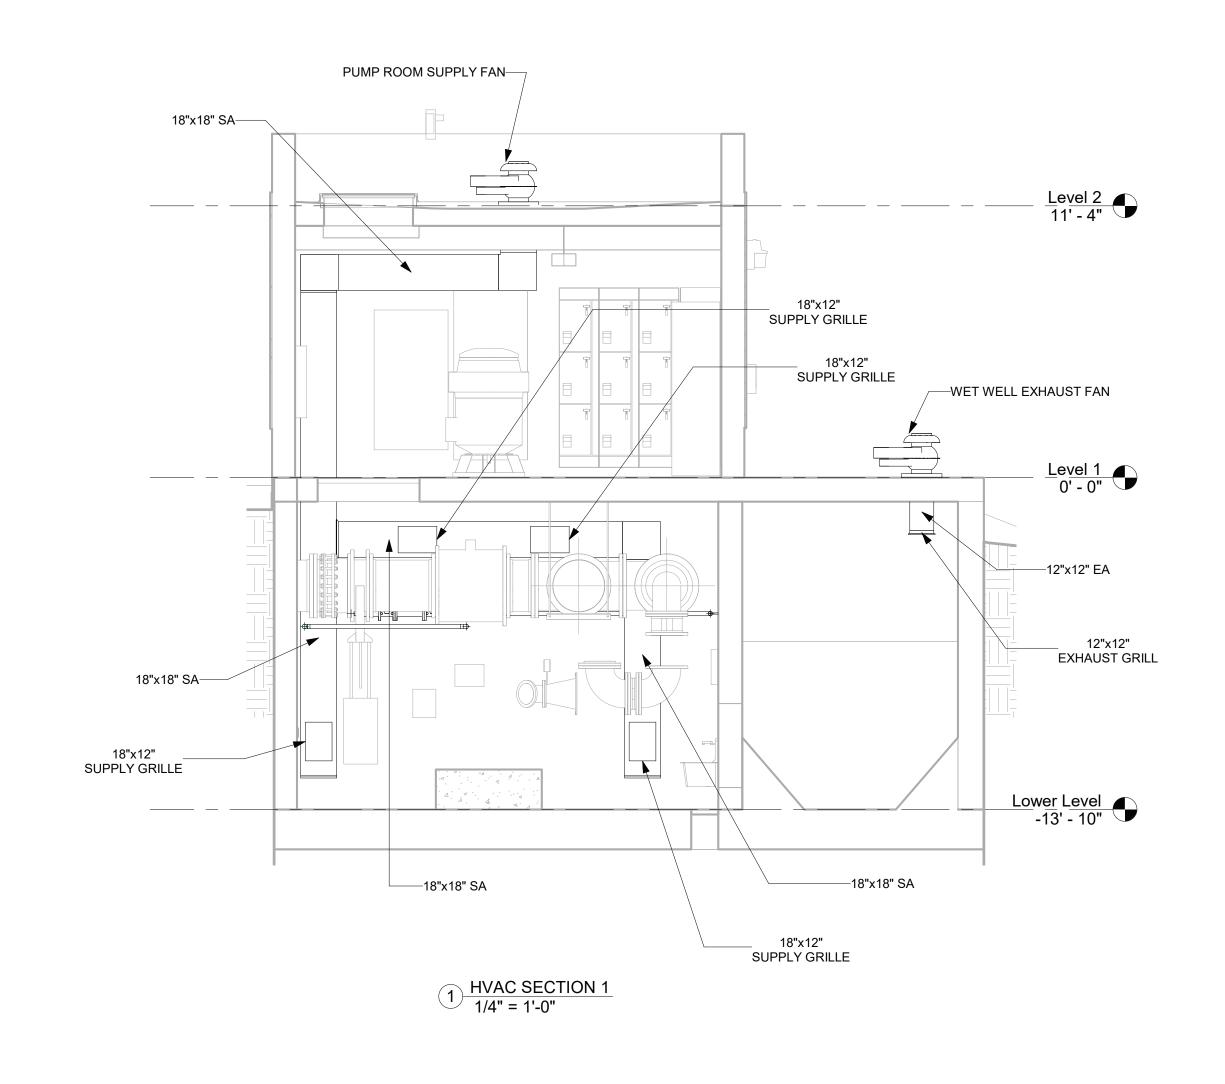

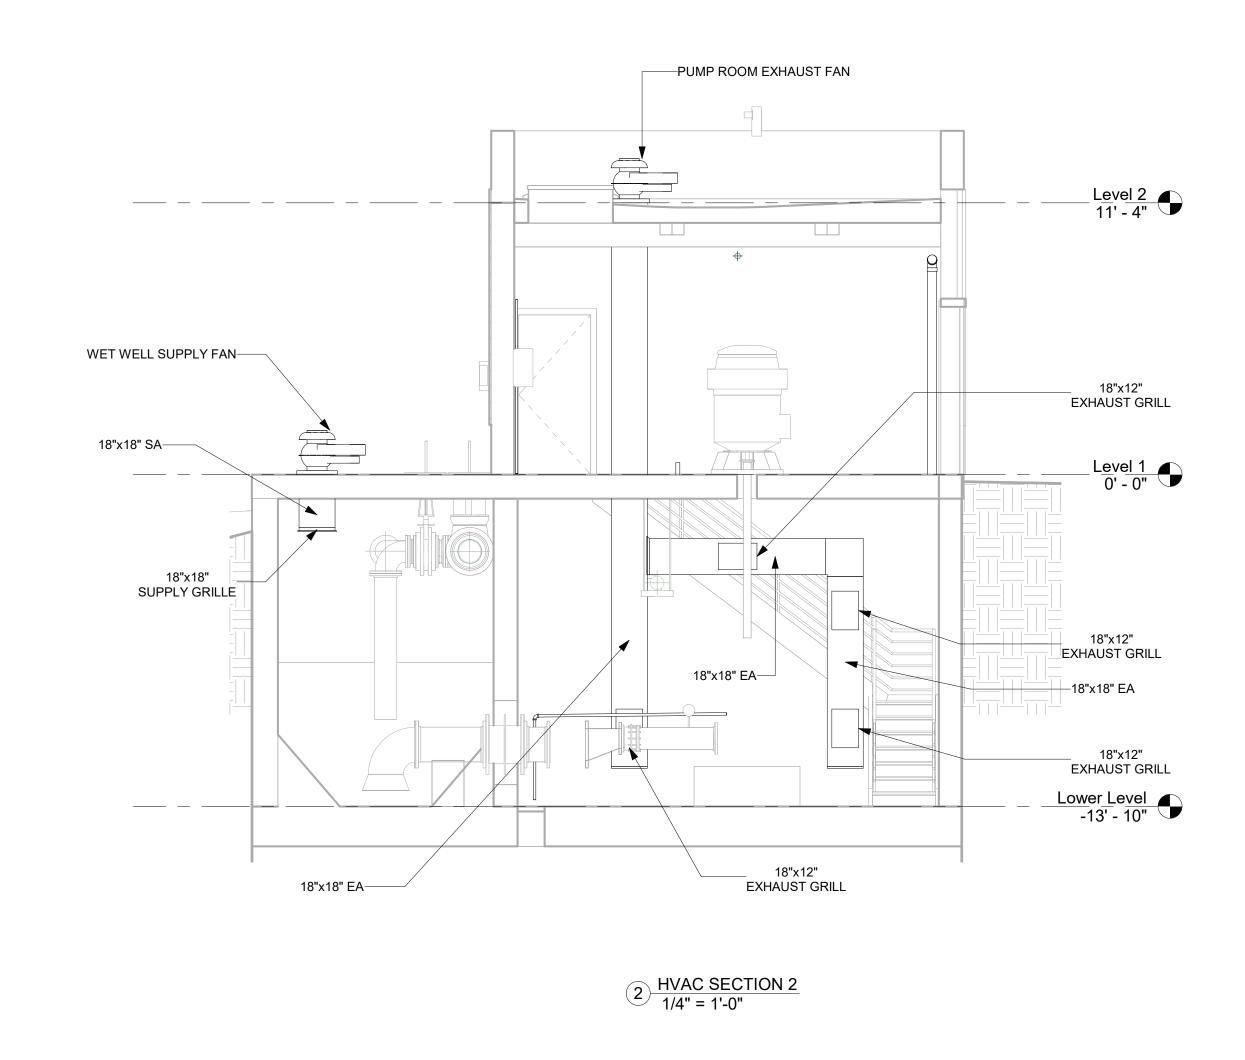

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CLIENT: ROCKLAND COUNTY SEWER DISTRICT No. 1		09/22	FOR REGULATORY REVIEW	MJL JGD GRL	CHECKED BY: G. LYNCH
DRAWING TITLE: TALLMAN PUMP STATION SECTIONS	CONTRACT 4	4 01/23	100 PERCENT DESIGN REVIEW	MJL JGD GRL	DRAWING NUMBER:
		5 03/23	100 PERCENT DESIGN REVIEW	MJL JGD GRL	H-206
	(6 06/23	FOR BID	MJL JGD GRL	