# INTERIOR RENOVATIONS OF THE COMMONS APARTMENTS 10.1 (ADA COMPLIANT) & 10.3

PROJECT # SU-040623

# SUNY PURCHASE COLLEGE

735 ANDERSON HILL ROAD PURCHASE NY 10577



19 West 21st Street New York, NY 10010

Tel: (212) 243-0725 Fax: (212) 243-0725


510 Broadhollow Road Melville, NY 11747 Tel: (631) 465-0786 Fax: (631) 465-0788



LONG ISLAND | NEW YORK CITY | CHARLOTTE | DANBURY

200 Old Country Road | Suite 670 Mineola | NY 11501 516 484 1020 Lizardos.com

Lizardos Engineering Associates D.P.C.

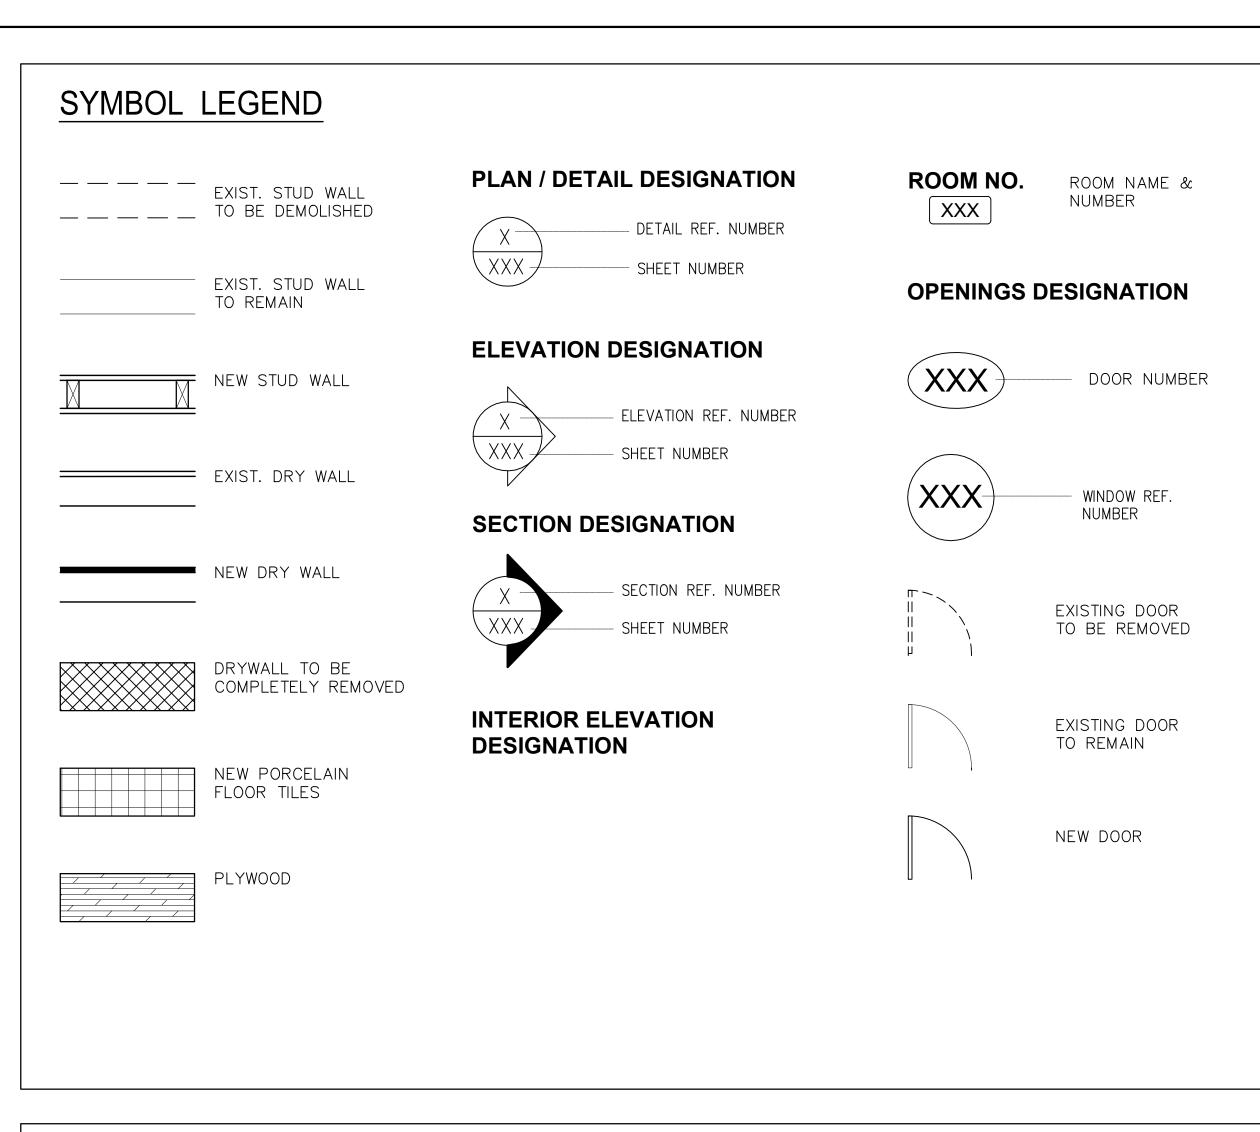

#### **ABBREVIATIONS** ABOVE EXTERIOR WIRE EIC TBD ACCESS DOOR ENGINEER IN CHARGE MATERIAL TO BE DECIDED MAX. ADJACENT EXPANSION JOINT MAXIMUM THICKNESS ALUMINUM ELEVATION MECH. MECHANICAL T.O.S. - TOP OF SLAB ALUM.A. ARCHITECT OF RECORD EMG. EXPANDED METAL MANHOLE TYP. TYPICAL M.H. MIN. MINIMUM TERRA COTTA APP'D. APPROVED GUARD EXISTING LEADER M.I.S. METAL INSECT SCREEN AAPR.B. APPROXIMATELY ENT. – ENTRANCE MT'D MOUNTED ARCH. ARCHITECT EOR ENGINEER OF RECORD ASPH. ASPHALT M.O. MASONRY OPENING EQ. VENT. VENTILATOR AUX. AUXILIARY EQUAL M.S. - MINERAL SURFACED VERT. EQUIPMENT VERTICAL AND VERIFY IN FIELD EXP. EXPANSION V.I.F. ANGLE EXIST. EXISTING VENT — AT EXT. EXTERIOR VERTICAL CRACK NOMINAL DIAMETER N.D. ELECTRICAL CONDUIT NEC. NECESSARY N.I.C. NOT IN BR BRICK CONTRACT B.0. BASE OF NO. NUMBER WITH FACE BRICK N.T.S. BRICK COURSE NOT TO SCALE W.F. WIDE FLANGE FD FLOOR DRAIN BUILDING LINE W.H. WEEP HOLE FIN. FINISH BLDG. BUILDING WROUGHT IRON BLOCK FLOOR WIRE MESH BLK W.M. FRESH AIR INTAKE BEAM ON CENTER WATERPROOFING F.P. FIREPROOFING B.S. 0.D. OUTSIDE DIAMETER WT. WEIGHT BLUE STONE FR. FRAME B.S.&A. BOARD OF STANDARDS OBSCURE GLAZING AND APPEAL BUILT—UP ROOF GAUGE PAVEMENT PAV. GALVANIZED P&D PLUMBING AND GLASS BLOCK WINDOW CASEMENT DRAINAGE G.C. GENERAL CONTRACTOR PLASTER CAB'T CABINET G.I. GALVANIZED IRON CENTER LINE - GLASS CONTROL JOINT GRNT. GRANITE CL'G CEILING RADIUS COL. COLUMN RAILING CONT. CONTINUOUS RADIATOR CONC. CONCRETE HORIZONTAL CRACK R.D. ROOF DRAIN C.R. CLASSROOM HANDICAPPED REF. REFERENCE CU.YD. CUBIC YARD HGT. HEIGHT REINF. REINFORCEMENT H.M. HOLLOW METAL RET. RETAINING HORIZ. HORIZONTAL RM. - ROOM DEPARTMENT DET. DETAIL D.H. DOUBLE HUNG INT. INTERIOR S.S. STAINLESS STEEL DIA. DIAMETER INSTRUCTOR SPEC. SPECIFICATION DIM. DIMENSION INSUL. – INSULATION S.F. SQUARE FEET DN. DOWN STD. STANDARD DITTO DO. DOOR ST. PL. STEEL PLATE DR. STANDARD DETAIL DWG. DRAWING L.S. LIMESTONE SQUARE YARD D.C. S.Y. DIAGONAL CRACK LIGHT SFT STRUCTURAL FACING LINEAR FOOT TILE

### **GENERAL NOTES**

- 1. ALL WORK OF THIS CONTRACT SHALL BE DONE IN ACCORDANCE WITH THE LATEST EDITION OF NEW YORK STATE BUILDING CODE, AND REGULATIONS OF OTHER AGENCIES HAVING JURISDICTION ON THE WORK OF THIS CONTRACT.
- 2. WHERE DIMENSIONS ARE INDICATED, DIMENSIONS GOVERN OVER SCALE. ALL DIMENSIONS AND CONDITIONS SHOWN AND ASSUMED ON THE DRAWINGS MUST BE VERIFIED AT THE SITE BY THE CONTRACTOR PRIOR TO ORDERING ANY MATERIAL OR COMMENCING ANY WORK. ANY DISCREPANCIES IN THE DRAWINGS AND SPECIFICATIONS SHALL BE REPORTED TO THE EIC. NO CHANGE IN DRAWINGS OR SPECIFICATIONS IS ACCEPTED WITHOUT THE WRITTEN CONSENT OF THE ARCHITECT/ENGINEER. NO WORK SHALL PROCEED UNTIL SUCH DISCREPANCY HAS BEEN RECTIFIED.
- 3. ALL WORK ON THESE DRAWINGS SHALL BE CONSIDERED NEW WORK WHETHER STATED OR NOT EXCEPT WHERE SPECIFICALLY NOTED AS "EXISTING TO REMAIN".
- 4. COORDINATION OF ALL WORK UNDER THIS CONTRACT SHALL BE MAINTAINED TO ENSURE THE QUALITY AND TIMELY COMPLETION OF THE WORK/PROJECT.
- 5. THE CONTRACTOR SHALL DISCONNECT AND/OR REMOVE ANY EXISTING PLUMBING, ELECTRICAL FIXTURES, WIRE CONDUITS. OR OTHER WORK WHICH MIGHT INTERFERE WITH THE WORK OF THIS CONTRACT. AFTER NEW WORK IS COMPLETED, THE DISCONNECTED OR REMOVED ITEMS SHALL BE REINSTALLED BY THE CONTRACTOR AT THE SAME LOCATION OR AT NEW LOCATION AS DIRECTED. FURNISH ALL NECESSARY NEW MATERIALS/HARDWARE FOR COMPLETION OF WORK.
- 6. THE CONTRACTOR SHALL PATCH AND REPAIR ALL DAMAGED OR EXPOSED SURFACES DUE TO CONTRACT WORK. ALL NEWLY INSTALLED, PATCHED WORK AND ALL AFFECTED AREAS SHALL BE PAINTED. ALL PAINTING WORK SHALL BE PERFORMED TO COVER THE ENTIRE HORIZONTAL OR VERTICAL SURFACE TO THE CLOSEST CORNER IN ALL FOUR DIRECTIONS. COLOR TO MATCH EXISTING CONDITIONS.
- 7. THE CONTRACTOR SHALL FURNISH AND INSTALL NEW MATERIALS AT NO ADDITIONAL COST TO SUNY PURCHASE, ON THE FOLLOWING CONDITIONS:

a) ANY EXISTING WORK THAT HAS BEEN REMOVED OR DAMAGED IN ORDER TO PERFORM THE CONTRACT WORK.

b) TO FURNISH THE WORK OF THIS CONTRACT IN WORKMANLIKE MANNER.

8. THE CONTRACTOR SHALL BE RESPONSIBLE FOR ADEQUATELY BRACING AND PROTECTING ALL WORK DURING CONSTRUCTION AGAINST DAMAGE, BREAKAGE, COLLAPSE, DISTORTIONS AND OFF ALIGNMENTS ACCORDING

TO CODES AND STANDARDS OF GOOD PRACTICE.

- 9. THE CONTRACTOR SHALL INCLUDE ALL PREPARATORY AND ASSOCIATED SUPPLEMENTARY WORK TO PROVIDE A COMPLETE AND FINISHED INSTALLATION.
- 10. WHERE MANUFACTURER'S NAMES AND PRODUCT NUMBERS ARE INDICATED ON DRAWINGS, IT SHALL BE CONSTRUED TO MEAN THE ESTABLISHMENT OF QUALITY AND PERFORMANCE STANDARDS OF SUCH ITEMS. ALL OTHER PRODUCTS MUST BE SUBMITTED TO THE ARCHITECT FOR APPROVAL BEFORE THEY SHALL BE DEEMED EQUAL.
- 11. SIZE OF MASONRY UNITS AND WOOD MEMBERS ON PLANS, BUILDING ELEVATIONS AND SECTIONS ARE SHOWN AS NOMINAL SIZE.
- 13. PROVIDE GUARDS, RAILS, BARRICADES, FENCES, SIDEWALK SHEDS, CATCH PLATFORMS, DECKING, NIGHT LIGHTING, ETC., AS REQUIRED BY THE NEW YORK STATE BUILDING CODE, SECTION 3302 AND 3306 AS REQUIRED TO PROVIDE ADEQUATE PROTECTION.
- 14. THE CONTRACTOR SHALL KEEP WORK SITE FREE FROM DEBRIS AND ACCUMULATED REFUSE, AND SHALL HAVE SOLE RESPONSIBILITY FOR PROTECTING ALL DANGEROUS AREAS FROM ENTRY BY UNAUTHORIZED PARTIES. SITE SHALL BE LEFT BROOM CLEAN AT THE END OF EACH WORKING DAY.
- 15. THE CONTRACTOR SHALL MAINTAIN FREE AND UNOBSTRUCTED ACCESS FROM ALL ADJACENT SPACES INTO THE EXISTING FIRE STAIRS TO OUTSIDE OF THE BUILDING AT ALL TIMES.
- 16. THE CONTRACTOR SHALL, UNLESS OTHERWISE PROVIDED IN THE CONTRACT DOCUMENTS, SECURE AND PAY FOR REQUIRED INSPECTIONS, PERMIT(S), FEES, LICENSE AND INSPECTIONS NECESSARY FOR THE PROPER EXECUTION OF THE WORK.
- 18. THE CONTRACTOR SHALL EXAMINE AND VERIFY IN THE FIELD ALL EXISTING AND GIVEN CONDITIONS AND DIMENSIONS WITH THOSE SHOWN ON THE CONTRACT DOCUMENTS. IF THE FIELD CONDITIONS AND DIMENSIONS DIFFER FROM THOSE SHOWN ON THE CONTRACT DOCUMENTS, THE CONTRACTOR SHALL NOTIFY THE ENGINEER. ALL FIELD CONDITIONS AND DIMENSIONS SHALL BE SO NOTED ON THE DRAWINGS AND SUBMITTED FOR APPROVAL.

- 19. THE CONTRACTOR'S ATTENTION IS DIRECTED TO THE FACT THAT, DUE TO THE NATURE OF THIS PROJECT, THE EXACT EXTENT OF WORK CAN NOT ALWAYS BE ACCURATELY DETERMINED PRIOR TO THE COMMENCEMENT OF THE WORK. THE CONTRACT DOCUMENTS HAVE BEEN PREPARED BASED ON FIELD INSPECTION AND OTHER INFORMATION AVAILABLE AT THE TIME. ACTUAL FIELD CONDITIONS MAY REQUIRE MODIFICATIONS TO THE CONSTRUCTION DETAILS AND WORK QUANTITIES. THE CONTRACTOR SHALL PERFORM THE WORK IN ACCORDANCE WITH THE FIELD CONDITIONS AND AS ORDERED BY THE ENGINEER.
- 20. ALL BIDDERS SHALL INSPECT THE PROJECT SITE PRIOR TO SUBMITTING BIDS TO VERIFY THE FIELD CONDITIONS WHICH MAY BE ENCOUNTERED AND THE NATURE OF THE WORK TO BE DONE UNDER THIS CONTRACT. NO COMPENSATION WILL BE ALLOWED TO THE BIDDER FOR FAILURE TO INCLUDE ALL LABOR, MATERIALS AND EQUIPMENT COSTS NECESSARY TO COMPLETE THE WORK.
- 21. THE CONTRACTOR SHALL PERFORM ALL WORK WITH CARE SO THAT ANY MATERIALS THAT ARE TO REMAIN IN PLACE, OR THAT ARE TO BE REMOVED AND REMAIN THE PROPERTY OF THE COLLEGE, WILL NOT BE DAMAGED. IF THE CONTRACTOR DAMAGES ANY MATERIALS THAT ARE TO REMAIN IN PLACE, OR WHICH ARE TO REMAIN THE PROPERTY OF THE COLLEGE. THE DAMAGED MATERIALS SHALL BE REPAIRED OR REPLACED IN A MANNER SATISFACTORY TO THE PARK MANAGER AT THE EXPENSE OF THE CONTRACTOR.
- 22. THE CONTRACTOR SHALL BE REQUIRED TO PROTECT HIS/HER WORKERS AT ALL TIMES IN CONFORMANCE WITH APPLICABLE OSHA REGULATIONS.
- 23. THE USE OF POWER DEVICES SUCH AS ELECTRIC HAMMERS OR OTHER PNEUMATIC TOOLS WILL NOT BE ALLOWED UNLESS APPROVED BY THE CAMPUS PROJECT REPRESENTATIVE. NO POWER-ACTUATED DEVICES MAY BE USED TO ATTACH STUDS TO EXISTING FLOORS, CEILINGS OR WALLS UNLESS A LIST OF PROPOSED TOOLS IS SUBMITTED AND APPROVED BY THE CAMPUS PROJECT REPRESENTATIVE. POWER-ACTUATED DEVICES MAY NOT BE UTILIZED WITHOUT PRIOR CONSENT FROM THE BOARD, AS PER THE ALTERATION AGREEMENT.
- 24. CONTRACTOR TO PROVIDE FOR PAINT, DUST, DEBRIS AND NOISE CONTAINMENT AS DIRECTED BY THE CAMPUS PROJECT REPRESENTATIVE. ALL VENTS AND EXHAUSTS MUST BE FULLY SEALED TO PREVENT INFILTRATION OF DUST AND DIRT.
- 25. ANY CHANGES TO THE SCOPE OF WORK MUST BE SUBMITTED TO THE CLIENT AND THE ARCHITECT FOR REVIEW AND APPROVAL PRIOR TO THE COMMENCEMENT OF THAT WORK.
- 26. CONTRACTOR SHALL SCHEDULE AND SEQUENCE WORK SO AS NOT TO INTERFERE WITH OTHER ONGOING OR SCHEDULED WORK, OR WITH ACTIVITIES OF THE OWNER. COORDINATE WITH OWNER'S REPRESENTATIVE.
- 27. CONSTRUCTION WORK SHALL NOT IMPACT THE ADJOINING OCCUPIED APARTMENTS.
- 28. DO NOT SCALE DRAWINGS. DETAILS, NOTES, AND THE LIKE ARE TYPICAL AND APPLY IN GENERAL TO SIMILAR CONDITIONS.

### SUMMARY OF WORK

THE WORK SHALL BE AS SHOWN AND CALLED FOR IN THE CONTRACT DOCUMENTS AND SHALL INCLUDE, BUT NOT BE LIMITED TO, THE FOLLOWING GENERAL ITEMS OF WORK:

PARTIAL REMOVAL OF EXISTING STUD WALLS, DROPPED CEILING, FLOORING, PARTIAL MECHANICAL AND PLUMBING WORKS.

INSTALLATION OF NEW MECHANICAL AND ELECTRICAL WORK.

INSTALLATION OF NEW INTERIOR STUD WALLS, NEW BATHROOM FINISHES AND FIXTURES, NEW FLOORS, NEW DROPPED CEILING AND NEW GYPSUM CEILINGS, NEW DOORS. INSTALLATION AND CONNECTION OF NEW PLUMBING,

2 04/06/2023 100% SUBMISSION

1 09/24/2022 80% SUBMISSION

No. Date Revision

### AFRIDI ASSOCIATES

**CONSULTING ENGINEERS** 510 Broadhollow Road 19 West 21st Street

Melville, NY 11747 New York, NY 10010 Tel: (212) 243-0725 Tel: (631) 465-0786 Fax: (212) 243-0725 Fax: (631) 465-0788 aafridi@afridiassociates.com

LONG ISLAND | NEW YORK CITY | CHARLOTTE | DANBURY

200 Old Country Road | Suite 670 Mineola | NY 11501 516 484 1020 Lizardos.com

Lizardos Engineering Associates D.P.C.

AKBER AFRIDI, P.E. Designer: AZHER MALIK Drawn by: Checked by: AKBER AFRIDI, P.E.

INTERIOR RENOVATIONS OF THE COMMONS APARTMENTS 10.1 (ADA COMPLIANT) & 10.3

735 Anderson Hill Road Purchase NY 10577

Drawing Title: GENERAL NOTES, SUMMARY OF WORKS, & MISCELLANOUS INFO.

> Drawing No.: T002.00

Scale: AS NOTED

SU-040623

Date:

08/24/2020

DRAWIN	IG LIST
SHEET NO.	SHEET TITLE
COVER & GE	NERAL NOTES
T001.00	COVER SHEET
T002.00	SYMBOL LEGEND, ABBREVIATIONS, GENERAL NOTES, SUMMARY OF WORK
T003.00	LIST OF DRAWINGS
T004.00	ADA CODE COMPLIANCE
FIRE PROTE	CTION DRAWINGS
SP-001.00	SPRINKLER LEGENDS, NOTES, ABBREVIATIONS, SCHEDULE AND DETAILS
SP-101.00	SPRINKLER FIRST FLOOR DEMO AND NEW WORK
SP-201.00	SPRINKLER SPECIFICATIONS
ARCHITECT	JRAL DRAWINGS
A101.00	LOCATION/KEY PLAN (FOR REFERENCE ONLY)
A102.00	ADA APARTMENT 10.1 PARTIAL REMOVALS & PROPOSED PLANS
A103.00	APARTMENT 10.3 PARTIAL REMOVALS & PROPOSED PLANS
A201.00	WALL SECTIONS
A202.00	ENLARGED BATHROOM PLANS, ADA APARTMENT 10.1
A203.00	BATHROOM WALL ELEVATIONS & FINISHES, ADA APARTMENT 10.1
A204.00	ENLARGED BATHROOM PLANS, APARTMENT 10.3
A205.00	BATHROOM WALL ELEVATIONS & FINISHES, APARTMENT 10.3
A206.00	ENLARGED KITCHEN DETTAILS, ADA APARTMENT 10.1
A207.00	MILLWORK DETAILS, ADA APARTMENT 10.1
A208.00	ENLARGED KITCHEN DETAILS, APARTMENT 10.3
A209.00	MILLWORK DETTAILS, APARTMENT 10.3
A210.00	BEDROOM CLOSET DETAILS (TYP.), APARTMENT 10.1 & 10.3
A301.00	FINISHES PLAN (FLOOR & WALL), ADA APARTMENT 10.1
A302.00	FINISHES PLAN (FLOOR & WALL), APARTMENT 10.3
A303.00	FINISHES (CEILING & SOFFIT), ADA APARTMENT 10.1
A304.00	FINISHES (CEILING & SOFFIT), APARTMENT 10.3
A305.00	DOOR DETAILS, (TYPICAL)
A401.00	ELECTRICAL LAYOUT PLAN, ADA APARTMENT 10.1
A402.00	ELECTRICAL LAYOUT PLAN, APARTMENT 10.3
MECHANICA	L DRAWINGS
M-001.00	MECHANICAL LEGENDS, ABBREVIATIONS, NOTES AND SCHEDULE
M-101.00	MECHANICAL FIRST AND SECOND FLOOR NEW WORK
M-301.00	MECHANICAL DETAILS
M-401.00	MECHANICAL SPECIFICATIONS, SHEET 1 OF 2
M-402.00	MECHANICAL SPECIFICATIONS, SHEET 2 OF 2

PLUMBING I	DRAWINGS
P-001.00	PLUMBING LEGENDS, ABBREVIATIONS, NOTES, SCHEDULE AND DETAILS
P-101.00	PLUMBING FIRST FLOOR DEMOLITION AND RISER DIAGRAMS
P-102.00	PLUMBING SECOND FLOOR DEMOLITION AND RISER DIAGRAMS
P-201.00	PLUMBING FIRST FLOOR NEW WORK AND RISER DIAGRAMS
P-202.00	PLUMBING SECOND FLOOR NEW WORK AND RISER DIAGRAMS
P-301.00	PLUMBING DETAILS
P-401.00	PLUMBING SPECIFICATIONS
ELECTRICA	L DRAWINGS
E-001.00	ELECTRICAL LEGEND, ABBREVIATIONS AND NOTES
E-101.00	ELECTRICAL FIRST FLOOR POWER AND LIGHTING - DEMOLITION PLANS
E-102.00	ELECTRICAL SECOND FLOOR POWER, LIGHTING - DEMOLITION PLANS
E-201.00	ELECTRICAL FIRST FLOOR POWER, LIGHTING — NEW WORK PLANS
E-202.00	ELECTRICAL SECOND FLOOR POWER, LIGHTING - NEW WORK PLANS
E-401.00	ELEC. SPECIFICATIONS, SHEET 1 OF 2
E-402.00	ELEC. SPECIFICATIONS, SHEET 2 OF 2
FIRE ALARM	1 DRAWINGS

2 04/06/2023 100% SUBMISSION

1 09/24/2022 80% SUBMISSION

No. Date Revision

# AFRIDI ASSOCIATES CONSULTING ENGINEERS

510 Broadhollow Road 19 West 21st Street

New York, NY 10010 Tel: (212) 243-0725 Fax: (212) 243-0725

Melville, NY 11747 Tel: (631) 465-0786 Fax: (631) 465-0788

aafridi@afridiassociates.com

# **LIZARDOS**

LONG ISLAND | NEW YORK CITY | CHARLOTTE | DANBURY

200 Old Country Road | Suite 670 Mineola | NY 11501 516 484 1020 Lizardos.com

Lizardos Engineering Associates D.P.C.

AKBER AFRIDI, P.E. Designer: Drawn by: AZHER MALIK AKBER AFRIDI, P.E. Checked by:

INTERIOR RENOVATIONS OF THE COMMONS APARTMENTS 10.1 (ADA COMPLIANT) & 10.3


Address: 735 Anderson Hill Road Purchase NY 10577

Drawing Title: LIST OF DRAWINGS

> Drawing No.: T003.00


Scale: AS NOTED

SU-040623

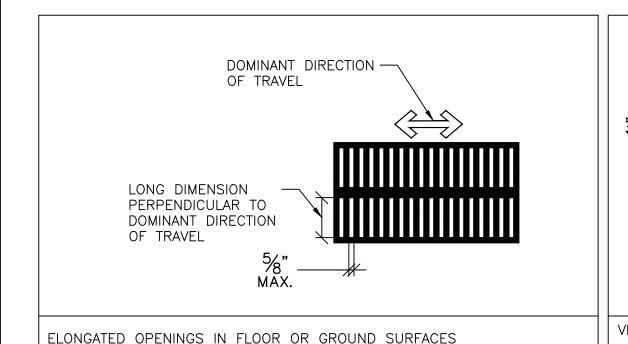

ELONGATED OPENINGS IN FLOOR OR GROUND SURFACES

302.3 2010 ADAAG FIG. 302.3 2009 ICC A117.1 FIG.

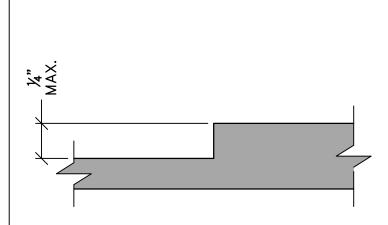

VERTICAL CHANGES IN LEVEL


303.2

303.2

20"-25"


2010 ADAAG FIG.

2009 ICC A117.1 FIG.

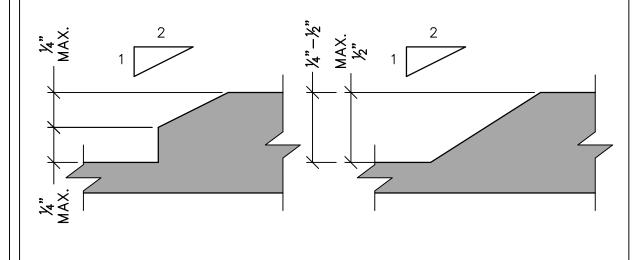

VERTICAL	CHANGES	IN	LEVEL	


2010 ADAAG FIG. 2009 ICC A117.1 FIG. 303.2(A) & 303.2(B)

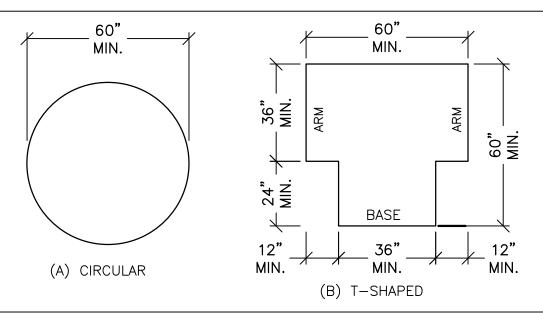

VERTICAL CHANGES IN LEVEL

2009 ICC A117.1 FIG.


2010 ADAAG FIG. 2009 ICC A117.1 FIG. 304.3(A) & 304.3(B)

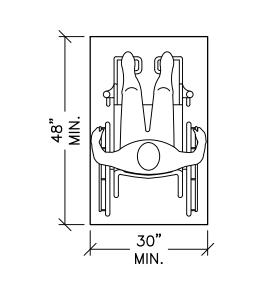

CLEAR FLOOR OR GROUND SPACE

305.3 2010 ADAAG FIG. 305.3 2009 ICC A117.1 FIG.

307.2

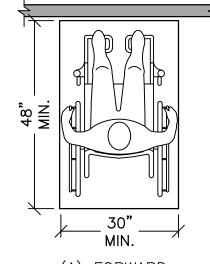


(B) PARALLEL

(A) FORWARD

POSITION OF CLEAR FLOOR OR GROUND SPACE

2010 ADAAG FIG. 2009 ICC A117.1 FIG. 305.5

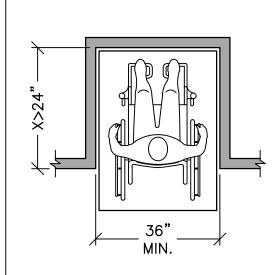

2010 ADAAG FIG.

2009 ICC A117.1 FIG.

UNOBSTRUCTED FORWARD REACH

CLEAR WIDTH OF AN ACCESSIBLE ROUTE

2010 ADAAG SECTION

2009 ICC A117.1 FIG.


2010 ADAAG FIG.

NOTE:WHEN THE DEPTH OF AN ALCOVE EXCEEDS 24" APPROACH, THE WIDTH OF

MANEUVERING CLEARANCE INCREASES TO 36" MIN. IN

WIDTH OF MANEUVERING CLEARANCE INCREASES TO 60" MIN. IN WIDTH. MANEUVERING CLEARANCE IN ALCOVE, PARALLEL APPROACH


2010 ADAAG FIG.	305.7.2
2009 ICC A117.1 FIG.	305.7(B) 20"

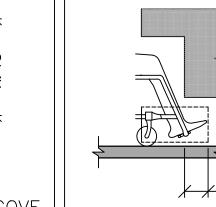

17"−25" <del>/</del>


(A) ELEVATION (B) PLAN TOE CLEARANCE

2010 ADAAG FIG.	306.2
2009 ICC A117.1 FIG.	306.2

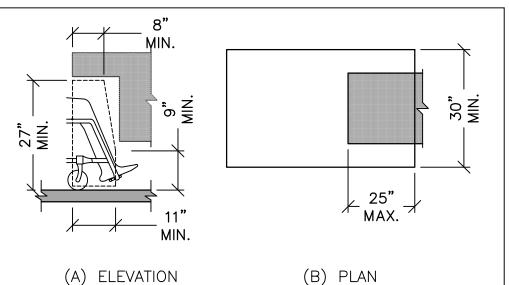


( ) ===	(-)
KNEE CLEARANCE	
2010 ADAAG FIG.	306.3

306.3

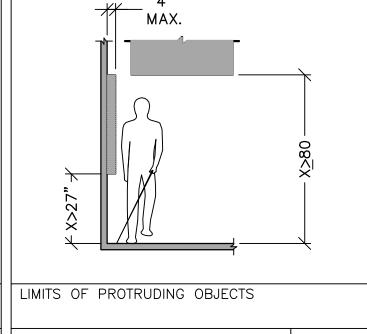


2009 ICC A117.1 FIG.

307.2 2010 ADAAG FIG. 2009 ICC A117.1 FIG.

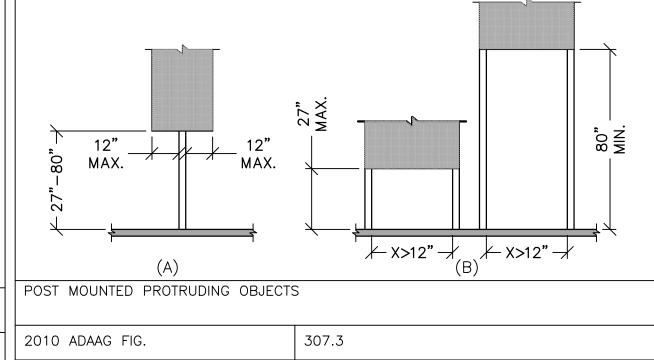

307.3

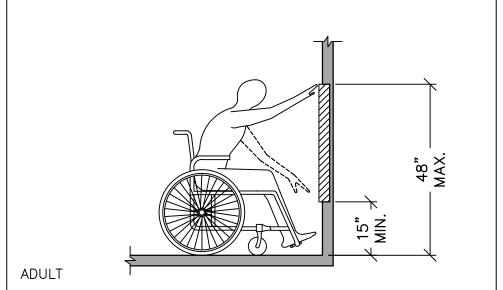



MANEUVERING CLEARANCE IN ALCOVE, FORWARD APPROACH


305.7.1

305.7(A)

MAX. OBSTRUCTED HIGH FORWARD REACH 2010 ADAAG FIG. 308.2.2 308.2.2 2009 ICC A117.1 FIG.

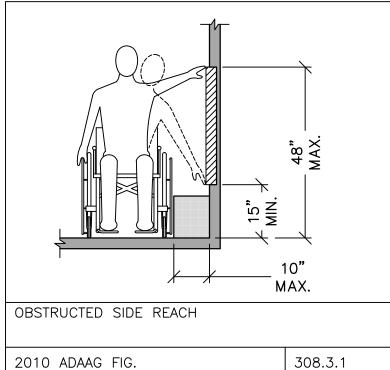

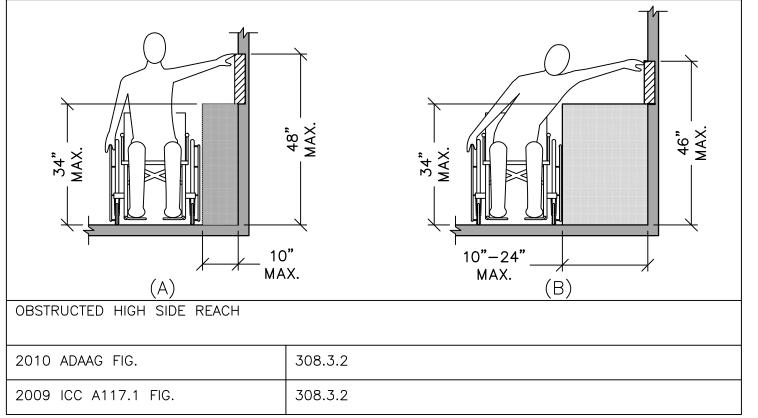


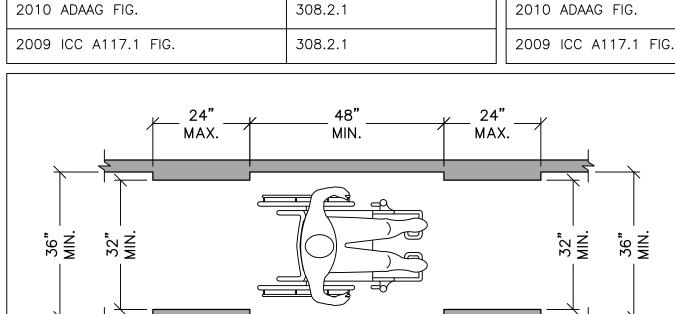

403.5.1

604.5.1

604.5.1

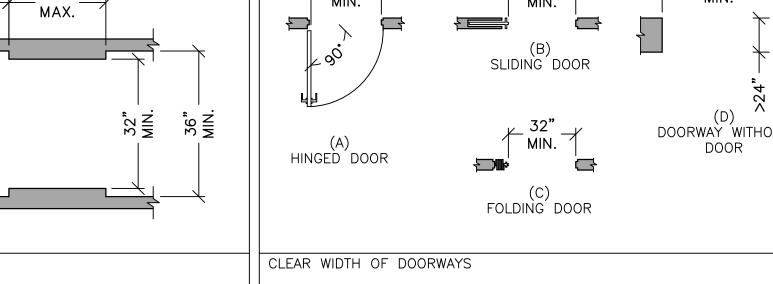


ADULT DISPENSER OUTLET LOCATION

2010 ADAAG SECTION

2009 ICC A117.1 FIG.


604.7

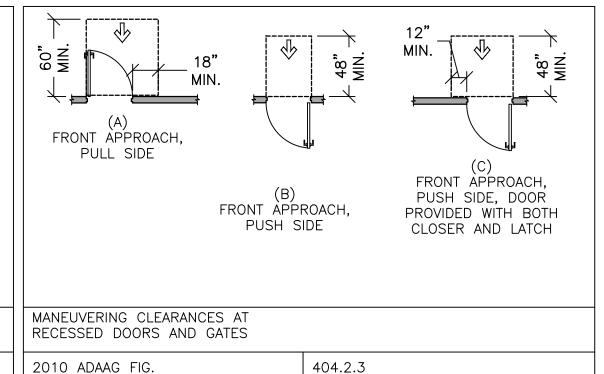


308.3.1

MIN.  MIN.  HINGED DOOR	MIN.  (B) SLIDING DOOR  32" MIN.  (C) FOLDING DOOR	DOORWAY WITHOUT DOOR	18" MIN.  (A) FRONT APPROACH, PULL SIDE	(B) RONT APPROACH, PUSH SIDE	(C) FRONT APPROACH, PUSH SIDE, DOOR PROVIDED WITH BOTH CLOSER AND LATCH
CLEAR WIDTH OF DOORWAYS			MANEUVERING CLEARANCES RECESSED DOORS AND GAT		
2010 ADAAG FIG.	404.2.3		2010 ADAAG FIG.	404.2.3	
2009 ICC A117.1 FIG.	404.2.2		2009 ICC A117.1 FIG.	404.2.2	


2009 ICC A117.1 FIG.

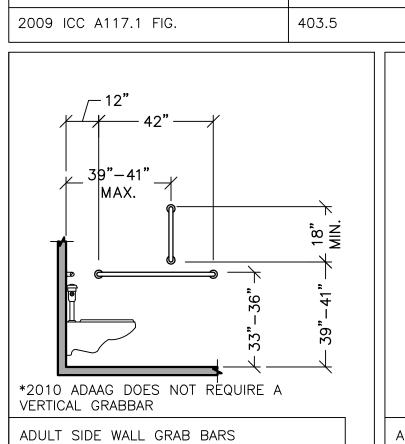


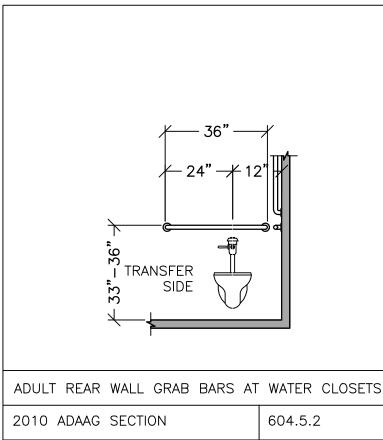

604.5.2

2009 ICC A117.1 FIG.

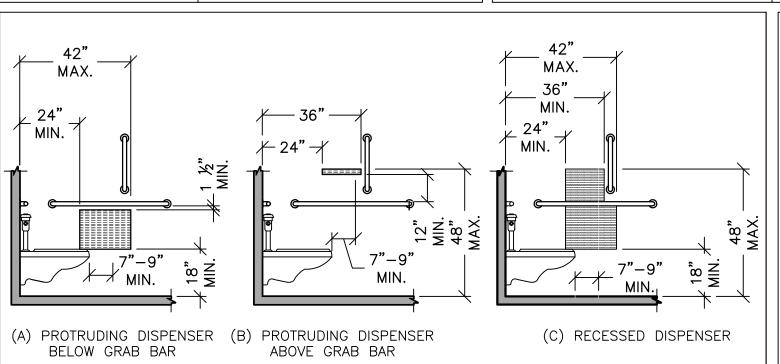

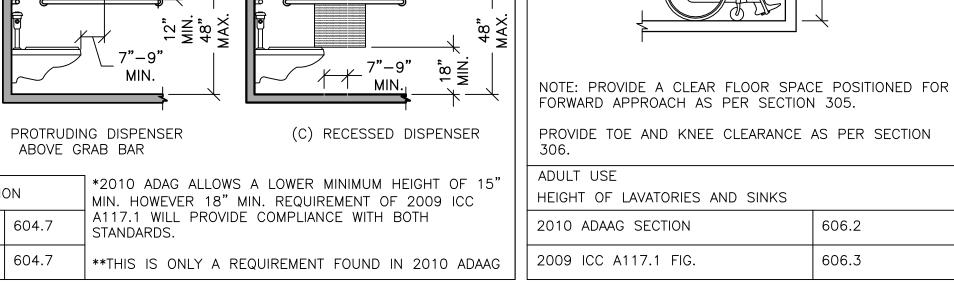

2	04/06/2023	100% SUBMISSION	
1	09/24/2022	80% SUBMISSION	
No.	Date	Revision	
, and the second		·	

#### AFRIDI ASSOCIATES **CONSULTING ENGINEERS**

19 West 21st Street 510 Broadhollow Road Melville, NY 11747 New York, NY 10010 Tel: (212) 243-0725 Tel: (631) 465-0786 Fax: (212) 243-0725 Fax: (631) 465-0788

aafridi@afridiassociates.com

LONG ISLAND | NEW YORK CITY | CHARLOTTE | DANBURY

200 Old Country Road | Suite 670 Mineola | NY 11501 516 484 1020 Lizardos.com

Lizardos Engineering Associates D.P.C.

Designer:	AKBER AFRIDI, P.E.
Drawn by:	AZHER MALIK
Checked by:	AKBER AFRIDI, P.E.

INTERIOR RENOVATIONS OF


THE COMMONS APARTMENTS 10.1 (ADA COMPLIANT) & 10.3


735 Anderson Hill Road Purchase NY 10577


ADA CODE COMPLAINCE

TOO	4.00	
Scale:	AS NOTED	

SU-040623

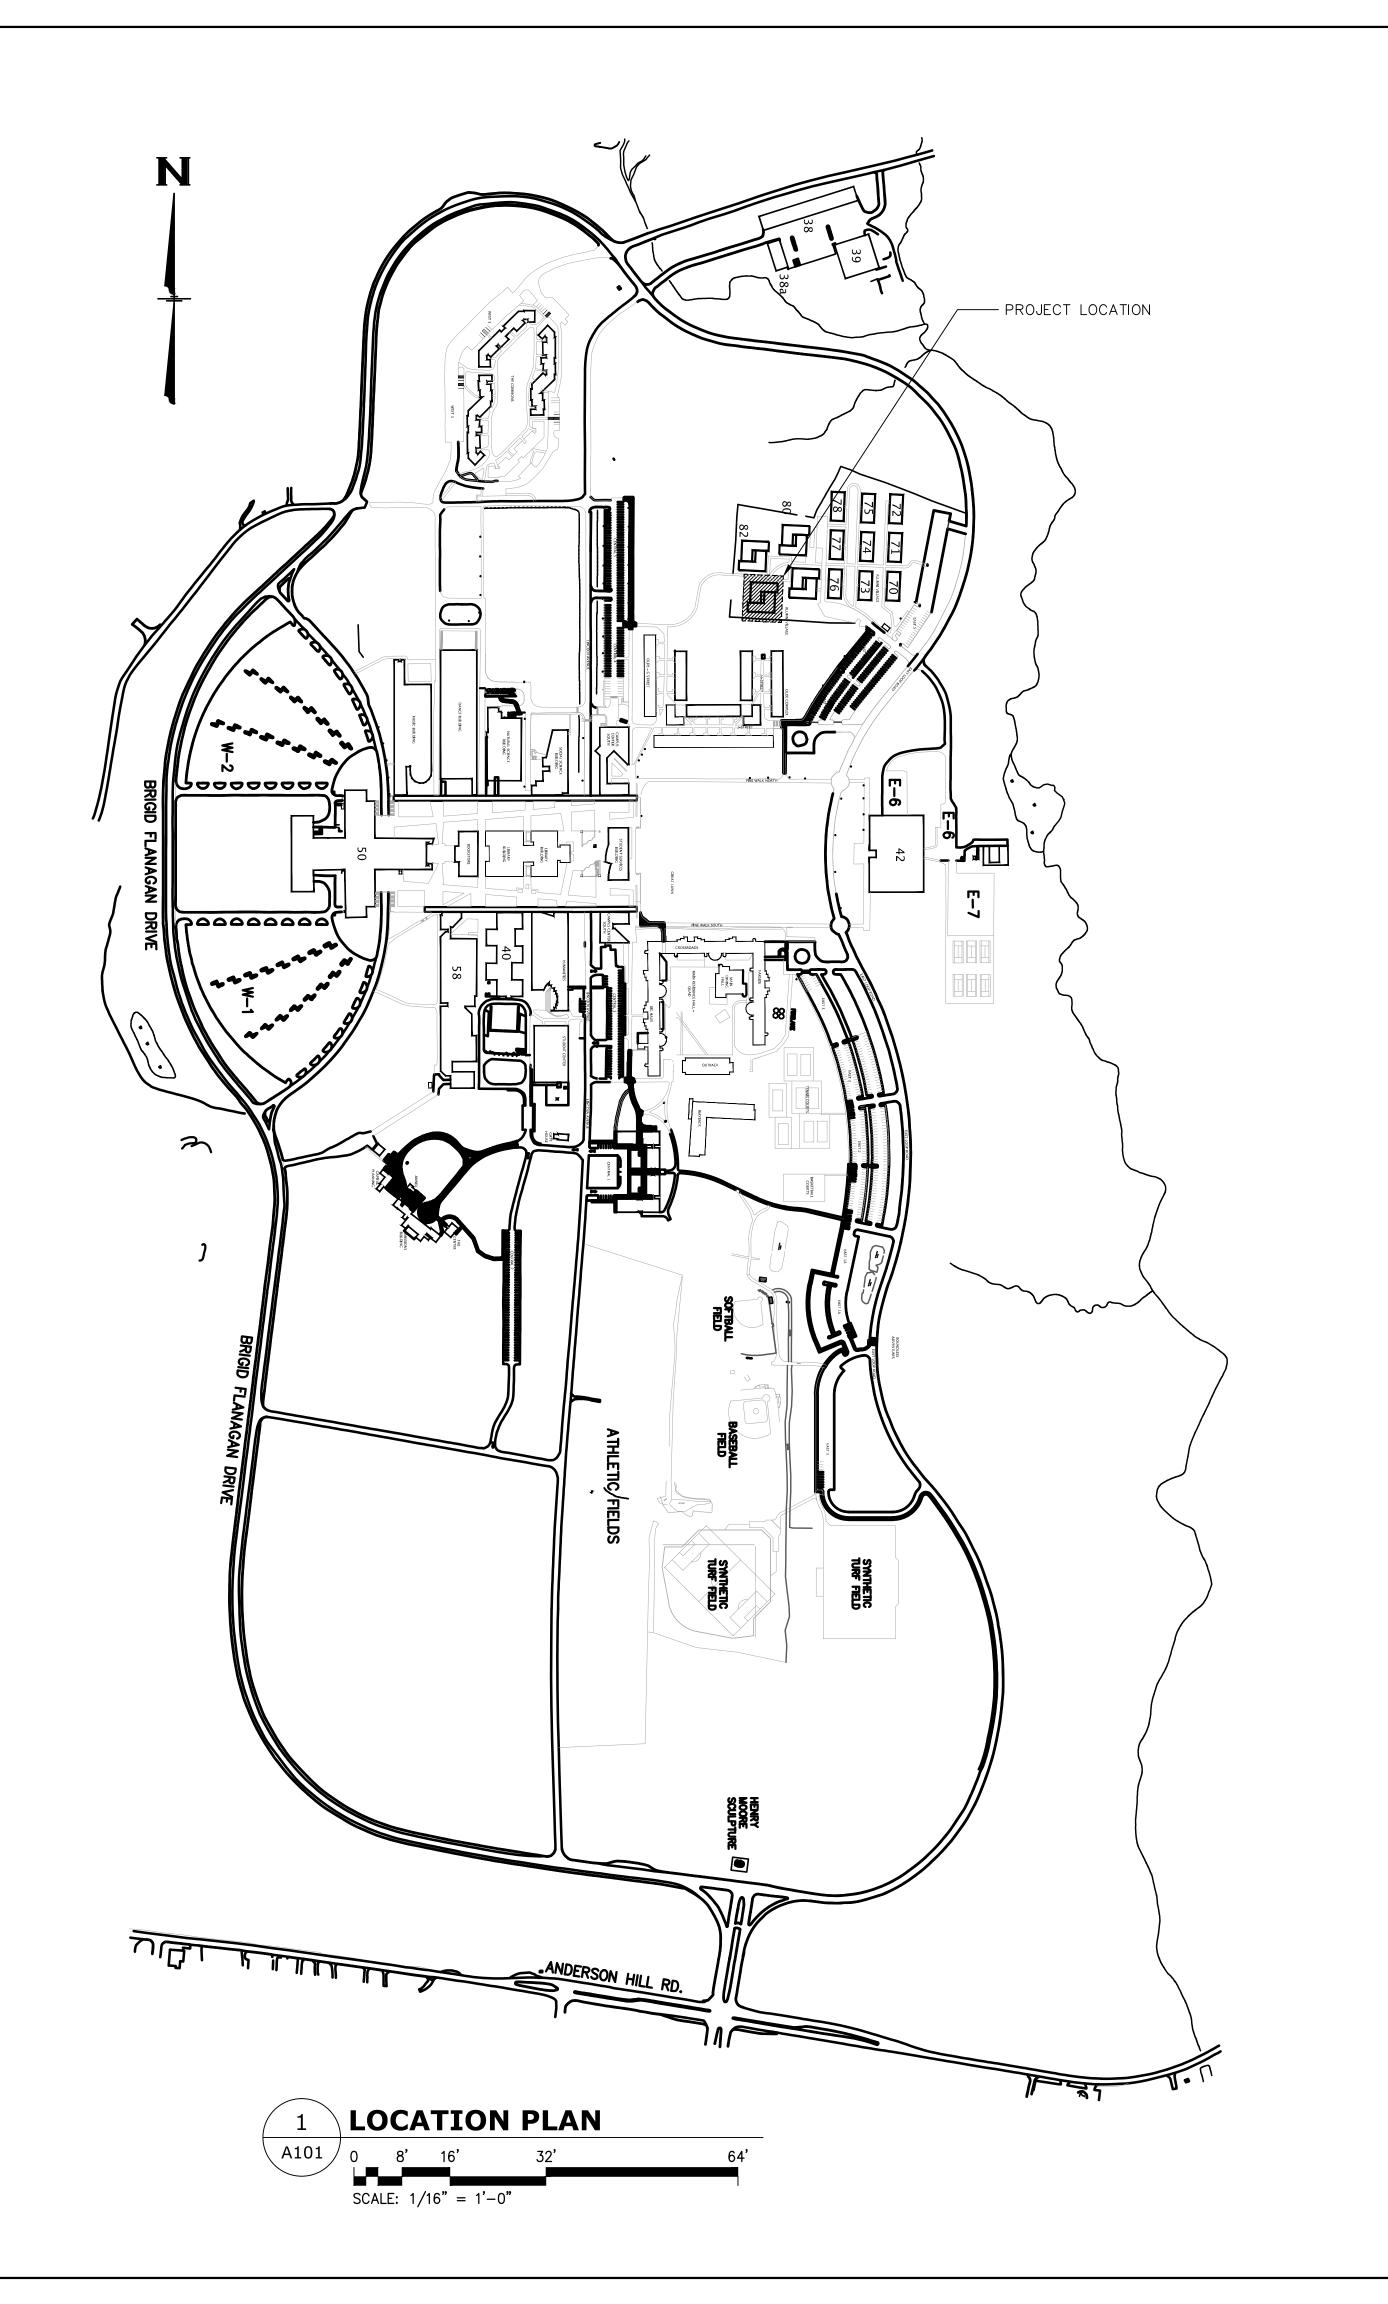

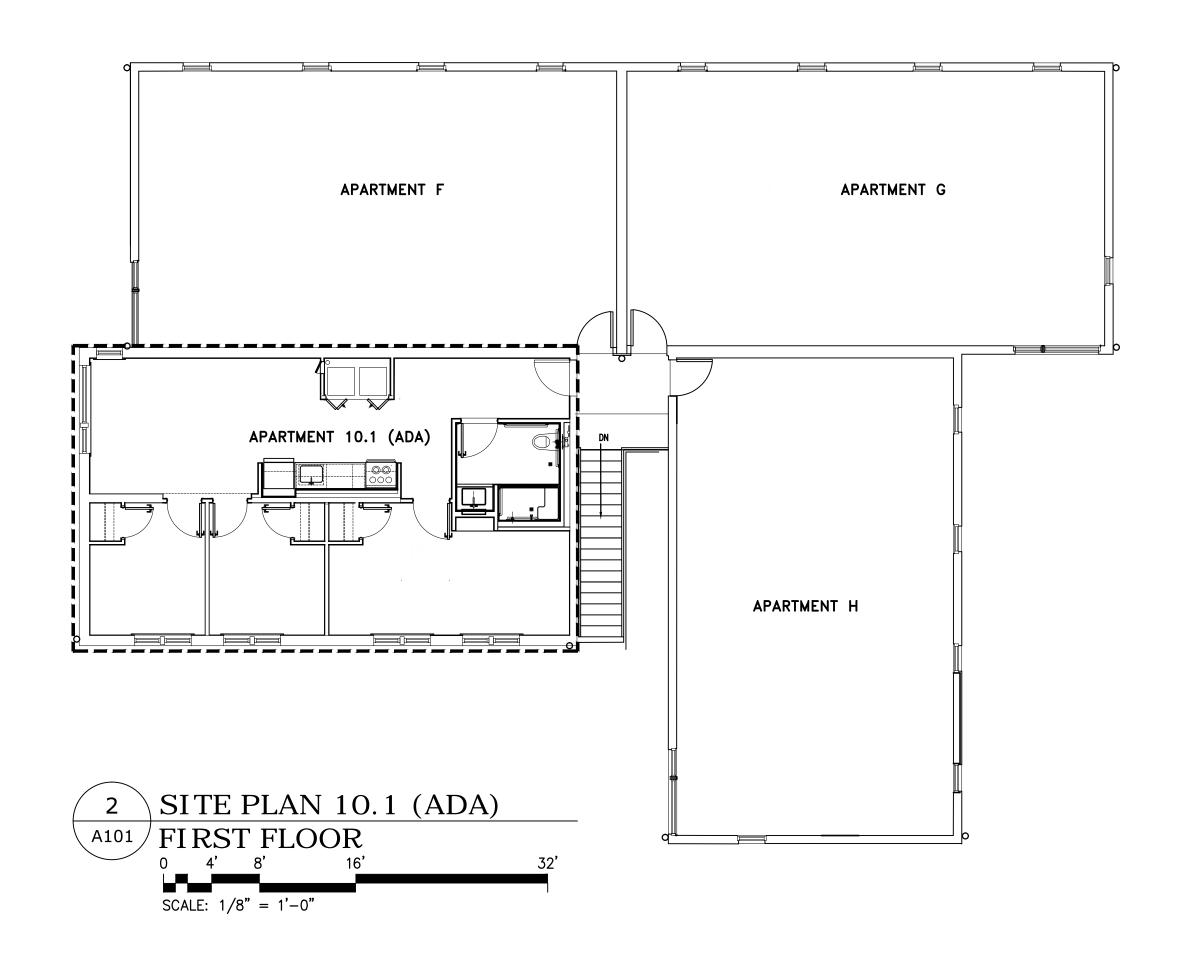

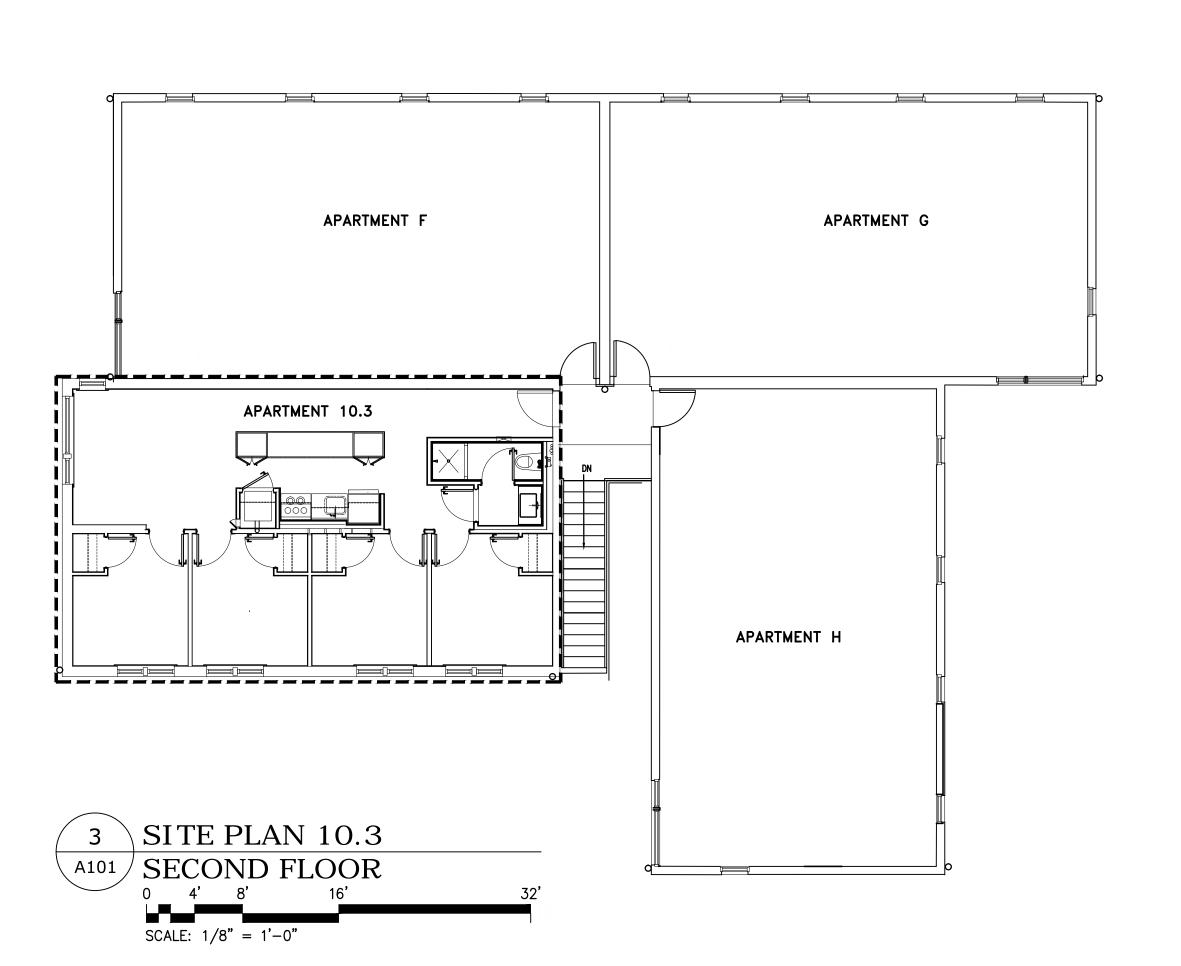

2 04/06/2023 100% SUBMISSION 1 09/24/2022 80% SUBMISSION

No. Date Revision

### AFRIDI ASSOCIATES

CONSULTING ENGINEE

19 West 21st Street 510 Broadhollow Road New York, NY 10010 Melville, NY 11747
Tel: (212) 243-0725 Tel: (631) 465-0786
Fax: (212) 243-0725 Fax: (631) 465-0788

aafridi@afridiassociates.com

## **LIZARDOS**

LONG ISLAND | NEW YORK CITY | CHARLOTTE | DANBURY

200 Old Country Road | Suite 670 Mineola | NY 11501 516 484 1020 Lizardos.com

Lizardos Engineering Associates D.P.C.

Designer: AKBER AFRIDI, P.E.

Drawn by: AZHER MALIK

Checked by: AKBER AFRIDI, P.E.

Project:

INTERIOR RENOVATIONS OF

### THE COMMONS APARTMENTS 10.1 (ADA COMPLIANT) & 10.3

735 Anderson Hill Road
Purchase NY 10577


LOCATION/KEY PLAN
(FOR REFERENCE ONLY)

Drawing No.:
A101.00

Scale: AS NOTED

Date: 08/24/2020

SU-040623

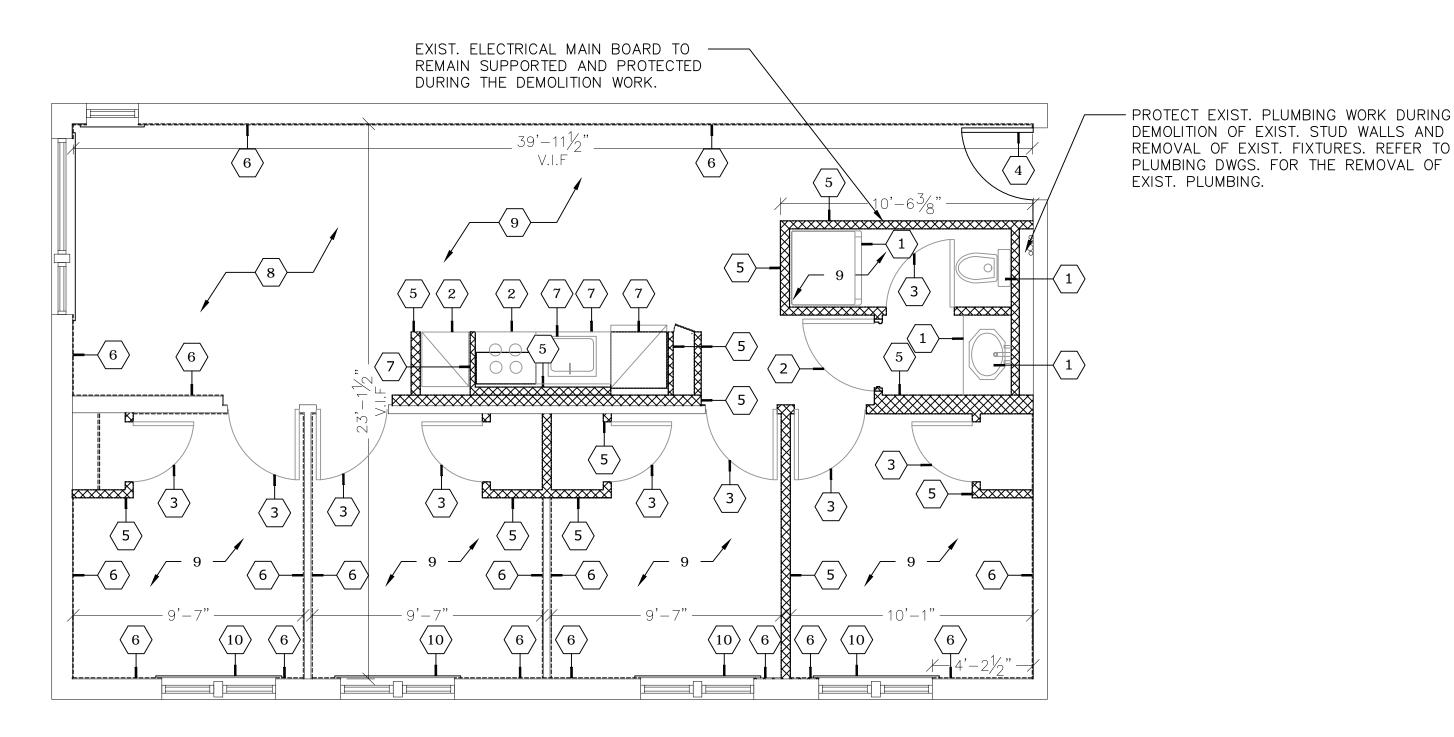

### **DEMOLITION KEY**

- REMOVE TOILET FIXTURES AND ASSOCIATED HARDWARE AND ASSOCIATED PLUMBING AND CARRIERS: PREPARE FOR NEW FIXTURES IN RELOCATED AREAS: PATCH AREAS AS NECESSARY TO MATCH ADJACENT FINISHES.
- 2 DISCONNECT AND REMOVE KITCHEN APPLIANCES.
- 3 REMOVE EXISTING DOOR AND DOOR HARDWARE.
- 4 EXIST. DOOR TO REMAIN.
- REMOVE INTERIOR NON LOAD-BEARING WALL AND ASSOCIATED FRAMING AND BLOCKING AND SUPPORT AS INDICATED.
- REMOVE DAMAGED EXIST. DRYWALL, AND PREPARE EXIST. FRAMING FOR NEW DRYWALL. EXIST. DRYWALL IN GOOD CONDITION TO REMAIN.
- REMOVE CASEWORK AND BUILT-IN THROUGHOUT WORK AREA.
- REMOVE FINISH FLOOR AND REPAIR FOR NEW FLOOR FINISH.
- 9 REMOVE EXIST. DRYWALL CEILING CAREFULLY.
- 10 UNINSTALL EXIST. WINDOW APRON AND CASING.

#### **GENERAL NOTES**

- 1. SHUT DOWN ALL EXIST UTILITY CONNECTION PRIOR TO DISCONNECTING FIXTURES AND FAUCETS.
- 2. DISCONNECT AND SAFELY REMOVE ALL EXIST. EQUIPMENT.
- 3. CAP ALL EXIST. UTILITY CONNECTIONS PRIOR TO REINSTATING THE UTILITIES.
- 4. FOR REMOVAL OF ELECTRIC WIRING, SWITCHES, OUTLETS REFER TO ELECTRICAL DWGS.
- 5. FOR SMOKE DETECTORS AND OTHER EQUIPMENT REFER TO MEP DWGS.
- 6. NEW ROUGH DOOR OPENING SIZE MAY VARY ON METAL DOOR FRAME SIZE.
- 7. USE R-21, 5 ½" INSULATION BATTS FOR 2"x6" STUD WALL.
- 8. USE R-15, 3 ½" INSULATION BATTS FOR 2"X4" STUD WALL.

#### <u>LEGEND</u>

EXIST. WALL, TO REMAIN



NEW PARTIAL DRYWALL



NEW DRYWALL, FRAMING
AND SHEET ROCK


DEMOLITION PLAN

A102 ADA APARTMENT 10.1

O 2' 4' 8'

SCALE: 1/4" = 1'-0"

ALL DAMAGE TO ADJOINING WORK DUE TO FAILURE TO PROVIDE ADEQUATE PROTECTION SHALL BE CORRECTED BY THE CONTRACTOR AT THE CONTRACTOR'S EXPENSE.

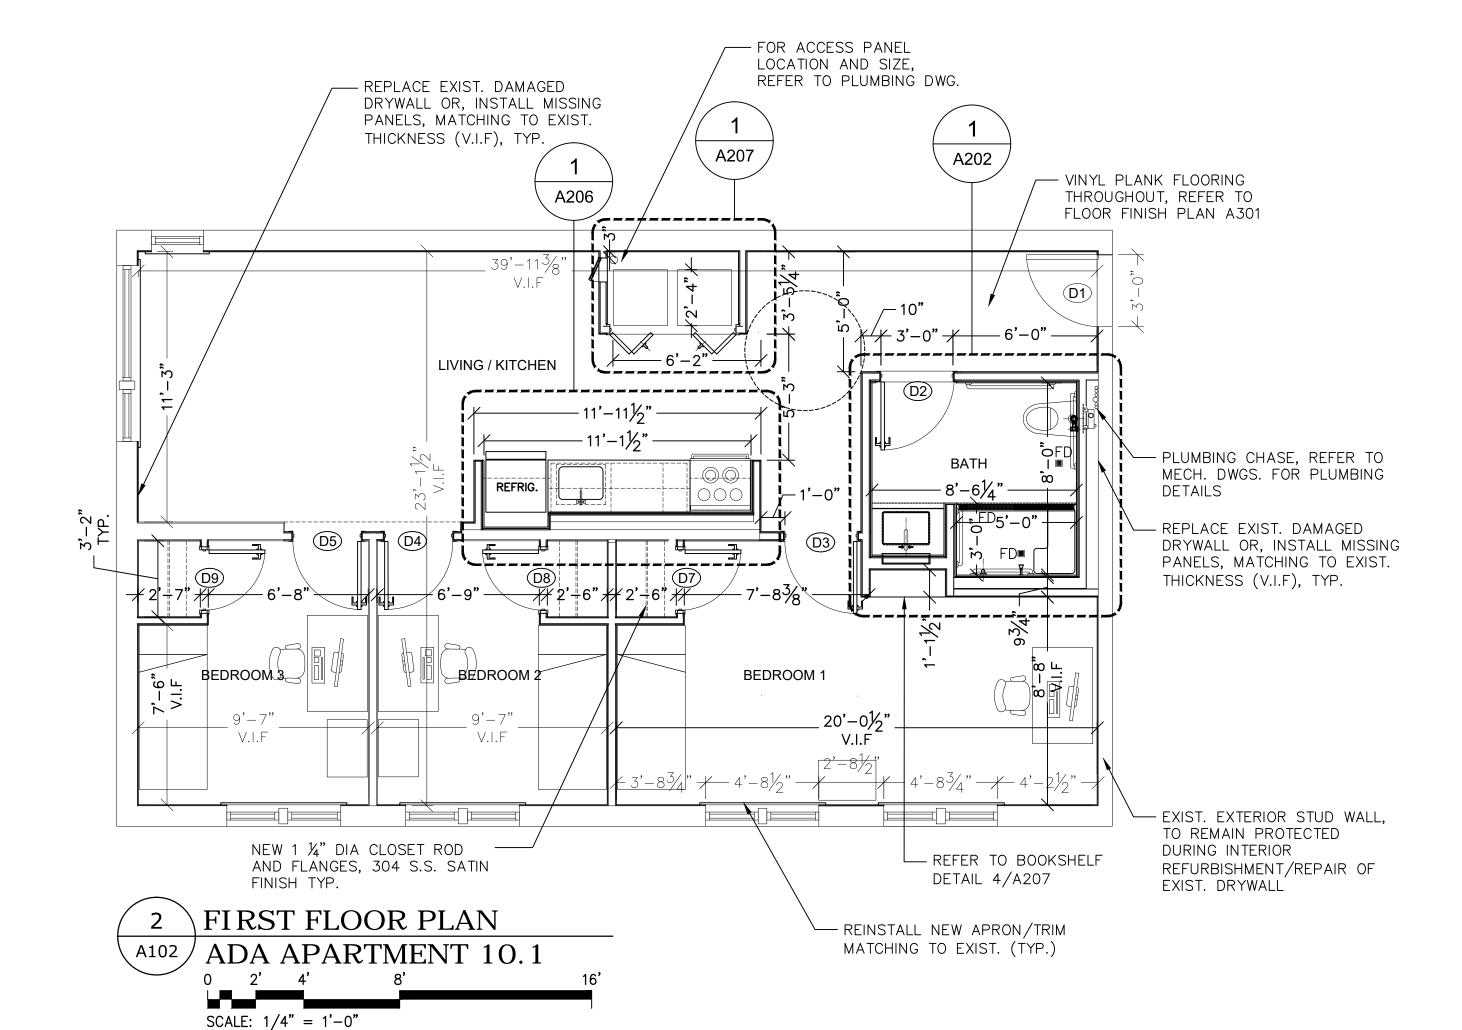

		CAPACITY POWER SU		RSUPPLY				
No.	APPLIANCE	WIDTH	DEPTH	HEIGHT	CAPACITY	COLOR	AMPS	WATTS
01	SPEED QUEEN (COMMERCIAL FRONT LOAD) WASHER	27"	27 3/4"	44 1/2"	4.5 CF	WHITE	15 A	
02	SPEED QUEEN (COMMERCIAL FRONT LOAD) DRYER	27"	30 3/8"		7.4 CF	WHITE	30 A	
03	FRIGIDAIRE REFRIGERATOR	30"	30 3/8"	66.38"	18.3 CF	S. STEEL	15 A	
04	FRIGIDAIRE COOKING RANGE (4 BURNERS)	30"	32"	34"	6.3 CF	S. STEEL	40 A	1500-4800
05	FRIGIDAIRE MICROWAVE (OVER THE RANGE)	30"	15 3/4"	16 3/8"	1.9 CF	S. STEEL	15 A	1000

2 04/06/2023 100% SUBMISSION

1 09/24/2022 80% SUBMISSION

No. Date Revision

# AFRIDI ASSOCIATES CONSULTING ENGINEERS

19 West 21st Street 510 Broadhollow Road New York, NY 10010 Melville, NY 11747 Tel: (212) 243-0725 Tel: (631) 465-0786

Fax: (212) 243-0725 Fax: (631) 465-0788 aafridi@afridiassociates.com

### LIZARDOS

LONG ISLAND | NEW YORK CITY | CHARLOTTE | DANBURY

200 Old Country Road | Suite 670 Mineola | NY 11501 516 484 1020 Lizardos.com

Lizardos Engineering Associates D.P.C.

Designer:	AKBER AFRIDI, P.E.
Drawn by:	AZHER MALIK
Checked by:	AKBER AFRIDI, P.E.

Project:

#### INTERIOR RENOVATIONS OF THE COMMONS APARTMENTS 10.1 (ADA COMPLIANT) & 10.3

Address: 735 Anderson Hill Ro


735 Anderson Hill Road Purchase NY 10577


Drawing Title:


ADA APARTMENT 10.1, PARTIAL
REMOVALS & PROPOSED PLANS

Drawing No.:
A102.00

Scale: AS NOTED

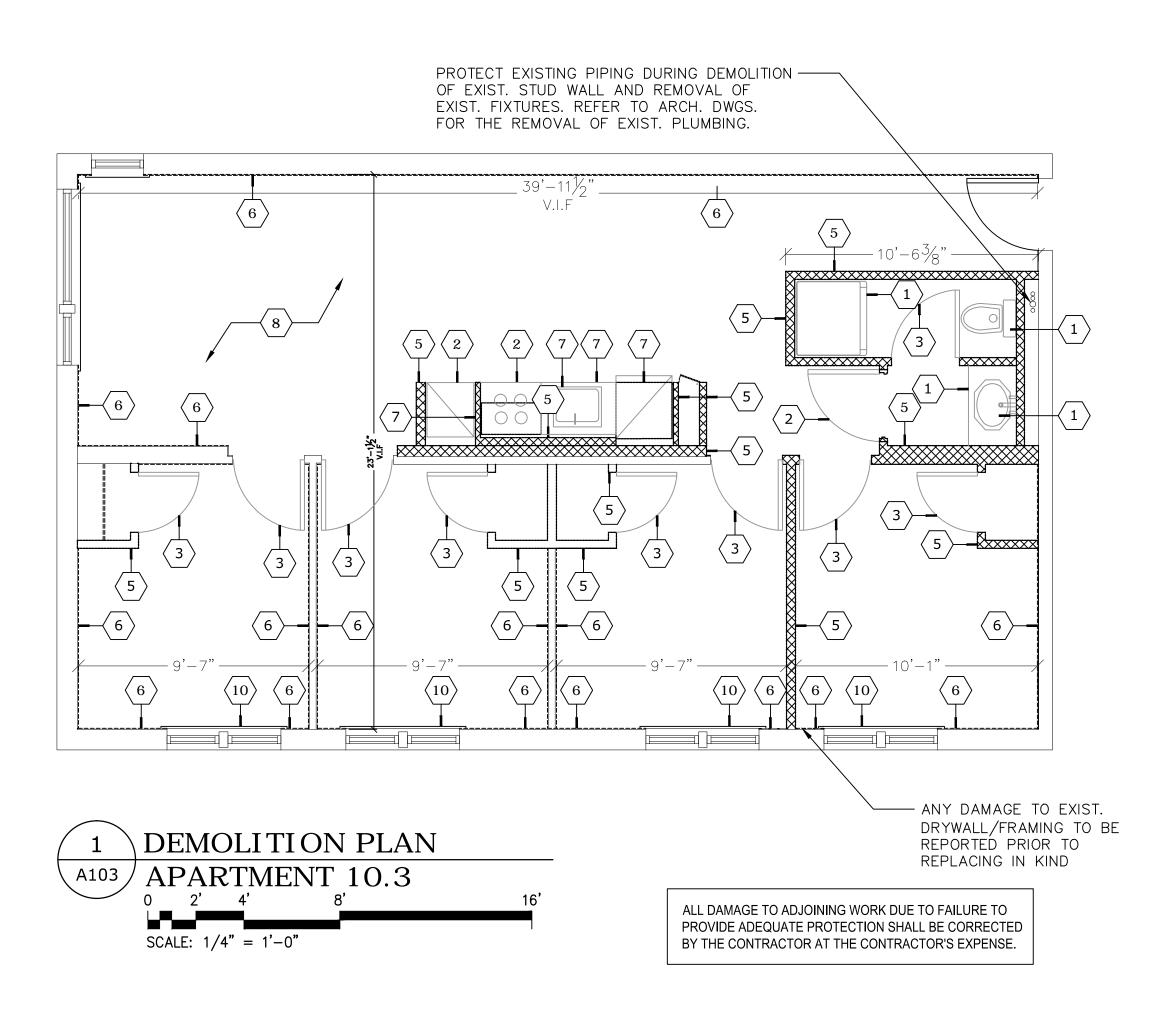

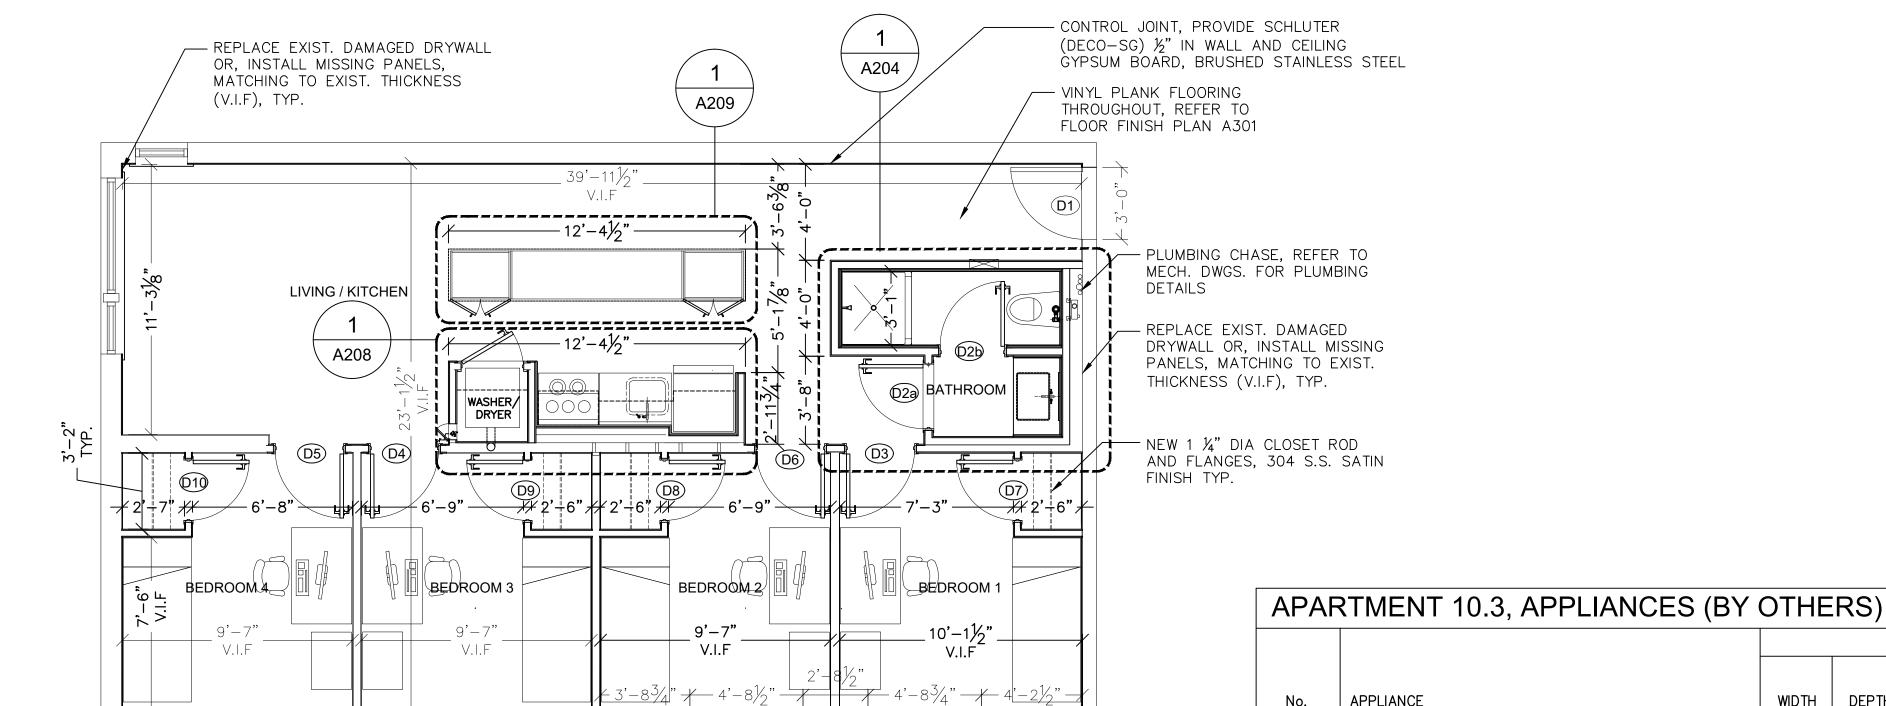

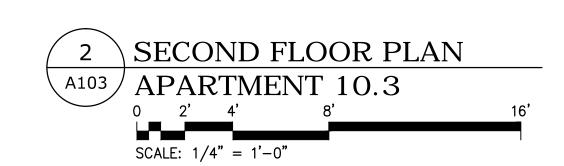

#### DEMOLITION KEY

- REMOVE TOILET FIXTURES AND ASSOCIATED HARDWARE AND ASSOCIATED PLUMBING AND CARRIERS: PREPARE FOR NEW FIXTURES IN RELOCATED AREAS: PATCH AREAS AS NECESSARY TO MATCH ADJACENT FINISHES.
- DISCONNECT AND REMOVE KITCHEN APPLIANCES.
- REMOVE EXISTING DOOR AND DOOR HARDWARE.
- EXISTING DOOR TO REMAIN.
- REMOVE INTERIOR NON LOAD-BEARING WALL AND ASSOCIATED FRAMING AND BLOCKING AND SUPPORT AS INDICATED.
- EXISTING DRYWALL TO REMAIN. REMOVE ANY BROKEN PIECES WALL AND PREPARE STUD WALL FOR NEW
- 7 REMOVE CASEWORK AND BUILT-IN THROUGHOUT WORK
- 8 REMOVE FINISH FLOOR AND PREPARE FOR NEW FLOOR

CAPACITY

DEPTH | HEIGHT | CAPACITY

34" 6.3 CF

27" | 27 3/4" | 78 1/4" | 21.5 LB

30" | 30 3/8" | 66.38" | 18.3 CF

30" | 15 3/4" | 16 3/8" | 1.9 CF

APPLIANCE

| SPEED QUEEN (COMMERCIAL FRONT LOAD)

FRIGIDAIRE COOKING RANGE (4 BURNERS)

FRIGIDAIRE MICROWAVE (OVER THE RANGE)

STACKED WASHER/DRYER

FRIGIDAIRE REFRIGERATOR

- REMOVE EXIST. DRYWALL CEILING CAREFULLY.
  - UNINSTALL EXIST. WINDOW APRON AND CASING.

#### **GENERAL NOTES**

POWER SUPPLY

40 A 1500-4800

WATTS

AMPS

30 A

30 A

15 A

15 A

COLOR

S. STEEL

S. STEEL

S. STEEL

- 1. SHUT DOWN ALL EXIST UTILITY CONNECTION PRIOR TO DISCONNECTING FIXTURES AND FAUCETS.
- 2. DISCONNECT AND SAFELY REMOVE ALL EXIST. EQUIPMENT.
- 3. CAP ALL EXIST. UTILITY CONNECTIONS PRIOR TO REINSTATING THE UTILITIES.
- 4. FOR REMOVAL OF ELECTRIC WIRING, SWITCHES, OUTLETS REFER TO ELECTRICAL DWGS.
- 5. FOR SMOKE DETECTORS AND OTHER EQUIPMENT REFER TO MEP DWGS.
- 6. NEW ROUGH DOOR OPENING SIZE MAY VARY ON METAL DOOR FRAME SIZE.
- 7. USE R-21, 5  $\frac{1}{2}$ " INSULATION BATTS FOR 2"X6" STUD WALL.
- 8. USE R-15, 3 ½" INSULATION BATTS FOR 2"X4" STUD WALL.

#### LEGEND

----- EXIST. WALL, TO REMAIN



----- NEW PARTIAL DRYWALL



----- NEW DRYWALL, FRAMING AND SHEET ROCK

2 04/06/2023 100% SUBMISSION

1 09/24/2022 80% SUBMISSION

No. Date Revision

#### AFRIDI ASSOCIATES **CONSULTING ENGINEERS**

19 West 21st Street 510 Broadhollow Road New York, NY 10010 Melville, NY 11747 Tel: (212) 243-0725

Tel: (631) 465-0786 Fax: (212) 243-0725 Fax: (631) 465-0788

aafridi@afridiassociates.com

## LIZARDOS

LONG ISLAND | NEW YORK CITY | CHARLOTTE | DANBURY

200 Old Country Road | Suite 670 Mineola | NY 11501 516 484 1020 Lizardos.com

Lizardos Engineering Associates D.P.C.

Designer:	AKBER AFRIDI, P.E.
Drawn by:	AZHER MALIK
Checked by:	AKBER AFRIDI, P.E.

#### INTERIOR RENOVATIONS OF THE COMMONS APARTMENTS 10.1 (ADA COMPLIANT) & 10.3

Address:

735 Anderson Hill Road Purchase NY 10577

Drawing Title: **APARTMENT 10.3, PARTIAL** REMOVAL & PROPOSED PLANS


> Drawing No.: A103.00


> > Date:

Scale: AS NOTED


08/24/2020

SU-040623

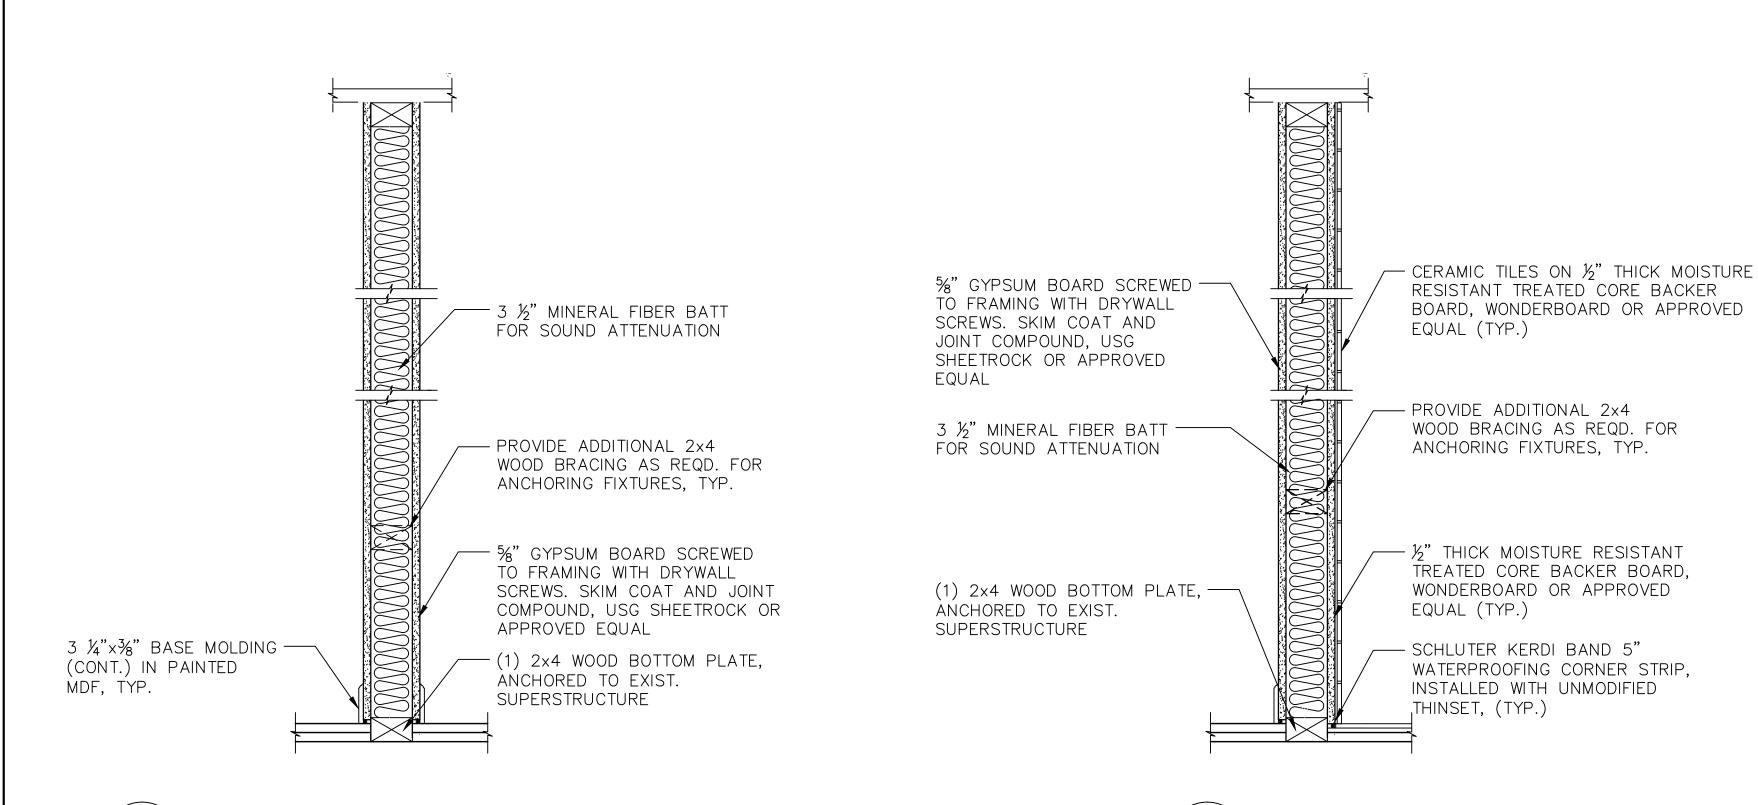

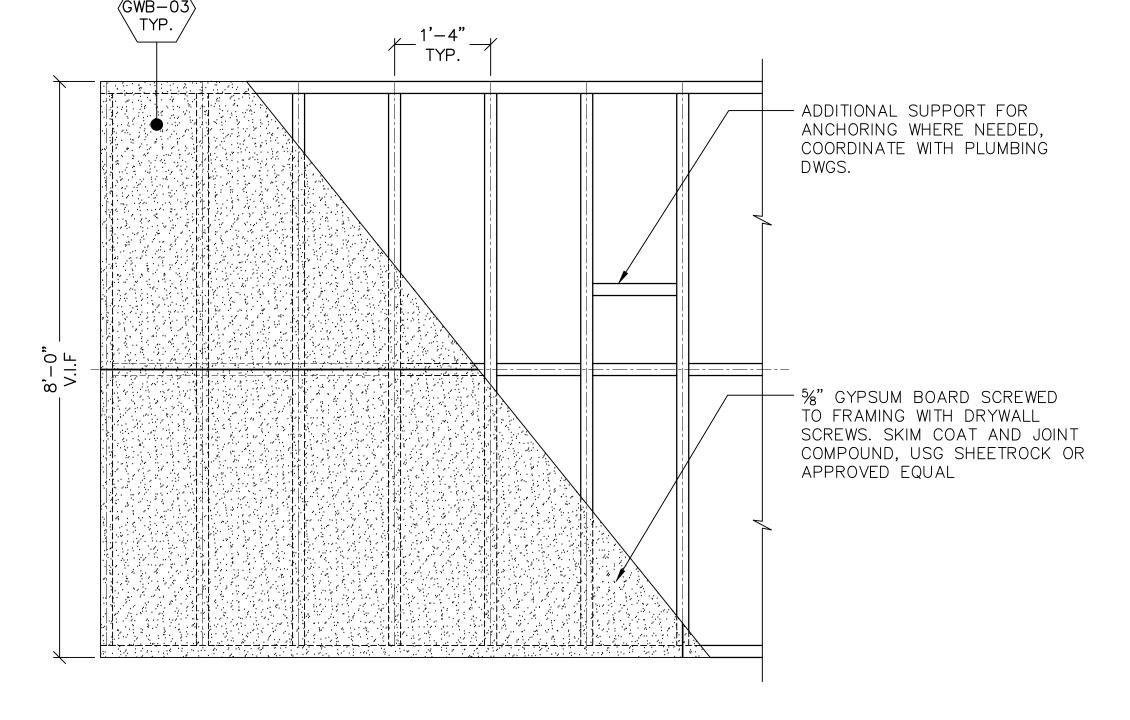



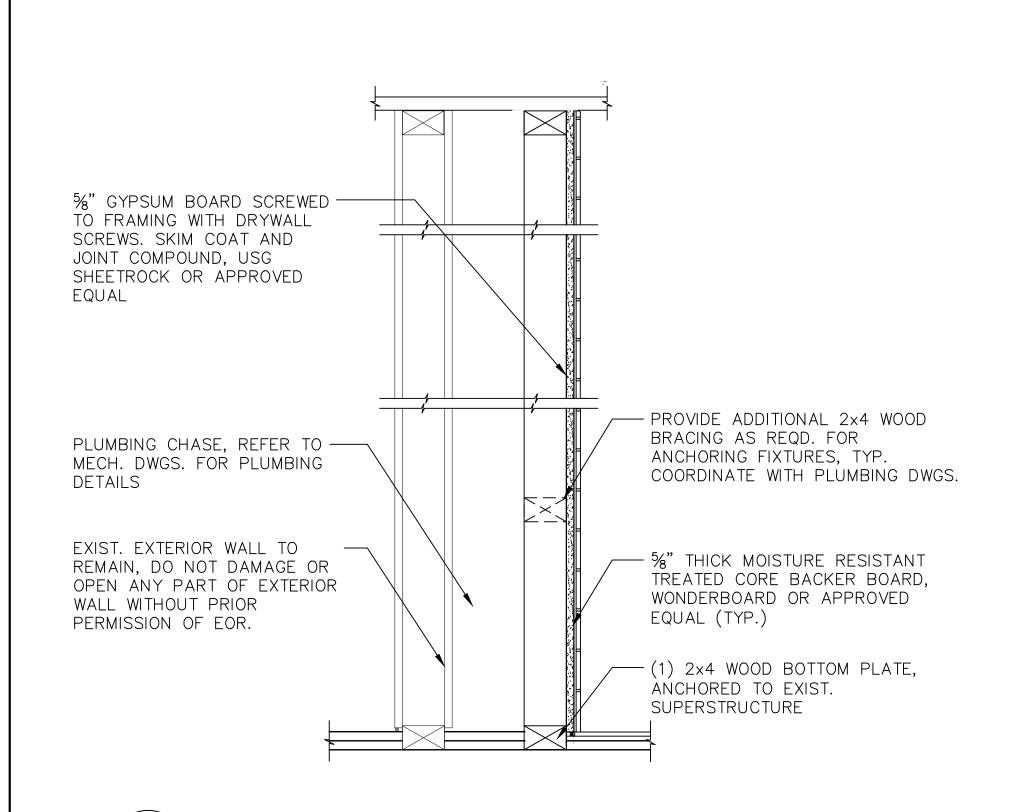

**SECTION - CERAMIC WALL TILE** 


**ON BACKER BOARD** 

SCALE:  $1 \frac{1}{2} = 1 - 0$ 

SECTION - INT. GYPSUM DRYWALL

A201 / 0 6" 1'


 $\frac{1}{1} = \frac{1}{1} = \frac{1}$ 

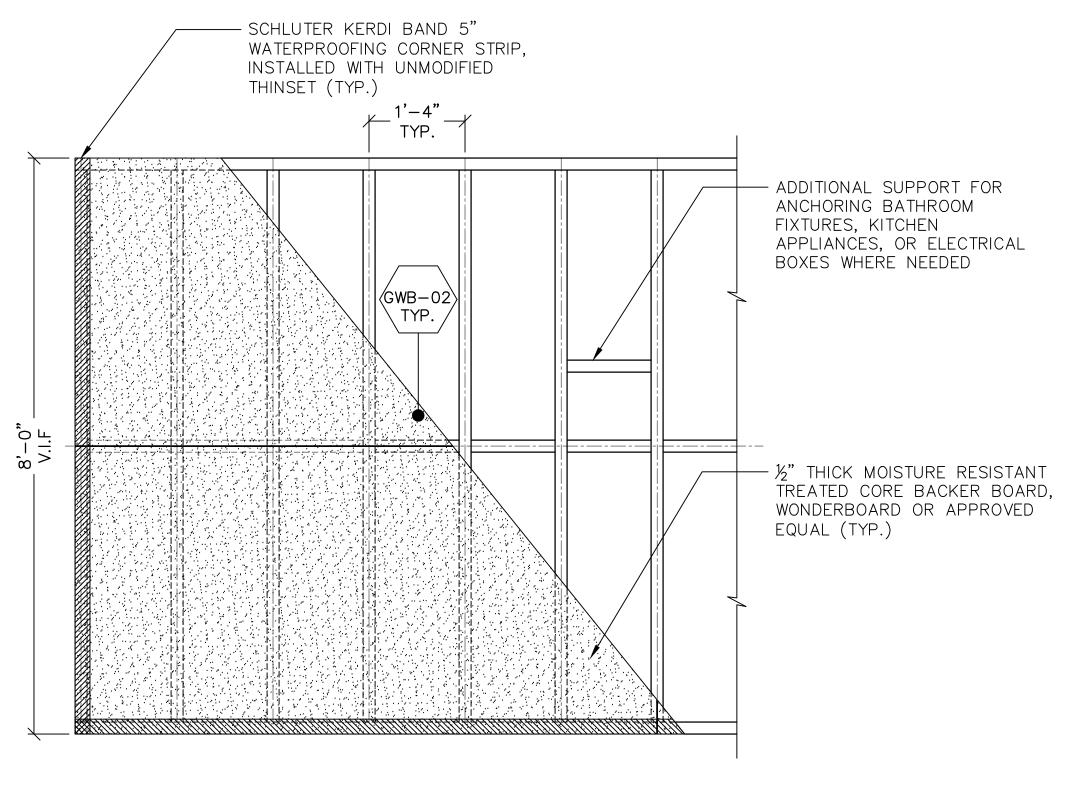


DRYWALL / FRAMING

 $\frac{1}{5}$  SCALE:  $\frac{3}{4}$ " =  $\frac{1}{-0}$ "

(KITCHEN & BATHROOM)

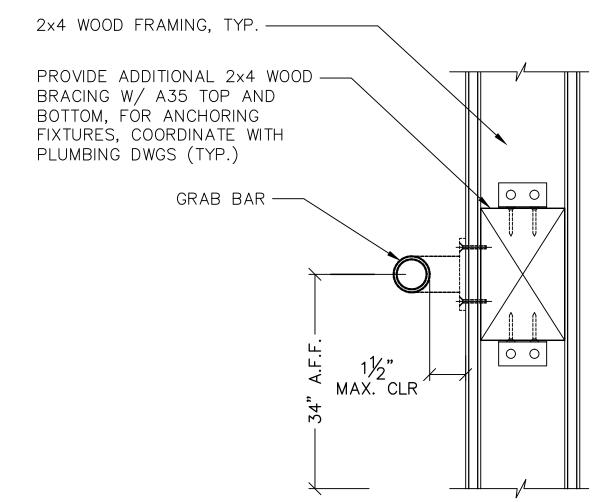

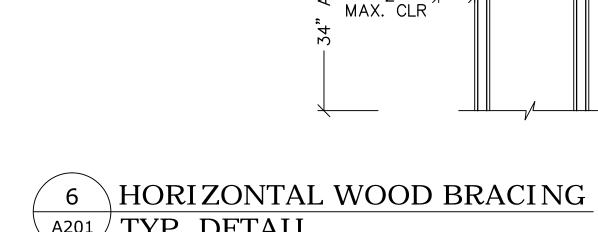

# A<sup>201</sup> TYP. DETAIL

SCALE: 3'' = 1'-0''

#### NOTE:

- 1. GRAB BAR MOUNTING TO WITHSTAND 250 LBS IN BENDING SHEAR AND TENSION W/ 1/8" MIN. RADIUS ON ALL EDGES. BAR SHALL NOT ROTATE IN FITTINGS.
- 2. A GRAB BAR AND ANY WALL SURFACE ADJACENT TO IT SHALL BE FREE OF ANY SHARP OR ABRASIVE ELEMENTS. EDGES SHALL HAVE A MINIMUM RADIUS OF 1/8".
- 3. ALL OTHER EQUIPMENT SHALL BE ADA COMPLIANT WITH ADDITIONAL HORIZONTAL BRACING.

2 04/06/2023 100% SUBMISSION 1 09/24/2022 80% SUBMISSION No. Date Revision

#### AFRIDI ASSOCIATES **CONSULTING ENGINEERS**

19 West 21st Street 510 Broadhollow Road Melville, NY 11747 New York, NY 10010 Tel: (212) 243-0725 Tel: (631) 465-0786 Fax: (212) 243-0725 Fax: (631) 465-0788

aafridi@afridiassociates.com

## **LIZARDOS**

LONG ISLAND | NEW YORK CITY | CHARLOTTE | DANBURY

200 Old Country Road | Suite 670 Mineola NY 11501 516 484 1020 Lizardos.com

Lizardos Engineering Associates D.P.C.

Designer:	AKBER AFRIDI, P.E.
Drawn by:	AZHER MALIK
Checked by:	AKBER AFRIDI, P.E.


INTERIOR RENOVATIONS OF THE COMMONS APARTMENTS 10.1 (ADA COMPLIANT) & 10.3


735 Anderson Hill Road Purchase NY 10577

Drawing Title: WALL SECTIONS

> Drawing No.: A201.00 Scale: AS NOTED

SU-040623

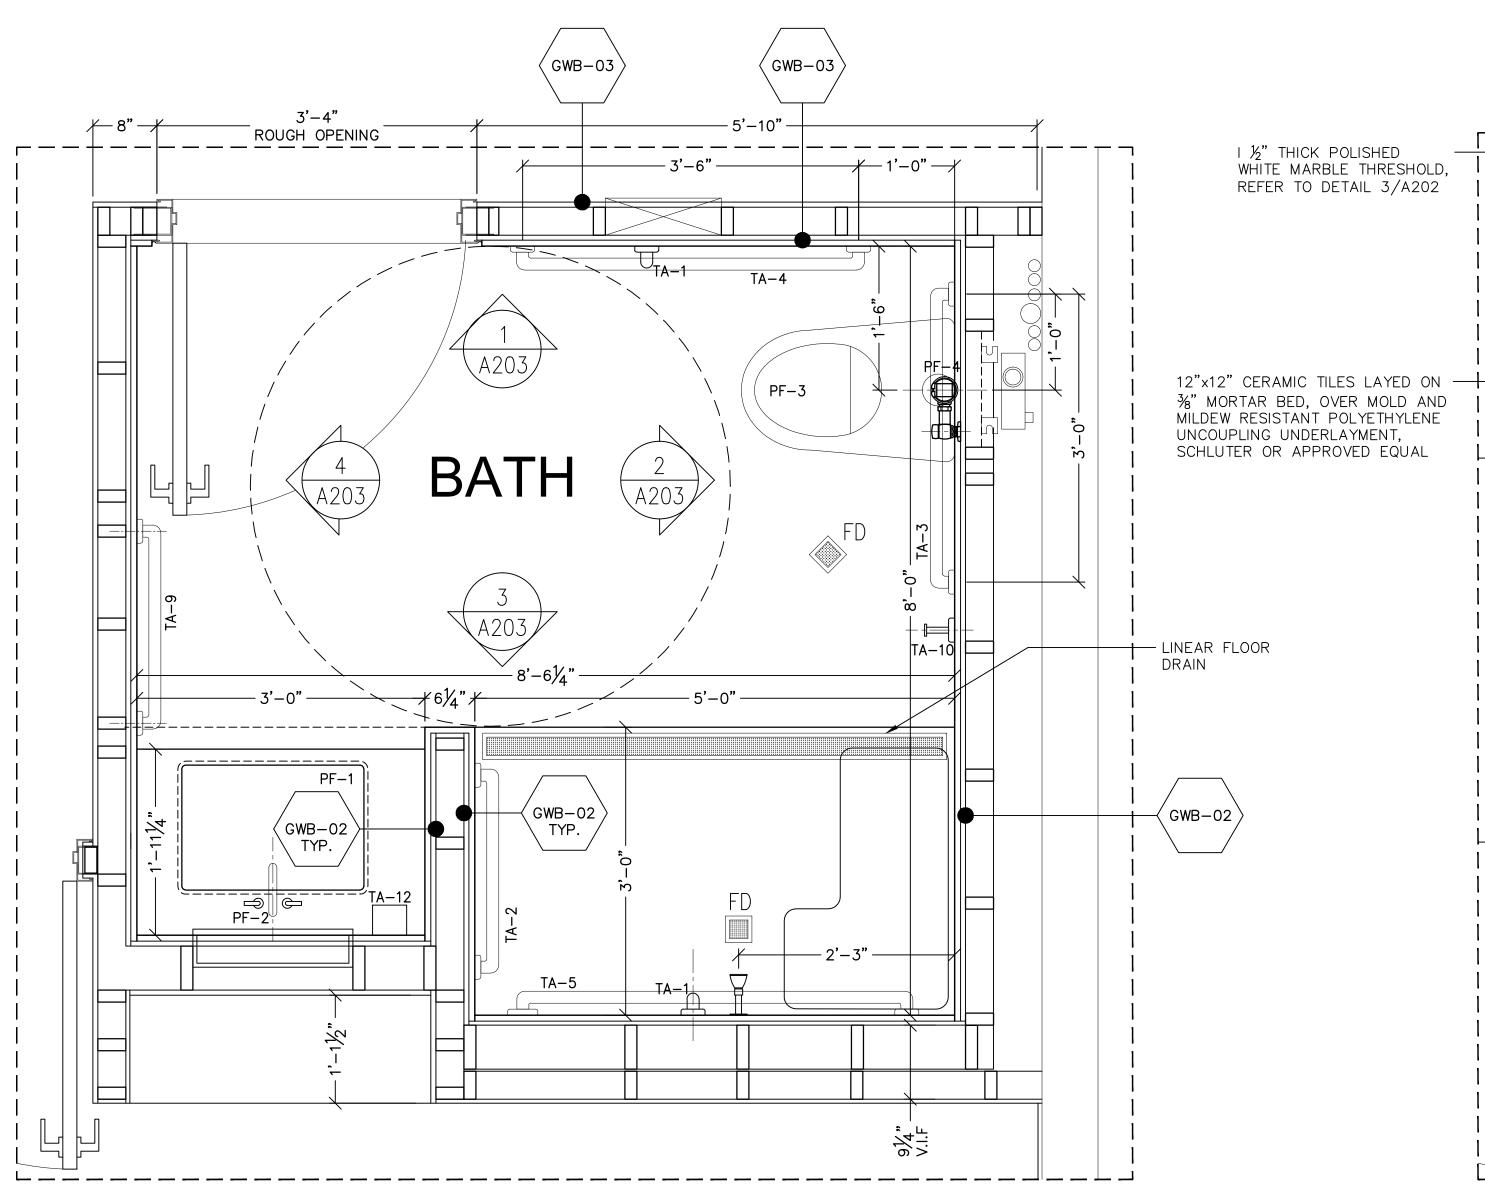


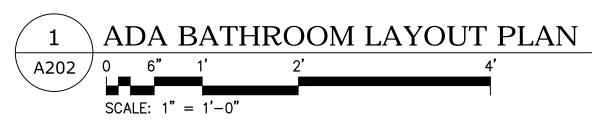

APA	RTM	ENT 10.1 PLUMBING FIXTURE SCHEDULE			
MARK	QTY	DESCRIPTION	MANUFACTURER	MODEL	REMARKS
PF-1	1	'STUDIO' UNDERCOUNTER SINK, VITREOUS CHINA	AMERICAN STANDARD	STUDIO - 0618.300	
PF-1K	1	'RUVATI' MODENA UNDERMOUNT 20 1/2"x17 3/4" BRUSHED SS SINK (16 GAUGE)	RUVATI	MODENA	
PF-2	1	'MONTERREY' TWO HANDLE 8" WIDESPREAD LAVATORY FAUCET	AMERICAN STANDARD	MONTERREY - 6500.170	
PF-2K	1	'HYDROLOCK' SINGLE HANDLE HIGH ARC PULL DOWN KITCHEN FAUCET	MOEN	CA87094 SERIES	
PF-3	1	'MODERA' FLOWISE 16 1/2" (FLUSHOMETER TOILET), 1.28 GPF	AMERICAN STANDARD		
PF-4	1	'SOLIS' SLOAN BATTERY/SOLAR POWERED DUAL FLUSH (8111-1.6/1.1)	SLOAN	8111-1.6/1.1	
			SLOAN		
PF-5	1	'M-DURA' COMMERCIAL THREE-FUNCTION SHOWER SYSTEM	MOEN	T9342	

NOTE: STANDARD CAMPUS WIDE FIXTURES, FINISHES AND OPERATION, G.C. TO COORDINATE.


	В	ATHROOM ACCESSORIES			
MARK	QTY	DESCRIPTION	MANUFACTURER	MODEL	REMARKS
TA-1	2	BOBRICK B-5806.99x18 STRAIGHT PEENED GRAB BAR	BOBRICK WASHROOM EQUIPMENT, INC.	B-5806.99x18	S.S. SATIN EXTRA HEAVY DUTY SURFACE MOUNTED
TA-2	1	BOBRICK B-5806.99x24 STRAIGHT PEENED GRAB BAR	BOBRICK WASHROOM EQUIPMENT, INC.	B-5806.99x24	S.S. SATIN EXTRA HEAVY DUTY SURFACE MOUNTED
TA-3	1	BOBRICK B-5806.99x36 STRAIGHT PEENED GRAB BAR	BOBRICK WASHROOM EQUIPMENT, INC.	B-5806.99x36	S.S. SATIN EXTRA HEAVY DUTY SURFACE MOUNTED
TA-4	1	BOBRICK B-5806.99x42 STRAIGHT PEENED GRAB BAR	BOBRICK WASHROOM EQUIPMENT, INC.	B-5806.99x42	S.S. SATIN EXTRA HEAVY DUTY SURFACE MOUNTED
TA-5	1	BOBRICK B-5806.99x48 STRAIGHT PEENED GRAB BAR	BOBRICK WASHROOM EQUIPMENT, INC.	B-5806.99x48	S.S. SATIN EXTRA HEAVY DUTY SURFACE MOUNTED
TA-6	1	BOBRICK COMMERCIAL TOILET PAPER DISPENSER	BOBRICK WASHROOM EQUIPMENT, INC.	B-6677	S.S. SATIN FIN.
TA-7	1	KOHLER, MEDICINE CABINET, RECESSED-MOUNTED	KOHLER	CATALAN	ANODIZED ALUMINUM (20 1/8"x36 1/8")
TA-8	1	BOBRICK B-542, SATIN FINISH STAINLESS STEEL COAT HOOK	BOBRICK WASHROOM EQUIPMENT, INC.	B-9542	S.S. SATIN FIN.
TA-9	1	BOBRICK B-530x18, TOWEL BAR	BOBRICK WASHROOM EQUIPMENT, INC.	B-530x18	S.S. SATIN EXTRA HEAVY DUTY SURFACE MOUNTED
TA-10	1	BOBRICK B-6777, SATIN FINISH STAINLESS STEEL TOWEL PIN	BOBRICK WASHROOM EQUIPMENT, INC.	B-6777	S.S. SATIN FIN.
TA-11	1	BOBRICK B-207x60, SHOWER CURTAIN ROD/CONCEALED MOUNT	BOBRICK WASHROOM EQUIPMENT, INC.	B-207x60	S.S. SATIN FIN.
TA-12	1	BOBRICK B-40, SURFACE MOUNTED SOAP DISPENSER	BOBRICK WASHROOM EQUIPMENT, INC.	B-40 (ADA)	POLYETHYLENE FIN.(BLACK)

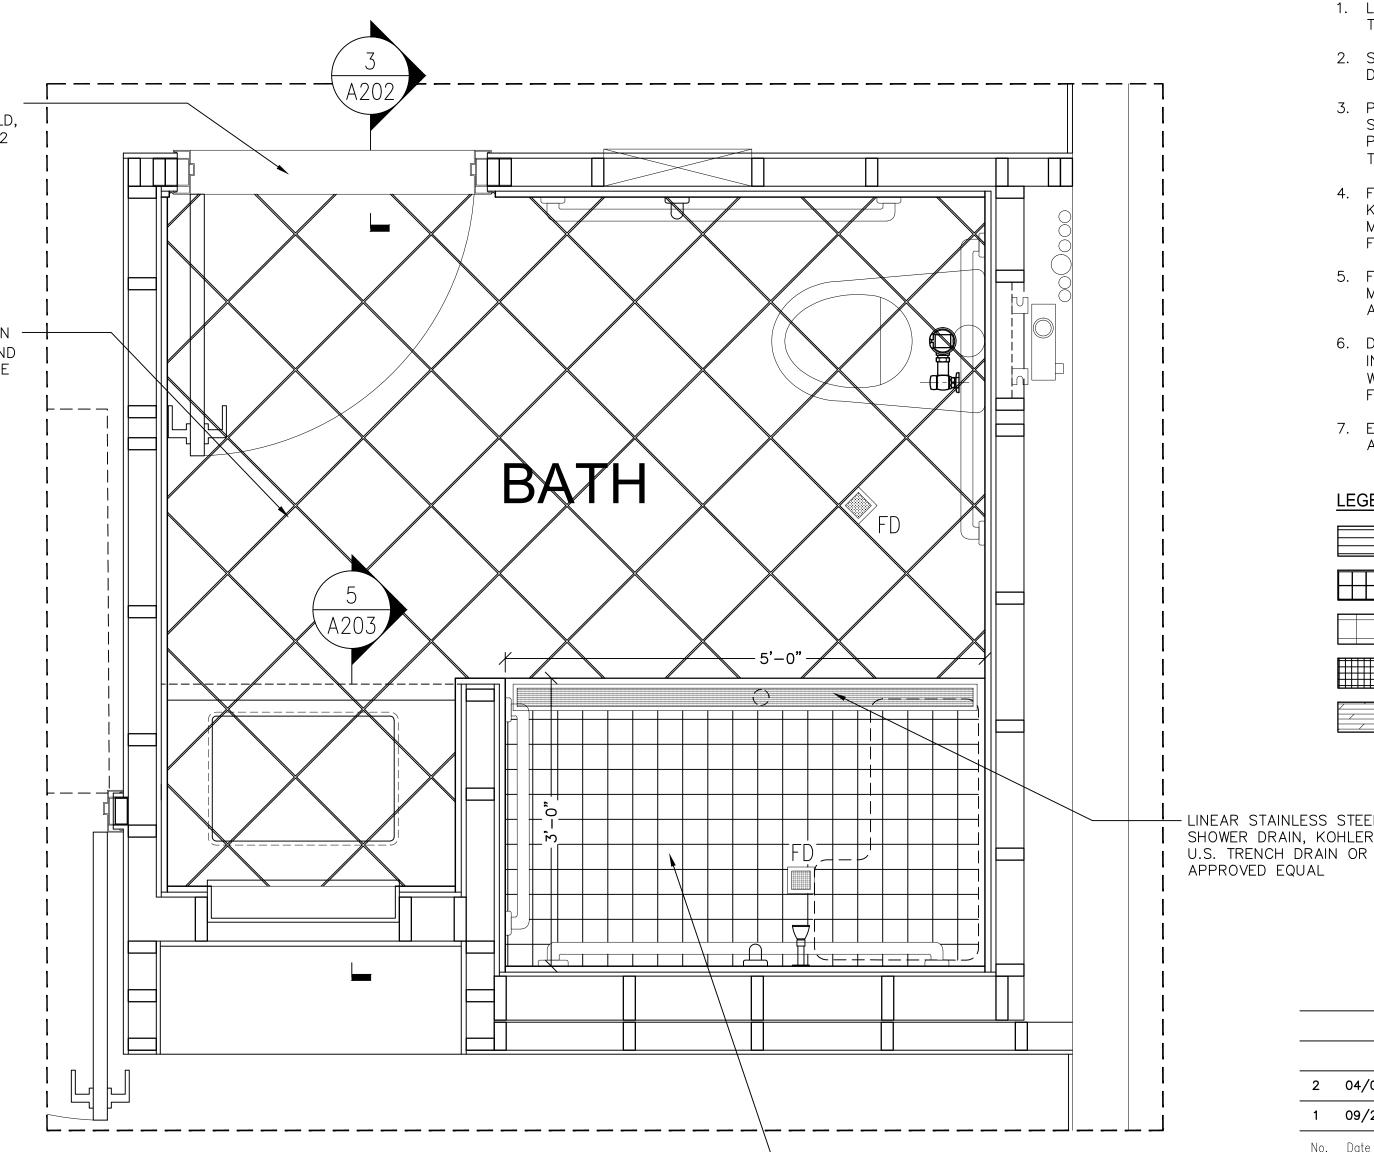

2 \ ADA BATHROOM PLAN - FLOOR TILES

A202 / 0 6" 1'

SCALE: 1" = 1'-0"

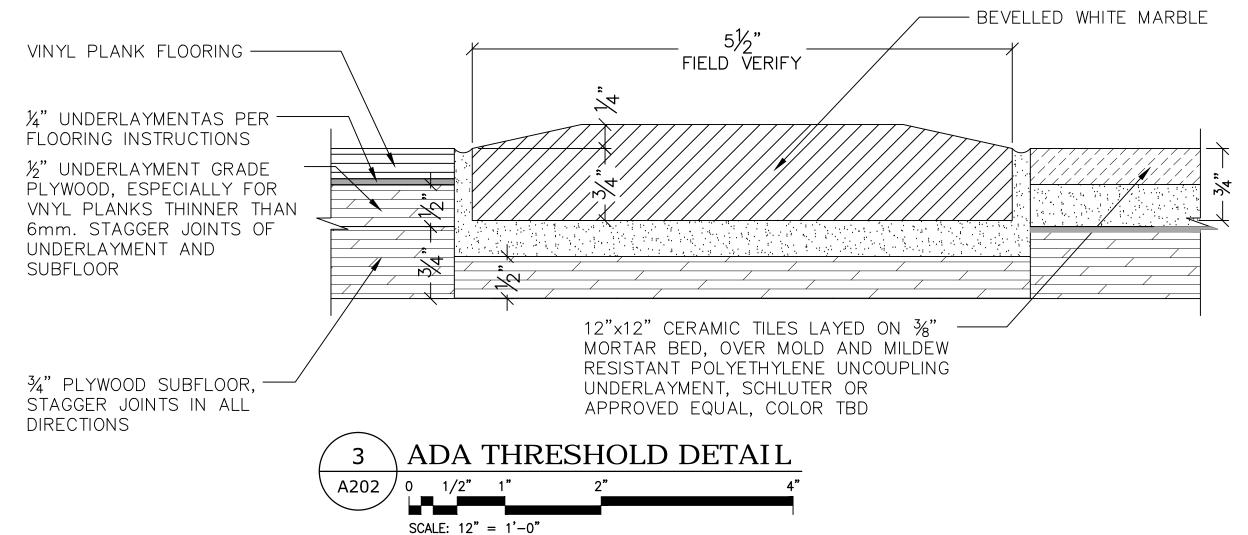


NOTES

- 1. LEVEL SUBFLOOR AS REQUIRED PRIOR TO INSTALLING FINISH FLOOR.
- 2. STAGGER SUBFLOOR JOINTS IN BOTH DIRECTIONS.
- 3. PROVIDE COLOR SAMPLES AND FULL SIZE TILE SAMPLES FOR APPROVAL PRIOR TO INSTALLATION OF TILES/VINYL PLANKS.
- 4. FOR SHOWER AREA, BATHROOM AND KITCHEN WALLS, USE SCHLUTER KERDI MEMBRANE, CORNER STRIPS AND FIXTURE AND FAUCET SEALS.
- 5. FOR BATHROOM FLOOR UNCOUPLING MEMBRANE, USE SCHLUTER DITRA OR APPROVED EQUAL.
- 6. DOOR STOP IN BATHROOM, TO BE INSTALLED ON BASEBOARD/TILED WALL. DO NOT INSTALL ON FINISH FLOOR.
- 7. ELECTRICAL RECEPTACLES NEAR WET AREA TO BE GFCI OUTLETS.

#### <u>LEGEND</u>



12"x12" CERAMIC FLOOR TILES (BATHROOM)

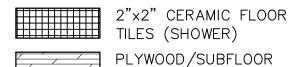

LINEAR STAINLESS STEEL SHOWER DRAIN, KOHLER,

- 2"x2" MOSAIC/CERAMIC TILES LAYED ON

MEMBRANE UNDERLAYMENT, SCHLUTER OR APPROVED EQUAL

3/8" MORTAR BED, OVER WATERPROOFING

2 04/06/2023 100% SUBMISSION

1 09/24/2022 80% SUBMISSION

No. Date Revision

#### AFRIDI ASSOCIATES **CONSULTING ENGINEERS**

19 West 21st Street 510 Broadhollow Road

New York, NY 10010 Melville, NY 11747 Tel: (212) 243-0725 Tel: (631) 465-0786 Fax: (212) 243-0725 Fax: (631) 465-0788

aafridi@afridiassociates.com

## **LIZARDOS**

LONG ISLAND | NEW YORK CITY | CHARLOTTE | DANBURY

200 Old Country Road | Suite 670 Mineola | NY 11501 516 484 1020 Lizardos.com

Lizardos Engineering Associates D.P.C.

Designer:	AKBER AFRIDI, P.E.
Drawn by:	AZHER MALIK
Checked by:	AKBER AFRIDI, P.E.

### INTERIOR RENOVATIONS OF THE COMMONS APARTMENTS 10.1 (ADA COMPLIANT) & 10.3

Address:

735 Anderson Hill Road Purchase NY 10577

Drawing Title: **ENLARGED BATHROOM PLANS ADA APARTMENT 10.1** 

> Drawing No.: A202.00


> > Scale: AS NOTED


Date:

SU-040623

08/24/2020



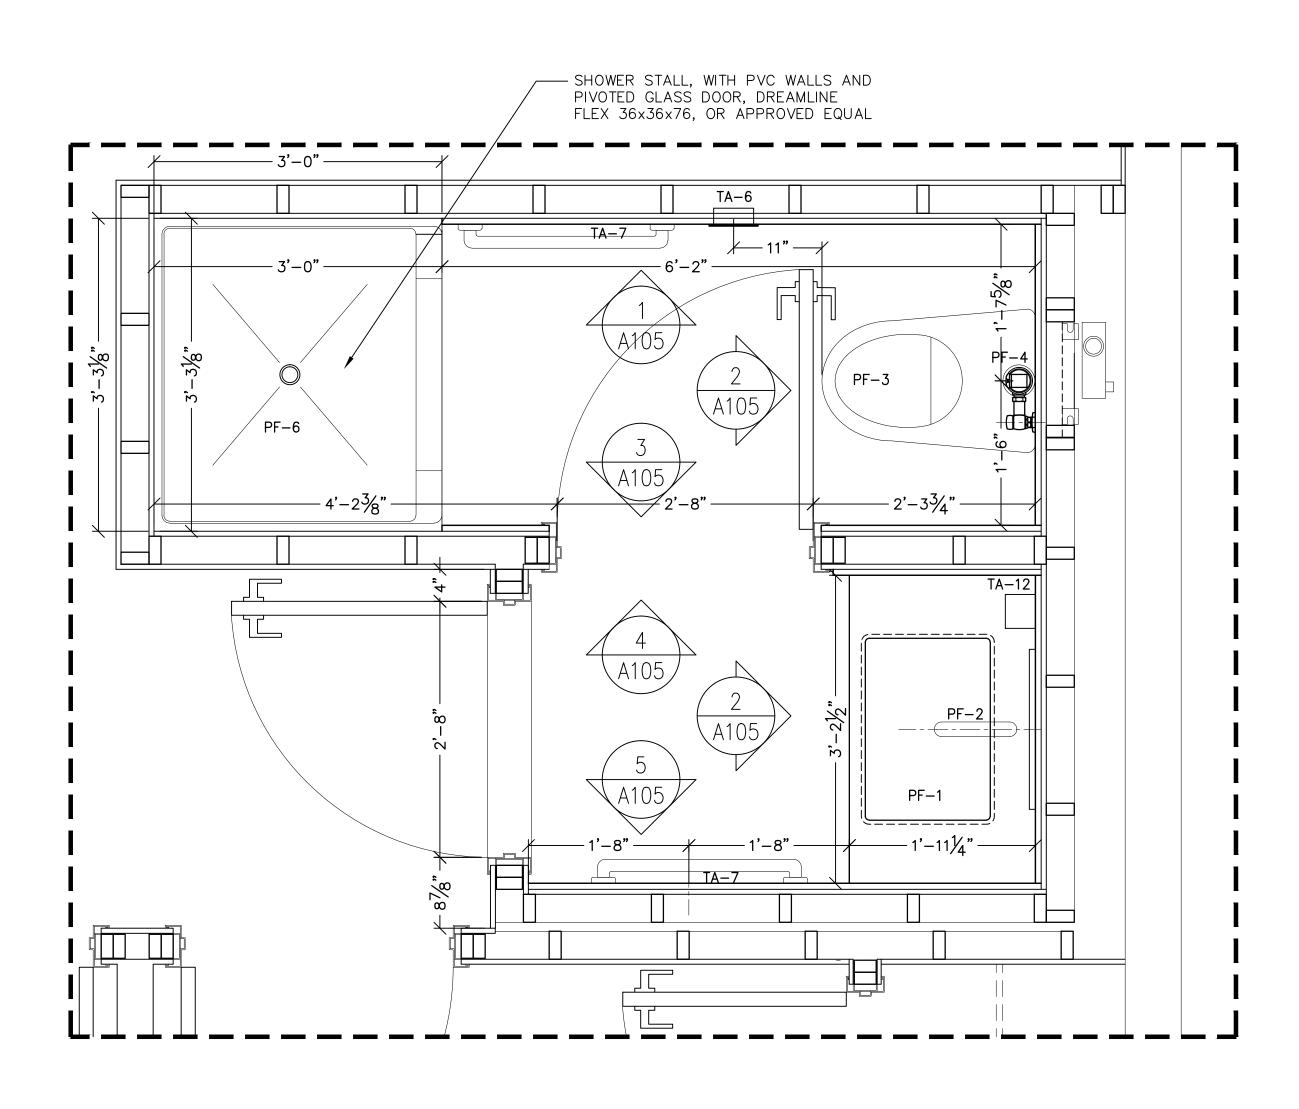


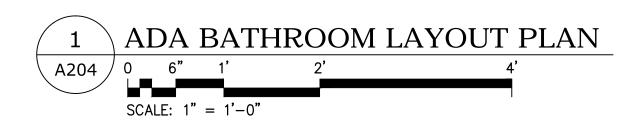

APA	RTM	ENT 10.1 PLUMBING FIXTURE SCHEDULE			
MARK	QTY	DESCRIPTION	MANUFACTURER	MODEL	REMARKS
PF-1	1	'STUDIO' UNDERCOUNTER SINK, VITREOUS CHINA	AMERICAN STANDARD	STUDIO - 0618.300	GLAZED UNDERSIDE
PF-1K	1	'RUVATI' MODENA UNDERMOUNT 20 1/2"x17 3/4" BRUSHED SS SINK (16 GAUGE)	RUVATI	MODENA	
PF-2	1	'MONTERREY' TWO HANDLE 8" WIDESPREAD LAVATORY FAUCET	AMERICAN STANDARD	MONTERREY - 6500.170	
PF-2K	1	'HYDROLOCK' SINGLE HANDLE HIGH ARC PULL DOWN KITCHEN FAUCET	MOEN	CA87094 SERIES	
PF-3	1	'MODERA' FLOWISE 16 1/2" (FLUSHOMETER TOILET), 1.28 GPF	AMERICAN STANDARD		
PF-4	1	'SOLIS' SLOAN BATTERY/SOLAR POWERED DUAL FLUSH (8111-1.6/1.1)	SLOAN	8111-1.6/1.1	
PF-5	1	'M-DURA' COMMERCIAL THREE-FUNCTION SHOWER SYSTEM	MOEN	T9342	
PF-6	1	36Dx36Lx76 3/4 H SEMI FRAMLESS DOOR, BASE/BACKWALLS, SATIN CHROME	DREAMLINE	DL-6218C-04CL FLEX	

NOTE: STANDARD CAMPUS WIDE FIXTURES, FINISHES AND OPERATION, G.C. TO COORDINATE.

MARK	QTY	DESCRIPTION	MANUFACTURER	MODEL	REMARKS
TA-1		BOBRICK B-5806.99x18 STRAIGHT PEENED GRAB BAR	BOBRICK WASHROOM EQUIPMENT, INC.	B-5806.99x18	S.S. SATIN EXTRA HEAVY DUTY SURFACE MOUNTED
TA-2		BOBRICK B-5806.99x24 STRAIGHT PEENED GRAB BAR	BOBRICK WASHROOM EQUIPMENT, INC.	B-5806.99x24	S.S. SATIN EXTRA HEAVY DUTY SURFACE MOUNTED
TA-3		BOBRICK B-5806.99x36 STRAIGHT PEENED GRAB BAR	BOBRICK WASHROOM EQUIPMENT, INC.	B-5806.99x36	S.S. SATIN EXTRA HEAVY DUTY SURFACE MOUNTED
TA-4		BOBRICK B-5806.99x42 STRAIGHT PEENED GRAB BAR	BOBRICK WASHROOM EQUIPMENT, INC.	B-5806.99x42	S.S. SATIN EXTRA HEAVY DUTY SURFACE MOUNTED
TA-5		BOBRICK B-5806.99x48 STRAIGHT PEENED GRAB BAR	BOBRICK WASHROOM EQUIPMENT, INC.	B-5806.99x48	S.S. SATIN EXTRA HEAVY DUTY SURFACE MOUNTED
TA-6	1	BOBRICK COMMERCIAL TOILET PAPER DISPENSER	BOBRICK WASHROOM EQUIPMENT, INC.	B-6677	S.S. SATIN FIN.
TA-7	1	KOHLER, MEDICINE CABINET, RECESSED-MOUNTED	KOHLER	CATALAN	ANODIZED ALUMINUM (20 1/8"x36 1/8")
TA-8	1	BOBRICK B-542, SATIN FINISH STAINLESS STEEL COAT HOOK	BOBRICK WASHROOM EQUIPMENT, INC.	B-9542	S.S. SATIN FIN.
TA-9	2	BOBRICK B-530x18, TOWEL BAR	BOBRICK WASHROOM EQUIPMENT, INC.	B-530x18	S.S. SATIN EXTRA HEAVY DUTY SURFACE MOUNTED
TA-10		BOBRICK B-6777, SATIN FINISH STAINLESS STEEL TOWEL PIN	BOBRICK WASHROOM EQUIPMENT, INC.	B-6777	S.S. SATIN FIN.
TA-11		BOBRICK B-207x60, CLOSET ROD/CONCEALED MOUNT	BOBRICK WASHROOM EQUIPMENT, INC.	B-207x60	S.S. SATIN FIN.
TA-12	1	BOBRICK B-40, SURFACE MOUNTED SOAP DISPENSER	BOBRICK WASHROOM EQUIPMENT, INC.	B-40 (ADA)	POLYETHYLENE FIN.(BLACK)

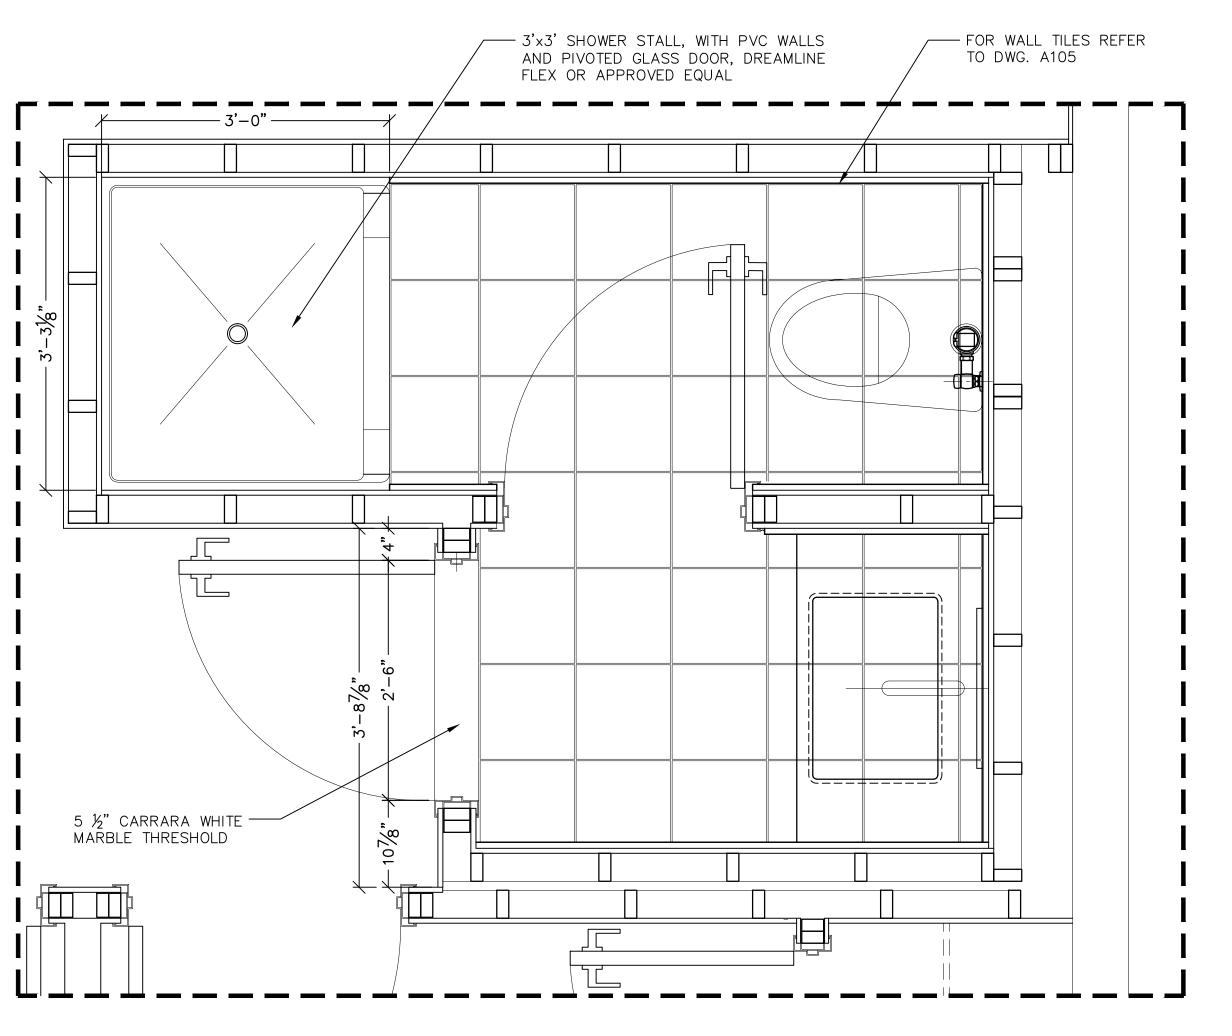



#### NOTES

- 1. LEVEL SUBFLOOR AS REQUIRED PRIOR TO INSTALLING FINISH FLOOR.
- 2. STAGGER SUBFLOOR JOINTS IN BOTH DIRECTIONS.
  - 3. PROVIDE COLOR SAMPLES AND FULL SIZE TILE SAMPLES FOR APPROVAL PRIOR TO INSTALLATION OF TILES/VINYL PLANKS.
  - 4. FOR SHOWER AREA, BATHROOM AND KITCHEN WALLS, USE SCHLUTER KERDI MEMBRANE, CORNER STRIPS AND FIXTURE AND FAUCET SEALS.
  - 5. FOR BATHROOM FLOOR UNCOUPLING MEMBRANE, USE SCHLUTER DITRA OR APPROVED EQUAL.
  - 6. DOOR STOP IN BATHROOM, TO BE INSTALLED ON BASEBOARD/TILED WALL. DO NOT INSTALL ON FINISH FLOOR.
- 7. ELECTRICAL RECEPTACLES NEAR WET AREA TO BE GFCI OUTLETS.

TI VINYL FLOOR PLANK (VF-01)12"x12" CERAMIC

12"x12" CERAMIC TILES (KITCHEN)

12"x12" CERAMIC FLOTILES (BATHROOM) 12"x12" CERAMIC FLOOR

PLYWOOD/SUBFLOOR

2 04/06/2023 100% SUBMISSION

1 09/24/2022 80% SUBMISSION

No. Date Revision

### AFRIDI ASSOCIATES

CONSULTING ENGINEERS 510 Broadhollow Road

19 West 21st Street New York, NY 10010 Tel: (212) 243-0725 Fax: (212) 243-0725

Melville, NY 11747 Tel: (631) 465-0786 Fax: (631) 465-0788

aafridi@afridiassociates.com

LONG ISLAND | NEW YORK CITY | CHARLOTTE | DANBURY

200 Old Country Road | Suite 670 Mineola | NY 11501 516 484 1020 Lizardos.com

Lizardos Engineering Associates D.P.C.

AKBER AFRIDI, P.E. Designer: AZHER MALIK Drawn by: AKBER AFRIDI, P.E. Checked by:

INTERIOR RENOVATIONS OF THE COMMONS APARTMENTS 10.1 (ADA COMPLIANT) & 10.3


Address: 735 Anderson Hill Road Purchase NY 10577


Drawing Title: **ENLARGED BATHROOM PLANS APARTMENT 10.3** 


> Drawing No.: A204.00

Scale: AS NOTED

SU-040623

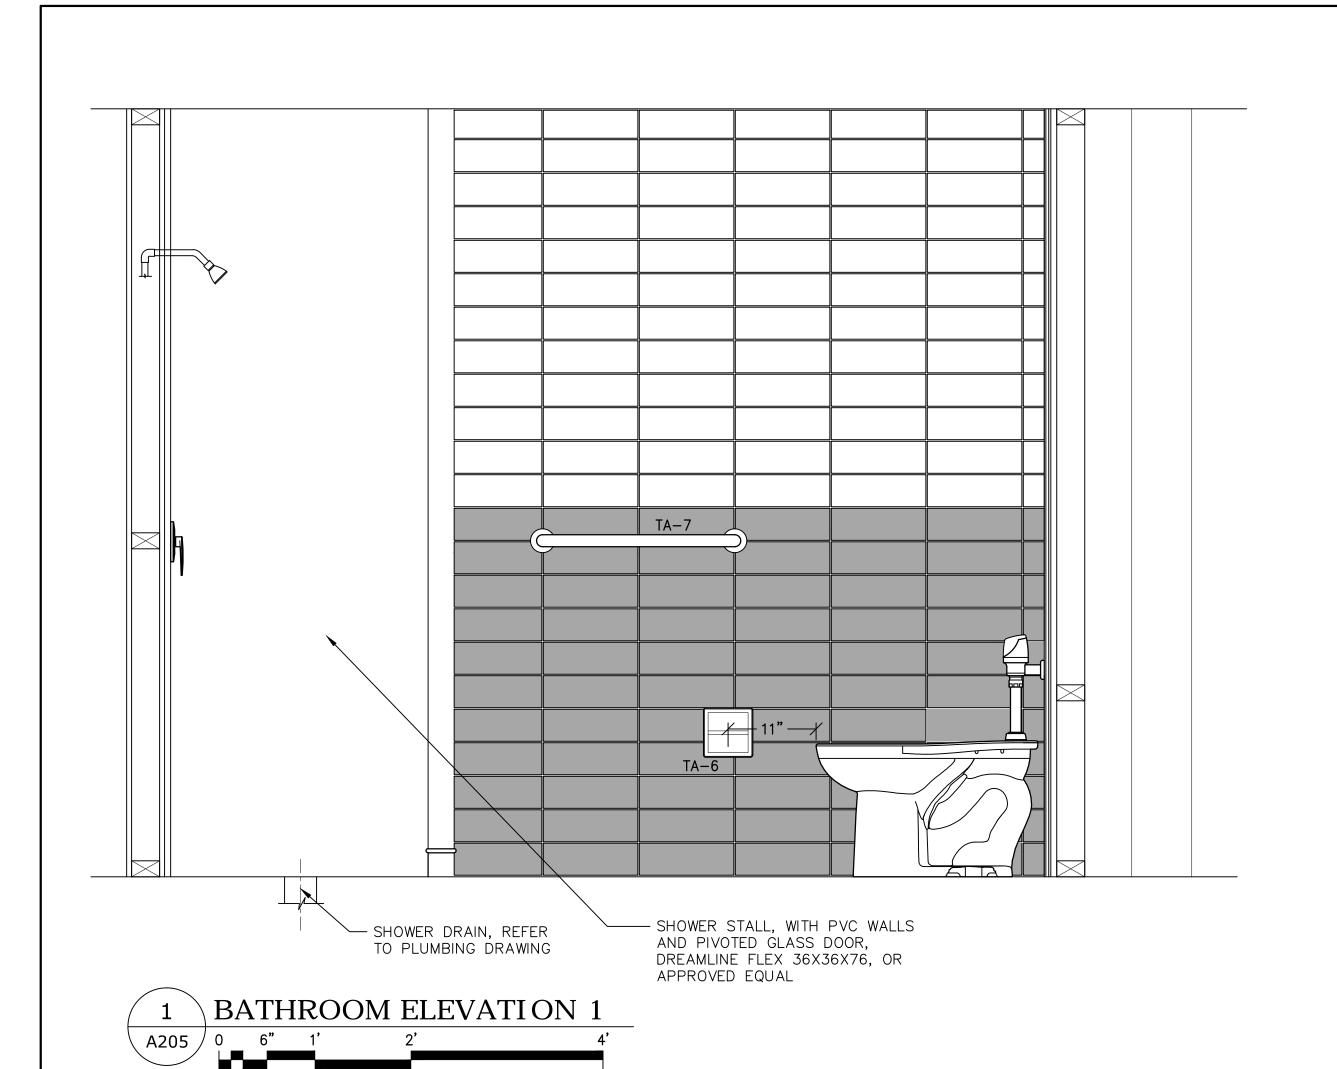


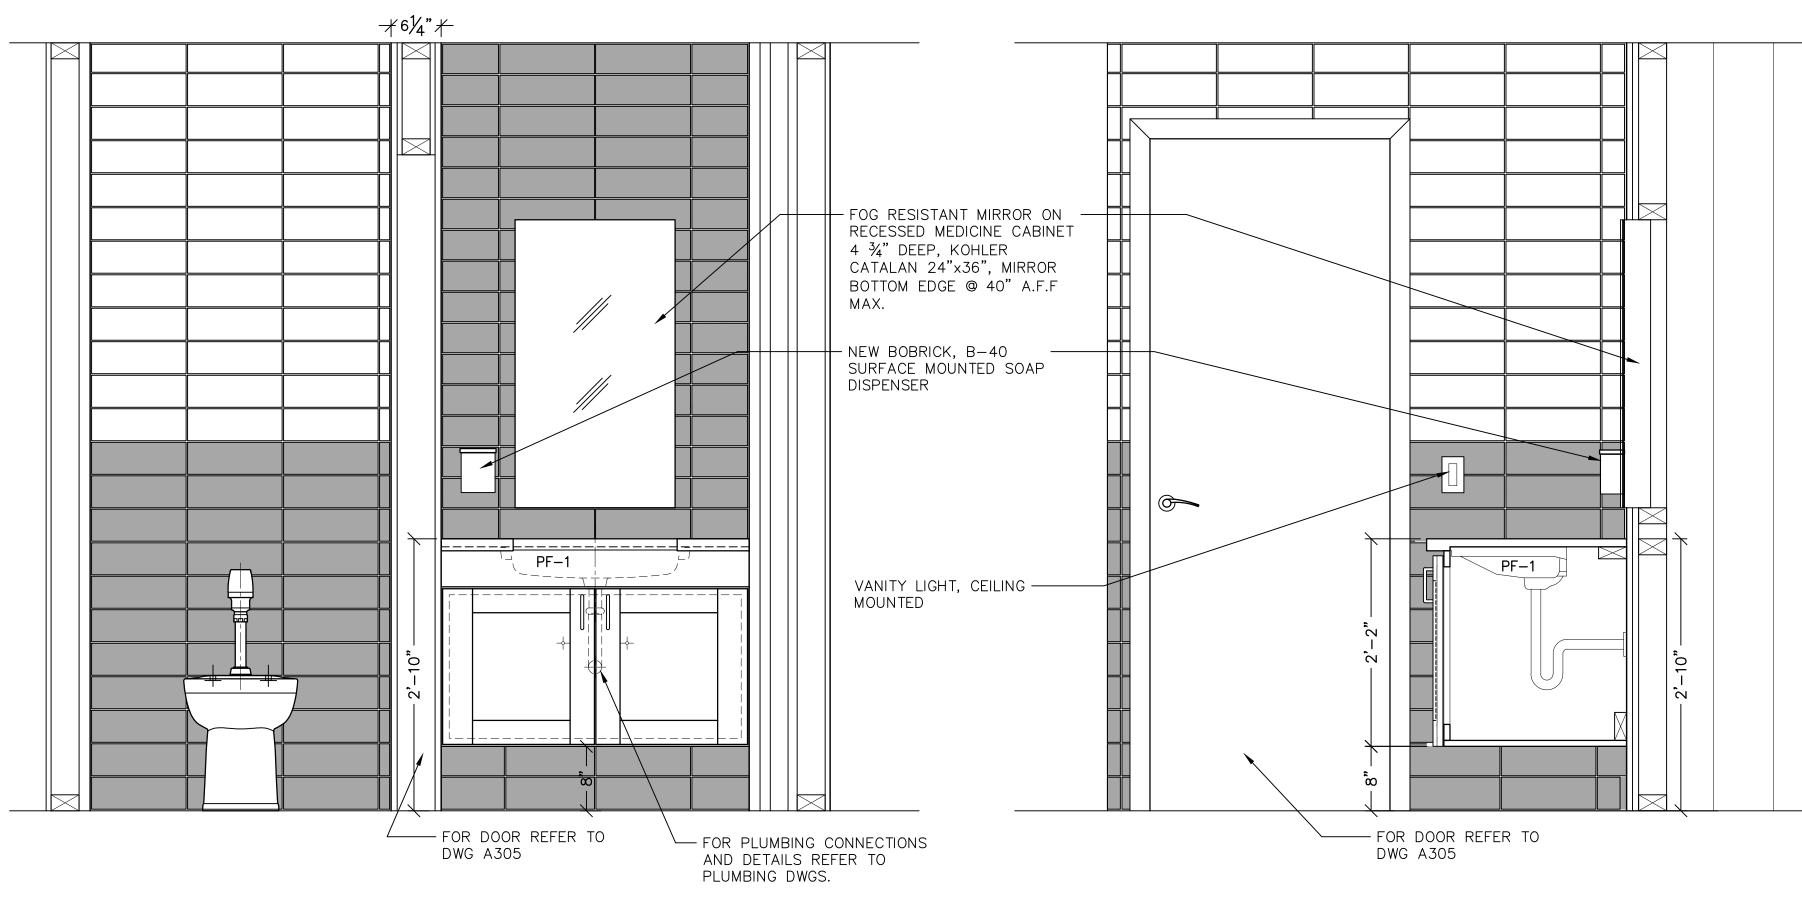


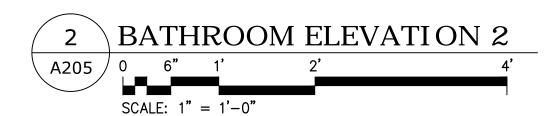

5 BATHROOM ELEVATION 6


SCALE:  $1" = \overline{1'-0"}$ 

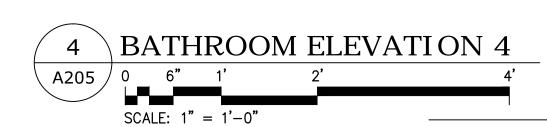

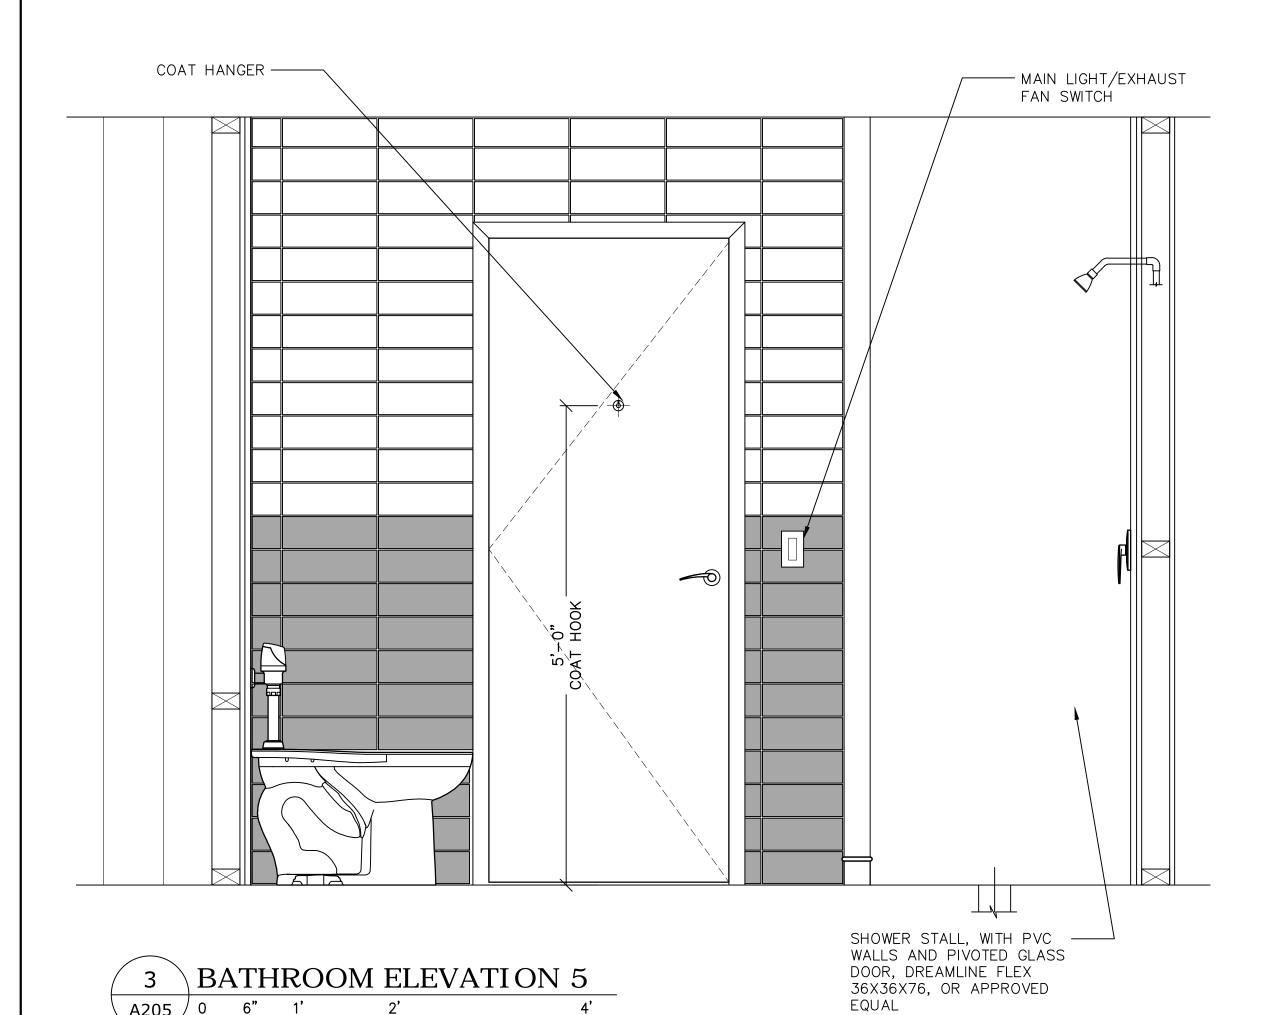

SCALE: 1" = 1'-0"

SCALE: 1" = 1'-0"

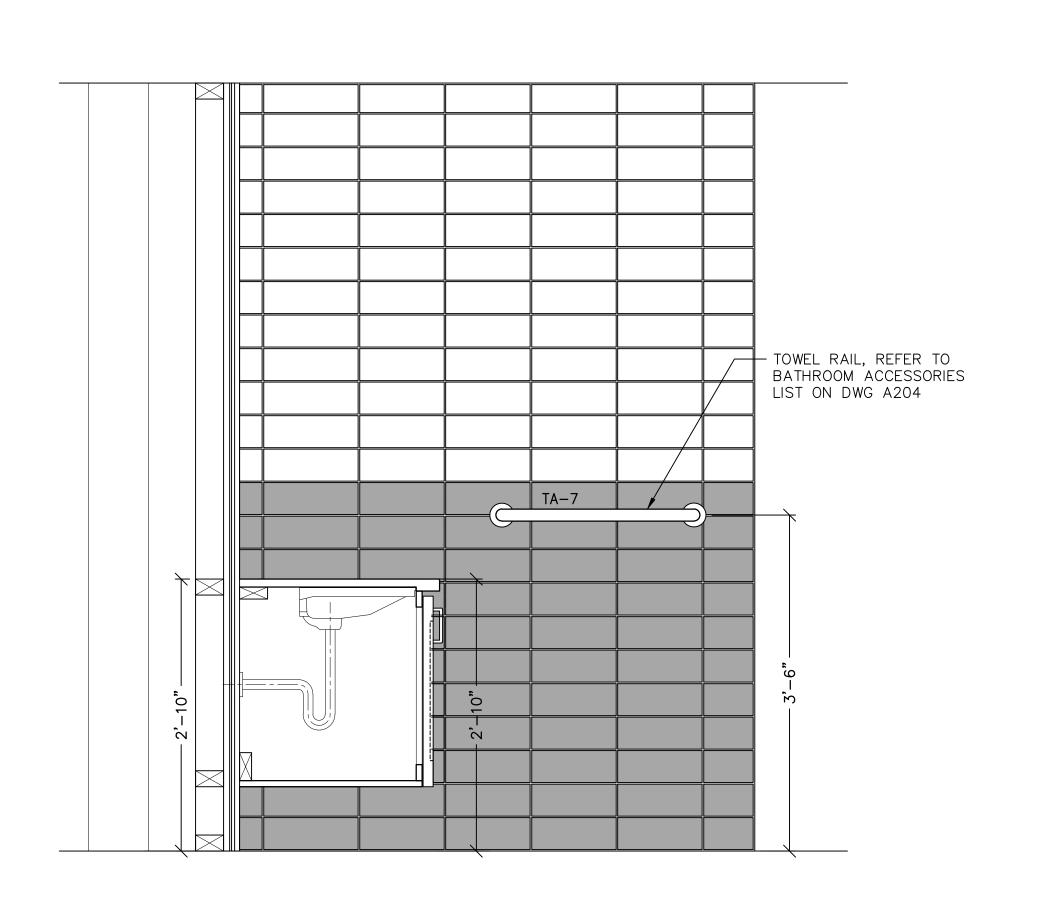

CONSULTING ENGINEERS 19 West 21st Street New York, NY 10010 Tel: (212) 243-0725 Fax: (212) 243-0725 aafridi@afridiassociates.com **LIZARDOS** LONG ISLAND | NEW YORK CITY | CHARLOTTE | DANBURY 200 Old Country Road | Suite 670 Mineola | NY 11501 516 484 1020 Lizardos.com Lizardos Engineering Associates D.P.C. AKBER AFRIDI, P.E. Designer: AZHER MALIK Drawn by: AKBER AFRIDI, P.E. Checked by: INTERIOR RENOVATIONS OF THE COMMONS APARTMENTS 10.1 (ADA COMPLIANT) & 10.3 Address: 735 Anderson Hill Road

Purchase NY 10577

Drawing Title:

No. Date

2 04/06/2023 100% SUBMISSION

1 09/24/2022 80% SUBMISSION

Revision

AFRIDI ASSOCIATES

510 Broadhollow Road

Melville, NY 11747

Tel: (631) 465-0786

Fax: (631) 465-0788

FINISHES, APARTMENT 10.3 Drawing No.: A205.00

BATHROOM WALL ELEVATIONS &

Scale: AS NOTED