
TOWN OF BLOOMING GROVE

LASSER PARK SENIOR CENTER CONTRACT 2: ENTRY PORCH, DECK, AND SITEWORK

AUGUST 2023

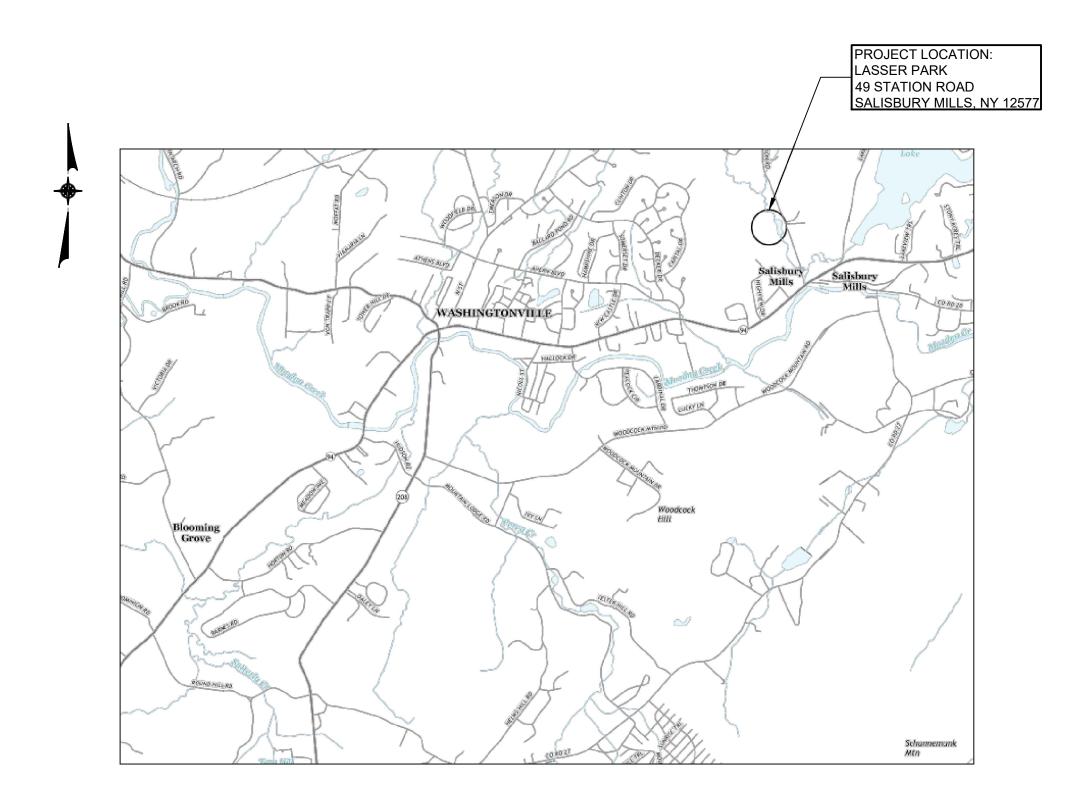

LOCATION MAP



DRAWING LIST

RAWING NO. DRAWING TITI

GENERAL

- COVER SHEET

G1 SYMBOLS AND ABBREVIATIONS

CIVIL

- C1 SITE PLAN
- C2 EROSION AND SEDIMENT CONTROL PLA
- 3 DETAILT
- C4 DETAIL
- C5 EROSION AND SEDIMENT CONTROL DETAILS

ARCHITECTURAL / STRUCTURAL

- 01 CODE ANALYSIS
- A1 CONSTRUCTION PLAN
- A2 FOUNDATION PLAN
 A3 EXTERIOR ELEVATIONS
- A4 SECTIONS AND DETAILS
- A5 SECTIONS AND DETAILS
- A6 SECTIONS AND DETAILS
- A7 SECTIONS AND DETAILS
- A8 FOUNDATION DETAILS
 A9 SECTIONS AND DETAILS
- A9 SECTIONS AND DETA

MECHANICAL


M1 FLOOR PLAN - BASEMENT

ELECTRICAL


- E1 SITE PLAN
- E2 FIRST FLOOR POWER AND LIGHTING PLAN
- E3 BASEMENT POWER PLAN
- BASEMENT LIGHTING PLAN
- 5 PANELBOARD SCHEDULES AND SINGLE LINE DIAGRAM
 6 WIRING DIAGRAMS AND DETAILS
- WIRING DIAGRAMS AND DI

PLUMBING


- P1 PLUMBING PLAN FIRST FLOOR
 P2 PLUMBING PLAN SECOND FLOOR
- P2 PLUIVIBING
- P4 DETAILS
- P5 DETAILS

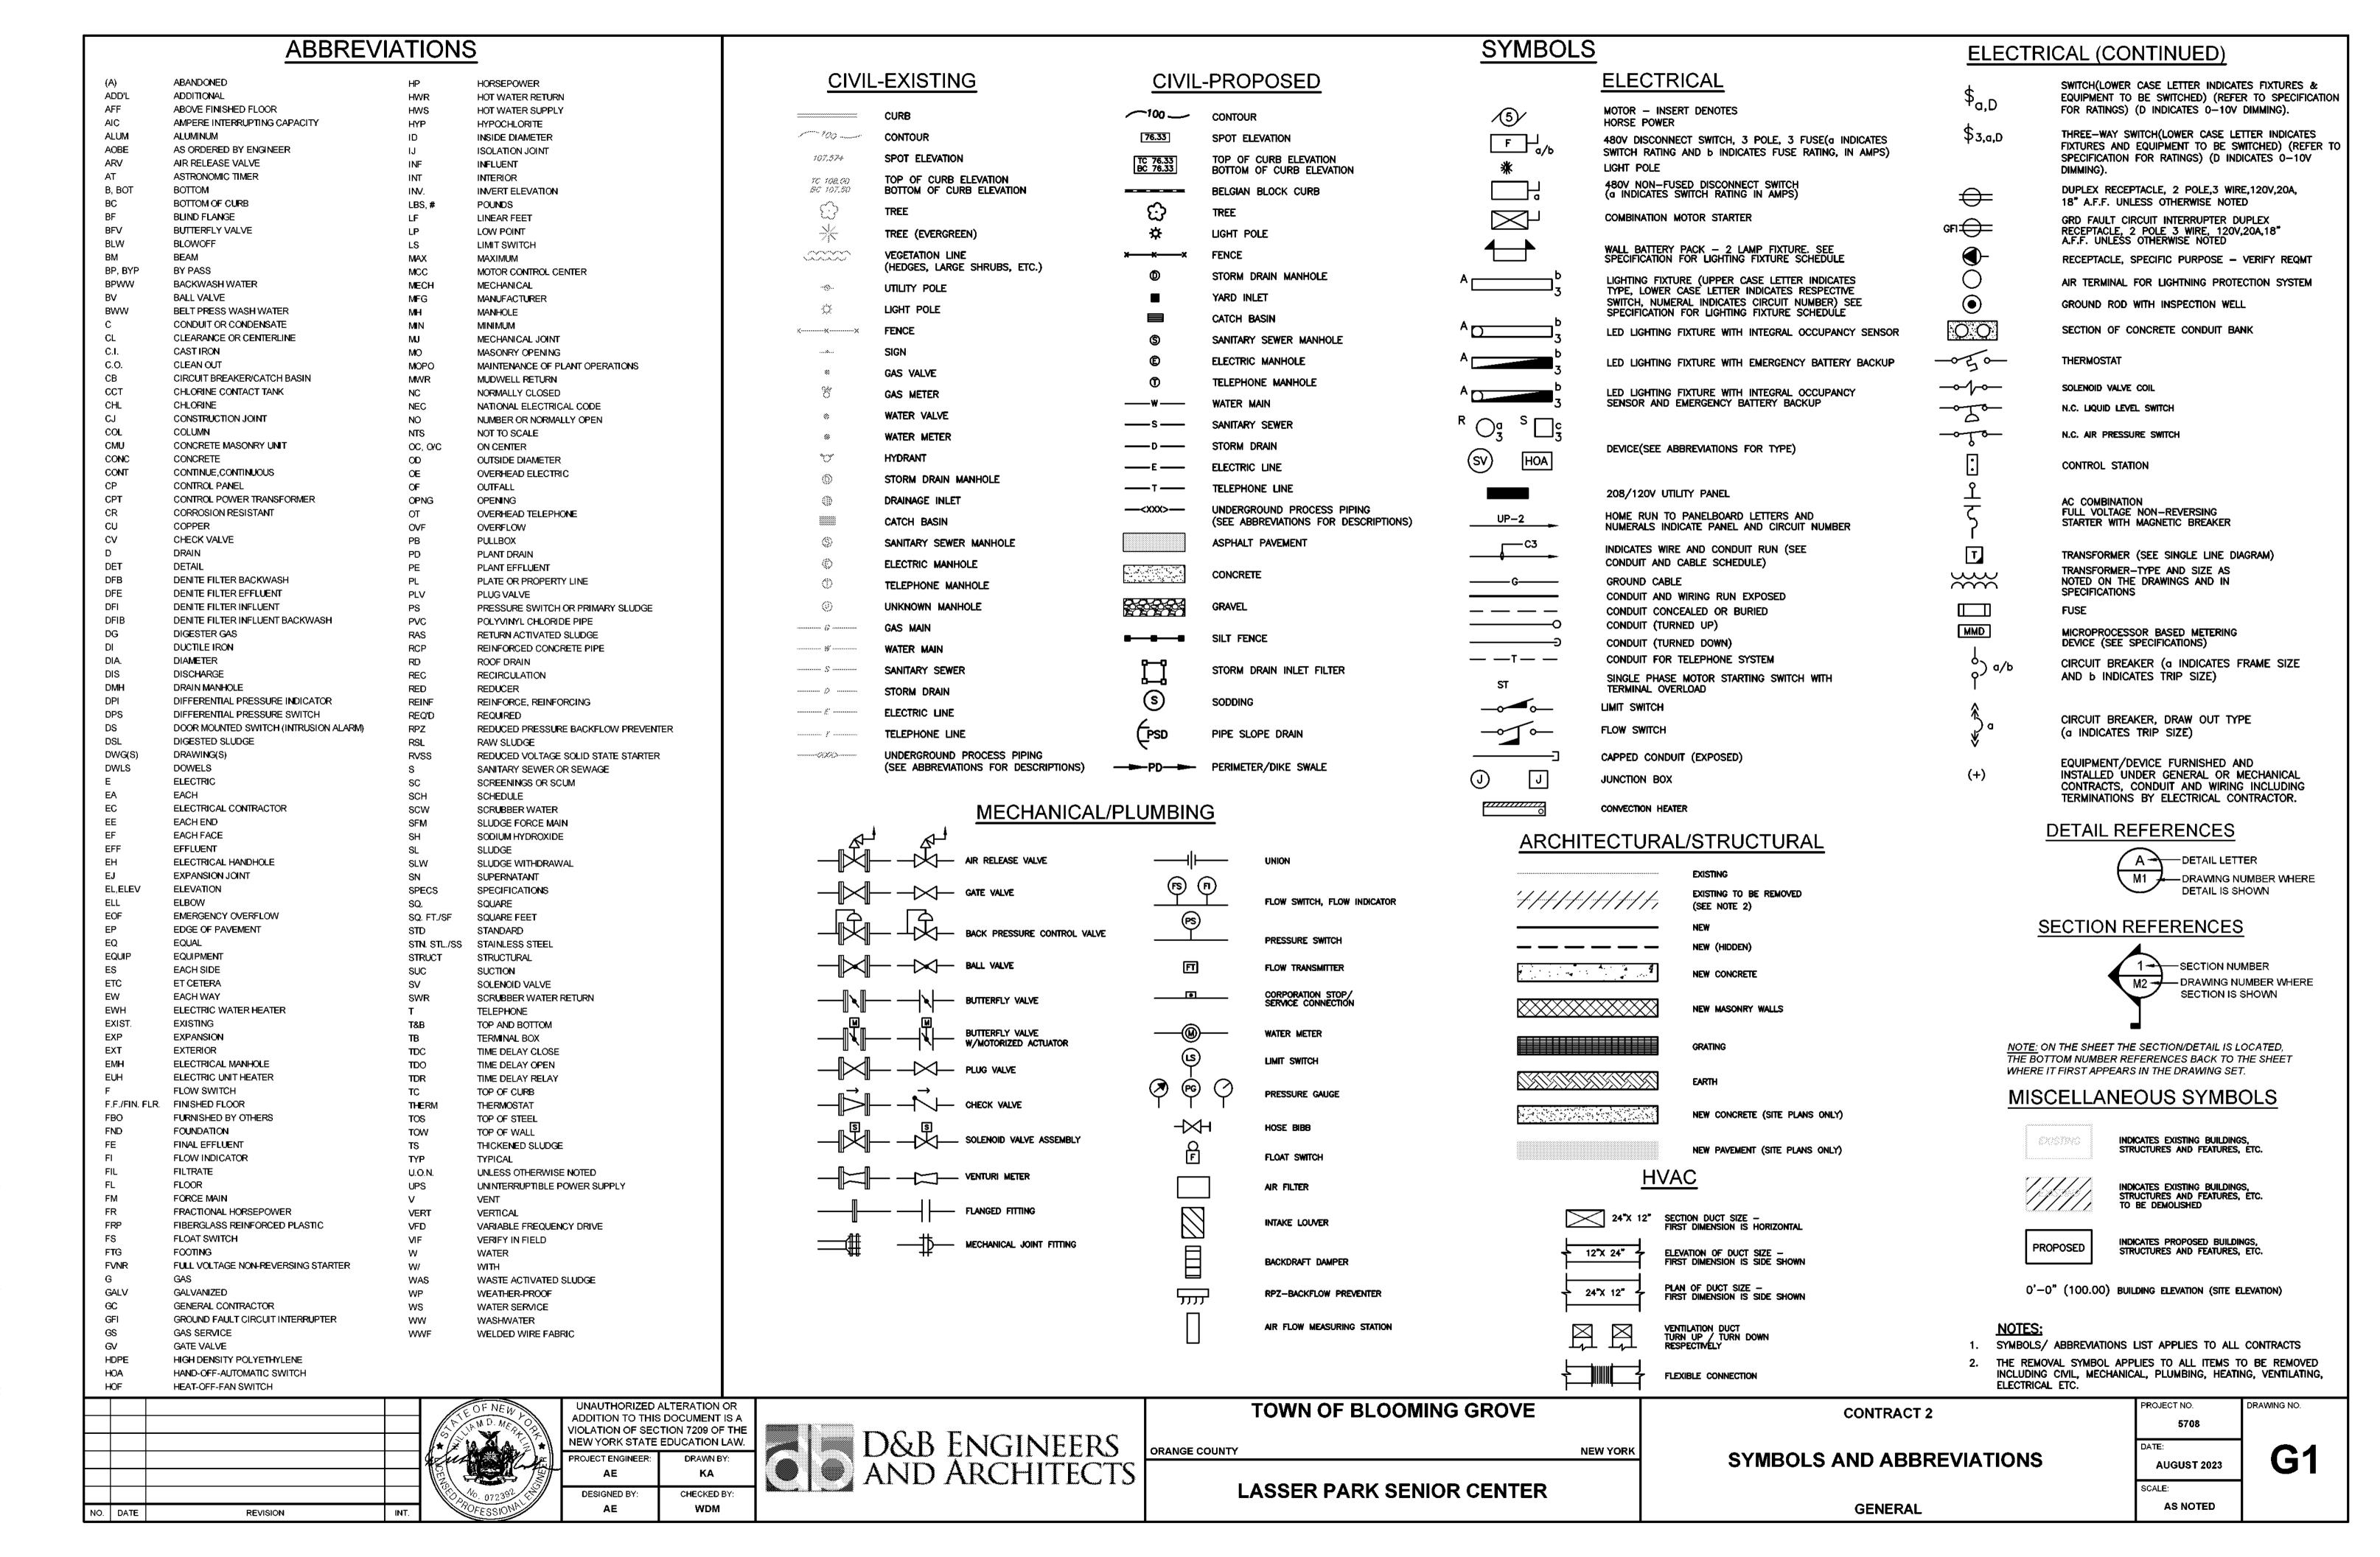



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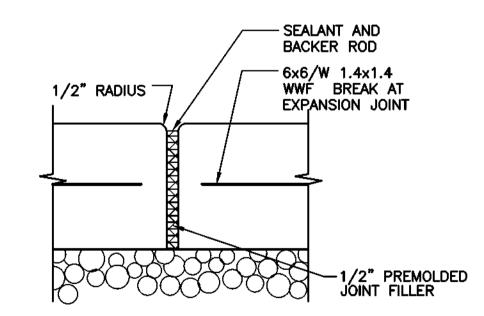


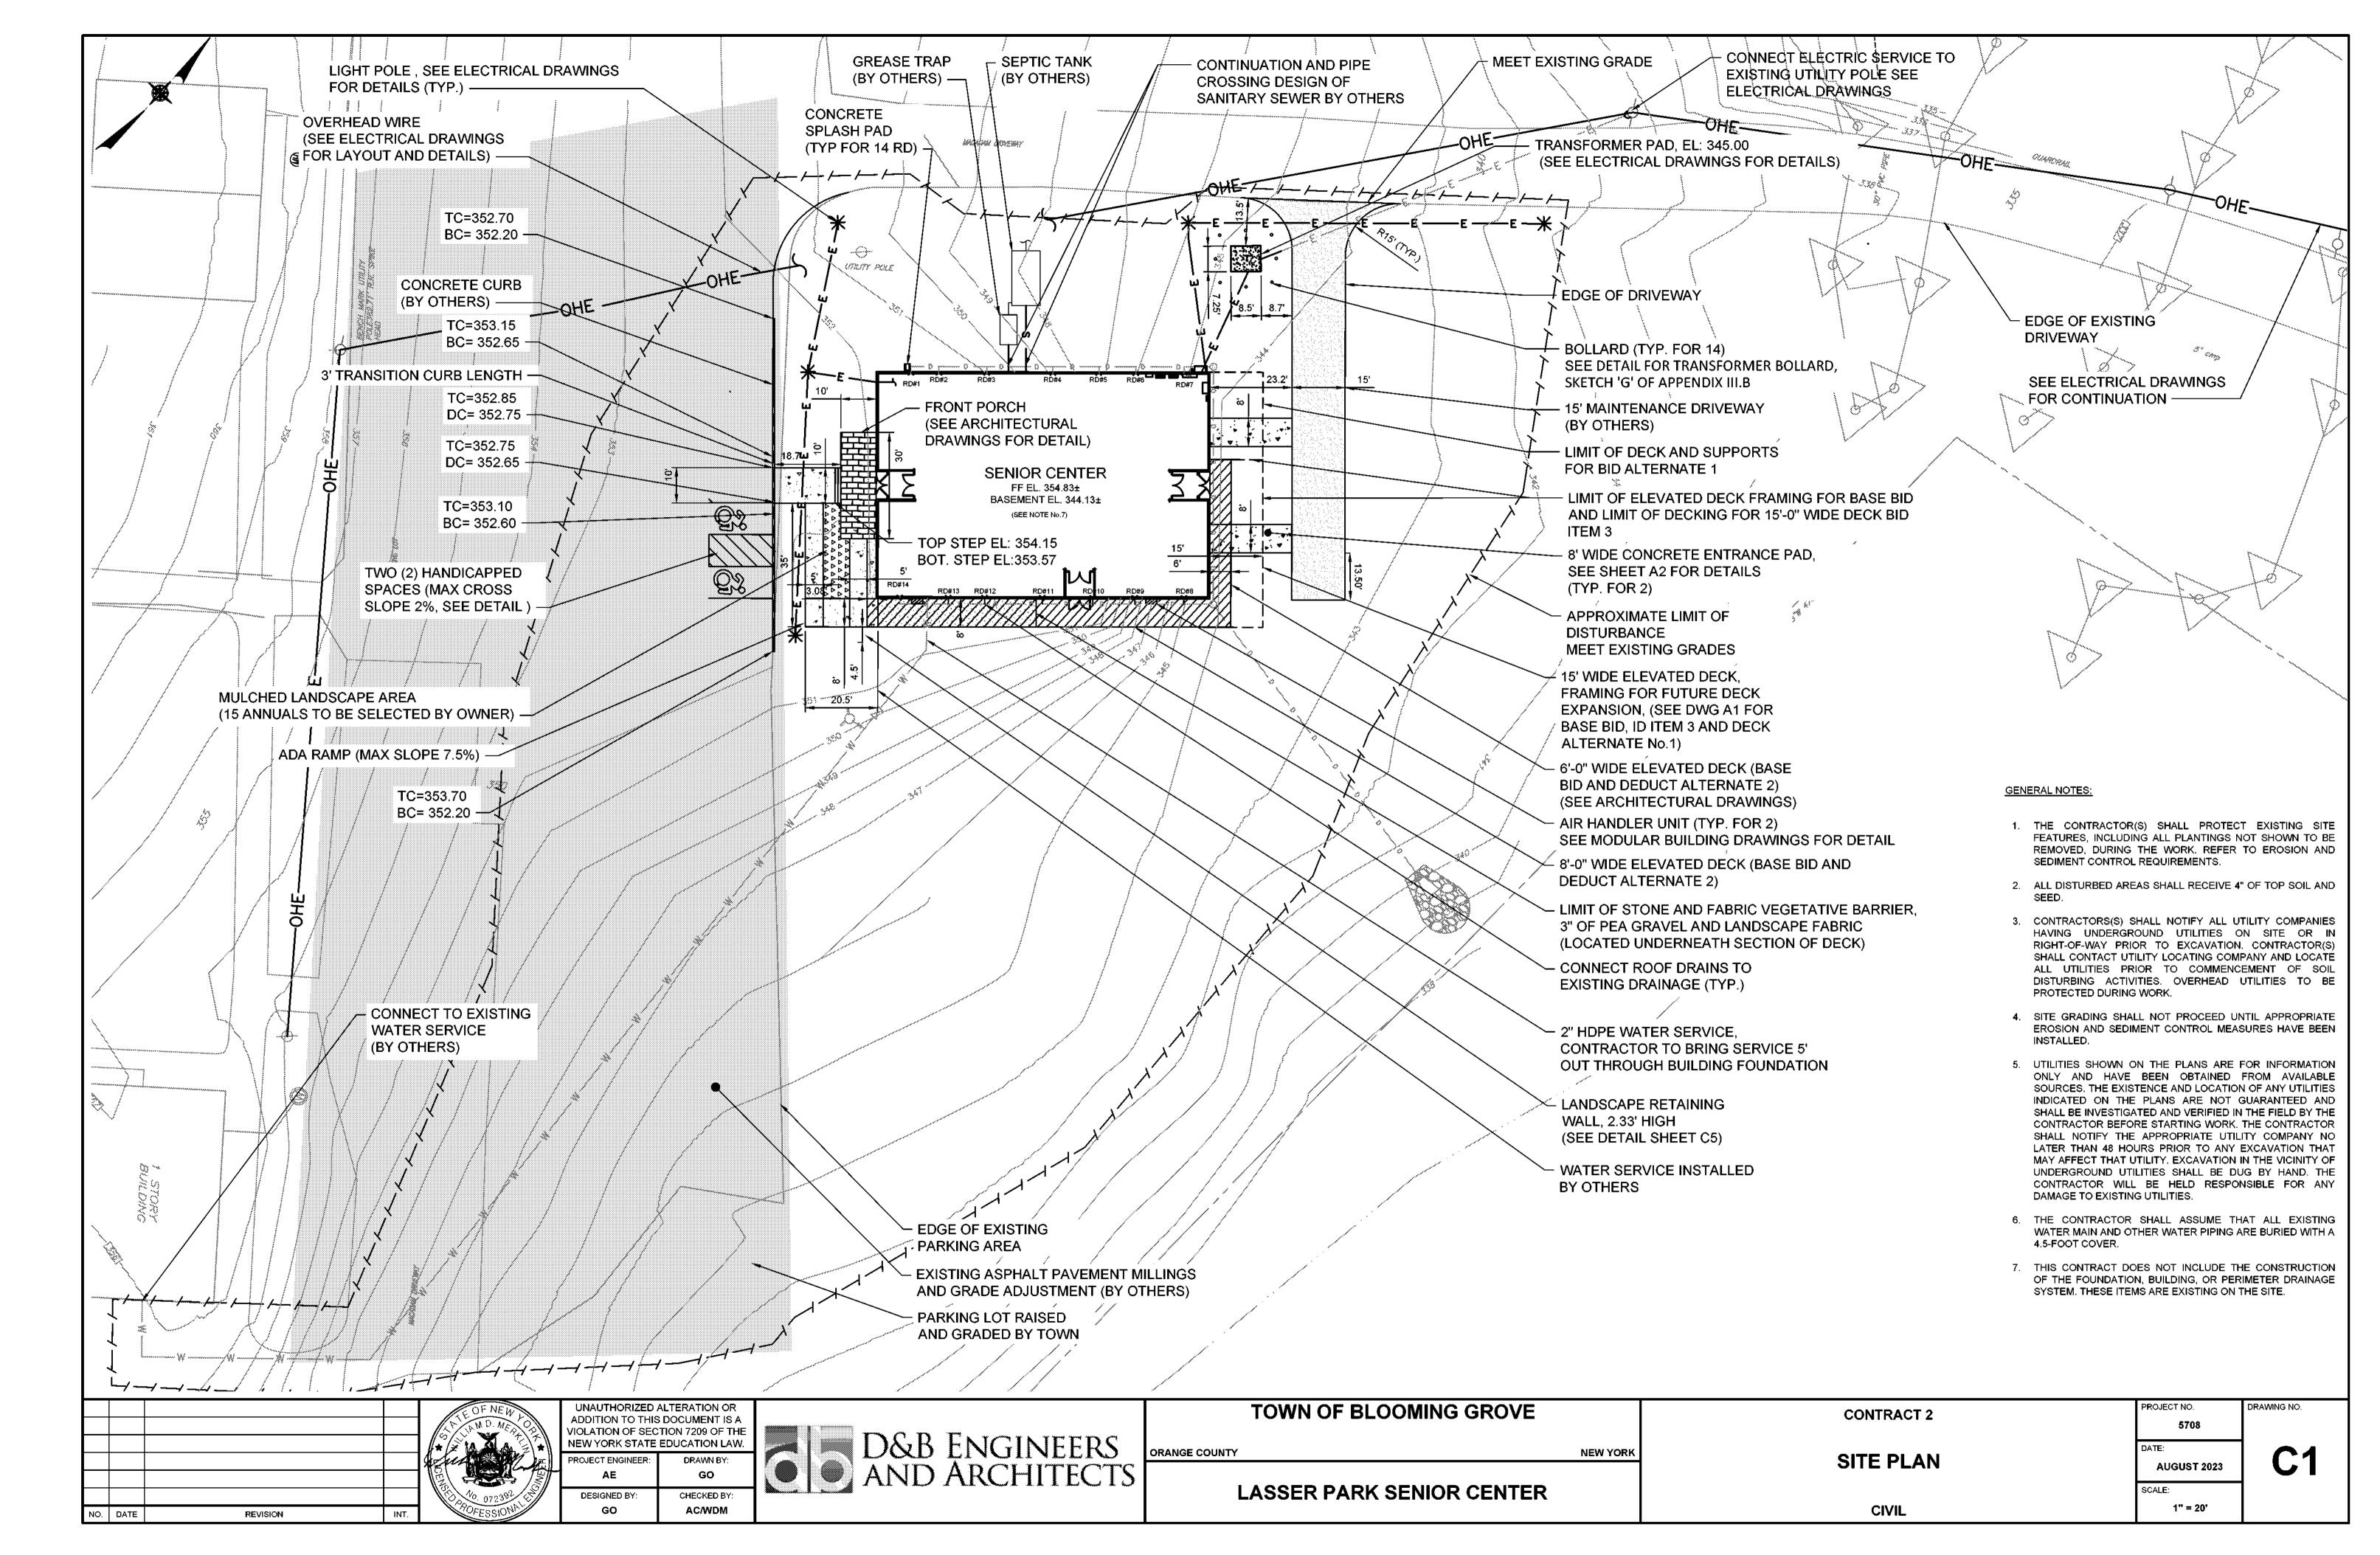

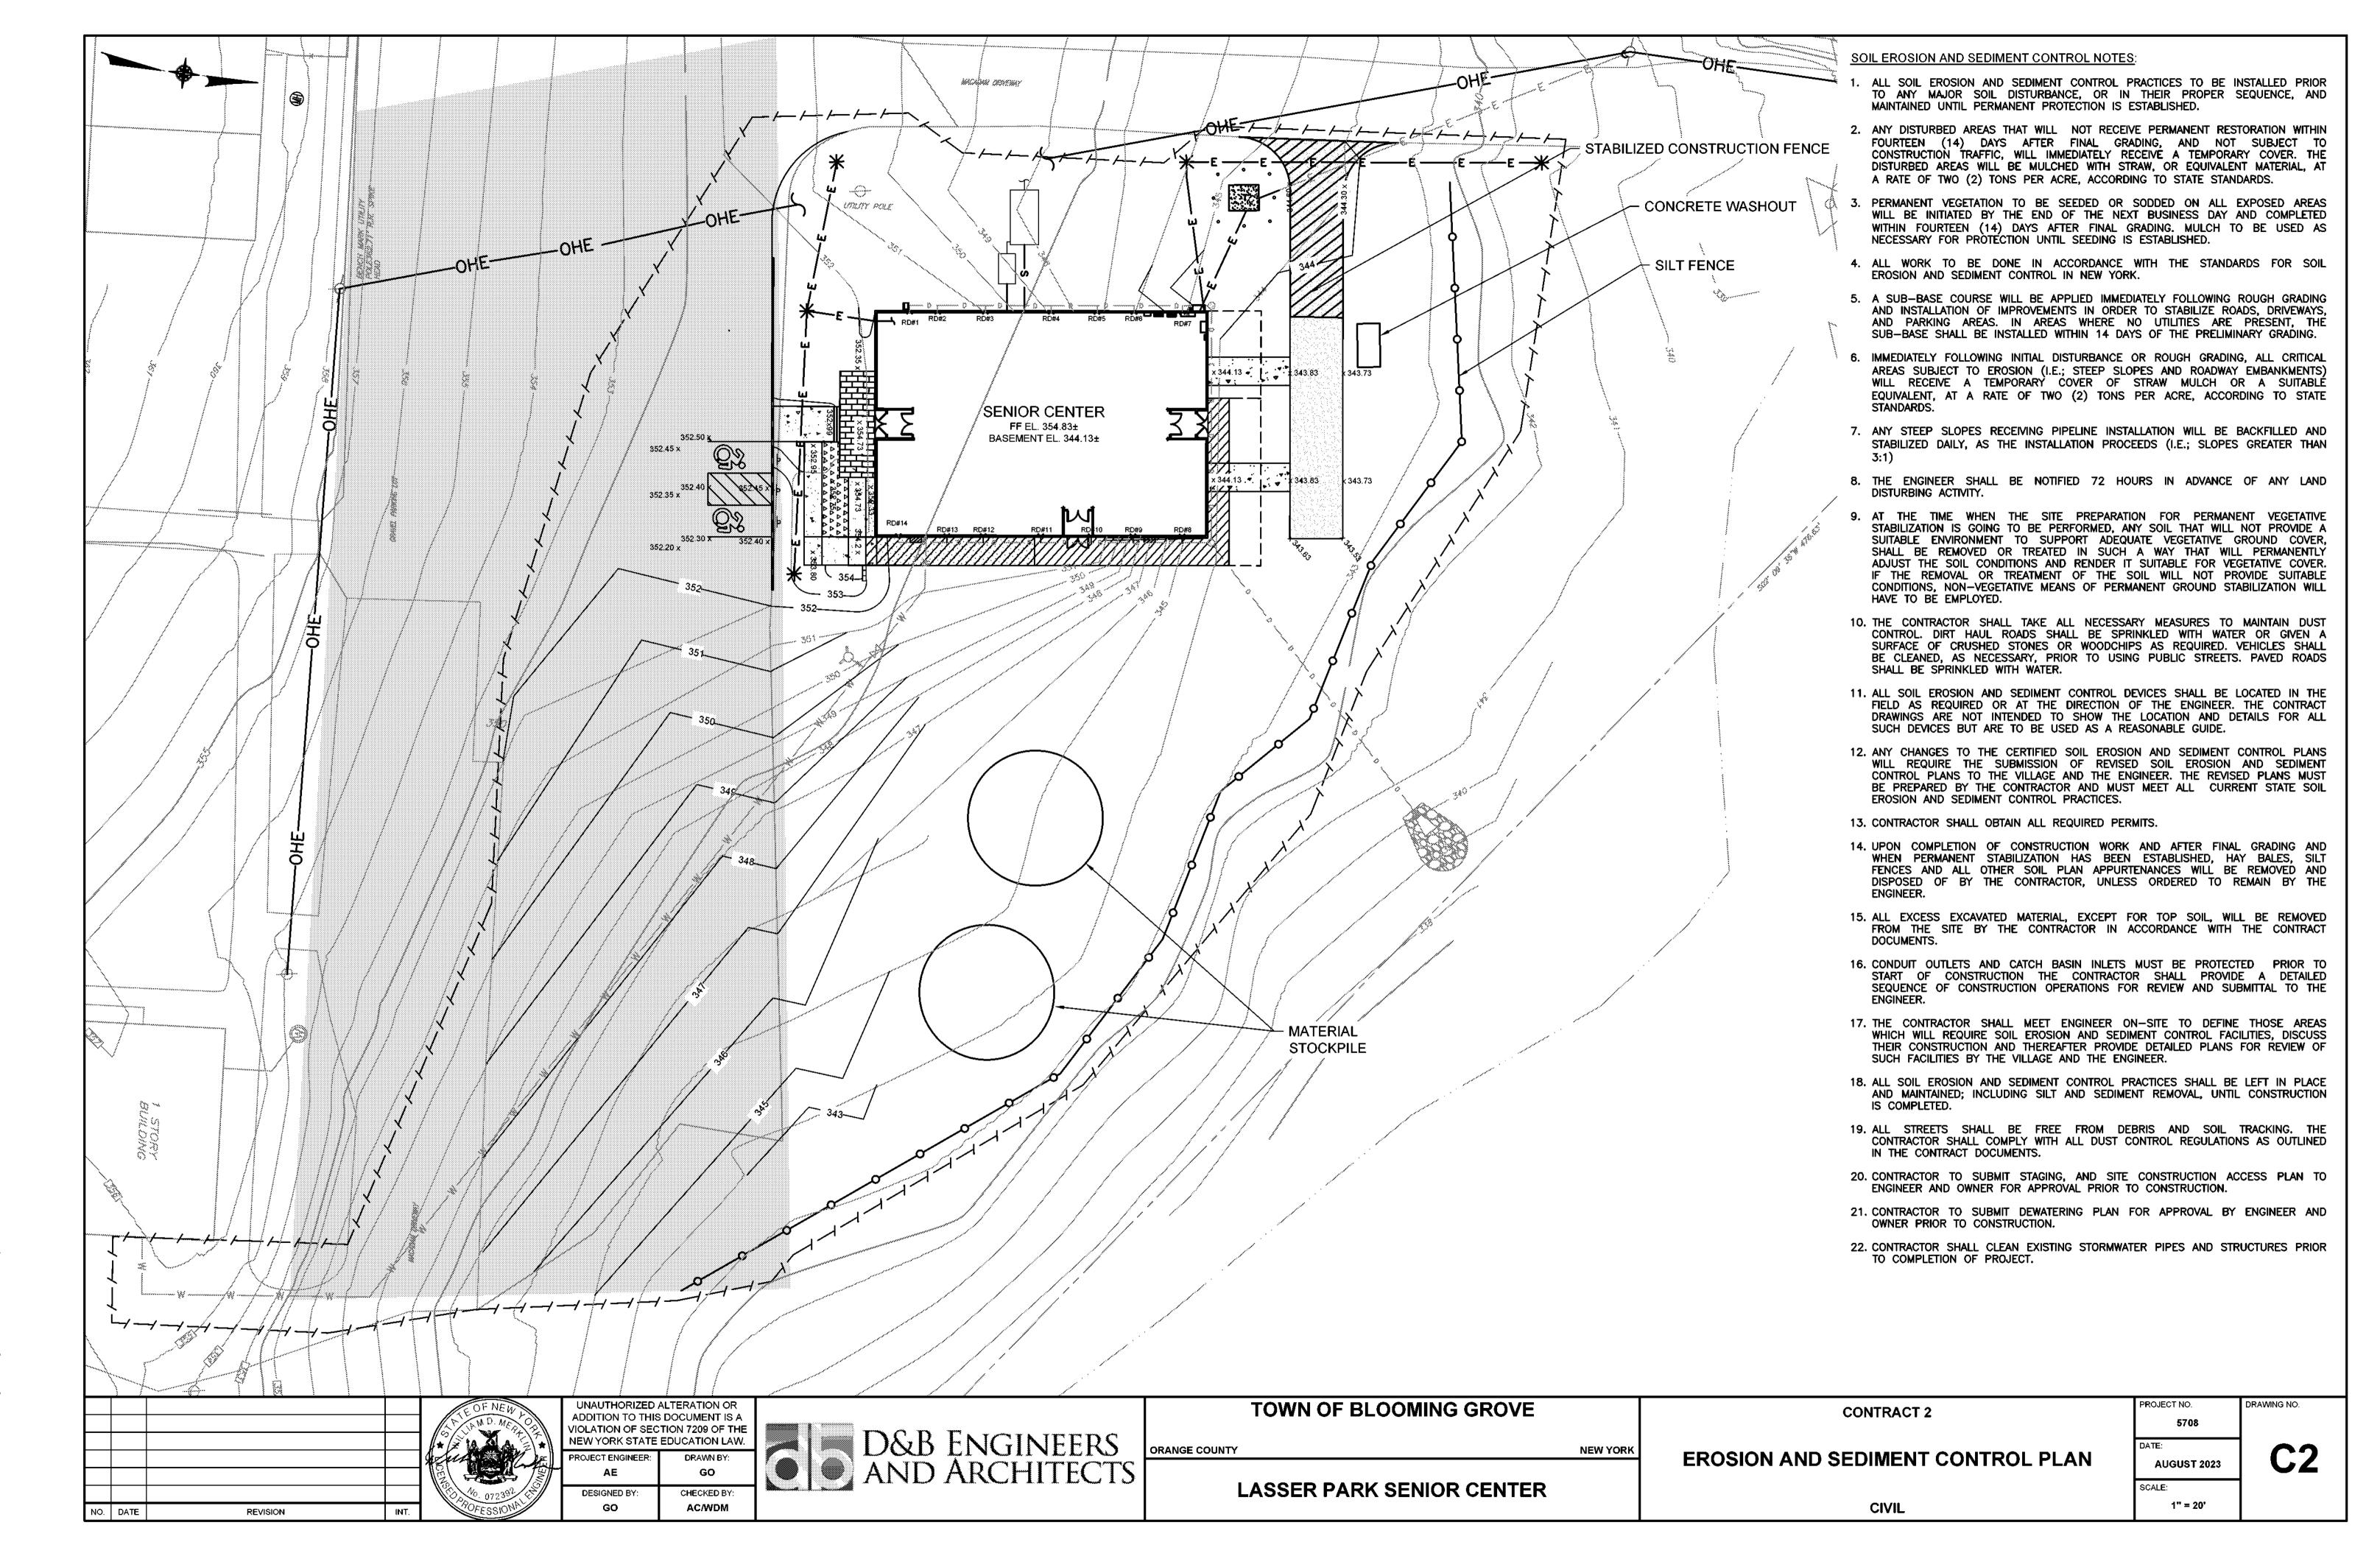


CONSTRUCTION CONTROL JOINT DETAIL

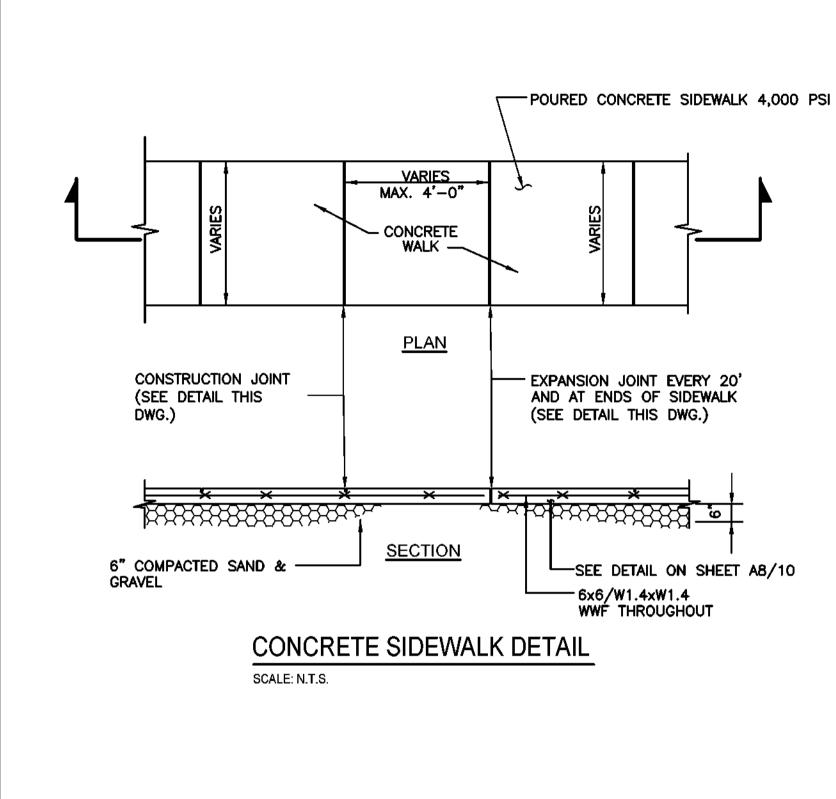SCALE: N.T.S.

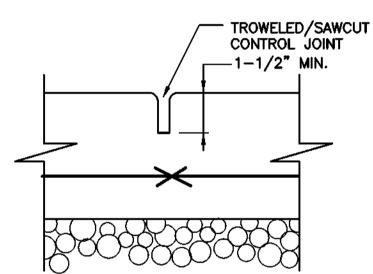

EXPANSION JOINT DETAIL SCALE: N.T.S.


SEE CONCRETE SIDEWALK DETAIL THIS SHEET FOR NOTES AND DIMENSIONS OF JOINTS.

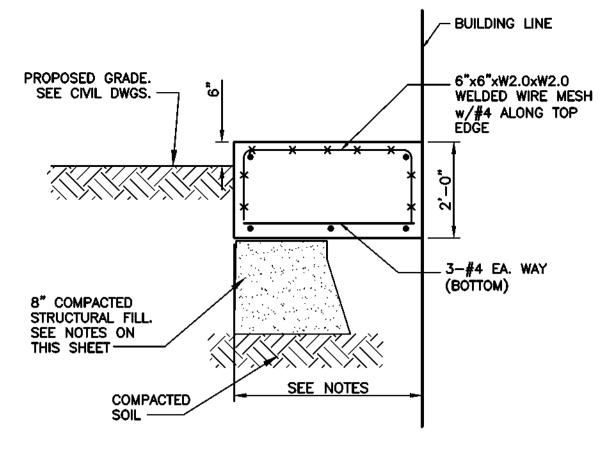


- 1) CONCRETE PAD FOR CT CABINET 42"X20" TOP EL:345.50
- 2) CONCRETE PAD FOR SWITCHBOARD "MDP" 30"X13" EL:345.50 3) GENERAL CONTRACTOR TO COORDINATE WITH ELECTRICAL CONTRACTOR FOR FINAL DIMENSIONS. GC TO SUBMIT SHOP DRAWINGS.

CONCRETE PAD FOR ELECTRICAL CABINETS

SCALE: N.T.S.

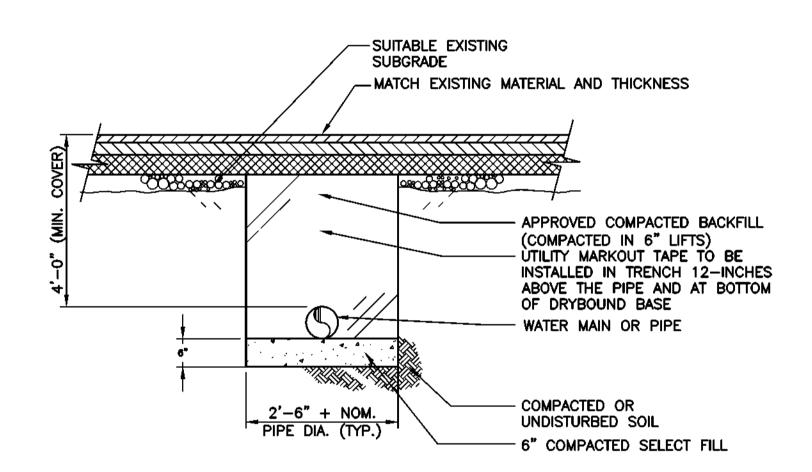


TYPICAL WATER PIPE TRENCH IN PAVED AREA

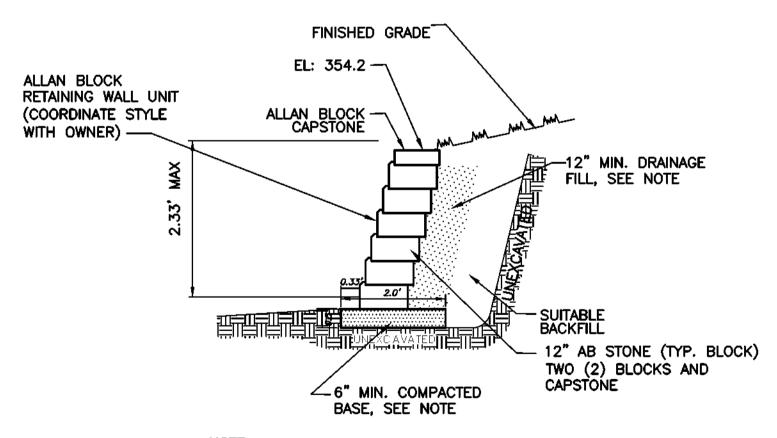


BASE AND DRAINAGE MATERIAL MUST BE WELL GRADED COMPACTIBLE AGGREGATE, 0.25 INCH TO 1.5 INCH, (5mm-38mm) WITH NO MORE THAN 10% PASSING THE #200 SIEVE.

LANDSCAPE RETAINING WALL

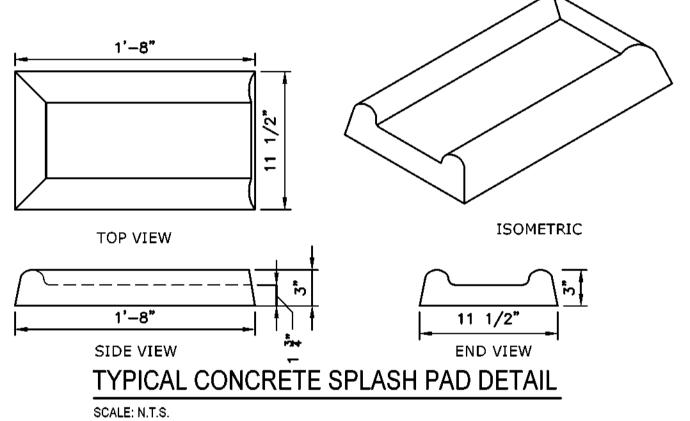

1) A SPLASH PAD SHOULD BE USED FOR ALL ROOF DOWNSPOUTS THAT ARE NOT TIED INTO THE SUBSURFACE DRAINAGE SYSTEM.

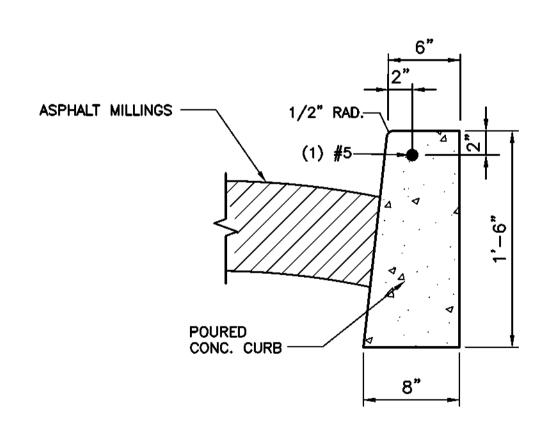

NOTES:

- 1. CURB REVEAL SHALL BE 6" EXCEPT AT DROP-CURB AND/OR HANDICAP RAMP. (SEE RESPECTIVE DETAILS)
- 2. 1/2" PREMOULDED EXPANSION JOINT FILLER SHALL BE INSTALLED 20' O.C.
- 3. WORK BY OTHERS.

CONCRETE CURB DETAIL

SCALE: N.T.S.

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				A IND. MED OF
				A SULLANDER
				072392
NO.	DATE	REVISION	INT.	POFESSIONA

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AC/WDM



SCALE: N.T.S.

TOWN OF BLOOMING GROVE ORANGE COUNTY **NEW YORK**

DETAIL I


CIVIL

CONTRACT 2

PROJECT NO. DRAWING NO. 5708 **AUGUST 2023** SCALE:


AS SHOWN




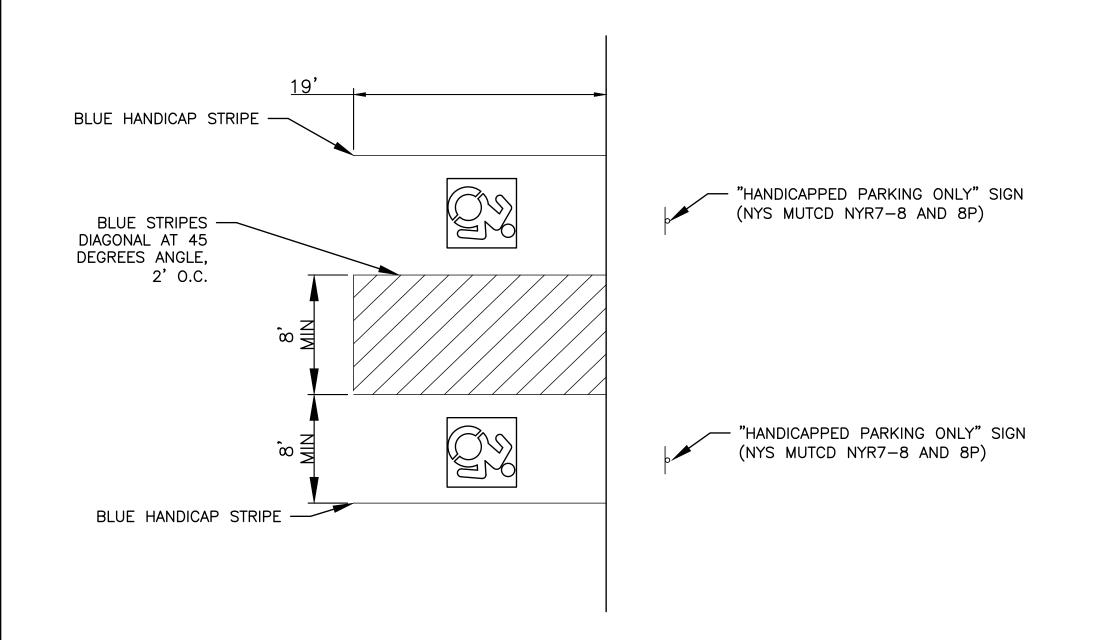


TYPICAL ACCESSIBLE PARKING LAYOUT

SCALE: N.T.S.

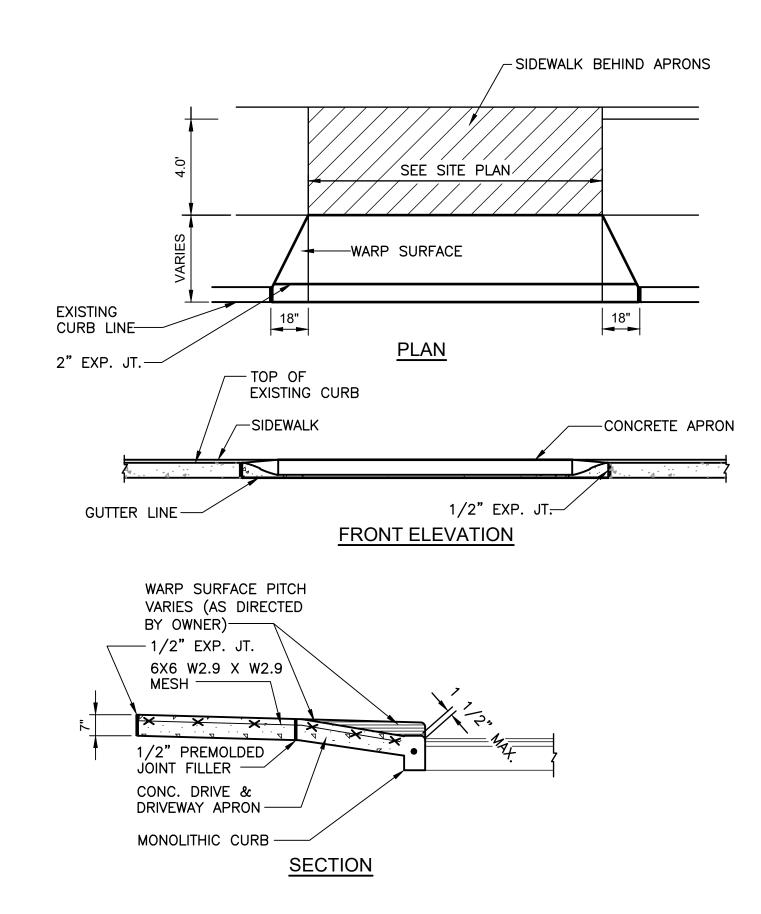

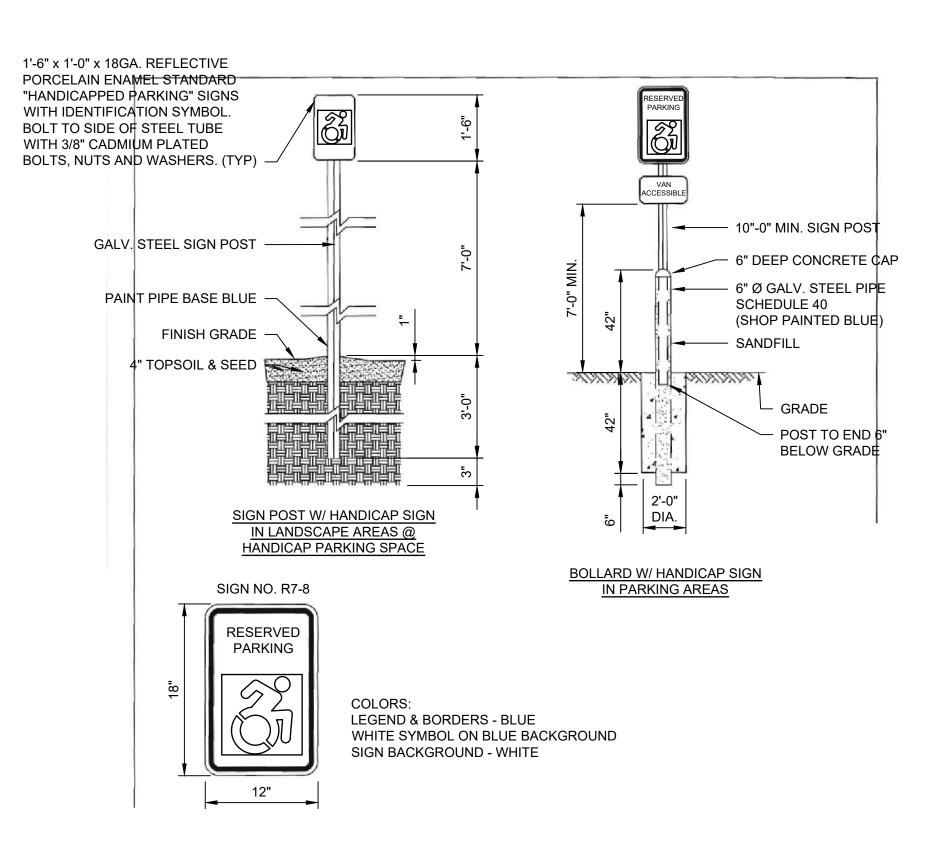

ACCESSIBLE PARKING SPACE AND ACCESS AISLE SIGN SCALE: N.T.S.

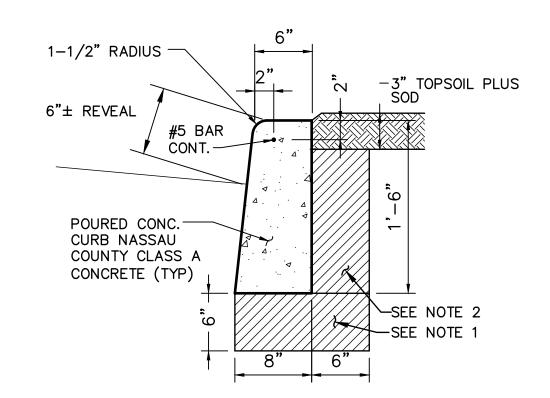

CONCRETE CURB DETAIL

SCALE: N.T.S.

NOTE:

- 1. CUT AND REMOVE ALL ROOTS AND OTHER UNSUITABLE SUBGRADE MATERIALS. REPLACE WITH COMPACTED MATERIAL.
- 2. CUT AND REMOVE ALL ROOTS AND OTHER UNSUITABLE MATERIALS.

DROP CURB AND DRIVEWAY APRON DETAIL

SCALE: N.T.S.

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N OR IT IS A OF THE N LAW.	D&B ENGINEERS AND ARCHITECTS
D BY:	TH (B) THEOTHER

TOWN OF BLOOMING GROVE	
E COUNTY	NEW YORK
LASSER PARK SENIOR CENTER	

CONTRACT 2 DETAIL II

PROJECT NO. DRAWING NO. 5708 **C4 AUGUST 2023** SCALE:

AS SHOWN


CIVIL


STABILIZED CONSTRUCTION ENTRANCE DETAIL

SCALE: N.T.S.

NOTES:

- 1. STONE SIZE USE 1 1/2 2 1/2" STONE, OR RECLAIMED OR RECYCLED CONCRETE EQUIVALENT.
- 2. LENGTH -50 FEET MINIMUM.
- 3. THICKNESS NOT LESS THAN SIX (6) INCHES. 4. WIDTH - TWENTY FOUR (24) FOOT MINIMUM, BUT NOT LESS THAN THE FULL WIDTH AT POINTS WHERE
- INGRESS OR EGRESS OCCURS.
- 5. FILTER CLOTH, MIRAFI OR APPROVED EQUAL, WILL BE PLACED OVER THE ENTIRE AREA PRIOR TO PLACING
- 6. SURFACE WATER-ALL SURFACE WATER FLOWING OR DIVERTED TOWARD CONSTRUCTION ENTRANCES SHALL BE PIPED ACROSS THE ENTRANCE. IF PIPING IS IMPRACTICAL, A MOUNTABLE BERM WITH 5:1 SLOPES WILL
- 7. MAINTENANCE THE ENTRANCE SHALL BE MAINTAINED IN A CONDITION WHICH WILL PREVENT TRACKING OR FLOWING OF SEDIMENT ONTO PAVED SURFACES. ALL SEDIMENT SPILLED, DROPPED, WASHED, OR TRACTED ONTO PAVED SURFACES MUST BE REMOVED IMMEDIATELY.
- 8. WHEN WASHING IS REQUIRED, IT SHALL BE DONE ON AN AREA STABILIZED WITH STONE AND WHICH DRAINS INTO AN APPROVED SEDIMENT TRAPPING DEVICE.
- PERIODIC INSPECTION AND NEEDED MAINTENANCE SHALL BE PROVIDED AFTER EACH RAIN.
- 10. THE SITE SHALL BE MAINTAINED IN SUCH A WAY THAT ALL CONSTRUCTION VEHICLES EXITING THE SITE ONTO A PAVED SURFACE SHALL PASS OVER THE STABILIZED CONSTRUCTION ENTRANCE IF THEY HAVE TRANSVERSED OVER DISTURBED EARTH.

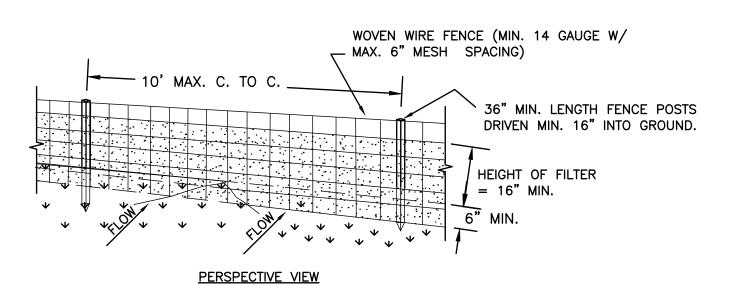


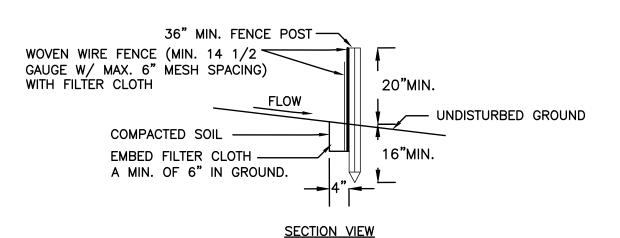


SEDIMENT FENCE DETAIL


SCALE: N.T.S.

- WOVEN WIRE FENCE TO BE FASTENED SECURELY TO FENCE POSTS WITH WIRE TIES OR STAPLES.
- POSTS SHALL BE STEEL EITHER "T" OR "U" TYPE OR HARDWOOD. 2. FILTER CLOTH TO BE TO BE FASTENED SECURELY TO WOVEN WIRE FENCE WITH TIES SPACED EVERY
- 24" AT TOP AND MID SECTION. FENCE SHALL BE WOVEN WIRE, 6" MAXIMUM MESH OPENING. 3. WHEN TWO SECTIONS OF FILTER CLOTH ADJOIN EACH OTHER THEY SHALL BE OVERLAPPED BY SIX INCHES AND FOLDED. FILTER CLOTH SHALL BE EITHER FILTER X, MIRAFI 100X, STABILINKA T140N, OR
- APPROVED EQUIVALENT. 4. PREFABRICATED UNITS SHALL BE GEOFAB, ENVIROFENCE, OR APPROVED EQUIVALENT.
- 5. MAINTENANCE SHALL BE PERFORMED AS NEEDED AND MATERIAL REMOVED WHEN "BULGES" DEVELOP IN THE SILT FENCE.

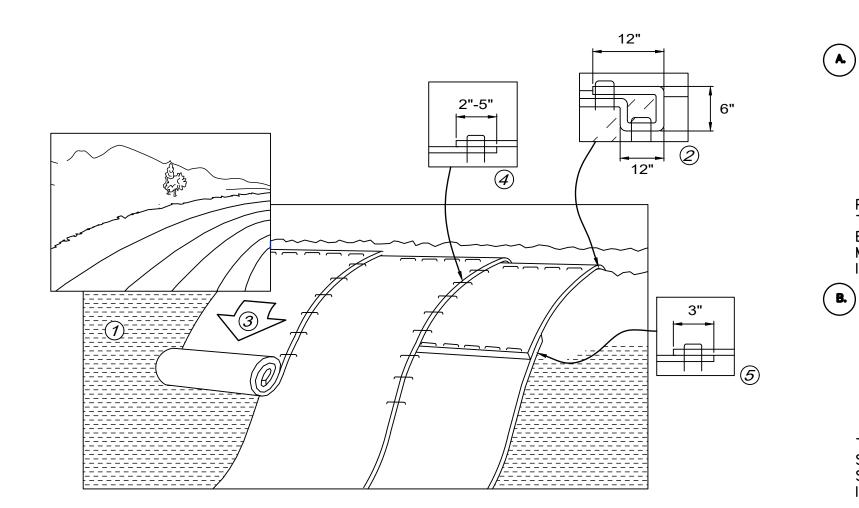


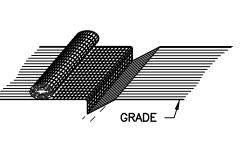

PREPARE ANCHORING TRENCHES AT THE TOP AND BOTTOM OF SLOPES. BURY THE TOP ENDS OF THE MATTING STRIPS IN A TRENCH 4 INCHES OR MORE IN DEPTH.

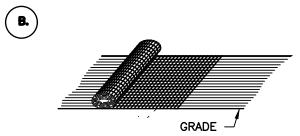


TAMP THE TRENCH FULL OF SOIL. SECURE WITH ROW OF STAPLES. 10 INCH SPACING 4 INCHES DOWN FROM TRENCH.

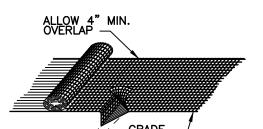

 $(\mathbf{c}.)$

OVERLAP-BURY UPPER END OF LOWER STRIP AS IN "A" AND "B" OVERLAP END OF TOP STRIP 4 INCHES AND STAPLE AT 10 INCH INTERVALS.

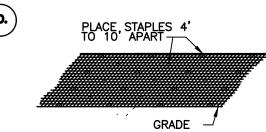


EROSION STOP-FOLD OF MATTING BURIED IN SILT TRENCH AND TAMPED. DOUBLE ROW OF STAPLES. EROSION STOPS SHOULD BE INSTALLED AT THE MIDPOINT OF SLOPES GREATER THAN 50 FEET IN LENGTH; OR AT 50 FOOT INTERVALS MEASURED FROM TOP OF SLOPES GREATER THAN 100 FEET IN LENGTH.

EROSION PROTECTION WITH SOIL STABILIZATION MATTING

SCALE: N.T.S.

NOTES:

- 1. BEGIN AT THE TOP OF THE SLOPE BY ANCHORING THE BLANKET IN A 6" WIDE TRENCH WITH APPROXIMATELY 12" OF BLANKET EXTENDED BEYOND THE UP-SLOPE PORTION OF THE TRENCH. ANCHOR THE BLANKET WITH A ROW OF STAPLES/STAKES APPROXIMATELY 12" APART IN THE BOTTOM OF THE TRENCH. BACK FILL AND COMPACT THE TRENCH AFTER STAPLING. APPLY SEED TO PREPARED SOIL AND FOLD REMAINING 12" PORTION OF THE BLANKET BACK OVER SEED AND SOIL. SECURE BLANKET OVER SOIL WITH A ROW OF STAPLES/STAKES SPACED APPROXIMATELY 12" APART ACROSS THE WIDTH OF THE BLANKET.
- 2. ROLL THE BLANKETS DOWN ACROSS THE SLOPE. BLANKETS WILL UNROLL WITH THE APPROPRIATE SIDE AGAINST THE SOIL SURFACE. ALL BLANKETS MUST BE SECURELY FASTENED TO SOIL SURFACE BY PLACING STAPLES/STAKES IN APPROPRIATE LOCATIONS AS SHOWN IN THE STAPLE PATTERN GUIDE.
- 3. WHEN USING OPTIONAL DOT SYSTEM, STAPLES/STAKES SHOULD BE PLACED THROUGH EACH OF THE COLORED DOTS CORRESPONDING TO THE APPROPRIATE STAPLE PATTERN.
- 4. THE EDGES OF PARALLEL BLANKETS MUST BE STAPLED WITH APPROXIMATELY 2"-5" OVERLAP DEPENDING ON BLANKET TYPE. TO ENSURE PROPER SEAM ALIGNMENT, PLACE THE EDGE OF THE OVERLAPPING BLANKET (BLANKET BEING INSTALLED ON TOP) EVEN WITH THE COLORED SEAM STITCH ON THE PREVIOUSLY INSTALLED BLANKET.
- CONSECUTIVE BLANKETS SPLICED DOWN THE SLOPE MUST BE PLACED ACCORDING TO DETAILS A. B. C. D. 6. EROSION CONTROL BLANKETS SHALL BE INSTALLED FOLLOWING MANUFACTURERS SPECIFICATIONS.
- 7. IN LOOSE SOIL CONDITIONS, THE USE OF STAPLE OR STAKE LENGTHS GREATER THAN 6" MAY BE NECESSARY TO PROPERLY ANCHOR THE BLANKETS.

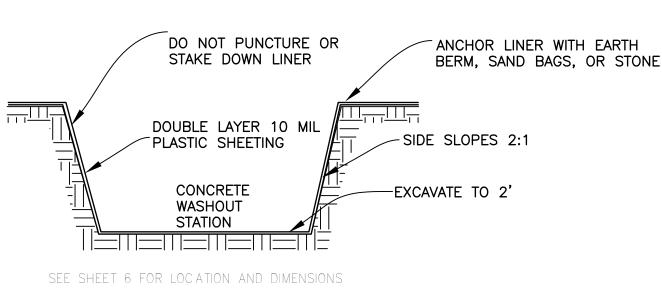

CONCRETE WASHOUT SCALE: N.T.S.

1. THE MINIMUM SIZE SHALL BE 8' X 8' AT THE BOTTOM AND 2' DEEP.


2. AN EXCAVATED PIT SHALL PROVIDE 2' HORIZONTAL TO 1' VERTICAL.


3. CONTRACTOR TO PROVIDE SIGNS ON SITE TO DIRECT DRIVERS TO ITS LOCATION.

4. LOCATION SHALL BE A MINIMUM OF 100' FROM DRAINAGE SWALES, STORM DRAIN INLETS, WETLANDS, STREAMS, AND OTHER SURFACE WATERS.

5. REFER TO "NEW YORK STATE STANDARDS AND SPECIFICATIONS FOR EROSION AND SEDIMENT CONTROL" STANDARD AND SPECIFICATIONS FOR CONCRETE WASHOUT PG 2.24 FOR DEFINITIONS AND MAINTENANCE PARAMETERS.

ORANGE COUNTY

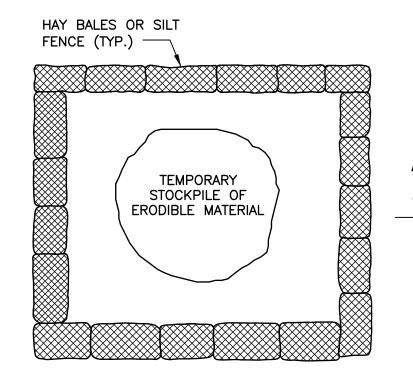

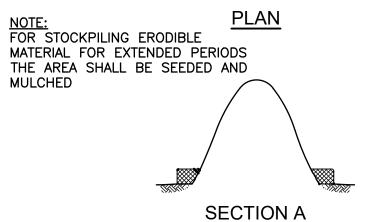

SEDIMENT CONTROL DETAIL FOR STOCKPILING OF ERODIBLE MATERIAL

NO. DATE REVISION

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TOWN OF BLOOMING GROVE

NEW YORK

EROSION AND SEDIMENT CONTROL DETAILS

CONTRACT 2

5708 DATE: **AUGUST 2023** SCALE:

ROJECT NO.

C5

DRAWING NO.

LASSER PARK SENIOR CENTER

CIVIL

AS SHOWN

PROJECT GENERAL INFORMATION

ADULT EDUCATION

CITY:

THE TOWN OF BLOOMING GROVE - LASSER PARK SENIOR CENTER

THE TOWN OF BLOOMING GROVE CITY/COUNTY

PLANS ARE FOR THE CONSTRUCTION OF A NEW PORCH AND DECK ON EXISTING MODULAR BUILDING AND FOUNDATION .

☐ PRIVATE

COUNTY: ORANGE STATE: NEW YORK

49 STATION ROAD, SALISBURY MILLS, NY 12577

NEW CONSTRUCTION ☐ EXISTING STRUCTURE ☐ TENANT IMPROVEMENT

NAME OF PROJECT:

PROPOSED USE:

AUTHORIZED AGENT:

CODE ENFORCEMENT

PROJECT DESCRIPTION:

JURISDICTION:

ADDRESS:

OWNER OR

OWNED BY:

NO. DATE

REVISION

BUILDING AREAS &

OCCUPANCY LOADS: (TABLE 1004.5)

	AREA	FUNCTION	OCC. LOAD	PROPOSED	OCC.
		OF SPACE	FACTOR	AREA	LOAD
			(GROSS)	(GROSS)	
	GROUND FLOOR	BUSINESS AREA	150	5,995, SF	170
	BASEMENT	STORAGE	300	5,995, SF	2
FIF	RST FLOOR TOTAL				

EGRESS REQUIREMENTS - NUMBER AND ARRANGEMENT OF EXITS: (REFER TO CONSTRUCTION PLAN DWG A2)

FLOOR, ROOM, OR SPACE DESIGNATION		I NUMBER EXITS ²	TRAVEL DISTANCE 3, 4			ARRANGEMENT MEANS OF EGRESS⁵		
& OCC. LOAD			СОММ	ON PATH	TRAVEL	. DISTANCE	REQUIRED	PROPOSED
	REQUIRED	PROPOSED	ALLOWED	PROPOSED	ALLOWED	PROPOSED	DISTANCE BETWEEN EXIT DOORS	DISTANCE
GROUND FLOOR - BASEMENT -	1	-	75'	<75' REFER TO EGRESS PLAN	200'	186'	45'-3"	60'

¹CORRIDOR DEAD ENDS (SECTION 1020.4)

NOTES

DB

CHECKED BY:

BA/WDM

DESIGNED BY

D&B ENGINEERS
AND ARCHITECTS

- ² SPACES WITH ONE EXIT OR EXIT ACCESS DOORWAY (TABLE 1006.2.1), MULTIPLE EXITS (SECTION 1006)
- ³ COMMON PATH OF TRAVEL (TABLE 1006.2.1)
- ⁴ EXIT ACCESS TRAVEL DISTANCE (TABLE 1017.2)
- ⁵ EXIT AND EXIT ACCESS DOORWAY CONFIGURATION (SECTION 1007)

EGRESS REQUIREMENTS - EXIT WIDTHS: (OTHER: SECTIONS 1005.3.2, 1010.1.1) (STAIR: SECTIONS 1005.3.1, 1011.2, 1014.8)

	(enime electronic leading, forme)							
FLOOR, ROOM OR SPACE DESIGNATION	LOAD	CAPACITY FACTOR REQUIRED PER OCC.	REQUIRED EXIT WIDTH	PROPOSED EXIT WIDTH (EACH)				
GROUND FL	•	OTHER: 0.2" (27 X .2 = 5.4")	3'-8" CLEAR	>3'-8" CLEAR				
BASEMENT	-	STAIR: 0.3" (27 X .3 = 8.1")	36" (INCL 4-1/2" PROJECTION EACH SIDE)	36"				
	(14+12) 26	OTHER: 0.2" (41 X .2 = 8.2")	32" CLEAR	32" CLEAR				

FIRE PROTECTION REQUIREMENTS:

MAXIMUM AREA OF EXTERIOR WALL OPENINGS:

		_							
IFE SAFETY PLAN SHEET #, IF					FIRE SEPARATION		BLE AREA % LE 705.8)	F	PROPOSED
BUILDING ELEMENT	FIRE SEPARATION DISTANCE (FEET) (PER PLAN)	RATING REQUIRED (TABLE 601 & 602)	RATING	WALL	DISTANCE (FEET) (PER PLAN)	UNPROTECTED, NON-SPRINKLERED	٩		
STRUCTURAL FRAME (INCLUDING COLUMNS, GIRDERS, TRUSSES)		0 HR		EXTERIOR WALL		PROTEC	РКОТЕСТЕР		
BEARING WALLS				<u>\</u>		52	g.		
EXTERIOR				NORTH					
NORTH	10 < X < 30"	0 HR		NORTH	15' TO LESS		T NO LIMIT		NOTAL
EAST	30' +	0 HR	1		THAN 20'	NO LIIMI	T NO LIMIT		NO LIMIT
SOUTH	30' +	0 HR]						
WEST	30' +	0 HR]	EAST					
INTERIOR		0 HR			30' OR	l No.Linu	T NO LIMIT		NOLIMIT
NONBEARING WALLS & PARTITIONS INTERIOR		0 HR			GREATER	NO LIIMI	T NO LIMIT		NO LIMIT
FLOOR CONSTRUCTION (INCLUDING SUPPORTING BEAMS AND JOISTS)		0 HR		SOUTH	30' OR GREATER	NO LIIMI	T NO LIMIT		NO LIMIT
ROOF CONSTRUCTION (INCLUDING SUPPORTING BEAMS AND JOISTS)		0 HR		WEST	30' OR GREATER	NO LIIMI	T NO LIMIT		NO LIMIT
SHAFTS - EXIT (SECTION 713)		N/A		INTERIO	R FINISHES	S - FLAI	ME SPREAD)	
CORRIDOR SEPARATION (TABLE 1020.1)		N/A			WALL & CE			_	
OCCUPANCY SEPARATION (TABLE 508.4)		N/A		INTERIOR	R WALL &	GROUP			NKLERED
FIRE WALL (SECTION 706)		N/A		REQUIRE	MENTS BY		ALLOWED - RO ENCLOSED SI		PROPOSED
FIRE BARRIER (SECTION 707)		N/A N/A			PANCY 803.3)				
FIRE PARTITION (SEC. 708)		N/A N/A		(,,,,,,,,,,,,,,,,,,,,,,,,,,,,,,,,,,,,,,		U	NO RESTRIC	TIONS	NO RESTRICTIONS
SMOKE BARRIER SEPARATION (SECTION 709)		N/A N/A		ACCORDAN BE GROUP	ICE WITH ASTI IN THE FOLLO	EILING FINISHES SHALL BE CLASSIFIED IN TM E 84. SUCH INTERIOR FINISHES MATERIAL SHALL OWING CLASSES IN ACCORDANCE WITH THEIR			
CONCEALED SPACES		N/A			READ INDEX.	DEAD INDE	V 0. 25		

CLASS A: FLAME SPREAD INDEX 0-25.

(VERTICAL EXITS & EXIT PASSAGEWAYS) (EXIST ACCESS CORRIDOR & OTHER EXITWAYS) 2. CLASS B : FLAME SPREAD INDEX 26-75

3. CLASS C : FLAME SPREAD 76-200. (ROOMS & ENCLOSED SPACES)

BUILDING THERMAL ENVELOPE COMPLIANCE - PRESCRIPTIVE METHOD: (C402.1)

CLIMATE ZONE 4 (NASSAU COUNTY, NY) TABLE C402.1.3 - INSULATION BY COMPONENT & TABLE C402.1.4 - ENVELOPE ASSEMBLY PROPOSED NOTES COMPONENT / ASSEMBLY DESCRIPTION REQUIRED ATTIC AND OTHER DORMER WALLS (BY OTHERS) WALLS / WOOD FRAMED R-9.75 c.i. MASS WALLS R-9.5 c.i. BELOW GRADE WALLS R-7.5 c.i. R-10 c.i. SLAB ON GRADE FLOORS **UNHEATED SLABS** R-10 R-10 24" BELOW GRADE SWINGING U-0.61 DOORS - SWINGING U-0.61

TABLE C402.4 - FENESTRATION U - FACTOR REQUIRED PROPOSED FIXED FENESTRATION U - 0.38 U - 0.38 OPERABLE FENESTRATION U - 0.45 U - 0.45 ENTRANCE DOORS (NON OPAQUE) U - 0.77 N/A SHGC (PF = PROJECTION FACTOR OF WINDOW OVERHANG) U - FACTOR REQUIRED PROPOSED PF < 0.2 U - 0.36 N/A		
TABLE C402.4 - FENESTI	RATION	
VERTICAL FENESTRATION	U - F.	ACTOR
VERTICALT ENESTRATION	REQUIRED	PROPOSED
FIXED FENESTRATION	U-0.38	U-0.38
OPERABLE FENESTRATION	U-0.45	U-0.45
ENTRANCE DOORS (NON OPAQUE)	U-0.77	N/A
	U - F.	ACTOR
WINDOW OVERHANG)	REQUIRED	PROPOSED
PF < 0.2	U-0.36	N/A
0.2 ≤ PF < 0.5	U-0.43	U-0.38
PF ≥ 0.5	U-0.58	U-0.53

* INSTALL FIRE BLOCKING AND DRAFT STOPPING IN

ACCORDANCE WITH SECTION 718

STATEMENT OF COMPLIANCE NOTE:

AS THE REGISTERED DESIGN PROFESSIONAL RESPONSIBLE FOR THESE PLANS, I HEREBY STATE THAT TO THE BEST OF MY KNOWLEDGE, BELIEF, AND PROFESSIONAL JUDGEMENT, THESE PLANS AND SPECIFICATIONS ARE IN COMPLIANCE WITH THE 2020 NYS ENERGY CONSTRUCTION CODE.

AIR BARRIER NOTE:

ENTIRE BUILDING EXTERIOR ENVELOPE SHALL BE PROVIDED WITH AN AIR BARRIER COMPLYING WITH SECTION C402.5 OF THE 2020 NYSECC (WITH AMENDMENTS).

MAXIMUM AREA OF VERTICAL FENESTRATION: (C402.4.1)

ALLOWABLE	PROPOSED	NOTES	
< 30% OF GROSS	+/- 9%	1	
ABOVE-GRADE WALL AREA		·	

1. EXCLUDES OPAQUE DOORS AND OPAQUE SPANDREL PANELS.

NEW YORK

5708 **AUGUST 2023**

AS NOTED

DRAWING NO.

LASSER PARK SENIOR CENTER

ORANGE COUNTY


TOWN OF BLOOMING GROVE

CODE ANALYSIS


ARCHITECTURAL

CONTRACT 2


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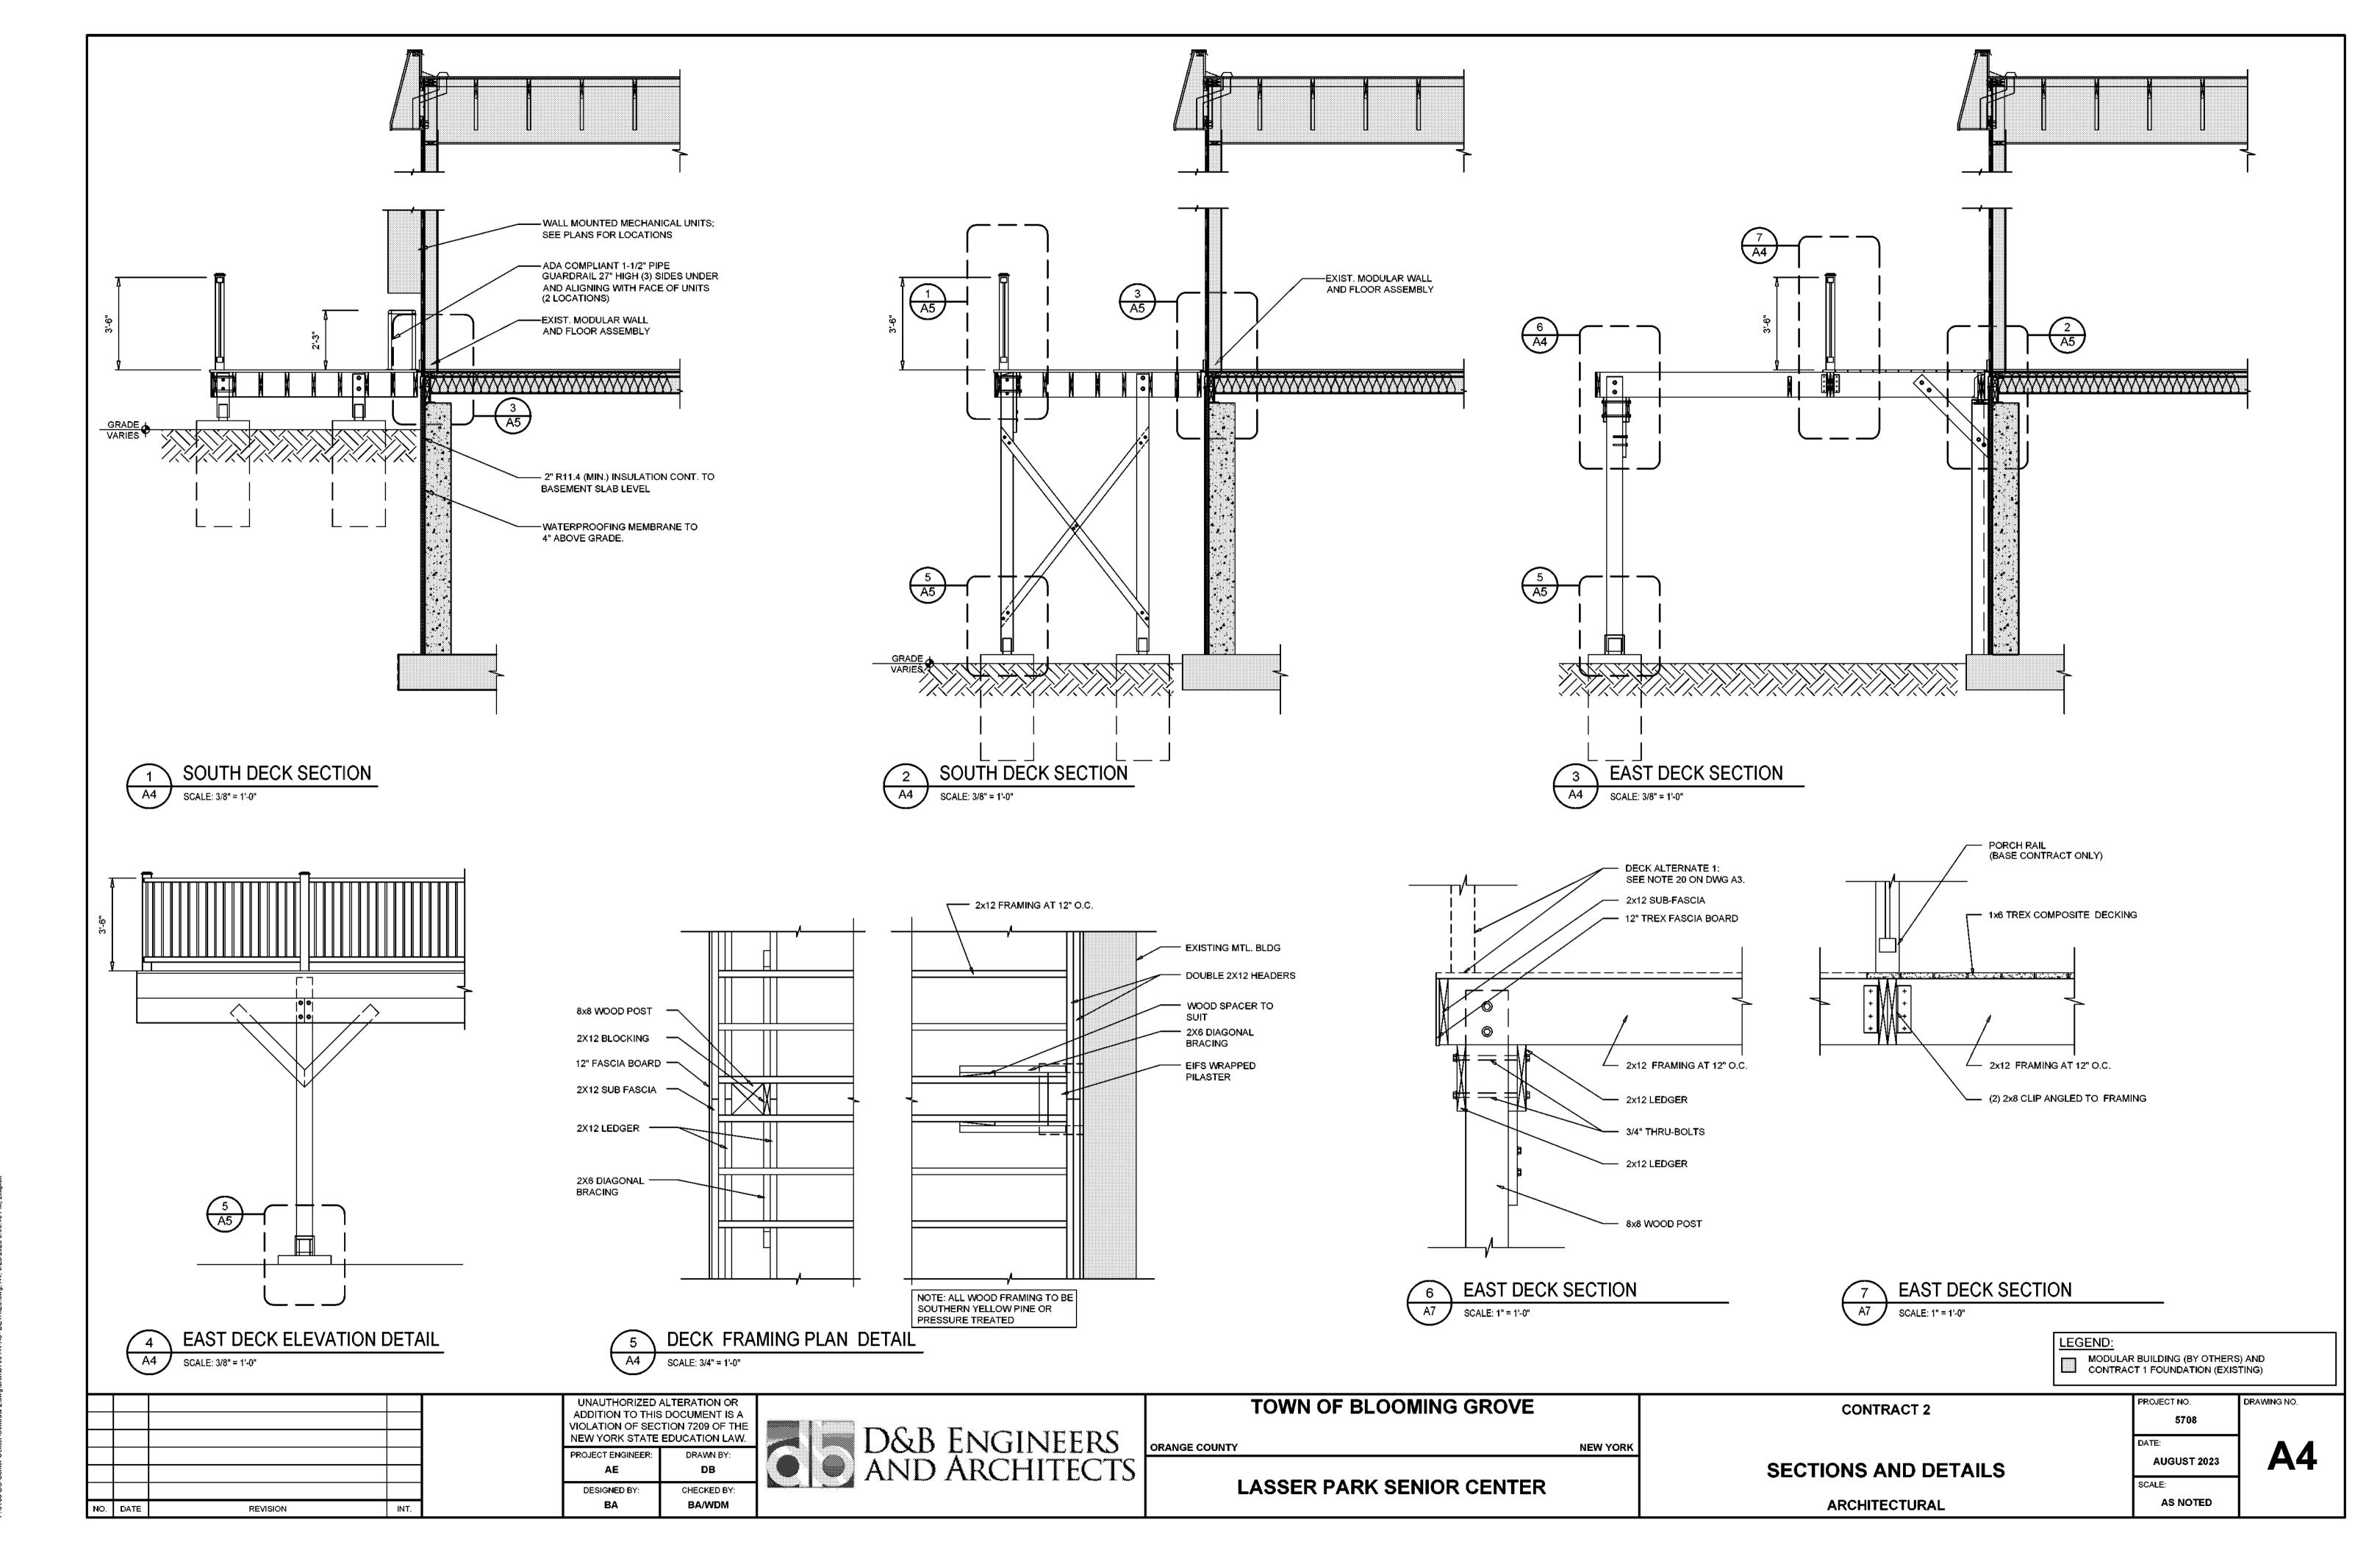
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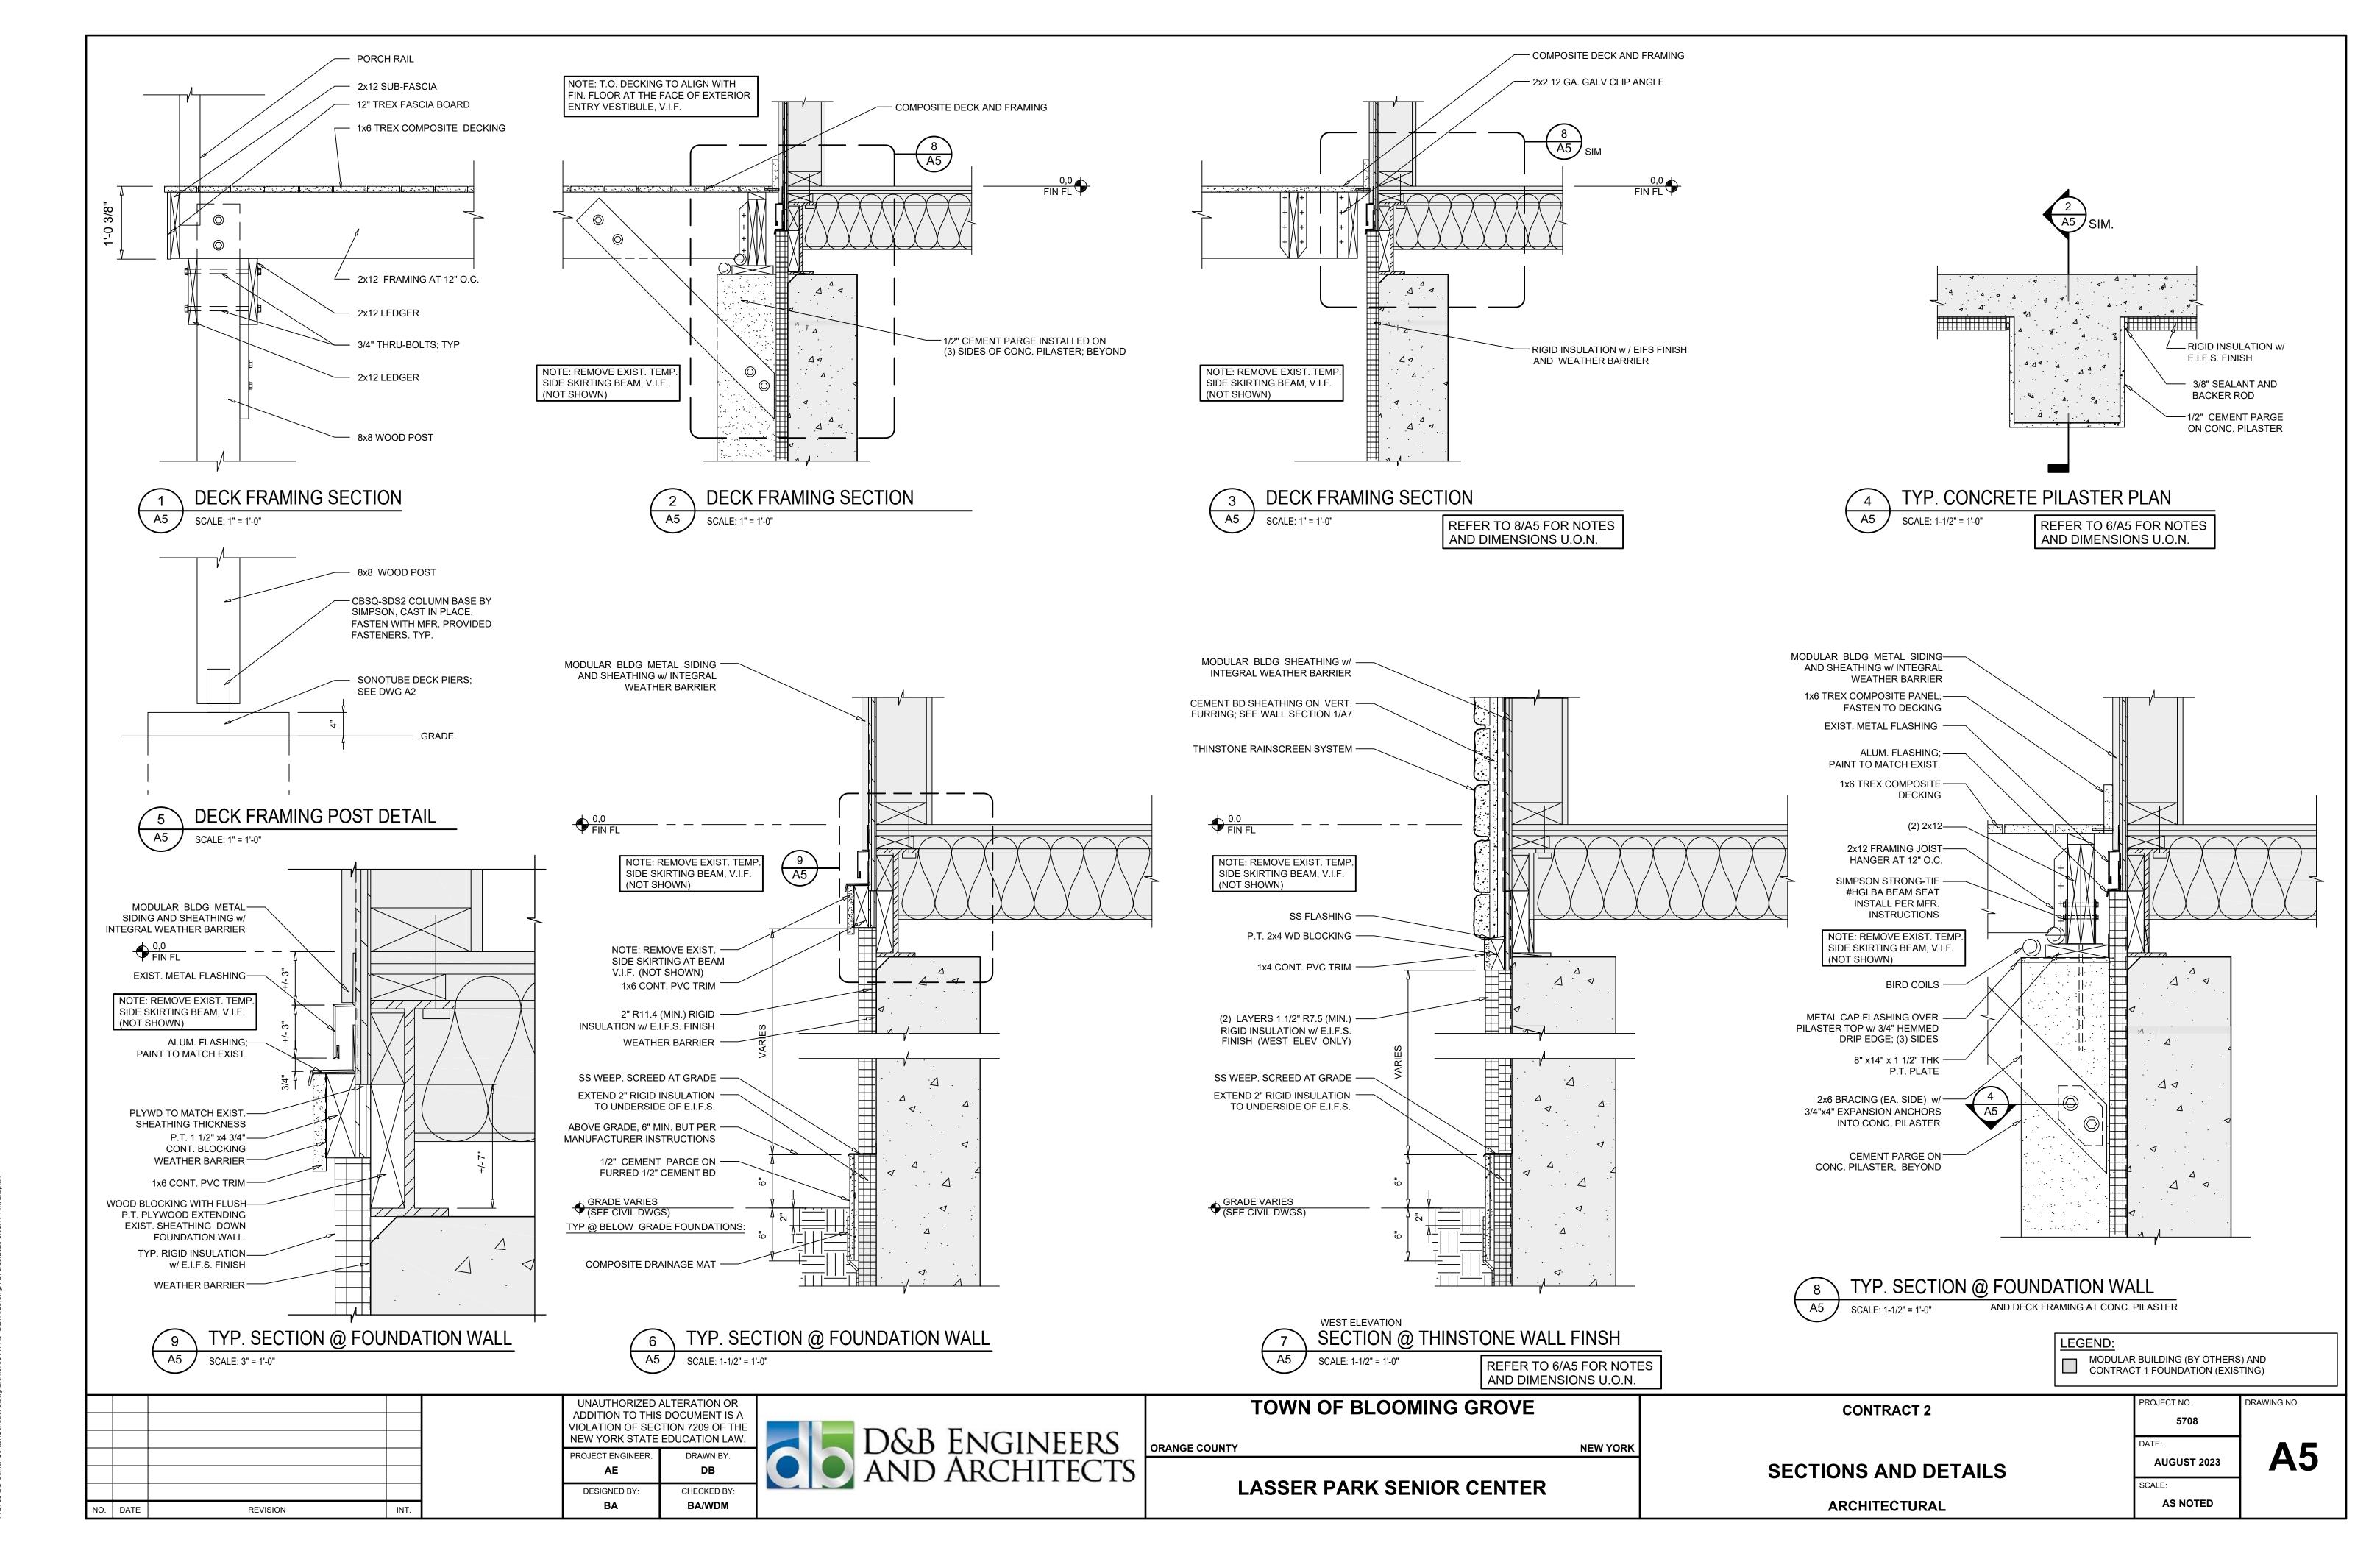
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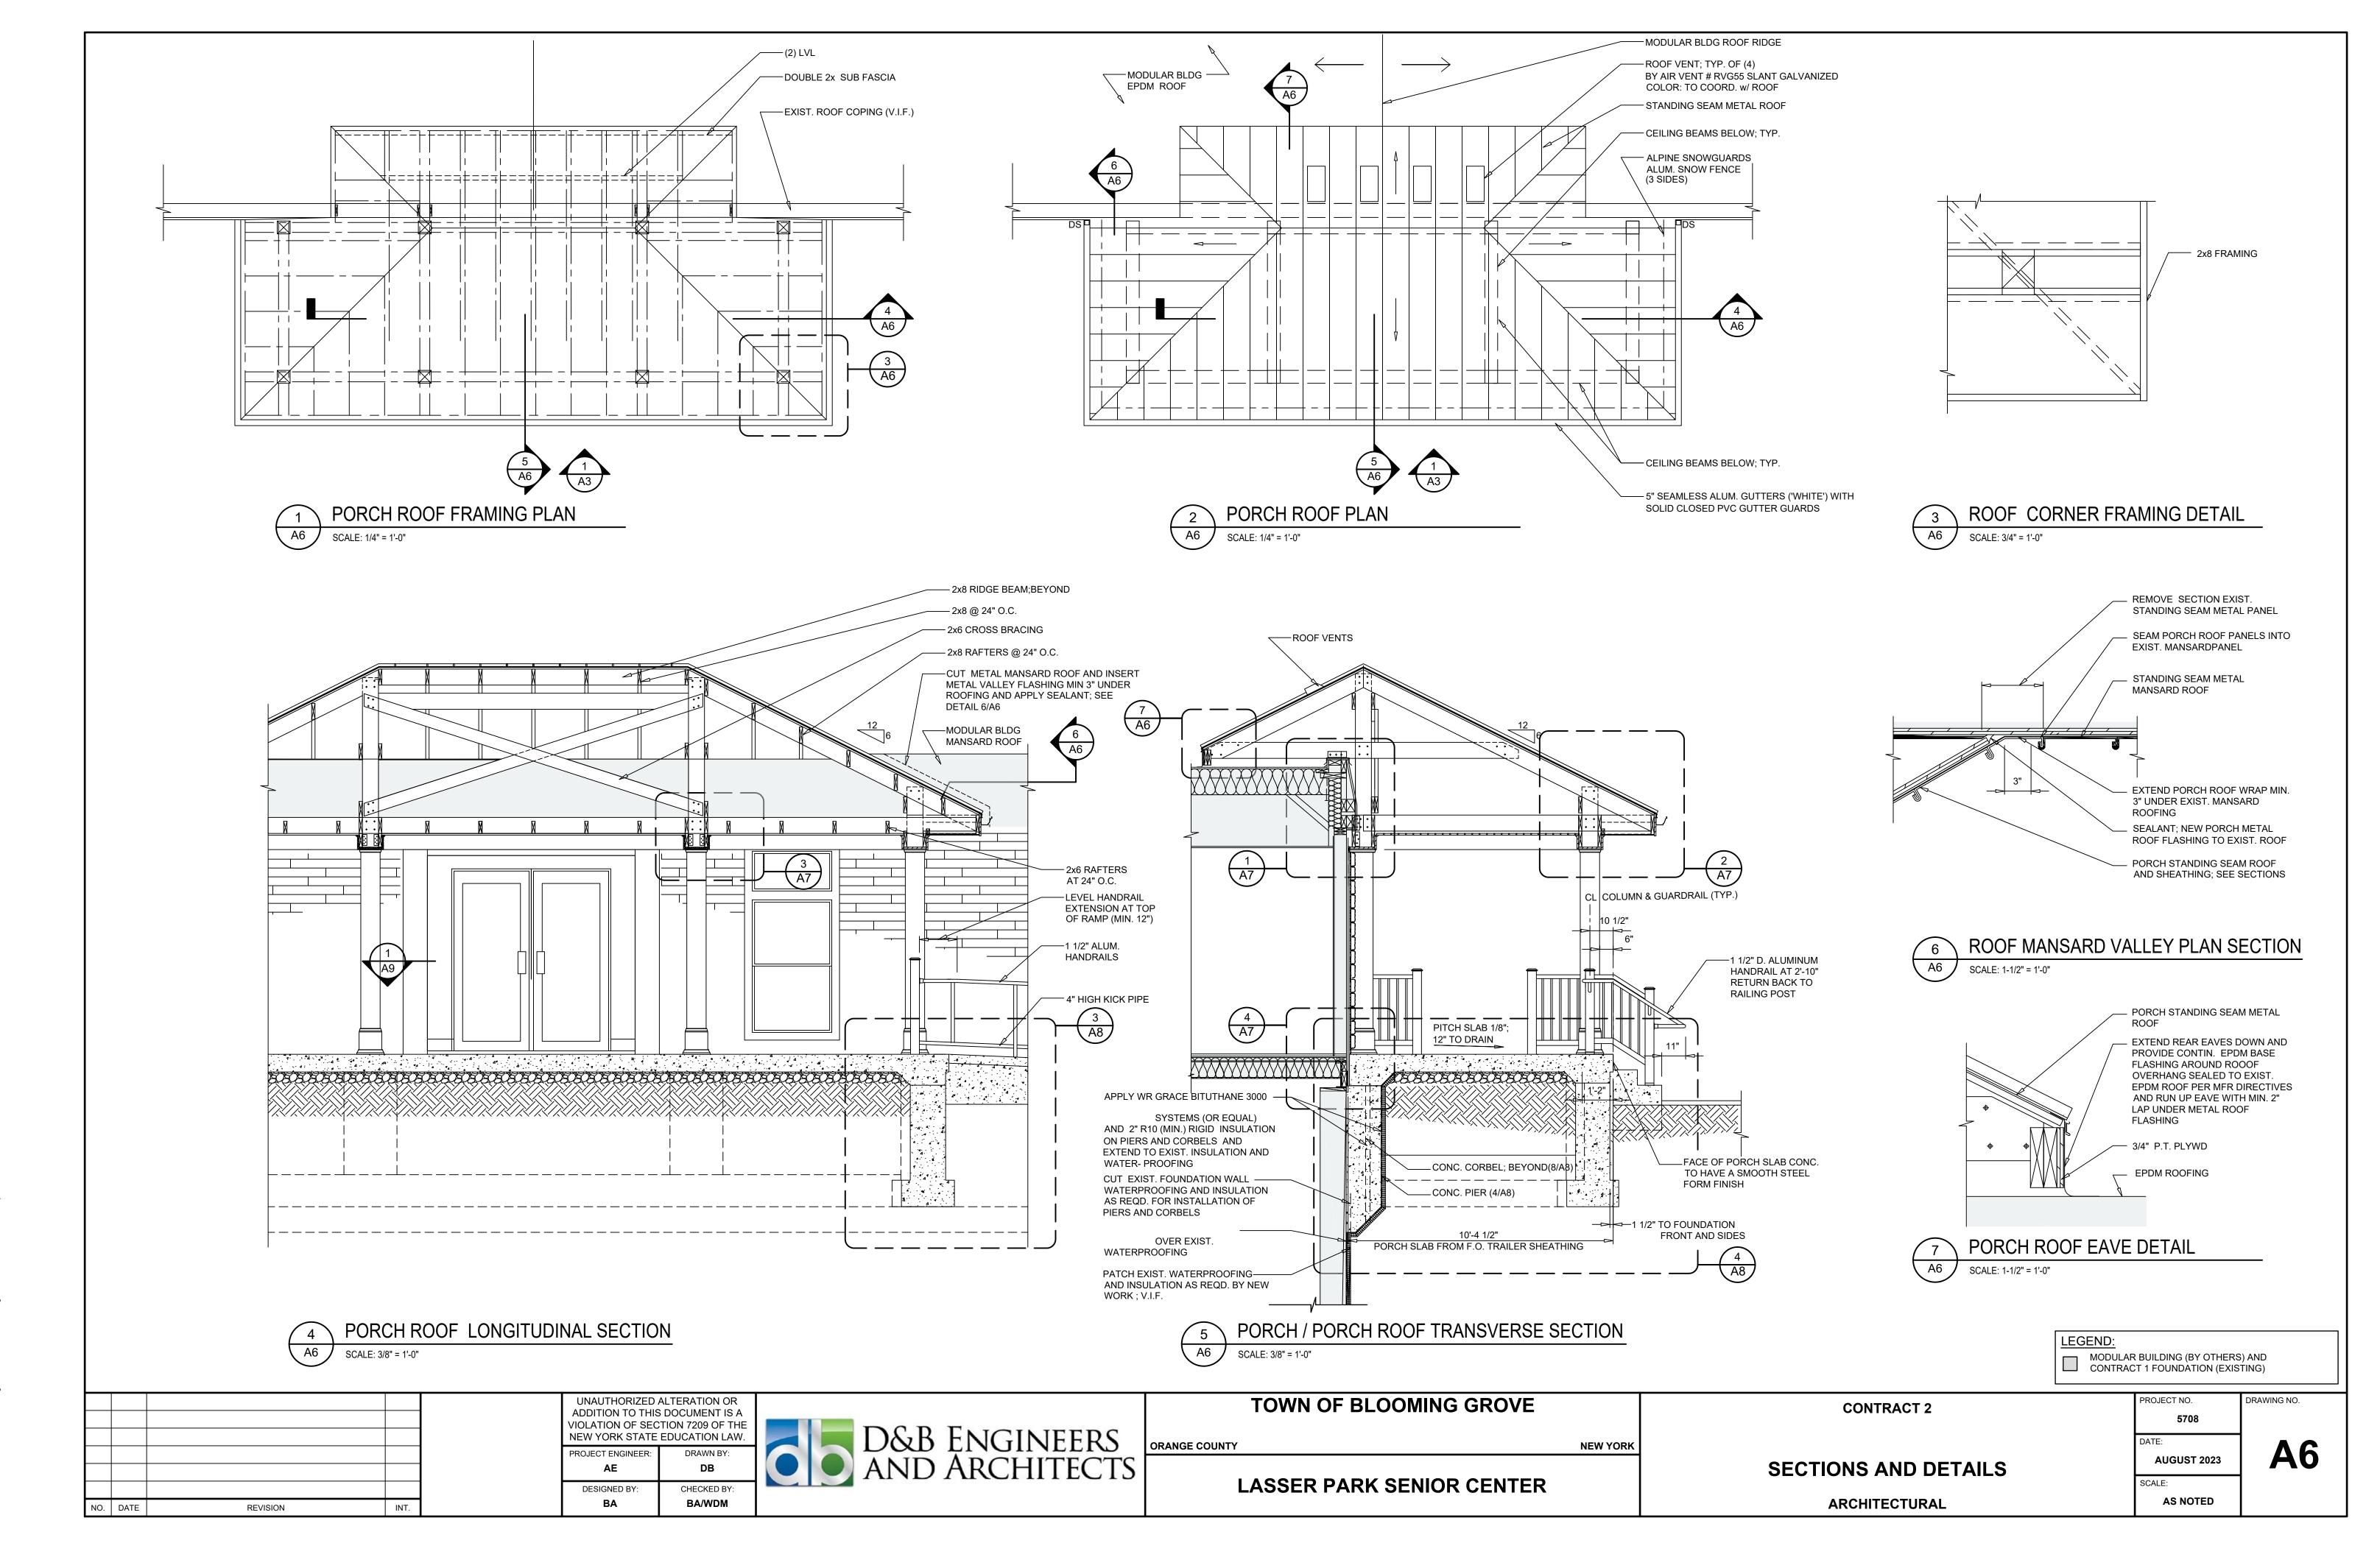

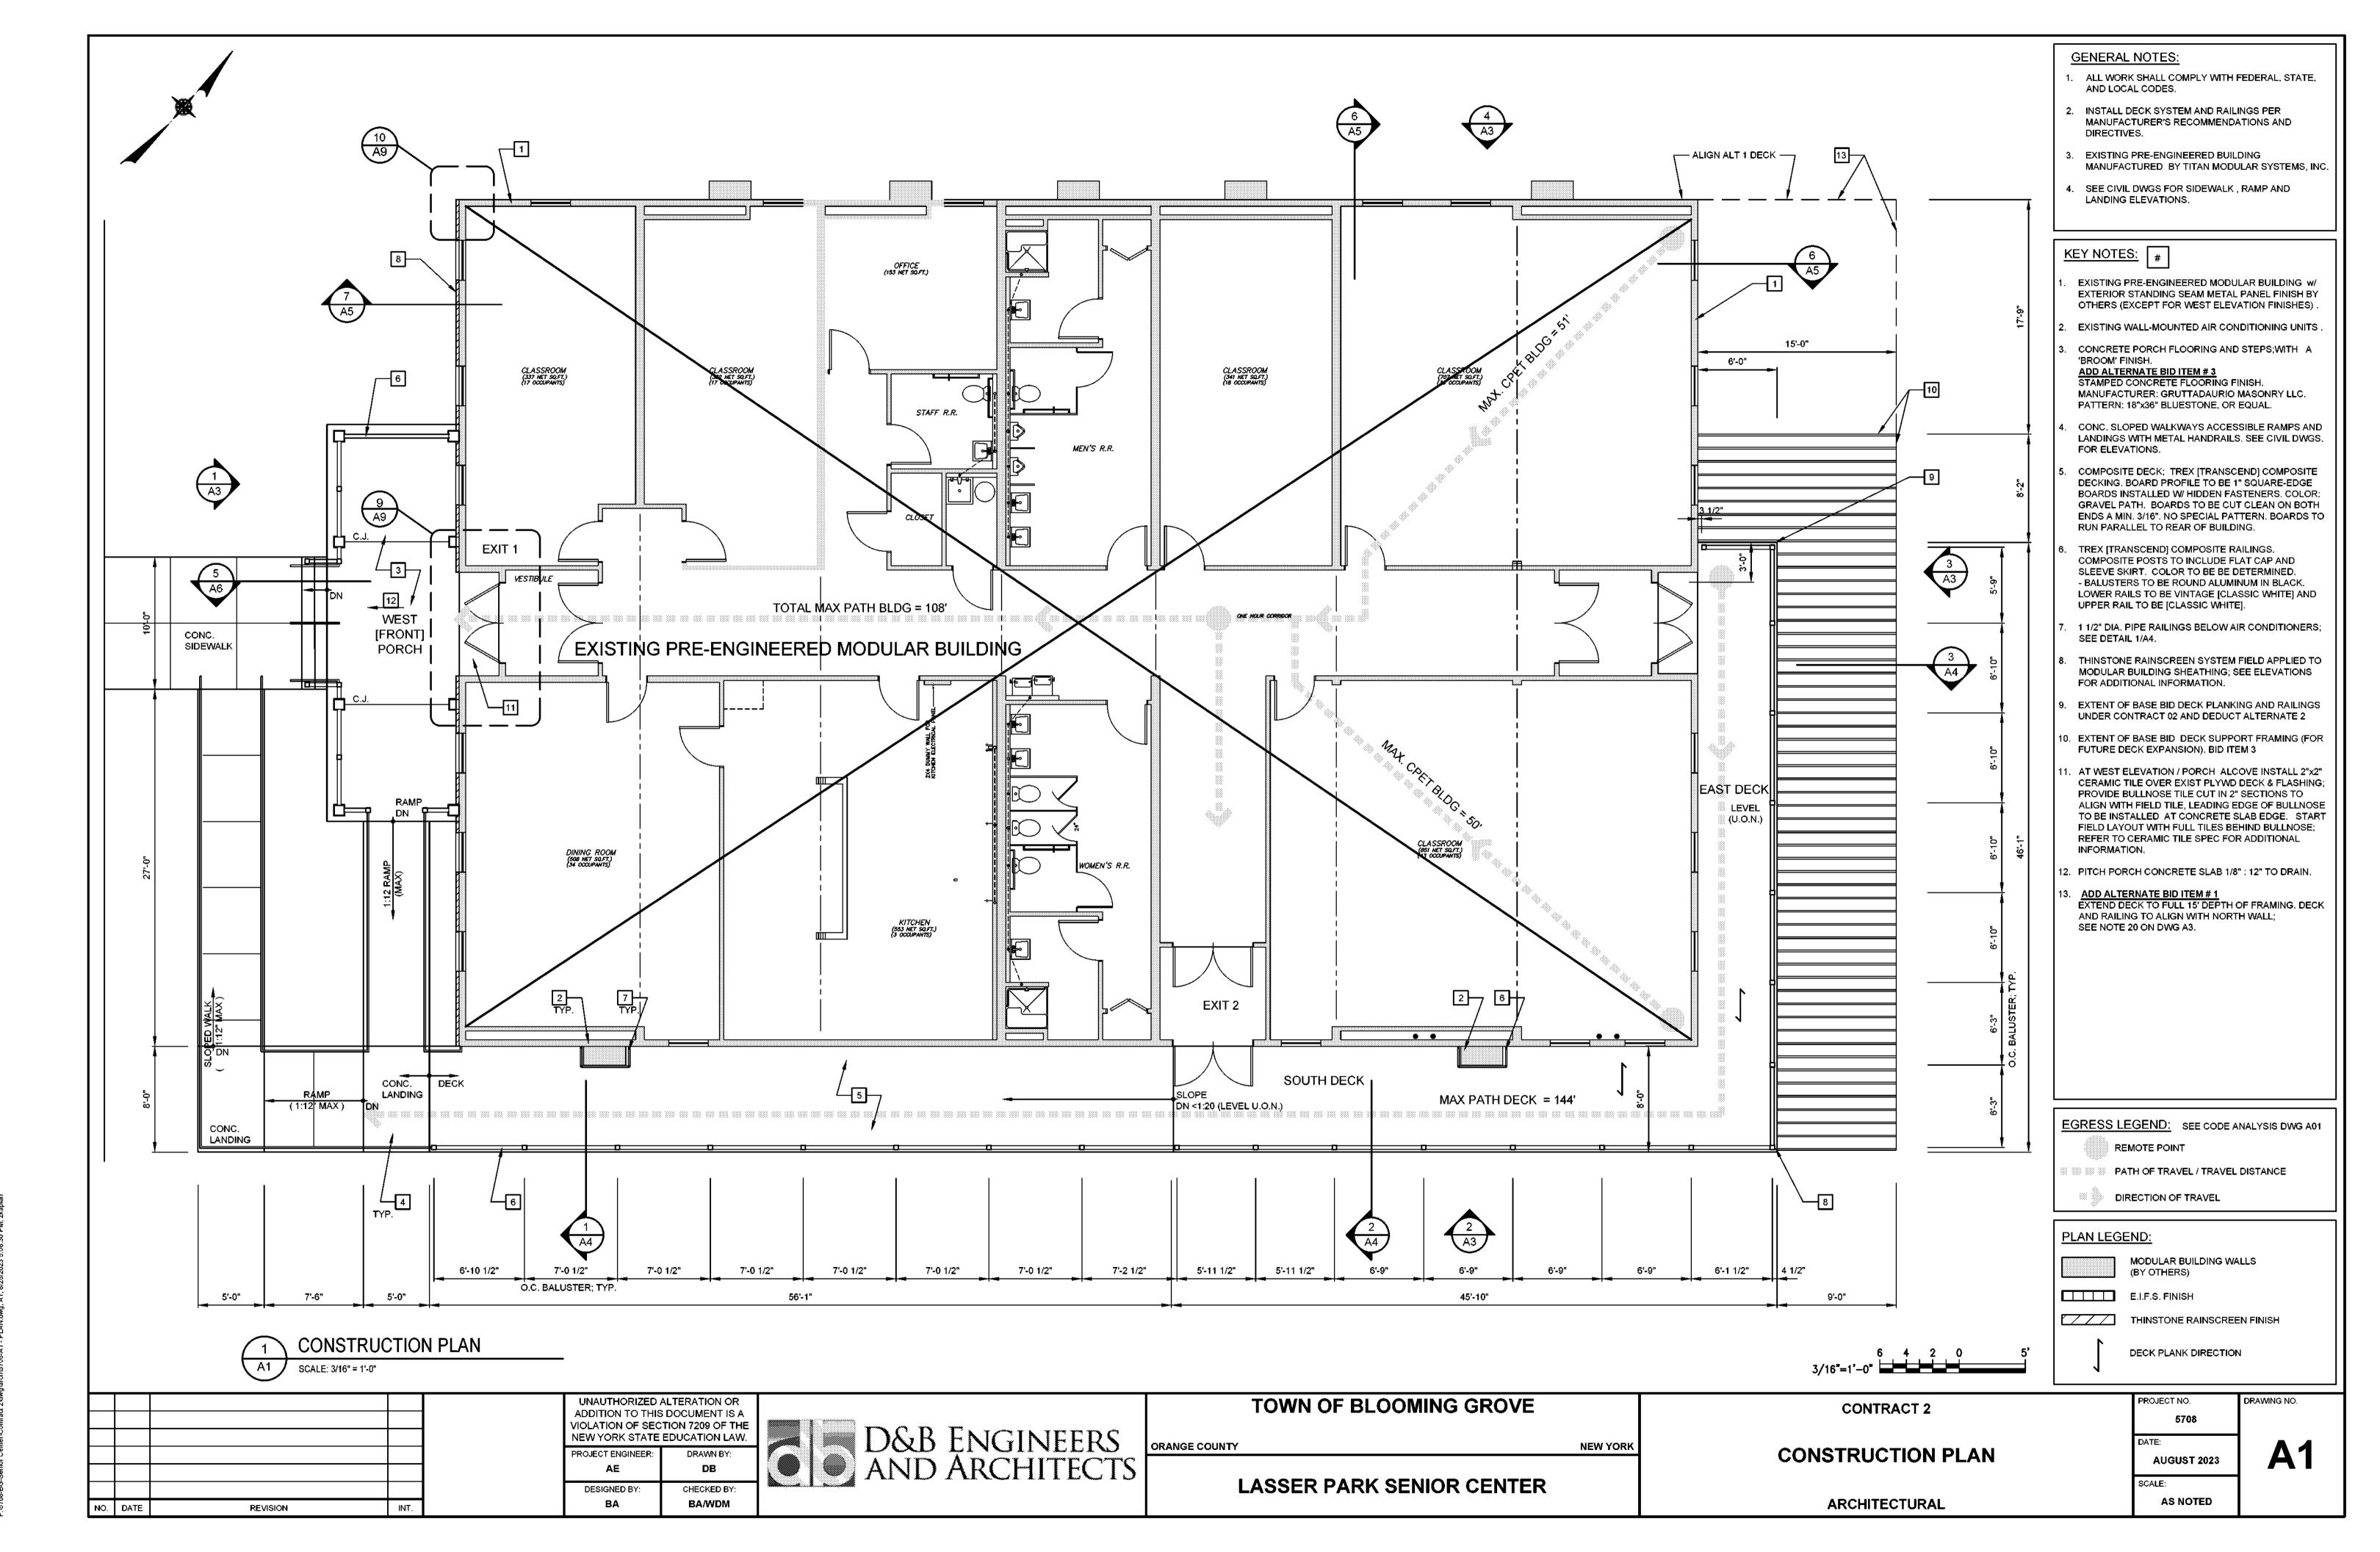
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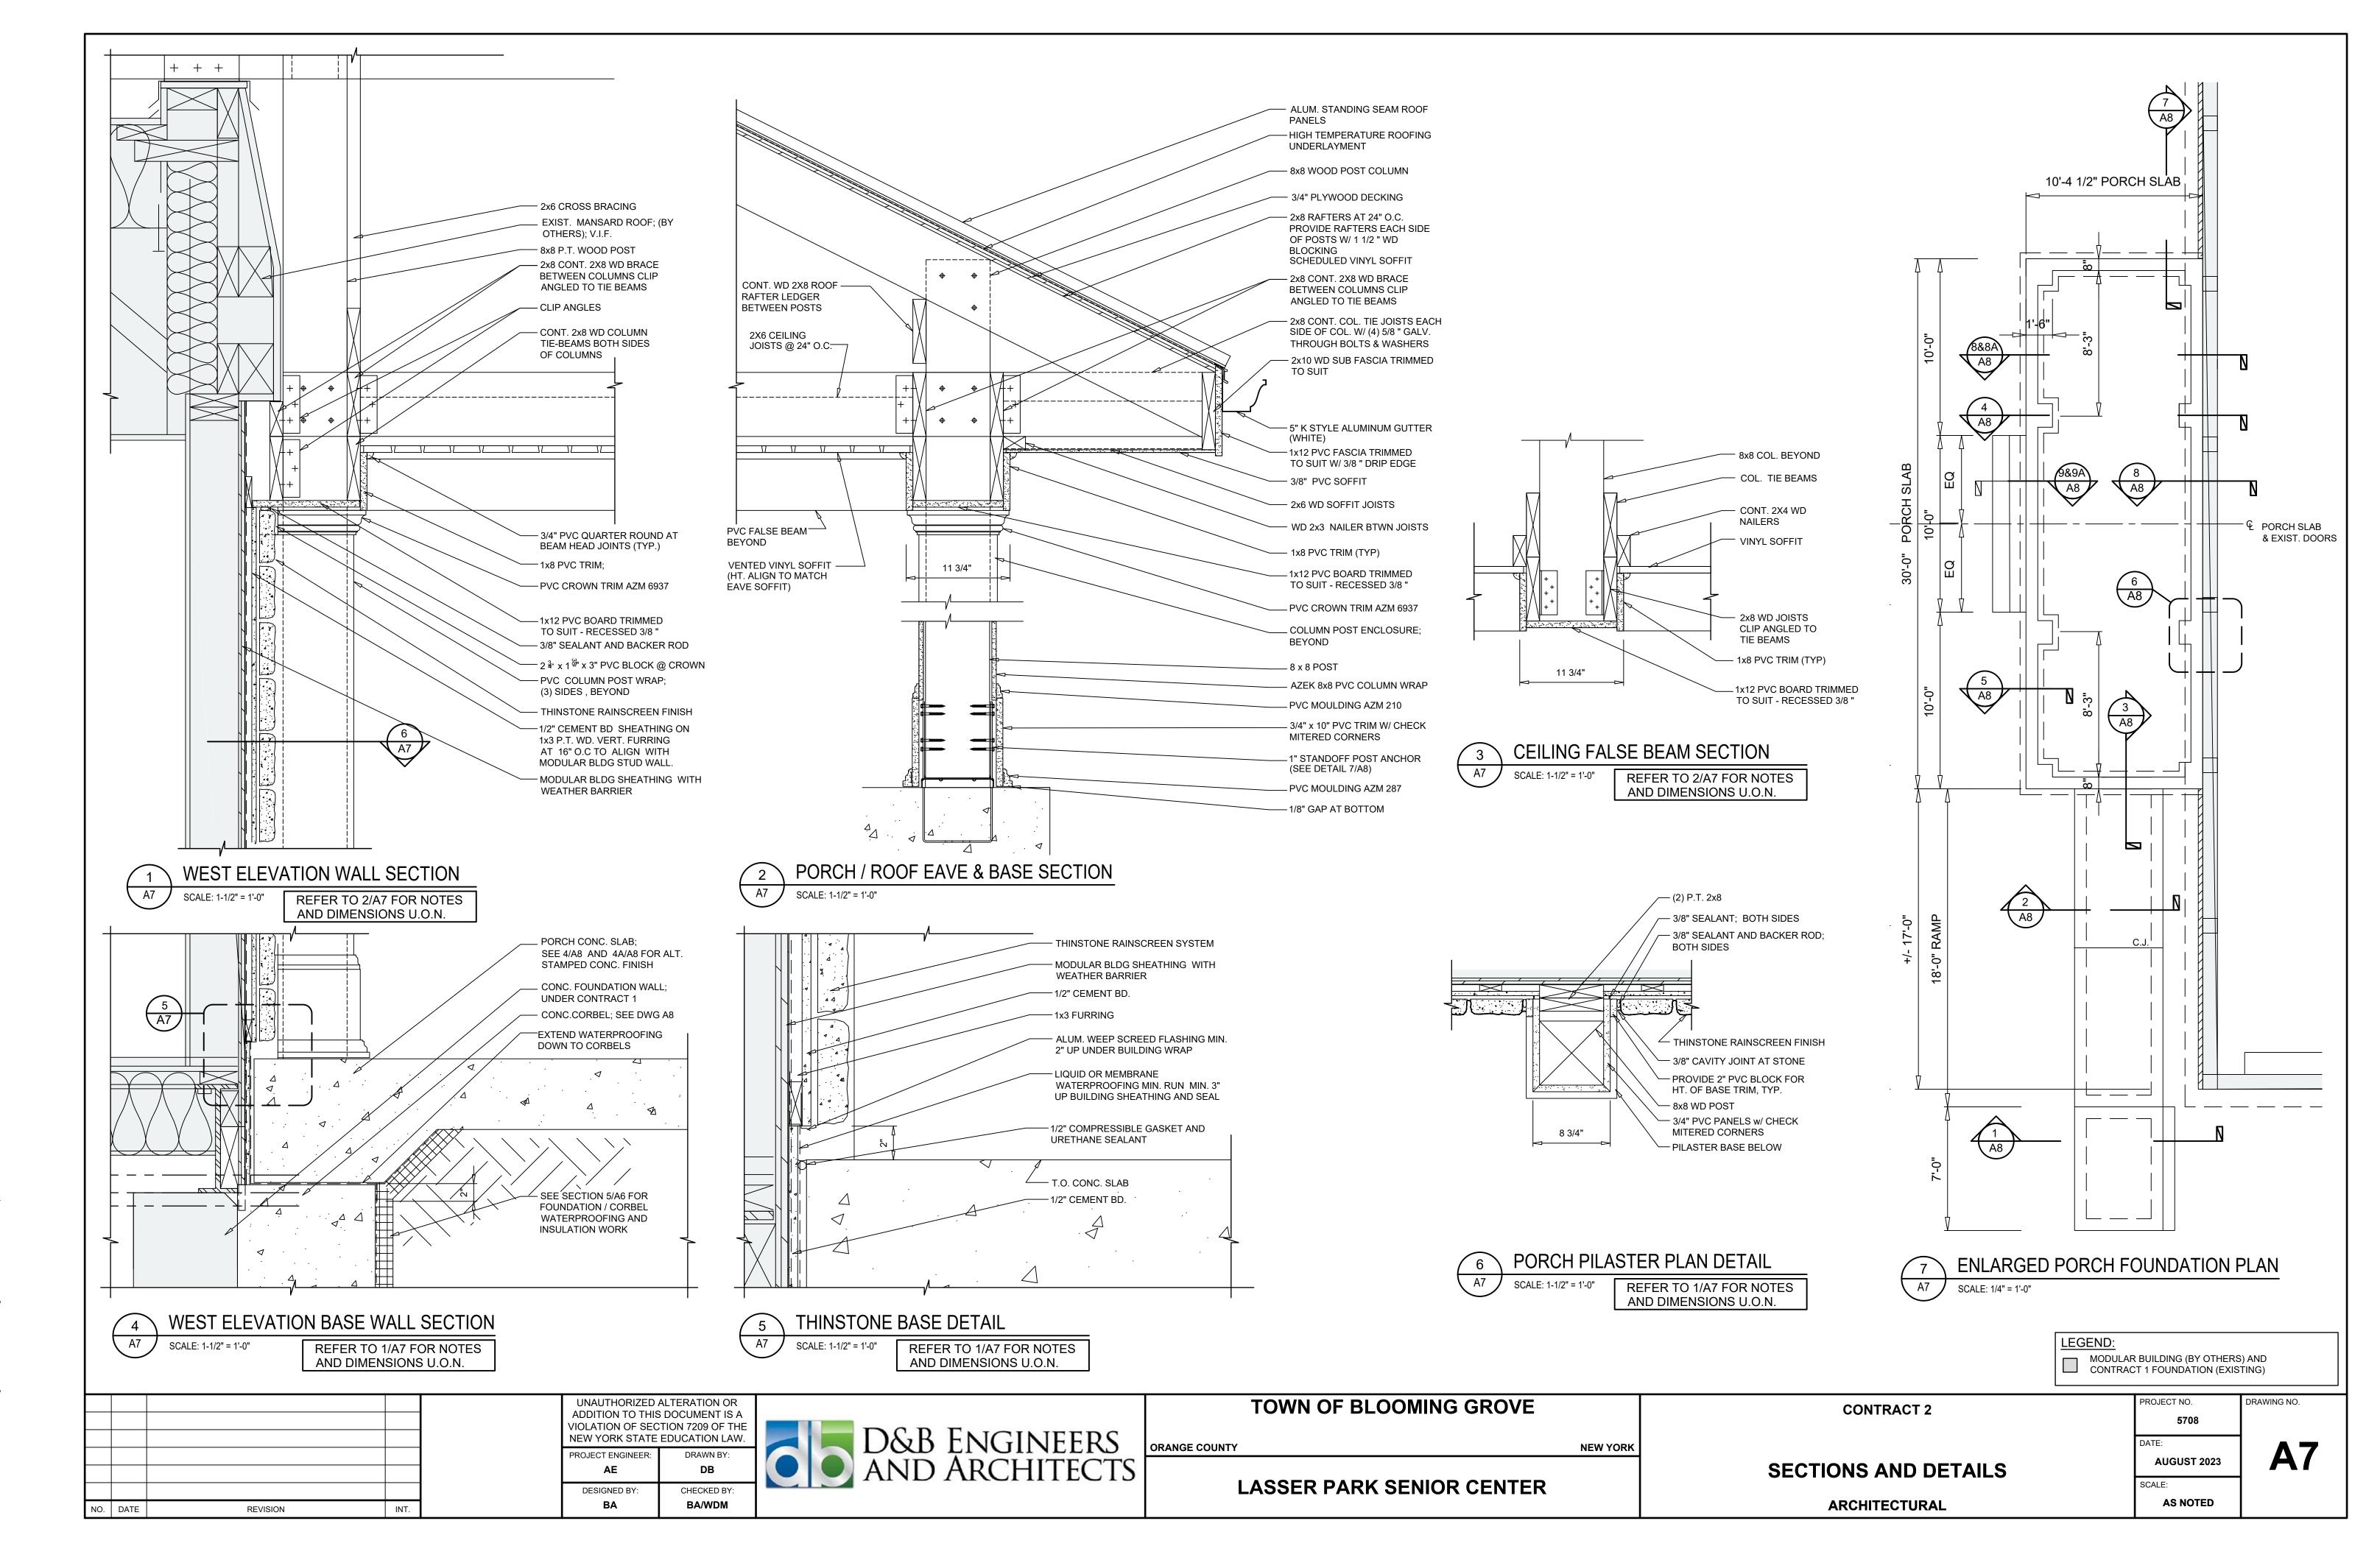


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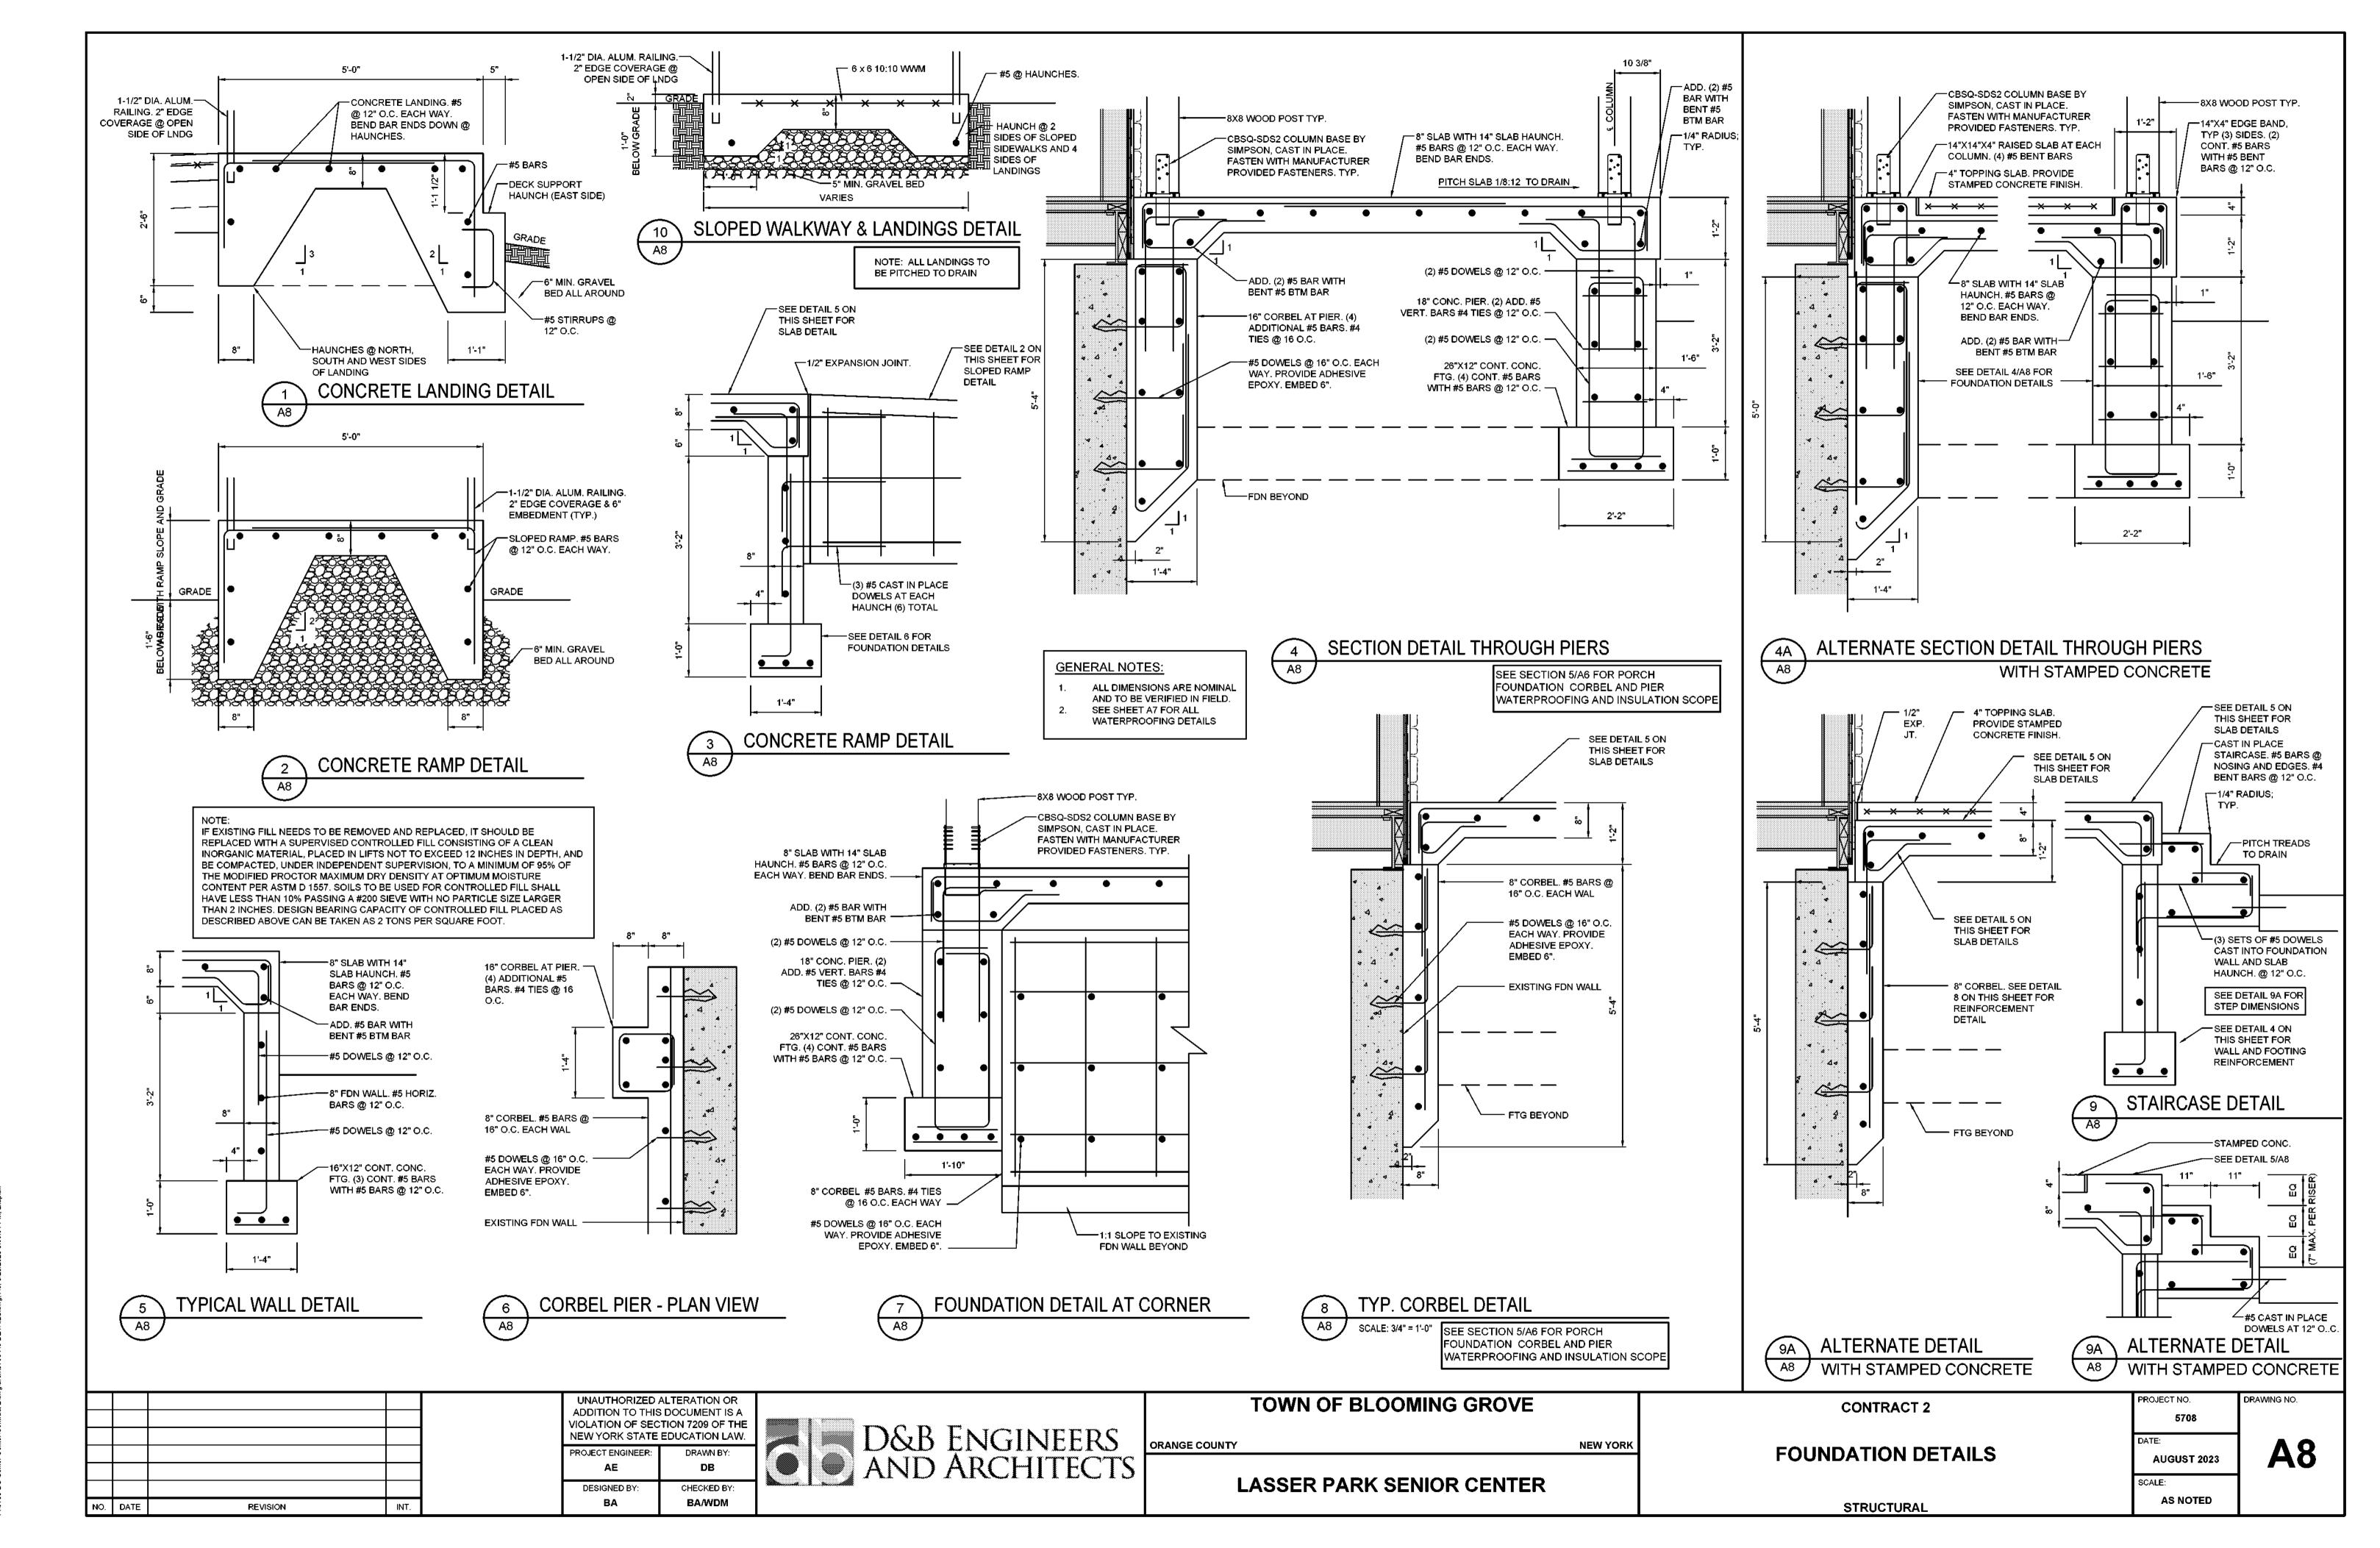


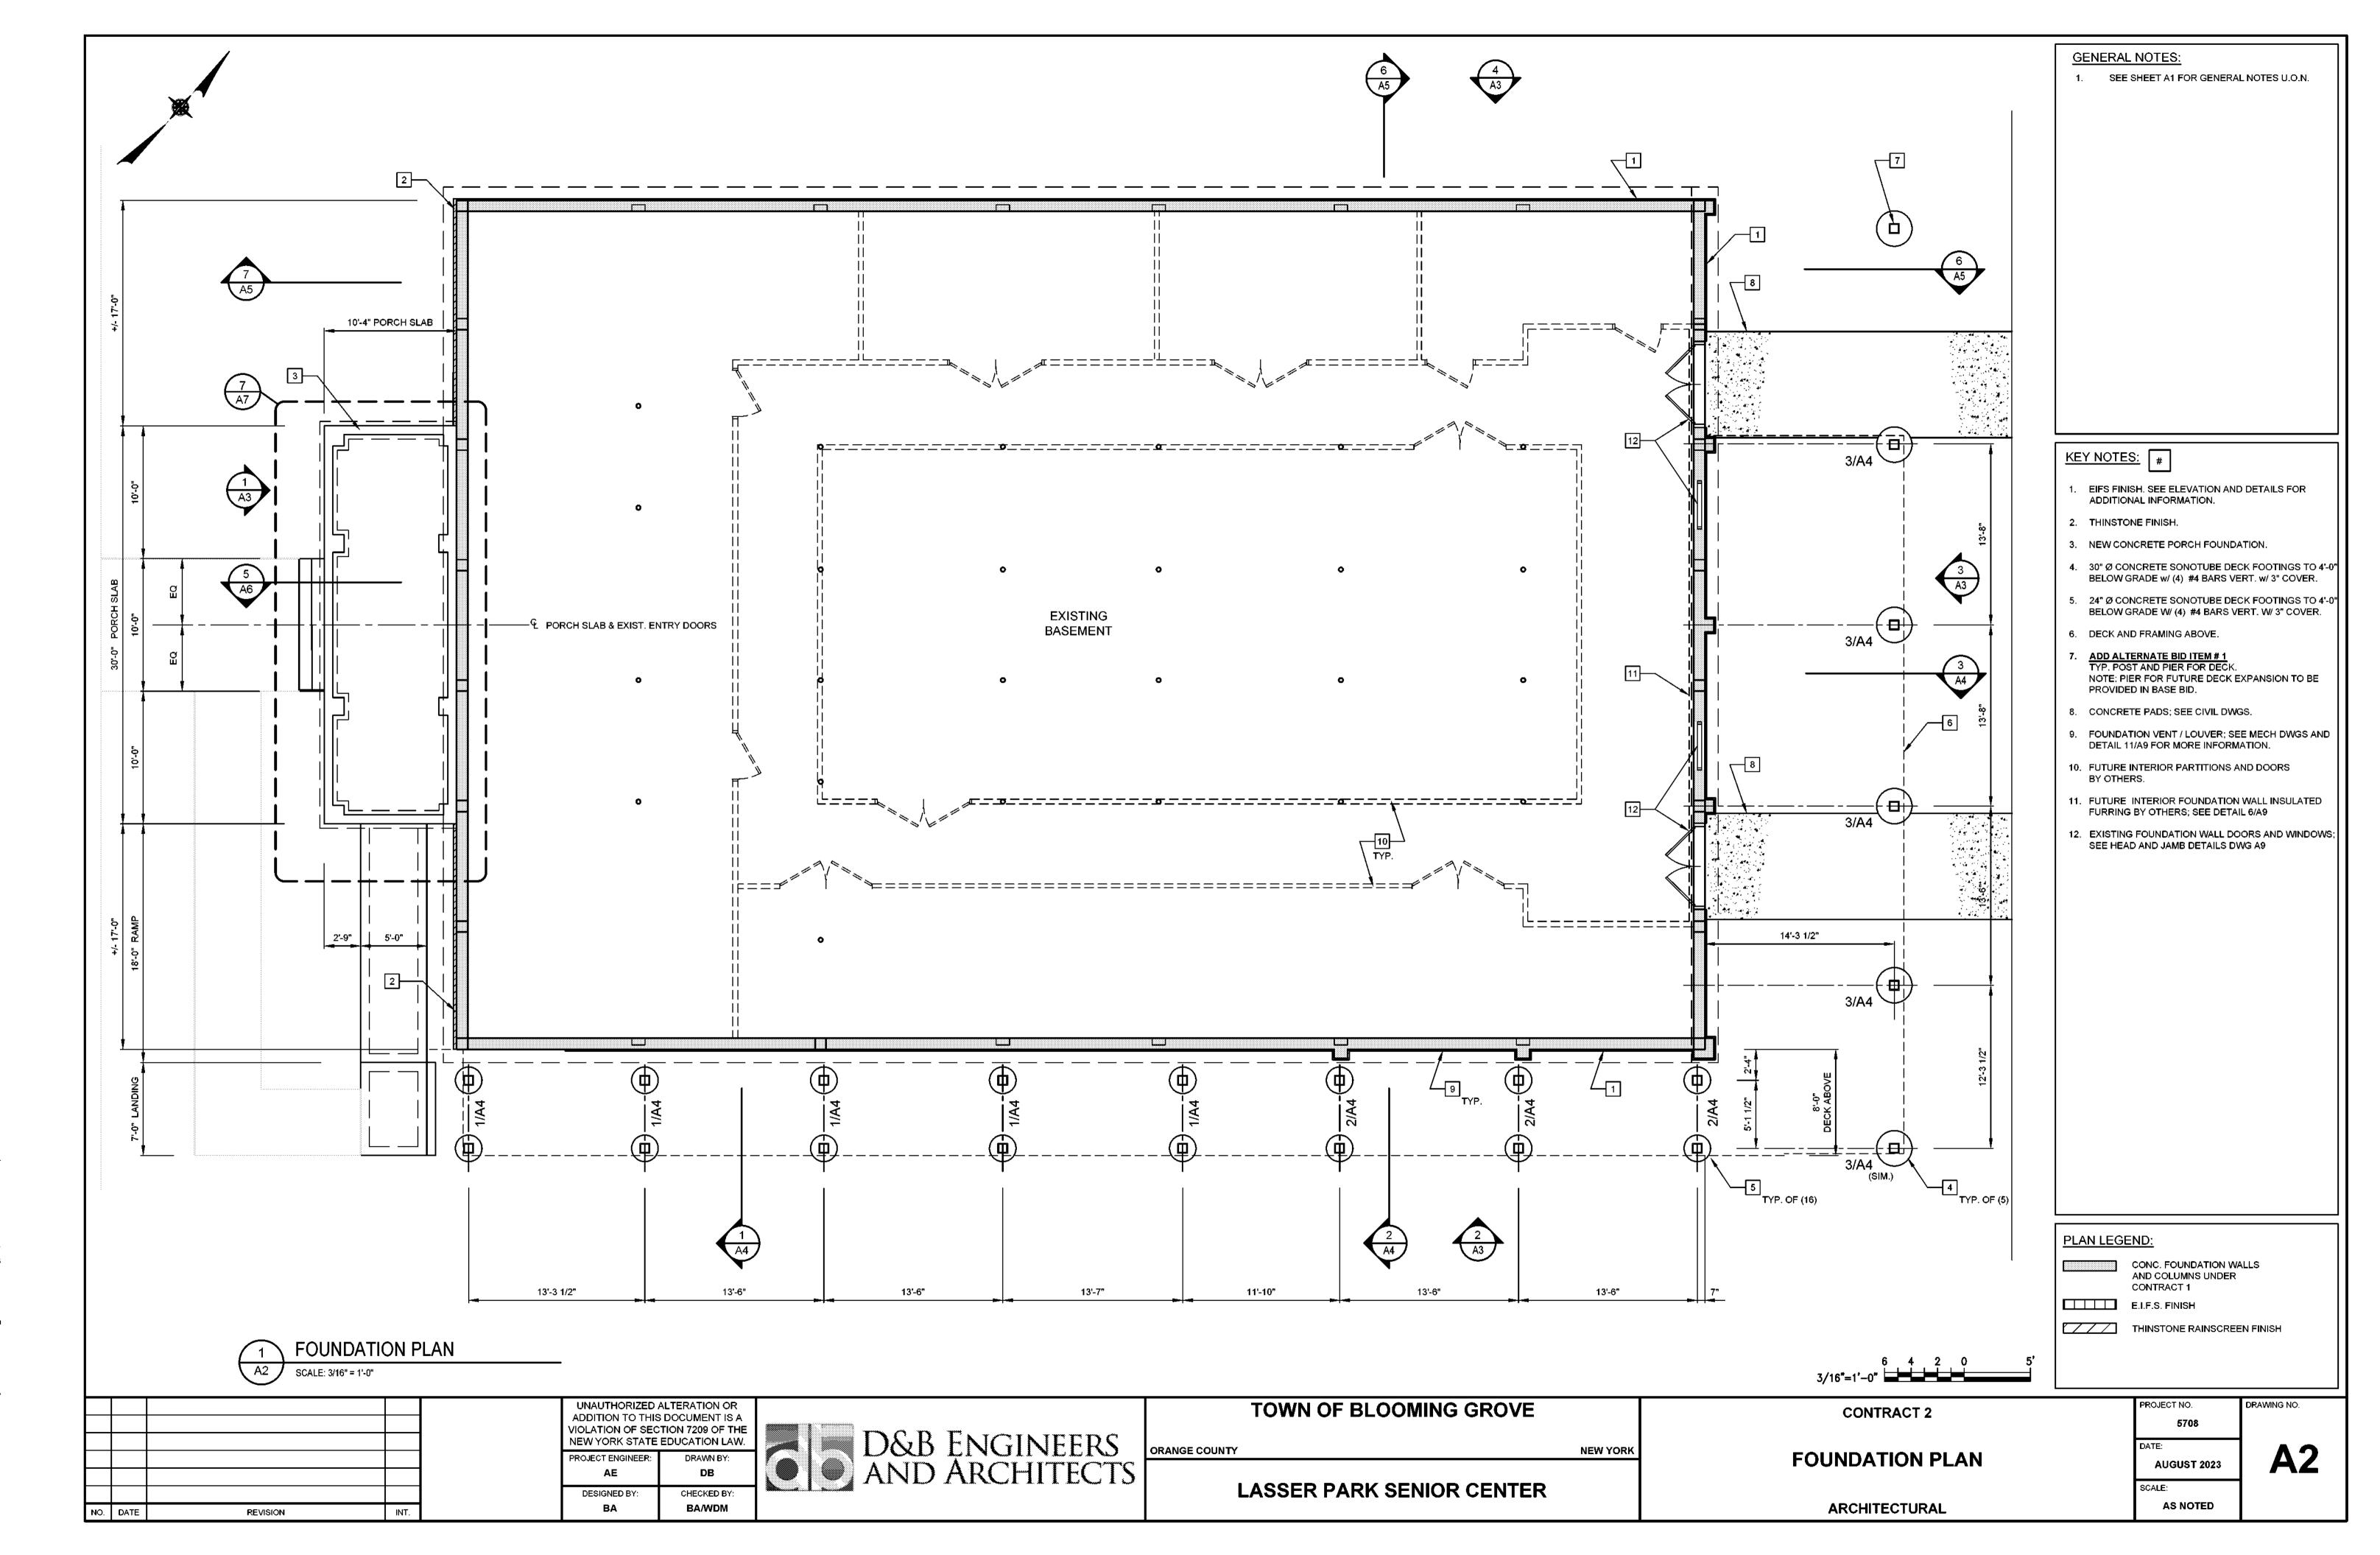


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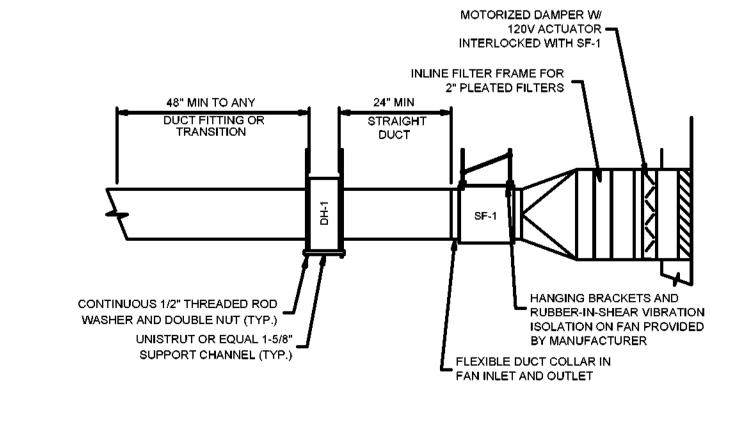

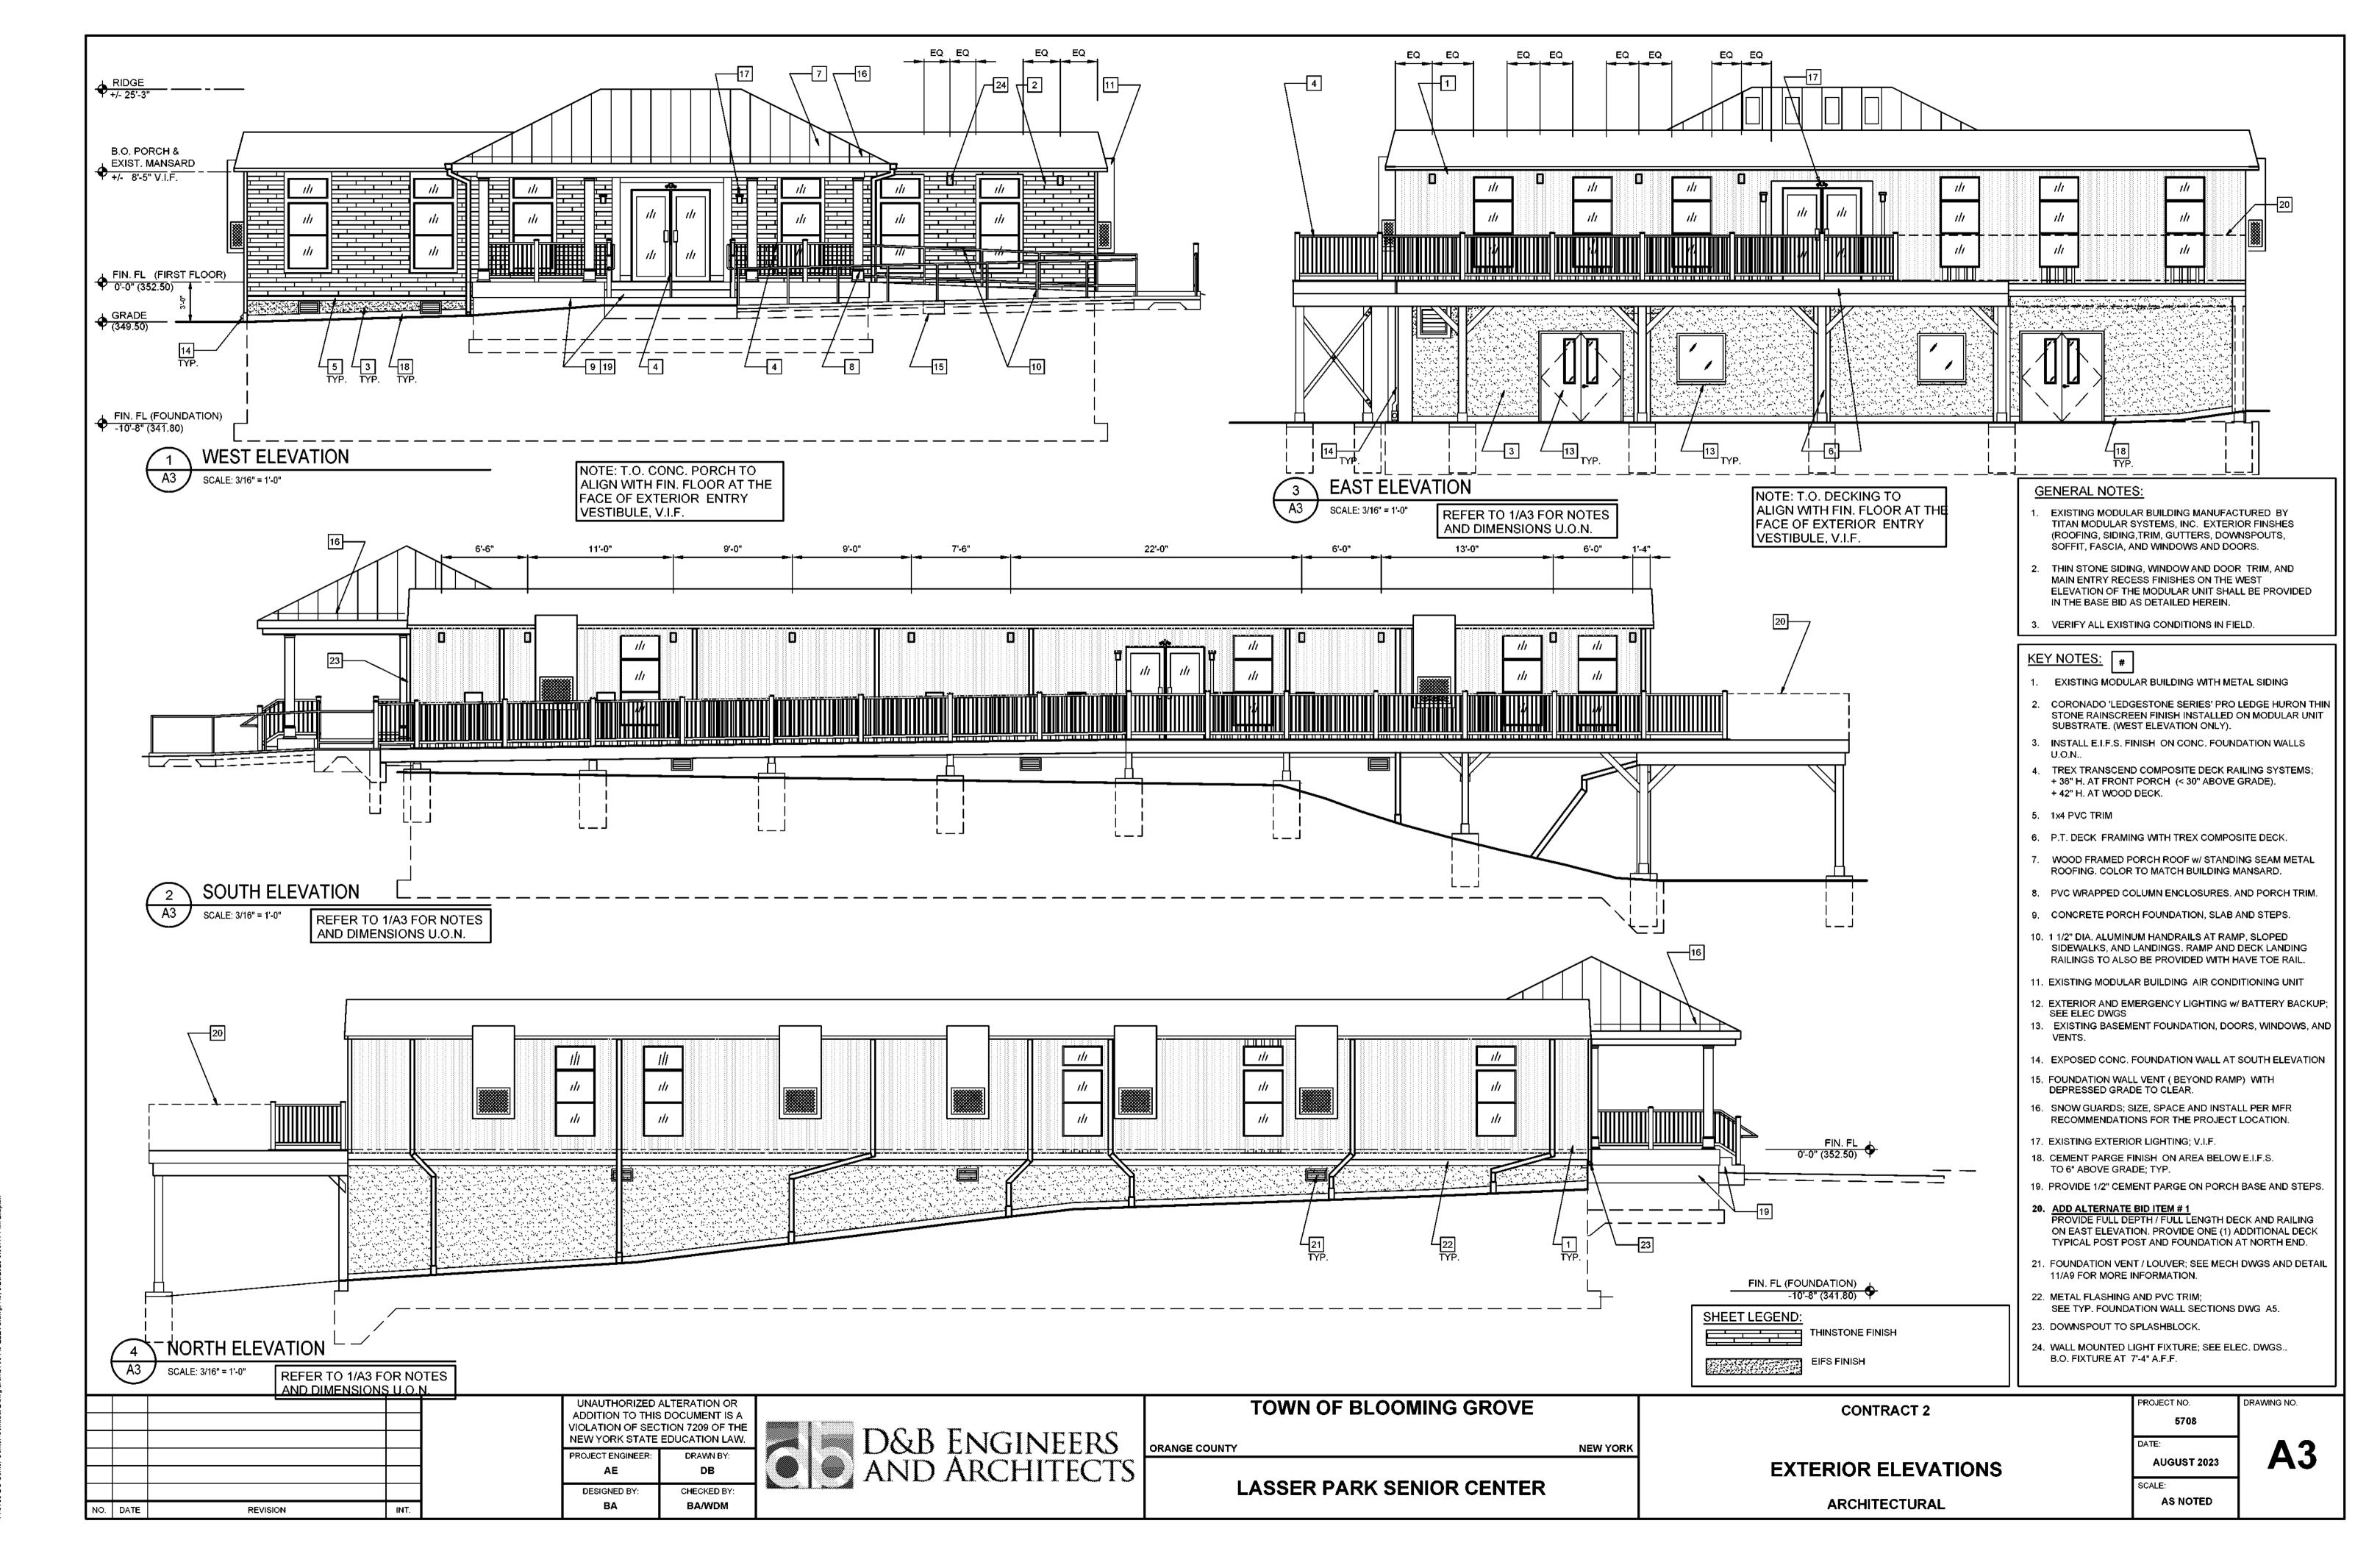
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E-15708-BG. Senior Cented/Contract 2)dum/serth 5708-40-DETAII S. dum. 49, 8/28/2023 5-00-07 DM - Wenten

| | 6"Ø (FUTURE) 6"Ø (FU**†**�RE)**| |** 9"Ø (FUTURE) 100 CFM 6 P (FUTURE) SUPPLY FAN SCHEDULE TYPE | DRIVE WxH ▮ L MODEL AREA SERVED. REMARKS GREENHECK SQ-120 CELLAR STORAGE 720 0.66 1/6 0.15 1140 INLINE DIRECT 115/1/60 INTERLOCK WITH DH-1 THERMOSTAT PROVIDE 2" FILTER FRAME ON INLET CENT. MERV 8 2" PLEATED DISPOSABLE FILTERS



PROVIDE 6" DUCT STUB FOR

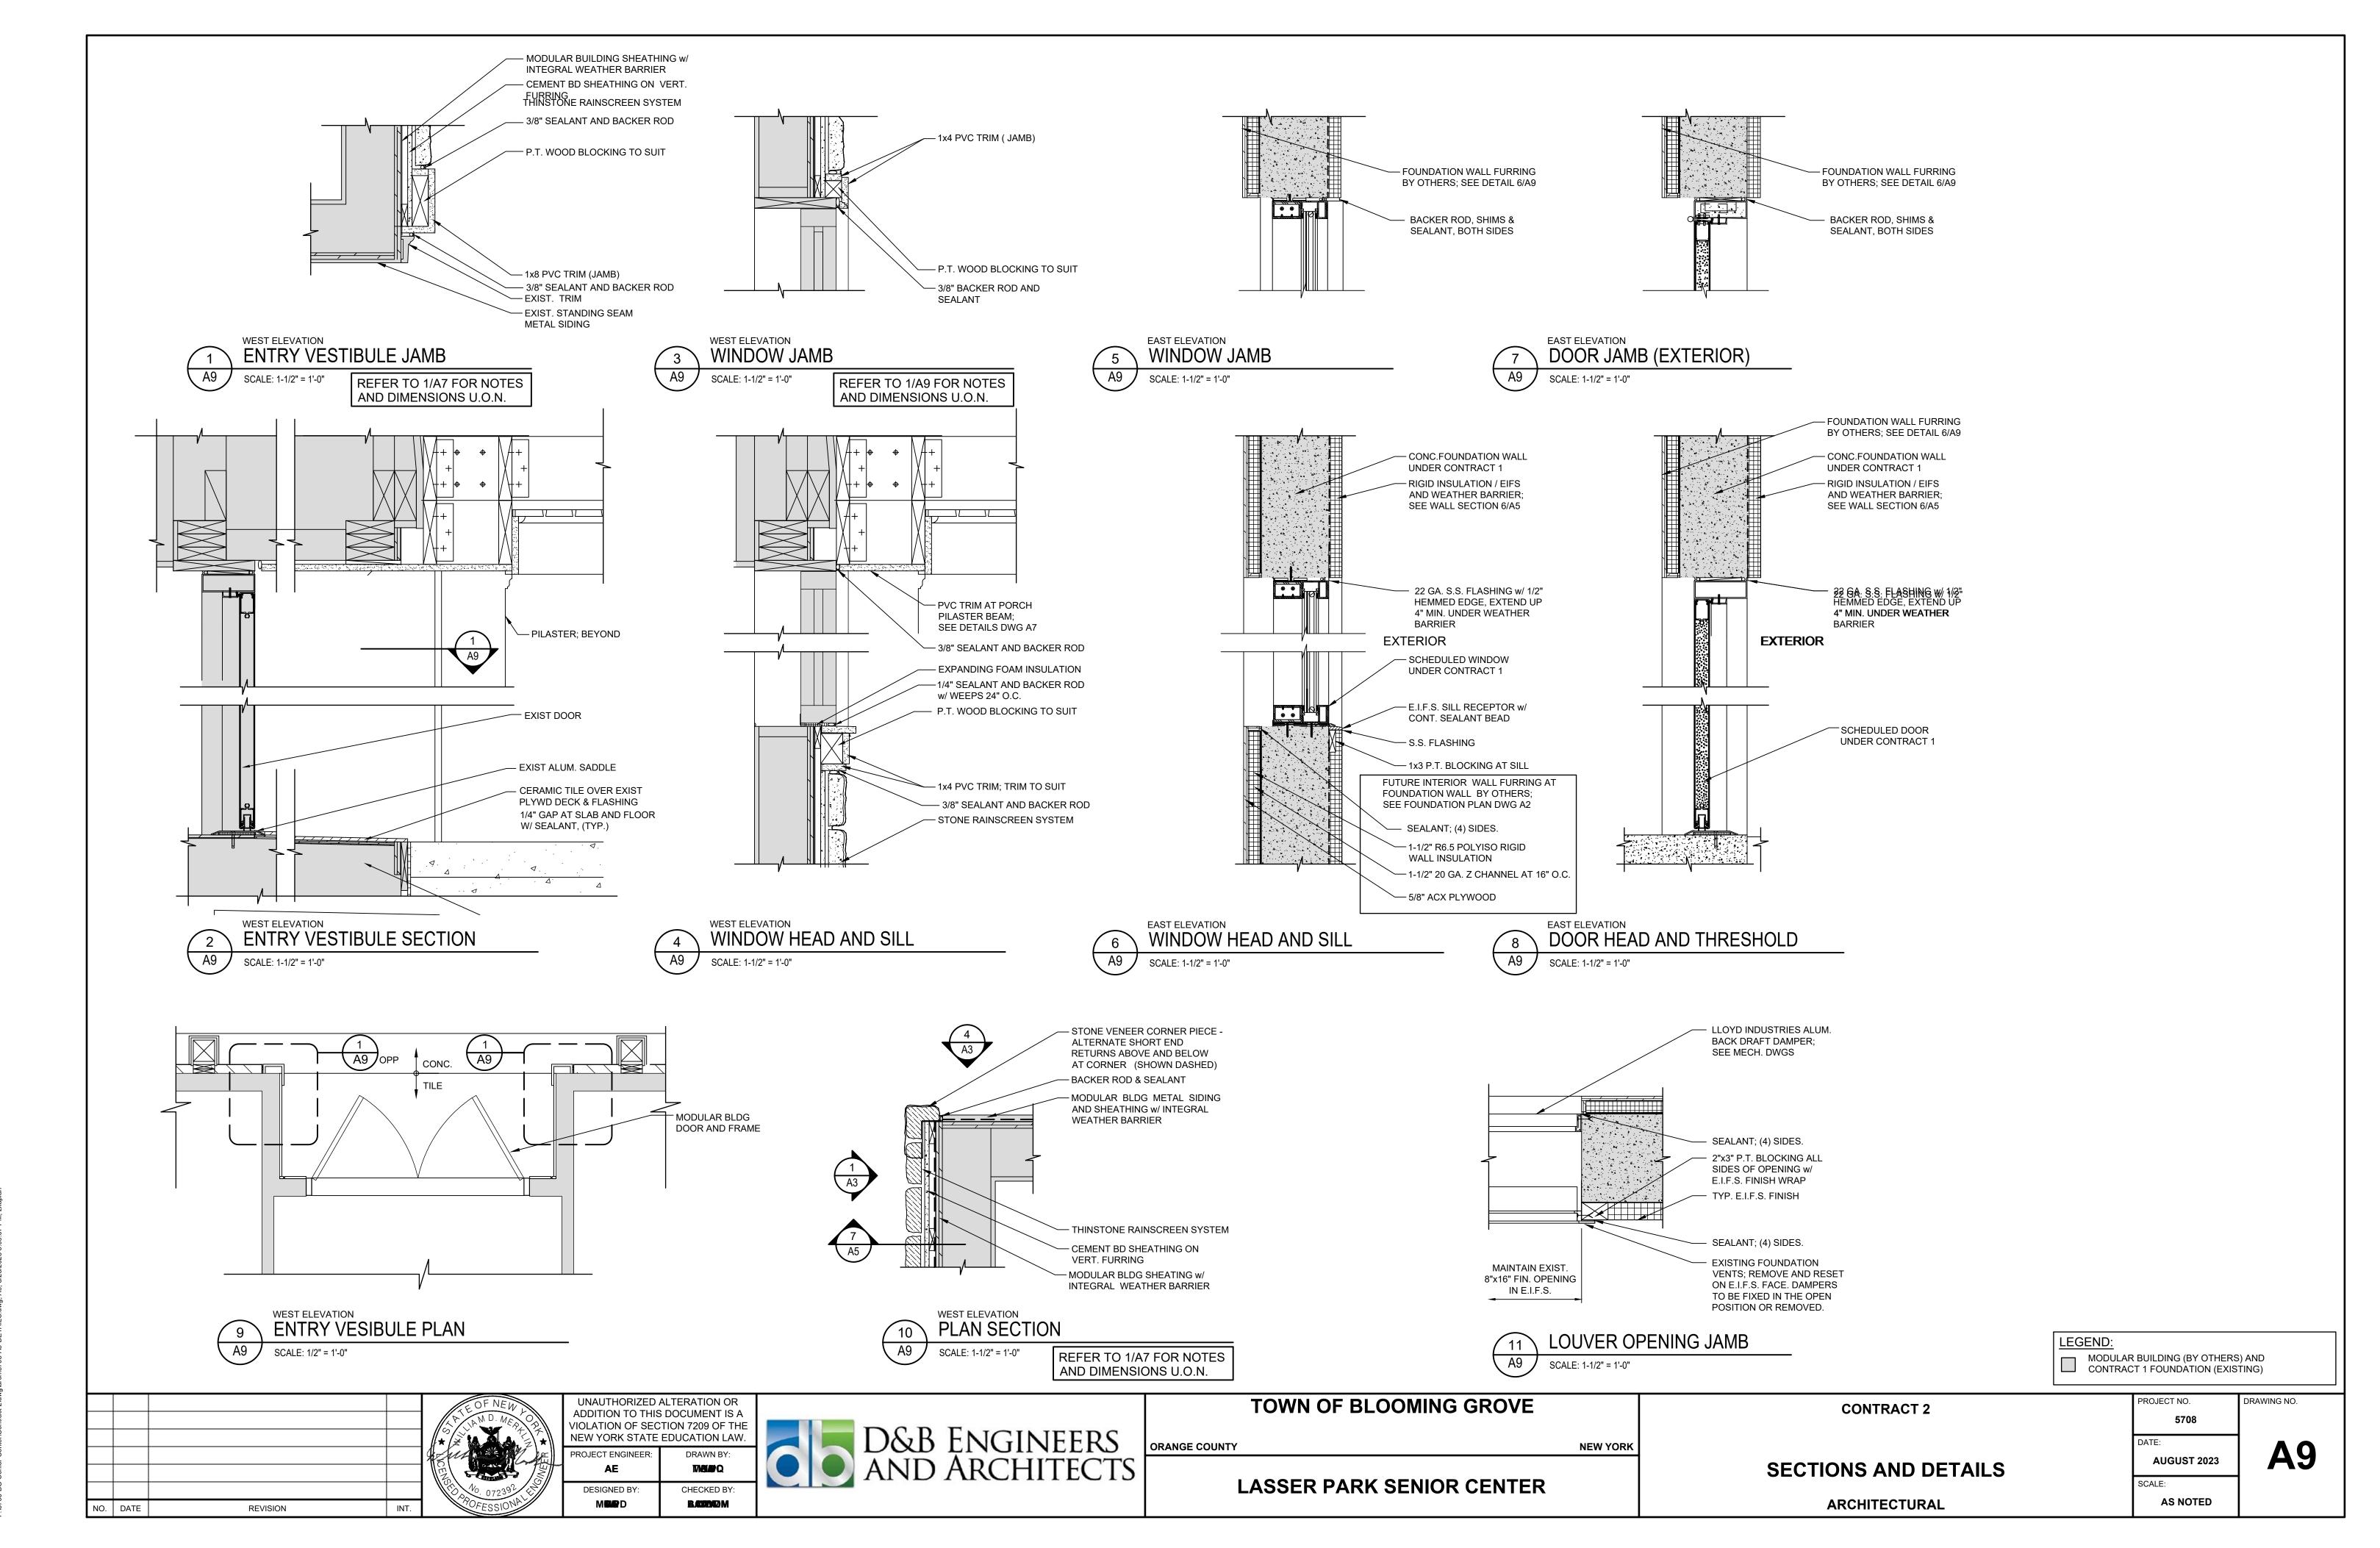FUTURE CONNECTION PROVIDE VOLUME DAMPER,

BALANCE TO 100 CFM

PROVIDE 9" DUCT TAP FOR

FUTURE CONNECTION PROVIDE VOLUME DAMPER,

BALANCE TO 340 CFM

PROPOSED FUTURE WALLS

- PROPOSED FUTURE WALLS -

MECHANICAL - NEW WORK GENERAL NOTES

- 1. DUCTWORK SHALL BE CONSTRUCTED AND INSTALLED IN ACCORDANCE WITH SMACNA STANDARDS.
- 2. PROVIDE PROPER ACCESS TO MATERIALS AND EQUIPMENT THAT REQUIRE INSPECTION, REPLACEMENT, REPAIR OR SERVICE SUCH AS COILS, DAMPERS, HEATERS, VALVES, ETC.
- 3. MAINTAIN MAXIMUM HEADROOM AT ALL TIMES. ALL PIPING TO BE INSTALLED AS HIGH AS POSSIBLE. ALL DUCTWORK SHALL BE INSTALLED AS CLOSE AS POSSIBLE TO 'WALL AND UNDERSIDE OF MATELINE BEAMS'.
- 4. CONTRACTOR IS RESPONSIBLE FOR ALL WORK RELATED TO ISOLATING, SHUTTING DOWN, DRAINING, FILLING AND RESTARTING SYSTEMS, INCLUDING THOSE REQUIRED FOR RELOCATIONS, TO ALLOW FOR COMPLETION OF ALL
- 5. CONTRACTOR SHALL FURNISH ALL REQUIRED FLUIDS FOR FILLING NEW SYSTEMS OR REFILLING EXISTING SYSTEMS. CONTROLS AND WIRING FOR ALL HVAC EQUIPMENT SHALL BE BY CONTRACTOR.

MECHANICAL COMMISSIONING:

1. CONTRACTOR SHALL COMMISSION AND STARTUP 1.5 TON AND 3-TON UNITS WITH ELECTRICAL HEATING UNITS ON THE ENDS OF EACH TRAILER MODULE SECTIONS A-G, SEE REFERENCE DRAWINGS. EACH UNIT SHALL BE TESTING, STARTED UP AND CHECKED COMPLETE FOR PROPER OPERATION. PRIOR TO FINAL COMPLETION CONTRACTOR SHALL FURNISH AND INSTALL NEW FILTERS THROUGHOUT.



NO. DATE REVISION

CATALOG #

AREA SERVED.

CELLAR STORAGE

DUCT HEATER SCHEDULE

INDEECO

DH-1

UNAUTHORIZED ALTERATION OR ADDITION TO THIS DOCUMENT IS A VIOLATION OF SECTION 7209 OF THE NEW YORK STATE EDUCATION LAW. CHECKED BY:

REMARKS

BASIC CONTROLS (CODE G) W/ TRANSFORMER DELETE

STANDARD BUILT-IN AIRFLOW SWITCH THERMOSTAT HONEYWELL T812C OR EQUAL SUPPLY EXTERNAL 24VAC CONTROL TRANSFORMER

DIMENSIONS DUCT COIL

KW STAGES ELECTRICAL

208/3/60

35 AMP



	TOWN OF BLOOMING GROVE	
OUNTY		NEW YORK

LASSER PARK SENIOR CENTER

VD 90 CFM

FAN & HEATER

FLOOR PLAN - BASEMENT


CONTRACT 2


AUGUST 2023

PROJECT NO.

MECHANICAL

3/16" = 1'-0"

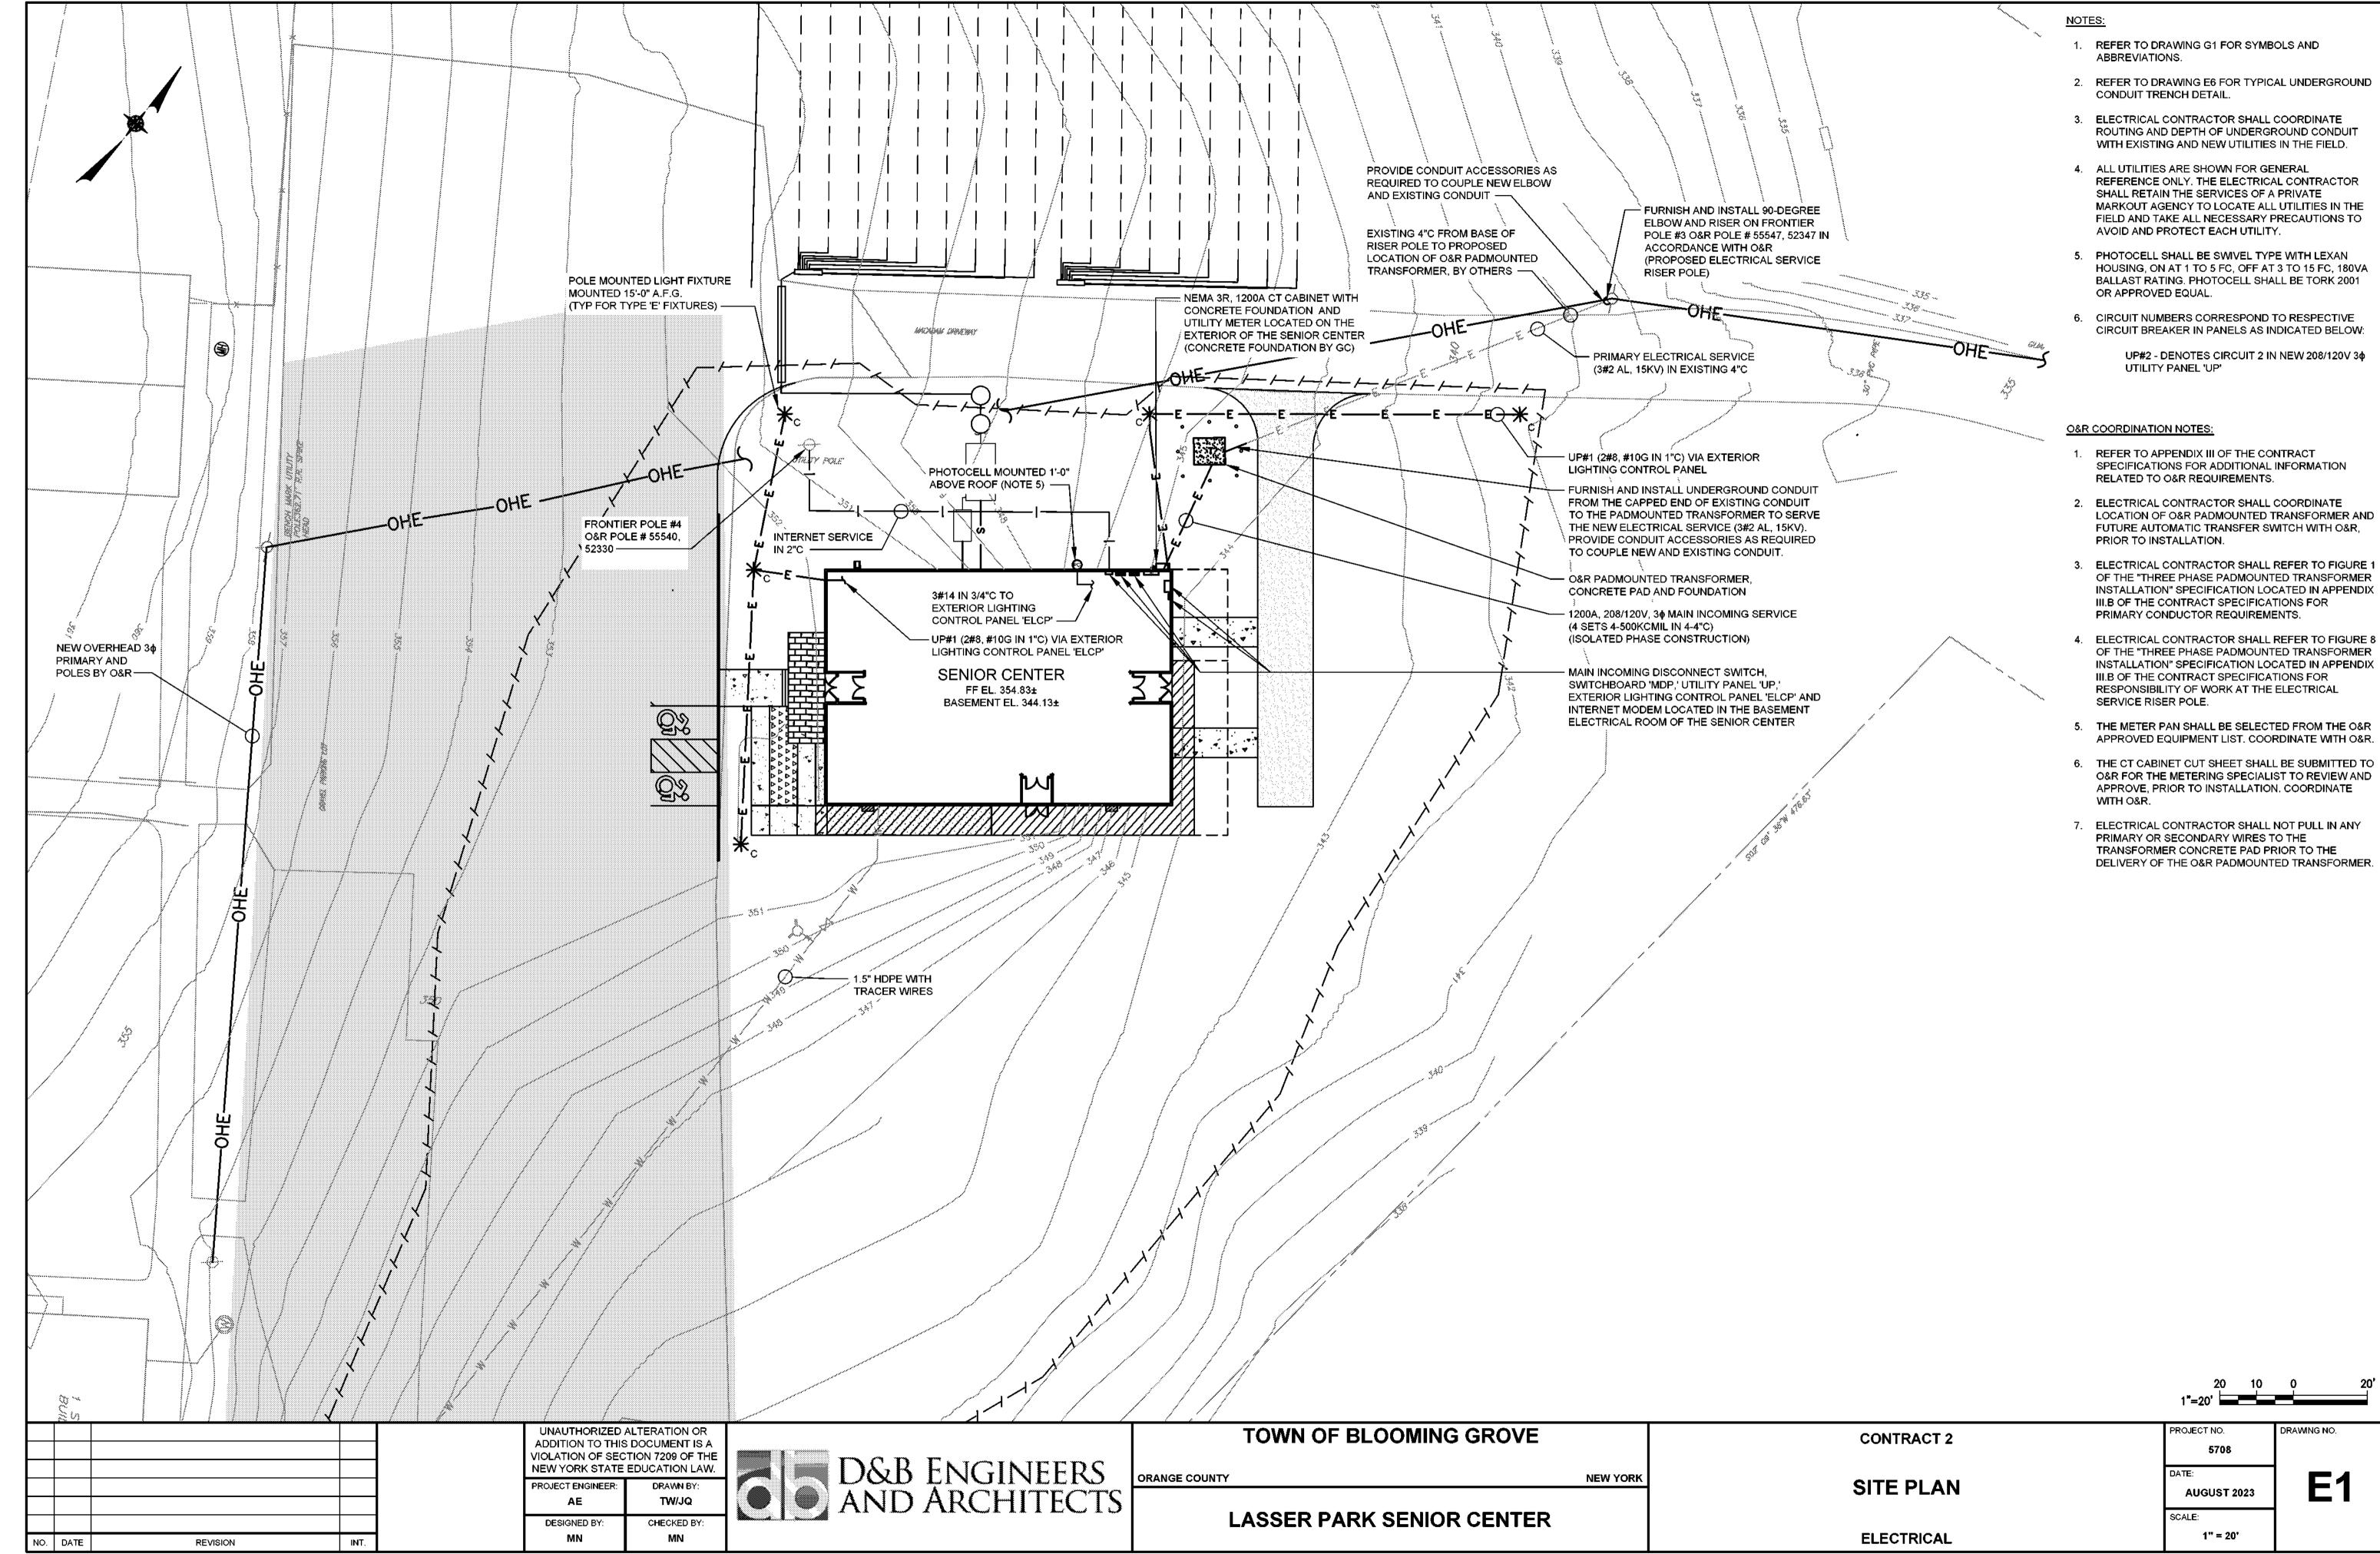

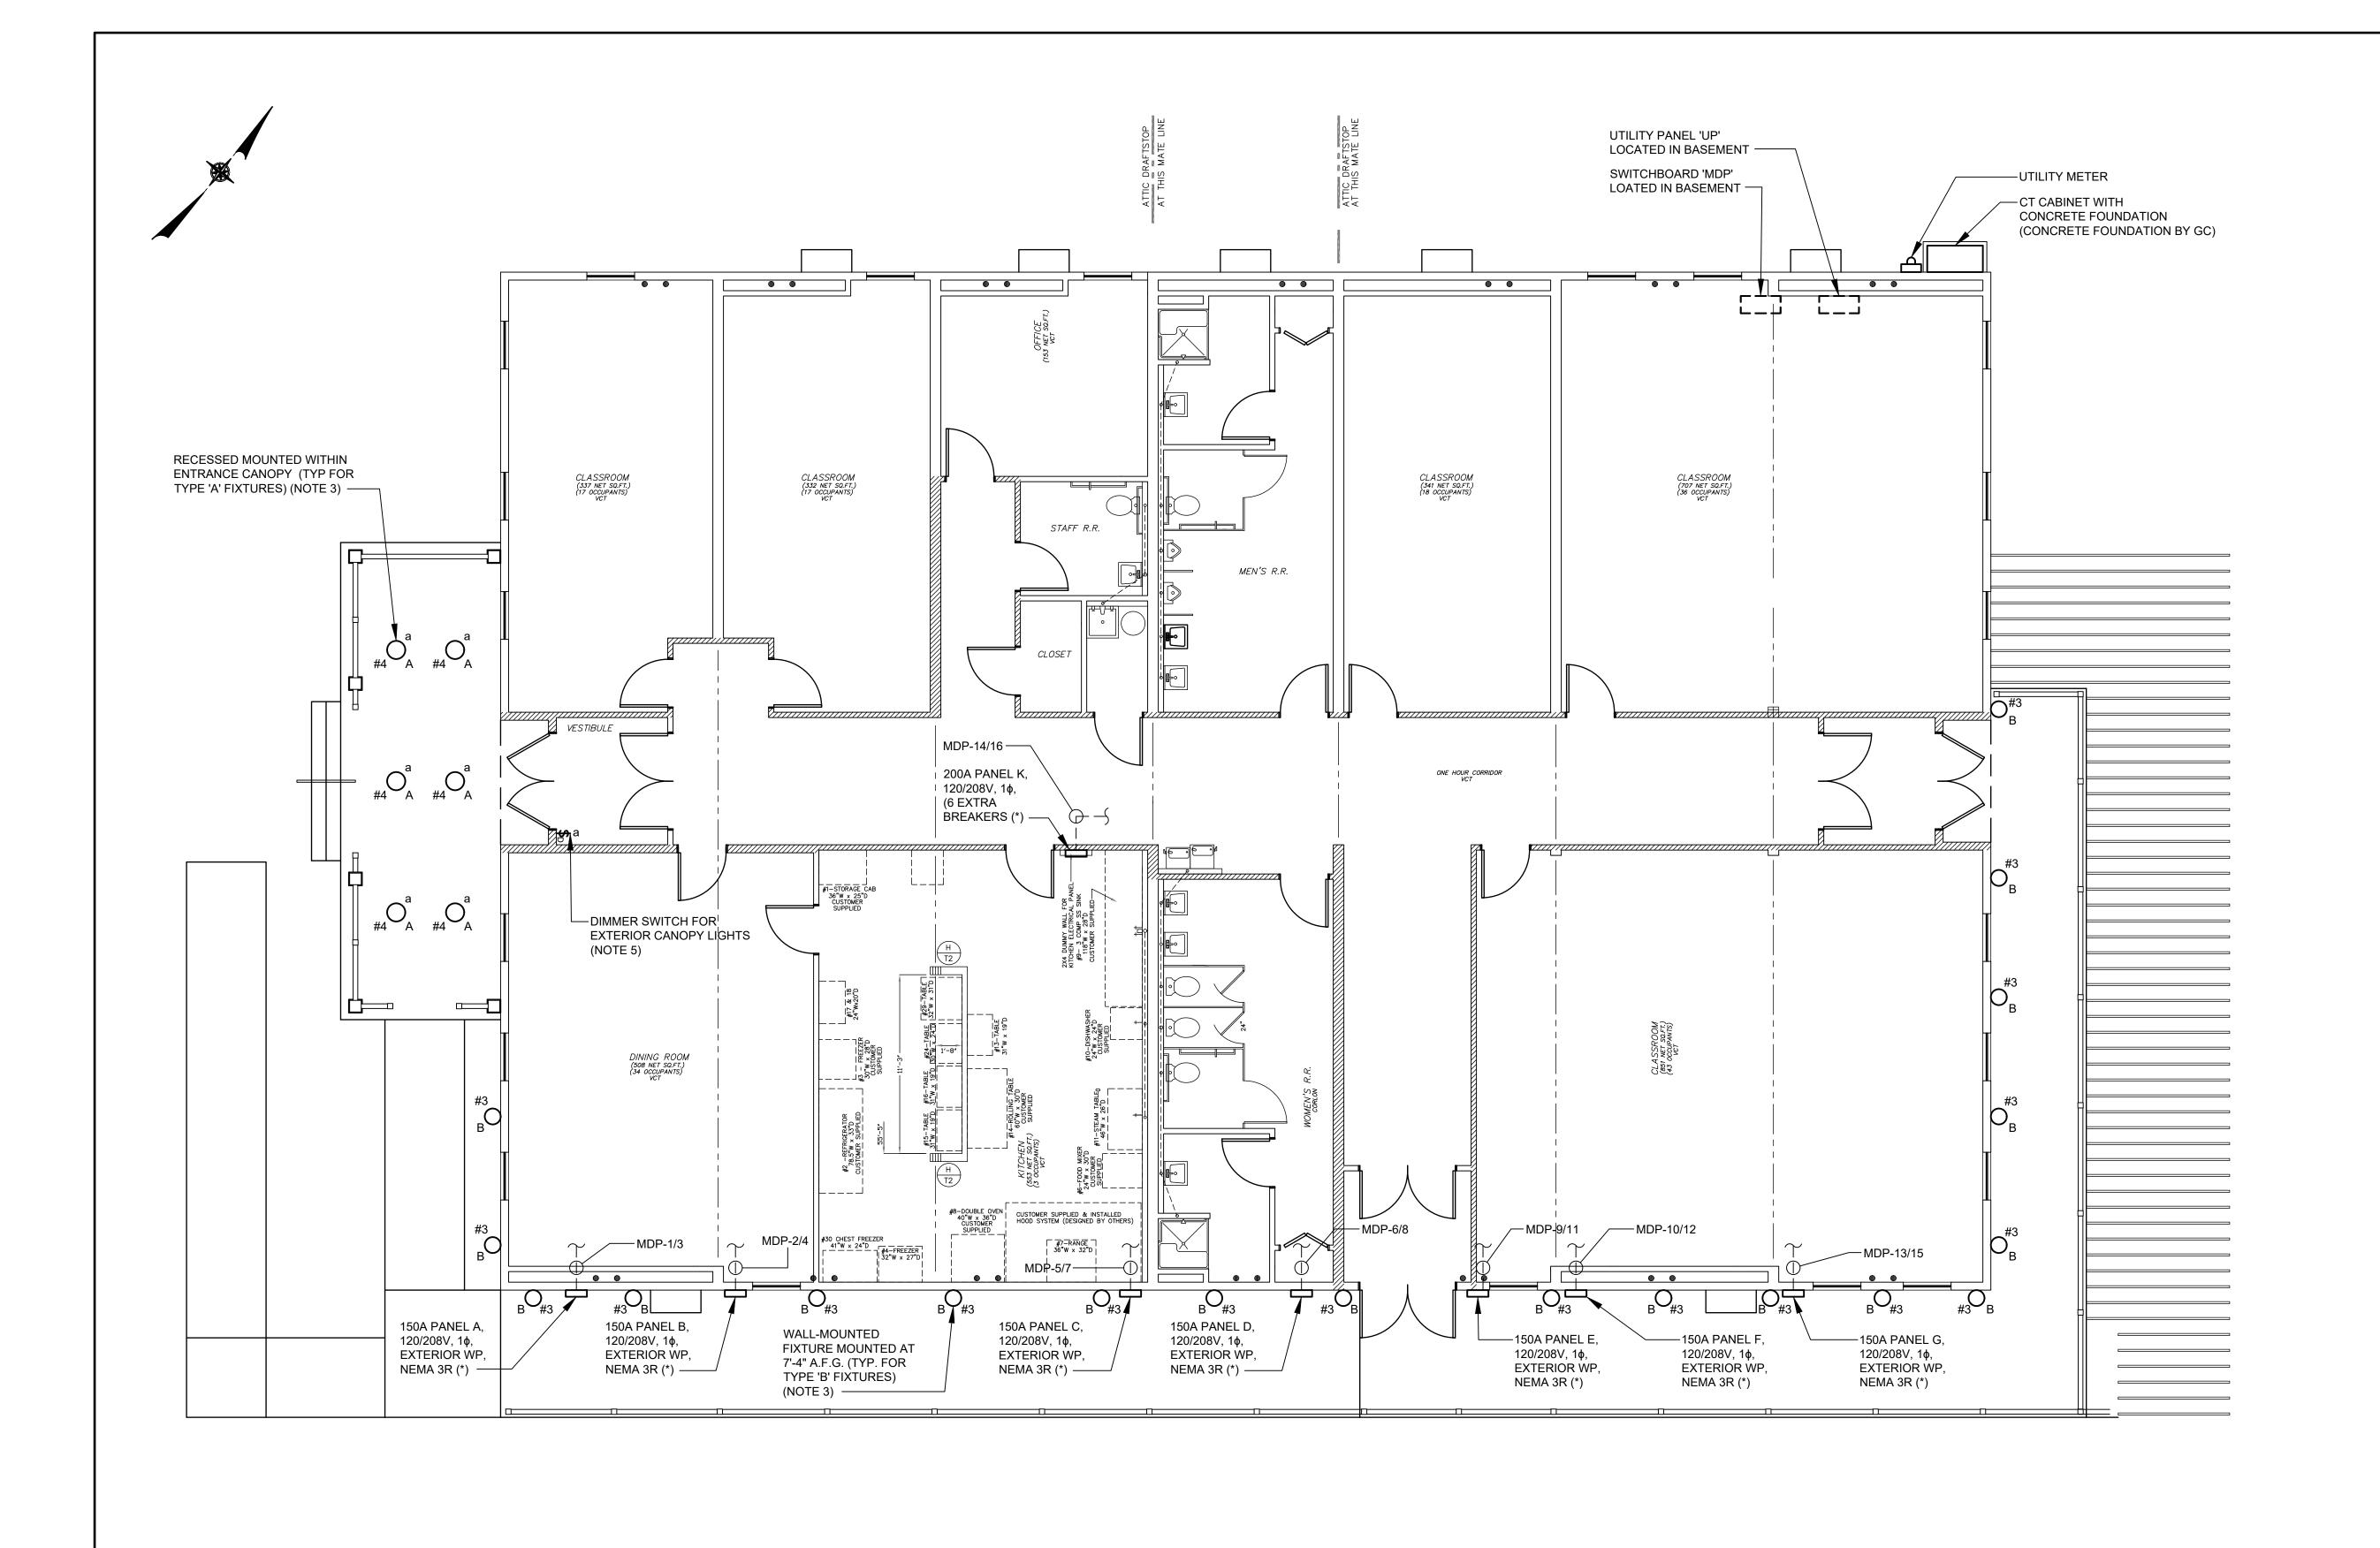

6 4 2 0 5'

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PROJECT ENGINEER: DRAWN BY:
AE TW/JQ

DESIGNED BY: CHECKED BY:
NO. DATE REVISION INT.

D&B ENGINEERS
AND ARCHITECTS

TOWN OF BLOOMING GROVE

ORANGE COUNTY

NEW YORK

LASSER PARK SENIOR CENTER

FIRST FLOOR
POWER AND LIGHTING PLAN
ELECTRICAL

NOTES:

LEGEND:

SCHEDULES.

1. REFER TO DRAWING G1 FOR SYMBOLS AND ABBREVIATIONS.

2. REFER TO DRAWING E5 FOR SWITCHBOARD AND PANELBOARD

3. ENTRANCE CANOPY LIGHT FIXTURES AND BUILDING EXTERIOR

4. CIRCUIT NUMBERS CORRESPOND TO RESPECTIVE CIRCUIT

BREAKER IN PANELS AS INDICATED BELOW:

UTILITY PANEL 'UP'

BY LUTRON, OR APPROVED EQUAL.

POWER FEEDS IN BASEMENT.

208/120V, 3φ PANELBOARD 'MDP'

(*) PANELBOARDS A, B, C, D, E, F, G, K FURNISHED WITH PREFABRICATED BUILDING. POWER FEEDS TO

PANELBOARDS FROM SWITCHBOARD 'MDP' SHALL BE

FURNISHED AND INSTALLED BY CONTRACTOR. ROUTE

LIGHT FIXTURES SHALL BE POWERED FROM UTILITY PANEL 'UP.'

MDP-1/3 - DENOTES CIRCUITS 1 AND 3 IN NEW

#2 - DENOTES CIRCUIT 2 IN NEW 208/120V 3\$\phi\$

5. DIMMER SWITCH SHALL BE MODEL DVSTV AS MANUFACTURED

DRAWING NO.


5708

DATE:

AUGUST 2023

SCALE:

3/16" = 1'-0"

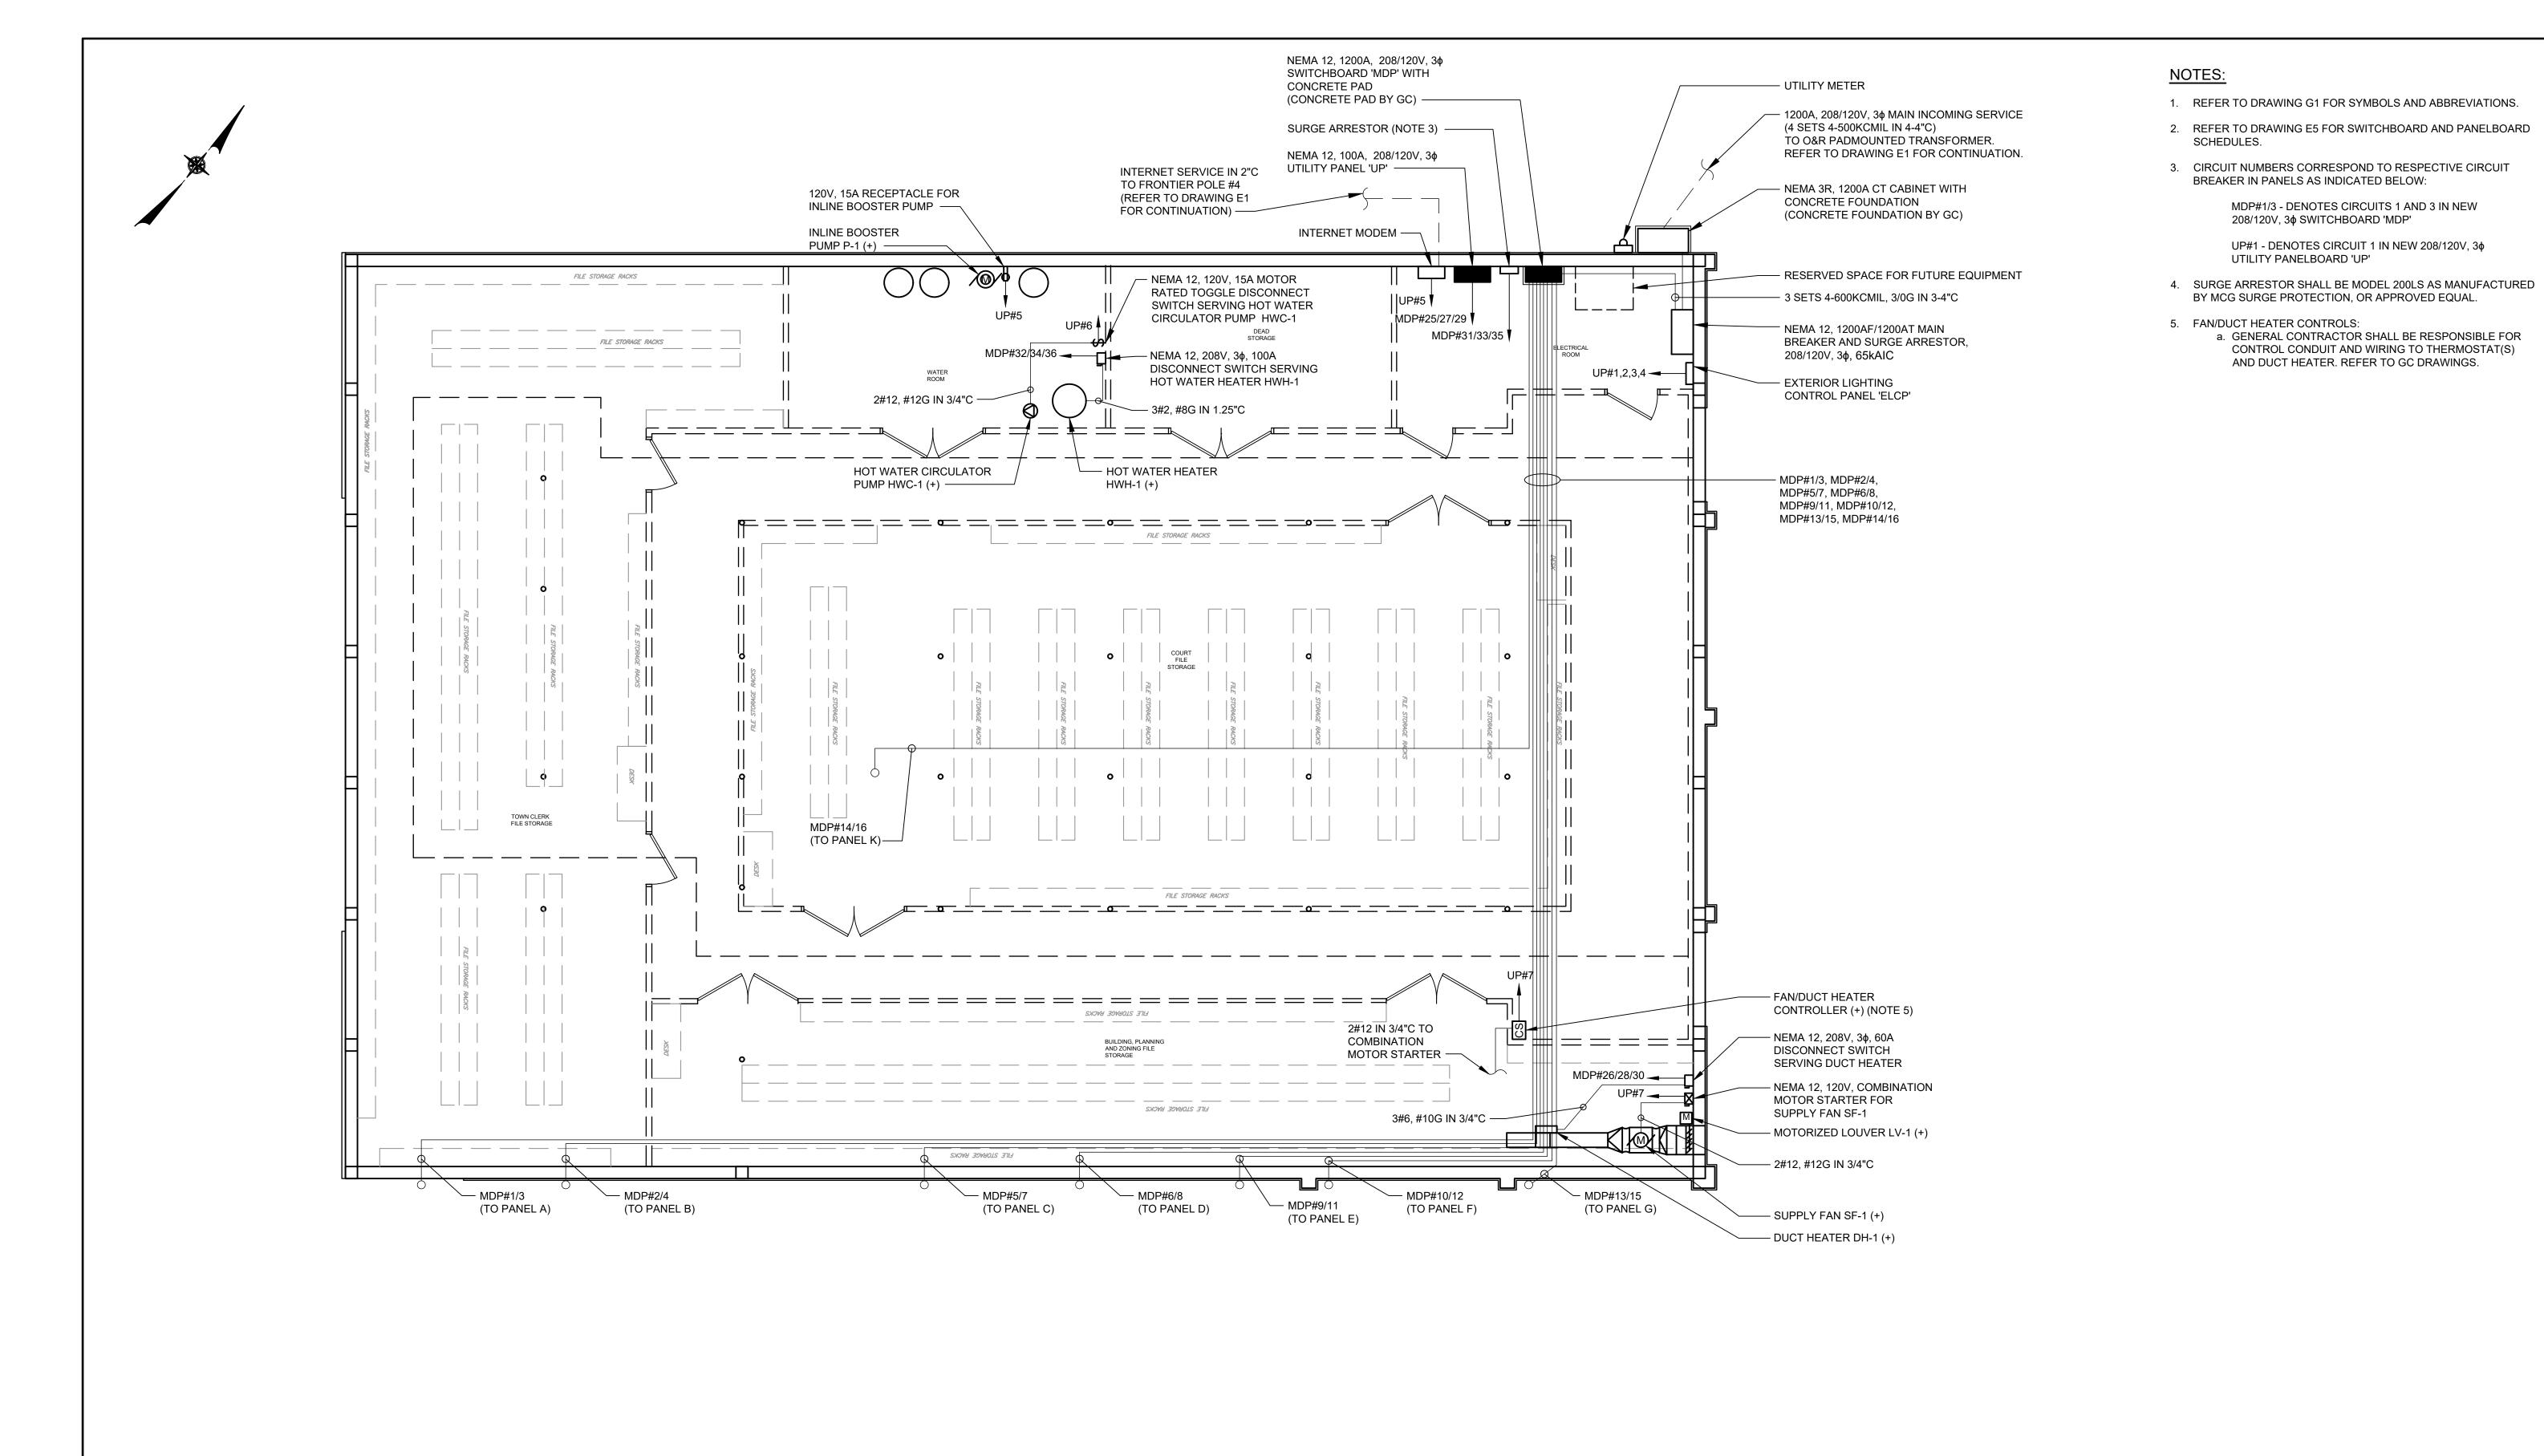

MDP#1/3 - DENOTES CIRCUITS 1 AND 3 IN NEW

UP#1 - DENOTES CIRCUIT 1 IN NEW 208/120V, 36

a. GENERAL CONTRACTOR SHALL BE RESPONSIBLE FOR


AND DUCT HEATER. REFER TO GC DRAWINGS.

CONTROL CONDUIT AND WIRING TO THERMOSTAT(S)

208/120V, 3φ SWITCHBOARD 'MDP'

UTILITY PANELBOARD 'UP'

			5, 15		
	UNAUTHORIZED ALTERATION OR ADDITION TO THIS DOCUMENT IS A	TOWN OF BLOOMING GROVE	CONTRACT 2	PROJECT NO. D 5708	DRAWING NO.
	VIOLATION OF SECTION 7209 OF THE NEW YORK STATE EDUCATION LAW. DROUGHT ENGINEED: DRAWA DV.	ORANGE COUNTY NEW YORK	BASEMENT	DATE:	E 2
	AE TW/JQ AND ARCHITECTS	LACCED DADIZ CENTED	POWER PLAN	AUGUST 2023	LJ
NO. DATE REVISION INT.	DESIGNED BY: CHECKED BY: MN MN	LASSER PARK SENIOR CENTER	ELECTRICAL	SCALE: 3/16" = 1'-0"	ı

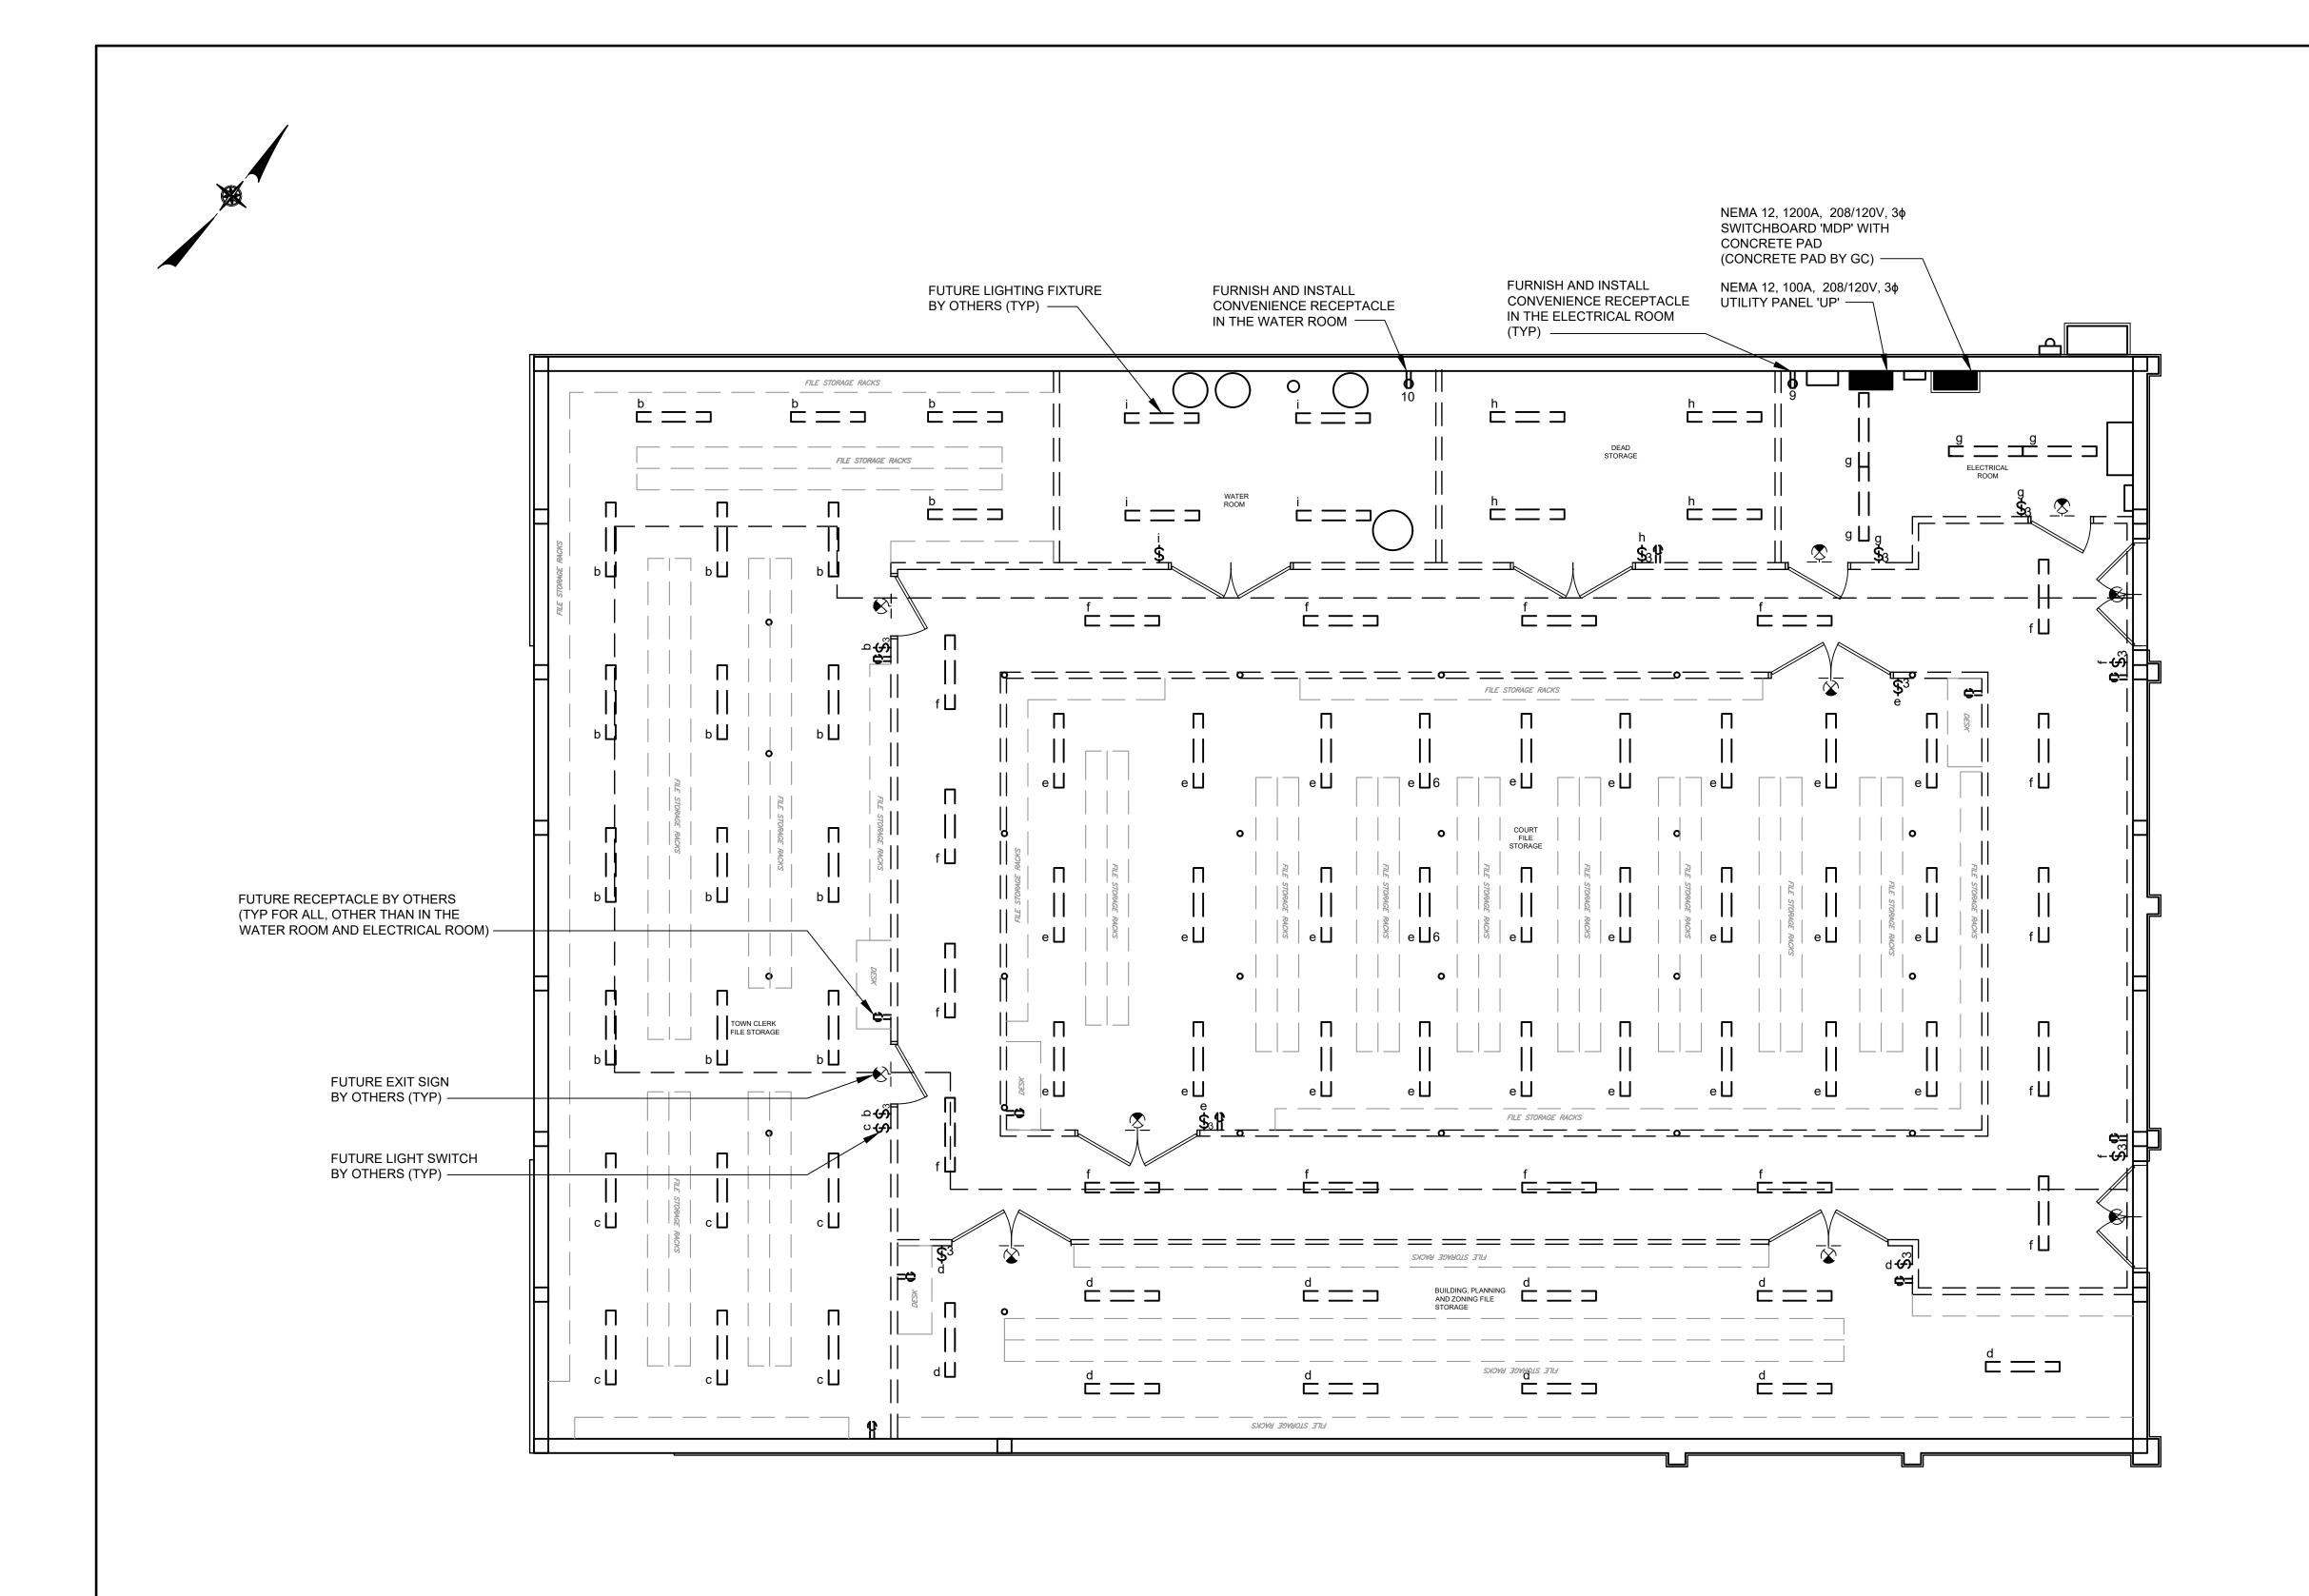

NOTES:

- REFER TO DRAWING G1 FOR SYMBOLS AND ABBREVIATIONS.
- REFER TO DRAWING E5 FOR SWITCHBOARD AND PANELBOARD SCHEDULES.
- 3. CIRCUIT NUMBERS CORRESPOND TO RESPECTIVE CIRCUIT BREAKER IN PANELS AS INDICATED BELOW:
 - 1 DENOTES CIRCUIT 1 IN NEW 208/120V, 3φ UTILITY PANEL 'UP.'

6 4 2 0


TOWN OF BLOOMING GROVE CONTRACT 2 D&B ENGINEERS AND ARCHITECTS **BASEMENT** ORANGE COUNTY **E4 NEW YORK AUGUST 2023** LIGHTING PLAN TVNSLED Q LASSER PARK SENIOR CENTER CHECKED BY: DESIGNED BY: **ELECTRICAL** 3/16" = 1'-0" NO. DATE

NOTES:

- 1. REFER TO DRAWING G1 FOR SYMBOLS AND ABBREVIATIONS.
- GROUND NEW SERVICE IN ACCORDANCE WITH NEC AND O&R REQUIREMENTS.
- SURGE ARRESTOR SHALL BE MODEL 200LS AS MANUFACTURED BY MCG SURGE PROTECTION OR APPROVED EQUAL.

кт	DE\	/ICE	LOAD DEGIONATION	LC	DAD	DDANGU GIDGUIT	
NO.	POLE	TRIP	LOAD DESIGNATION	H.P.	KVA	BRANCH CIRCUIT	
1	2	150	PANEL 'A'		22.0	3-2/0, #6 IN 2"C	
3	-	-	-				
5	2	150	PANEL 'C'		23.5	3-1/0, #6 IN 2"C	
7	-	-	-				
9	2	150	PANEL 'E'		22.9	3-1/0, #6 IN 2"C	
11	-	450	PANEL (C)		100	2.4/0.46 IN 250	
13 15	2	150	PANEL 'G'		19.9	3-1/0, #6 IN 2"C	
15 17	2	150	SPARE		 		
19	-	-	-		1		
21	2	150	SPARE		\vdash		
23	 -	-	•		<u> </u>		
25	3	100	UTILITY PANEL UP		2.6	4#2, #8G IN 1.25"C	
27	-	-	-				
29	-	-	-				
31	3	30	SURGE ARRESTOR			3#10, #10G IN 3/4"C	
33	-	-	-				
35	-	-	-				
37	3	100	SPARE				
39	-	-	-				
41	-	-	-			0.040.440.111.0110	
2	2	150	PANEL 'B'		24.7	3-2/0, #6 IN 2"C	
6	2	150	PANEL 'D'		22.6	3-1/0, #6 IN 2"C	
8	-	-	-		23.0	0-170, #0 II V Z G	
10	2	150	PANEL 'F'		27.6	3-1/0, #6 IN 2"C	
12	 -	-	•		1		
14	2	200	PANEL 'K'		34.6	3-4/0, #6 IN 2"C	
16	-	-	-				
18	2	150	SPARE				
20	-	-	-				
22	2	200	SPARE				
24	-	-	-		40.5	0.40 4400 IN 0/440	
<u> 26</u>	3	50	DUCT HEATER DH-1		12.0	3#6, #10G IN 3/4"C	
28	-	-	-		 		
30	3	100	- HOT WATER HEATER HWH-1		27	3#2, #8G IN 1.25"C	
32 34	-	100	-		21	3#2, #0G IN 1.23 C	
34 36	+ -	-	•		\vdash		
<u>36 </u>	3	50	SPARE		+		
40	-	-	-		<u> </u>		
42	-	-	-		<u> </u>		
	BUS: 1200 1200AF/		TYPE: BOLT-ON MAIN BREAKER VOLTS: 208/120V	<u>'</u>		MOUNTING: FREESTANDIN AIC(SYM): 65,000	

CKT	DE	/ICE	LOAD DESIGNATION	LC	AD	BRANCH CIRCUIT
NO.	POLE	TRIP	EOAD DESIGNATION	H.P.	KVA	BRANGITOIRECT
1	1	20	EXTERIOR LTG: POLE MOUNTED FIXTURES		0.3	2#8, #10G IN 1"C
3	1	20	EXTERIOR LTG: BUILDING EXTERIOR		0.5	2#10, #10G IN 3/4"C
5	1	20	INTERNET MODEM		0.1	2#12, #12G IN 3/4"C
7	1	20	SUPPLY FAN SF-1; FAN/DUCT HEATER CTRL	1/6		2#12, #12G IN 3/4"C
9	1	20	BSMNT REC: ELECTRICAL ROOM		0.2	2#12, #12G IN 3/4"C
11	1	20	SPARE			
13	1	20	SPARE			
15	1	20	SPARE			
17	1		SPARE			
19	1	20	SPARE	_		
21	1 1	20	SPARE			
23	1	20	SPARE			
25	1 1	20	SPARE			
27	1	20	SPARE			
29	1	20	SPARE	_		
31	1	20	SPARE	_		
33	<u>'</u>		SPARE			
35	1 1		SPARE			
37	1 1		SPARE			
39 41	1	20 20	SPARE SPARE	_		
	<u> </u>		EXTERIOR LIGHTING CONTROL PANEL		0.4	0440 4400 IN 2/480
2	1	15 20	EXTERIOR LIGHTING CONTROL PANEL EXTERIOR LTG: ENTRANCE CANOPY		0.1	2#12, #12G IN 3/4"C 2#10, #10G IN 3/4"C
6	1 1	15		1/40	0.1	2#10, #10G IN 3/4 C
8	1	15	HOT WATER CIRCULATOR PUMP HWC-1	1/40	0.8	2#12, #12G IN 3/4 C
10	1 1	20	INLINE BOOSTER PUMP P-1 BSMNT REC: WATER ROOM		0.0	2#12, #12G IN 3/4"C
12	1		SPARE		0.2	2#12, #128 111 3/4 6
14	1		SPARE	_		
16	1 1	20	SPARE			
18	1 1		SPARE			
20	1 1	20	SPARE			
22	1	20	SPARE			
24	1 1	20	SPARE			
26	1	20	SPARE			
28	1 1	20	SPARE			
30	1	20	SPARE			
32	1	20	SPARE			
34	1	20	SPARE			
36	1	20	SPARE			
38	1	20	SPARE			
40	1	20	SPARE			
42	1	20	SPARE			
MAIN E	US: 100	A	TYPE: BOLT-ON			MOUNTING: SURFACE

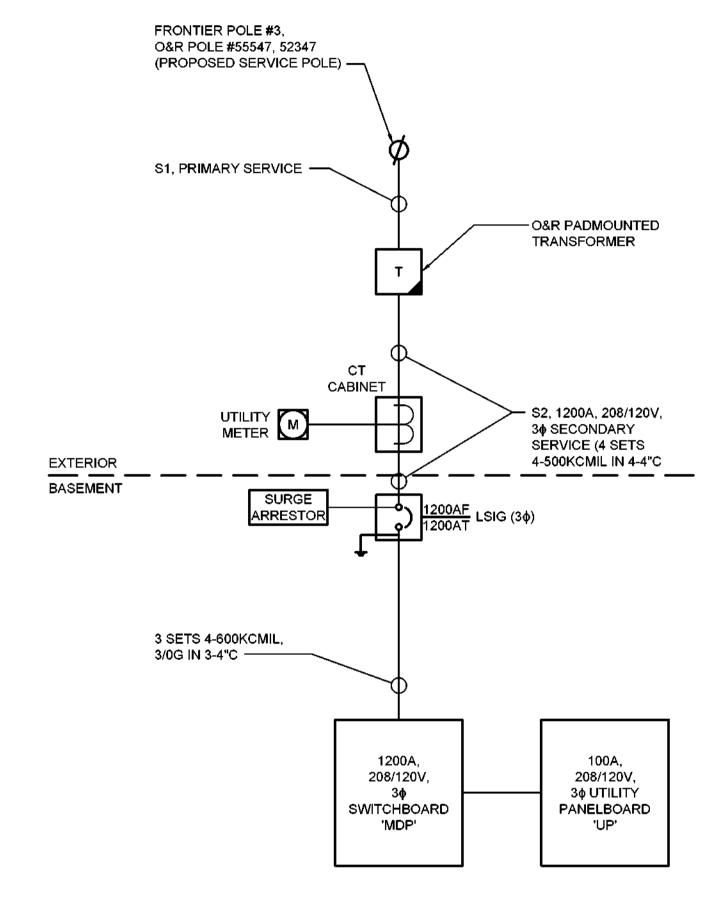

SINGLE LINE DIAGRAM

N.T

NO.	DATE	REVISION	INT.	DESIGNED BY:	CHECKED BY: MN
				PROJECT ENGINEER:	DRAWN BY: TW/JQ
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TOWN OF BLOOMING GROVE	
ITY	NEW YORK
LASSER PARK SENIOR CENTER	

CONTRACT 2
PANELBOARD SCHEDULES
AND SINGLE LINE DIAGRAM
ELECTRICAL

PROJECT NO.

5708

DATE:


AUGUST 2023

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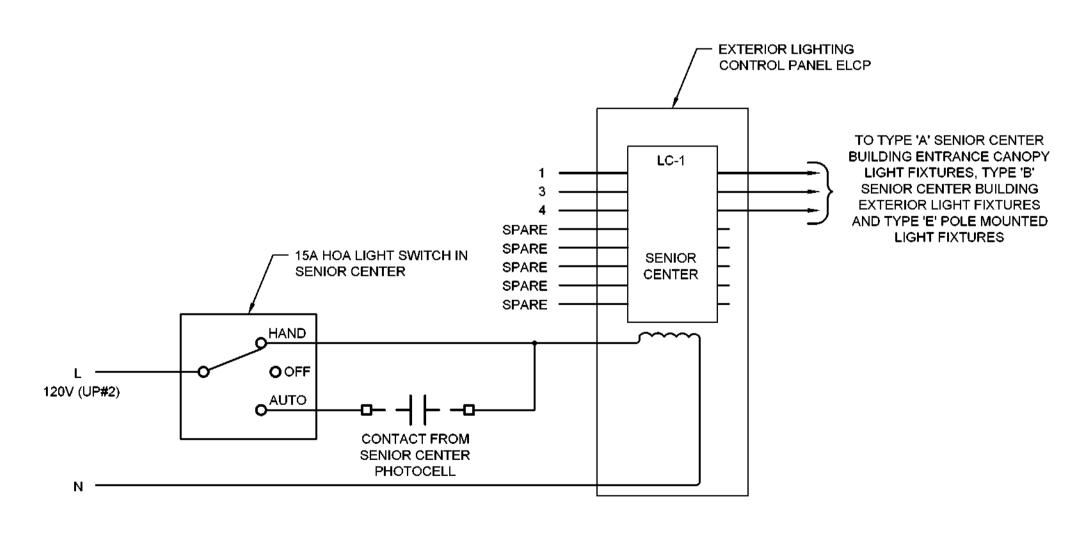
N.T.S.

NOTES:

1. REFER TO DRAWING G1 FOR SYMBOLS AND ABBREVIATIONS.




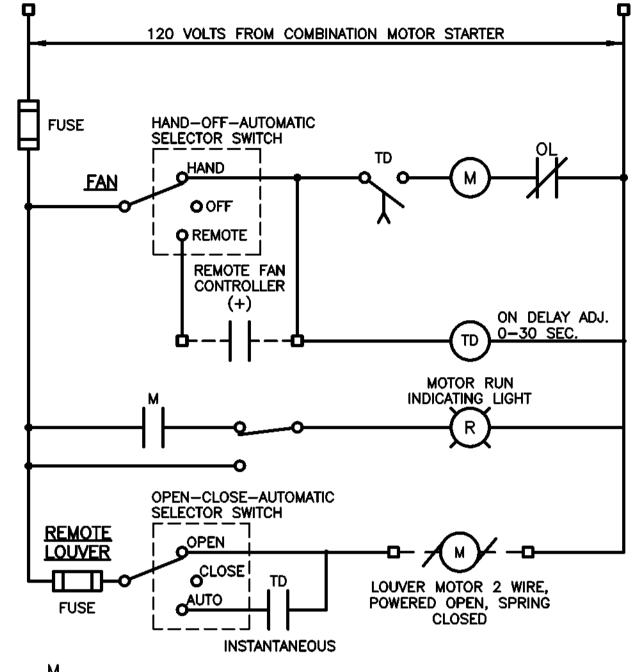



NOTE: CIRCUIT NUMBERS FOR LIGHTING CONTACTOR 'LC-1'
REFER TO SENIOR CENTER UTILITY PANEL 'UP.'

EXTERIOR LIGHTING CONTROL WIRING DIAGRAMS

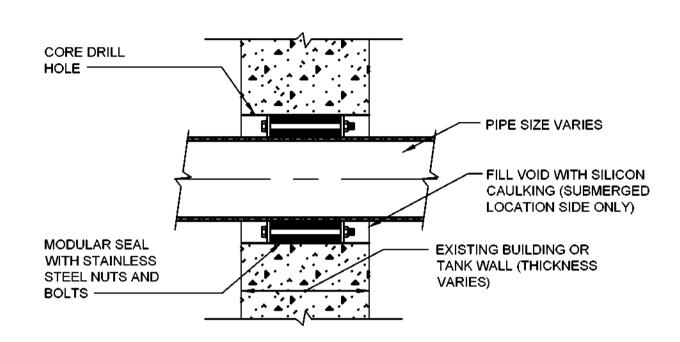


NOTES:

- 1. MODULAR SEAL STRIP SHALL BE PLACED SO THAT BOLTS CAN BE ADJUSTED DURING NORMAL OPERATION.
- 2. WALLS 12" OR LARGER IN THICKNESS SHALL REQUIRE 2 MODULAR SEAL STRIPS.


TYPICAL CONDUIT PENETRATION THRU EXISTING WALL

(USE FOR ALL EXISTING WALL PENETRATIONS) N.T.S.

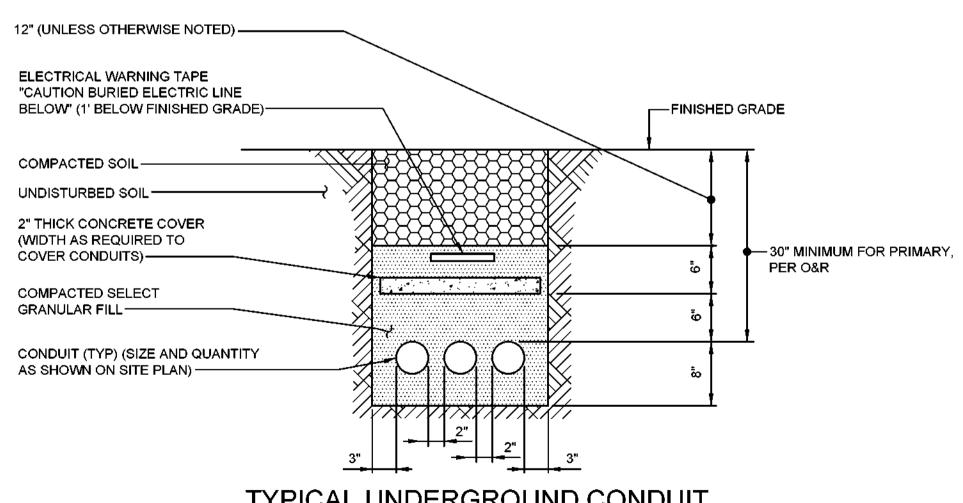


TYPICAL UNDERGROUND CONDUIT TRENCH DETAIL

(USE FOR ALL UNDERGROUND CONDUITS) N.T.S.

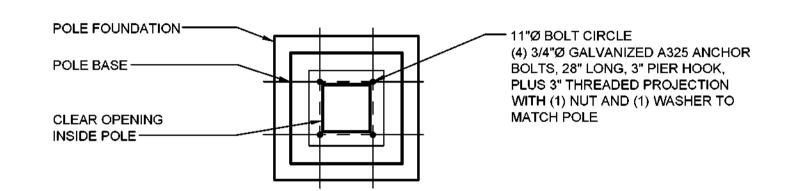

<u>PLAN</u>

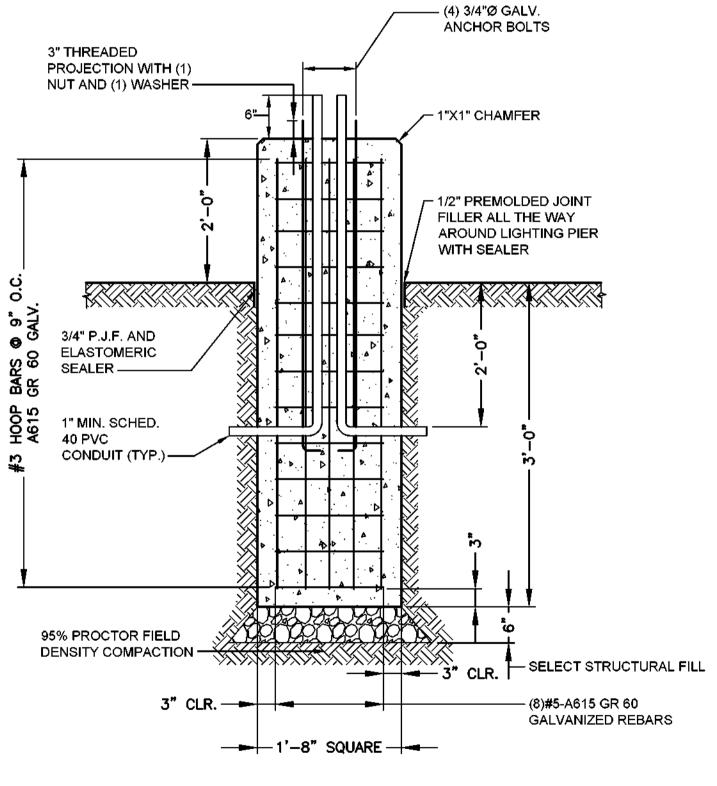

<u>SECTION</u>

POLE FOUNDATION DETAIL - TYPE 'E' FIXTURES

N.T.S.

NO.	DATE	REVISION	INT.	MN	MN
				DESIGNED BY:	CHECKED BY:
				PROJECT ENGINEER AE	DRAWN BY:
					E EDUCATION LAW.
					IIS DOCUMENT IS A ECTION 7209 OF THE
					D ALTERATION OR

≣	D&R	ENGINEERS	
	AND	ARCHITECTS	ř

TOWN OF BLOOMING GROVE

ORANGE COUNTY

NEW YORK

LASSER PARK SENIOR CENTER

WIRING DIAGRAM AND DETAILS

ELECTRICAL

CONTRACT 2

PROJECT NO.


5708

DATE:

AUGUST 2023

SCALE:

N.T.S.

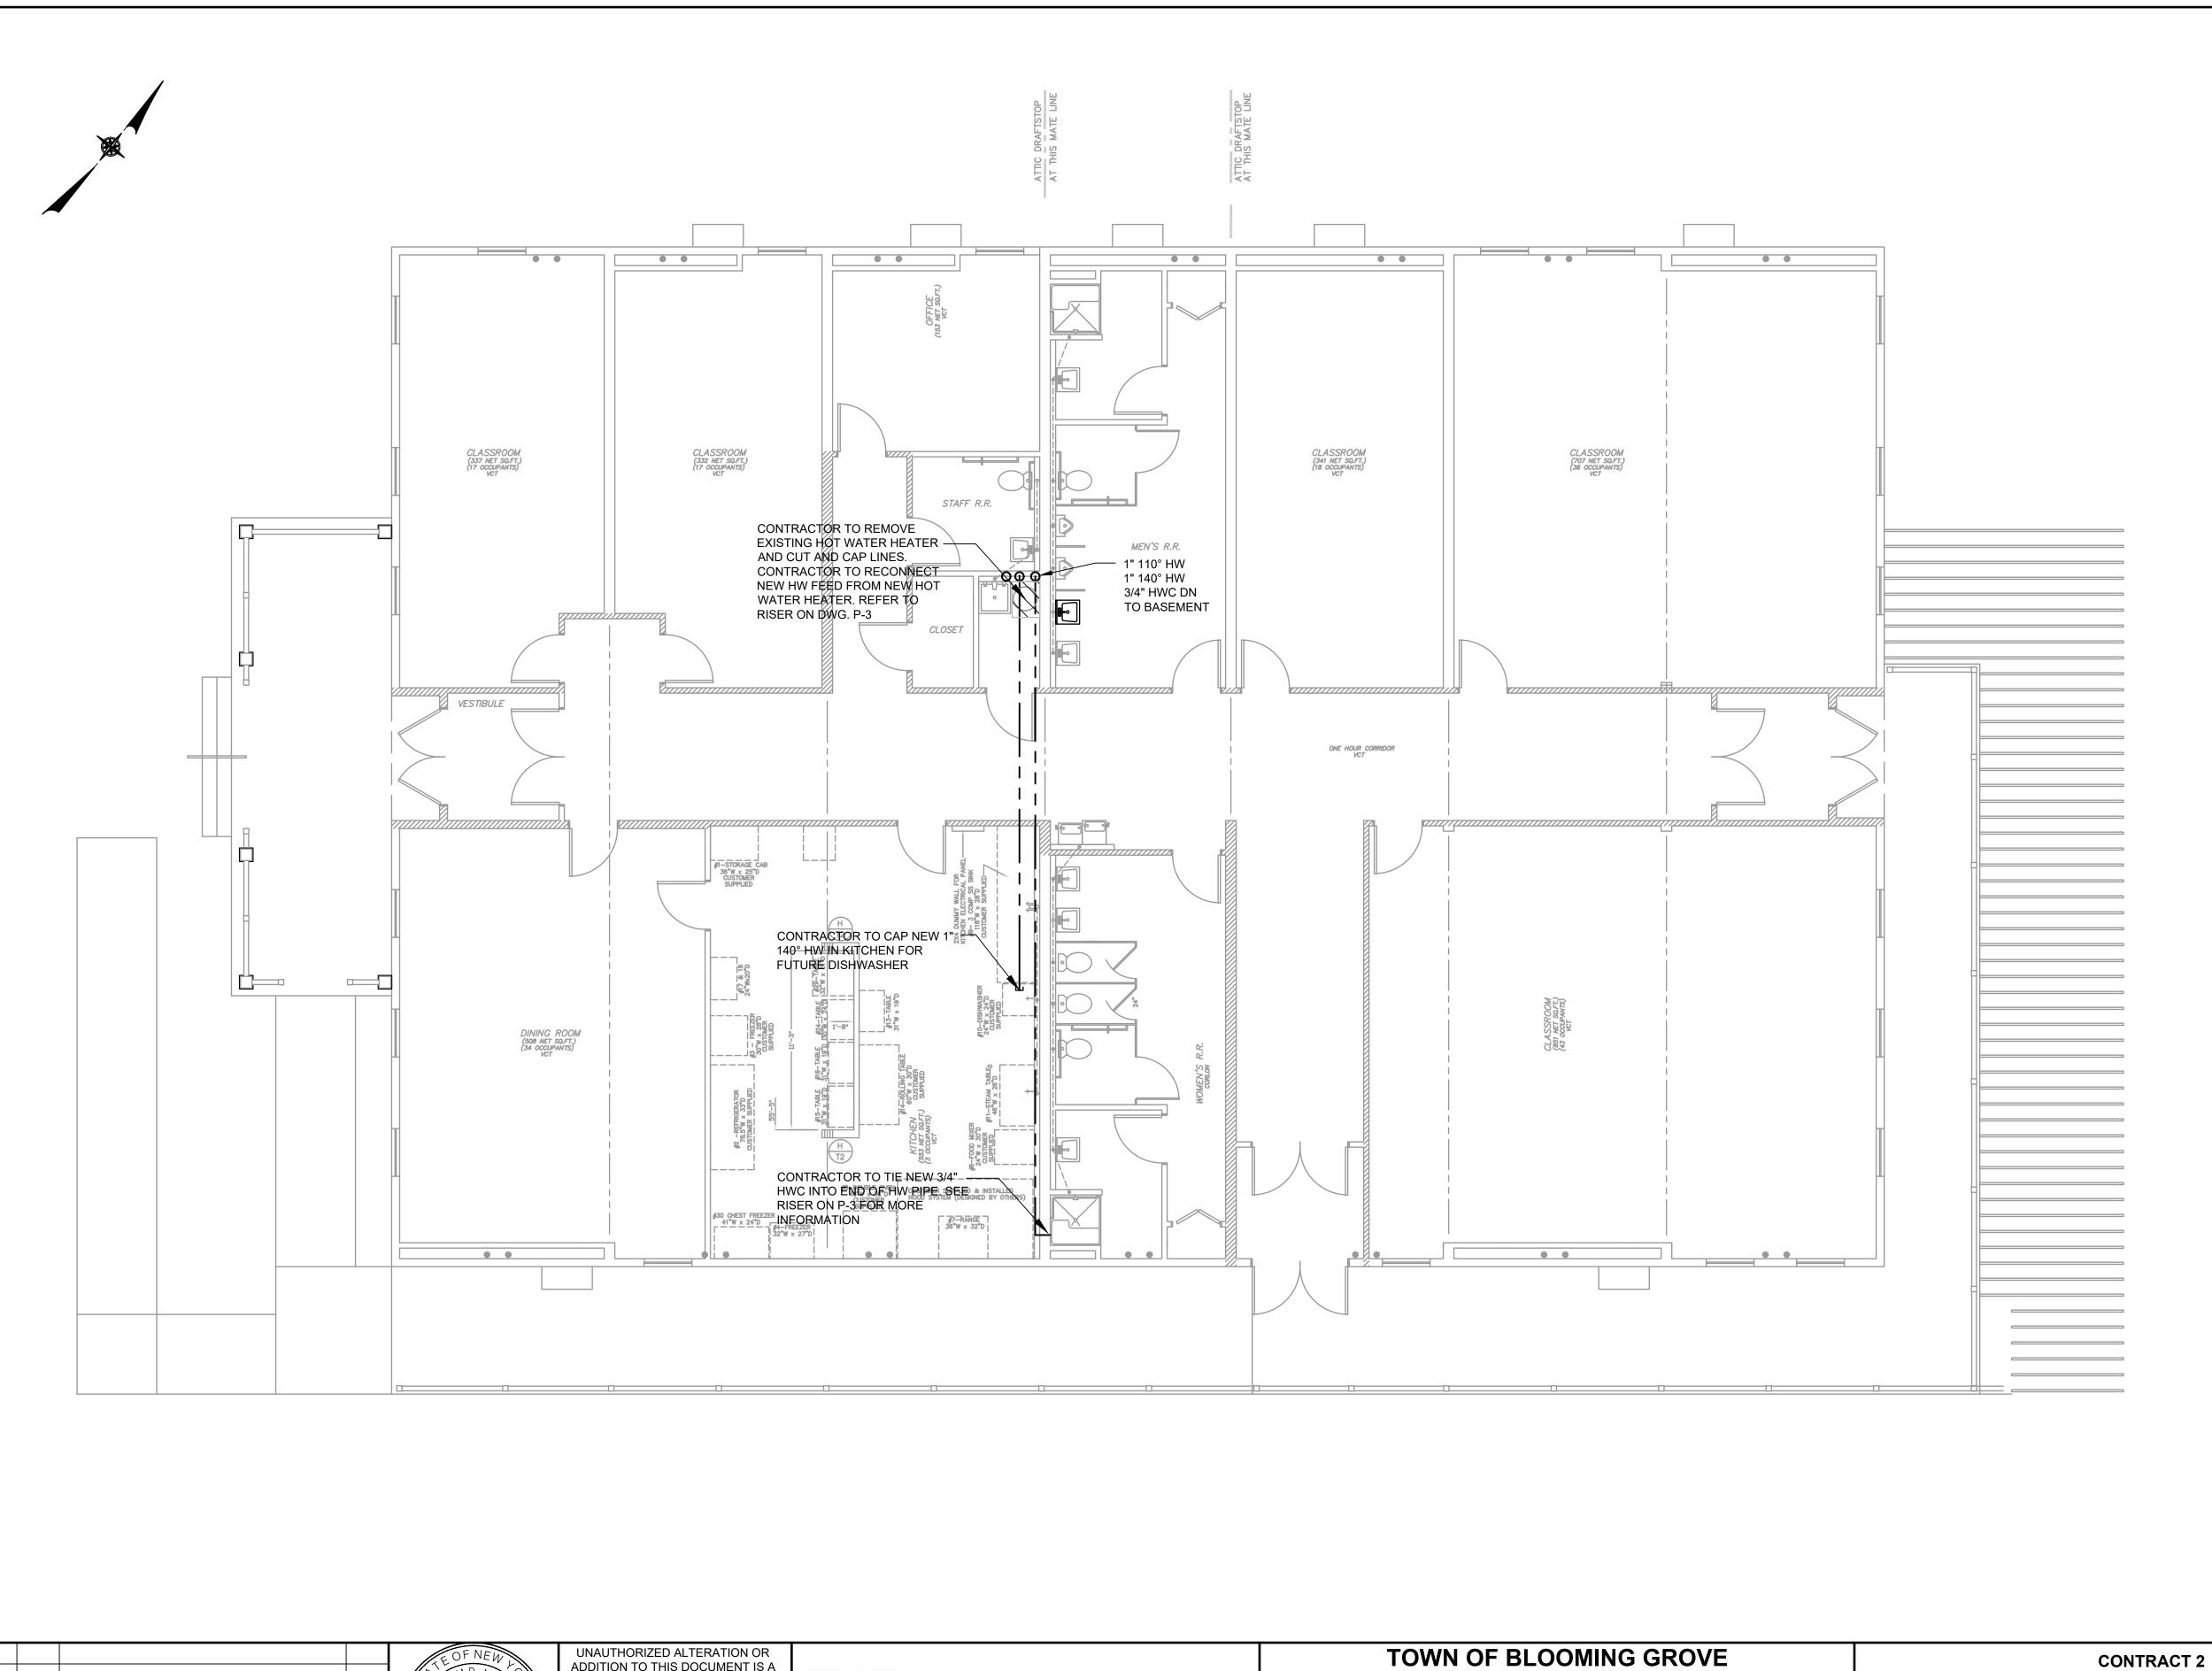

NOTE

1. PLUMBING FIXTURES ON THIS PLAN ARE SHOWN FOR REFERENCE ONLY UNLESS OTHERWISE NOTED. ALL FIXTURES SHOWN HAVE BEEN PREVIOUSLY INSTALLED UNDER A SEPARATE CONTRACT AS HAS ALL OF THE WATER DISTRIBUTION/ SANITARY VENTING AND SANITARY STUBS UNLESS OTHERWISE NOTED ON THIS PLAN. REFER TO DRAWING P3 FOR FURTHER CLARIFICATION ON THE WATER/SANITARY RISER DIAGRAMS.

3/16"=1'-0"

NO. DATE REVISION INT.

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PROJECT ENGINEER: DRAWN BY:

AE MP/PD

DESIGNED BY: CHECKED BY:

BA/WDM



GE COUNTY	NEW YORK	
<u>GE GGGKI I</u>	NEW TORK	
LASSER PARK SENIOR CENTER		

PLUMBING PLAN
- FIRST FLOOR
PLUMBING

PROJECT NO.


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DATE:

AUGUST 2023

SCALE:

3/16" = 1'-0"

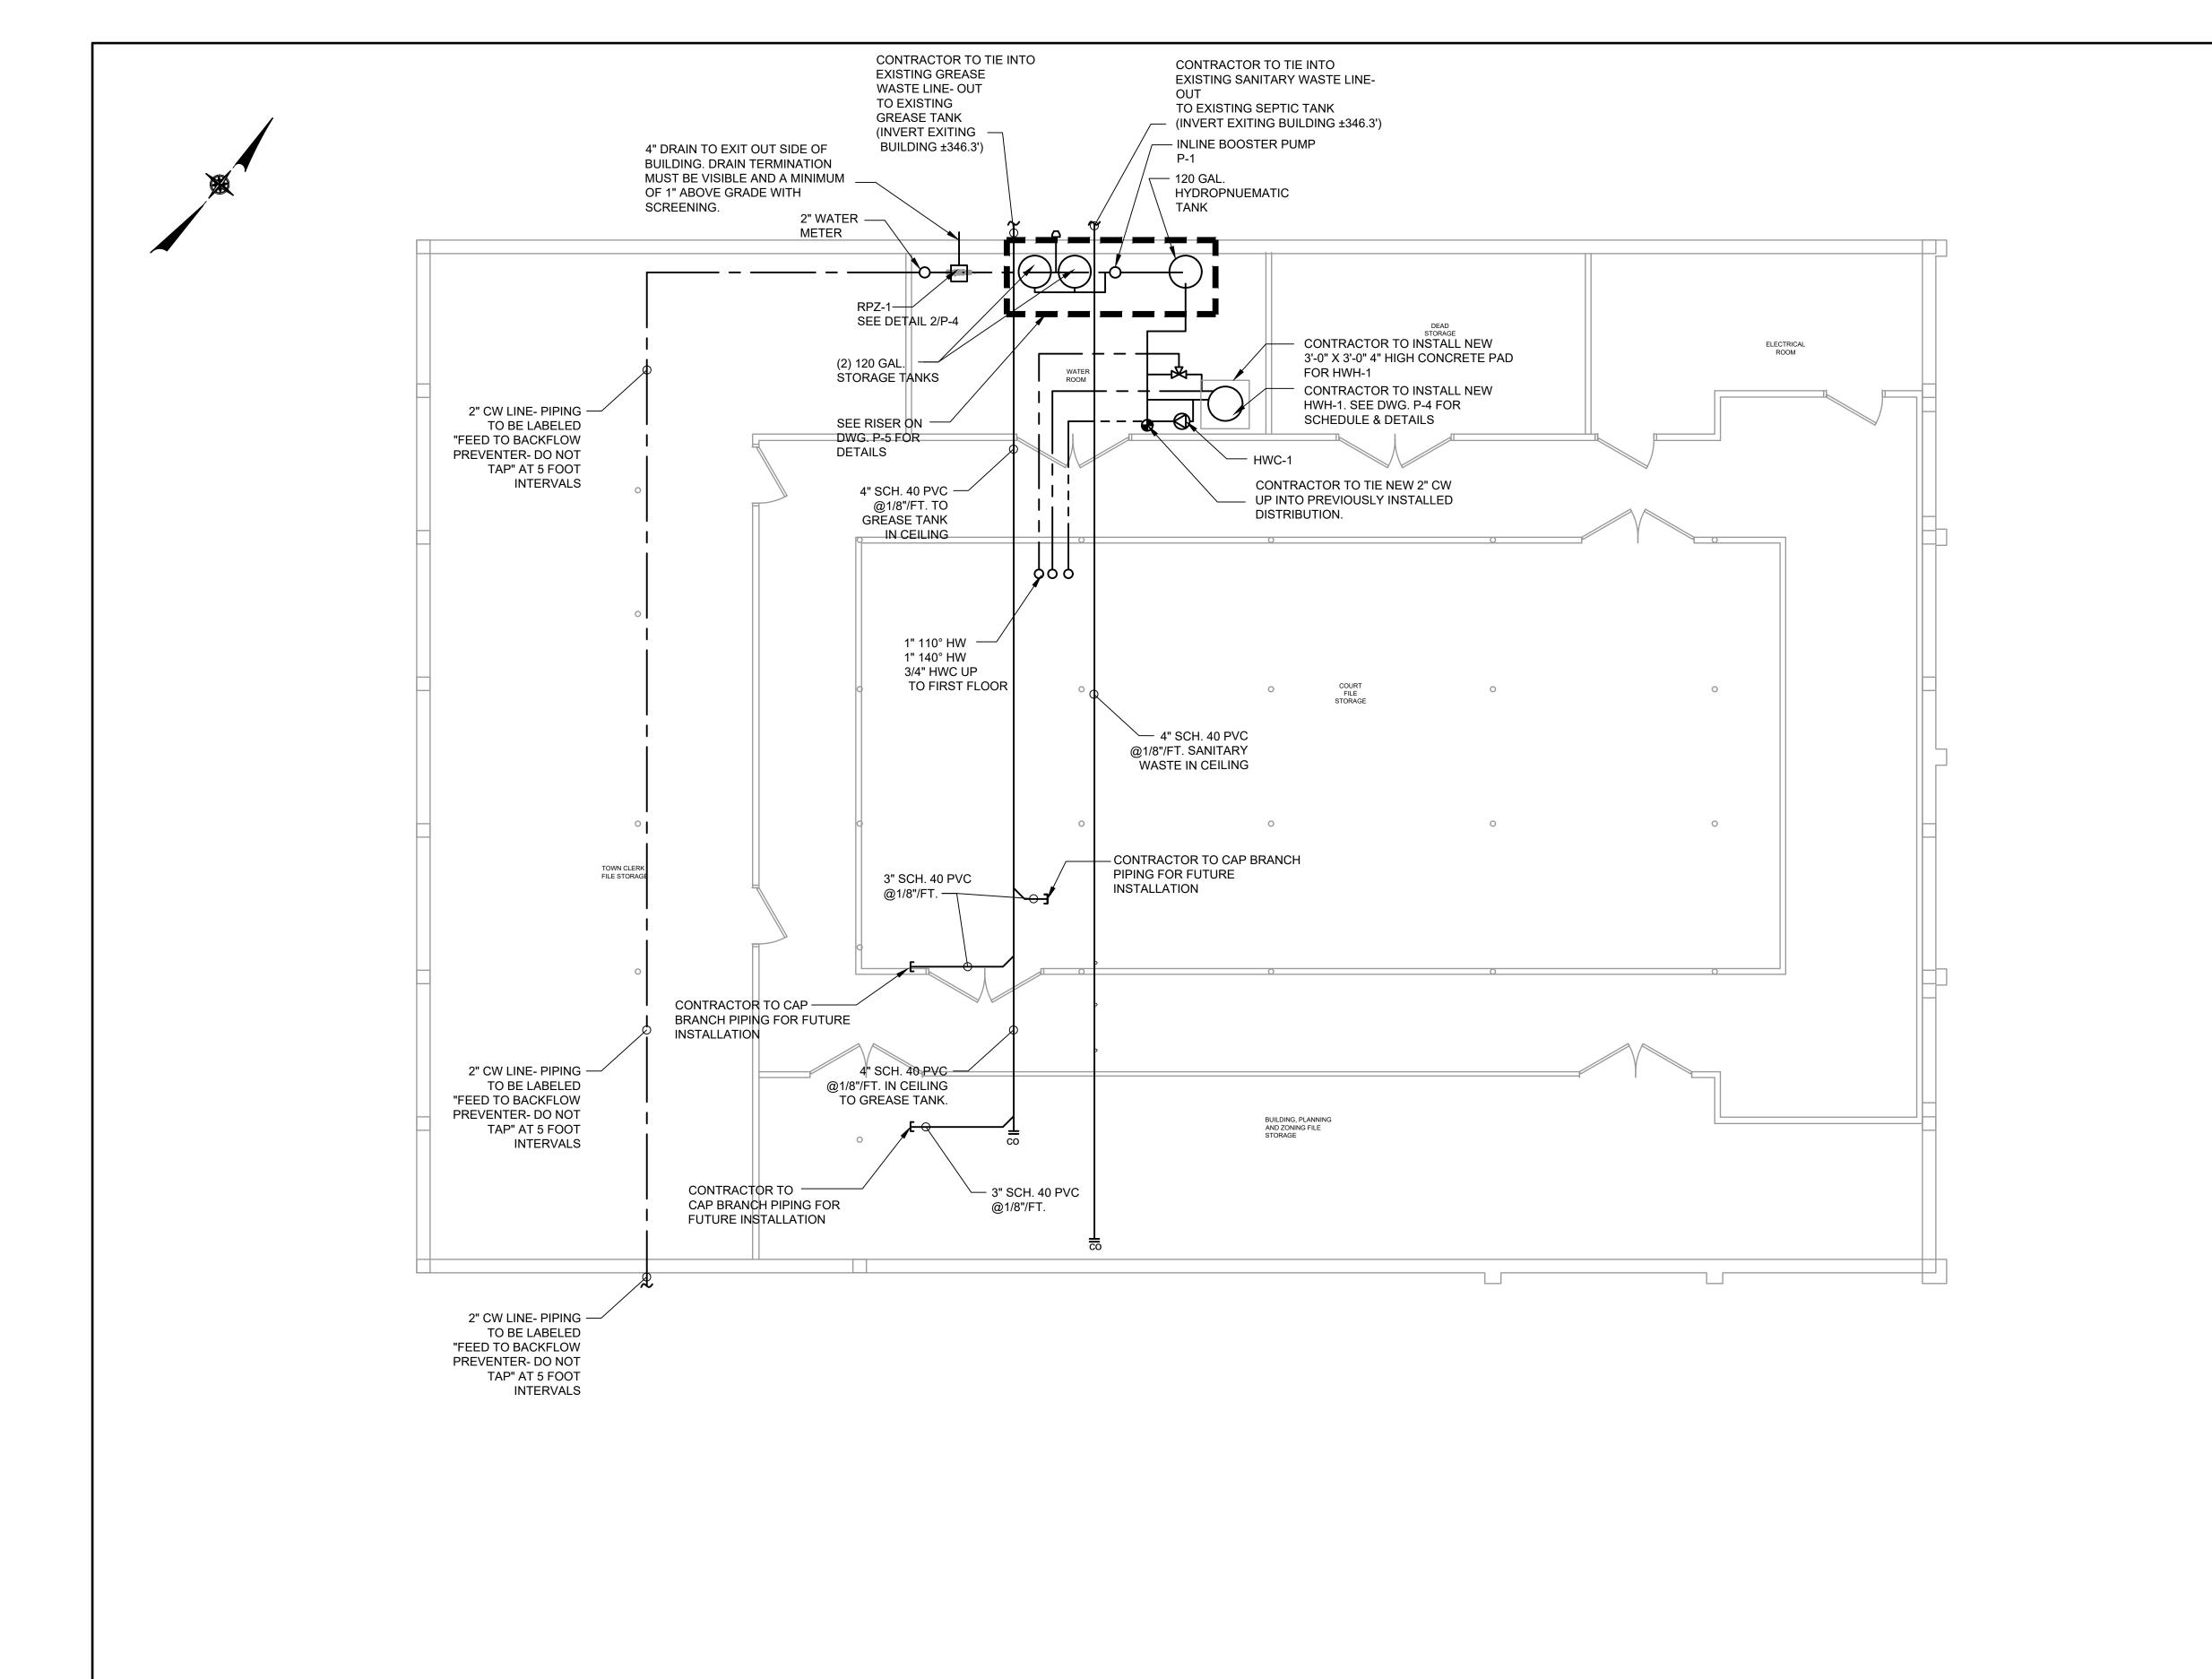

6 4 2 0 5'

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PROJECT ENGINEER: MP/PD

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PROJECT ENGINEER: MP/PD

DESIGNED BY: CHECKED BY: BA/WDM

TOWN OF BLOOMING GROVE

ORANGE COUNTY

NEW YORK

LASSER PARK SENIOR CENTER

PLUMBING PLAN - BASEMENT
PLUMBING

CONTRACT 2

NOTES:

1. REFER TO DRAWING G1 FOR SYMBOLS AND ABBREVIATIONS.

2. REFER TO RISER DIAGRAM ON DRAWING P-3 FOR ALL TIE INS

EXISTING STUBS SHOWN ON RISER INTO NEW 4" MAIN.

INTO THE NEW 4" SANITARY MAIN. CONTRACTOR TO TIE IN ALL

PROJECT NO.


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DATE:

AUGUST 2023

SCALE:


3/16" = 1'-0"

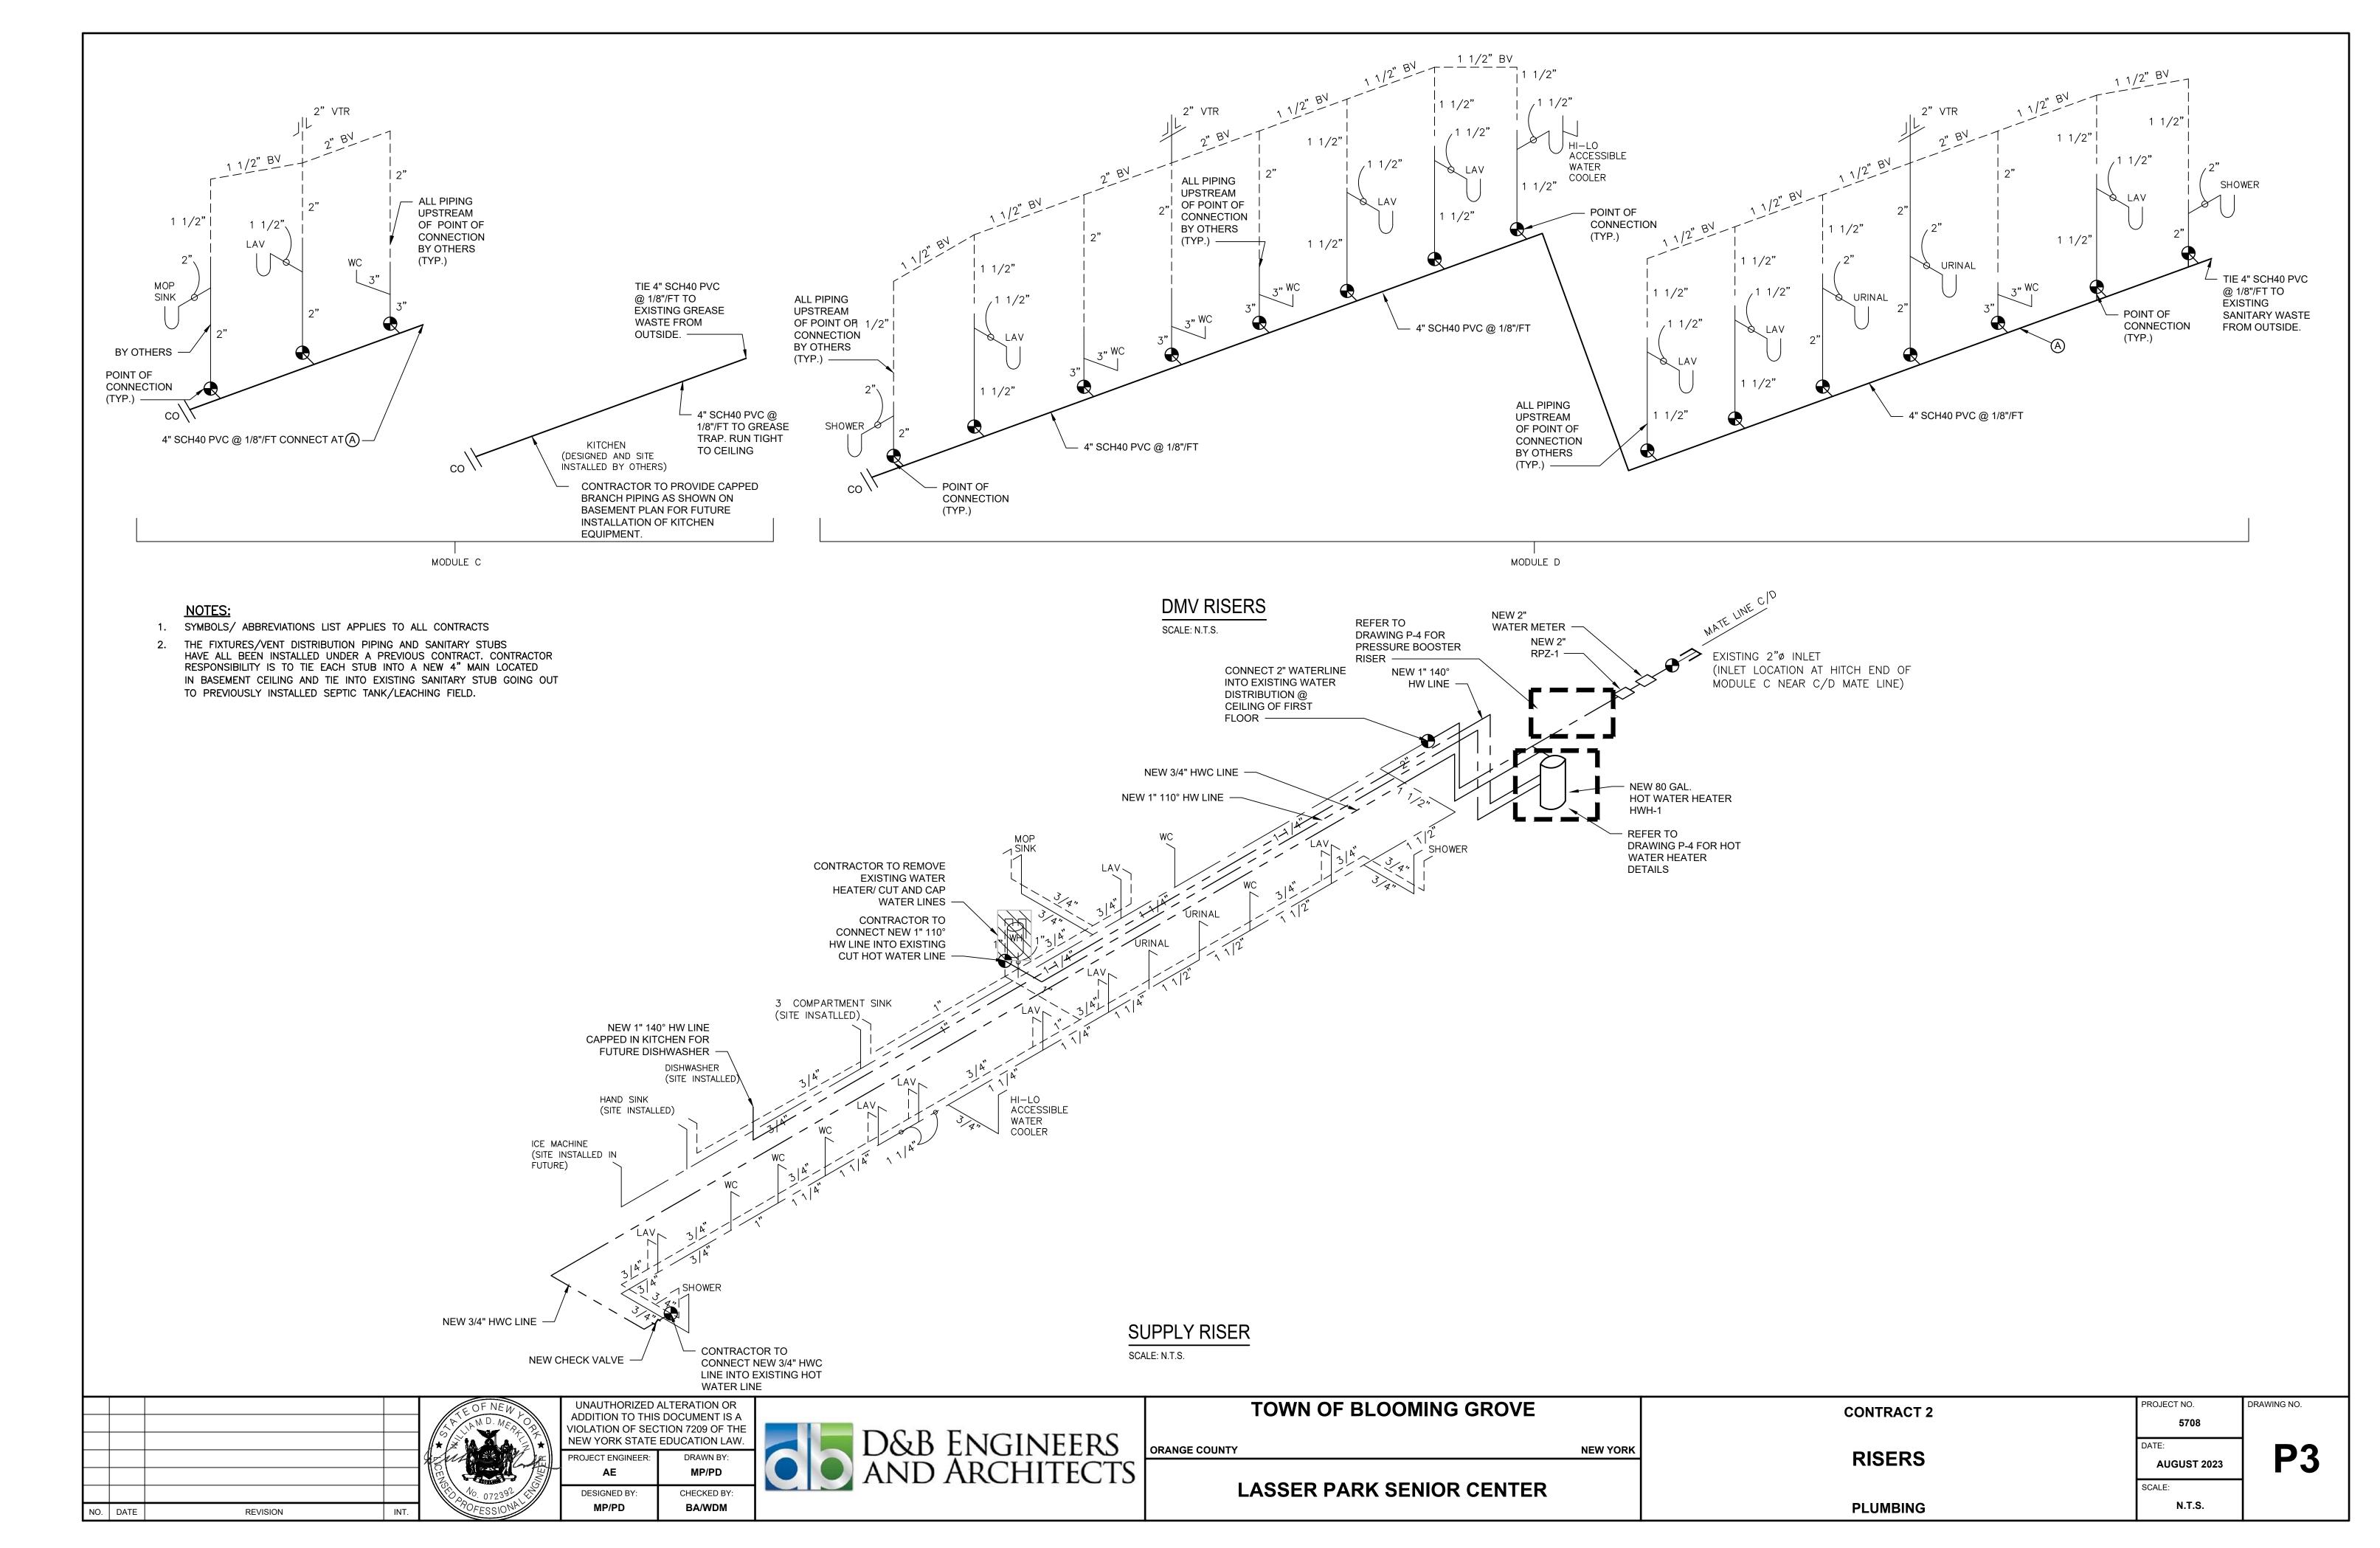

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NO. DATE

REVISION

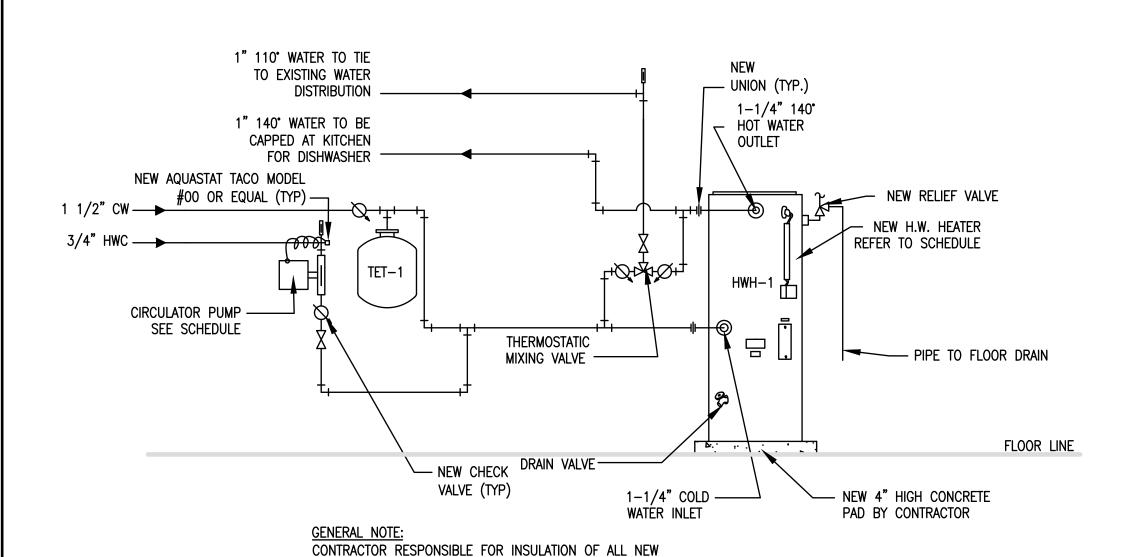

HOT WATER HEATER DETAIL Scale: NTS

DOMESTIC WATER HEATER - BASED ON AO SMITH COMMERCIAL ELECTRIC WATER HEATER

DOMESTIC WATER LINES.


MARK	MODEL	TYPE	CAPACITY	KW INPUT	RECOVERY @ 100° F RISE	PHYSICAL DIN DIA.	MENSIONS (IN.) HEIGHT	WATER CONNECTIONS	WEIGHT
HWH-1	DRE-80-27	ELECTRIC	80 GAL	27 KW	111 GPH	25-1/2"	60-1/4"	1-1/4"	280 LBS

REFER TO DETAIL 1/P-4 FOR MORE INFORMATION

HOT WATE	ER CIRCULATOR	PUMP SCHEDU	JLE -BASED ON	TACO					
MARK	MODEL NO.	MANF.	FLOW	MOTOR	VOLTAGE	RPM	CONTROL	DISCONNECT	REMARKS
HWC-1	003-B4	TACO	.25 GPM @ 2.75' HEAD	1/40 HP 60 HZ, 1 PH	115V	3250	AQUASTAT & 12 HR. TIMER	ON/OFF SWITCH	ALL BRONZE CONSTRUCTION

HOT WATER EXPANSION TANK SCHEDULE -BASED ON WATTS

				·· ·· · =				
MARK	MODEL NO.	MANF.	VOLUME	ACCEPTANCE VOLUME	DIAMETER	HEIGHT	CONN.	WEIGHT
TET-1	DETA12	WATTS	5 GAL.	3.3 GAL.	12"	14"	3/4"	28 LBS

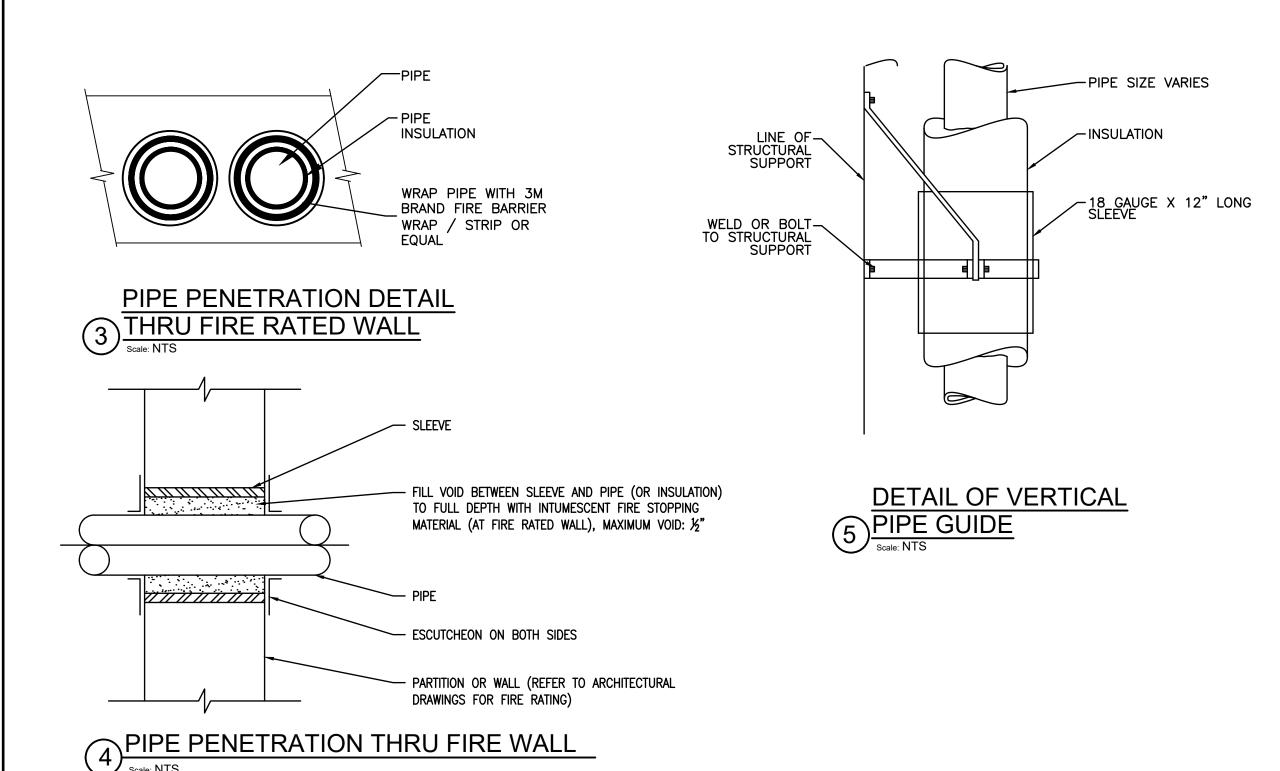

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NEW YORK STATE EDUCATION LAW.

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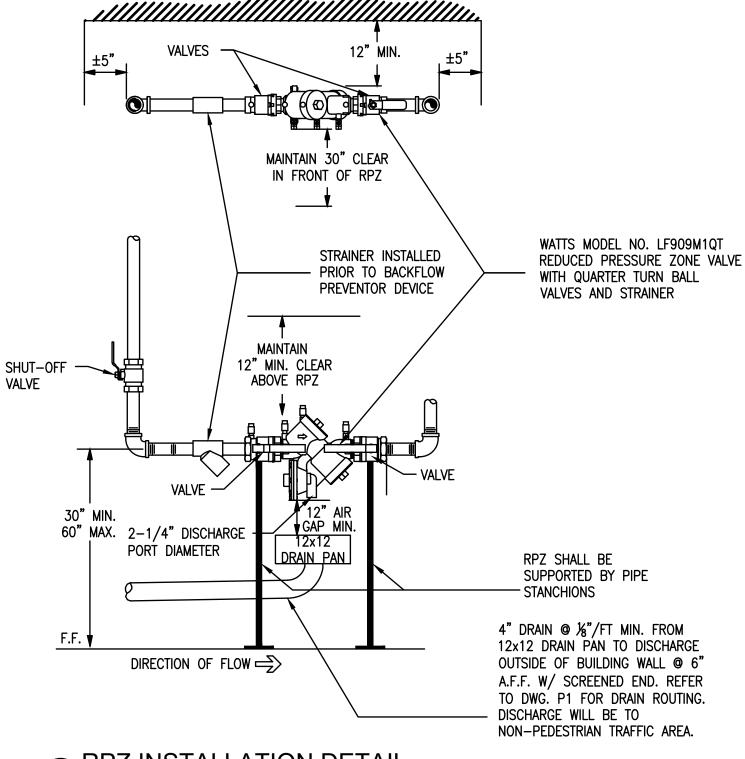
CHECKED BY:

BA/WDM

ROJECT ENGINEER:

DESIGNED BY:

DIRECTION OF FLOW



PPZ INSTALLATION DETAIL Scale: NTS

GENERAL PLUMBING SHEET NOTES

- 1. THE PLUMBING WORK SHALL BE PERFORMED IN STRICT ACCORDANCE WITH THE PROJECT SPECIFICATIONS AND WITH THE LATEST EDITION OF THE PREVAILING STATE PLUMBING CODES AS WELL AS ALL LOCAL REGULATIONS THAT MAY APPLY. IN CASE OF CONFLICT BETWEEN THE CONTRACT DOCUMENTS AND A GOVERNING CODE OR ORDINANCE THE MORE STRINGENT STANDARD SHALL APPLY.
- 2. ALL PLUMBING WORK SHALL BE COORDINATED WITH ALL OTHER TRADES BEFORE PROCEEDING.
- 3. INVERT ELEVATIONS AND EXACT LOCATIONS OF ALL EXISTING UTILITIES SHALL BE VERIFIED BEFORE PROCEEDING WITH NEW WORK.
- 4. NO CHANGES ARE TO BE MADE IN PLUMBING LAYOUT WITHOUT WRITTEN PERMISSION BY THE ARCHITECT AND/OR ENGINEER.
- 5. NO PIPING SHALL BE EXPOSED IN FINISHED AREAS.
- 6. ROUGHING DIMENSIONS OF TOILET FIXTURES MUST BE COORDINATED WITH ALL TRADES.
- 7. WATER SUPPLY PIPING SHALL BE TYPE "L" COPPER, OR EQUAL.
- 8. INSULATE ALL WATER PIPING EXCEPT EXPOSED TO FIXTURES WITH 1/2" FIBERGLASS INSULATION WITH NON-COMBUSTIBLE UL RATED VAPOR BARRIER OR CLOSED CELL FLEXIBLE INSULATION.
- 9. PROVIDE SHUT-OFF VALVES AT EACH FIXTURE ON WATER SUPPLY PIPES, COLD AND HOT.
- ALL ACCESS PANELS & LOCATIONS SHALL BE BY CONTRACTOR AND COORDINATED WITH ALL OTHER TRADES.
- 11. INSTALL ALL REQUIRED CLEANOUTS TO CLEAR EQUIPMENT AND FIXTURES.
- 12. ALL WORK SHALL BE PROPERLY TESTED, BALANCED, CLEANED AND DISINFECTED.
- 13. CONTRACTOR TO FIRESEAL ALL THRU-WALL PENETRATIONS THROUGH RATED WALLS WITH 3M BRAND FIRESTOP SEALANT OR APPROVED EQUAL.
- 14. REFER TO PLUMBING FIXTURE CONNECTION SCHEDULE.
- 15. ALL UNDERGROUND COPPER WATER PIPING SHALL BE PROTECTED IN A PVC CASING PIPE 2" GREATER THAN THE LARGEST DIAMETER SUPPLY LINE. PIPING SHALL BE COATED WITH ASPHALTUM AND BITUMASTIC.
- 16. ALL PIPING TO BE RUN AS TIGHT AS POSSIBLE TO STRUCTURE. COORDINATE WITH ALL TRADES
- 17. CONTRACTOR IS RESPONSIBLE FOR THE PRODUCTION OF PLUMBING AS BUILT DRAWINGS AND ASSOCIATED DOCUMENTS.
- 18. CONTRACTOR TO PROTECT PLUMBING PIPING FROM DAMAGE RESULTING FROM EXPANSION, CONTRACTION AND STRUCTURAL SETTLEMENT.
- 19. EXPANSION JOINT FITTINGS TO BE USED WHERE NECESSARY TO PROVIDE FOR EXPANSION AND CONTRACTION OF PIPING.

DRAWING NO.

P4

ROJECT NO.

SCALE:

PLUMBING

5708

AUGUST 2023

N.T.S.

REDUCED PRESSURE PRINCIPLE ASSEMBLY SCHEDULE

ORANGE COUNTY

MARK	MANUF	MODEL	SIZE	FLOW	FLOW RATE	PRESSURE LOSS	MAX WORKING PRESSURE	REMARKS
RPZ-1	WATTS	LF909M1QT	2"	77 GPM	7.5 FPS	10 PSI	175 PSI	SEE NOTES BELOW

NOTES:

D&B ENGINEERS AND ARCHITECTS

- 1. MOUNT RPZ DEVICE AT 30" FROM FLOOR TO CENTERLINE OF DEVICE, INSTALL WITH 12" CLEAR FROM BACK OF DEVICE TO FINISHED WALL
- (REFER TO INSTALLATION ON THIS SHEET).


 TEST COCKS MUST BE POSITIONED TO FACILITATE TESTING (30" MINIMUM CLEARANCE)
- DRAINS CANNOT BE SUBJECT TO FLOODING AND MUST BE SCREENED.
- 4. RPZ MUST BE A LEAD FREE MODEL. 5. RPZ MUST BE ADEQUATELY SUPPORTED TO PREVENT LATERAL MOVEMENT TO THE FLOOR.
- 6. SUPPORTS MUST BE PLACED WHERE THEY WILL NOT OBSTRUCT THE FUNCTION OR ACCESS TO RELIEF VALVE.
 7. RPZ MUST HAVE USC FOUNDATION FOR CROSS CONNECTION CONTROL APPROVAL.

LASSER PARK SENIOR CENTER

- 8. A SEPARATE SHUT OFF VALVE IS REQUIRED UPSTREAM OF THE ASSEMBLY.
- 9. RPZ MAY NOT BE INSTALLED HIGHER THAN 5' ABOVE THE FLOOR OR A FIXED PLATFORM IS REQUIRED.
- 10. INSTALL PROTECTIVE STRAINER PER MANUFACTURERS RECOMMENDATION
 11. RPZ DEVICE WILL BE INSTALLED ABOVE THE 100 YEAR FLOOD ELEVATION.


TOWN OF BLOOMING GROVE NEW YORK DETAILS



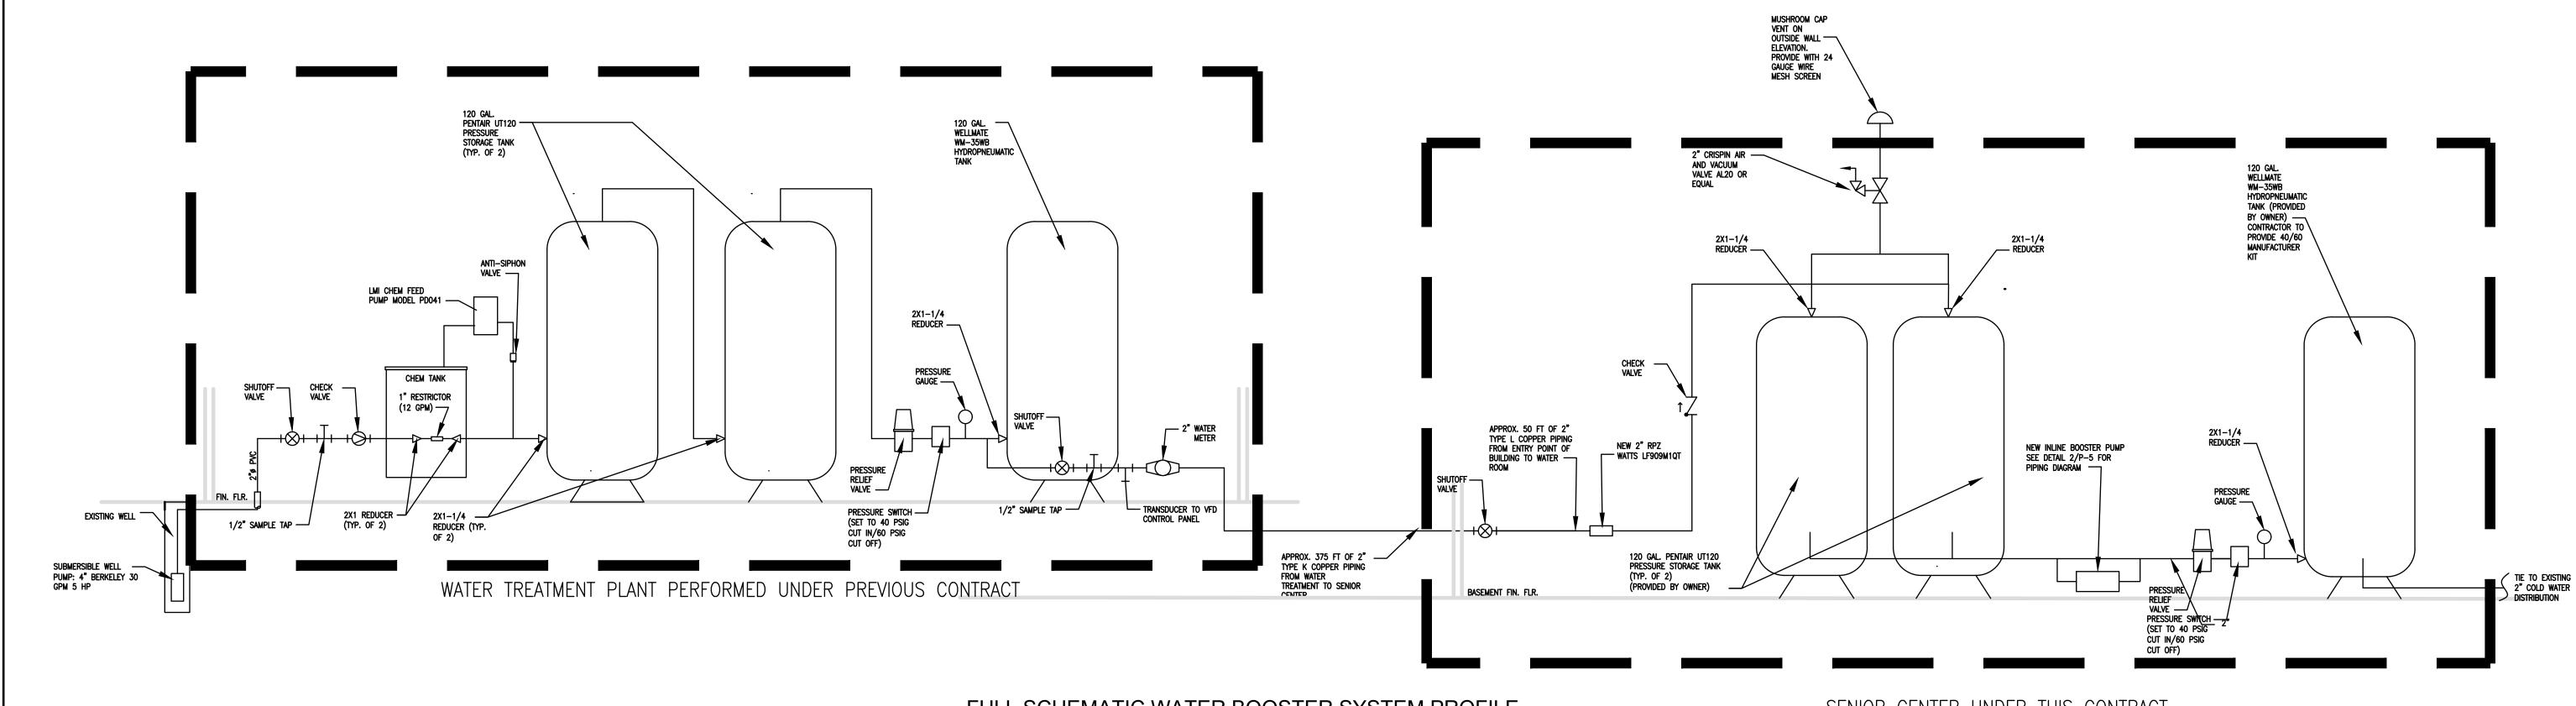

FULL SCHEMATIC WATER BOOSTER SYSTEM PROFILE

SENIOR CENTER UNDER THIS CONTRACT

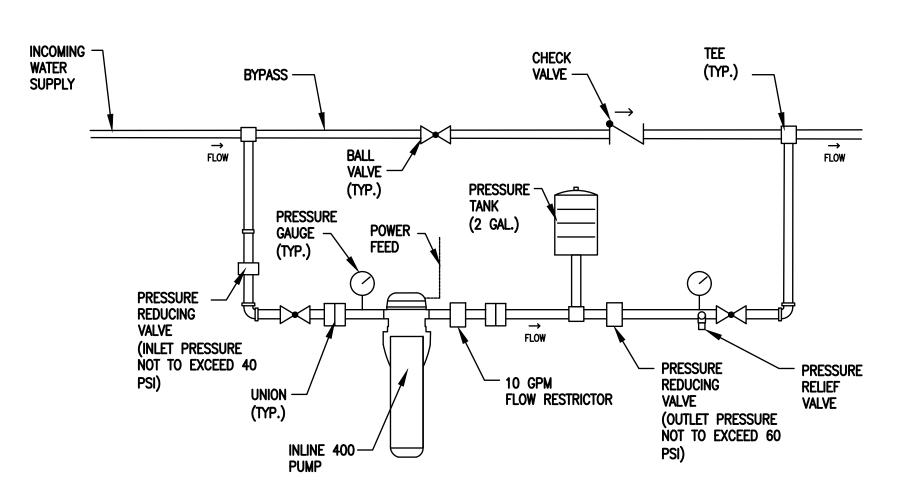

2 INLINE BOOSTER PUMP PIPING SCHEMATIC Scale: NTS

INLINE PRESSURE BOOSTER PUMP

MARK	MODEL	MANF.	ELECTRICAL
P-1	INLINE 400	LITTLE GIANT	1/3 HP 115V 60 HZ 6.6 AMP

NOTES: PRESSURE TANK PURCHASED WITH UNIT. PRESSURE TANK TO BE MOUNTED NO MORE THAN 5 FEET FROM BOOSTER PUMP. UNIT IS EQUIPPED WITH A FLOW SENSOR AND DUAL PRESSURE SWITCHES.

UNIT WILL TURN ON WHEN DISCHARGE PRESSURE DROPS BELOW 40 PSI AND FLOW THROUGH THE PUMP IS GREATER THAN 1/2 GPM.

]] [UNAUTHORIZED ALTERATION OR ADDITION TO THIS DOCUMENT IS A VIOLATION OF SECTION 7209 OF THE NEW YORK STATE EDUCATION LAW.			D&B FNGINFERS
]*		PROJECT ENGINEER: AE	DRAWN BY: MP/PD	ab	AND ARCHITECTS
				100 No. 072392 W	DESIGNED BY:	CHECKED BY:		
NO.	DATE	REVISION INT.	1	POFESSIONA	MP/PD	BA/WDM		

	TOWN OF BLOOMING GROVE	
	ORANGE COUNTY	NEW YORK
5	LASSER PARK SENIOR CENTER	

PROJECT NO. **CONTRACT 2 DETAILS AUGUST 2023** SCALE: **PLUMBING**

N.T.S.

DRAWING NO.