

CITY SCHOOL DISTRICT OF NEW ROCHELLE

ALBERT LEONARD MIDDLE SCHOOL

2023 CAPITAL PROJECTS - PHASE 1

25 GERADA LN. NEW ROCHELLE, NY 10804

ISSUED FOR BID: 10/29/2024




CSARCH - ARCHITECTS

GREENMAN - PEDERSEN, INC. - MEP & STRUCTURAL ENGINEER

STATE EDUCATION DEPARTMENT PROJECT CONTROL NUMBER:
2023 CAPITAL PROJECTS - PHASE 1 66-11-00-01-0-002-016

THE DESIGN OF THIS PROJECT CONFORMS TO APPLICABLE PROVISIONS OF THE NEW YORK STATE UNIFORM FIRE PREVENTION AND BUILDING CODE, THE NEW YORK STATE ENERGY CONSERVATION CONSTRUCTION CODE, AND THE MANUAL OF PLANNING STANDARDS OF THE NEW YORK STATE EDUCATION DEPARTMENT.


CSArch PROJECT NO. 188-2301.01

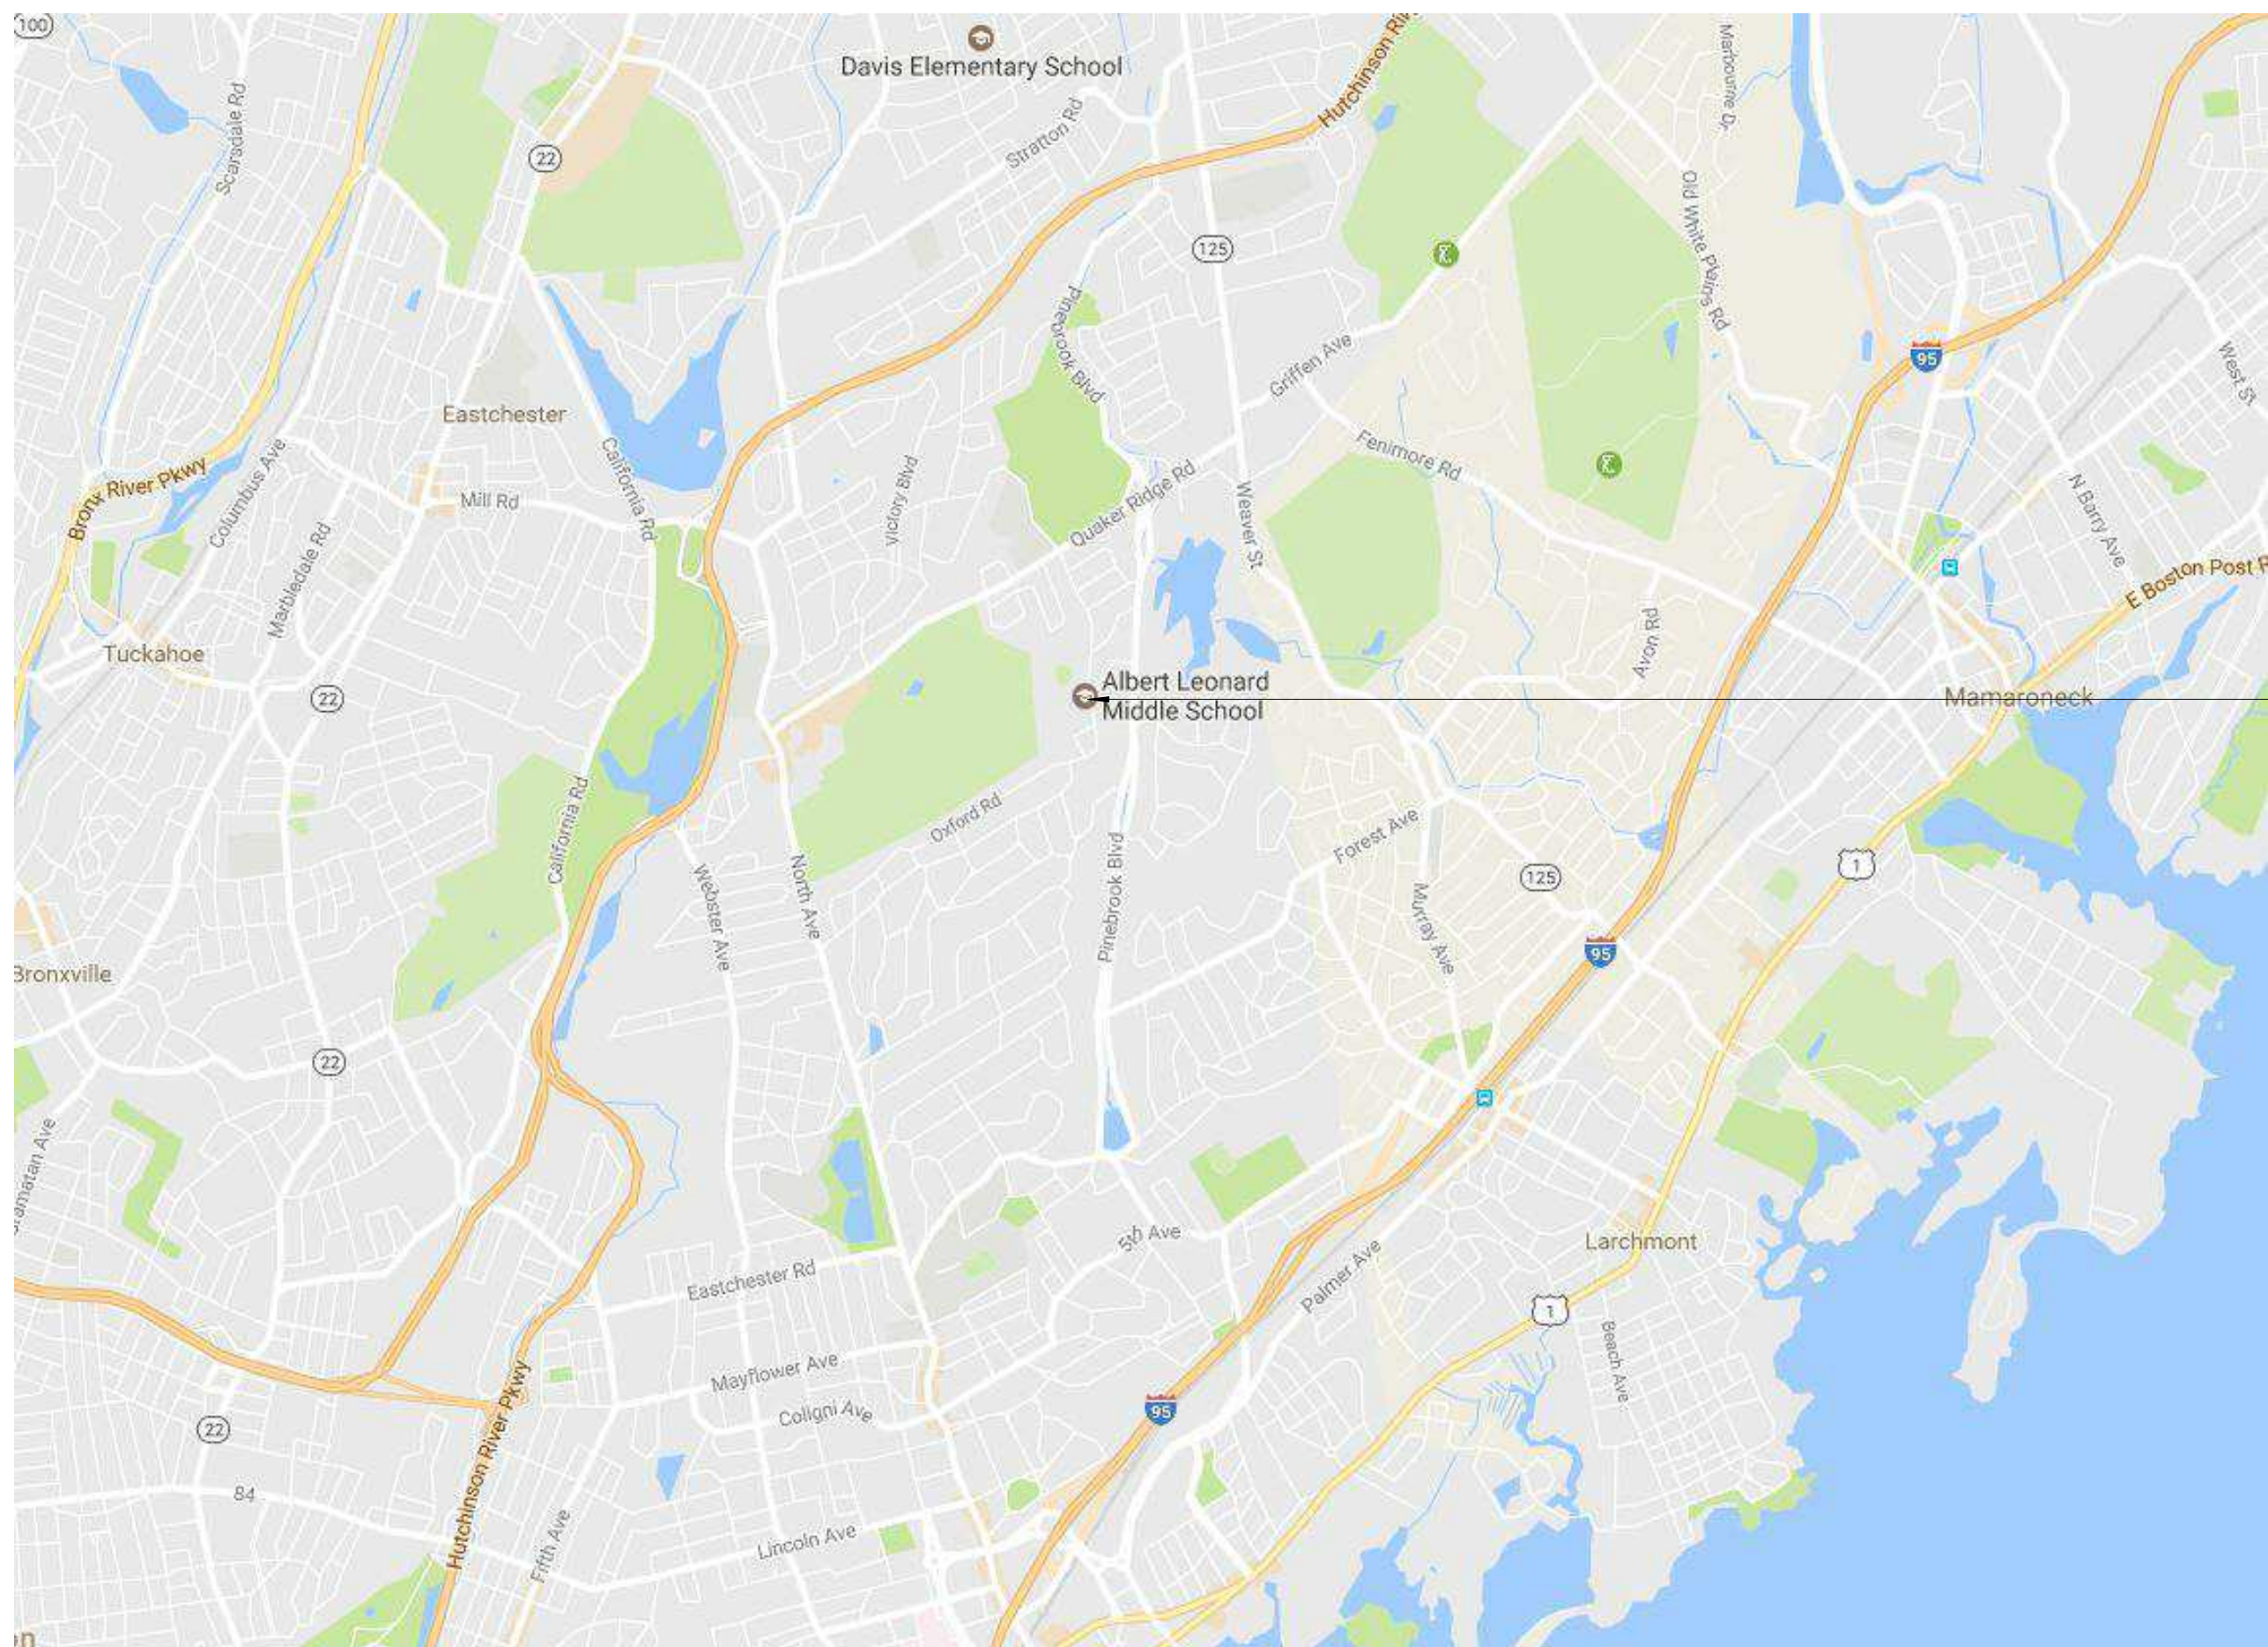

ALBERT LEONARD MIDDLE SCHOOL

VICINITY MAP

NTS

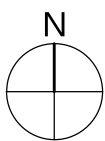

DRAWING LIST - VOLUME 2

GENERAL DRAWINGS	
G000	COVER
G001	SYMBOLS, ABBREVIATIONS, AND MISC
G112	OVERALL FIRST FLOOR PLAN
G121	OVERALL SECOND FLOOR PLAN
LIFE SAFETY DRAWINGS	
LS111	AREA 'A' & 'B' - PARTIAL FIRST FLOOR LIFE SAFETY PLAN
LS113	AREA 'C', 'D', 'E', 'F' - PARTIAL FIRST FLOOR LIFE SAFETY PLAN
LS123	SECOND FLOOR LIFE SAFETY PLAN
LS131	SMOKE ZONE PLANS
ARCHITECTURAL DRAWINGS	
A112	AREA 'B' - PARTIAL FIRST FLOOR PLAN
A611	ENLARGED SECURED VESTIBULE, ELEVATIONS AND DETAILS
A651	CASEWORK DETAILS AND LINTEL SCHEDULE
A611	ENLARGED NEW WORK AND DEMO REFLECTED CEILING PLANS
A900	DOOR AND WINDOW SCHEDULE, ELEVATIONS, DETAILS
A921	STOREFRONT ELEVATIONS
ARCHITECTURAL FINISH DRAWINGS	
AF112	AREA 'B' - PARTIAL FIRST FLOOR FINISH PLAN
MECHANICAL GENERAL DRAWINGS	
M001	MECHANICAL LEGENDS AND ABBREVIATIONS
MECHANICAL DEMOLITION DRAWINGS	
MD101	MECHANICAL REMOVALS PLAN
MECHANICAL DRAWINGS	
M101	MECHANICAL NEW WORK PLAN
ELECTRICAL GENERAL DRAWINGS	
E001	ELECTRICAL LEGEND AND ABBREVIATIONS
ELECTRICAL DEMOLITION DRAWINGS	
ED101	FIRST FLOOR AREA 'B' ELECTRICAL REMOVALS PLAN
ELECTRICAL DRAWINGS	
E101	FIRST FLOOR AREA 'B' ELECTRICAL NEW WORK PLAN

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ABBREVIATIONS

ABBREVIATION	DESCRIPTION
ADA	AMERICANS WITH DISABILITIES ACT
ADD	ADDENDUM
ADMIN	ADMINISTRATIVE
AFF	ABOVE FINISHED FLOOR
ALT	ALTERNATE
APPROX	APPROXIMATE
ARCH	ARCHITECT / ARCHITECTURAL
AV	AUDIO VISUAL
BLDG	BUILDING
BOT OR B/	BOTTOM OF
BSMT	BASEMENT
C-J	CONTROL / CONSTRUCTION JOINT
CL	CENTERLINE
CLG	CEILING
CLR	CLEAR
CMU	CONCRETE MASONRY UNIT
COL	COLUMN
CONG	CONCRETE
CONF	CONFERENCE
CONT	CONTINUOUS
CONTR	CONTRACTOR
COORD	COORDINATE
CORR	CORRIDOR
DEMO	DEMOLITION
DET	DETAIL
DIA	DIAMETER
DN	DOWN
DWG	DRAWING
ED	EDUCATION
EIFS	EXTERIOR INSULATION FINISH SYSTEM
ELECT	ELECTRIC / ELECTRICAL
ELEV	ELEVATION
EPDM	ETHYLENE PROPYLENE DIENE MONOMER
EQ	EQUAL
EQUIP	EQUIPMENT
EXST	EXISTING
EJ	EXPANSION JOINT
EXT	EXTERIOR
FIN	FINISH
FIN FL	FINISH FLOOR
FIXT	FIXTURE
FLR	FLOOR
FRF	FIRE-RETARDANT-TREATED MATERIAL
FTS	FOOTING
G	GROUND
GA	GAUGE
GAL	GALLON(S)
GALV	GALVANIZE(D)
GC	GENERAL CONTRACTOR
GMB	GYPSUM WALL BOARD
GMB5	GYPSUM WALL BOARD SOFFIT
HM	HOLLOW METAL
HORIZ	HORIZONTAL
HR	HOOR
HT	HEIGHT
HTG	HEATING
HVAC	HEATING/VENTILATING/AIR CONDITIONING
ID	INSIDE DIMENSION
IN	INCH
INT	INTERIOR
JAN	JANITOR
JC	JANITOR'S CLOSET
JST	JOIST
JT	JOINT
LAB	LABORATORY
LB	LOAD
LN	LINEAR
LVL	LEVEL
MAN	MANUAL
MAS	MASONRY
MAX	MAXIMUM
MDF	MEDIUM DENSITY FIBERBOARD
MECH	MECHANICAL
MEZZ	MEZZANINE
MFR	MANUFACTURER
MD	MODEL
MIN	MINIMUM
MISC	MISCELLANEOUS
MO	MASONRY OPENING
MTL	METAL
NA	NOT APPLICABLE
NC	NOT IN CONTRACT
NOM	NOMINAL
NTS	NOT TO SCALE
OC	ON CENTER
OD	OUTSIDE DIAMETER
OH	OVERHEAD
OPT	OPTIONAL
OVR	OVERALL
OZ	OUNCE
PERIM	PERIMETER
PLAM	PLASTIC LAMINATE
PLBG	PLUMBING
PLAS	PLASTER
PLYMD	PLYWOOD
PNL	PANEL
PNT	PAINT
POLYISO	POLYISOCYANURATE
PPT	PRESSURE PRESERVATIVE TREATED
PR	PAIR
PREP	PREPARATORY
PTN	PARTITION
PVC	POLYVINYL CHLORIDE
RAD	RADIUS
REQD	REQUIRED
RM	ROOM
RND	ROUND
RO	ROUGH OPENING
SCH	SCHEDULED
SECT	SECTION
SF	SQUARE FEET
SH	SIMILAR
SPEC	SPECIFICATION
SQ	SQUARE
SS	STAINLESS STEEL
STC	SOUND TRANSMISSION CLASS
STD	STANDARD
STL	STEEL
STOR	STORAGE
STRUCT	STRUCTURAL / STRUCTURE
SUSP	SUSPENDED
SAC	SUSPENDED ACOUSTICAL CELING
T&B	TOP AND BOTTOM
T&G	TONGUE AND GROOVE
TECH	TECHNOLOGY
TEMP	TEMPORARY
TMFD	TEMPERED
TOM	TOP OF MASONRY
TOS	TOP OF STEEL
TYP	TYPICAL
UL	UNDERWRITERS LABORATORY
UNO	UNLESS NOTED OTHERWISE
VERT	VERTICAL
VEST	VESTIBULE
VIF	VERIFY IN FIELD
W/	WITH
W/O	WITHOUT
WD	WOOD
WPT	WOOD PRESERVED-TREATED MATERIAL
WST	WEIGHT
YD	YARD

ARCHITECTURAL LEGEND

MATERIAL INDICATIONS	
	EARTH
	GRANULAR FILL
	BRICK
	CONCRETE MASONRY UNIT
	CONCRETE
	GROUT
	ROUGH WOOD BLOCKING
	SHIM
	FINISH WOOD
	PLYWOOD
	SHEATHING
	RIGID INSULATION
	BATT INSULATION
	SPRAY FOAM INSULATION
	EPS INSULATION
	STEEL

DIMENSIONING CONVENTIONS






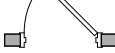
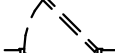

	FACE OF STUD OR CMU
	COLUMN CENTER LINE

SYMBOLS



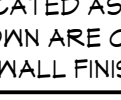
	ROOM NAME
	ROOM NUMBER
	AREA OF ROOM
	DOOR NUMBER, REFER TO A100 DRAWINGS
	WINDOW TAG, REFER TO A100 DRAWINGS
	BORROWED LIGHT NUMBER, REFER TO A100 DRAWINGS
	STOREFRONT / CURTAINWALL NUMBER, REFER TO A100 DRAWINGS
	COLUMN GRID DESIGNATION
	PARTITION TAG, REFER TO A100 DRAWINGS
	HOOR RATING OF PARTITION
	ADDITIONAL NOTES FOR PARTITION
	REVISION NUMBER
	KEY NOTE, NEW WORK
	KEY NOTE, DEMOLITION WORK
	ELEVATION TAG
	HANDICAPPED ACCESSIBLE ELEMENT OR FIXTURE
	ROOM NAME
	INTERIOR FINISH TAG, REFER TO A100 DRAWINGS
	BASE FINISH

DETAIL INDICATOR LEGEND

	SECTION INDICATOR
	SECTION NUMBER
	SECTION NUMBER
	SECTION NUMBER
	SECTION NUMBER
	SECTION NUMBER

PLAN GRAPHICS LEGEND	
	EXISTING CONSTRUCTION TO REMAIN
	EXISTING CONSTRUCTION TO BE REMOVED
	NEW CONCRETE MASONRY WALL
	NEW METAL STUD WALL
	NEW BRICK VENEER
	EXISTING DOOR TO REMAIN
	EXISTING DOOR TO BE REMOVED
	NEW DOOR

FINISHED DOOR OPENINGS SHALL BE LOCATED AS INDICATED BELOW UNING DIMENSIONS SHOWN ARE CLEAR DIMENSIONS FROM INSIDE OF FRAME TO WALL FINISH.

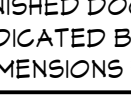		
18" MIN	6'	12"

GENERAL NOTES

- DIMENSIONS ARE GIVEN THUS (UNLESS NOTED OTHERWISE)
 - TO FACE OF MASONRY WALL
 - TO FACE OF METAL STUD
 - TO COLUMN CENTERLINES
 - TO FINISH FACE OF SOFFIT OR CEILING
 - FACE OF EXISTING CONSTRUCTION
- DO NOT SCALE DRAWINGS. IF A DIMENSION IS NOT SHOWN, BRING IT TO THE ATTENTION OF THE ARCHITECT FOR VERIFICATION BEFORE PROCEEDING WITH THE ASSOCIATED WORK
- WALLS ON COLUMN LINES ARE CENTERED, UNO
- ALL DIMENSIONS RELATED TO EXISTING CONDITIONS SHALL BE VERIFIED IN FIELD. CONTRACTOR TO NOTIFY ARCHITECT OF ANY DISCREPANCIES PRIOR TO BEGINNING WORK IN THAT AREA.
- LAYOUT OF TOILET FIXTURES AND ACCESSIBILITY CLEARANCES ARE SHOWN AS CLEAR DIMENSION. CONTRACTORS ARE REQUIRED TO COORDINATE LAYOUTS OF PARTITIONS, UTILITY CONNECTIONS, AND THICKNESS OF FINISHES TO ALLOW THESE CLEAR DIMENSIONS.
- ALL ELEVATIONS (X'-X") ARE REFERENCE FROM FIRST FLOOR ELEVATION
- ALL WOOD BLOCKING WITHIN 2'-0" OF GRADE SHALL BE PRESSURE TREATED
- ALL FLOOR PENETRATIONS SHALL BE SMOKE-SEALED AND / OR FIRE STOPPED. COORDINATE WITH H'DWGSS FOR SMOKE / FIRE DAMPER REQUIREMENTS.
- FOR INTERIOR PARTITION TYPES, REFER TO DRAWING A101
- FOR DOOR SCHEDULE, REFER TO DRAWING A101
- FOR FINISH SCHEDULE, REFER TO DRAWING AF
- ALL EXPOSED SURFACES OF NEW PARTITIONS AND SOFFITS ARE TO BE FINISHED.
- PROVIDE PATCH TO MATCH EXISTING FINISHES AT ALL WALL REMOVAL AREAS, COORDINATE WITH DEMOLITION DRAWINGS AND SPECIFICATIONS.
- ALL CONSTRUCTION SHOWN IS NEW UNLESS NOTED OTHERWISE

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CITY SCHOOL DISTRICT OF NEW ROCHELLE
ALBERT LEONARD MIDDLE SCHOOL
2023 CAPITAL PROJECTS - PHASE 1

Project Title



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DATE	DESCRIPTION

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Sheet Title


SYMBOLS,
ABBREVIATIONS,
AND MISC

Sheet No.

ALMS
G001

CONSTRUCTION DOCUMENTS

CONSTRUCTION DOCUMENTS

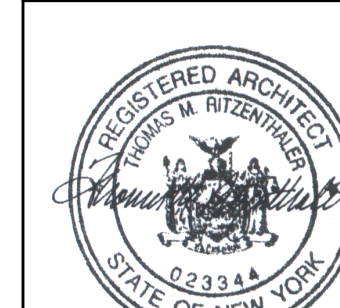

Expiration Date: 02/28/2025

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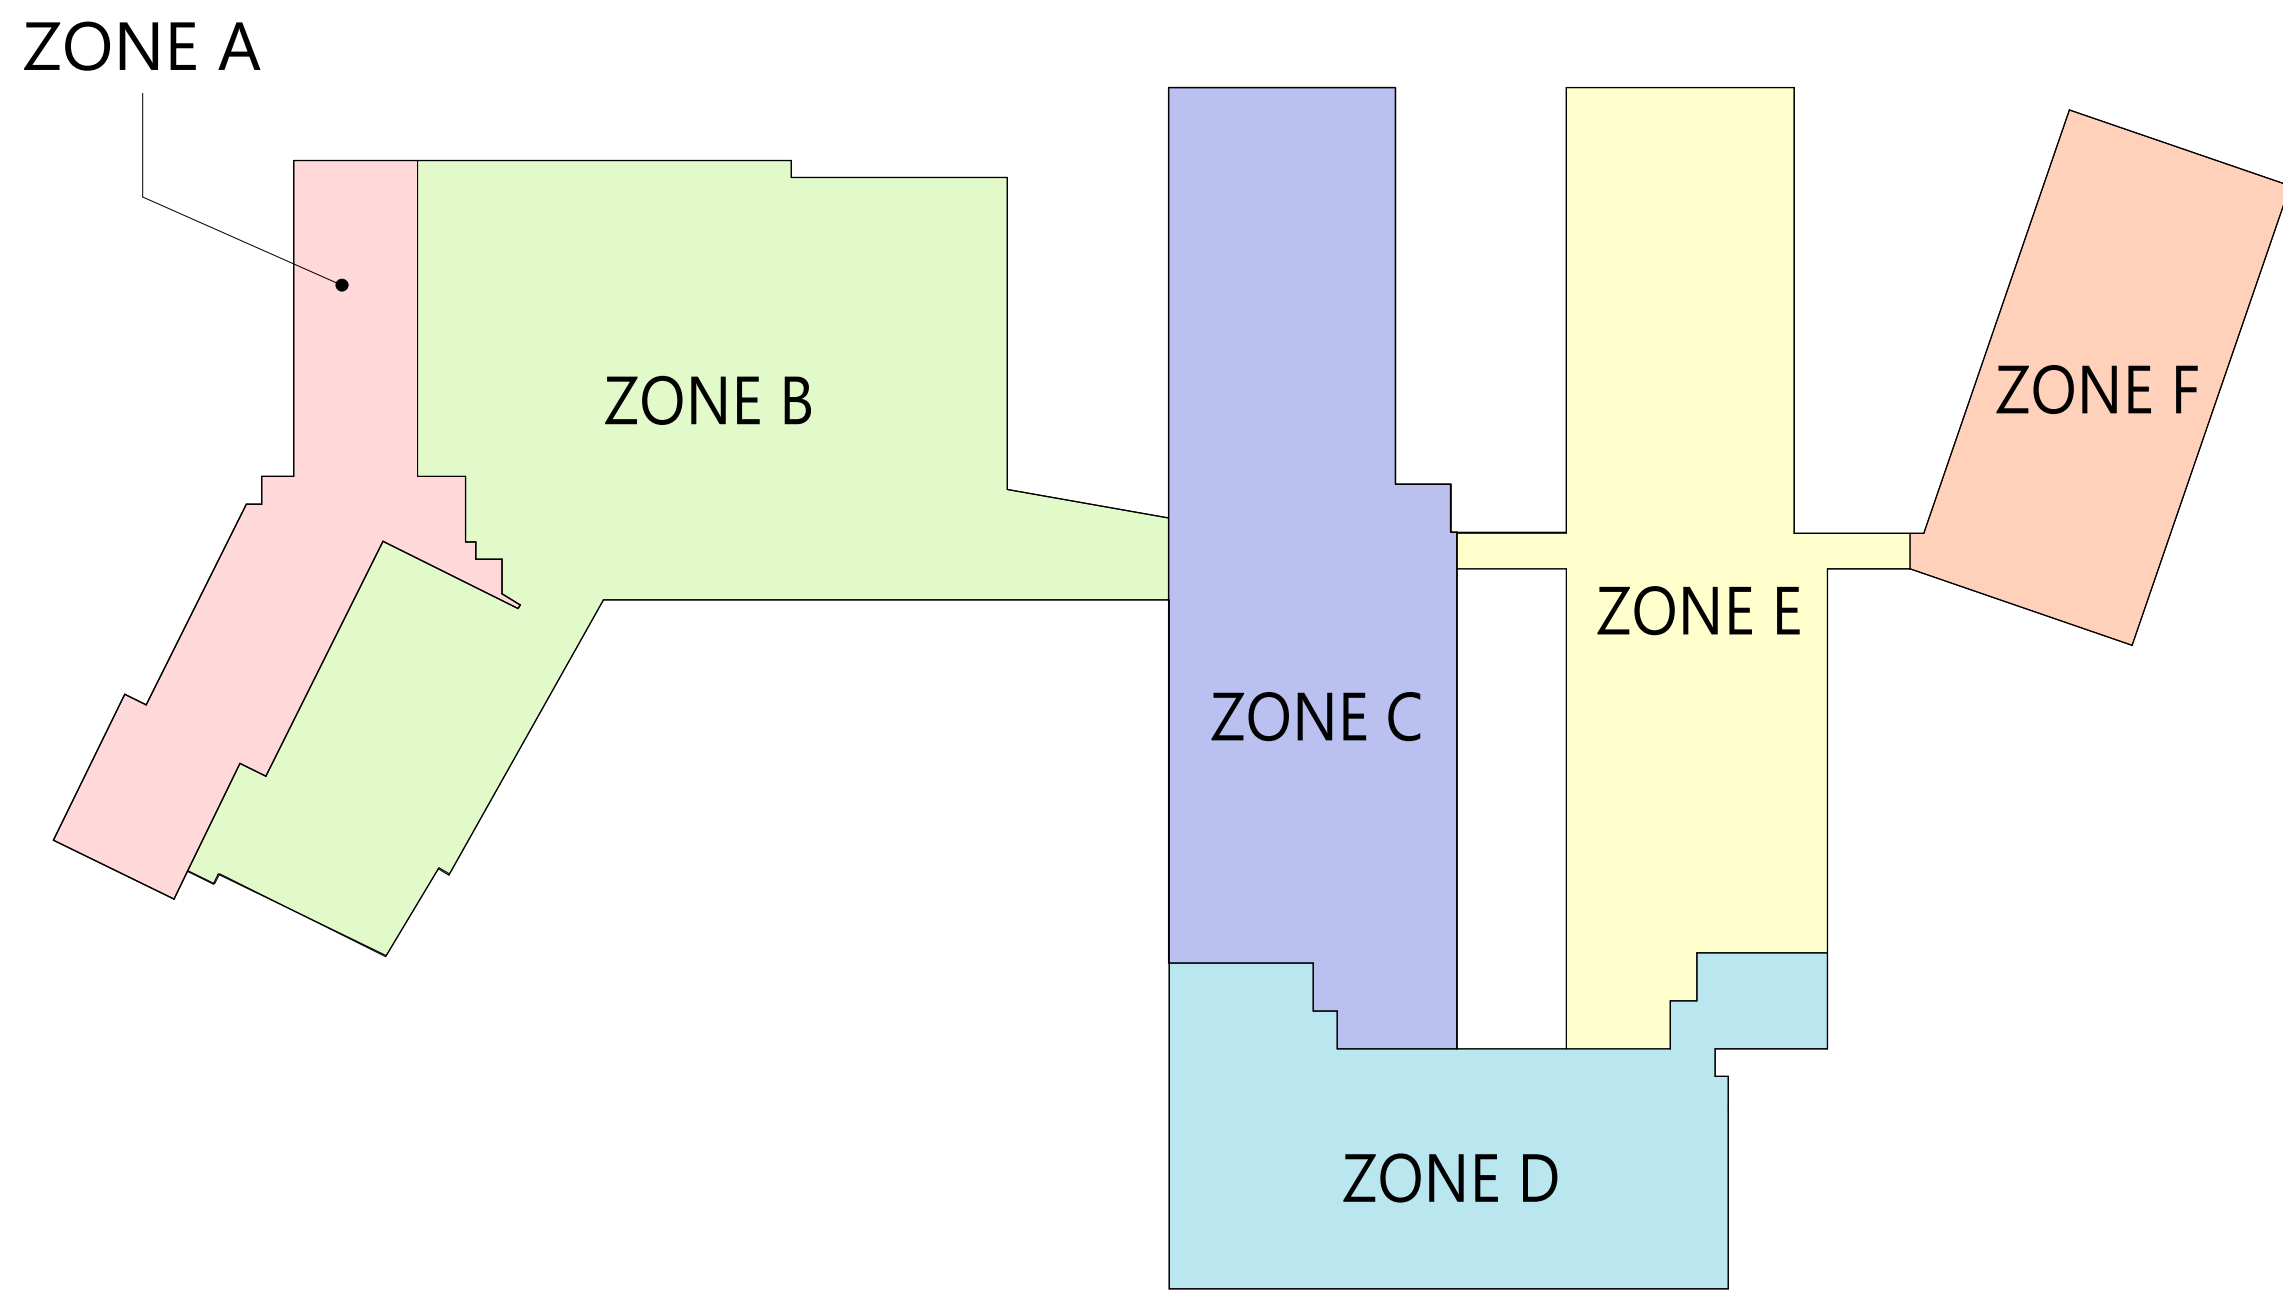
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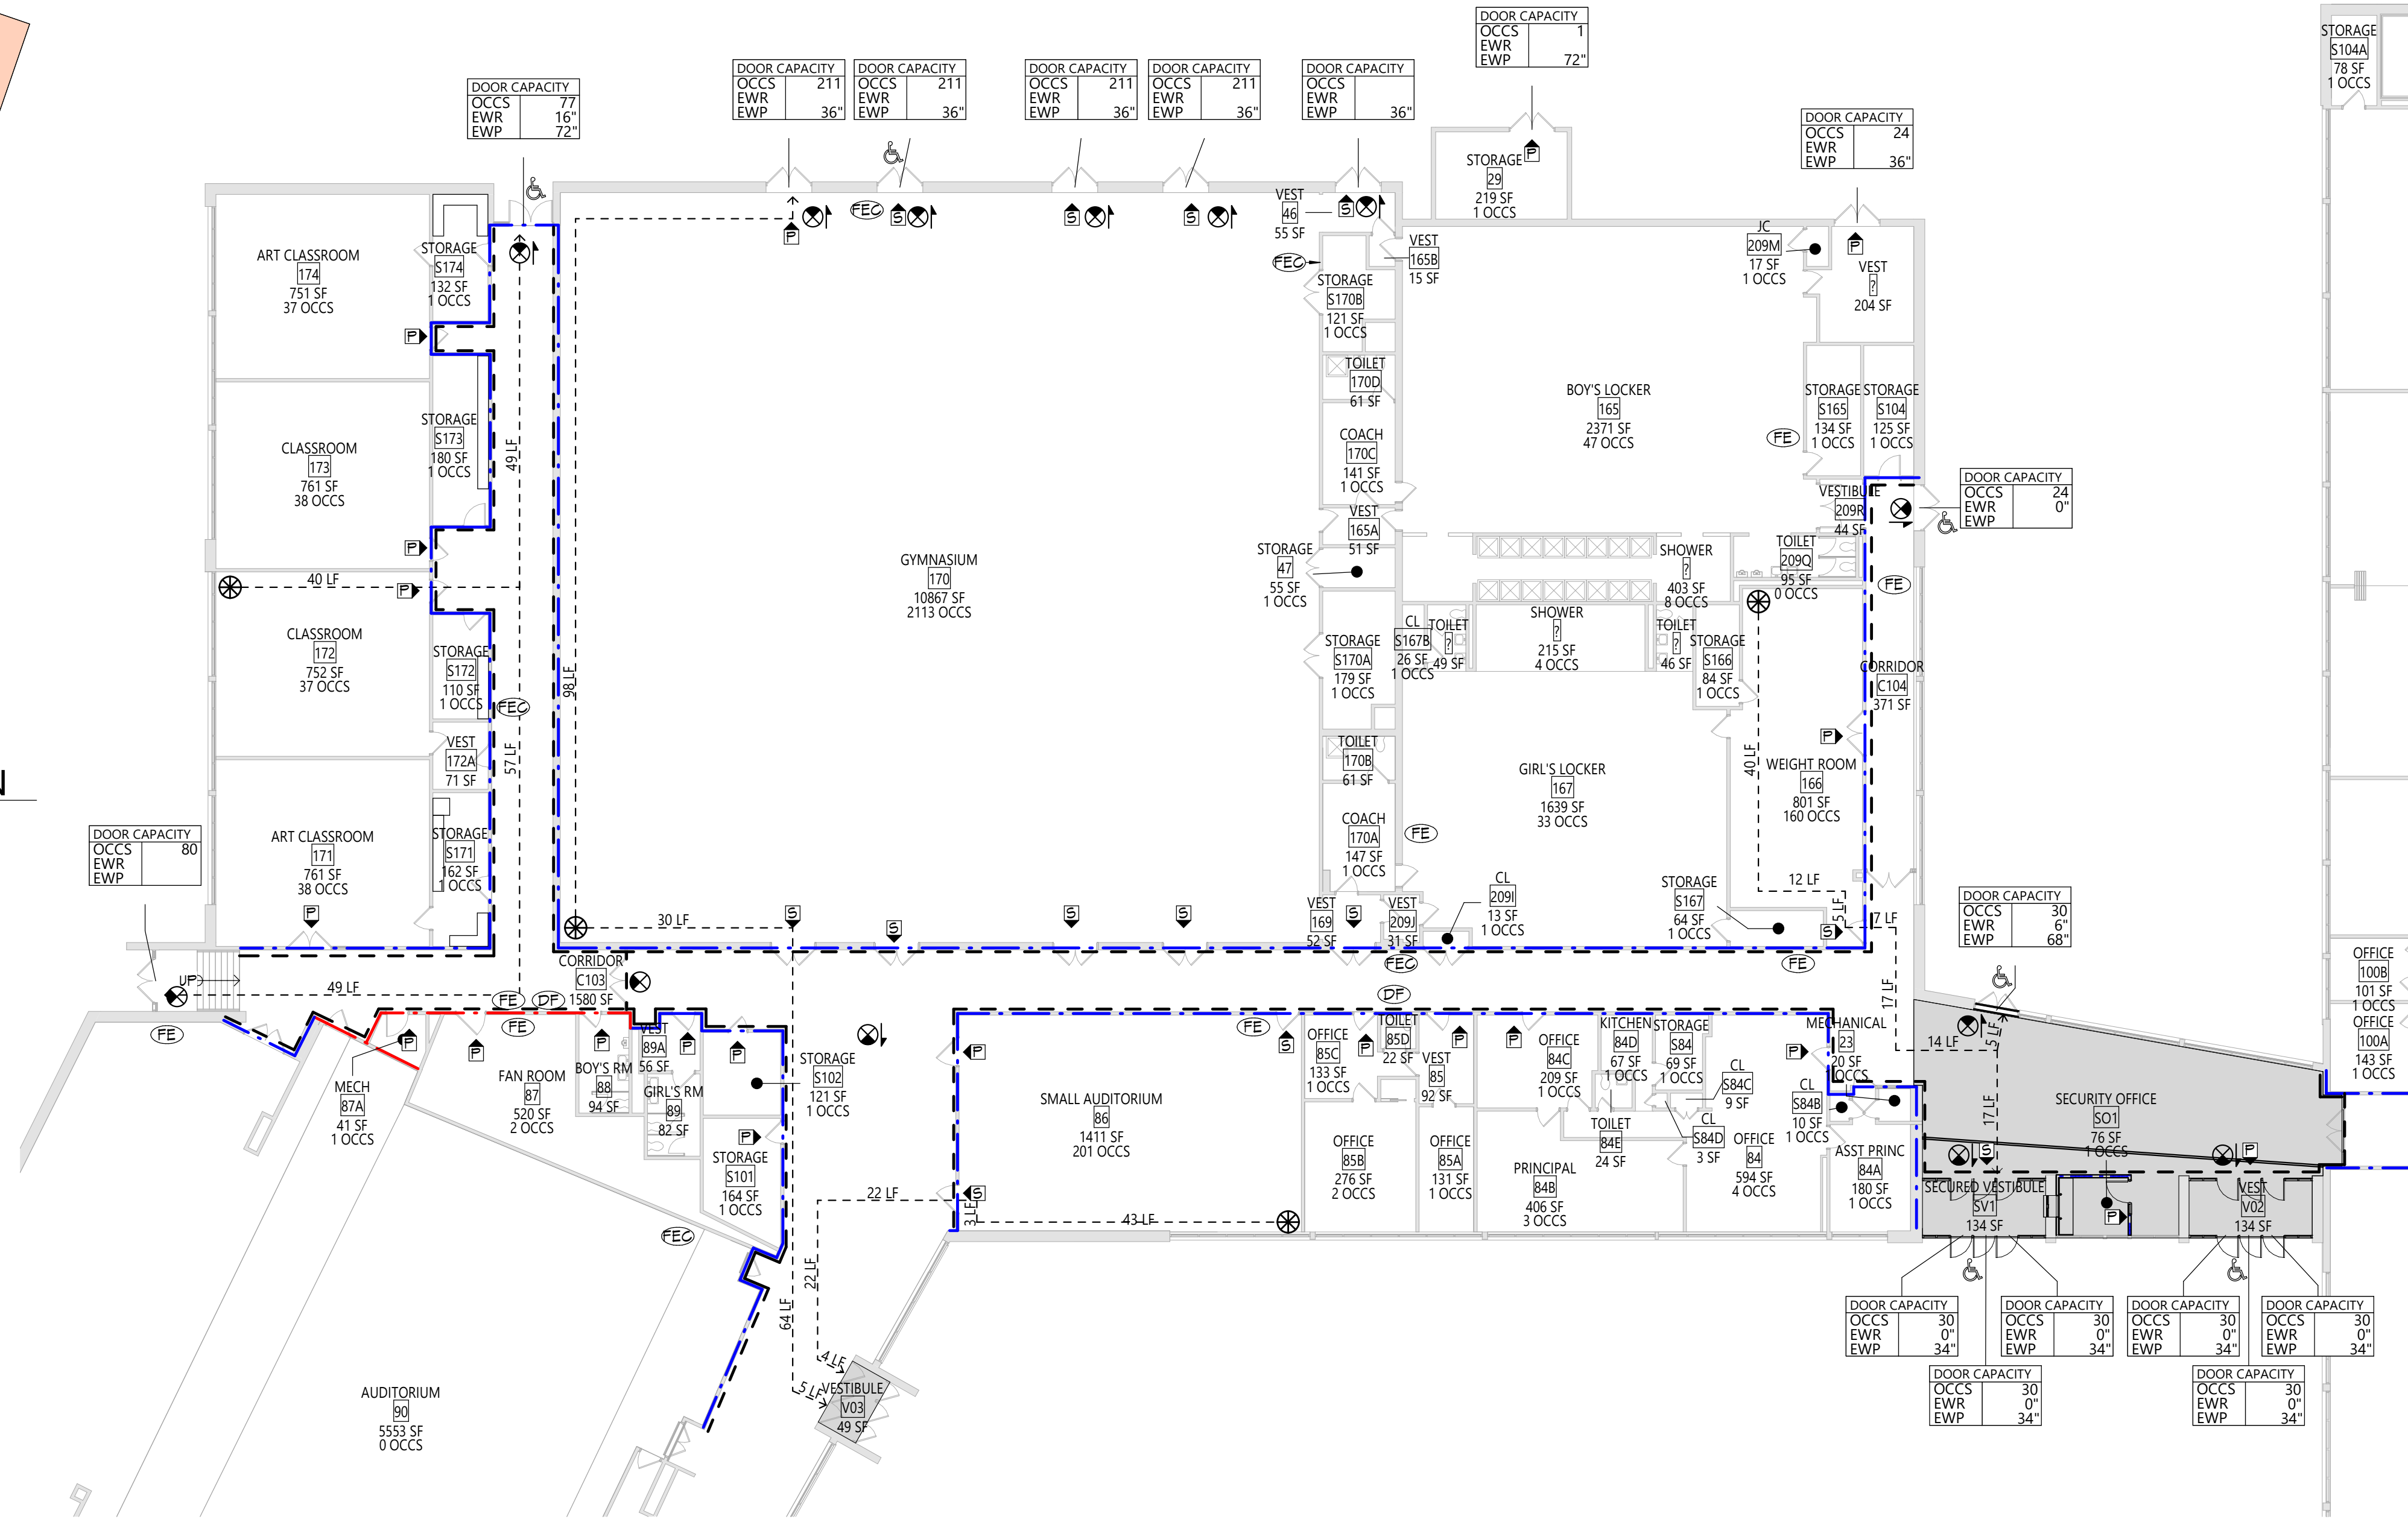
OVERALL
SECOND
FLOOR PLAN

Sheet No. ALMS
G121


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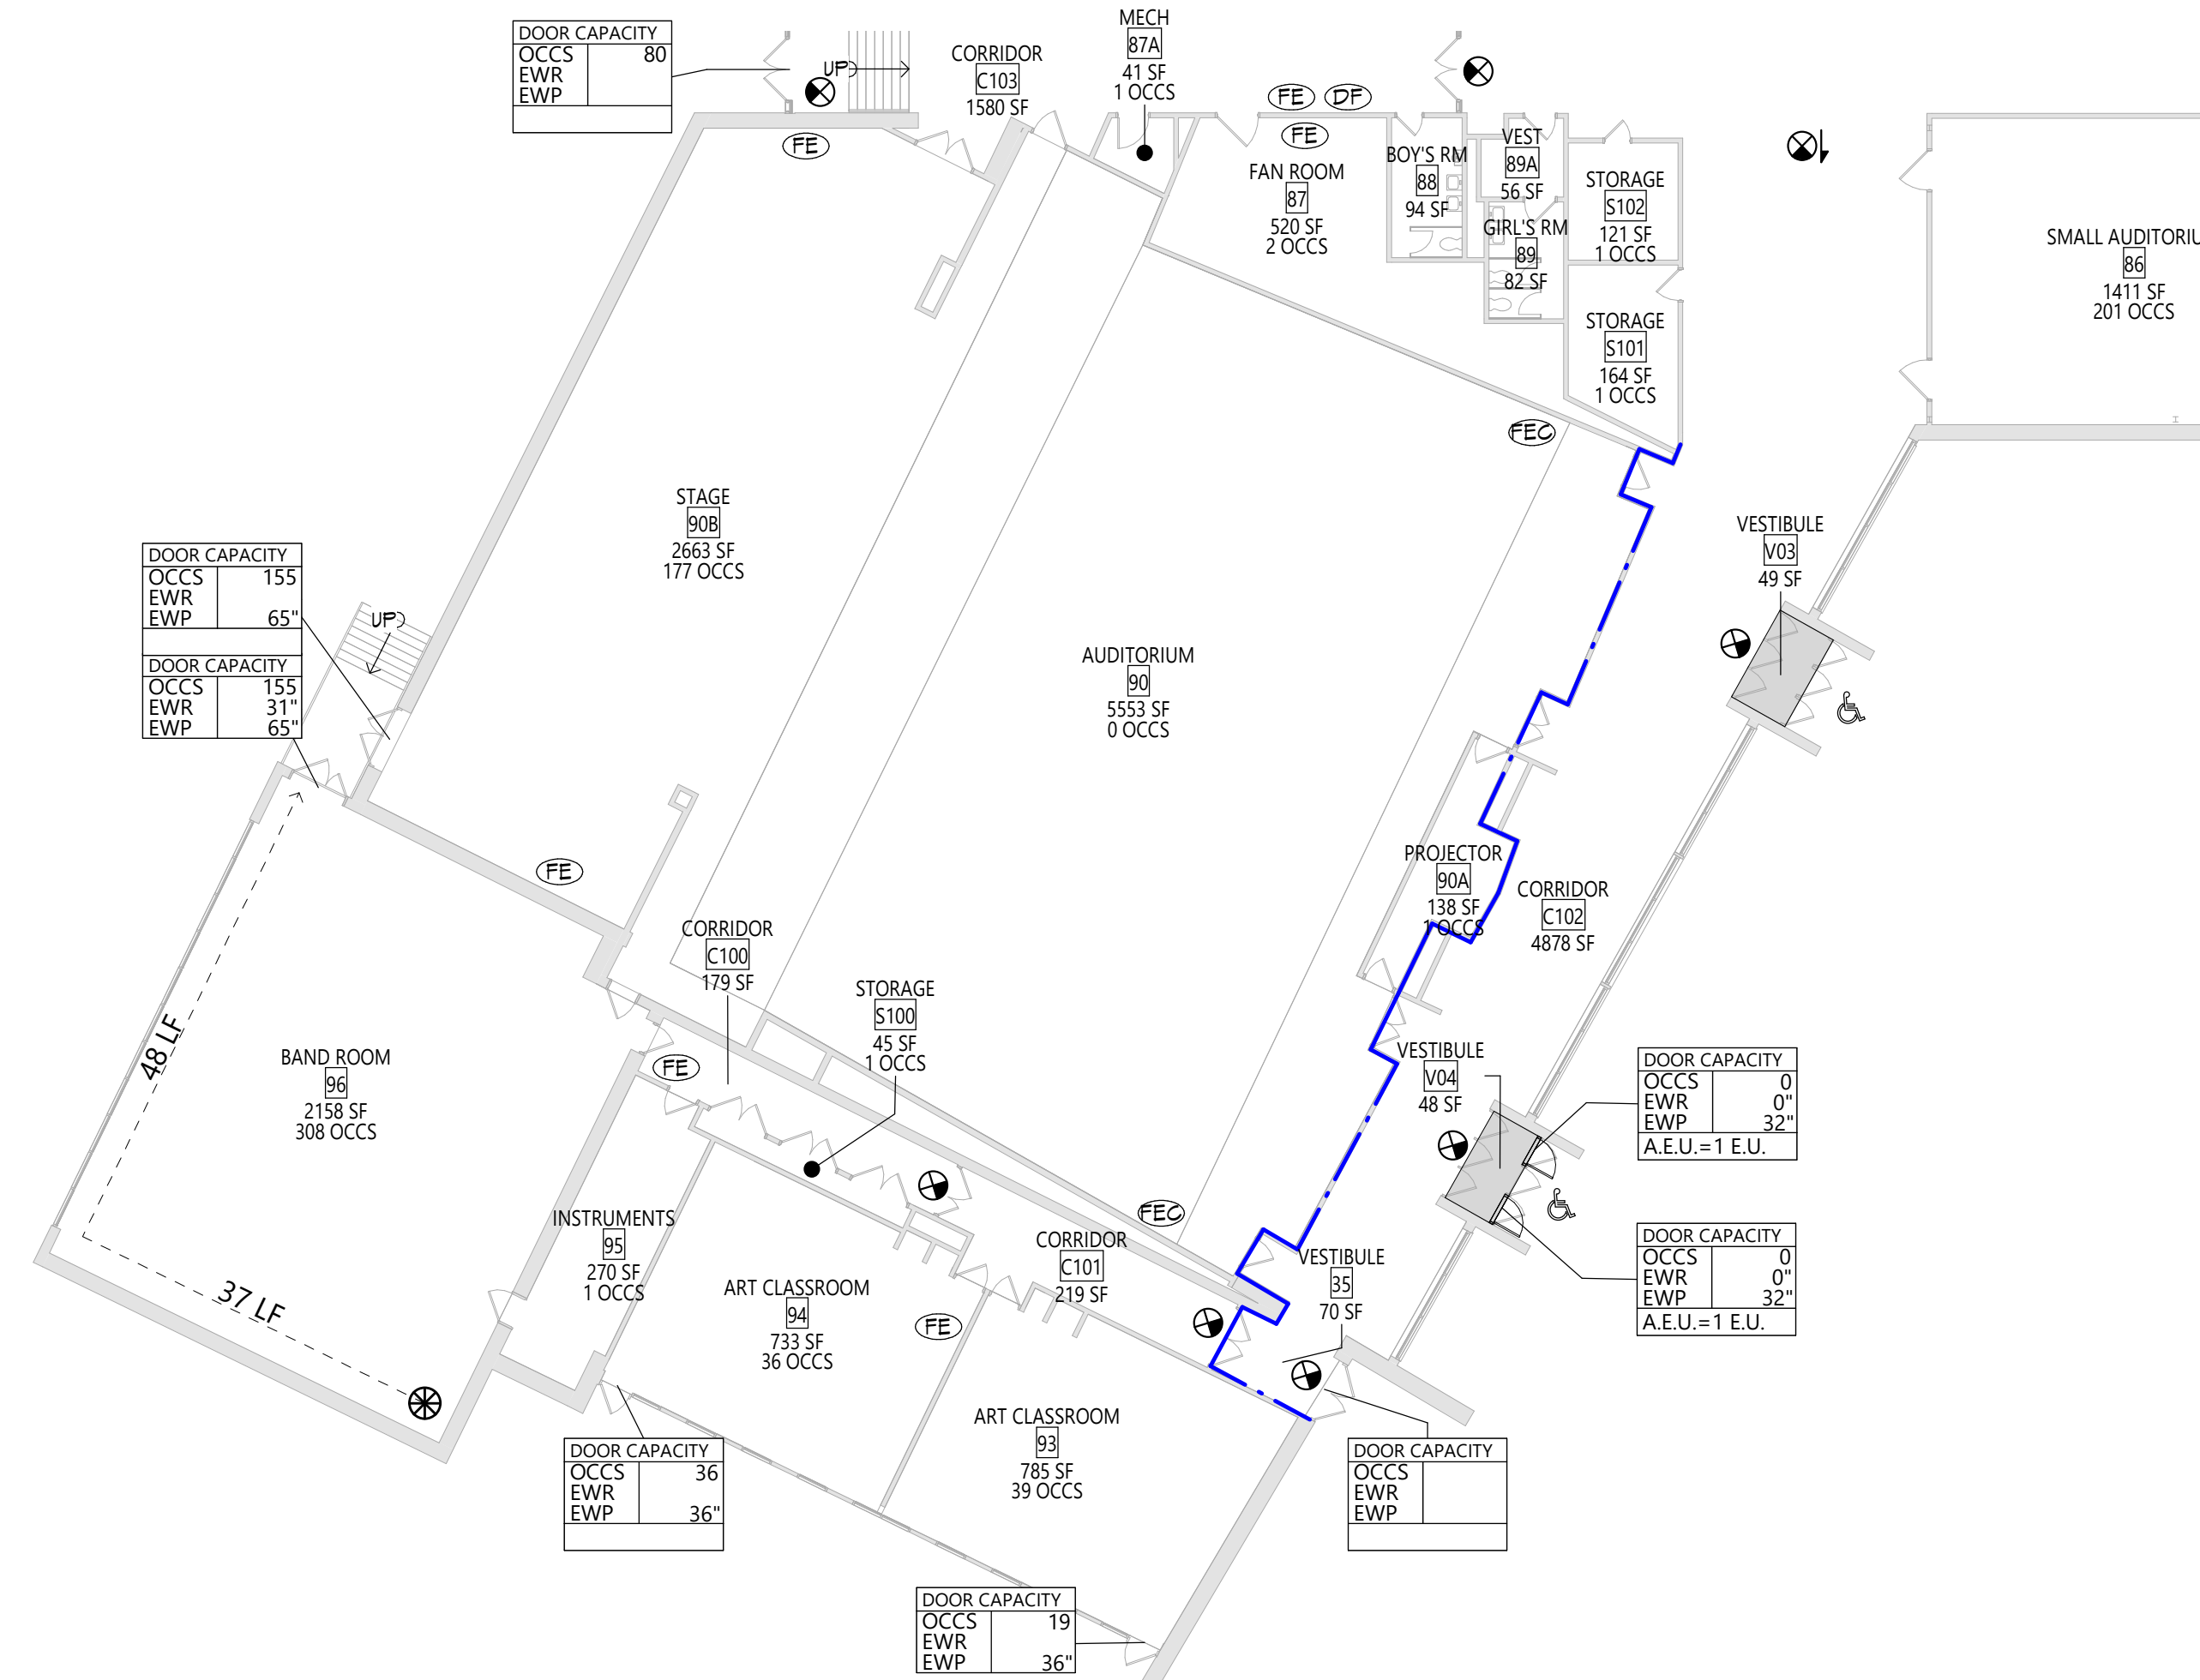
3 ALBERT LENARD FIRE/SMOKE ZONE PLAN
LS111 6" = 1'-0"



2 AREA 'B' FIRST FLOOR PLAN
LS111 1/16" = 1'-0"



ALBERT LEONARD VINTAGE KEY PLAN
6" = 1'-0"

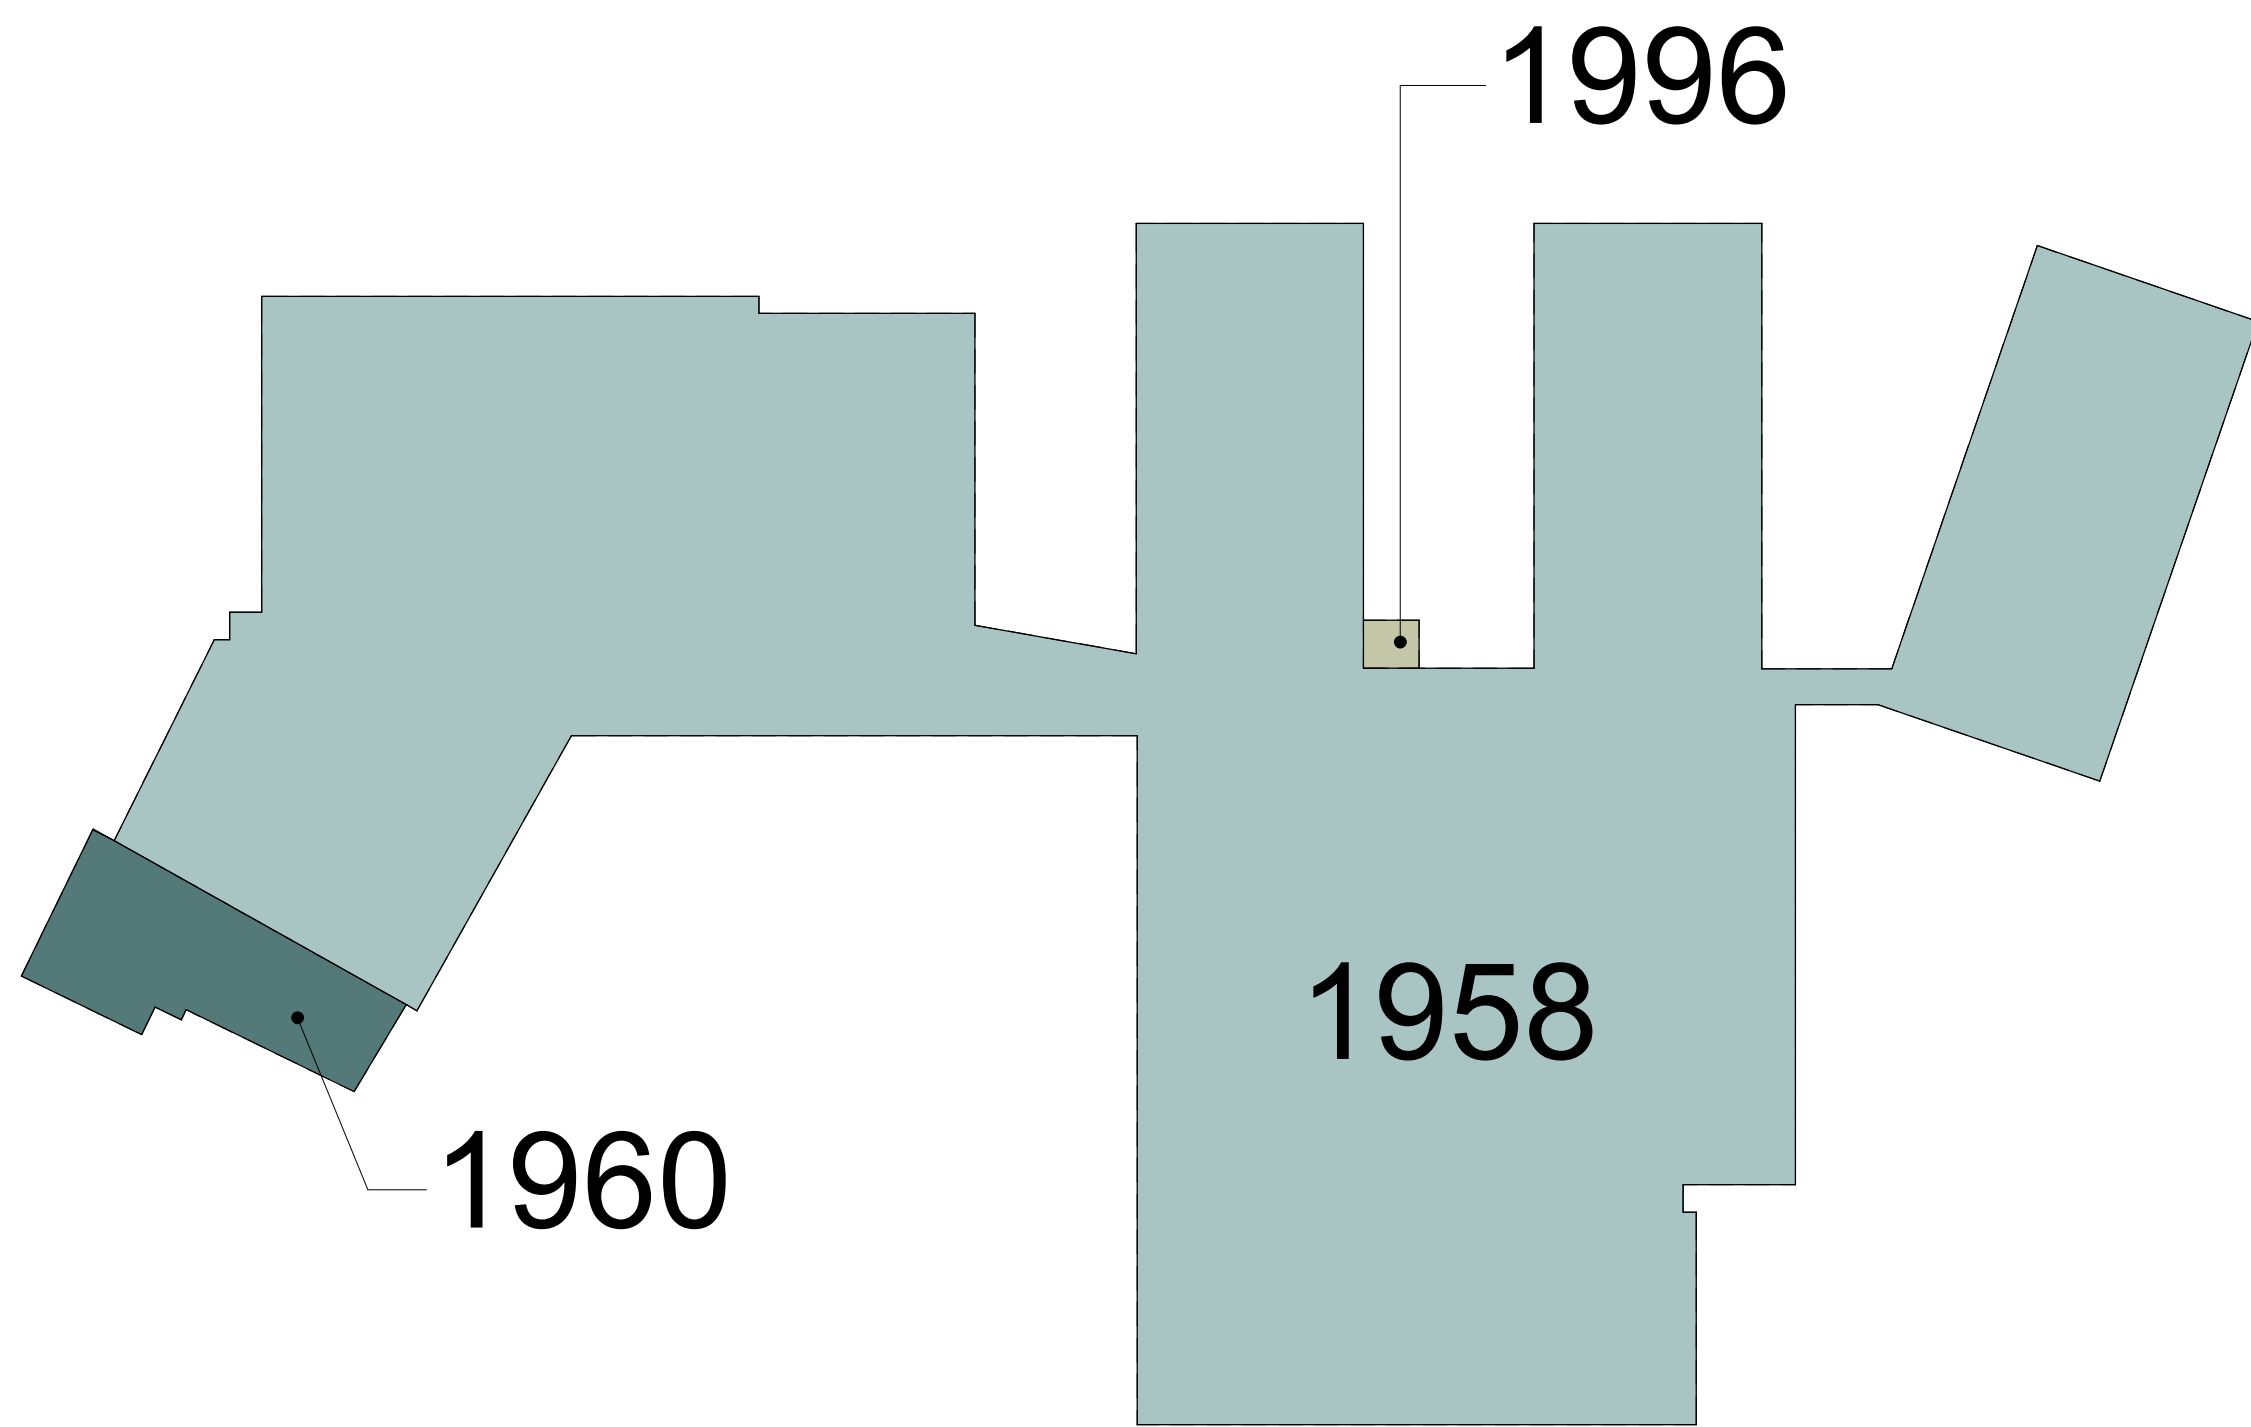

1 AREA 'A' FIRST FLOOR PLAN
LS111 1/16" = 1'-0"

LIFE SAFETY PLAN LEGEND

- PRIMARY EXIT
- SECONDARY EXIT
- RESUE WINDOW (SECONDARY EXIT)
- ACCESSIBLE EXIT
- RESUE ASSISTANCE STATION/AREA OF REFUGE
- NUMBER OF OCCUPANTS PER TABLE 1004.1.2 (ACTUAL NUMBER OF OCCUPANTS)
- REQUIRED EXIT WIDTH FOR DOOR BASED ON (OCCUPANT * 0.2)
- REQUIRED EXIT WIDTH FOR STAIRS BASED ON (OCCUPANT * 0.3)
- EXIT PATH OF TRAVEL (START - END)
- EXIT SIGN, WALL MOUNTED, ILLUMINATED FACE INDICATED BY SHADING, ARROW INDICATES DIRECTIONAL ARROW REQUIRED.
- EXIT SIGN, CEILING MOUNTED, ILLUMINATED FACE INDICATED BY SHADING, ARROW INDICATES DIRECTIONAL ARROW REQUIRED.
- ABBREVIATIONS
 - AED AUTOMATED EXTERNAL DEFIBRILLATOR
 - DF DRINKING FOUNTAIN
 - ESB EMERGENCY EYEWASH STATION
 - FE FIRE EXTINGUISHER, WALL MOUNT
 - FE2 FIRE EXTINGUISHER CABINET

SMOKE SEPARATION NOTES

- SMOKE BARRIER
- CORRIDOR, ENCLOSED WITH SMOKE PARTITIONS - NO COMMINGATING MECHANICAL AIR BETWEEN CORRIDOR AND ADJACENT SPACES.

FIRE SEPARATION LEGEND

- 1 HOUR RATED FIRE PARTITION
- 1 HOUR RATED FIRE BARRIER
- 2 HOUR RATED FIRE BARRIER
- 2 HOUR RATED FIRE WALL

CODE NARRATIVE:
ORIGINAL CONSTRUCTION: 1958
CONSTRUCTION TYPE: IIB
FIRST FLOOR AREA: 121,724 SF GROSS
SECOND FLOOR AREA: 40,814 SF GROSS
ADDITION CONSTRUCTION: 1960
CONSTRUCTION TYPE: IIB
BASEMENT AREA: 2,200 SF GROSS
FIRST FLOOR AREA: 5,400 SF GROSS
ADDITION CONSTRUCTION: 1993
CONSTRUCTION TYPE: IIB
FIRST FLOOR AREA: 300 SF GROSS
SECOND FLOOR AREA: 300 SF GROSS

- CLASSIFICATION OF WORK:
- LEVEL 1 ALTERATION 0 SF
 - LEVEL 2 ALTERATION 1,700 SF


OCCUPANT LOAD

ACCESSORY STORAGE AREA, MECH. ROOM	300 GROSS
ASSEMBLY W/ FIXED SEATS	SEGT. 1004.6
ASSEMBLY W/OUT FIXED SEATS	
CONCENTRATED	7 NET
UNCONCENTRATED	15 NET
BUSINESS AREAS	150 GROSS
CLASSROOM AREAS	20 NET
VOCATIONAL ROOM AREAS	50 NET
LOCKER ROOMS	50 GROSS
EXERCISE ROOMS	50 GROSS
KITCHENS, COMMERCIAL	200 GROSS
READING ROOMS	50 GROSS
STAGES AND PLATFORMS	15 NET

STRUCTURAL LOAD

RISK CATEGORY:	III
DEAD LOADS:	
CONCRETE SLAB	XXX PSF
LIVE LOADS:	
SLAB	XXX PSF
RAIN LOADS:	
15-MINUTE RAINFALL INTENSITY	XXX IN./H
60-MINUTE RAINFALL INTENSITY	XXX IN./H
SNOW LOADS:	
GROUND SNOW LOAD	XX PSF
FLAT ROOF SNOW LOAD	XXX PSF
SLOPED ROOF SNOW LOAD	XXX
WIND LOADS:	
ULTIMATE WIND SPEED	XXX MPH
EXPOSURE CATEGORY	X
SEISMIC DESIGN DATA:	
SITE CLASS	X
SEISMIC DESIGN CATEGORY	X

FIRE AREA MODIFICATIONS (NYS SECTION 506)	
A _a ALLOWABLE AREA PER FLOOR (SQUARE FEET)	
A _t TABULAR ALLOWABLE AREA FACTOR (NYS SECTION 506.3 OR 513D VALUE) IN ACCORDANCE WITH TABLE 506.2 (SQUARE FEET)	
I _f AREA FACTOR INCREASE DUE TO FRONTAGE AS CALCULATED IN ACCORDANCE WITH SECTION 506.3 (PERCENT)	
NS TABULAR ALLOWABLE AREA FACTOR IN ACCORDANCE WITH TABLE 506.2 FOR NONSPRINKLERED BUILDINGS	
S _a ACTUAL NUMBER OF BUILDING STORIES ABOVE GRADE PLANE, NOT TO EXCEED THREE	
W CALCULATED WIDTH OF PUBLIC WAY OR OPEN SPACE (FEET) IN ACCORDANCE WITH SECTION 506.3.2	
L _n LENGTH OF A PORTION OF THE EXTERIOR PERIMETER WALL	
W _n WIDTH (≥ 20 FEET) OF A PUBLIC WAY OR OPEN SPACE ASSOCIATED WITH THAT PORTION OF THE EXTERIOR PERIMETER WALL	
F BUILDING PERIMETER THAT FRONTS ON A PUBLIC WAY OR OPEN SPACE HAVING A WIDTH OF 20 FEET OR MORE	
P PERIMETER OF ENTIRE BUILDING (FEET)	
$I_s = (P/P - 0.25)W/30$ $I_s = [100(XX - 0.25)] XX/30$ $I_s = [0.0XX] 1.00$ $I_s = XX\%$	
$A_a = A_t + (NS \times I_s)$ $A_a = XXX + (XXX \times 0.0XX)$ $A_a = XXX + (XXX)$ $A_a = XXX \text{ sq ft}$	

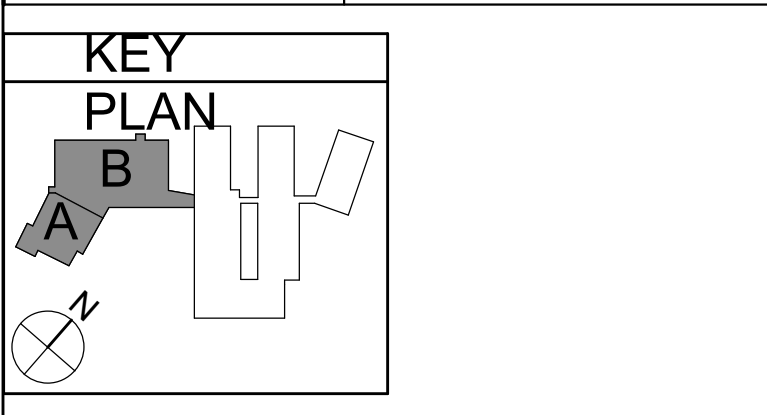

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LIFE SAFETY PLAN | LEGEND

- ## SMOKE SEPARATION NOTES

FIRE SEPARATION LEGEND

- ### OCCUPANT LOAD

STRUCTURAL LOAD

SEISMIC DESIGN CATEGORY	X
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$$I_1 = [0.XX] 1.00$$

KEY




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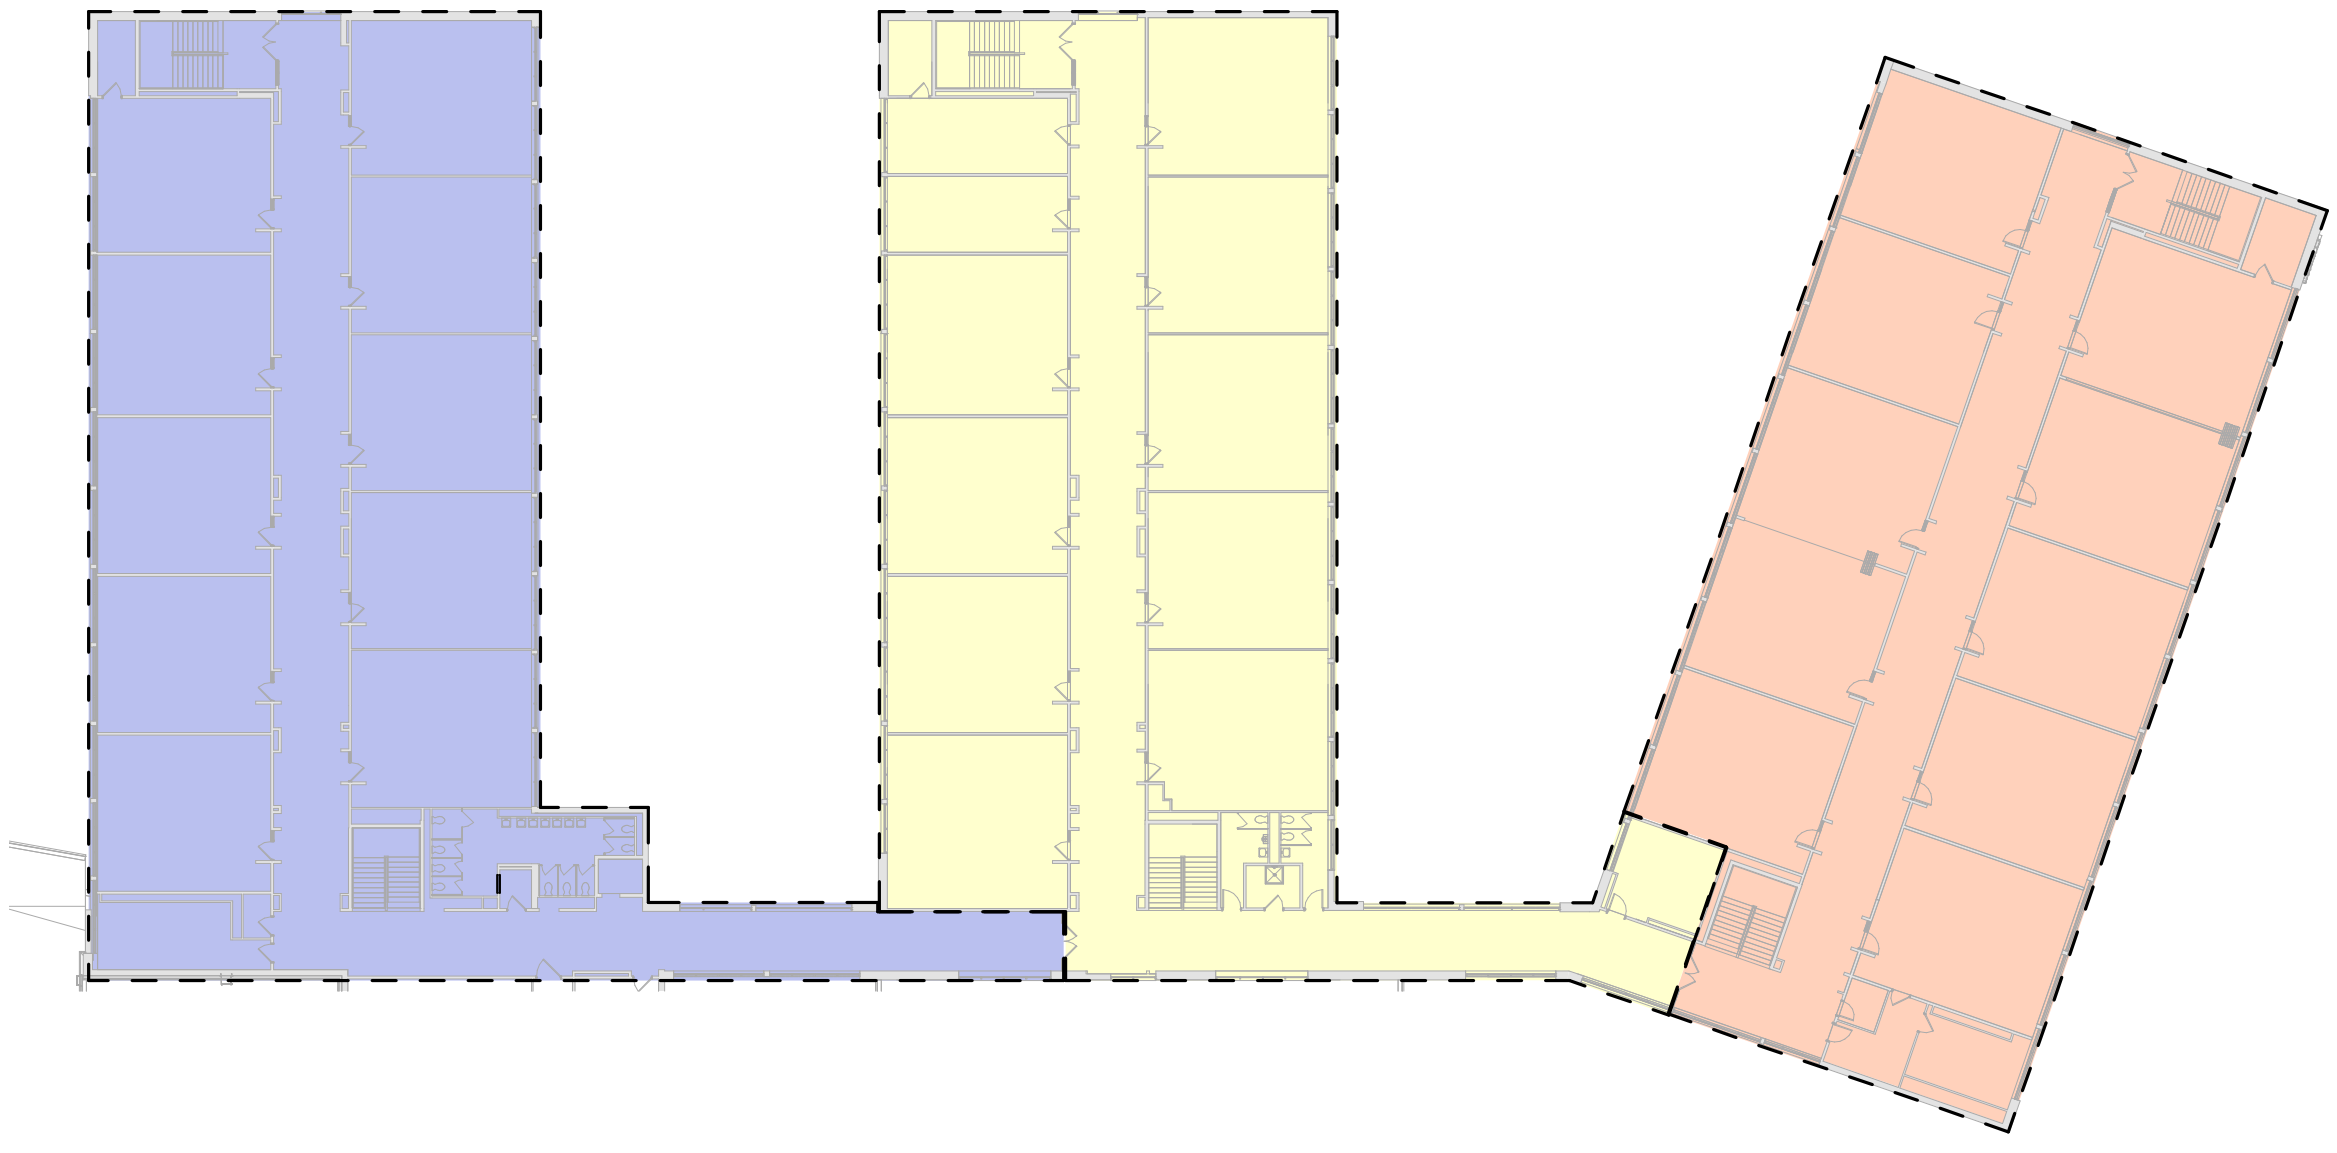
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CONSTRUCTION DOCUMENTS

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1 AREA 'C' FIRST FLOOR PLAN
LS131 1/32" = 1'-0"



2 AREA 'F' SECOND FLOOR PLAN
LS131 1/32" = 1'-0"

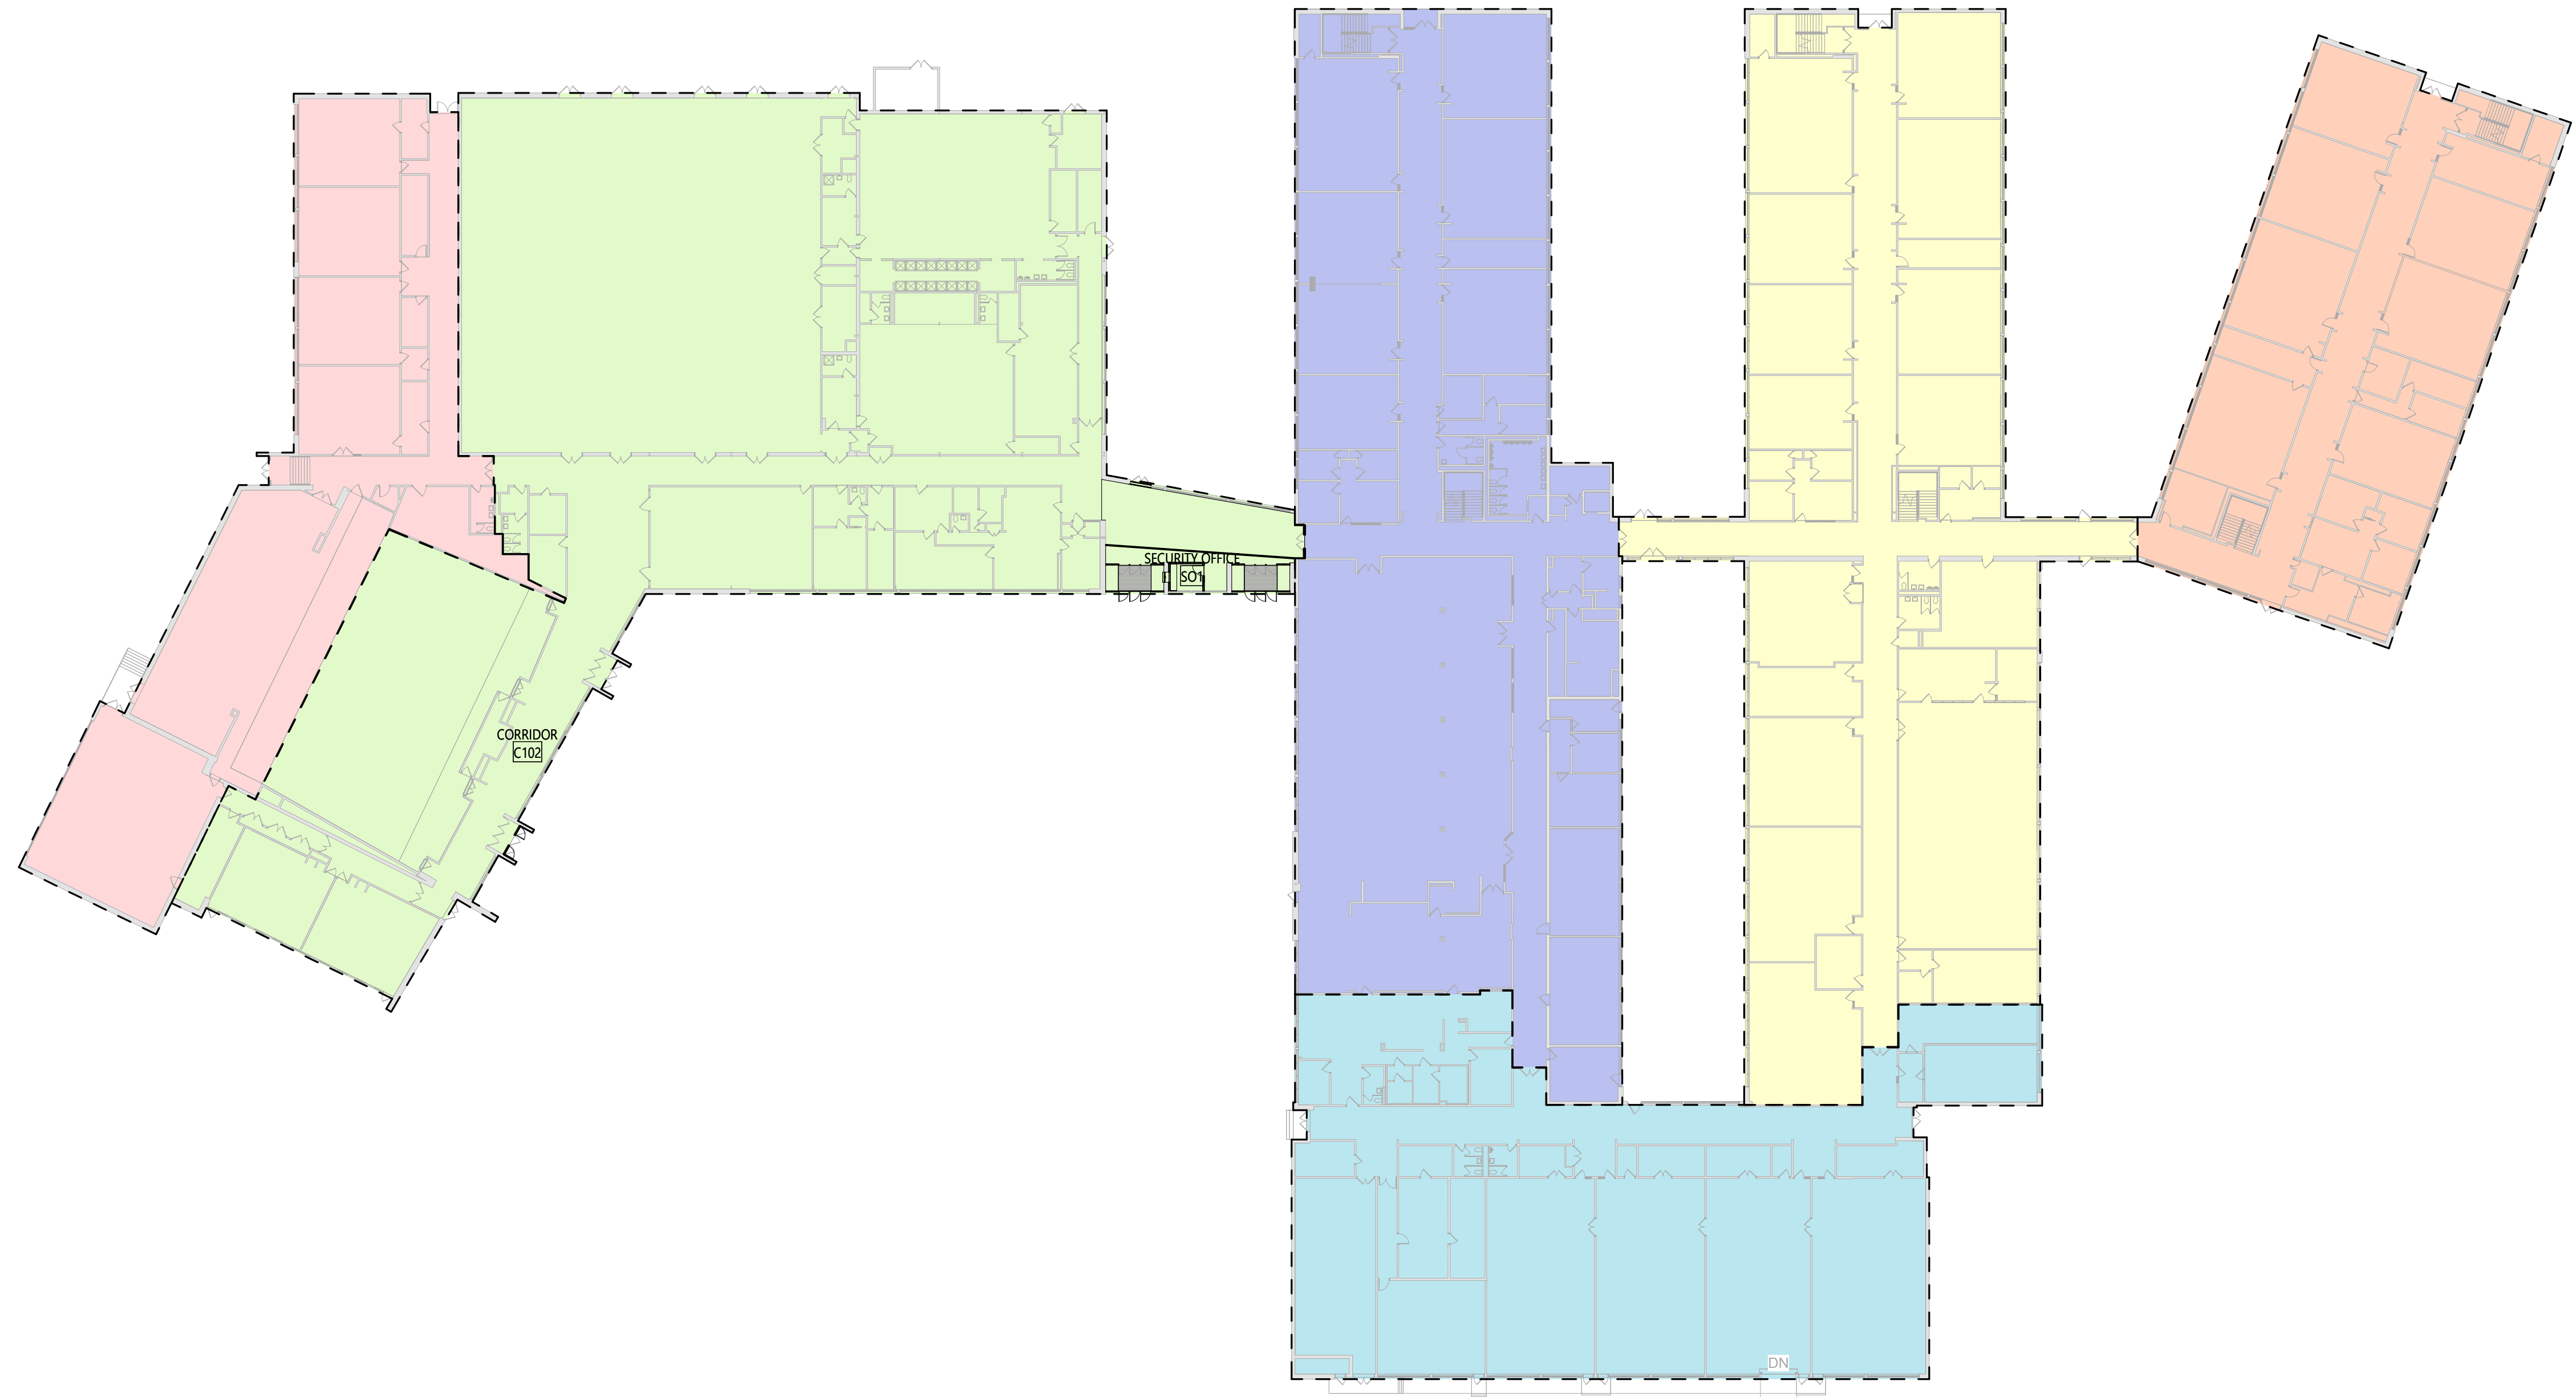
SMOKE ZONE LEGEND

- SMOKE ZONE A
- SMOKE ZONE B
- SMOKE ZONE C
- SMOKE ZONE D
- SMOKE ZONE E
- SMOKE ZONE F

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**CITY SCHOOL DISTRICT OF NEW ROCHELLE
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2023 CAPITAL PROJECTS - PHASE 1**

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Sheet Title
**SMOKE ZONE
PLANS**

Sheet No.
**ALMS
LS131**

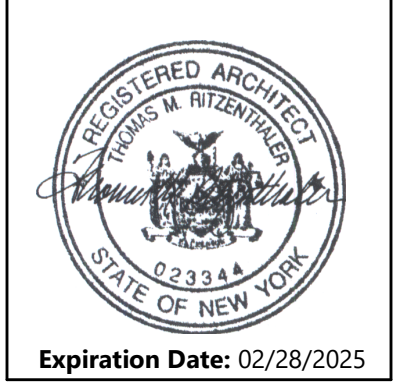1. REFER TO SHEET G001 FOR ADDITIONAL GENERAL NOTES.
2. REFER TO A600 SERIES DRAWINGS FOR ENLARGED PLANS AND ELEVATIONS, ADDITIONAL DIMENSIONS AND DETAILED INFORMATION OF CABINETS, SECURITY PARTITION TYPE AND ADDITIONAL NOTES, LINTEL SCHEDULE AND DETAIL.
3. REFER TO A800 SERIES DRAWINGS FOR ENLARGE RCPS, DETAILS AND NOTES.
4. REFER TO A900 SERIES DRAWINGS FOR DOOR, STOREFRONT, CURTAINWALL, WINDOW AND LOUVER SCHEDULES, DETAILS AND NOTES.

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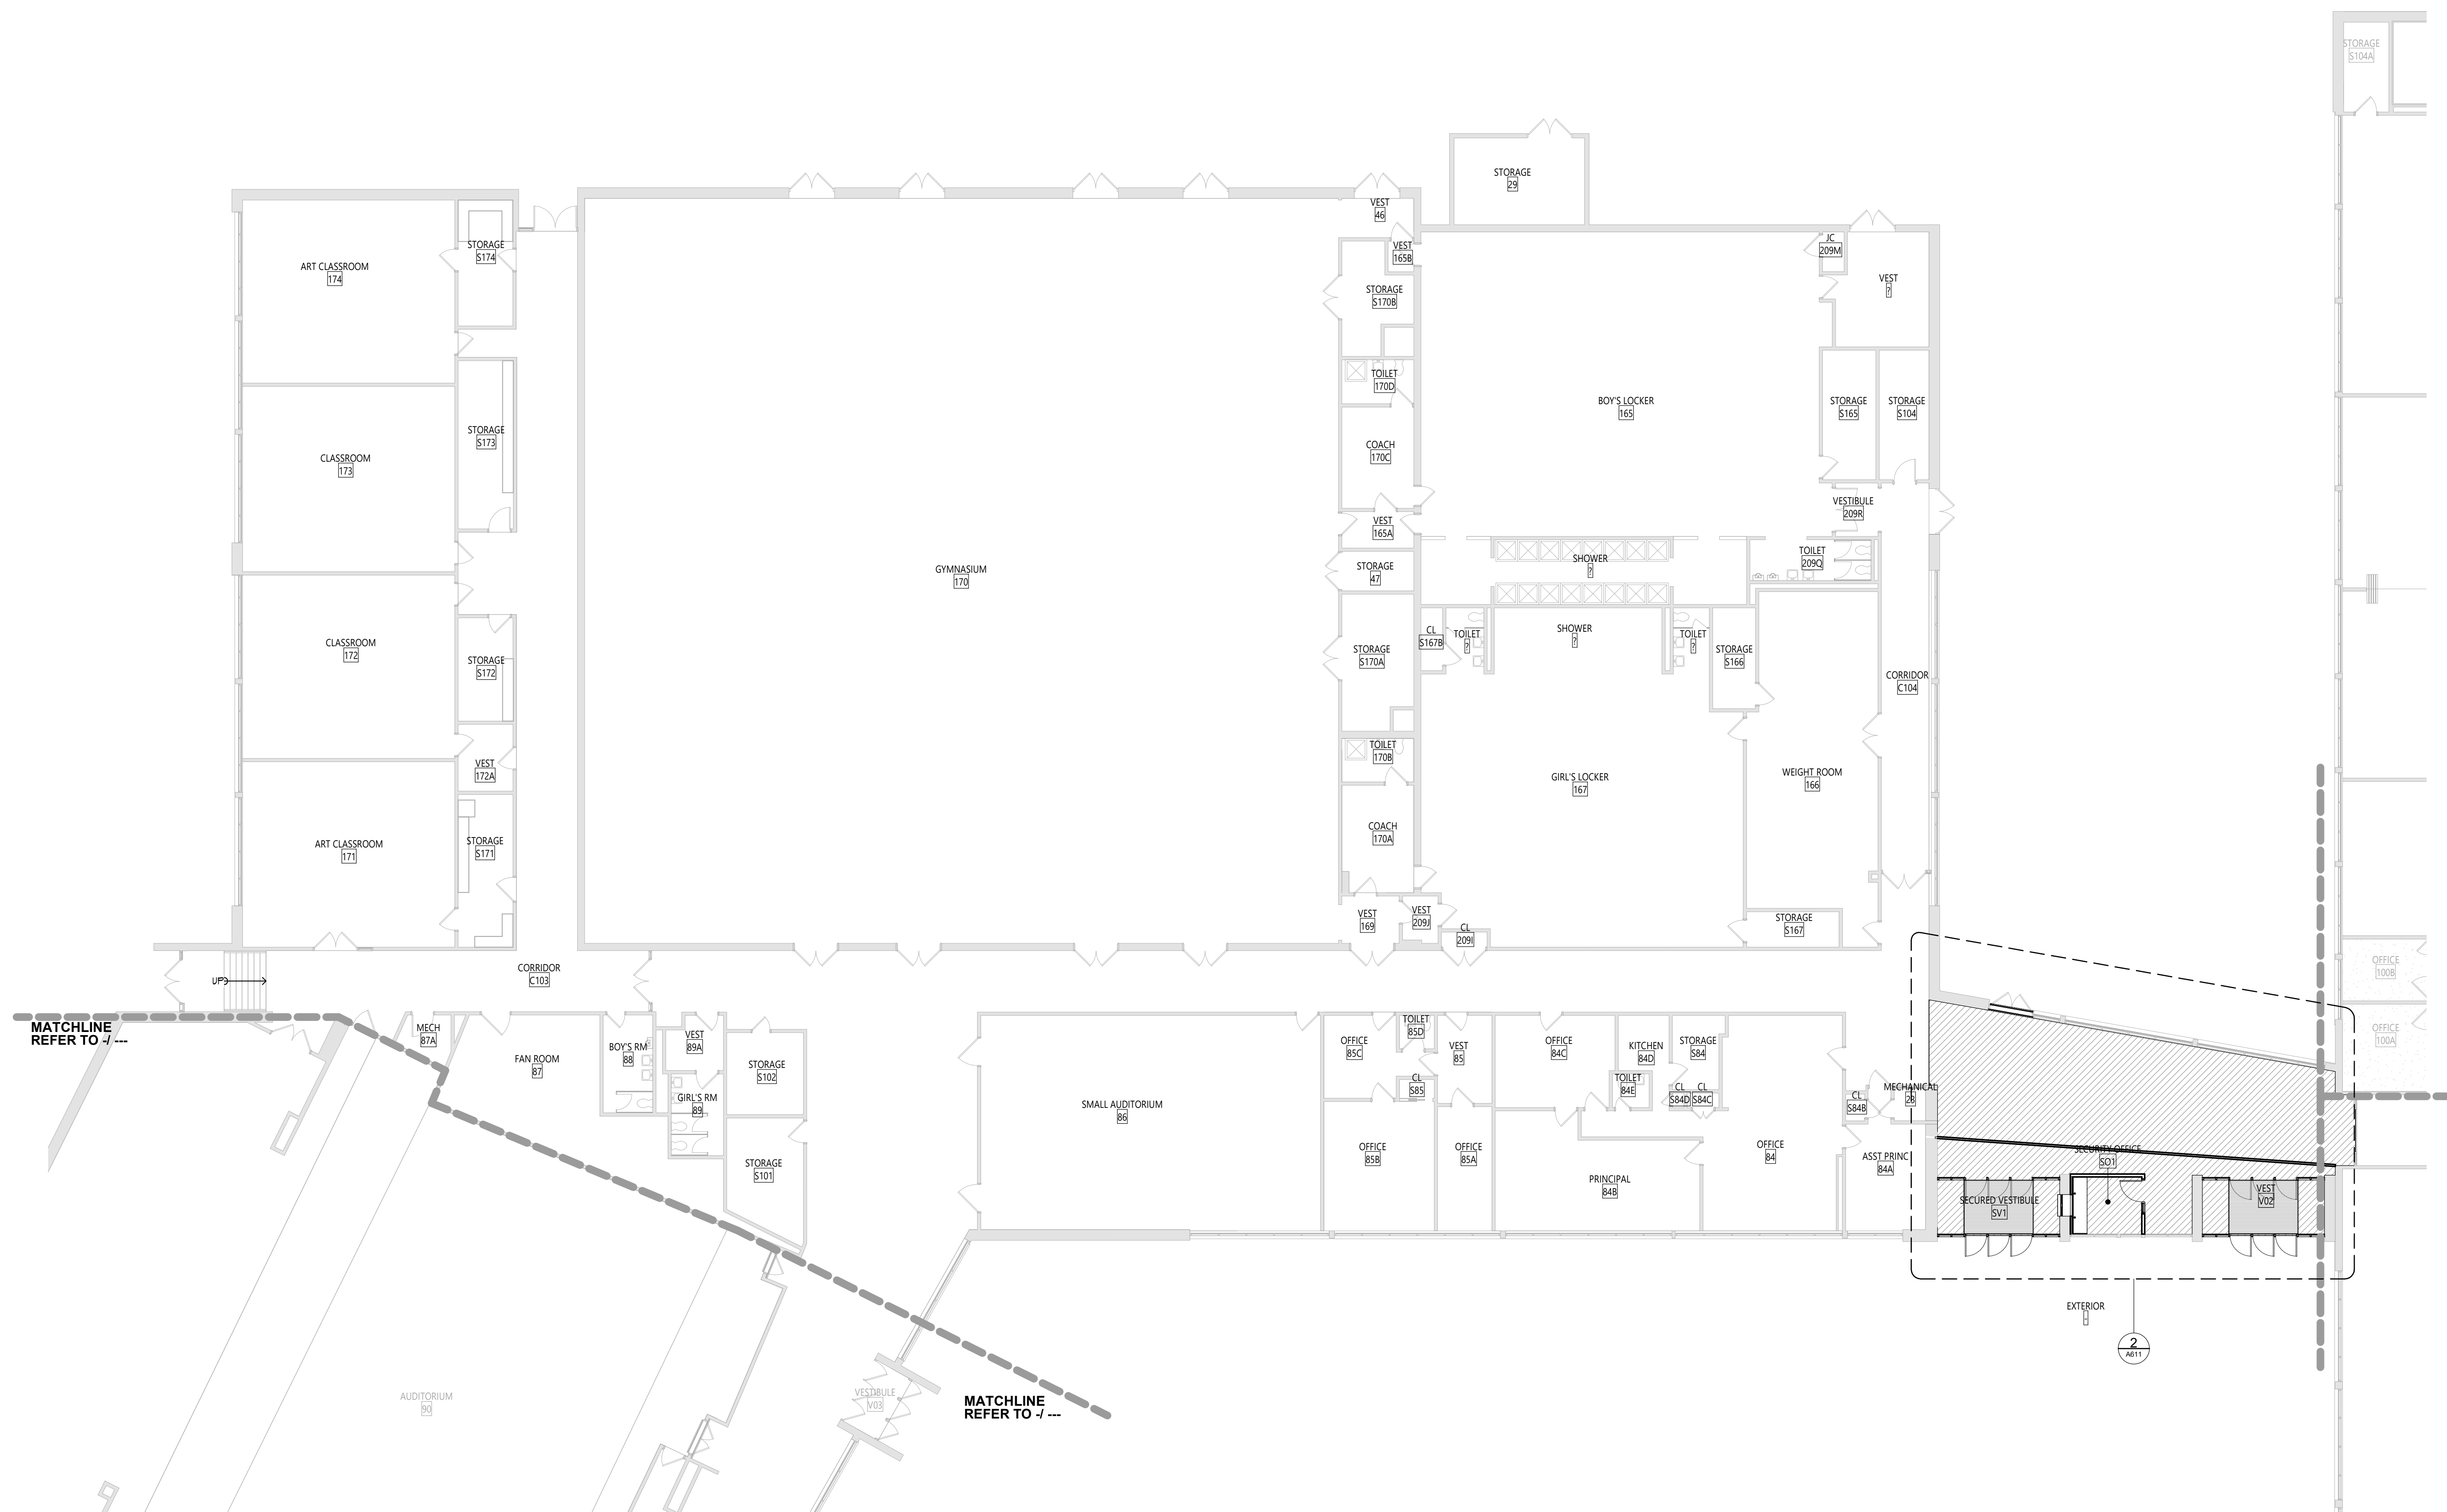
Sheet Title

AREA 'B' -
PARTIAL FIRST
FLOOR PLAN

Sheet No.


ALMS
A112

CONSTRUCTION DOCUMENTS



1 AREA 'B' FIRST FLOOR PLAN

KEY PLAN

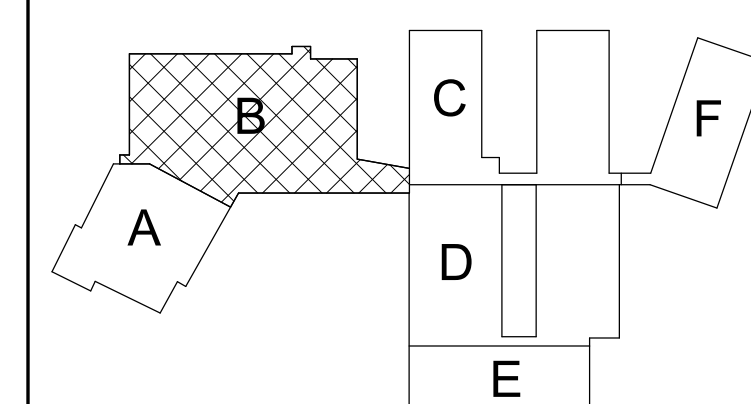

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Sheet No.



CONSTRUCTION DOCUMENTS

1. REFER TO SHEET G001 FOR ADDITIONAL GENERAL NOTES.
2. REFER TO A600 SERIES DRAWINGS FOR ENLARGED PLANS AND ELEVATIONS, ADDITIONAL DIMENSIONS AND DETAILED INFORMATION OF CABINETS, SECURITY PARTITION TYPE AND ADDITIONAL NOTES, LUNEL SCHEDULE AND DETAIL.
3. REFER TO A800 SERIES DRAWINGS FOR ENLARGE RCPS, DETAILS AND NOTES.
4. REFER TO A900 SERIES DRAWINGS FOR DOOR, STOREFRONT, CURTAINWALL, WINDOW AND LOUVER SCHEDULES, DETAILS AND NOTES.

1. ALL CASEWORK SHALL HAVE PLASTIC LAMINATE (PLAM) COUNTERTOPS AND 4" BACK SPLASHES, UNO.
2. INSTALL MATCHING FILLER PANELS IN LOCATIONS SHOWN. ADD MATCHING FILLER PANELS AS REQUIRED FOR FINAL FIT/FINISH.
3. PROVIDE BLOCKING IN ALL ADJACENT WALLS AS REQUIRED TO INSTALL ALL CASEWORK.
4. PROVIDE FINISHED END PANEL AT ALL EXPOSED FACES OF CASEWORK.
5. PROVIDE WALL BASE AS SCHEDULED ON ALL EXPOSED TOE KICK SPACES AND EXPOSED END PANELS.




Diagram illustrating the components of a casework symbol:

- WIDTH OF CASEWORK
- DEPTH OF CASEWORK
- HEIGHT OF CASEWORK
- AWI DESIGN NUMBER (INDICATES ELEVATION LAYOUT ONLY, REFER TO DETAILS AND SPECIFICATIONS FOR CASEWORK CONSTRUCTION REQUIREMENTS)
- TYPE OF CASEWORK
 - PL = PLASTIC LAMINATE
 - M = METAL
 - W = WOOD

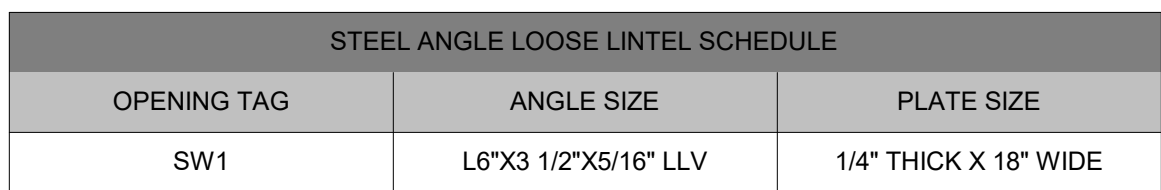
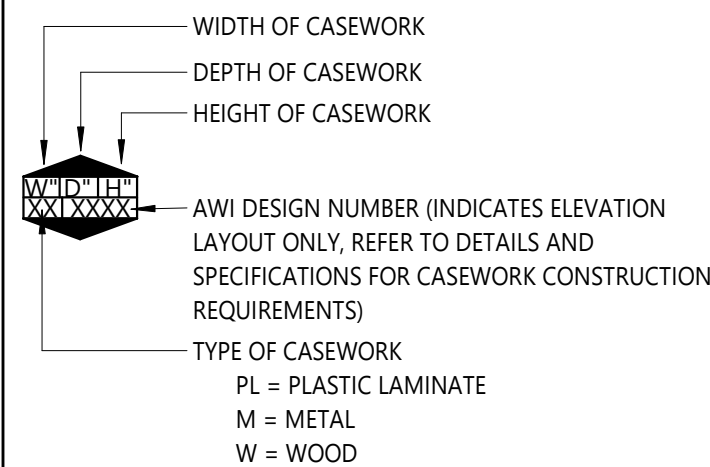


1. BEAR LINTELS 6" MINIMUM EACH END OF OPENING.
2. SEE ARCH DRAWINGS FOR SIZE AND LOCATION OF OPENINGS.
3. THE CONTRACTOR IS RESPONSIBLE FOR DESIGNING, PROVIDING, AND INSTALLING ALL TEMPORARY SHORING THAT IS REQUIRED TO SUPPORT EXISTING STRUCTURE DURING CONSTRUCTION DUE TO THE REMOVALS FOR INSTALLATION OF NEW CONSTRUCTION.

A651 1 1/2" = 1'-0"

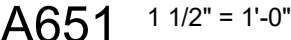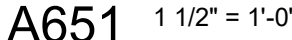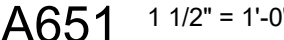

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- ### GENERAL NOTES
1. REFER TO SHEET 0001 FOR ADDITIONAL GENERAL NOTES.
 2. REFER TO A600 SERIES DRAWINGS FOR ENLARGED PLANS AND ELEVATIONS, ADDITIONAL DIMENSIONS AND DETAILED INFORMATION OF CABINETS, SECURITY PARTITION TYPE AND ADDITIONAL NOTES, UNITS, SCHEDULE AND DETAIL.
 3. REFER TO A800 SERIES DRAWINGS FOR ENLARGE RCPS, DETAILS AND NOTES.
 4. REFER TO A900 SERIES DRAWINGS FOR DOOR, STOREFRONT, CURTAINWALL, WINDOW AND LOUVER SCHEDULES, DETAILS AND NOTES.

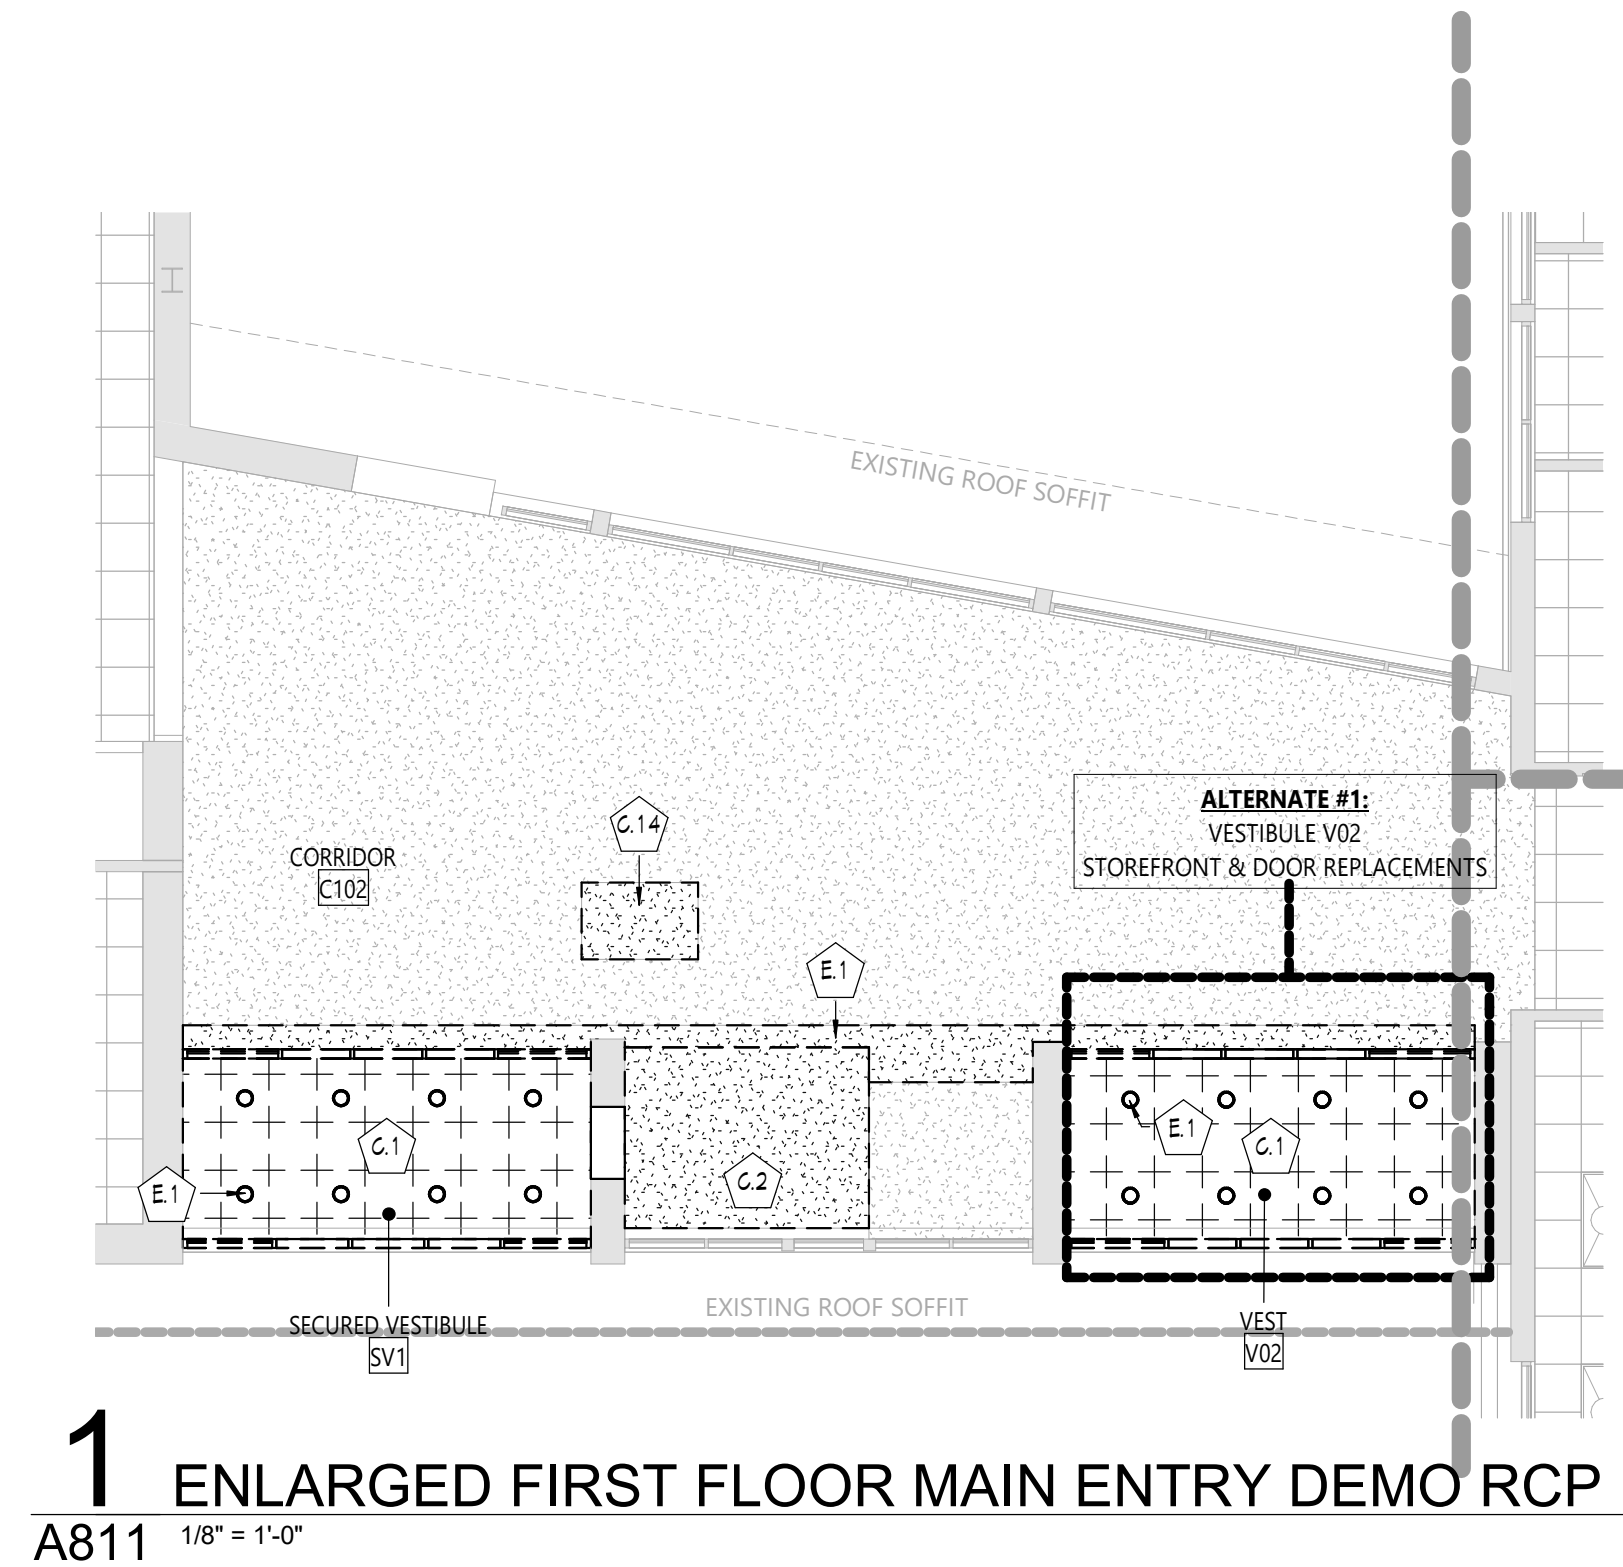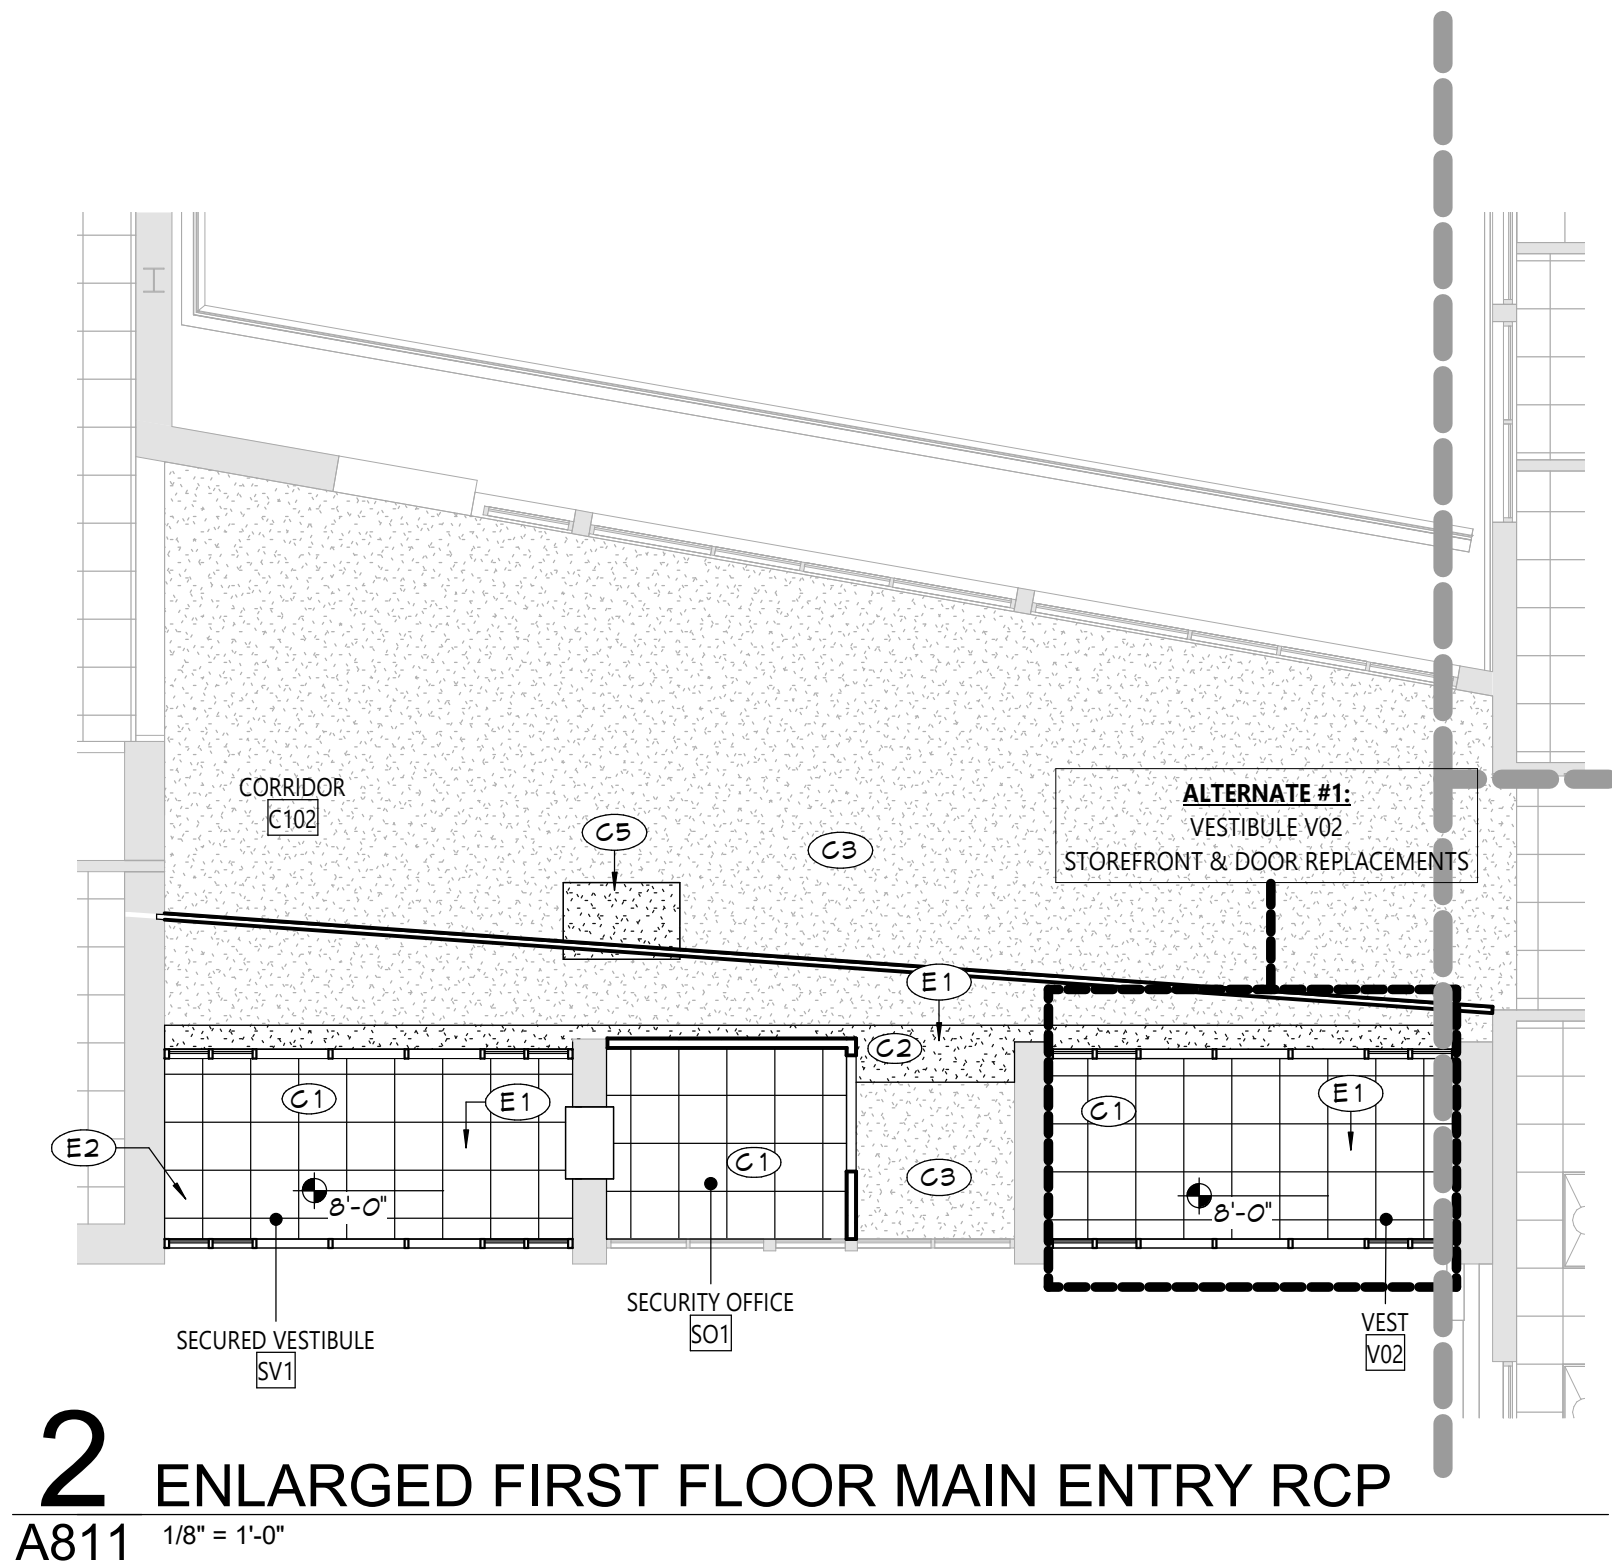- ### GENERAL DEMOLITION NOTES
1. COORDINATE ALL REMOVALS WITH NEW CONSTRUCTION.
 2. PATCH AND REPLACE EXISTING AND NEWLY CREATED HOLES IN WALLS (DUE TO REMOVAL) WITH MATERIALS TO MATCH EXISTING CONSTRUCTION.
 3. SALVAGED ITEMS SHALL BE TURNED OVER TO OWNER, UNO.
 4. ALL KEYED REMOVALS SHALL INCLUDE REMOVAL OF ANY AND ALL ANCHORING SYSTEMS INCLUDING OBJECTS EMBEDDED INTO EXISTING WALLS.
 5. REFER TO MEP DRAWINGS FOR ADDITIONAL REMOVAL INFORMATION.
 6. PROVIDE TEMPORARY SHORING AS NECESSARY AT ALL AREAS OF WALL REMOVAL AND NEW WALL PENETRATIONS.
 7. DRILL CORNERS OF ALL NEW SAWCUT OPENING PRIOR TO SAWCUTTING, TO PREVENT CUTTING INTO SCHEDULED CONSTRUCTION TO REMAIN.

- ### CEILING NEW WORK
- #### NOTES
1. INSTALL CEILING GRIDS IN THE ROOM, UNO, IN ROOMS OTHER THAN RECTANGULAR SHAPED, INSTALL GRIDS CENTERED ON WALLS OR OTHER BUILT FEATURES AS INDICATED.
 2. INSTALLATION HEIGHTS OF THE CEILINGS MAY VARY SLIGHTLY FROM PLANS IN ROOMS WITH EXTERIOR WINDOWS. ACTUAL CEILING HEIGHT TO BE VERIFIED IN THE FIELD.
 3. FINAL INSTALLED CEILINGS SHALL HAVE HEIGHTS COORDINATED WITH OTHER CONTRACTORS WITH ABOVE CEILING WORK AND VERIFIED WITH FIELD CONDITIONS. ALL CHANGES IN CONFIGURATION OR HEIGHTS ARE TO BE APPROVED BY THE ARCHITECT.
 4. PROTECT EXISTING SECURITY CAMERAS THROUGHOUT ALL AREAS OF CEILING REPLACEMENT, UNLESS NOTED OTHERWISE.

- ### CEILING LEGEND
- GWB OR SUSPENDED ACOUSTICAL PANEL CEILING SYSTEM
- CEILING HEIGHT ABOVE FINISHED FLOOR

- ### ELECTRICAL EQUIPMENT
- REFER TO ELECTRICAL DRAWINGS FOR ADDITIONAL INFORMATION.
- 2'x4' LIGHT FIXTURE
 - 2'x2' LIGHT FIXTURE
 - 1'x1' LIGHT FIXTURE
 - PENDANT LIGHT FIXTURE
 - RECESSED DOWN LIGHT
 - CEILING MOUNTED EXIT SIGN
 - CEILING MOUNTED OCCUPANCY SENSOR
 - CEILING MOUNTED SMOKE DETECTOR
 - CEILING MOUNTED HEAT DETECTOR
 - CEILING MOUNTED PA SPEAKER
 - CEILING MOUNTED SECURITY J-BOX
 - CEILING MOUNTED MOTION SENSOR
 - CEILING MOUNTED DATA J-BOX

- ### MECHANICAL EQUIPMENT
- REFER TO MECHANICAL DRAWINGS FOR ADDITIONAL INFORMATION.
- HVAC SUPPLY GRILLE
 - HVAC RETURN GRILLE


KEYNOTES

#	DESCRIPTION
C1	24"x24" ACOUSTIC PANELS AND SUSPENSION SYSTEM.
C2	PATCH, REPAIR, AND PAINT EXISTING GWB CEILING SYSTEM AS NEEDED TO FACILITATE NEW PARTITION CONSTRUCTION. FINISHES TO MATCH ADJACENT CEILING.
C3	PREP AND PAINT EXISTING CEILING SYSTEM IN ITS ENTIRETY.
C5	PROVIDE GWB CEILING ON METAL STUD FRAMING.
C1	REMOVE EXISTING SUSPENDED CEILING SYSTEM IN ITS ENTIRETY, INCLUDING ALL HANGERS AND FASTENERS. REFER TO ELECTRICAL AND MECHANICAL DRAWINGS FOR EQUIPMENT REMOVALS.
C2	REMOVE EXISTING PLASTER CEILING SYSTEM IN ITS ENTIRETY, INCLUDING ALL FRAMING AND FASTENERS. REFER TO ELECTRICAL AND MECHANICAL DRAWINGS FOR EQUIPMENT REMOVALS.
C14	REMOVE PORTION OF EXISTING PLASTER AND/OR GWB CEILING SYSTEM INCLUDING ALL FRAMING. COORDINATE WITH M DRAWINGS FOR OTHER REMOVALS.
E1	LIGHT FIXTURE INSTALLATION, TYPICAL REFER TO 'E' DRAWINGS.
E2	ELECTRICAL INSTALLATION, TYPICAL REFER TO 'E' DRAWINGS.
E1	LIGHT FIXTURE REMOVAL, REFER TO 'E' DRAWINGS AND ABATEMENT DRAWINGS AND REPORT.
M1	MECHANICAL INSTALLATION, TYPICAL REFER TO 'M' DRAWINGS.

KEY PLAN

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CITY SCHOOL DISTRICT OF NEW ROCHELLE
ALBERT LEONARD MIDDLE SCHOOL
2023 CAPITAL PROJECTS - PHASE 1

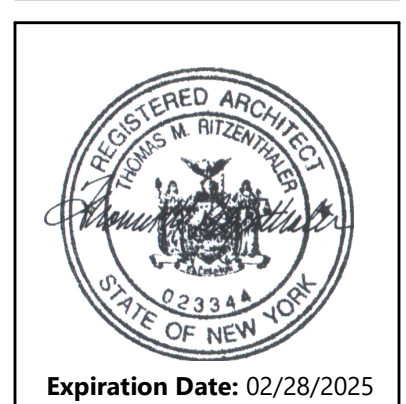


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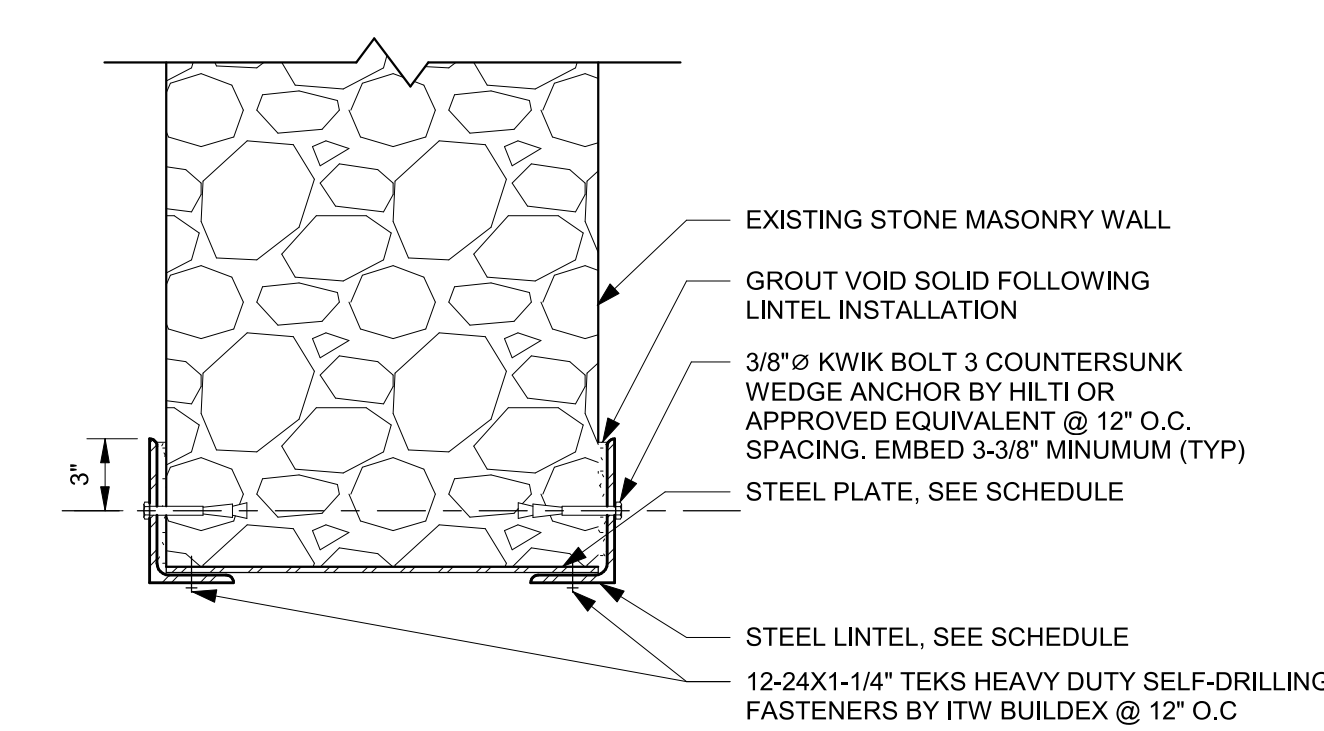
Sheet Title
ENLARGED
NEW WORK
AND DEMO
REFLECTED
CEILING PLANS

Sheet No.
ALMS
A811
CONSTRUCTION DOCUMENTS



A900 DOOR-TYPES

1/4" = 1'-0"

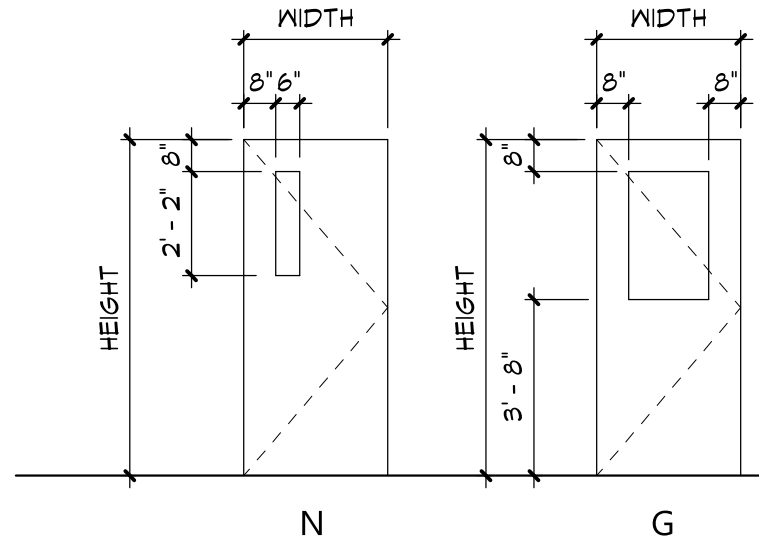


STEEL ANGLE LOOSE LINTEL SCHEDULE		
OPENING TAG	ANGLE SIZE	PLATE SIZE
SW 1	(2) L6X3 1/2X5/16" LLV	1/2" THICK X 18" WIDE

- NOTES:
- BEAR LINTELS 6" MINIMUM EACH END OF OPENING. GROUT TO PROVIDE, SOLID, LEVEL BEARING SURFACE.
 - SEE ARCH DRAWINGS FOR SIZE AND LOCATION OF OPENINGS.
 - THE CONTRACTOR IS RESPONSIBLE FOR DESIGNING, PROVIDING, AND INSTALLING ALL TEMPORARY SHORING THAT IS REQUIRED TO SUPPORT EXISTING STRUCTURE DURING CONSTRUCTION DUE TO THE REMOVALS FOR INSTALLATION OF NEW CONSTRUCTION.


12 LINTEL SCHEDULE

A900 1 1/2" = 1'-0"

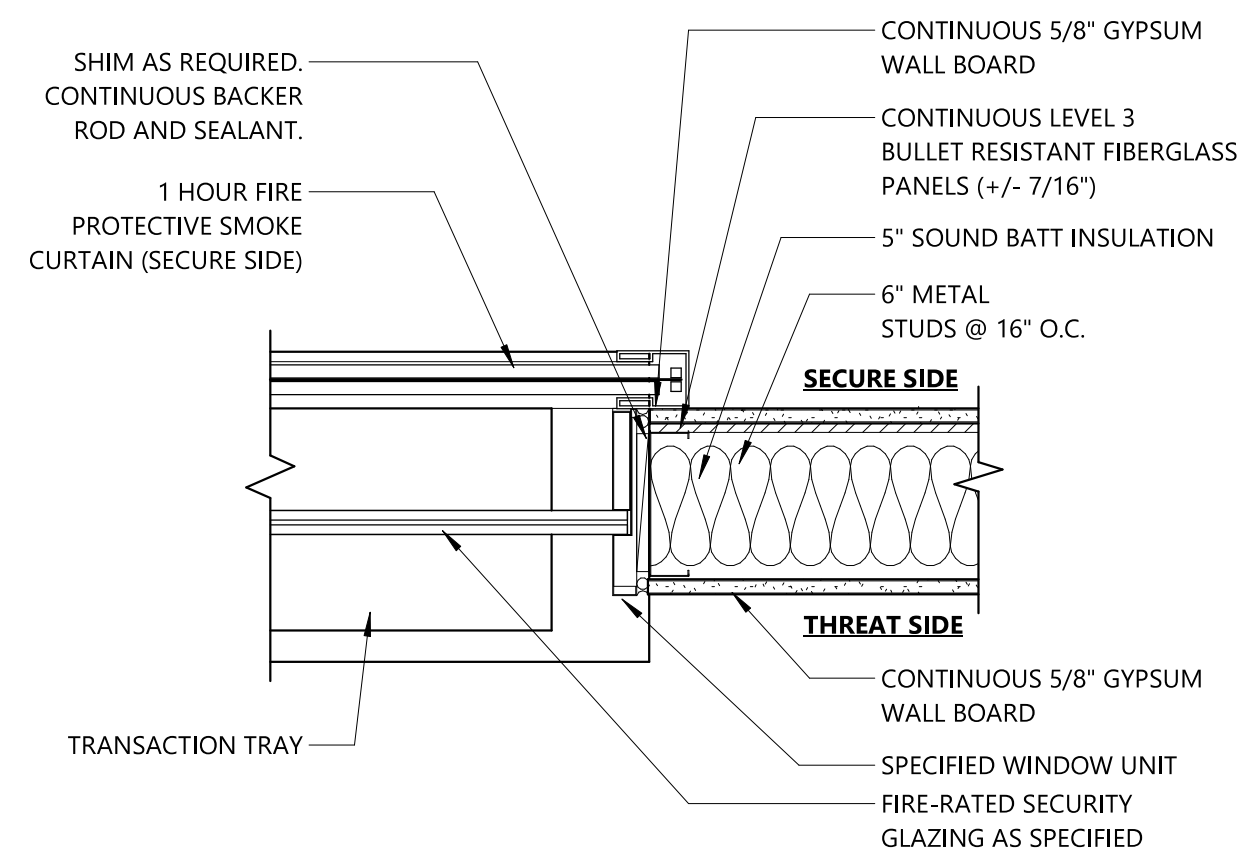


11 JAMB DETAIL - SECURITY WINDOW

A900 1 1/2" = 1'-0"

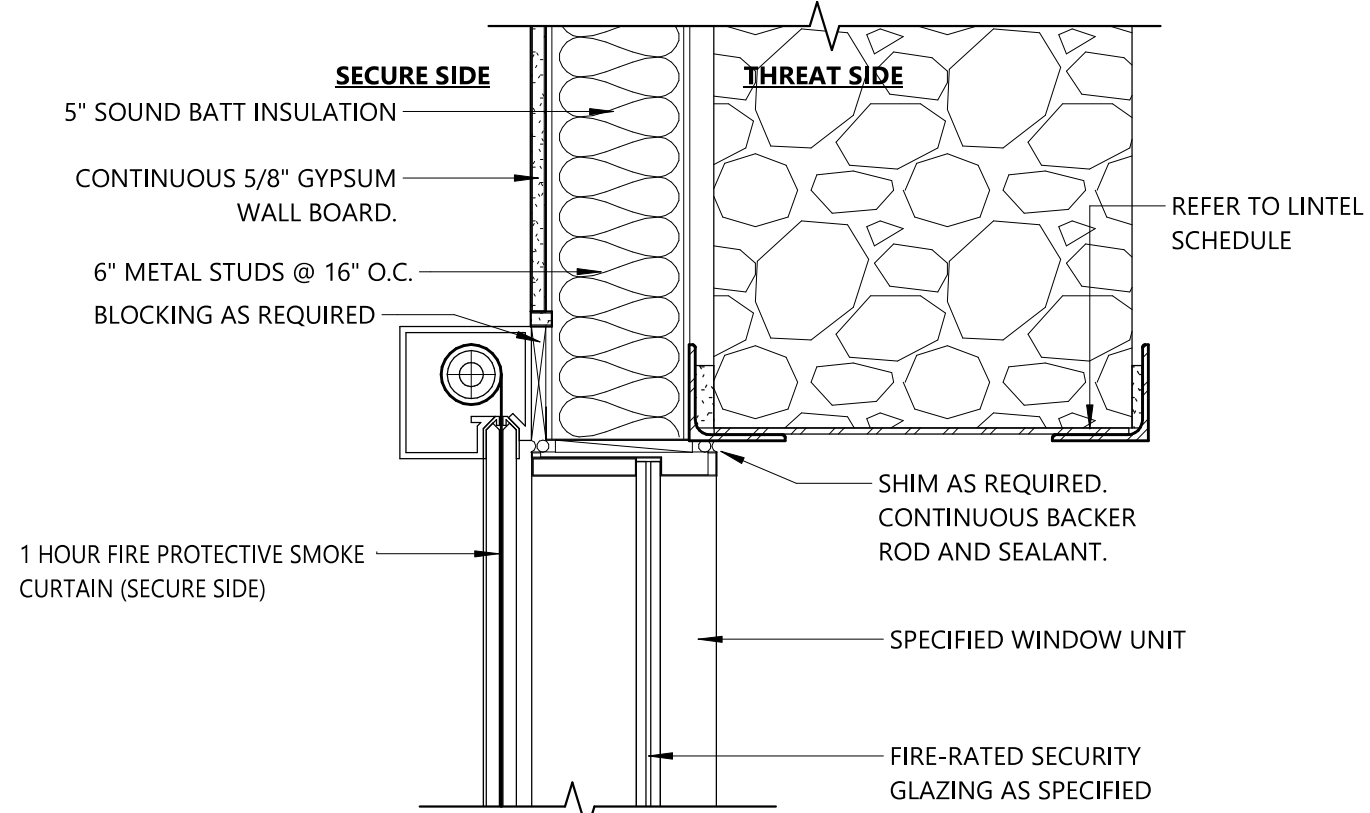

10 HEAD DETAIL - SECURITY WINDOW

A900 1 1/2" = 1'-0"

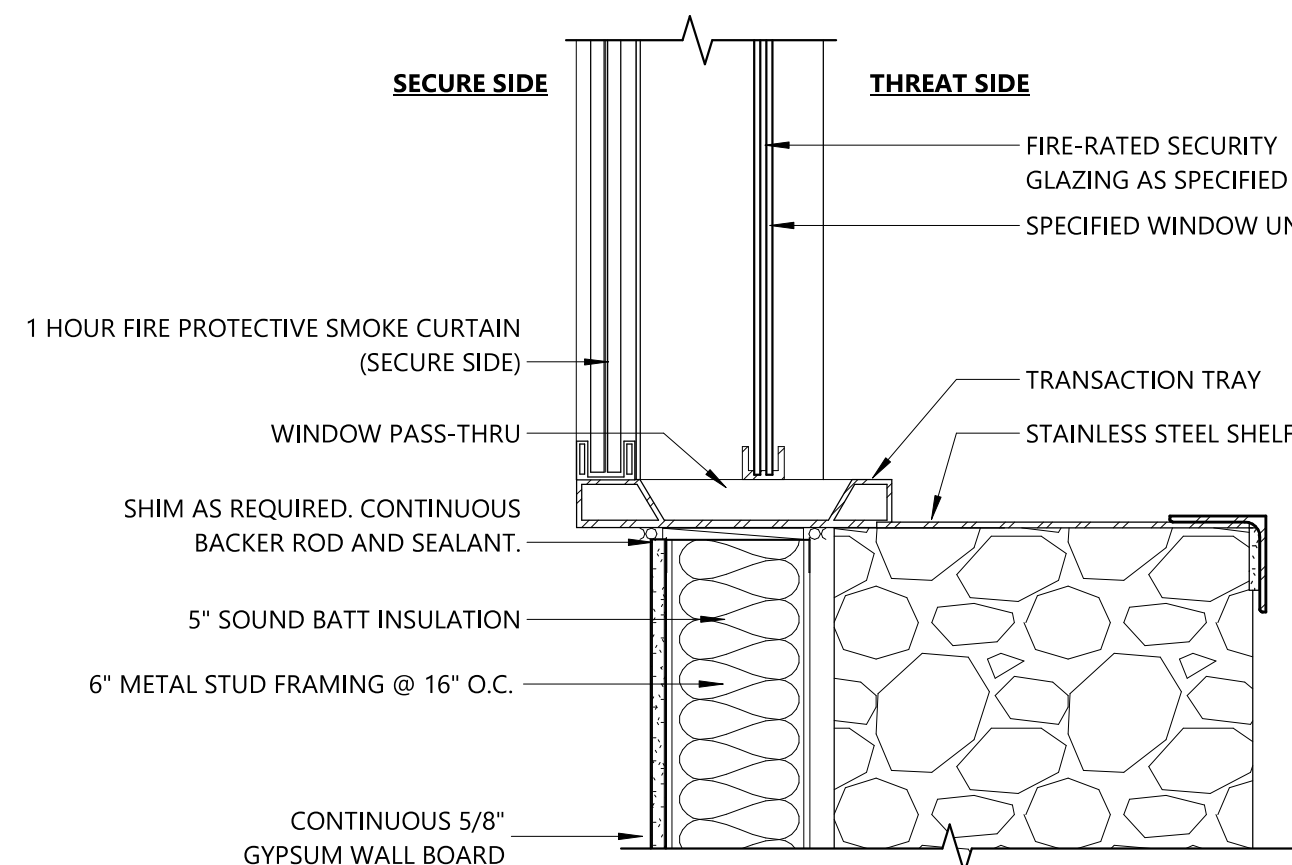


9 SILL DETAIL - SECURITY WINDOW

A900 1 1/2" = 1'-0"


DOOR SCHEDULE																							
DOOR NUMBER	DOOR												FRAME										
	FROM			TO		WIDTH	HEIGHT	THICKNESS	TYPE	MATERIAL	FINISH	TYPE	MATERIAL	FINISH	HEAD DETAIL	JAMB DETAIL	SILL DETAIL	LABEL (MIN)	GLAZING	HARDWARE	MAG HOLD-OPEN	ACCESS CONTROL	DOOR NUMBER
S01	C102	CORRIDOR		S01	SECURITY OFFICE	3'-0"	7'-0"	1 3/4"	N	WD	PT	1	HM	PT	3/A900	2/A900	4/A900	20	FR		*	YES	S01
SV1A	SV1	SECURED VESTIBULE			EXTERIOR	3'-0"	7'-0"	1 3/4"	G	FRP	FF		AL	FF	3/A900	2/A900	4/A900	*	SG		*	YES	SV1A
SV1B	SV1	SECURED VESTIBULE			EXTERIOR	3'-0"	7'-0"	1 3/4"	G	FRP	FF		AL	FF	3/A900	2/A900	4/A900	*	SG		*	YES	SV1B
SV1C	SV1	SECURED VESTIBULE			EXTERIOR	3'-0"	7'-0"	1 3/4"	G	FRP	FF		AL	FF	3/A900	2/A900	4/A900	*	SG		*	YES	SV1C
SV1D	C102	CORRIDOR		SV1	SECURED VESTIBULE	3'-0"	7'-0"	1 3/4"	G	FRP	FF		AL	FF	3/A900	2/A900	4/A900	*	SG		*	YES	SV1D
SV1E	C102	CORRIDOR		SV1	SECURED VESTIBULE	3'-0"	7'-0"	1 3/4"	G	FRP	FF		AL	FF	3/A900	2/A900	4/A900	*	SG		*	YES	SV1E
SV1F	C102	CORRIDOR		SV1	SECURED VESTIBULE	3'-0"	7'-0"	1 3/4"	G	FRP	FF		AL	FF	3/A900	2/A900	4/A900	*	SG		*	YES	SV1F
V02A	V02	VEST			EXTERIOR	3'-0"	7'-0"	1 3/4"	G	FRP	FF		AL	FF	3/A900	2/A900	4/A900	*	SG		*	YES	V02A
V02B	V02	VEST			EXTERIOR	3'-0"	7'-0"	1 3/4"	G	FRP	FF		AL	FF	3/A900	2/A900	4/A900	*	SG		*	YES	V02B
V02C	V02	VEST			EXTERIOR	3'-0"	7'-0"	1 3/4"	G	FRP	FF		AL	FF	3/A900	2/A900	4/A900	*	SG		*	YES	V02C
V02D	C102	CORRIDOR		V02	VEST	3'-0"	7'-0"	1 3/4"	G	FRP	FF		AL	FF	3/A900	2/A900	4/A900	*	SG		*	YES	V02D
V02E	C102	CORRIDOR		V02	VEST	3'-0"	7'-0"	1 3/4"	G	FRP	FF		AL	FF	3/A900	2/A900	4/A900	*	SG		*	YES	V02E
V02F	C102	CORRIDOR		V02	VEST	3'-0"	7'-0"	1 3/4"	G	FRP	FF		AL	FF	3/A900	2/A900	4/A900	*	SG		*	YES	V02F

Grand total: 13

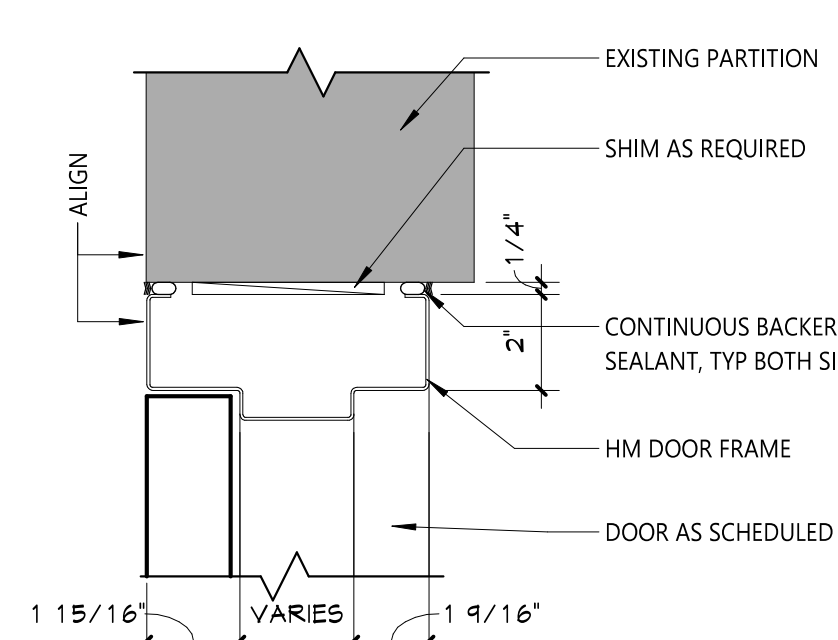


8 HEAD DETAIL

A900 3" = 1'-0"

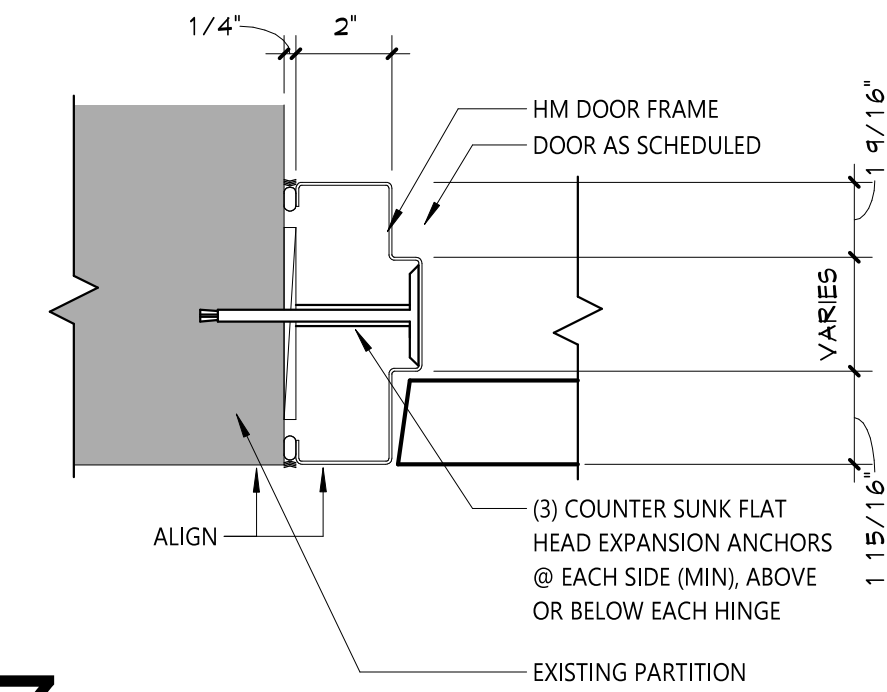


7 JAMB DETAIL

A900 3" = 1'-0"

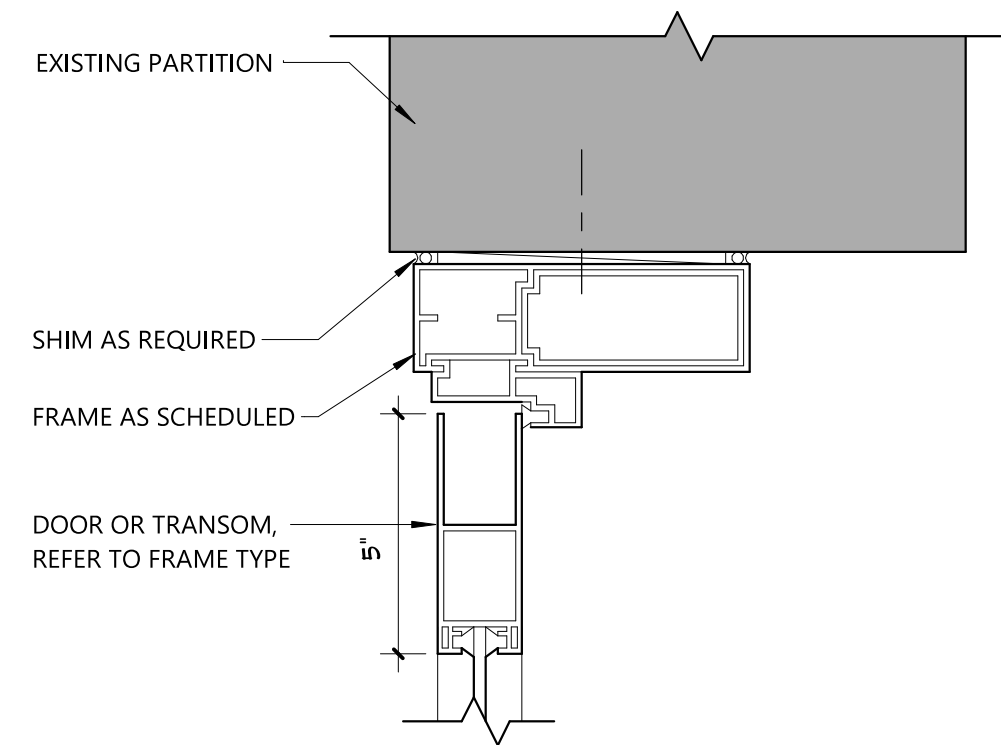


6 HEAD DETAIL

A900 3" = 1'-0"

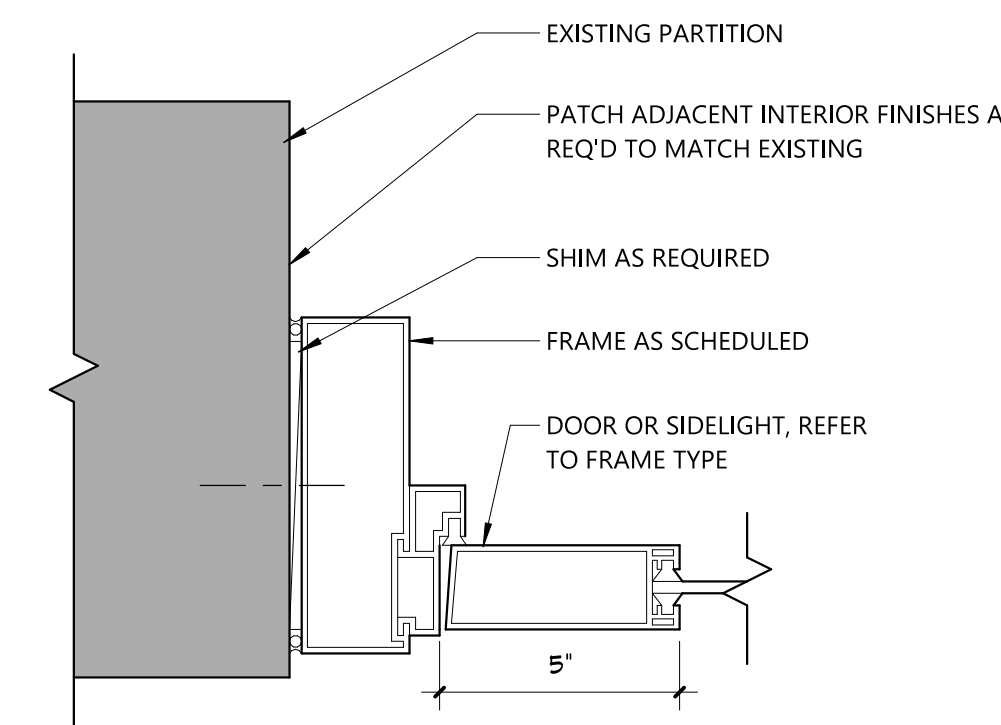


5 JAMB DETAIL

A900 3" = 1'-0"

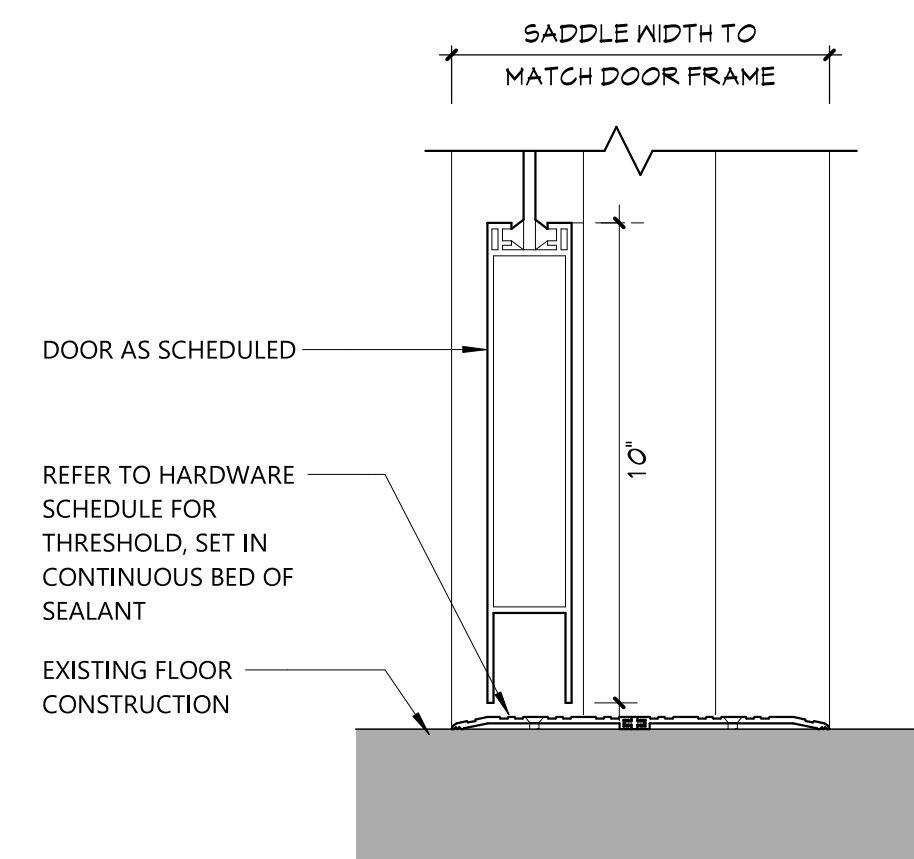


4 SILL DETAIL

A900 3" = 1'-0"

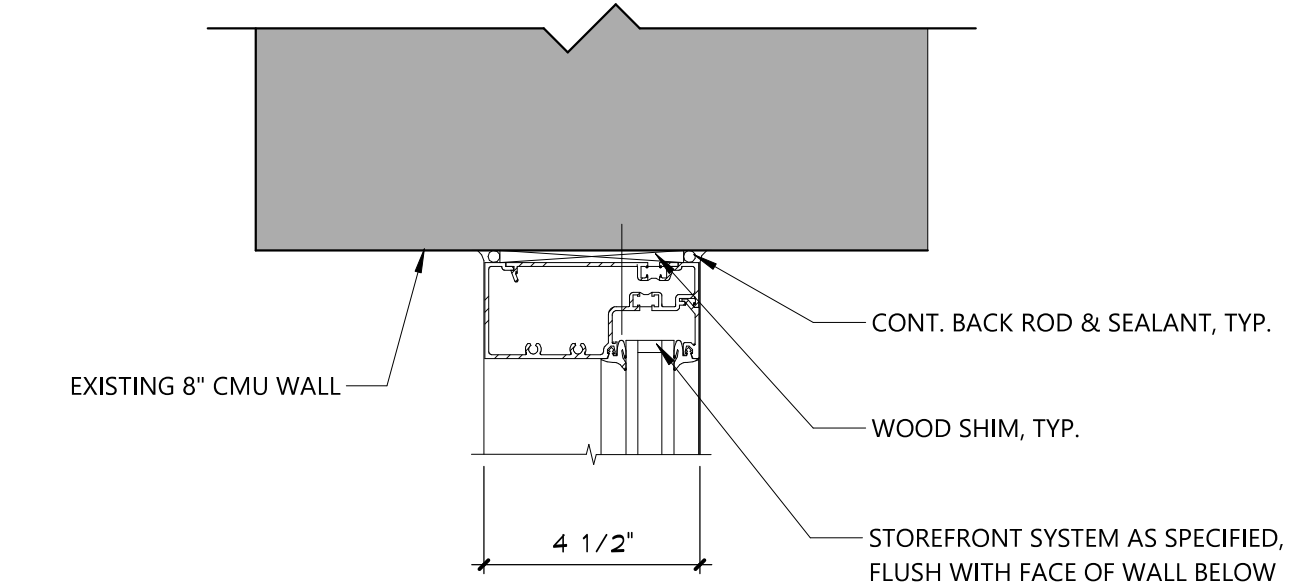


3 HEAD DETAIL

A900 3" = 1'-0"

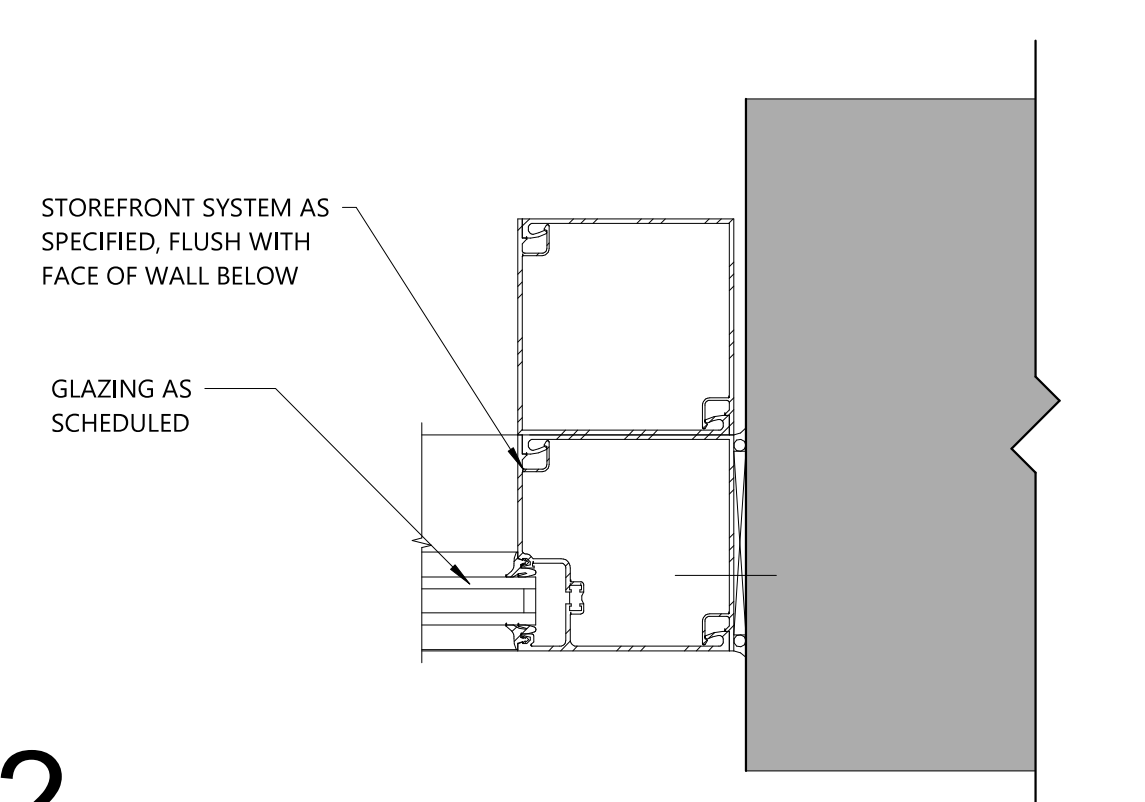

2 JAMB DETAIL

A900 3" = 1'-0"

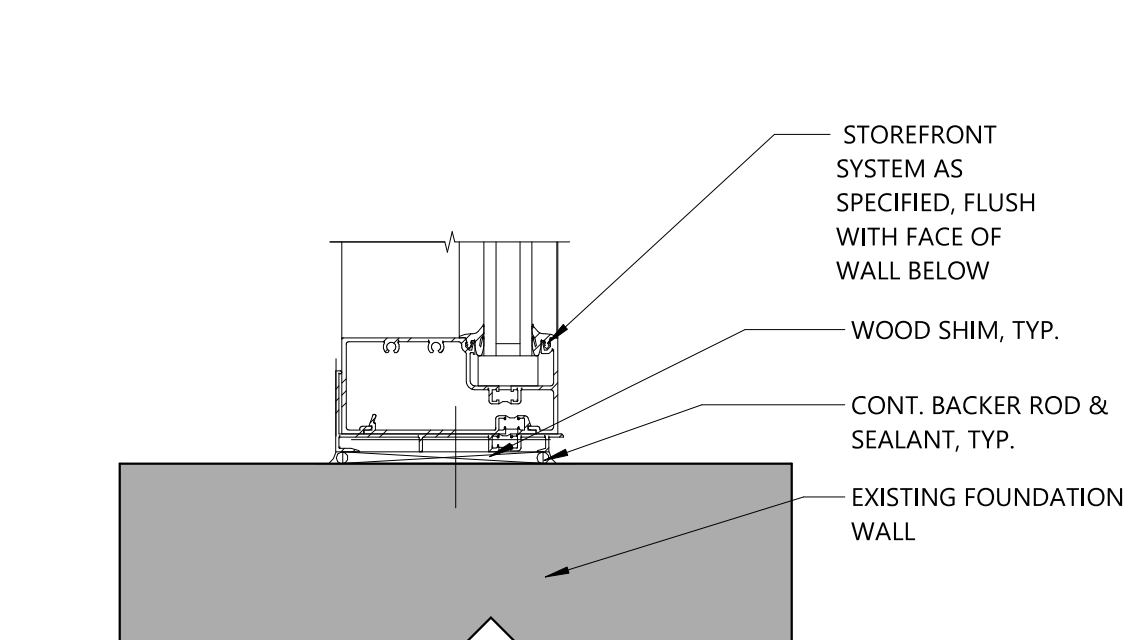

1 SILL DETAIL

A900 3" = 1'-0"

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ALBERT LEONARD MIDDLE SCHOOL
2023 CAPITAL PROJECTS - PHASE 1

Project Title



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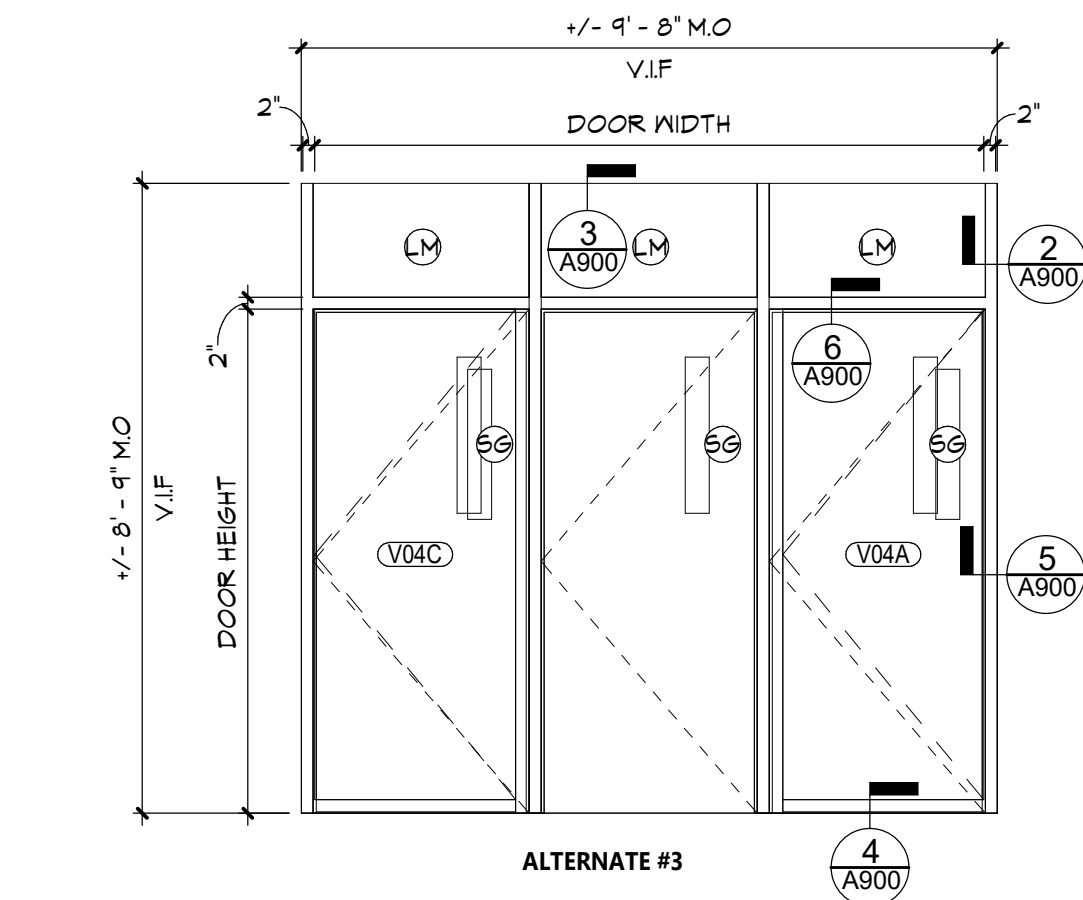
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DOOR AND WINDOW
SCHEDULE,
ELEVATIONS,
DETAILS

Sheet No.
ALMS
A900


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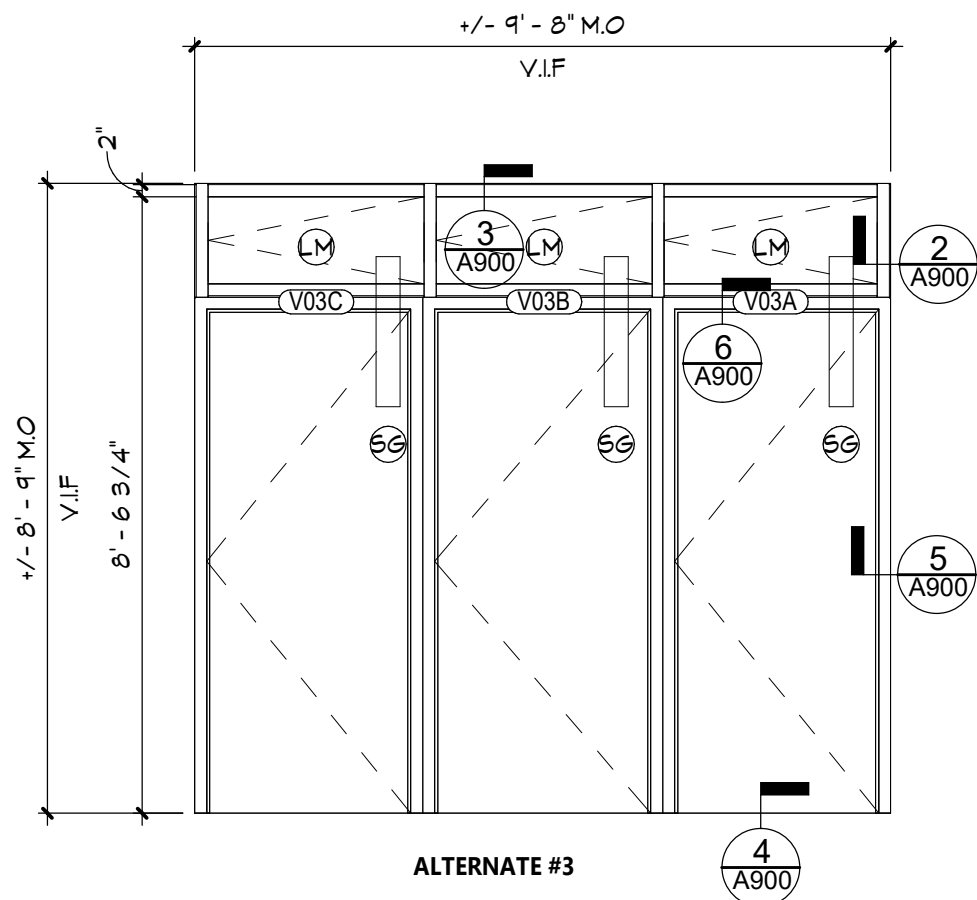
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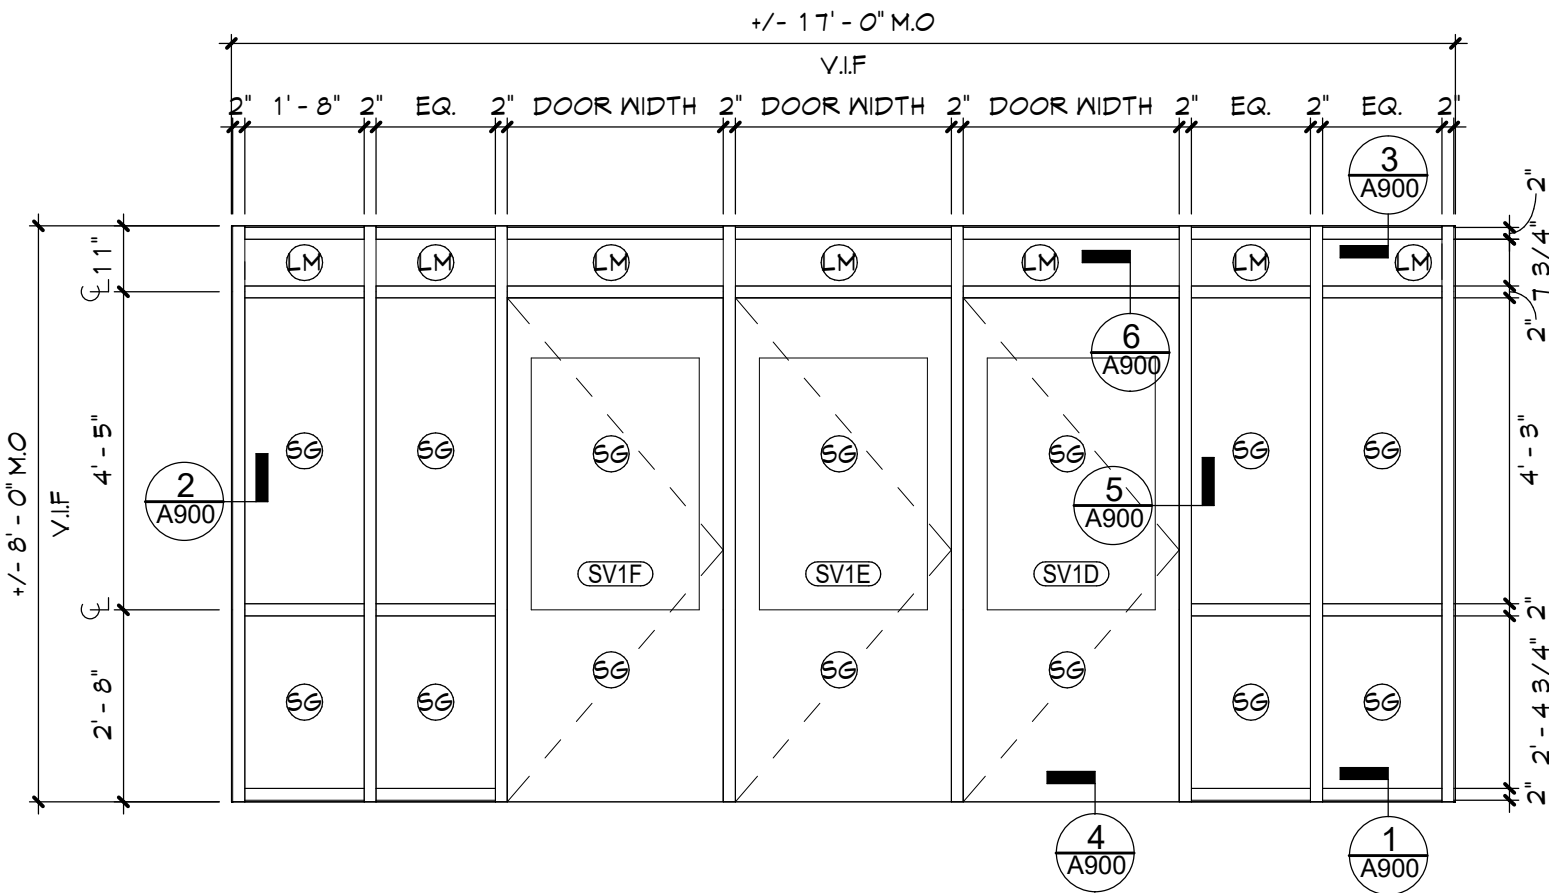
6 S7 Storefront Elevation
A921 3/8" = 1'-0"




3 S4 Storefront Elevation
A921 3/8" = 1'-0"




5 S6 Storefront Elevation
A921 3/8" = 1'-0"

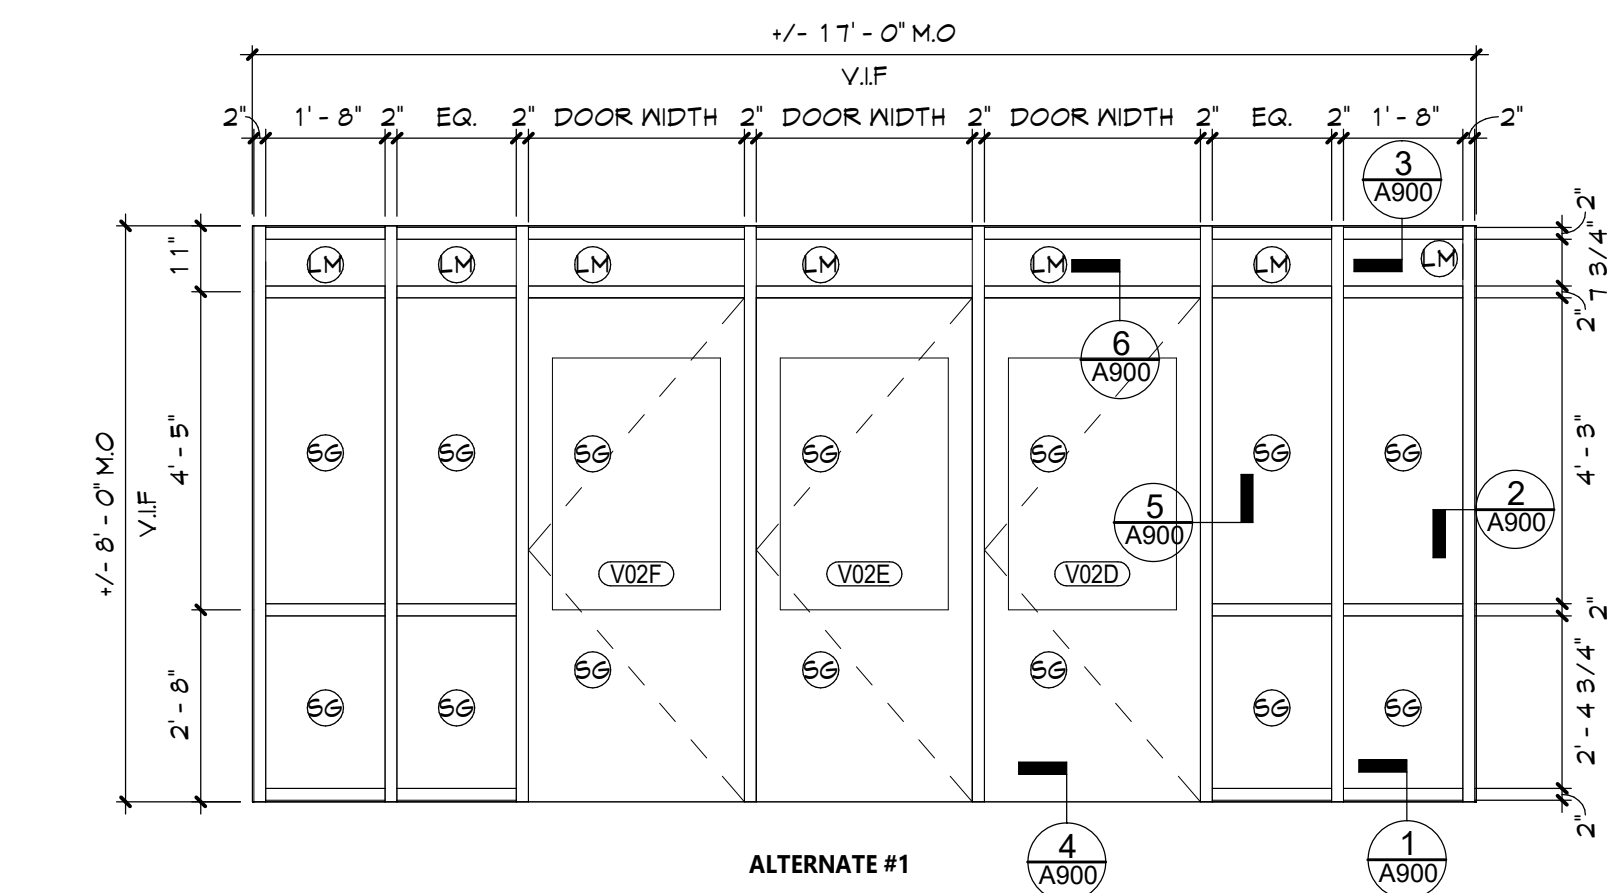


2 S2 Storefront Elevation
A921 3/8" = 1'-0"

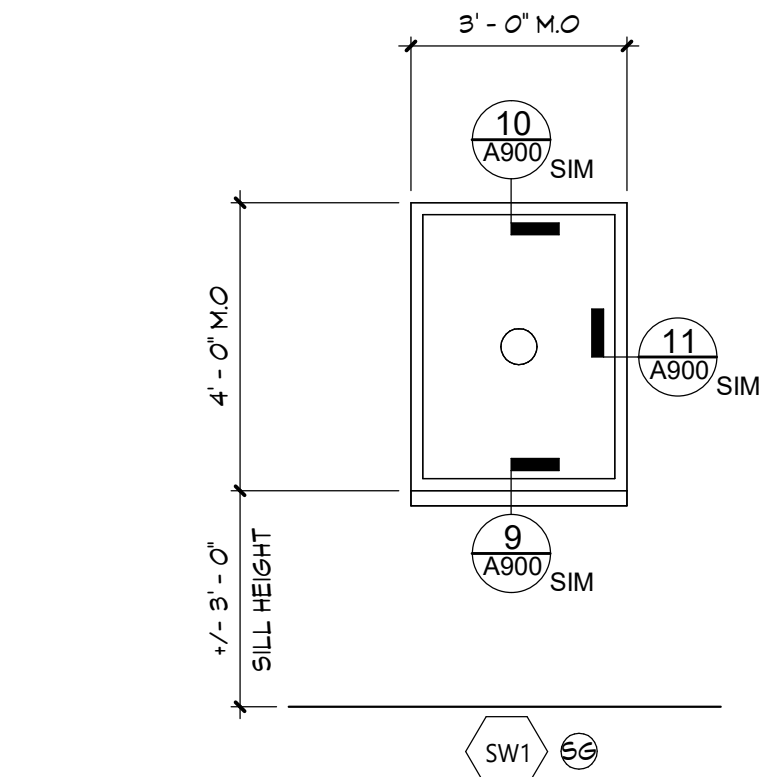

A900 WINDOW TYPES
3/8" = 1'-0"

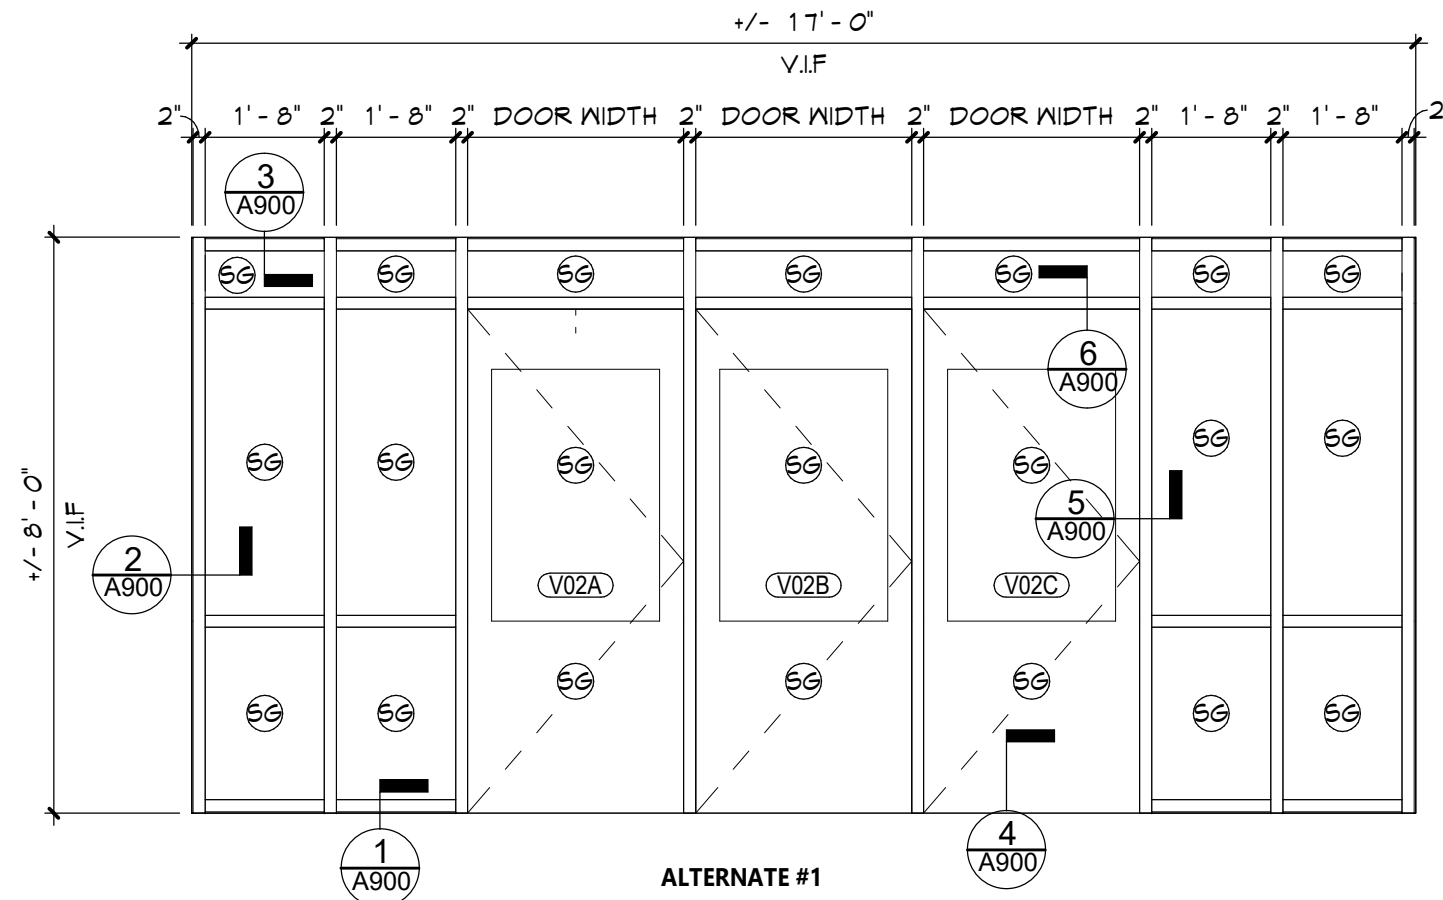

4 S5 Storefront Elevation
A921 3/8" = 1'-0"

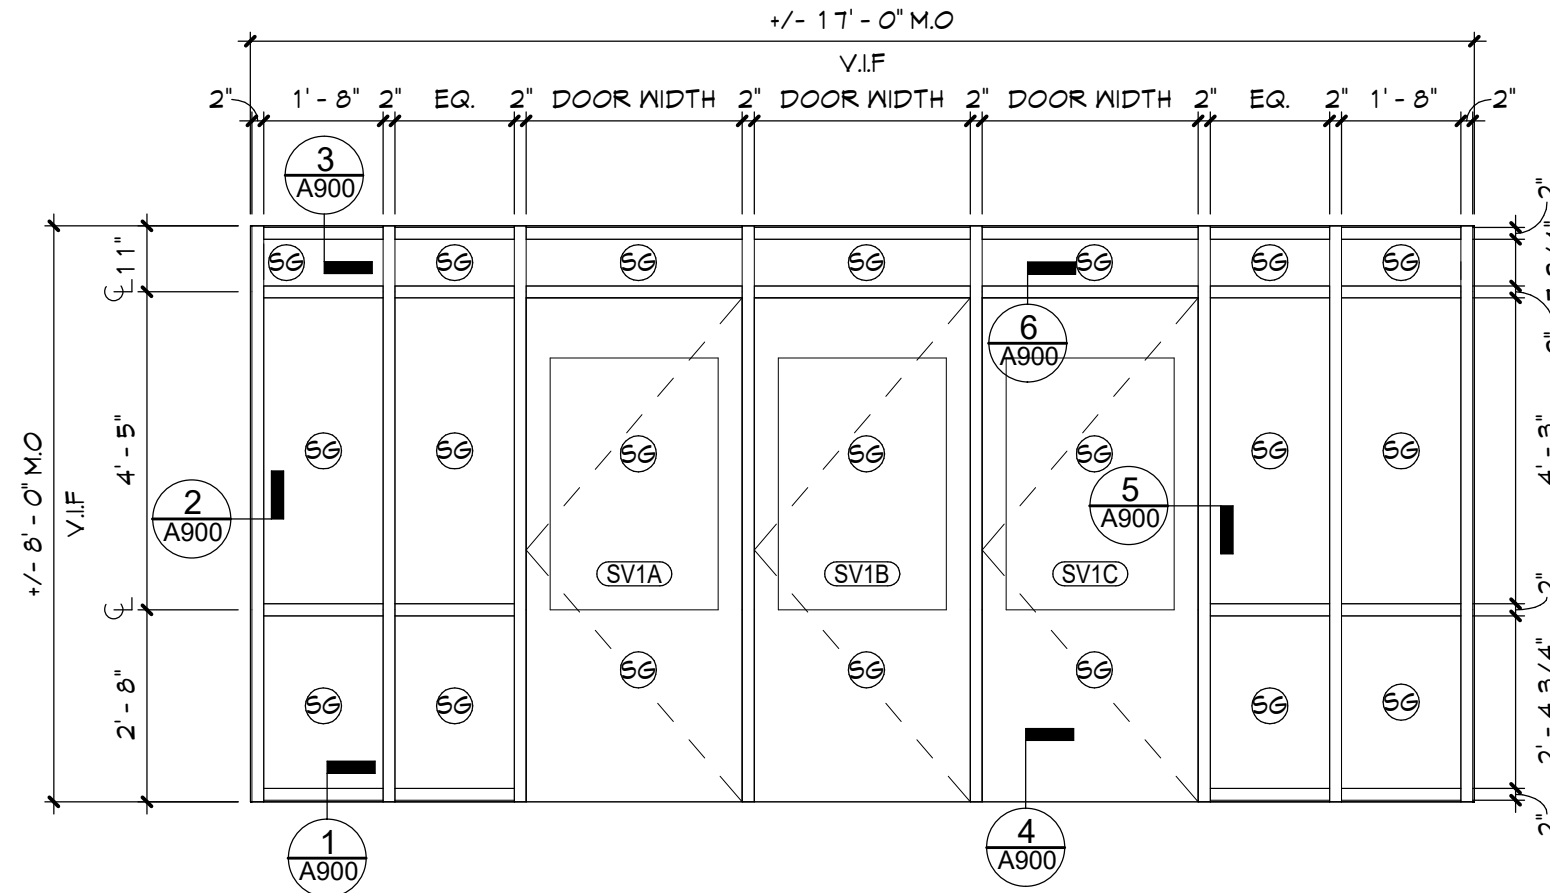

1 S1 Storefront Elevation
A921 3/8" = 1'-0"

GLAZING TYPES	
CGL	LOW-E COATED, INSULATED GLASS
LM	LAMINATED GLASS
S6	SECURITY GLASS
S6F	SECURITY GLAZING FILM
FR	FIRE-RATED GLASS
FRS6	FIRE-RATED SECURITY GLASS


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Sheet Title

STOREFRONT
ELEVATIONS

Sheet No.

ALMS
A921


CONSTRUCTION DOCUMENTS
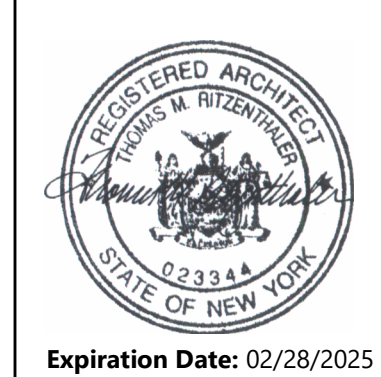
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ROOM FINISH SCHEDULE						
ROOM NUMBER	ROOM NAME	FLOOR		CEILING	Wall Finish	REMARKS
		FINISH	BASE			
C102	CORRIDOR	LVT-1	RB-1	ETR ACT-1	ETR/PNT-1	
SV1	SECURED VESTIBULE	LVT-1	RB-1	ETR		
S01	SECURITY OFFICE	LVT-1	RB-1	ETR ACT-1	PNT-1	
V02	VEST	LVT-1	RB-1	ETR		

MATERIALS LEGEND					
MATERIAL	MANUFACTURER	MODEL	COLOR #/NAME	SIZE	NOTE
LUXURY VINYL TILE					
LVT-1	MOHAWK GROUP	MATUTO PLUS STONE	926A AGREEABLE GREY	12" X 24"	TYP. FEILD
PAINT					
PNT-1	SHERWIN WILLIAMS	EGGSHELL	SW 7551 GREEK VILLA		TYP. FEILD
PNT-2	SHERWIN WILLIAMS	SEMI-GLOSS	SW 6076 TURKISH COFFEE		HM DOOR AND FRAMES
PNT-3	SHERWIN WILLIAMS	FLAT	SW 7005 PURE WHITE		CEILING
RUBBER BASE					
RB-1	ROPPE	BASEWORKS	44 DARK BROWN	4"	TYP. FEILD
SOLIDK SURFACE					
SS-1	DUPONT	CORIAN	NEUTRAL CONCRETE		COUNTERTOP @ SECURITY



1 AREA 'B' FIRST FLOOR PLAN
AF112 3/32" = 1'-0"

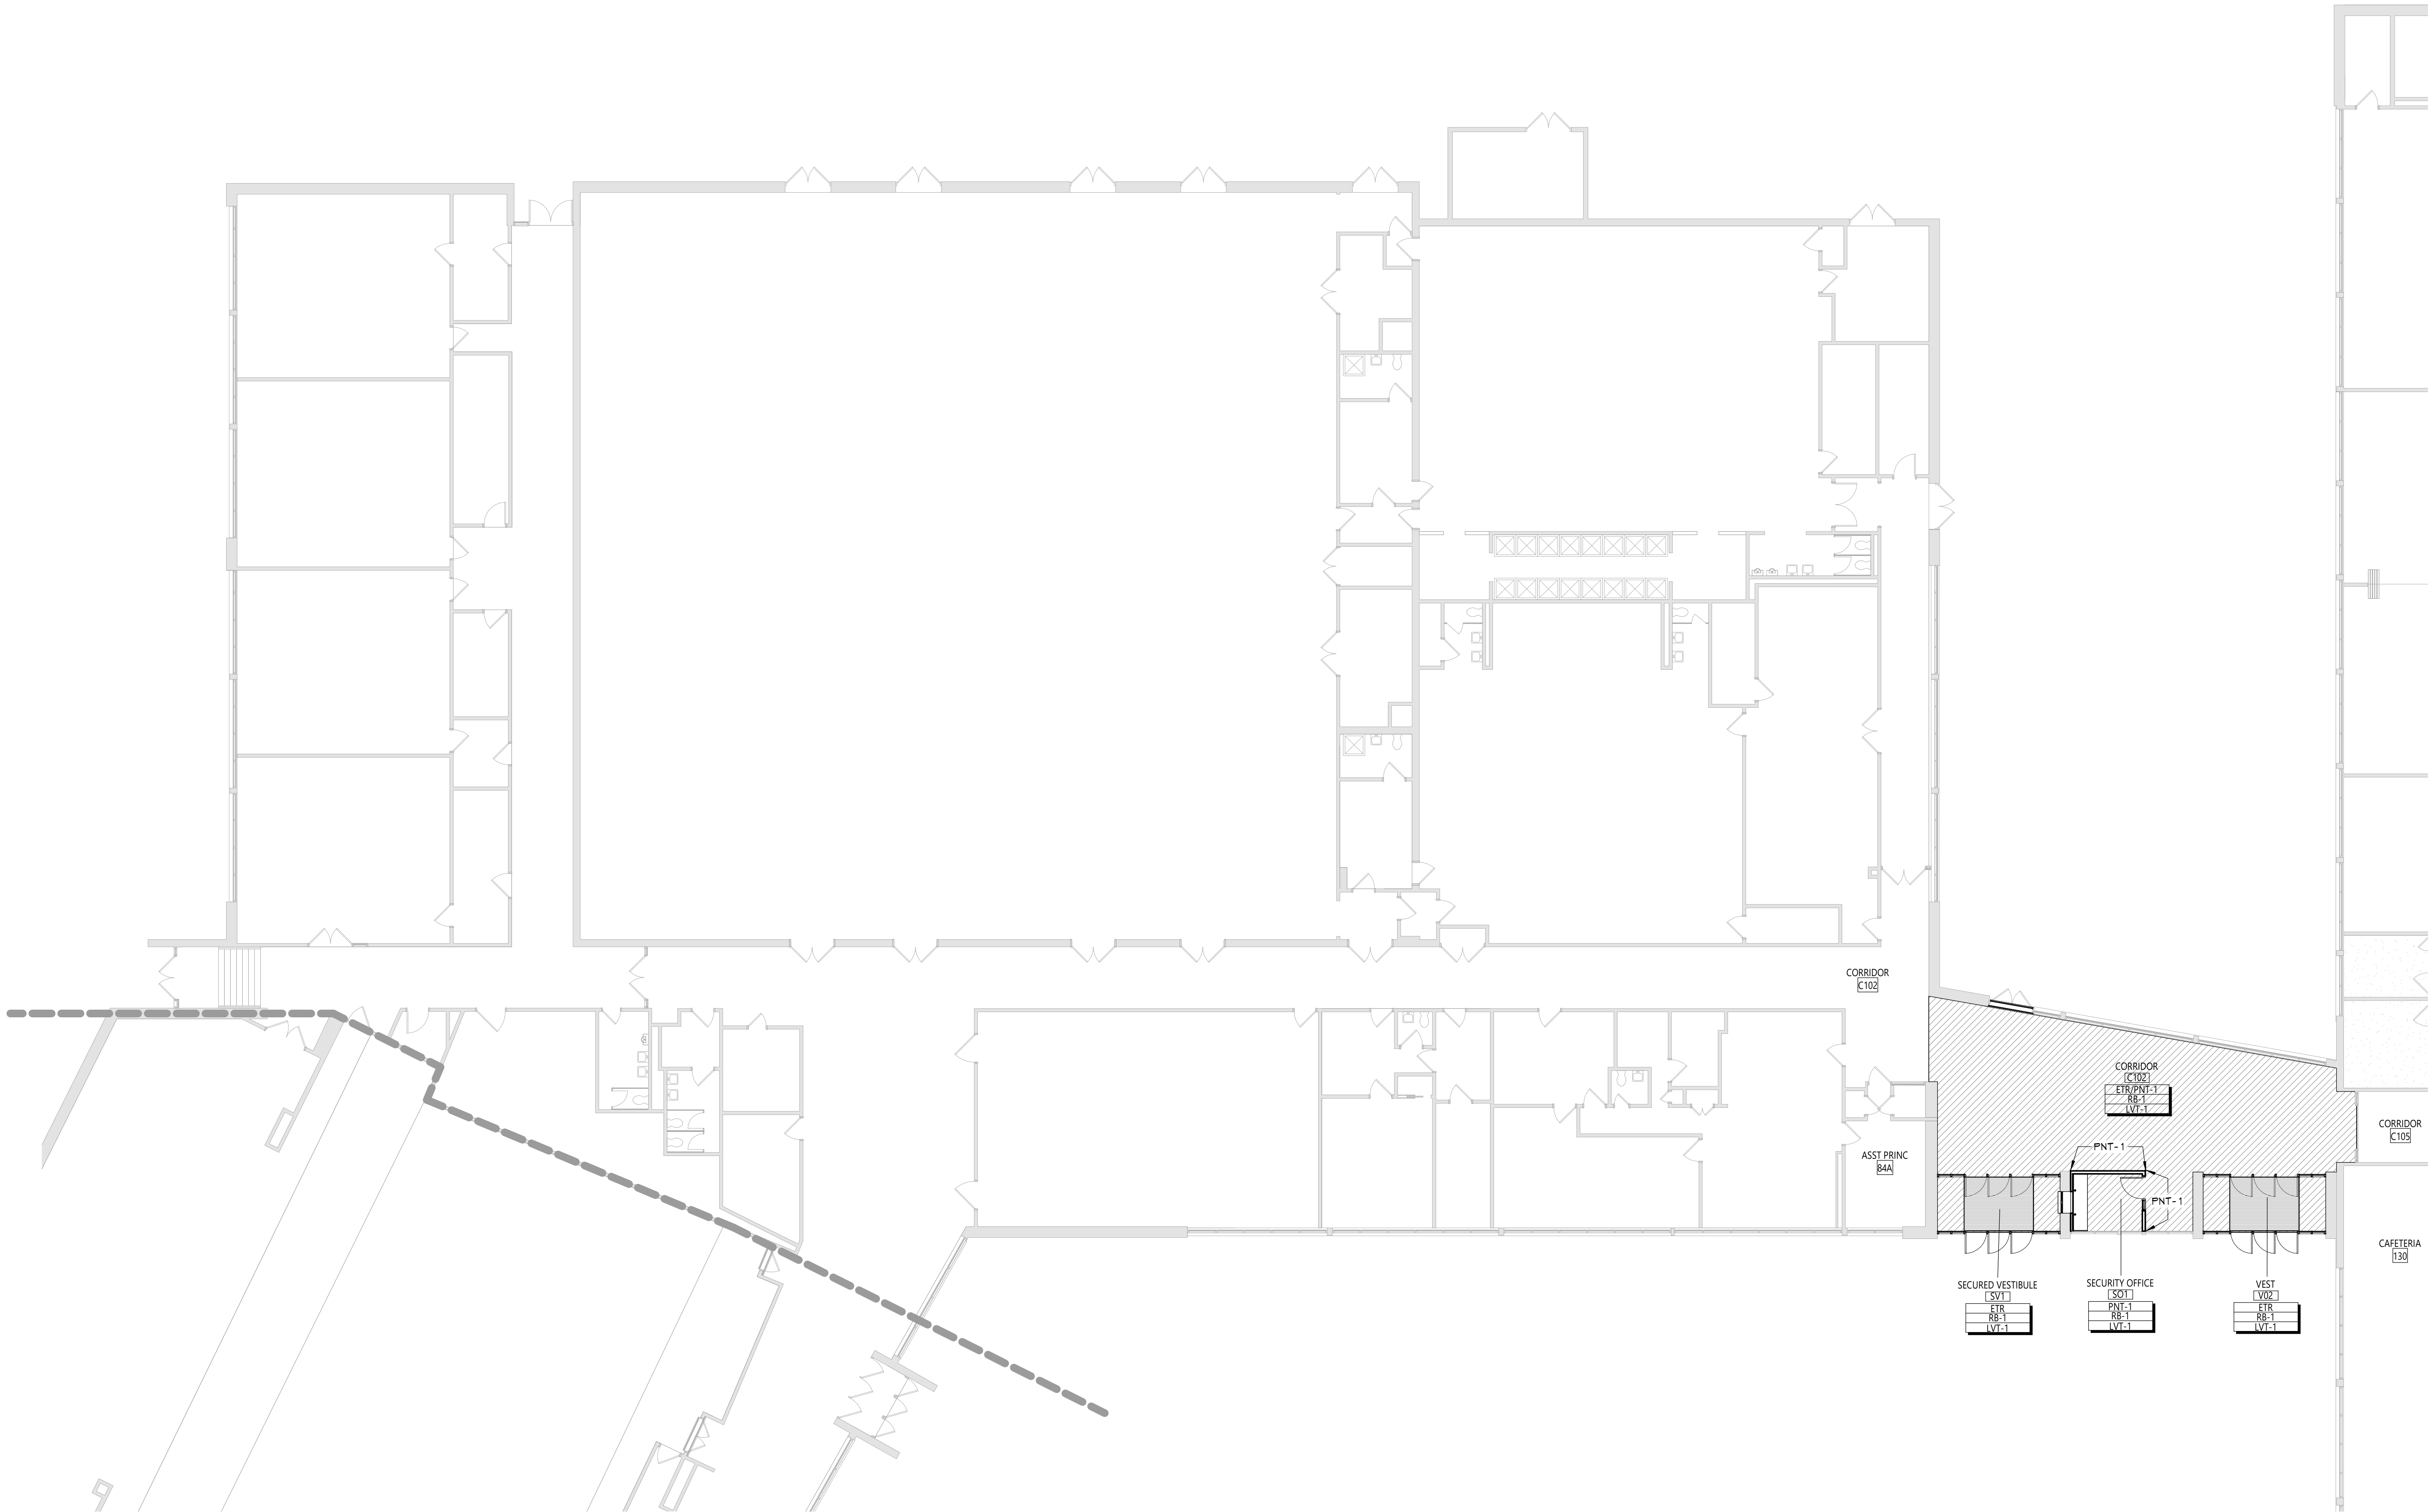DISCLAIMER NOTE	
MANUFACTURER'S NAMES AND FINISH INFORMATION ARE INDICATED AS REFERENCED TO THE ARCHITECT'S BASIS-OF-DESIGN SELECTIONS AND HAVE BEEN DETERMINED PRIOR TO BID. THE CONTRACTOR AND OWNER ARE HEREBY NOTIFIED THAT FINISHES INSTALLED IN THE WORK ARE SUBJECT TO CHANGE IN RESPONSE TO SUBMITTALS, CONFIRMED SELECTIONS, PRODUCT AVAILABILITY AND THE SUBSEQUENT COORDINATION OF FINISHES BY ARCHITECT AND MAY DIFFER FROM PRODUCTS LISTED HEREIN.	
ABBREVIATION	
ACMU	ARCHITECTURAL CONCRETE MASONRY UNIT
ACT	ACOUSTICAL CEILING TILE
APC	ACOUSTICAL PANEL CEILING
BRK	BRICK
GBB	CEMENT BACKER BOARD
GFT	CERAMIC FLOOR TILE
CMU	CONCRETE MASONRY UNIT
GONG	CONCRETE
CPT	CARPET
CTB	CERAMIC TILE BASE
GWT	CERAMIC WALL TILE
EPT	EPOXY PAINT
ETERR	EPOXY TERRAZZO
ETR	EXISTING TO REMAIN
EXP	EXPOSED
FAC/FF	FACTORY FINISH
FBP	FIBERBOARD PANEL
FRT	FIRE RETARDANT TREATED MATERIAL
GMB	GYPSPUM WALL BOARD
HPC	HIGH PERFORMANCE COATING
MNC	MAGNETIC WALLCOVERING
PGON	POLISHED CONCRETE
FLAH	PLASTIC LAMINATE
FLAS	PLASTER
PLYND	PLYWOOD
PNT	PAINT
RS	RUBBER BASE
RST	RUBBER STAIR TREAD / LANDING
RT	RUBBER TILE FLOORING
SC	STAGE CURTAIN
SCF	SPECIAL CONCRETE FINISH
SCONG	SEALED CONCRETE
SS	SOLID SURFACE
STL	STEEL
TERR	TERRAZZO
TP	TOILET PARTITIONS
TYP	TYPICAL
VGT	VINYL COMPOSITION TILE
ND	NOOD
NM	NAIL-OFF MAT
NT	NOOD TRIM
NV	NOOD VENEER
X-	EXISTING

- ### GENERAL FINISH NOTES
- ALL EXPOSED SURFACES OF NEW PARTITIONS ARE TO BE PAINTED.
 - WHEN ANY WORK IS PERFORMED ON ANY EXISTING WALL, THE ENTIRE WALL SURFACE IS TO BE PAINTED CORNER TO CORNER, UNLESS NOTED OTHERWISE. MATCH EXISTING ADJACENT FINISH.
 - ALL ELECTRIC, MECHANICAL COMPONENTS AND TELEPHONE PANELS EXPOSED IN A ROOM TO MATCH WALL COLOR.
 - ALL NEW GNB CEILINGS, FASCIAS, AND SOFFITS TO BE PAINTED.
 - NEW HM DOORS, DOOR FRAMES AND WINDOW FRAMES AND ETR CORRIDOR DOOR & WINDOW FRAMES AS SCHEDULED ON A600 SERIES DRAWINGS.
 - REFER TO A600 DRAWINGS FOR CEILING SCOPE, TYPES & LOCATIONS INCLUDING SUSPENDED ACOUSTICAL CEILING TILE SYSTEMS.
 - EXISTING TERRAZZO, WALL BASE & PAINT TO REMAIN. INFILL AREA EFFECTED BY DEMOLITION WITH NEW EPOXY TERRAZZO, WALL BASE & PAINT TO MATCH EXISTING AS REQUIRED. FLASH PATCHING AS REQUIRED TO EXISTING SLAB.
 - STONE WALL FINISH TO REMAIN.

FINISH KEYS	
Room Name [101]	ROOM FINISH TAG
Wall Finish [101]	
Base Finish [101]	
PNT-#	ACCENT PAINT LOCATION
[Hatched Box]	= LVT

KEY PLAN

Sheet Title

AREA 'B' -
PARTIAL FIRST
FLOOR FINISH
PLAN

Sheet No.

ALMS
AF112

CONSTRUCTION DOCUMENTS

19 Front St., Newburgh - New York 12550-7601
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Consultant





CITY SCHOOL DISTRICT OF NEW ROCHELLE
ALBERT LEONARD MIDDLE SCHOOL
2023 CAPITAL PROJECTS - PHASE 1

Project Title



DATE	DESCRIPTION

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ABBREVIATION	DESCRIPTION
ACC	AIR-COOLED CONDENSER
ACCU	AIR-COOLED CONDENSING UNIT
AD	ACCESS DOOR
AF	AIR FILTER
AFF	ABOVE FINISHED FLOOR
AFM	AIR FLOW MEASURING DEVICE
AHU	AIR HANDLING UNIT
APD	AIR PRESSURE DROP
AV	AUTOMATIC AIR VENT
B	
BTU/H	BRITISH THERMAL UNITS PER HOUR
C	
CC	COOLING COIL
CCCT	CLOSED CIRCUIT COOLER
CD	CEILING DIFFUSER
CEF	CEILING EXHAUST FAN
CFM	CUBIC FEET PER MINUTE
CM	CLEAN OUT
CO	CONTINUED
CR	CEILING RETURN
CUH	COOLING TOWER
CH	CABINET UNIT HEATER
D	
DB	DECIBELS
DBT	DRY BULB TEMPERATURE
DIA	DIAMETER
DPT	DEW POINT TEMPERATURE
DX	DIRECT EXPANSION
E	
EA	EXHAUST AIR
EAT	ENTERING AIR TEMPERATURE
EC	ELECTRICAL CONTRACTOR
EF	EXHAUST FAN
EFT	ENTERING FLUID TEMPERATURE
EG	EXHAUST GRILLE
EHC	ELECTRIC HEATING COIL
ER	EXHAUST REGISTER
ERC	ENERGY RECOVERY COIL
ERP	ELECTRIC RADIANT PANEL
ET	EXPANSION TANK
EW	ENTERING WATER TEMPERATURE
EX	EXISTING
F	
FCU	FAN COIL UNIT
FD	FIRE DAMPER
FDSD	COMBINATION FIRE/SMOKE DAMPER
FF	FINAL FILTER
FL	FLOOR
FM	FEET PER MINUTE
FT	FEET
G	
GAL	GALLONS
GPM	GALLONS PER MINUTE
GLY	GLYCOL SUPPLY
GRV	GRAVITY ROOF VENTILATION
GS	GLYCOL SUPPLY
H	
H	HUMIDIFIER
HC	HEATING COIL
HC	HEIGHT
HHP	HORSEPOWER OR HEAT PUMP
HRU	HEAT RECOVERY UNIT
HX	HEAT EXCHANGER
IN	INCH
KW	KILOWATT
L	
LAT	LEAVING AIR TEMPERATURE
LBS/HR	POUNDS PER HOUR
LD	LINEAR DIFFUSER
LFT	LEAVING FLUID TEMPERATURE
LPC	LOW PRESSURE CONDENSATE RETURN
LPS	LOW PRESSURE STEAM (15 PSIG AND BELOW)
LSD	LINEAR SLOT DIFFUSER
LWT	LEAVING WATER TEMPERATURE
M	
MAX	MAXIMUM
MBH	ONE THOUSAND BRITISH THERMAL UNITS PER HOUR
MC	MECHANICAL CONTRACTOR
MD	MOTORIZED DAMPER
MIN	MINIMUM
MPC	MEDIUM PRESSURE CONDENSATE RETURN
MPS	MEDIUM PRESSURE STEAM (16-59 PSIG)
N	
NC	NOT IN CONTRACT
NOM	NOMINAL
O	
OA	OUTSIDE AIR
P	
P	PUMP
PC	PUMPED CONDENSATE
PD	PRESSURE DROP
PR	PRESSURE REDUCING VALVE OR POWER ROOF VENTILATOR
PSIG	POUND PER SQUARE INCH - GAUGE
R	
RA	RETURN AIR
RF	RETURN FAN
RG	RETURN GRILLE
RH	REHEAT COIL
RM	ROOM
ROTV	ROTARY VENTILATOR
RPM	REVOLUTIONS PER MINUTE
RTM	RETURN REGISTER
RTU	ROOF-TOP UNIT
S	
SA	SUPPLY AIR
SD	SMOKE DAMPER
SF	SUPPLY FAN
SP	STATIC PRESSURE
SR	SUPPLY REGISTER
T	
TO	TRANSFER OPENING
U	
UNO	UNLESS NOTED OTHERWISE
UV	UNIT VENTILATOR
V	
VA	VENTILATION AIR
VAV	VARIABLE AIR VOLUME
VD	VOLUME DAMPER
VFD	VARIABLE FREQUENCY DRIVE
VACU	VACUUM PUMP
VR	VACUUM STEAM CONDENSATE RETURN
W	
WB	WET BULB TEMPERATURE
WG	WATER GAUGE
WMS	WIRE MESH SCREEN
WPD	WATER PRESSURE DROP

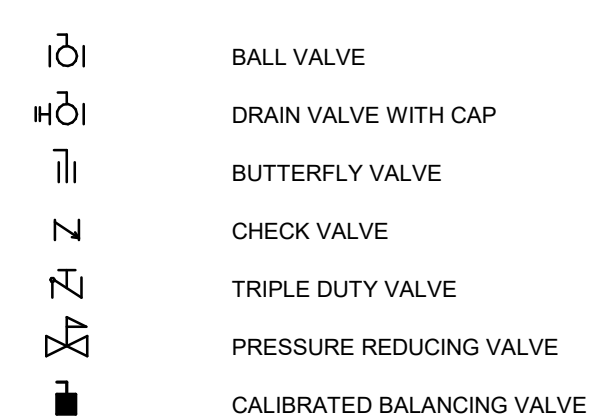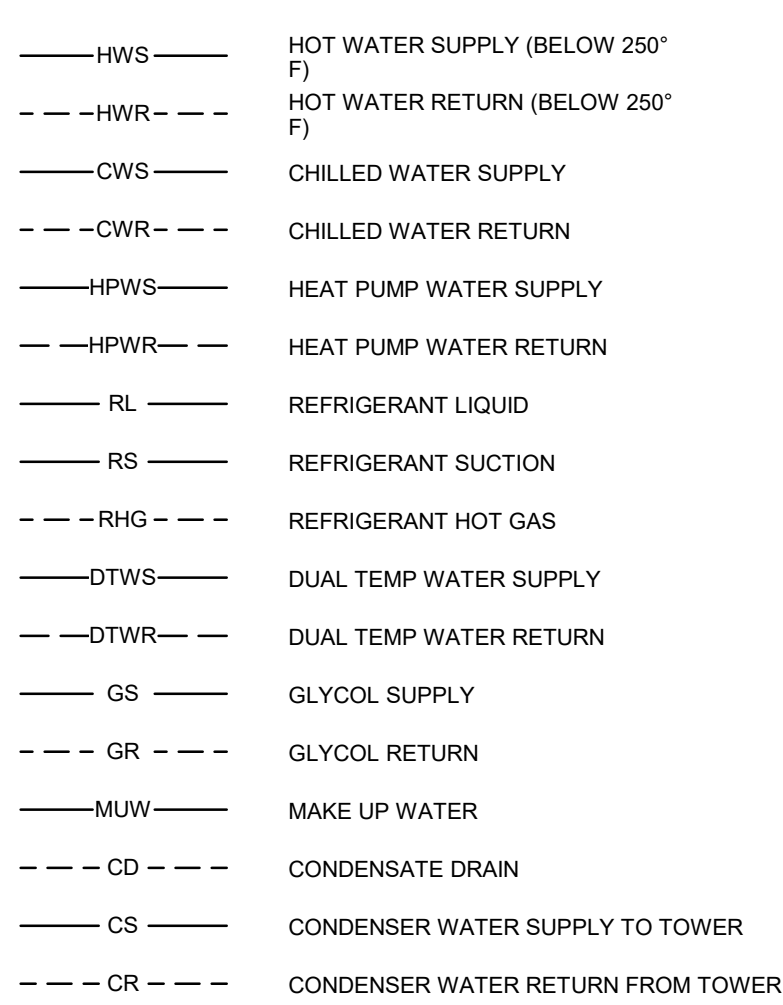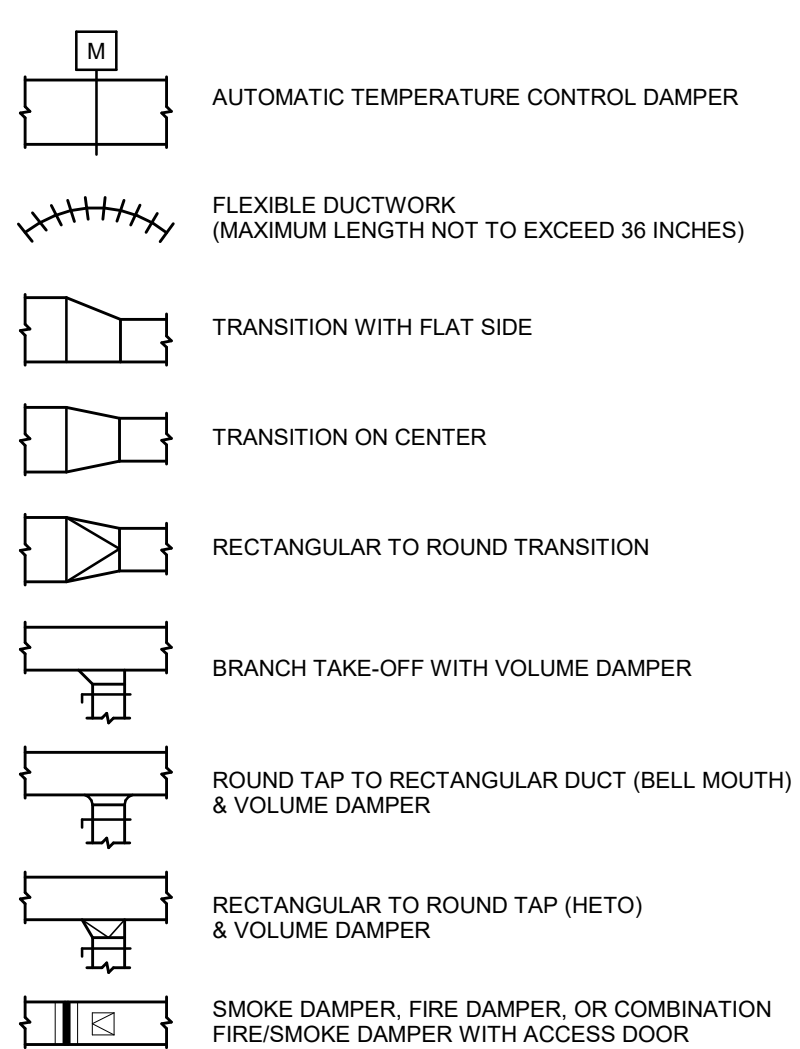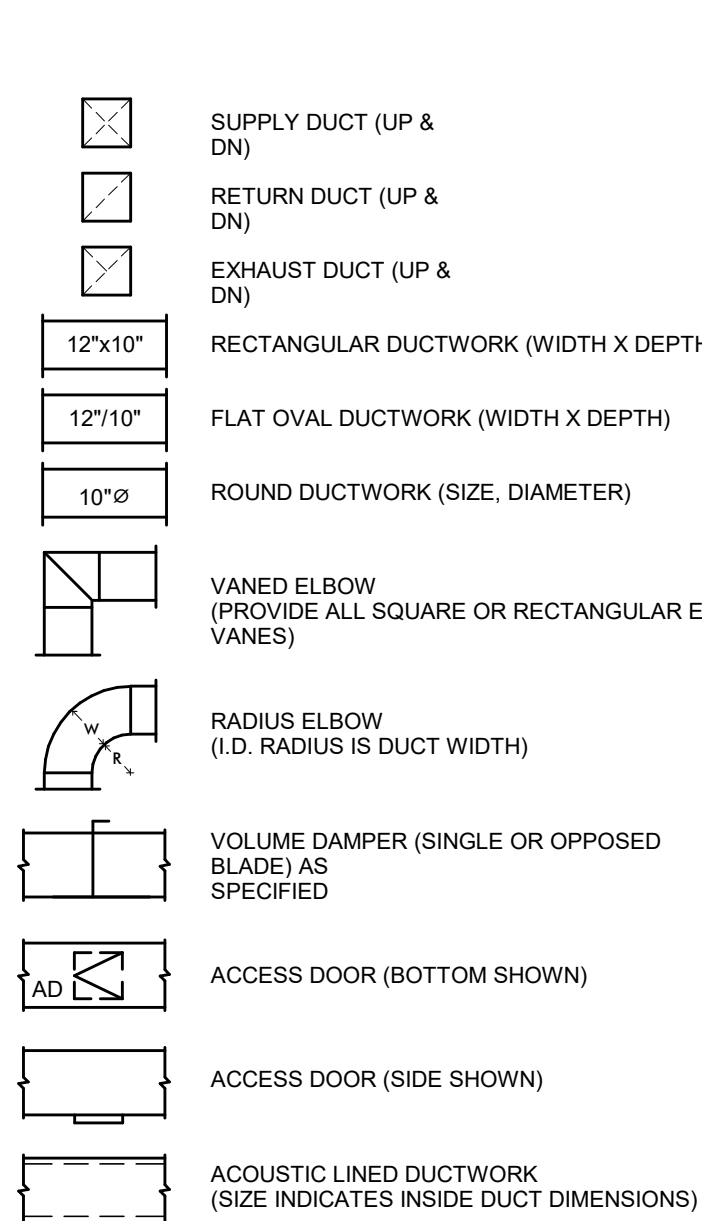TAG	SERVICE	NOMINAL TONS	SUCTION TEMP (F)	COOLING OAT (F)	HEATING OAT (F)	SEER	ELECTRICAL				MANUFACTURERS	REMARKS
							VOLTS	PH	MCA	MCCP		
ALMS-CU-A	ALMS-HP-1	0.75	45	95	5	20.2	208	1	14	24	NTXSKH09A112AA	1.2

REMARKS:

1. PROVIDE UNIT MOUNTED DISCONNECT.
2. PROVIDE ALL ACCESSORIES FOR OPERATION DOWN TO -13F

TAG	ASSOCIATED CONDENSING UNIT	UNIT STYLE	SERVICE	CFM (LOW-HIGH)	OA FPM	EXT S.P.	COOLING				HEATING			ELECTRICAL			MANUFACTURERS	REMARKS	
							OAT F	EAT DB	EAT WB	MAXIMUM (MBH)	MINIMUM (MBH)	OAT F	EAT DB	MAXIMUM (MBH)	VOLTS	PH			MCA
ALMS-HP-1	ALMS-CU-1	CEILING CASSETTE	SECURITY OFFICE 43	230 - 335	20	0	95	80	67	9.0	4.8	5	70	11.0	208	1	0.25	NTXK/S50A112AA	1.2,3,4

REMARKS:

1. PROVIDE UNIT MOUNTED DISCONNECT, WALL MOUNTED WIRED CONTROLLER, INTEGRAL CONDENSATE LIFT PUMP AND OUTSIDE AIR KIT.
2. PROVIDE BACnet INTERFACE FOR CONNECTION TO BMS.
3. PROVIDE INDOOR UNIT WITH AUXILIARY HEAT RELAY KIT TO ENABLE ZONE FINNED RADIATION AS SECOND STAGE OF HEATING.
4. OUTDOOR UNIT SHALL SUPPLY POWER TO INDOOR UNIT.

TAG	SERVICE	MAX. CFM	HOOD VELOCITY (FPM)	THROAT SIZE (")	CURB CAP SIZE(18)	S.P. DROP AT MAX. CFM (%)	HOOD			COOK	REMARKS
							H (")	L (")	W (")		
ALMS-GV-1	INTAKE	690	500	8 DIA.	18x18	0.375	8	18 DIA.	18 DIA.	PR	1

REMARKS:
1. PROVIDE 24" TALL INSULATED ROOF CURB.

TAG	STYLE	TOTAL WATTS	HEATING ELEMENT			ENCLOSURE					MANUFACTURERS	REMARKS
			VOLTS	PH	WATTS/FT	DEPTH	HGT.	MTG/H	OUTLET	LENGTH		
ALMS-EFT-1	PEDESTAL	1000	208	1	125	3"	5.5"	3" AFF	TOP	8'	CPH05A	1.2

REMARKS:

1. PROVIDE UNIT MOUNTED DISCONNECT AND INTEGRAL THERMOSTAT.
2. PROVIDE ALL NECESSARY MOUNTING AND TRIM ACCESSORIES.

				PEOPLE OUTDOOR AIR RATE (Rp) (CFM/PERSON)				AREA OUTDOOR AIR RATE (Ra) (CFM/SP)		DEFAULT VALUES		OUTSIDE AIRFLOWS (CFM)				
ROOM	ROOM NUMBER	OCCUPANCY CATEGORY	AREA (SF)			OCCUPANT DENSITY (#/100 SF)	NUMBER OF OCCUPANTS	CODE MIN. PEOPLE	CODE MIN. AREA	CODE MIN. COMBINED	DIST. EFF. (Eq)	ZONE OA MIN. (Voz)	DESIGN			
SECURITY OFFICE	43	OFFICE SPACE	131	5	0.06	5	1	5	8	13	0.8	16	20			

- 1 AIR COOLED CONDENSING UNIT
- 2 COUNTER FLASHING OVER TREATED WOOD NAILER
- 3 WELDED GALVANIZED STEEL EQUIPMENT RAIL (MIN 24" HIGH), MIN. 18 GAGE AS MANUFACTURED BY GREENHECK OR APPROVED EQUAL.
- 4 FASTEN CONDENSING UNIT TO EQUIPMENT RAIL, COORDINATE SPACING PRIOR TO INSTALLATION.


NOTE: EQUIPMENT RAIL FURNISHED BY MC AND
TURNED OVER TO GC FOR INSTALLATION.
COORDINATE SIZE AND LAYOUT WITH GC.

PROVIDE PROFESSIONAL ENGINEER STAMPED AND SIGNED
ENGINEERING CALCULATIONS AND DETAILS OF WIND RESTRAINT
SYSTEMS TO MEET TOTAL DESIGN LATERAL FORCE
REQUIREMENTS FOR SUPPORT AND RESTRAINT OF MECHANICAL
SYSTEMS.

WIND RESTRAINT ENGINEERING CALCULATIONS AND DETAILS SHALL PROVIDE THE QUANTITY OF ATTACHMENTS AND SIZE/TYPE OF ATTACHMENTS FOR THE MOUNTING OF SUPPORT RAIL TO THE BUILDING STRUCTURE, AND FOR ATTACHMENT OF THE EQUIPMENT TO THE SUPPORT RAIL.


SUBMIT WIND FORCE LEVEL (FP) CALCULATIONS FROM APPLICABLE BUILDING CODE. SUBMIT PRE-APPROVED RESTRAINT SELECTIONS, INSTALLATION DETAILS, PLANS INDICATING LOCATIONS OF RESTRAINTS AND MANUFACTURER'S PRODUCT DATA.

WIND RESTRAINT DESIGN CRITERIA:	
ULTIMATE DESIGN WIND SPEED, V	126 MP
EXPOSURE CATEGORY	B
RISK CATEGORY	III
HEIGHT & EXPOSURE ADJUSTMENT COEFFICIENT	N/A (1)
(1) BUILDING HEIGHT LESS THAN 60 FT.	

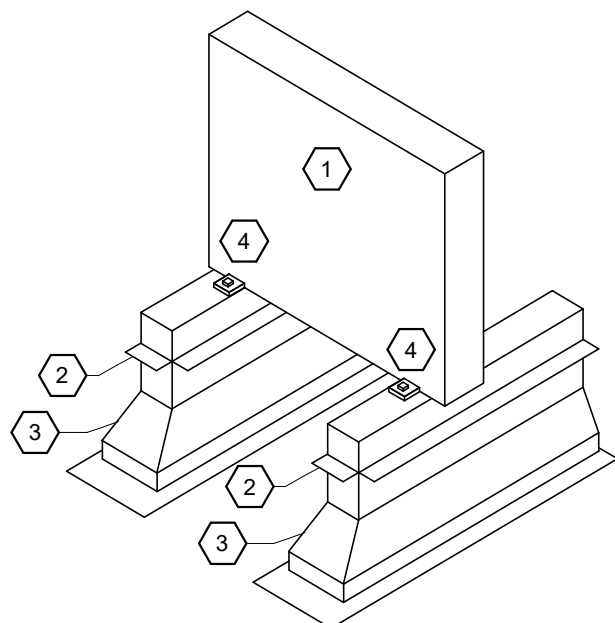

1	Roof Mounted Condensing Unit Support - Single Unit
M001	N.T.S.

- 1 CAP FLASHING
- 2 ROOF CURB MIN. 24" HIGH. ROOF CURB TO BE PROVIDED FOR INSTALLATION ON SLOPED ROOF. COORDINATE WITH ARCHITECTURAL DRAWINGS.
- 3 INSULATED THERMALLY BROKEN MOTORIZED DAMPER. TAMCO OR EQUAL
- 4 LAG TO CURB
- 5 ROOF FLASHING
- 6 ROOF
- 7 DUCT TO BE FULL SIZE OF CURB OPENING
- 8 BIRD SCREEN
- 9 HOOD
- 10 12" BASE ON INTAKES
- 11 FLANGED CONNECTION
- 12 DUCT INSULATION
- 13 SEE PLAN FOR DUCT SIZE AND CONTINUATION

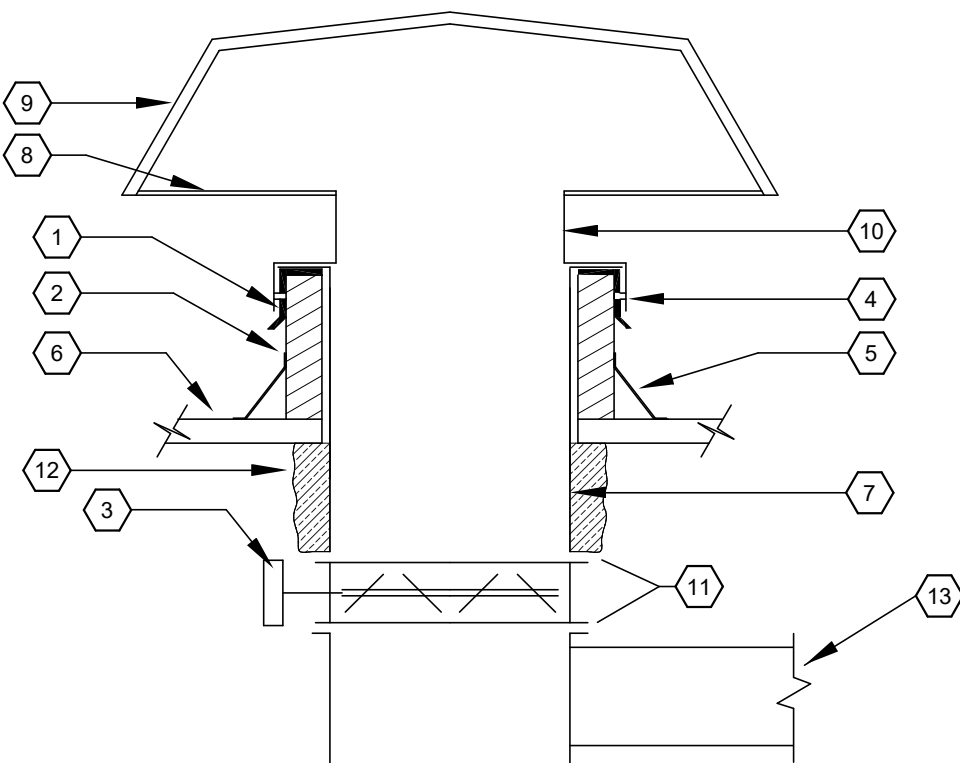


2	Fresh Air Intakes And Air Relief Vents Detail
M001	N.T.S.


- 1 PROVIDE STRAIGHT SIDED INSULATED CURB (MIN. 24" HIGH), COVER, CAP AND CLAMPS AS MANUFACTURED BY PORTALS PLUS OR APPROVED EQUAL.
- 2 REFRIGERANT PIPE; QTY PER PLANS
- 3 ELECTRICAL CONDUIT; QTY PER PLANS
- 4 ROOF FLASHING AND ROOF DECK

NOTE: EACH COMPLETE PIPE PORTAL SHALL INCLUDE A BASE WITH A MOLDED SEALING RING ON A COLLARED OPENING AND AN EPDM COMPRESSION MOLDED RUBBER CAP. THE CAP AND BASE SHALL BE LOCKED WITH A "WEATHER TIGHT PRESSURE SEAL". THE PORTAL SHALL INCLUDE STAINLESS STEEL CLAMP SEALING UNITS. THE PIPE PORTAL SHALL INCLUDE A PREFABRICATED ROOF CURB, A LAMINATED ACRYLIC COATED ABS COVER WITH PRE-PUNCHED MOUNTING HOLES AND A DOUBLE MOLDED SEALING RING ON THE COLLARED OPENING.

CONTRACTOR TO VERIFY CURB DIMENSIONS IN FIELD.

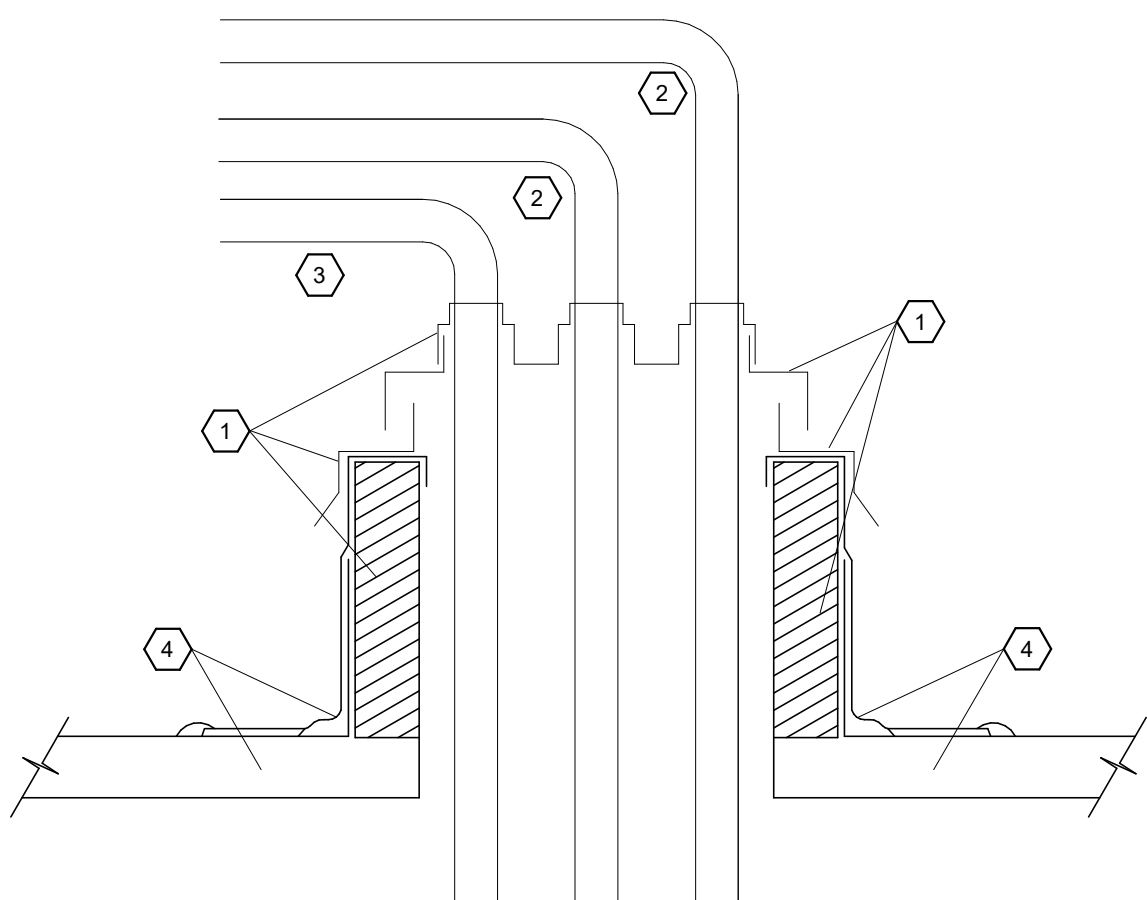

3	Roof Piping Penetration At Condensing Unit Detail
M001	N.T.S.

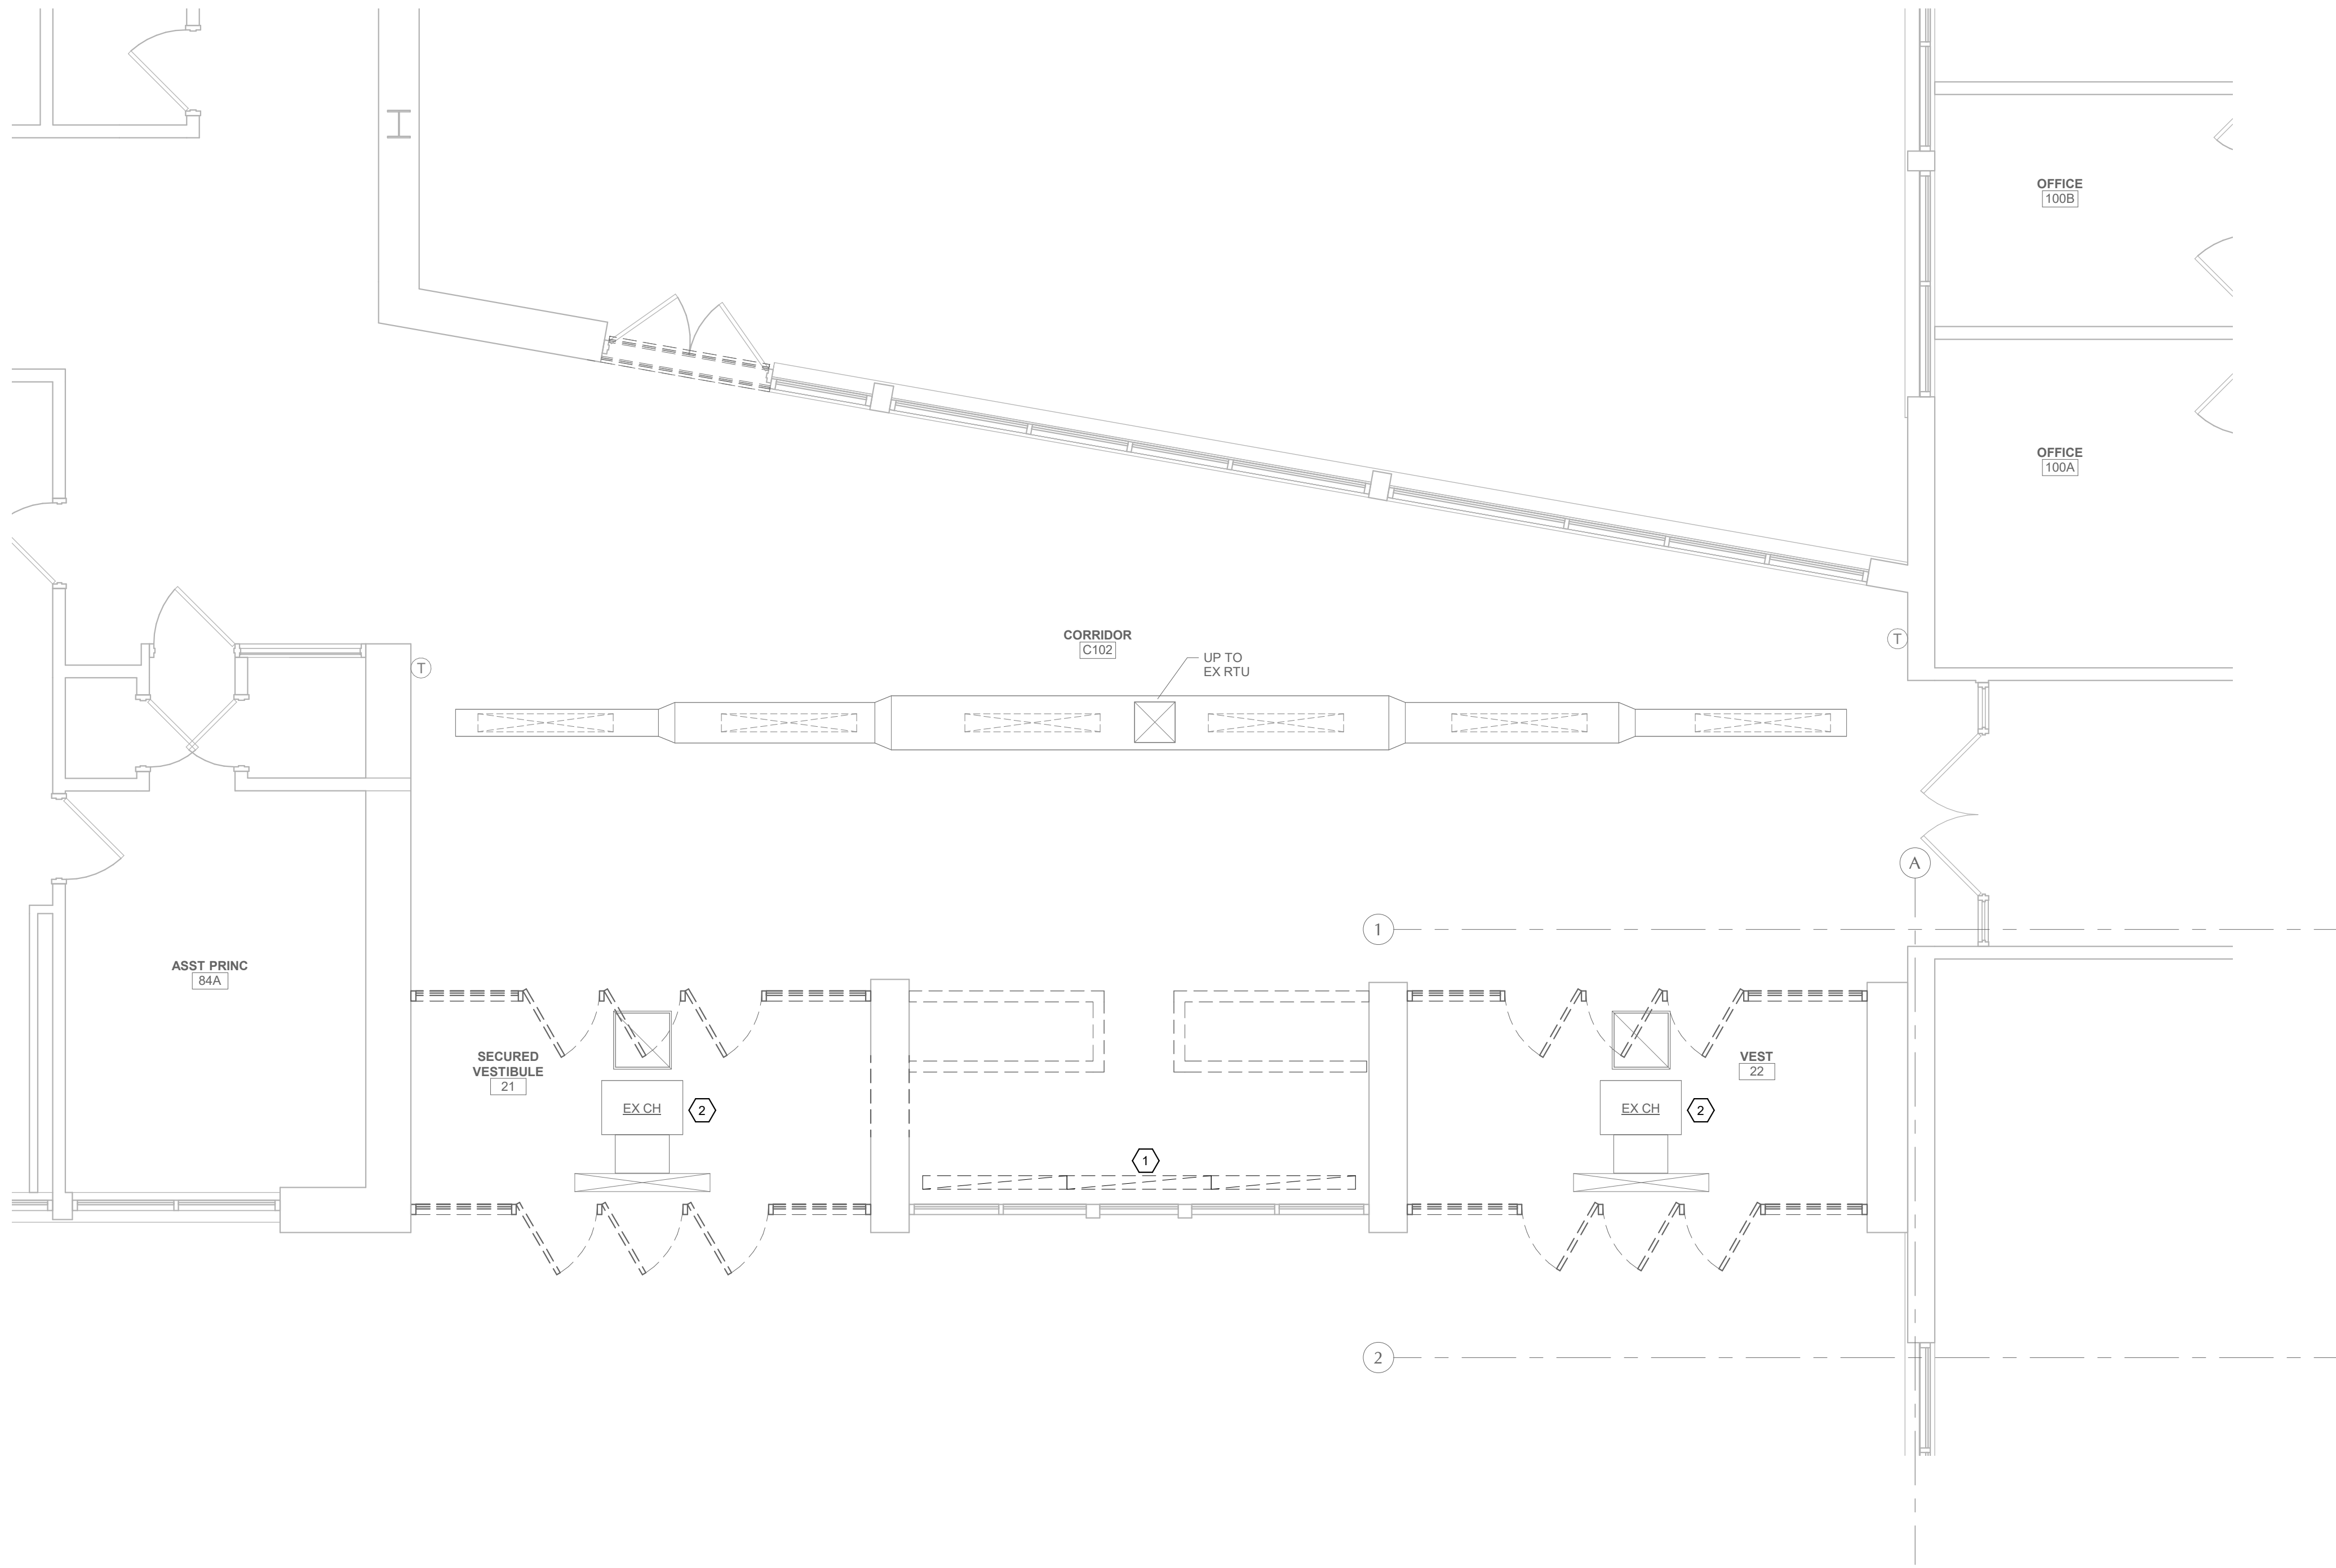

1 Mechanical First Floor Plan - Removals
MD101 1/4" = 1'-0"


GENERAL REMOVALS NOTES

- A. REMOVALS INDICATED BY HEAVY DASHED LINE.
- B. UNLESS NOTED OTHERWISE, ALL ITEMS INDICATED ARE TO BE REMOVED "COMPLETE". REMOVAL SHALL INCLUDE ALL COMPONENTS, DUCTWORK, PIPING, HANGERS, SUPPORTS AND ACCESSORIES, ASSOCIATED WITH THE EQUIPMENT.
- C. CONTRACTOR IS TO INSPECT EQUIPMENT THAT IS TO BE REUSED AND DETERMINE THAT IT IS COMPLETE AND IN GOOD WORKING ORDER. IF NOT, REPORT FINDINGS TO THE ARCHITECT/ENGINEER.
- D. EVERY EFFORT HAS BEEN MADE TO INDICATE ALL EQUIPMENT THAT IS TO BE REMOVED THROUGH FIELD OBSERVATIONS, HOWEVER, THE CONTRACTOR IS TO VISIT THE SITE PRIOR TO BIDDING AND VERIFY ALL REMOVALS.
- E. ALL ITEMS BEING REMOVED AND NOT REUSED SHALL BE TURNED OVER TO THE OWNER FOR FUTURE USE. IF OWNER DECIDES THE ITEMS ARE NOT REUSABLE, THE MECHANICAL CONTRACTOR SHALL DISPOSE OF THEM.
- F. IF THERE IS A QUESTION REGARDING A REMOVAL, THE CONTRACTOR IS TO VERIFY WITH THE OWNER OR THE OWNER'S REPRESENTATIVE AS TO THE REMOVAL STATUS BEFORE PROCEEDING.
- G. ALL INTERRUPTIONS OF SERVICE SHALL BE SCHEDULED AND COORDINATED WITH THE OWNER. MECHANICAL SYSTEMS FEEDING FROM OR THROUGH THE CONTRACT AREA SHALL BE MAINTAINED.
- H. COORDINATE THIS DRAWING WITH ARCHITECTURAL DRAWINGS FOR EXTENT OF NEW WALL AND CEILING WORK.
- I. COORDINATE THIS PLAN WITH NEW WORK PLAN.

CODED REMOVALS NOTES

- 1 DISCONNECT, REMOVE AND SALVAGE EXISTING LINEAR RETURN GRILLE. REFER TO NEW WORK PLAN FOR NEW LOCATION OF EXISTING GRILLE.
- 2 EXISTING CONCEALED CEILING CABINET HEATER AND CONTROLS TO REMAIN. REMOVE AND SALVAGE EXISTING LINEAR SUPPLY DIFFUSER AND RETURN GRILLE TO ACCOMMODATE NEW CEILING INSTALLATIONS.

KEY PLAN

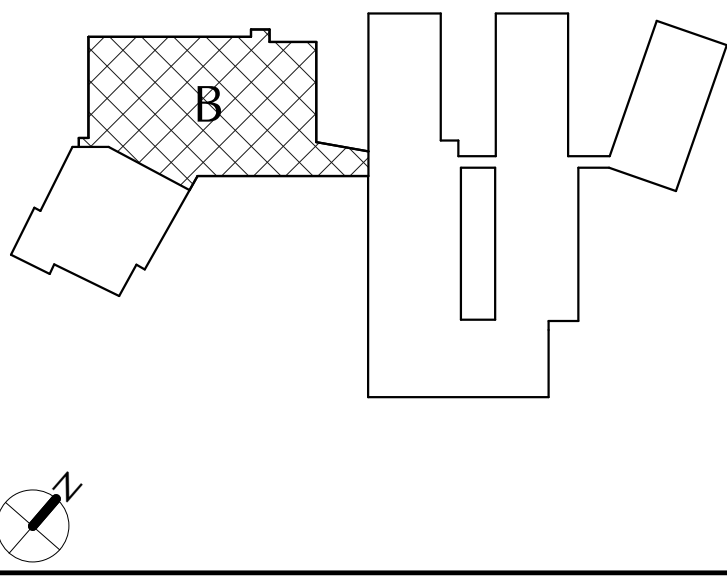

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CITY SCHOOL DISTRICT OF NEW ROCHELLE
ALBERT LEONARD MIDDLE SCHOOL
2023 CAPITAL PROJECTS - PHASE 1

Project Title



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Sheet Title

Mechanical
Removals Plan

Sheet No.

ALMS
MD101

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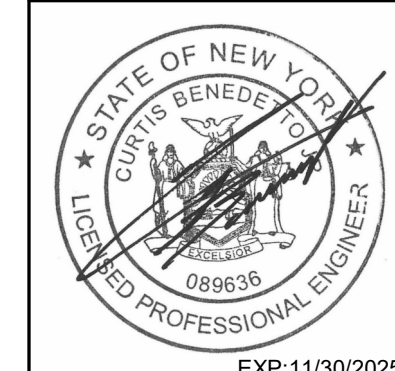
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


- ### CODED NOTES
- 1 PROVIDE DUCTLESS CEILING CASSETTE HEAT PUMP UNIT PER SCHEDULE.
 - 2 PROVIDE ROOF MOUNTED HEAT PUMP CONDENSING UNIT, HANGING ROOF PIPE PORTAL AND ROOF EQUIPMENT RAILS. MAINTAIN 1" SETBACK FROM ROOF EDGE.
 - 3 PROVIDE ROOF MOUNTED INTAKE HOOD.
 - 4 PROVIDE CONDENSATE PUMP (CP-1, LITTLE GIANT, LOCAL) 1/2" 115V/1PH/60HZ CEILING CASSETTE UNIT WITH 3/4" CD PIPING IN PIPE PORTAL AND SPILL PAN.
 - 5 PROVIDE PNEUMATIC MOUNTED ELECTRIC FAN RADIATION ALL WINDOW.
 - 6 REINSTALL EXISTING SLANGED VANERIN SLOT RETURN GRILLE IN NEW LOCATION. THOROUGHLY CLEAN AND REINSTATE.
 - 7 EXISTING CONCEALED ELEGANT CABINET HEATER AND CONTROLS TO REMAIN. THOROUGHLY CLEAN EXISTING SURFACE. REINSTALL EXISTING RETURN GRILLE, AND REINSTALL IN NEW CEILING.

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CITY SCHOOL DISTRICT OF NEW ROCHELLE
ALBERT LEONARD MIDDLE SCHOOL
2023 CAPITAL PROJECTS - PHASE 1



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Sheet Title

Mechanical
New Work Plan

Sheet No. **ALMS**
M101

CONSTRUCTION DOCUMENTS

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CITY SCHOOL DISTRICT OF NEW ROCHELLE
ALBERT LEONARD MIDDLE SCHOOL
2023 CAPITAL PROJECTS - PHASE 1

Project Title
<div style="text-align: center;">  EXP: 11/30/2025 </div>

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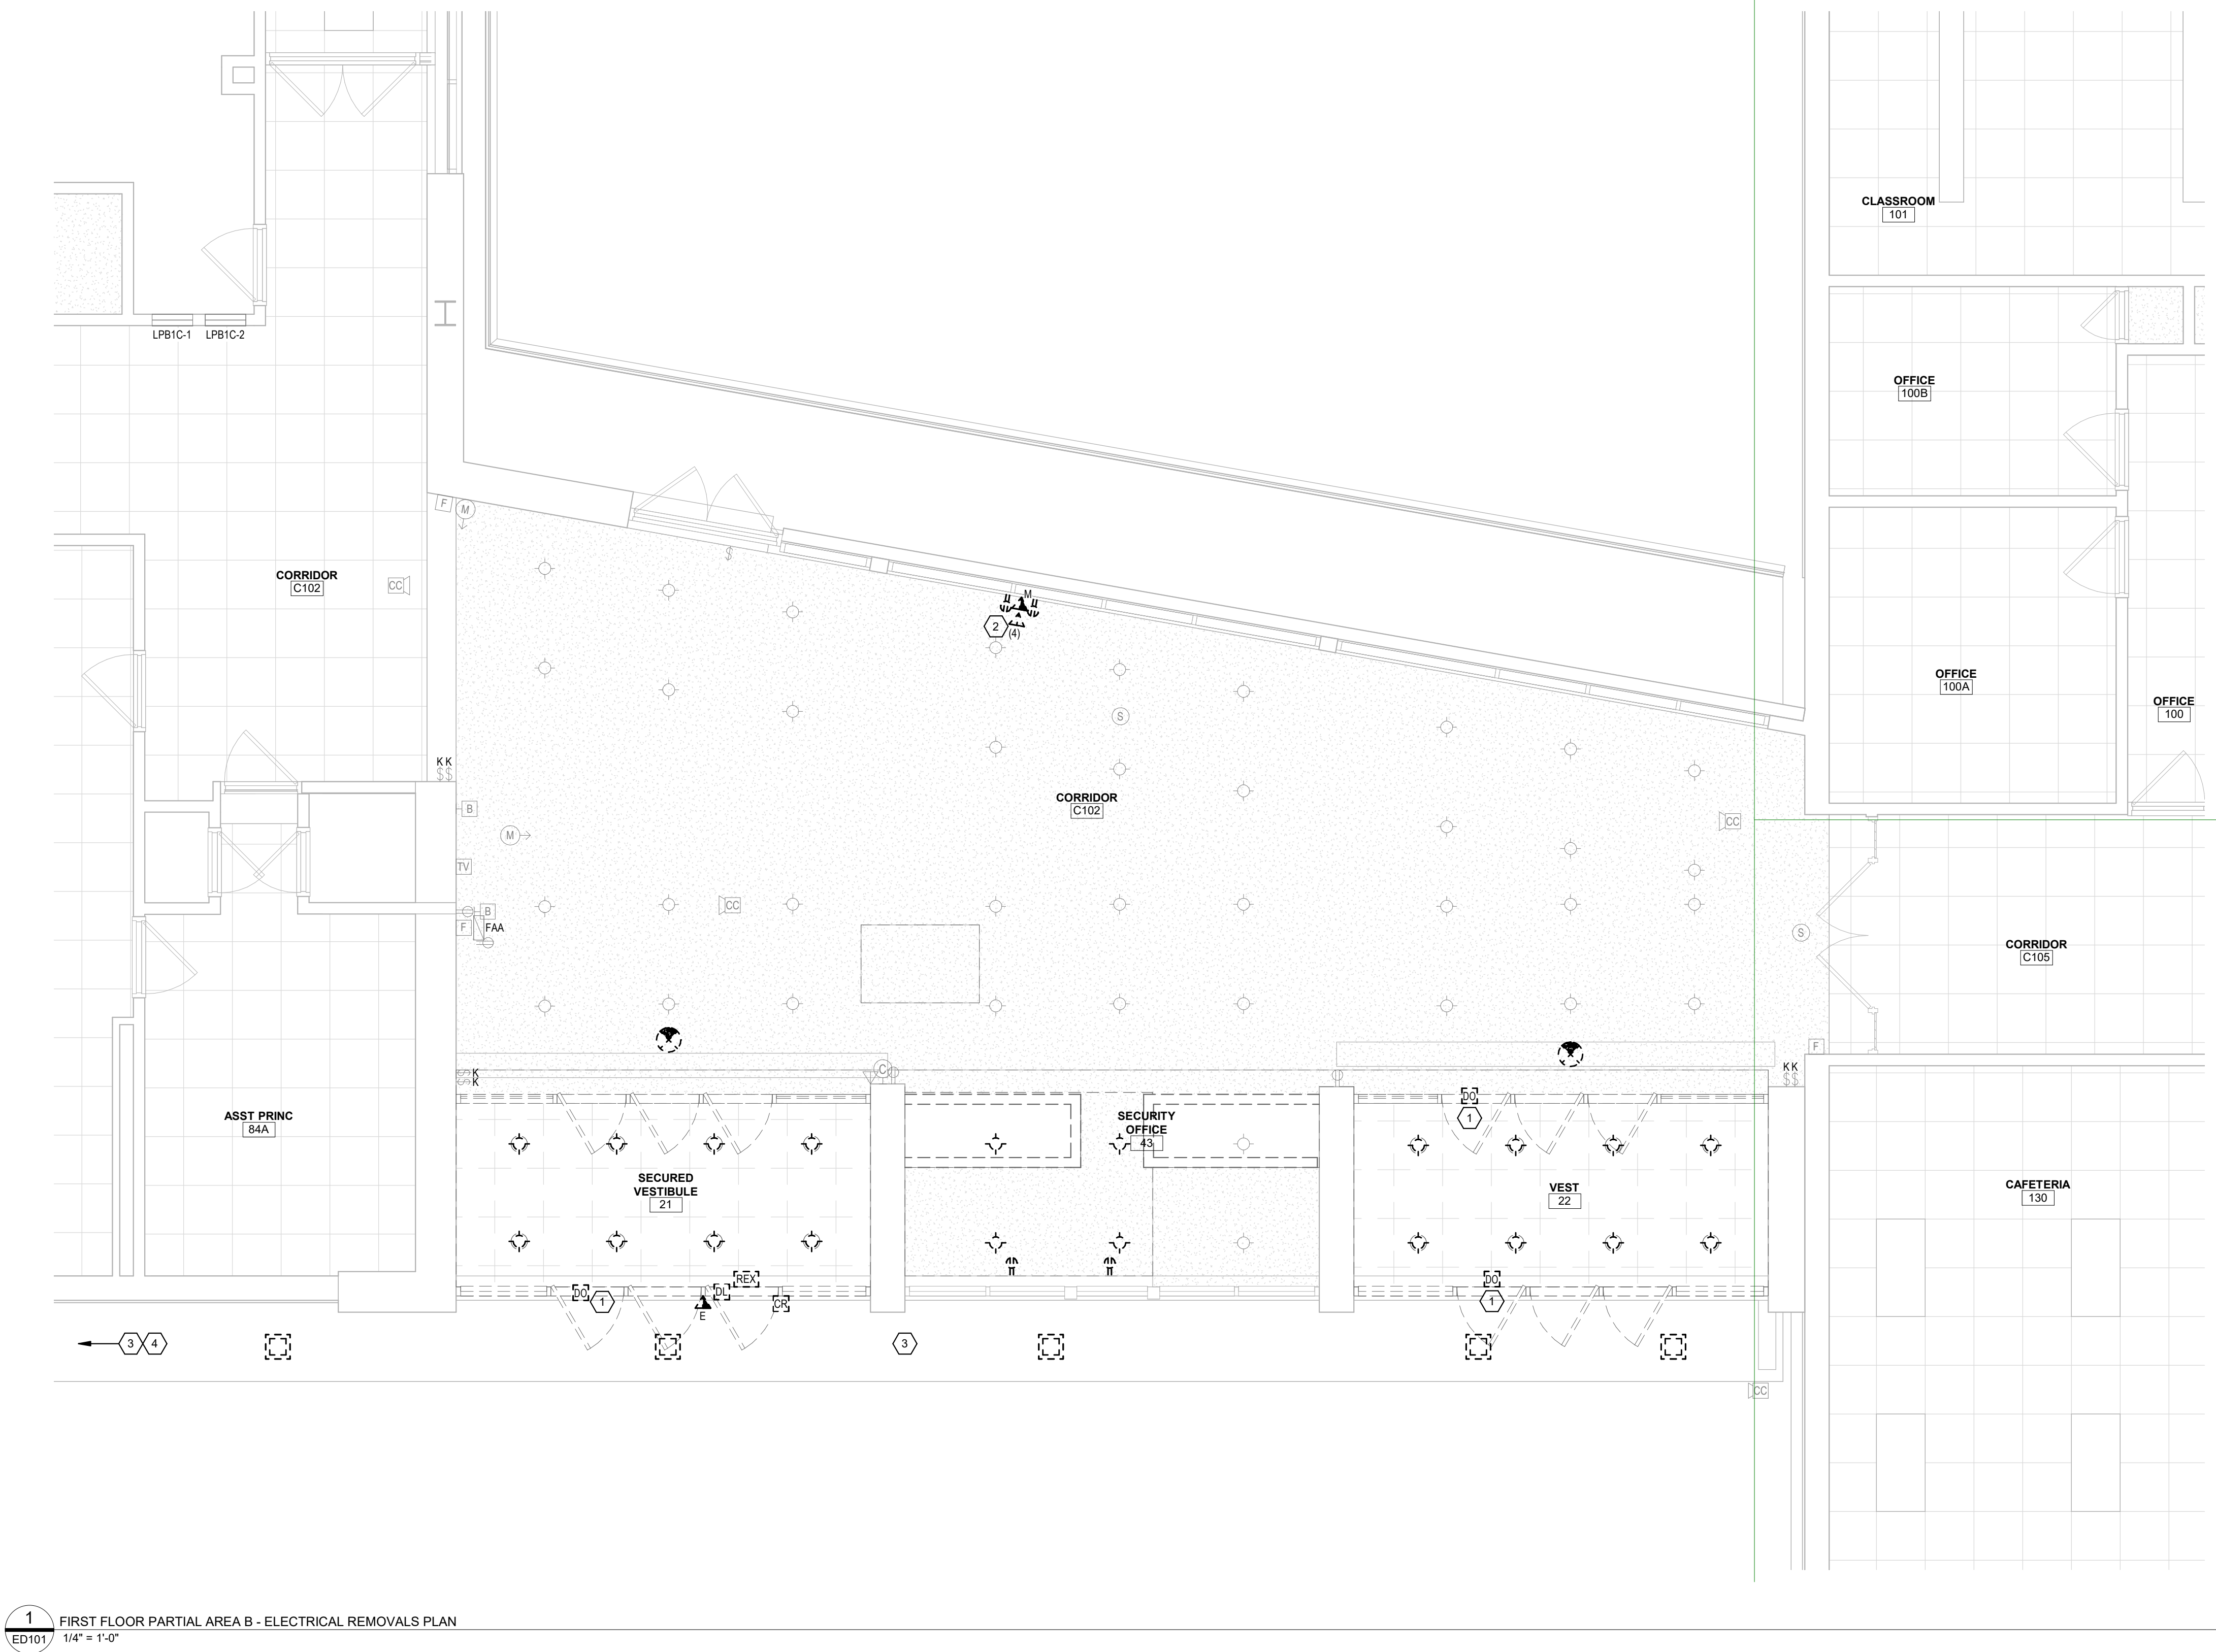
ELECTRICAL
LEGEND AND
ABBREVIATIONS

Sheet No.

ALMS
E001

CONSTRUCTION DOCUMENT

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1 FIRST FLOOR PARTIAL AREA B - ELECTRICAL REMOVALS PLAN
ED101 1/4" = 1'-0"


GENERAL NOTES

- A. SCOPE: ELECTRICAL REMOVALS PLAN INDICATES GENERAL SCOPE OF ELECTRICAL REMOVALS WORK, BUT DOES NOT SHOW ALL ELEMENTS OF SAME. PROVIDE ALL ELECTRICAL DISCONNECTIONS AND REMOVALS WORK INDICATED ON DRAWINGS, REQUIRED BY THE SPECIFICATIONS, AND THAT ARE REASONABLY REQUIRED FOR SUCCESSFUL PROJECT COMPLETION.
- B. LIGHT/GRAY LINES: INDICATE EXISTING ELECTRICAL ITEMS TO REMAIN, UNLESS INDICATED OTHERWISE.
- C. BLACK DASHED LINES: REMOVE ALL ELECTRICAL ITEMS SHOWN WITH BLACK DASHED LINES UNLESS INDICATED OTHERWISE. REMOVE ALL ASSOCIATED WIRING AND ALL WIRING WHICH IS OR WILL NO LONGER BE IN USE. REMOVE ALL EXISTING CONDUITS, BOXES, STRAPS, ETC. WHICH WILL NO LONGER BE IN USE.
- D. "BX" INDICATES RELOCATE EXISTING ELECTRICAL ITEM. SEE DRAWING E101 FOR CORRESPONDING NEW LOCATION.
- E. EXISTING BRANCH CIRCUITS DISCONNECTED: GENERALLY RETAIN EXISTING 120V AND 200V BRANCH CIRCUITS BEING DISCONNECTED AS PART OF REQUIRED ELECTRICAL REMOVALS WORK. REUSE SAME PER DWG. E101. FOR ANY SUCH DISCONNECTED EXISTING CIRCUITS NOT BEING REUSED, REMOVE COMPLETE BACK TO SOURCE.

KEYED NOTES

- 1 DISCONNECT EXISTING DOOR OPERATOR FOR REMOVAL. RETAIN EXISTING 120V, 20A CIRCUIT FOR REUSE IN SECURED VESTIBULE 21 PER DWG. E101.
- 2 REMOVE EXISTING POWER/TELECOM RACEWAY STRIP AND ALL ASSOCIATED RECEPITS, OUTLETS AND WIRING, ETC.
- 3 DISCONNECT AND REMOVE EXISTING SURFACE LIGHTING FIXTURES ALONG SOFFIT. RETAIN EXISTING 120V LIGHTING CIRCUIT FOR REUSE PER DWG. E101.
- 4 DISCONNECT AND REMOVE APPROXIMATELY EIGHT ADDITIONAL FIXTURES ALONG SOFFIT (NOT SHOWN).

KEY PLAN

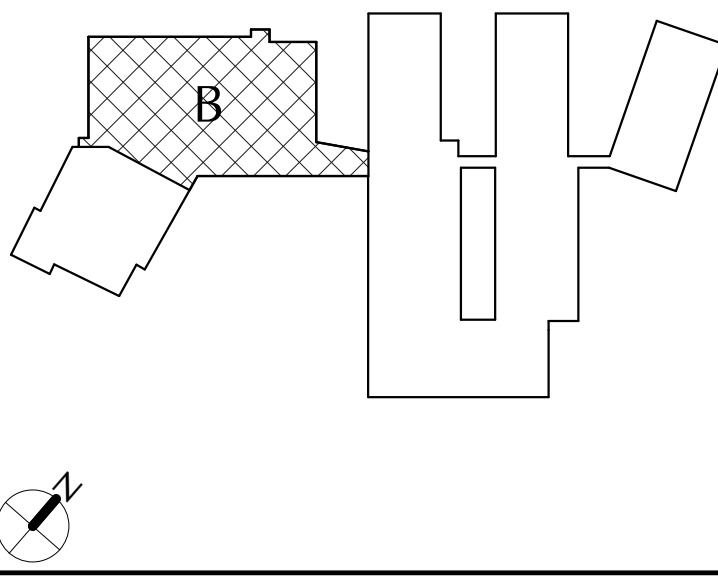

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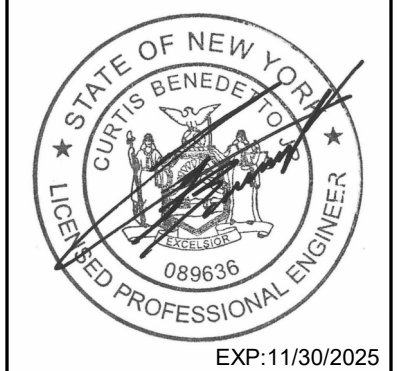
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Project Title



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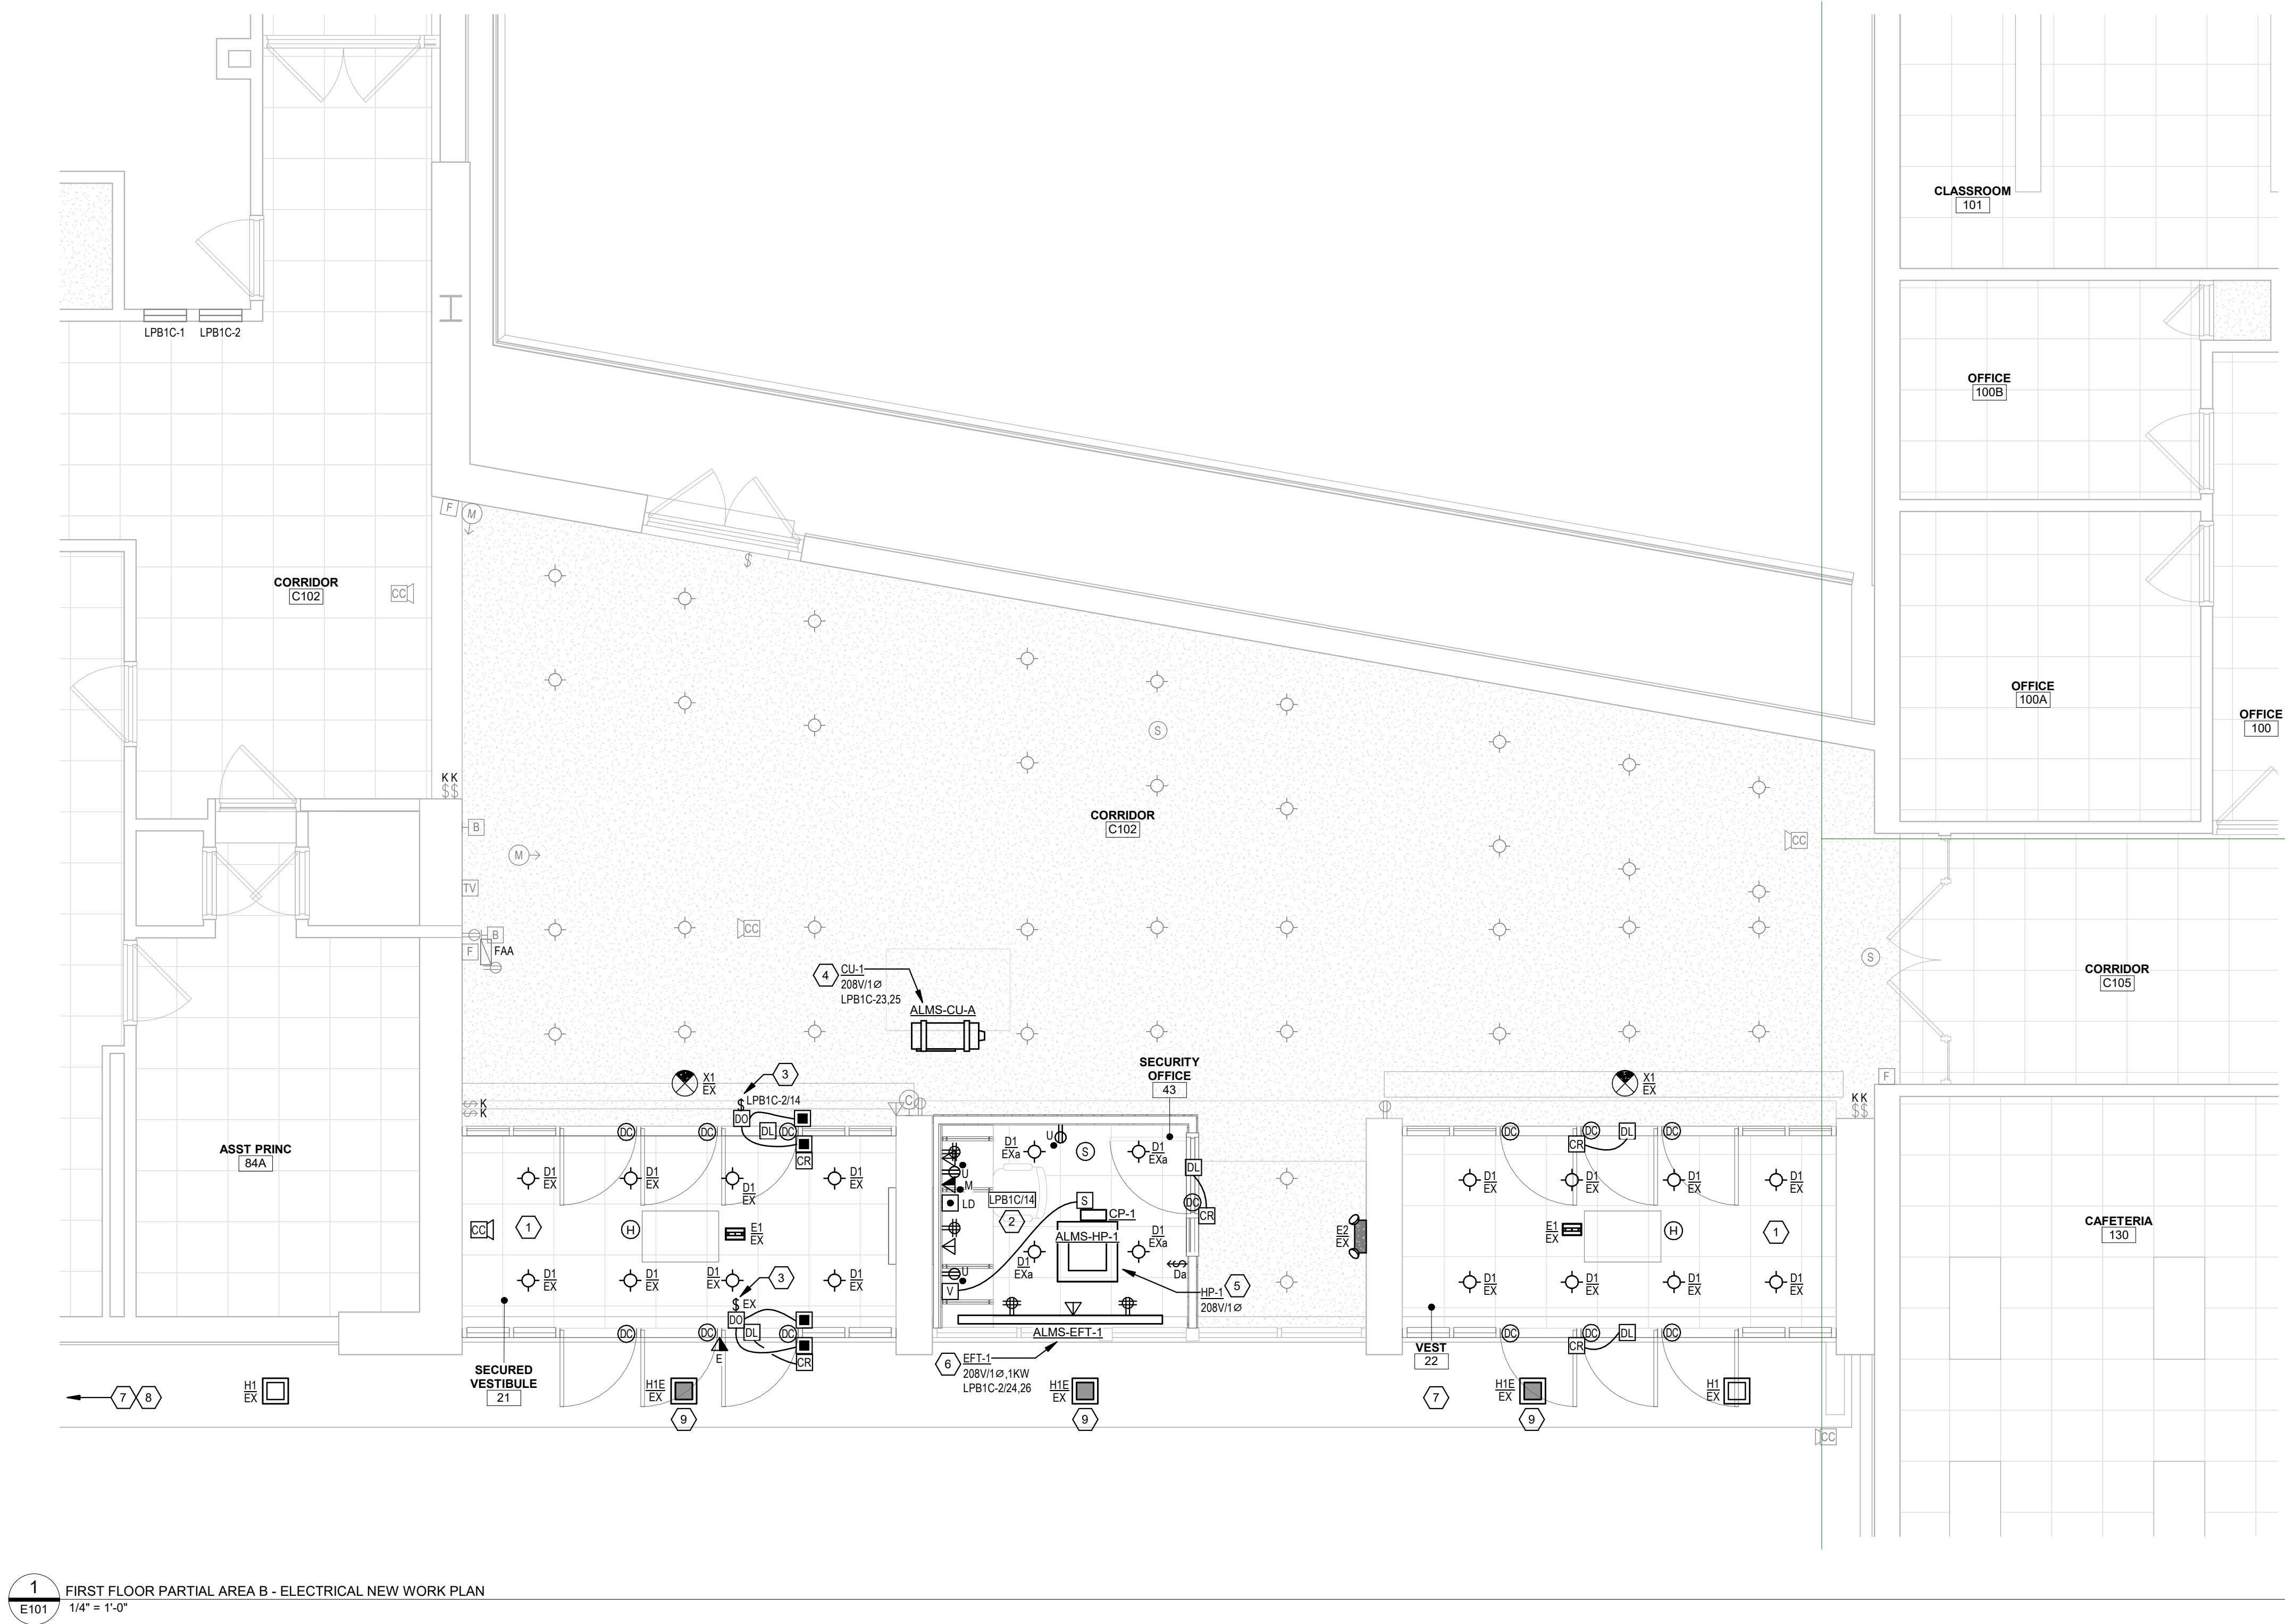
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Sheet Title
FIRST FLOOR
AREA B
ELECTRICAL
REMOVALS
PLAN

Sheet No.
ALMS
ED101

CONSTRUCTION DOCUMENTS

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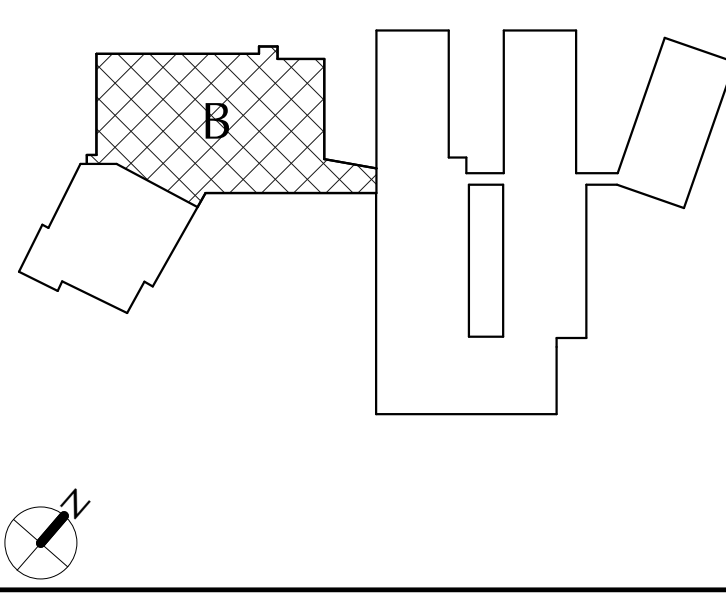
GENERAL NOTES

- LIGHT/GRAY LINES: INDICATE EXISTING ELECTRICAL ITEMS TO REMAIN, UNLESS INDICATED OTHERWISE.
- SOLID BLACK LINES: INDICATE ELECTRICAL NEW WORK, UNLESS INDICATED OTHERWISE.
- *NC: INDICATES NEW LOCATION FOR EXISTING ELECTRICAL ITEM. RECONNECT PER ORIGINAL UNLESS INDICATED OTHERWISE. EXTEND CIRCUITING IF NECESSARY. SEE DWG ED101 FOR ORIGINAL LOCATION.
- *EX: INDICATES CONNECT TO EXISTING 120V, 20A LIGHTING OR RECEPTACLE CIRCUIT (AS INDICATED) IN ROOM/VICINITY. EXTEND CIRCUITING AS REQUIRED.
- BRANCH CIRCUITS: ALL BRANCH CIRCUITS TO BE 12/2, 2P12 & 1P12G OR EQUIVALENT TYPE "MC" CABLE WHERE PERMITTED BY SPECS. 90001. UNLESS INDICATED OR REQUIRED OTHERWISE BY NEC.
- FIRE ALARM INITIATING DEVICES: CONNECT TO EXISTING FIRE ALARM INITIATING/CONTROL LOOP IN VICINITY (CONFIRM ADEQUATE CAPACITY).
- FIRE ALARM NOTIFICATION DEVICES: CONNECT TO EXISTING FIRE ALARM NOTIFICATION CIRCUIT(S) IN VICINITY (CONFIRM ADEQUATE CAPACITY).
- TELECOM OUTLETS: FOR EACH, PROVIDE 4" SQUARE 2-2 1/2" DEEP BOX WITH SINGLE-GANG EXTENSION RING AND BLANK COVERPLATE, AND 3/4" C. FROM BOX STUBBED UP TO NEAREST ACCESSIBLE CEILING SPACE. REAM AND BUSH CONDUIT STUB AND PROVIDE NYLON PULL STRING. TELECOM CABLEING AND JACK(S) TO BE PROVIDED SEPARATELY BY OWNER OR OWNER'S VENDOR. COORDINATE ALL WORK AS REQUIRED.
- SECURITY SYSTEMS DEVICES/STATIONS: FOR EACH, PROVIDE MINIMUM 4" SQUARE X 2-1/2" DEEP BOX WITH SINGLE-GANG EXTENSION RING AND BLANK COVERPLATE, AND 3/4" C. FROM BOX STUBBED UP TO NEAREST ACCESSIBLE CEILING SPACE. REAM AND BUSH CONDUIT STUB AND PROVIDE NYLON PULL STRING. CONFIRM REQUIRED OUTLET BOX SIZE WITH OWNER'S SELECTED SECURITY SYSTEMS VENDOR AND PROVIDE BIGGER OR SPECIAL OUTLET BOX IF REQUIRED. SECURITY DEVICES/STATION AND REQUIRED CABLEING TO BE PROVIDED SEPARATELY BY OWNER'S SELECTED SECURITY SYSTEMS CONTRACTOR/VENDOR. COORDINATE ALL WORK AS REQUIRED.
- *NX: INDICATES NEW LOCATION FOR EXISTING ELECTRICAL ITEM (SEE DWG. ED101 FOR ORIGINAL LOCATION). CLEAN, CHECKOUT, REINSTALL AND RECONNECT ITEM PER ORIGINAL. EXTENDING EXISTING CIRCUITING IN KIND AS REQUIRED.

KEYED NOTES

- CONNECT VESTIBULE LIGHTS TO EXISTING KEY SWITCH (CONFIRM SWITCH LOCATION). EXCEPT CONNECT EMERGENCY LIGHTING UNIT TO SAME CIRCUIT, AHEAD OF SWITCH.
- CONNECT ALL RECEPITS IN THIS ROOM TO INDICATED EXISTING 120V, 20A/1P SPARE (FIELD CONFIRM) CIRCUIT BREAKER IN EXISTING PANELBOARD.
- CONNECT DOOR OPERATOR TO EXISTING 120V, 20A/1P DOOR OPERATOR CIRCUIT MADE AVAILABLE FROM REMOVALS WORK IN VESTIBULE 22 (SEE DWG. ED101). PROVIDE 120V, 1-POLE TOGGLE SWITCH DISCONNECT FOR DOOR OPERATOR. PROVIDE OUTLET BOX FOR REMOTE PUSH PLATE STATION AND 1/2" C. FROM DOOR OPERATOR TO PUSH PLATE BOX. CONTROL WIRING TO BE PROVIDED BY DMV. 8.
- CONNECT A/C CONDENSING UNIT TO NEW 208V, 20A/2P CIRCUIT BREAKER IN EXISTING PANELBOARD. (REMOVE EXISTING CIRCUIT BREAKERS IN SAME POLE POSITIONS; FIELD CONFIRM SPARE).
- CONNECT HEAT PUMP TO RESPECTIVE A/C CONDENSING UNIT USING 12" C., 2P12 & 1P12G. PROVIDE 200V, 2-POLE TOGGLE SWITCH DISCONNECT FOR HEAT PUMP.
- CONNECT ELECTRIC FIN TUBE HEATER TO INDICATED NEW 208, 20A/2P CIRCUIT BREAKER IN EXISTING PANELBOARD. REMOVE EXISTING CIRCUIT BREAKERS IN SAME POLE POSITIONS; FIELD CONFIRM SPARE).
- CONNECT ALL NEW TYPE "H1, H1E" FIXTURES TO EXISTING 120V SOFFIT LIGHTING CIRCUIT.
- PROVIDE AND CONNECT APPROXIMATELY EIGHT ADDITIONAL TYPE "H1" SOFFIT LIGHTS (NOT SHOWN).
- PROVIDE "CONSTANT-ON" CIRCUIT WIRING FOR EMERGENCY FIXTURE, SO THAT FIXTURE REMAINS OFF WHEN NORMALLY CONTROLLED OFF AND POWER IS AVAILABLE.

KEY PLAN



CITY SCHOOL DISTRICT OF NEW ROCHELLE
ALBERT LEONARD MIDDLE SCHOOL
2023 CAPITAL PROJECTS - PHASE 1

Project Title



DATE	DESCRIPTION

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Sheet Title
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E101

CONSTRUCTION DOCUMENTS