

	SAND AND OIL SEPARATOR CALCULATIONS				
,	NUMBER OF PARKING SPACES	10			
>	1-3 VEHICLES	6 CU. FT.			
,	1 ADDITIONAL CU. FT. PER VEHICLE UP TO 10 VEHICLES	7 CU. FT.			
>	0.15 ADDITIONAL CU. FT. PER VEHICLE ABOVE 10 VEHICLES	0 CU. FT.			
	CU. FT. REQUIREMENT	13 CU. FT.			
, >	GAL. REQUIREMENT	97 GAL.			

GREASE INTERCEPTOR CALCULATIONS (2018 UPC)				
<u>FIXTURE</u>	QUANTITY	DRIANAGE F.U.	TOTAL DRIANAGE F.U.	
DISHWASHER	1	2.0	2.0	
FLOOR DRAIN	1	2.0	2.0	
COMMERCIAL SINK W/ FOOD WASTE	1	3.0	3.0	

MINIMUM GREASE INTERCEPTOR SIZE (TABLE 1014.3.6) = 750

PLUMBING CONTRACTOR RESPONSIBLE

FOR ALL GAS PIPING AFTER OUTLET OF

GAS PRESSURE

STOP VALVES

(TYPICAL OF 2)

DIELECTRIC UNION (TYPICAL OF 2)

SPECIFICATIONS. DO NOT

INTERFERE WITH ADA

REQUIREMENTS.

PIPE 3/4" ASME P&T

2 POINT OF USE WATER HEATER

3" PVC INTAKE

RELIEF TO FLOOR DRAIN

MOUNT WATER HEATER TO WALL

150 MBH GAS

INPUT SEE PLANS

1.5" HW OUT

ASME P&T

150 MBH

RELIEF PIPED

TO 1" ABOVE <u>FD</u>

PAN DRAIN

PIPED TO FD

PLUG

FOR SIZE AND

LAYOUT

ACCORDING TO MANUFACTURERS

REGULATOR

SERVICE TERMINAL

FINISHED GRADE

VALVE

GAS LINE

LOCAL UTILITY

GAS METER INTO BUILDING. SEE PLANS

FOR SIZE AND CONTINUATION

TOTAL D.F.U = 9.0

ISOLATION VALVE

SEE PLANS FOR CONTINUATION

NEW GAS METER

GAS PIPING TO BUILDING, GAS

REGULATOR, AND GAS METER

NOTE: WATER HEATER MAXIMUM

HAVING JURISDICTION

ADJUSTABLE

AQUASTAT

SET TO 130°

3" CPVC VENT UP THROUGH

ROOF OR SIDEWALL TO

TEMPERATURE PROBE

WATER HEATER DETAIL

APPROVED TERMINATION

COMBUSTION CONDENSATE DRAIN PIPED TO

1" ABOVE FD. PROVIDE CONDENSATE PUMP

AND ACID NEUTRALIZATION AS REQUIRED.

GALVANIZED PAN SOLDERED WATER

TIGHT. 4" DEEP. (OR EQ. PER CODE)

GAGE AS APPROVED BY STRUCTURAL

SETPOINT LIMIT TO BE 110°F. PROVIDE

THERMOSTATIC MIXING VALVE WHEN HIGHER TEMPERATURES ARE POSSIBLE

OR AS REQUIRED BY LOCAL AUTHORITY

CHECK VALVE

VACUUM RELIEF

WATTS #N36 (ABV.

TOP OF HEATER)

FLOOR -


CONTRACTOR TO VERIFY COMBUSTION


AIR INTAKE AND VENT ARE PROVIDED

GAS METER DETAIL SCALE N.T.S.

3/4" CHECK VALVE

HAND SINK

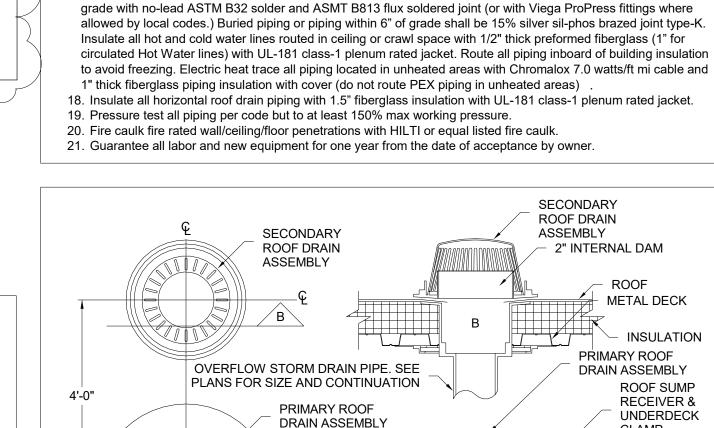

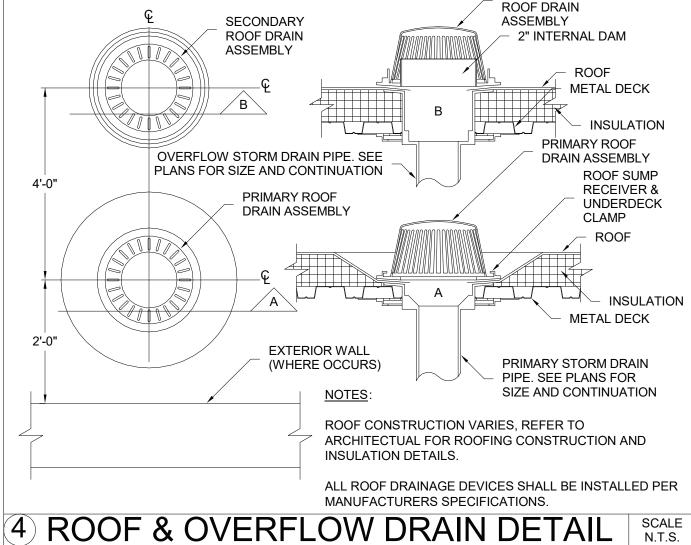

SPECIFICATIONS

1. Follow all Local and state codes/ordinances and general conditions of contract. Pay all required fees and obtain all

required permits. Submit these plans to building department for plan review. Implement all code review required

3. Visit site to verify existing conditions prior to ordering equipment, providing price quote or fabricating piping.

4. Plumbing drawings are schematic and not to be scaled. Refer to architectural, certified drawings, and site

5. Contractor shall purchase, receive, uncrate, assemble, insure, and install in conformance to manufacturer's

6. Provide 2 operating manuals to owner and engineer for all systems and equipment including manufacturer's

8. Sleeves shall be provided for all pipe through walls, floors, and ceilings. Provide chrome plated escutcheons for

Prevention Data Sheet 3-11; Pressure Reducing Valves. Immediately after installation and once a year after that,

conduct a full flow test on the valve. The annual performance Test Record of Pressure Reducing Valves Form

12. Electrical: confirm voltage, phase, and ampacity with electrical contractor prior to ordering equipment. All 24v

all 3-phase motors with protection on all three leads. Electrical equipment to automatically restart after power

13. Excavate for all mechanical work. Compact to 95% AASHO or proctor density in 6" maximum lifts at optimum

14. Valves shall be provided to isolate each piece of equipment and for all rough-ins excluding waste and vent.

Water valves shall be Apollo ball valve line-size rated for 200 psig wog. Gas valves shall be AGA listed line-size

15. Waste and vent piping shall be cast iron no-hub listed for location installed. Schedule-40 plastic PVC may be

16. Pipe each evaporative pan drain with p-trap 3/4" minimum to waste. Provide condensate pumps as required

17. Water piping shall be type-L copper (or approved PEX piping and fittings where allowed by local codes) above

a total cross sectional area to equal to or greater than building sewer main shall be provided.

used if code approved. Provide cleanouts 50'-0" min oc of appropriate type inside buildings. Vent through roof with

where gravity drain condensate is not possible. Provide condensate acid neutralization for all condensate drains to

controls including interlock wiring for plumbing equipment by division 15 contractor. Provide magnetic starters for

11. Any pressure reducing valves should be arranged, tested, and maintained per FM Global Property Loss

recommendations all Plumbing equipment. Plumbing Contractor shall install and final connect owner furnished

maintenance manuals. Include lubrication, filter types and sizes, starting and stopping procedures. List contractor's

2. Equipment, insulation and controls shall be provided as required by the Adopted energy code.

7. Supports and anchors shall be provided for plumbing work. No chain, tape, or wire.

10. Cut and patch to match adjacent areas. No structural member shall be cut or notched.

changes into installation.

equipment as indicated.

piping penetrations in finished areas.

2707 should be used for all full flow tests.

failure. All wire in conduit per NEC latest edition.

moisture content. Rework if any settlement within first years guarantee.

9. Conceal all work in finished areas.


telephone numbers.


lubricated.


sanitary sewer.


Change orders for non-compliance will not be accepted.

measurements for all dimensions prior to duct and piping fabrication.

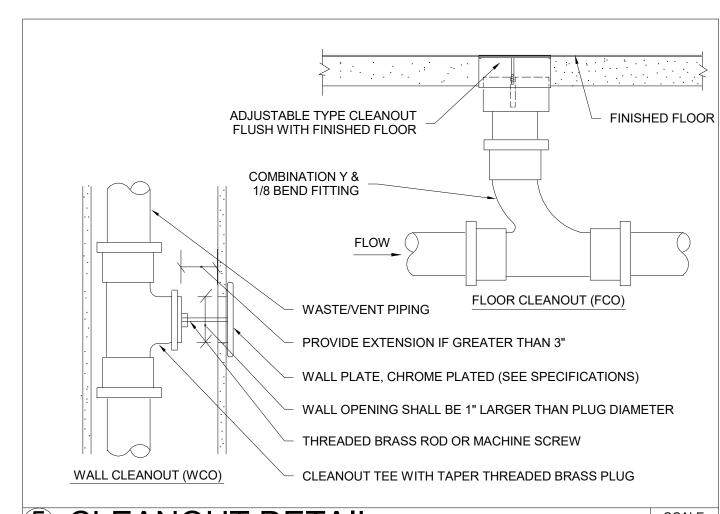

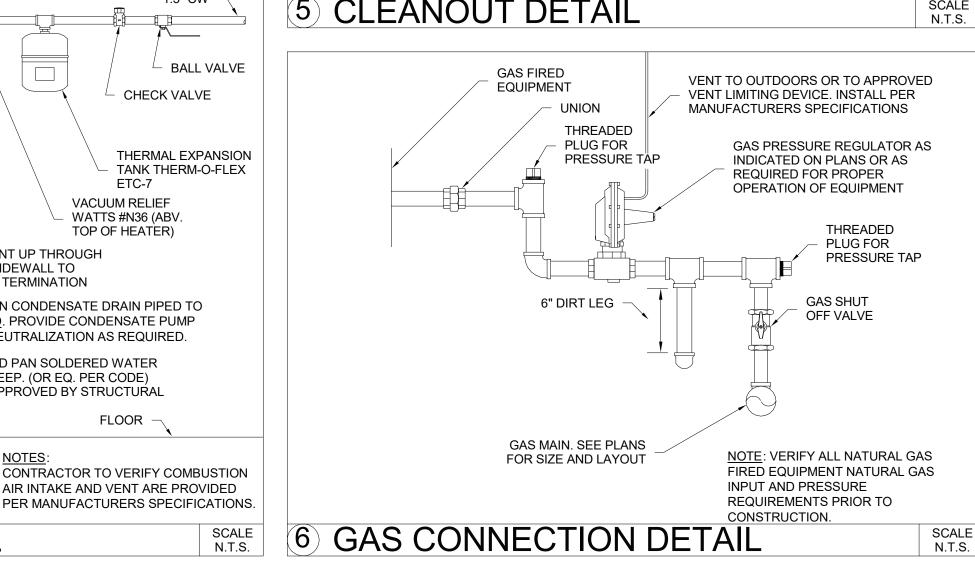

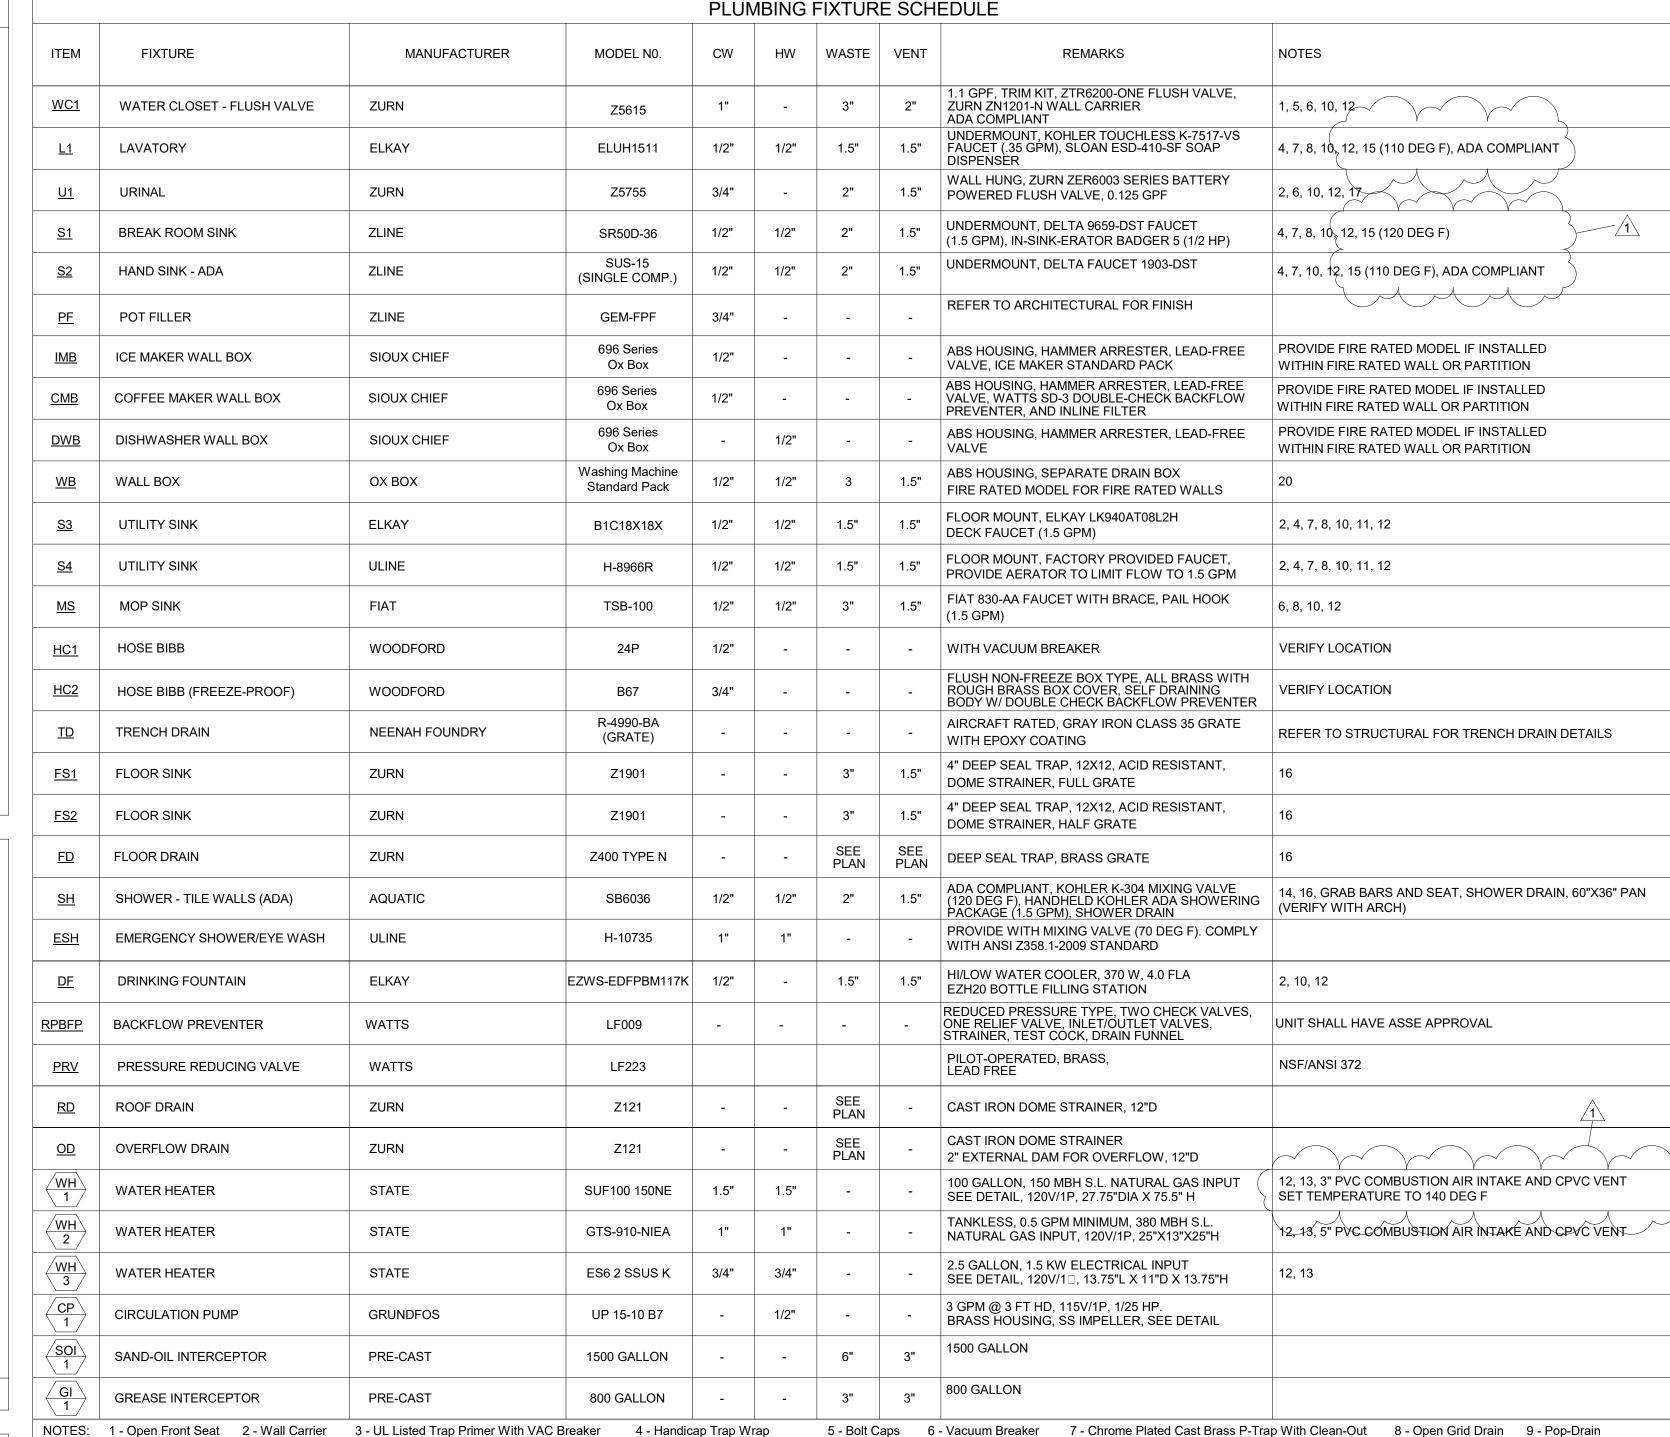


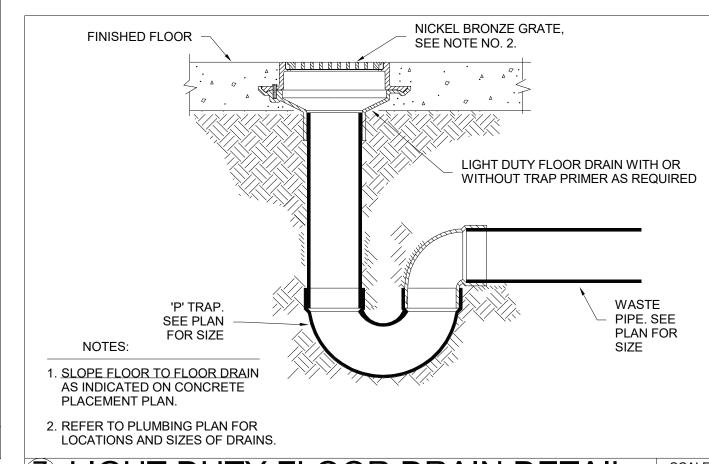


OVER FLOOR DRAIN FUNNEL FROM 1.5" METER AND 1.5" TAP. ') LIGHT DUTY FLOOR DRAIN DETAIL | SCALE | 9 WATER ENTRY DETAIL

10 - Angle Supply With Stops 11 - 1/2 GPM Flow Limiters 12 - Anchors, Supports Trim Complete 13 - UL and AGA Listed, Reg Stat. High Limit Safety, ASME P&T Relief To Drain, ASHRAE 90A80 Insulation 14 - 2.5 GPM Flow Limiters

15 - Provide Thermostatic Mixing Valve 16 - Provide UL Listed Trap Primer With VAC Breaker or ASSE Certified Trap Seal Where Required 17 - Water Hammer Arrester (HA1), Sioux Chief Hydra-Rester Part No. 652-AS, 1/2" male sweat, 1-11 water supply units

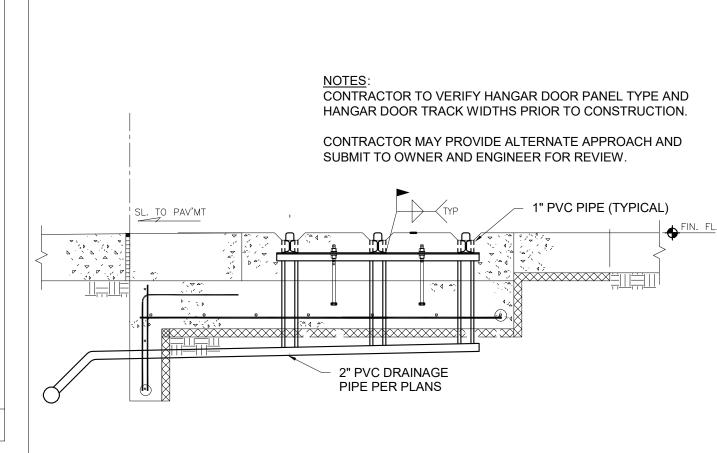

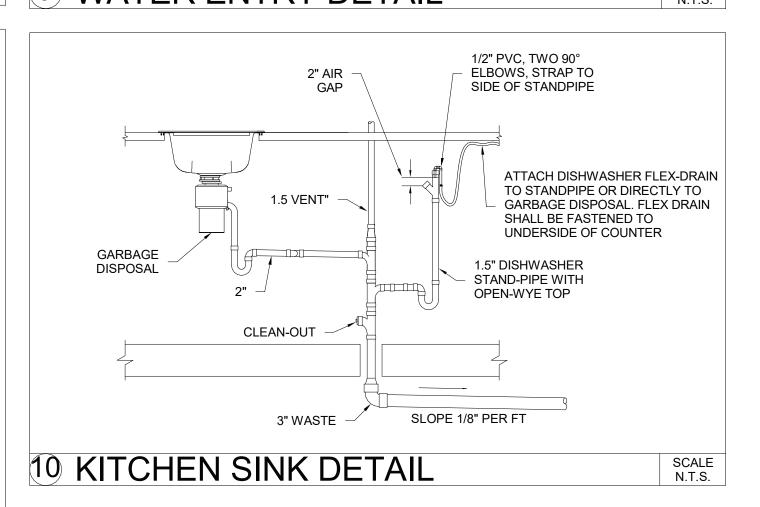

STRAINER

OPTIONAL IRRIGATION SUPPLY TAP LOCATION: REFER TO

LANDSCAPING PLANS BY OTHERS FOR IRRIGATION SUPPLY LOCATION, SIZE, AND CONTINUATION. PROVIDE BACKFLOW

PREVENTER AS REQUIRED. VERIFY IRRIGATION DOES NOT HAVE A

ROUTE DRAIN WITH AIR GAP

TO BUILDING

ENLARGE TO 2"

SERVICE AT

DOMESTIC WATER

ISOLATION VALVE

DEDICATED TAP & METER PRIOR TO CONSTRUCTION PER LEED

127 W. FAIRBANKS AVENUE, SUITE 140 WINTER PARK, FL 32789 (PH): 407-739-9000



8201 SHAFFER PARKWAY SUITE A LITTLETON, COLORADO 80127 303.991.0991



REVISIONS DATE DESCRIPTION PERMIT COMMENTS

Key Plan

SIGNATURE STEWART (SWF) HANGAR

1188 1ST STREET, NEW WINDSOR, NY 12553




SIGNATURE FLIGHT SUPPORT 13485 VETERANS WAY, SUITE 600 ORLANDO, FLORIDA 32827

ISSUE DATE: 06/12/2024 COMM. NO.: 2023-177


DRAWN BY: JH CHECKED BY: DL/RS


PLUMBING DETAILS AND SCHEDULES

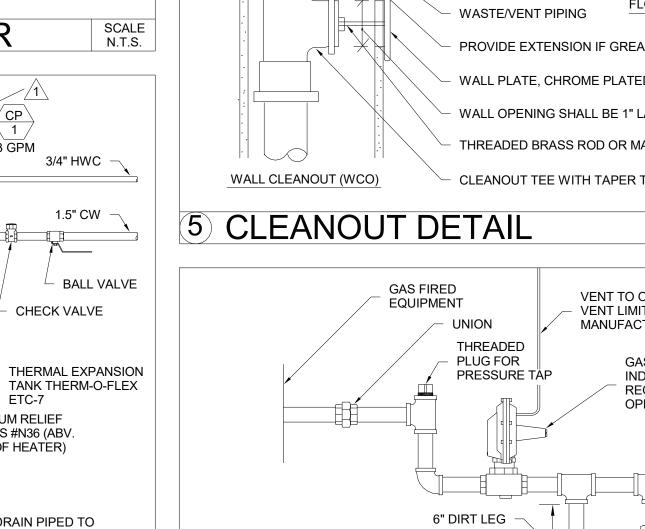



8 HANGAR DOOR TRACK DRAIN SCALE N.T.S.

6/28/2024 9:48:15 AM Autodesk Docs://23715 - SWF Terminal and Hangar (Halle House)/2023-177-SFS SWF HANGAR-M&P-CENTRAL-R23.rvt

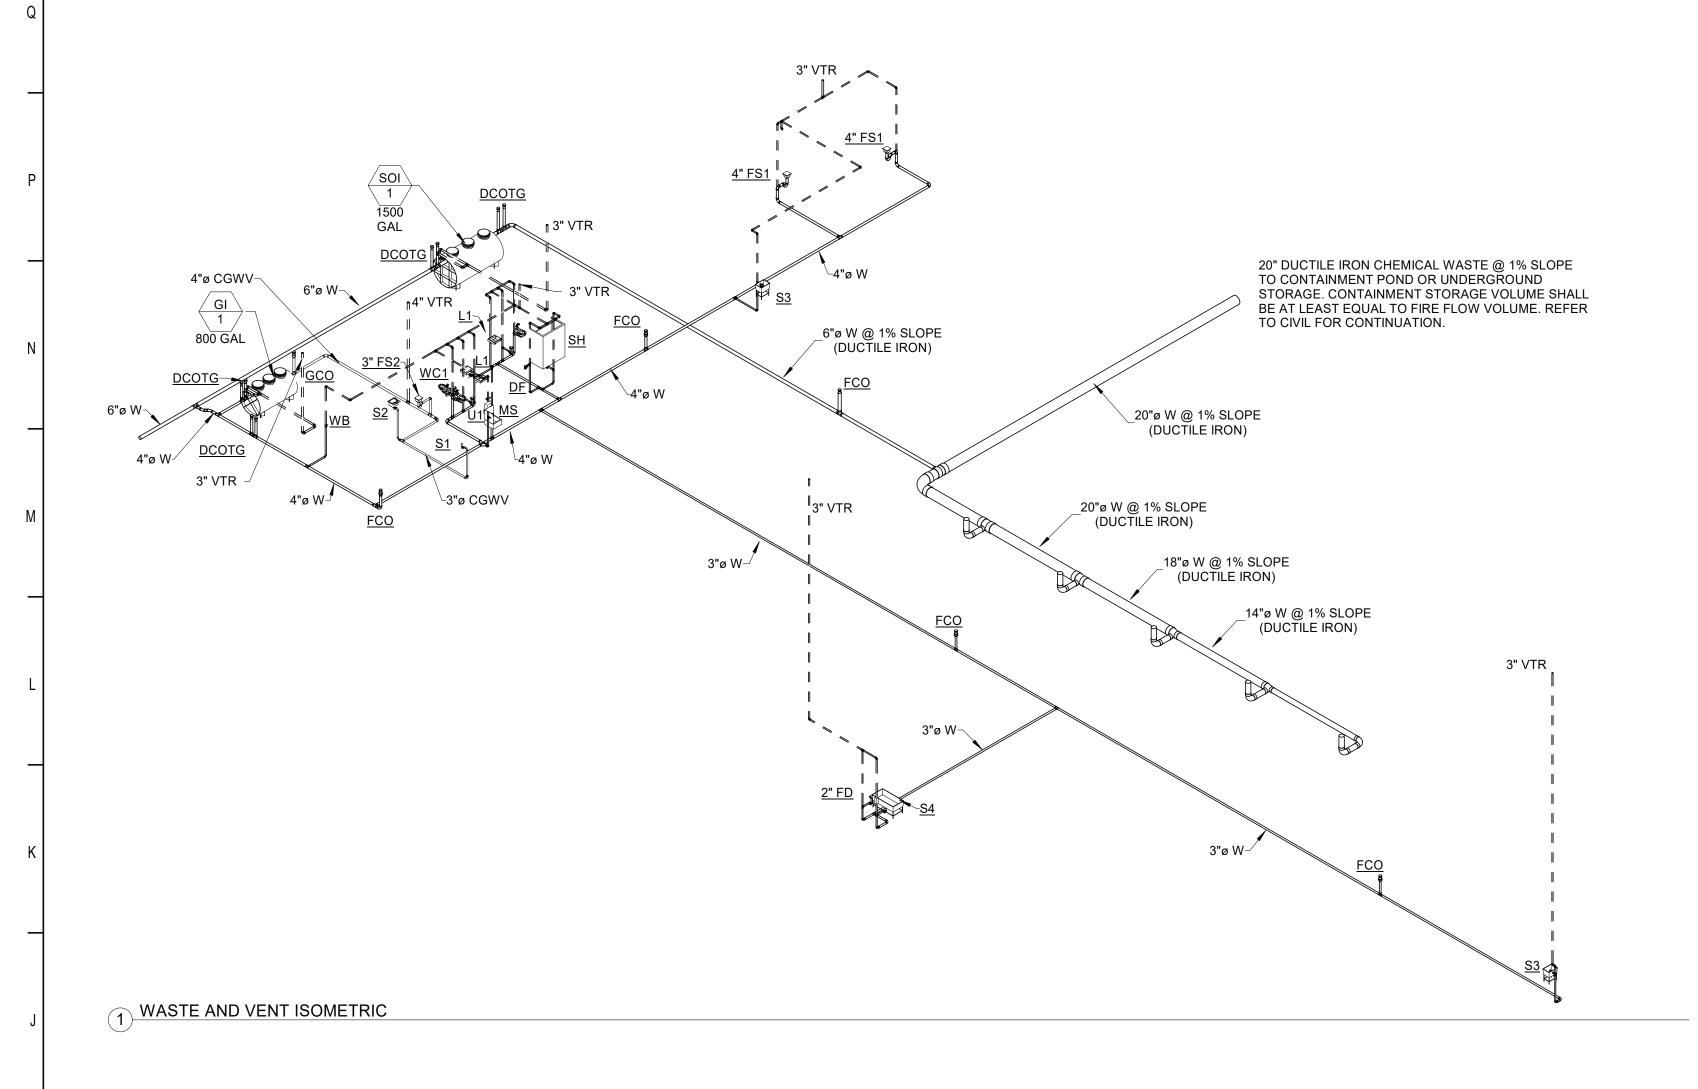

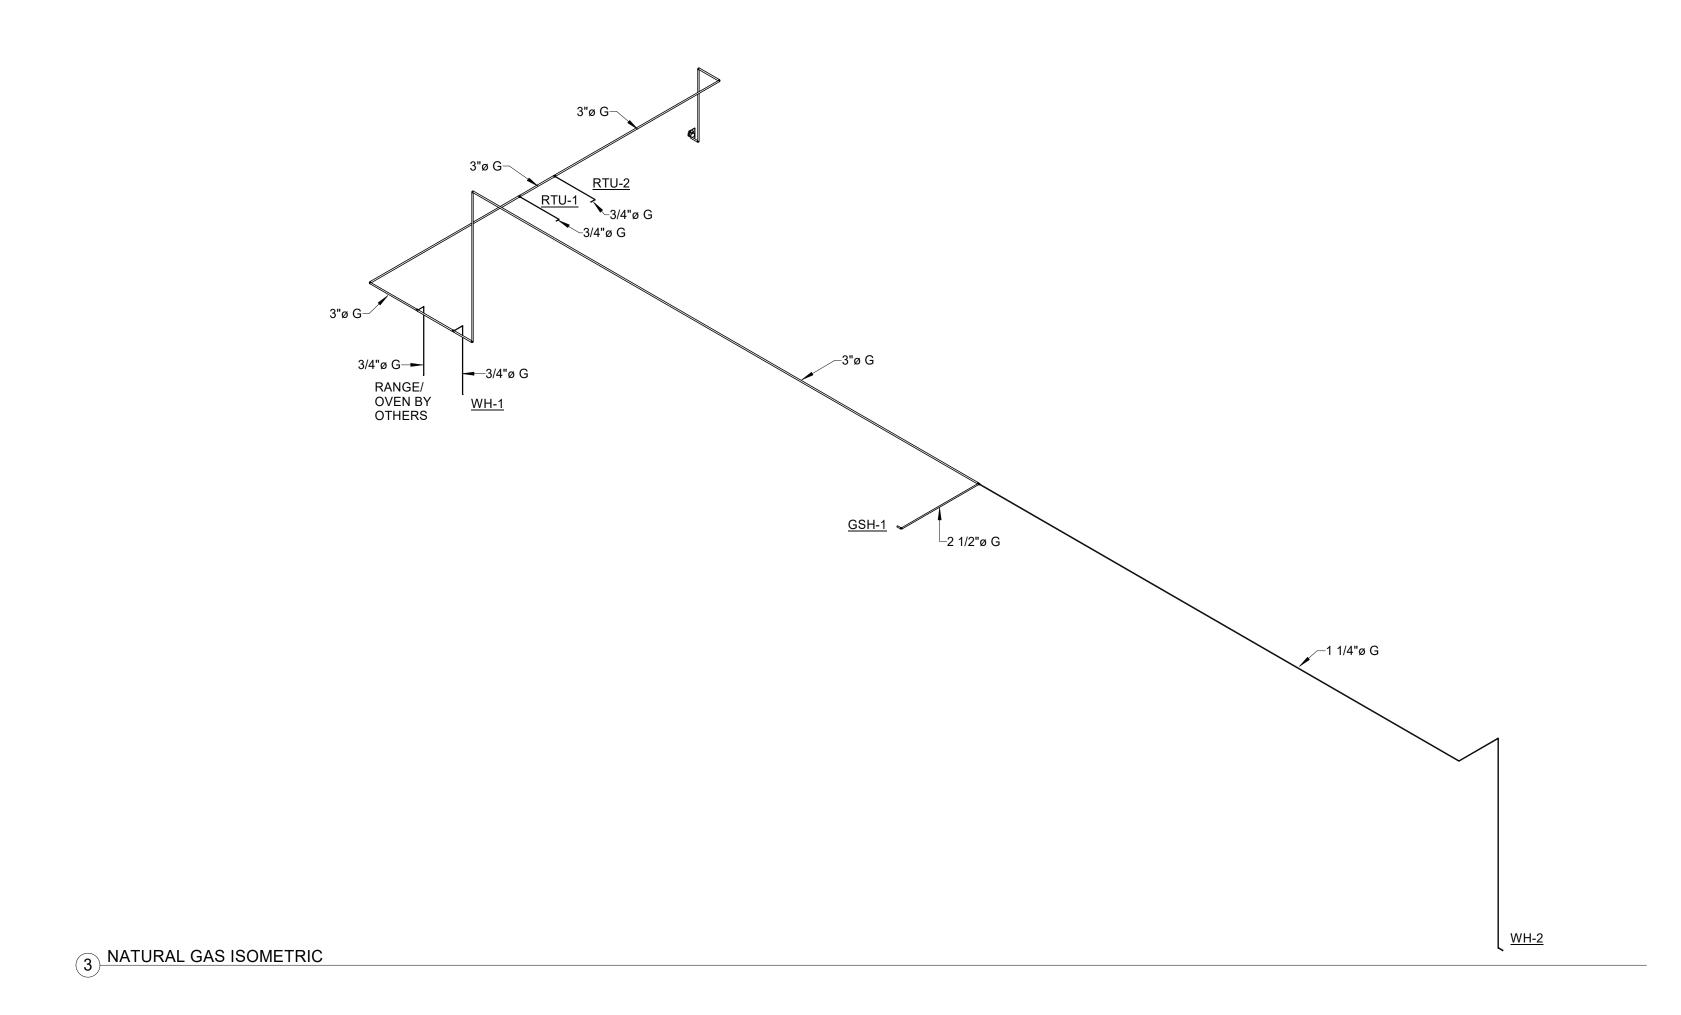

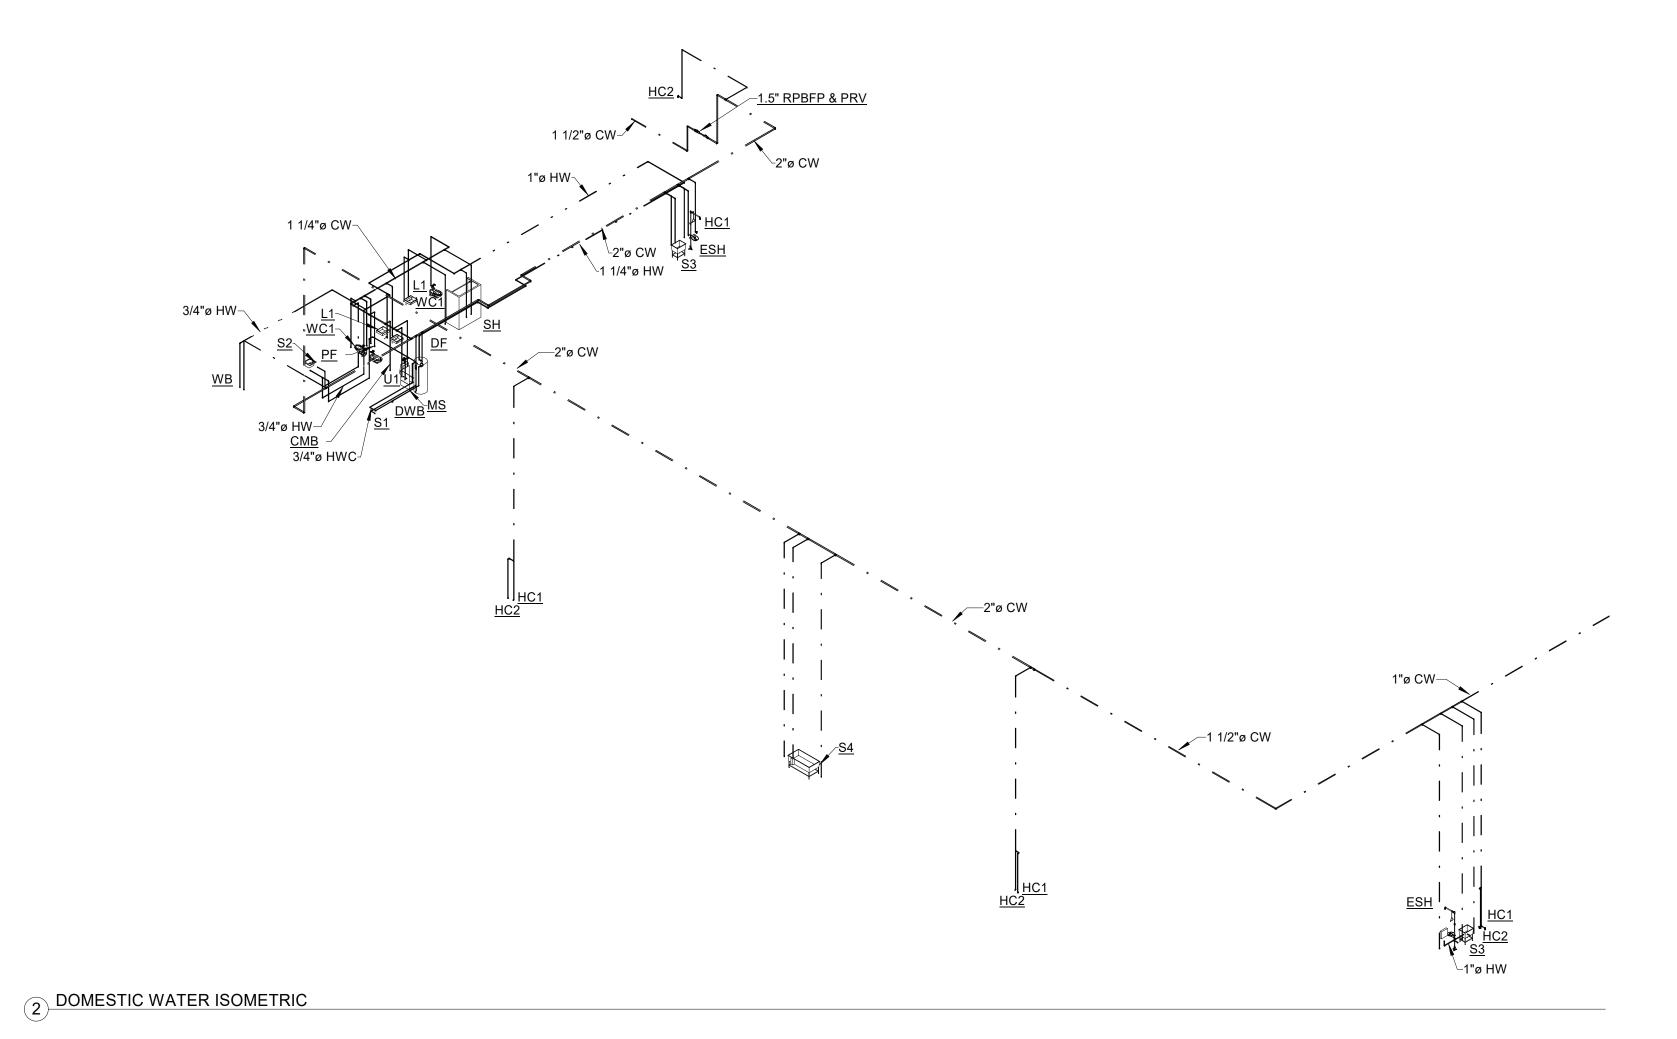

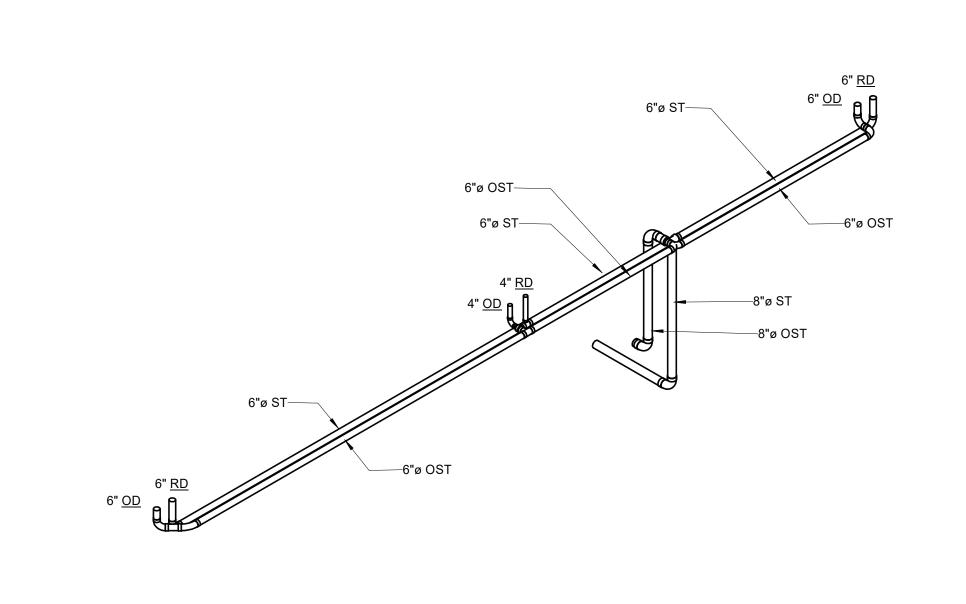

4 STORM ISOMETRIC





8201 SHAFFER PARKWAY SUITE A LITTLETON, COLORADO 80127 303.991.0991 THOMPSON-ENG.COM



REVISIONS

MARK DESCRIPTION DATE

1 PERMIT COMMENTS 6/28/2024

| Key Plan

SIGNATURE STEWART (SWF) HANGAR

1188 1ST STREET, NEW WINDSOR, NY 12553




SIGNATURE FLIGHT SUPPORT 13485 VETERANS WAY, SUITE 600 ORLANDO. FLORIDA 32827

ISSUE DATE: 06/12/2024 COMM. NO.: 2023-177

DRAWN BY: JH CHECKED BY: DL/RS

PIPING DIAGRAMS

P002

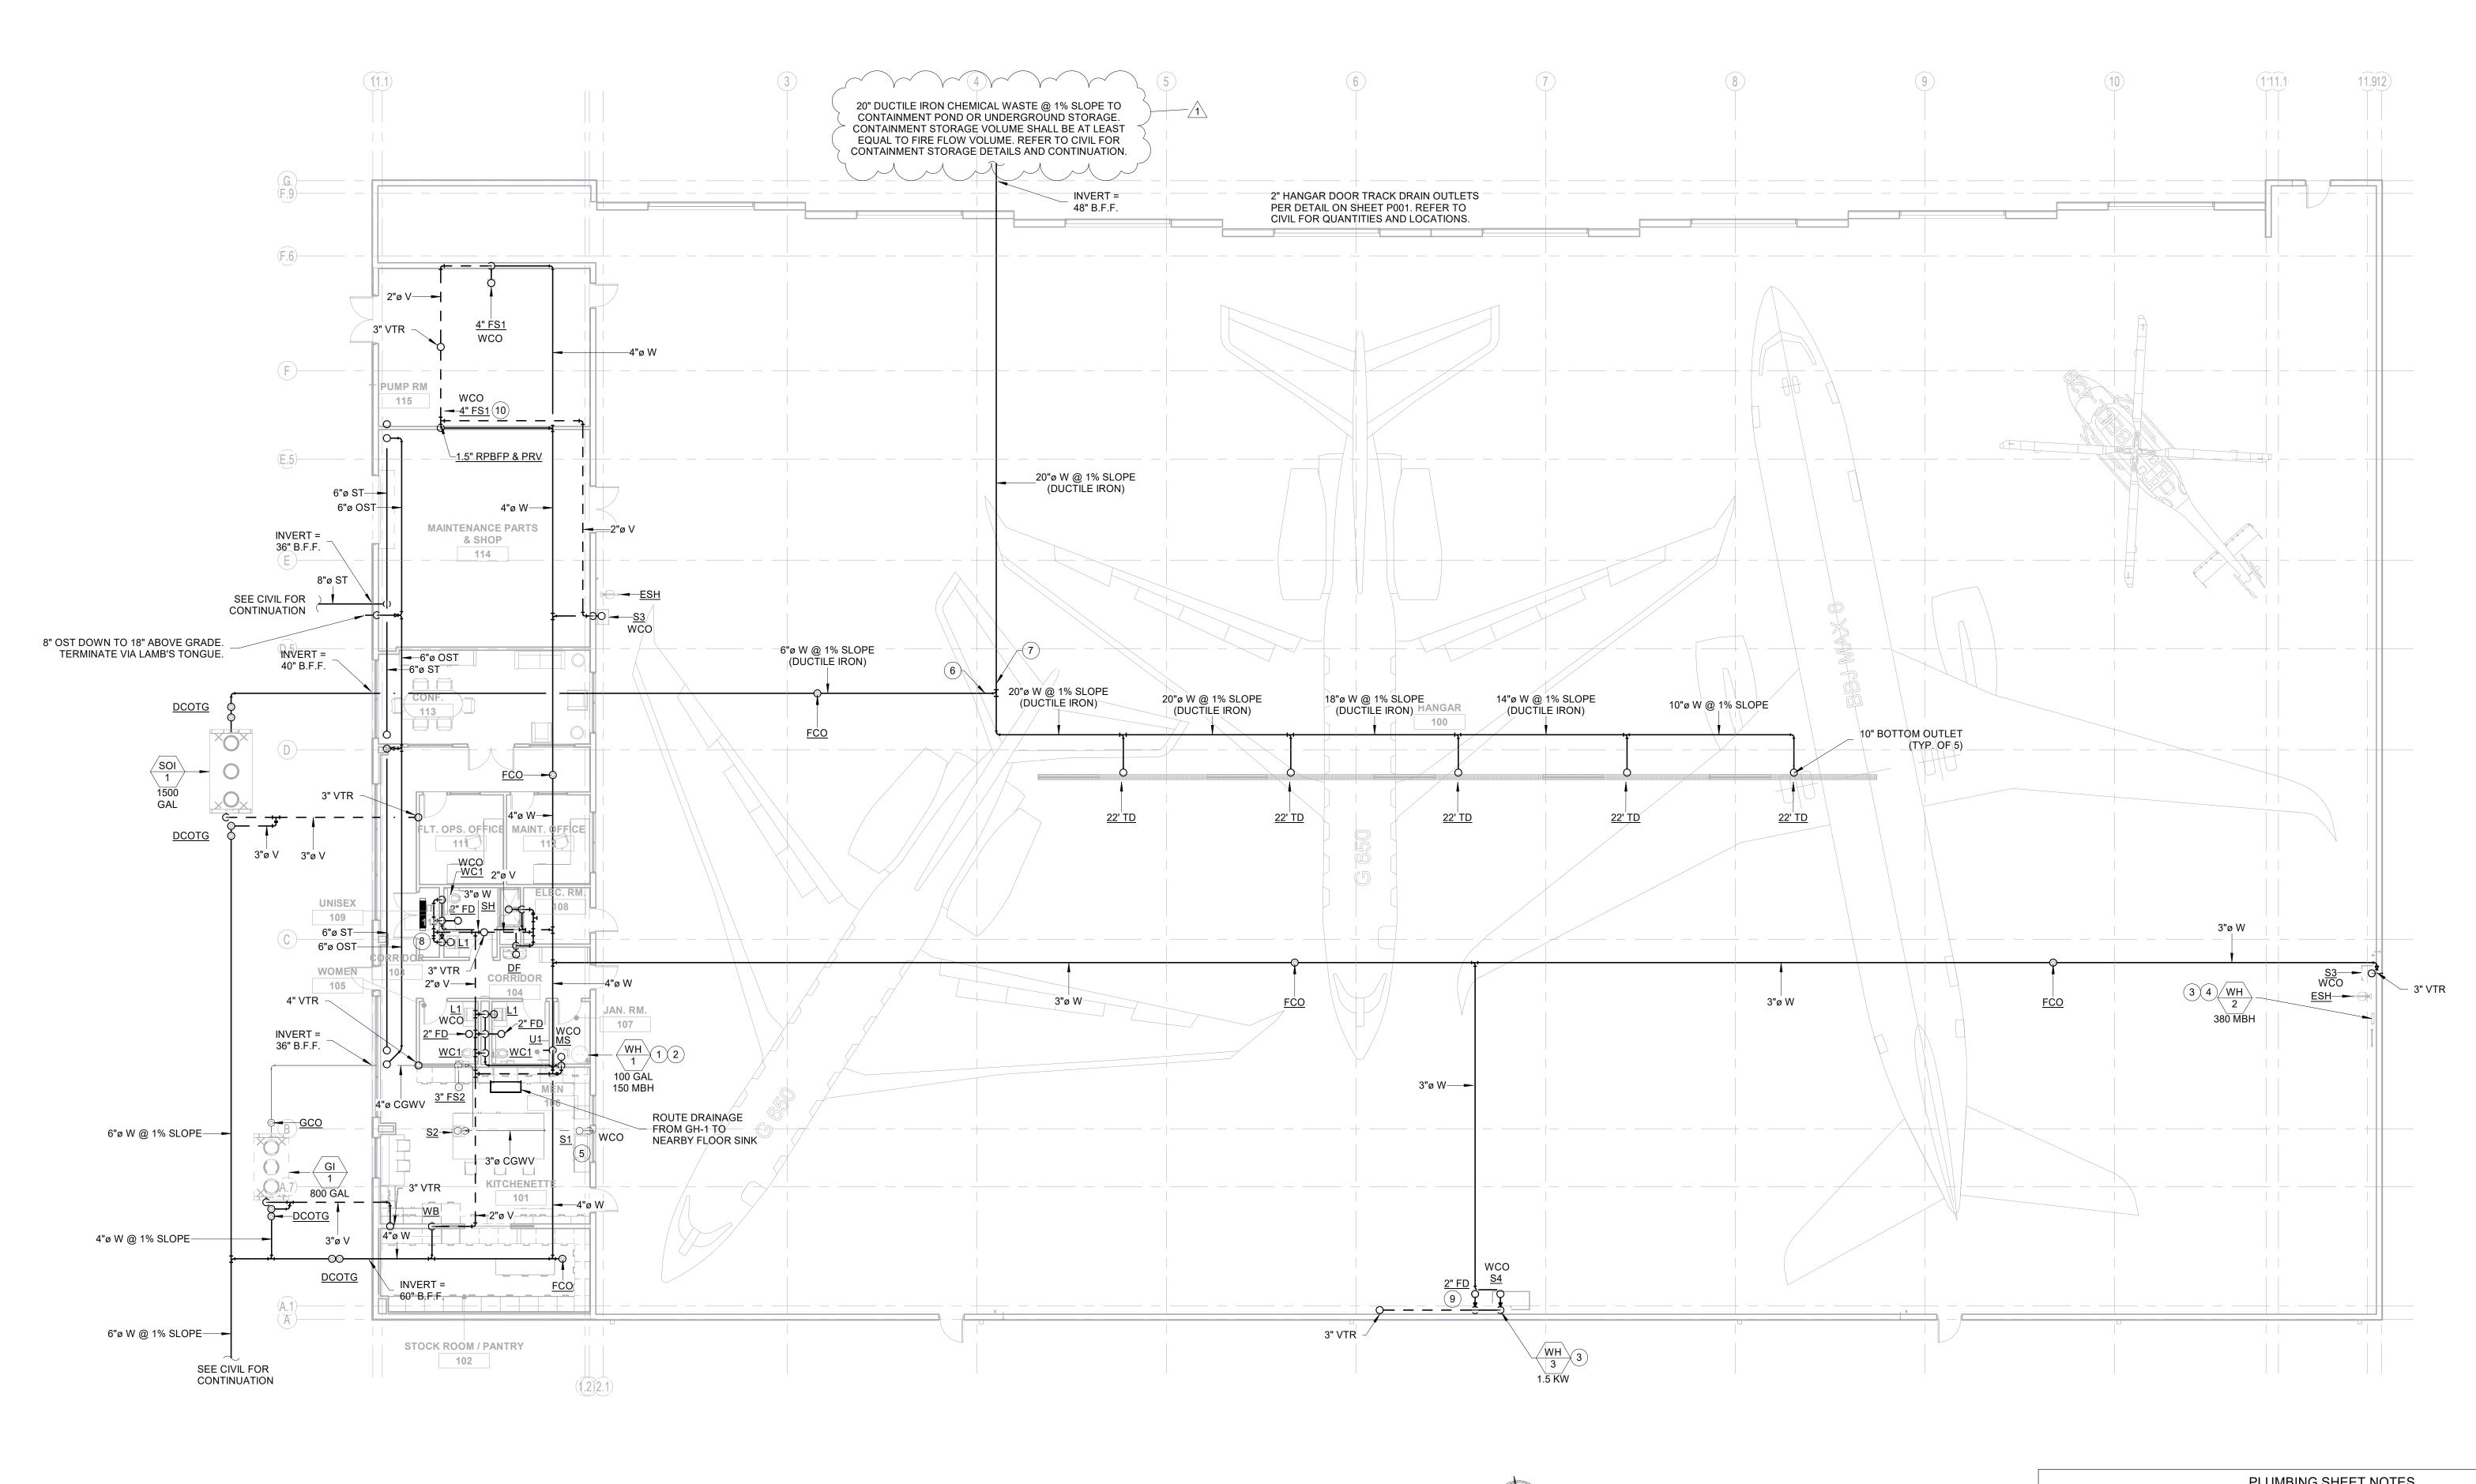

- WATER HEATER P&T RELIEF TO INDIRECT DRAIN TO MOP SINK. RAISE WATER HEATER 18" A.F.F. PROVIDE 3" PVC COMBUSTION AIR INTAKE AND CPVC VENT UP THROUGH ROOF TO MANUFACTURERS
- WATER HEATER P&T RELIEF TO INDIRECT DRAIN TO SLOPED HANGAR FLOOR. RAISE WATER HEATER
- 18" A.F.F. MINIMUM.
- PROVIDE 5" PVC COMBUSTION AIR INTAKE AND CPVC VENT UP THROUGH ROOF TO MANUFACTURERS TERMINATIONS. PROVIDE CONDENSATE PUMP AND ACID NEUTRALIZATION AS REQUIRED.

20" RED-WHITE VALVE CORPORATION ELECTRIC ACTUATED (MODEL 3PT) BUTTERFLY VALVE (MODEL

- 6" RED-WHITE VALVE CORPORATION ELECTRIC ACTUATED (MODEL 3PT) BUTTERFLY VALVE (MODEL 938) INTERLOCKED WITH FIRE ALARM SYSTEM. INSTALL WITHIN ACCESSIBLE AIRCRAFT RATED VALVE BOX SIZED PER VALVE MANUFACTURER RECOMMENDATIONS. VALVE TO BE NORMALLY OPEN AND SHALL CLOSE DURING FIRE ALARM EVENT. VALVE SHALL FAIL CLOSE IN EVENT OF POWER FAILURE.
- SHALL OPEN DURING FIRE ALARM EVENT. VALVE SHALL FAIL OPEN IN EVENT OF POWER FAILURE.
- (10) INDIRECT DRAIN COMPRESSOR DRYER CONDENSATE TO NEARBY FLOOR SINK.

WASTE AND VENT GENERAL NOTES

WASTE PIPING 2" DIAMETER OR SMALLER TO BE SLOPED AT A MINIMUM OF 1/4" PER FOOT. ALL

VERIFY ACTUAL SIZE, LOCATION, FLOW DIRECTION, AND INVERT OF EXISTING WASTE AND VENT

= CONNECT TO EXISTING

ALL EQUIPMENT TO BE INSTALLED PER MANUFACTURERS SPECIFICATIONS. MAINTAIN ALL REQUIRED

OTHER WASTE PIPING TO BE SLOPED AT A MINIMUM 1/8" PER FOOT.

PIPING PRIOR TO CONSTRUCTION.

PLUMBING SHEET NOTES

- TERMINATIONS. PROVIDE CONDENSATE PUMP AND ACID NEUTRALIZATION AS REQUIRED.
- 5 DISHWASHER TO INDIRECT DRAIN TO KITCHEN SINK STANDPIPE VIA AIR GAP. SEE DETAIL ON SHEET P001.
- 938) INTERLOCKED WITH FIRE ALARM SYSTEM. INSTALL WITHIN ACCESSIBLE AIRCRAFT RATED VALVE BOX SIZED PER VALVE MANUFACTURER RECOMMENDATIONS. VALVE TO BE NORMALLY CLOSED AND
- 8 ROUTE CONDENSATE FROM DFC-1 TO NEARBY MOP SINK. PROVIDE CONDENSATE PUMP AS
- 9 PROVIDE 2"H DAM AROUND FLOOR DRAIN GRATE TO AVOID SAND OR OIL CONTAMINATION. INDIRECT DRAIN ICE MAKER TO FLOOR DRAIN.

127 W. FAIRBANKS AVENUE, SUITE 140 WINTER PARK, FL 32789 (PH): 407-739-9000



8201 SHAFFER PARKWAY SUITE A LITTLETON, COLORADO 80127 303.991.0991 THOMPSON-ENG.COM



REVISIONS DATE

PERMIT COMMENTS

Key Plan

SIGNATURE STEWART (SWF) HANGAR

1188 1ST STREET, NEW WINDSOR, NY 12553



SIGNATURE FLIGHT SUPPORT 13485 VETERANS WAY, SUITE 600

ORLANDO, FLORIDA 32827

COMM. NO.: 2023-177

ISSUE DATE: 06/12/2024

CHECKED BY: DL/RS DRAWN BY: JH

OVERALL WASTE AND VENT

6/28/2024 9:48:18 AM

Autodesk Docs://23715 - SWF Terminal and Hangar (Halle House)/2023-177-SFS SWF HANGAR-M&P-CENTRAL-R23.rvt

100% PERMIT SET

