GENERAL NOTES

- AT A MINIMUM, ALL WORK SHALL COMPLY WITH AND BE INSTALLED IN ACCORDANCE WITH THE SUPPLEMENTAL UNIFORM AND FIRE PREVENTION BUILDING CODE, NYS BUILDING CODE, NYS MECHANICAL CODE, 2020 NYS ENERGY CODE, AND ALL CODES LOCAL OR OTHERWISE HAVING JURISDICTION OVER THE WORK. IF THE CONTRACT DOCUMENT SHOW DIFFERENT THAN THE CODE, THE MORE STRINGENT SHALL APPLY.
- 2. ALL WORK SHOWN ON THE DRAWINGS SHALL BE PROVIDED UNLESS OTHERWISE NOTED.
- 3. PIPING AND DUCTWORK IS DIAGRAMMATICALLY SHOWN. EXACT ROUTING OF NEW PIPING SHALL BE DETERMINED IN FIELD WITH THE APPROVAL OF THE ENGINEER.
- 4. THE WORDS PROVIDE OR INSTALL, SINGLY OR IN COMBINATION SHALL MEAN FURNISH AND INSTALL IN ACCORDANCE WITH THE PLANS AND SPECIFICATIONS.
- 5. EXISTING CONDITION HAVE BEEN GENERATED FROM AVAILABLE AS-BUILT DRAWINGS. CONTRACTOR SHALL VERIFY AS-BUILT CONDITIONS IN FIELD AND DEVIATIONS SHALL BE REPORTED TO THE ENGINEER PRIOR TO PERFORMING THE WORK.
- 6. THE CONTRACTOR SHALL PROVIDE ALL CUTTING AND PATCHING TO MATCH EXISTING AS REQUIRED FOR THE INSTALLATION OF HIS WORK.
- 7. THIS CONTRACTOR SHALL BE RESPONSIBLE FOR THE PROTECTION OF HIS WORK AND NEWLY INSTALLED WORK, INCLUDING PROTECTION OF BUILDING OCCUPANTS AND OWNERS EQUIPMENT, PUBLIC, AND PERSONNEL. PROVIDE APPROPRIATE SIGNAGE, BARRIERS, AND SAFETY GUARD RAILS AS REQUIRED.
- 8. WHERE WELDING OR OPEN FLAME IS USED FOR CUTTING, SOLDERING, ETC., CONTRACTOR SHALL PROVIDE FIRE EXTINGUISHERS AND A FIRE WATCH IN PROXIMITY OF WORK AREA.
- 9. ALL WORK SHALL BE COORDINATED WITH ALL TRADES RELATED TO THE COMPLETION OF THIS PROJECT
- 10. THE CONTRACTOR SHALL FILE PLANS WITH THE GOVERNING AUTHORITIES HAVING JURISDICTION AND SHALL SECURE ALL PERMITS AND PAY ALL FEES REQUIRED FOR THE INSTALLATION OF HIS WORK.
- 11. THE CONTRACTOR SHALL GUARANTEE ALL MATERIAL AND WORK INSTALLED TO BE FREE FROM DEFECTS IN MATERIAL AND WORKMANSHIP FOR A PERIOD OF ONE (1) YEAR, AFTER ACCEPTANCE OF THE INSTALLATION BY THE ENGINEER AND OWNER. THE CONTRACTOR SHALL SUBMIT IN WRITING TO OWNER STATING THE SAME, EQUIPMENT WARRANTEES OF A LONGER DURATION SHALL APPLY.
- 12. THE CONTRACTOR SHALL INDEMNIFY THE OWNER, HIS REPRESENTATIVES AND THE ENGINEER FROM ANY CLAIMS OR SUITS RESULTING IN NEGLIGENCE ON THE PART OF THE CONTRACTOR AND FOR FAILING TO EXECUTE HIS WORK IN ACCORDANCE WITH THE CONTRACT DOCUMENTS.
- 13. THE CONTRACTOR SHALL PROVIDE ALL RIGGING, HOISTING AND SCAFFOLDING AS REQUIRED FOR THE INSTALLATION OF HIS WORK.
- 14. ALL WORK SHALL BE PERFORMED BY LICENSED CONTRACTORS AND WORKMEN EXPERIENCED IN THE TRADE HAVING JURISDICTION. ALL WORK SHALL BE SUPERVISED AT ALL TIMES AND WORKMANSHIP SHALL BE FIRST CLASS IN ALL RESPECTS AND IN ACCORDANCE WITH BEST TRADE PRACTICES.
- 15. ANY DEVIATION OR CHANGE IN DESIGN SHALL NOT BE MADE WITHOUT WRITTEN APPROVAL OF THE ENGINEER AND SIGNED BY THE OWNER. ANY WORK INSTALLED WITHOUT PRIOR APPROVAL OF THE ENGINEER AND OWNER OR FOUND TO BE DEFECTIVE IN ANY WAY SHALL BE REPLACED BY THE CONTRACTOR AT HIS OWN EXPENSE.
- 16. ALL CONSTRUCTION WORK SHALL BE CONFINED TO THE AREA INDICATED ON PLANS AND SHALL NOT BLOCK MEANS OF EGRESS FOR OCCUPANTS OF THE BUILDING.
- 17. ALL WORK SHALL BE PERFORMED DURING NORMAL WORKING HOURS: 8AM TO 5PM MONDAY THROUGH FRIDAY EXCEPT LEGAL HOLIDAYS OR FOR EMERGENCY REPAIRS, UNLESS DIRECTED OTHERWISE BY THE OWNER. WORKING HOURS MUST BE COORDINATED WITH CONTRACTOR. HOWEVER, THE CONTRACTOR MAY WORK EXTRA HOURS AS NEEDED TO COMPLETE THE CONTRACT SCOPE OF WORK AND MEET THE COMPLETION DATE AT NO ADDITIONAL COST TO OWNER, AS LONG AS OWNER HAS BEEN PROPERLY NOTIFIED AND HAS APPROVED SAME.
- 18. ROUGH PATCHING OF WALLS, FLOORS, ETC. SHALL BE BY TRADE WHO PERFORMED WORK UNLESS OTHERWISE NOTED AND SHALL MATCH EXISTING SURROUNDING AREA IN ALL RESPECTS. WORK AREA SHALL BE LEFT BROOM CLEAN AT THE END OF EACH DAY. ALL DISCARDED AND DEMOLISHED MATERIAL AND RUBBISH SHALL BE REMOVED FROM PREMISES DAILY IN A LEGAL AND APPROVED MANNER. FINAL PATCHING AND PAINTING SHALL BE PERFORMED BY GENERAL CONTRACTOR
- 19. LIMIT THE SPREAD OF DUST WHEN CUTTING BY INSTALLING POLYETHYLENE BARRIERS OR TARPAULINS AND EXHAUST TO CONTAIN AIRBORNE MATERIALS.
- 20. THE CONTRACTOR SHALL SUBMIT DIGITAL COPIES OF SHOP DRAWINGS OF ALL EQUIPMENT, PIPING, DUCTWORK, AND MATERIALS TO THE ENGINEER FOR APPROVAL PRIOR TO FABRICATION AND INSTALLATION OF NEW WORK, WITHIN TWO WEEKS AFTER AWARD OF CONTRACT. SHOP DRAWINGS SHALL INDICATE ALL TECHNICAL DATA, STRUCTURAL MEMBERS, WALLS, FLOORS, DUCTWORK, ETC., WITH ELEVATIONS AT WHICH NEW WORK IS TO BE INSTALLED. ANY DEVIATION IN DESIGN SHALL NOT BE MADE WITHOUT WRITTEN APPROVAL OF THE ENGINEER AND OWNER. THE ENGINEER SHALL REVIEW AND TURN AROUND SHOP DWGS. WITHIN (7) DAYS OF RECEIPT OF SAME.
- 21. THE CONTRACTOR SHALL MAINTAIN ON THE JOB SITE A SET OF CONTRACT DRAWINGS.
- 22. THE CONTRACTOR SHALL MAINTAIN ON THE JOB SITE A SET OF SHOP DRAWINGS IN WHICH ANY DEVIATIONS FROM THE ORIGINAL DESIGN SHALL BE NOTED. UPON COMPLETION OF THE INSTALLATION OF NEW WORK THE CONTRACTOR SHALL TURN OVER TO THE OWNER AND ENGINEER (1) SET OF AS-BUILT REPRODUCIBLE DRAWINGS AND (1) SET OF PRINTS INCLUDING ALL APPROVED FIELD CHANGES AND DESIGN DEVIATIONS PRIOR TO RECEIPT OF FINAL PAYMENT BY OWNER.
- 23. ALL PENETRATIONS THROUGH PARTITIONS, FLOORS, WALLS AND ROOF FOR ALL PIPING, CONDUIT AND DUCTWORK SHALL BE SEALED AND FIRE SAFED OFF TO MAINTAIN FIRE INTEGRITY OF EXISTING STRUCTURE.
- 24. THE CONTRACTOR SHALL SUPERVISE AND DIRECT THE WORK, AS WELL AS BE SOLELY RESPONSIBLE FOR THE CONSTRUCTION MEANS METHODS, TECHNIQUES, SEQUENCES, AND PROCEDURES OF THE WORK.
- 25. THE CONTRACTOR SHALL BE RESPONSIBLE FOR TAKING ADEQUATE PRECAUTIONS AND SHALL PROVIDE REASONABLE PROTECTION TO PREVENT INJURY OR DAMAGE TO PERSONS, THE WORK, AND OTHER PROPERTY.

HVAC NOTES

- 1. PROVIDE ACCESSIBLE VOLUME DAMPERS AS INDICATED ON DRAWINGS AND AT ALL BRANCH DUCT TAKE OFFS FROM DUCT MAINS AND TO DIFFUSERS, REGISTERS AND GRILLES. VOLUME DAMPERS SHALL BE OPPOSED BLADE OR BUTTERFLY TYPE, GALVANIZED STEEL THAT CAN BE MANUALLY ADJUSTED AND LOCKED IN PLACE EXTERNALLY OF THE DUCT. PROVIDE LOCKING QUADRANT. ALL CONCEALED DAMPERS SHALL BE PROVIDED WITH ACCESS DOORS.
- 2. PROVIDE SLEEVES FOR ALL DUCTS PENETRATING AND PASSING THROUGH ALL PARTITIONS, FLOORS, CEILINGS AND WALLS, ALLOW ROOM IN SLEEVE FOR INSULATION. SLEEVES SHALL BE MINIMUM OF 22 GAUGE SHEET METAL. PACK ANNULAR SPACE IN SLEEVE AROUND DUCT WITH FIRE RATED MATERIAL, SIMILAR TO THERMAFIBER. SEAL AND CAULK ALL WALL, FLOOR, CEILING AND SLAB OPENINGS WITH U.L. APPROVED FIRE RATED MATERIAL TO PREVENT TRANSMISSION OF ODORS AND SMOKE TO ADJACENT SPACES. ALL DUCT PENETRATIONS OF FIRE RATED WALLS AND SLABS SHALL BE EQUIPPED WITH FIRE/SMOKE RATED DAMPERS
- 3. CONTRACTOR SHALL PROVIDE ACCESS DOORS IN ALL CEILINGS, DUCTS, CHASES AND WALLS AS REQUIRED FOR ACCESS TO ALL CONCEALED OPERATING DEVICES INCLUDING BUT NOT LIMITED TO FIRE DAMPERS, VOLUME DAMPERS, CONTROL DAMPERS AND BOXES, ETC.
- 4. PROVIDE FIRE DAMPERS IN DUCTS PENETRATING ALL FIRE RATED WALLS. FIRE DAMPERS SHALL BE U.L. 555 CONSTRUCTED CURTAIN TYPE MINIMUM 1 1/2 HR RATED, SUITABLE FOR HORIZONTAL OR VERTICAL MOUNTING. PROVIDE BREAKAWAY DUCT FITTINGS AT ALL FIRE-DAMPER LOCATIONS. COORDINATE WITH GENERAL CONTRACTOR FOR WALL CLASSIFICATIONS.
- 5. ALL HVAC WORK SHALL BE INSTALLED IN STRICT ACCORDANCE WITH THE NYS MECHANICAL CODE, STATE AND LOCAL BUILDING CODES, SMACNA AND ASHRAE STANDARDS, NFPA-90A, ALL CODES AND ORDINANCES HAVING JURISDICTION, AND IN ACCORDANCE WITH MANUFACTURERS RECOMMENDATIONS AT A MINIMUM.
- 6. UPON COMPLETION OF ALL WORK, ALL EQUIPMENT AND DUCTWORK SHALL BE THOROUGHLY CLEANED AND LEFT IN FIRST CLASS CONDITION.
- 7. CONTRACTOR SHALL BE RESPONSIBLE FOR THE PROTECTION OF ALL EQUIPMENT UNDER THIS SECTION UNTIL FINAL ACCEPTANCE BY THE ENGINEER.
- 8. ALL EQUIPMENT SHALL BE TESTED IN ACCORDANCE WITH ALL APPLICABLE CODES. MANUFACTURER SPECIFICATIONS, AND TO THE SATISFACTION OF THE ENGINEER.
- 9. BALANCE AND ADJUST AIRFLOW TO REGISTERS AND GRILLES AS INDICATED ON DRAWINGS. ALL SYSTEMS SHALL BE BALANCED TO WITHIN 0+-5% OF DESIGN FLOW WITH REPORT SUBMITTED TO OWNER. BALANCING WORK SHALL BE PERFORMED BY AN INDEPENDENT CERTIFIED BALANCING CONTRACTOR WHO IS CERTIFIED BY AABC OR NEBB. SUBMIT BALANCING REPORT TO ENGINEER FOR APPROVAL.
- 10. ALL DUCTWORK SHALL BE GALVANIZED SHEET METAL UNLESS OTHERWISE NOTED AND SHALL BE INSTALLED IN ACCORDANCE WITH SMACNA METAL AND FLEXIBLE DUCT CONSTRUCTION STANDARDS LATEST EDITION AND APPLICABLE CODES. ALL DUCTWORK SIZES SHOWN ARE SHEETMETAL SIZES, AND REDUCTIONS IN FREE AREA CREATED BY INTERNAL SOUND-LINING ARE ACCOUNTED FOR IN DESIGN.
- 11. CONTRACTOR SHALL PROVIDE ALL CONTROLS, AND CONTROL WIRING AS REQUIRED FOR COMPLETE CONTROL OF EQUIPMENT FOR A COMPLETE FUNCTIONING SYSTEM. REFER TO ELECTRICAL DRAWINGS FOR STANDARDS OF CONSTRUCTION.
- 12. ALL AIR CONDITIONING SUPPLY AND RETURN DUCTWORK SHALL BE INSULATED WITH R5 HEAVY DENSITY FIBERGLASS BLANKET WRAP WITH VAPOR BARRIER FOIL FACED JACKET WHERE DUCTWORK IS CONCEALED ABOVE DROP CEILING AND NOT SHOWN TO BE ACOUSTICALLY LINED. DUCT SIZES SHOWN ARE CLEAR OF ACOUSTIC LINING. INCREASE DUCT SIZE ACCORDINGLY. ALL EXPOSED DUCTWORK TO BE ACOUSTICALLY LINED.
- 13. INSTALL ALL REQUIRED APPURTENANCES PER CODE WHETHER SPECIFIED OR NOT FOR COMPLETE FUNCTIONING SYSTEMS.
- 14. HVAC INSULATION (AS MANUFACTURED BY OWENS CORNING, KNAUF, SCHULLER, OR ENGINEERED APPROVED EQUAL)
- 14.A. INSULATE ALL NON-LINED SUPPLY, RETURN, AND EXHAUST DUCTS IN UNCONDITIONED SPACES WITH 1-1/2" THICK FOIL FACED REINFORCED KRAFT JACKET. FIBERGLASS DUCT WRAP FULLY SECURED TO DUCT. LAP AND TAPE SEAMS AND SECURE TIGHTLY TO THE DUCTS WITH WIRE OR STICK PINS.
- 14.B. ALL INSULATION TO BE APPLIED IN FULLY ACCORDANCE WITH THE MANUFCATURERS RECOMMENDATIONS AND COMPLY WITH 25/50 FLAME AND SMOKE HAZARD RATINGS PER ASTM E-84, NFPA 255 AND UL 723.
- 14.C. INSULATE AIR CONDITIONING CONDENSATE DRAIN PIPING WITH 1" THICK MOLDED FIBER GLASS INSULATION.
- 15. 15. CONDENSATE DRAIN PIPING SHALL BE COPPER DWV. ROUTE ALL CONDENSATE DRAIN PIPING TO SPILL OVER INTERIOR BUILDING DRAINS.

SYMBOL	DESCRIPTION
	EXISTING WORK OR BY OTHERS
	WORK TO BE PROVIDED
1111	WORK TO BE REMOVED
	POINT OF CONNECTION
	POINT OF DISCONNECTION
0	RISER
G	ELBOW DOWN
—	UNION
	EXHAUST DUCT
	RETURN DUCT
\boxtimes	SUPPLY DUCT
	DUCT ELBOW WITH TURNING VANES
H	AIR TERMINAL
	CHECK VALVE
\triangleright	GLOBE VALVE
\bowtie	GATE VALVE
M	MOTORIZED OPERATED DAMPER
T	DUCT MOUNTED TEMPERATURE SENSOR
(T)	THERMOSTAT
RS	REFRIGERANT SUCTION
RL	REFRIGERANT LIQUID
OA	OUTSIDE AIR
SA	SUPPLY AIR
RA	RETURN AIR
CD	CEILING DIFFUSER
EAT	ENTERING AIR TEMPERATURE
LAT	
LAT	LEAVING AIR TEMPERATURE
ESP	LEAVING AIR TEMPERATURE EXTERNAL STATIC PRESSURE
ESP	EXTERNAL STATIC PRESSURE
ESP CU-1	EXTERNAL STATIC PRESSURE DENOTES CONDENSER UNIT NO.1
ESP CU-1 IDU-1	EXTERNAL STATIC PRESSURE DENOTES CONDENSER UNIT NO.1 DENOTES INDOOR UNIT NO.1
ESP CU-1 IDU-1 BS-1	EXTERNAL STATIC PRESSURE DENOTES CONDENSER UNIT NO.1 DENOTES INDOOR UNIT NO.1 DENOTES BRANCH SELECTOR NO.1

LEGEND

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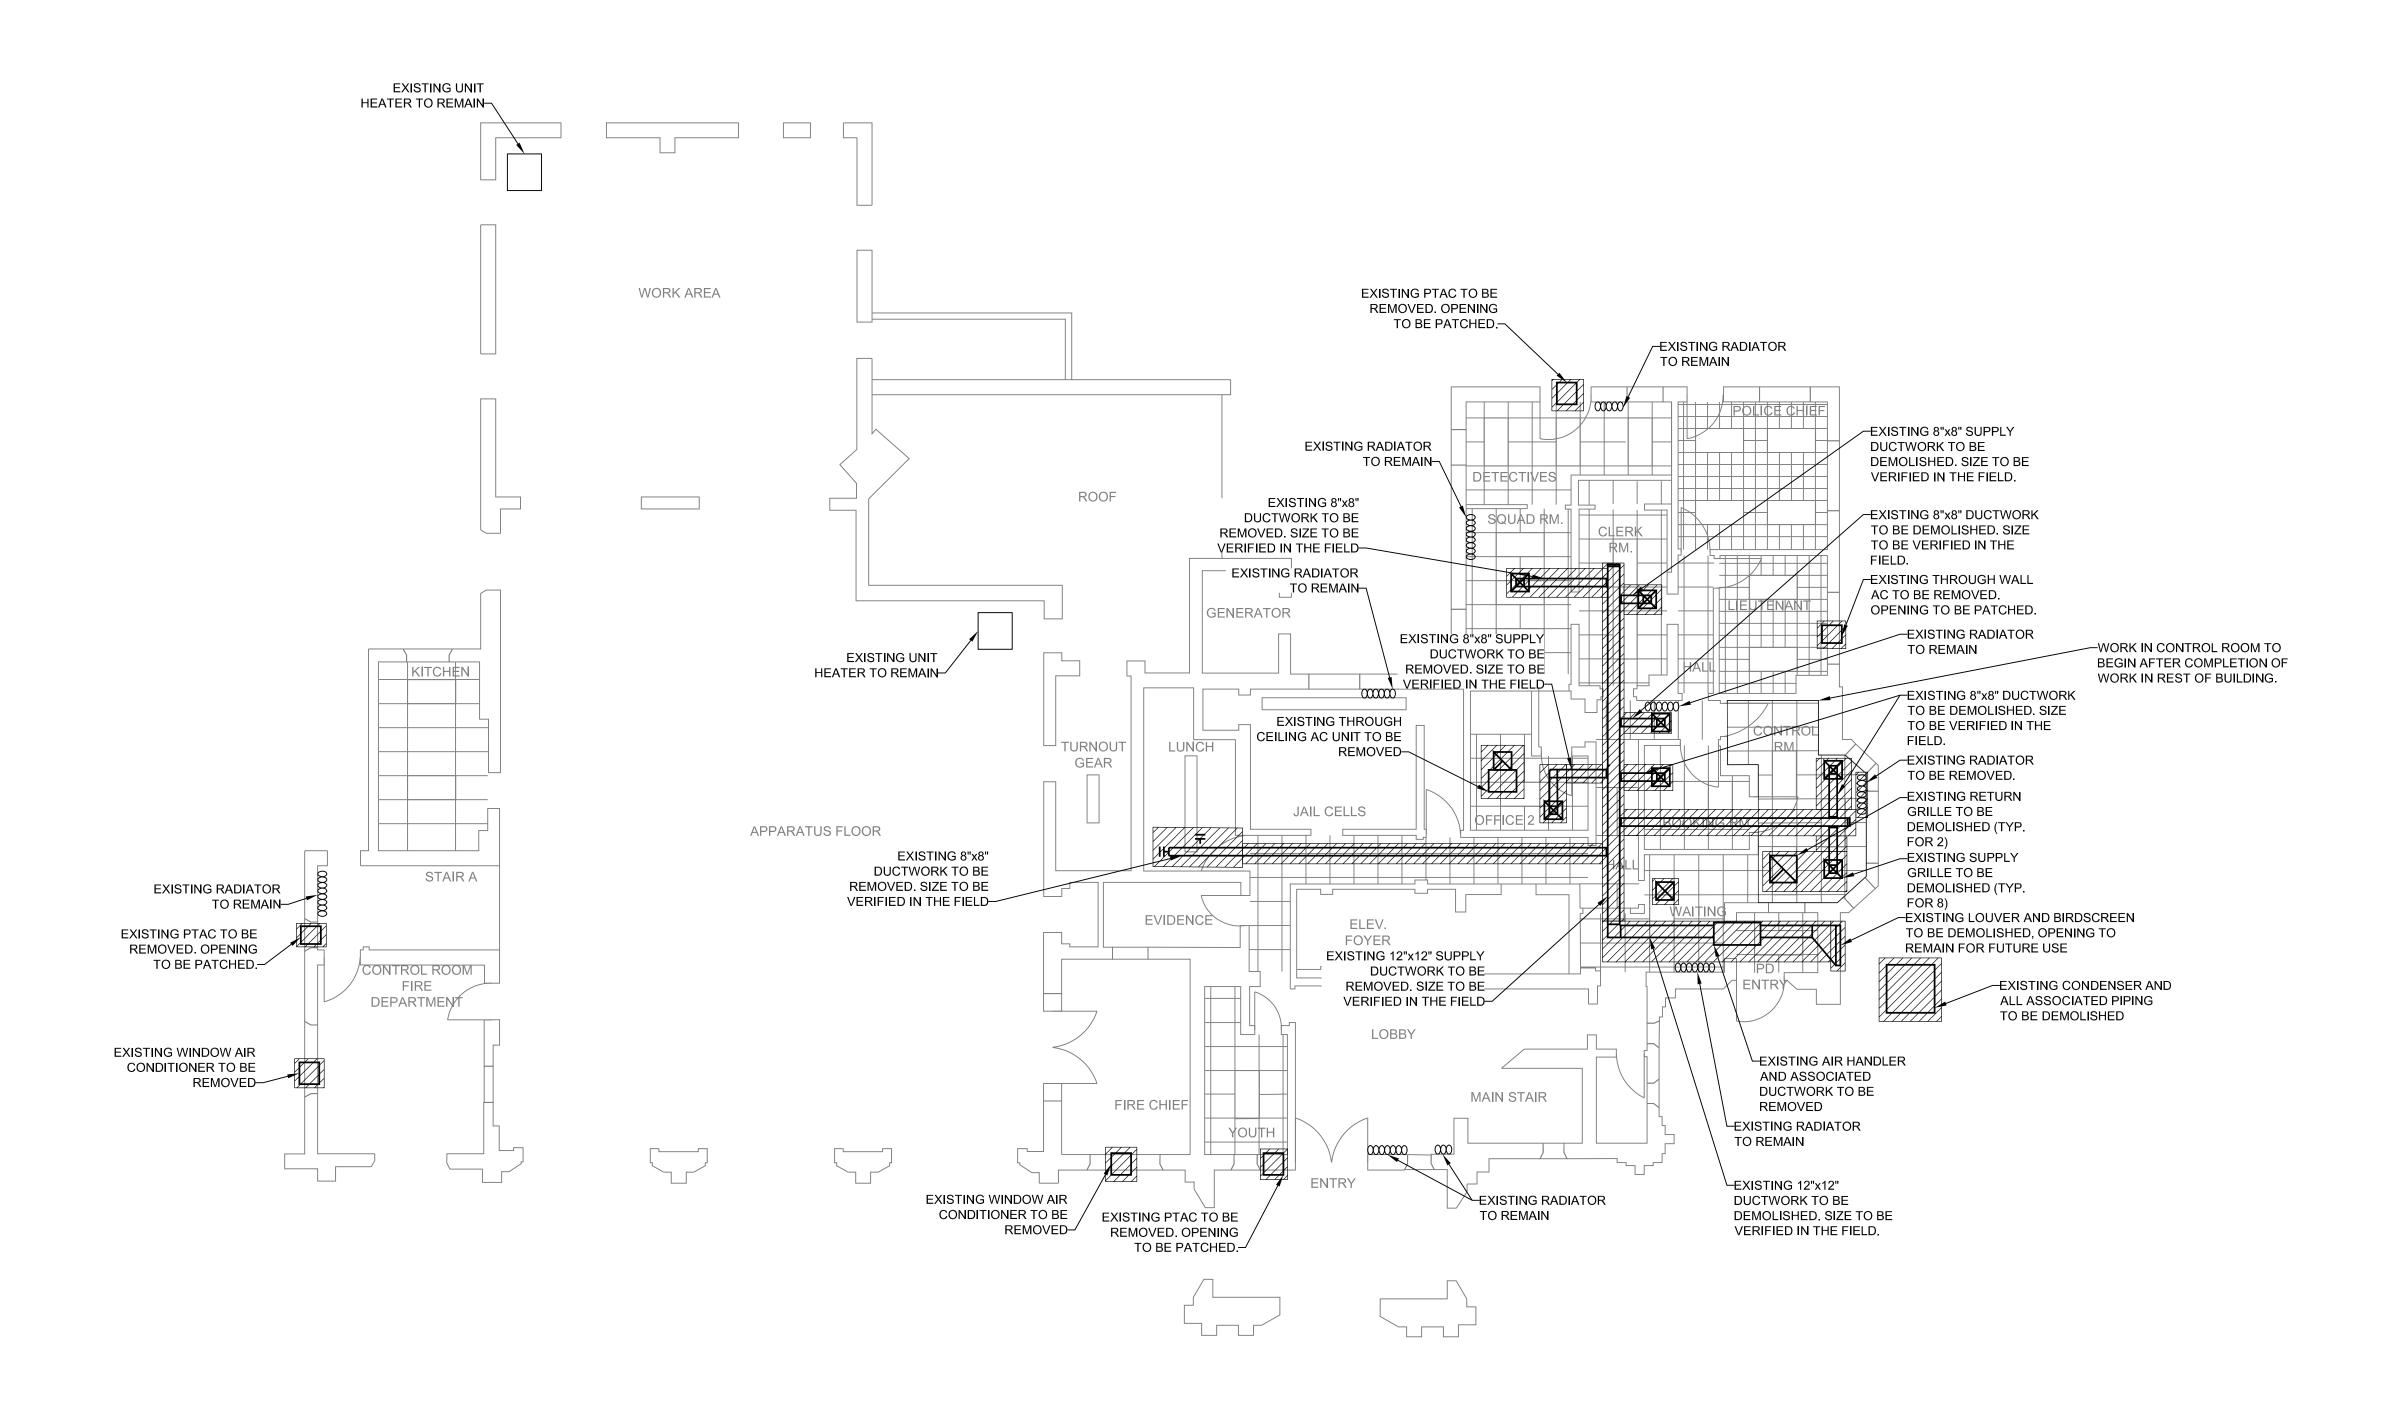


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	PROJECT TITLE:	DR.	AWINGS ISSU	JED FOR / REVISIONS				EDR JOB#: 2307
	COOLING SYSTEM REPLACEMENT AT LARCHMONT VILLAGE HALL	NO.	DATE	ISSUED FOR / REVISION	BY	CHK	APP	DATE: 03/21/2024
٦,		1	03/21/2024	100% FOR BID	EDR	JSR (GRL	SCALE: NTS
9	PROJECT LOCATION: 120 LARCHMONT AVE, LARCHMONT NY	2						DRAWN BY: KPT
	CLIENT: VILLAGE OF LARCHMONT	3						CHECKED BY: GRL
	DRAWING TITLE: MECHNICAL CONTRACT	4						DRAWING NUMBER:
	NOTES AND LEGEND	5						LJ 1
		6						П-1

NOTE FOR CONTRACTOR

CONSTRUCTION TO BE PERFORMED IN PHASES.
CONTRACTOR WILL NOT HAVE ACCESS TO ENTIRE BUILDING
DURING CONSTRUCTION PHASE AND WILL HAVE TO
COORDINATE PHASING WITH CLIENT.



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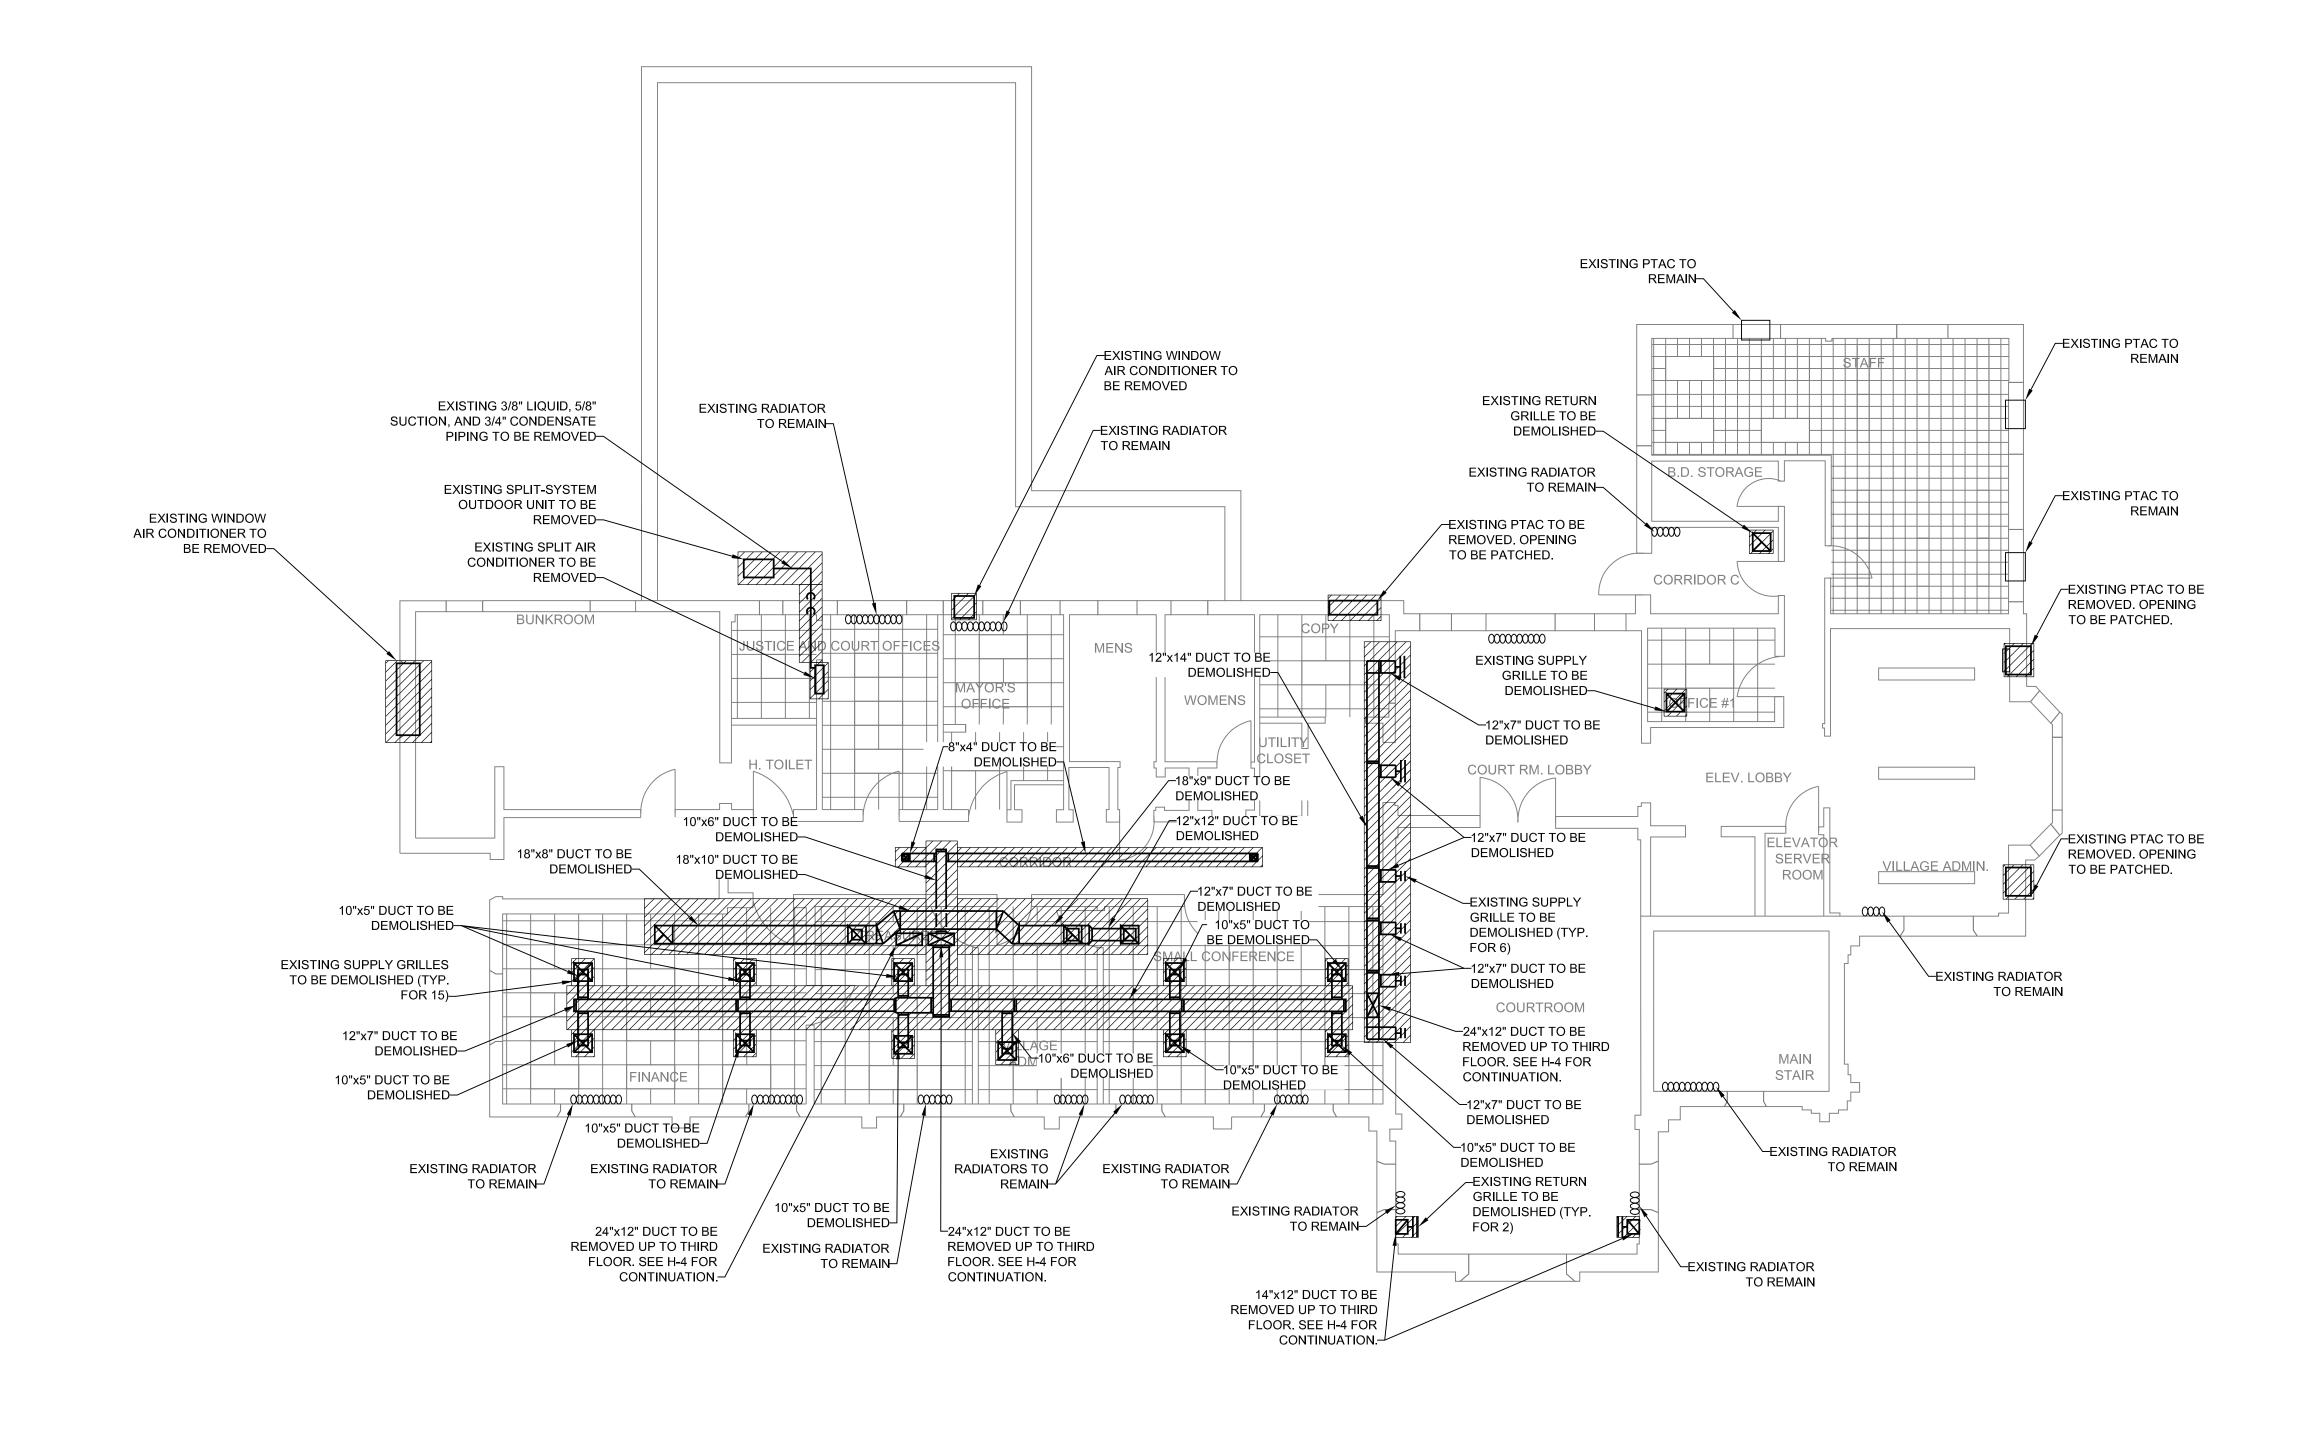
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CLIENT: VILLAGE OF LARCHMONT	3					CHECKED BY: GRL
DRAWING TITLE: MECHNICAL	RACT 4					DRAWING NUMBER:
FIRST FLOOR DEMOLITION PLAN	5					H-2
	6	5				П-2



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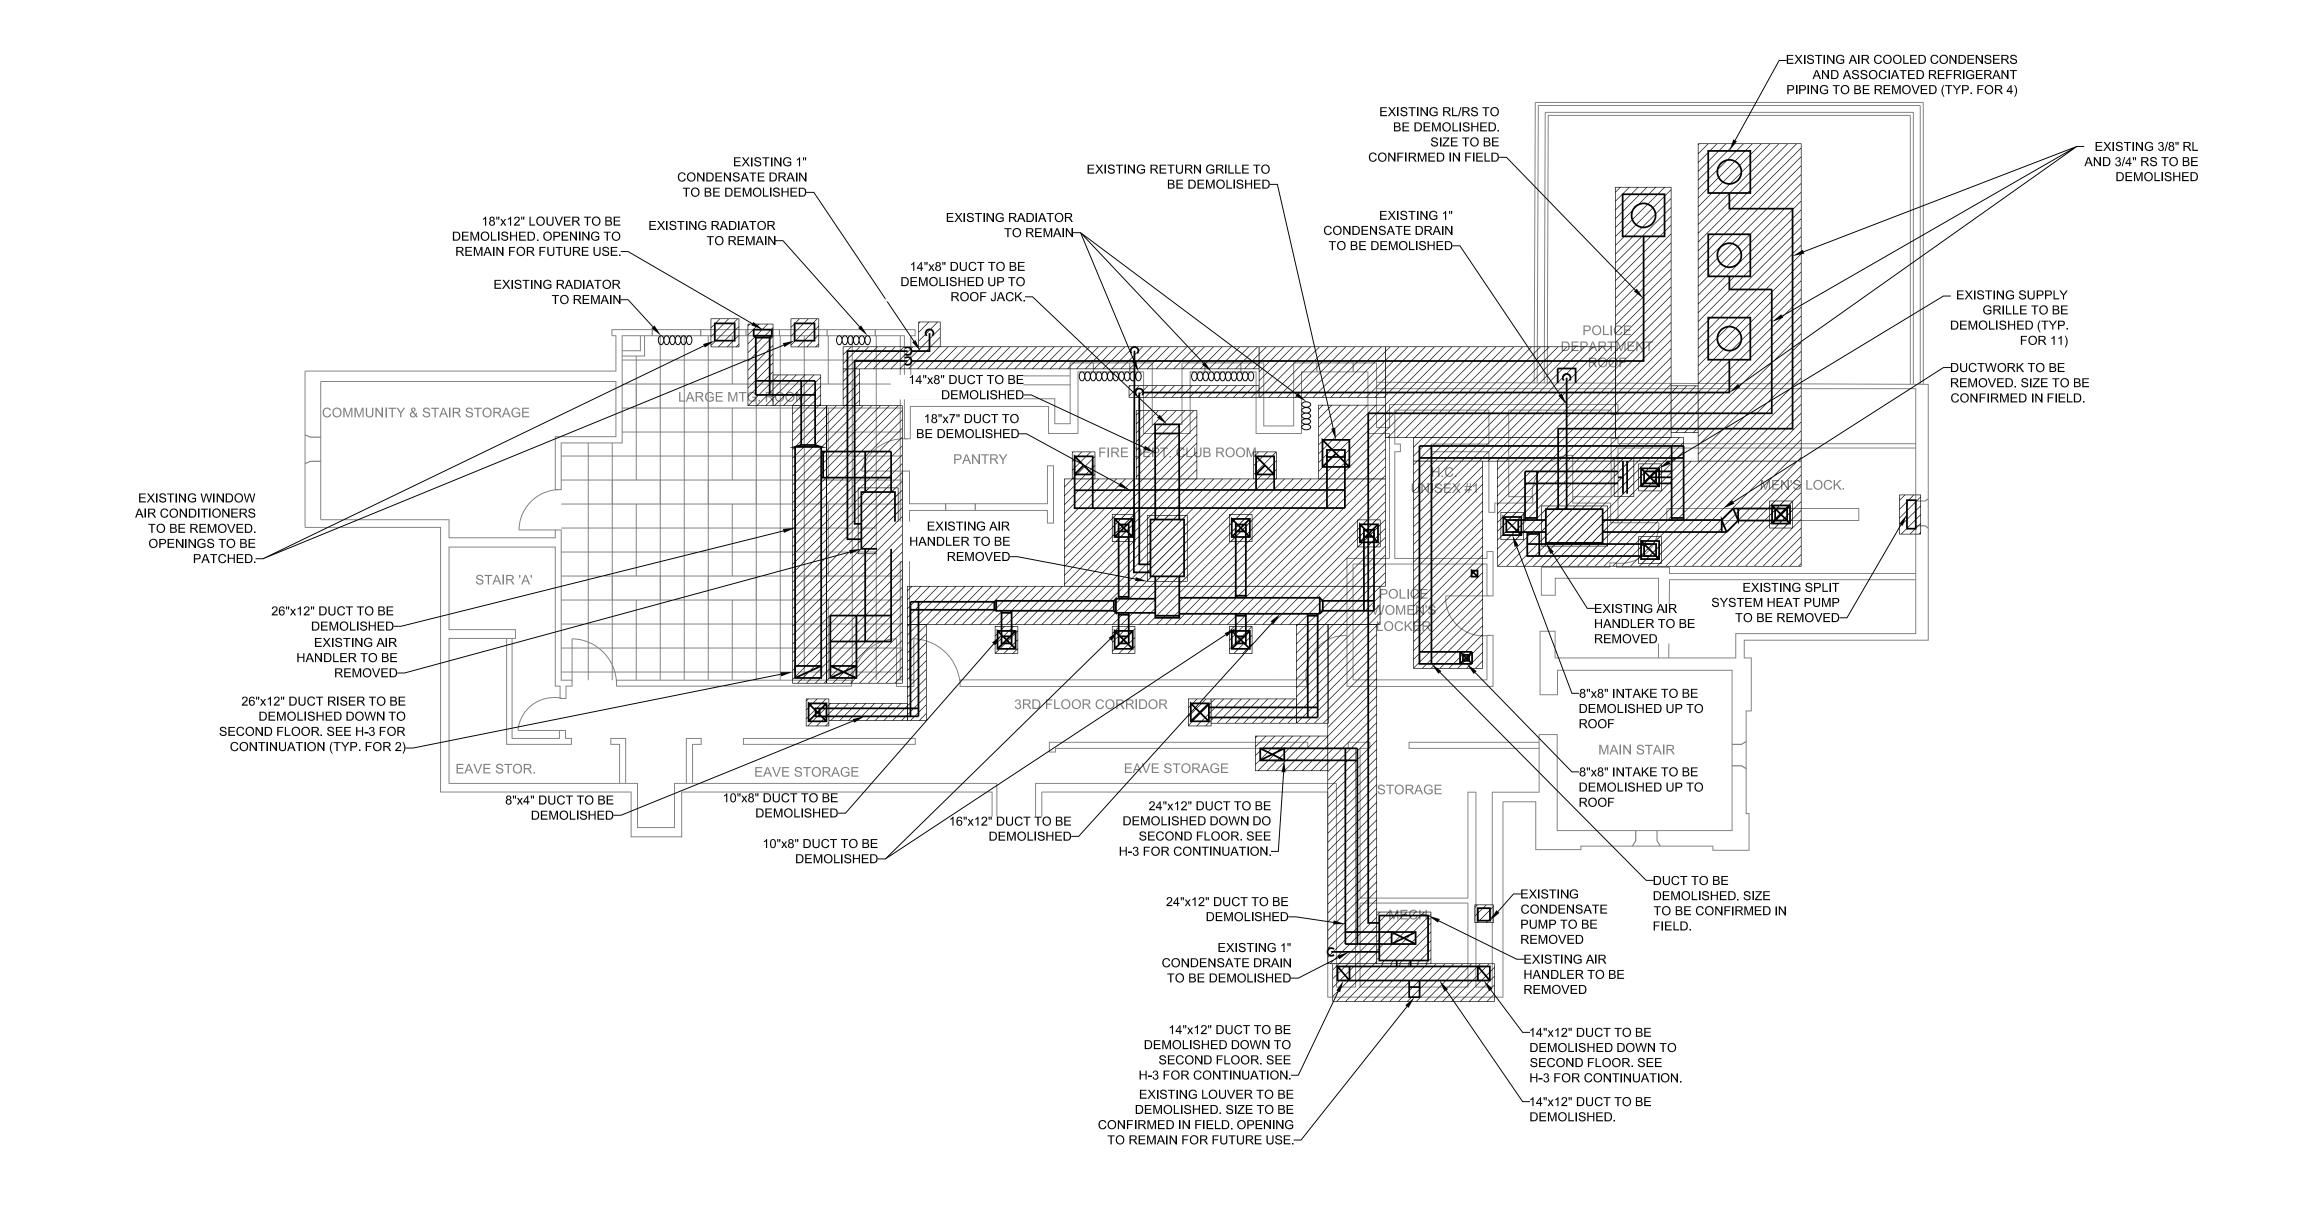
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COOLING SYSTEM REPLACEMENT AT LARCHMONT VILLAGE HALL	1	NO. DATE		ISSUED FOR / REVISION	BY	СНК	APP	DATE: 03/21/2024
		1 03/21	1/2024	100% FOR BID	EDR	JSR	GRL	SCALE: 1/8" = 1'-0"
PROJECT LOCATION: 120 LARCHMONT AVE, LARCHMONT NY		2						DRAWN BY: KPT
CLIENT: VILLAGE OF LARCHMONT		3						CHECKED BY: GRL
DRAWING TITLE: MECHNICAL	NTRACT	4						DRAWING NUMBER:
SECOND FLOOR DEMOLITION PLAN		5						H-3
		6						п-5



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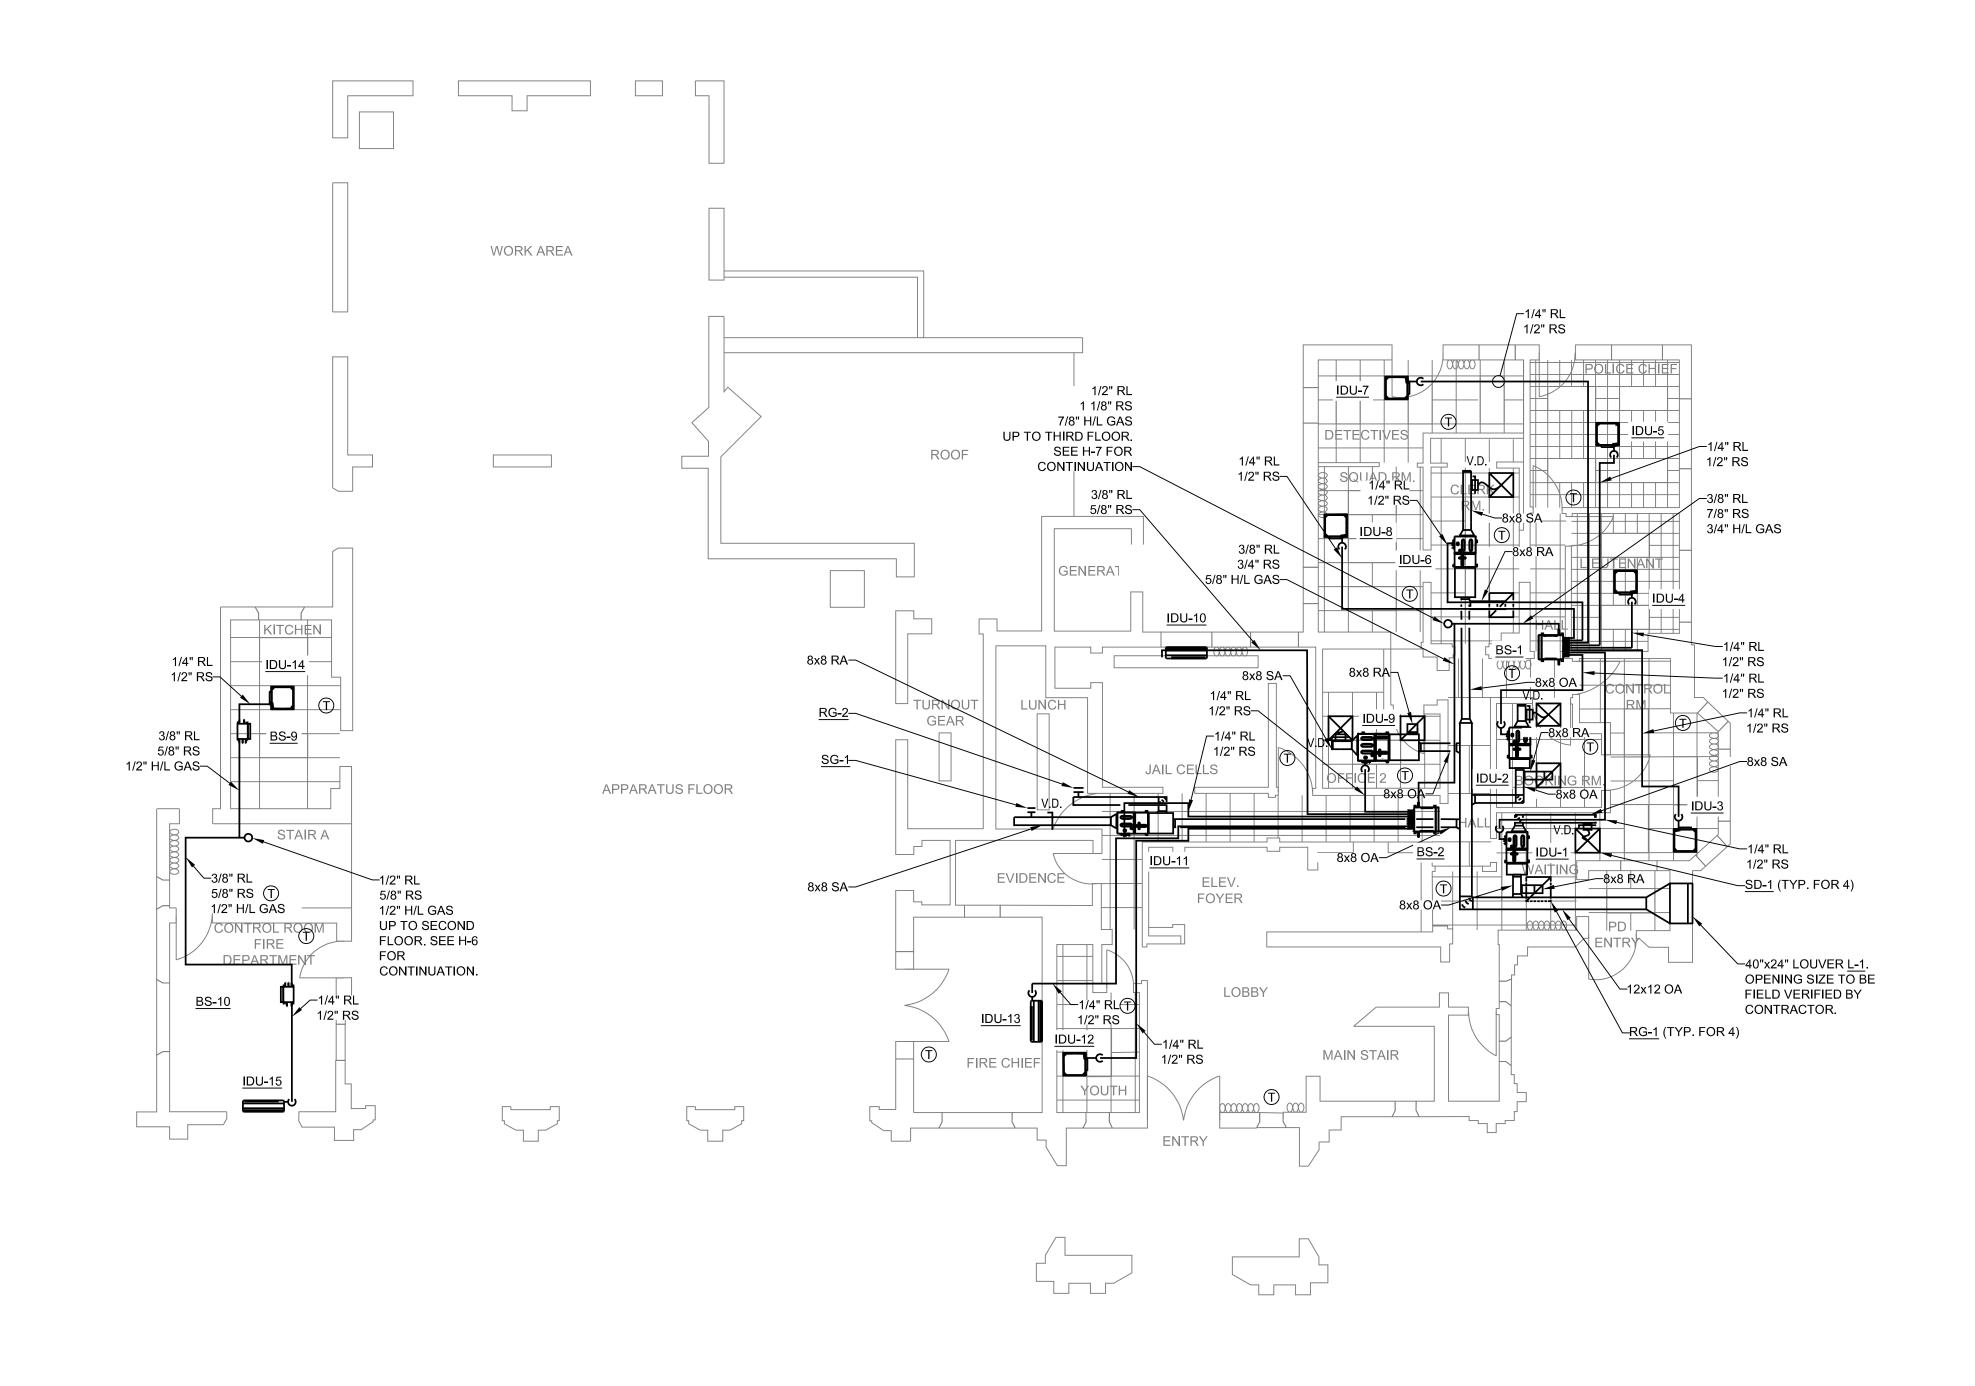
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COOLING SYSTEM REPLACEMENT AT LARCHMONT VILLAGE HALL		NO. DAT	E	ISSUED FOR / REVISION	BY	СНК	APP	DATE: 03/21/2024
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PROJECT LOCATION: 120 LARCHMONT AVE, LARCHMONT NY		2						DRAWN BY: KPT
CLIENT: VILLAGE OF LARCHMONT		3						CHECKED BY: GRL
DRAWING TITLE: MECHNICAL	ONTRACT	4						DRAWING NUMBER:
THIRD FLOOR DEMOLITION PLAN		5						H-4
		6						П-4



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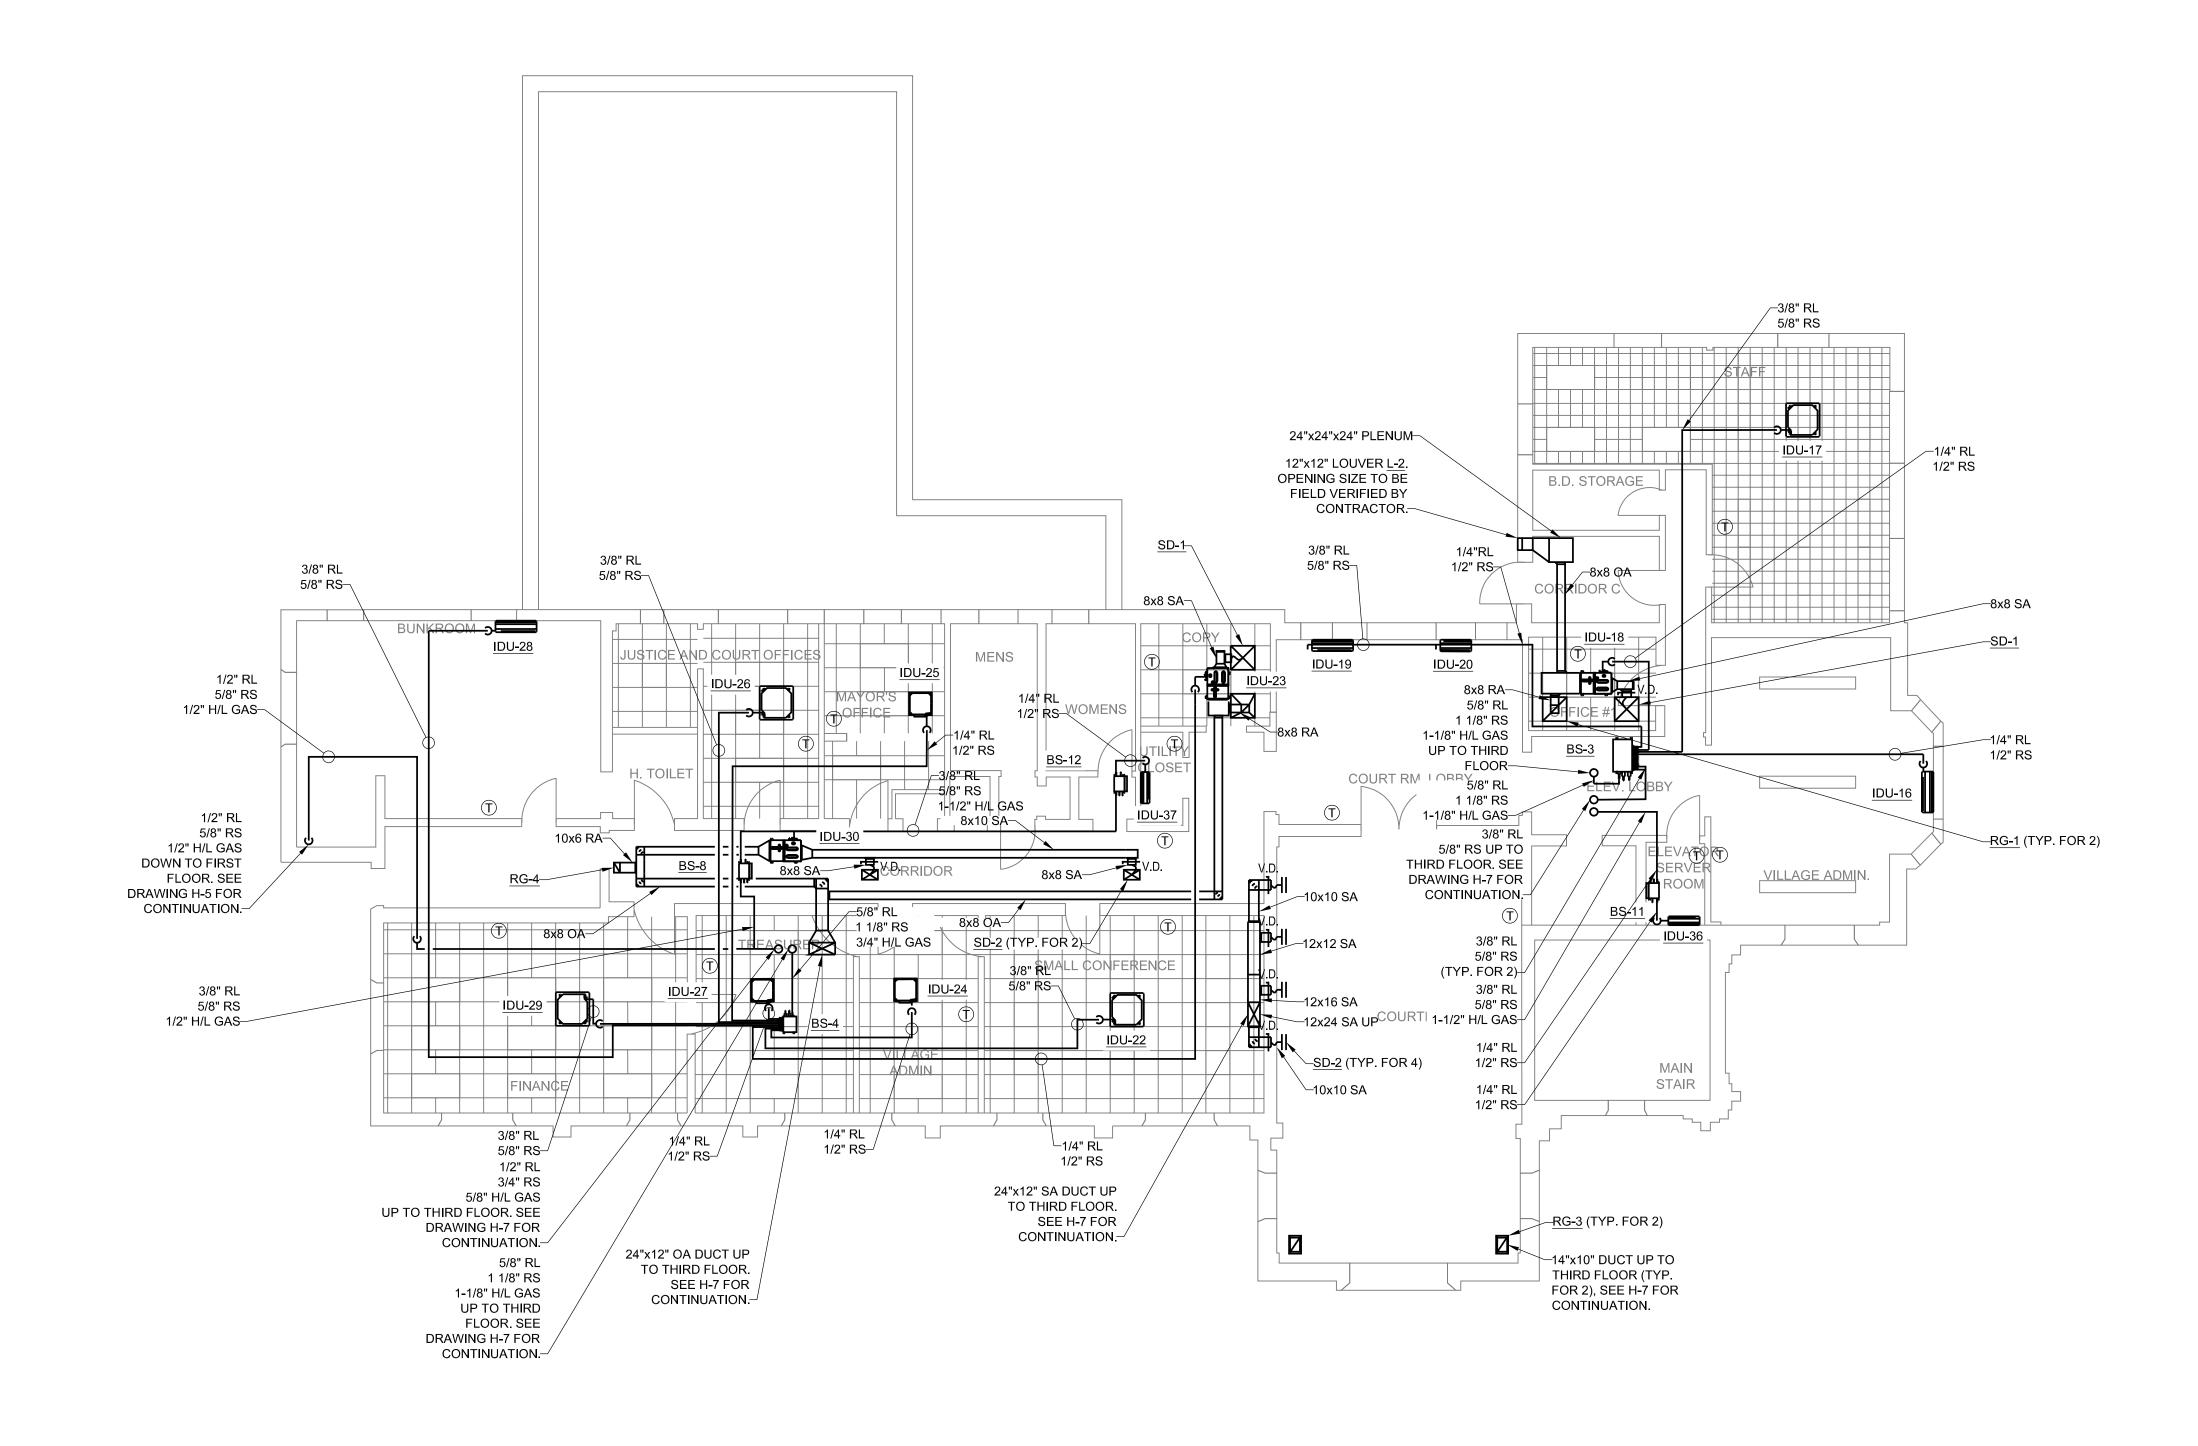
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COOLING SYSTEM REPLACEMENT AT LARCHMONT VILLAGE HALL		NO.	DATE ISSUED FOR / REVISION	BY	СНК	APP	DATE: 03/21/2024
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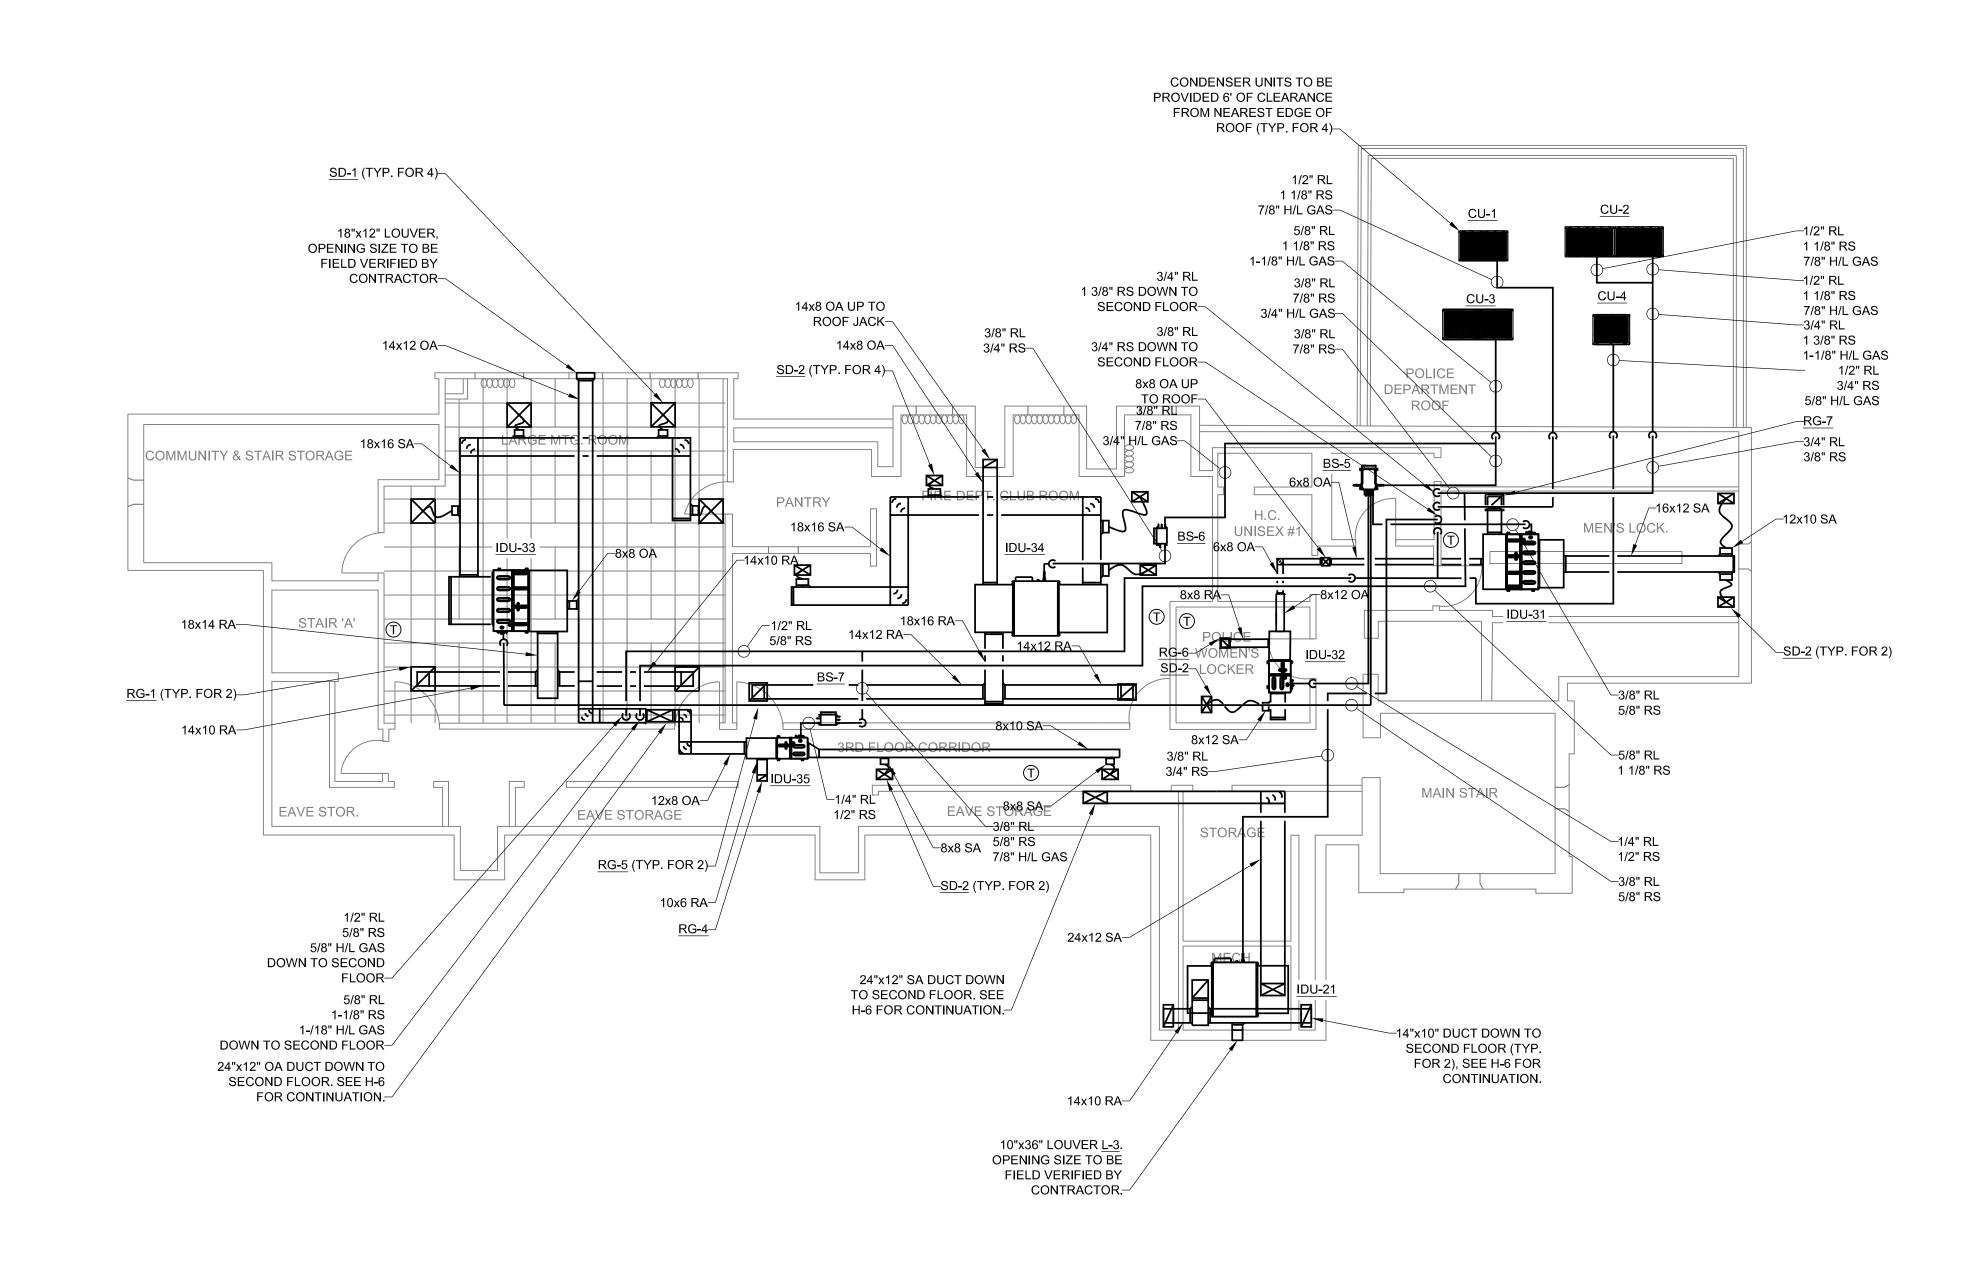
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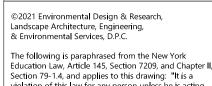


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CLIENT: VILLAGE OF LARCHMONT		3						CHECKED BY: GRL
DRAWING TITLE: MECHNICAL	CONTRACT	4						DRAWING NUMBER:
SECOND FLOOR PLAN		5						H-6
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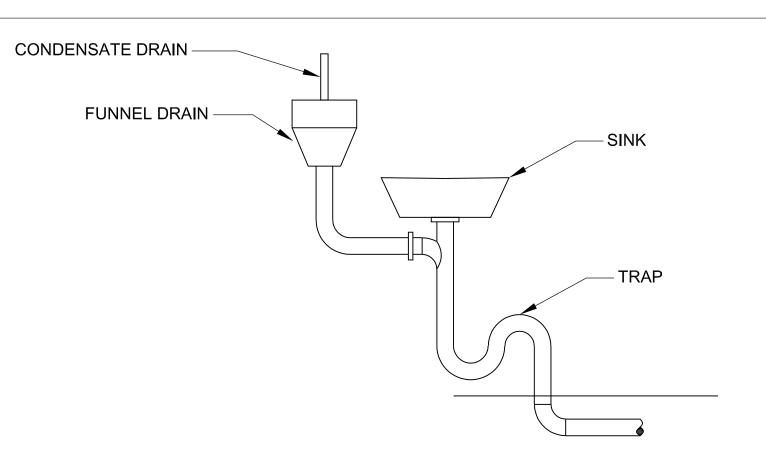
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COOLING SYSTEM REPLACEMENT AT LARCHMONT VILLAGE HALL	N	O. DATE ISSUED FOR / REVISION	ВУ	СНК	APP	DATE: 03/21/2024
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PROJECT LOCATION: 120 LARCHMONT AVE, LARCHMONT NY	2	2				DRAWN BY: KPT
CLIENT: VILLAGE OF LARCHMONT	3	3				CHECKED BY: GRL
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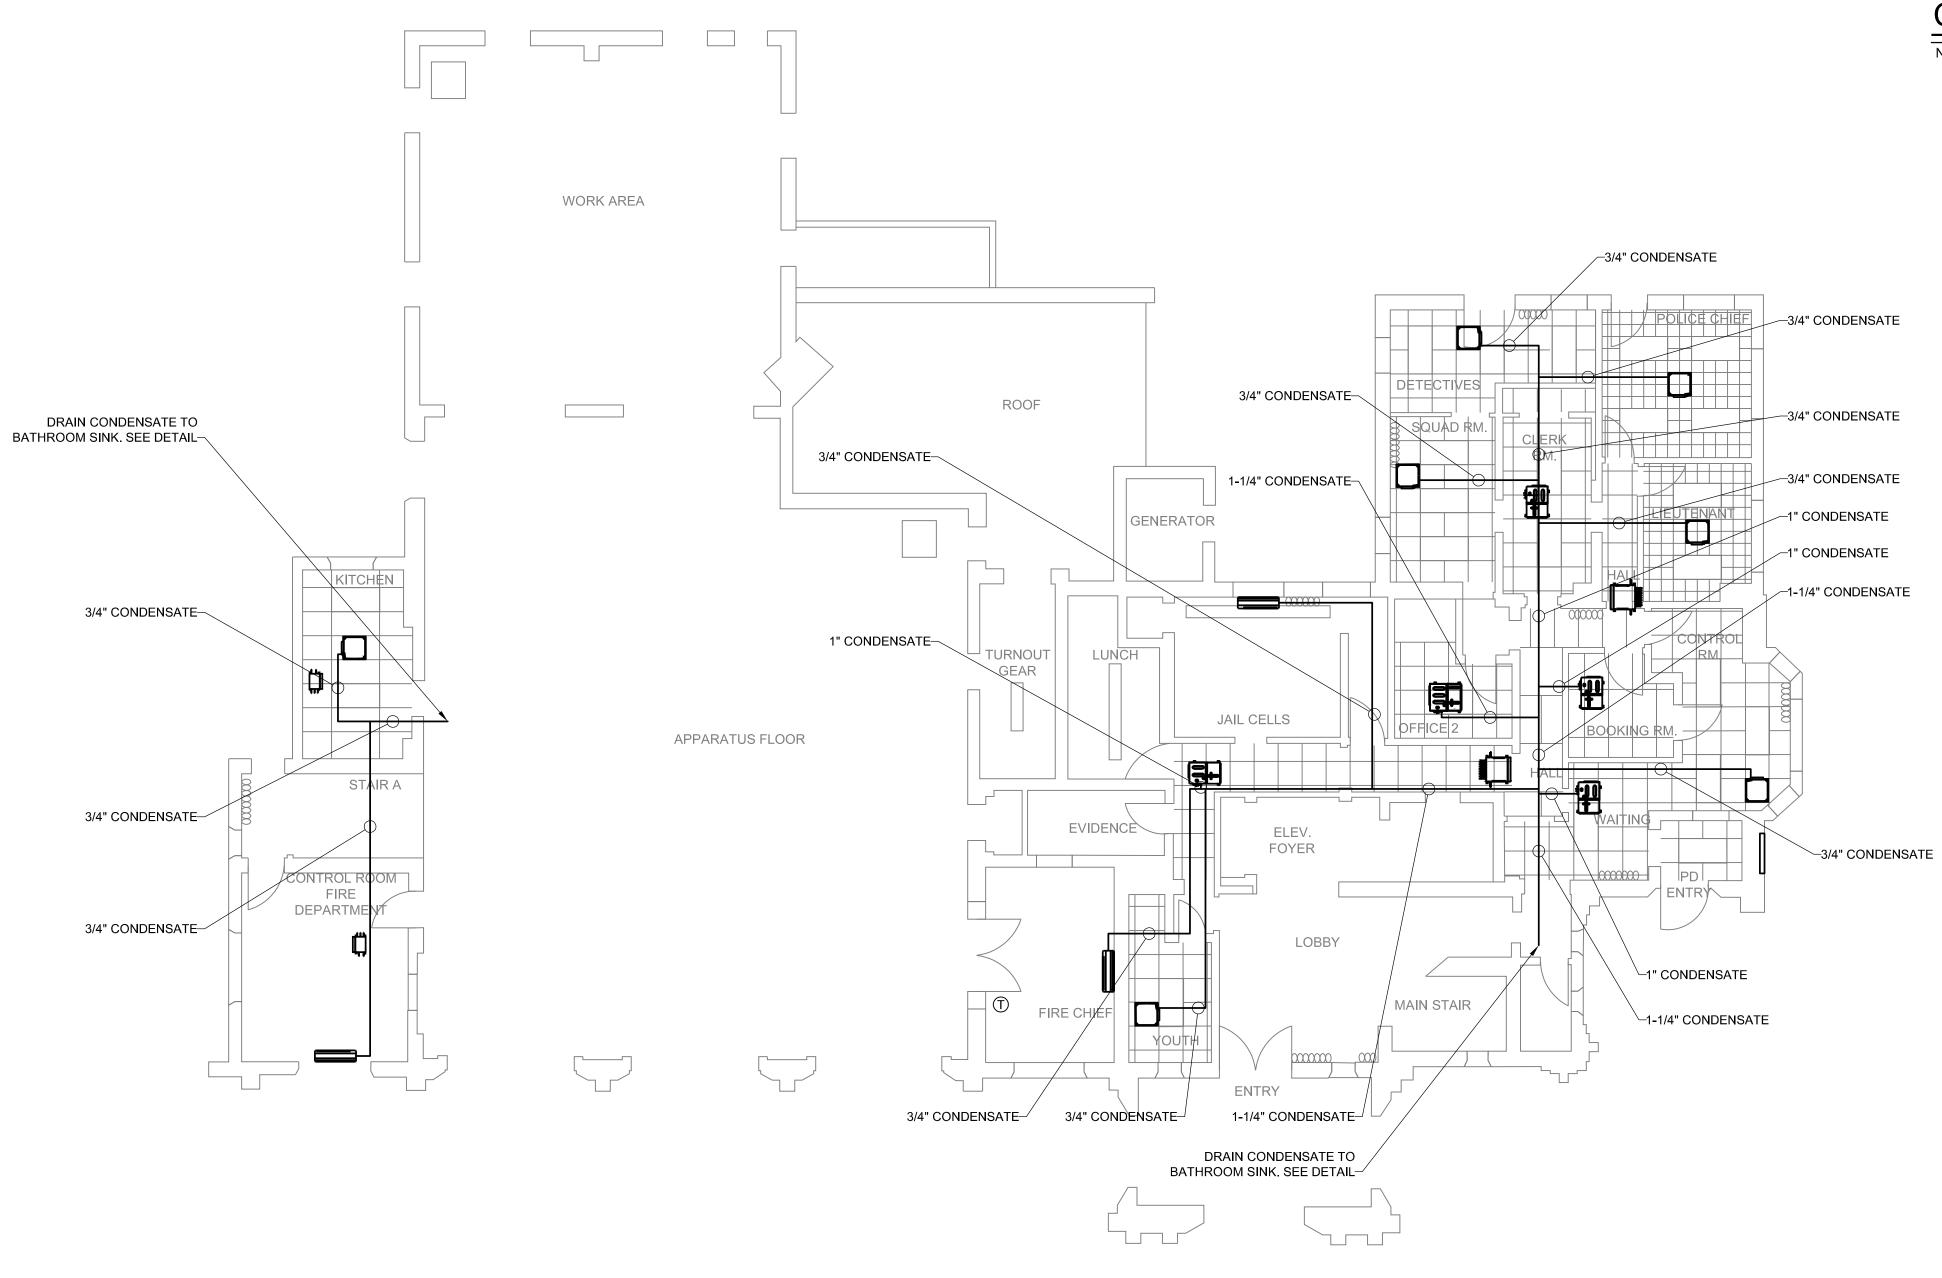
NOTES

- 1. ALL CONDENSATE PIPING TO BE DWV COPPER.
- 2. CONDENSATE DRAINS SHALL NOT DIRECTLY CONNECT TO ANY PLUMBING DRAIN, WASTE OR VENT PIPE.
- 3. CONDENSATE DRAINS SHALL NOT DISCHARGE INTO A PLUMBING FIXTURE OTHER THAN A FLOOR SINK, FLOOR DRAIN, TRENCH DRAIN, MOP SINK, HUB DRAIN, STANDPIPE, UTILITY SINK OR LAUNDRY SINK.
- 4. CONDENSATE DRAIN CONNECTIONS TO A LAVATORY WYE BRANCH TAILPIECE OR TO A BATHTUB OVERFLOW PIPE SHALL NOT BE CONSIDERED AS DISCHARGING TO A PLUMBING FIXTURE.
- 5. EXCEPT WHERE DISCHARGING TO GRADE OUTDOORS, THE POINT OF DISCHARGE OF CONDENSATE DRAINS SHALL BE LOCATED WITHIN THE SAME OCCUPANCY, TENANT SPACE OR DWELLING UNIT AS THE SOURCE OF THE CONDENSATE.



CONDENSATE DRAIN DETAIL

NO SCALE



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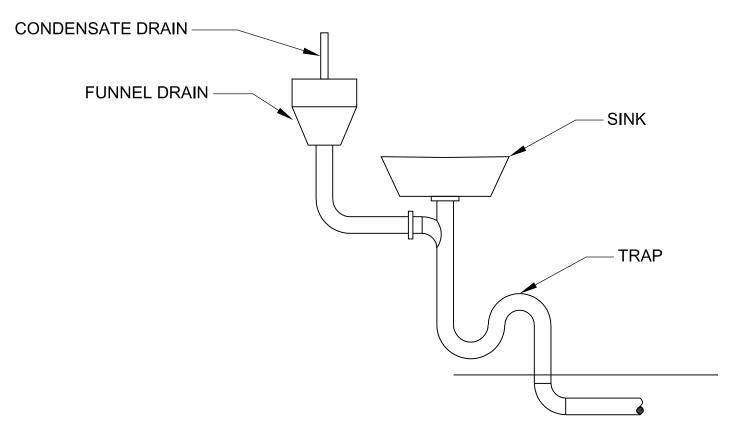
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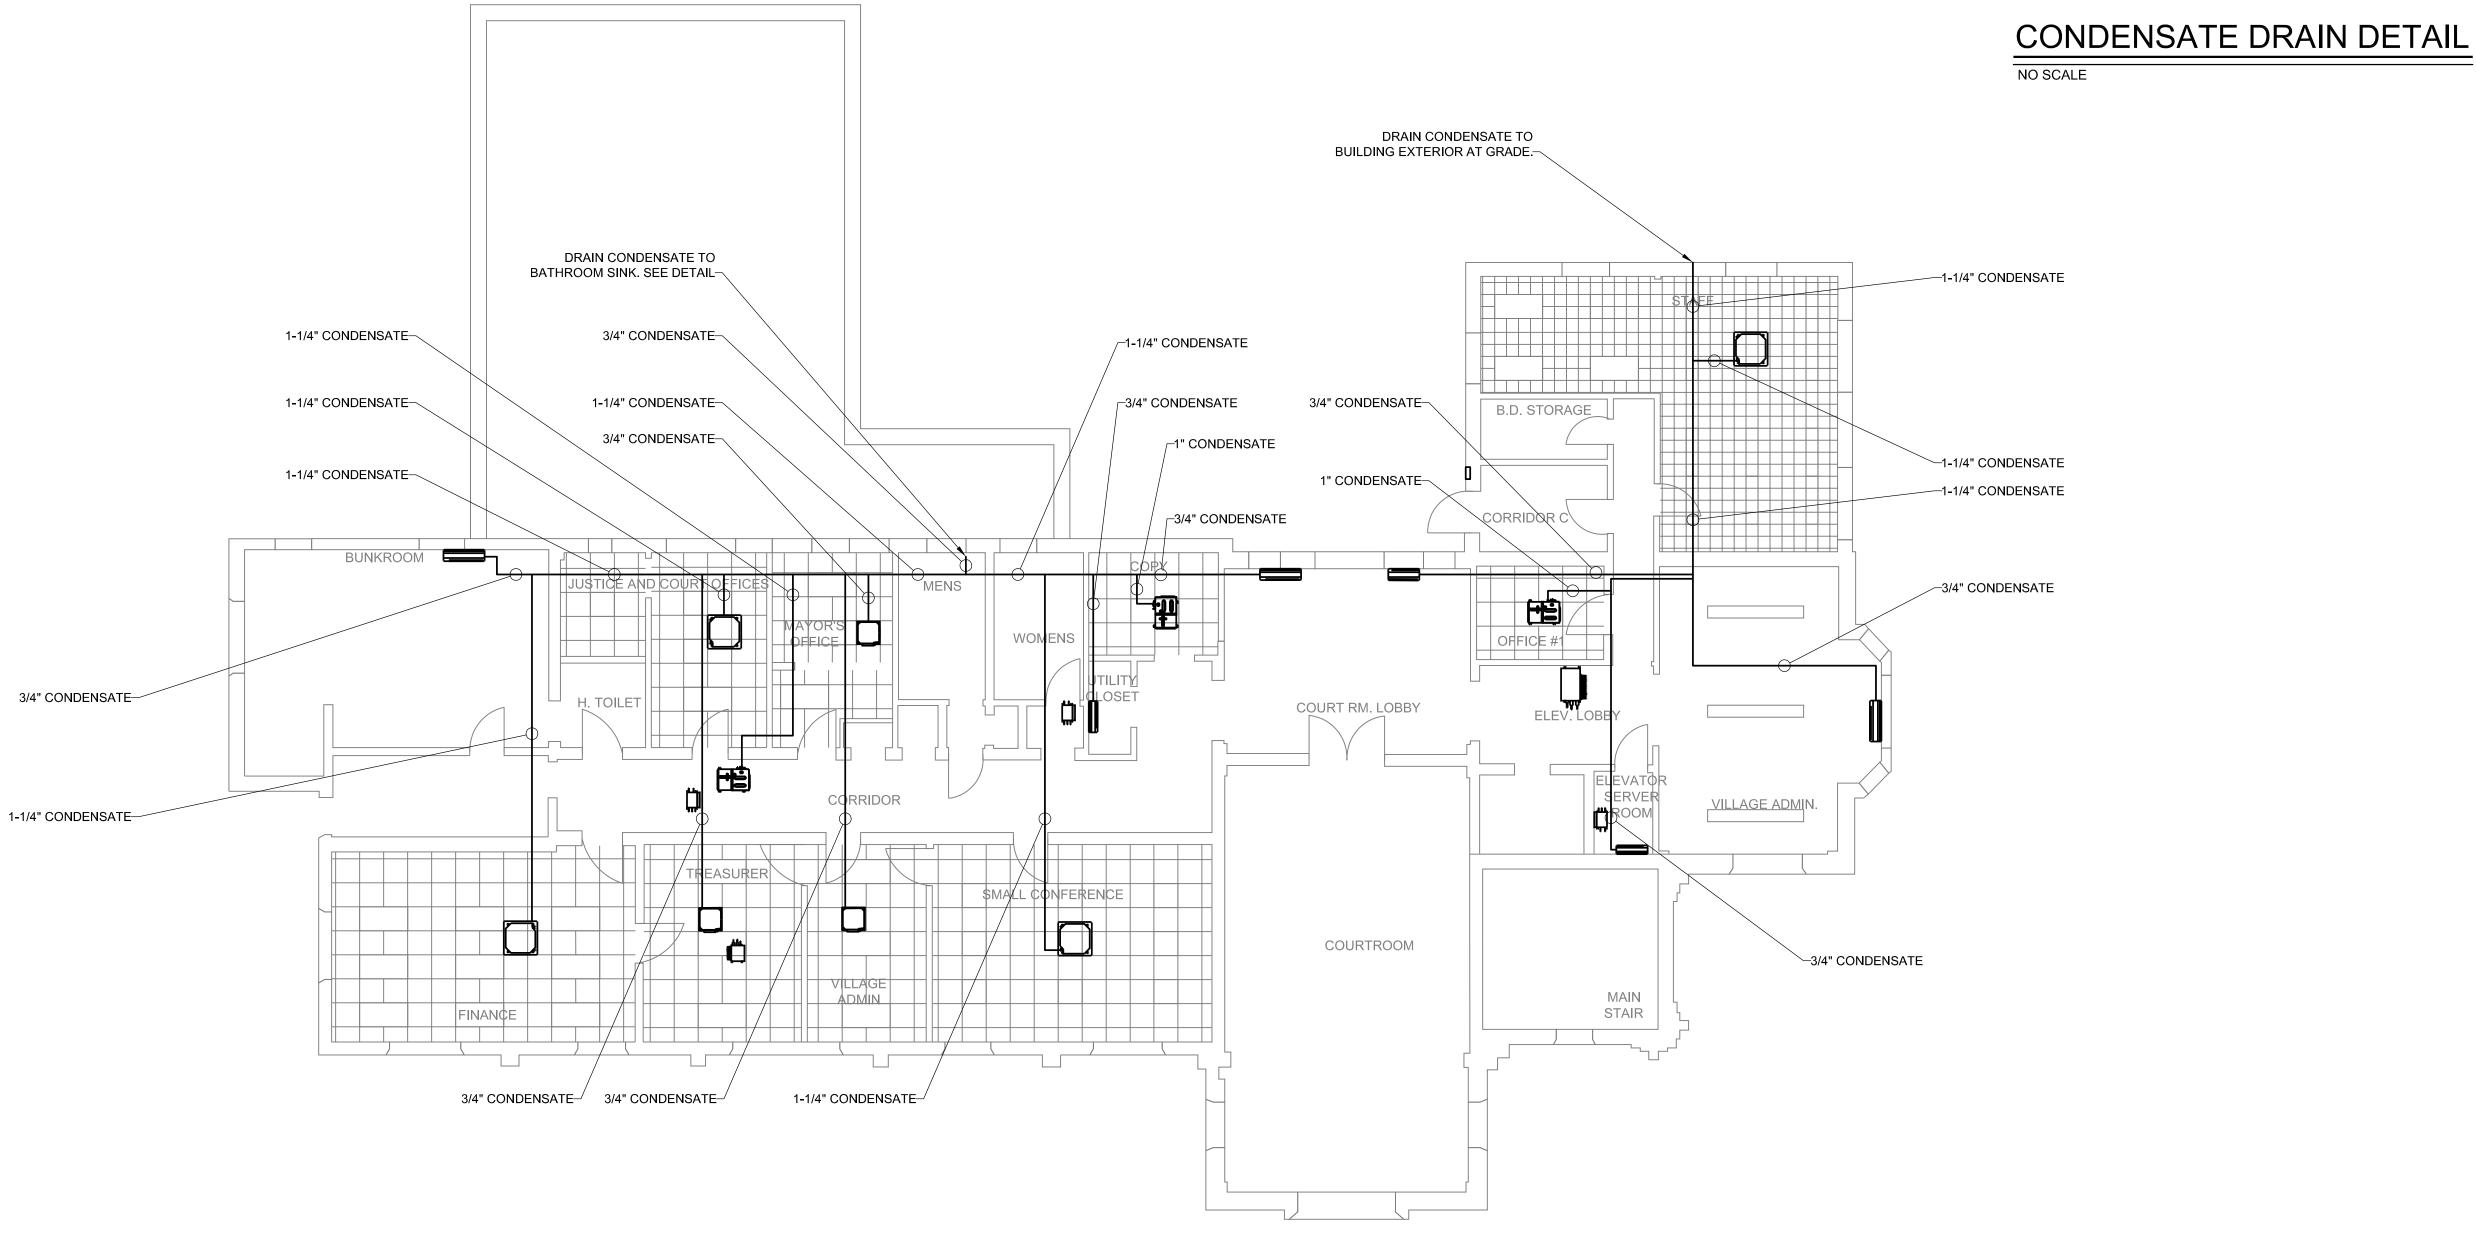




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PROJECT TITLE:	D	RAWINGS ISSU	JED FOR / REVISIONS			EDR JOB#: 2307
COOLING SYSTEM REPLACEMENT AT LARCHMONT VILLAGE HALL	NC	DATE	ISSUED FOR / REVISION	ВУ	CHK A	APP DATE: 03/21/2024
	1	03/21/2024	100% FOR BID	EDR	JSR G	RL SCALE: 1/8" = 1'-0"
ROJECT LOCATION: 120 LARCHMONT AVE, LARCHMONT NY	2					DRAWN BY: KPT
CLIENT: VILLAGE OF LARCHMONT	3					CHECKED BY: GRL
DRAWING TITLE: CONDENSATE	ACT 4					DRAWING NUMBER:
FIRST FLOOR PLAN	5					H-8
	6					П-0






©2021 Environmental Design & Research, Landscape Architecture, Engineering, & Environmental Services, D.P.C. The following is paraphrased from the New York Education Law, Article 145, Section 7209, and Chapter II, Section 79-1.4, and applies to this drawing: "It is a violation of this law for any person unless he is acting under the direction of a licensed professional engineer, licensed landscape architect or licensed land surveyor to alter an item in any way. If an item bearing the seal of an engineer, landscape architect or land surveyor is altered, the altering engineer, landscape architect or land surveyor shall affix to the item his seal and the notation "altered by" followed by his signature and the date of such alteration and a specific description of the alteration".






Environmental Design & Research,

PROJECT TITLE:	D	RAWINGS ISSU	JED FOR / REVISIONS		EDR JOB#: 2307
COOLING SYSTEM REPLACEMENT AT LARCHMONT VILLAGE HALL	NC	DATE	ISSUED FOR / REVISION	ВУ	CHK APP DATE: 03/21/2024
	1	03/21/2024	100% FOR BID	EDR	JSR GRL SCALE: 1/8" = 1'-0"
PROJECT LOCATION: 120 LARCHMONT AVE, LARCHMONT NY	2				DRAWN BY: KPT
CLIENT: VILLAGE OF LARCHMONT	3				CHECKED BY: GRL
DRAWING TITLE: CONDENSATE	RACT 4				DRAWING NUMBER:
SECOND FLOOR PLAN	5				L O
	6				H-9

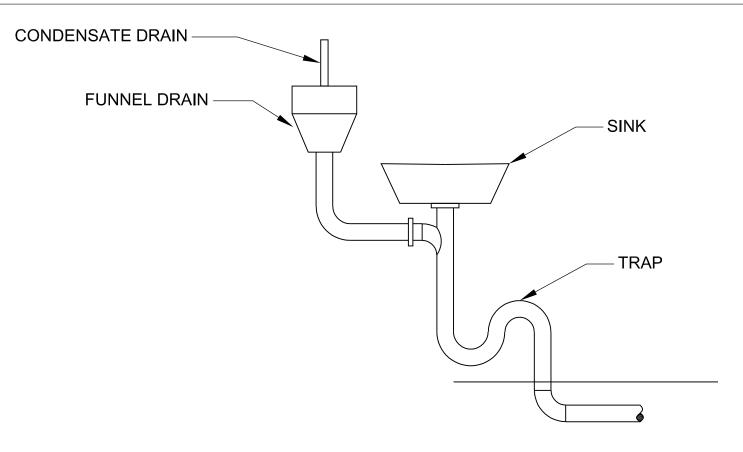

CONDENSATE DRAIN DETAIL

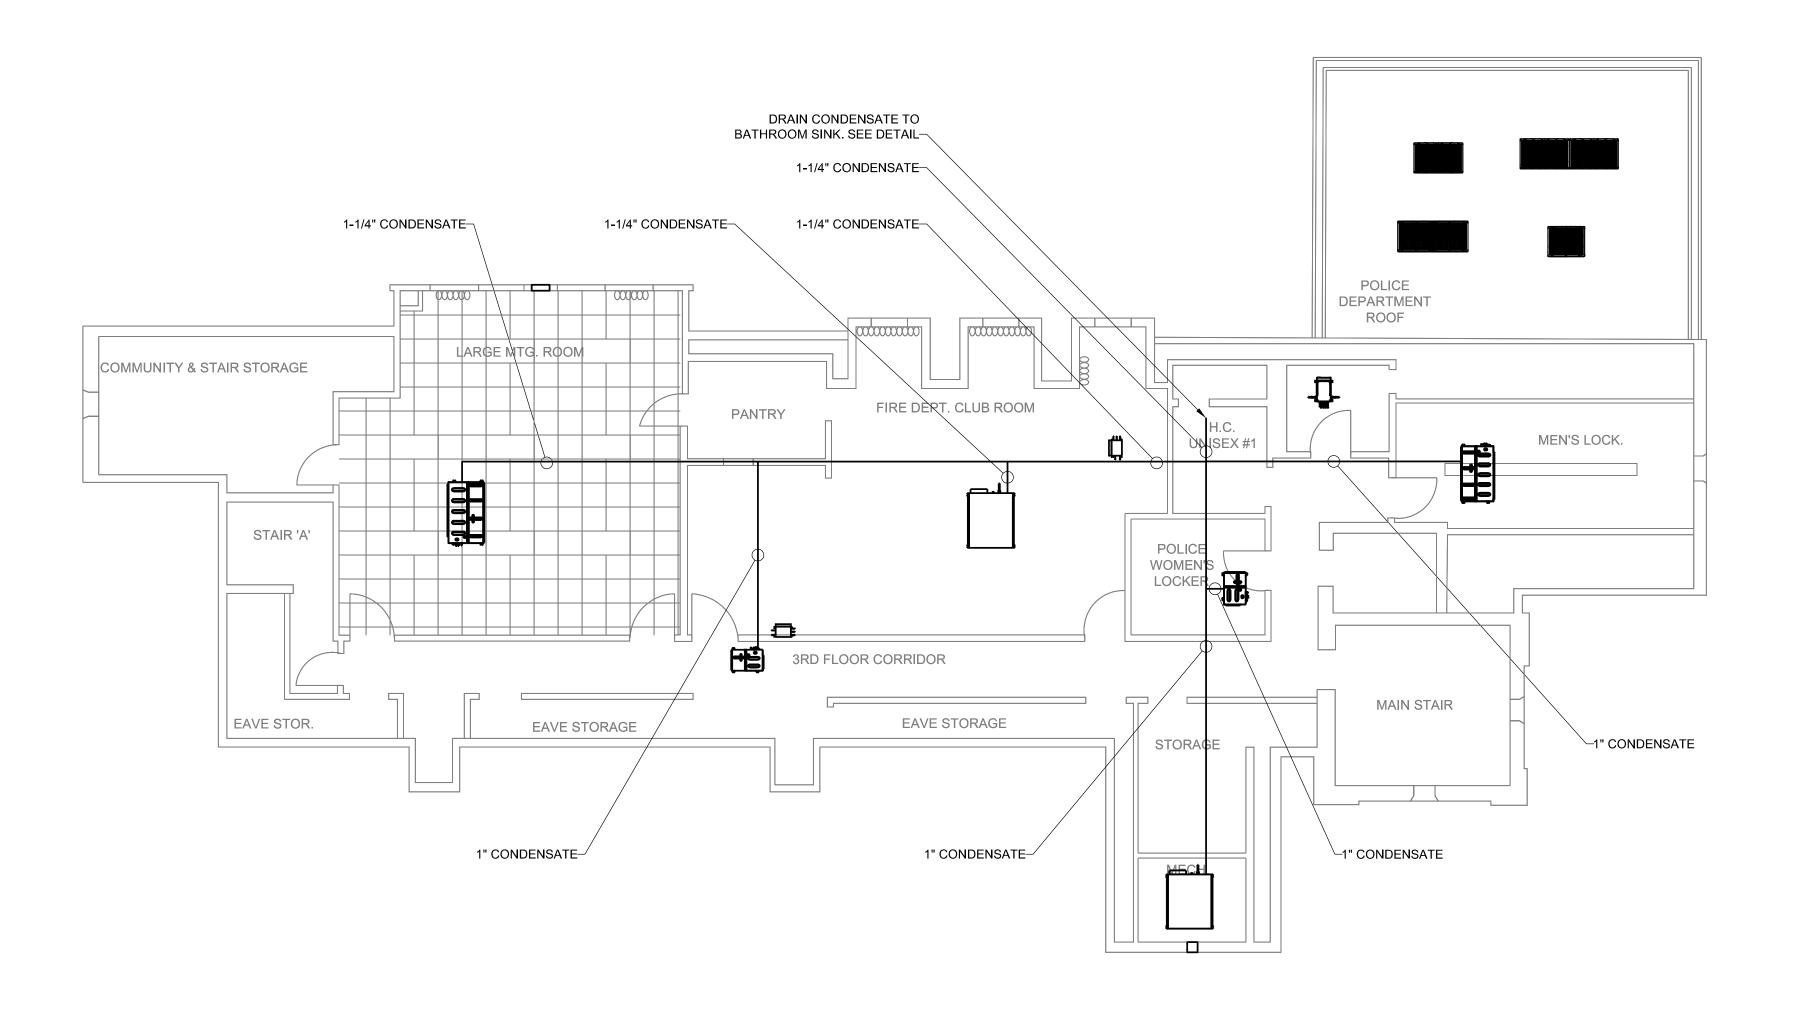

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Environmental Design & Research,

PROJECT TITLE:	DF	rawings issu	JED FOR / REVISIONS				EDR JOB#: 2307
COOLING SYSTEM REPLACEMENT AT LARCHMONT VILLAGE HALL	NO.	. DATE	ISSUED FOR / REVISION	BY	СНК	APP	DATE: 03/21/2024
	1	03/21/2024	100% FOR BID	EDR	JSR	GRL	SCALE: 1/8" = 1'-0"
PROJECT LOCATION: 120 LARCHMONT AVE, LARCHMONT NY	2						DRAWN BY: KPT
CLIENT: VILLAGE OF LARCHMONT	3						CHECKED BY: GRL
DRAWING TITLE: CONDENSATE	CT 4						DRAWING NUMBER:
THIRD FLOOR PLAN	5						H-10
	6						H-IV

CONDENSER SCHEDULE

				COOLING				-	ECTRICAL D	A T A				
UNIT NO.	LOCATION	NOMINAL	COOLING CAPACITY	EFFIC	IENCY	REFRIGE RANT	HEATING CAPACITY (BTU/h)	ELECTRICAL DATA			DIMENSIONS LxWxH	WEIGHT (LBS)	MFR. & MODEL NO.	REMARKS
		TONNAGE	(BTU/h)	IEER	EER	TYPE		V/P/Hz	MCA	MOCP				
CU-1	POLICE DEPARTMENT ROOF	12	142,537	26.5 / 22.5	12.5 / 12	R-410A	121,474	208/3/60	47.8	50	48.8" x 65.4" x 30.1"	784.8	DAIKIN REYQ144AATJA	
CU-2	POLICE DEPARTMENT ROOF	24	291,252	23.2 / 19.3	12 / 11	R-410A	245,625	208/3/60	47.8 + 47.8	50 + 50	97.6" x 65.4" x 30.1"	1,569.6	DAIKIN REYQ288AATJA	
CU-3	POLICE DEPARTMENT ROOF	16	185,565	24 / 21	12.3 / 11.5	R-410A	154,807	208/3/60	59.8	60	48.8" x 65.4" x 30.1"	787.1	DAIKIN REYQ192AATJA	
CU-4	POLICE DEPARTMENT ROOF	6	63,042	28 / 23	15.7 / 12.8	R-410A	70,855	208/3/60	27.3	30	36.6" x 65.4" x 30.1"	509.3	DAIKIN REYQ72AATJA	


BRANCH SELECTOR BOXES												
UNIT NO.	SERVICE		ELECTRIC	CAL DATA		DIMENSIONS LxWxH	WEIGHT (LBS)	MFR. & MODEL NO.	REMARKS			
		V/P/Hz	MCA	MOCP MAX CAPACITY								
BS-1	CU-1	208/1/60	0.8	15	54,000	23.3" x 9.5" x 23.7"	81.6	DAIKIN BSF8Q54TVJ				
BS-2	CU-1	208/1/60	0.6	15	54,000	23.3" x 9.5" x 23.7"	72.8	DAIKIN BSF6Q54TVJ				
BS-3	CU-2	208/1/60	1.0	15	54,000	32.3" x 11.7" x 18.9"	101.4	DAIKIN BS10Q54TVJ				
BS-4	CU-2	208/1/60	0.6	15	54,000	22.8" x 11.7" x 18.9"	68.3	DAIKIN BS6Q54TVJ				
BS-5	CU-3	208/1/60	0.4	15	54,000	13.7" x 9.5" x 23.7"	48.5	DAIKIN BSF4Q54TVJ				
BS-6	CU-3	208/1/60	0.1	15	96,000	15.3" x 8.1" x 12.8"	33.1	DAIKIN BSQ96TVJ				
BS-7	CU-4	208/1/60	0.1	15	36,000	15.3" x 8.1" x 12.8"	27.0	DAIKIN BSQ36TVJ				
BS-8	CU-4	208/1/60	0.1	15	36,000	15.3" x 8.1" x 12.8"	27.0	DAIKIN BSQ36TVJ				
BS-9	CU-4	208/1/60	0.1	15	36,000	15.3" x 8.1" x 12.8"	27.0	DAIKIN BSQ36TVJ				
BS-10	CU-4	208/1/60	0.1	15	36,000	15.3" x 8.1" x 12.8"	27.0	DAIKIN BSQ36TVJ				
BS-11	CU-4	208/1/60	0.1	15	36,000	15.3" x 8.1" x 12.8"	27.0	DAIKIN BSQ36TVJ				
BS-12	CU-4	208/1/60	0.1	15	36,000	15.3" x 8.1" x 12.8"	27.0	DAIKIN BSQ36TVJ				

	LOUVER SCHEDULE													
UNIT NO.	SERVICE	DII	MENSIONS (INCHE	ES)	MINIMUM FREE	AIRFLOW RATE	PRESSURE	MFR. & MODEL NO.	REMARKS					
UNIT NO.	SERVICE	WIDTH	LENGTH	SECTIONS	AREA (SQFT)	(CFM)	DROP ('WG)	WIFR. & WODEL NO.	REWARKS					
L-1	IDU-1, IDU-2, IDU-6 IDU-9, IDU-11	40"	24"	1	3.71	160	0.000	GREENHECK ESD-635	1, 2					
L-2	IDU-18	12"	12"	1	0.19	15	0.001	GREENHECK ESD-635	1, 2					
L-3	IDU-21	10"	36"	1	0.7	310	0.028	GREENHECK ESD-202	1, 2					

1. PROVIDE UNIT WITH BIRDSCREEN.

2. CONTRACTOR RESPONSIBLE FOR COORDINATING LOUVER FINISH WITH ARCHITECT AND MANUFACTURER PRIOR TO ORDERING

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COOLING SYSTEM REPLACEMENT AT LARCHMONT VILLAGE HALL				DRAWINGS ISSUED FOR / REVISIONS						
				ISSUED FOR / REVISION	BY	СНК	APP	DATE: 03/21/2024		
		1 03/2	21/2024	100% FOR BID	EDR	JSR	GRL	SCALE: NTS		
PROJECT LOCATION: 120 LARCHMONT AVE, LARCHMONT NY		2						DRAWN BY: KPT		
CLIENT: VILLAGE OF LARCHMONT		3						CHECKED BY: GRL		
DRAWING TITLE: MECHNICAL COL	NTRACT	4						DRAWING NUMBER:		
SCHEDULES		5						H-11		
		6						П-11		

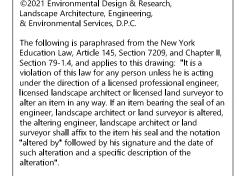					AIR	TERN	MINAL	.S		
UNIT NO.	NO.	CFM (MAX/MIN)	ESP ("WG)	DIMENSIONS LxW (INCHES)	BLADE SPACING (INCHES)	MATERIAL	NC	THROW (FEET)	MFR. & MODEL NO.	REMARKS
SD-1	10	380 / 281	.062	24x24	-	ALUMINUM	35	6	TITUS TMSA-AA 8" DIA.	1, 2
SD-2	15	565 / 140	.090	16x10	-	ALUMINUM	30	27	TITUS 250-AA 1 WAY DISCHARGE	1, 2
SG-1	1	281	.068	10x6	3/4"	ALUMINUM	25	15	TITUS 271FL	1, 2
RG-1	8	281 / 760	.002	24x24	3/4"	ALUMINUM	15	-	TITUS 3FL	1, 2
RG-2	1	281	.031	12x6	3/4"	ALUMINUM	35	-	TITUS 3FL	1, 2
RG-3	2	810	.022	18x12	3/4"	ALUMINUM	35	-	TITUS 3FL	1, 2
RG-4	2	281	.016	10x10	3/4"	ALUMINUM	30	-	TITUS 3FL	1, 2
RG-5	2	905	.016	18x18	3/4"	ALUMINUM	35	-	TITUS 3FL	1, 2
RG-6	1	275	.016	10x10	3/4"	ALUMINUM	30	-	TITUS 3FL	1, 2
RG-7	1	485	.016	18x16	3/4"	ALUMINUM	35	-	TITUS 3FL	1, 2

1. GRILLES SHALL BE COMPATIBLE WITH ARCHITECTURAL CEILING GRID AND/OR WALLS AS REQUIRED. CONTRACTOR IS RESPONSIBLE FOR COORDINATING GRILLE MOUNTING OPTIONS WITH ARCHITECT AND MANUFACTURER PRIOR TO ORDERING AND INSTALLING.

2. COORDINATE GRILLE INSTALLATION WITH ALL OTHER TRADES.

							INDO	OR L	JNITS	1						
			NOMINAL	CONDENSING		СО	OLING CAPA	CITY		HEATING	ELEG	CTRICAL [DATA	DIMENSIONS LxW	WEIGHT	
UNIT NO.	SERVICE	UNIT TYPE	TONNAGE	UNIT	CFM	TOTAL BTU/h	SENSIBLE BTU/H	ENTERING AIR (°F DB)	ENTERING AIR (°F WB)	CAPACITY (BTU/h)	V/P/Hz	MCA	МОСР	(INCHES)	(lbs.)	MFR. & MODEL NO.
IDU-1	WAITING	CONCEALED DUCTED	0.6	CU-1	281	7,507	5,625	80	67	8,503	208/1/60	0.8	15.0	21.7" x 9.6" x 31.5"	55	DAIKIN FXSQ07TAVJU
IDU-2	BOOKING ROOM	CONCEALED DUCTED	0.6	CU-1	281	7,507	5,625	80	67	8,503	208/1/60	0.8	15.0	21.7" x 9.6" x 31.5"	55	DAIKIN FXSQ07TAVJU
IDU-3	CONTROL ROOM PD	CEILING CASSETTE	1.0	CU-1	353	11,944	7,696	80	67	13,649	208/1/60	0.4	15.0	22.6" x 10.2" x 22.6"	36.4	DAIKIN FXZQ12TAVJU
IDU-4	LIEUTENANT	CEILING CASSETTE	0.5	CU-1	300	5,802	4,651	80	67	6,483	208/1/60	0.3	15.0	22.6" x 10.2" x 22.6"	35.3	DAIKIN FXZQ05TAVJU
IDU-5	POLICE CHIEF	CEILING CASSETTE	1.3	CU-1	405	15,015	10,672	80	67	17,061	208/1/60	0.4	15.0	22.6" x 10.2" x 22.6"	36.4	DAIKIN FXZQ15TAVJU
IDU-6	CLERK ROOM	CONCEALED DUCTED	0.5	CU-1	281	5,801	4,618	80	67	6,503	208/1/60	0.8	15.0	21.7" x 9.6" x 31.5"	55	DAIKIN FXSQ05TBVJU
IDU-7	DETECTIVES	CEILING CASSETTE	1.0	CU-1	353	11,944	7,686	80	67	13,649	208/1/60	0.4	15.0	22.6" x 10.2" x 22.6"	36.4	DAIKIN FXZQ12TAVJU
IDU-8	SQUAD ROOM	CEILING CASSETTE	0.6	CU-1	307	7,508	5,334	80	67	8,530	208/1/60	0.3	15.0	22.6" x 10.2" x 22.6"	35.3	DAIKIN FXZQ07TAVJU
IDU-9	OFFICE 2	CONCEALED DUCTED	1.3	CU-1	530	15,014	11,026	80	67	17,006	208/1/60	0.8	15.0	27.6" x 9.6" x 31.5"	60.0	DAIKIN FXSQ15TBVJU
IDU-10	JAIL CELLS	WALL MOUNTED	2.0	CU-1	635	24,004	17,105	80	67	20,132	208/1/60	0.6	15.0	41.4" x 11.4" x 9.3"	30.9	DAIKIN FXAQ24PVJU
IDU-11	LUNCH	CONCEALED DUCTED	0.6	CU-1	281	7,507	5,625	80	67	8,503	208/1/60	0.8	15.0	21.7" x 9.6" x 31.5"	41.9	DAIKIN FXSQ07TAVJU
IDU-12	YOUTH	CEILING CASSETTE	0.5	CU-1	300	5,802	4,651	80	67	6,483	208/1/60	0.3	15.0	22.6" x 10.2" x 22.6"	35.3	DAIKIN FXZQ05TAVJU
IDU-13	FIRE CHIEF	WALL MOUNTED	1.5	CU-1	500	18,003	13,374	80	67	20,009	208/1/60	0.4	15.0	41.3" x 11.4" x 9.6"	30.9	DAIKIN FXAQ18PVJU
IDU-14	KITCHEN	CEILING CASSETTE	1.3	CU-4	405	15,015	10,672	80	67	17,061	208/1/60	0.4	15.0	22.6" x 10.2" x 22.6"	36.4	DAIKIN FXZQ15TAVJU
IDU-15	CONTROL ROOM FD	WALL MOUNTED	1.5	CU-4	500	18,003	13,374	80	67	20,009	208/1/60	0.4	15.0	41.3" x 11.4" x 9.6"	30.9	DAIKIN FXAQ18PVJU
IDU-16	VILLAGE ADMIN S	WALL MOUNTED	1.5	CU-2	500	18,003	13,374	80	67	20,009	208/1/60	0.4	15.0	41.3" x 11.4" x 9.6"	30.9	DAIKIN FXAQ18PVJU
IDU-17	STAFF	CEILING CASSETTE	3.0	CU-2	1,165	36,000	27,590	80	67	40,004	208/1/60	1.5	15.0	33.1" x 11.3" x 33.1"	57.3	DAIKIN FXFQ36TVJU
IDU-18	OFFICE 1	CONCEALED DUCTED	0.5	CU-2	281	5,800	4,621	80	67	6,503	208/1/60	0.8	15.0	21.7" x 9.6" x 31.5"	55	DAIKIN FXSQ05TAVJU

						0.0		NOITY			El Ec	STDICAL F) A T A			
LINIT NO	055)/105		NOMINAL	CONDENSING		C	OOLING CAPA	ACITY		HEATING CAPACITY	ELEC	CTRICAL [JATA	DIMENSIONS LxW	WEIGHT	MED & MODEL NO
UNIT NO.	SERVICE	UNIT TYPE	TONNAGE	UNIT	CFM	TOTAL BTU/h	SENSIBLE BTU/H	ENTERING AIR (°F DB)	ENTERING AIR (°F WB)	(BTU/h)	V/P/Hz	MCA	MOP	(INCHES)	(lbs.)	MFR. & MODEL NO.
IDU-19	COURTROOM LOBBY	WALL MOUNTED	2.0	CU-2	635	24,004	17,105	80	67	26,509	208/1/60	0.6	15.0	41.4" x 11.4" x 9.3"	30.9	DAIKIN FXAQ24PVJU
IDU-20	COURTROOM LOBBY	WALL MOUNTED	1.0	CU-2	290	12,002	8,695	80	67	13,505	208/1/60	0.4	15.0	31.3" x 11.4" x 9.3"	26.5	DAIKIN FXAQ12PVJU
IDU-21	COURTROOM	CONCEALED DUCTED	6.0	CU-2	2,048	72,004	55,504	80	67	81,027	208/1/60	9.0	15.0	54.3" x 18.1" x 43.3"	302.0	DAIKIN FXMQ72MVJU
IDU-22	SMALL CONFERENCE	CEILING CASSETTE	3.0	CU-2	1,165	36,000	27,590	80	67	40,004	208/1/60	1.5	15.0	33.1" x 11.3" x 33.1"	57.3	DAIKIN FXFQ36TVJU
IDU-23	COPY	CONCEALED DUCTED	0.5	CU-2	281	5,800	4,621	80	67	6,503	208/1/60	0.8	15.0	21.7" x 9.6" x 31.5"	55.0	DAIKIN FXSQ05TAVJU
IDU-24	VILLAGE ADMIN E	CEILING CASSETTE	0.6	CU-2	307	7,508	5,334	80	67	8,530	208/1/60	0.3	15.0	22.6" x 10.2" x 22.6"	35.3	DAIKIN FXZQ07TAVJU
IDU-25	MAYOR'S OFFICE	CEILING CASSETTE	1.0	CU-2	353	11,944	7,696	80	67	13,649	208/1/60	0.4	15.0	22.6" x 10.2" x 22.6"	36.4	DAIKIN FXZQ12TAVJU
IDU-26	JUSTICE AND COURT ROOM	CEILING CASSETTE	2.5	CU-2	1,112	29,994	21,795	80	67	34,012	208/1/60	1.3	15.0	33.1" x 11.3" x 33.1"	57.3	DAIKIN FXFQ30TVJU
IDU-27	TREASURER	CEILING CASSETTE	1.3	CU-2	405	15,015	10,672	80	67	17,061	208/1/60	0.4	15.0	22.6" x 10.2" x 22.6"	36.4	DAIKIN FXZQ15TAVJU
IDU-28	BUNK ROOM	WALL MOUNTED	2.0	CU-2	635	24,004	17,105	80	67	26,509	208/1/60	0.6	15.0	41.4" x 11.4" x 9.3"	30.9	DAIKIN FXAQ24PVJU
IDU-29	FINANCE	CEILING CASSETTE	2.5	CU-2	1,112	29,994	21,795	80	67	34,012	208/1/60	1.3	15.0	33.1" x 11.3" x 33.1"	57.3	DAIKIN FXFQ30TVJU
IDU-30	2ND FLOOR CORRIDOR	CONCEALED DUCTED	0.6	CU-4	281	7,200	5,392	80	67	8,503	208/1/60	0.8	15.0	21.7" x 9.6" x 31.5"	55.0	DAIKIN FXSQ07TBVJU
IDU-31	MEN'S LOCKER	CONCEALED DUCTED	3.0	CU-3	1,130	36,000	25,126	80	67	40,015	208/1/60	2.5	15.0	55.1" x 9.6" x 31.5"	101.0	DAIKIN FXSQ36TBVJU
IDU-32	POLICE WOMEN'S LOCKER	CONCEALED DUCTED	1.0	CU-3	335	12,012	9,413	80	67	13,506	208/1/60	0.8	15.0	21.7" x 9.6" x 31.5"	82.0	DAIKIN FXSQ12TBVJU
IDU-33	LARGE MTG. ROOM	CONCEALED DUCTED	4.5	CU-3	1,519	57,006	40,821	80	67	63,026	208/1/60	3.6	15.0	61.0" x 9.6" x 31.5"	114.6	DAIKIN FXMQ54TBVJU
IDU-34	FIRE DEPT. CLUB ROOM	CONCEALED DUCTED	6.0	CU-3	2,048	72,004	55,504	80	67	81,027	208/1/60	9.0	15.0	54.3" x 18.1" x 43.3"	302.0	DAIKIN FXMQ72MVJU
IDU-35	3RD FLOOR CORRIDOR	CONCEALED DUCTED	0.6	CU-4	281	7,200	5,392	80	67	8,503	208/1/60	0.8	15.0	21.7" x 9.6" x 31.5"	55.0	DAIKIN FXSQ07TBVJU
IDU-36	ELEVATOR SERVER ROOM	WALL MOUNTED	0.6	CU-4	260	7,501	6,041	80	67	8,502	208/1/60	0.3	15.0	31.3" x 11.4" x 9.3"	26.5	DAIKIN FXAQ07PVJU
IDU-37	UTILITY CLOSET	WALL MOUNTED	0.6	CU-4	260	7,501	6,041	80	67	8,502	208/1/60	0.3	15.0	31.3" x 11.4" x 9.3"	26.5	DAIKIN FXAQ07PVJU


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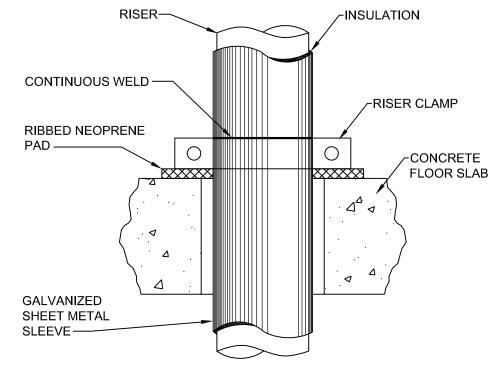




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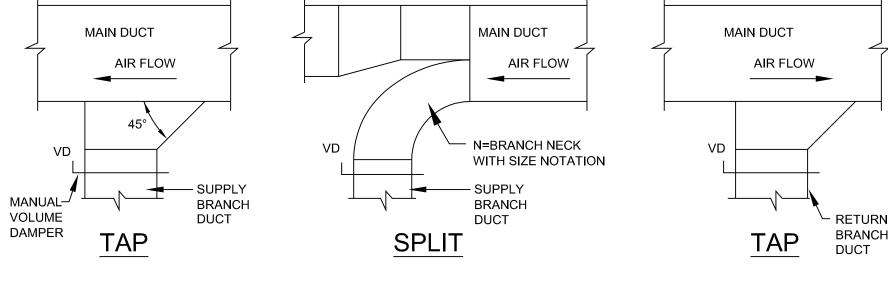
PROJECT TITLE:	DR	AWINGS ISSU		EDR JOB#: 2307			
COOLING SYSTEM REPLACEMENT AT LARCHMONT VILLAGE HALL	NO.	DATE	ISSUED FOR / REVISION	ВҮ	СНК	APP	DATE: 03/21/2024
	1	03/21/2024	100% FOR BID	EDR	JSR	GRL	SCALE: NTS
PROJECT LOCATION: 120 LARCHMONT AVE, LARCHMONT NY	2						DRAWN BY: KPT
CLIENT: VILLAGE OF LARCHMONT	3						CHECKED BY: GRL
DRAWING TITLE: MECHNICAL CONTRACT	4						DRAWING NUMBER:
SCHEDULES 2	5						⊔ _12
	6						, m-12



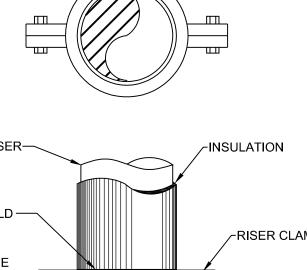


TYPICAL RISER SUPPORT DETAIL

NO SCALE



TYPICAL BRANCH DUCT TAKE-OFF DETAIL

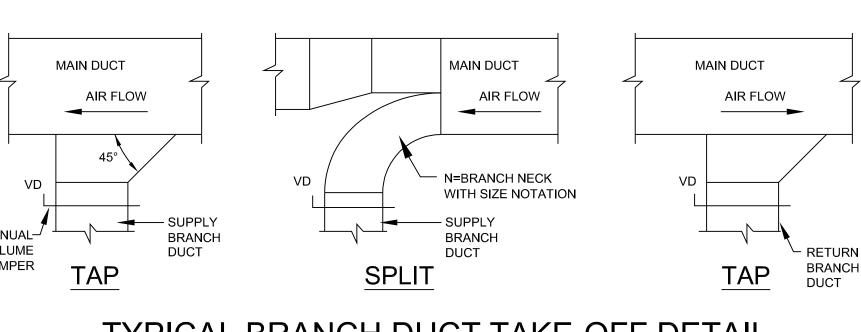

NO SCALE

1. BRACKETS ARE SIZED FOR 12' OF DUCT, MAXIMUM. 2. LOCATE CUTS AGAINST WALL OR MAXIMUM OF 2" AWAY FROM WALL. 3. EACH WALL ANCHOR SHALL SATISFY THE FOLLOWING CRITERIA

A. TENSILE LOAD= 3/8 x DUCT WEIGHT; SAFETY FACTOR OF 4.

SUGGESTED SIZING

ALLOWABLE LOAD

BAND 1-1/2" x 16 Ga.

1" x 1/8"

ALLOWABLE LOAD

25 LBS

35 LBS

50 LBS

BAND 1" x 1" x 1/8"

1" x 1" x 1/8"

1-1/4" x 1-1/4" x 1/8"

1-1/4" x 1-1/4" x 1/8"

WELD, BOLT OR NO. 8 SCREW (MIN.) ACCEPTABLE

MINIMUM OF 3 FASTENERS ON 24" WIDTH AND UP

ADD ALONG SIDE NEAREST ANCHORS

SUGGESTED SIZING

PER FASTENER

DUCT SIZE

18" x 12" 24" x 20"

DUCT GAGE

24, 22, 20

AS FASTENERS

DUCT SIZE


30" x 12"

36" x 18"


42" x 24"

48" x 30"

28, 26

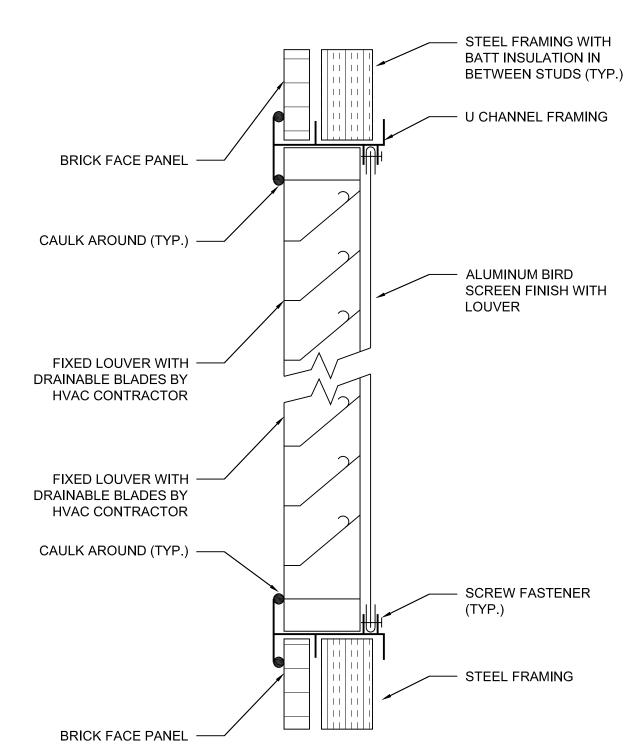


LOUVER DETAIL

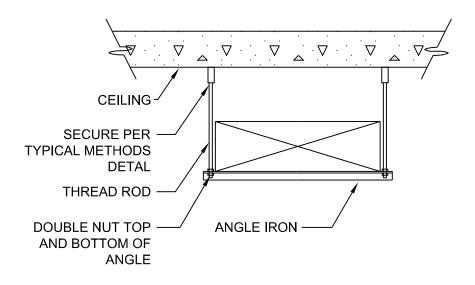

NO SCALE

CONTRACTOR SHALL PROVIDE ADDITIONAL SUPPORTS AS NECESSARY

DUCT HANGER DETAIL

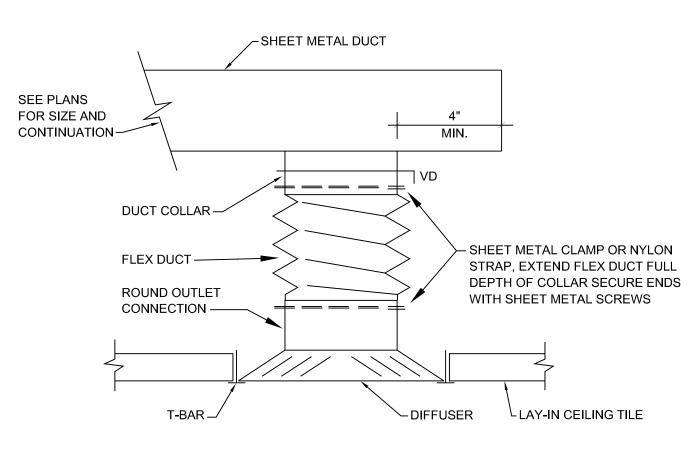

CEILING DIFFUSER CONNECTION DETAIL

NOTE: DUCT TAP AND FLEX DUCT SIZES SHALL MATCH DIFFUSER NECK SIZE.

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HANGER ROD ATTACH TO CONCRETE INSERT OR ANCHOR BOLT TO DECK -- SPRING ISOLATORS WHERE SPECIFIED -ADJUSTABLE STEEL GRINNEL FIG. 260 YOKE PIPE ROLLER HANGER ROD (SIZE AS PER GRINNEL FIG. 181 -PIPE SUPPORT SCHEDULE) -PIPE SADDLE OR RIGID INSULATION SECTION -TYPICAL FOR CHILLED AND CONDENSER WATER PIPING TYPICAL FOR CHILLED WATER AND CONDENSER WATER PIPING

SUSPENDED PIPING SUPPORT DETAIL


NO SCALE

EDR JOB#: **2307** DRAWINGS ISSUED FOR / REVISIONS COOLING SYSTEM REPLACEMENT AT LARCHMONT VILLAGE HALL 03/21/2024 ISSUED FOR / REVISION BY CHK APP 03/21/2024 | 100% FOR BID EDR | JSR | GRL | SCALE: NTS PROJECT LOCATION: 120 LARCHMONT AVE, LARCHMONT NY DRAWN BY: **KPT** : VILLAGE OF LARCHMONT CHECKED BY: GRL DRAWING NUMBER: DRAWING TITLE: MECHNICAL CONTRACT 4 **DETAILS** H-13


DUCT SUPPORTS FROM WALL

UNLESS OTHER ANALYSIS IS MADE:

B. SHEAR LOAD= 1/2 x DUCT WEIGHT; SAFETY FACTOR OF 4.

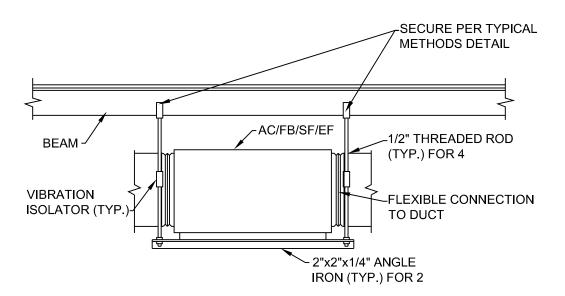

EQUIPMENT SUPPORT DETAIL (TYP.)

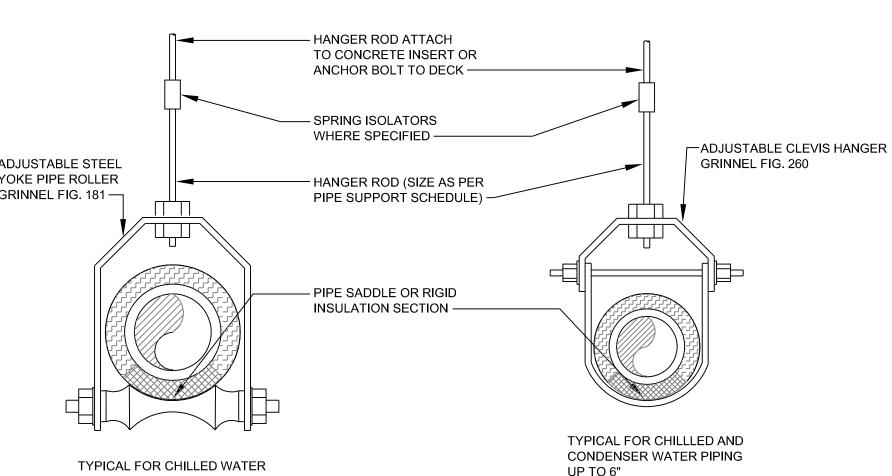

PIPE SLEEVE THRU INTERIOR WALL

- CONDENSATE DRAIN FOR

ACCORDANCE WITH MFR'S

RECOMMENDATIONS.

PIPE SIZE

CONDENSATE DRAIN

CONNECTION DETAIL

- OUTSIDE FACE

- SEAL WATERTIGHT

WITH MASTIC OR

OF WALL

ASPHALT

IRON PIPE SLEEVE

PIPE SLEEVE THRU EXTERIOR WALL

EXPANSION JOINT ---

STANDARD WEIGHT STEEL

- FINISHED ESCUTCHEON PLATE

SIZE TO COMPLETELY COVER

FLUSH AGAINST WALL & OF

FINISHED WALL SURFACE

PIPING EXPOSED TO VIEW

PIPE SLEEVE OF SIZE TO

PASS PIPE & INSULATION

CONTROL ROD ----

INSTALL IN

UNIT OR DUCT CASING

DRAIN CONNECTION

HUMIDIFIER, DUCT CASINGS AS NOTED.)

(TYP.FOR IDU,

INSIDE FACE OF

ESCUTCHEON

2" DEEP SEAL

CONTINUOUS

NO SCALE

TERMINATE SLEEVE FLUSH WITH FINISHED

WALL SURFACES -

SEAL OR CAULK

SLEEVES THRU FIRE

WALLS IN A SMOKE TIGHT MANNER-

PIPE & INSULATION

SLEEVE - DO NOT SUPPORT PIPE


FROM SLEEVE

TO BE CENTERED IN

CONCEALED PIPING

OAKUM -

WELD —

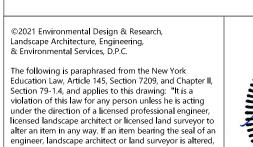



the altering engineer, landscape architect or land surveyor shall affix to the item his seal and the notation

"altered by" followed by his signature and the date of such alteration and a specific description of the





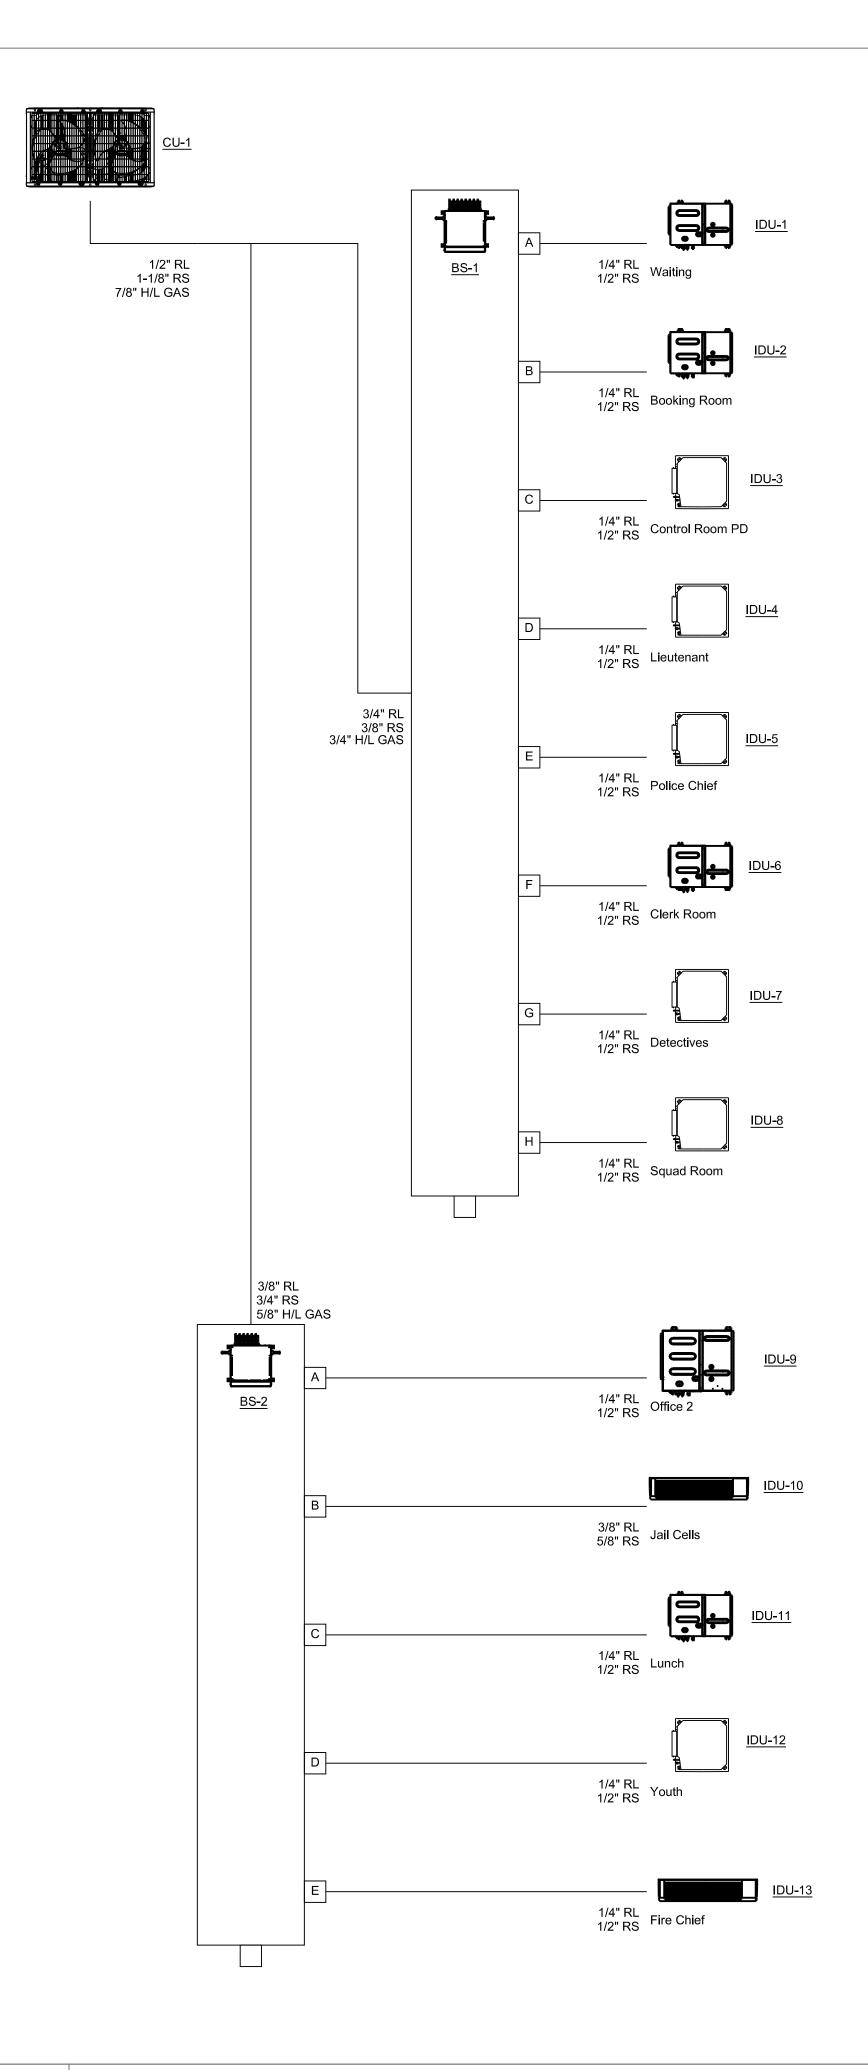

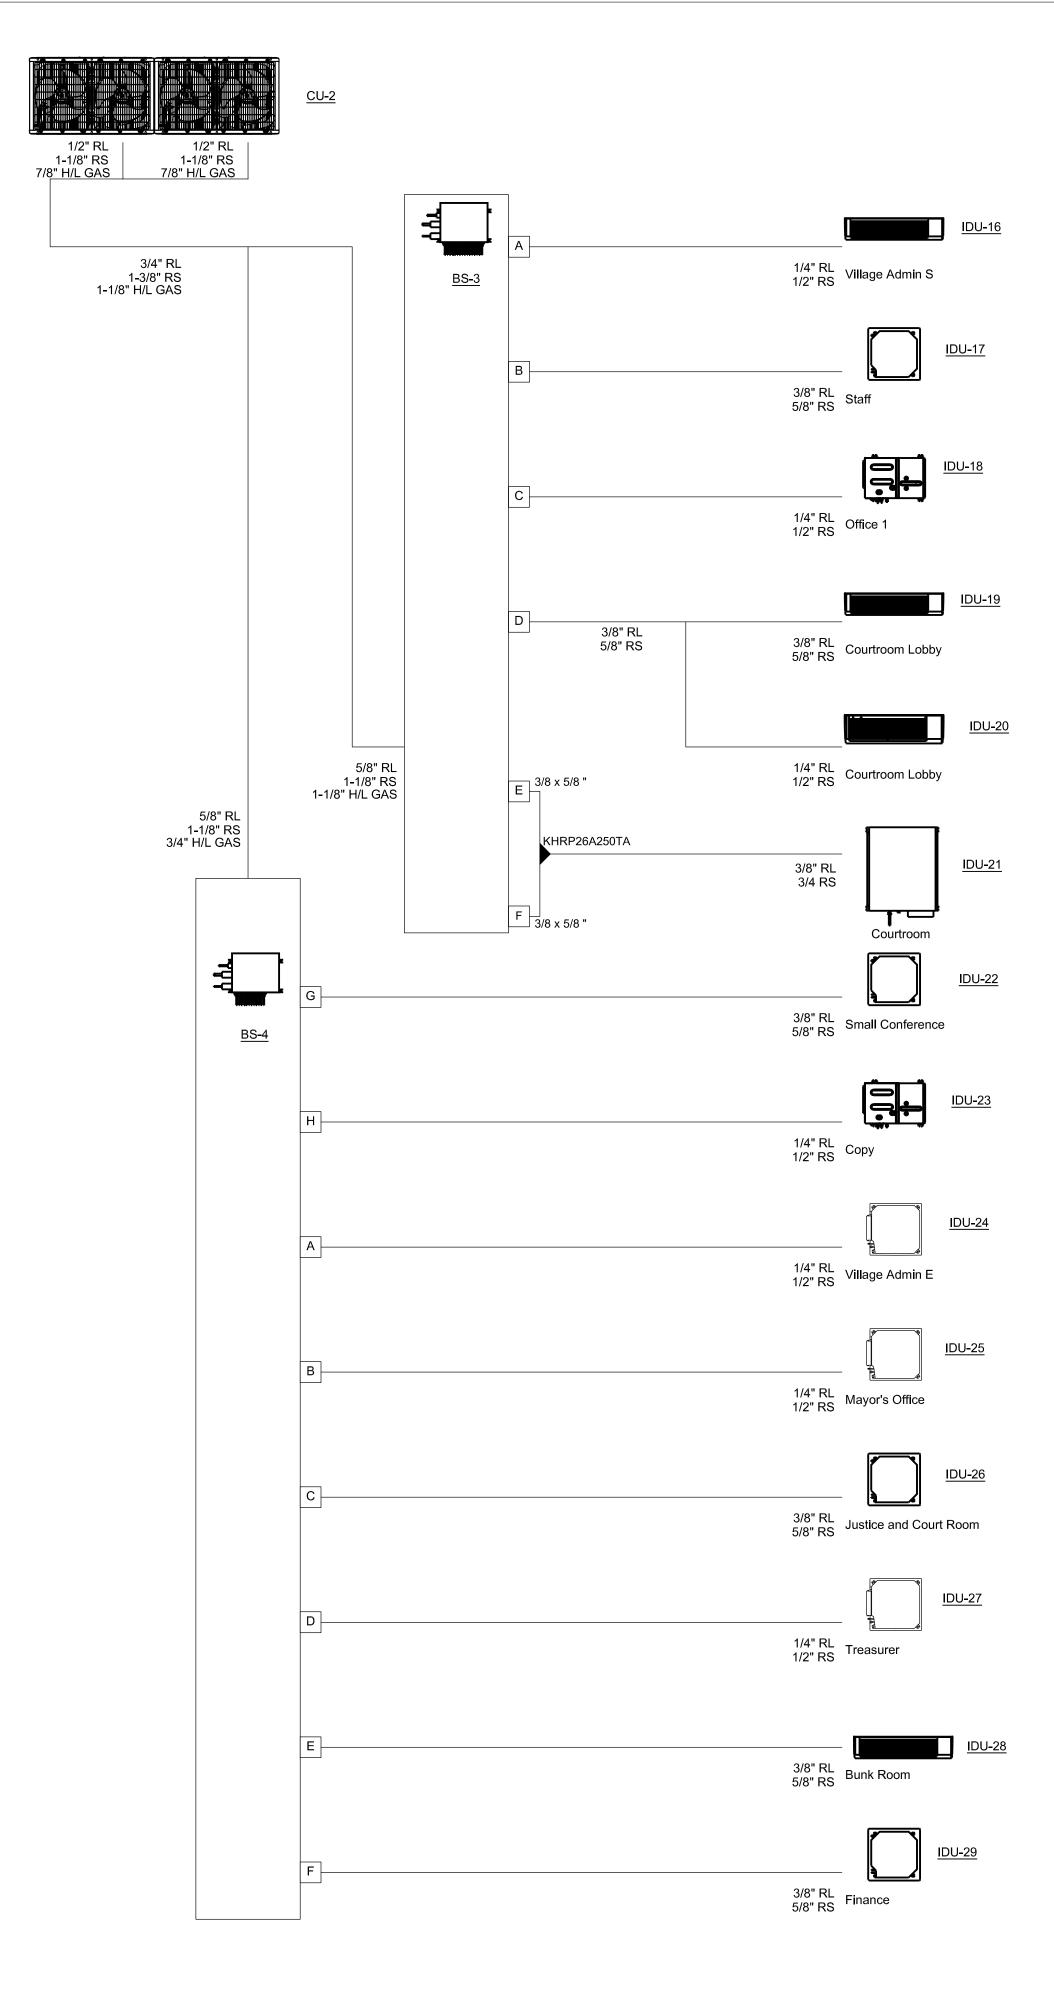


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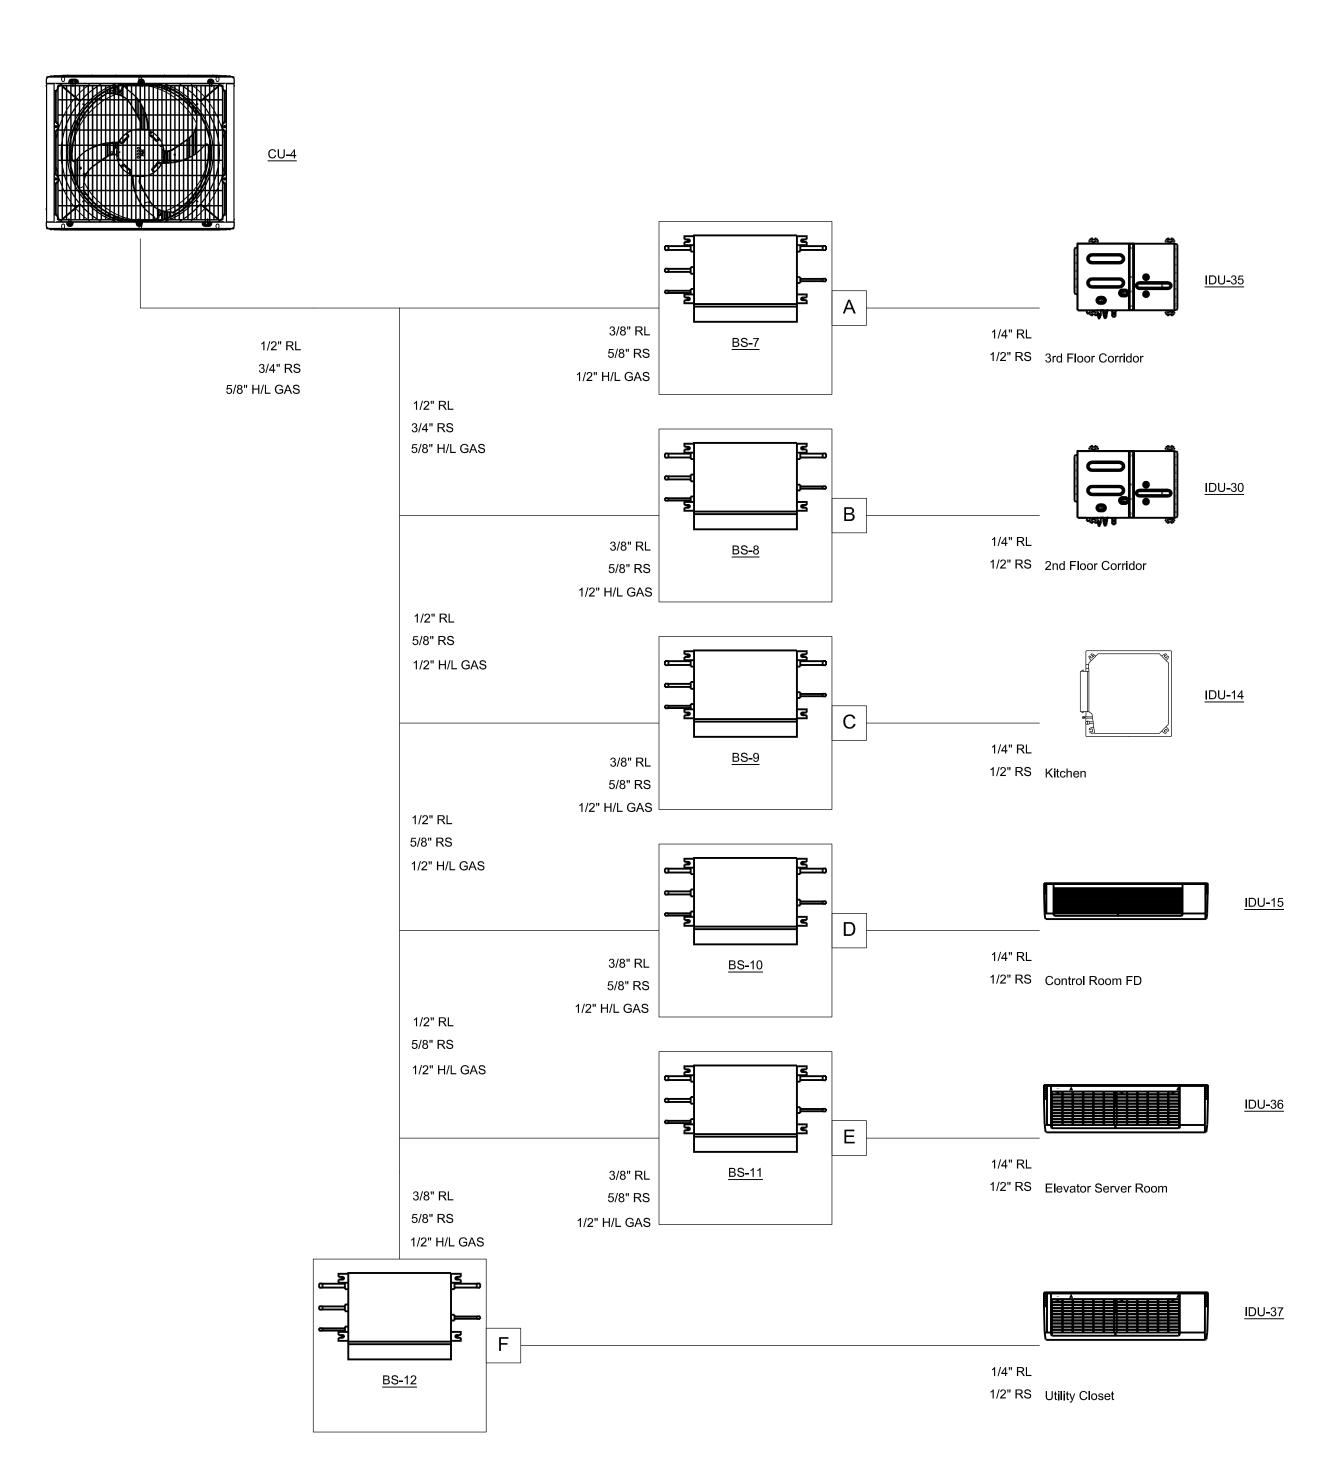


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PROJECT TITLE:		DRAWINGS ISSUED FOR / REVISIONS EDR JOB#: 230							
COOLING SYSTEM REPLACEMENT AT LARCHMONT VILLAGE HALL		NO.	DATE	ISSUED FOR / REVISION	ВУ	СНК	APP	DATE: 03/21/2024	
		1	03/21/2024	100% FOR BID	EDR	JSR	GRL	SCALE: NTS	
PROJECT LOCATION: 120 LARCHMONT AVE, LARCHMONT NY		2						DRAWN BY: KPT	
CLIENT: VILLAGE OF LARCHMONT		3						CHECKED BY: GRL	
DRAWING TITLE: MECHNICAL	ONTRACT	4						DRAWING NUMBER:	
REFRIGERANT DIAGRAMS 1 AND 2		5						H-14	
		6						П-14	





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Education Law, Article 145, Section 7209, and Chapter II,
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such alteration and a specific description of the
alteration".

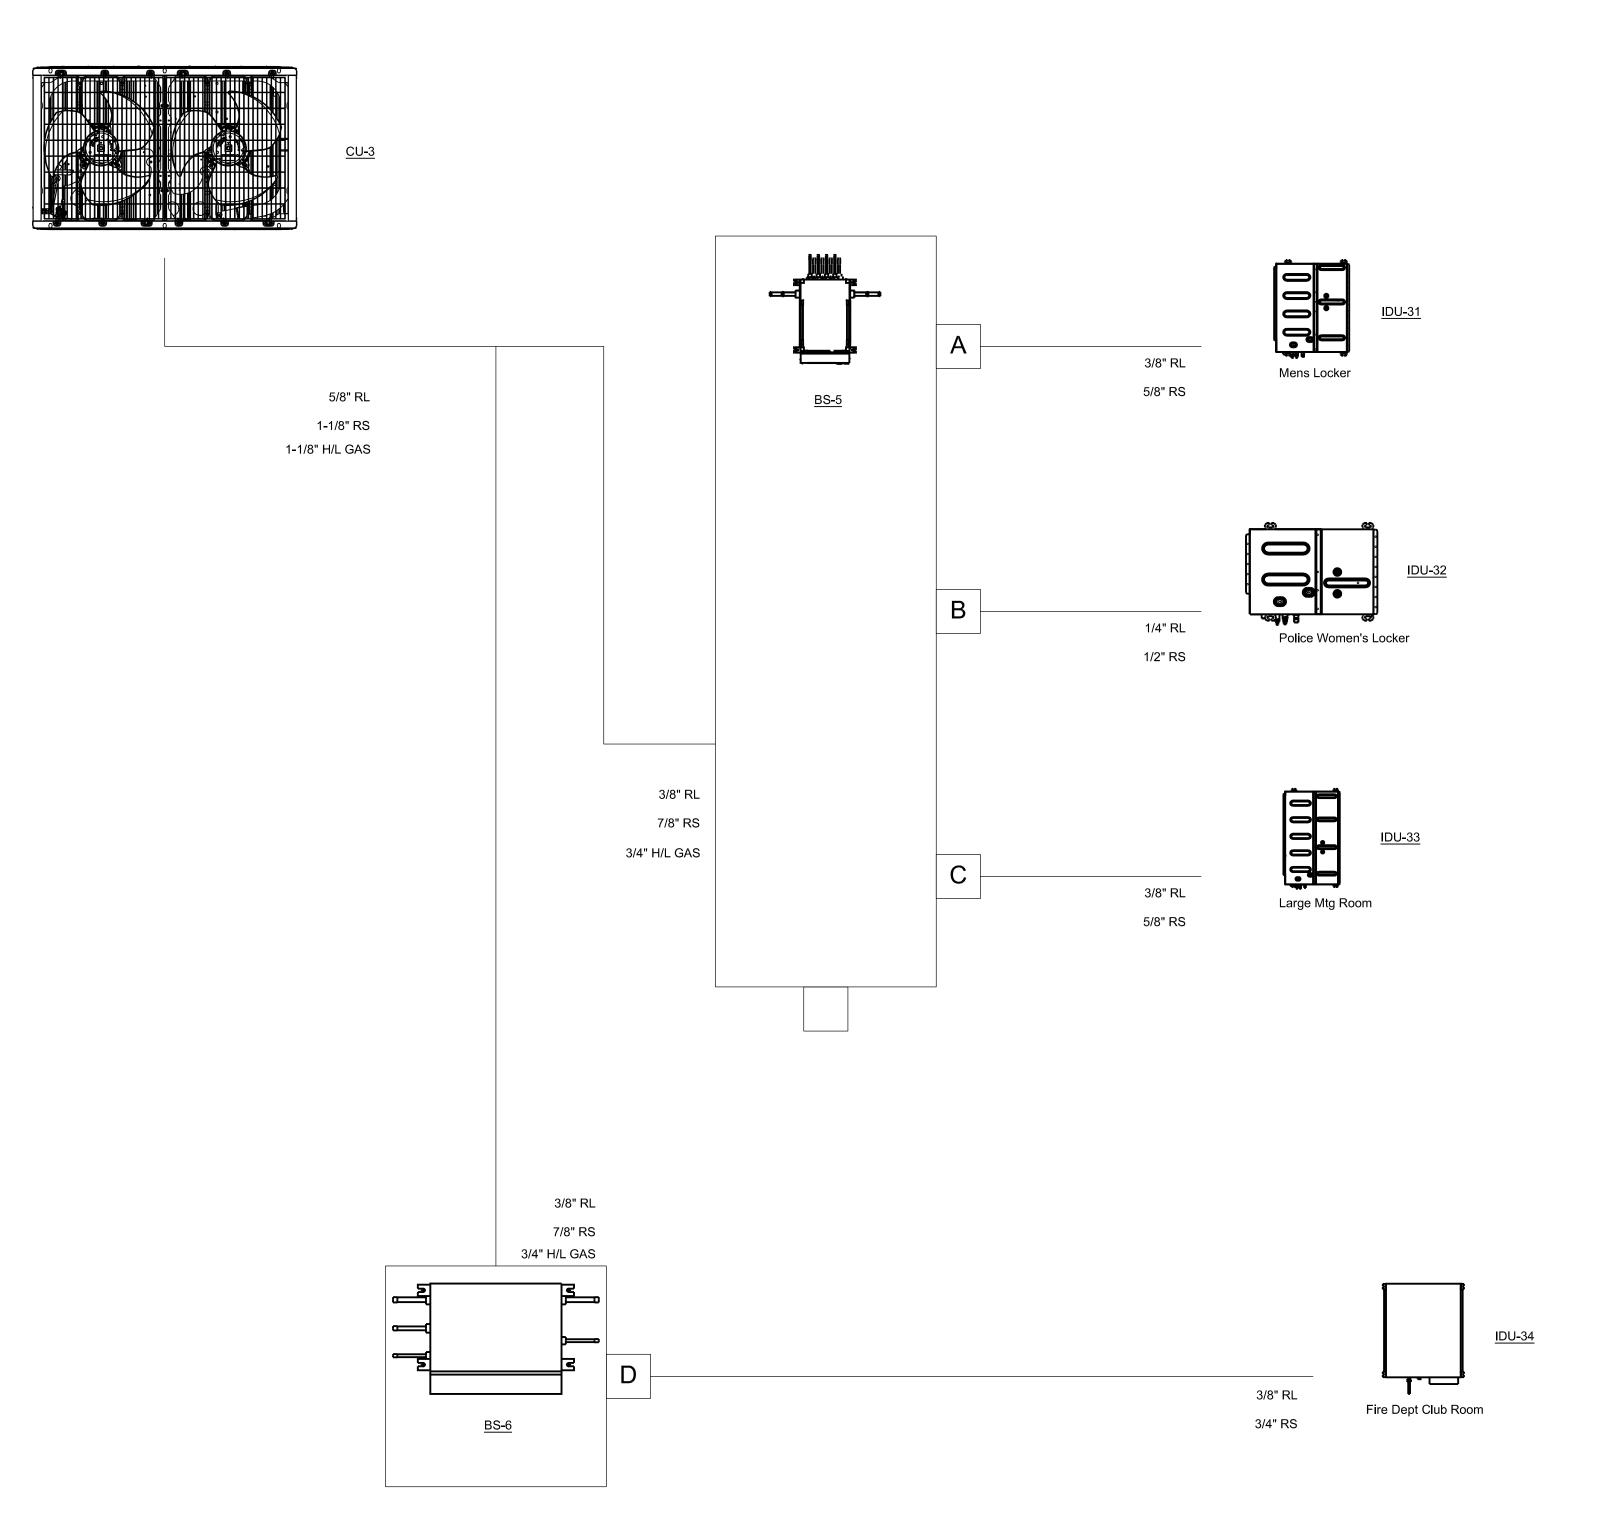



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COOLING SYSTEM REPLACEMENT AT LARCHMONT VILLAGE HALL				DRAWINGS ISSUED FOR / REVISIONS						
				ISSUED FOR / REVISION	BY	СНК	APP	DATE: 03/21/2024		
		1	03/21/2024	100% FOR BID	EDR	JSR	GRL	SCALE: NTS		
PROJECT LOCATION: 120 LARCHMONT AVE, LARCHMONT NY		2						DRAWN BY: KPT		
CLIENT: VILLAGE OF LARCHMONT		3						CHECKED BY: GRL		
DRAWING TITLE: MECHNICAL	CONTRACT	4						DRAWING NUMBER:		
REFRIGERANT DIAGRAMS 3 AND 4		5						H-15		
		6						П-1Э		

GENERAL NOTES:

- ALL WORK SHALL COMPLY WITH AND BE INSTALLED IN ACCORDANCE WITH THE SUPPLEMENTAL UNIFORM AND FIRE PREVENTION BUILDING CODE OF NEW YORK AND ALL CODES LOCAL OR OTHERWISE HAVING JURISDICTION OVER THE WORK. CONTRACTOR MUST BE LICENSED AND CERTIFIED TO WORK IN AREAS CONTAINING ASBESTOS.
- 2. THE WORDS PROVIDE OR INSTALL, SINGLY OR IN COMBINATION SHALL MEAN FURNISH AND INSTALL.
- THE CONTRACTOR SHALL PROVIDE ALL CUTTING AND PATCHING AS REQUIRED FOR THE INSTALLATION OF HIS WORK.
- 4. THIS CONTRACTOR SHALL BE RESPONSIBLE FOR THE PROTECTION OF HIS WORK AND NEWLY INSTALLED OR EXISTING WORK, INCLUDING PROTECTION OF BUILDING OCCUPANTS, PUBLIC, AND PERSONNEL. PROVIDE APPROPRIATE BARRIERS, AND SAFETY GUARD RAILS AS REQUIRED.
- 5. LIMIT THE SPREAD OF DUST WHEN CUTTING BY INSTALLING POLYETHYLENE BARRIERS OR TARPAULINS TO CONTAIN AIRBORNE MATERIALS.
- NO SYSTEM SHALL BE SHUT DOWN WITHOUT PERMISSION OF THE FACILITIES OPERATION MGR. A MINIMUM TWO WEEK NOTICE SHALL BE GIVEN TO THE FACILITIES OPERATION MGR. WHEN SYSTEM SHUTDOWN INVOLVES A TEMPORARY DISRUPTION TO BUILDING SERVICES.
- 7. ANY DISRUPTION IN BUILDING SERVICES SHALL BE KEPT TO A MINIMUM AND SHALL NOT BE IMPLEMENTED WITHOUT RECEIVING PRIOR WRITTEN APPROVAL OF THE FACILITIES OPERATION MANAGER.
- 8. ALL WORK SHALL BE COORDINATED WITH THE FACILITIES OPERATION MANAGER AND ALL TRADES RELATED TO THE INSTALLATION OF THIS PROJECT
- 9. THE CONTRACTOR SHALL TURN OVER TO THE OWNER AT THE COMPLETION OF ALL WORK, ELECTRONIC AND BOUND HARD COPIES OF DESIGNATED QUANTITY, ALL OPERATING, MAINTENANCE, AND INSTRUCTION MANUALS WHICH SHALL INCLUDE ALL EQUIPMENT BROCHURES, PIPING AND WIRING DIAGRAMS, DRAWINGS, TEMPERATURE CONTROLS, AND STARTUP AND SHUTDOWN PROCEDURES OF ALL NEWLY INSTALLED EQUIPMENT.
- 10. THE CONTRACTOR SHALL FILE PLANS WITH GOVERNING AUTHORITIES HAVING JURISDICTION AND SHALL SECURE ALL PERMITS AND PAY ALL FEES REQUIRED FOR THE INSTALLATION OF HIS WORK.
- 11. THE CONTRACTOR SHALL GUARANTEE ALL MATERIAL AND WORK INSTALLED TO BE FREE FROM DEFECTS IN MATERIAL AND WORKMANSHIP FOR A PERIOD OF ONE (1) YEAR, AFTER ACCEPTANCE OF THE INSTALLATION BY THE ENGINEER AND OWNER. THE CONTRACTOR SHALL SUBMIT IN WRITING TO OWNER STATING SAME.
- 12. THE CONTRACTOR SHALL INDEMNIFY THE OWNER, HIS REPRESENTATIVES AND THE ENGINEER FROM ANY CLAIMS OR SUITS RESULTING IN NEGLIGENCE ON THE PART OF THE CONTRACTOR FOR FAILING TO EXECUTE HIS WORK OR WORK NOT IN ACCORDANCE WITH THE CONTRACT DOCUMENTS.
- 13. ALL WORK SHALL BE PERFORMED BY LICENSED CONTRACTORS AND WORKMAN EXPERIENCED IN THE TRADE HAVING JURISDICTION. ALL WORK SHALL BE SUPERVISED AT ALL TIMES AND WORKMANSHIP SHALL BE FIRST CLASS IN ALL RESPECTS.
- 14. ALL WORK SHALL BE INSPECTED BY A THIRD PARTY. CONTRACTOR SHALL PAY ALL ASSOCIATED FEES.
- 15. ANY DEVIATION OR CHANGE IN DESIGN SHALL NOT BE MADE WITHOUT WRITTEN APPROVAL OF THE ENGINEER OR OWNER. ANY WORK INSTALLED WITHOUT PRIOR APPROVAL OF THE ENGINEER OR OWNER OR FOUND TO BE DEFECTIVE OR OF POOR QUALITY SHALL BE REPLACED BY THE CONTRACTOR AT HIS OWN EXPENSE.
- 16. ALL CONSTRUCTION WORK SHALL BE CONFINED TO THE AREA INDICATED ON PLANS AND SHALL NOT BLOCK MEANS OF EGRESS FOR OCCUPANTS OF THE BUILDING.
- 17. ALL WORK SHALL BE PERFORMED DURING NORMAL WORKING HOURS: 8 A.M. TO 5 P.M. MONDAY THROUGH FRIDAY EXCEPT LEGAL HOLIDAYS OR FOR EMERGENCY REPAIRS, UNLESS DIRECTED OTHERWISE BY THE OWNER. HOWEVER, THE CONTRACTOR MAY WORK EXTRA HOURS AS NEEDED TO COMPLETE THE CONTRACT SCOPE OF WORK AND MEET THE COMPLETION DATE AT NO ADDITIONAL COST TO OWNER, AS LONG AS OWNER HAS BEEN PROPERLY NOTIFIED AND HAS APPROVED SAME.
- 18. PATCHING AND PAINTING OF WALLS, FLOORS, ETC. SHALL BE BY TRADE WHO PERFORMED WORK AND SHALL MATCH EXISTING SURROUNDING AREA IN ALL RESPECTS. WORK AREA SHALL BE LEFT BROOM CLEAN AT THE END OF EACH DAY. ALL DISCARDED AND DEMOLISHED MATERIAL AND RUBBISH SHALL BE REMOVED FROM PREMISES DAILY IN A LEGAL AND APPROVED MANNER.
- 19. THE CONTRACTOR SHALL MAINTAIN ON THE JOB SITE A SET OF SHOP DRAWINGS IN WHICH ANY DEVIATIONS FROM THE ORIGINAL DESIGN SHALL BE NOTED. UPON COMPLETION OF THE INSTALLATION OF WORK PERFORMED THE CONTRACTOR SHALL TURN OVER TO THE OWNER AND ENGINEER ELECTRONIC REPRODUCIBLE AND HARD COPY OF DESIGNATED QUANTITIES OF AS-BUILT DRAWINGS INCLUDING ALL APPROVED FIELD CHANGES AND DESIGN DEVIATIONS PRIOR TO RECEIPT OF FINAL PAYMENT BY OWNER.
- 20. PROVIDE APPROVED TERMINAL STRIPS IN ALL JUNCTION BOXES WHERE SPLICES ARE MADE.
- 21. ALL WORK SHOWN ON ALL DRAWINGS IS TO BE PROVIDED UNLESS OTHERWISE NOTED.
- 22. ALL PENETRATIONS THROUGH PARTITIONS, FLOORS, WALLS AND ROOF FOR ALL PIPING, CONDUIT AND DUCTWORK SHALL BE SEALED AND FIRE SAFED OFF TO MAINTAIN FIRE INTEGRITY OF EXISTING STRUCTURE.
- 23. ALL DOWNSTREAM DEVICES WHICH BECOME DISCONNECTED DURING THIS CONSTRUCTIONS SHALL BE RECONNECTED AT NO COST TO THE OWNER. PROVIDE ALL CONDUIT AND WIRE AS REQUIRED.
- 24. THE CONTRACTOR SHALL SUPERVISE AND DIRECT THE WORK, AS WELL AS BE SOLELY RESPONSIBLE FOR THE CONSTRUCTION MEANS METHODS, TECHNIQUES, SEQUENCES, AND PROCEDURES OF THE WORK.
- 25. THE CONTRACTOR SHALL BE RESPONSIBLE FOR TAKING REASONABLE PRECAUTIONS AND SHALL PROVIDE REASONABLE PROTECTION TO PREVENT INJURY OR DAMAGE TO PERSONS. THE WORK AND OTHER PROPERTY.
- 26. OWNER RESERVES THE RIGHT TO MOVE EQUIPMENT LOCATION 10'-0" FROM WHERE SHOWN ON CONTRACT DRAWINGS WITH NO ADDITIONAL COST.

GENERAL DEMOLITION NOTES

- 1. REMOVE ALL ELECTRICAL EQUIPMENT AS INDICATED TO BE REMOVED. EX: CONTROL STATIONS, INSTRUMENTATION, LOCAL DISCONNECTS, ETC. UNLESS OTHERWISE NOTED.
- REMOVE ALL CONDUIT AND WIRE FOR ALL ELECTRICAL EQUIPMENT TO BE REMOVED BACK TO SOURCE UNLESS OTHERWISE NOTED ON DEMOLITION DRAWINGS.
- 3. IF POWER SOURCE (POWER PANEL, MCC, ETC) FOR EQUIPMENT REMOVED IS TO REMAIN. RE-LABEL AS "SPARE" OR NEW CIRCUIT DESIGNATION UNLESS OTHERWISE NOTED ON DEMOLITION DRAWINGS.

ELECTRICAL NOTES:


- 1. CONTRACTOR SHALL BE RESPONSIBLE TO VISIT SITE AND FOR FAMILIARIZING HIMSELF WITH FIELD CONDITIONS.
- CONTRACTOR SHALL RUN ALL CONDUITS AND CABLING ABOVE DROP CEILINGS IF POSSIBLE.
- 3. CONTRACTOR SHALL USE SURFACE METAL RACEWAY IN ALL OFFICE AREAS AND INTERIOR SPACES WHERE WIRING IS NOT RUN ABOVE CEILINGS. ALL EXTERIOR CONDUIT SHALL BE GALVANIZED RIGID STEEL CONDUIT AND INTERIOR CONDUIT SHALL BE EMT CONDUIT WITH COMPRESSION TYPE FITTINGS.
- 4. CONTRACTOR SHALL LABEL ALL CABLES/WIRES AND CONDUITS AT BOTH ENDS.
- 5. CONTRACTOR SHALL PERFORM ALL WIRE AND CABLE TERMINATIONS.
- ALL WORK SHALL COMPLY WITH 2020 NEC AND 2020 NFPA CODES.


ELECTRICAL SPECIFICATIONS:

- 1. ALL ELECTRICAL WORK SHALL COMPLY WITH THE REQUIREMENTS OF THE 2020 NATIONAL ELECTRIC CODE. ALL LOCAL CODES, ORDINANCES AND AUTHORITIES HAVING JURISDICTION.
- 2. BEFORE COMMENCING HIS WORK, THE ELECTRICAL CONTRACTOR SHALL VISIT THE PREMISES AND NOTIFY THE OWNER AND ENGINEER OF ANY EXISTING CONDITIONS THAT WILL INTERFERE WITH HIS WORK.
- ALL WIRING SHALL BE TYPE THWN COPPER, THERMOPLASTIC INSULATION, 75°C RATED.
- 4. ALL CONDUIT SHALL BE EMT WITH COMPRESSION FITTINGS. SET SCREW FITTINGS ARE NOT ACCEPTABLE.
- 5. ELECTRICAL CONTRACTOR SHALL COORDINATE ELECTRICAL SERVICE FACILITIES AND MAKE ARRANGEMENTS WITH OWNER AND UTILITY COMPANY FOR SERVICE CONNECTIONS. ALL CONNECTIONS OF SERVICE FACILITIES SHALL COMPLY WITH LOCAL AUTHORITY REQUIREMENTS.
- 6. COLOR CODE ALL WIRES FOR PROPER PHASE/VOLTAGE IDENTIFICATION.
- 7. ENGRAVED BAKELITE NAMEPLATES SHALL BE INSTALLED ON ALL EQUIPMENT DENOTING FUNCTION/NAME OF THE EQUIPMENT OR LOAD SERVICE.
- 8. CUTTING AND PATCHING FOR ALL ELECTRICAL WORK IS THE RESPONSIBILITY OF THE ELECTRICAL CONTRACTOR.
- 9. PROPERLY GROUND ELECTRIC EQUIPMENT TO BUILDING STEEL, GROUND RODS AS REQUIRED.
- 10. ALL WIRE DEVICES SHALL BE SPECIFICATION GRADE. OUTLETS SHALL BE NEMA 5-20R.
- 11. DISCONNECT SWITCHES SHALL BE AS MANUFACTURED BY SQUARE D, OR EQUAL. SWITCHES SHALL BE HEAVY DUTY, LOCKABLE IN THE ON AND OFF POSITIONS. PROVIDE NEMA 1 ENCLOSURE FOR INDOOR SWITCHES AND NEMA 3R FOR OUTDOOR SWITCHES.
- 12. PANELBOARDS SHALL BE EQUAL TO SQUARE D TYPE "NQOD", ARRANGED FOR 120/208 VOLTS, 3 PHASE, 4 WIRE, COPPER BUS, 10,000 AIC (MIN). REFER TO PANEL SCHEDULES FOR ADDITIONAL REQUIREMENTS, CIRCUIT BREAKERS SHALL BE BOLT-ON TYPE.
- 13. ALL EQUIPMENT SHALL BE AS SPECIFIED, OR EQUAL.

SYMBOL	DESCRIPTION
	EXISTING
	TO BE PROVIVED
	CIRCUIT HOMERUN (120V) TO PANELBOARD
	CIRCUIT HOMERUN (208, 3Ø V) TO PANELBOARD
7-111-	CIRCUIT HOMERUN (208V/1Ø) TO PANELBOARD
	120/208V 3Ø 4W PANELBOARD
S	240 VOLT, 3-POLE, 30 AMP TAZ-MS303 TOGGLE DISCONNECT SWITCH AND BOX.
60/50	240 VOLT NON FUSED DISCONNECT SWITCH. NEMA 4X STAINLESS STEEL. FRAME/FUSE SIZE
⊕ WP, GFI	120V 1φ 20A WEATHER-PROOF, GROUND FAULT-INTERRUPT RECEPTACLE WITH IN SERVICE COVER.
1	UNSWITCHED CIRCUIT
CU #	CONDENSER (208V/3Ø)
IDU#	INDOOR UNIT (208V/1Ø)
BS#	BRANCH SELECTOR BOX (208V/1Ø)
0	CIRCUIT BREAKER
	ITEM TO BE DEMOLISHED AND REMOVED

NOTE: ALL WORK IS TO BE PROVIDED UNLESS OTHERWISE NOTED

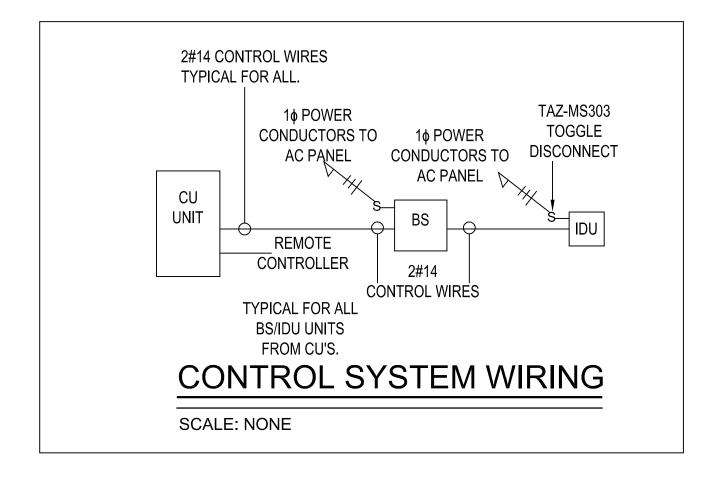

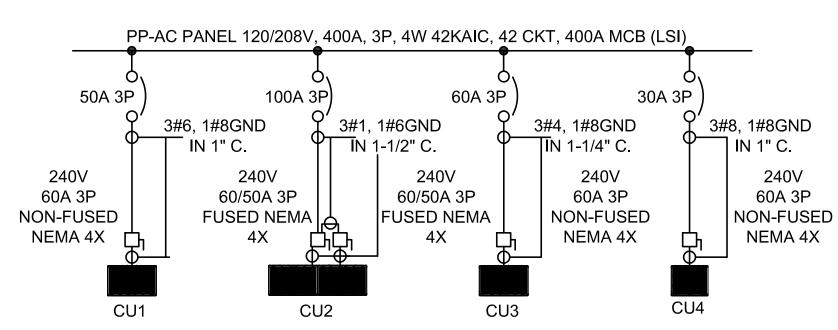

AC CONDENSER POWER SINGLE LINE DIAGRAM

SCALE NONE

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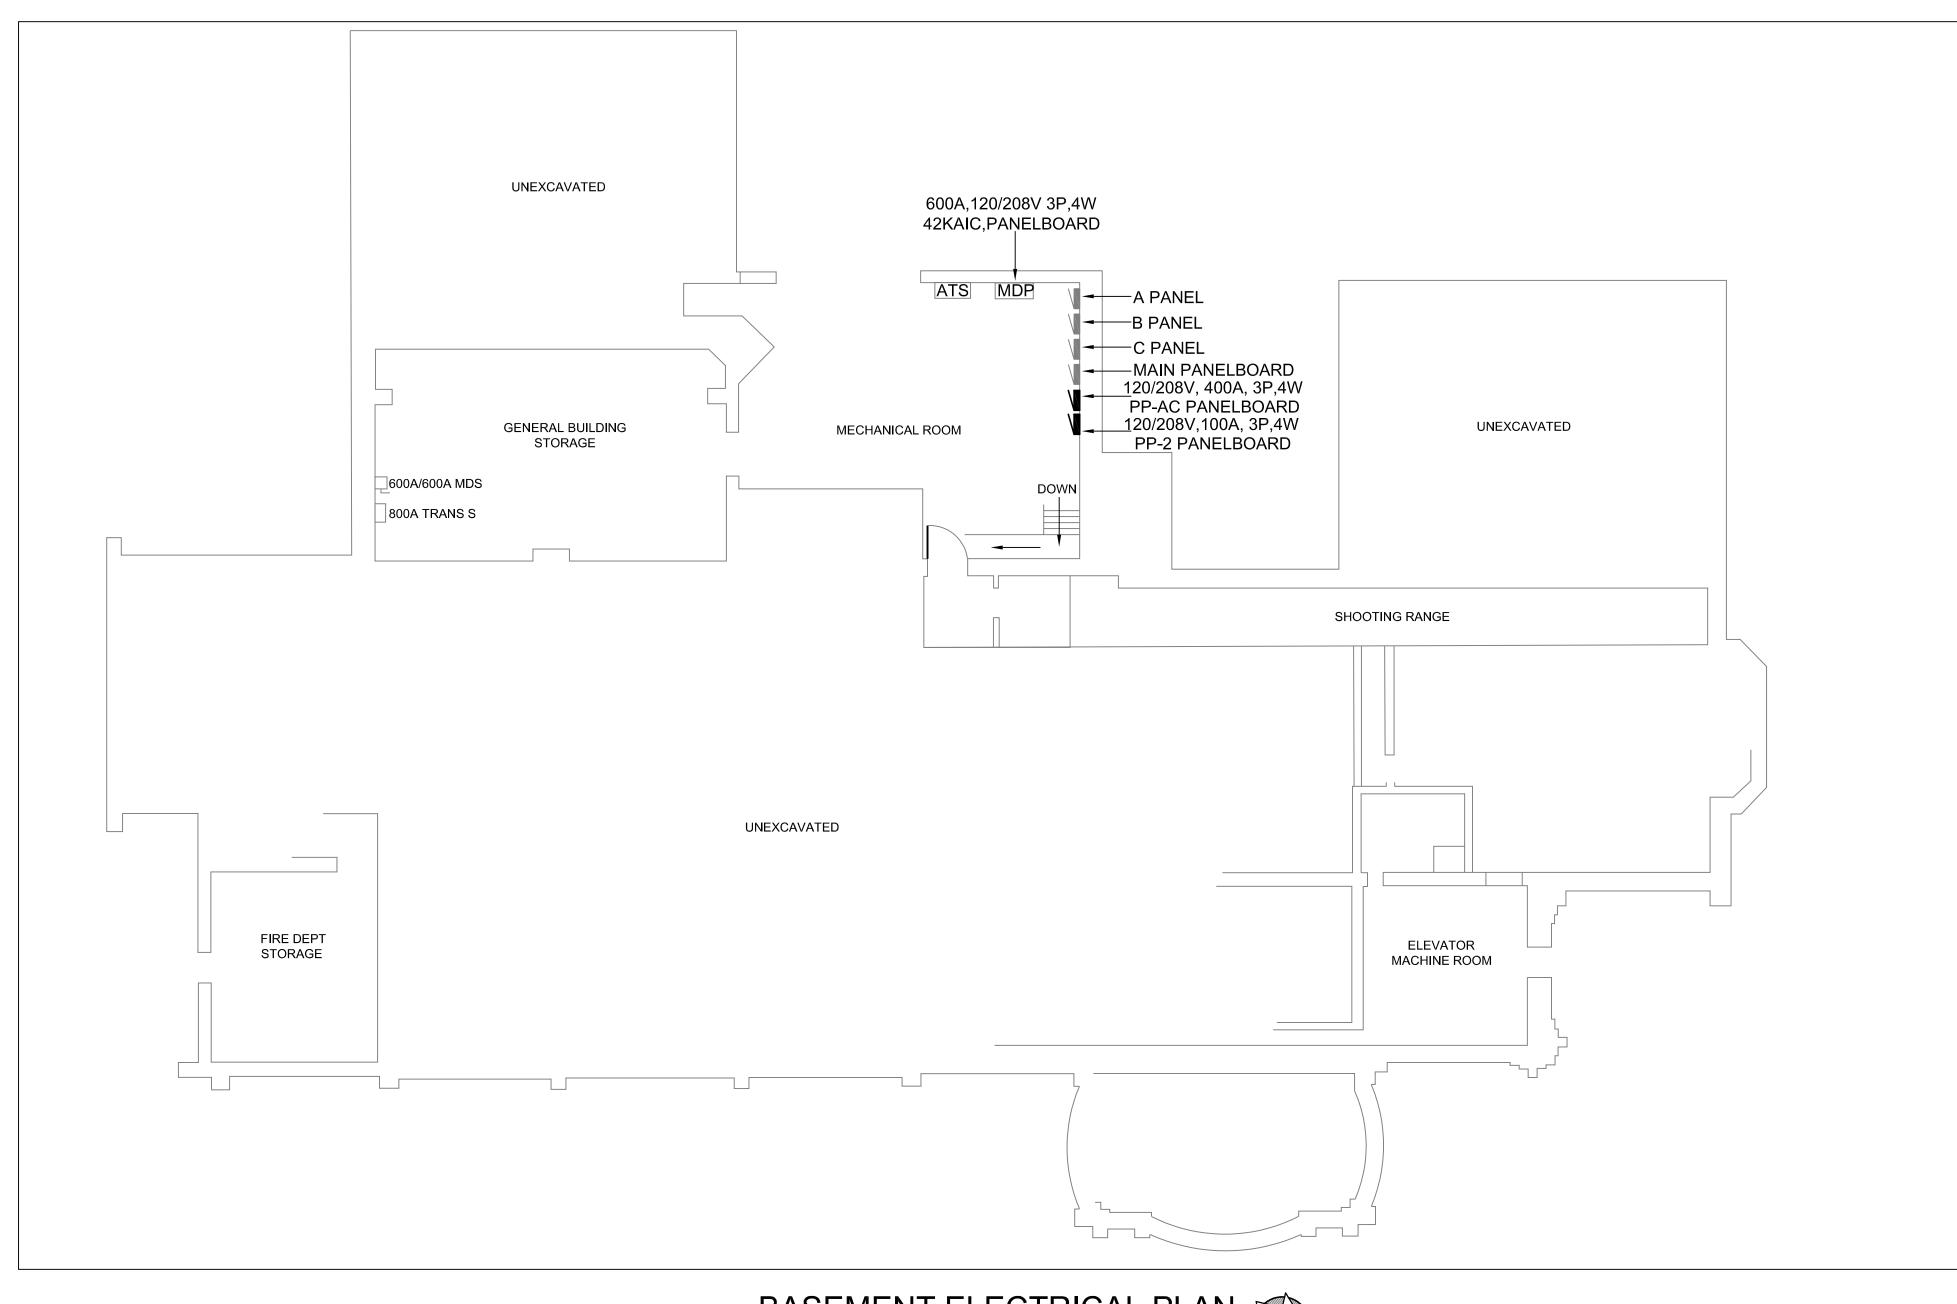
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Environmental

PROJECT TITLE:		PRAWINGS IS:	SUED FOR / REVISIONS			EDR JOB#: 2307	
COOLING SYSTEM REPLACEMENT AT LARCHMONT VILLAGE HALL	N	O. DATE	ISSUED FOR / REVISION	ВУ	CHK	APP	DATE: 03/21/2024
	,	03/21/2024	1 100% FOR BID	EDR	JSR	GRL	SCALE: NTS
PROJECT LOCATION: 120 LARCHMONT AVE, LARCHMONT NY	2	2					DRAWN BY: AMG
CLIENT: VILLAGE OF LARCHMONT	3	}					CHECKED BY: JGD
DRAWING TITLE: ELECTRICAL	RACT 4						DRAWING NUMBER:
SYMBOLS AND LEGENDS	5	;					E_1
	6	5					E- I




BASEMENT ELECTRICAL PLAN

SCALE: 1/8"=1'-0"

ELECTRICAL NOTES:

1. CONTRACTOR SHALL BE RESPONSIBLE TO VISIT SITE AND FOR FAMILIARIZING HIMSELF WITH FIELD CONDITIONS.

- 2. CONTRACTOR SHALL FURNISH AND INSTALL A FULLY RATED 208/120 VOLT, 400 AMP, 3 PHASE POWER PANEL WITH A VERTICAL 400 AMP MAIN CIRCUIT BREAKER (LSI) WITH A 42KAIC RATING, 42 CIRCUIT FULLY RATED POWER PANEL INTERIOR WITH BOLT-ON CIRCUIT BREAKERS. PLUS SPARE 20 AMP 1-POLE BOLT-ON CIRCUIT BREAKERS TO FILL REMAINING SPACES INSTALLED IN THE PANEL FOR FUTURE USE.
- 3. CONTRACTOR SHALL PERFORM ALL WIRE AND CABLE TERMINATIONS. CONTRACTOR SHALL BE RESPONSIBLE FOR ALL COSTS ASSOCIATED WITH INSTALLING THE PANELBOARD.
- 4. ALL WORK SHALL COMPLY WITH 2020 NEC AND 2020 NFPA CODES.

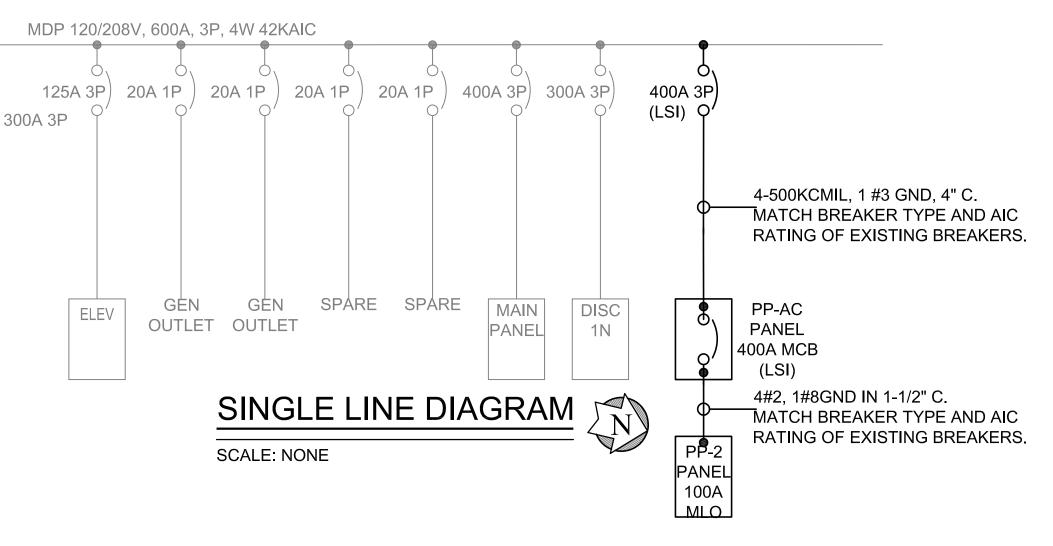

PANELBOARD PP-AC SCHEDULE

400A, 120/208 VOLTS, 3 PHASE, 4 WIRE MAIN BUS RATINGS: 42,000 AIC

MINIMUM SHORTCIRCUIT INTERRUPTION RATING:

MAIN BREAKER TRIP: 400A

ESTIMATED CONNECTED LOAD: 87KW

FED FROM: MDP 4-500KCMIL 1 #2 INCOMING FEED: 4-5001.0 ENCLOSURE: NEMA1

DESCRIPTION	LOAD	СВ	CIR.			CIR.	СВ	LOAD	DESCRIPTION
	KW	TRIP/POLE	NO			NO	TRIP/POLE	KW	
				А В	С				
			1			2			
CU 1	13.8	50A/3P	3			4	100A/3P	27.7	CU 2
			5			6			
			7			8			
CU 3	18	60A/3P	9			10	30A/3P	8	CU 4
			11			12			
			13			14			
BS 1, IDUS 1,2,3,4	.69	15A/2P	15			16	15A/2P	.6	BS 3,IDUS 16,1
			17			18			
IDUS 5,6,7,8	.4	15A/2P	19			20	15A/2P	.38	IDUS 18,19,20
BS 2			21			22			BS 4,
IDUS 9,10	.4	15A/2P	23			24	15A/2P	.75	IDUS 22,23,24,2
BS 9,10			25			26			
IDUS 11,12,13,14,15	.7	15A/2P	27			28	15A/2P	.9	IDUS 26,27,28,2
BS 5, 7,			29			30			BS 8, 11,12,
IDUS 31,32,33,35	1.7	20A/2P	31			32	15A/1P	.3	IDUS 30, 36, 37
			33			34			
BS 6 AND IDU 34	1.9	25A/2P	35			36	20A/1P	1.9	IDU 21
SPARE		20A/1P	37			38			
SPARE		20A/1P	39			40	100A/1P	29.85	PP-2
SPARE		20A/1P	41			42			

PANELBOARD GENERAL NOTES:

1. FOR THREE PHASE CIRCUITS - PROVIDE 3/4" C W/ 3#12, 1#12 GND FOR 20 AMP CIRCUITS SERVING EQUIPMENT WITHIN 60' OF PANELBOARD. UNLESS OTHER WISE NOTED. INCREASE CONDUIT AND WIRE SIZES IN ACCORDANCE WITH THE N.E.C. FOR LONGER CIRCUITS OR CIRCUITS MORE THAN 20 AMPS.

2. FOR SINGLE PHASE CIRCUITS - PROVIDE 3/4" C W/ 2#12, 1#12 GND FOR 20 AMP CIRCUITS SERVING EQUIPMENT WITHIN 60' OF PANELBOARD. UNLESS OTHER WISE NOTED. INCREASE CONDUIT AND WIRE SIZE IN ACCORDANCE WITH THE N.E.C. FOR LONGER CIRCUITS OR CIRCUITS MORE THAN 20 AMPS.

3. CONTRACTOR SHALL BALANCE ALL PANELBOARD LOADS ACROSS PHASES.

PANELBOARD PP-2 SCHEDULE 100A, 120/208 VOLTS, 3 PHASE, 4 WIRE MAIN BUS RATINGS: FED FROM: PP-AC INCOMING FEED: 1772, 1772" C. MINIMUM SHORTCIRCUIT INTERRUPTION RATING: 42,000 AIC MLO 100A ENCLOSURE: NEMA1 ESTIMATED CONNECTED LOAD: 29.85KW LOAD DESCRIPTION DESCRIPTION LOAD CB NO TRIP/POLE KW TRIP/POLE NO KW A B C GFI CONDENSERS 20A/1P GFI PUMP ADMIN 20A/1P GFI PUMP COURT 20A/1P GFI PUMP JAIL 20A/1P GFI PUMP COURT GFI PUMP FIRE CHIEF 20A/1P 20A/1P 1ST FL RAD ZONE 2ND FL RAD ZONE 15A/1P 15A/1P VALVES 1,2,3,4 VALVES 1,2,3,4 1ST FL RAD ZONE 2ND FL RAD ZONE 15A/1P 15A/1P

VALVES 5,6,7 VALVES 5,6,7,8,9 3RD FL RAD ZONE 2ND FL RAD ZONE 15A/1P 15A/1P **VALVES 1,2,3** VALVES 10,11,12,13,14 3RD FL RAD ZONE SPARE 20A/1P 15A/1P VALVES 4,5 20A/1P GFI PUMP COURT 20A/1P GFI PUMP FIRE CONT 20A/1P GFI PUMP UT CLO 20A/1P GFI PUMP ELEV RM 20A/1P SPARE 20A/1P 1.5 GFI PUMP BUNK RM SPACE SPACE SPACE SPACE SPACE SPACE SPACE SPACE SPACE SPACE

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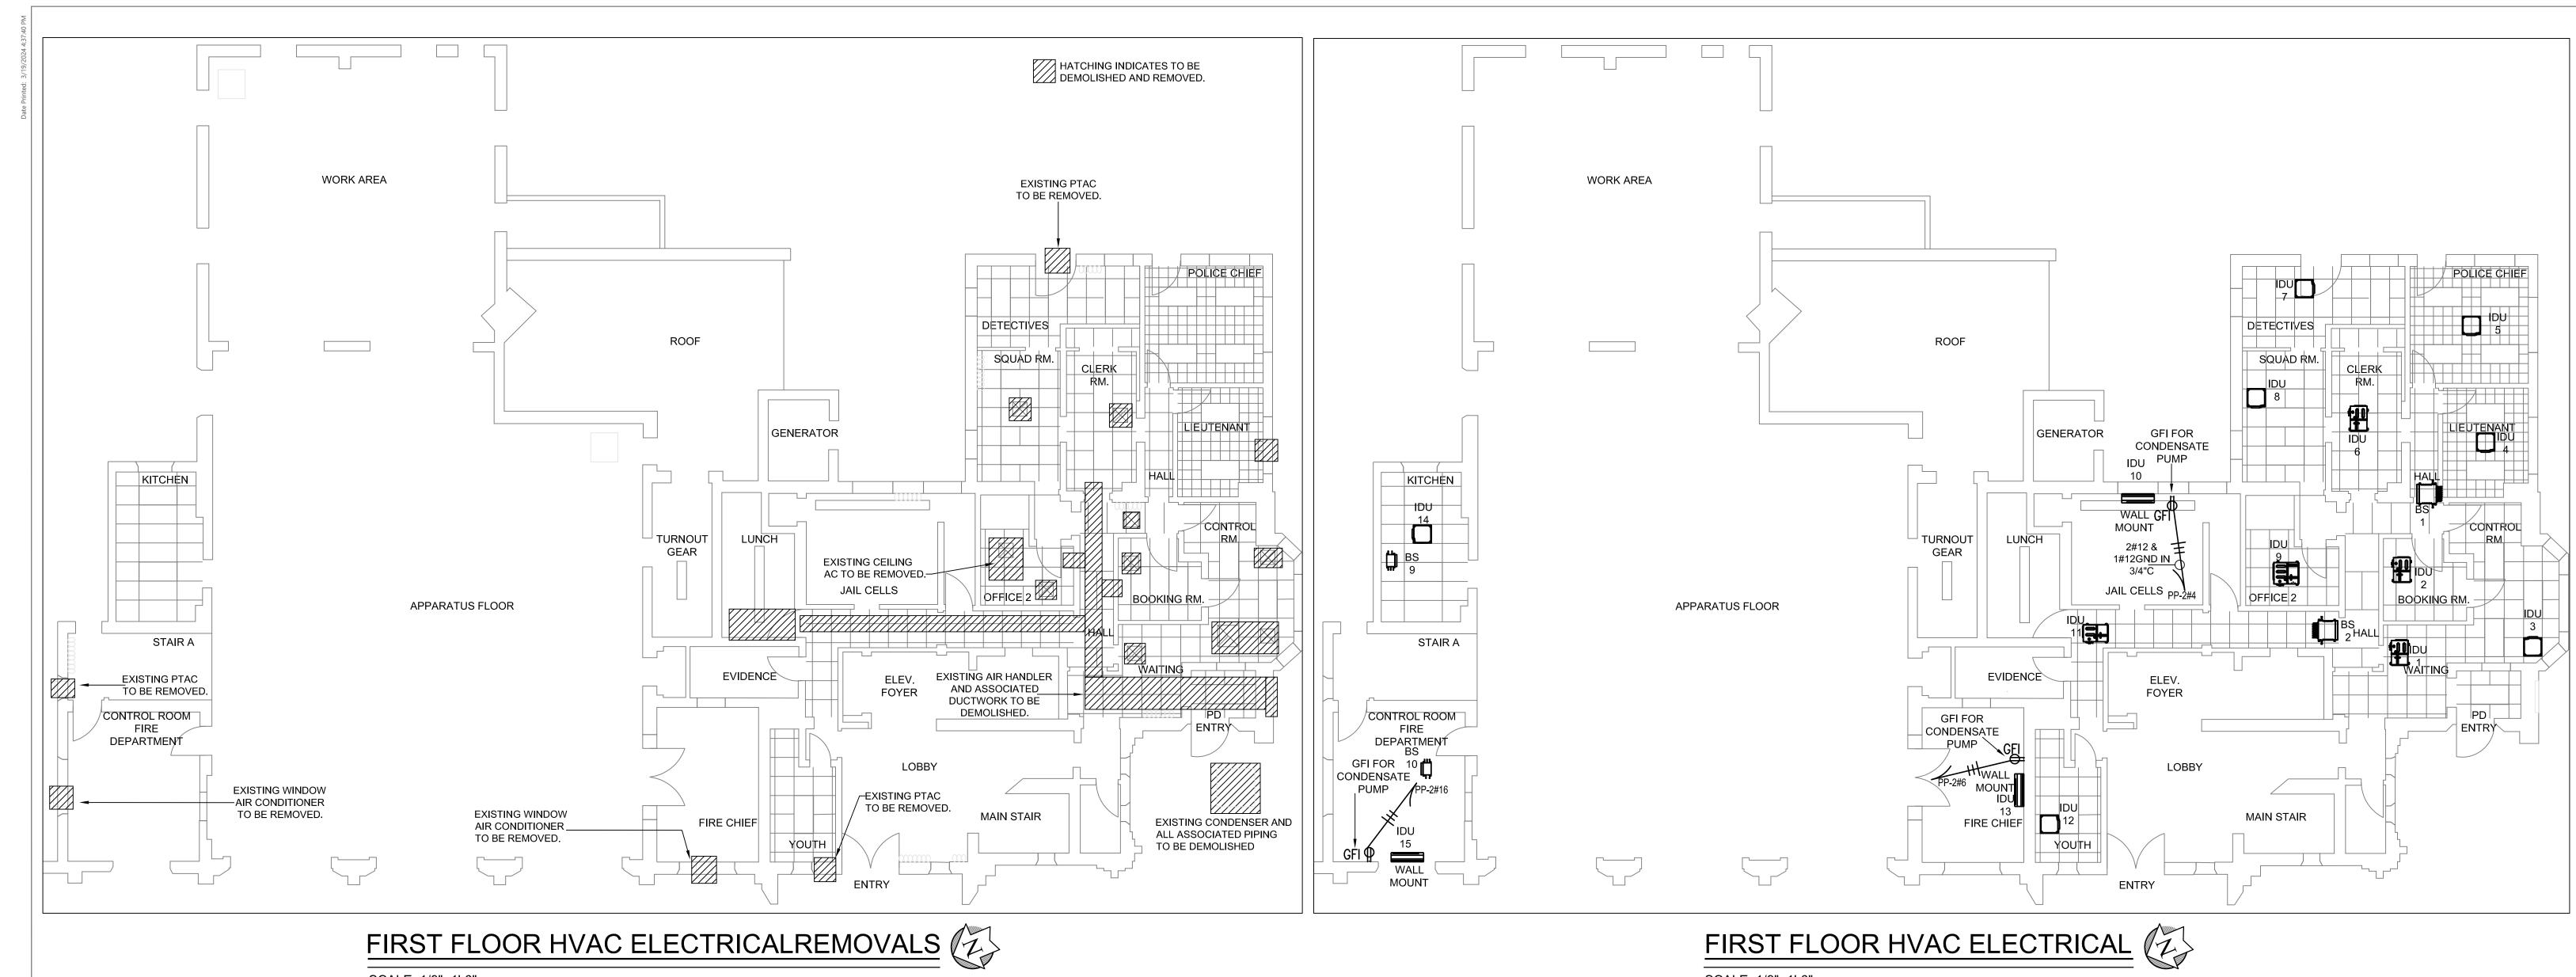
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PROJECT TITLE:	DR	AWINGS ISSU	EDR JOB#: 2307				
COOLING SYSTEM REPLACEMENT AT LARCHMONT VILLAGE HALL	NO.	DATE	ISSUED FOR / REVISION	ВУ	СНК	APP	DATE: 03/21/2024
	1	03/21/2024	100% FOR BID	EDR	JSR	GRL	SCALE: 1/2" = 1'-0"
PROJECT LOCATION: 120 LARCHMONT AVE, LARCHMONT NY	2						DRAWN BY: KPT
CLIENT: VILLAGE OF LARCHMONT	3						CHECKED BY: GRL
DRAWING TITLE: ELECTRICAL CONTRACT	4						DRAWING NUMBER:
BASEMENT PLAN	5						E 2
	6						[-2



SCALE: 1/8"=1'-0"

SCALE: 1/8"=1'-0" 2#14 CONTROL WIRES 2#10 & 1#12GND TYPICAL FOR ALL. IDU 5 208V 1 ф IDU 3 CONTROL IDU 4 POLICE IDU 6 IDU 7 IDU 2 3#6 & 1#8GND WAITING BOOKING PD LIEUTENANT CHIEF CLERK DETECTIVES SQUAD PP-AC#1,3,5 2#14 CONTROL WIRES PP-AC#17,19 208V 1¢ IDU 12 IDU 13 208V 3¢ TYPICAL FOR ALL. BS2 —2#10 & 1#12GND IN 3/4"C IDU 10 IDU 11 2#14 CONTROL WIRES YOUTH FIRE CHIEF OFF<u>IC</u>E 2 JAIL CELLS LUNCH TYPICAL FOR ALL PP-AC#21,23</ 208V 1¢ 2#10 & 1#12GND 2#14 CONTROL WIRES IDU 14 TYPICAL FOR ALL. 2#10 & 1#12GND 3#8 & 1#8GND IN KITCHEN PP-AC#8,10,12 208V 3¢ CONTROL CONTROL 2#14 CONTROL WIRES RM FIRE TYPICAL FOR ALL.

FIRST FLOOR HVAC ELECTRICAL SINGLE LINE DIAGRAM

SCALE: NONE

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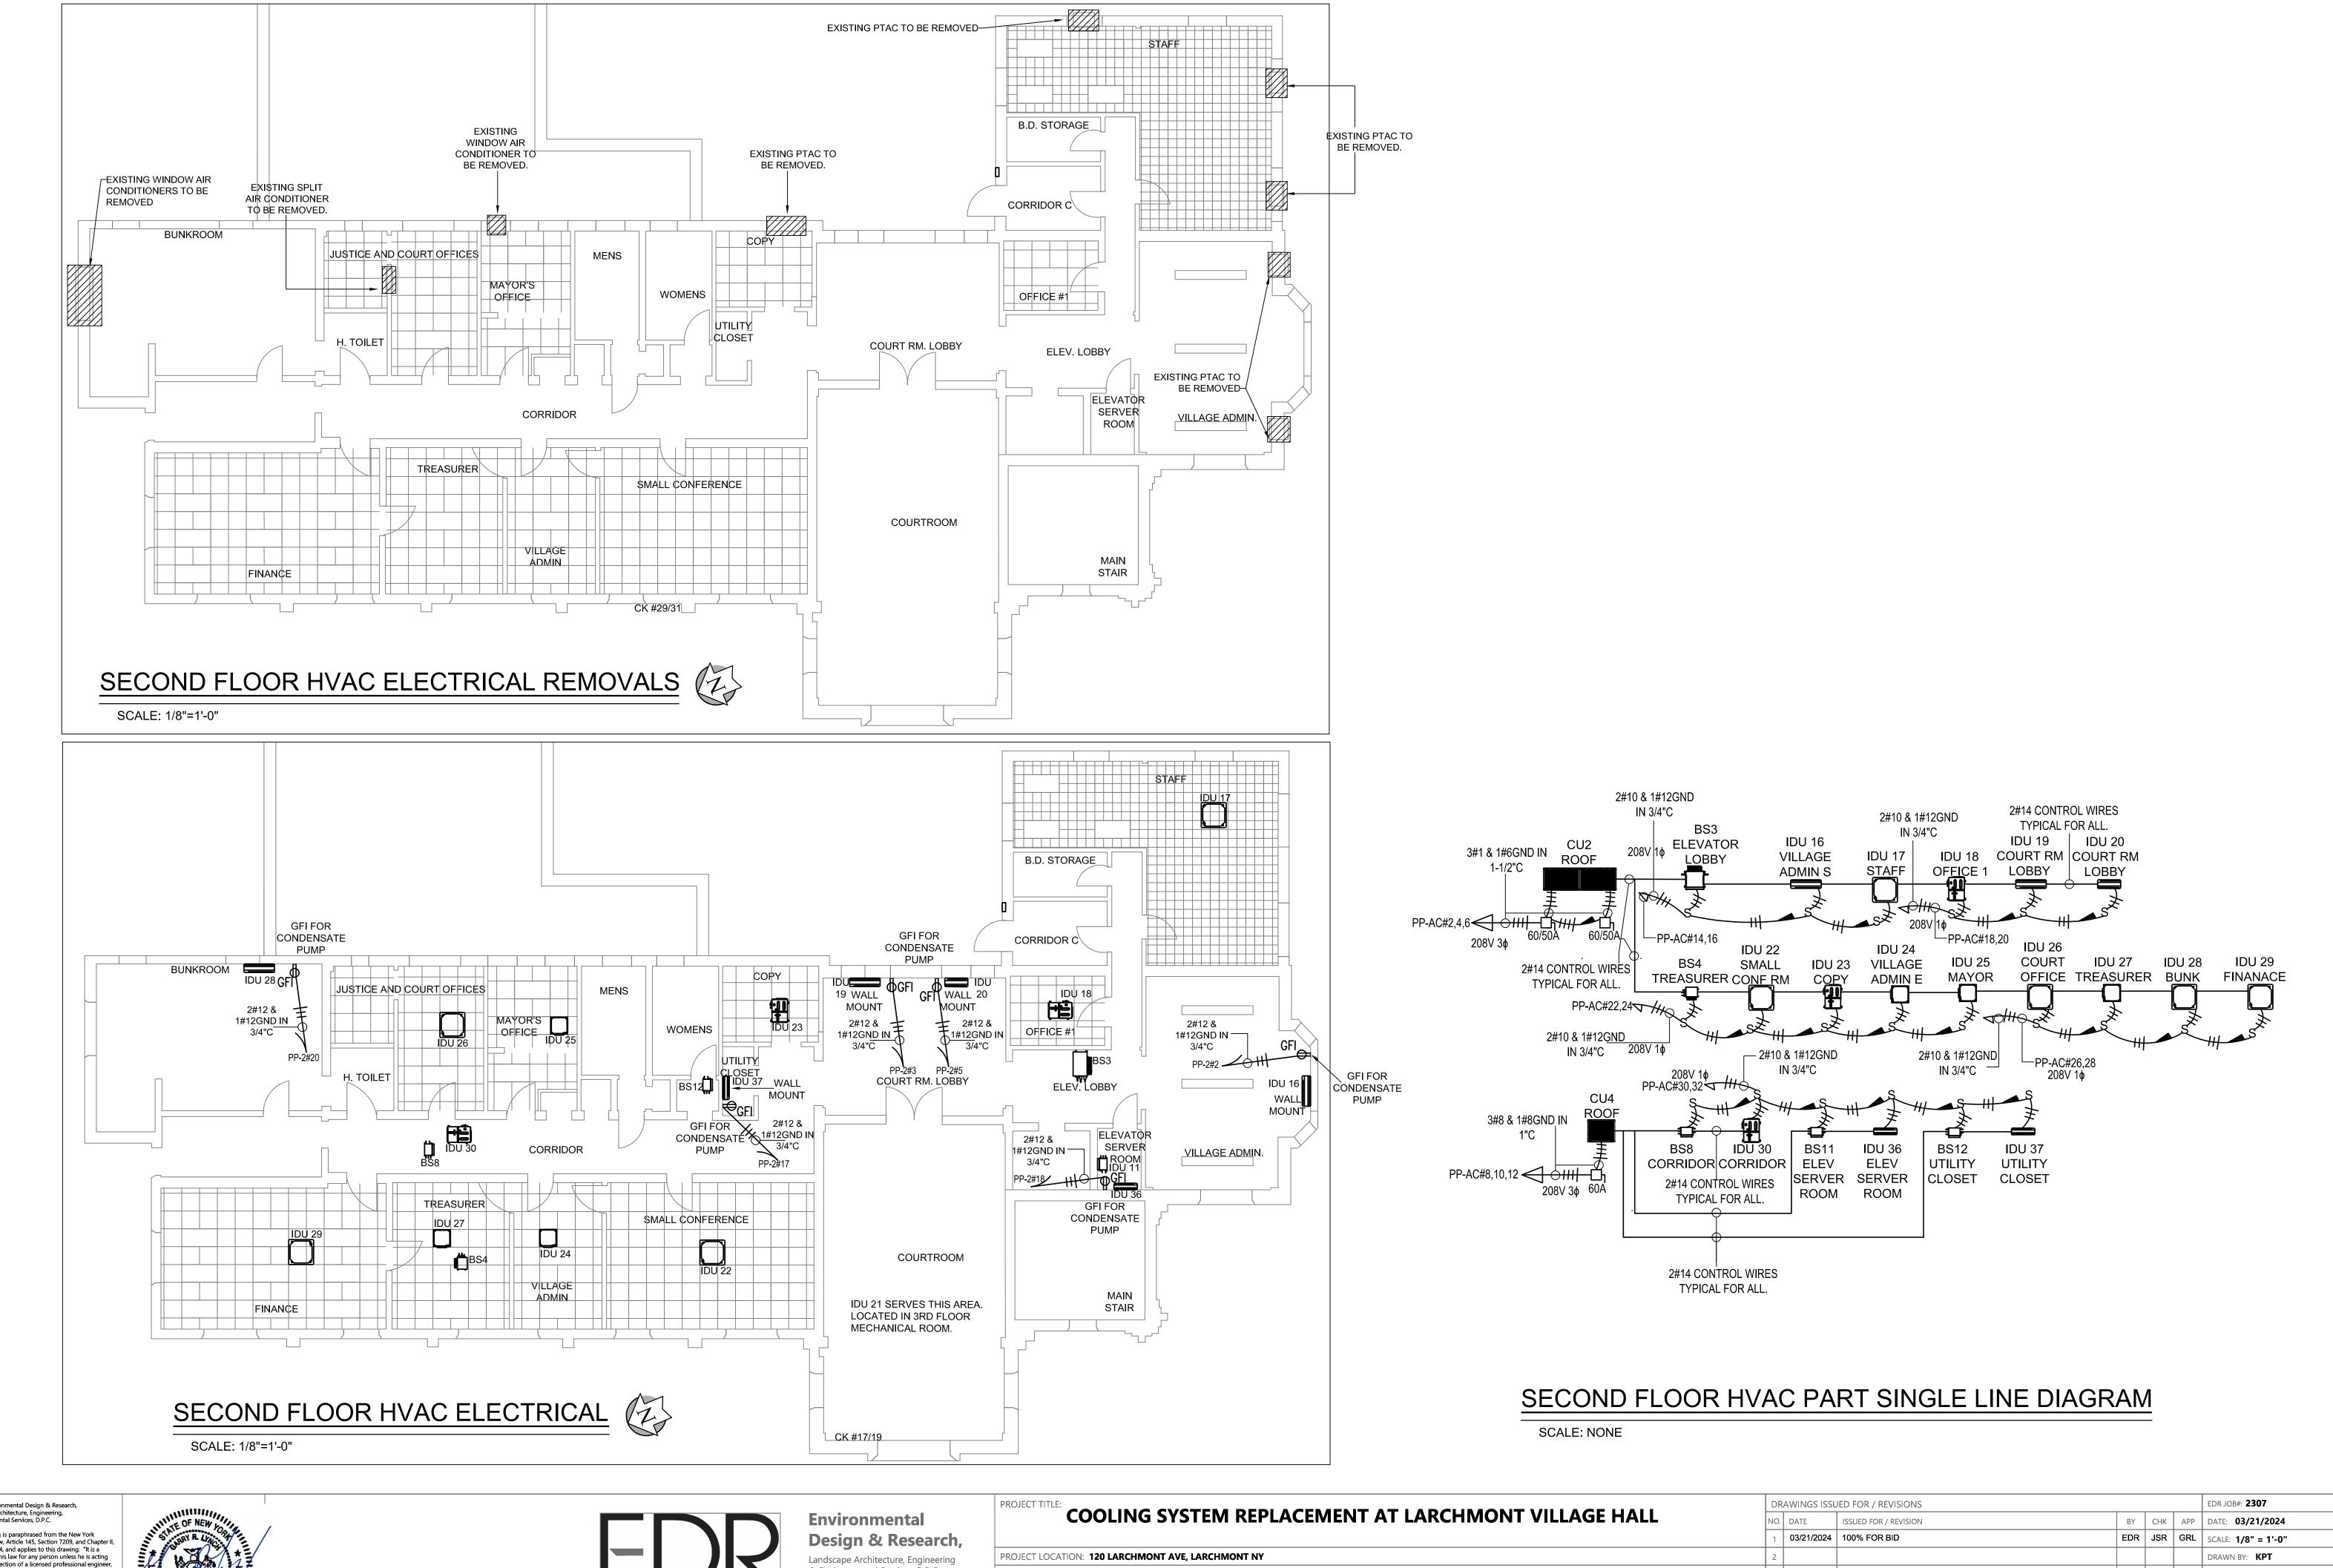


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COOLING SYSTEM DEDIACEMENT AT LADCHMONT VILLAGE HALL		DRAWINGS I		EDR JOB#: 2307			
		O. DATE	ISSUED FOR / REVISION	BY	CHK	APP	DATE: 03/21/2024
		1 03/21/20:	24 100% FOR BID	EDR	JSR	GRL	SCALE: 1/8" = 1'-0"
PROJECT LOCATION: 120 LARCHMONT AVE, LARCHMONT NY		2					DRAWN BY: KPT
CLIENT: VILLAGE OF LARCHMONT		3					CHECKED BY: GRL
DRAWING TITLE: ELECTRICAL	TRACT	4					DRAWING NUMBER:
FIRST FLOOR PLAN		5					E-3
		6					E-3



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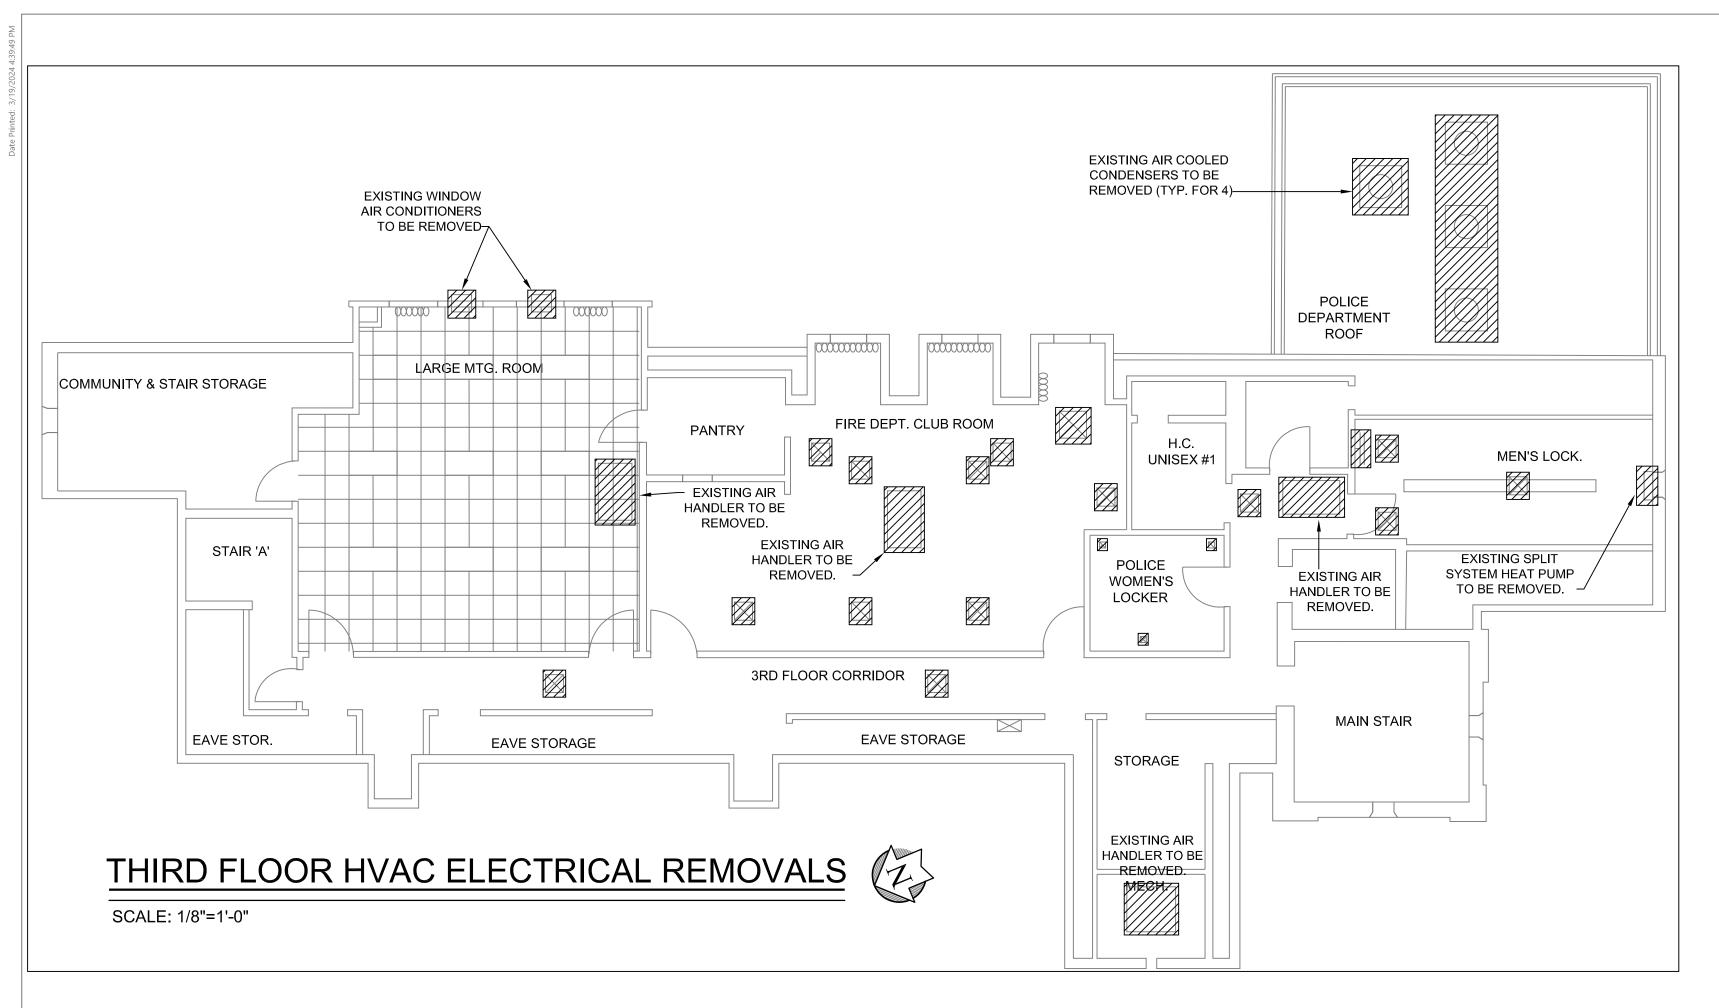



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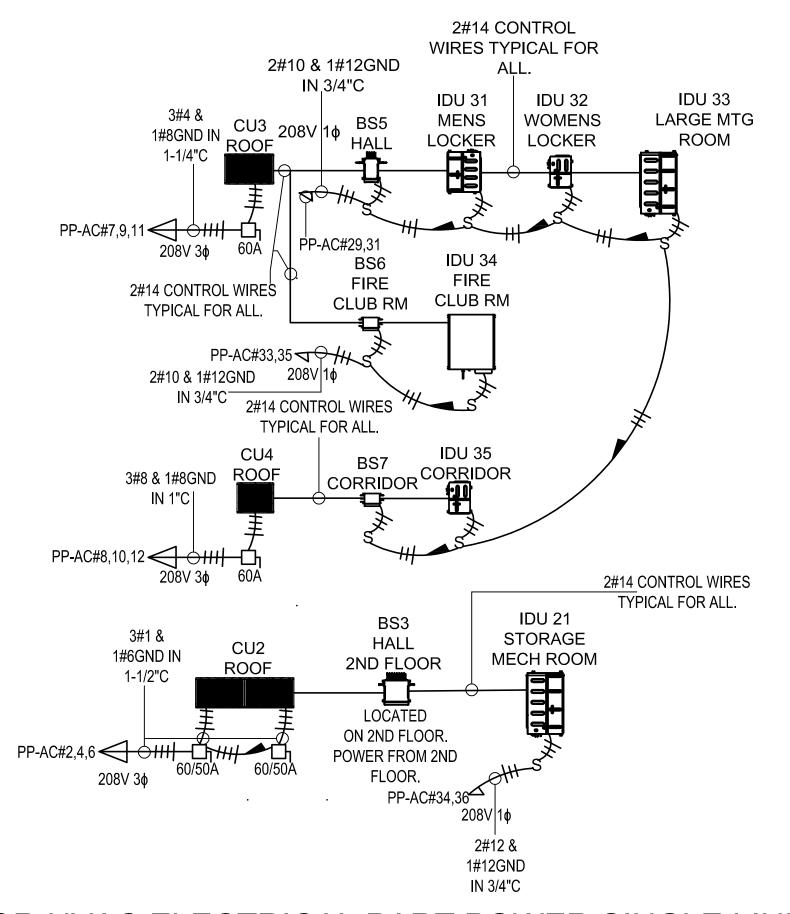
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PROJECT TITLE:		DRAWINGS ISS		EDR JOB#: 2307			
COOLING SYSTEM REPLACEMENT AT LARCHMONT VILLAGE HALL		O. DATE	ISSUED FOR / REVISION	BY	СНК	APP	DATE: 03/21/2024
	-	03/21/2024	100% FOR BID	EDR	JSR	GRL	SCALE: 1/8" = 1'-0"
PROJECT LOCATION: 120 LARCHMONT AVE, LARCHMONT NY	2	2					DRAWN BY: KPT
CLIENT: VILLAGE OF LARCHMONT	3	3					CHECKED BY: GRL
DRAWING TITLE: ELECTRICAL CONT	RACT _	ı					DRAWING NUMBER:
SECOND FLOOR PLAN	5	;					□ □ /
							│ ८-4







THIRD FLOOR HVAC ELECTRICAL PART POWER SINGLE LINE DIAGRAM

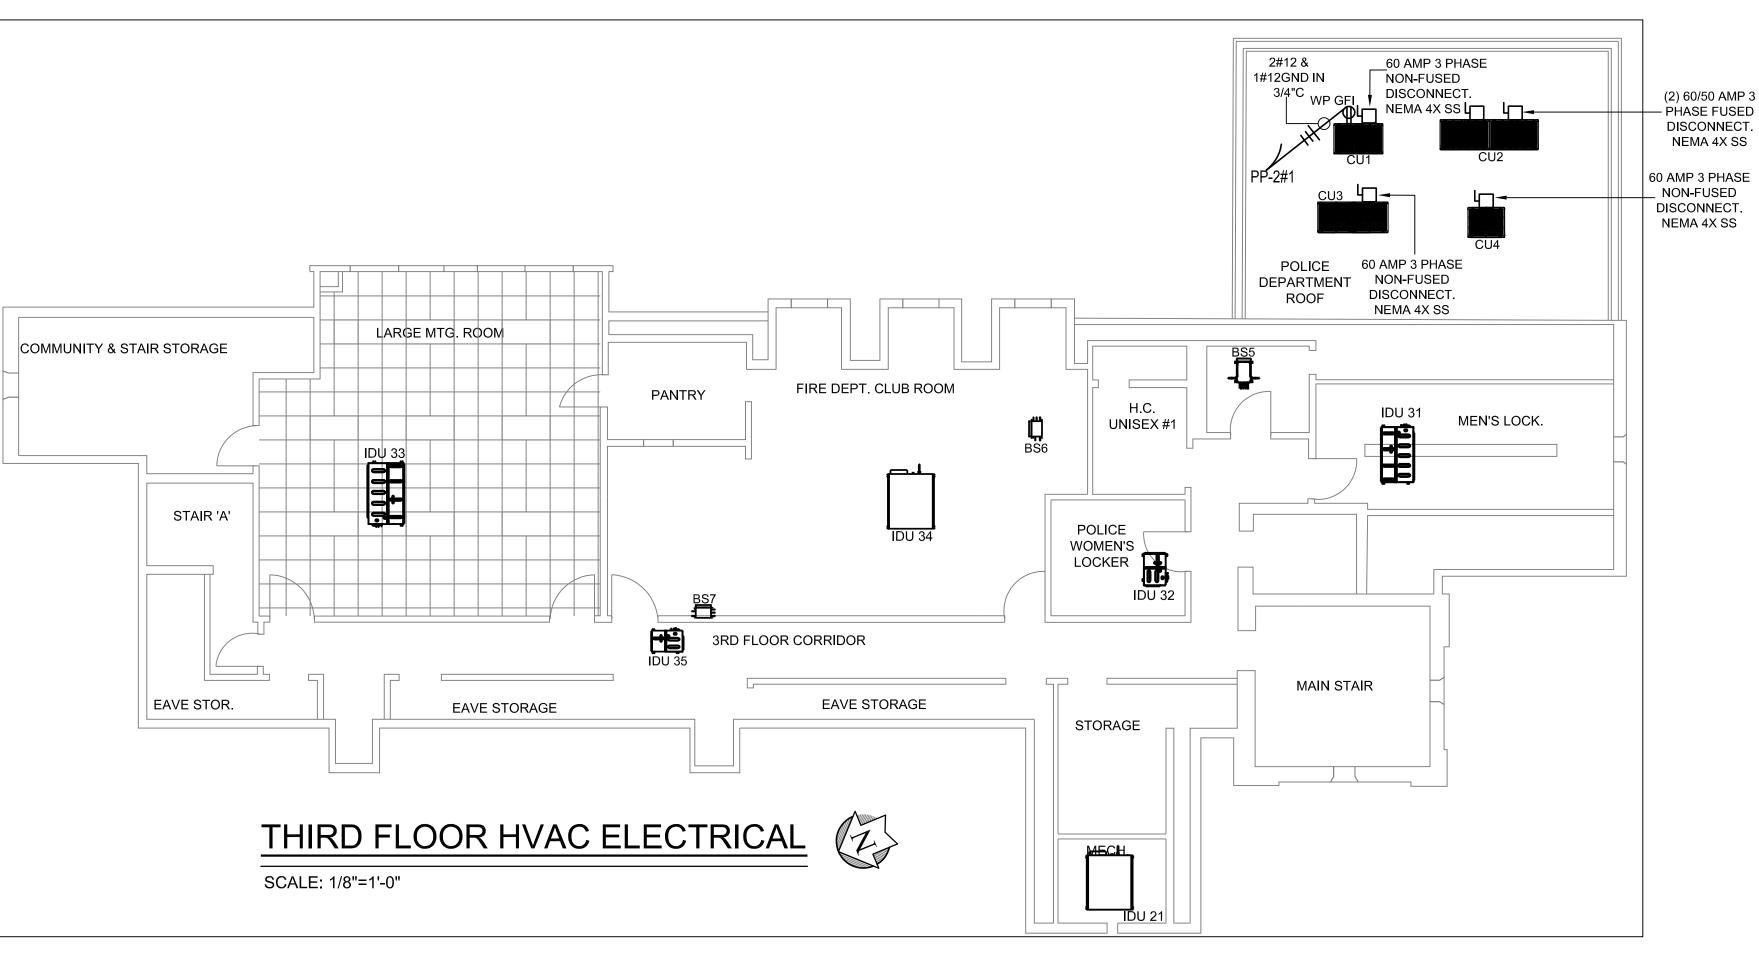SCALE: NONE

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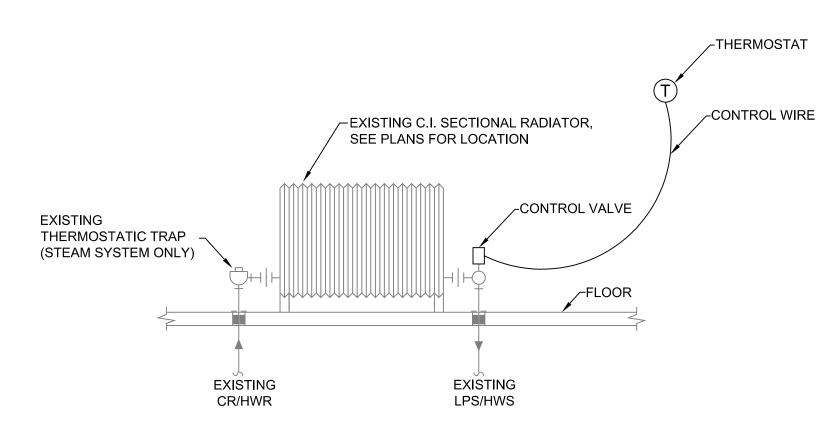




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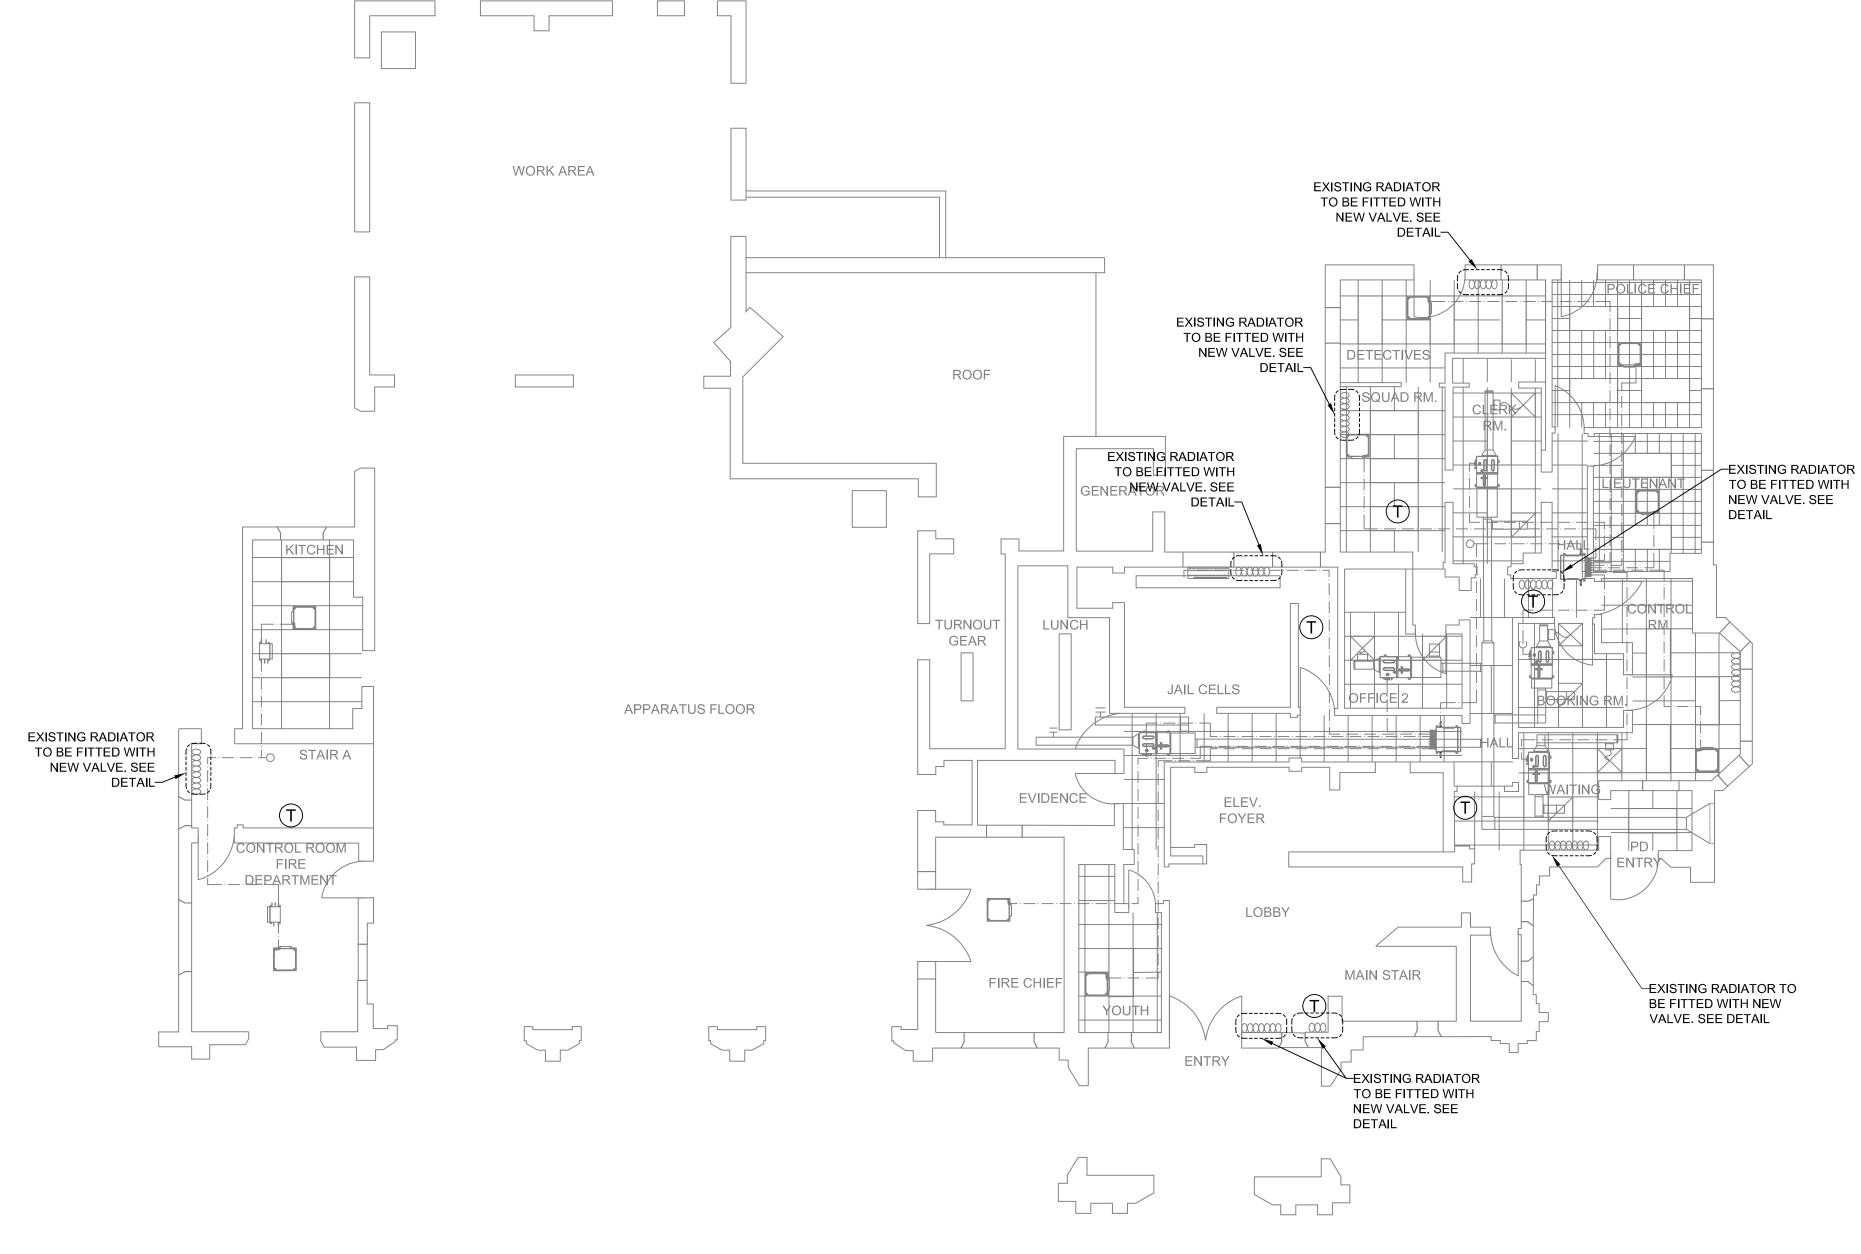
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PROJECT TITLE:		DR	AWINGS ISSUED FOR / REVISIONS				EDR JOB#: 2307
COOLING SYSTEM REPLACEMENT AT LARCHMONT VILLAGE HALL		NO.	DATE ISSUED FOR / REVISION	ВУ	СНК	APP	DATE: 03/21/2024
		1	03/21/2024 100% FOR BID	EDR	JSR	GRL	SCALE: 1/8" = 1'-0"
PROJECT LOCATION: 120 LARCHMONT AVE, LARCHMONT NY		2					DRAWN BY: KPT
CLIENT: VILLAGE OF LARCHMONT		3					CHECKED BY: GRL
DRAWING TITLE: ELECTRICAL	CONTRACT	4					DRAWING NUMBER:
THIRD FLOOR PLAN		5					EE
		6					E-3



CAST IRON RADIATOR PIPING DETAIL

NOTE: THERMOSTAT TO BE HONEYWELL TH2110DH1002 OR ENGINEER APPROVED ALTERNATE




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		1	03/21/2024 100% FOR BID	EDR	JSR	GRL	SCALE: 1/8" = 1'-0"
PROJECT LOCATION: 120 LARCHMONT AVE, LARCHMONT NY		2					DRAWN BY: KPT
CLIENT: VILLAGE OF LARCHMONT		3					CHECKED BY: GRL
DRAWING TITLE: MECHNICAL	CONTRACT	4					DRAWING NUMBER:
FIRST FLOOR RADIATOR PLAN		5					□ Λ1 1
		6					H-A1-1




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COOLING SYSTEM REPLACEMENT AT LARCHMONT VILLAGE HALL	NO.	DATE	ISSUED FOR / REVISION	BY	СНК	APP	DATE: 03/21/2024
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CLIENT: VILLAGE OF LARCHMONT	3						CHECKED BY: GRL
DRAWING TITLE: MECHNICAL CONTRAC	T 4						DRAWING NUMBER:
SECOND FLOOR RADIATOR PLAN	5						H-A1-2
	6						N-A1-2



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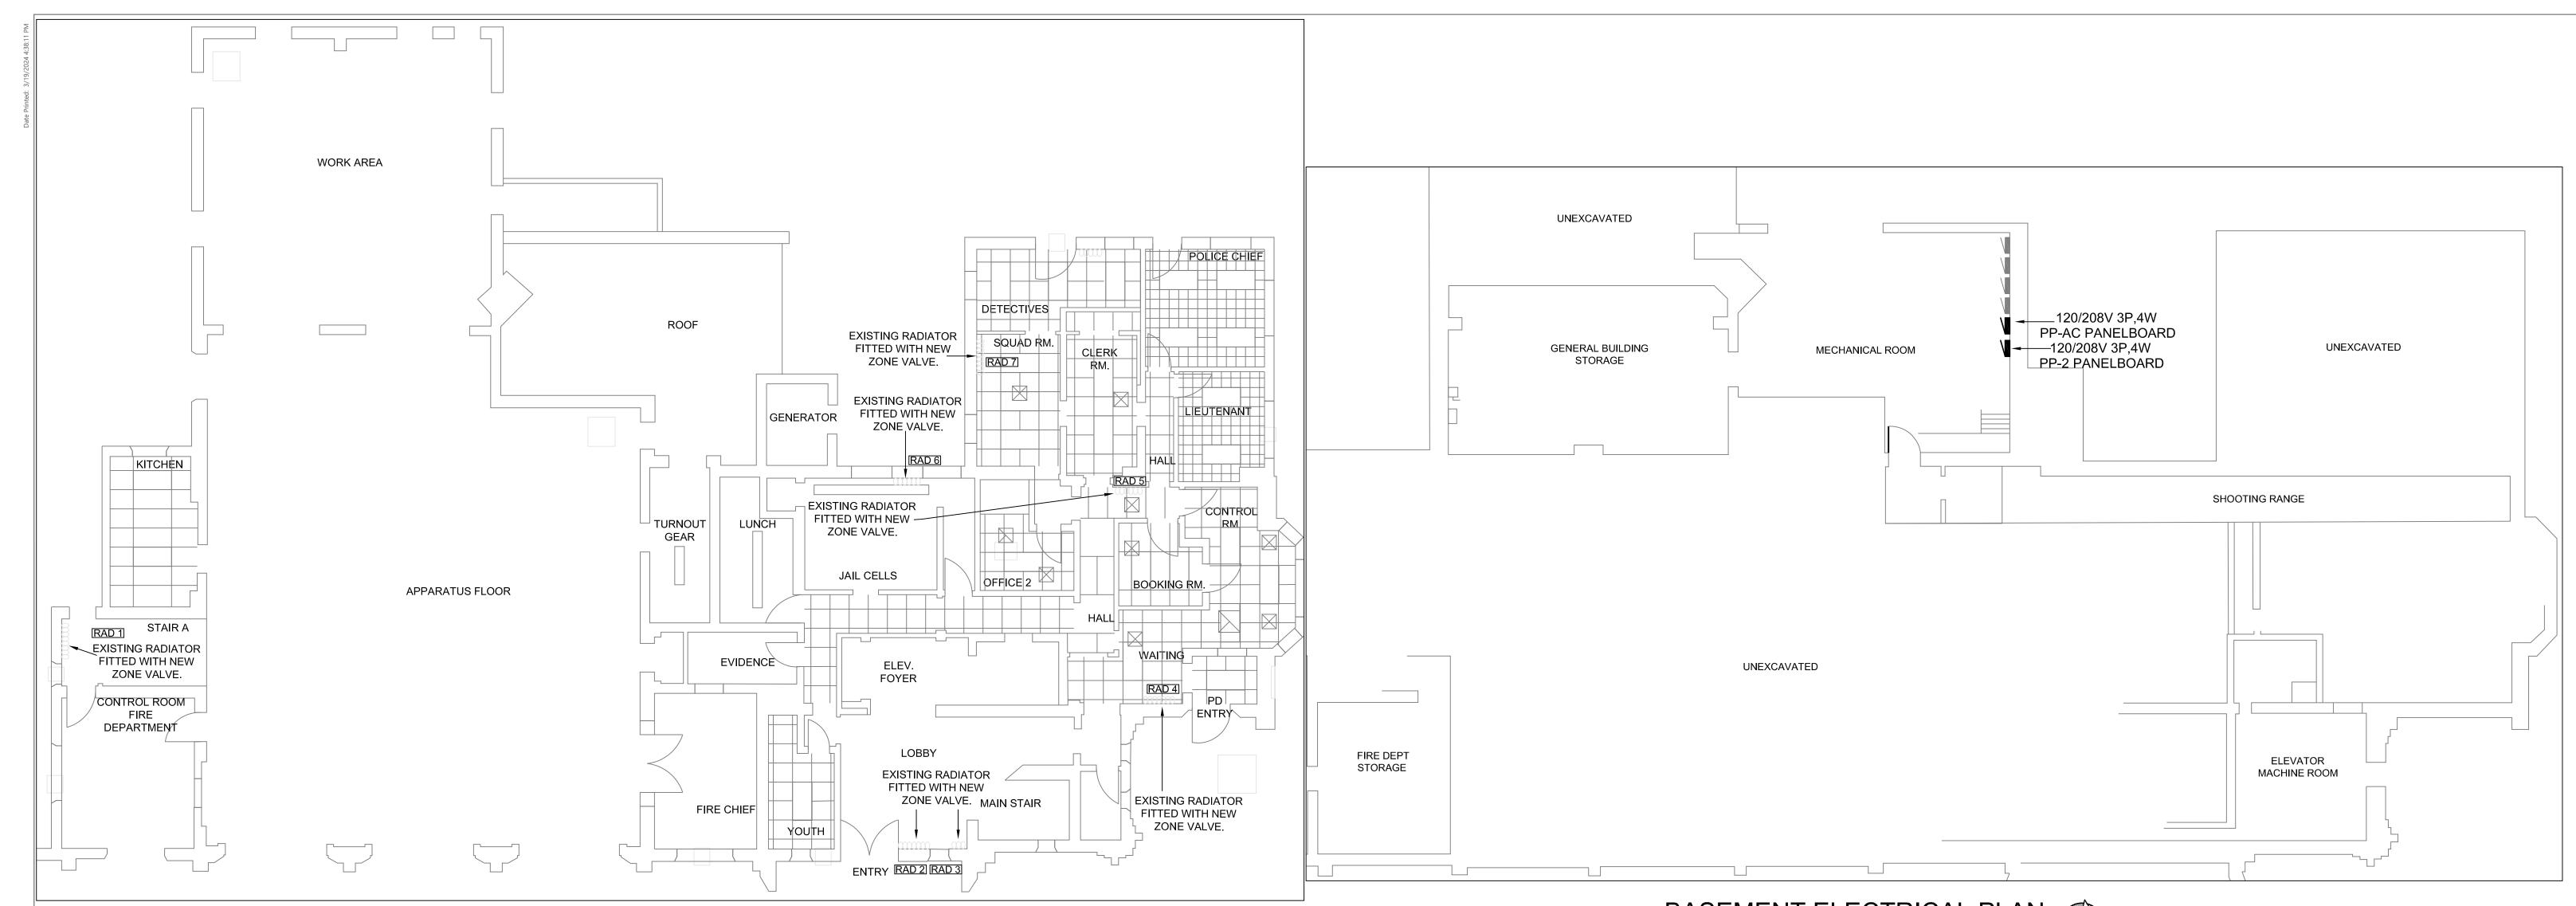
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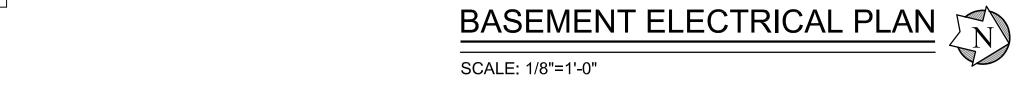
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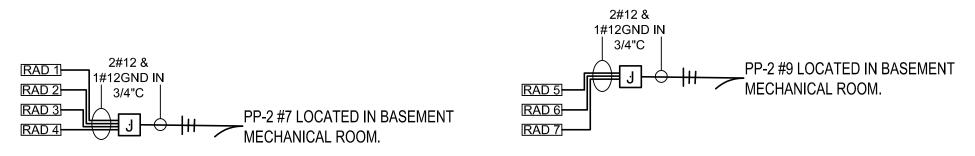
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COOLING SYSTEM REPLACEMENT AT LARCHMONT VILLAGE HALL	NO	DATE	ISSUED FOR / REVISION	BY	СНК	APP	DATE: 03/21/2024
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PROJECT LOCATION: 120 LARCHMONT AVE, LARCHMONT NY	2						DRAWN BY: KPT
CLIENT: VILLAGE OF LARCHMONT	3						CHECKED BY: GRL
DRAWING TITLE: MECHNICAL CONTRA	CT 4						DRAWING NUMBER:
THIRD FLOOR RADIATOR PLAN	5						H-A1-3
	6					П-АІ-Э	

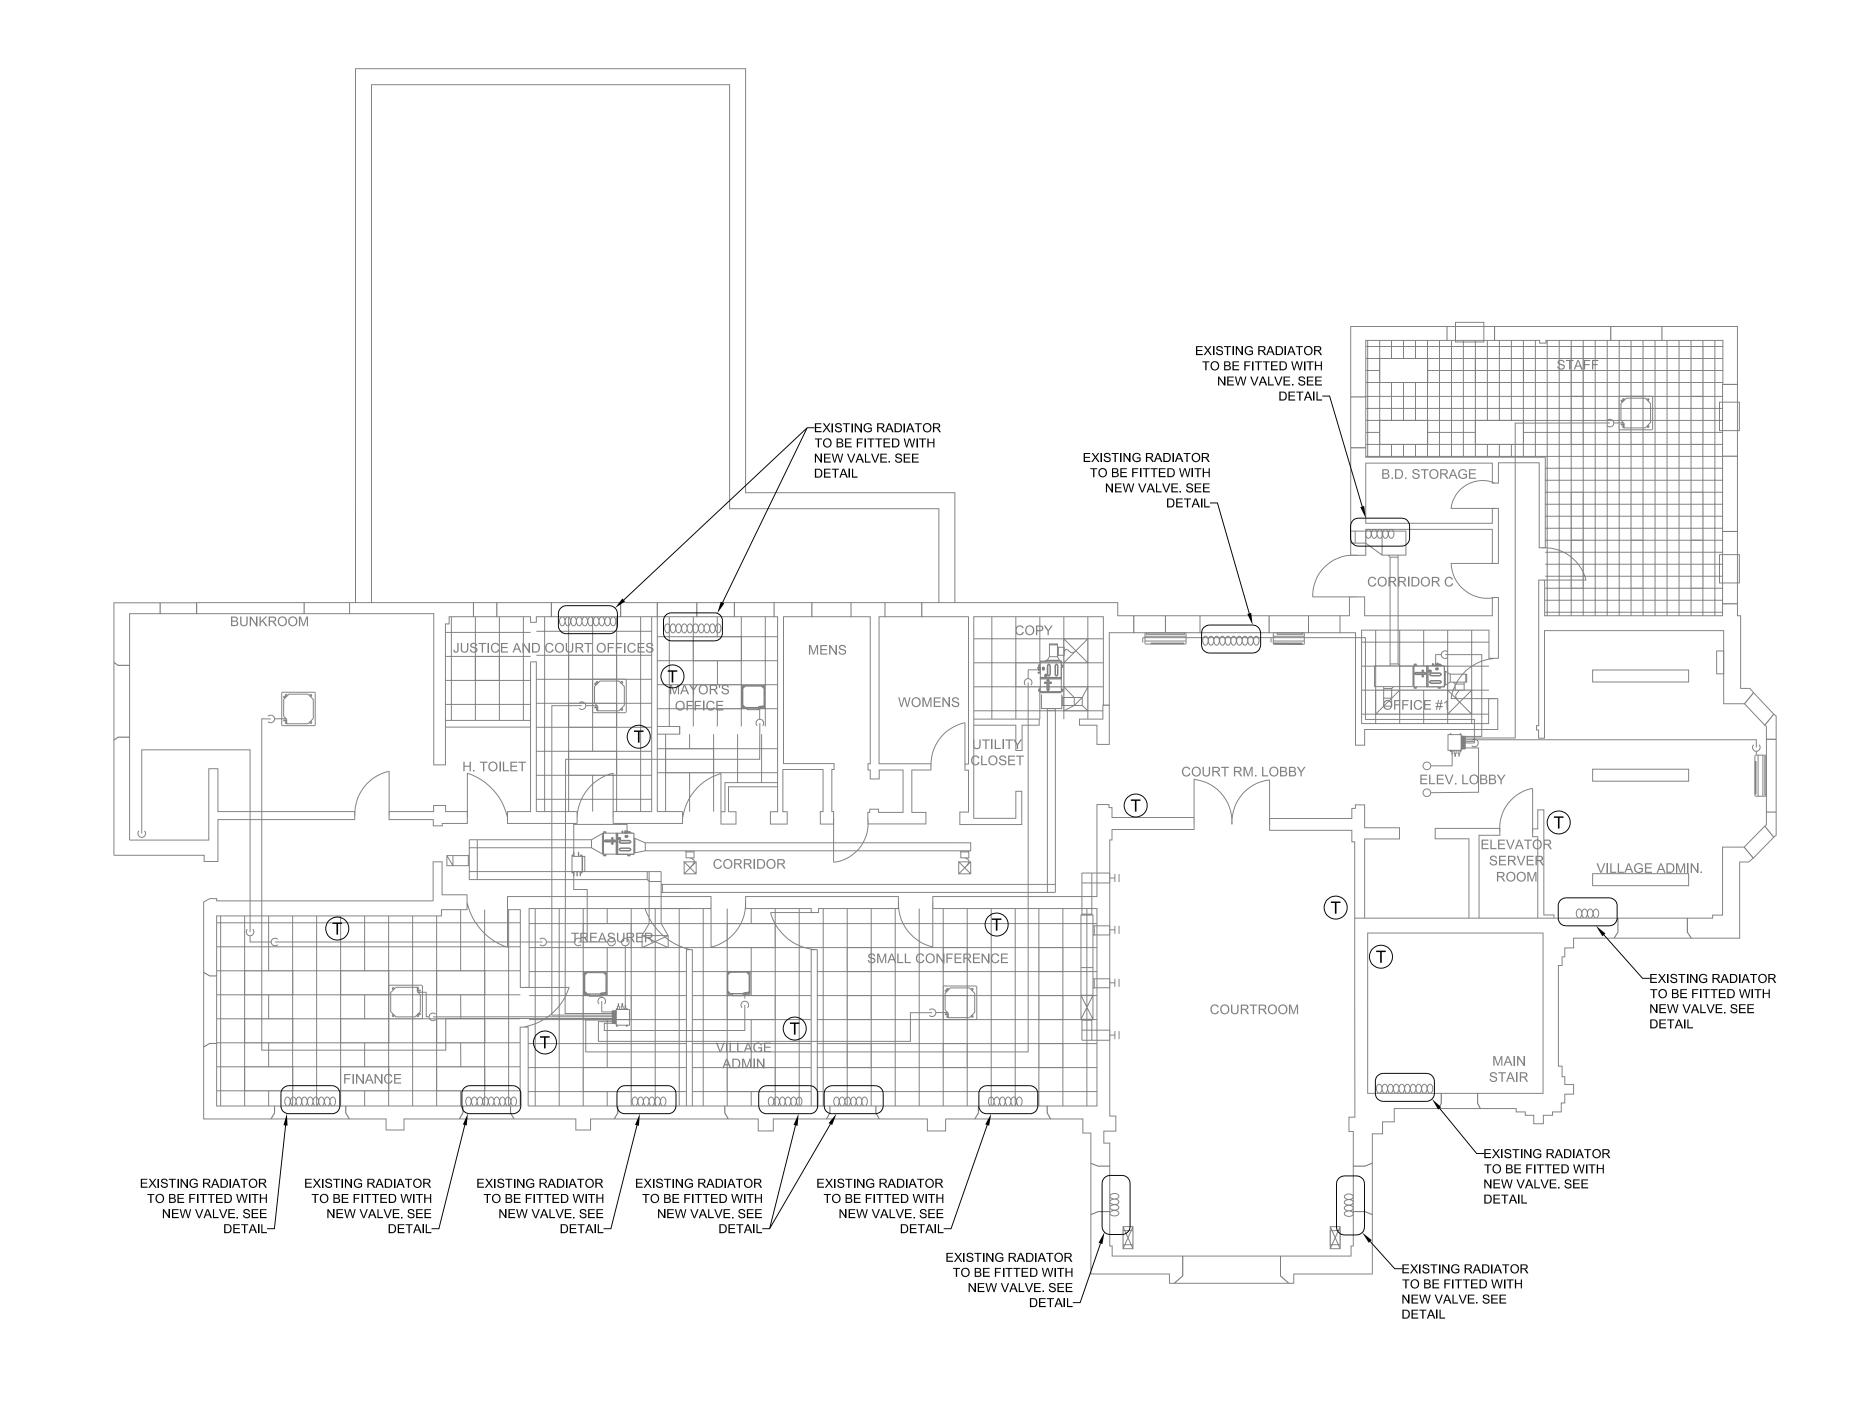

FIRST FLOOR RADIATOR ZONE VALVE ELECTRICAL

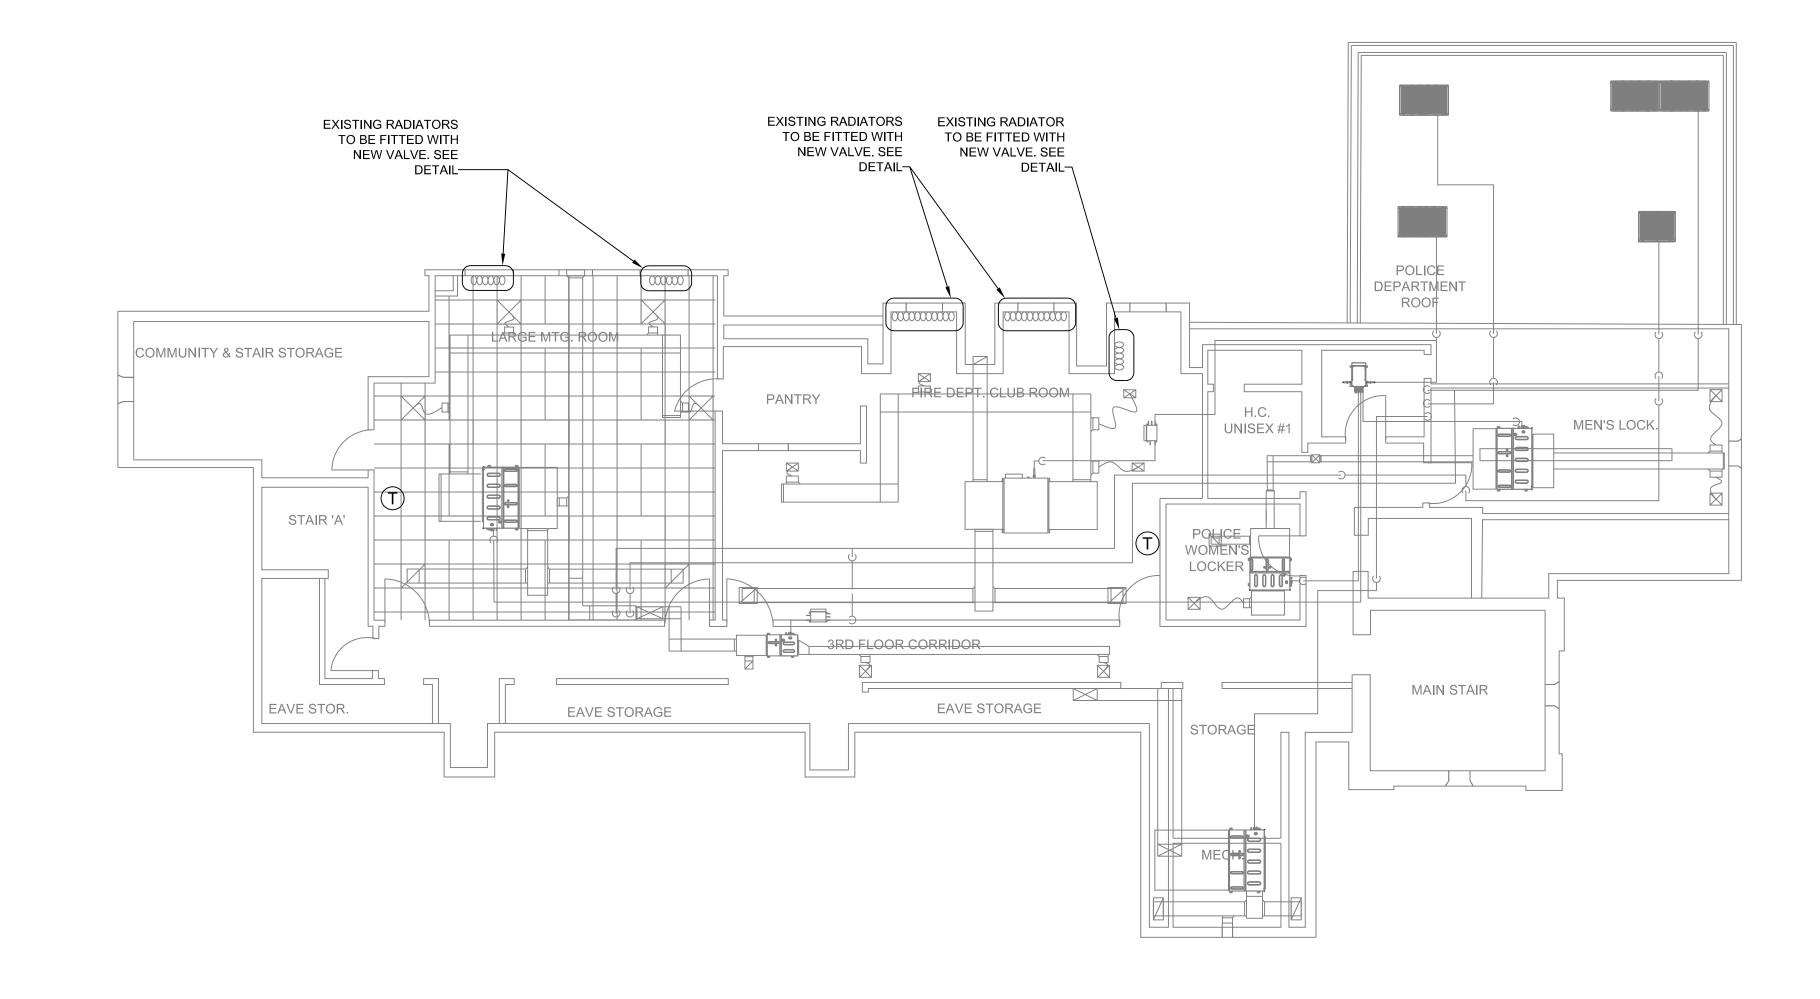SCALE: 1/8"=1'-0"





RADIATOR ZONE VALVE WIRING DIAGRAM

SCALE: NONE

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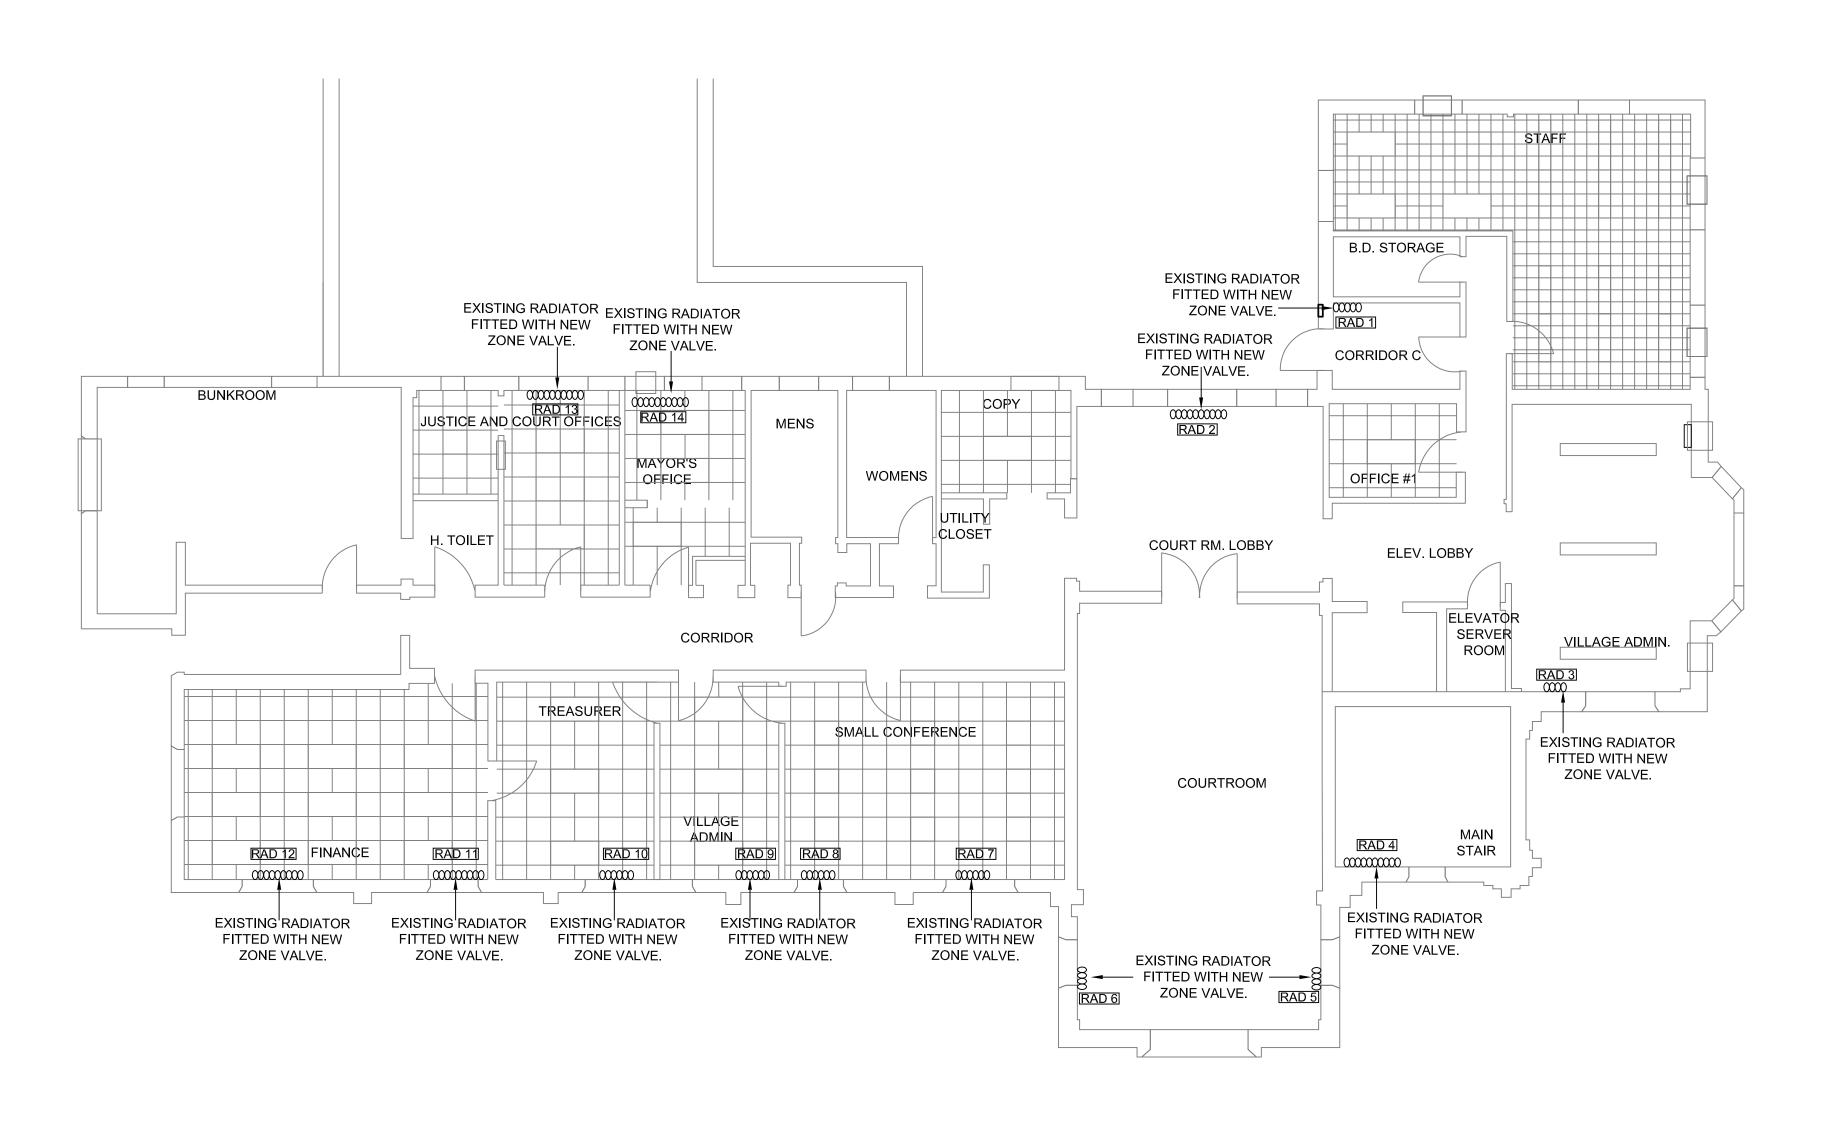



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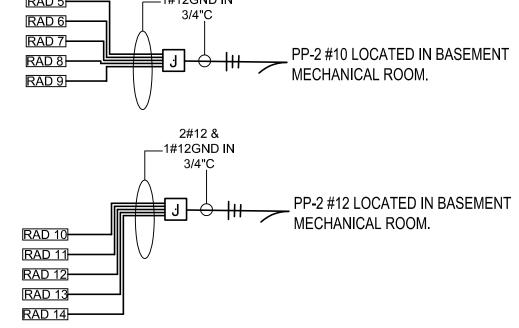
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PROJECT TITLE:		RAWINGS ISSU		EDR JOB#: 2307			
COOLING SYSTEM REPLACEMENT AT LARCHMONT VILLAGE HALL	NO.	DATE	ISSUED FOR / REVISION	BY	СНК	APP	DATE: 03/21/2024
	1	03/21/2024	100% FOR BID	EDR	JSR	GRL	SCALE: 1/8" = 1'-0"
PROJECT LOCATION: 120 LARCHMONT AVE, LARCHMONT NY	2						DRAWN BY: KPT
CLIENT: VILLAGE OF LARCHMONT	3						CHECKED BY: GRL
DRAWING TITLE: ELECTRICAL CONTRAC	T 4						DRAWING NUMBER:
FIRST FLOOR RADIATOR ZONE VALVE PLAN	5						E-A1-1
FIRST LOOK NADIATOR ZONE VALVE PLAN	6						







RADIATOR ZONE VALVE WIRING DIAGRAM

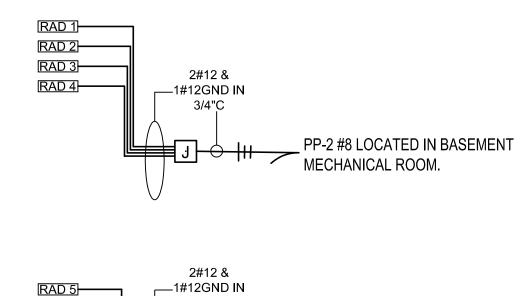SCALE: NONE

SECOND FLOOR RADIATOR ZONE VALVE ELECTRICAL

SCALE: 1/8"=1'-0"

LOOK KADIATOK ZONE VALVE ELECTRICA

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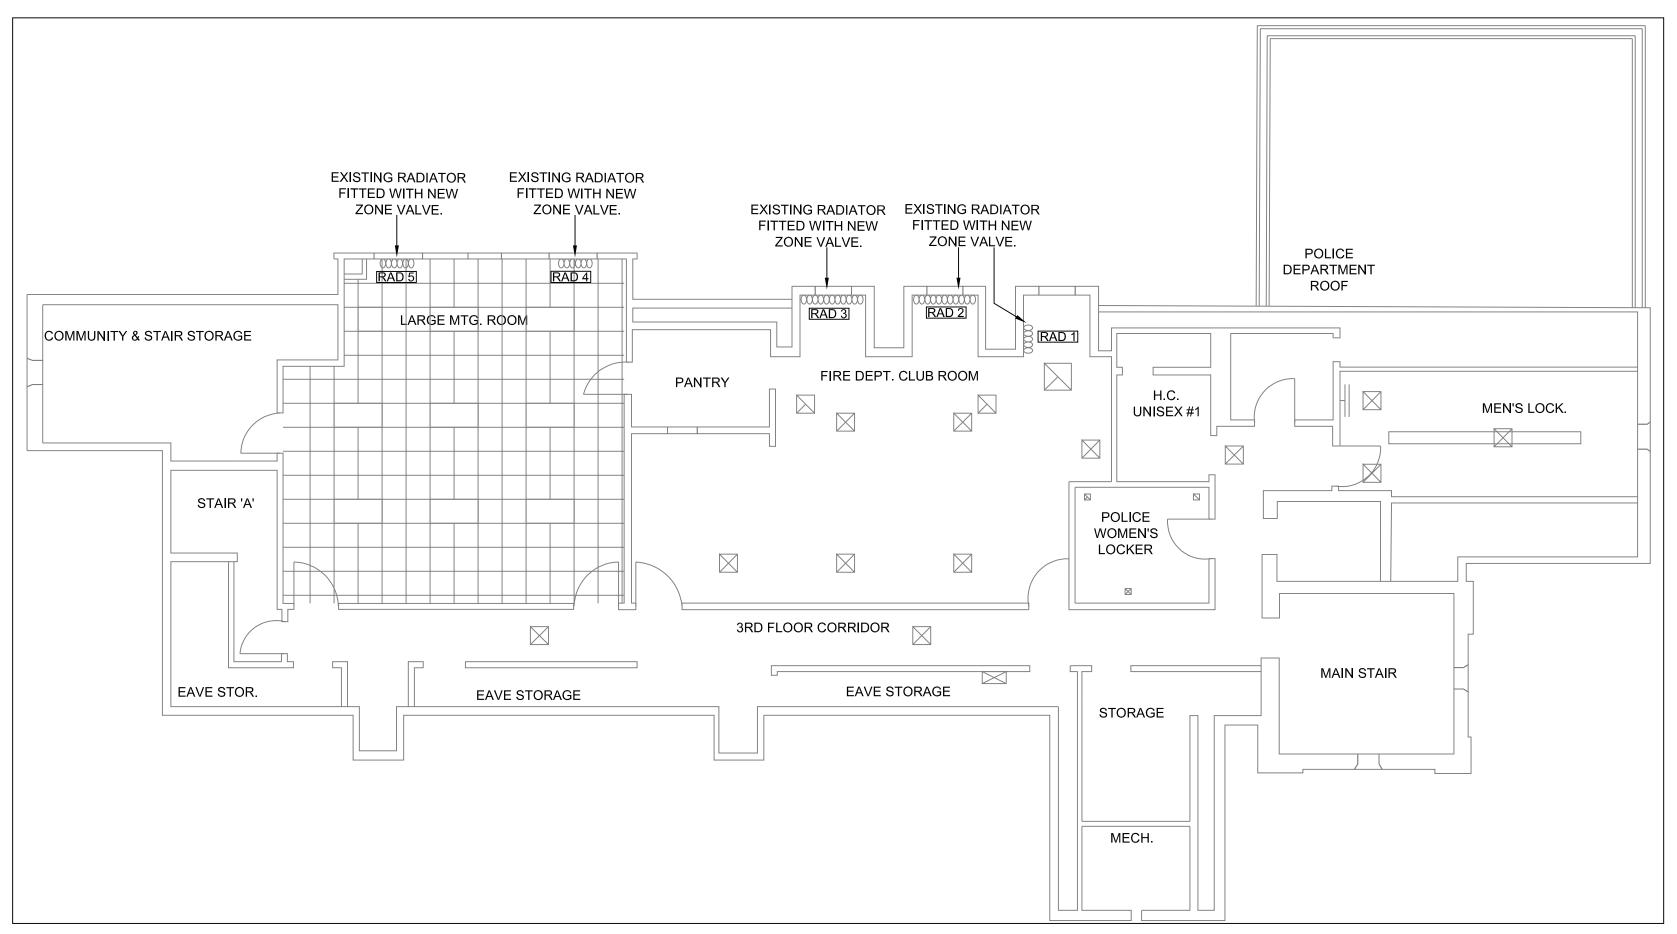



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COOLING SYSTEM REPLACEMENT AT LARCHMONT VILLAGE HALL	NC	D. DATE ISSUED FOR / REVISION	BY	СНК	APP	DATE: 03/21/2024				
	1	03/21/2024 100% FOR BID	EDR	JSR	GRL	- SCALE: 1/8" = 1'-0"				
PROJECT LOCATION: 120 LARCHMONT AVE, LARCHMONT NY	2					DRAWN BY: KPT				
CLIENT: VILLAGE OF LARCHMONT	3					CHECKED BY: GRL				
DRAWING TITLE: ELECTRICAL CONTRACT	4					DRAWING NUMBER:				
SECOND FLOOR RADIATOR PLAN	5					E-A1-2				
SECOND FEGOR ICADIATION FEATURE	6					E-MI-Z				





SCALE: NONE

THIRD FLOOR RADIATOR ZONE VALVE ELECTRICAL

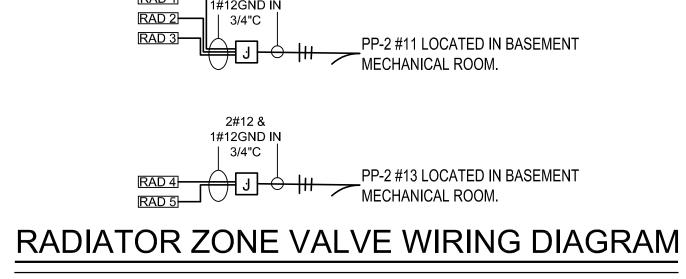SCALE: 1/8"=1'-0"

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COOLING SYSTEM REPLACEMENT AT LARCHMONT VILLAGE HALL		NO. DATE	DATE ISSUED FOR / REVISION		СНК	APP	DATE: 03/21/2024
		1 03/21/2024	100% FOR BID	EDR	JSR	GRL	SCALE: 1/8" = 1'-0"
OJECT LOCATION: 120 LARCHMONT AVE, LARCHMONT NY		2					DRAWN BY: KPT
ENT: VILLAGE OF LARCHMONT		3					CHECKED BY: GRL
AWING TITLE: ELECTRICAL	CONTRACT	4					DRAWING NUMBER:
THIRD FLOOR RADIATOR ZONE VALVE PLAN		5					E-A1-3
		6					E-WI-3