



Rockland County

FACILITIES MANAGEMENT

HON. EDWIN J. DAY
COUNTY EXECUTIVE

ROBERT H. GRUFFI, P.E. LEED AP
DIRECTOR, FACILITIES MANAGEMENT

CAPITAL PROJECT 1519 GOVERNMENT CENTER BUILDING IMPROVEMENTS COURTHOUSE COOLING TOWER REPLACEMENT

1 SOUTH MAIN STREET
NEW CITY, NY 10956

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1 South Main Street
New City, NY 10956

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2	ISSUED FOR BID	09.09.2024
1	ISSUE FOR PERMIT	04.05.2024


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COOLING TOWER REPLACEMENT
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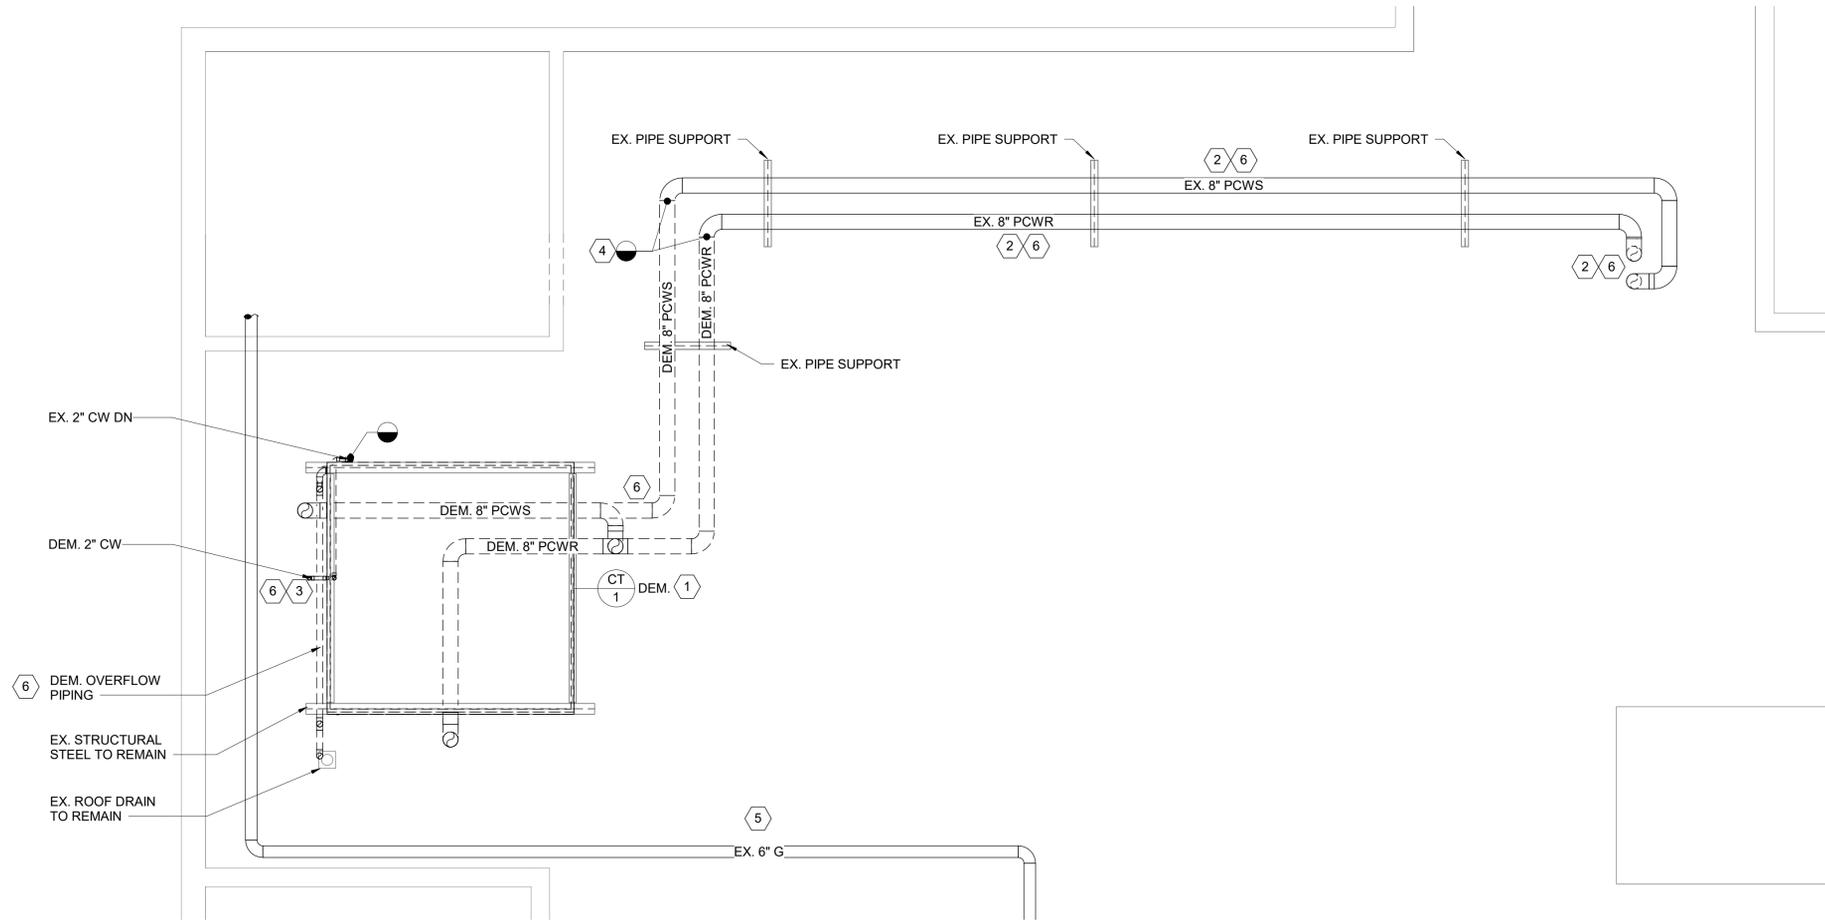
DRAWING TITLE
COVER SHEET

SEAL	SCALE	PROJECT NO. NRCK0018
	DRAWN BY JC	DRAWING NO. T0.1
	CHECKED BY RS	
	DATE 2024.04.05	

DRAWING INDEX			
DWG #	DRAWING TITLE	ISSUES / REVISIONS	
		ISSUE FOR PERMIT	ISSUED FOR BID
COVER			
T0.1	COVER SHEET	X	X
MECHANICAL			
M0.1	MECHANICAL ABBREVIATIONS, SYMBOLS, AND NOTES	X	X
M1.1	MECHANICAL DEMOLITION PLANS	X	X
M2.1	MECHANICAL NEW WORK PLANS	X	X
M6.1	MECHANICAL SCHEDULES	X	X
M7.1	MECHANICAL DETAILS	X	X
ELECTRICAL			
E0.1	ELECTRICAL ABBREVIATIONS, SYMBOLS AND NOTES	X	X
E1.1	ELECTRICAL DEMOLITION PLANS	X	X
E1.2	ELECTRICAL DEMOLITION SINGLE LINE DIAGRAMS AND PLAN	X	X
E2.1	ELECTRICAL NEW WORK PLANS	X	X
E2.2	ELECTRICAL NEW WORK SINGLE LINE DIAGRAMS AND PLAN	X	X
E7.1	ELECTRICAL DETAILS	X	X
TOTAL: 12			



2 LEVEL 02 MECHANICAL DEMOLITION PLAN
SCALE: 1/4" = 1'-0"
NORTH

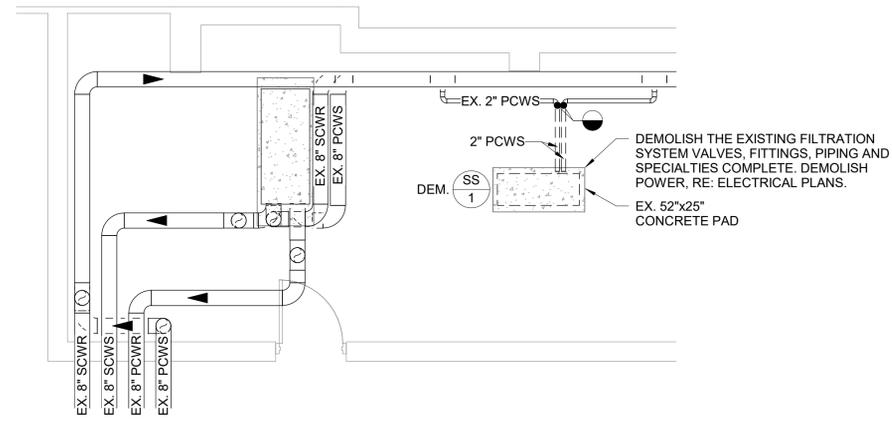


1 ROOF MECHANICAL DEMOLITION PLAN
SCALE: 1/4" = 1'-0"
NORTH

GENERAL NOTES

1. CONDITIONS MAY NOT BE EXACTLY AS INDICATED ON THIS DRAWING. HVAC CONTRACTOR SHALL VISIT THE SITE TO UNDERSTAND THE EXISTING FIELD CONDITIONS AND TO VERIFY SCOPE OF WORK PRIOR TO SUBMITTING BID. NO ALLOWANCE WILL BE MADE AFTER CONTRACT IS APPROVED.
2. ALL ABANDONED AND UNUSED EQUIPMENT SHALL BE REMOVED.
3. CONTRACTOR SHALL REPAIR ANY LEAKS IN THE CONDENSER WATER SYSTEM, INCLUDING PIPING NOT SPECIFICALLY SHOWN ON PLAN. SUBMIT REPORT TO ENGINEER.
4. COORDINATE ALL SHUTDOWNS WITH BUILDING FACILITIES, OWNER, AND TENANTS.

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KEYNOTES

1. DEMOLISH COOLING TOWER AND ASSOCIATED PIPING AS SHOWN. REMOVE VIBRATION ISOLATORS AND DUNNAGE ON TOP OF THE STRUCTURAL STEEL FRAMING. STRUCTURAL STEEL FRAMING TO REMAIN.
2. REMOVE INSULATION FOR ALL CONDENSER WATER PIPING ON THE ROOF. RE-FINISH ANY RUST-DAMAGED SEGMENTS OF THE CONDENSER WATER PIPING.
3. DEMOLISH 2" CW BACK TO SHUT-OFF VALVE. CAP AND SEAL OPEN PIPING WHILE WORK IS NOT BEING PERFORMED.
4. DISCONNECT CONDENSER WATER PIPING. CAP AND SEAL WHILE WORK IS NOT BEING PERFORMED.
5. NO WORK TO THE EXISTING GAS LINE. SHOWN FOR REFERENCE ONLY.
6. DEMOLISH HEAT TRACING ASSOCIATED ON THE EXISTING PCWS/R PIPING ABOVE THE ROOF.

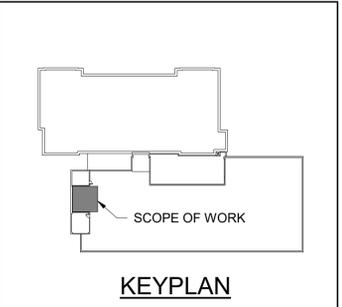
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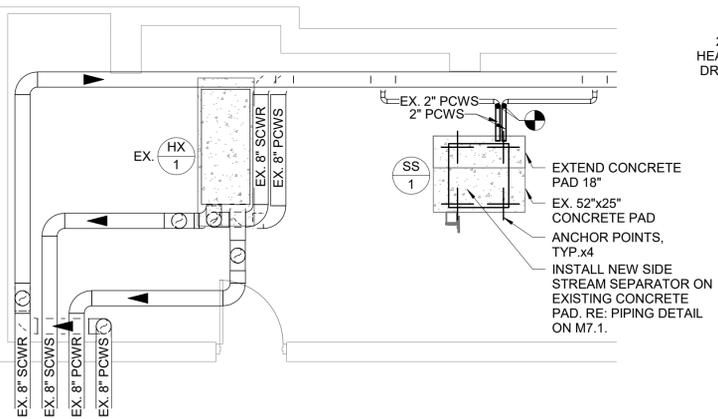
PROJECT
**CAPITAL PROJECT 1519
GOVERNMENT CENTER BUILDING
IMPROVEMENTS COURTHOUSE
COOLING TOWER REPLACEMENT**
1 SOUTH MAIN STREET
NEW CITY, NY 10956

DRAWING TITLE
**MECHANICAL DEMOLITION
PLANS**


SCALE	PROJECT NO.
As indicated	NRCK0018
DRAWN BY JC	DRAWING NO.
CHECKED BY RS	M1.1
DATE 2024.04.05	




5 LEVEL 05 MECHANICAL NEW WORK PLAN
SCALE: 1/8" = 1'-0"
NORTH

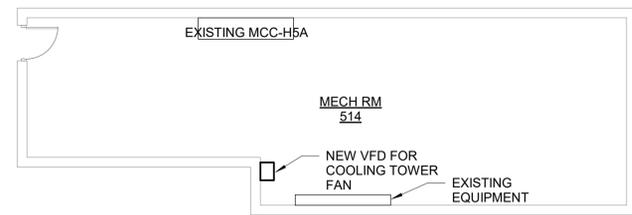

2 LEVEL 02 MECHANICAL NEW WORK PLAN
SCALE: 1/4" = 1'-0"
NORTH

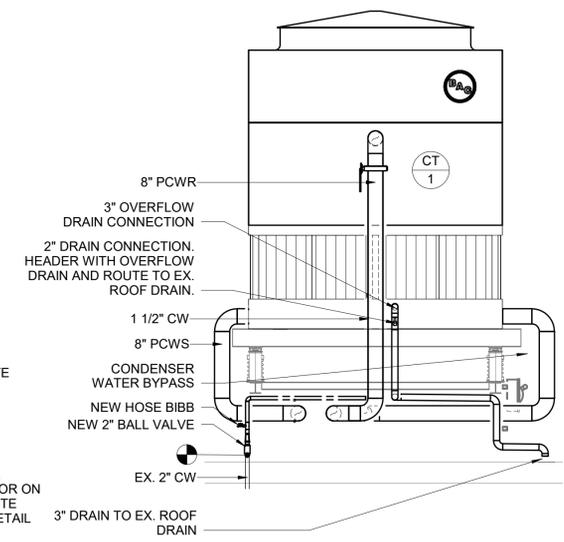

4 COOLING TOWER ELEVATION - SIDE
SCALE: 1/4" = 1'-0"

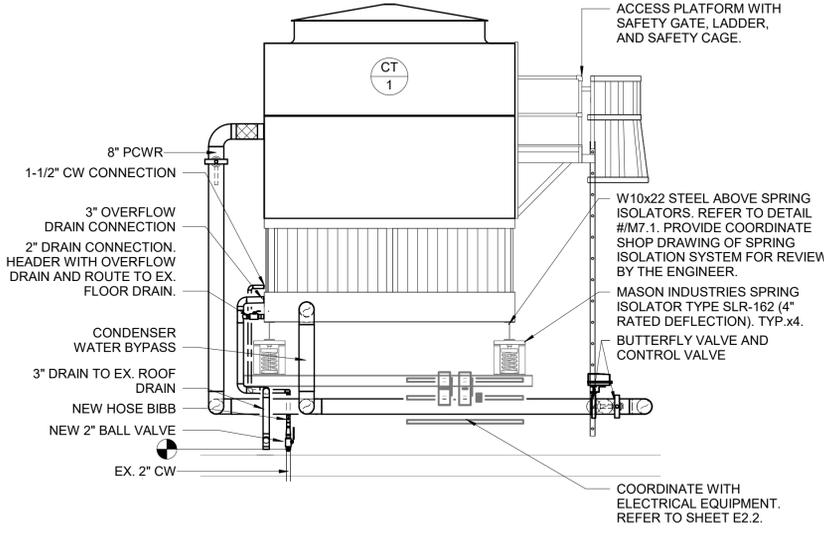


3 COOLING TOWER ELEVATION - FRONT
SCALE: 1/4" = 1'-0"

GENERAL NOTES

- CONDITIONS MAY NOT BE EXACTLY AS INDICATED ON THIS DRAWING. HVAC CONTRACTOR SHALL VISIT THE SITE TO UNDERSTAND THE EXISTING FIELD CONDITIONS AND TO VERIFY SCOPE OF WORK PRIOR TO SUBMITTING BID. NO ALLOWANCE WILL BE MADE AFTER CONTRACT IS APPROVED.
- CONTRACTOR SHALL REPAIR ANY LEAKS IN THE CONDENSER WATER SYSTEM, INCLUDING PIPING NOT SPECIFICALLY SHOWN ON PLAN. SUBMIT REPORT TO ENGINEER.
- COORDINATE ALL SHUTDOWNS WITH BUILDING FACILITIES, OWNER, AND TENANTS.
- MECHANICALLY CLEAN ALL THE EXISTING CWS&R PIPING ON THE ROOF OF RUST. WIRE WHEEL DOWN TO BASE METAL. COAT WITH RUST STOPPING AGENT AS PER MANUFACTURER'S INSTRUCTIONS. INTERSTATE "ONE STEP" RUST KILLER, OR EASTWOOD RUST ENCAPSULATOR PLUS, OR LOCKTITE RUST TREATMENT 754.
- PAINT ALL NEW AND EXISTING CONDENSER WATER PIPING WITH RUST PREVENTATIVE PRIMER AND GRAY ENAMEL OIL BASED PAINT.
- RE-INSULATE ALL CONDENSER WATER PIPING ABOVE THE ROOF AND JACKET WITH WATERPROOF JACKET AS PER SPECIFICATIONS.
- STENCIL JACKET AND LABEL ALL PIPING INCLUDING FLOW ARROWS.
- THE EXISTING STEEL DUNNAGE SHALL BE CLEANED OF ALL RUST BY MECHANICAL GRINDING OR WIRE WHEEL. COAT BARE METAL SPOTS WITH COLD GALVANIZED BY ZRC.
- NEW DUNNAGE, HANGER BRACKETS, PIPE OR CONDUIT SUPPORTS SHALL BE GALVANIZED STEEL. CLEAN AND COLD GALVANIZE ALL WELDS IN THE FIELD WITH ZRC.
- ALL FASTENERS, NUTS, BOLTS, WASHERS, ETC. SHALL BE GALVANIZED STEEL.

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KEYNOTES

- RE-INSULATE ALL ROOFTOP CONDENSER WATER PIPING. REFER TO SPECIFICATIONS.
- RE-USE PIPE SUPPORTS.
- PROVIDE NEW 2" BALL VALVE AND CONNECT TO EXISTING COLD WATER AT ROOF PENETRATION.
- NO WORK TO THE EXISTING GAS LINE. SHOWN FOR REFERENCE ONLY.
- VFD IS LOCATED IN ROOM MECH RM 514 ON LEVEL 5. REFER TO 2/E2.2 FOR EXACT LOCATION.
- PROVIDE NEW HEAT TRACING ON ALL NEW AND EXISTING PCWS/R. COLD WATER MAKEUP, AND DRAIN PIPING ABOVE THE ROOF.

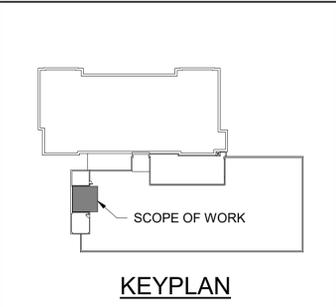
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IMPROVEMENTS COURTHOUSE
COOLING TOWER REPLACEMENT**
1 SOUTH MAIN STREET
NEW CITY, NY 10956

DRAWING TITLE
**MECHANICAL NEW WORK
PLANS**

SCALE	PROJECT NO.
As indicated	NRCK0018
DRAWN BY JC	DRAWING NO.
CHECKED BY RS	M2.1
DATE 2024.04.05	



1 ROOF MECHANICAL NEW WORK PLAN
SCALE: 1/4" = 1'-0"
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COOLING TOWER SCHEDULE	
DESIGNATION	CT-1
LOCATION	ROOF
MANUFACTURER	BAC
MODEL	PT2-1212A-2M1
TYPE	INDUCED DRAFT COUNTERFLOW
OPERATING WEIGHT (LBS)	12,440
NOMINAL SIZE (TONS)	400
DESIGN WET BULB TEMP. (°F)	78
GPM (PER CELL)	1200
WPD (FT H2O)	12.2
EWI / LWT (°F)	85/95
FANS	
NO. OF FANS	1
MOTOR HP (EACH)	20
TOTAL FAN AIRFLOW (CFM)	90,356
STARTER TYPE	VFD
STARTER LOCATION	SEE PLANS
DISCONNECT SWITCH	YES
CONNECTION SIZES:	
INLET (IN.)	8
OUTLET (IN.)	8
COLD WATER MAKE UP (IN.)	1 1/2"
DRAIN (IN.)	2
OVERFLOW (IN.)	3
ELECTRICAL DATA:	
VOLTAGE / PH / FREQ.	460/3/60
NOTES:	
1. PROVIDE UNITARY CONTROLLER BY AUTOMATIC TEMPERATURE CONTROLS MANUFACTURER. ALL CONTROLS SHALL BE TRANE TRACE SUMMIT COMPATIBLE WITH THE EXISTING BUILDING VERSION.	
2. PROVIDE VIBRATION ISOLATION RAIL PACKAGE BY COOLING TOWER MANUFACTURER. TO BE INSTALLED BETWEEN THE TOWER & SUPPORTING STEEL.	
3. PROVIDE WITH LOW SOUND FAN.	
4. TOWER SHALL BE ALL 304 OR 316 STAINLESS STEEL CONSTRUCTION.	
5. ALL MOTOR STARTERS, VARIABLE FREQUENCY DRIVES, AND DISCONNECT SWITCHES SHALL BE FURNISHED BY THE MECHANICAL CONTRACTOR & INSTALLED BY THE ELECTRICAL CONTRACTOR.	
6. ALL MOTORS 1 HP OR GREATER SHALL BE PREMIUM EFFICIENCY.	
7. ALL MOTORS FURNISHED WITH VARIABLE FREQUENCY DRIVES SHALL BE INVERTER DUTY RATED AND APPROVED FOR VARIABLE SPEED AND TORQUE APPLICATIONS.	
8. PROVIDE WITH SERVICE PLATFORM WITH 42" HANDRAILS AROUND TOP OF TOWER, SAFETY GATES AND ACCESS LADDER BY MANUFACTURER. ALL COMPONENTS SHALL BE GALVANIZED STEEL.	
9. PROVIDE WITH ELECTRIC WATER LEVEL CONTROL PACKAGE.	
10. PROVIDE WITH FACTORY-FURNISHED FULL FLOW BYPASS CONNECTION.	
11. PROVIDE 12KW BASIN HEATER FOR EACH CELL WITH CONTROL PANEL, COMBINATION MOTOR STARTER AND DISCONNECT SWITCH. 460/3/60.	
12. PROVIDE MECHANICAL VIBRATION CUTOFF SWITCH WITH SEPARATE 120V ELECTRICAL CONNECTION.	
13. PROVIDE INLET SCREENS AND EXTENDED LUBRICATION LINES.	
14. PROVIDE STEEL BRAIDED FLEXIBLE CONNECTION AT THE TOWER INLET AND OUTLET.	
15. THE MECHANICAL CONTRACTOR SHALL FURNISH A VFD FOR THE COOLING TOWER FAN AS PER THE SPECIFICATIONS. THE VFD SHALL BE INSTALLED BY THE ELECTRICAL CONTRACTOR IN MER 514.	

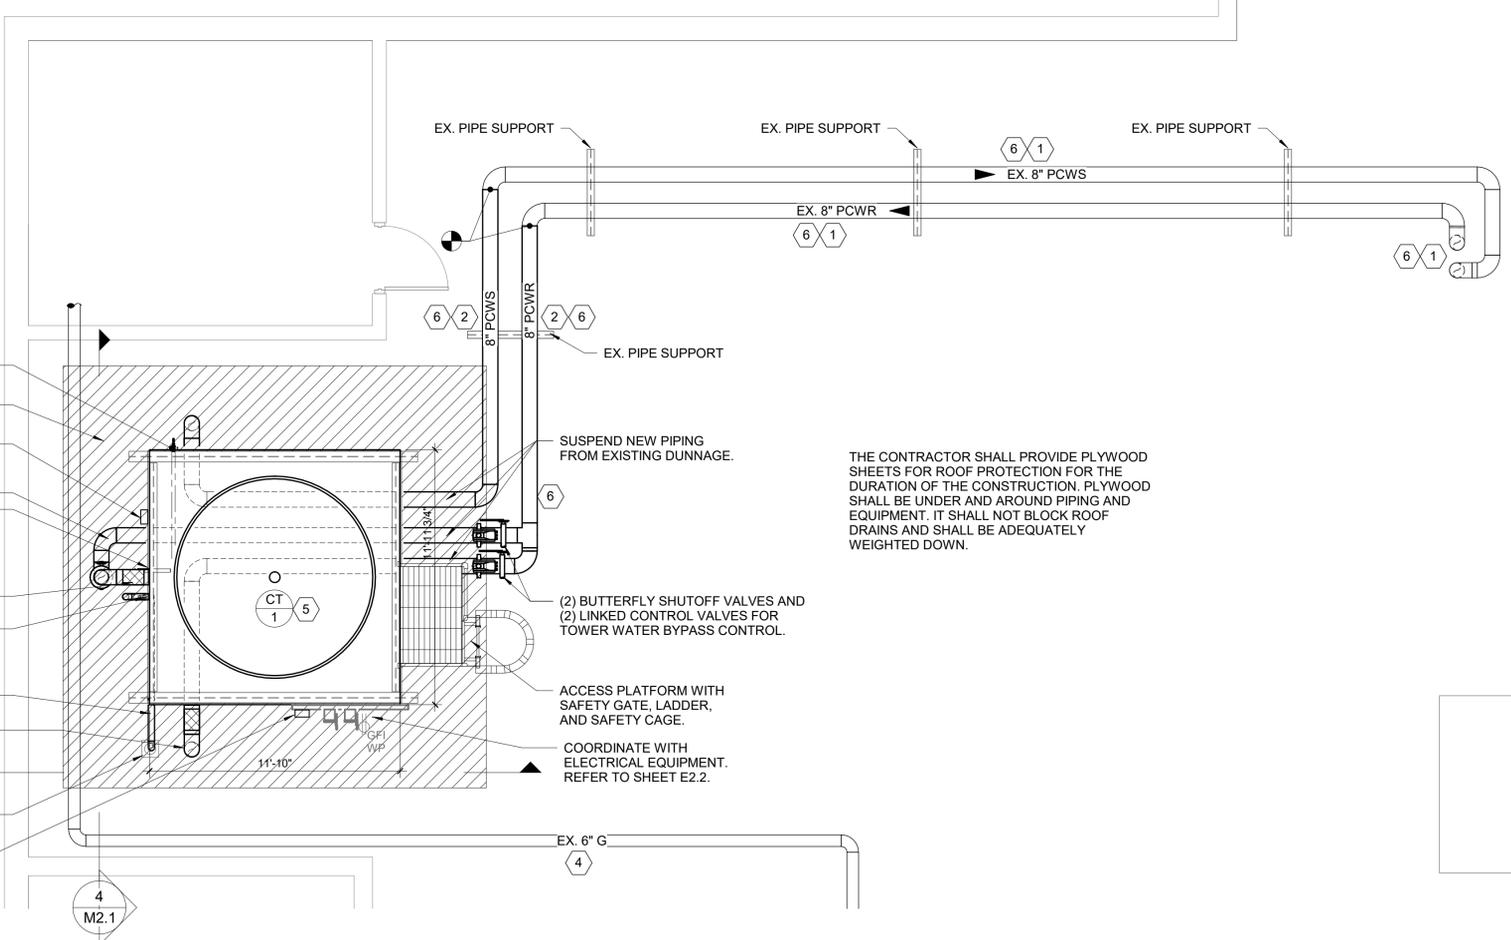SIDE STREAM SEPARATOR SCHEDULE	
DESIGNATION	SS-1
LOCATION	PUMP ROOM (LEVEL 02)
MANUFACTURER	PEP
MODEL	HM-F-24
MAX WORKING PRESSURE...	150
PUMP HORSEPOWER (HP)	2
DIMENSIONS:	
LENGTH (IN.)	36
WIDTH (IN.)	34
HEIGHT (IN.)	55.25
OPERATING WEIGHT (LBS.)	1,076
CONNECTION SIZES:	
INLET (IN.)	1.5
OUTLET (IN.)	1.5
ELECTRICAL DATA:	
VOLTAGE / PH / FREQ.	460/3/60
FLA (A)	2.7
NOTES:	
1. PROVIDE NEMA 4X CONTROL ENCLOSURE WITH DISCONNECT SWITCH.	
2. PROVIDE A 1-1/2" AUTOMATIC BALL VALVE WITH ASSOCIATED WALL MOUNTED CONTROL PANEL. CONTROL PANEL AND VALVE SHALL BE 120V HARDWIRED.	
3. PROVIDE INLET AND OUTLET VALVE KIT.	
4. UNIT SHALL BE MANUFACTURED IN ACCORDANCE WITH ASME CODE.	

EQUIPMENT NOTES	
1.	HEAT TRACING CABLE SHALL BE BASED ON NELSON TYPE CLT SELF-REGULATING HEATERS. HEATER CABLE PERFORMANCE FOR CONDENSER WATER PIPING SHALL BE 9 WATTS PER FOOT AT 120 VOLTS AND 15 AMPS. HEATER CABLE PERFORMANCE FOR MAKEUP COLD WATER AND DRAIN/OVERFLOW SHALL BE 5 WATTS PER FOOT AT 120 VOLTS AND 15 AMPS. SYSTEM SHALL BE COMPLETE WITH COMPATIBLE NELSON POWER CONNECTION KIT AND COMPATIBLE NELSON THERMOSTAT. SYSTEM SHALL BE UL LISTED AND APPROVED.
2.	PIPE INSULATION (EXTERIOR): SHALL BE AEROFLEX AEROCCELL W/EPDM TUBE OR SHEET FOR PIPING WITH PREMOLDED PIPE FITTING INSULATION. INSTALL WITH AEROFLEX EPDM TAPE. PERMEABILITY SHALL BE 0.01 PER INCH. K +/- 0.245.
3.	EXTERIOR PIPE JACKET: SHALL BE POLYGUARD-ALUMNAGUARD ALL WEATHER JACKET. COMPOSITE MEMBRANE CONSISTING OF MULTIPLE UV RESISTANT ALUMINUM FOIL POLYMER LAMINATE.

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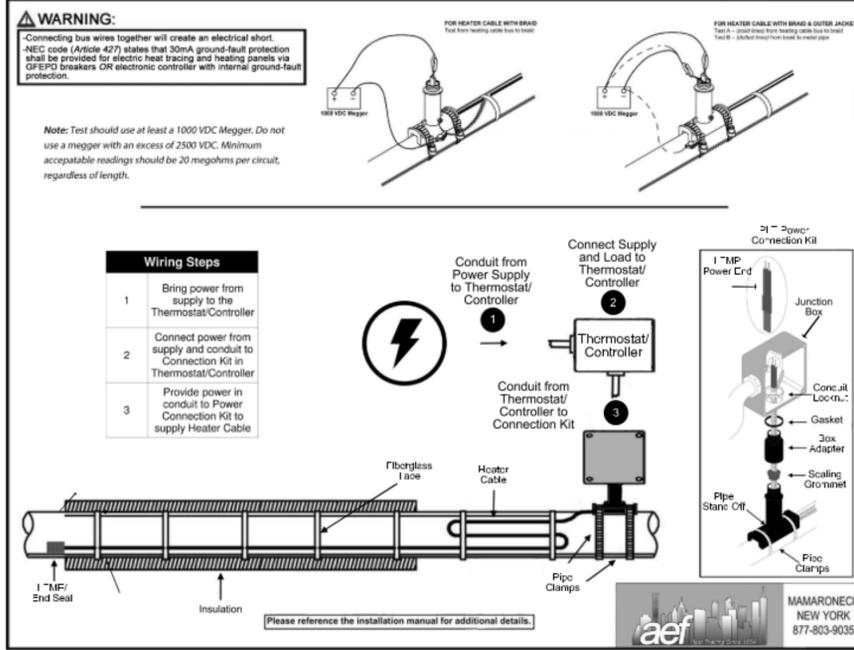
DRAWING TITLE

MECHANICAL SCHEDULES


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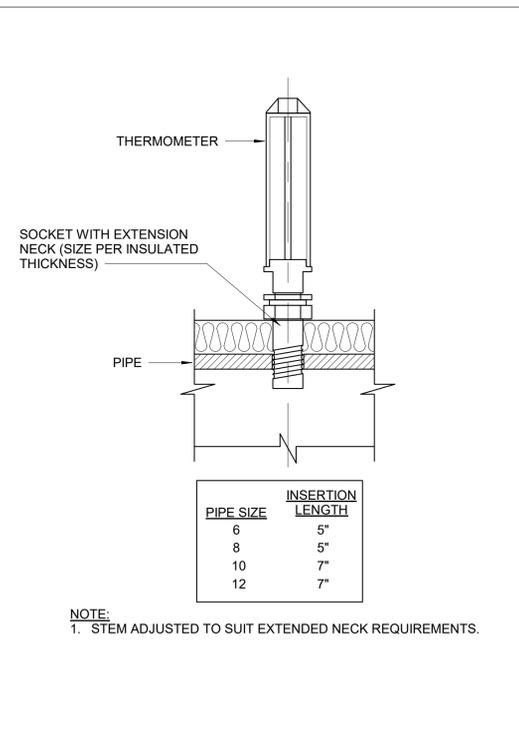
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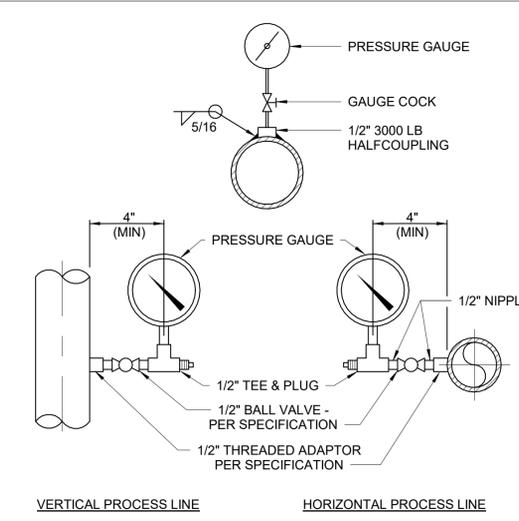
6 HEAT TRACE DETAILS
 SCALE: NONE





4 THERMOMETER INSTALLATION DETAIL
 SCALE: NONE



3 DRAIN VALVE CONNECTION DETAIL
 SCALE: NONE

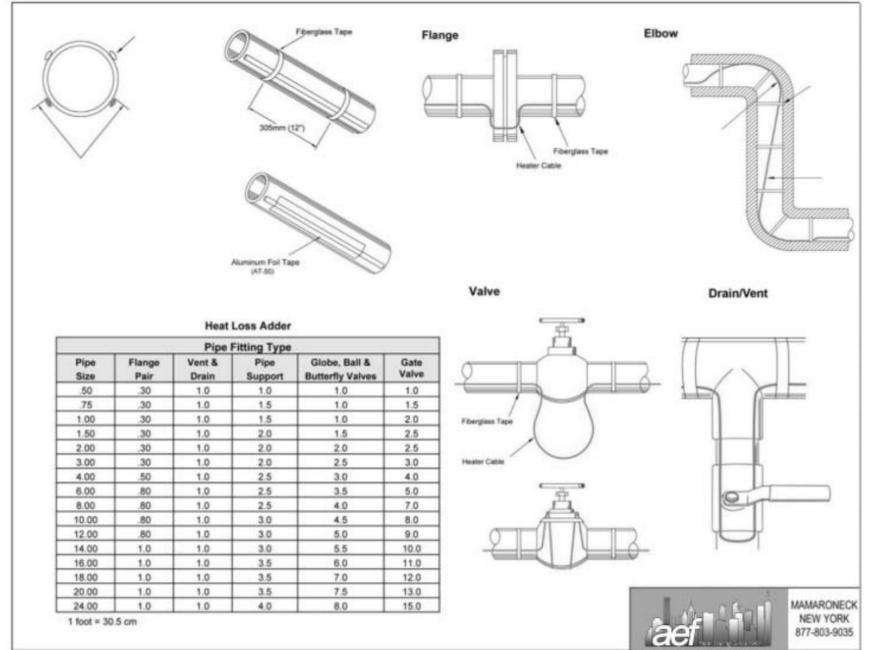

1 COOLING TOWER PIPING DETAIL
 SCALE: NONE

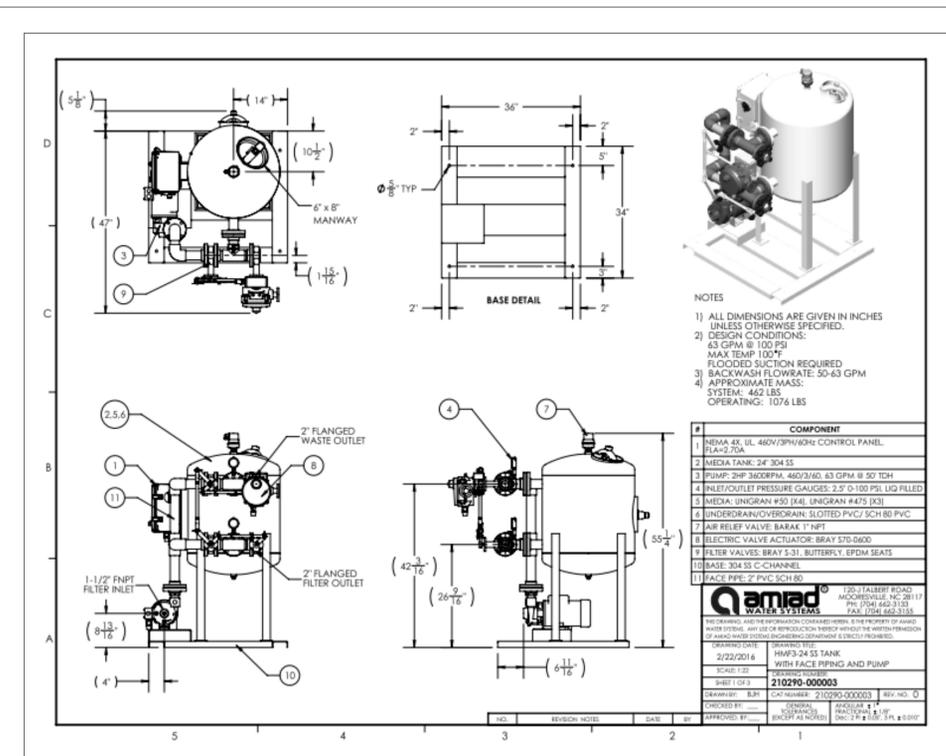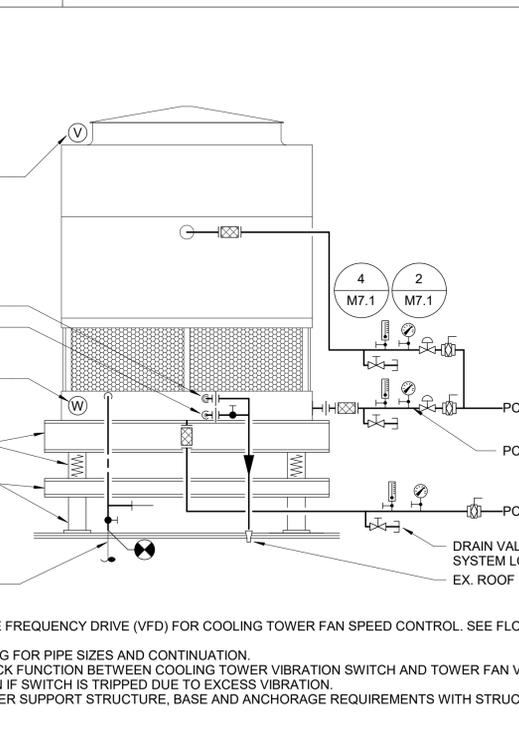

5 SIDE STREAM FILTER DETAIL
 SCALE: NONE

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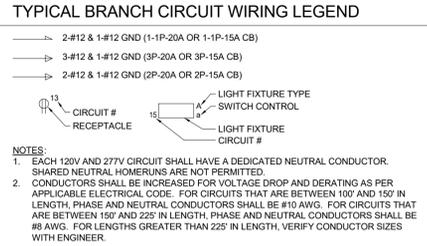
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MECHANICAL DETAILS

SEAL	SCALE 12" = 1'-0"	PROJECT NO. NRCK0018
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SYMBOLS AND ABBREVIATIONS			SYMBOL			ABBREVIATION			DESCRIPTION		
---	-	CONDUIT AND WIRING		A	AMPERE(S)						
---	-	CONDUIT & WIRING TO BE REMOVED UON		AC	AIR CONDITIONER						
UG	-	BURIED CONDUIT		ACC	AIR CONDITIONER CONDENSER						
OH	-	OVERHEAD CONDUCTORS		AFF	ABOVE FINISHED FLOOR						
~	-	HOMERUN TO PANEL, ARROWS INDICATE # 1P		AF	AMPERAGE OF FUSE						
←	-	ABOVE GRADE HOMERUN		AGL	ABOVE GRADE LEVEL						
□	-	ELECTRICAL EQUIPMENT AS INDICATED		AHU	AIR HANDLING UNIT						
□	-	ELECTRICAL EQUIPMENT TO BE REMOVED UON		AL	ALUMINUM						
M	-	ELECTRIC METER		ARC	ARC FAULT INTERRUPTER						
J	-	JUNCTION BOX		AS	AMPERAGE OF SWITCH						
⊠	-	FUSED DISCONNECT SWITCH		AWG	AMERICAN WIRE GAUGE						
⊠	-	UNFUSED DISCONNECT SWITCH		BCW	BARE COPPER WIRE						
⊠	-	COMBINATION MOTOR STARTER/FUSED DISC.		BLDG	BUILDING						
⊠	-	MOTOR STARTER		BMS	BUILDING MANAGEMENT SYSTEM						
○	-	MOTOR		C	CONDUIT						
⊠	-	BATTERY PACK EMERGENCY LIGHT FIXTURE		CP	CONTROL PANEL						
⊠	-	EXIT LIGHT, FACES-SHADED, CHEVRON-ARROW		CKT	CIRCUIT						
S ₁	-	SINGLE POLE SWITCH (X - INDICATES FIXTURE BEING CONTROLLED)		CLG	CEILING						
S ₃	-	THREE WAY SWITCH (X - INDICATES FIXTURE BEING CONTROLLED)		COL	COLUMN						
S ₄	-	FOUR WAY SWITCH (X - INDICATES FIXTURE BEING CONTROLLED)		CU	COPPER						
S ₄	-	FOUR WAY SWITCH (X - INDICATES FIXTURE BEING CONTROLLED)		CUH	CABINET UNIT HEATER						
S ₄	-	FOUR WAY SWITCH (X - INDICATES FIXTURE BEING CONTROLLED)		DEM.	DEMOLISH AND REMOVE						
S ₄	-	FOUR WAY SWITCH (X - INDICATES FIXTURE BEING CONTROLLED)		DISC	DISCONNECT						
S ₄	-	FOUR WAY SWITCH (X - INDICATES FIXTURE BEING CONTROLLED)		DIM	DIMMER						
S ₄	-	FOUR WAY SWITCH (X - INDICATES FIXTURE BEING CONTROLLED)		DWG	DRAWING						
S _M	-	MOTOR RATED TOGGLE SWITCH		EMT	ELECTRICAL METALLIC TUBING						
S _K	-	KEY OPERATED SINGLE POLE SWITCH		EM	EMERGENCY						
S _V	-	SPEED CONTROLLER (FBD)		EX.	EXISTING TO REMAIN						
⊠	-	DUPLEX RECEPTACLE		F	FLOOR						
⊠	-	DOUBLE DUPLEX RECEPTACLE		FBO	FURNISHED BY OTHERS						
⊠	-	SPECIAL RECEPTACLE		FC	FAN COIL UNIT						
MD	-	SECURITY MOTION DETECTOR		GEN	GENERATOR						
KP	-	KEY PAD		GFI	GROUND FAULT INTERRUPTER						
PA	-	PANIC ALARM		HP	HORSEPOWER						
CB	-	CIRCUIT BREAKER		HVAC	HEATING VENTILATION AIR CONDITIONING						
⊠	-	ENCLOSED CIRCUIT BREAKER		IMC	INTERMEDIATE METAL CONDUIT						
⊠	-	FUSED SWITCH		KVA	KILO-VOLT-AMPERE						
⊠	-	GROUND AS PER LOCAL CODE		KW	KILO-WATT						
⊠	-	GROUND BAR		MAX	MAXIMUM						
⊠	-	GROUND ROD		MCB	MAIN CIRCUIT BREAKER						
⊠	-	TRANSFER SWITCH		MIN	MINIMUM						
⊠	-	XFMR		MLO	MAIN LUG ONLY						
⊠	-	CT		NIC	NOT IN CONTRACT						
⊠	-	UTILITY POLE		NL	NIGHT LIGHT						
⊠	-	WM		NTS	NOT TO SCALE						
B	-	BOILER BREAK GLASS STATION		OH	OVERHEAD						
NC	-	NORMALLY CLOSED CONTACTS		P	POLE						
NO	-	NORMALLY OPEN CONTACTS		PBO	PROVIDED BY OTHERS						
CV	-	CONTROL VALVE		PNL	PANEL						
MD	-	MOTORIZED DAMPER		PVC	POLY VINYL CHLORIDE						
SD OR CFS	-	SMOKE DAMPER		REL.	REMOVE AND RELOCATE						
UH	-	UNIT HEATER		REM.	REMOVE AND REINSTALL						
CL	-	CLOCK		RTU	ROOF TOP UNIT						
A	-	AIR TERMINAL		SCH	SCHEDULE						
				SPD	SURGE PROTECTION DEVICE						
				SW	SWITCH(ES)						
				TELCO	TELEPHONE COMPANY						
				TYP	TYPICAL						
				UG	UNDERGROUND						
				UON	UNLESS OTHERWISE NOTED						
				UV	UNIT VENTILATOR						
				VIF	VERIFY IN FIELD						
				V	VOLT(S)						
				VSD	VARIABLE SPEED DRIVE						
				WG	WIRE GUARD						
				WH	WATER HEATER						
				WP	WEATHERPROOF						

NOTES:
1. ALL SYMBOLS AND ABBREVIATIONS MAY NOT BE APPLICABLE FOR THIS PROJECT.
2. SEE LIGHTING FIXTURE SCHEDULE FOR LIGHT FIXTURE SYMBOLS.



DEFINITION OF TERMS

- WHEREVER IN THE CONTRACT DOCUMENTS THE WORD "CLIENT" IS USED, IT MUST BE UNDERSTOOD THAT "ROCKLAND COUNTY" IS INTENDED.
- WHEREVER IN THE CONTRACT DOCUMENTS THE WORD "ENGINEER" IS USED, IT MUST BE UNDERSTOOD THAT "OLA CONSULTING ENGINEERS" IS INTENDED.
- "WORK" MUST BE DEEMED TO CONSIST OF ALL LABOR AND OPERATIONS, TRANSPORTATION, HOISTING, MATERIALS, TOOLS, EQUIPMENT, SERVICES, INSPECTIONS, INVESTIGATIONS, COORDINATION AND SUPERVISION REQUIRED AND / OR REASONABLY NECESSARY TO PRODUCE THE CONSTRUCTION REQUIRED BY THE CONTRACT DOCUMENTS.
- "FURNISH" MEANS THE DESIGN, FABRICATION, PURCHASE AND DELIVERY TO THE JOB SITE.
- "INSTALL OR INSTALLATION" MEANS THE ACT OF PHYSICALLY PLACING, APPLYING, SETTING, ERECTING, ANCHORING, SECURING, ETC., CONSTRUCTION MATERIALS, EQUIPMENT, FURNISHINGS, APPLIANCES, AND SIMILAR ITEMS SPECIFIED AND FURNISHED AT THE JOB SITE. INSTALLATION OF SPECIFIED ITEMS MUST BE COMPLETE IN ALL RESPECTS.
- "PROVIDE" MEANS TO FURNISH AND INSTALL CONSTRUCTION MATERIAL, EQUIPMENT, ETC. AS DEFINED ABOVE.
- THE FOLLOWING ARE DEFINITIONS OF SHOP DRAWING STAMP ACTIONS:
- "NO EXCEPTIONS TAKEN" MEANS THAT THE SHOP DRAWING IS CORRECT AS TO PERFORMANCE, CAPACITY, ETC. AND SUBSTANTIAL CONFORMANCE TO THE CONTRACT DRAWINGS AND SPECIFICATIONS. FABRICATION AND/OR PURCHASE MAY COMMENCE.
- "MAKE CORRECTIONS NOTED" MEANS THAT THE SHOP DRAWING IS CORRECT AS TO PERFORMANCE, CAPACITY, ETC. AND SUBSTANTIAL CONFORMANCE TO THE CONTRACT DRAWINGS AND SPECIFICATIONS, SUBJECT TO AND IN COMPLIANCE WITH THE ANNOTATIONS AND/OR CORRECTIONS INDICATED ON THE SHOP DRAWING. FABRICATION AND/OR PURCHASE MAY COMMENCE.
- "AMEND AND RESUBMIT" MEANS THAT THE COMMENTS AND/OR CORRECTION ARE SO EXTENSIVE AND IMPORTANT THAT THE REVIEWER WANTS TO SEE HOW THE COMMENTS AND/OR CORRECTIONS ARE RESOLVED PRIOR TO RELEASE FOR FABRICATION AND/OR PURCHASE. FABRICATIONS AND/OR PURCHASE MAY NOT COMMENCE.
- "REJECTED" MEANS THAT THE SHOP DRAWING DOES NOT COMPLY OR CONFORM TO THE CONTRACT DRAWINGS AND/OR SPECIFICATIONS. FABRICATION AND/OR PURCHASE MAY NOT COMMENCE.

GENERAL NOTES

- ALL WORK SHOWN IS NEW UNLESS OTHERWISE NOTED (UON) EXISTING TO REMAIN (EX).
- THE DRAWINGS ARE TO BE CONSIDERED SCHEMATIC ONLY AND DO NOT NECESSARILY SHOW THE EXACT LOCATIONS AND DETAILS OF THE WORK TO BE INSTALLED.
- CONTRACTOR TO FIELD VERIFY ALL EXISTING CONDITIONS PRIOR TO BEGINNING OF WORK AND COORDINATE NEW WORK.
- THE ELECTRICAL CONTRACTOR SHALL BE RESPONSIBLE FOR OBTAINING ALL NECESSARY PERMITS AND PAYING ALL FEES ASSOCIATED WITH THIS WORK INCLUDING FILING WITH THE UTILITY COMPANY (AS REQUIRED), AND WITH LOCAL AUTHORITY HAVING JURISDICTION.
- ELECTRICAL CONTRACTOR SHALL BE RESPONSIBLE TO HIRE A THIRD PARTY ELECTRICAL INSPECTION AGENCY TO PROVIDE UL INSPECTIONS AND SUBMIT A CERTIFICATE OF INSPECTION PRIOR TO FINAL REQUEST FOR PAYMENT.
- ALL CONDUCTORS SHALL BE COPPER UON "ON DRAWINGS".
- ELECTRONIC FILES OF THE MECHANICAL, ELECTRICAL, PLUMBING AND FIRE PROTECTION DRAWINGS ARE AVAILABLE TO THE CONTRACTOR. THE ENGINEER MAY GRANT THE CONTRACTOR A LIMITED LICENSE TO MAKE A DERIVATIVE WORK OF THE DATABASE FOR THE PURPOSE OF SHOP DRAWINGS, SUBMITTALS AND AS-BUILT DRAWINGS. UPON REQUEST, THE ENGINEER SHALL PROVIDE A RELEASE FORM THAT MUST BE SIGNED AND RETURNED BY THE CONTRACTOR PRIOR TO RELEASE OF THE ELECTRONIC FILES.
- CIRCUIT NUMBERS ARE FOR INFORMATION PURPOSES ONLY. ACTUAL CIRCUIT NUMBERS SHALL BE DETERMINED IN THE FIELD.
- UNLESS OTHERWISE NOTED, DISCONNECT SWITCHES, STARTERS, HOAS AND MOTOR RATED TOGGLE SWITCHES FOR MECHANICAL PUMPS, CABINET AND UNIT HEATERS, RETURN FANS, ROOF FANS, VAV BOXES, COMPRESSORS, FAN COIL UNITS, AIR HANDLERS AND CONDENSERS SHALL BE FURNISHED BY THE MECHANICAL CONTRACTOR AND INSTALLED BY THE ELECTRICAL CONTRACTOR. COORDINATE ALL WORK WITH THE MECHANICAL CONTRACTOR.
- CORE DRILLING OR TRENCHING THROUGH AN EXISTING FLOOR SLAB, WHEN REQUIRED, SHALL BE COORDINATED WITH THE OWNER. FLOOR SLABS SHALL BE RADAR SCANNED PRIOR TO CORE DRILLING OR TRENCHING. ALL WORK, INCLUDING CORE DRILLING, RADAR SCAN, INSTALLATION OF FIRE STOPPING, & CONDUIT/CABLE INSTALLATION SHALL BE PERFORMED DURING NON-BUSINESS HOURS AND INCLUDED IN BASE BID. USE EXTREME CAUTION DURING ANY CUTTING OPERATION TO AVOID DAMAGE TO EXISTING EQUIPMENT/SYSTEMS. ANY ITEMS DAMAGED AS A RESULT OF CORE DRILLING SHALL BE REPAIRED AT NO COST TO THE CLIENT. ALL CORES SHALL BE FIRE SEALED.
- WHERE GFI RECEPTACLES ARE CIRCUITED WITH GENERAL CONVENIENCE RECEPTACLES, THE GFI RECEPTACLE SHALL BE THE LAST DEVICE ON THE CIRCUIT.
- INSTALL CONDUIT EXPANSION FITTINGS AT ALL LOCATIONS WHERE CONDUITS CROSS BUILDING OR STRUCTURE EXPANSION JOINTS.
- THE ELECTRICAL CONTRACTOR SHALL PROVIDE ALL CUTTING, PATCHING, PAINTING, AND FINAL RESTORATION REQUIRED TO FACILITATE THE DEMOLITION AND INSTALLATION OF ALL ELECTRICAL EQUIPMENT, INCLUDING BUT NOT LIMITED TO PANELBOARDS, CONDUITS, WIRING, DEVICES, FIXTURES, ETC. INCLUDING ABOVE CEILINGS; CONTRACTOR TO REMOVE AND REPLACE CEILINGS AND OPEN AND PATCH WALLS, AS REQUIRED TO EXECUTE THE ELECTRICAL WORK.
- ALL CONDUITS SHALL BE RECESSED IN NEW WALLS. SURFACE MOUNTED CONDUITS WILL ONLY BE ACCEPTED IN EXISTING AREAS WHERE ABSOLUTELY NECESSARY.
- THE ELECTRICAL CONTRACTOR SHALL BE RESPONSIBLE FOR PROTECTING EXISTING CEILINGS IN AREAS OF WORK WHERE THE CEILINGS ARE DUE TO REMAIN. THE ELECTRICAL CONTRACTOR SHALL BE RESPONSIBLE FOR REPAIRING ANY DAMAGE TO EXISTING TO REMAIN CEILINGS OR CEILING TILES CAUSE BY THE ELECTRICAL SCOPE OF WORK.
- EACH DUPLEX AND QUAD RECEPTACLE SHALL BE LABELED WITH THE CIRCUIT NUMBER WHICH IT SERVES. ALPHANUMERICS TO BE 1/8" HIGH AND BLACK ON CLEAR BACKGROUND. LABELS SHALL BE SELF ADHESIVE. IDENTIFY ASSOCIATED PANEL AND CIRCUIT NUMBER.
- ALL CONDUCTORS INSTALLED BETWEEN VFDS AND ASSOCIATED MOTORS SHALL BE XHHW-2, 1000V IN RGS, IMC, EMT FMC OR LFMC.

DEMOLITION NOTES

- ALL EQUIPMENT SHALL BE DISCONNECTED AND REMOVED BACK TO POWER SOURCE ORIGINATION UNLESS OTHERWISE NOTED (UON) EXISTING TO REMAIN (EX).
- CONTRACTOR SHALL VERIFY EXTENT OF DEMOLITION WORK IN THE FIELD PRIOR TO BID AND SHALL INCLUDE ALL LABOR AND MATERIALS IN BASE BID INCLUDING ALL TEMPORARY CONNECTIONS, CONDUIT AND WIRE IN ORDER TO ACCOMMODATE CONSTRUCTION AND PROVIDE CONTINUOUS SERVICE TO DEVICES AND SYSTEMS TO REMAIN, TEMPORARY AND PERMANENTLY. WORK INCLUDING THE SHUT-DOWN OF THE BUILDING POWER SHALL BE PERFORMED DURING OVERTIME AND SHALL BE INCLUDED IN BASE BID.
- CIRCUIT BREAKER, DISCONNECT SWITCHES, FUSES, CONDUIT AND CONDUCTOR SIZES INDICATED SHALL BE FIELD VERIFIED PRIOR TO BID.
- ALL EXISTING ELECTRICAL EQUIPMENT NO LONGER IN USE, SUCH AS DISCONNECT SWITCHES, MOTOR CONTROLLERS, MOTOR STARTER PANELS, ETC. SHALL BE REMOVED UON.
- ALL DISCONNECTED & REMOVED EXISTING ELECTRICAL ITEMS THAT ARE NOT BEING REUSED SHALL BE RETURNED TO THE OWNER OR DISPOSED OF AS DIRECTED.
- THE CONTRACTOR SHALL INCLUDE IN THE BASE BID ALL MATERIAL & LABOR REQUIRED FOR THE EXTENSIONS, REROUTING & RELOCATION OF EXISTING SYSTEM COMPONENTS, EQUIPMENT, WIRING, CONDUITS & CABLING AS TO MAINTAIN OPERATION OF ALL SYSTEMS THROUGHOUT THE BUILDING DURING DEMOLITION & CONSTRUCTION PHASES.

LIGHTNING PROTECTION SYSTEM NOTES:

- THE FOLLOWING IS A PERFORMANCE SPECIFICATION OF THE LIGHTNING PROTECTION SYSTEM. CONTRACTOR SHALL BE RESPONSIBLE TO HIRE AN ORGANIZATION THAT IS UL APPROVED (MASTER LABEL) TO MODIFY SUCH SYSTEMS DESIGN AS TO BE FORWARDED TO THE ENGINEER AS A SHOP DRAWING FOR APPROVAL PRIOR TO CONSTRUCTION.
- A SYSTEM OF LIGHTNING PROTECTION SHALL BE PROVIDED AND INSTALLED IN COMPLIANCE WITH THE PROVISIONS OF THE LATEST "CODE OF PROTECTION AGAINST LIGHTNING" FOR BUILDINGS AS ADOPTED BY THE NATIONAL FIRE PROTECTION ASSOCIATION AND THE UNDERWRITERS' LABORATORIES, INC. FOR A MASTER LABEL SYSTEM.
- IF ANY DEPARTURES FROM THE CONTRACTOR DOCUMENTS ARE DEEMED NECESSARY BY THE CONTRACTOR, DETAILS OF SUCH DEPARTURES AND THE REASONS THEREFOR SHALL BE SUBMITTED AS SOON AS PRACTICABLE TO THE ENGINEER FOR APPROVAL. NO SUCH DEPARTURES SHALL BE MADE WITHOUT THE PRIOR WRITTEN APPROVAL OF THE OWNER AND THE ARCHITECT. ALSO, THE LIGHTNING PROTECTION SYSTEM SHALL BE INSTALLED BY A LIGHTNING PROTECTION CONTRACTOR WHO SPECIALIZES IN THIS FIELD.
- MATERIALS THE LIGHTNING PROTECTION EQUIPMENT SPECIFICATION SHALL BE BASED ON EQUIPMENT MANUFACTURED BY HEAVY BROS. LIGHTNING PROTECTION CO., INC. OF MOORE ROAD, SPRINGVILLE, NEW YORK 14141, OR EQUIVALENT. ALL MATERIALS SHALL COMPLY IN WEIGHT, SIZE, AND COMPOSITION WITH THE REQUIREMENTS OF THE UNDERWRITERS' LABORATORIES, INC. AND THE NATIONAL FIRE PROTECTION ASSOCIATION CODE RELATING TO THIS TYPE OF STRUCTURE.
- AIR TERMINALS AIR TERMINALS SHALL BE 1/2" X 1/2" SOLID ALUMINUM AND SHALL EXTEND AT LEAST 18" ABOVE THE OBJECT TO BE PROTECTED. ALL AIR TERMINAL BASES SHALL BE CAST ALUMINUM WITH STAINLESS STEEL BOLT/PRESSURE CABLE CONNECTORS. THE AIR TERMINALS SHOULD BE SPACED SO AS NOT TO EXCEED 30 FEET APART AROUND THE OUTSIDE PERIMETER OF THE ROOF OR THE RIDGE AND NOT OVER 50 FEET APART THROUGH THE CENTER OF FLAT ROOF AREAS. THE AIR TERMINALS IN THE CENTER ROOF AREA SHALL BE 1/2" X 24" SOLID ALUMINUM WITH A PROPER BRACE. ALL AIR TERMINAL BASES FOR FLAT ROOF AREAS SHALL BE OF THE ADHESIVE TYPE.
- CONDUCTORS CONDUCTORS SHALL CONSIST OF U.L. LISTED 28 STRANDS OF 14 GAUGE ALUMINUM WIRE WEIGHING 114 LBS. PER 1000 FEET AND INSTALLED IN ACCORDANCE WITH THE U.L. CODE. A PERIMETER CABLE SHALL BE INSTALLED AROUND THE ENTIRE MAIN ROOF AND ALL HEAT REJECTION EQUIPMENT. EACH PERIMETER CABLE SHALL BE CONNECTED TO DOWN LEAD, PROVIDING A TWO-WAY PATH FROM GROUND TO EACH AIR TERMINAL. ALL CENTER ROOF AIR TERMINALS SHALL BE INTERCONNECTED WITH CONDUCTORS TO THE OUTSIDE PERIMETER CABLE. CONDUCTORS ON THE FLAT ROOF AREAS MAY BE RUN EXPOSED. GROUND CONNECTION SHALL BE MADE AROUND THE PERIMETER OF EACH ROOF AND TO THE MAIN DOWN CONDUCTOR AT THE MAXIMUM OF 100'-0" ON CENTERS.
- CONCEALED CONDUCTORS ALL CONCEALED CONDUCTORS SHALL BE INSTALLED IN SCHEDULE 40, 1" PVC CONDUIT. CONDUIT TO BE FURNISHED AND INSTALLED BY THE ELECTRICAL CONTRACTOR. ALL DOWN CONDUCTORS SHALL RUN INSIDE WALLS OF THE BUILDING THROUGH THE 1" PVC CONDUIT.
- FASTENERS CONDUCTOR FASTENERS SHALL BE AN APPROVED TYPE NON-CORROSSIVE METAL, HAVE AMPLE STRENGTH TO SUPPORT CONDUCTORS, AND SHALL BE SPACED NOT TO EXCEED 3'-0" CENTERS. MASONRY TYPE CABLE FASTENERS SPACED EVERY 3'-0" ON MASONRY.
- ROOF PENETRATION WHEREVER THE CONDUITS PENETRATES THE ROOF, COPPER PITCH PANIS SHALL BE FURNISHED BY THE LIGHTNING PROTECTION CONTRACTOR AND INSTALLED BY THE ROOFING CONTRACTOR. WOOD NAILING BLOCKS SHALL BE FURNISHED AND INSTALLED BY THE ROOFING CONTRACTOR. ALL PATCHING AND MASONRY WORK SHALL BE FURNISHED AND INSTALLED BY THE ROOFING CONTRACTOR.
- DOWN CONDUCTORS BUILDINGS THAT ARE OF REINFORCED CONCRETE OR WALL BEARING STRUCTURES, THE CONCEALED DOWN CONDUCTORS SHALL BE INSTALLED IN SCHEDULE 40, 1" P.V.C. CONDUIT. EACH PERIMETER ROOF CABLE SHALL BE CONNECTED AT LEAST TWO (2) DOWN LEADS. THE AVERAGE DISTANCE BETWEEN DOWN LEADS SHALL NOT EXCEED 90 FEET. IRREGULARLY SHAPED STRUCTURES MAY REQUIRE EXTRA DOWN CONDUCTORS TO PROVIDE A TWO-WAY PATH TO GROUND FROM EACH AIR TERMINAL.
- CABLE CONNECTORS ALL CABLE CONNECTORS SHALL BE CAST ALUMINUM WITH SCREW-PRESSURE TYPE STAINLESS STEEL BOLTS AND NUTS.
- INTERCONNECTION OF METALS ALL METAL BODIES WITHIN 6 FEET OF THE CONDUCTOR SHALL BE BONDED TO THE SYSTEM WITH APPROVED FITTINGS AND CONDUCTOR. CONNECTIONS BETWEEN DISSIMILAR METALS SHALL BE MADE WITH APPROVED BIMETALLIC CONNECTIONS.
- BONDING OF ALL METALLIC OBJECTS AND SYSTEMS AT ROOF LEVELS AND ELSEWHERE ON THE STRUCTURE SHALL BE COMPLETE. PRIMARY BONDS FOR METAL BODIES OF CONDUCTANCE SHALL BE BONDED WITH APPROPRIATE FITTINGS AND FULL-SIZE CONDUCTOR, AND SHALL CONSIST OF, BUT NOT BE LIMITED TO, THE FOLLOWING: ROOF EXHAUST FANS, HVAC UNITS WITH RELATED PIPING DUCTWORK, EXHAUST VENTS AND ANY OTHER ROOF PIPING SYSTEMS, COOLING TOWERS, AND RAIL SYSTEMS, WINDOW WASHING TRACKS, ANTENNA MAST FOR TV, RADIO OR MICROWAVE FLAG POLES, ROOF HANDRAILS AND/OR DECORATIVE SCREENS, ROOF LADDERS, SKYLIGHTS, METAL PLUMBING STACKS, ETC. EXTERIOR ARCHITECTURAL METAL FASCIA AND/OR CURTAIN WALLS OR MULLIONS WHICH EXTEND THE FULL HEIGHT OF THE STRUCTURE SHALL ALSO BE BONDED, IF NOT INHERENTLY BONDED THRU THE BUILDING FRAME.
- METAL BODIES OF INDUCTANCE LOCATED WITHIN 6 FEET OF A CONDUCTOR OR OBJECT WITH SECONDARY BONDS SHALL BE BONDED WITH SECONDARY CABLE AND FITTINGS. TYPICAL OF THESE ARE: ROOF FLASHINGS, PARAPET COPING CAPS, GRAVEL GUARDS, ISOLATED METAL BUILDING PANELS OR SIDING, ROOF DRAINS, DOWN SPOUTS, ROOF ISULATION VENTS, AND ANY OTHER SIZEABLE MISCELLANEOUS METALS, ETC.
- GROUNDING GROUNDING TERMINATIONS SHALL BE MADE TO THE #40 AWG COPPER GROUND RING LOCATED AT THE BASE OF THE STRUCTURE. GROUND CONNECTIONS SHALL BE MADE AROUND THE PERIMETER OF THE STRUCTURE, AND IN NO CASE SHALL AVERAGE OVER 100'-0" APART. GROUND TERMINALS SHALL BE #4" IN DIAMETER AND SHALL BE DRIVEN TO A MINIMUM DEPTH OF 10 FEET AND MORE, IF NECESSARY, TO REACH PERMANENT MOISTURE. ONE GROUND SHALL HAVE CONNECTION TO THE WATER SYSTEM WHERE THE WATER SUPPLY ENTERS THE BUILDING - IN ADDITION TO ARTIFICIAL GROUND. IN CASE OF ROCK LEDGE OR OTHER CONDITIONS MAKING IT IMPOSSIBLE TO COMPLY WITH THE ABOVE, TRENCHING OR A COPPER GROUND PLATE WILL PERMITTED; PROVIDING IT WILL MEET THE UNDERWRITERS' LABORATORIES, INC. REQUIREMENTS.
- COMMON GROUNDING COMMON GROUNDINGS BETWEEN THE LIGHTNING PROTECTION SYSTEM AND THE ELECTRIC SERVICE ENTRANCE WIRES BE MADE BY THE ELECTRICAL CONTRACTOR, AS SHOWN IN THE DRAWINGS AND PER THE SPECIFICATIONS.
- UNDERWRITERS' LABORATORIES, INC. MASTER LABEL SHALL BE FURNISHED AS EVIDENCE THAT THE INSTALLATION HAS MET WITH U.L. #6A CODE REQUIREMENTS. SHOP DRAWINGS IN DETAIL AND CATALOG CUTS SHALL BE SUBMITTED FOR APPROVAL BY THE ARCHITECT AND ENGINEER PRIOR TO INSTALLATION OF THE SYSTEM.
- THE LIGHTNING PROTECTION CONTRACTOR SHALL FURNISH OWNER AND ENGINEER WITH SYSTEM SHOP DRAWINGS FOR REVIEW. INCLUDE LAYOUT AND ALL COMPONENTS.
- THE ELECTRICAL CONTRACTOR SHALL INSTALL THE LIGHTNING PROTECTION SYSTEM PER THE LIGHTNING PROTECTION CONTRACTOR'S SHOP DRAWINGS, (APPROVED SET).

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Rockland County
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Director Facilities Management
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New City, NY 10956

NO.	DESCRIPTION	DATE
2	ISSUED FOR PERM	09.09.2024
1	ISSUE FOR BID	04.05.2024

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PROJECT


**CAPITAL PROJECT 1519
GOVERNMENT CENTER BUILDING
IMPROVEMENTS COURTHOUSE
COOLING TOWER REPLACEMENT**

1 SOUTH MAIN STREET
NEW CITY, NY 10956

DRAWING TITLE


**ELECTRICAL
ABBREVIATIONS, SYMBOLS
AND NOTES**

SCALE 1" = 1'-0"	PROJECT NO. NRCK0018
DRAWN BY GD	DRAWING NO.
CHECKED BY JF	E0.1
DATE 2024.04.05	

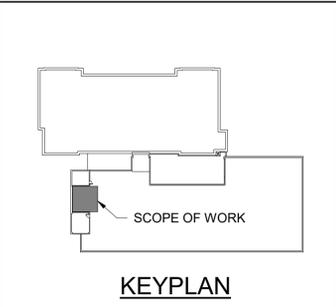


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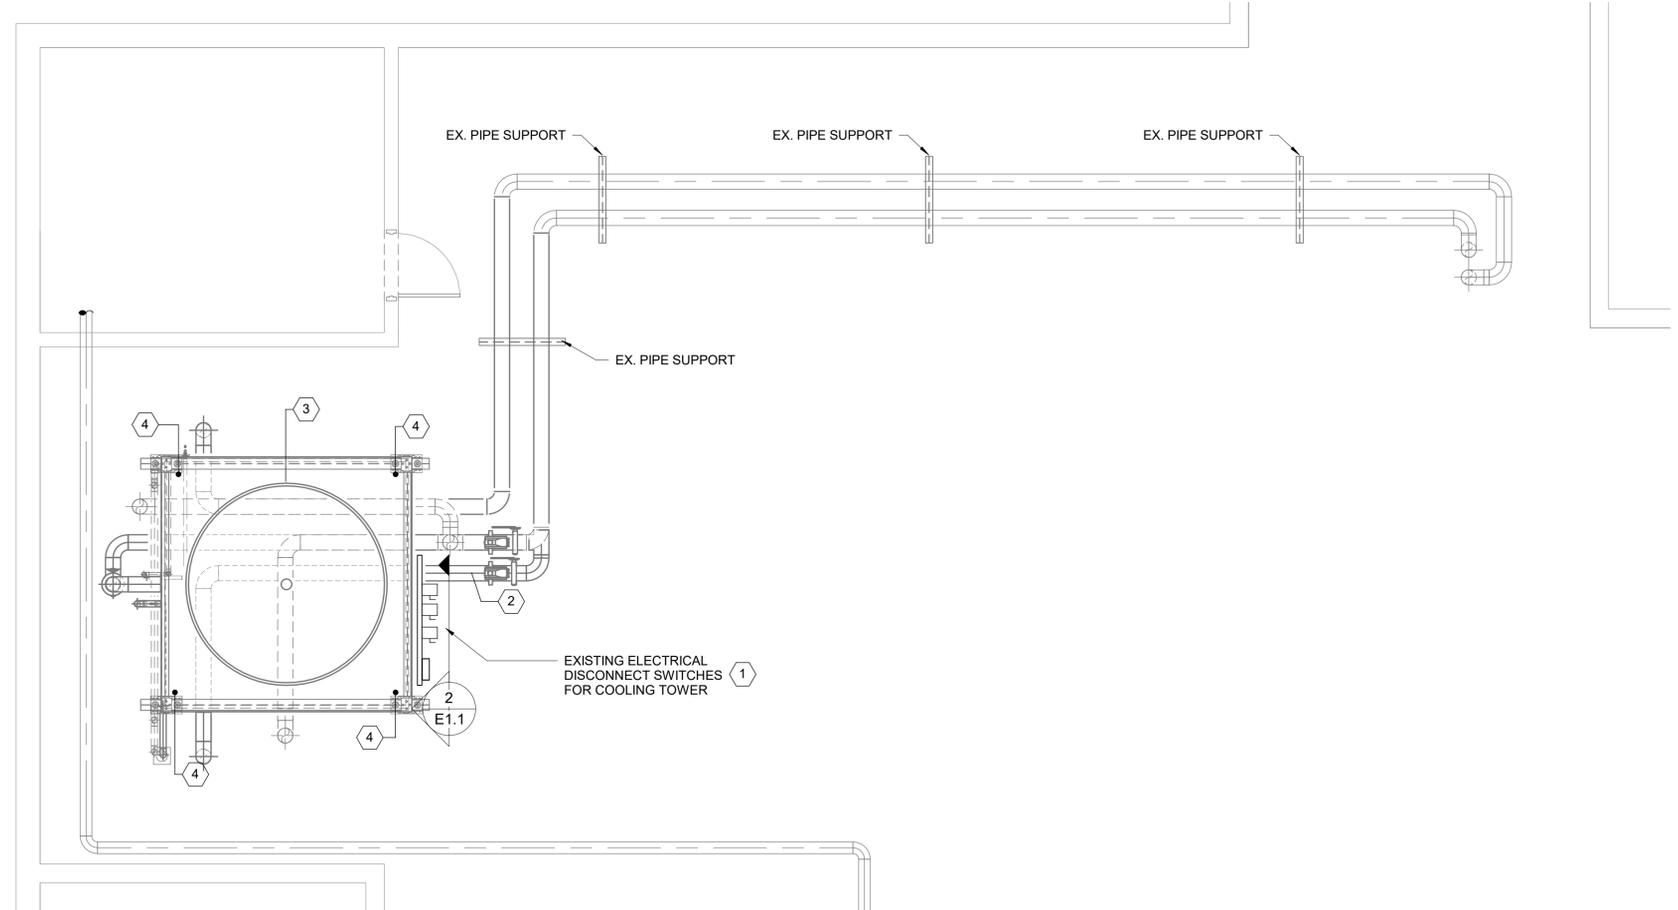
1. CONDITIONS MAY NOT BE EXACTLY AS INDICATED ON THIS DRAWING. ELECTRICAL CONTRACTOR SHALL VISIT THE SITE TO UNDERSTAND THE EXISTING FIELD CONDITIONS AND TO VERIFY SCOPE OF WORK PRIOR TO SUBMITTING BID. NO ALLOWANCE WILL BE MADE AFTER CONTRACT IS APPROVED.
2. ALL ABANDONED AND UNUSED EQUIPMENT, INCLUDING, BUT NOT LIMITED TO PIPING, DUCTWORK, AND TERMINAL UNITS SHALL BE REMOVED.
3. COORDINATE ALL SHUTDOWNS WITH BUILDING FACILITIES, OWNER, AND TENANTS.

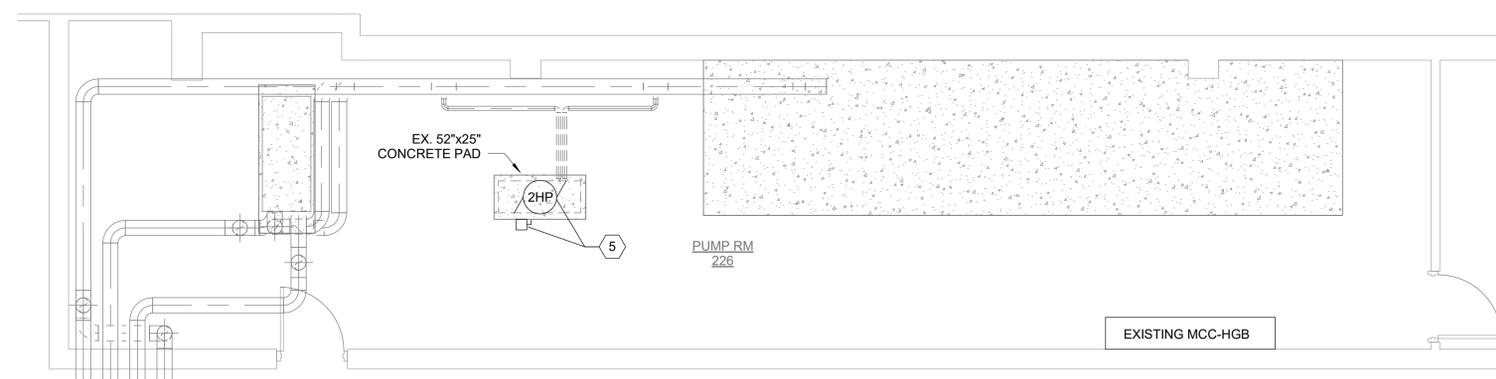

3 LEVEL 02 ELECTRICAL DEMOLITION PLAN
 SCALE: 1/4" = 1'-0"
 NORTH

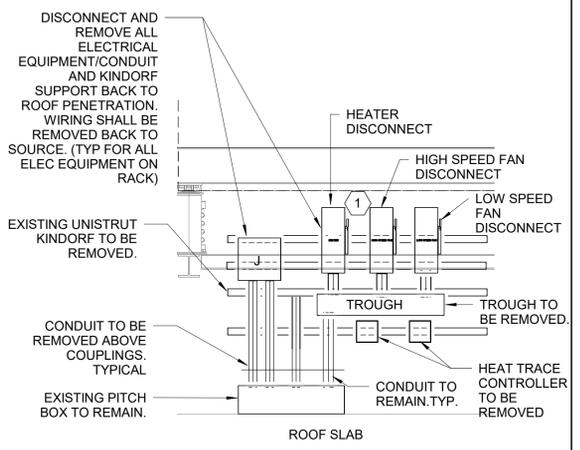

2 Section 2
 SCALE: NONE



1 ROOF ELECTRICAL DEMOLITION PLAN
 SCALE: 1/4" = 1'-0"
 NORTH

KEYNOTES

- 1 DISCONNECT AND REMOVE ALL DISCONNECT SWITCHES ON KINDORF UNISTRUT RACK. ALL ASSOCIATED WIRING SHALL BE DISCONNECTED AND REMOVED BACK TO SOURCE. EXISTING EXPOSED CONDUIT TO BE REMOVED TO COUPLINGS ABOVE PITCH BOX ON ROOF. KINDORF UNISTRUT TO BE REMOVED.
- 2 DISCONNECT AND REMOVE ALL WIRING AND CONDUIT BACK TO SOURCE ASSOCIATED WITH HEAT TRACE
- 3 DISCONNECT AND REMOVE ALL WIRING AND CONDUIT ASSOCIATED TO COOLING TOWER BACK TO SOURCE.
- 4 DISCONNECT AND REMOVE ALL ASSOCIATED LIGHTNING PROTECTION AND GROUND WIRING ON EXISTING COOLING TOWER TO BE DEMOLISHED.
- 5 DISCONNECT WATER FILTER SYSTEM PUMP WSF-1. REMOVE LOCAL DISCONNECT AND WIRING BACK TO SOURCE. CONDUIT TO REMAIN.


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1	ISSUE FOR PERMIT	04.05.2024

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PROJECT
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DRAWING TITLE
**ELECTRICAL DEMOLITION
 PLANS**

SCALE	PROJECT NO.
As indicated	NRCK0018
DRAWN BY GD	DRAWING NO.
CHECKED BY JF	E1.1
DATE 2024.04.05	



NO.	DESCRIPTION	DATE
2	ISSUED FOR BID	09.09.2024
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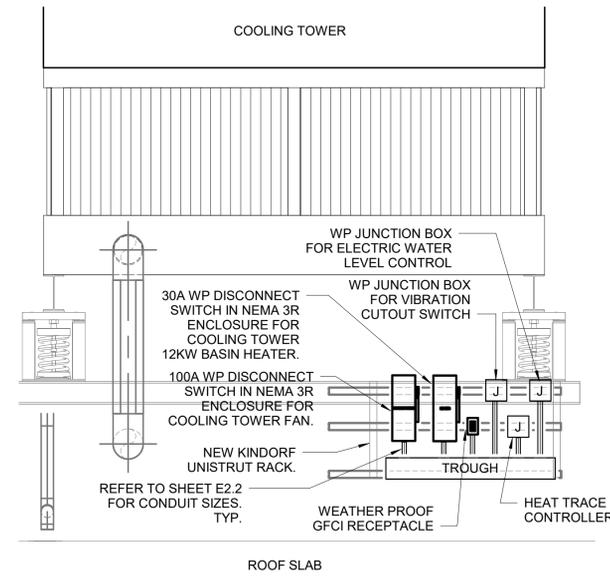
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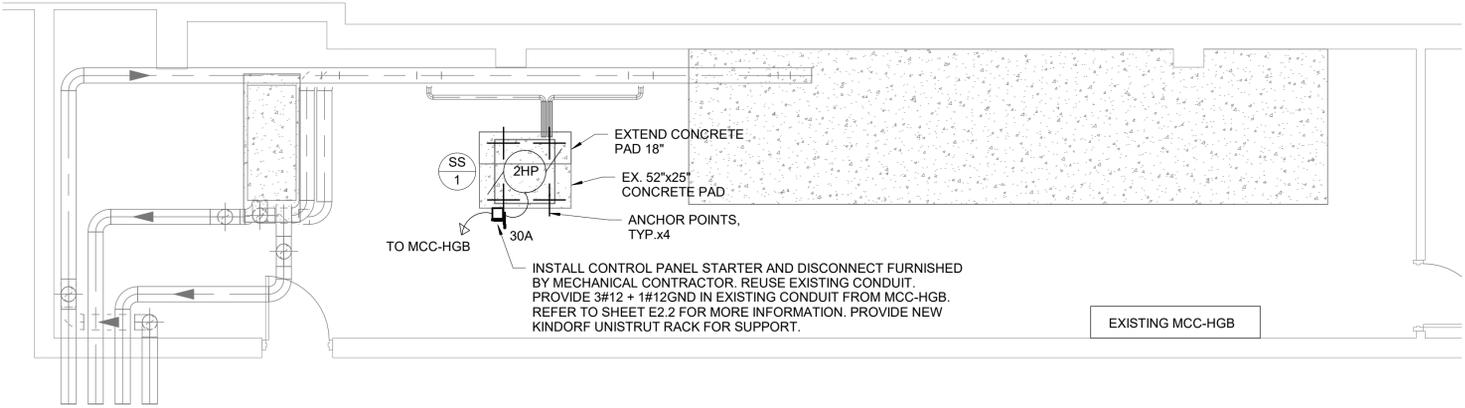
DRAWING TITLE
**ELECTRICAL NEW WORK
 PLANS**

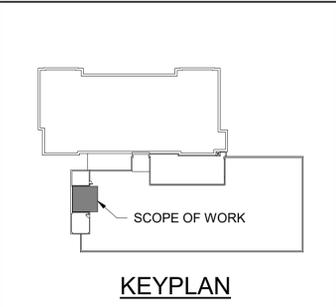SCALE	PROJECT NO.
As indicated	NRCK0018
DRAWN BY GD	DRAWING NO.
CHECKED BY JF	E2.1
DATE 2024.04.05	


- NOTES**
- CONDITIONS MAY NOT BE EXACTLY AS INDICATED ON THIS DRAWING. ELECTRICAL CONTRACTOR SHALL VISIT THE SITE TO UNDERSTAND THE EXISTING FIELD CONDITIONS AND TO VERIFY SCOPE OF WORK PRIOR TO SUBMITTING BID. NO ALLOWANCE WILL BE MADE AFTER CONTRACT IS APPROVED.
 - ALL ABANDONED AND UNUSED EQUIPMENT, INCLUDING, BUT NOT LIMITED TO PIPING, DUCTWORK, AND TERMINAL UNITS SHALL BE REMOVED.
 - COORDINATE ALL SHUTDOWNS WITH BUILDING FACILITIES, OWNER, AND TENANTS.





2 ELECTRICAL NEW WORK
 SCALE: 1/2" = 1'-0"




3 LEVEL 02 ELECTRICAL NEW WORK PLAN
 SCALE: 1/4" = 1'-0"

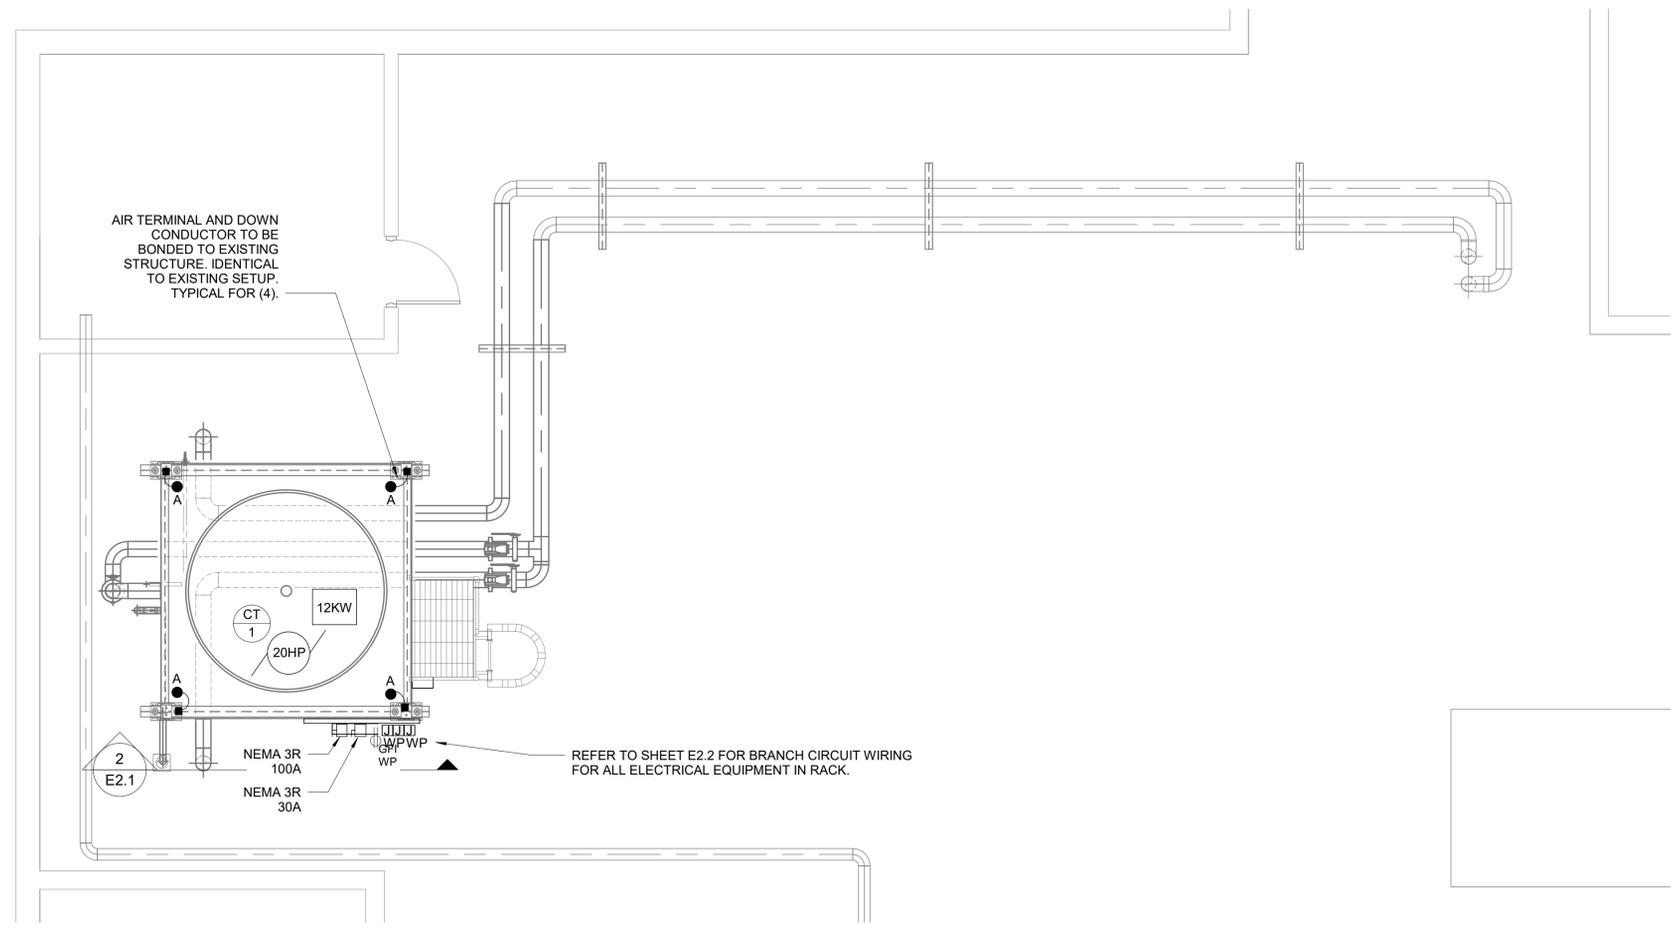


1 ROOF ELECTRICAL NEW WORK PLAN
 SCALE: 1/4" = 1'-0"

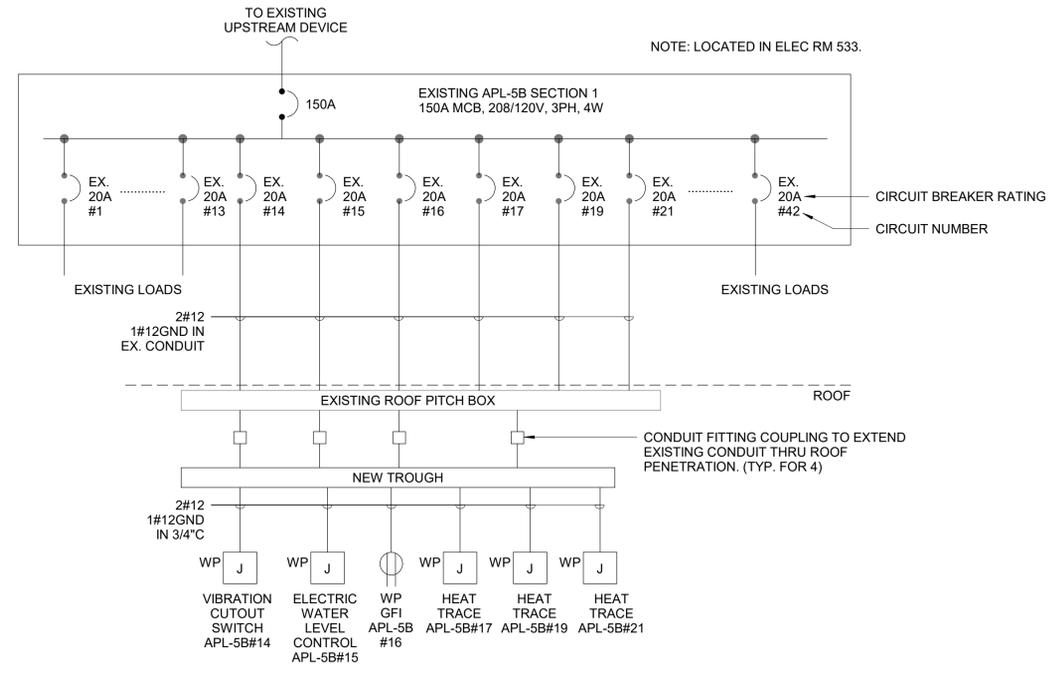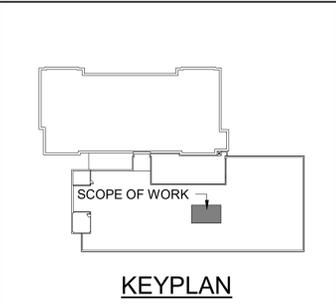


4 APL-5B SINGLE LINE NEW WORK
 SCALE: NONE

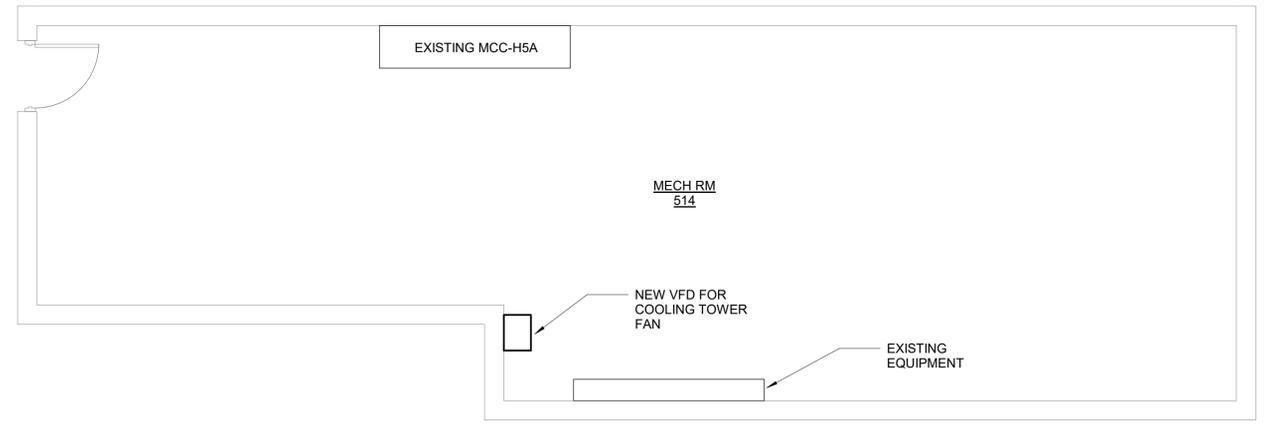


2 LEVEL 05 ELECTRICAL NEW WORK PLAN
 SCALE: NONE

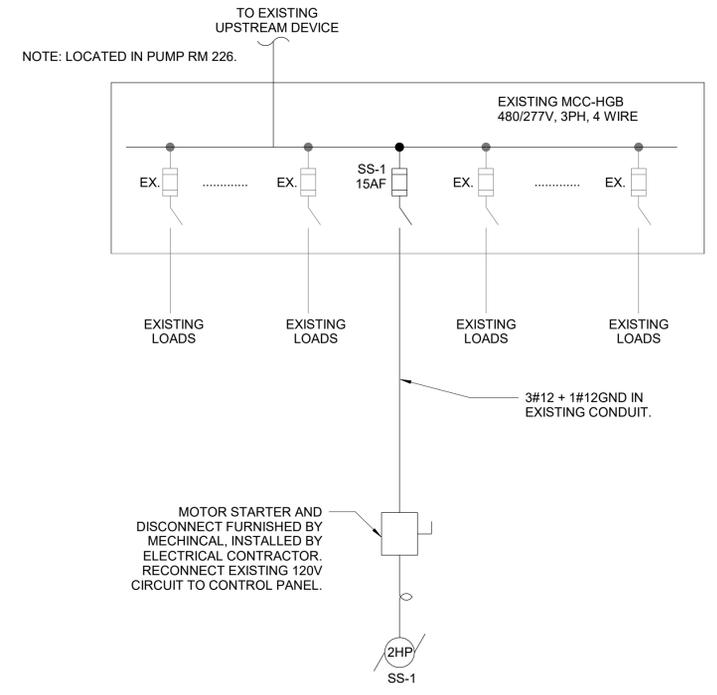

3 MCC-HGB SINGLE LINE NEW WORK
 SCALE: NONE

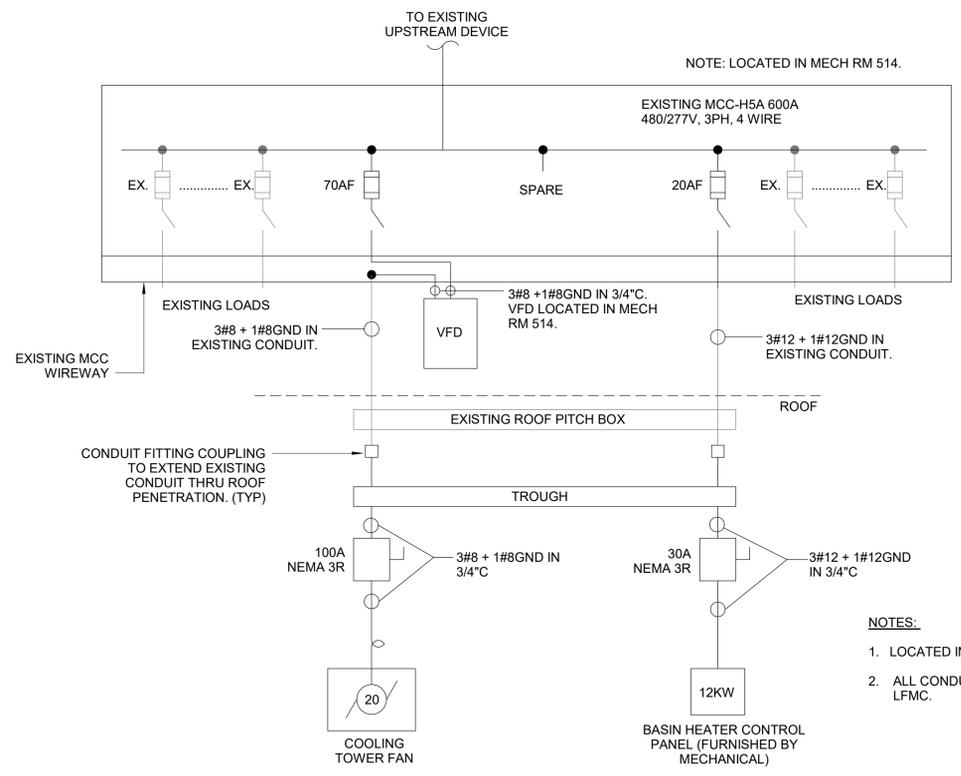

1 MCC-5HA SINGLE LINE AND ELEVATION NEW WORK
 SCALE: NONE

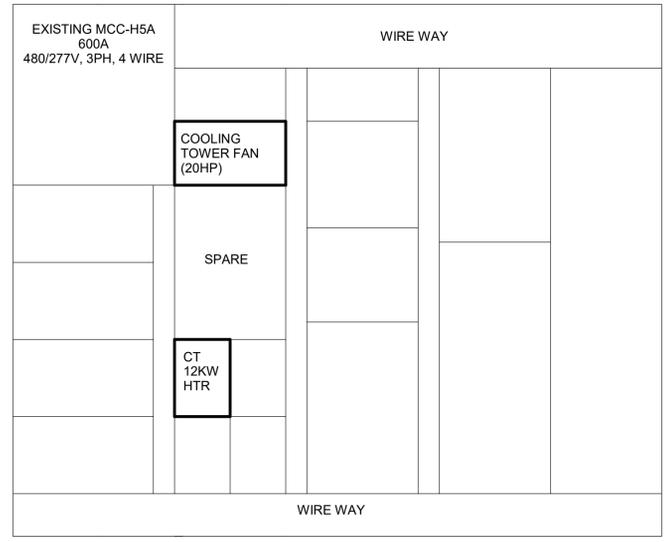

- NOTES:
1. LOCATED IN MECH RM 514.
 2. ALL CONDUCTORS INSTALLED BETWEEN VFD'S AND ASSOCIATED MOTORS SHALL BE XHHW-2, 1000V IN RGS, IMC, EMT FMC OF LPMC.

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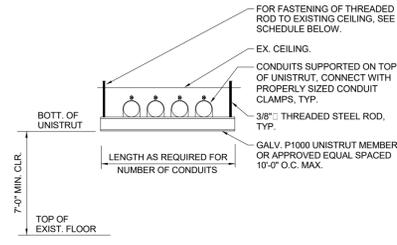
PROJECT
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 NEW CITY, NY 10956

DRAWING TITLE
**ELECTRICAL NEW WORK
 SINGLE LINE DIAGRAMS AND
 PLAN**

SCALE	PROJECT NO.
As indicated	NRCK0018
DRAWN BY GD	DRAWING NO.
CHECKED BY JF	E2.2
DATE 2024.04.05	


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 1 South Main Street
 New City, NY 10956




CEILING CONSTRUCTION	ANCHOR TYPE	EMBEDMENT
NORMAL WT. CONC	HILTI HDI DROP-IN ANCHOR	1" MIN.
CINDER CONCRETE	HILTI KWIK BOLT II	3" MIN.
HOLLOW CONSTRUCTION	TOGGLE BOLTS	NA


7 TRAPEZE SUPPORT DETAIL
 SCALE: NONE

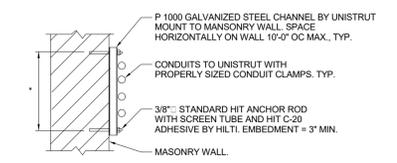


6 TYPICAL CONDUIT SUPPORT ON MASONRY DETAIL
 SCALE: NONE

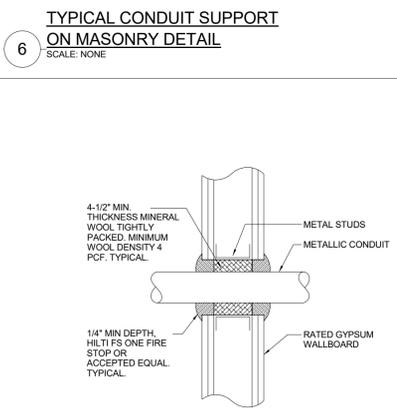


5 WALL PENETRATION DETAIL
 SCALE: NONE

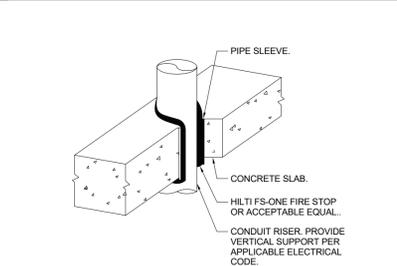


4 TYPICAL VERTICAL CONDUIT PENETRATION DETAIL
 SCALE: NONE

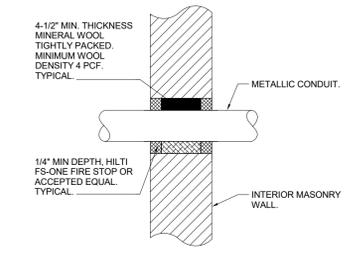


3 TYPICAL INTERIOR MASONRY WALL CONDUIT PENETRATION DETAIL
 SCALE: NONE

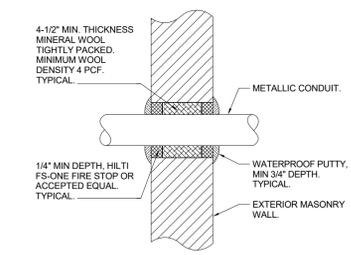


2 TYPICAL EXTERIOR MASONRY WALL ABOVE GRADE CONDUIT PENETRATION DETAIL
 SCALE: NONE

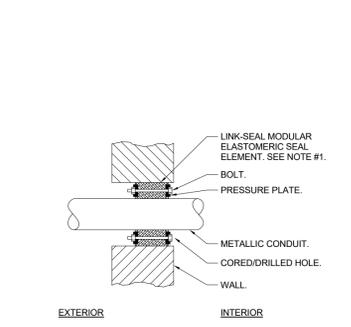


1 TYPICAL EXTERIOR MASONRY WALL BELOW GRADE CONDUIT PENETRATION DETAIL
 SCALE: NONE

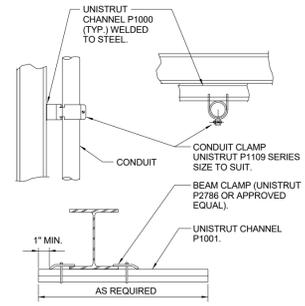


10 STRUCTURAL STEEL CONDUIT SUPPORTED FROM
 SCALE: NONE

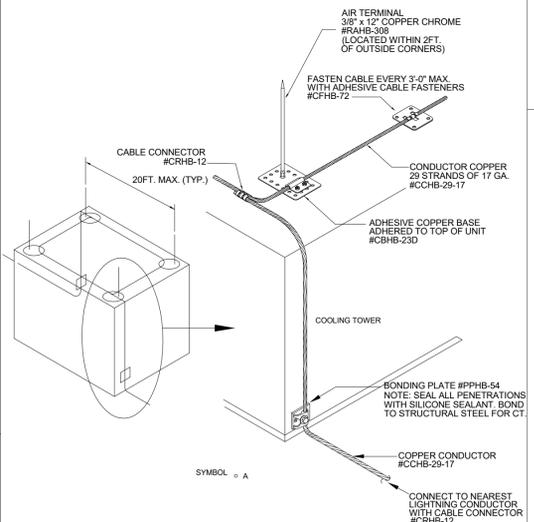

9 LIGHTNING PROTECTION AT COOLING TOWER
 SCALE: NONE

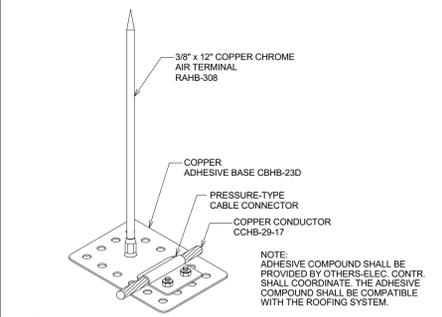

8 ADHESIVE AIR TERMINAL BASE
 SCALE: NONE

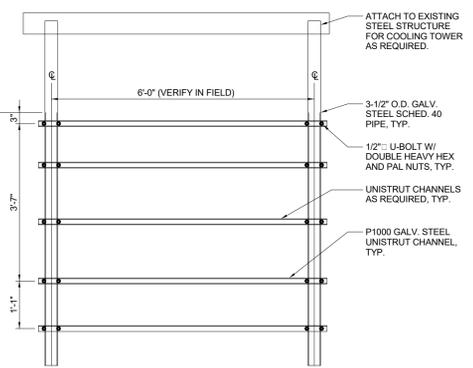

11 EQUIPMENT SUPPORT FRAME DETAIL
 SCALE: NONE

NOTE:
 1.) DESIGN TYPICAL FOR MOUNTING ALL WALL MOUNTED POWER EQUIPMENT.

NO.	DESCRIPTION	DATE
2	ISSUED FOR BID	09.09.2024
1	ISSUE FOR PERMIT	04.05.2024

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PROJECT
**CAPITAL PROJECT 1519
 GOVERNMENT CENTER BUILDING
 IMPROVEMENTS COURTHOUSE
 COOLING TOWER REPLACEMENT**
 1 SOUTH MAIN STREET
 NEW CITY, NY 10956

DRAWING TITLE
ELECTRICAL DETAILS

SCALE	PROJECT NO.
1" = 1'-0"	NRCK0018
DRAWN BY GD	DRAWING NO.
CHECKED BY JF	E7.1
DATE 2024.04.05	