

# VALLEY CENTRAL SCHOOL DISTRICT MONTGOMERY ELEMENTARY SCHOOL 2023 CAPITAL PROJECT - PHASE 1

**ISSUED FOR BID:** 10/18/24

**CSARCH** - ARCHITECTS

BLAKE ENGINEERING, PLLC - M.E.P. ENGINEERS

PASSERO ASSOCIATES - SITE/CIVIL AND STRUCTURAL ENGINEERS


AECC ENVIRONMENTAL CONSULTING - HAZARDOUS MATERIALS DESIGNERS

STATE EDUCATION DEPARTMENT PROJECT CONTROL NUMBER:

2023 CAPITAL PROJECT - PHASE 1 44-13-01-06-0-004-015

THE DESIGN OF THIS PROJECT CONFORMS TO APPLICABLE PROVISIONS OF THE NEW YORK STATE UNIFORM FIRE PREVENTION AND BUILDING CODE, THE NEW YORK STATE ENERGY CONSERVATION CONSTRUCTION CODE, AND THE MANUAL OF PLANNING STANDARDS OF THE NEW YORK STATE EDUCATION DEPARTMENT.

CSArch PROJECT NO. 187-2302.01

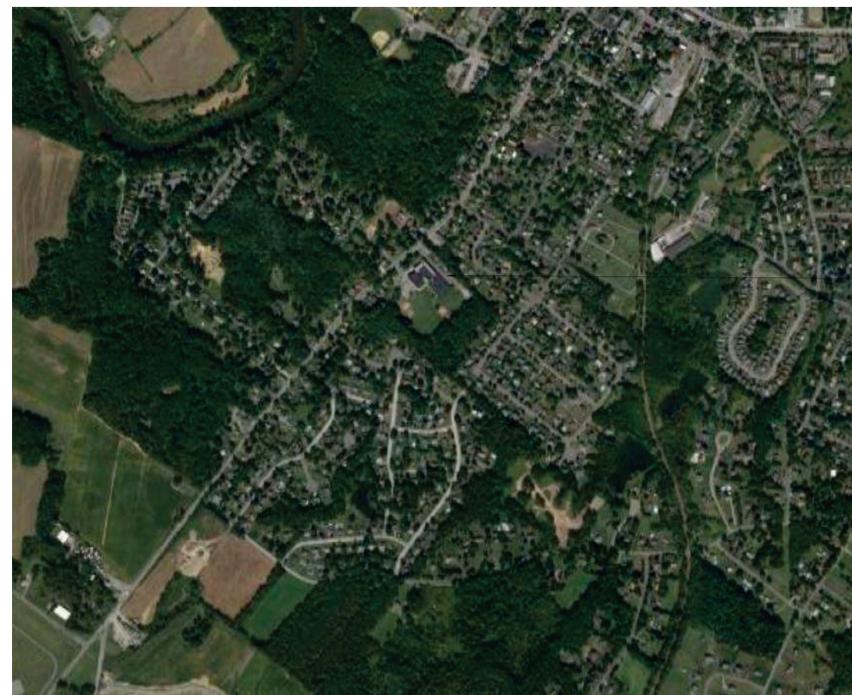

Montgomery Elementary School  
141 Union St  
Montgomery, NY 12549

VICINITY MAP

NTS




DRAWING LIST	
<b>GENERAL DRAWINGS</b>	
MES G000	COVER & SHEET INDEX
MES G001	SYMBOLS, ABBREVIATIONS, MISC. AND PARTITION TYPES
MES G111	OVERALL FLOOR PLAN - FIRST FLOOR
<b>LIFE SAFETY DRAWINGS</b>	
MES LS111	FIRST FLOOR LIFE SAFETY PLAN
MES LS112	SMOKE ZONE PLANS
<b>ARCHITECTURAL DEMOLITION DRAWINGS</b>	
MES AD111	ENLARGED REMOVAL PLAN - FIRST FLOOR - AREA C
<b>ARCHITECTURAL DRAWINGS</b>	
MES A111	ENLARGED NEW WORK PLAN - FIRST FLOOR - AREA C
MES A201	EXTERIOR ELEVATIONS
MES A202	EXTERIOR ELEVATIONS
MES A811	REFLECTED CEILING PLAN - FIRST FLOOR - AREA C
MES A901	DOOR, WINDOW, & STOREFRONT DETAILS
<b>ARCHITECTURAL FINISH DRAWINGS</b>	
MES AF001	SIGNAGE TYPES AND SCHEDULE
MES AF111	MATERIAL SCHEDULE & FLOOR FINISHES PLAN - AREA C
<b>PLUMBING GENERAL DRAWINGS</b>	
MES P001	PLUMBING NOTES, SCHEDULE, LEGEND & DETAILS
<b>PLUMBING DRAWINGS</b>	
MES P111	PLUMBING PLANS
<b>MECHANICAL GENERAL DRAWINGS</b>	
MES M001	MECHANICAL NOTES, LEGENDS, SCHEDULES & DETAILS
<b>MECHANICAL DEMOLITION DRAWINGS</b>	
MES MD111	MECHANICAL DEMOLITION PLAN
<b>MECHANICAL DRAWINGS</b>	
MES M111	MECHANICAL PLAN
<b>ELECTRICAL GENERAL DRAWINGS</b>	
MES E001	ELECTRICAL NOTES, LEGENDS, SCHEDULES & DETAILS
<b>ELECTRICAL DEMOLITION DRAWINGS</b>	
MES ED111	ELECTRICAL DEMOLITION PLAN
<b>ELECTRICAL DRAWINGS</b>	
MES E111	ELECTRICAL PLAN




EXPIRATION DATE: 02/28/2025

VOLUME 3 OF 8

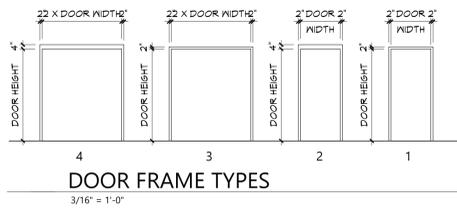


**DOOR FRAME TYPES**  
3/16" = 1'-0"

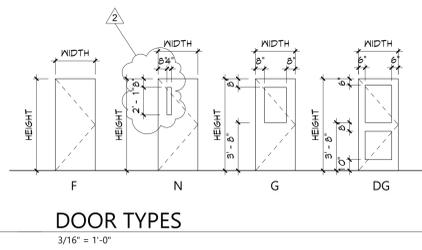


**DOOR TYPES**  
3/16" = 1'-0"


DOOR SCHEDULE																
DOOR NUMBER	QUANTITY	DOOR		WIDTH	HEIGHT	THICKNESS	TYPE	MATERIAL	FINISH	FRAME		GLAZING	HARDWARE	REMARKS	DOOR NUMBER	
		FROM	TO							MATERIAL	FINISH					
001	PR	100	VEST		3'-0"	7'-0"	1 3/4"	G	FRP	FF	HM	PT	7	HW1	4" FRAME HEAD	001
002	1	101	SECURITY VESTIBULE	103	3'-0"	7'-0"	1 3/4"	N	WD	FF	HM	PT	20	HW4	4" FRAME HEAD	002
003	101	SECURITY VESTIBULE	X44	CORRIDOR	3'-0"	7'-0"	1 3/4"	N	ALUM	ANOD	ALUM	ANOD	20	HW1		003
004	102	SRO	X44	CORRIDOR	3'-0"	7'-0"	1 3/4"	N	ALUM	ANOD	ALUM	ANOD	20	HW5		004

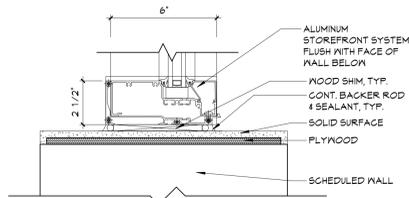


**22 SILL DETAIL 2**  
A901 3" = 1'-0"

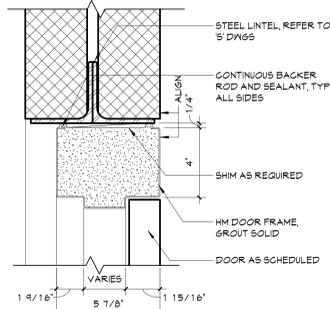


**5 HEAD DETAIL**  
A901 3" = 1'-0"

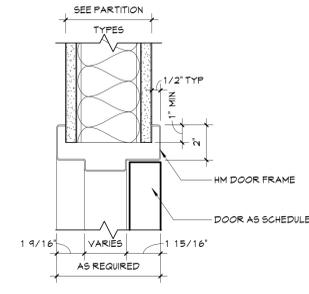


**4 HEAD DETAIL**  
A901 3" = 1'-0"

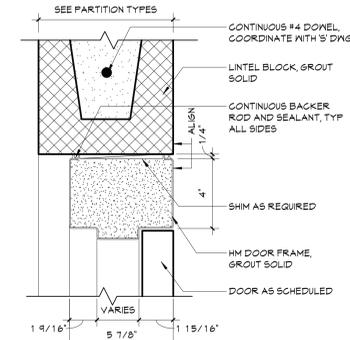


**3 HEAD DETAIL**  
A901 3" = 1'-0"

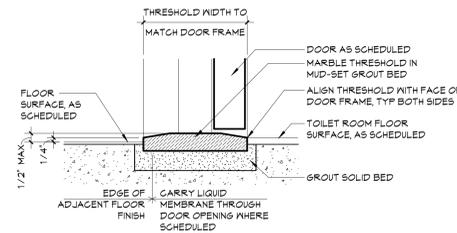


**6 THRESHOLD DETAIL**  
A901 3" = 1'-0"

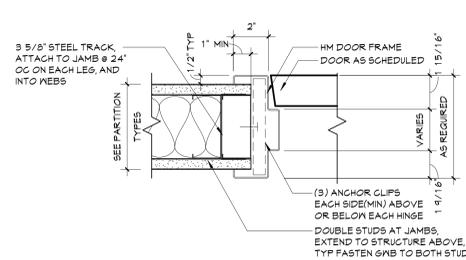


**2 JAMB DETAIL**  
A901 3" = 1'-0"

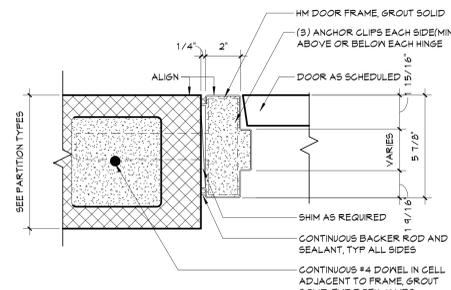


**1 HEAD DETAIL**  
A901 3" = 1'-0"

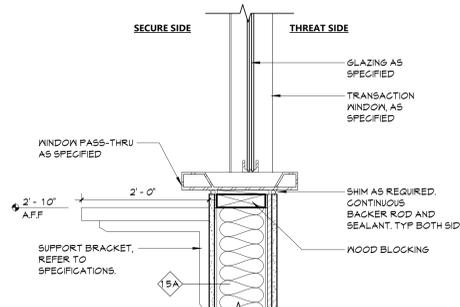


**14 SILL DETAIL - SECURITY WINDOW**  
A901 1 1/2" = 1'-0"

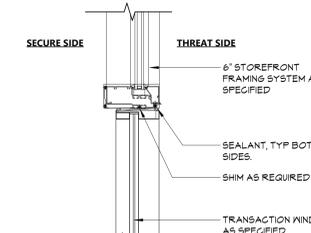


**12 HEAD DETAIL - SECURITY WINDOW**  
A901 1 1/2" = 1'-0"

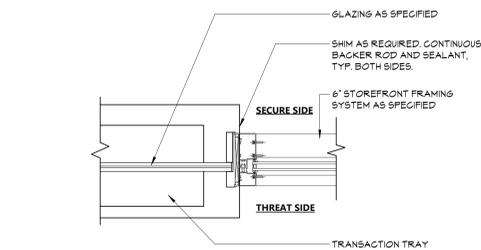


**13 JAMB DETAIL - SECURITY WINDOW**  
A901 1 1/2" = 1'-0"

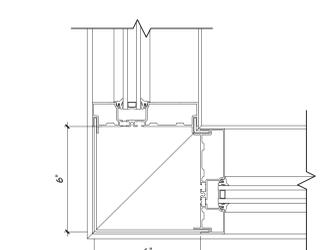


**20 CORNRO MULLION DETAIL**  
A901 3" = 1'-0"

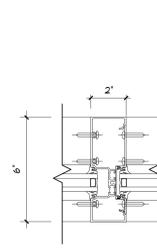


**19 VERTICAL MULLION DETAIL**  
A901 3" = 1'-0"

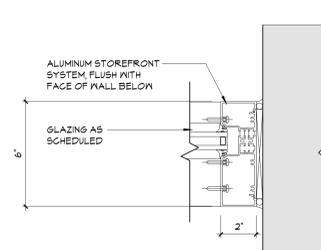


**18 JAMB DETAIL**  
A901 3" = 1'-0"

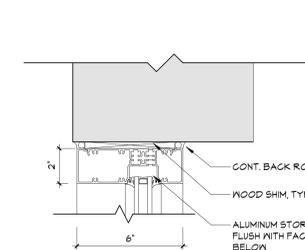


**16 HEAD DETAIL**  
A901 3" = 1'-0"

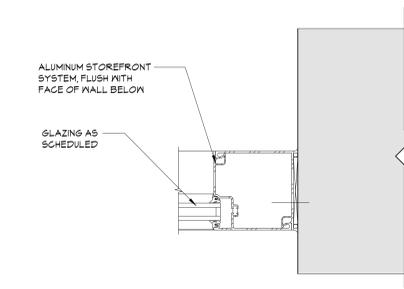


**17 JAMB DETAIL**  
A901 3" = 1'-0"

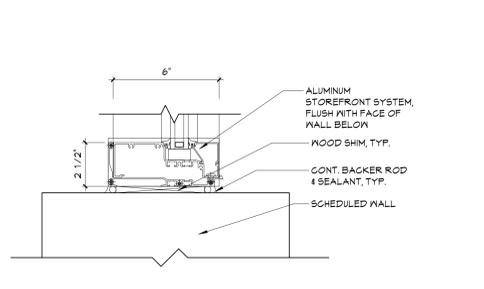


**15 SILL DETAIL**  
A901 3" = 1'-0"

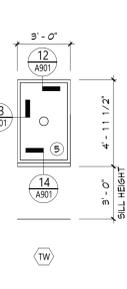

**11 TRANSITION WINDOW**  
A901 1/4" = 1'-0"

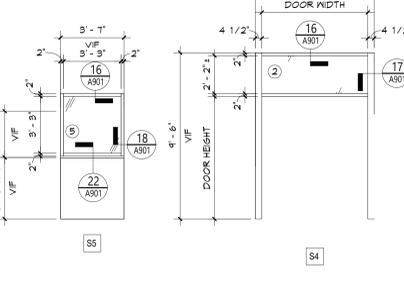

**7 STOREFRONT ELEVATION**  
A901 1/4" = 1'-0"

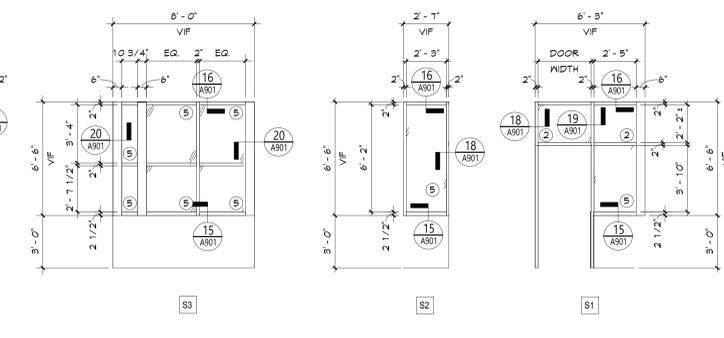

**DOOR LITE, GLAZING & PANEL TYPES**

- ① INSULATED GLAZING UNIT (IGL)
- ② FIRE-PROTECTION-RATED GLAZING MATCH RATING OF OPENING EXISTING CORRIDOR WALLS ARE PRESUMED 1-HOUR RATED, U.N.O. (FR)
- ③ INSULATED SECURITY GLAZING UNIT (ISA)
- ④ SECURITY GLAZING (SA)
- ⑤ FIRE-PROTECTION-RATED SECURITY GLAZING RATING BASED ON MALL OR DOOR RATING (FRSA)
- ⑥ INSULATED LAMINATED/TEMPERED GLASS (EXTERIOR)
- ⑦ SECURITY FILM ON INSULATED GLAZING UNIT
- ⑧ LAMINATED GLASS (LM)
- ⑨ SAFETY GLAZING (ISG)
- ⑩ FIRE-PROTECTION RATED INSULATED GLAZING UNIT (FGIL)


**LEGEND**

- [SH] STOREFRONT LABEL
- [X] WINDOW TAG

**STOREFRONT NOTES**

- 1) GLAZING SYSTEMS TO BE FIRE RATED TO MATCH FIRE RATING OF SCHEDULED DOORS. REFER TO DOOR SCHEDULE FOR FIRE RATINGS.
- 2) STOREFRONT FRAMING SYSTEM TO BE FIRE RATED TO MATCH FIRE RATING OF SCHEDULED GLAZING SYSTEMS. REFER TO STOREFRONT ELEVATIONS FOR GLAZING TYPES.

**KEY PLAN**

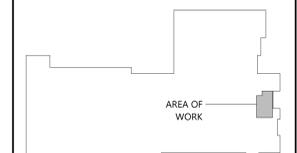

**DOOR, WINDOW, & STOREFRONT DETAILS**

MES A901

19 Front St., Newburgh - New York 12550-1601  
 845-581-3179 www.csarch.com  
**CSARCH**  
 Project Title  
**VALLEY CENTRAL SCHOOL DISTRICT  
 MONTGOMERY ELEMENTARY SCHOOL  
 2023 CAPITAL PROJECT - PHASE 1**  
 Project Title  
  
 EXPIRATION DATE: 02/28/2025  
 Drawn By: [Blank]    Author: [Blank]  
 Checked By: [Blank]    Checked By: [Blank]  
 Proj. #: 44-13-01-06-004-015  
 CSArch Proj. #: 187-2302-01  
 Issued for Bid: 10/18/24  
 Sheet No.  
**MES A901**  
 CONSTRUCTION DOCUMENTS

Consultant

VALLEY CENTRAL SCHOOL DISTRICT  
MONTGOMERY ELEMENTARY SCHOOL  
2023 CAPITAL PROJECT - PHASE 1

Project Title



EXPIRATION DATE: 02/28/2025

NO.	DATE	BID ADDENDUM NO.	DESCRIPTION
2	11/1/24		


Drawn By: *[Signature]*      Auth'd  
Checked By: *[Signature]*      44-13-01-06-0-004-015  
CSArch Proj. #: 187-2302.01  
Issued for Bid: 3/1/18/24

Sheet Title

SIGNAGE  
TYPES AND  
SCHEDULE

Sheet No.  
**MES  
AF001**


CONSTRUCTION DOCUMENTS

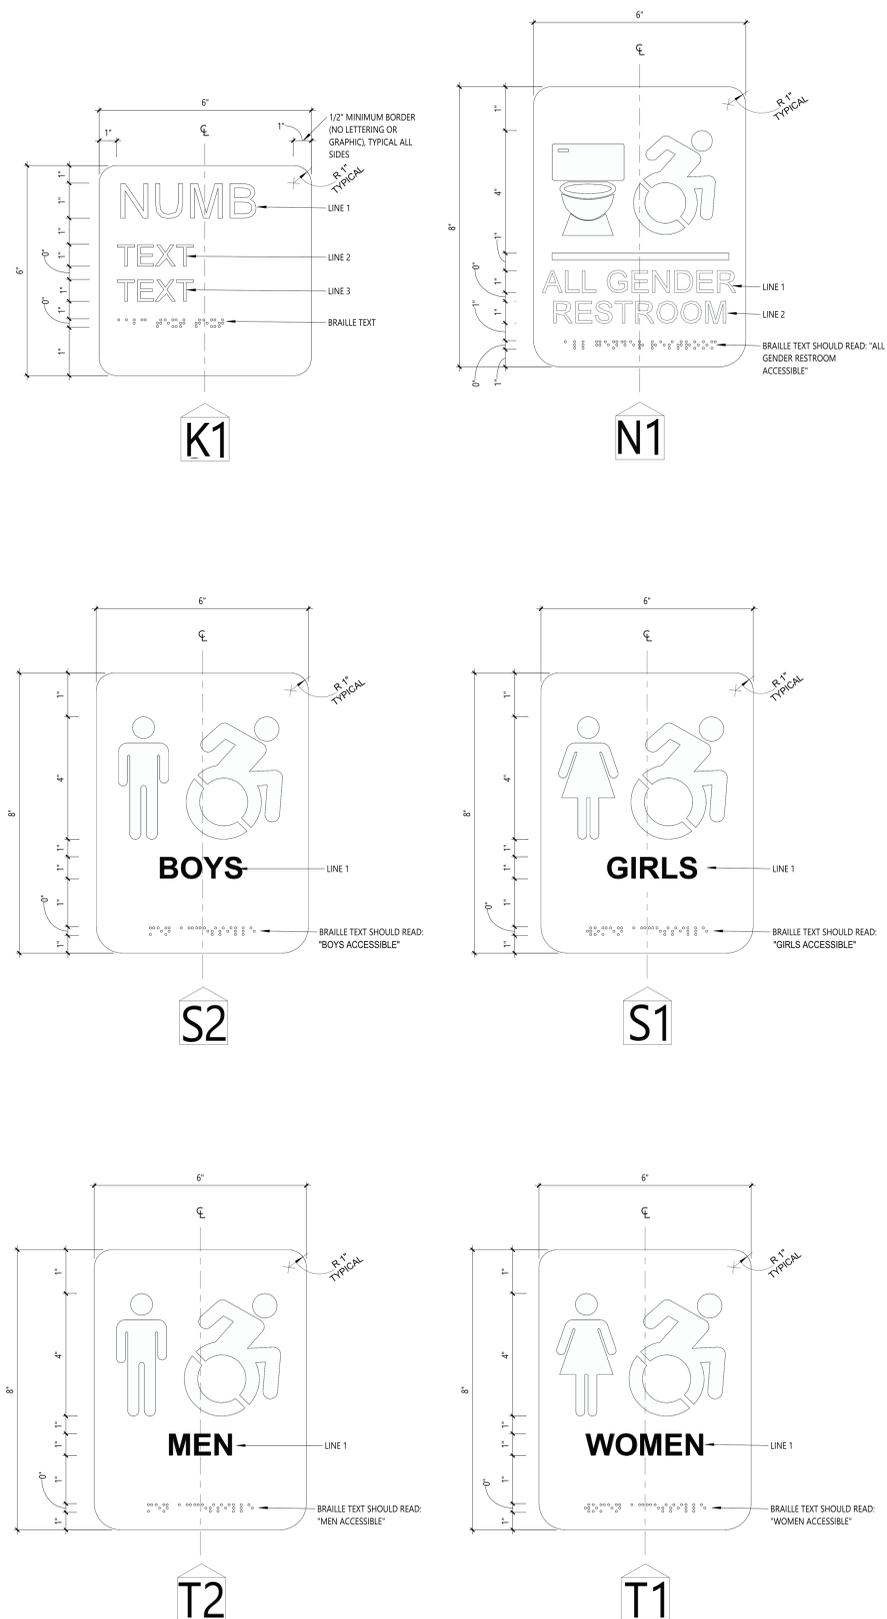

**1** PANEL SIGNAGE ELEVATIONS  
AF001 1/4" = 1'-0"

ROOM SIGNAGE SCHEDULE				
ROOM NUMBER	ROOM NAME	SIGNAGE TYPE	QUANTITY	REMARKS
101	SECURITY VESTIBULE	K1	2	FIRST FLOOR
102	SRG	K1	1	FIRST FLOOR
103	MAIN OFFICE	K1	3	FIRST FLOOR

- NOTES:**  
 1) REFER TO PANEL SIGNAGE ELEVATIONS FOR SIGNAGE TYPES.  
 2) REFER TO SPECIFICATION SECTION 101423 - "INTERIOR PANEL SIGNAGE" FOR ADDITIONAL INFORMATION.  
 3) ALL EXISTING PANEL SIGNAGE FOR ROOMS NOTED ABOVE SHALL BE REMOVED AND REPLACED WITH NEW.  
 4) FINAL NUMBERING AND NAMING OF ROOMS TO BE DETERMINED BY OWNER DURING THE SUBMITTAL AND SHOP DRAWING REVIEW.

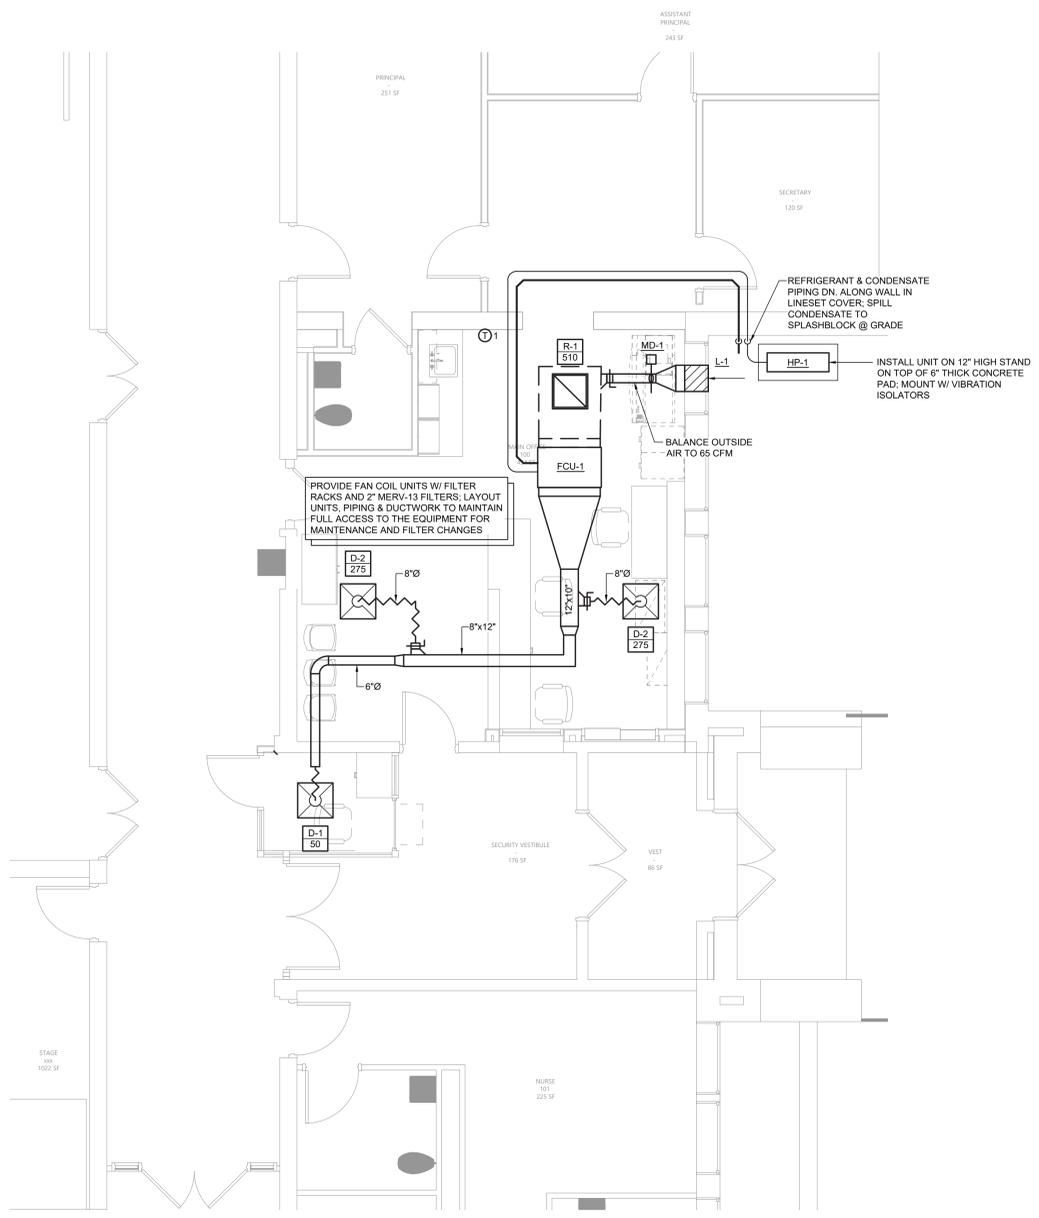

1 Mechanical Plan  
M111 Scale: 1/4" = 1'-0"

- DDC Temperature Control Notes:**
- HVAC CONTROLS SHALL BE FURNISHED & INSTALLED BY THE OWNER TO MATCH THE EXISTING BUILDING AUTOMATION SYSTEM IN EACH BUILDING (SIEMENS AT MAYBROOK ALC). ALL HARDWARE, WIRING AND PROGRAMMING TO BE PROVIDED BY OWNER. MECHANICAL CONTRACTOR IS RESPONSIBLE FOR COORDINATING WITH THE OWNER'S VENDOR THROUGHOUT THE PROJECT TO SUPPORT INSTALLATION, TESTING AND COMMISSIONING. MECHANICAL CONTRACTOR TO INSTALL ALL DEVICES MOUNTED IN OR ON THE PIPING AND/OR DUCTWORK INCLUDING BUT NOT LIMITED TO HYDRONIC CONTROL VALVES, TEMPERATURE SENSORS, FLOW SENSORS, ETC. MECHANICAL CONTRACTOR TO PROVIDE ALL NECESSARY PORTS/THERMOWELLS FOR SENSORS, GAUGES, ETC. COORDINATE WITH OWNER'S VENDOR FOR QUANTITY AND LOCATIONS.
  - OWNER SHALL EXPAND EXISTING BUILDING AUTOMATION SYSTEM TO PROVIDE THE CONTROL SEQUENCES SPECIFIED ON THE DRAWINGS AND IN THE SPECIFICATIONS. THE SYSTEM SHALL PROVIDE CONTROL AND MONITORING OF THE EQUIPMENT INDICATED.
  - OWNER SHALL PROVIDE CONTROLLERS AND COMMUNICATIONS INFRASTRUCTURE TO MATCH EXISTING CAMPUS-WIDE BUILDING AUTOMATION SYSTEM. PROVIDE SEAMLESS INTEGRATION WITH EXISTING CONTROL NETWORK AND USER INTERFACES. NETWORK GATEWAYS AND PROTOCOL INTERFACE EQUIPMENT ARE NOT ACCEPTABLE UNLESS OTHERWISE NOTED.
  - OWNER SHALL PROVIDE INSTRUMENTATION, SENSORS, VALVES, DAMPERS, ACTUATORS AND WIRING AS REQUIRED TO PROVIDE SPECIFIED OPERATING SEQUENCES.
  - OWNER SHALL MODIFY EXISTING GRAPHIC USER INTERFACES TO INCLUDE ALL EQUIPMENT AND SYSTEMS INCLUDED IN THIS PROJECT.
  - OWNER SHALL REPLACE THE EXISTING BAS SERVER HARDWARE AND UPGRADE THE SOFTWARE TO THE LATEST VERSION OF WEB-ENABLED GRAPHICAL USER INTERFACE WITH A SEAMLESS INTEGRATION OF THE NEW AND EXISTING CONTROL POINTS.
  - OWNER SHALL BE RESPONSIBLE FOR POWER THAT IS NOT SHOWN ON THE ELECTRICAL DRAWINGS, TO CONTROLS FURNISHED BY THIS CONTRACTOR. IF POWER CIRCUITS ARE SHOWN ON THE ELECTRICAL DRAWINGS, OWNER SHALL CONTINUE THE POWER RUN TO THE CONTROL DEVICE. IF POWER CIRCUITS ARE NOT SHOWN, OWNER SHALL PROVIDE BREAKERS AT DISTRIBUTION PANELS FOR POWER TO CONTROLS AND PROVIDE POWER FROM THE DISTRIBUTION PANEL TO THE CONTROL DEVICES.
  - OWNER SHALL FURNISH & INSTALL ALL REQUIRED END DEVICES, POWER SUPPLY, LOW VOLTAGE TRANSFORMERS, CONTROL WIRING & CONDUITS, ETC. FOR A COMPLETE & OPERATIONAL DDC CONTROL SYSTEM.
  - NEW WIRING & CONDUITS SHALL BE RUN CONCEALED ABOVE CEILING. ALL EXPOSED WIRING & CONDUITS SHALL BE RUN CONCEALED IN EMT IN UTILITY SPACES AND WIREMOLD IN FINISHED AREAS.
  - OWNER TO FIELD INSTALL SENSORS, CONTROLLERS, ETC. WHICH ARE NOT FACTORY-INSTALLED BY EQUIPMENT MANUFACTURERS.
  - ANY EQUIPMENT FURNISHED WITH FACTORY CONTROLS SHALL BE PROVIDED WITH BACNET MSTP INTEGRATION CAPABILITIES AND INCLUDE ON-SITE FACTORY CONTROLS INTEGRATION START-UP IN COORDINATION WITH OWNER'S BUILDING AUTOMATION SYSTEM.

INDOOR MINI-SPLIT UNIT SCHEDULE																			
EQUIPMENT TAG	MANUFACTURER (OR ACCEPT. EQUAL)	MODEL	MINI-SPLIT UNIT TYPE	AREA OF BUILDING SERVED	AIRFLOW (CFM)	COOLING			HEATING			PAIRED OUTDOOR UNIT	EXTERNAL STATIC PRESSURE (IN. W.C.)	ELECTRICAL POWER REQUIREMENTS			WEIGHT (LB)	NOTES	
						CAPACITY (MBH)	EDB (°F)	EWB (°F)	CAPACITY (MBH)	EDB (°F)	EWB (°F)			VOLT.	PHASE	Hz.			
FCU-1	mitsubishi	PEAD-A18AA8	DUCTED MEDIUM STATIC	MAIN OFFICE	600	18.0	80.0	67.0	21.6	70.0	60.0	HP-1	0.50	208	1	60	121	60	HYPER HEATING UNIT; SEE VRF SYSTEM NOTES

AIR-COOLED HEAT PUMP SCHEDULE																				
EQUIPMENT TAG	MANUFACTURER (OR ACCEPT. EQUAL)	MODEL	INDOOR UNITS SERVED	COMPRESSOR TYPE	NOM. COOL CAPACITY (MBH)	NOM. HEAT CAPACITY (MBH)	OUTDOOR OPERATING TEMP. RANGE (°F)		AHRU EFFICIENCY RATINGS			REFRIGERANT	SOUND PRESSURE LEVEL (COOLING/HEATING) (DBA)	ELECTRICAL POWER REQUIREMENTS			WEIGHT (LB)	NOTES		
							COOLING	HEATING	EER	SEER	COOP			VOLT.	PHASE	Hz.				
HP-1	mitsubishi	SUZ-KA18NAHZ	FCU-1	INVERTER SCROLL HERMETIC	18.0	21.6	0 TO 115	-13 TO 75	12.8	18.9	3.3	R410A	52/53	208	1	60	17	30	131	HYPER HEATING UNIT; FURNISH W/ REQUIRED PIPING ACCESSORIES




AIR GRILLE/DIFFUSER SCHEDULE													
EQUIPMENT TAG	MANUFACTURER (OR ACCEPT. EQUAL)	MODEL	AIR DEVICE TYPE	AIRFLOW (CFM)		MAX AIR PRESS. DROP (IN. W.C.)	MOUNTING	PANEL/FRAME SIZE (IN.)	NECK SIZE (IN.)	MAX NC	DAMPER	FINISH	NOTES
				MIN.	MAX.								
D-1	KRUEGER	PLQ-6-F23-24x24-PR10-IB-44	SQUARE PLAQUE FACE DIFFUSER	50	175	0.10	LAY-IN	24"x24"	6"Ø	20	OBD	WHITE	PROVIDE W/ INSULATED BLANKET ON BACKPAN
D-2	KRUEGER	PLQ-8-F23-24x24-PR10-IB-44	SQUARE PLAQUE FACE DIFFUSER	176	300	0.10	LAY-IN	24"x24"	8"Ø	20	OBD	WHITE	PROVIDE W/ INSULATED BLANKET ON BACKPAN
R-1	KRUEGER	S80P-20x20-F23-24x24-00-00-00-44	PERFORATED FACE RETURN GRILLE	0	1,600	0.10	LAY-IN	24"x24"	20"x20"	25	-	WHITE	FURNISH & INSTALL FULL-SIZE SHEET METAL PLENUM BOX ON REAR OF GRILLE; PAINT INSIDE FLAT BLACK

LOUVER SCHEDULE														
EQUIPMENT TAG	QTY.	MANUFACTURER (OR ACCEPT. EQUAL)	MODEL	AIR DEVICE TYPE	LOUVER SIZE			FREE AREA (SQ. FT.)	AIRFLOW (CFM)	VELOCITY (FT./MIN.)	MOUNTING	SCREEN	FINISH	NOTES
					WIDE	HIGH	DEPTH							
L-1	1	RUSKIN	ELF6375DX	STATIONARY LOUVER	18"	12"	6"	0.63	65	103.2	EXTERIOR WALL	YES	TBD	1, 2 & 3

1. COLOR TO BE COORDINATED WITH OWNER/ARCHITECT BEFORE ORDERING  
2. FURNISH WITH INSECT-SCREEN OPTION  
3. FURNISH W/ PROPER MOUNTING HARDWARE.

SPLIT SYSTEMS WITH DUCT FAN COIL & HEAT PUMP FURNISHED BY OWNER. INSTALLED BY CONTRACTOR. CONTRACTOR IS RESPONSIBLE TO RECEIVE THE EQUIPMENT DELIVERY AT THE PROJECT SITE, MOVE EQUIPMENT FROM TRUCK(S) TO A DESIGNATED STORAGE LOCATION ON THE SITE & RIG THE UNIT INTO THE FINAL INSTALLATION LOCATION. CONTRACTOR IS TO PROVIDE ALL ASSOCIATED COMPONENTS, I.E., DUCTWORK, PIPING, CONTROLS, ACCESSORIES, ETC. UNLESS OTHERWISE NOTED IN THE PROJECT DOCUMENTS; REFER TO FRONT END DOCUMENTS FOR ADDITIONAL INFORMATION.

- VRF System Notes:**
- WIRE 7 DAY PROGRAMMABLE THERMOSTAT SHALL BE FURNISHED BY MECHANICAL CONTRACTOR FOR EACH INDOOR UNIT. THERMOSTATS SHIP LOOSE FOR FIELD INSTALLATION AND WIRING BY THE MECHANICAL CONTRACTOR.
  - MECHANICAL CONTRACTOR TO PROVIDE CENTRAL CONTROLLER FOR LOCAL SET POINT CONTROL AND SYSTEM VIEWING. CONTROLLER TO BE INSTALLED AND WIRING BY MECHANICAL CONTRACTOR. 24V POWER BY ELECTRICAL CONTRACTOR.
  - DISCONNECT SWITCHES FOR CONDENSING UNITS AND INDOOR UNITS SHALL BE FURNISHED BY THE MECHANICAL CONTRACTOR AND INSTALLED BY THE ELECTRICAL CONTRACTOR.
  - EXTERNAL SUPPORTS FOR INDOOR AND CONDENSING UNITS SHALL BE FURNISHED AND INSTALLED BY THE MECHANICAL CONTRACTOR.
  - FILTER RACK AND 3" PLEATED MERV-13 FILTERS FOR DUCTED UNITS SHALL FURNISHED AND INSTALLED BY THE MECHANICAL CONTRACTOR. FILTER RACK SHALL BE GALVANIZED STEEL, FULLY INSULATED & FACTORY ASSEMBLED, TYPICAL OF FT-H SERIES OR EQUAL.
  - CONDENSATE PUMPS SHIP FOR FIELD INSTALLATION BY MECHANICAL CONTRACTOR FOR WALL MOUNTED UNITS. DUCTED UNITS FURNISHED WITH FACTORY MOUNTED CONDENSATE PUMP. MECHANICAL CONTRACTOR TO PROVIDE CONDENSATE PIPING FROM ALL UNITS TO SANITARY DRAIN. FIELD VERIFY EXACT ROUTING AND TERMINATION POINT IN BUILDING.
  - PROVIDE REFRIGERANT ISOLATION VALVES ON LIQUID AND GAS LINES AT EVERY FAN COIL UNIT.

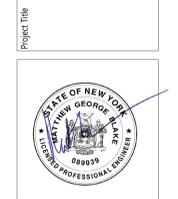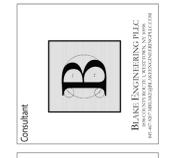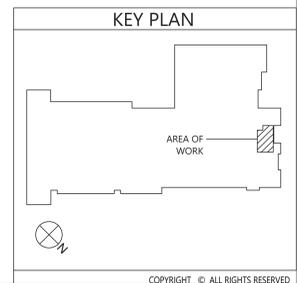

NO.	DATE	DESCRIPTION
1	1/2024	ISSUE FOR CONSTRUCTION

Drawn By: BJK  
Checked By: BJK  
Proj. #: 44-13-01-06-004-015  
CSArch Proj. #: 187-2302.01  
Issued for Bid: 10/18/24


MECHANICAL PLAN

MES  
M111



**Key Notes:**

- 1 EXISTING LIGHT FIXTURE TO REMAIN
- 2 PROVIDE NEW 120V ELECTRICAL CONNECTION FOR FIRE SHUTTER
- 3 FIRE ALARM RELAY; FIRE SHUTTER TO CLOSE UPON ACTIVATION OF FIRE ALARM
- 4 RELOCATE EXISTING LIGHT FIXTURE TO AVOID CONFLICT W/ NEW SECURITY OFFICE; CENTER FIXTURE IN VESTIBULE; EXTEND WIRING & CONDUIT FROM EXISTING CIRCUIT AS NECESSARY
- 5 REINSTALL EXISTING WIRELESS ACCESS POINT; CONNECT TO EXISTING DATA CABLING
- 6 EXISTING FIRE ALARM ANNUNCIATOR PANEL TO REMAIN; TEMPORARILY REMOVE, PROTECT & STORE DURING CONSTRUCTION; REINSTALL AFTER COMPLETION OF VESTIBULE
- 7 PROVIDE SMOKE DETECTORS ON BOTH SIDES OF THE AUTOMATIC FIRE SHUTTER AT THE TRANSACTION WINDOW; CONNECT TO THE EXISTING BUILDING FIRE ALARM SYSTEM

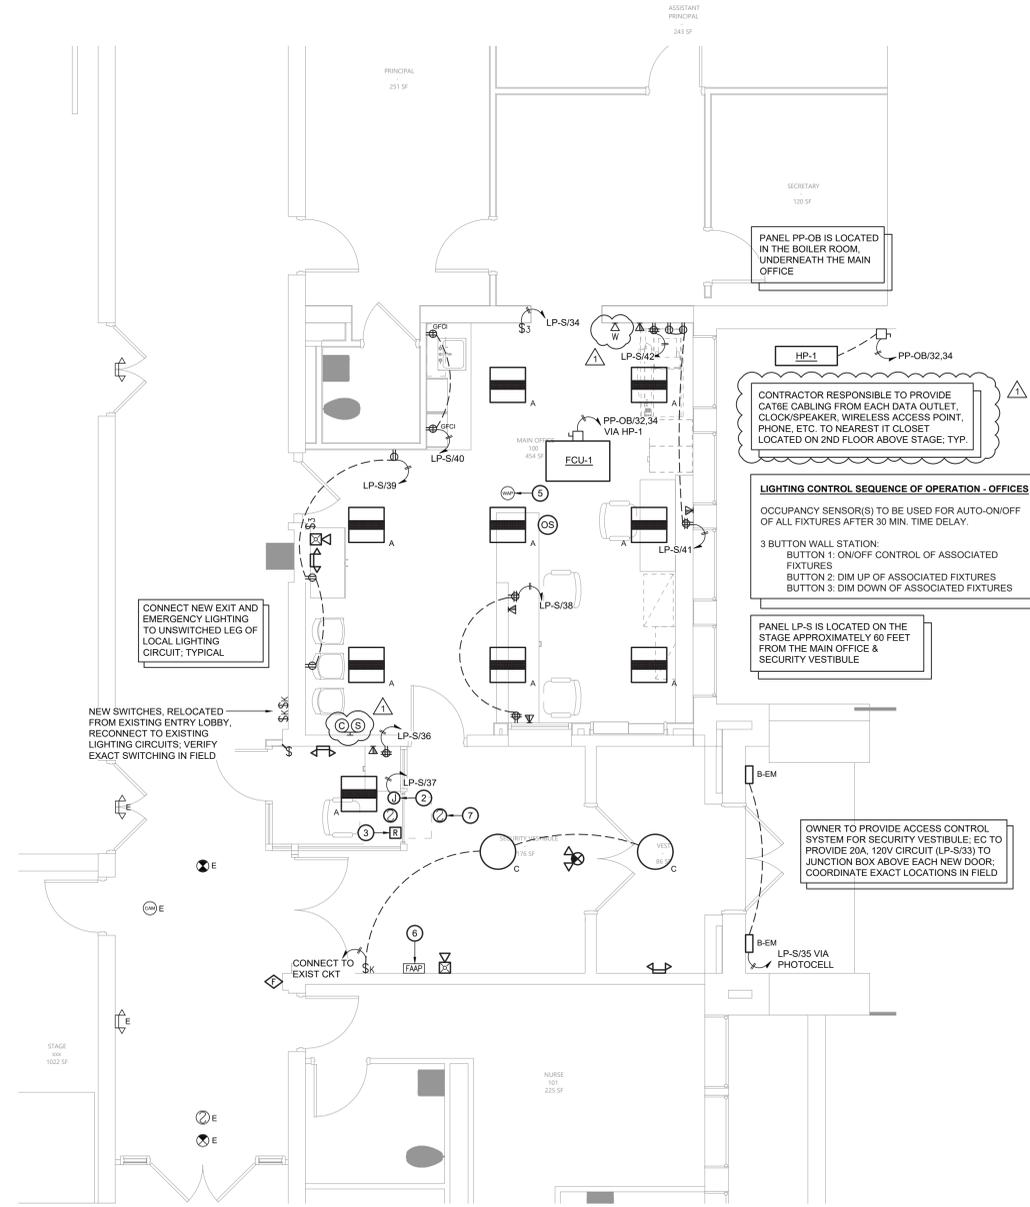

1 Electrical Plan  
Scale: 1/4" = 1'-0"



VALLEY CENTRAL SCHOOL DISTRICT  
MONTGOMERY ELEMENTARY SCHOOL  
2023 CAPITAL PROJECT - PHASE 1

Project Title



NO.	DATE	DESCRIPTION
1	10/24	802 ADDENDUM #2

Drawn By: BJK  
Checked By: BJK  
Proj. #: 44-13-01-06-0-004-015  
CSArch Proj. #: 187-2302.01  
Issued for Bid: 10/18/24

Sheet Title  
**ELECTRICAL PLAN**

Sheet No.  
**MES E111**

CONSTRUCTION DOCUMENTS

