# COUNTY OF WESTCHESTER NEW YORK

## **DIVISION OF ENGINEERING**

# ADDENDUM NO. 3

# CONTRACT NO. <u>20-502</u>

# LOW RISE BUILDING RENOVATIONS AND HVAC IMPROVEMENTS - PHASE II 110 DR. MARTIN LUTHER KING, JR. BOULEVARD WHITE PLAINS, NEW YORK

The attention of the bidder is directed to the following changes, additions, and/or substitutions affecting the above referenced contract.

# I. RE: THE SPECIFICATIONS:

# Item A: PROPOSAL PAGE 6

Delete: Proposal Page 6 (1 of 1 in its entirety) Insert: Revised Proposal Page 6 (3 of 3 in its entirety) Including Alternate #1 The revised Proposal Pages must be used for bid.

# Item B: Summary of modifications to Elevator Modernization Specification Section 142150

# 110 Martin Luther King Blvd.

- General Comment: The latest applicable version during contract award of all Codes and Ordinances including but not limited to NY State and White Plains Building Code and applicable elevator Code (ANSI A17.1), Electrical and Plumbing Codes by reference will govern for all work.
- 2. Warranty: Section 1.5 A will be deleted and modified to state as follows: Warranty period will be 1 year including all labor and materials and 24/7/365 callback. Warranty period to start once elevator has passed all inspections and is signed off by County's Code Enforcement. Contractor shall perform a Category 1 Test 1 month prior to the end of the warranty period and make any required repairs. The test shall be witnessed by County's elevator Inspector. At the conclusion of the test contractor shall also inspect and adjust the ropes as necessary. The elevator Contractor shall also be present for the Biannual inspection during the warranty period.
- 3. Maintenance: Section 1.6 will be modified to state as follows: Maintenance by County's elevator vendor will begin when warranty expires.
- 4. Card Reader: Appendix II is deleted from the scope of work
- 5. Car Lantern: Section 2.08C is deleted from the scope.

- 6. Emergency Communications Section 2.08 E will be amended to add: Emergency communication shall meet the requirements of the latest applicable code. Elevator emergency communication must include: Two-way (text-based) messaging capability and video capability. A display message to indicate call has been received and help is on the way and/or onsite. All required wiring shall be included in the traveling cable and controller. Emergency communications need to be actively monitored at all times.
- 7. Governors: Section 2.04 M shall be modified to read as follows:

Safety and Governor

- 1. GAL /Hollister Whitney
- 2. Approved Equal

All safety devices shall be replaced with new. All safeties shall be completely tested before any elevator is restored to service. All missing or worn parts/hardware shall be replaced. Car safety shall be mounted on the bottom members of the car frame and be operated by a centrifugal speed governor and tension sheave assembly. Governor rope shall be 3/8" iron. The governor shall be designed to cut off power to the motor and apply the brake whenever the governor indicates the car has excessive speed. The governor shall function when the car over speeds in either the up or down direction. The governor will be mounted in the pit with remote solenoids or similar switches which will be operated controlled by switches in the controller. Provide proper signage and operating procedure for remote control operation in the pit and the controller. The proper tension in the governor rope shall be maintained by the weighted tension sheave located in the overhead. The governor shall be equipped with rope grip jaws designed to clamp the governor rope so as to actuate the car safety upon a predetermined overspeed in either direction. Overspeed setting >115% of specified rated car speed and < the maximum governor tripping speed specified in the applicable elevator Code for the specified rated car speed. When operated, no undue damage to the governor rope shall result from the stopping action. Adjust the governor and mark the tripping speed specified on the tag.

# 111 Martin Luther King Blvd.

- General Comment: The latest applicable version during contract award of all Codes and Ordinances including but not limited to NY State and White Plains Building Code and applicable elevator Code (ANSI A17.1), Electrical and Plumbing Codes by reference will govern for all work.
- 2. Warranty: Section 1.5 A will be deleted and modified to state as follows: Warranty period will be 1 year including all labor and materials and 24/7/365 callback. Warranty period to start once elevator has passed all inspections and is signed off by County's Code Enforcement. Contractor shall perform a Category 1 Test 1 month prior to the end of the warranty period and make any required repairs. The test shall be witnessed by County's elevator Inspector. At the conclusion of the test contractor shall also inspect and adjust the ropes as necessary. The elevator Contractor shall also be present for the Biannual inspection during the warranty period.

- 3. Maintenance: Section 1.6 will be deleted and modified to state as follows: Maintenance by County's elevator vendor will begin when warranty expires.
- 4. Car Lantern: 2.08C is deleted from the scope.
- 5. Emergency Communications Section 2.08 E will be amended to add: Emergency communication shall meet the requirements of the latest applicable code. Elevator emergency communication must include: Two-way (text-based) messaging capability and video capability. A display message to indicate call has been received and help is on the way and/or onsite. All required wiring shall be included in the traveling cable and controller. Emergency communications need to be actively monitored at all times.

# 143 Grand Street.

- General Comment: The latest applicable version during contract award of all Codes and Ordinances including but not limited to NY State and White Plains Building Code and applicable elevator Code (ANSI A17.1), Electrical and Plumbing Codes by reference will govern for all work.
- 2. Section 1.2 shall be deleted and modified to state as follows:

Warranty: Warranty period will be 1 year including all labor and materials and 24/7/365 callback. Warranty period to start once elevator has passed all inspections and is signed off by County's Code Enforcement. Contractor shall perform a Category 1 Test 1 month prior to the end of the warranty period and make any required repairs. The test shall be witnessed by County's elevator Inspector. At the conclusion of the test contractor shall also inspect and adjust the ropes as necessary. The elevator Contractor shall also be present for the Biannual inspection during the warranty period.

Maintenance: Maintenance by County's elevator vendor will begin when warranty expires.

- 3. Card Reader: Appendix II is deleted from the scope.
- 4. Car Lantern: Section 2.07 B is deleted from the scope of work.
- 5. Emergency Communications Section 2.07D will be amended to add: Emergency communication shall meet the requirements of the latest applicable code. Elevator emergency communication must include: Two-way (text-based) messaging capability and video capability. A display message to indicate call has been received and help is on the way and/or onsite. All required wiring shall be included in the traveling cable and controller. Emergency communications need to be actively monitored at all times.

# II. RE: Drawings:

Item A: Drawings A-109, A-111, A-112, A-113, A-114, A-303 Delete: Drawings A-109, A-111, A-112, A-113, A-114, A-303 dated 01-19-24 Insert: <u>Drawings</u> A-109, A-111, A-112, A-113, A-114, A-303 with revision date of 02-21-24

# **III. RE: CLARIFICATIONS:**

٠	General Questions					
No.	Contractor Question	Answer				
Q1	Please provide contact information to BMS Controls Vendor	Walter E. Greenwood "Chip" Building Automation Specialists   Partner of Schneider Electric Phone: 914-747-1007   Mobile: 914-403-4702 Email: greenwoodw@emfcontrols.com   Site: www.emfcontrols.com   Address: 581 N State Rd, STE 6, Briarcliff Manor, NY 10510-1556, USA				
Q2	Please provide contact information to Fire Alarm Vendor	Melissa DeGiglio Fire Service Manager Johnson Controls +1 845 774 4120 office <u>melissa.degiglio@jci.com</u>				
Q3	Does attending the mandatory prebid apply to the named subcontractors?	No				
Q4	Is there a Roof warranty?	Yes				
Q5	Please provide contact information to roof warranty holder	John's Manville				
Q6	Please clarify what works is to be figured on overtime (i.e. noisy work, building shutdowns, etc.)	Asbestos abatement, fumes, noisy work, any work affecting employee or public access				
Q7	Please clarify what hours are working hours	7:00 – 4:00				
Q8	Please clarify what is defined as noisy work	Jack hammering, Shooting anchors, Metal cutting, Heavy demolition				
Q9	Please clarify are the allowances indicated on the bid proposal forms for work above and beyond what is indicated on the bid documents	Miscellaneous Additional Work is funds to be used in the project at the discretion of the County beyond the base bid contract requirements, Testing of Materials to be used for material testing beyond what is included as part of the base work.				
Q10	Please confirm where trades/subcontractors and GC personnel can park to access these projects	No Parking shall be provided, contractor and his personnel to park in adjacent municipal parking lot at their own expense				
Q11	What is the schedule duration for this project, start and completion	540 workdays from the Notice to Proceed				
Q12	The Mechanical Drawings contain notes referencing Alternate work; however, the bid form does not include a section for Alternate pricing. Is this work to be included in Base Bid or will the Bid form be revised?	Alternate #1 has been included in the revised bid form. See answer to Q30 for additional information.				
Q13	What is the total timeline to be done – Can we provide multiple teams to complete project if necessary	Project timeline is 540 workdays the contractor can provide multiple crews.				

Q14	Please provide existing roof system specifications.	Roof warranty attachment provided
•	Architectural Questions	
No.	Contractor Question	Answer
Q15	Who is responsible for furniture removal and relocation, specifically furniture for the tax accessor	Per G-003, furniture in TAX assessor's office to be relocated from 2 <sup>nd</sup> floor to temporary TAX office on 1 <sup>st</sup> floor. After 2 <sup>nd</sup> floor work is completed, furniture is to be reinstalled in its original location. All other existing furniture is to remain. GC is responsible for protecting all existing furniture.
Q16	How many signs of each type are we to include Ref. DWG. A-303, signage schedule Please provide a signage schedule.	Refer to drawings issued as part of Addendum #3 Please find revised finish plans, A-111 through 114 and signage details on A-303. Signage symbol S-# has been added on finish plans. Signage type, details, note, etc. have been modified on A-303.
Q17	Will the architect accept Melamine Plastic, Class A Fire retardant, ADA Compliant, Sand blasted signs instead of aluminum? With Aluminum, the letters and Braille are glued on because you can't etch those on to an aluminum sign. Sand blasted is when the entire sign has braille and text etched out of one piece. Also, they can choose the manufacturer's standard colors for the sign. I can't offer that in aluminum. They are also fire retardant. See attached specs and color chart.	No, it is not acceptable. The signage has been designed as per Westchester Building Standard.
Q18	Please clarify the difference phases	Phasing to be per drawing G-003. Mechanical, Electrical, Plumbing, & Fire Protection work to be coordinated with the phases on G-003.
Q19	Can we work on the 1 <sup>st</sup> floor & 2 <sup>nd</sup> floor at the same time?	It is not acceptable.
Q20	Is the relocation of the tax accessors office a separate phase?	Per DWG G-003, Temporary TAX office is part of Phase I and shall be completed before phase 1 demolition occurs. Temp. TAX office demolition and reinstall furniture and equipment at 2 <sup>nd</sup> floor is part of Phase II.
Q21	What is the deck-to-deck heights for the 1 <sup>st</sup> floor and 2 <sup>nd</sup> floor (bottom of floor slab to bottom of ceiling slab)	<ul> <li>1<sup>st</sup> floor top of slab to 2<sup>nd</sup> floor bottom of slab is approx. 14 feet.</li> <li>2<sup>nd</sup> floor top of slab to 3<sup>rd</sup> floor bottom of slab is approx. 12 feet.</li> </ul>

Q22	General Note #1 on A-101 through A-104 indicates to "Patch & Repair Existing Wall/Partition as required. Prepare existing walls to accept new finish." Please confirm this note addresses wall within the corridors that are to receive new paint finishes indicated on the finish plans	General Note #1 shall apply to walls receiving new finishes per finish plans. Walls/partitions which are damaged during work, shall be repaired and refinished to match existing. GC shall photo document existing damages prior to start of work.
Q23	Keynote #1 on A-101 and A-103 indicates to apply skim coat level 4 finishes over existing surfaces. Please confirm this note is directed for use at the Lobby Vestibule L1 and 2 <sup>nd</sup> floor Elevator Lobby L-212 only.	Yes.
Q24	Please confirm all other existing partitions to remain (except for two RFIs above) within the construction areas are existing to remain and no new finishes/paint is required unless affected by MEP trades.	At all existing wall/partition to remain. GC should patch & repair damage on the existing wall/partition affected by MEP work. Provide new finishes/paint as indicated on construction documents.
Q25	DWG A109 indicates Open Cell Spray Foam. Spec section 072100 indicates Closed Cell Type Insulation. Please confirmed material is closed cell at the Garage Level B2.	The note on A-109 has been revised. GC to provide closed cell spray foam.
Q26	The Mechanical drawings include notes to provide new fin tube covers to match existing. DWG A300 provides a detail that does not include enough information to quote. Please review and provide manufacturer and model numbers.	The manufacturer is Vulcan Radiator, and the enclosure model number is V4-ARPM/PM2 Pedestal Mounted. Finish to be determined.
Q27	Please confirm slab-to-slab heights from top of floor slab to bottom of ceiling slab for the 1 <sup>st</sup> and 2 <sup>nd</sup> floors at 110 / 111 M. King Blvd.	See Q23 response for 110 MLK.
Q28	DWG 135 Elevator at 111 MLK indicates the added steel required and references details for the roof slab removal. The note in detail 3 indicates Ceiling Removal & Replacement. It appears from the section the existing ceiling is approximately 15 feet below the roof slab where the new steel is required to be installed. Are there other existing mechanicals in this area that would impede access to the work or that would need to be temporarily relocated in order to complete the work? What is the existing ceiling? Is it an occupied office?	The area indicated in detail #3 on A135 is elevator lobby and the existing finish ceiling is acoustical ceiling tile. GC to verify the existing condition above the existing finish ceiling.
Q29	DWG 131 Elevator at 110 MLK indicates the added steel required which appears to span through the top of the elevator shaft and into what may or may not be an elevator lobby. What are the existing conditions in this area such as ceiling, lighting and/or mechanicals that may need to be relocated or removed to complete this work?	Additional steel is within the shaft at the top. See photos of the elevator shaft likely area. There is a new gypsum board ceiling in the elevator lobby on 3 <sup>rd</sup> floor.
•	MEP Questions	

No.	Contractor Question	Answer
Q30	Mechanical Ductworks plans M101 thru M105 indicate and add alternate toe replace all existing duct mains with new, please clarify the following: a. What duct mains are we to include (risers, vertical mains, horizontal mains, etc.) b. Is this for the entire building or only within our areas of work?	The Alternate #1 refers to the duct risers and horizontal mains from the mechanical room to the shaft which are boxed out on each floor and called to be provided with Aeroseal. The alternate is for replacement of the mains in lieu of the Aeroseal which is base scope.
Q31	Mechanical Ductwork plans M102 & M104 indicate to Aeroseal all existing mains, please clarify the following: a. What duct mains are we to include (different systems, risers, vertical mains, horizontal mains, etc.) b. Is this scope for the entire building or only within our areas of work	All existing risers and horizontal mains as boxed out on plan. See response to Q30 above.
Q32	The Electrical Drawing E-204 shows light fixture "F4" in the bathroom next to the elevator shaft. However, the light fixture schedule on Dwg A- 304 does not include "F4". Please, provide manufacture information for "F4" light fixture.	Refer to drawings issued as part of Addendum #3
Q33	The specified Vulcan baseboard element is only capable of producing and output of 580 BTU/ft. at the specified AWT. However, the schedule calls for an output of 1,060 BTU/ft. Please clarify.	Capacity shown is for 2 tier element
Q34	The following and attached specifications list basis of design manufactures and a list of system components basis of design. The basis of design manufacturer is in the specification s is EST or Edwards Fire Safety. Drawing FA-010 contains a contradicting note that the basis of design is Johnson Controls. Specification Section 263111 2. 1 A Manufacturers List Basis of Design (See Attached) Specification Section 263111 2. 5 System Components-Addressable Device Basis of Design Components (See Attached) Drawing FA-010 Fire Alarm Symbols Abbreviations Schedules & Notes (See Attached)	The base building fire alarm vendor is Johnson Controls. See Q2 response for additional information.
•	Elevator Questions	

No.	Contractor Question	Answer
Q35	Please advise who hold the current elevator maintenance contract with this property	Willie Seiz   Modernization Manager Slade Industries, Inc. Mountainside, NJ 07972 347.582.6366   <u>wseiz@slade-elevator.com</u>
Q36	Please advise make and model of current elevator	110 & 111 MLK- Westinghouse, 143 Grand- Dover
Q37	The specifications for the elevators indicate we can only use an approved equal manufacturer for the elevator control systems. Please confirm if any OEM controller (TK Elevator, Otis, KONE, Schindler) is acceptable.	Non-OEM controller is required. OEM controller is not acceptable.
Q38	Will the elevators be on emergency power or will battery lowering need to be provided? (110 MLK, 111 MLK)	111 MLK Emergency Power is available with ATS. For 110MLK traction elevators since emergency power is not currently available, battery lowering is required. Elevator must be wired ready for future emergency power hookup and controllers must have the required module for it.
Q39	Warranty Period – 1 year or 2 years? (110MLK, 111 MLK, 143 Grand)	Warranty period will be 1 year including all labor and materials and 24/7/365 callback. Warranty period to start once elevator has passed all inspections and is signed off by County's Code Enforcement. Contractor shall perform a Category 1 Test 1 month prior to the end of the warranty period and make any required repairs. The test shall be witnessed by County's elevator Inspector. At the conclusion of the test contractor shall also inspect and adjust the ropes as necessary. The elevator Contractor shall also be present for the Biannual inspection during the warranty period.
Q40	When does maintenance on these elevator begin? (110MLK, 111 MLK, 143 Grand)	Maintenance by County's elevator vendor will begin when warranty expires.
Q41	Does Cab platform and sling need to be replaced? If yes, what is the new platform rating? In addition, do the car safety and underslung sheaves need to be replaced as well? (110 MLK, 111 MLK, 143 Grand)	New platforms and slings have been specified but the capacity rating will be the same. Car safety and underslung sheaves will be replaced as specified.
Q42	There are currently Hall Lanterns for the existing elevators – Specification indicates to provide car lantern. Is the intent to remove Hall Lanterns and Provide Car Lanterns? If it is to keep existing Hall Lanterns, will Hall Position Indicators be integrated with Hall Lanterns? (110 MLK, 111 MLK)	Replace hall lanterns with new hall lanterns. Integrate position indicators with hall button stations. Car lanterns are not required. Section 142150 2.08 C (110 ,111 143) has been deleted.

Q43	Is Rath an approved communication device? (110 MLK, 111 MLK, 143 Grand)	Alternates to specified manufactures shall be reviewed after bid award. Bids should be based upon specifications.
Q44	Is Elevator Controls – Pixel and approved Control System? (110 MLK, 111 MLK, 143 Grand)	Alternates to specified manufactures shall be reviewed after bid award. Bids should be based upon specifications.
Q45	Can we start elevator work earlier than 7:30 am? (110 MLK, 111 MLK, 143 Grand)	Working hours: 7:00 – 4:00 (Q7 response)
Q46	Is Remote Elevator Monitoring Required for these elevators? (110 MLK, 111 MLK, 143 Grand)	Yes, as required by current Elevator Code. Emergency Communications Section 2.08 E will be amended to include the requirement of the latest applicable code. Elevator emergency communication must include: Two-way (text- based) messaging capability. Video capability. A display message to indicate call has been received and help is on the way and/or onsite.
Q47	Will storage be required to be provided for Elevator Company? (110 MLK, 111 MLK, 143 Grand)	WC will provide a location for material storage. GC is responsible to secure materials on site and to provide secure fencing etc.
Q48	Will parking be available for Elevator Installation Crew? (110 MLK, 111 MLK, 143 Grand)	No Parking shall be provided, contractor and his personnel to park in adjacent municipal parking lot at their own expense
Q49	Is a new lobby panel required? If so, where would the new location be? If not, is there a tie in required? (110 MLK, 111 MLK, 143 Grand)	Yes. Location to be determined.
Q50	Spec Section 142150 – Elevator Modernization This spec section refers to Security card readers, cab cameras and wiring and security contractors. Please clarify the scope of this work, who the security contractor is, and if this work is part of the GC's scope. This work will not be performed by the elevator contractors.	111 MLK only-All work and material (except cameras and housing but including power, all wiring and connectors) needed from the elevator controller to the tops of cars and the location of the server will be included in the scope of work. For 110MLK and 143 Grand the security option is removed from the scope. Appendix II will not apply to these addresses.
•	Elevator Questions (110 MLK)	
No.	Contractor Question	Answer
Q54	Is the intent to replace the overhead sheaves?	Yes
Q55	Please confirm that these elevators stop at B3, B2, G, 2 & 3	Correct.
Q56	Is the intent to move the governors from the overhead to the pit? – If not, will overhead access to the governor be provided?	Governors to be located in pits with properly labeled remote switches that will be located and operated from the controllers. Proper signage shall be provided in the pit on or near the governor.
•	Elevator Questions (111 MLK)	1
No.	Contractor Question	Answer

Q57	Can a new machine room door be provided from the side in lieu of current location to get direct access to machine room floor? If not, can the machine room floor be raised to maintain the same height as the current machine room door?	The floor will not be raised. No additional doors will be allowed.
Q58	Is the intent to replace the deflector sheave?	Yes
Q59	Please verify if Key Switches will be required with Corridor Pushbuttons or will card reader be sufficient	For any work pertaining to additional security the County will hire a spate security vendor that will work with the elevator company. The decision on whether the key switches will be replaced with card readers has not been made. For bid purposes the Contractor is to reconnect all existing equipment.
Q60	Please verify that this elevator will operate as a simplex	The current operation will be maintained.
Q61	Please verify if speed of elevator is 200 fpm or 500 fpm	200 fpm.
Q62	Please confirm that this elevator stops at B2, B, G, $2^{nd}$ floor to $19^{th}$ floor	Correct.
•	Elevator Questions (143 Grand)	
No.	Contractor Question	Answer
Q63	Please confirm that this elevator is a 4 stop	Confirmed.
Q64	Please confirm the speed for this elevator is 150 fpm	200 fpm.
Q65	Is only the entrance frame to be cladded at the floor 1 only?	Yes
Q66	Current railing is Omega? – do the existing car sliding guides need to be replaced with new Roller Guide Shoes or can the inserts be replaced?	New Roller Guides shall be provided.
Q67	Is the intent to provide Hall Position Indicators separately or to be integrated with Hall Pushbutton Stations?	Provide Hall Position Indicators integrated with Hall stations.
Q68	Dwg M-098 indicates the replacement of 4 existing VFDs but there is no information provided regarding the manufacturer or model number. Please provide the specifications for the VFDs required or provide the model number of the existing pumps.	PCE 2/21/24: Refer to specification 230513.1 for VFD specifications and requirements.

# ALL PROVISIONS OF THE CONTRACT NOT AFFECTED BY THE FOREGOING SHALL REMAIN IN FULL FORCE AND EFFECT.

# COUNTY OF WESTCHESTER DEPARTMENT OF PUBLIC WORKS AND TRANSPORTATION

By: Hugh J. Greechan, Jr., PE Commissioner

Dated: <u>02-21-24</u> WHITE PLAINS, NEW YORK LUMP SUM PROPOSAL

CONTRACT NO. <u>20-502</u>

# BASE BID ITEMS

ITEM DESCRIPTION		BID PRICE IN	FIGURES
	DESCRIPTION		CENTS
A	For providing all labor, material and equipment necessary to complete all work as shown on the contract drawings and in accordance with the specifications for the Low Rise Building Renovations and HVAC Improvements – Phase II, 110 Dr. Martin Luther King, JR. Boulevard, White Plains, New York		
В	Contract Bonds and Insurance (Must not exceed 3.00% of Item A above)		
С	Necessary for miscellaneous additional work per Article "Miscellaneous Additional Work (Item W-800)" of the Information for Bidders, as directed.	\$ 900,000	00
D	Testing of Materials and Field Testing Equipment (Item W-851)	\$ 100,000	00
ΤΟΤΑΙ	L SUM OF AMOUNT BID FOR BASE BID ITEMS A, B, C & D (WRITTEN IN FIGURES	DOLLARS	CENTS
COMPLET	<u>FE THIS FORM USING BLACK INK ONLY</u>		
(WC DPW&T	PROPOSAL PAGE 6 Version 5/14)		

# LUMP SUM PROPOSAL - ALTERNATES


# CONTRACT NO. <u>20-502</u>

# ALTERNATE LUMP SUM ITEMS

	DESCRIPTION	BID PRICE IN FIGURES		
ITEM	DESCRIPTION	DOLLARS	CENTS	
1	For providing all labor, material and equipment to replace the duct risers and horizontal mains from the mechanical room to the shaft which are boxed out on each floor including all associated construction work in lieu of Aeroseal installation as described in the contract documents and the addendum #3.			
COMPLE	<u>TE THIS FORM USING BLACK INK ONLY</u> PROPOSAL PAGE 6A			

(WC DPW&T Version 5/14)

GROSS SUM OF TOTAL BID AMOUNT	CONTRACT 1	NO. <u>20-502</u>
TOTAL BID FOR "BASE BID + ALTERNATE 1" (Written in Figures)	DOLLARS	CENTS
TOTAL BID FOR "BASE BID (Written in Figures)	DOLLARS	CENTS
 BY:	Sig	nature/Title
<b>BASIS OF AWARD</b>		
This contract consists of the Base Bid and ONE (1) Add Alternate, Alternate 1 as defined in Drawings.	the Specifications and	on the
It is the goal of the County to award the Base Bid and Alternate 1 if the low bid for all items this project. If the Base Bid and Alternate 1 exceed the amount budgeted for this project, the bidder submitting the lowest Base Bid.		
PROPOSAL PAGE 6B		
(WC DPW&T Version 5/14)		

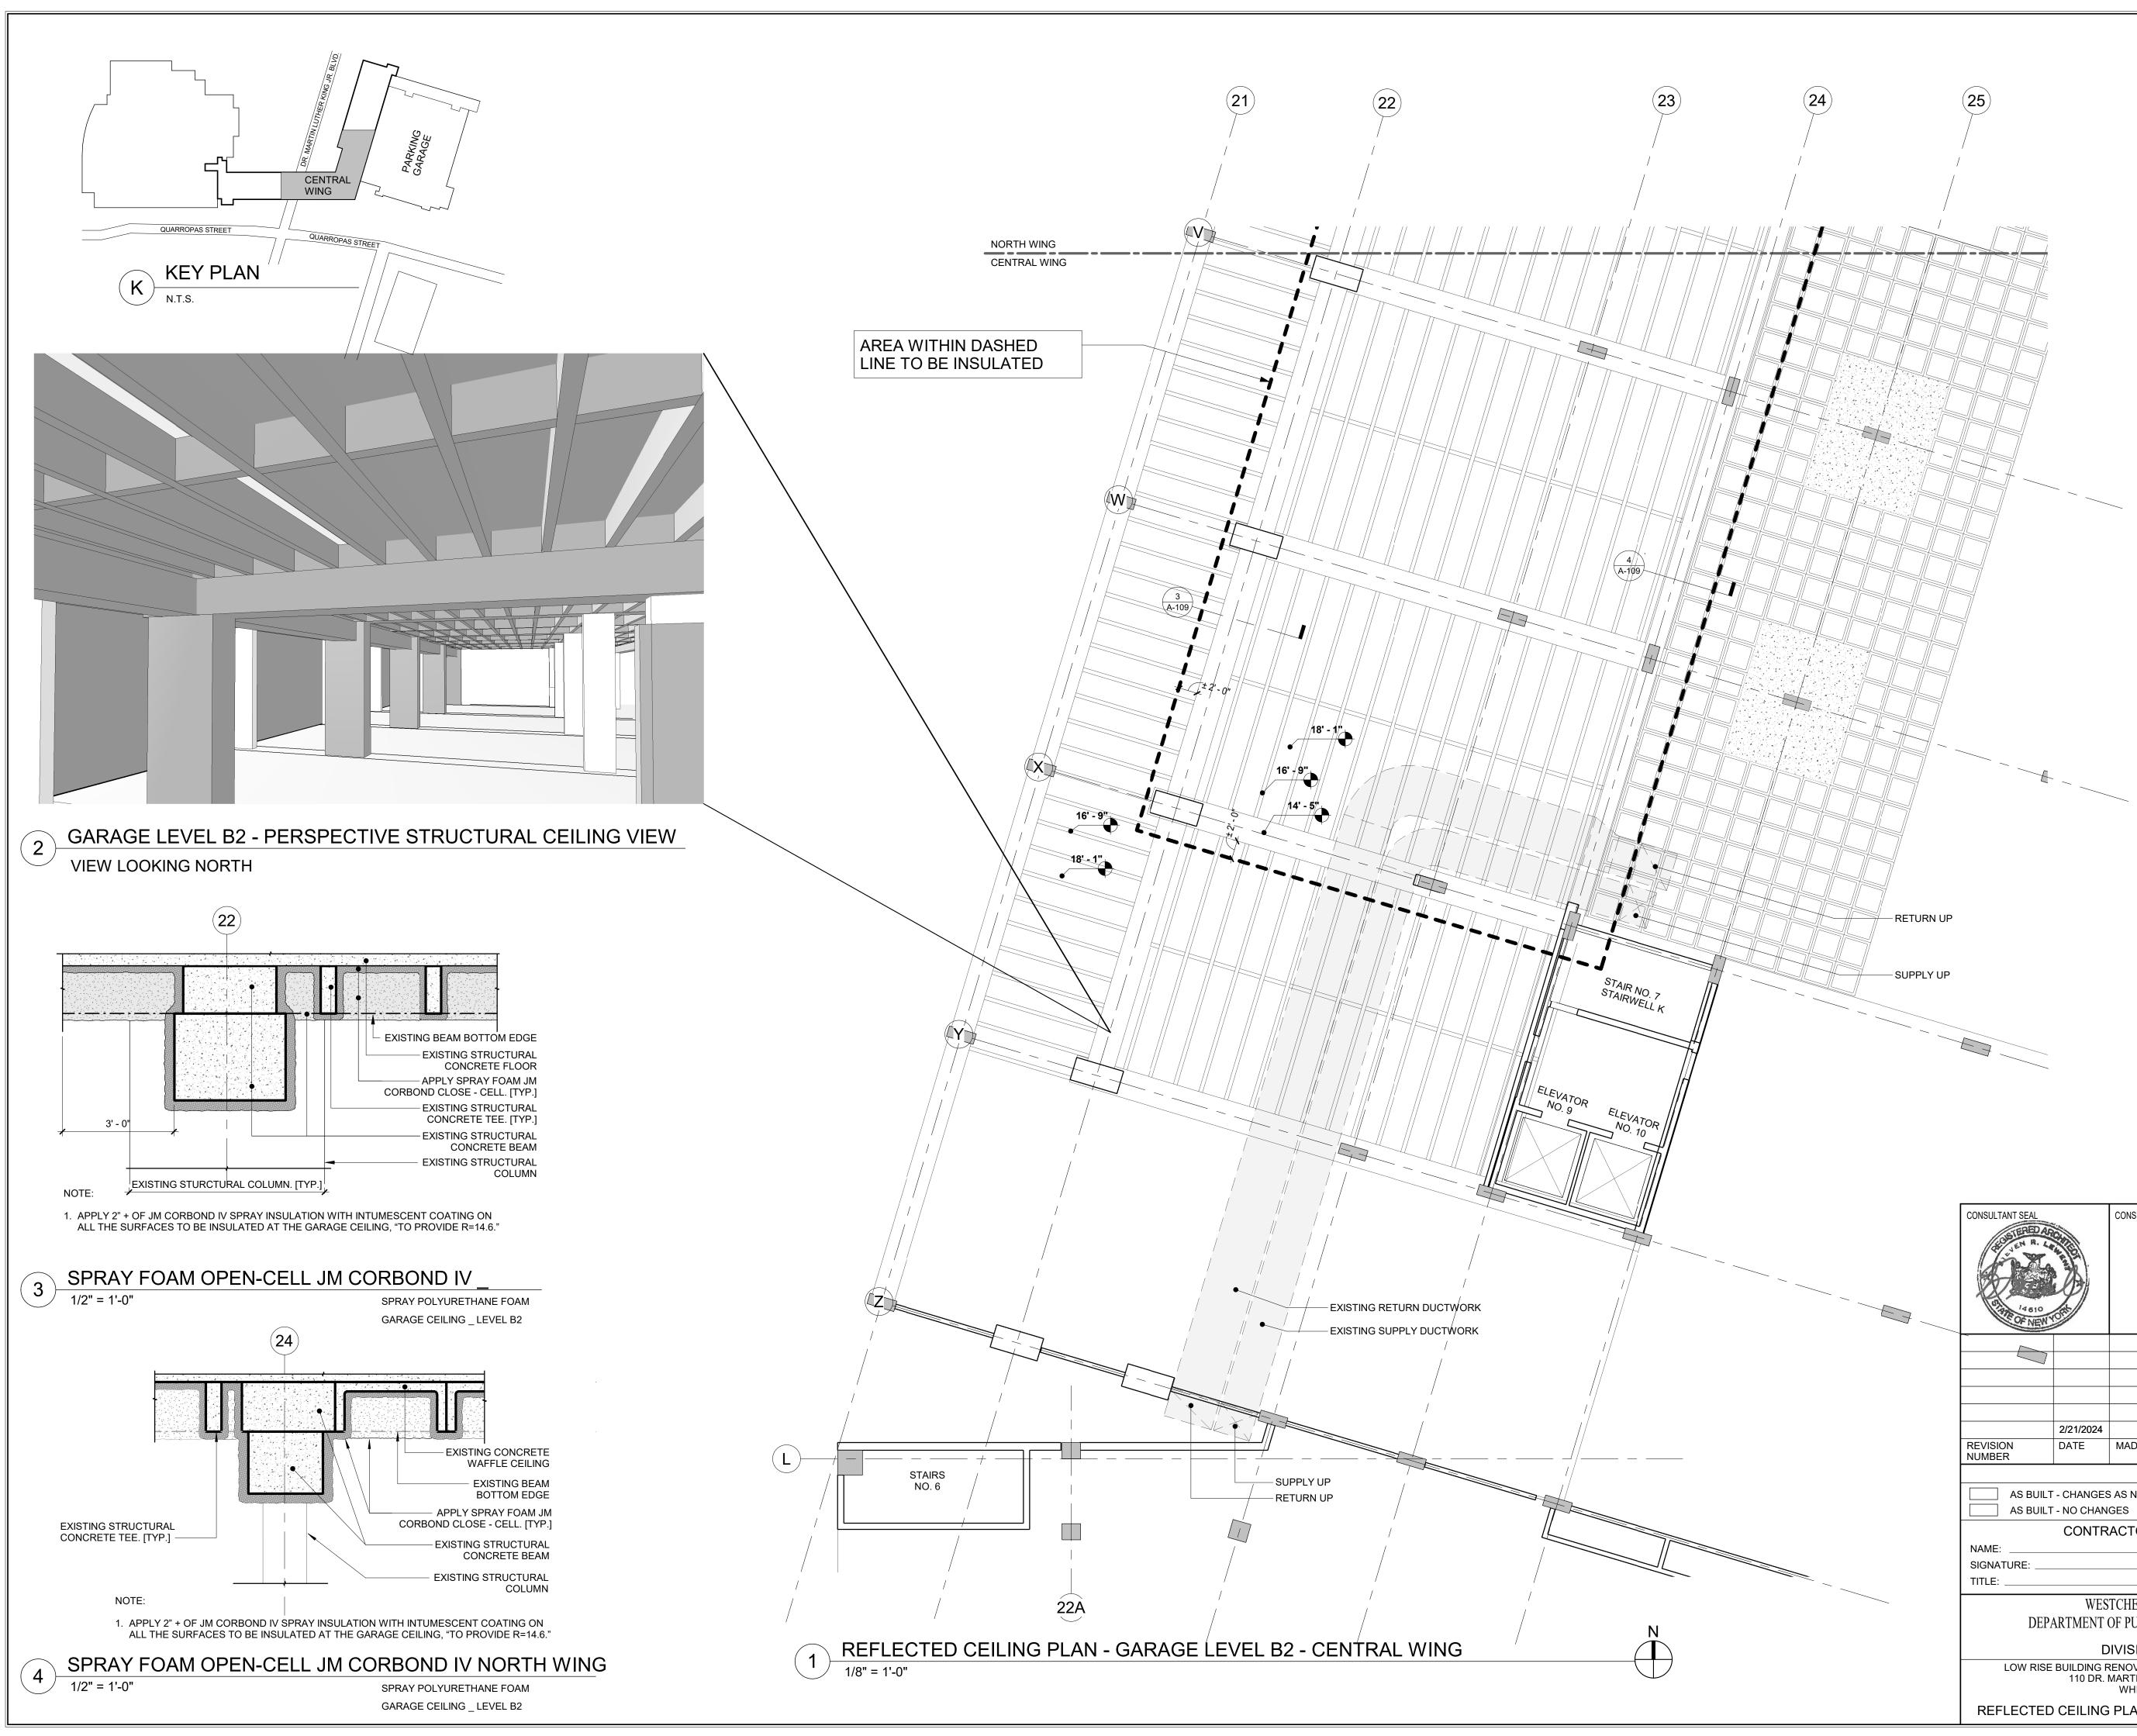

[						
REFLECTIVE CEILING PLAN LEGEND GARAGE LEVEL B2						
SYMBOL	DESCRIPTION					
	— EXISTING BEAM					
	— EXISTING COLUMN					
	— EXISTING BEAM					
	— EXISTING COLUMN					
	— EXISTING CONCRETE FILL — EXISTING COLUMN					
	EXISTING STRUCTURAL CONCRETE TEE					
	EXISTING STRUCTURAL CONCRETE WAFFLE CEILING					
RETURN	EXISTING SUPPLY AND RETURN DUCT WORK. SEE MECH. DWG M-101 FOR INSULATION.					

- 1. WITHIN AREA TO BE INSULATED, APPLY MANVILLE CORBOND IV IN THICKNESS REQUIRED TO PROVIDE R=14.6. APPLY MANVILLE FIRE SAFETY INTUMESCENT NO BURN OVER SPRAYED INSULATION. MAKE ACCOMMODATIONS FOR APPLICATION ABOVE AND AROUND EXISTING DUCTS, PIPES, ETC.
- 2. COORDINATE ALL WORK WITH PARKING GARAGE REHABILITATION PROJECT WHICH INCLUDES CONCRETE PATCHING & SPRINKLER REPLACEMENT. PROTECT ALL EXISTING HVAC, SPRINKLERS, LIGHT FIXTURES, ETC.
- 3. PRIOR TO INSULATION INSTALLATION, ENSURE THAT ALL COMPONENTS OF NEW SYSTEMS REQUIRED TO BE INSTALLED PRIOR TO INSULATION SPRAY ON ARE IN PLACE.

CONSULTANT SEAL	CONSULTANT	INFORMATION					
REDATEREDAT	Graf & Lewent Architects LLP 90-30 161st Street, Jamaica, NY 11432 P: 718-651-6200 F: 718-251-6989						
	0/04/0001						
REVISION	2/21/2024 DATE		עם חיססע				
NUMBER		MADE BY APP'D BY REVISION			ON		
		RE		AWIN	G CERTIFICATION		
AS BUILT - CHANGES AS NOTED AS BUILT - NO CHANGES							
	CONTR	ACTOR			CONT	RACTOR	
NAME:					NAME:		
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		DATE	<u> </u>				
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DEPARTMENT OF PU			F PUBLIC WORKS AND TRANS		NSPORTATION	20-502	A-109
DIVISION OF ENGINEERING			NG	SHEET NO. 24	OF 133		
LOW RISE BUILDING RENOVATIONS AND HVAC IMPROVEM				SCALE:	As indicated		
	110 DR. MARTIN LUTHER KING, JR. BOU WHITE PLAINS, NEW YORK			LEVARD	DATE: 01-19-2024	Issue Date	
REFLECTED	CEILING	IG PLAN - GARAGE LEVEL B2 - CENTRAL			B2 - CENTRAL WING	DPW FILE NO. 52-11-	A-1836-0

PARA GARA CENTRAL WING / QUARROPAS STREET QUARROPAS STREET K KEY PLAN





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FINISH PLAN LEGEND							
SYMBOL	DESCRIPTION						
<b>P-</b>	PAINT FINISH						
<b>SS-</b>	SOLID SURFACE PANELS						
<b>CT-</b>	CERAMIC WALL TILES						
SB-	STAINLESS STEEL WALL BASE						
<b>CB-</b>	COVE BASE						
<b>VB-</b>	VINYL BASE						
C->	CARPET FLOOR						
CT-	CERAMIC FLOOR TILE						
VT-	RESILIENT FLOOR TILES						
CR	CRASH RAIL						
CG	CORNER GUARD						
<b>S#</b>	SIGNAGE SEE SIGNAGE DETAIL ON A303						

1. SEE A-304 FOR SCHEDULE OF FINISHES.


2. BASE **VB**-1 IS TYPICAL TO ALL WALLS AND PARTITIONS, EXISTING AND NEW UNLESS OTHERWISE NOTED.


3. SEE REFLECTED CEILING PLANS AND ELEVATIONS FOR ADDITIONAL FINISH INFORMATION.

4. EXISTING FLOORING IN WORK AREAS TO BE REMOVED AND SUBSTRATE PREPARED FOR NEW FLOOR FINISH.

5. EXISTING DOOR & FRAME PAINT MATCH TO ADJACENT WALL PAINT.

CONSULTANT SEAL	CONSULTANT	90	)-30 1	f & Lewer Architects LI 61st Street, Jamaica, 3-651-6200 F: 718-2	L <b>P</b>		
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WESTCHESTER COUNTY, NEW Y DEPARTMENT OF PUBLIC WORKS AND TRA					CONTRACT NUMBER 20-502	SHEET NUMBER	
DIVISION OF ENGINEERING							OF 133
LOW RISE BUILDING RENOVATIONS AND HVAC IMPR 110 DR. MARTIN LUTHER KING, JR. BOU WHITE PLAINS, NEW YORK				OVEMENTS - PHASE II	SCALE: DATE: 01-19-2024 DPW FILE NO.	1/8" = 1'-0" Issue Date REV	
FINISH PLAN - 1ST FLOOR - CENTRAL WING					RAL WING	52-11-	A-1838-0

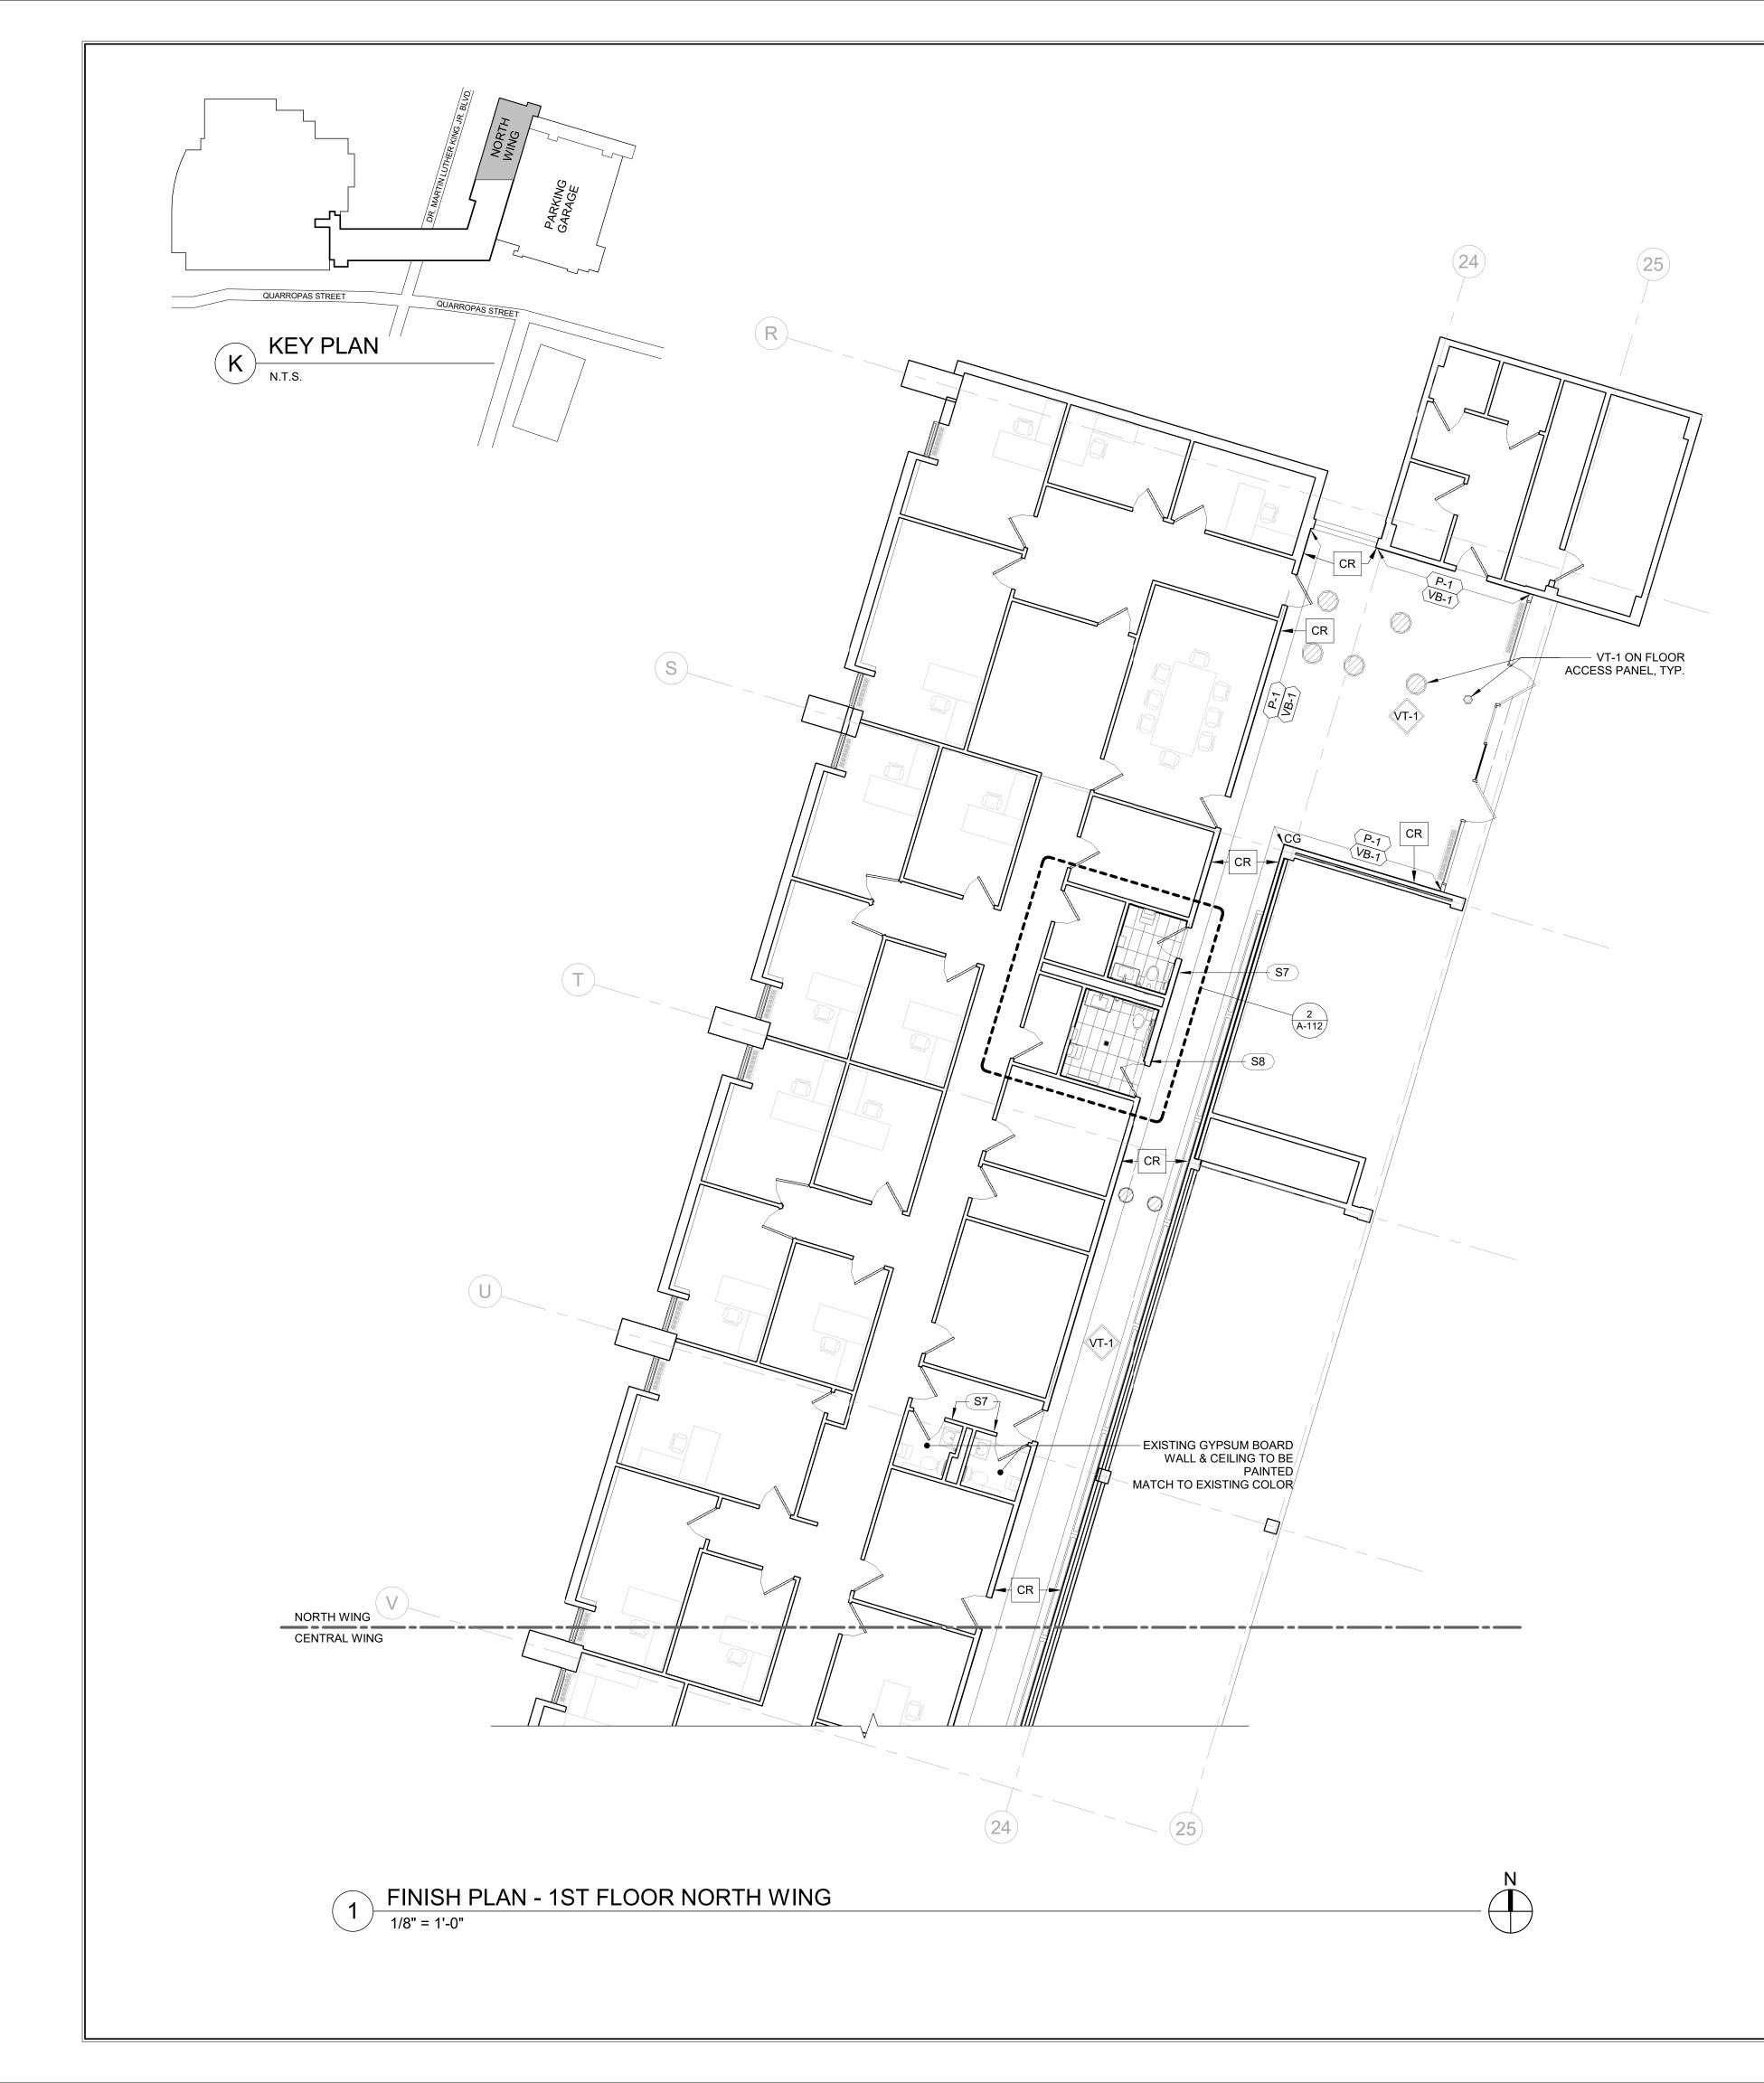

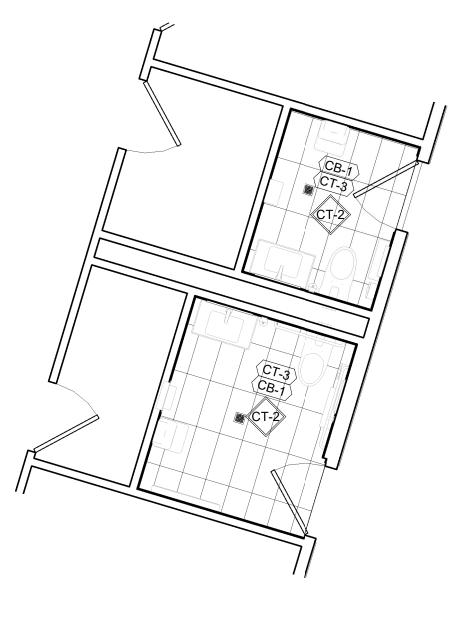



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WESTCHESTER COUNTY, NEW YORK DEPARTMENT OF PUBLIC WORKS AND TRANSPORTATION						CONTRACT NUMBER 20-502	SHEET NUMBER	
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LOW RISE BUILDING RENOVATIONS AND HVAC IMPROVED 110 DR. MARTIN LUTHER KING, JR. BOULEVA WHITE PLAINS, NEW YORK					EII	SCALE: DATE: 01-19-2024 DPW FILE NO.	As indicated Issue Date REV	
	FINISH P	LAN - 1S1	FLOOR ·	- NOR	TH WING			A-1839-0
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FIN	
SYMBOL	DESCRIPTION
<b>P-</b>	PAINT FINISH
<ul> <li>SS-</li> </ul>	SOLID SURFACE PANELS
CT-	CERAMIC WALL TILES
SB-	STAINLESS STEEL WALL BASE
<b>CB-</b>	COVE BASE
<b>VB-</b>	VINYL BASE
C-	CARPET FLOOR
Ст-	CERAMIC FLOOR TILE
VT-	RESILIENT FLOOR TILES
CR	CRASH RAIL
CG	CORNER GUARD
S#	SIGNAGE SEE SIGNAGE DETAIL ON A303

1. SEE A-304 FOR SCHEDULE OF FINISHES.

2. BASE **VB**-1 IS TYPICAL TO ALL WALLS AND PARTITIONS, EXISTING AND NEW UNLESS OTHERWISE NOTED.

3. SEE REFLECTED CEILING PLANS AND ELEVATIONS FOR ADDITIONAL FINISH INFORMATION.

4. EXISTING FLOORING IN WORK AREAS TO BE REMOVED AND SUBSTRATE PREPARED FOR NEW FLOOR FINISH.

5. EXISTING DOOR & FRAME PAINT MATCH TO ADJACENT WALL PAINT.



FINISH PLAN LEGEND						
SYMBOL	DESCRIPTION					
<b>P-</b>	PAINT FINISH					
<b>SS-</b>	SOLID SURFACE PANELS					
<b>CT-</b>	CERAMIC WALL TILES					
SB-	STAINLESS STEEL WALL BASE					
<b>CB-</b>	COVE BASE					
<b>VB-</b>	VINYL BASE					
<b>C-</b>	CARPET FLOOR					
CT-	CERAMIC FLOOR TILE					
VT-	RESILIENT FLOOR TILES					
CR	CRASH RAIL					
CG	CORNER GUARD					
S#)	SIGNAGE SEE SIGNAGE DETAIL ON A303					

1. SEE A-304 FOR SCHEDULE OF FINISHES.


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5. EXISTING DOOR & FRAME PAINT MATCH TO ADJACENT WALL PAINT.

CONSULTANT SEAL	CONSULTANT	90	)-30 1	<b>f &amp; Lewe</b> Architects Ll 61st Street, Jamaica 3-651-6200 F: 718-	L <b>P</b>		
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CONTRACTOR           NAME:					NAME:		
WESTCHESTER COUNTY, NEW Y DEPARTMENT OF PUBLIC WORKS AND TRA						CONTRACT NUMBER 20-502	SHEET NUMBER
DIVISION OF ENGINEERIN LOW RISE BUILDING RENOVATIONS AND HVAC IMPRO 110 DR. MARTIN LUTHER KING, JR. BOU WHITE PLAINS, NEW YORK FINISH PLAN - 2ND FLOOR - CENT					OVEMENTS - PHASE II LEVARD	SCALE: DATE: 01-19-2024 DPW FILE NO.	OF 133 As indicated Issue Date A-1840-0



FINISH PLAN LEGEND						
SYMBOL	DESCRIPTION					
<b>P-</b>	PAINT FINISH					
<b>SS-</b>	SOLID SURFACE PANELS					
<b>CT-</b>	CERAMIC WALL TILES					
SB-	STAINLESS STEEL WALL BASE					
<b>CB-</b>	COVE BASE					
<b>VB-</b>	VINYL BASE					
C->	CARPET FLOOR					
CT-	CERAMIC FLOOR TILE					
VT-	RESILIENT FLOOR TILES					
CR	CRASH RAIL					
CG	CORNER GUARD					
<b>S#</b>	SIGNAGE SEE SIGNAGE DETAIL ON A303					

1. SEE A-304 FOR SCHEDULE OF FINISHES.

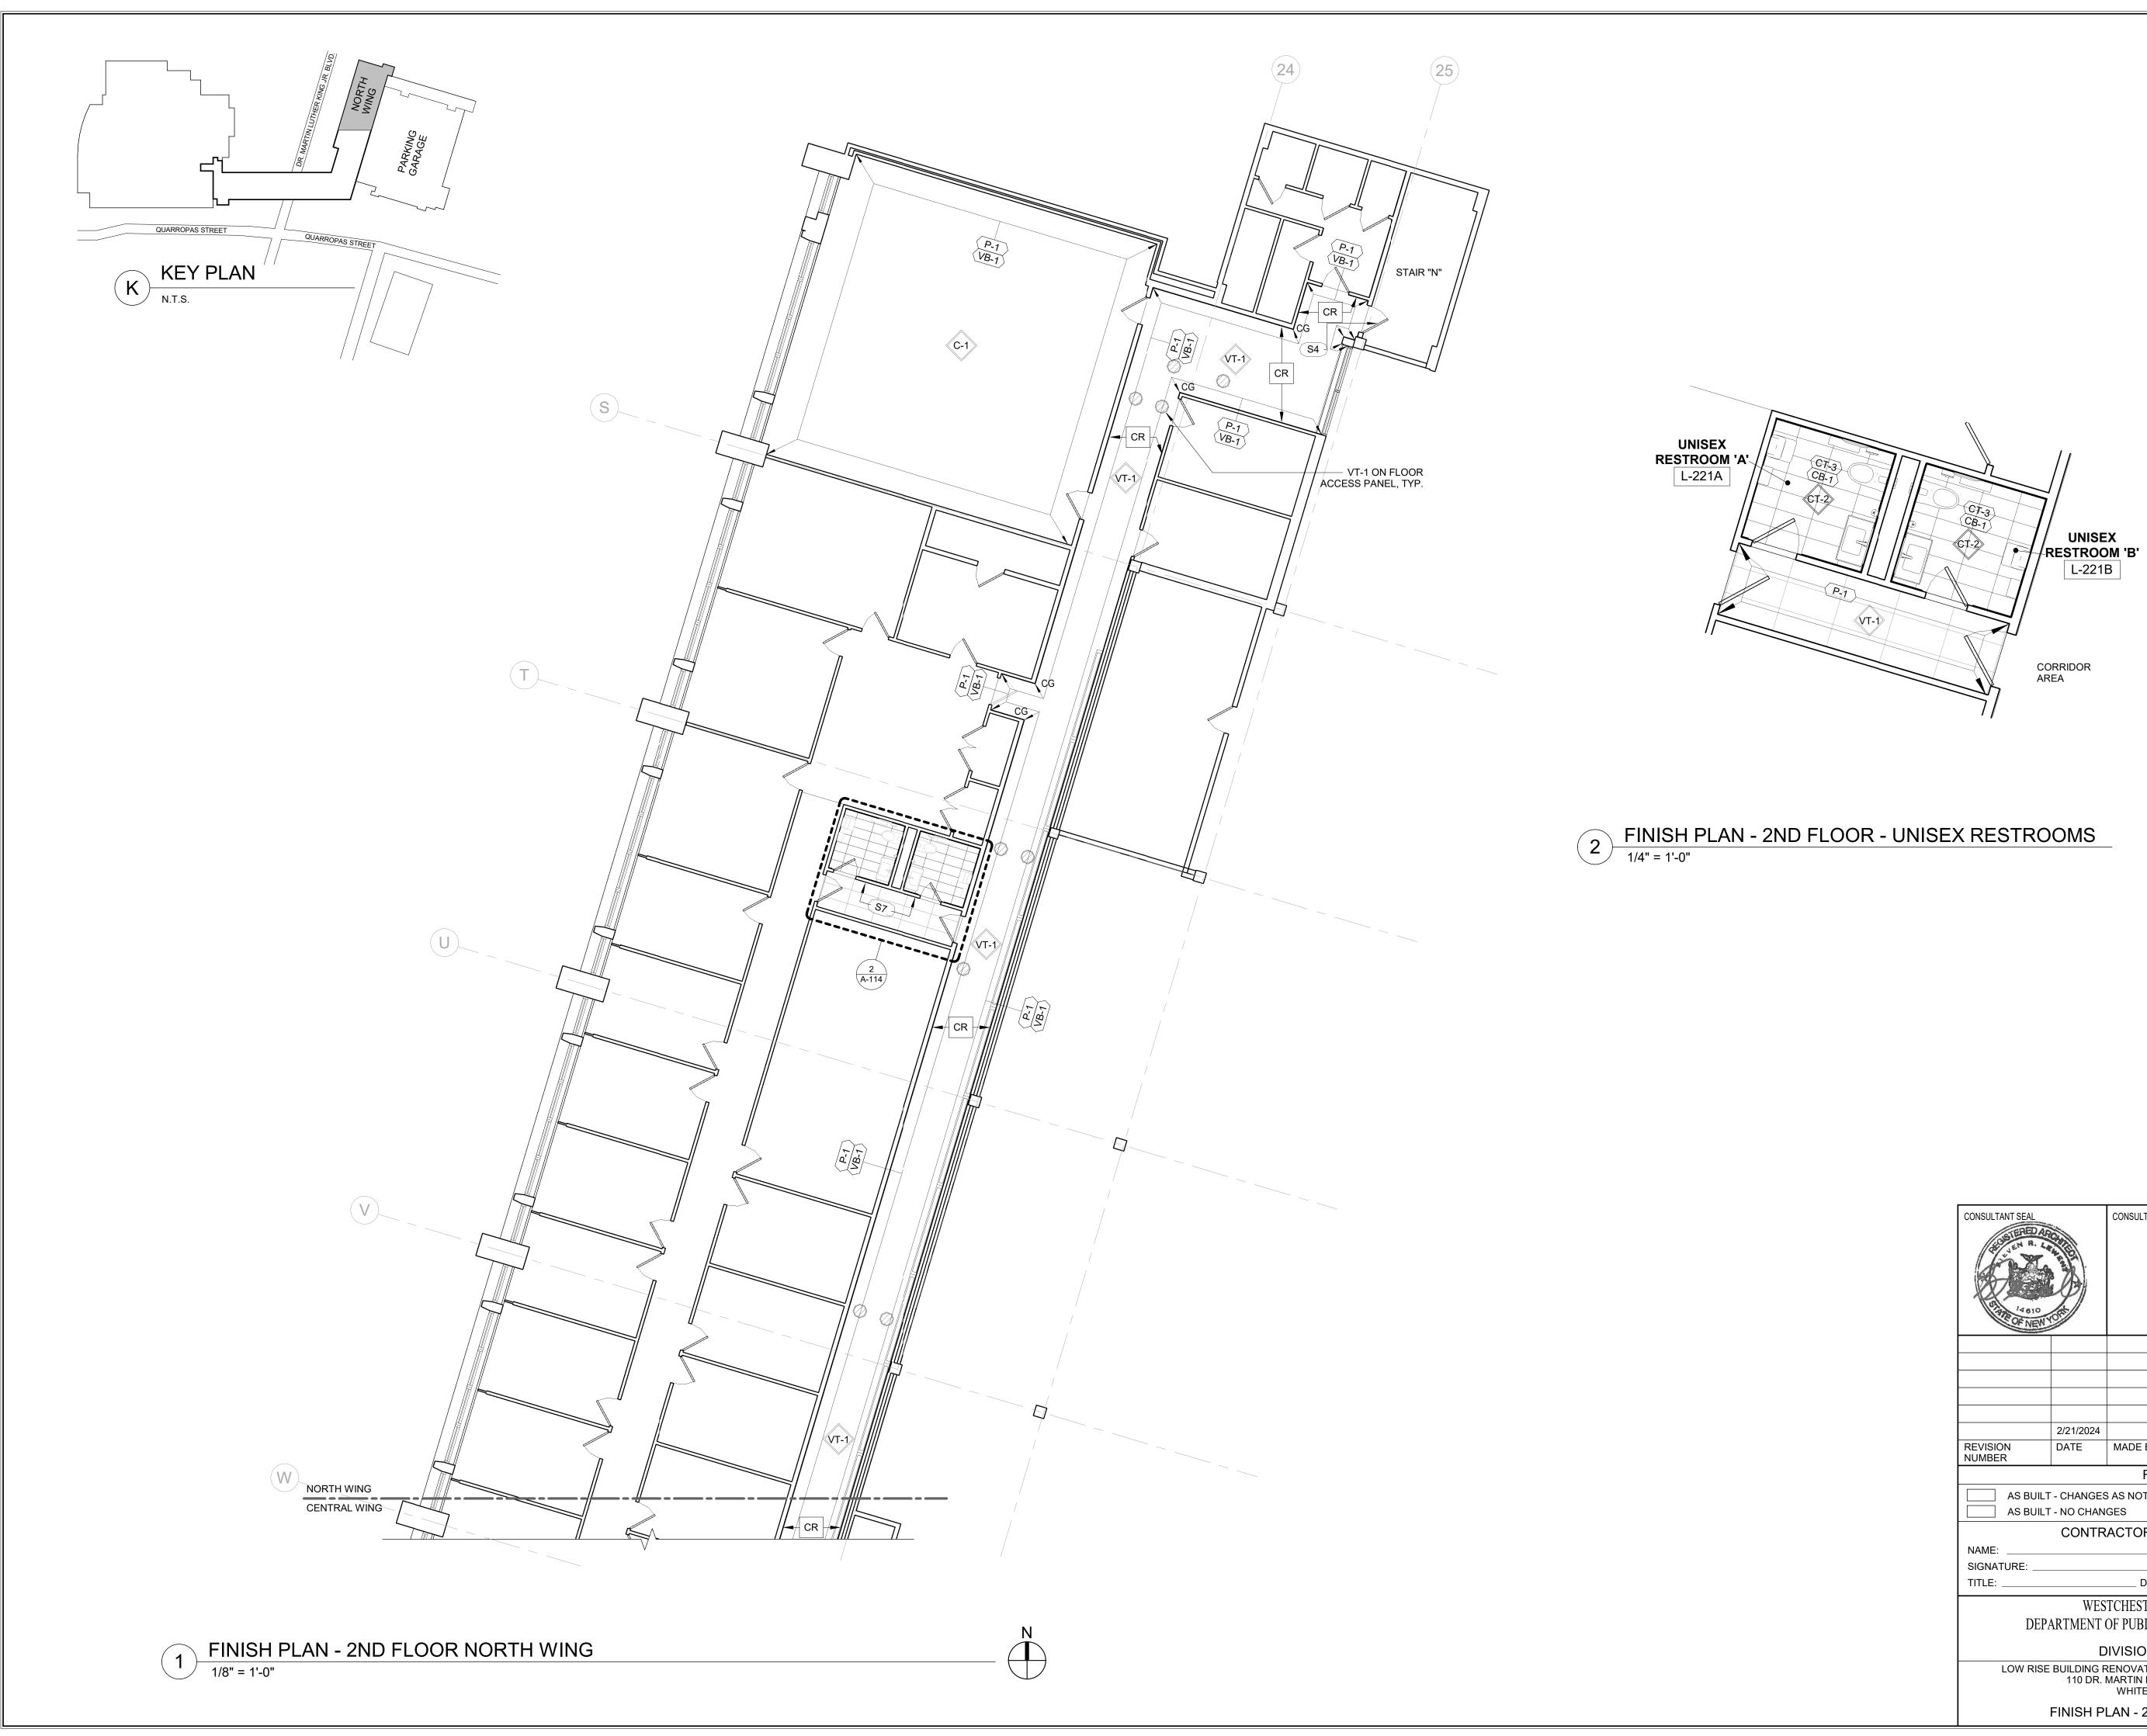
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WESTCHESTER COUNTY, NEW Y DEPARTMENT OF PUBLIC WORKS AND TRA						CONTRACT NUMBER 20-502	SHEET NUMBER	
	D			IEERII	NG	SHEET NO. 29	OF 133	
LOW RISE	E BUILDING F	RENOVATIO	NS AND HVA	C IMPR	OVEMENTS - PHASE II	SCALE:	As indicated	
110 DR. MARTIN LUTHER KING, JR. BOU WHITE PLAINS, NEW YORK					ILEVARD	DATE: 01-19-2024		
FINISH PLAN - 2ND FLOOR - NOR					TH WING	DPW FILE NO. 52-11-	A-1841-0	



	6"	,
IMPRINT VINYL (BLACK), 5/8" HELVETICA MEDIUM FONTS	STAIR-	STAIR SIGN (SEE SCHEDULE NOTES)
1/8" BRUSHED ALUMINUM PLATE IMPRINT VINYL (BLACK), MAP / FLOOR PLAN W/ LOCATION INDICATOR		
IMPRINT VINYL (BLACK),       آش         5/8" HELVETICA MEDIUM       Imprint VINYL (BLACK),         FONTS       Imprint VINYL (BLACK),         1/4" HELVETICA MEDIUM       Imprint VINYL (BLACK),         FONTS       Imprint VINYL (BLACK),		STAIR INDICATION TO BE CONFIMRED WITH WCDPW 
* * * *	••••••••••••••••••••••••••••••••••••••	BRAILLE (SEE SCHEDULE NOTES)
	NOTES • 1/32" ADA TACTILE IMPRINT VINYL • HELVETICA MEDIUM TYPESTYLE	

HELVETICA MEDIUM TYPESTYLE

• COLOR: BLACK (TYPICAL)

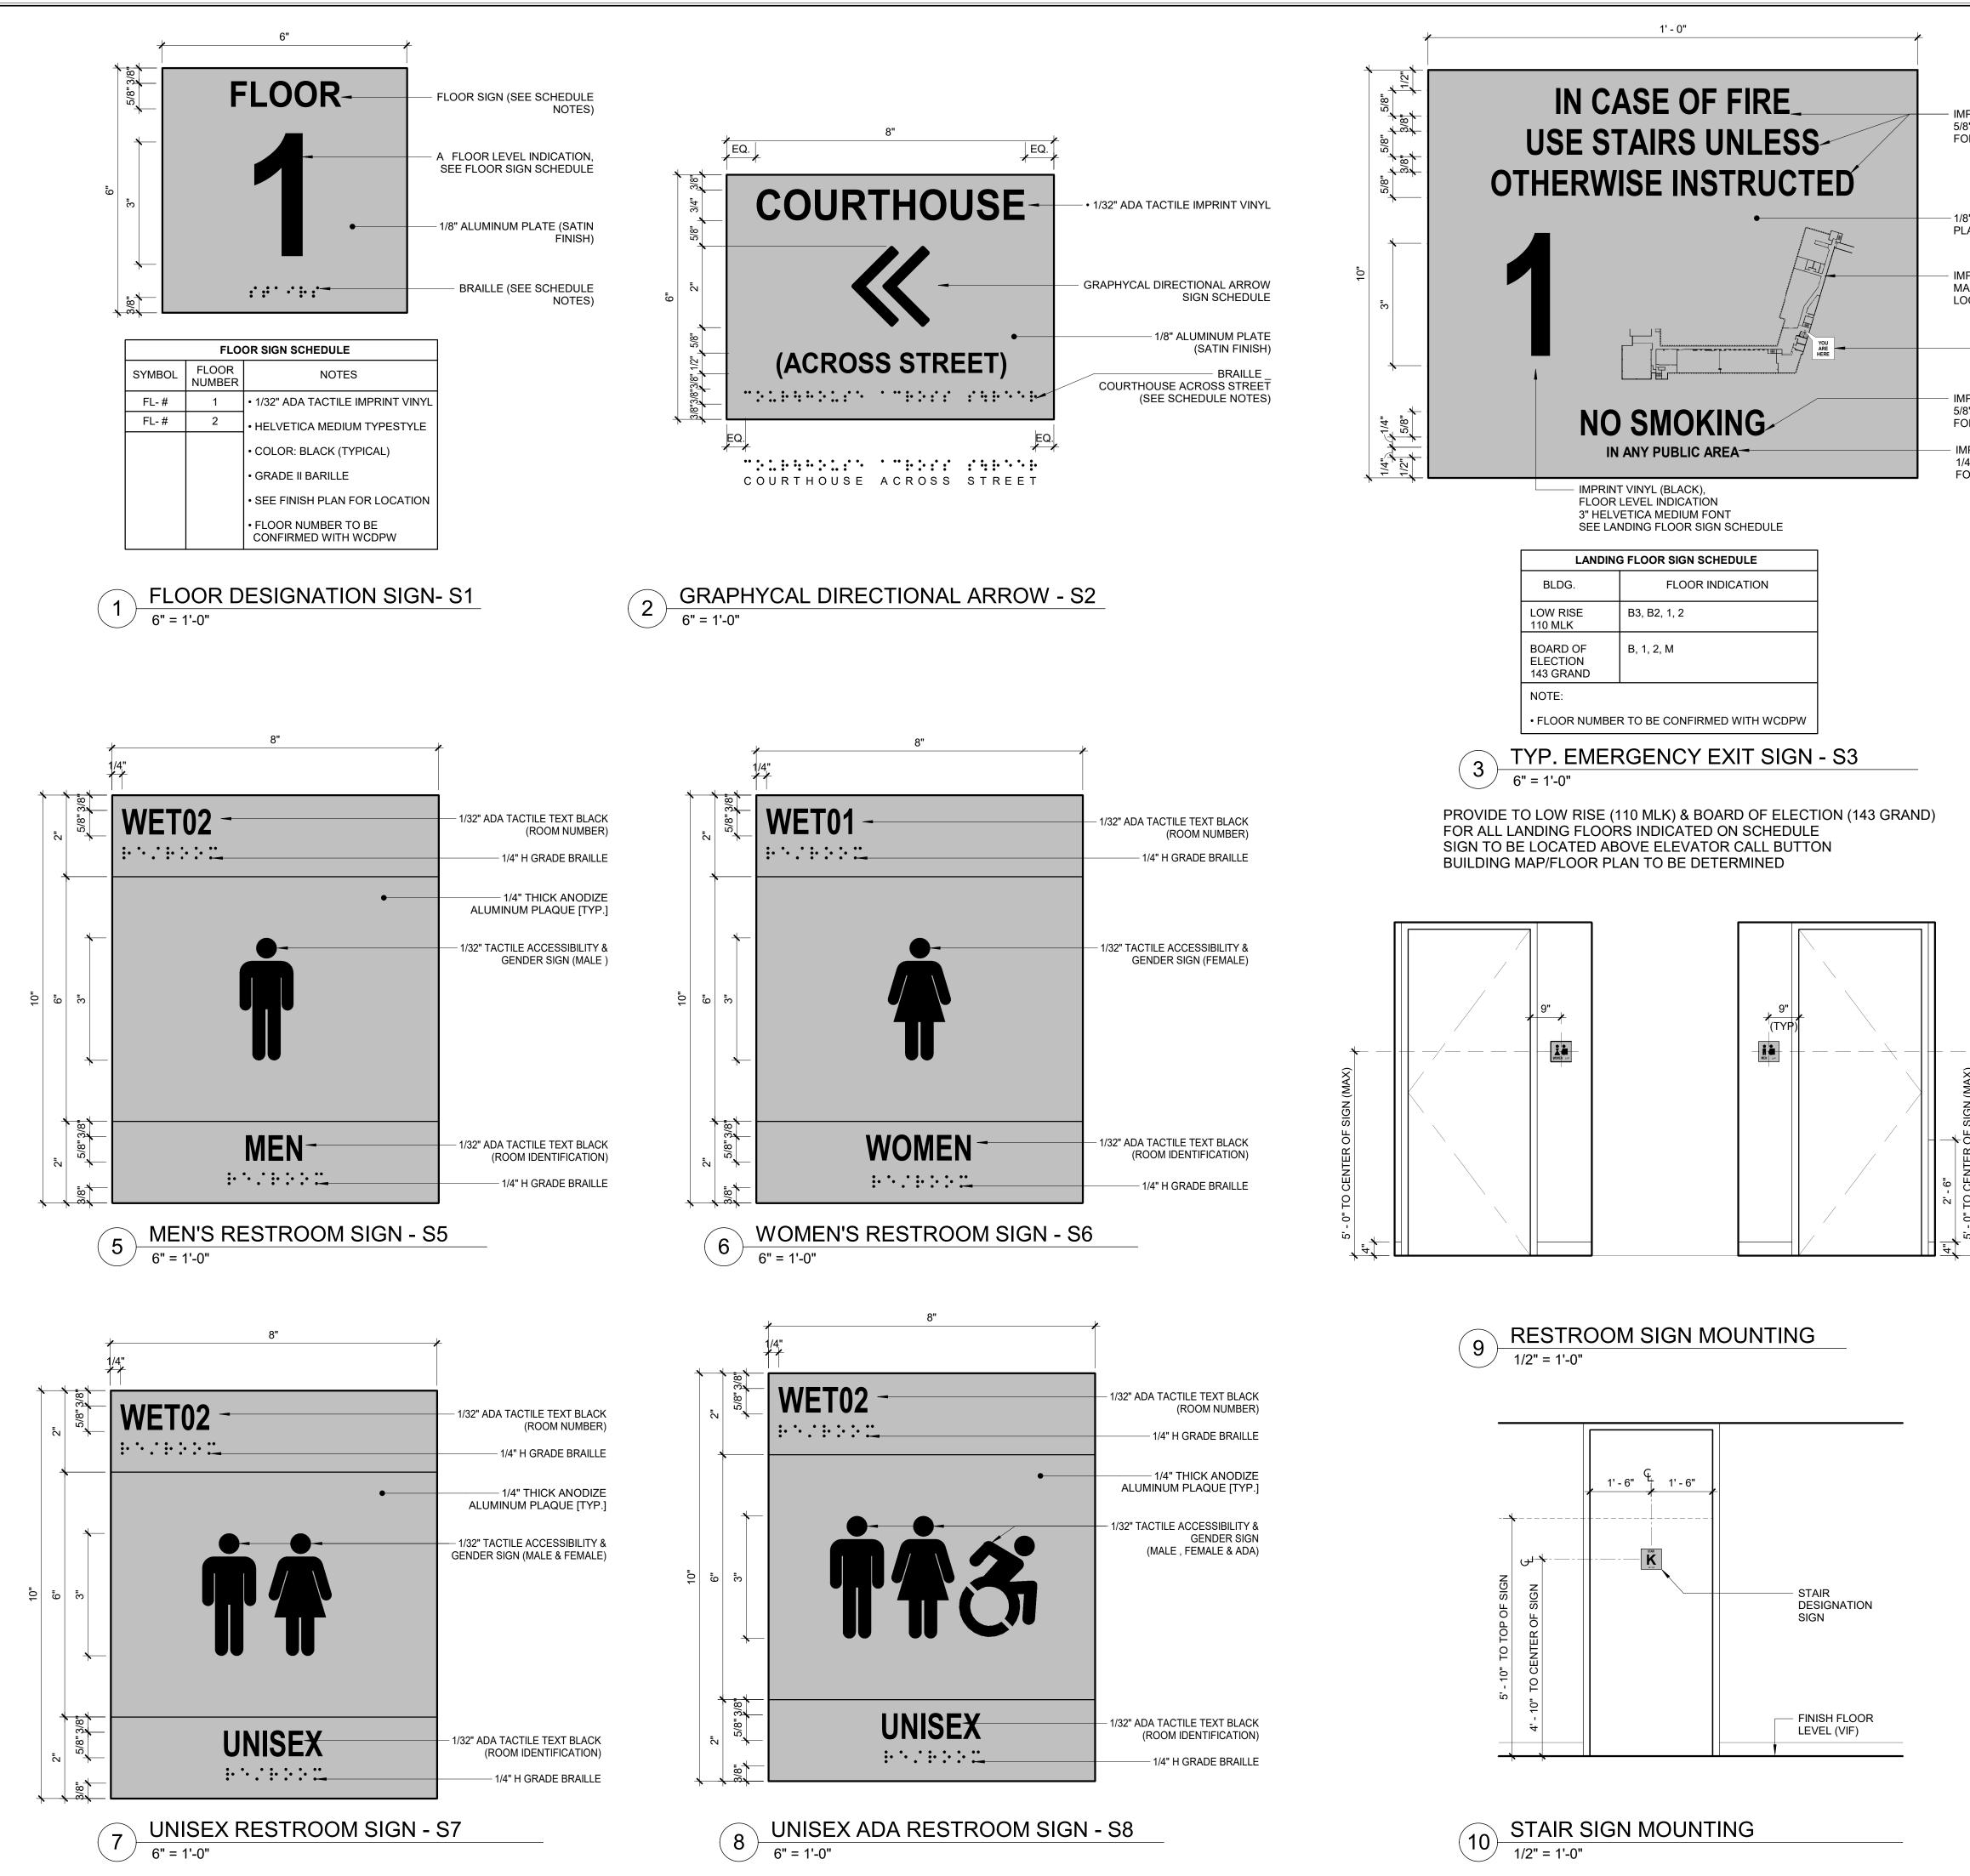GRADE II BRAILLE



		_						
CONSULTANT SEAL	CONSULTANT INFORMATION							
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	2/21/2024							
REVISION NUMBER	DATE	MADE BY APP'D BY REVISION						
		RE	CORD DR	AWIN	G CERTIFICATION			
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AS BUILT	- NO CHAN	GES						
	CONTR	ACTOR			CONTRACTOR			
NAME:					NAME:			
SIGNATURE:					SIGNATURE:			
		DATI	E:			DATE:		
	WES	TCHESTER	COUNTY,	NEW Y	ORK	CONTRACT	SHEET NUMBER	
DEP			,		NSPORTATION	NUMBER	A-303	
						20-502		
DIVISION OF ENGINEERING					NG	SHEET NO. 52	OF 133	
LOW RISE BUILDING RENOVATIONS AND HVAC IMPROVEMENTS - PHASE II 110 DR. MARTIN LUTHER KING, JR. BOULEVARD						SCALE:	As indicated	
			AINS, NEW		LEVANU	DATE: 01-19-2024	Issue Date	
	21			וו∆ד⊐ר	S	DPW FILE NO.	REV NO.	
SIGN SCHEDULE & DETAILS						52-11-	A-1864-0   <sup>ℕ∪.</sup>	



# KEY NOTES


RECONNECT NEW LIGHTING FIXTURES AND LIGHTING FIXTURE CONTROLS TO EXISTING CIRCUIT PRESENTLY SERVING THE AREA. EXTEND 2#12+#12G-3/4"C AS REQUIRED.

# GENERAL NOTES

- REFER TO ARCHITECTURAL PLANS FOR ALL LIGHTING FIXTURE LOCATIONS AND LIGHTING FIXTURE SWITCHES.
   REFER TO E-020 FOR TYPICAL LIGHTING DETAILS.
- 3. LIGHTING FIXTURES ARE TO BE TAKEN AT 277V U.O.N.
- 4. WIRE ALL EXIT SIGN TO EXISTING CIRCUIT SERVING EXISTING EXIT SIGNS.

5. FIXTURES DENOTED WITH SUBSCRIPT "EM" SHALL BE PROVIDED WITH EMERGENCY POWER VIA EMERGENCY LIGHTING PANEL LP-LRE2 AND WIRE FOR FULL-ON OPERATION UPON LOSS OF NORMAL POWER. PROVIDE IL 924 LISTED BYPASS RELAY FOR EACH NORMAL/EM ZONE. EXTEND WIRING FOR NORMAL POWER, EMERGENCY POWER, NORMAL POWER SENSING, AND LOW VOLTAGE AS REQUIRED.

6. WIRE ALL EMERGENCY FIXTURES SERVING THIS FLOOR TO CKT#5 IN EMERGENCY LIGHTING PNL LP-LRE2.

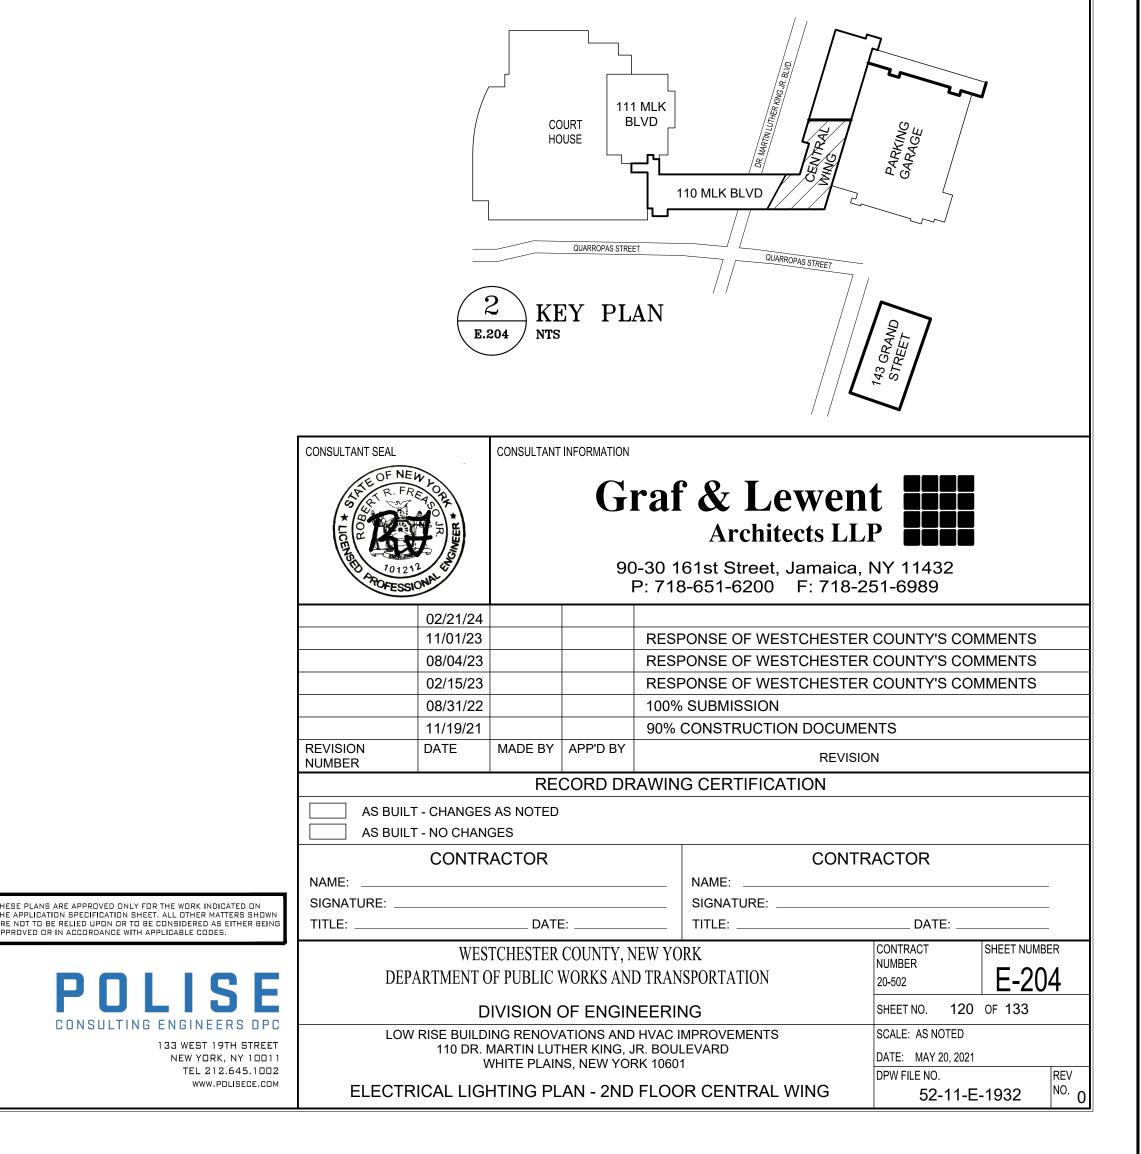

# Johns Manville

# **Peak Advantage Guarantee**

#### **Building Owner**

Westchester County White Plains, NY 10601

#### **Building Name**

White Plains Courthouse - Low Rise Bldg 110 Dr. Martin Luther King Jr. Blvd

White Plains, NY 10601

### Approved Roofing Contractor

NUA Construction Corp. 38 White Deer Lane

Guarantee Number: GNM101075020

Date of Completion: 11/15/2009

West Harrison, NY 10604

**Terms & Maximum Monetary Obligation to** Maintain a Watertight Roofing System.

Ś

No Dollar Limit

The components of the Roofing System	Total Squares:	430		
Membrane Spec. and Type	:	3CID-CA	•	SBS
Insulation Type	:	NRG3 ,None ,DuraBoard		
Accessories (Type and Quan	tity) :			

These Johns Manville Guaranteed components are referred to below as the "Roofing System" and ALL OTHER COMPONENTS OF THE OWNER'S BUILDING ARE EXCLUDED FROM THE TERMS OF THIS GUARANTEE.

Years 25

Johns Manville\* guarantees to the original Building Owner that during the Term commencing with the Date of Completion, JM will pay for the materials and labor required to promplly repair the Roofing System to return it to a watertight condition if leaks occur due to: ordinary wear and tear, or deficiencies in any or all of the component materials of the Roofing System, or workmanship deficiencies in the application of the Roofing System.

### WHAT TO DO IF YOUR ROOF LEAKS

If you should have a roof leak please refer to directions on the reverse side.

#### LIMITATIONS AND EXCLUSIONS

This Guarantee is not a maintenance agreement or an insurance policy; therefore, routine inspections and maintenance are the Building Owner's responsibility (see reverse This Guarantee is not a maintenance agreement of an insurance policy interior, routine inspectious and maintenance are the Building Owner's responsibility (see reverse side of this document). Failure to follow the Maintenance Program on the reverse side of this document will void the Guarantee. This Guarantee does not obligate JM to repair the Roofing System, or any part of the Roofing System, for leaks resulting from (a) natural disasters including but not limited to the direct or indirect effect of lightning, flood, hail storm, earthquake, tornados, hurricanes or other extraordinary natural occurrences and/or wind speeds in excess of 72 miles per hour, (b) misuse, abuse or negligence, (c) installation or material failures other than those involving the component materials expressly defined above as the Roofing System or exposure of the Roofing System components to damaging substances such as oil or solvents or to damaging conditions such as vermin, (d) changes to the Roofing System or the Building's usage that are not pre-approved in writing by JM, or (c) failure of the Building substrate (mechanical, structural, or otherwise and whether resulting from Building movement, design defects or other causes) or improper drainage. JM is not responsible for leaks and damage resulting from water entry from any portion of the Building structure not a part of the Roofing System.

This Guarantee becomes effective when (1) it is delivered to Owner: and (2) all bills for installation, materials, and services have been paid in full to the Approved Roofing contractor and to JM. Until that time, this Guarantee is not in force and has no effect.

The Parties agree that any controversy or claims relating to this Guarantee shall be first submitted to mediation under the Construction Industry Arbitration and Mediation Rules of the American Arbitration Association (Regular Track Procedures) or to such other mediation arrangement as the parties mutually agree. No court or other tribunal shall have jurisdiction until the mediation is completed.

TO THE FULLEST EXTENT PERMITTED BY LAW, JM DISCLAIMS ANY IMPLIED WARRANTY, INCLUDING THE WARRANTY OF MERCHANTABILITY AND THE WARRANTY OF FITNESS FOR A PARTICULAR PURPOSE, AND LIMITS SUCH WARRANTY TO THE DURATION AND TO THE EXTENT OF THE EXPRESS WARRANTY CONTAINED IN THIS GUARANTEE.

THE EXCLUSIVE RESPONSIBILITY AND LIABILITY OF JM UNDER THIS GUARANTEE IS TO MAKE REPAIRS NECESSARY TO MAINTAIN THE ROOFING SYSTEM IN A WATERTIGHT CONDITION IN ACCORDANCE WITH THE OBLIGATIONS OF JM UNDER THIS GUARANTEE.

IM AND ITS AFFILIATES WILL NOT BE LIABLE FOR ANY INCIDENTAL OR CONSEQUENTIAL DAMAGES TO THE BUILDING STRUCTURE (UPON WHICH THE ROOFING SYSTEM IS AFFIXED) OR IT'S CONTENTS, LOSS OF TIME OR PROFITS OR ANY INCONVENIENCE. JM AND ITS AFFILIATES SHALL NOT BE LIABLE FOR ANY DAMAGES WHICH ARE BASED UPON NEGLIGENCE, BREACH OF WARRANTY, STRICT LIABILITY OR ANY OTHER THEORY OF LIABILITY OTHER THAN THE EXCLUSIVE LIABILITY SET FORTH IN THIS GUARANTEE.

No one is authorized to change, alter, or modify the provision of this Guarantee other than the Manager, Guarantee Services Unit or authorized delegate. JM's delay or failure in enforcing the terms and conditions. This Guarantee is solely for the benefit of the Building Owner identified above and Building Owner's rights hereunder are not assignable. Upon sale or other transfer of the Building, Building Owner may request transfer of this Guarantee to the new owner, and JM may transfer this Guarantee, in its sole discretion only after receiving satisfactory information and payment of a transfer fee, which must be paid no later than 30 days after the date of Building ownership transfer.

In the event JM pays for repairs which are required due to the acts or omissions of others, JM shall be subrogated to all rights of recovery of the Building Owner to the extent of the amount of the repairs.

Because JM does not practice Engineering or Architecture, neither the issuance of this Guarantee nor any review of the Building's construction or inspection of roof plans (or the Building's roof deck) by JM representatives shall constitute any warranty by JM of such plans, specifications, and construction or in any way constitute an extension of the terms and conditions of this Guarantee. Any roof inspections are solely for the benefit of JM.

JM does not supervise nor is it responsible for a roofing contractor's work except to the extent stated herein, and roofing contractors are not agents of JM.

\*JOHNS MANVILLE ("JM") is a Delaware corporation with its principal mailing address at P.O. Box 5108, Denver, Colorado 80217-5108.

Fred Stephen

Rongungto

By : Fred Stephan Title : Vice President & General Manager **Roofing Systems Group** 

Attoney-in-Fact