

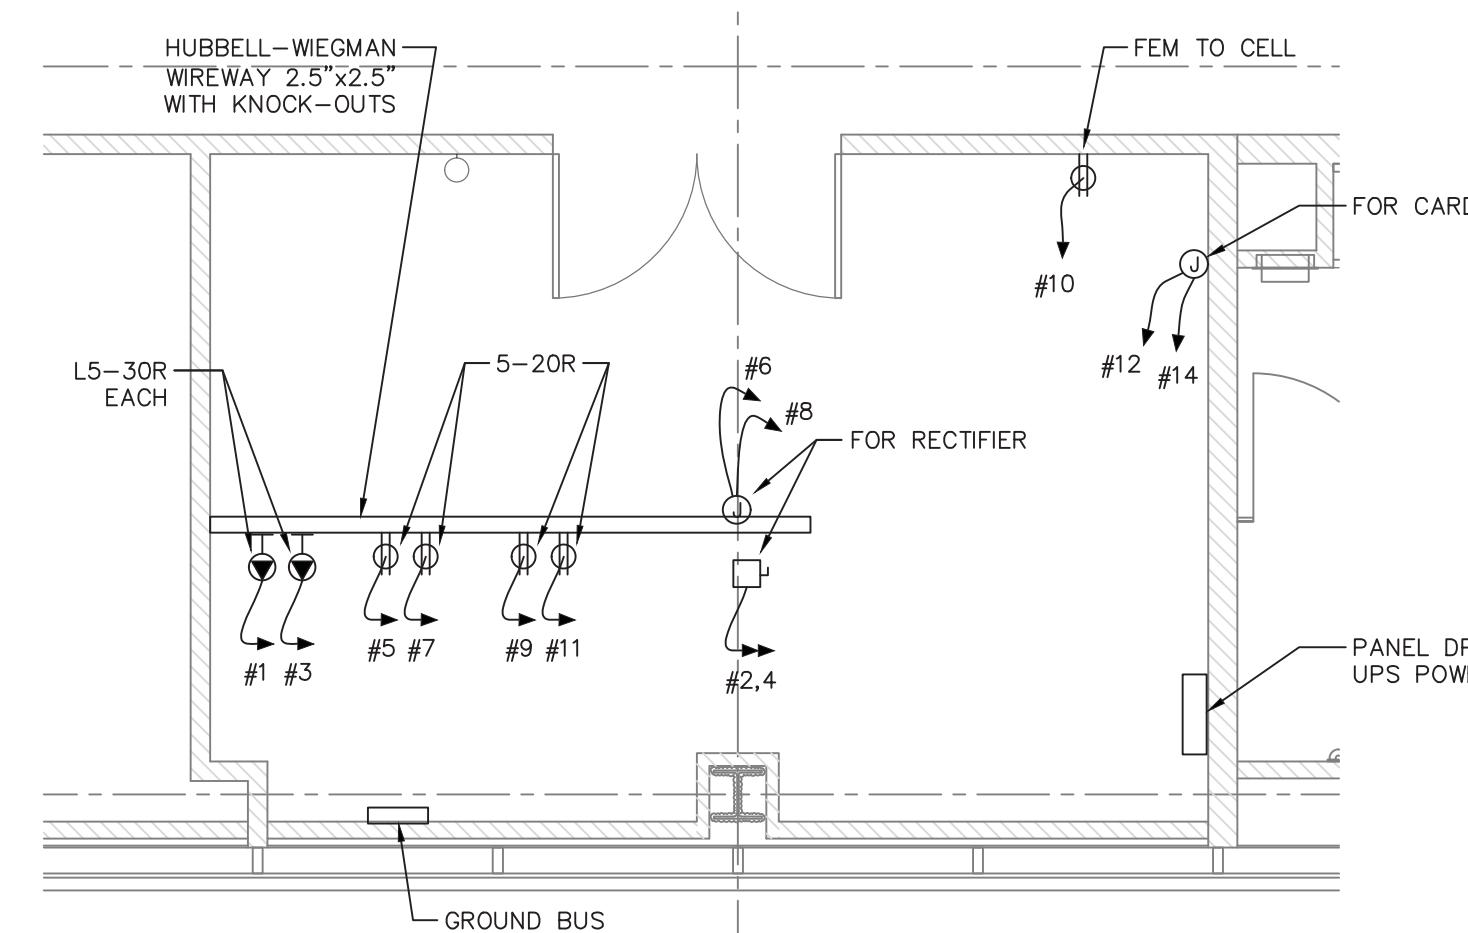
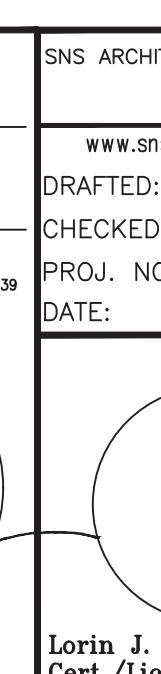
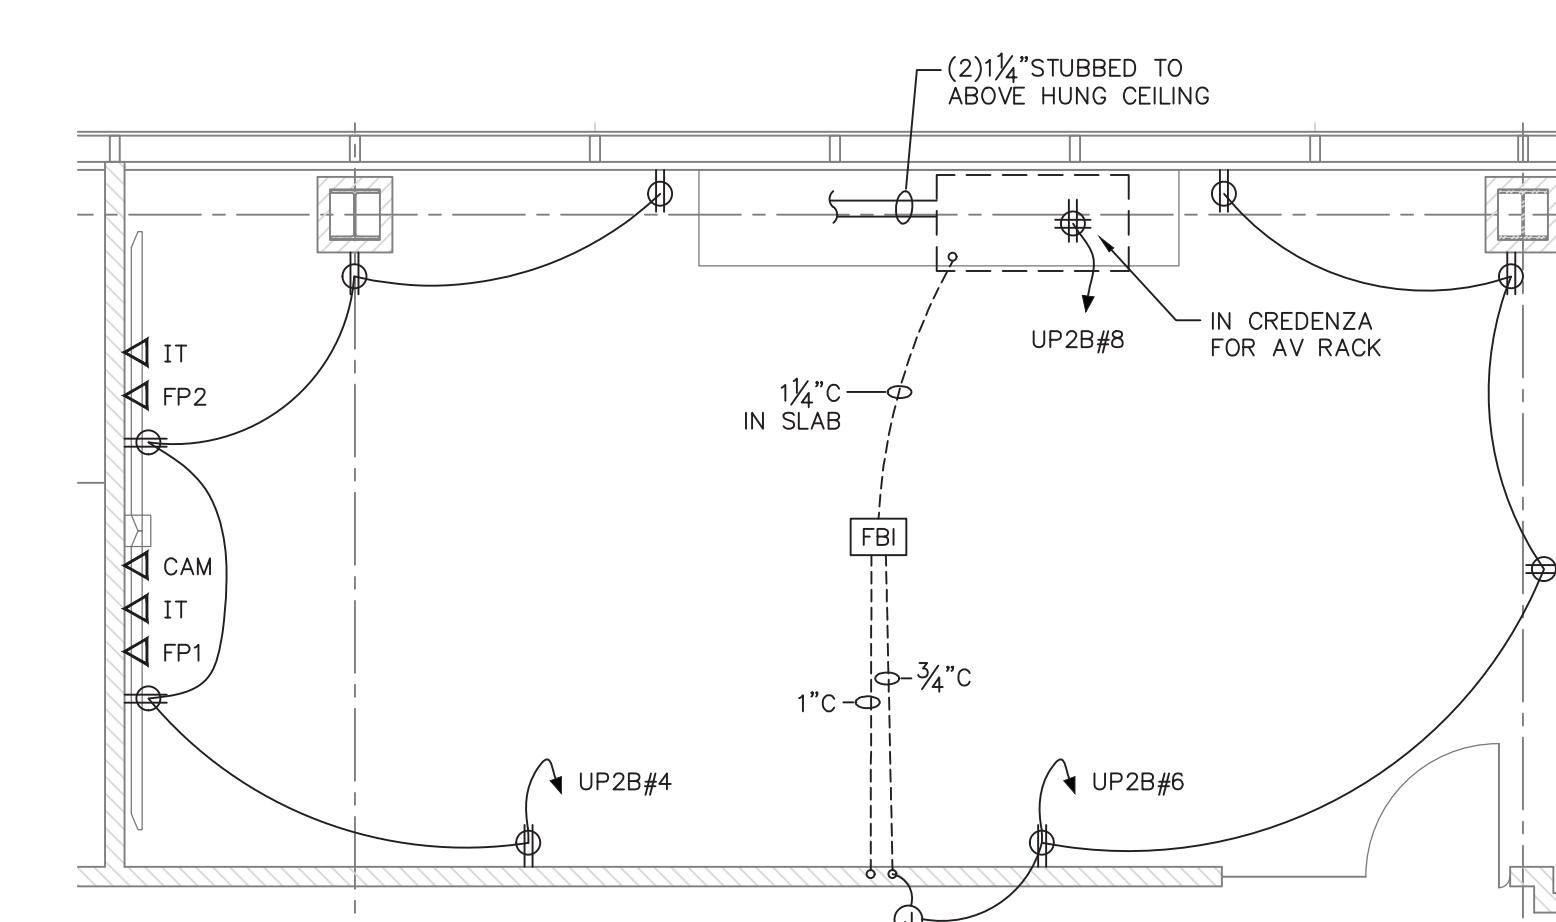
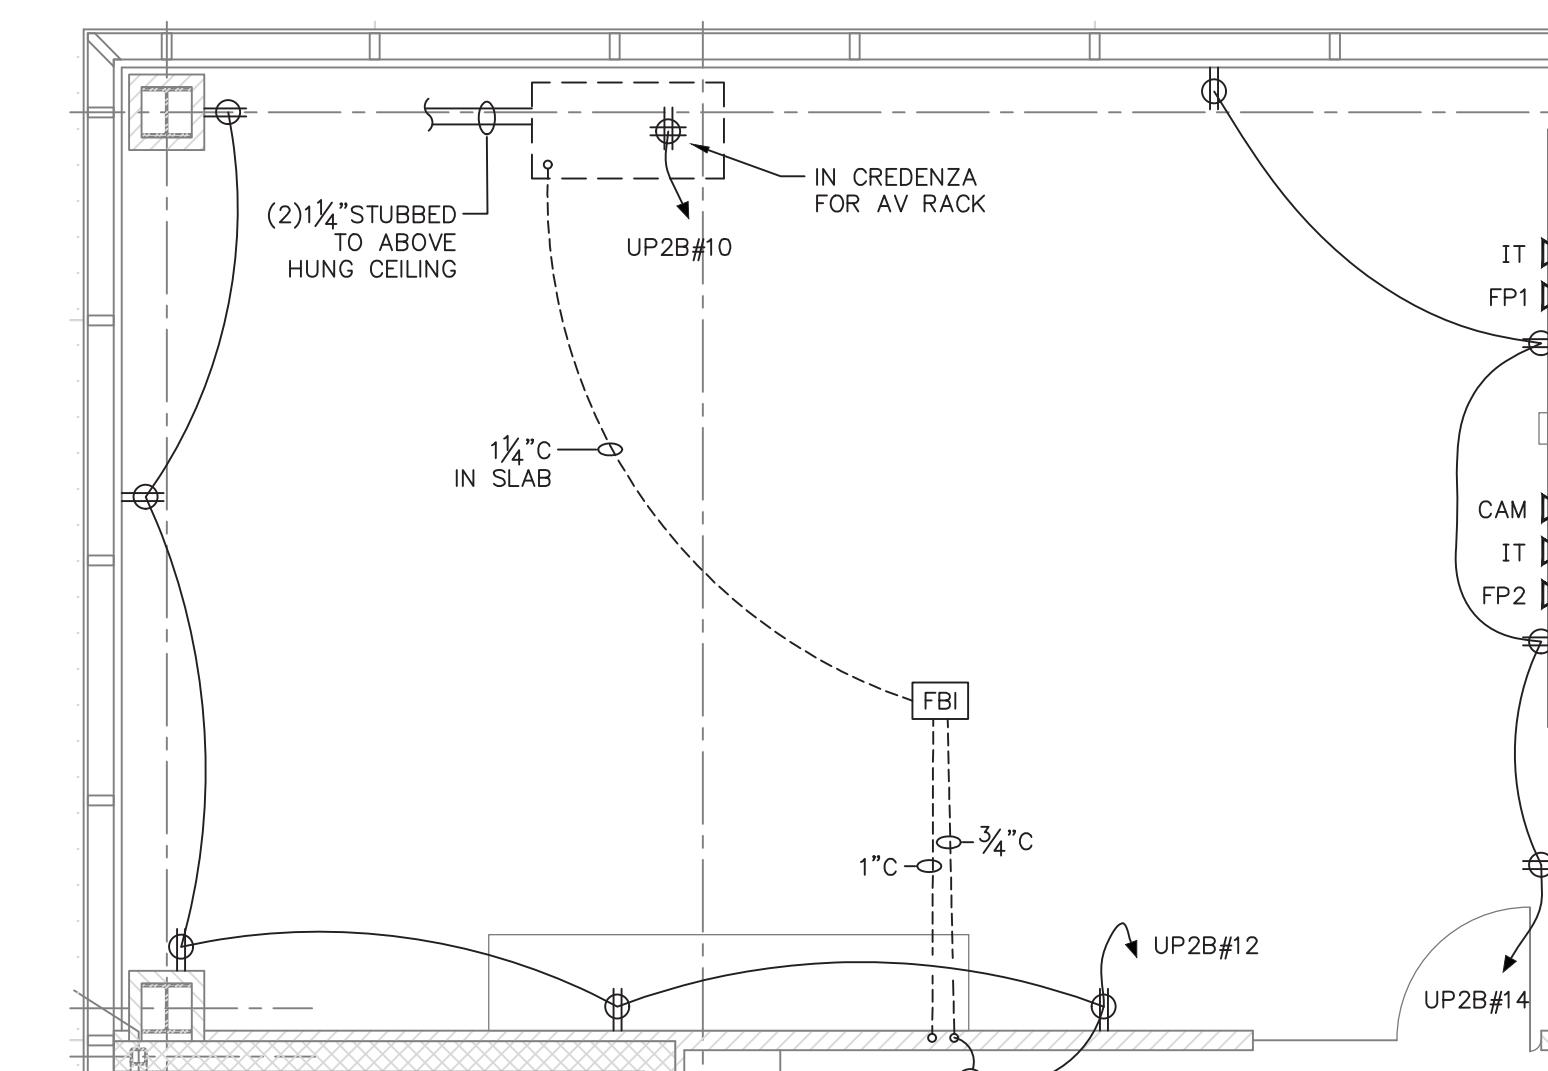
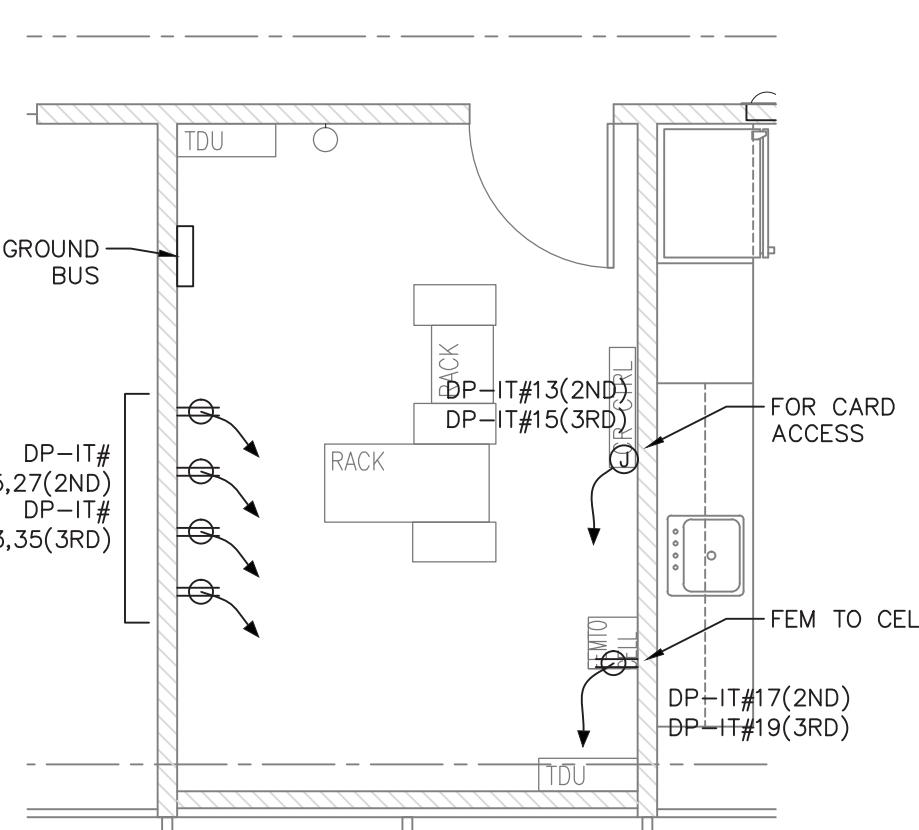


1 1st FLOOR PLAN
SCALE: 1/8" = 1'-0"

ELECTRICAL LEGEND	
	20A DUPLEX 125V RECEPTACLE (IVORY)
	20A GFCI DUPLEX RECEPTACLE 125V MOUNTED 48" AFF TO TOP OF BOX (IVORY)
	20A QUAD RECEPTACLE 125V
	JUNCTION BOX
	3/4" CONDUIT & SINGLE GANG BOX. CONDUIT STUBBED ABOVE HUNG CEILING, PROVIDE NYLON BUSHING & PULL CORD
	3/4" CONDUIT & (2) GANG BOX. CONDUIT STUBBED ABOVE HUNG CEILING, PROVIDE NYLON BUSHING & PULL CORD
	FLUSH WALL MOUNTED JUNCTION BOX WITH EMPTY CONDUIT STUBBED INTO HUNG CEILING. PROVIDE LIQUID TITE FOR CONNECTION TO FURNITURE SYSTEM (VIDEO/DATA). MOUNTED 4" AFF
	FLUSH WALL MOUNTED JUNCTION BOX FOR POWER CONNECTION TO FURNITURE SYSTEM. PROVIDE LIQUID TITE CONDUIT FOR CONNECTION, SIZE AND LENGTH AS REQUIRED. MOUNTED 4" AFF
	FLUSH FLOOR BOX FOR "ON GRADE" APPLICATION. LIQUID TITE CONNECTION TO FURNITURE SYSTEM DATA. PROVIDE LIQUID TITE CONNECTION TO FURNITURE FINAL CONNECTIONS BY OTHERS.
	FLUSH FLOOR BOX FOR "ON GRADE" APPLICATION FOR CONNECTION TO FURNITURE SYSTEM POWER. PROVIDE 1/4" LIQUID TITE CONNECTION TO FURNITURE AND FINAL CONNECTIONS.
	FLUSH FLOOR BOX MULTI-USE BOX WITH (1) DUPLEX RECEPTACLE WIRE MOLD EVOLUTION 4/5 BOX WITH FLUSH COVER AND FLOOR INSERT JET540CTX
	AREA OF REFUGE BASE STATION
	AREA OF REFUGE CALL BOXES

ELECTRICAL ABBREVIATIONS	
	DISCONNECT SWITCH
	COMBINATION STARTER/DISCONNECT SWITCH
	COMBINATION CONTACTOR/DISCONNECT SWITCH WITH OCP
	ELECTRICAL CONTACTOR
	T/C TIME CLOCK
	SINGLE POLE HOME RUN TO PANEL. TYPICAL BRANCH CIRCUIT.
	TWO POLE HOME RUN TO PANEL. TYPICAL 2 POLE BRANCH CIRCUIT OR 2 POLE APPLIANCE CIRCUIT
	THREE POLE HOME RUN TO PANEL. TYPICAL 3 PHASE BRANCH CIRCUIT OR 3 PHASE FEEDER
	TOGGLE SWITCH
	FLUSH MOUNTED COMBINATION ELECTRICAL/FLOOR BOX w/ ONE 20A DUPLEX AND DATA/TEL PORTS, WIREMOLD MODEL RP7CDBK, RPSFB-OG FOR ON GRADE APPLICATION, BLACK FINISH.
	FLUSH FLOOR BOX FOR "ON GRADE" APPLICATION FOR CONNECTION TO FURNITURE SYSTEM POWER. PROVIDE 1/4" LIQUID TITE CONNECTION TO FURNITURE AND FINAL CONNECTIONS.
	POKE THRU FOR DATA FURN FEED
	POKE THRU FOR POWER FURN FEED. PROVIDE LIQUID TITE WHIP AND CONNECTION TO FURNITURE
	AREA OF REFUGE BASE STATION
	AREA OF REFUGE CALL BOXES

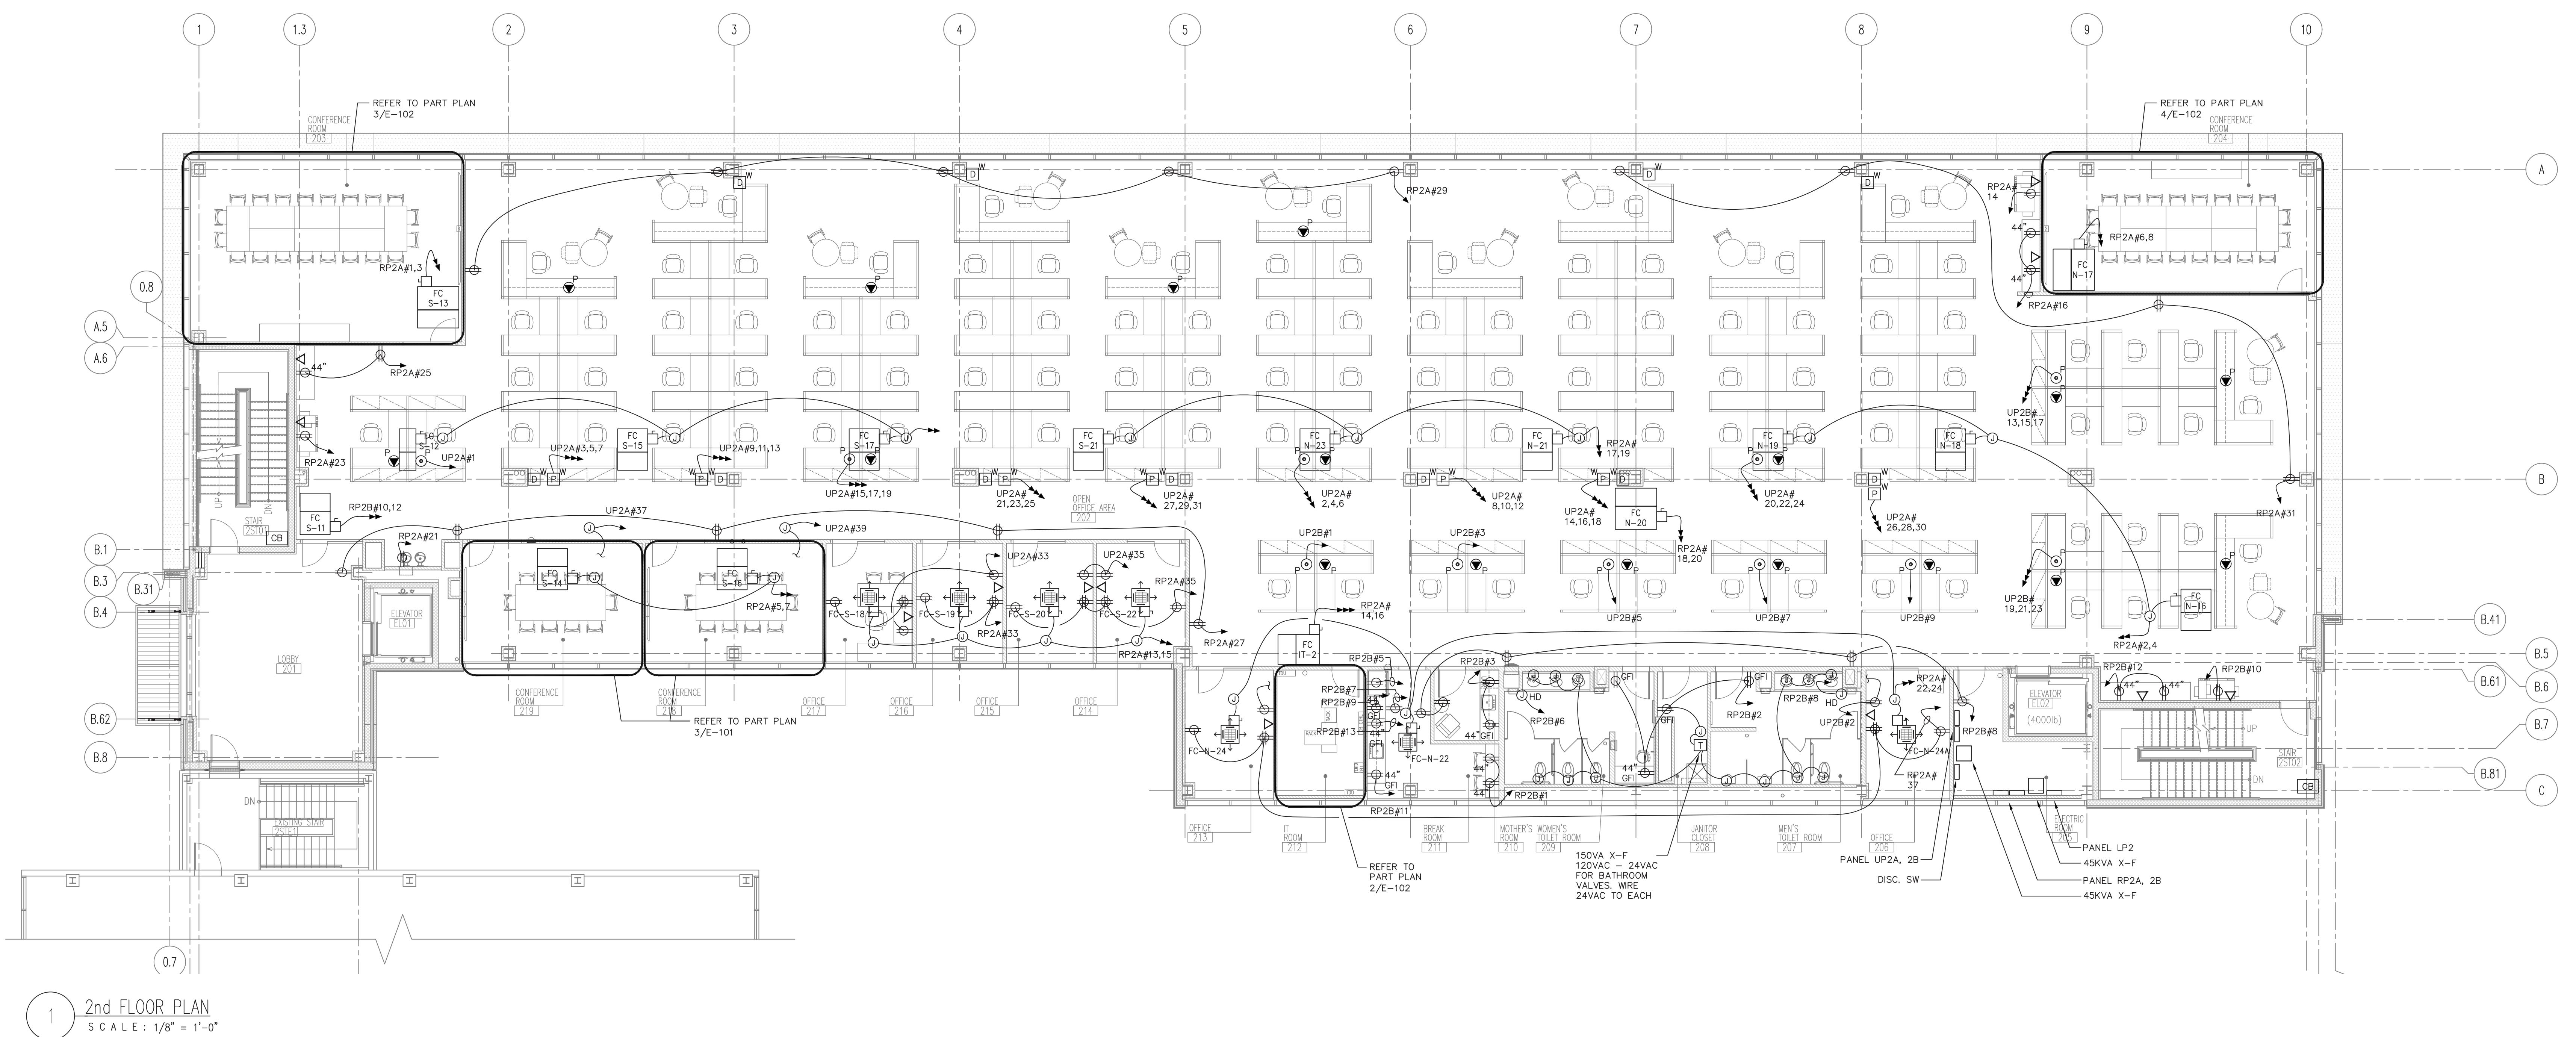


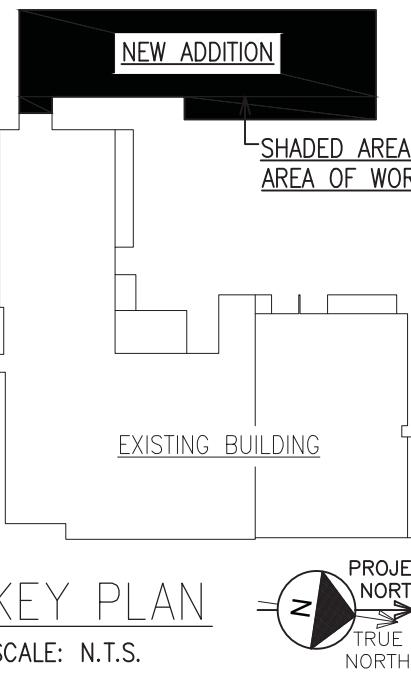




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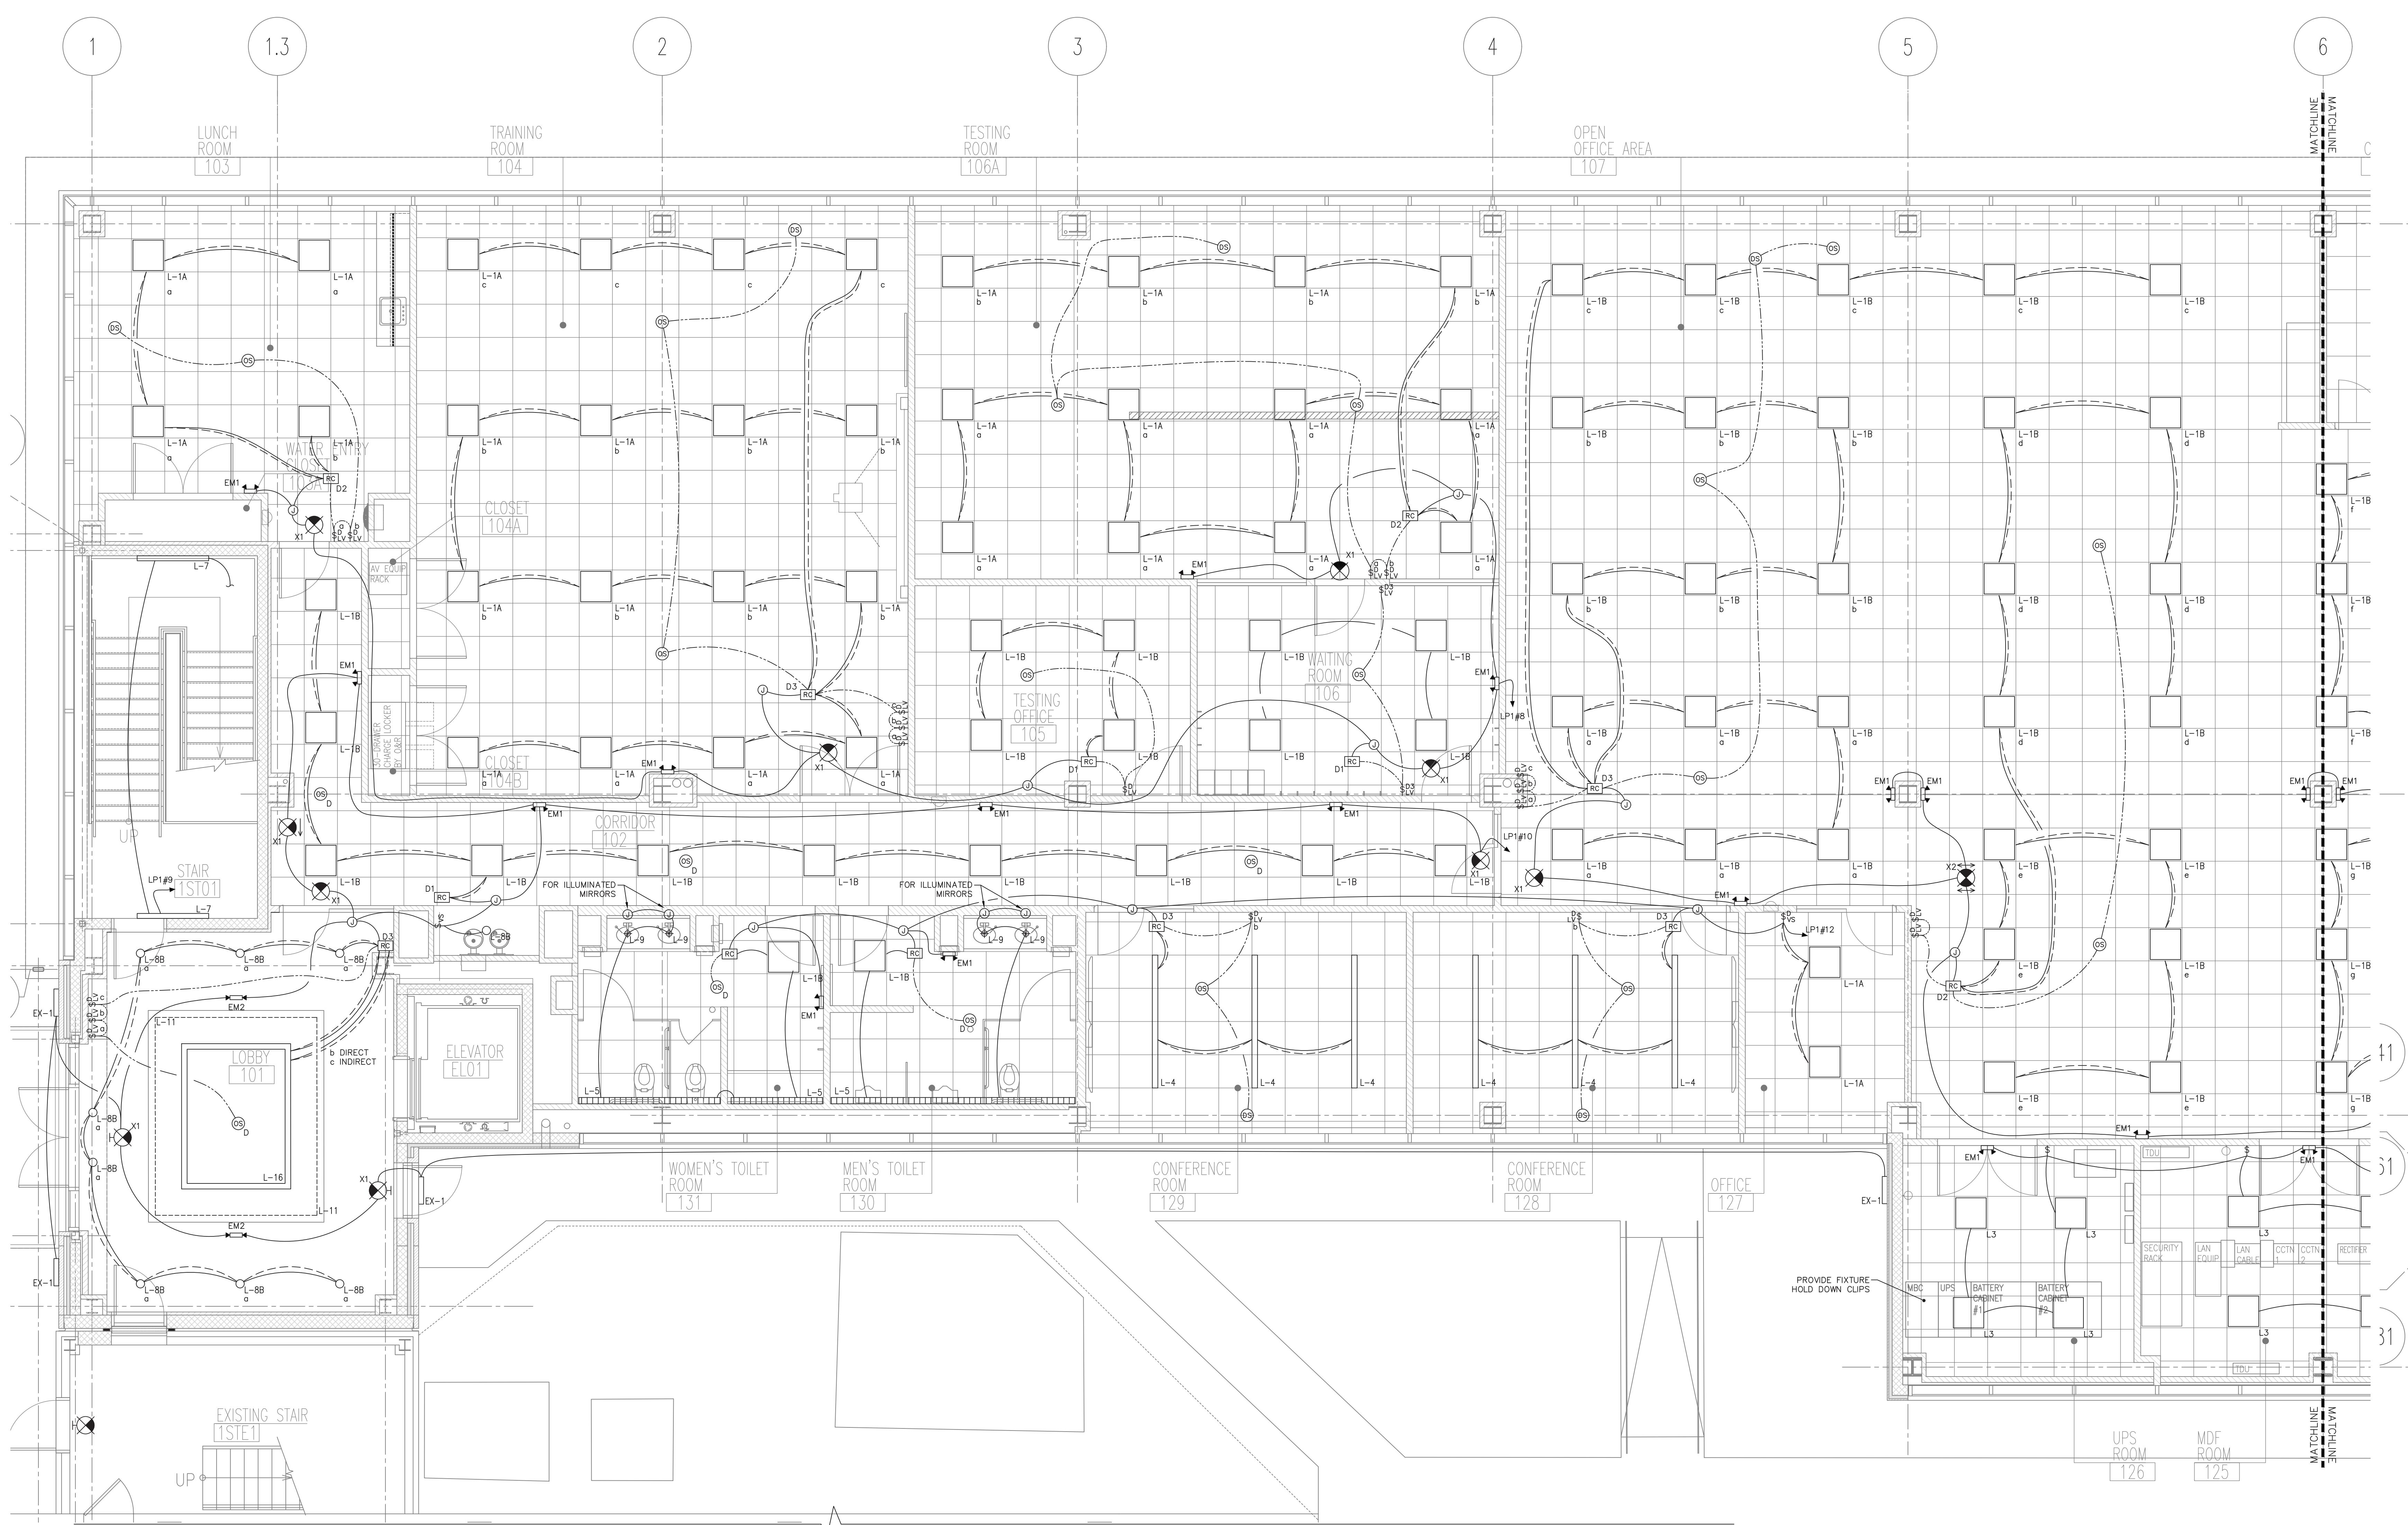
ONE PARAGON DRIVE . MONTVALE . NEW JERSEY . 07645







1 ROOF PLAN
SCALE: 1/8" = 1'-0"
NOTE: ALL WIRING SHALL RUN IN CEILING SPACE OF 3RD FLOOR.
THERE SHALL BE NO HORIZONTAL RUNS ON ROOF.

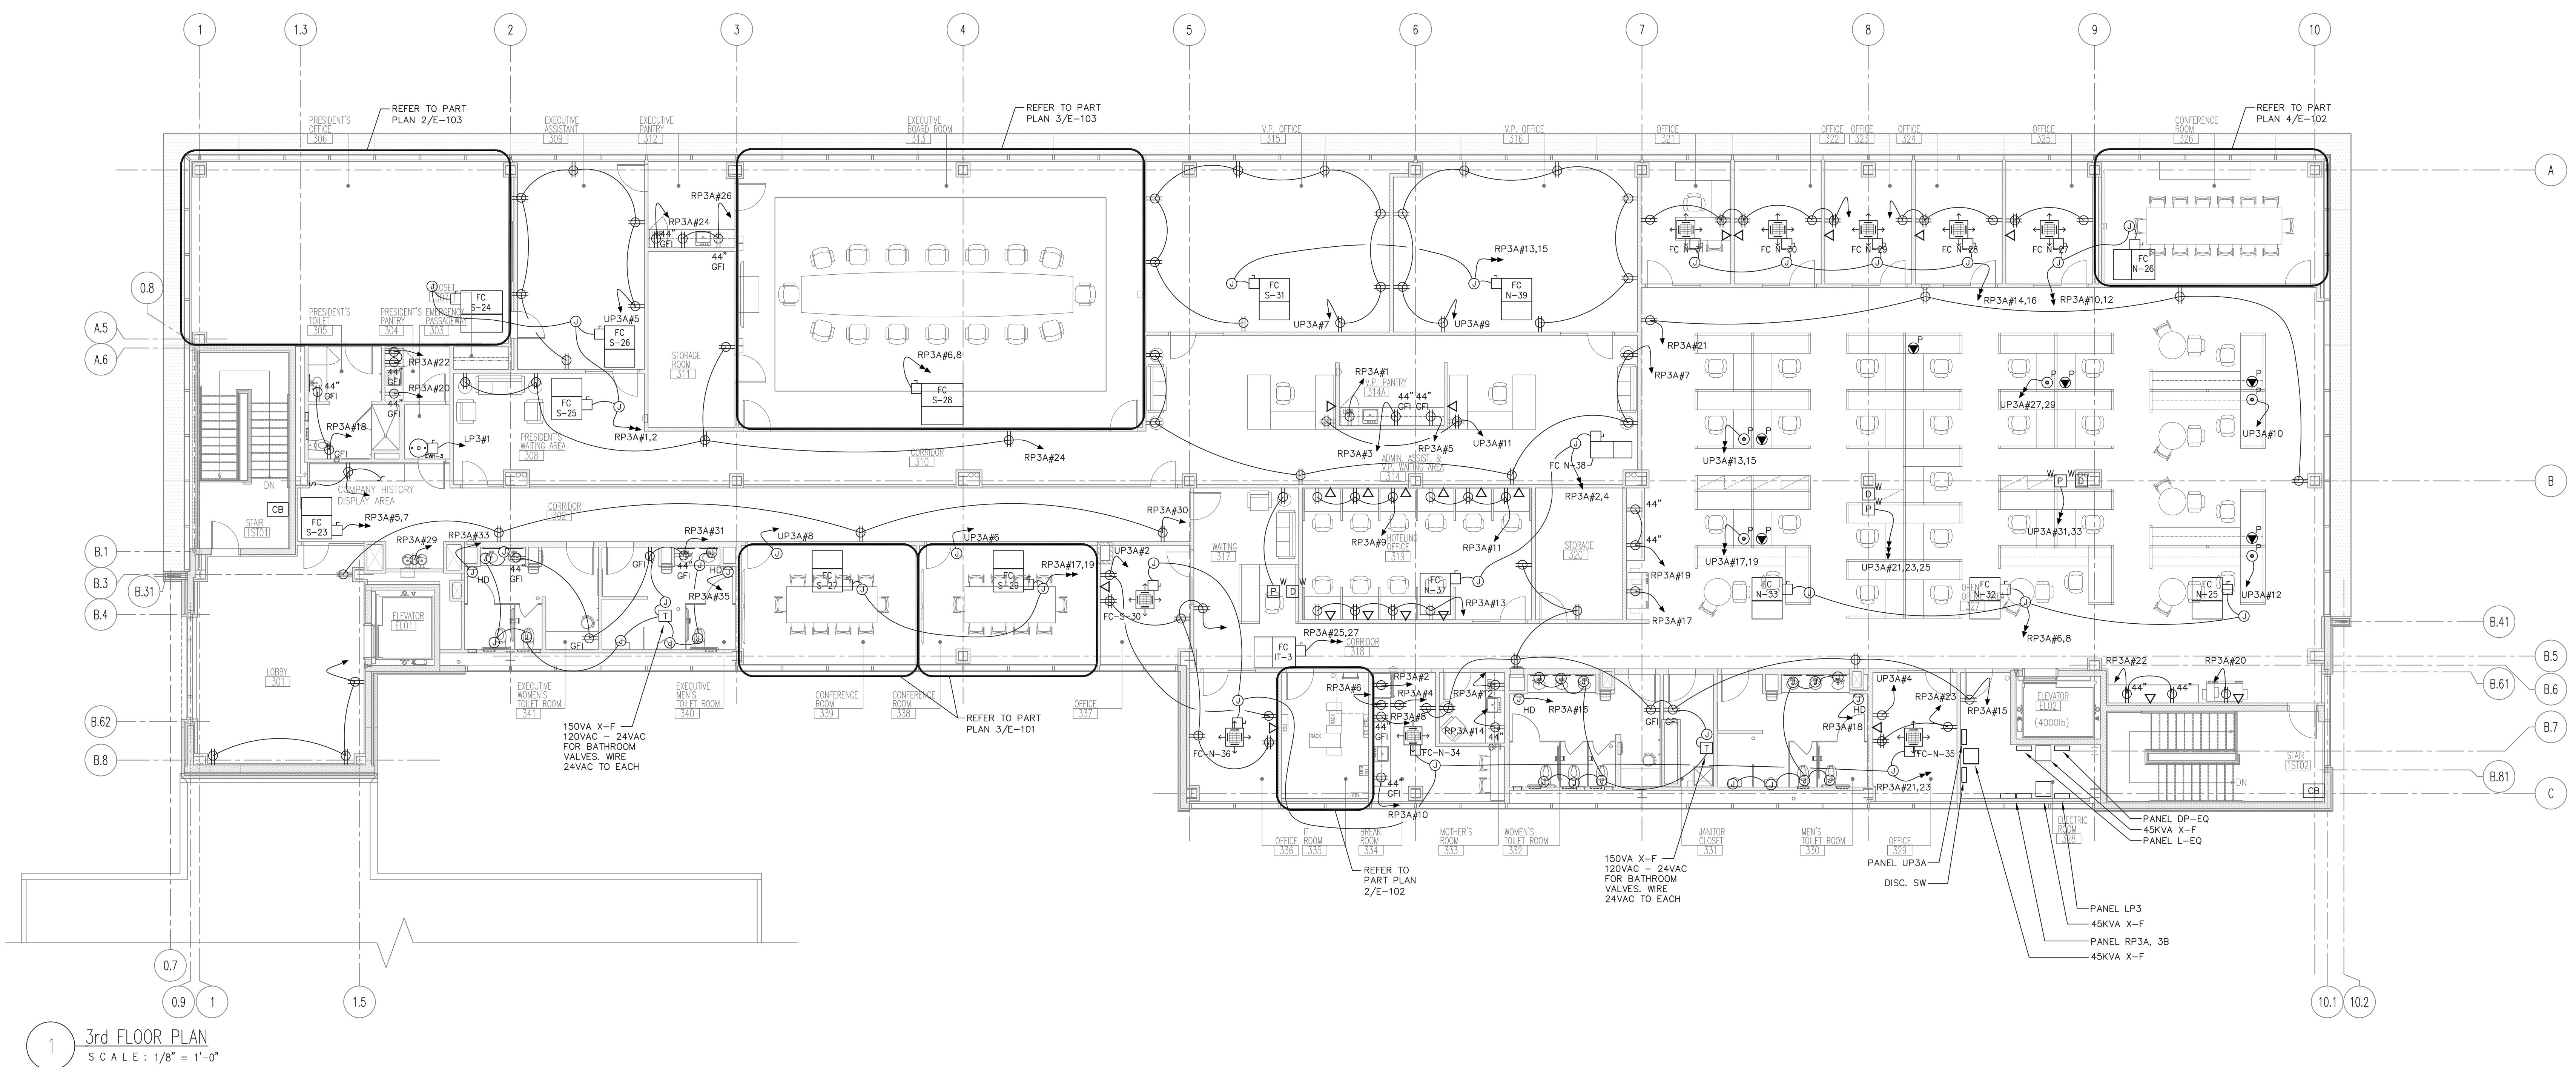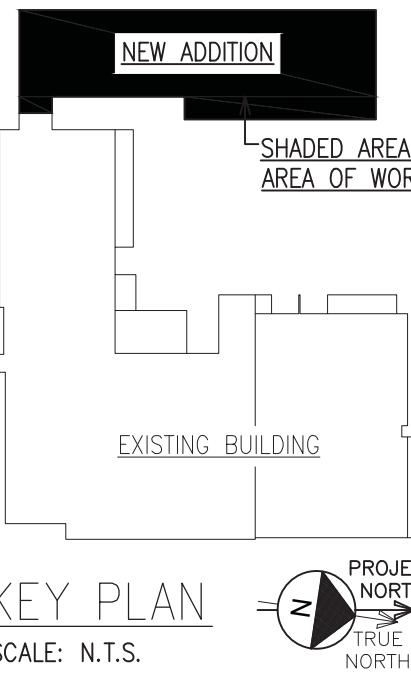1 ISSUED FOR BUILDING DEPARTMENT FILING & BIDDING 04-28-2025											
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John Lignos, AIA Lorin J. Sonenshine, AIA Steven Napolitano, PE, PP Lorin J. Sonenshine, AIA Cert./Lic. No. NY 018401 SNS Architects & Engineers, PC ONE PARAGON DRIVE . MONTVALE . NEW JERSEY . 07645 Robert Nocella, AIA											

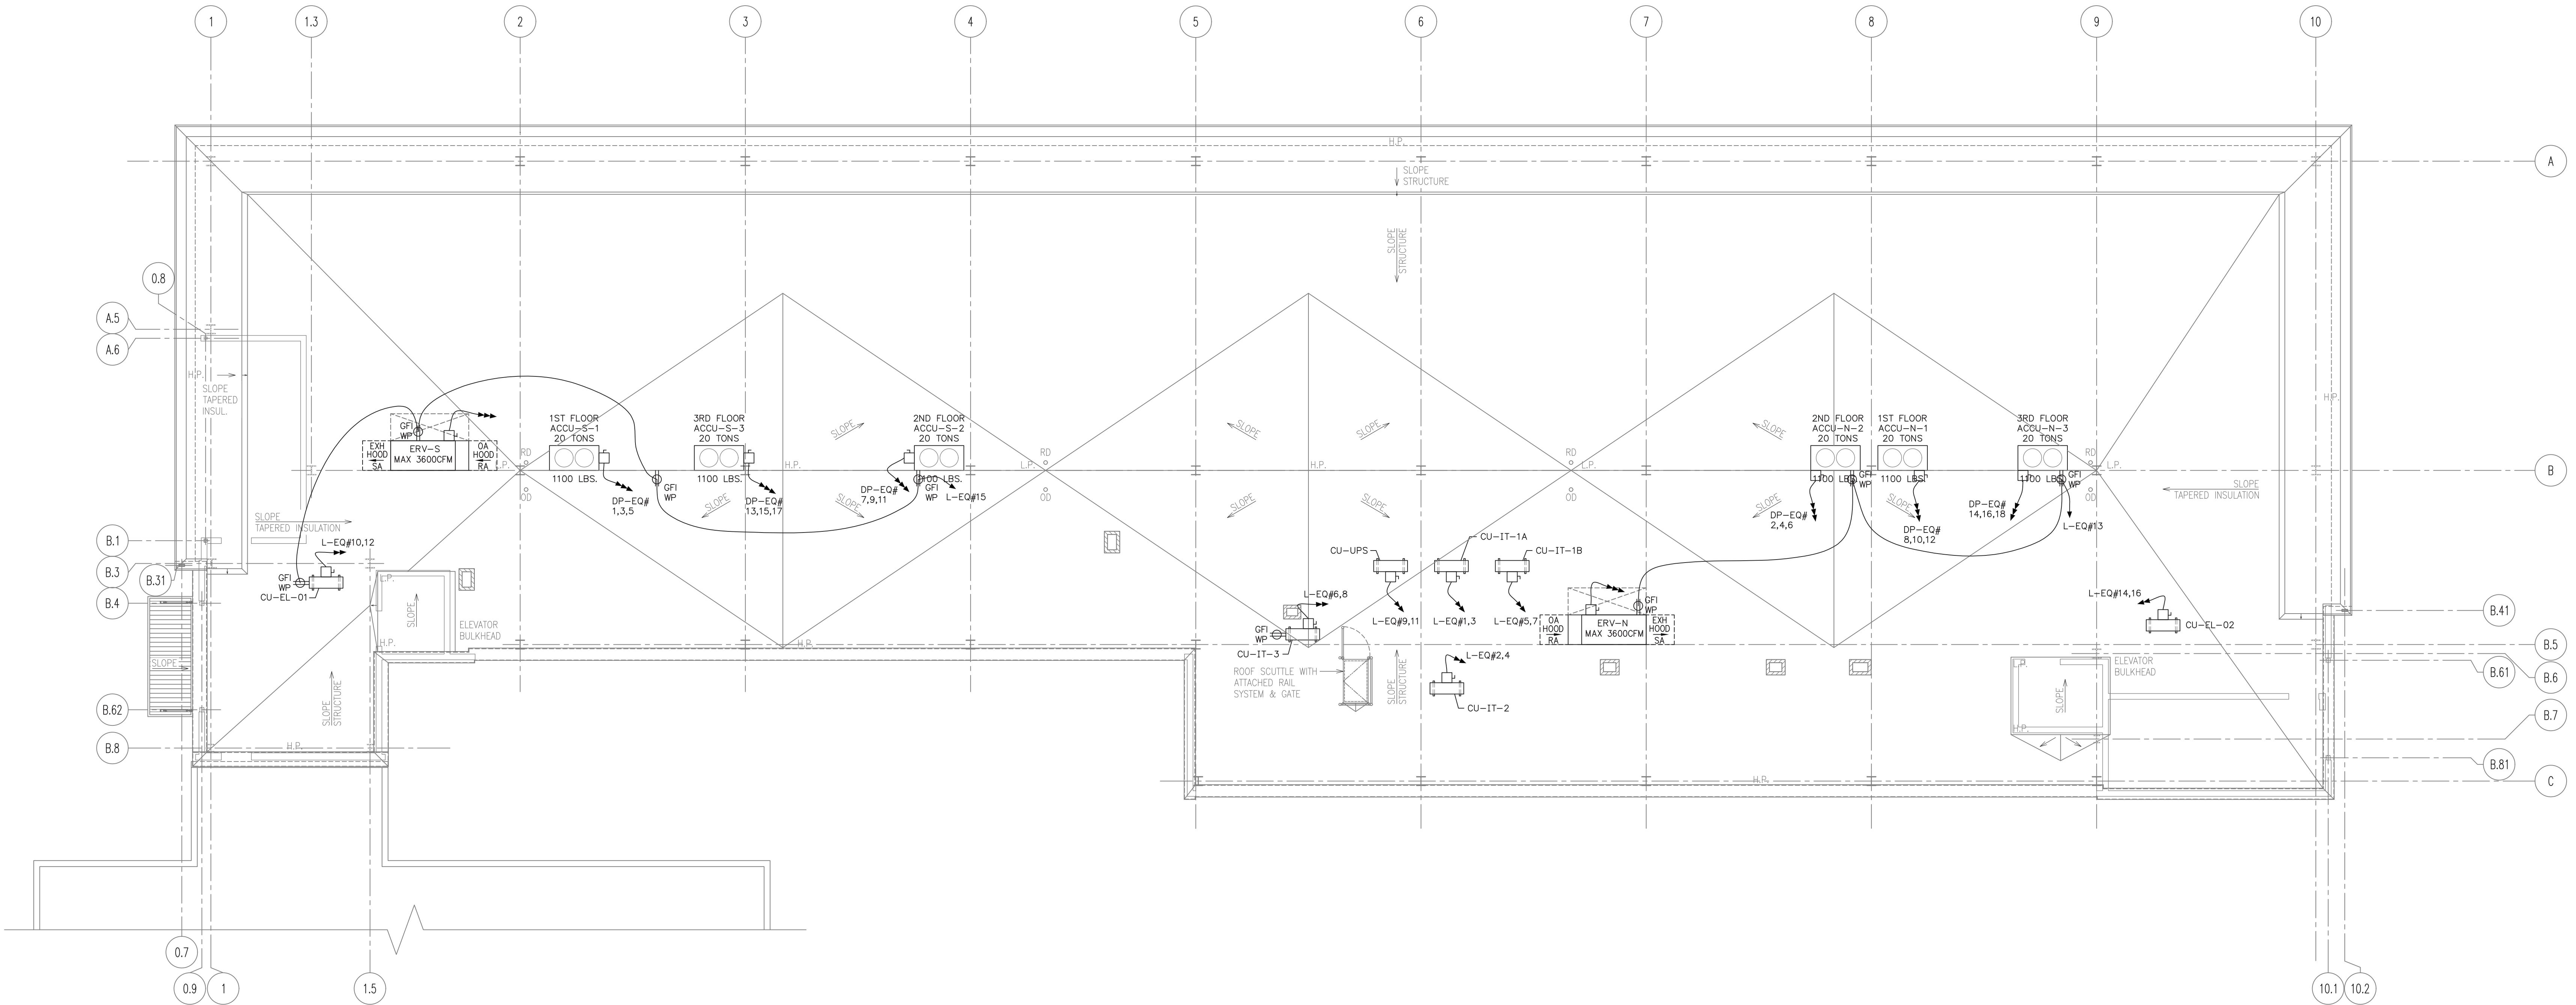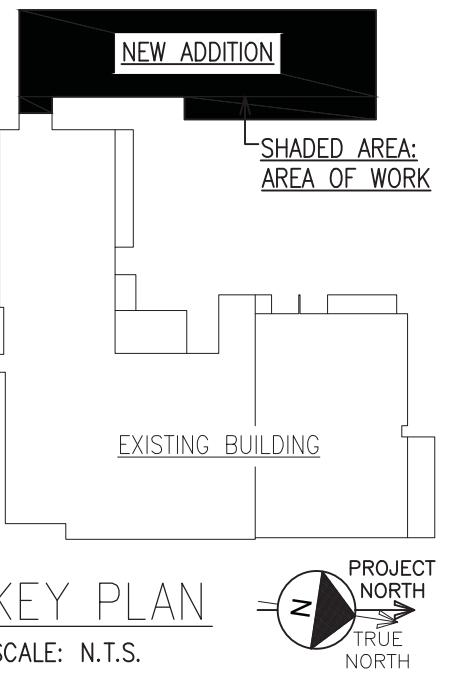

1 1st FLOOR PLAN
SCALE: 1/4" = 1'-0"

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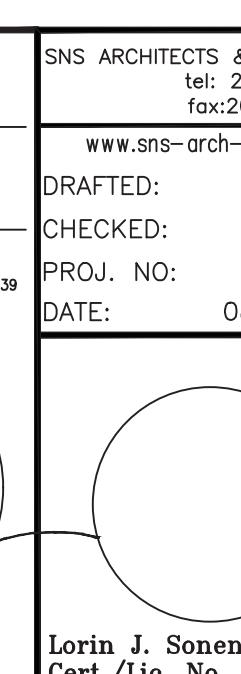
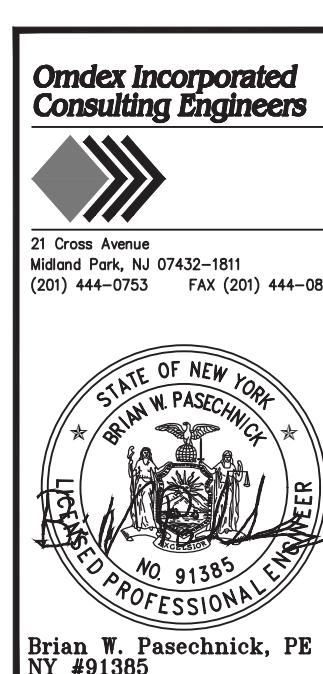
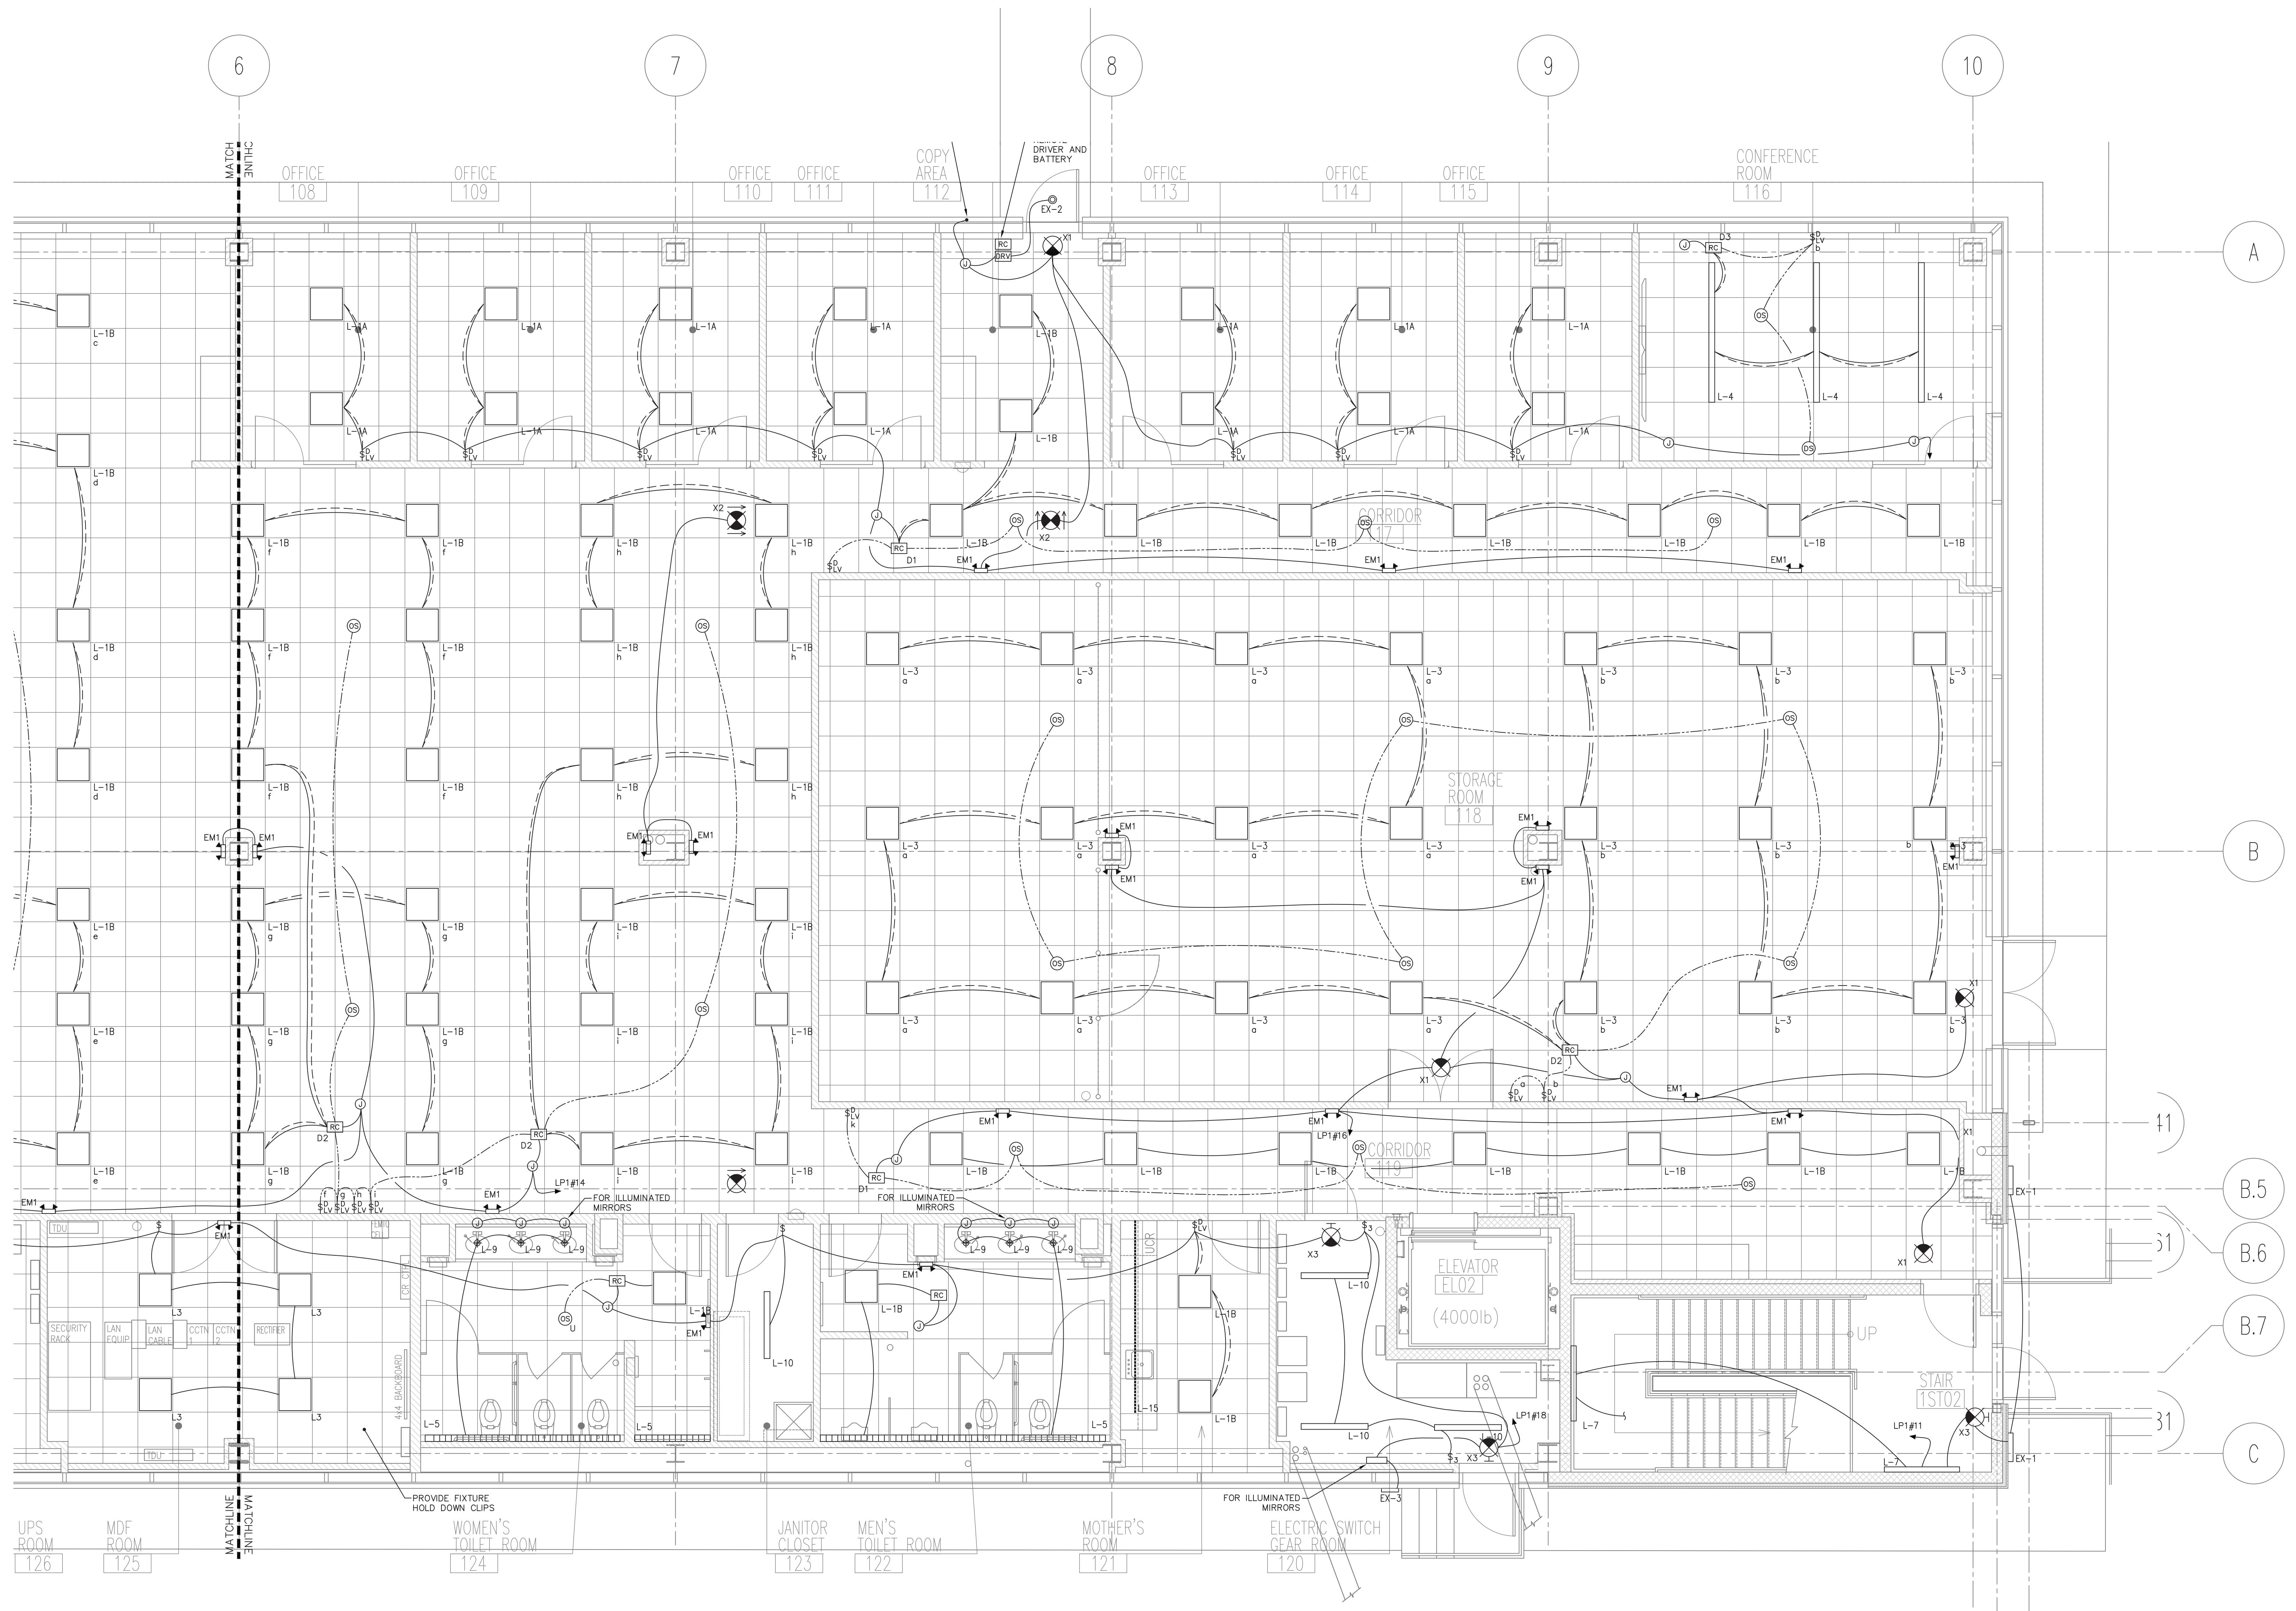
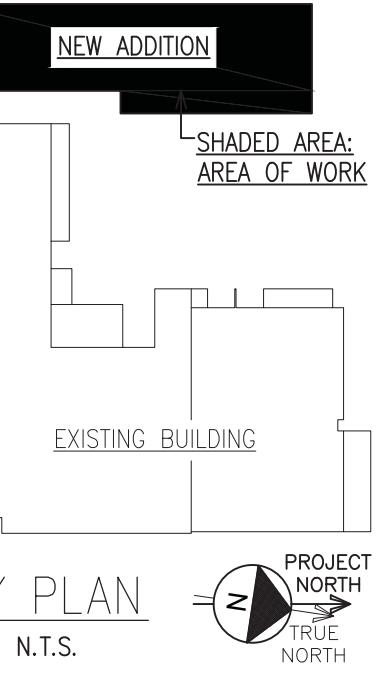
ROCKLAND COUNTY, NEW YORK
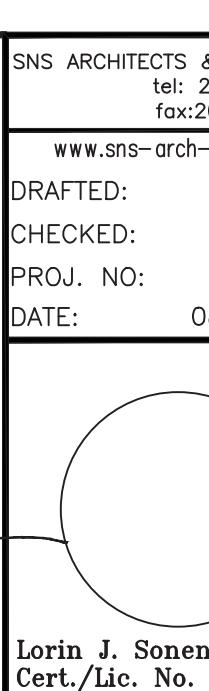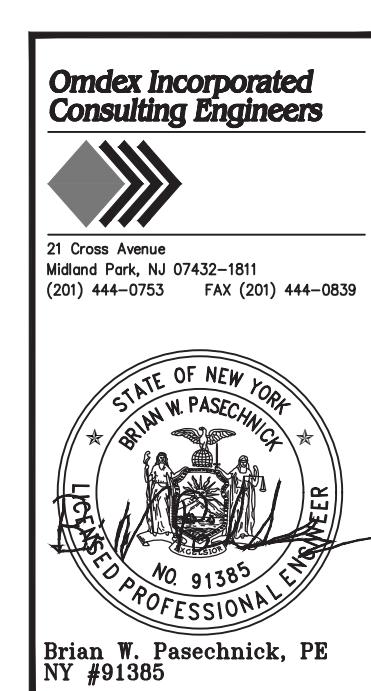
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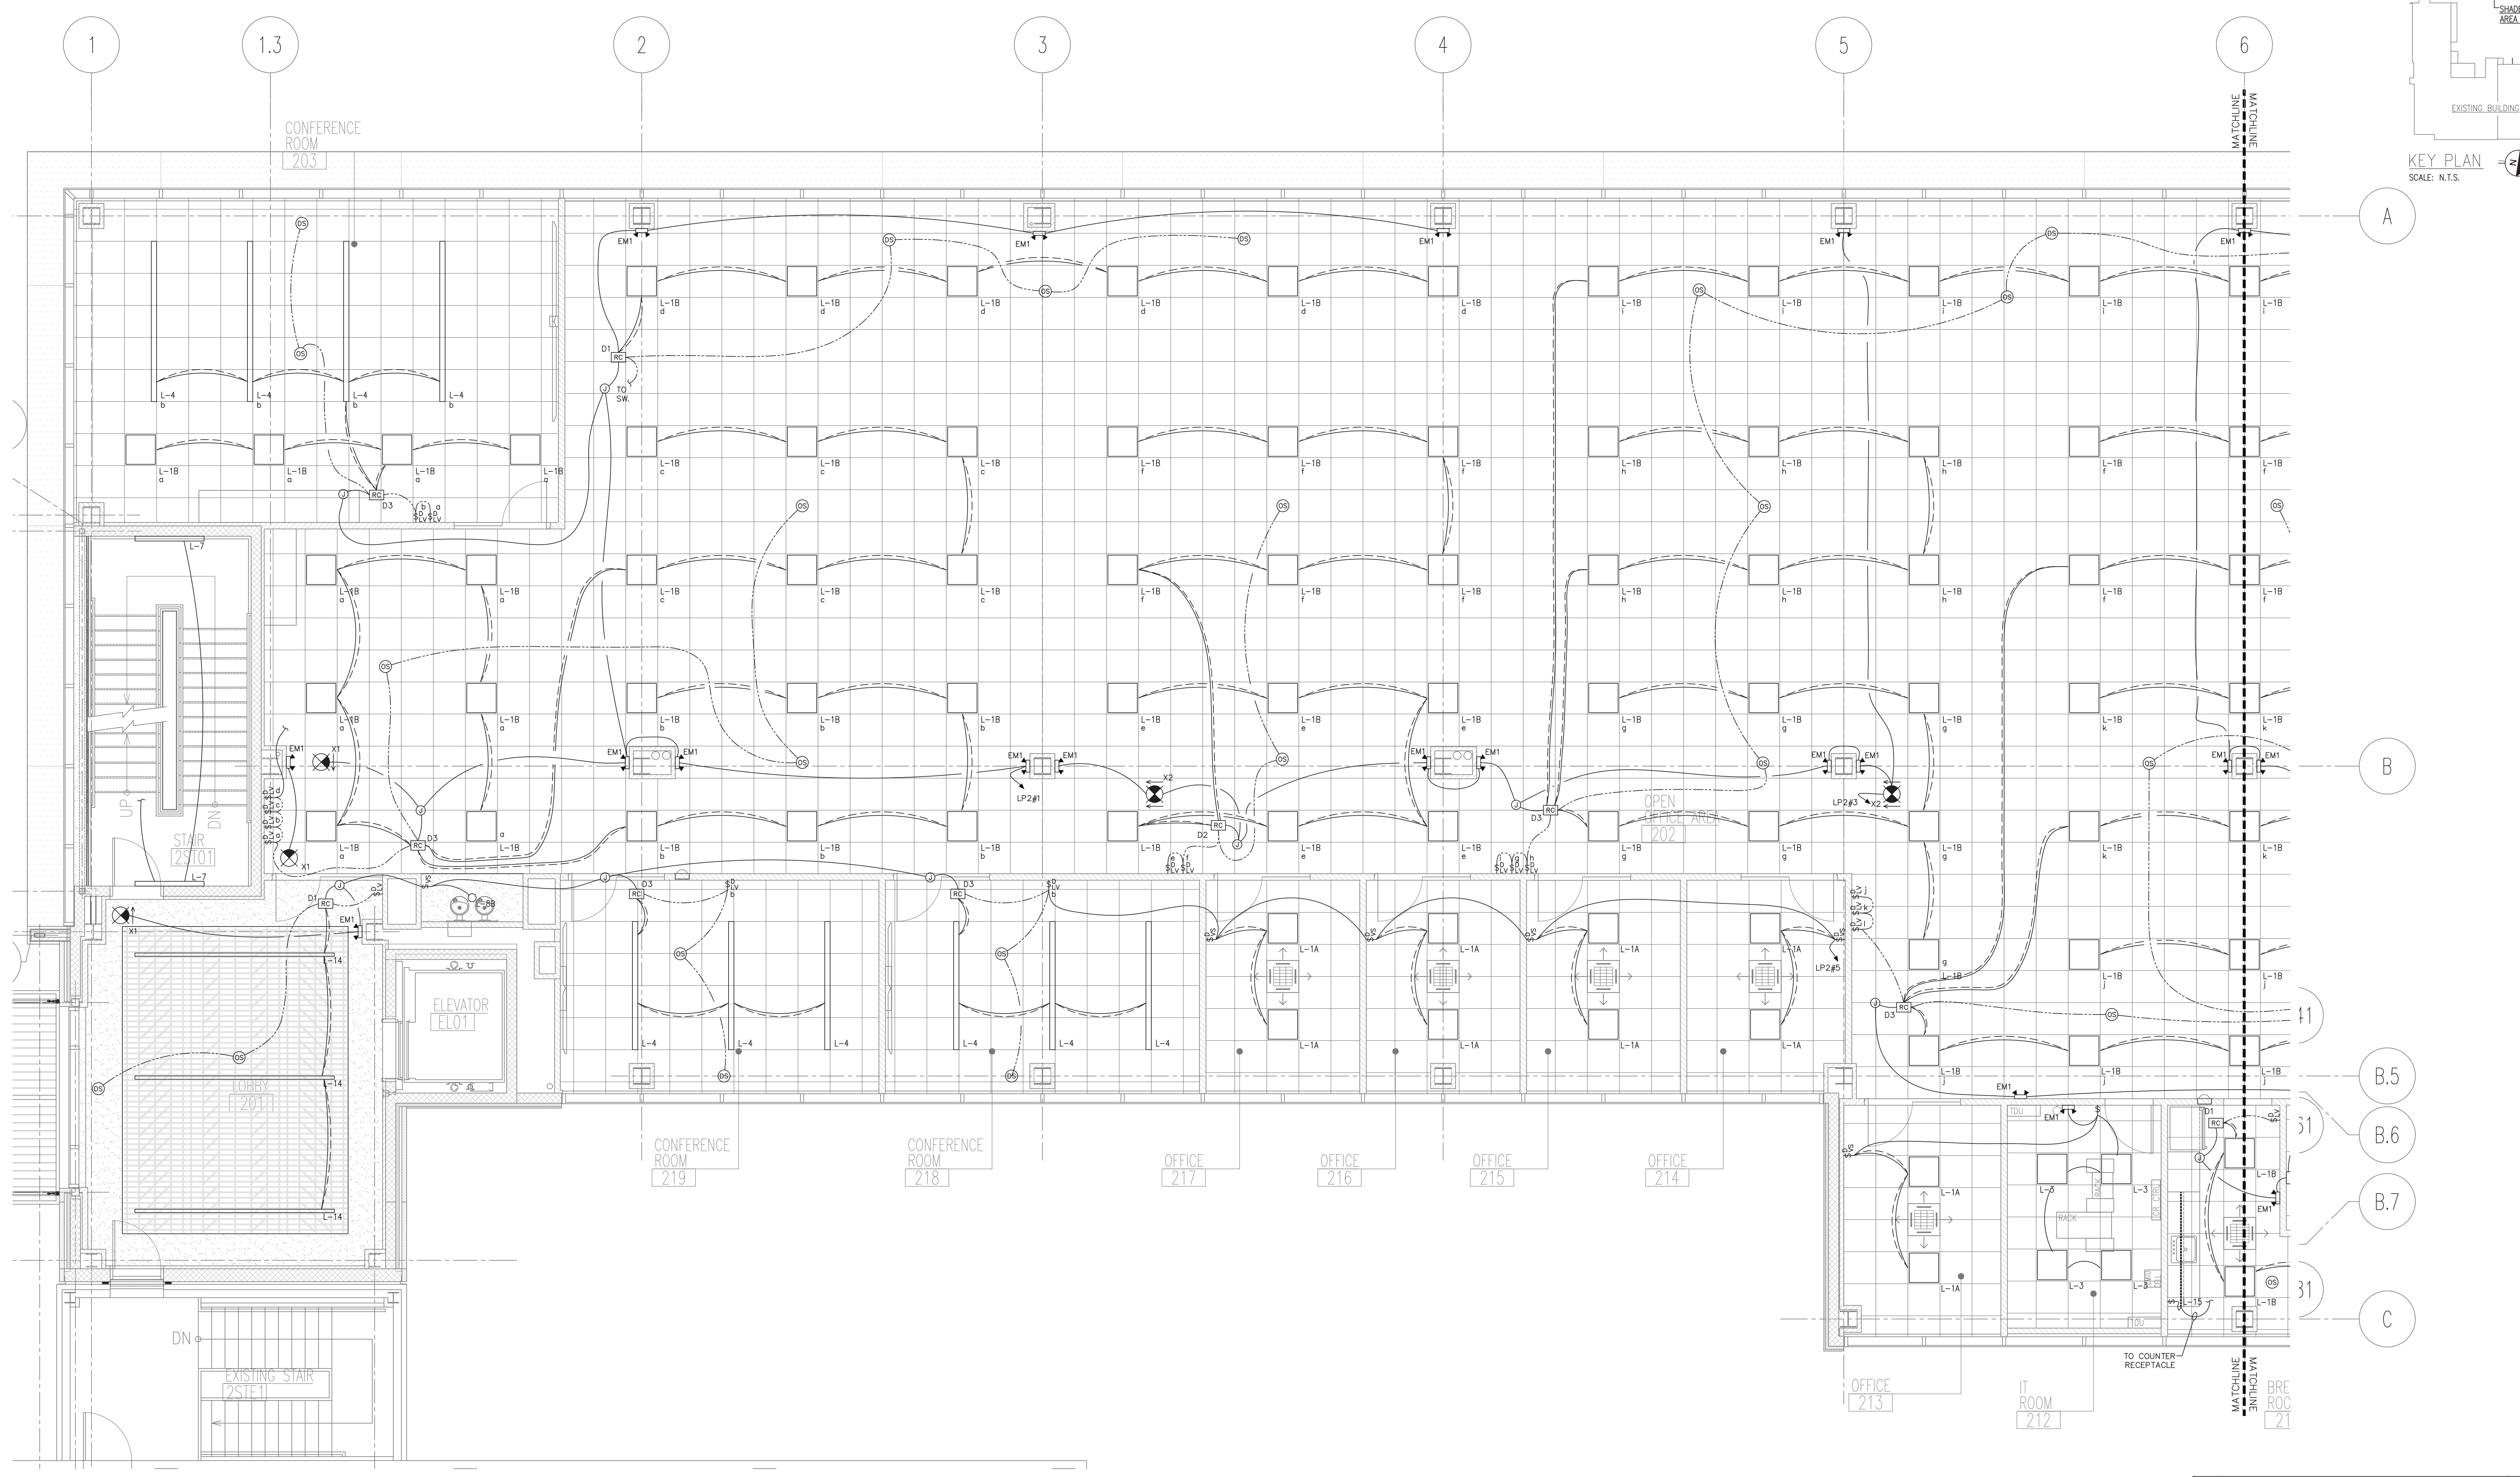
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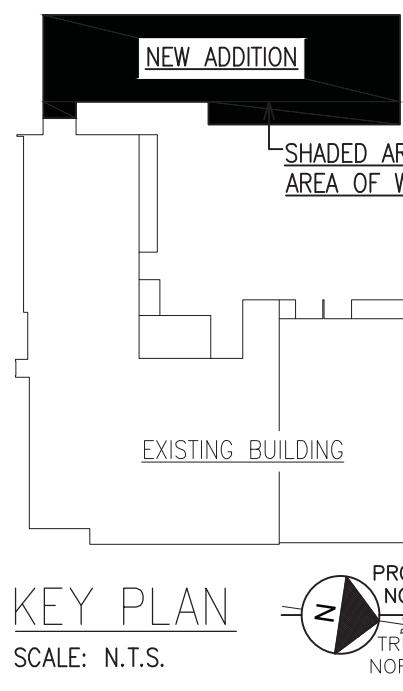
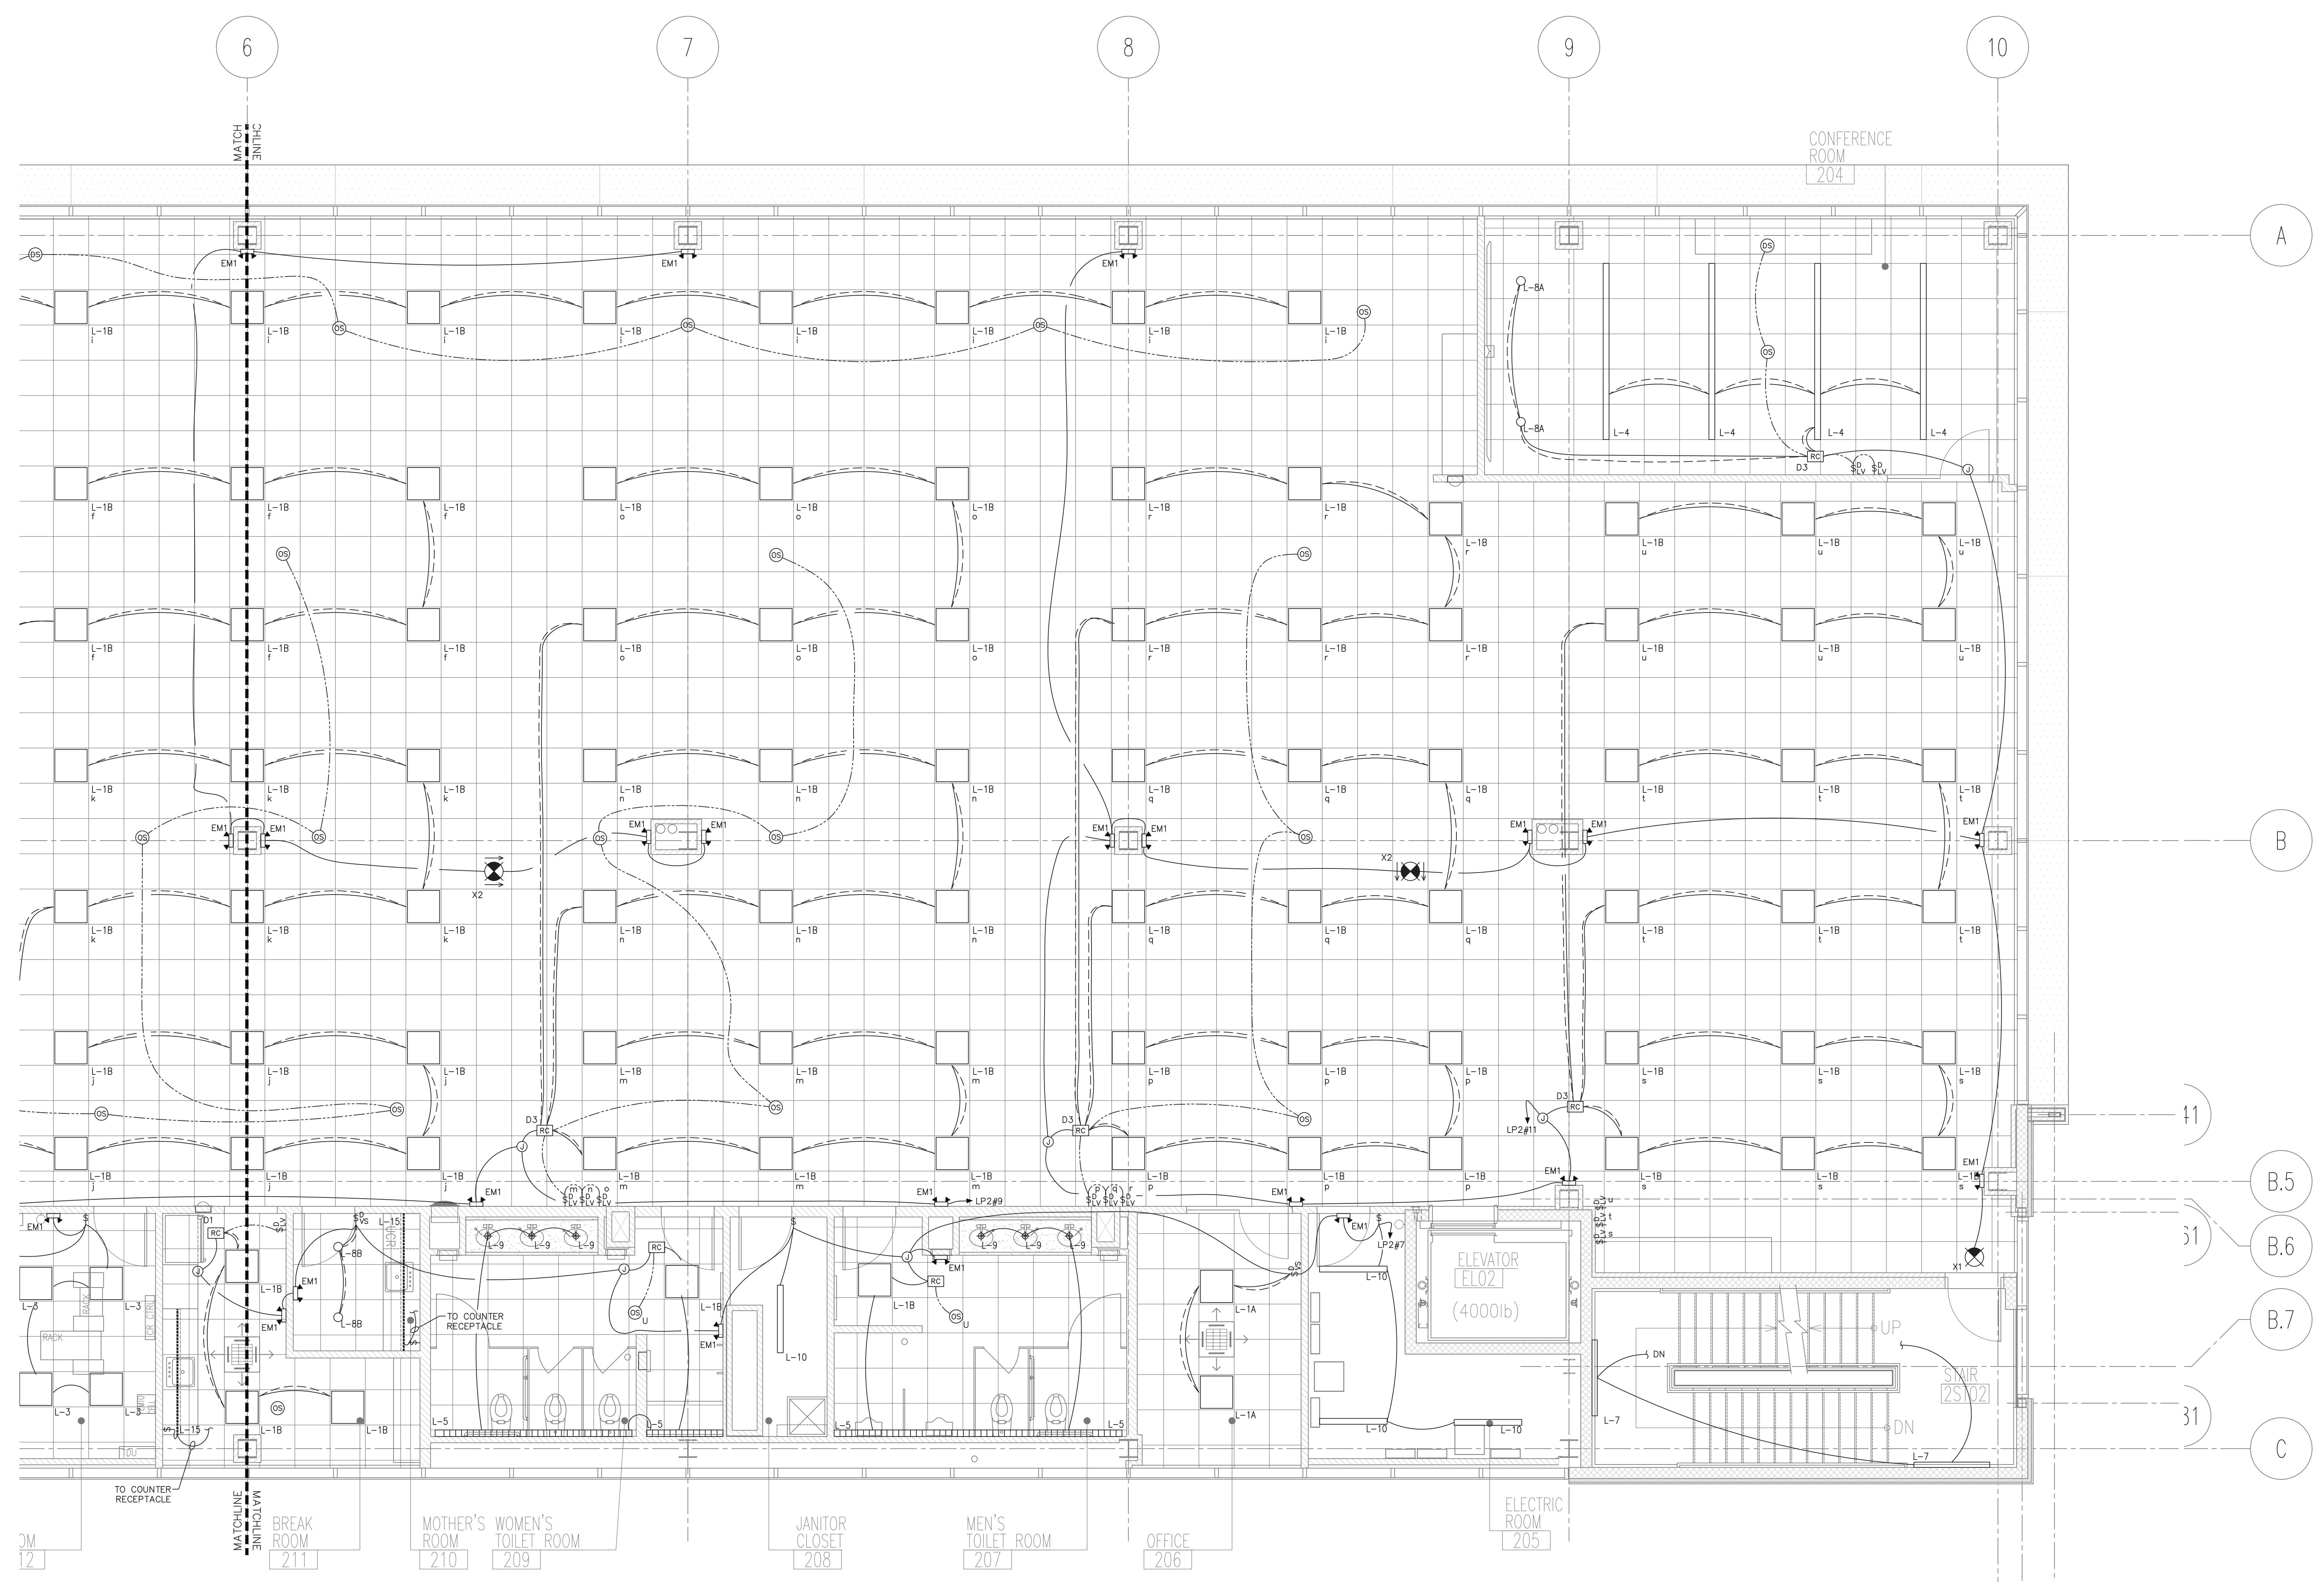


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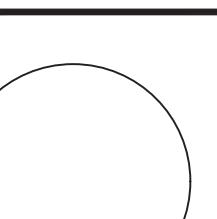



2nd FLOOR PLAN
S C A L E : $1/4'' = 1'-0''$

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		69 OF 95
ROCKLAND COUNTY, NEW YORK		
<ul style="list-style-type: none"> □ John Lignos, AIA ■ Lorin J. Sonenshine, AIA □ Steven Napolitano, PE, PP □ Robert Nocella, AIA 		
Architects & Engineers, PC MONTVALE . NEW JERSEY . 07645		




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 <p>Omdex Incorporated Consulting Engineers</p> <p>21 Cross Avenue Midland Park, NJ 07432-1811 (201) 444-0753 FAX (201) 444-0839</p> <p>STATE OF NEW YORK BRIAN W. PASECHNIK NO. 91385 LICENSED PROFESSIONAL ENGINEER</p> <p>Brian W. Pasechnick, PE NY #91385</p>		<p>SNS ARCHITECTS & ENGINEERS tel: 201.573.1767 fax: 201.573.0808</p> <p>www.sns-arch-eng.com</p> <p>DRAFTED: MJR CHECKED: — PROJ. NO: 5593 DATE: 08.11.2024</p>  <p>Lorin J. Sonenshine, AIA Cert./Lic. No. NY 018401</p>		<p>ENGINEERING REVIEW</p> <table border="1"> <tr> <th>DEPT.</th> <th>SIGNATURE</th> <th>DATE</th> </tr> <tr> <td>CIVIL</td> <td></td> <td></td> </tr> <tr> <td>METERING</td> <td></td> <td></td> </tr> <tr> <td>RELAY</td> <td></td> <td></td> </tr> <tr> <td>TRANS. & SUB.</td> <td></td> <td></td> </tr> </table>		DEPT.	SIGNATURE	DATE	CIVIL			METERING			RELAY			TRANS. & SUB.			<p>APPROVED</p> <table border="1"> <tr> <td>DATE</td> </tr> <tr> <td><input type="checkbox"/> INFORMATION</td> </tr> <tr> <td><input type="checkbox"/> COMMENTS</td> </tr> <tr> <td><input type="checkbox"/> BID</td> </tr> <tr> <td><input type="checkbox"/> CONSTRUCTION</td> </tr> <tr> <td><input type="checkbox"/> _____</td> </tr> </table>		DATE	<input type="checkbox"/> INFORMATION	<input type="checkbox"/> COMMENTS	<input type="checkbox"/> BID	<input type="checkbox"/> CONSTRUCTION	<input type="checkbox"/> _____	<p>ELECTRICAL PARTIAL SECOND FLOOR PLAN - LIGHTING</p> <p>SVOC NEW OFFICE ADDITION</p> <p>TAX MAP ID 56.52-1-2 390 WEST ROUTE 59 VILLAGE OF SPRING VALLEY TOWN OF RAMAPO ROCKLAND COUNTY, NEW YORK</p> <p>AS NOTED</p> <p>VILLAGE OF SPRING VALLEY</p> <p>SCALE</p> <p>FILE NO.</p> <p>DRAWING NUMBER</p> <p>SHEET</p> <p>REV.</p> <p>E-202B</p> <p>70 OF 95</p> <p>ROCKLAND COUNTY, NEW YORK</p> <ul style="list-style-type: none"> □ John Lignos, AIA ■ Lorin J. Sonenshine, AIA □ Steven Napolitano, PE, F □ Robert Nocella, AIA 			
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1 3rd FLOOR PLAN
SCALE: 1/4" = 1'-0"

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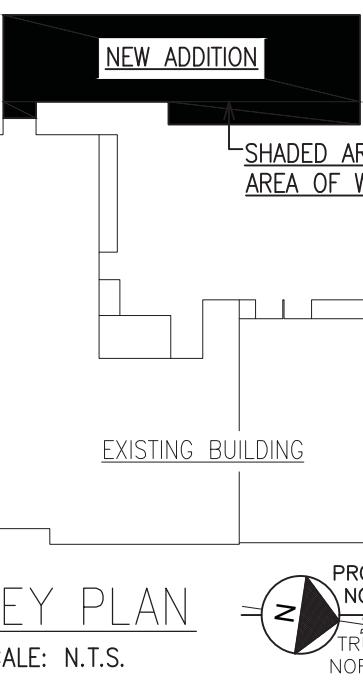
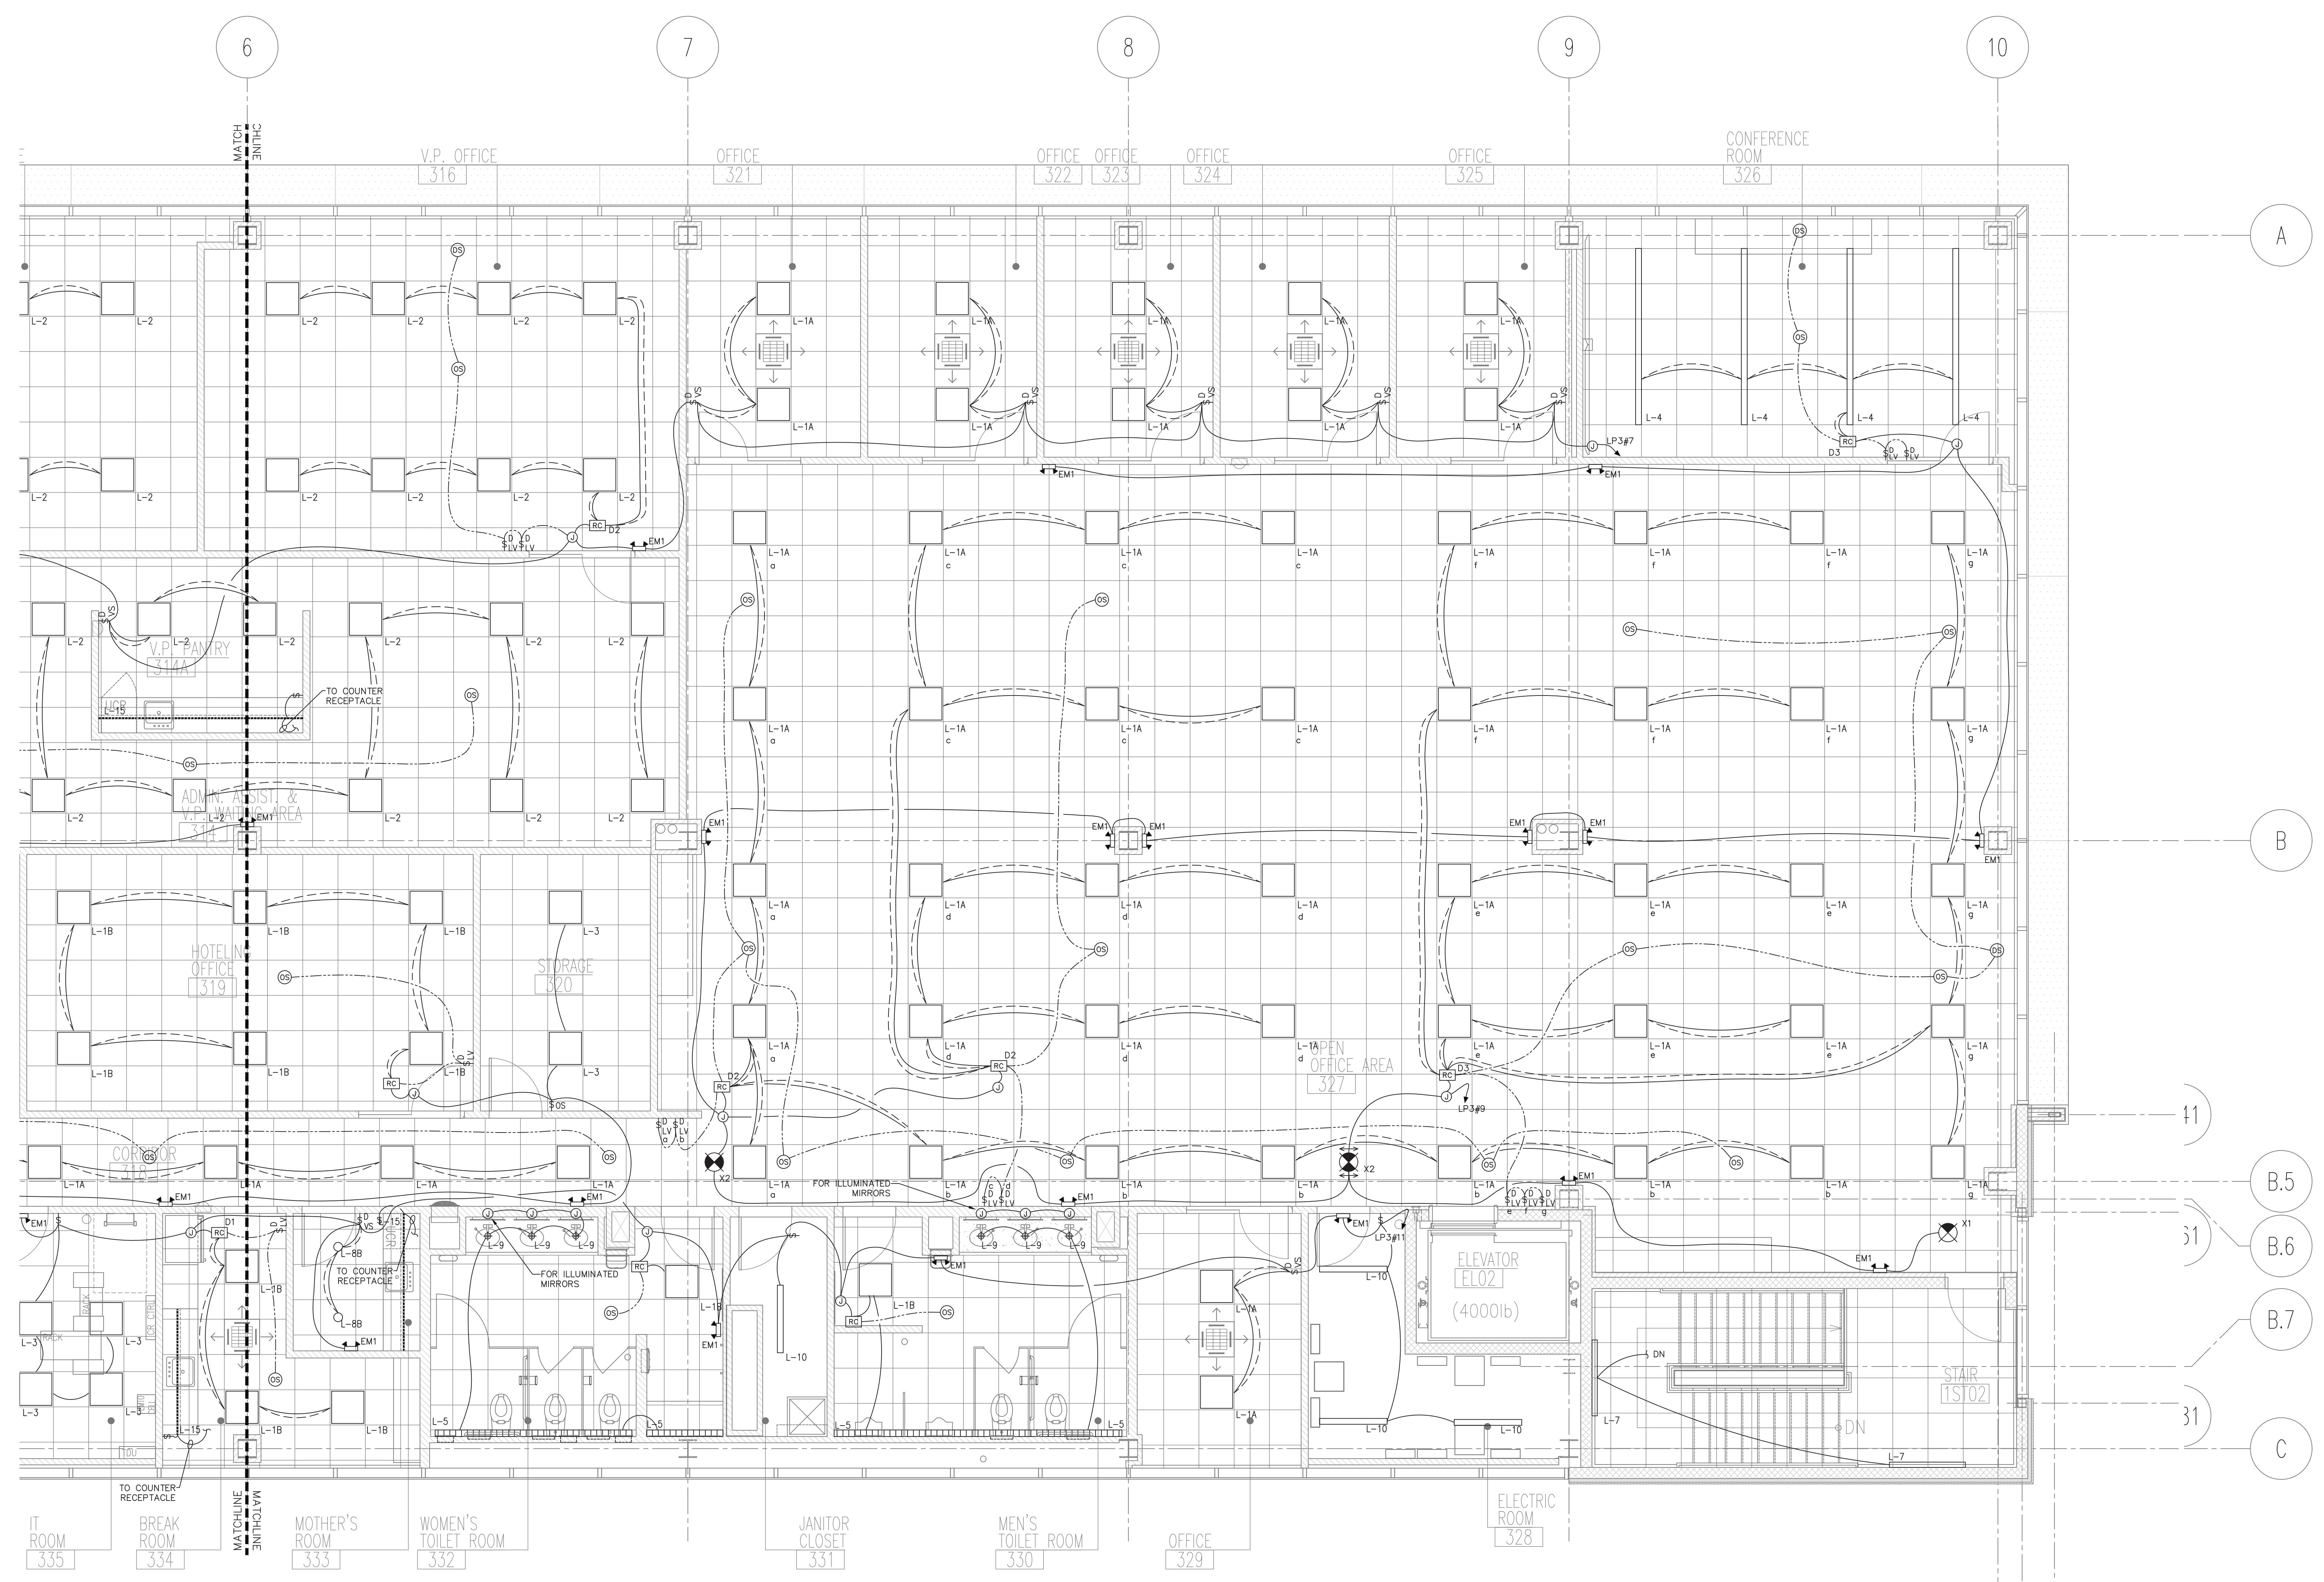


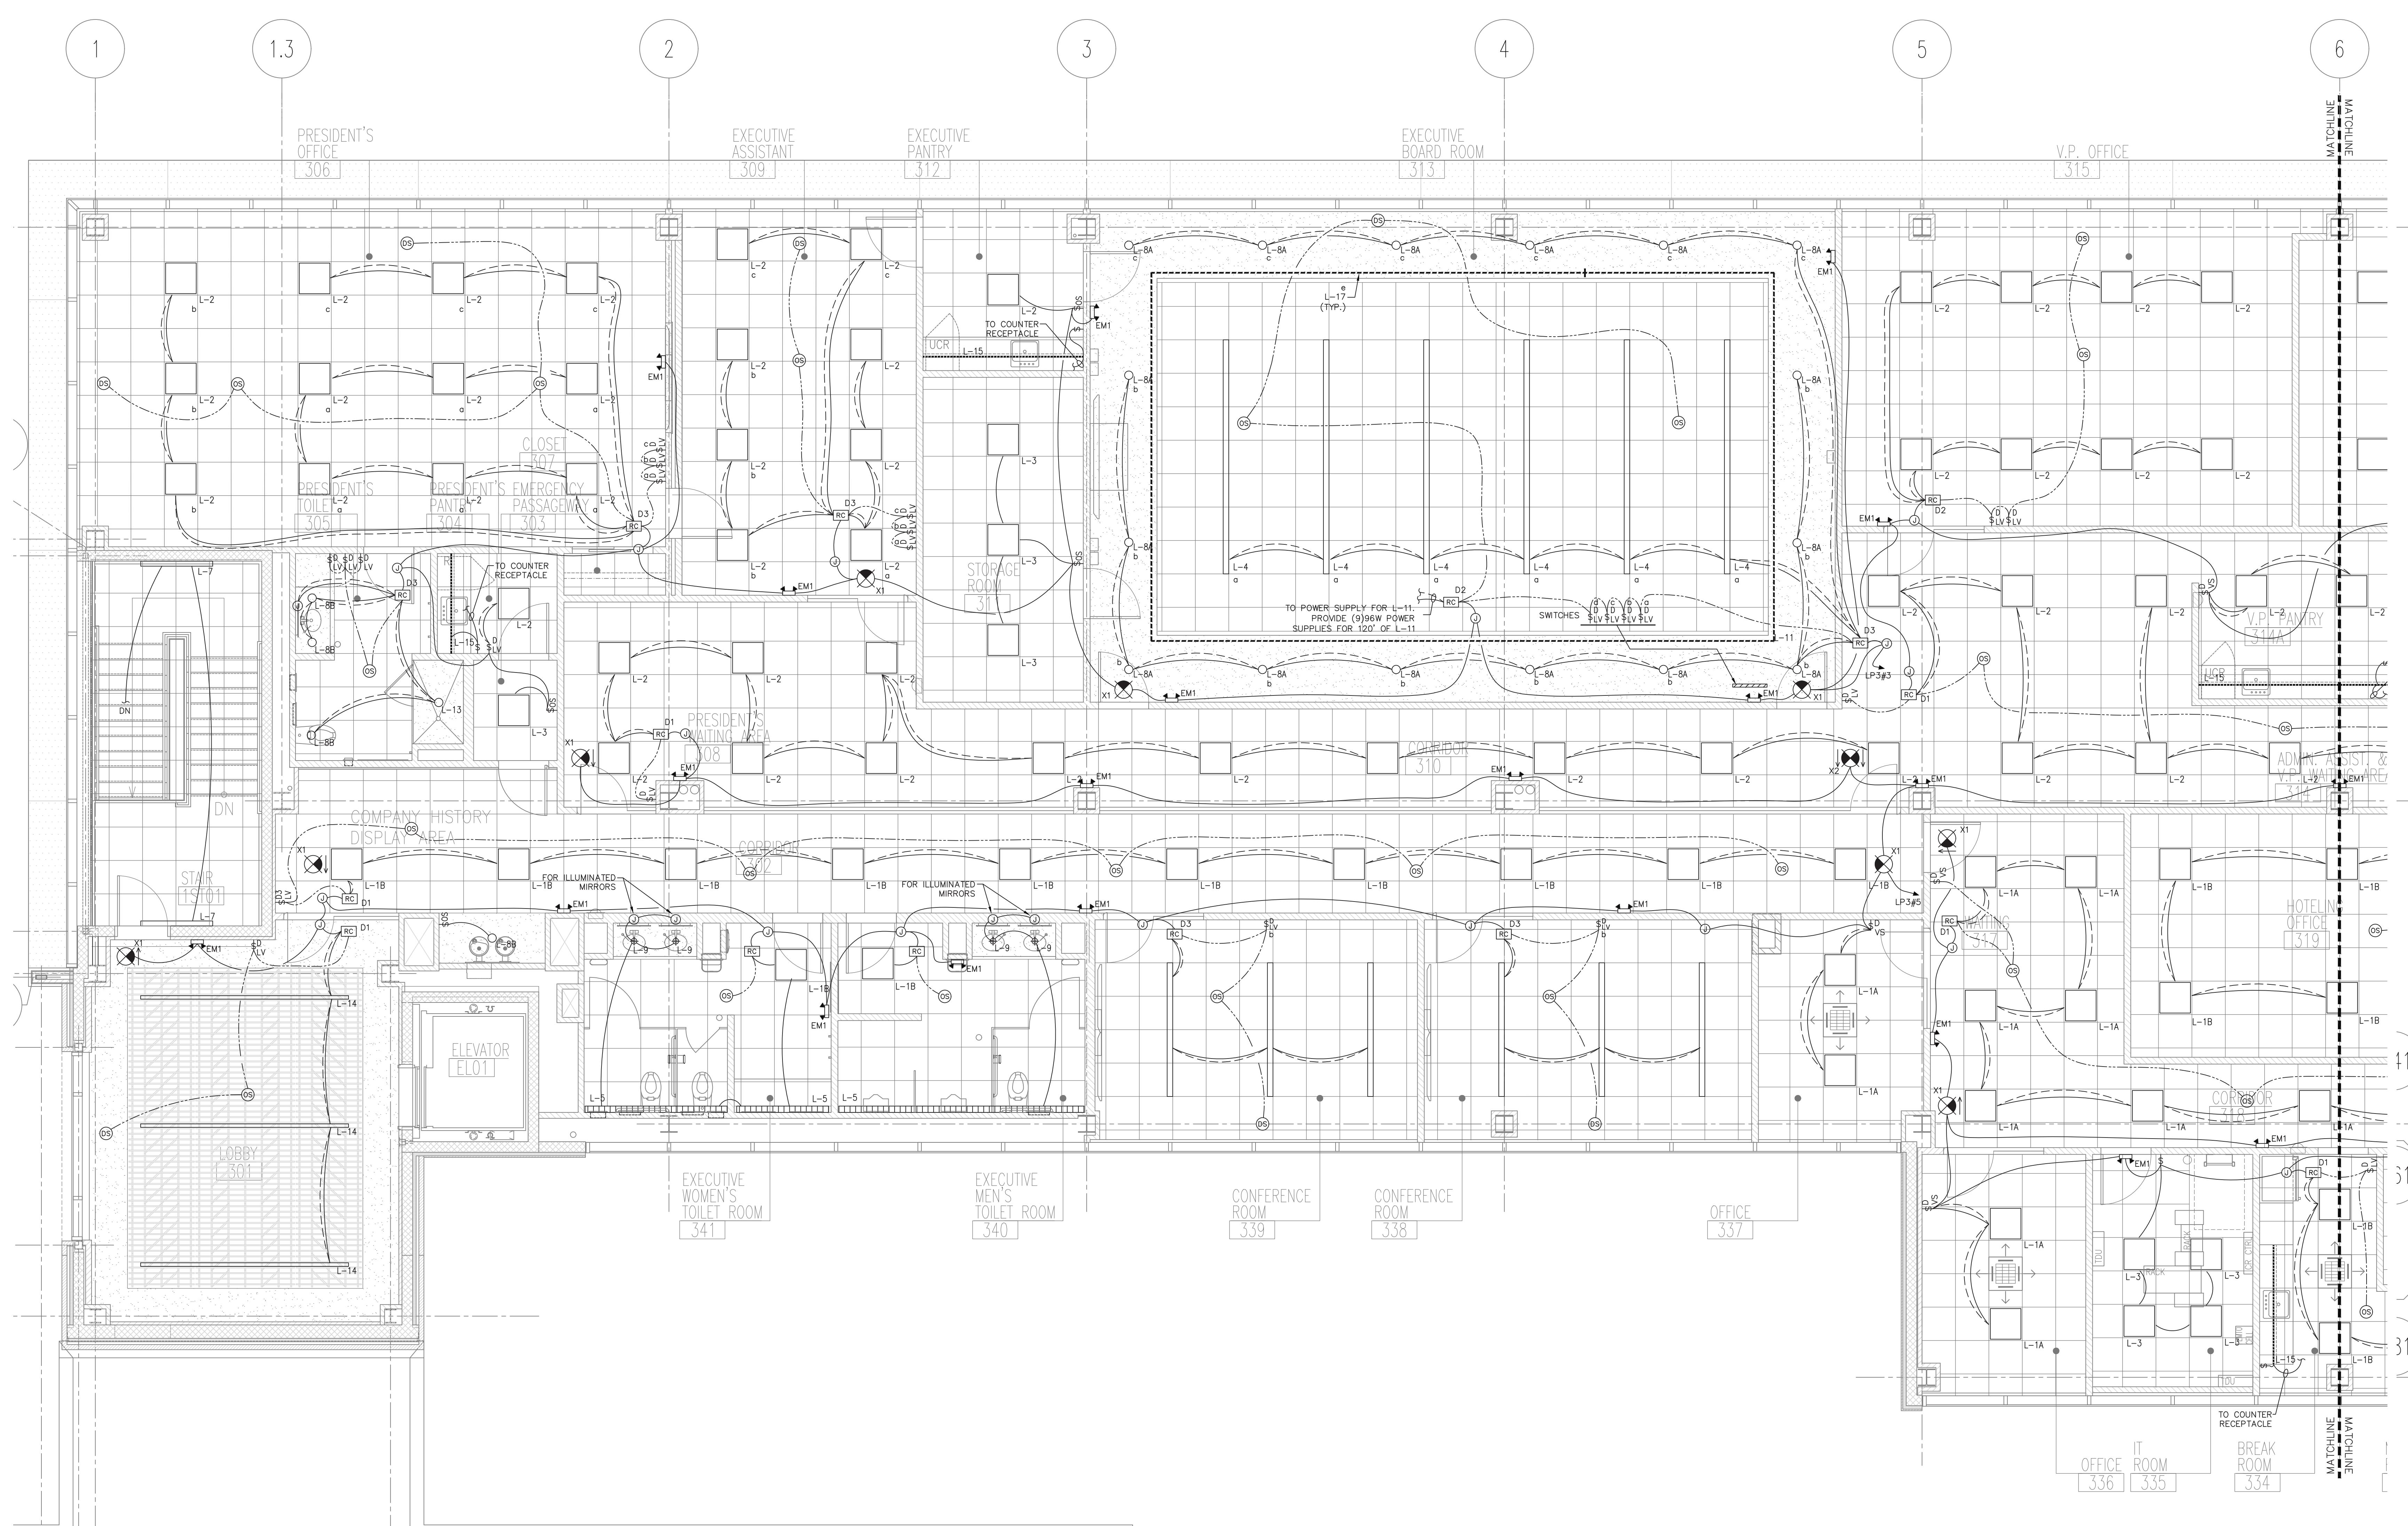STATE OF NEW YORK
BUREAU OF PROFESSIONAL ENGINEERS
NO. 91385
NY

Bratt Pasechnick, PE
#91385

Lorin J. Sonenshine, AIA
Cert./Lic. No. NY 018401


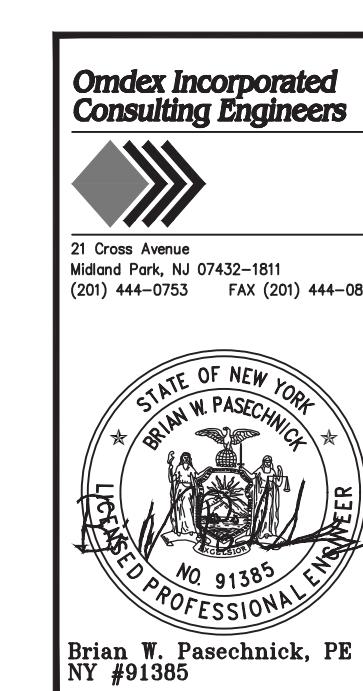
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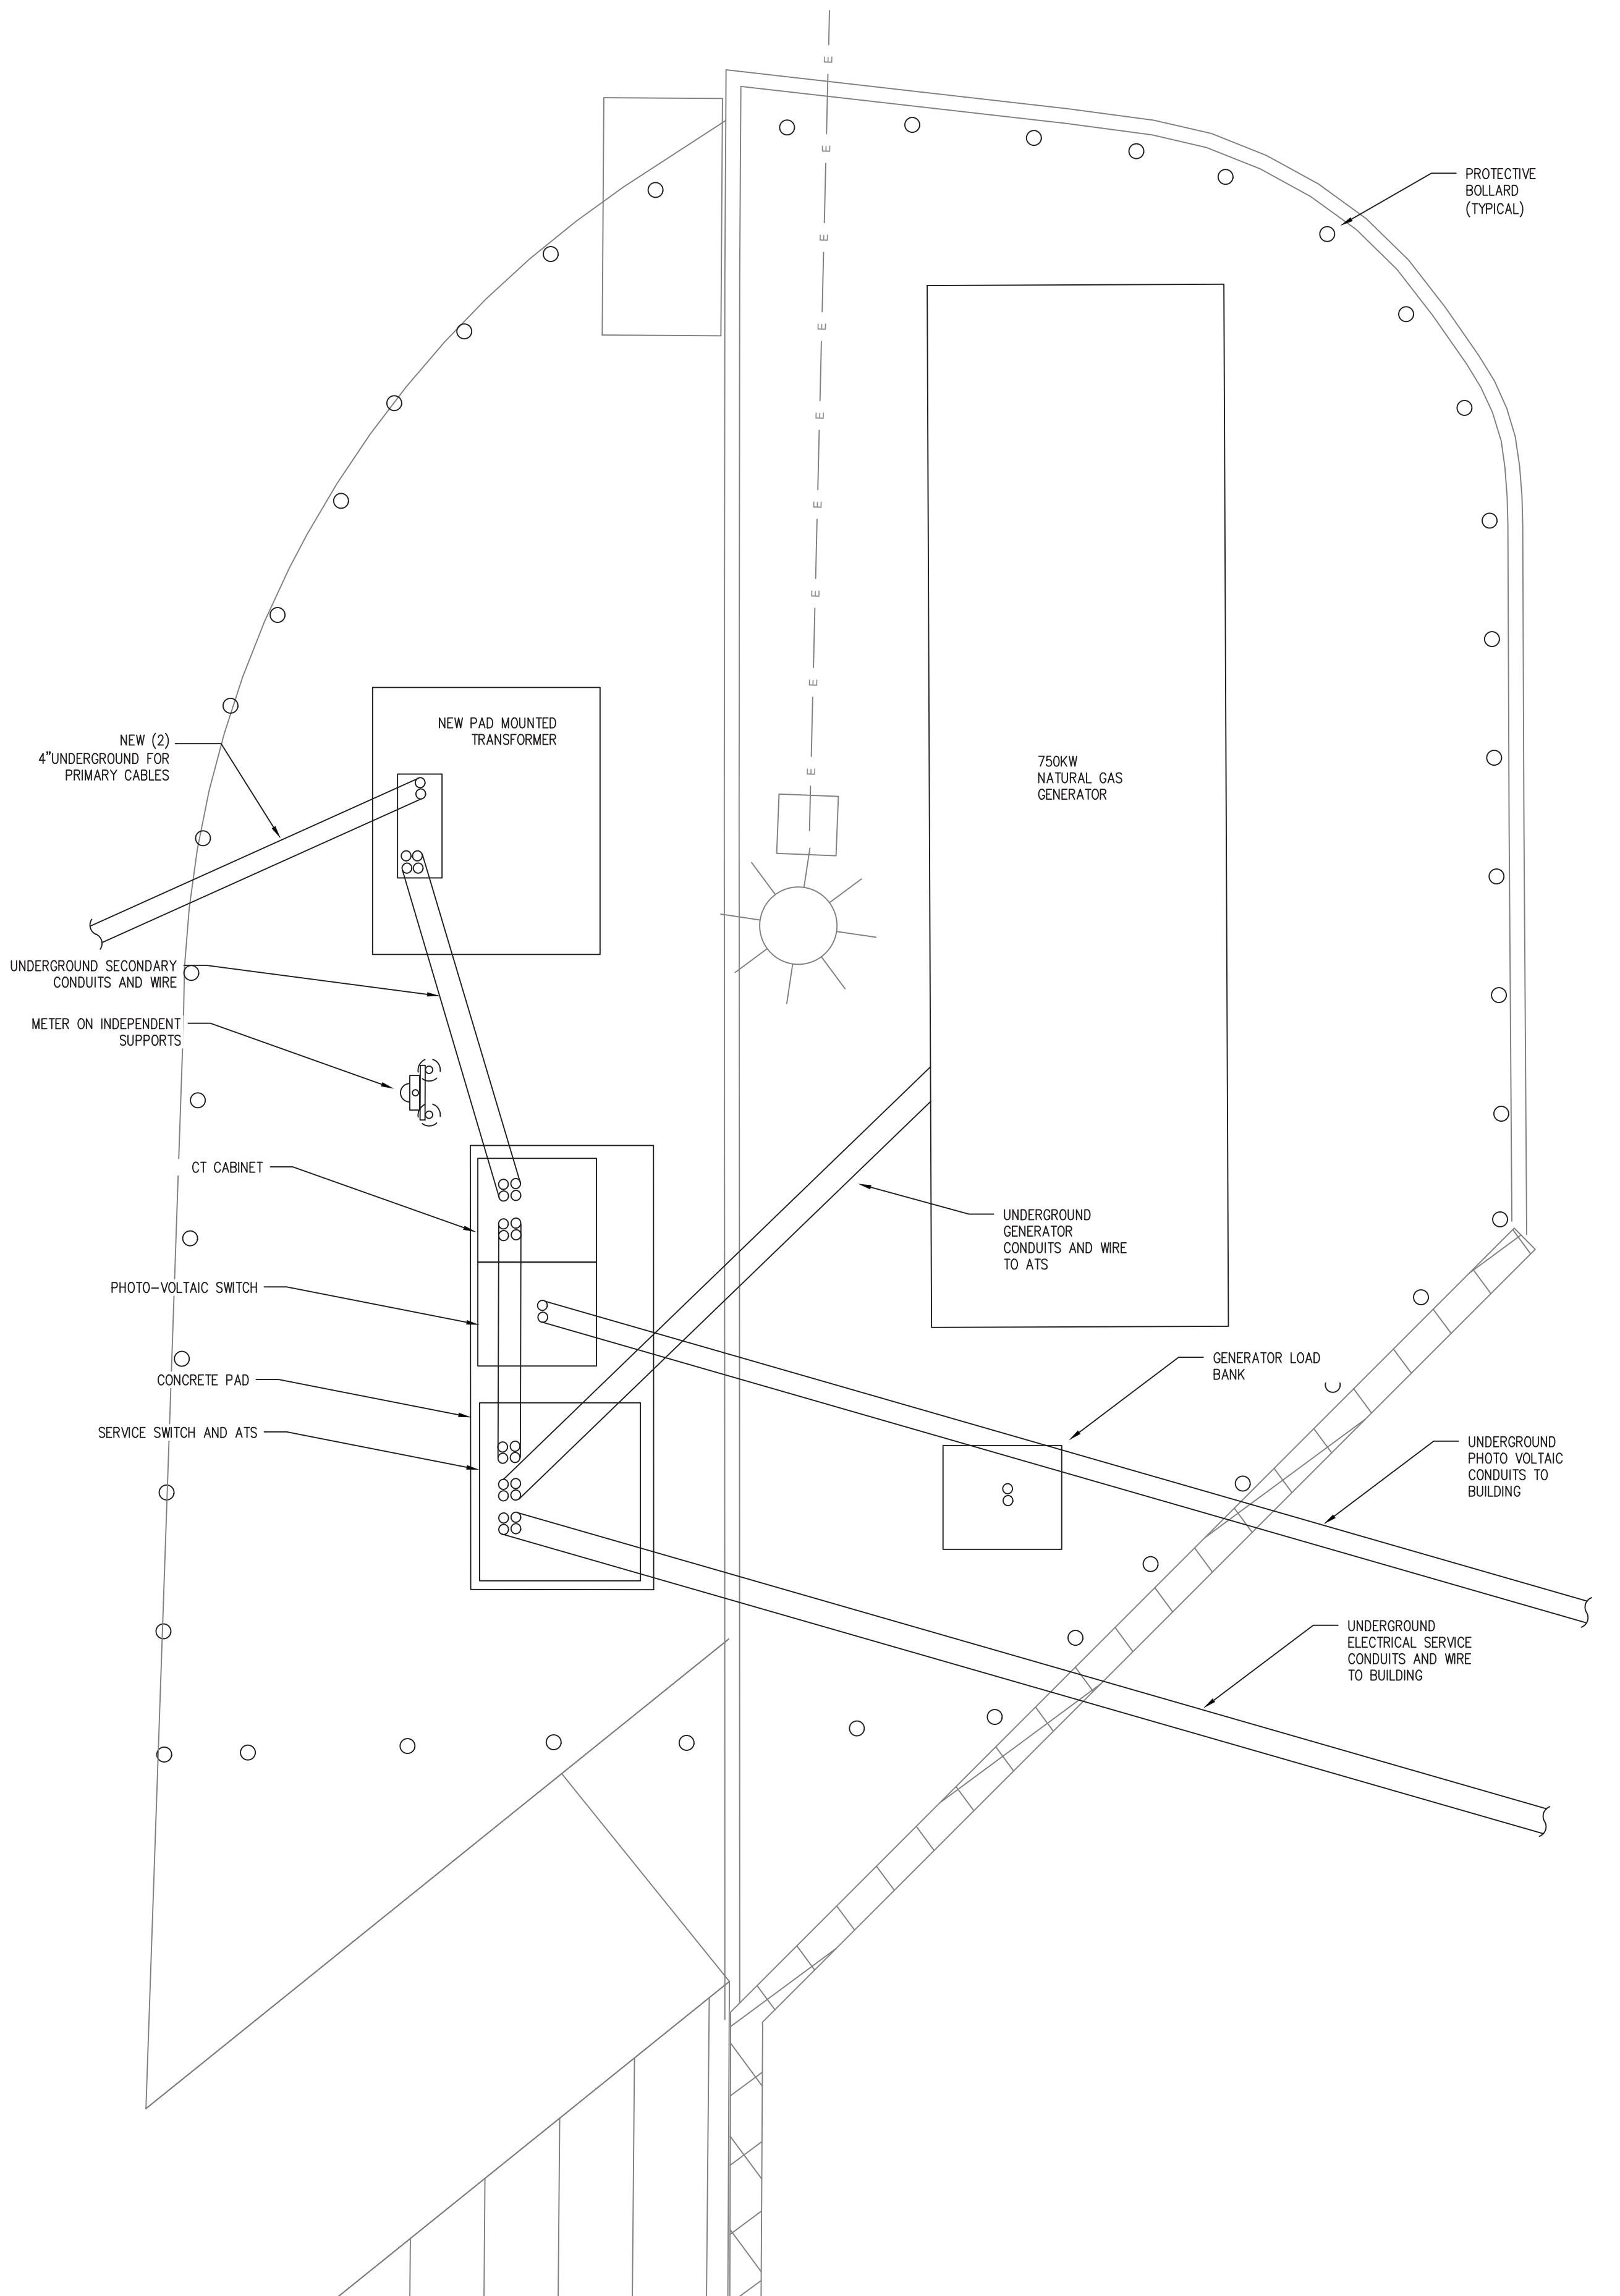
1 3rd FLOOR PLAN
S C A L E : $1/4"$ = $1'-0"$

SCALE : $1/4"$ = $1'-0"$

SNS ARCHITECTS & ENGINEERS tel: 201.573.1767 fax: 201.573.0808		ENGINEERING REVIEW			APPROVED		ELECTRICAL PARTIAL THIRD FLOOR PLAN - LIGHTING				
		DEPT.	SIGNATURE	DATE		DATE					
www.sns-arch-eng.com		CIVIL			<input type="checkbox"/> INFORMATION						
DRAFTED:	MJR	METERING			<input type="checkbox"/> COMMENTS						
CHECKED:	-	RELAY			<input type="checkbox"/> BID						
PROJ. NO:	5593	TRANS. & SUB.			<input type="checkbox"/> CONSTRUCTION						
DATE:	08.11.2024				<input type="checkbox"/>						
		DWN	DES	CHKD	SCALE	FILE NO.	DRAWING NUMBER	SHEET	REV.		
		DESIGN REVIEW		DATE	AS NOTED		E-203B	72 OF 95			
VILLAGE OF SPRING VALLEY										ROCKLAND COUNTY, NEW YORK	
 SNS Architects & Engineers, PC											<ul style="list-style-type: none"> □ John Lignos, AIA ■ Lorin J. Sonenshine, AIA □ Steven Napolitano, PE, PP □ Robert Nocella, AIA
ONE PARAGON DRIVE . MONTVALE . NEW JERSEY . 07645											




1 ELECTRICAL SITE PL
S C A L E : 1/30" = 1'-0"

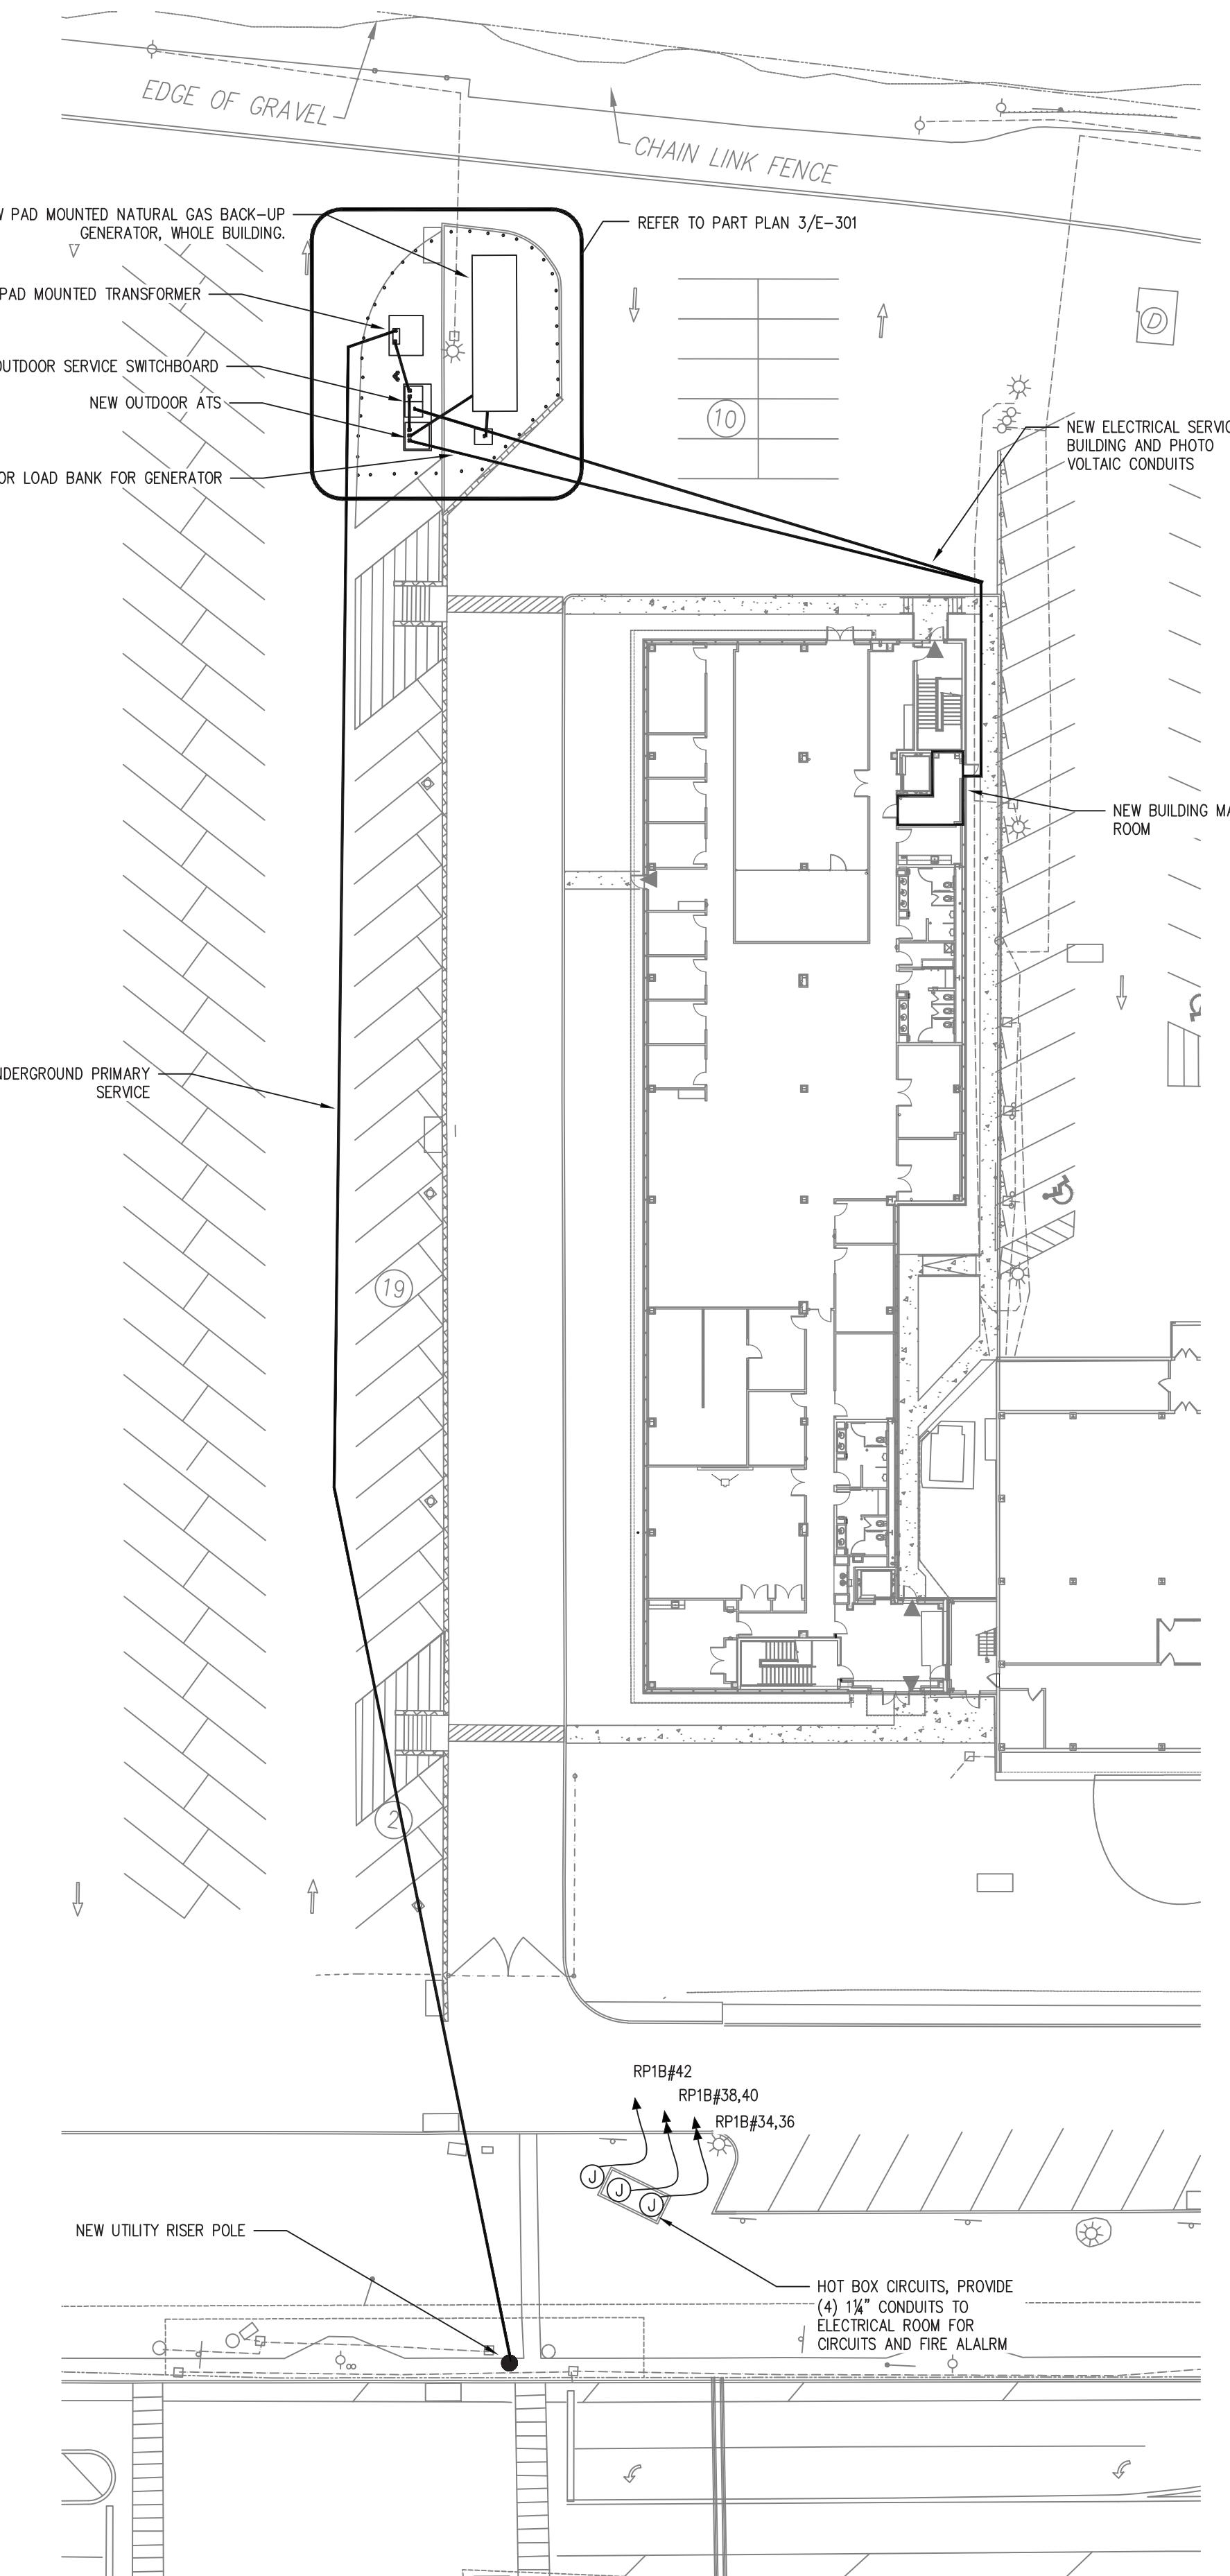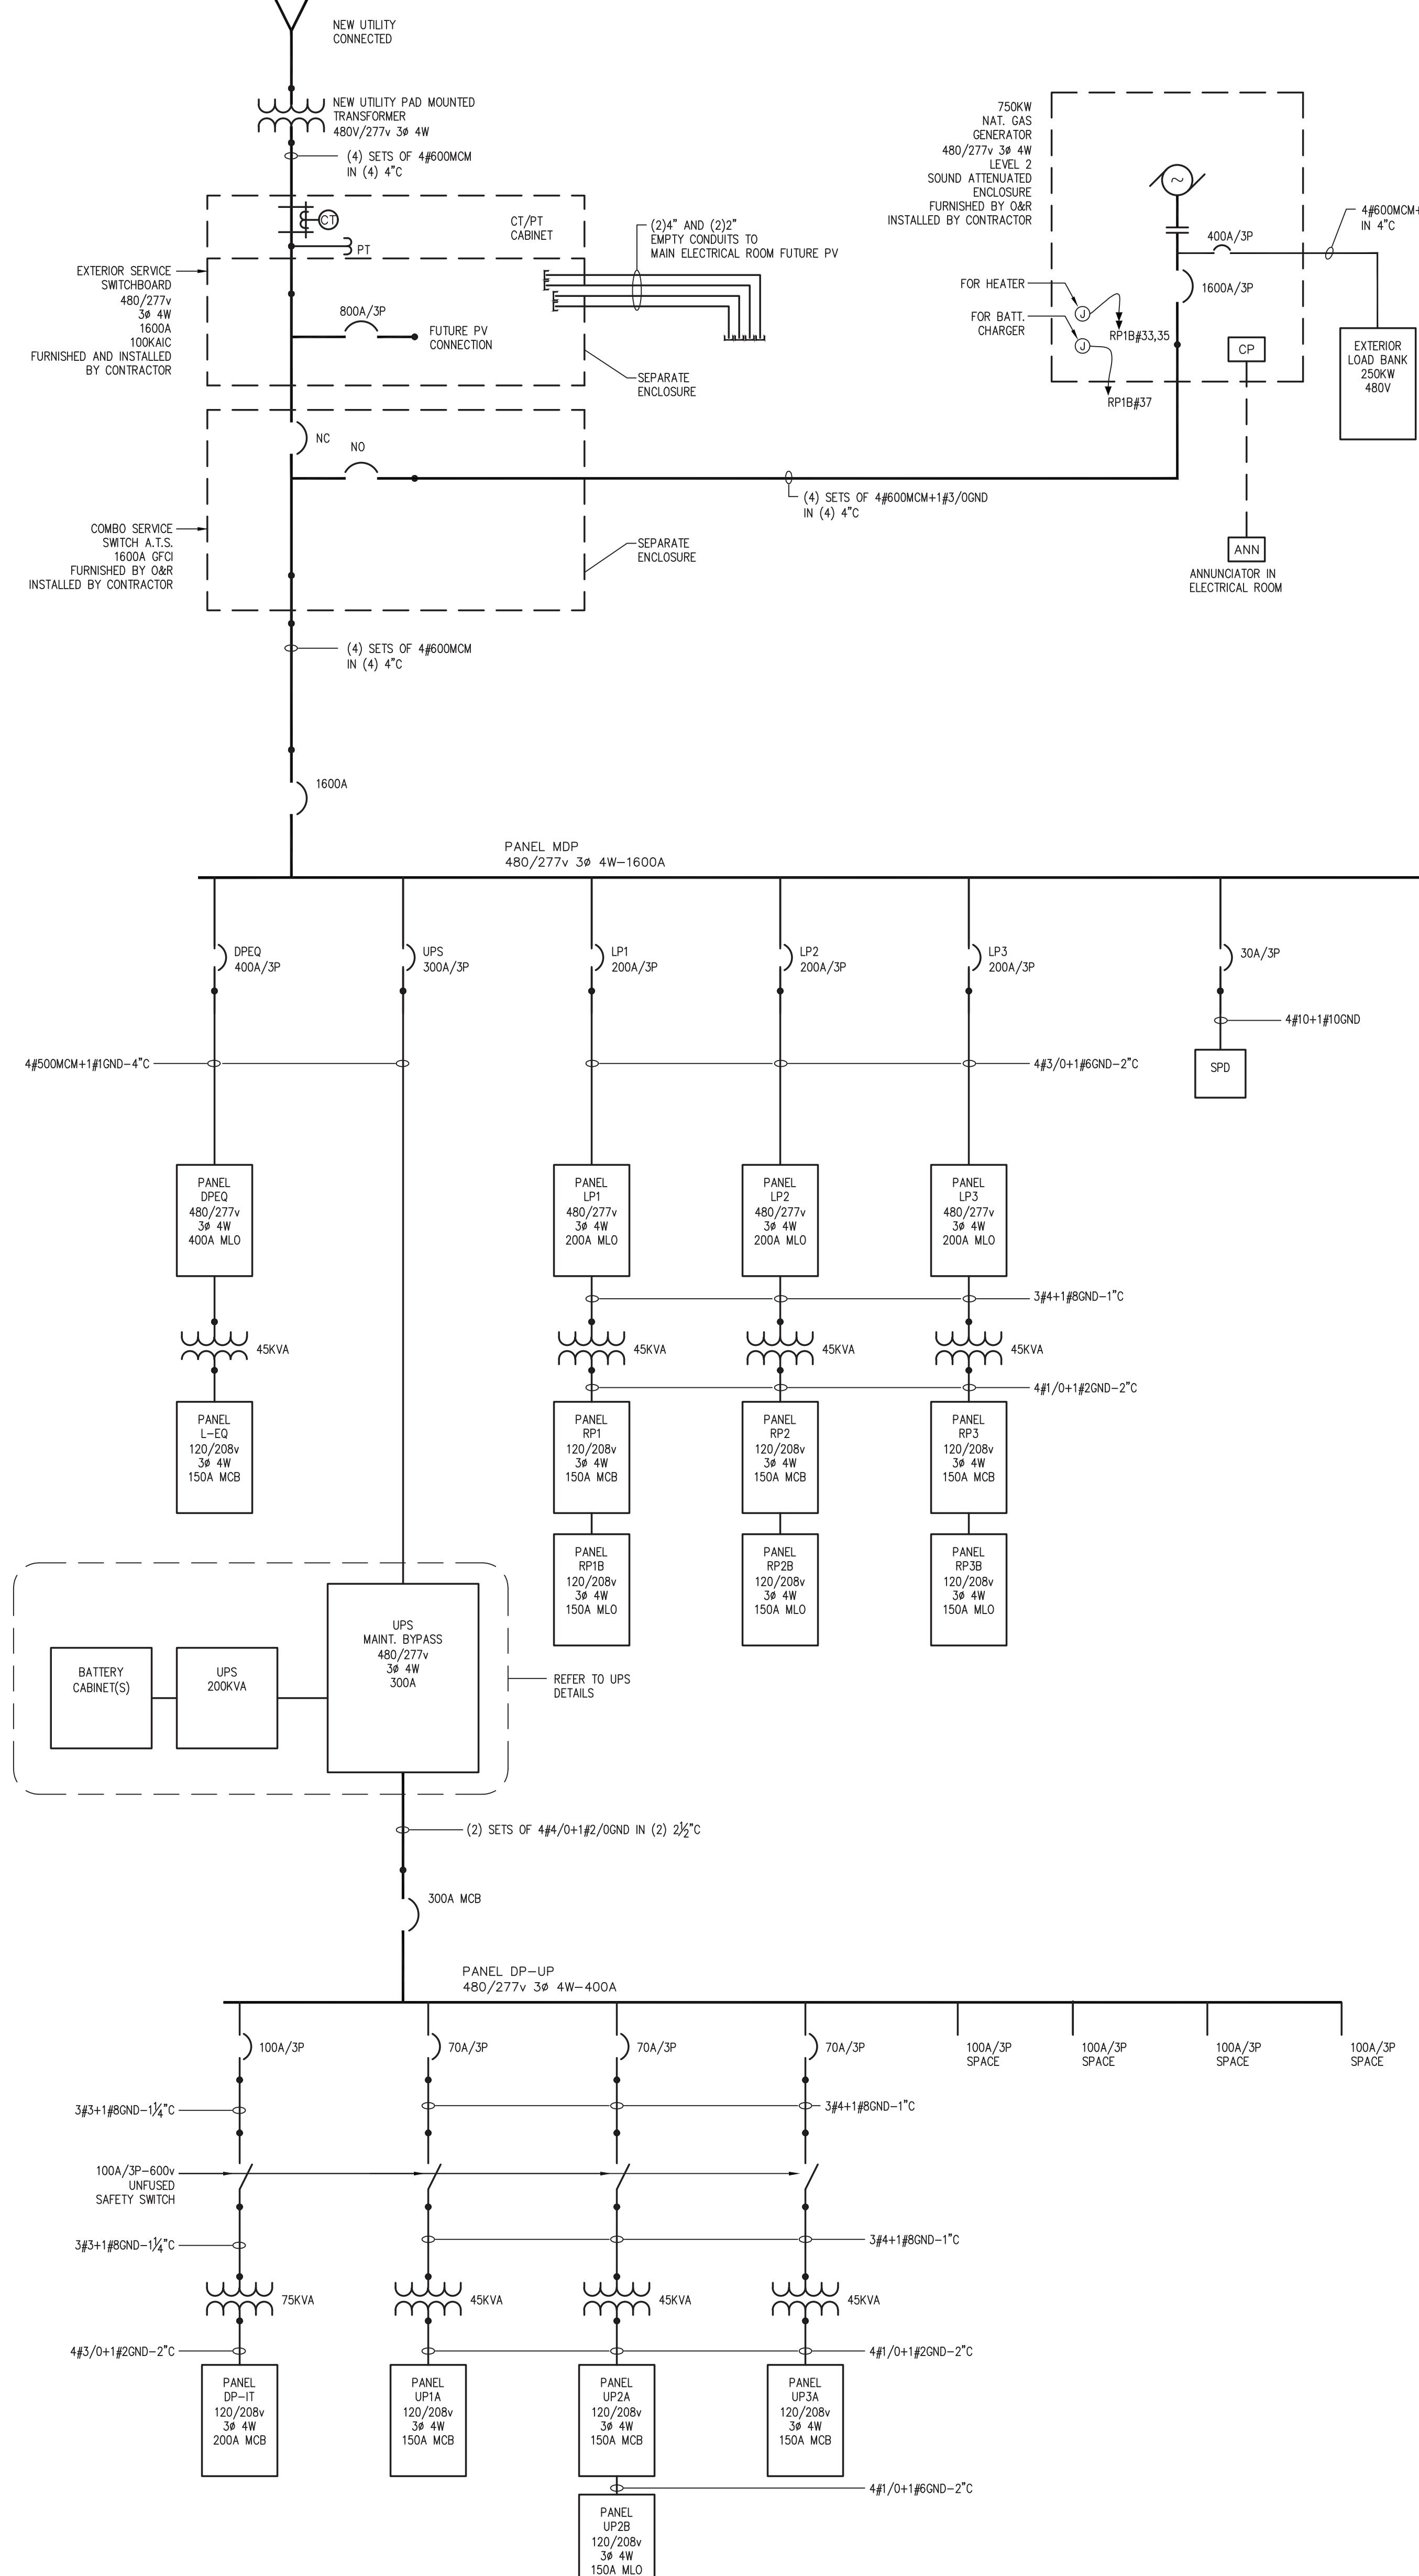

3 OUTDOOR ELECTRICAL SERVICE AREA PART PLAN
S C A L E : $1/4"$ = $1'-0"$

SINGLE LINE DIAGRAM

SCALE: NONE

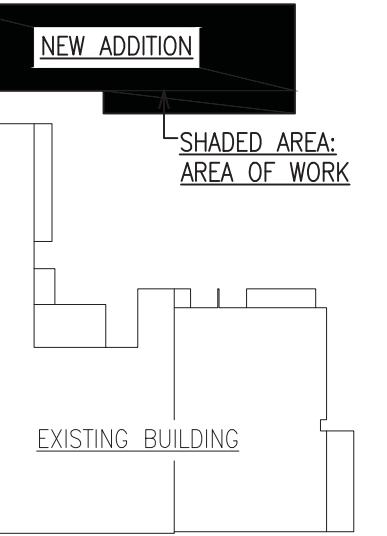

KEY PLAN

SCALE: N.T.S.

PANEL MDP									
480 / 277 VOLTS		SURFACE MOUNTING		1600 AMP 3 POLE		INTEGRATED EQUIPMENT RATING 65,000 A. SYM.			
3 & 4 WIRE+GND		MCB		MLO					
CKT No.	LOAD SERVED	POLES	FRAME	TRIP	LOAD	FEEDER			
1	PANEL DP-EQ	3	400A	400A	227.6 KVA	4#500CM+1#GND-4°C			
2	UPS	3	400A	300A	81.5 KVA	4#500CM+1#GND-4°C			
3	PANEL LP1	3	225A	200A	74.2 KVA	4#3/0+1#GND-2°C			
4	PANEL LP2	3	225A	200A	60.3 KVA	4#3/0+1#GND-2°C			
5	PANEL LP3	3	225A	200A	52.9 KVA	4#3/0+1#GND-2°C			
6	SPARE	3	225A	200A	-	-			
7	SPACE	3	225A	-	-	-			
8	SPACE	3	225A	-	-	-			
9	SPACE	3	100A	-	-	-			
10	SPACE	3	100A	-	-	-			

PANEL DP-EQ									
480 / 277 VOLTS		SURFACE MOUNTING		400 AMP 3 POLE		INTEGRATED EQUIPMENT RATING 44,000 A. SYM.			
3 & 4 WIRE+GND		MCB		MLO					
KVA	LOAD SERVED	NO. OCP	#A #B #C	OCP NO.	LOAD SERVED	KVA			
8.6	ACCU-S-1	1 40A		40A 2	ACCU-N-1	8.6			
8.6	3#6+1#GND-1°C	3 3P		3P 4	3#8+1#GND-3°C	8.6			
8.6	5			5	-	8.6			
8.6	ACCU-S-2	7 40A		40A 8	ACCU-N-2	8.6			
8.6	3#6+1#GND-1°C	9 3P		3P 10	3#8+1#GND-3°C	8.6			
8.6	11			12	-	8.6			
8.6	ACCU-S-3	13 40A		40A 14	ACCU-N-3	8.6			
8.6	3#6+1#GND-1°C	15 3P		3P 16	3#8+1#GND-3°C	8.6			
8.6	17			18	-	8.6			
7.5	35A 20			35A 20	EVN-N	7.5			
7.5	3#8+1#GND-3°C	21 3P		3P 22	3#8+1#GND-3°C	7.5			
7.5	23			24	-	7.5			
9.3	PANEL L-EQ	25 70A		70A 1	PANEL UP1A	5.0			
9.3	3#4+1#GND-1°C	27 3P		3P 4	3#4+1#GND-1°C	5.0			
9.3	29			30	SPACE	-			
9.3	31			32	SPACE	-			
9.3	33			34	SPACE	-			
9.3	35			36	SPACE	-			
9.3	37			38	SPACE	-			
9.3	39			40	SPACE	-			
9.3	41			42	SPACE	-			



HEAT PUMP LOAD 182.6 KVA x 100% = 182.6 KVA
VENTILATION 45.0 KVA x 100% = 45.0 KVA
TOTAL 227.6 KVA

PANEL DP-UP									
480 / 277 VOLTS		SURFACE MOUNTING		300 AMP 3 POLE		INTEGRATED EQUIPMENT RATING 44,000 A. SYM.			
3 & 4 WIRE+GND		MCB		MLO					
KVA	LOAD SERVED	NO. OCP	#A #B #C	OCP NO.	LOAD SERVED	KVA			
8.6	11.7 DP-IT	1 100A		100A 2	PANEL UP1A	5.0			
8.6	11.7 3#3+1#GND-3°C	3 3P		3P 4	3#8+1#GND-3°C	8.6			
8.6	5			6	-	8.6			
8.6	ACCU-N-1	7 40A		40A 8	ACCU-N-2	8.6			
8.6	3#6+1#GND-1°C	9 3P		3P 10	3#8+1#GND-3°C	8.6			
8.6	11			12	-	8.6			
8.6	ACCU-N-3	13 40A		40A 14	ACCU-N-4	8.6			
8.6	3#6+1#GND-1°C	15 3P		3P 16	3#8+1#GND-3°C	8.6			
8.6	17			18	-	8.6			
7.5	35A 20			35A 20	EVN-N	7.5			
7.5	3#8+1#GND-3°C	21 3P		3P 22	3#8+1#GND-3°C	7.5			
7.5	23			24	-	7.5			
9.3	PANEL L-EQ	25 70A		70A 8	PANEL UP3A	5.1			
9.3	27 3P			3P 10	3#4+1#GND-1°C	5.1			
9.3	29			30	SPACE	-			
9.3	31			32	SPACE	-			
9.3	33			34	SPACE	-			
9.3	35			36	SPACE	-			
9.3	37			38	SPACE	-			
9.3	39			40	SPACE	-			
9.3	41			42	SPACE	-			

RECEPS. 10.0 KVA x 100% = 10.0 KVA
RECEPS. 72.6 KVA x 50% = 36.3 KVA
EQUIPMENT 35.2 KVA x 100% = 35.2 KVA
TOTAL 81.5 KVA

NOTES:
1. PROVIDE #10AWG FOR 30A CIRCUITS
2. PROVIDE #10AWG FOR 30A CIRCUITS

PANEL RP1A									
120 / 208 VOLTS		SURFACE MOUNTING		150 AMP 3 POLE		INTEGRATED EQUIPMENT RATING 22,000 A. SYM.			
3 & 4 WIRE+GND		MCB		MLO					
KVA	LOAD SERVED	NO. OCP	#A #B #C	OCP NO.	LOAD SERVED	KVA			
.5	LUNCH ROOM 103	1 20A		20A 2	RECEPS. OFFICE 108	.4			
.5	2#2+1#GND-3°C	3 2P		2P 4	2#2+1#GND-3°C	.4			
.5	FC IT-1A	5 20A		20A 6	FC-S2 LUNCH ROOM	.3			
.5	2#2+1#GND-3°C	7 2P		2P 8	2#2+1#GND-3°C	.3			
.5	FC IT-1B	9 20A		20A 10	FC-S3 TRAINING				

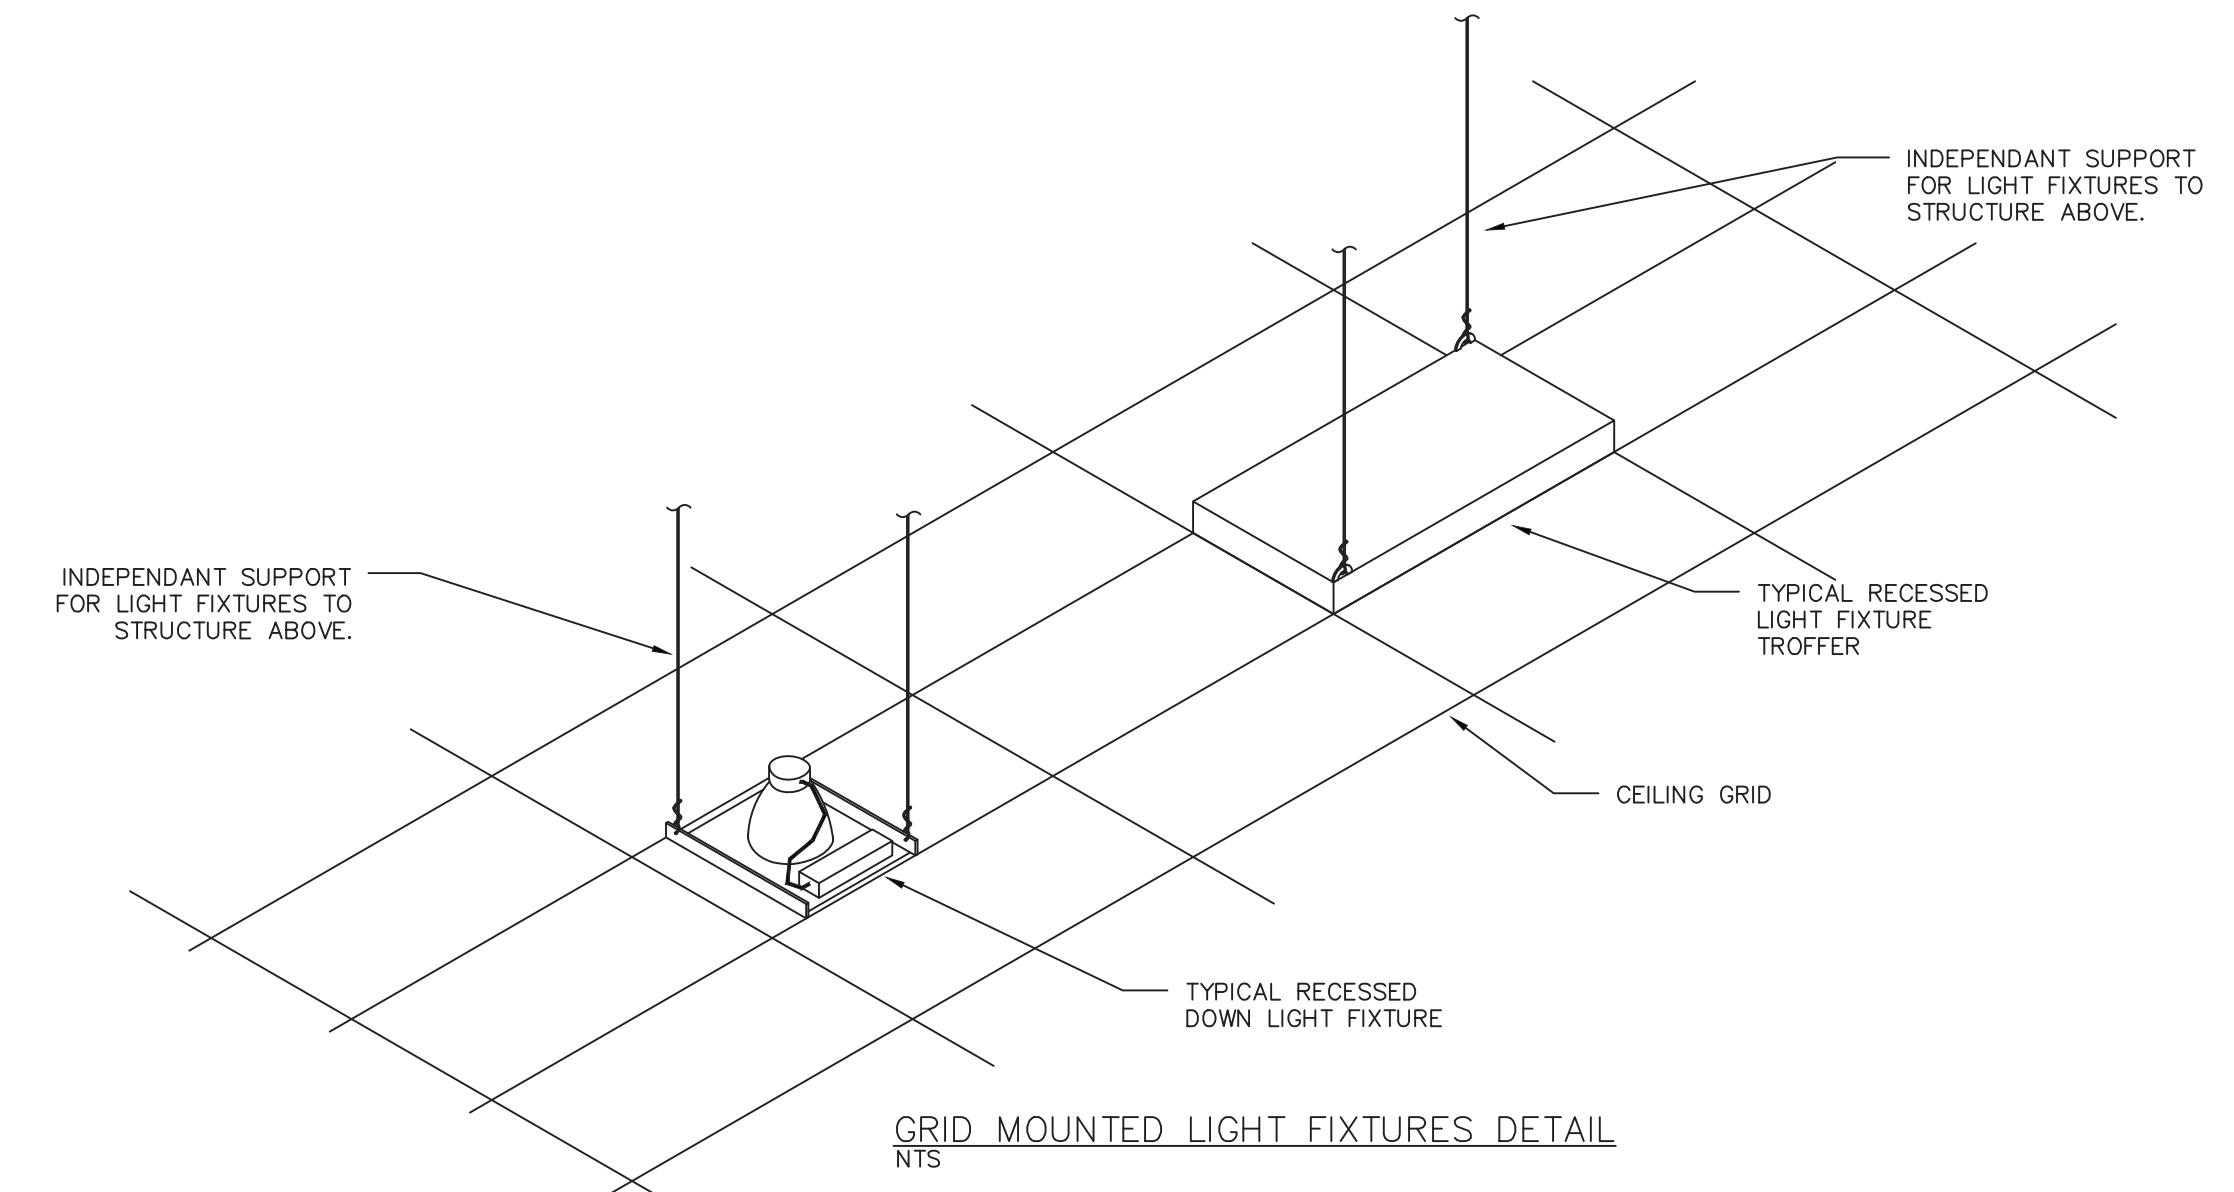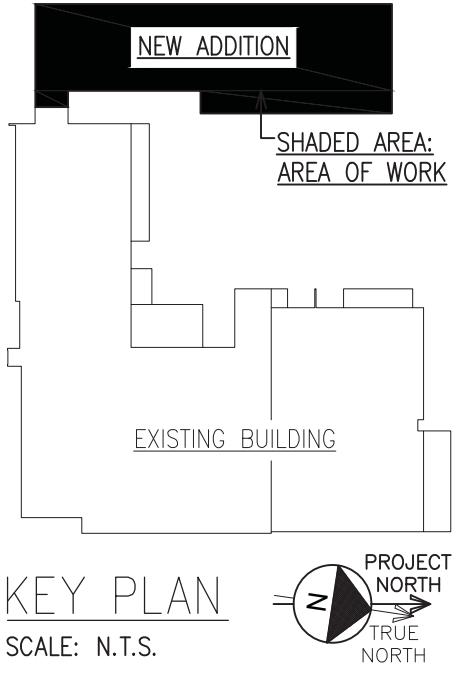

LIGHTING LEGEND			
U	CEILING MOUNTED LOW VOLTAGE ULTRASONIC OCCUPANCY SENSOR WATTSTOPPER LMC-100	\$	TOGGLE SWITCH, 120/277V 20A DECORA STYLE
P	CEILING MOUNTED LOW VOLTAGE PASSIVE INFRARED OCCUPANCY SENSOR WATTSTOPPER LMSW-101	\$LV	LOW VOLTAGE 1-BUTTON WALL SWITCH, WATTSTOPPER LMSW-101
D	CEILING MOUNTED LOW VOLTAGE DUAL-TECH OCCUPANCY SENSOR WATTSTOPPER LMDC-100	\$LV	LOW VOLTAGE 3-WAY 1-BUTTON WALL SWITCH, WATTSTOPPER LMSW-101
U	CEILING MOUNTED LOW VOLTAGE ULTRASONIC VACANCY SENSOR WATTSTOPPER LMCU-100	\$3LV	LOW VOLTAGE 3-WAY 2-BUTTON DIMMING WALL SWITCH, WATTSTOPPER LMSW-102
P	CEILING MOUNTED LOW VOLTAGE PASSIVE INFRARED VACANCY SENSOR WATTSTOPPER LMPC-100	\$LV	LOW VOLTAGE 1-BUTTON DIMMING WALL SWITCH, WATTSTOPPER LMDM-101
V	CEILING MOUNTED LOW VOLTAGE DUAL-TECH VACANCY SENSOR WATTSTOPPER LMDX-100	\$5LV	LOW VOLTAGE 5-BUTTON SCENE WALL SWITCH, WATTSTOPPER LMSW-105
S	CORNER MOUNTED LOW VOLTAGE DUAL-TECH VACANCY SENSOR WATTSTOPPER LMDX-100	\$VS	LINE VOLTAGE 1-BUTTON VACANCY SENSOR WALL SWITCH, WATTSTOPPER DSW-301
S	CORNER MOUNTED LOW VOLTAGE DUAL-TECH VACANCY SENSOR WATTSTOPPER LMDX-100	\$OS	LINE VOLTAGE 1-BUTTON OCCUPANCY SENSOR WALL SWITCH, WATTSTOPPER DSW-301
L	CORNER MOUNTED LOW VOLTAGE TEMPERATURE PASSIVE INFRARED OCCUPANCY SENSOR WATTSTOPPER LMDX-100	\$VS	LINE VOLTAGE 0-10V DIMMING VACANCY SENSOR WALL SWITCH, WATTSTOPPER DW-311
ML	ML-11-ZONE ON/OFF AND DIMMING OPEN LOOP VACANCY SENSOR WATTSTOPPER LMLS-400 (PRIMARY/SECONDARY ZONE ONLY), LMLS-500 (PRIMARY/SECONDARY ZONES)	\$3/4VS	LINE VOLTAGE 1-BUTTON 3-WAY 4-WAY VACANCY SENSOR WALL SWITCH, WATTSTOPPER DSW-301
LC004	0-10V TO PHASE ADAPTIVE CONVERTER (6.25A), WATTSTOPPER BF-SDS10V-AST	\$VS	LINE VOLTAGE DIMMING VACANCY SENSOR WALL SWITCH, WATTSTOPPER PW-101D
LMZC	ZONE CONTROLLER WITH ENCLOSURE, WATTSTOPPER LMZC-301	[RC]	LOW VOLTAGE ON/OFF ROOM CONTROLLER WITH 2 RELAYS, WATTSTOPPER LRMC-102
LMBC	NETWORK BRIDGE, WATTSTOPPER LMB-300	[RC]D1	LOW VOLTAGE ON/OFF/0-10V 10A DROWNING ROOM CONTROLLER WITH 1 RELAY AND 0-10V DIMMING OUTPUT, WATTSTOPPER LRMC-211
ELCU	EMERGENCY LIGHTING CONTROL UNIT, WATTSTOPPER ELCU-200	[RC]D2	LOW VOLTAGE ON/OFF/0-10V 10A DIMMING ROOM CONTROLLER WITH 2 RELAYS AND 0-10V DIMMING OUTPUTS, WATTSTOPPER LRMC-112
LMIN	INPUT INTERFACE, WATTSTOPPER LMIN-104	[RC]D3	LOW VOLTAGE ON/OFF/0-10V 20A DIMMING ROOM CONTROLLER WITH 3 RELAYS AND 3 0-10V DIMMING OUTPUTS, WATTSTOPPER LRMC-213
	NORMAL WIRING	[BZ]	UNIVERSAL VOLTAGE POWER PACK, WATTSTOPPER BZ-50
	EMERGENCY WIRING	[BZ]	UNIVERSAL VOLTAGE THREE CHANNEL DIMMABLE TRANSFORMER FOR 24V FIXTURE, TIVOLI INF-J-288-3-4-24
	LOW VOLTAGE WIRING	[PS]	LED DRIVER FOR 24V FIXTURE, JUSTIN, INC. 961-24SSD
	CAT5 CABLING		
	MS/TP CABLING		
	ACOLYTE	R890-SWS220-4.435-1-RBMNTSL	LED TAP
		24	LED - 4.4/ft -
			PROVIDE ALL ACCESSORIES AND POWER SUPPLIES
		L-13	FOCAL POINT RECESSED 3.5" ROUND DOWNLIGHT
			FLC3D-RD-SW-500L-UNV-LD1-T-BH-LC3-RO-900L-35K-DSS-10W
			277 LED - 10 -
		L-14	EXTANT ARCHITECTURAL LIGHTING LINEAR PENDANT
			HST-3P-CD-00-D-00-DNL-35-MEOCC-VU-0-BP
			277 LED - 4.5/ft -
		L-15	JADEMAR LIGHTING UNDER CABINET LIGHTING
			JUL-C50-120-35W
			120 LED - 5/ft -
		L-16	FOCAL POINT PENDANT LINEAR DIRECT/INDIRECT
			FSM1285-BWL-C-375UP-375DN-35K-2G-UNV-LD1-C24-1MC-BKCD-MB-AxBR
			277 LED - 6.5/ft -
		EM1	ISOLITE SURFACE 2-HEAD EM FIXTURE BUG-3W-WH-MB
			- - - - -
		EM2	ISOLITE RECESSED 2 HEAD EM FIXTURES
			- - - - -
		EX-1	PERFORMANCE IN LIGHTING EXTERIOR SURFACE EGGS LIGHT M50-5336-14-AM-3K-UNV-NA-EMPK-PHC-B
			277 LED - 53 -
		EX-2	FOCAL POINT EXTERIOR RECESSED DOWNLIGHT FL44D-RO-SW-2500L-UNV-LD1-1C-00-C4-R0-25L-30K-BJ-BP-REMOTE EM
			277 LED - 32 -
		EX-3	PERFORMANCE IN LIGHTING EXTERIOR SURFACE EGGS LIGHT M30-36-14-AM-3K-UNV-NA-EMPK-PHC-B
			277 LED - 36 -
		X1	ISOLITE EDGELET EXIT SIGN 1 FACE EUG-EM-R-1C-MTEB
			277 LED - - -
		X2	ISOLITE EDGELET EXIT SIGN 2 FACES EUG-EM-R-2M-MTEB
			277 LED - - -
		X3	ISOLITE THERMO PLASTIC EXIT SIGN UNIVERSAL FACE(S) EUG-EM-R-2M-MTEB
			277 LED - - -
			INTEGRAL BATTERY BACK-UP

LIGHTING FIXTURE SCHEDULE							
SYMBOL	MANUFACTURER	DESCRIPTION	CATALOG NUMBER	VOLTS	TYPE	LAMPS #	WATTS
L-1A	FOCAL POINT	RECESSED 2x2	FAN2-22-ARC-350L-35K-1C-UNV-LD1-G-WH	277	LED	-	23
L-1B	FOCAL POINT	RECESSED 2x2	FAN2-22-ARC-450L-35K-1C-UNV-LD1-G-WH	277	LED	-	32
L-2	ARON LIGHTING	RECESSED 2x2 EDGE LIT	LT-TG-ST-XXX-22FA-1250-B2-35K-B-UNV-BM	277	LED	-	44
L-3	JADEMAR LIGHTING	RECESSED 2x2 FLAT PANEL LED	JPT22-40W-CPS-UNV-35K	277	LED	-	40
L-4	FOCAL POINT	RECESSED LINEAR	FSM4L-BW-625LF-35K-1C-UNV-LD1-G1-G1-WH-00	277	LED	-	6/ft
L-5	FOCAL POINT	LINEAR WALL MOUNTED PERIMETER	FSM4PR-ALH-AFO-375LF-35K-1C-UNV-LD1-G-WH-00	277	LED	-	4.5/ft
L-6	FOCAL POINT	PENDANT LINEAR	FSM2L5-BW-625DL-35K-1C-UNV-LD1-C48-WH-00	277	LED	-	4.5/ft
L-7	XTRA LIGHT	WALL MOUNTED 4' STAIR FIXTURE	LRW-4-4000L-35K-DIM-U-MLD-EM	277	LED	-	35
L-8A	FOCAL POINT	RECESSED 3.5" ROUND DOWNLIGHT	FLC3D-RD-SW-500L-UNV-LD1-T-BH-LC3-RO-15L-35K-DSS-10W	277	LED	-	17 -
L-8B	FOCAL POINT	RECESSED 3.5" ROUND DOWNLIGHT	FLC3D-RD-SW-1100L-UNV-LD1-T-BH-LC3-RO-11L-35K-DSS-10W	277	LED	-	12 -
L-9	FOCAL POINT	RECESSED 2.5" ROUND DOWNLIGHT	FLC3D-RD-SW-1100L-UNV-LD1-T-BH-LC3-RO-11L-35K-DSS-10W	277	LED	-	12 -
L-10	XTRA LIGHT	SURFACE STRIP LIGHT 4' LENGTH	LRS-4-4000L-35K-DIM	277	LED	-	29
L-11	ACOLYTE	LED TAP	R890-SWS220-4.435-1-RBMNTSL	24	LED	-	4.4/ft -
L-13	FOCAL POINT	RECESSED 3.5" ROUND DOWNLIGHT	FLC3D-RD-SW-900L-UNV-LD1-T-BH-LC3-RO-900L-35K-DSS-10W	277	LED	-	10 -
L-14	EXTANT ARCHITECTURAL LIGHTING	LINEAR PENDANT	HST-3P-CD-00-D-00-DNL-35-MEOCC-VU-0-BP	277	LED	-	4.5/ft -
L-15	JADEMAR LIGHTING	UNDER CABINET LIGHTING	JUL-C50-120-35W	120	LED	-	5/ft -
L-16	FOCAL POINT	PENDANT LINEAR DIRECT/INDIRECT	FSM1285-BWL-C-375UP-375DN-35K-2G-UNV-LD1-C24-1MC-BKCD-MB-AxBR	277	LED	-	6.5/ft -
EM1	ISOLITE	SURFACE 2-HEAD EM FIXTURE BUG-3W-WH-MB	- - - - -				INTEGRAL BATTERY BACK-UP
EM2	ISOLITE	RECESSED 2 HEAD EM FIXTURES	- - - - -				INTEGRAL BATTERY BACK-UP
EX-1	PERFORMANCE IN LIGHTING	EXTERIOR SURFACE EGGS LIGHT M50-5336-14-AM-3K-UNV-NA-EMPK-PHC-B	277 LED - 53 -				INTEGRAL BATTERY BACK-UP
EX-2	FOCAL POINT	EXTERIOR RECESSED DOWNLIGHT FL44D-RO-SW-2500L-UNV-LD1-1C-00-C4-R0-25L-30K-BJ-BP-REMOTE EM	277 LED - 32 -				INTEGRAL BATTERY BACK-UP
EX-3	PERFORMANCE IN LIGHTING	EXTERIOR SURFACE EGGS LIGHT M30-36-14-AM-3K-UNV-NA-EMPK-PHC-B	277 LED - 36 -				INTEGRAL BATTERY BACK-UP
X1	ISOLITE	EDGELET EXIT SIGN 1 FACE EUG-EM-R-1C-MTEB	277 LED - - -				INTEGRAL BATTERY BACK-UP
X2	ISOLITE	EDGELET EXIT SIGN 2 FACES EUG-EM-R-2M-MTEB	277 LED - - -				INTEGRAL BATTERY BACK-UP
X3	ISOLITE	THERMO PLASTIC EXIT SIGN UNIVERSAL FACE(S) EUG-EM-R-2M-MTEB	277 LED - - -				INTEGRAL BATTERY BACK-UP

LIGHTING CONTROLS:

GENERAL:

- ALL LIGHTING CONTROLS SHALL BE IN CONFORMANCE WITH NEC, NFPA 70 AND ALL LOCAL CODES.
- ALL LIGHTING CONTROLS SHALL BE OF ONE MANUFACTURER.

PRODUCTS:

- ALL PRODUCTS SHALL BE UL LISTED.


SUBMITTALS:

- CONTRACTOR SHALL OBTAIN THE SERVICES OF A LIGHTING CONTROL VENDOR.
- OWNER SHALL PREPARE SITE SPECIFIC FLOOR PLANS AND WIRING DIAGRAMS.
- PRODUCT DATA SHEETS SHALL BE SUBMITTED ALONG WITH PLANS AND WIRING DIAGRAMS.
- THE BASIS OF DESIGN IS PER WATTSTOPPER LIGHTING CONTROLS.

LIGHTING NOTES:

- COORDINATE EXACT LOCATION & MOUNTING OF ALL LIGHTING FIXTURES WITH ARCHITECTURAL REFLECTED CEILING PLANS.
- PROVIDE SEPARATE HOT LEG TO ALL LIGHTING FIXTURES CONTAINING EMERGENCY BATTERY INVERTER. REFER TO DETAILS FOR SWITCHING THE SAME.
- ELECTRICAL CONTRACTOR TO COORDINATE ALL LIGHTING FIXTURE TRIMS WITH CEILING TYPES. SEE ARCHITECTURAL DRAWINGS FOR CEILING INFORMATION.
- PROVIDE ALL SEISMIC CLIPS AND/OR BRACING AS REQUIRED. SUPPORT ALL FIXTURES FROM STRUCTURE ABOVE BY 2 INDEPENDENT SUPPORTS.
- CONTRACTOR TO PROVIDE ALL SITE SPECIFIC LIGHTING CONTROL SHOP DRAWINGS, CONTROL DIAGRAMS, CUT SHEETS, ETC.
- ALL OCCUPANCY/VACANCY SENSORS SHALL BE A MINIMUM OF 6' FROM ANY HVAC DIFFUSER.
- ALL NEW LIGHTING FIXTURE CIRCUITS AND HOMERUNS SHALL BE RUN WITH DEDICATED NEUTRAL CONDUCTORS.
- PROVIDE AFC "LUMINARY" CABLE FOR LED FIXTURE DIMMING OR PROGRAM EQUAL METHOD. PROVIDE 2#16 CONTROL FOR 0-10V DIMMING.
- OR HALF SHADED DESIGNATES EMERGENCY LIGHTS WIRED TO EMERGENCY GENERATOR CIRCUITS. ALL EM FIXTURES TO BE UNSWITCHED AND ACT AS NIGHT LIGHTS UNLESS INDICATED OTHERWISE.
- ALL FIXTURES 3500K, UNLESS OTHERWISE SPECIFIED.

1	ISSUED FOR BUILDING DEPARTMENT FILING & BIDDING	04-28-2025
ORANGE AND ROCKLAND UTILITIES, INC.		
SPRING VALLEY NEW YORK		
APPROVED		
LIGHTING DETAILS		
SVOC NEW OFFICE ADDITION		
TAX ID # 56.52-1-2 301 W. 10TH STREET VILLAGE OF SPRING VALLEY TOWN OF RAMAPO ROCKLAND COUNTY, NEW YORK		
AS NOTED		
E-501 75 OF 95		
John Lignos, AIA		
Lorin J. Sonenshine, AIA Cert./Lic. No. NY 018401		
Steven Napolitano, PE, PP One Paragon Drive, Montvale, New Jersey 07645		
Robert Nocella, AIA		

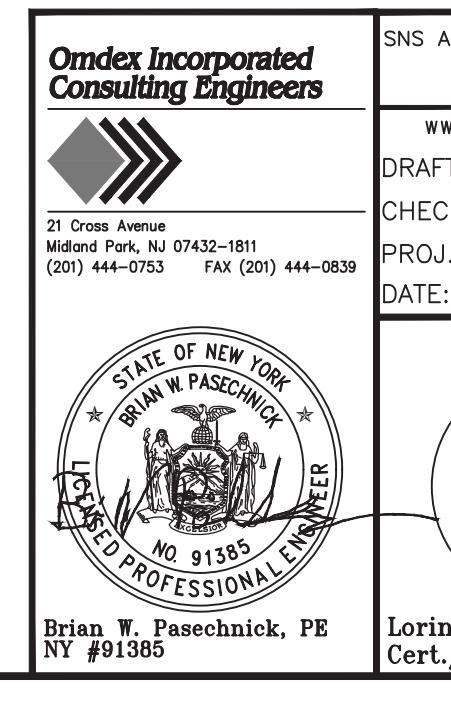

Engineering Review

Date

Information

Comments

Bid

Construction

Scale

File No.

Drawing Number

Sheet



Rev

04-28-2025

E-501

75 OF 95


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**TYP. CORRIDOR
(LMRC-211 WITH ELCU-200)
WIRING DIAGRAM**

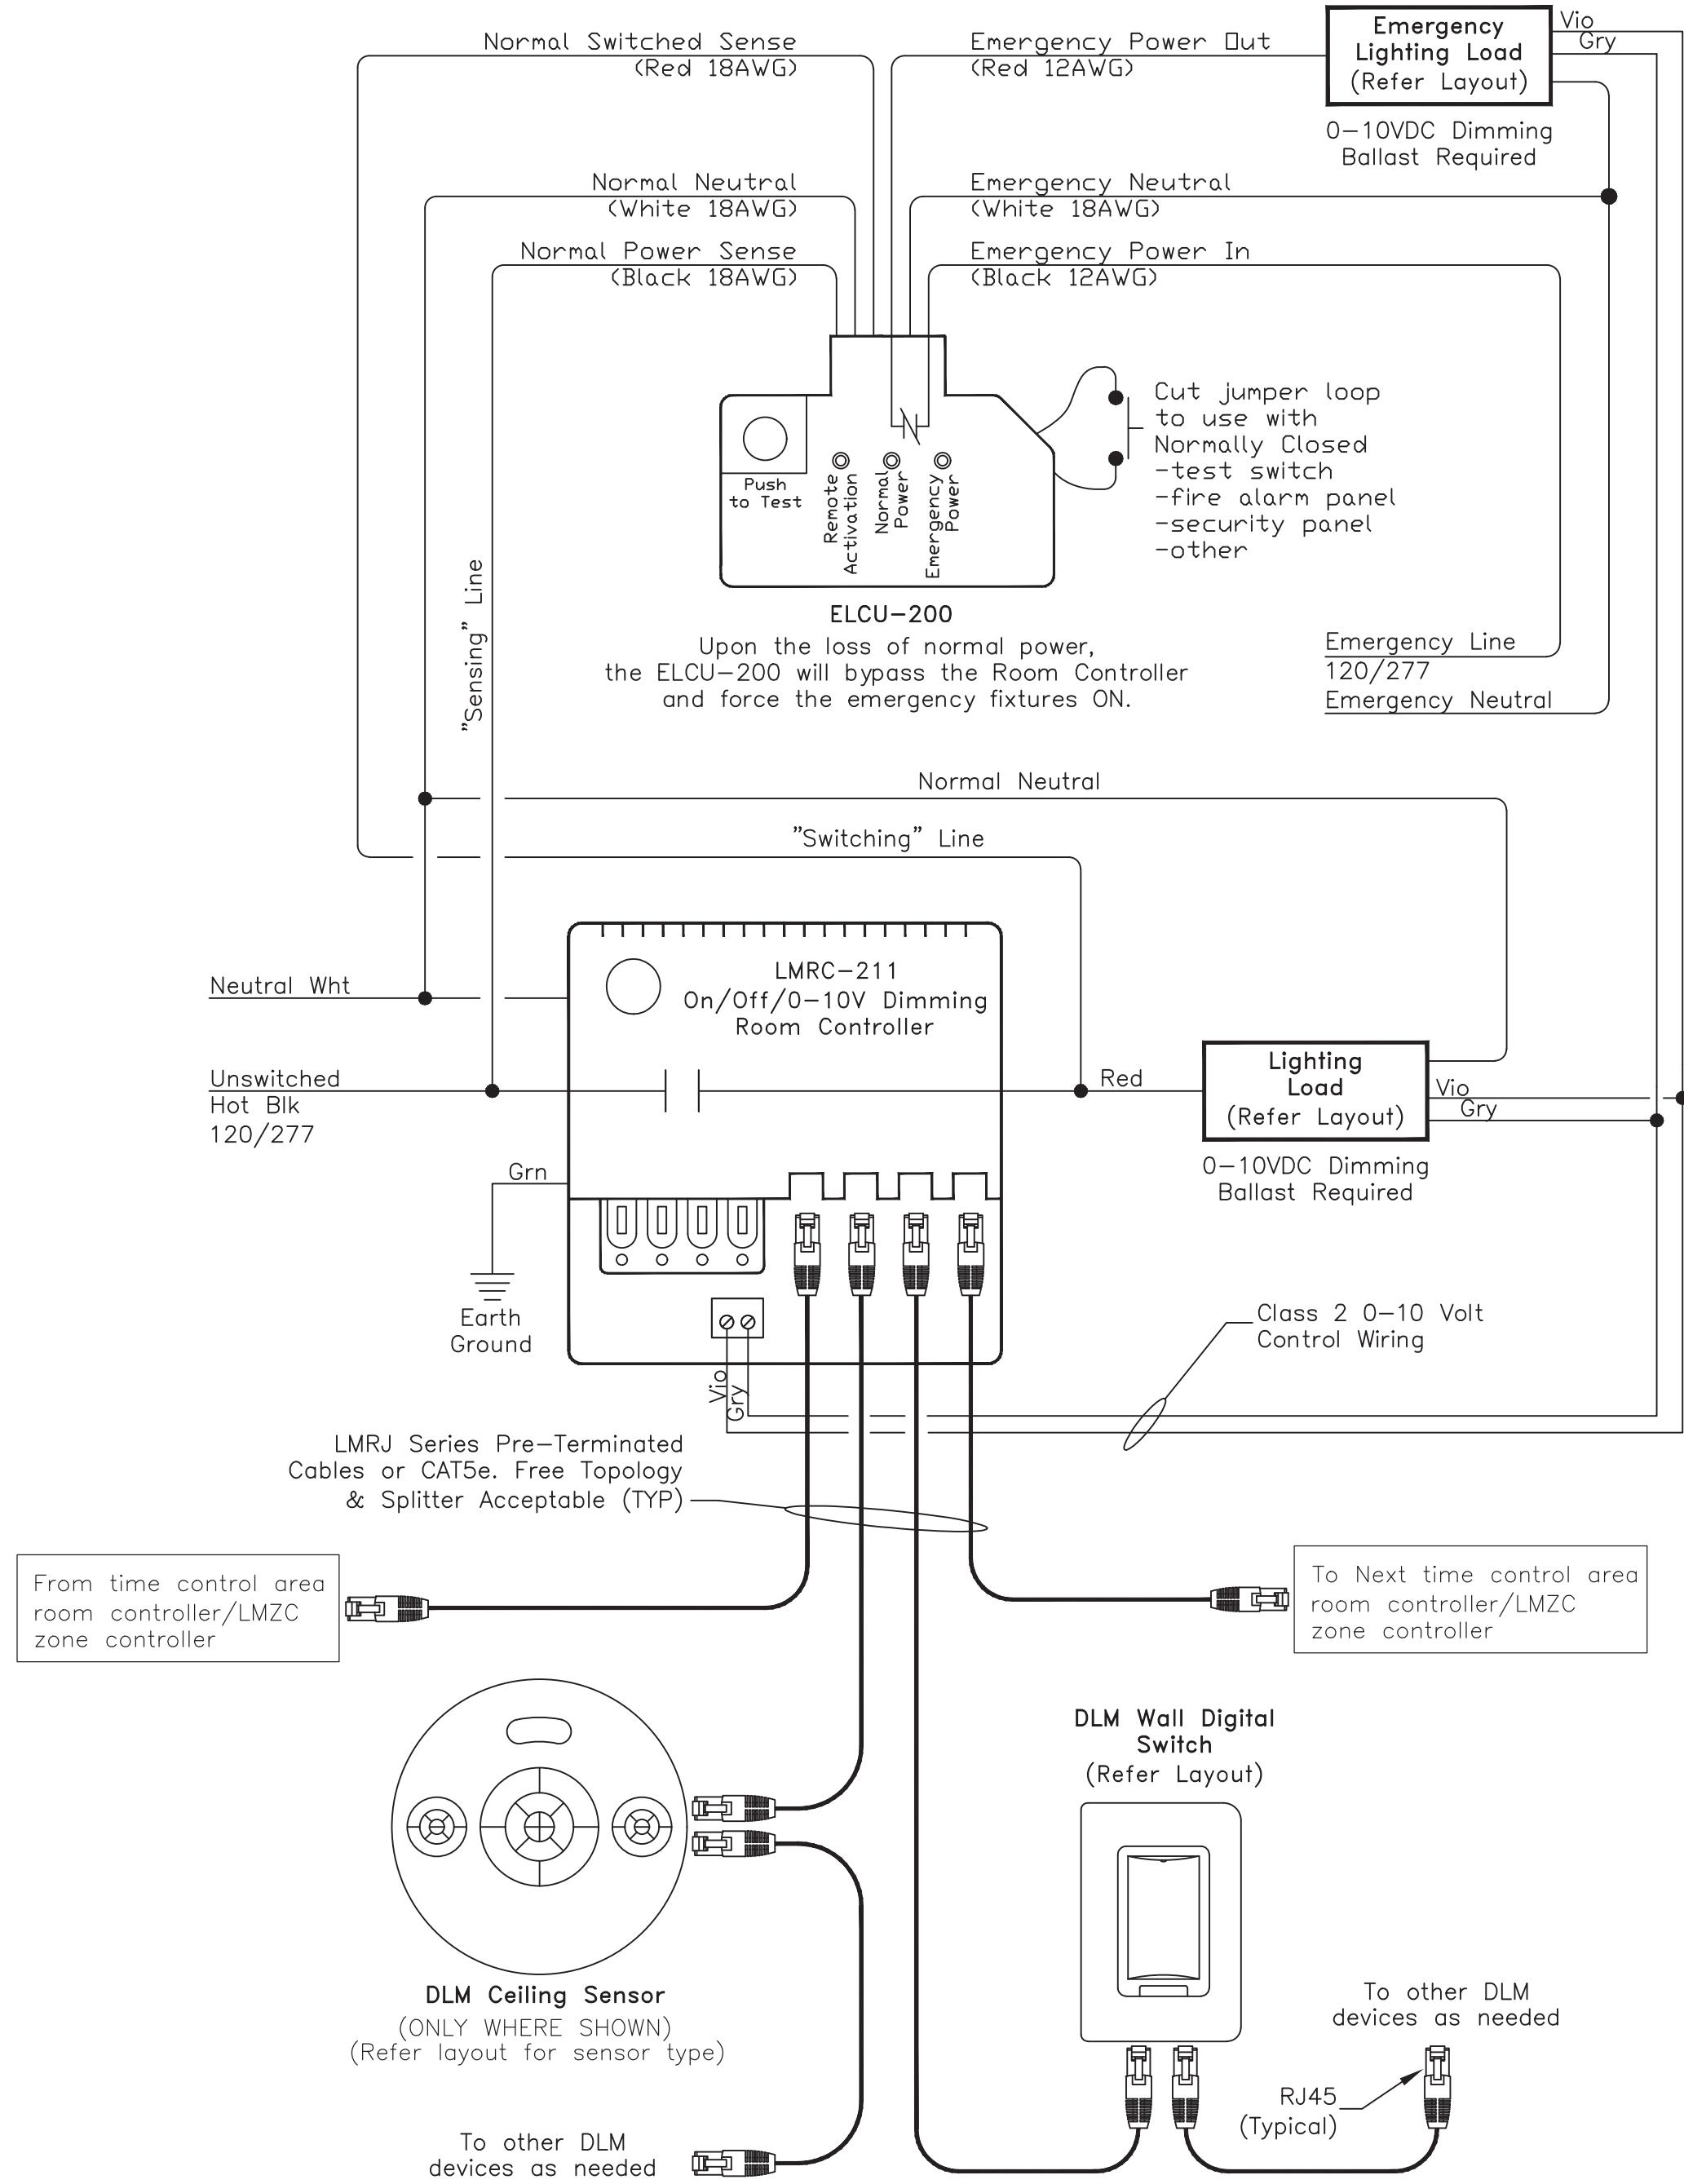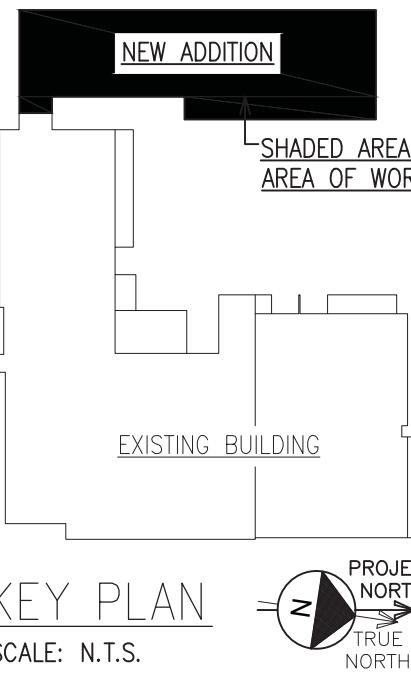
NOTE: Refer to layout for exact quantity and model number of devices.

NOTE: ALL ROOM CONTROLLERS WILL BE DAISY CHAINED VIA CAT5e CABLE TO A ZONE CONTROLLER LMZC-301 (NETWORK A/B) FOR TIME CONTROL. (REFER LMZC-301 RISER DIAGRAM)




**TYP. LMRC-212
WIRING DIAGRAM**

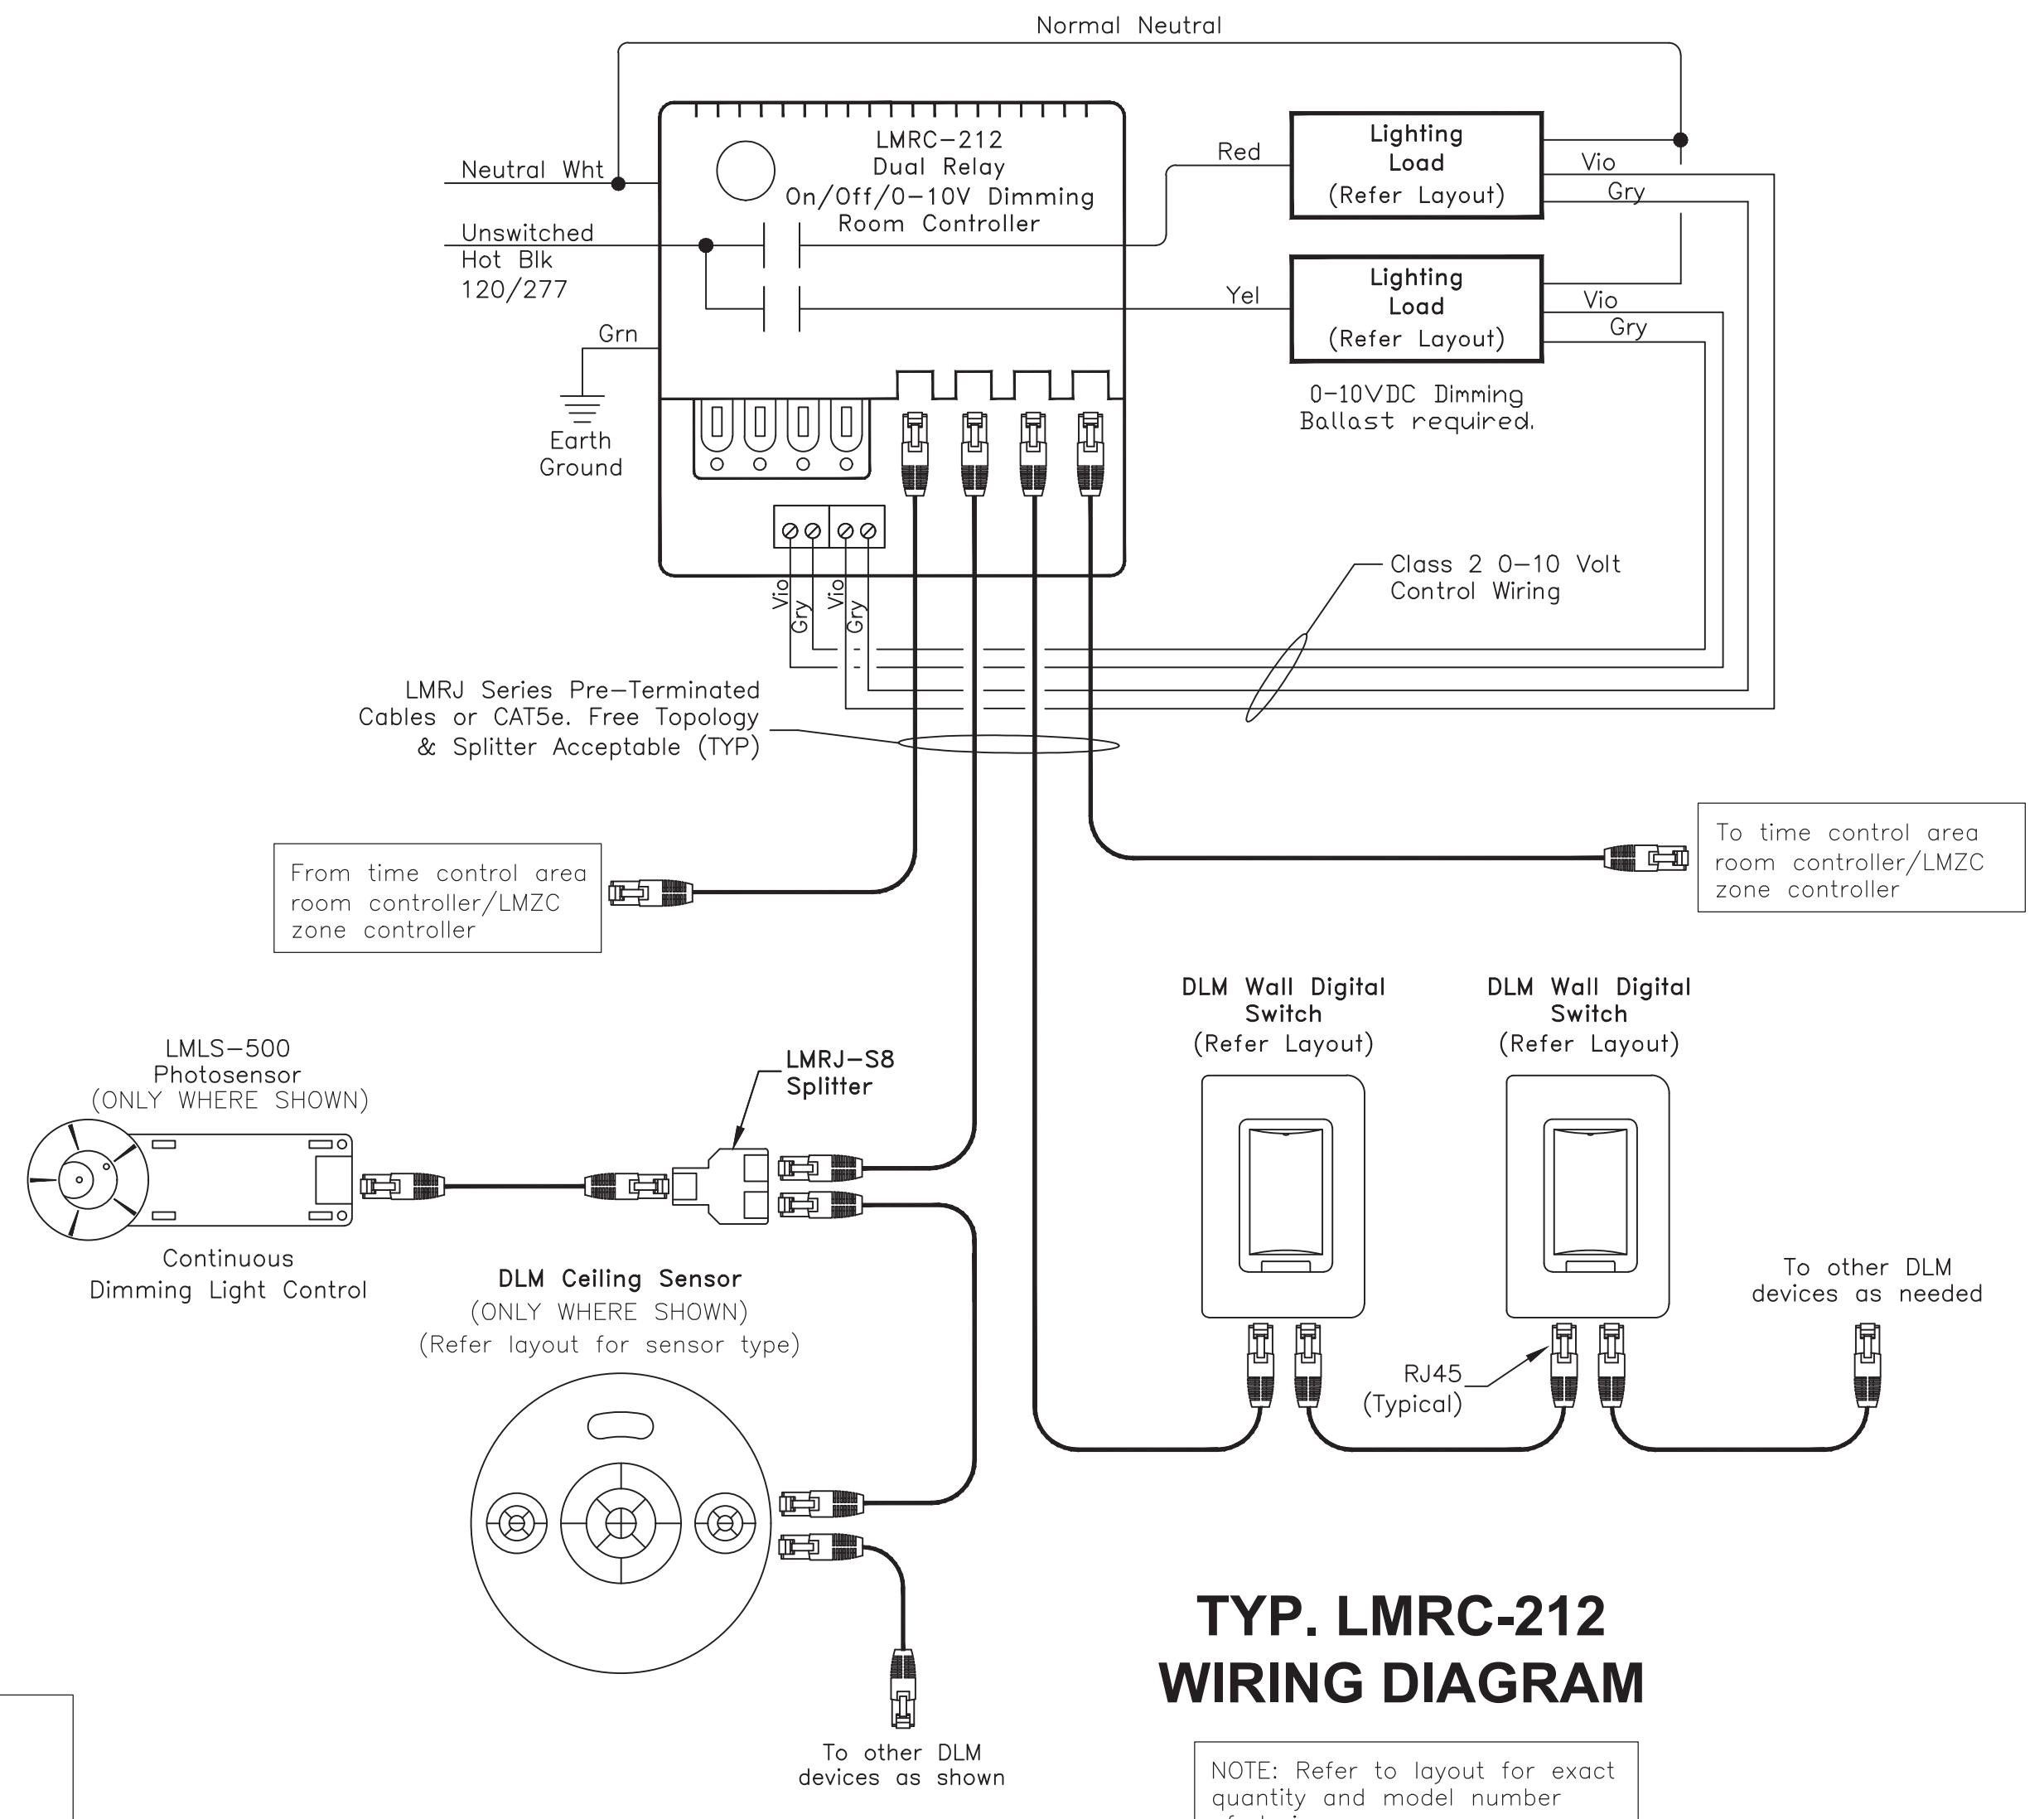NOTE: Refer to layout for exact quantity and model number of devices.

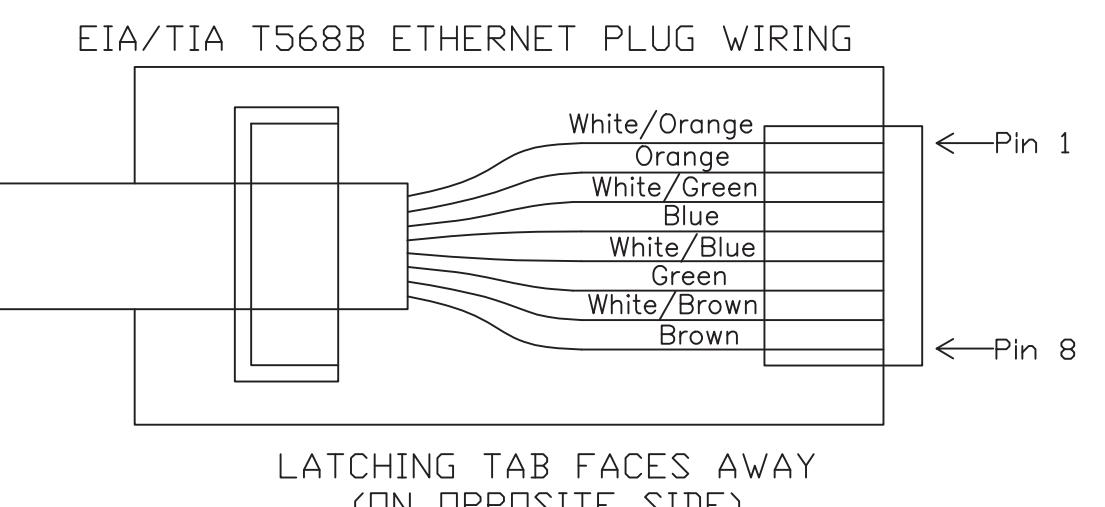


CAT5E WIRING DIAGRAM

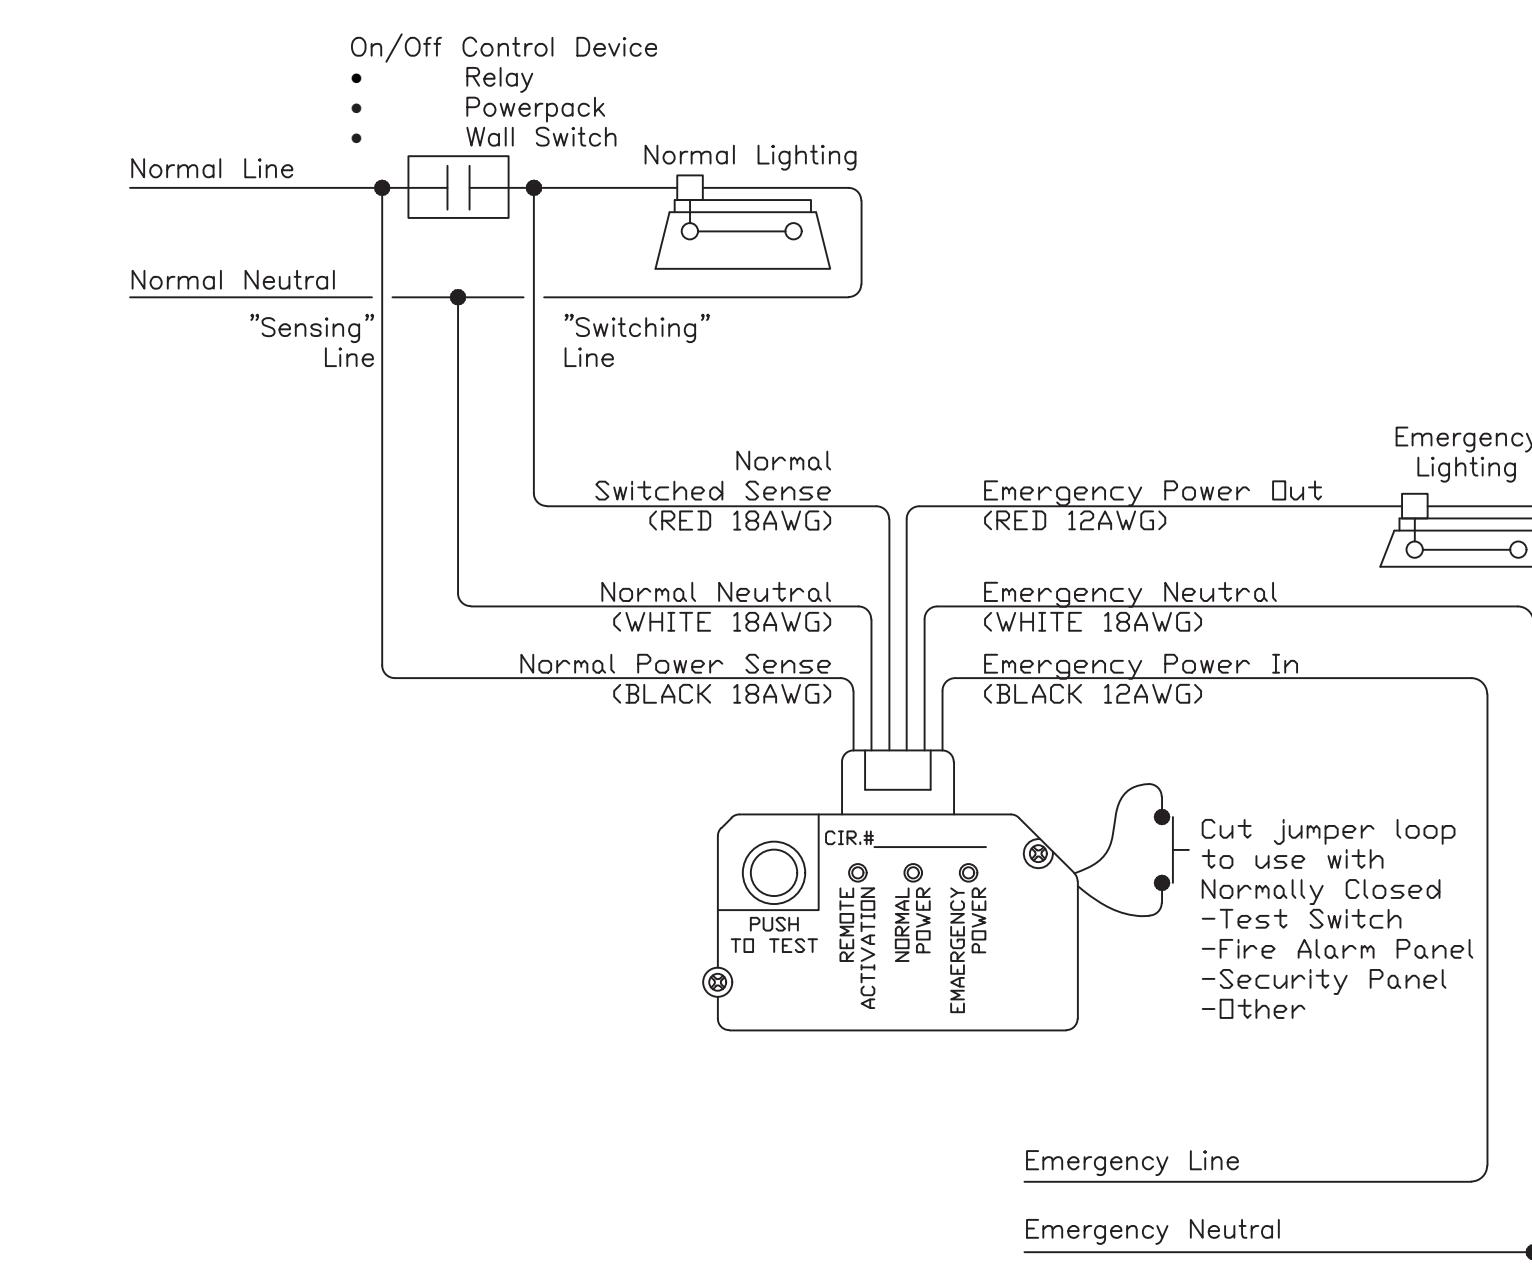

ELCU-200 TYPICAL WIRING DIAGRAM


PROVIDE ELCU-200 ONLY WHERE SHOWN ON FLOOR PLANS

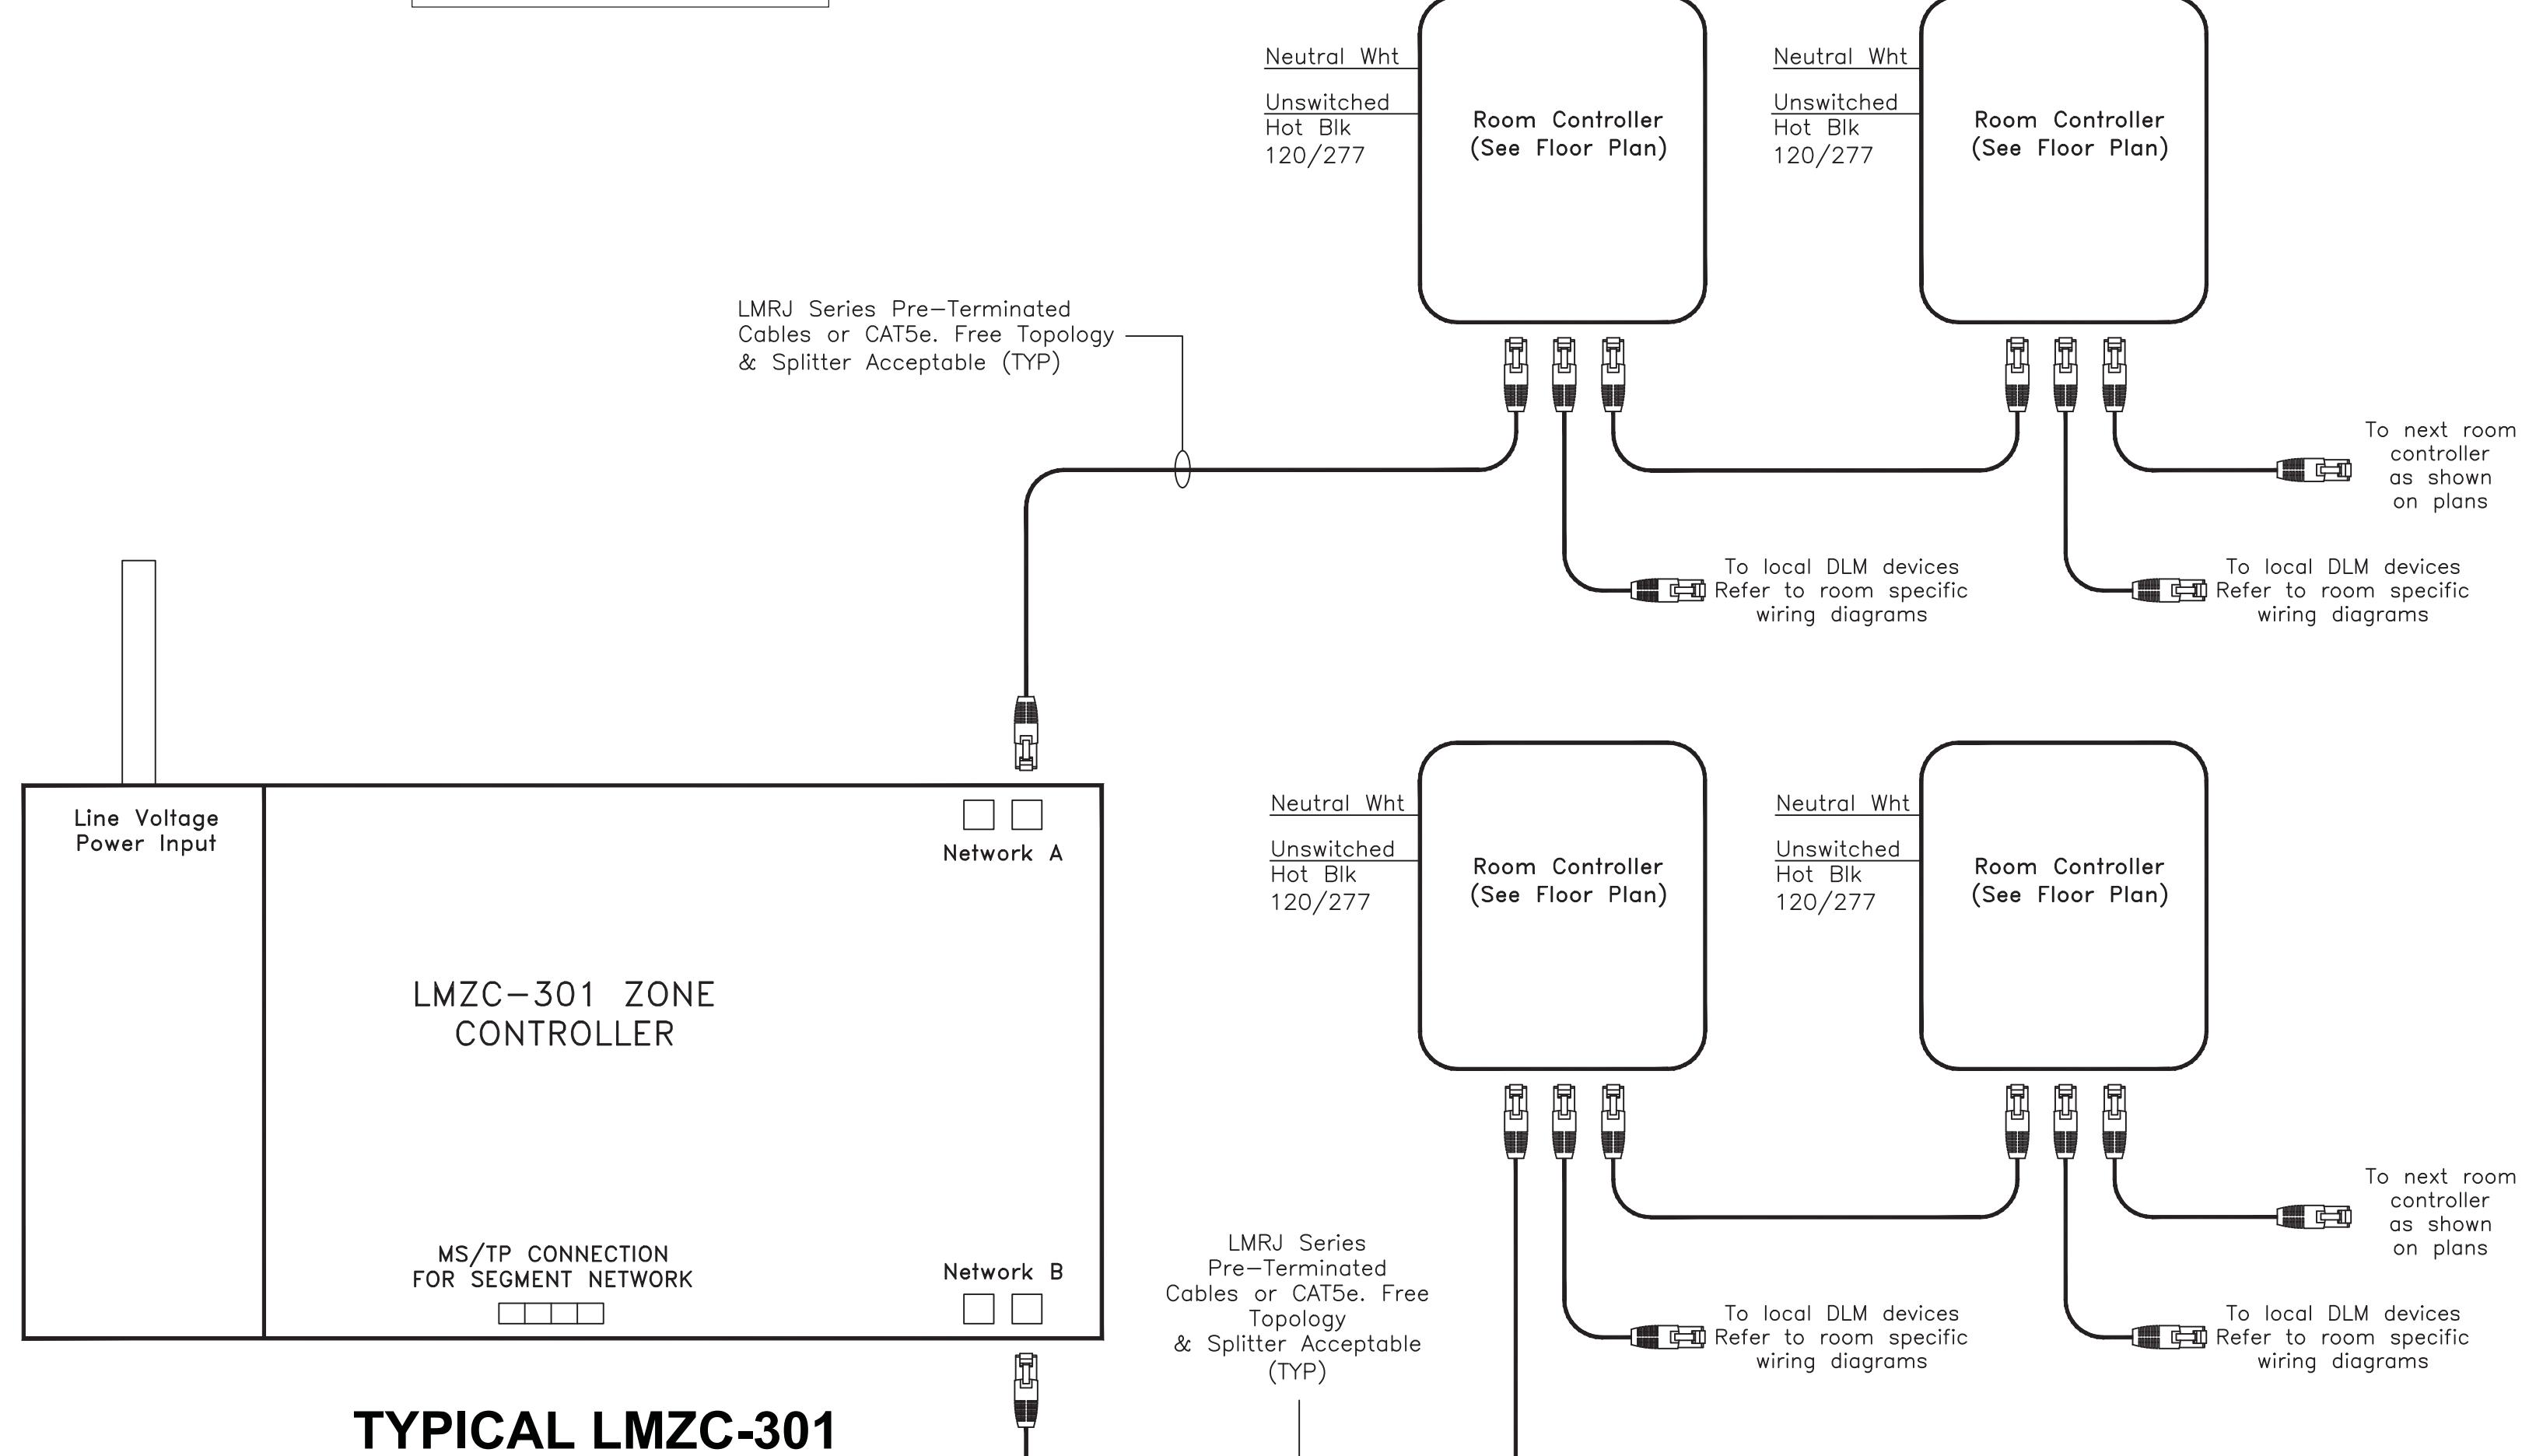

**TYPICAL LMZC-301
WIRING DIAGRAM**





NOTE: Refer to layout for exact quantity and model number of devices.

1 ISSUED FOR BUILDING DEPARTMENT FILING & BIDDING		04-28-2025
ORANGE AND ROCKLAND UTILITIES, INC.		
SPRING VALLEY NEW YORK		
 Ondex Incorporated Consulting Engineers 21 Cross Avenue, Midland Park, NJ 07442-1811 (201) 444-0753, FAX (201) 444-0839		
ENGINEERING REVIEW APPROVED <input type="checkbox"/> INFORMATION <input type="checkbox"/> COMMENTS <input type="checkbox"/> BID <input type="checkbox"/> CONSTRUCTION DEPT. SIGNATURE DATE CIVIL _____ METERING _____ RELAY _____ DRAFTED: MUR CHECKED: _____ PROJ. NO: 5593 DATE: 08.11.2024		
LIGHTING DETAILS SVOC NEW OFFICE ADDITION TAX ID # 56.52-1-2 300 W. 1ST STREET VILLAGE OF SPRING VALLEY TOWN OF RAMAPO ROCKLAND COUNTY, NEW YORK		
AS NOTED FILE NO. E-502 DRAWING NUMBER 76 OF 95 SHEET REV. VILLAGE OF SPRING VALLEY ROCKLAND COUNTY, NEW YORK		
John Lignos, AIA Lorin J. Sonenshine, AIA Steven Napolitano, PE, PP Robert Nocella, AIA		

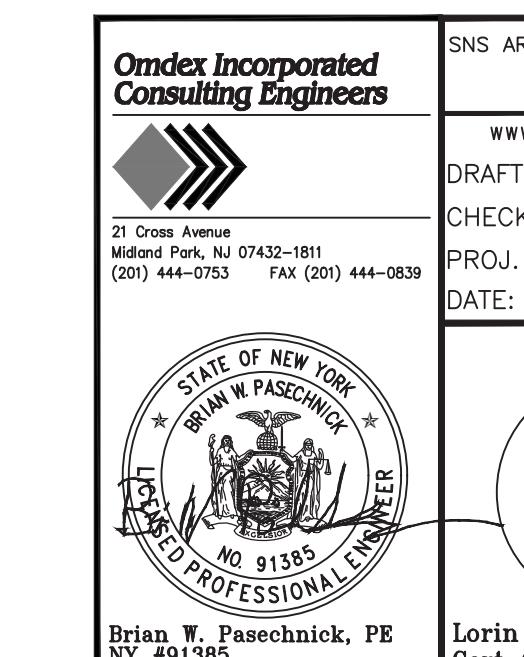

Lorin J. Sonenshine, AIA
Cert./Lic. No. NY 018401






SNS Architects & Engineers, PC
ONE PARAGON DRIVE . MONTVALE . NEW JERSEY . 07645

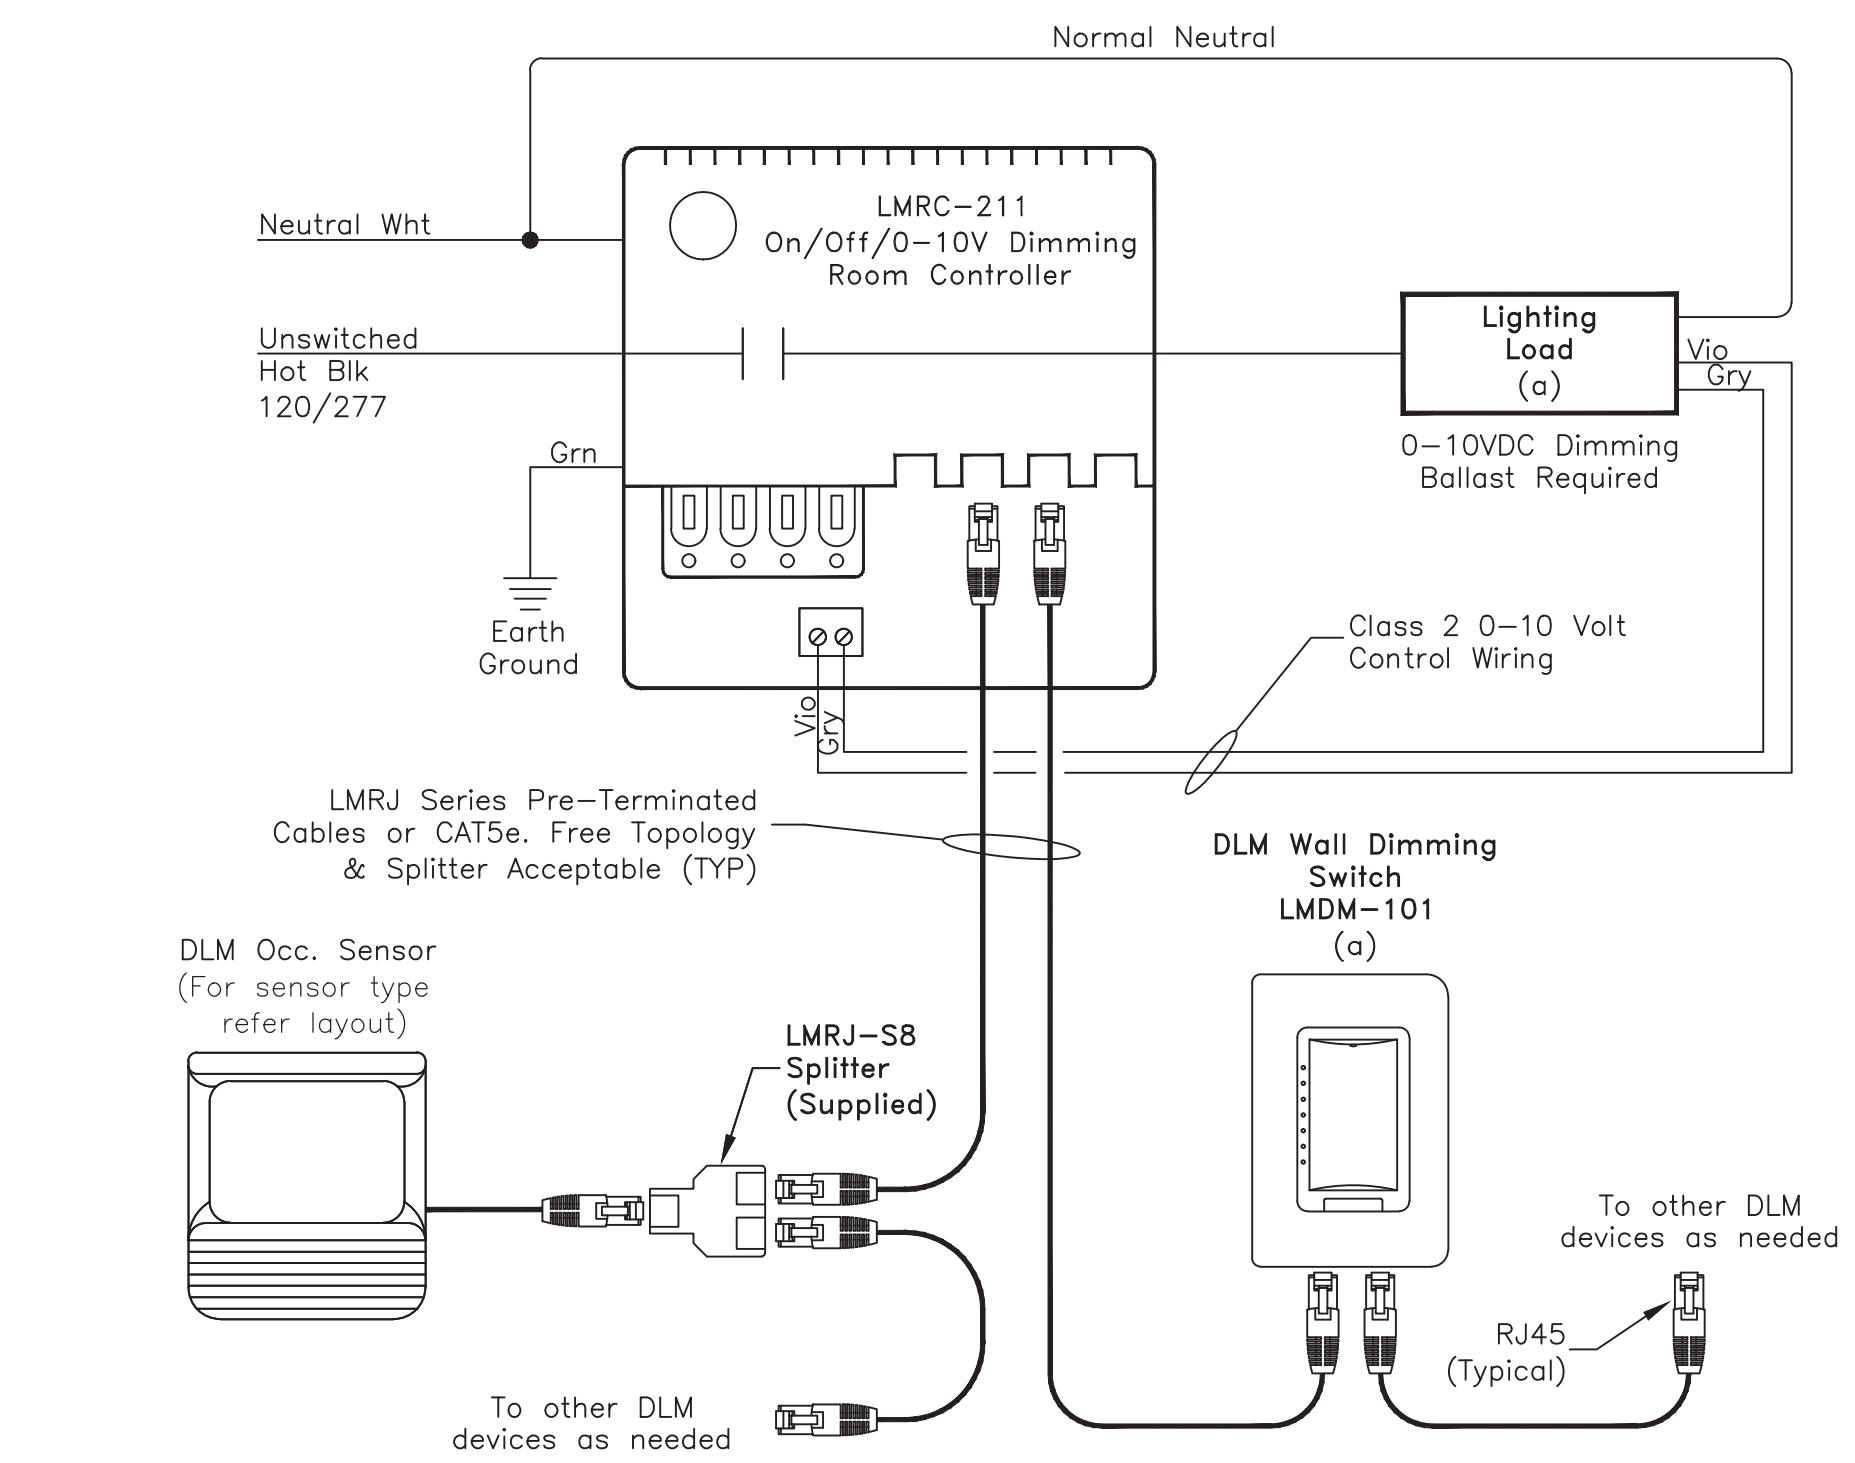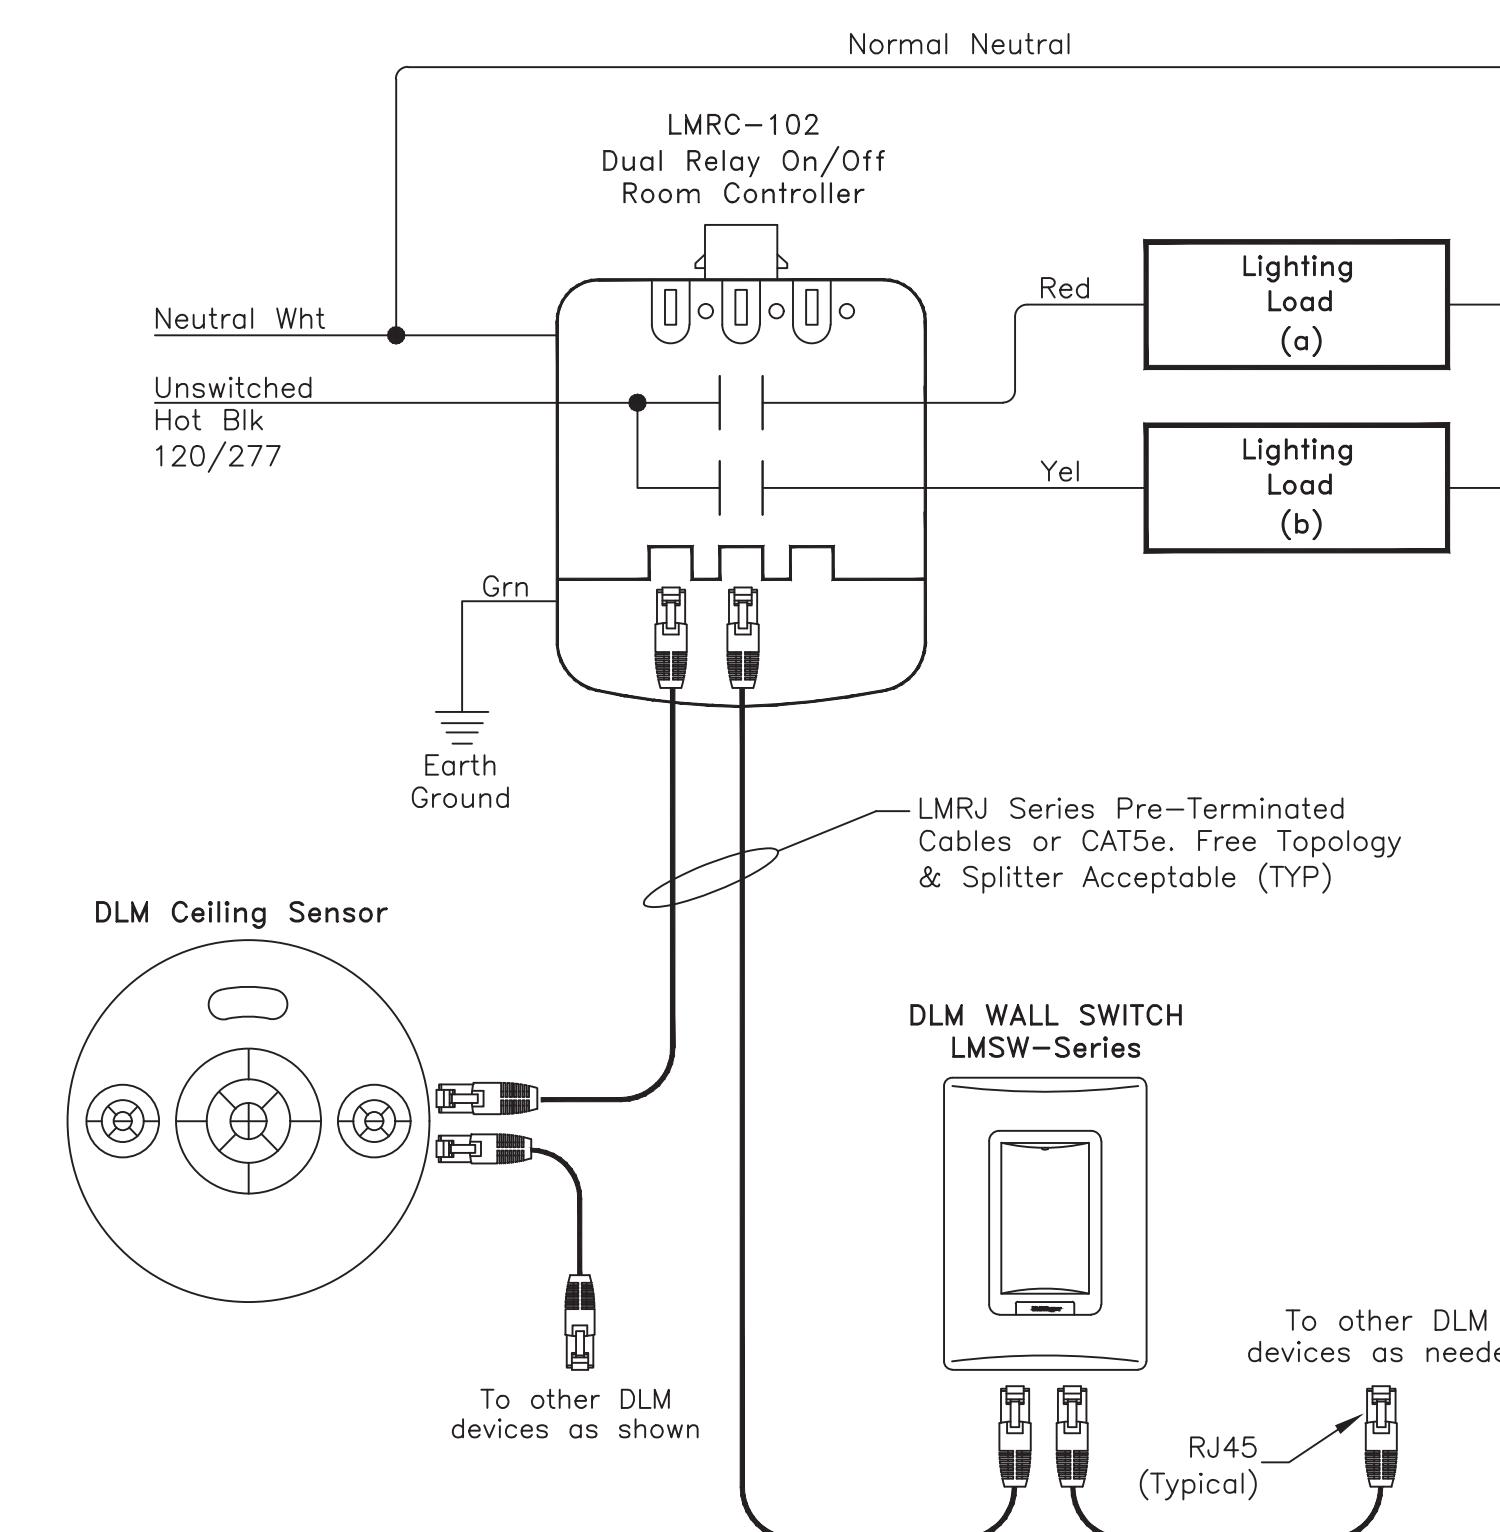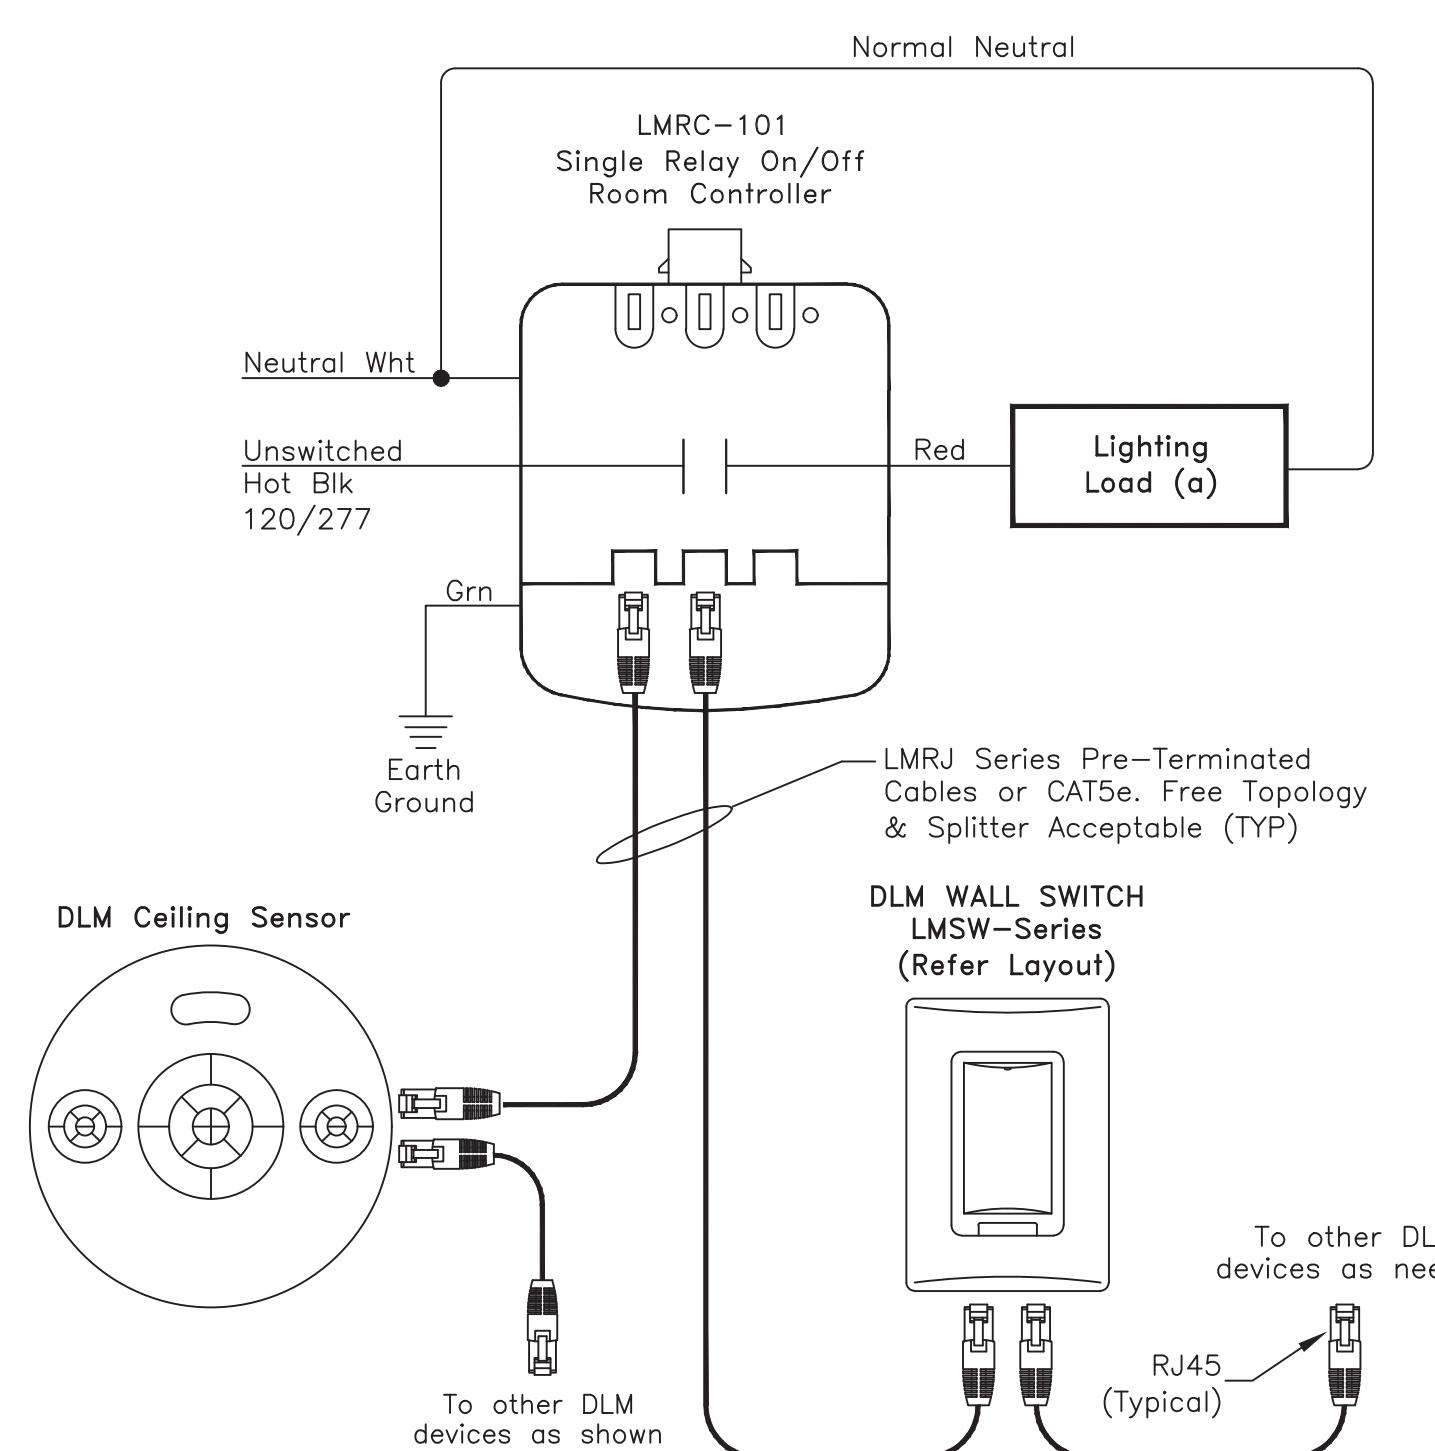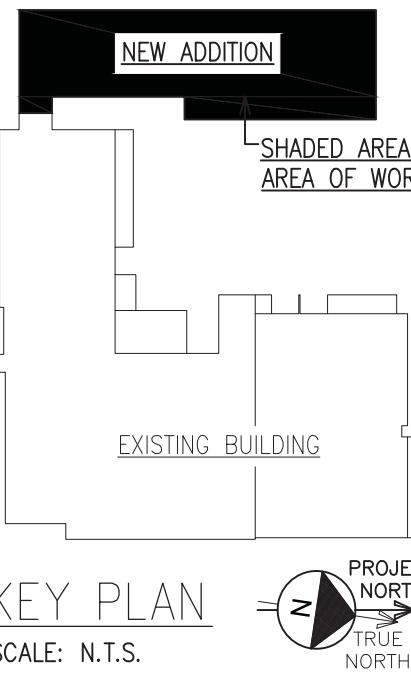

**TYP. LMRC-101
WIRING DIAGRAM**

**TYP. LMRC-102
WIRING DIAGRAM**

**TYP. LMRC-211
WIRING DIAGRAM**

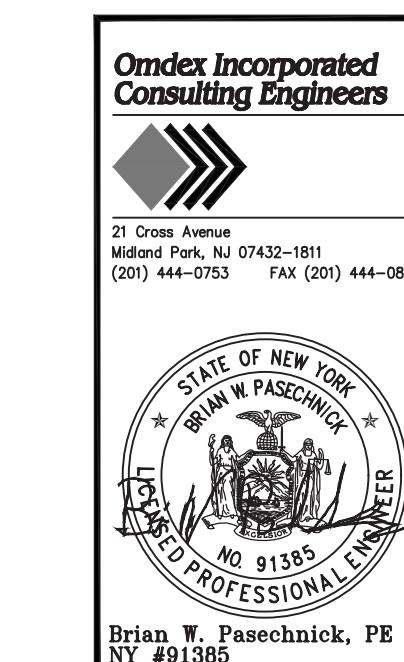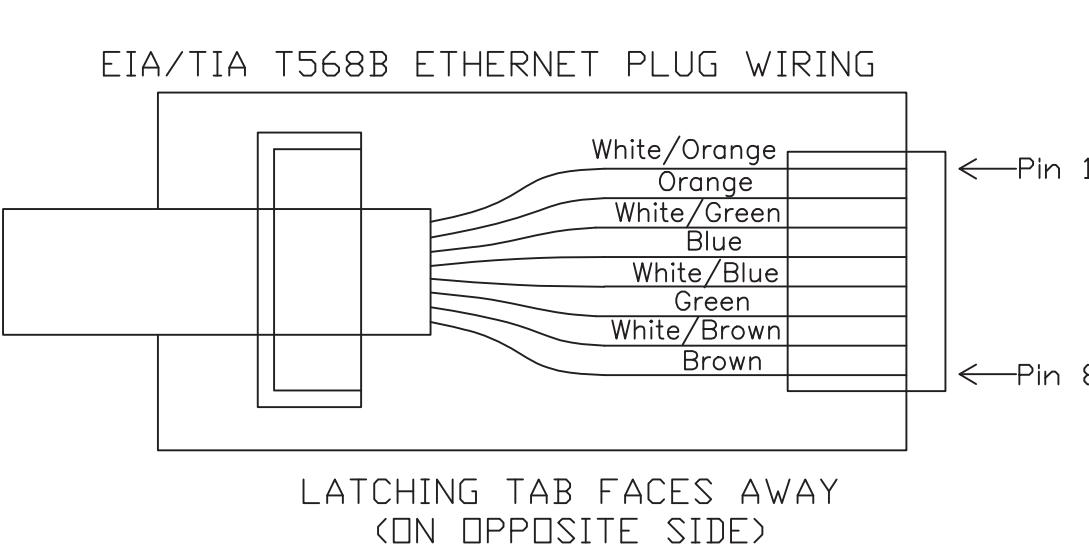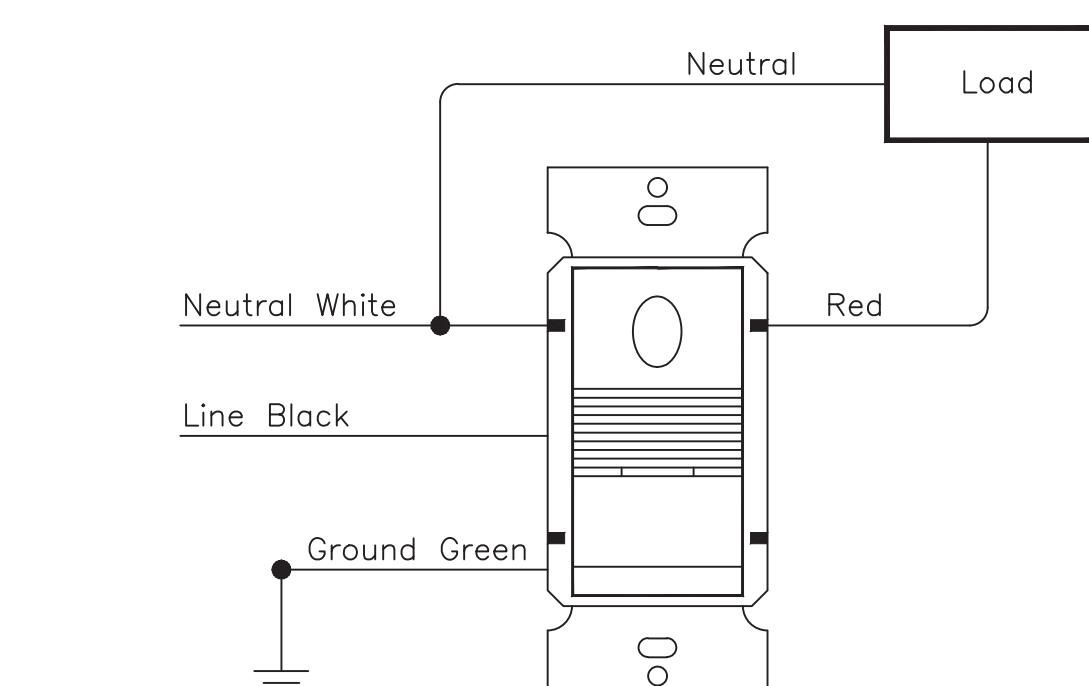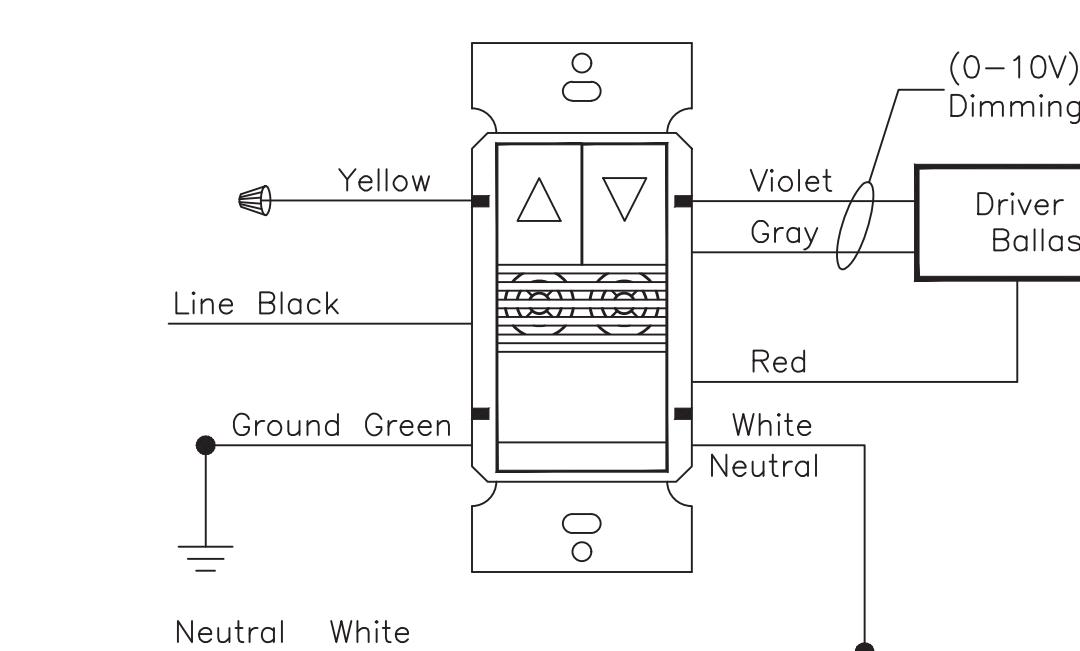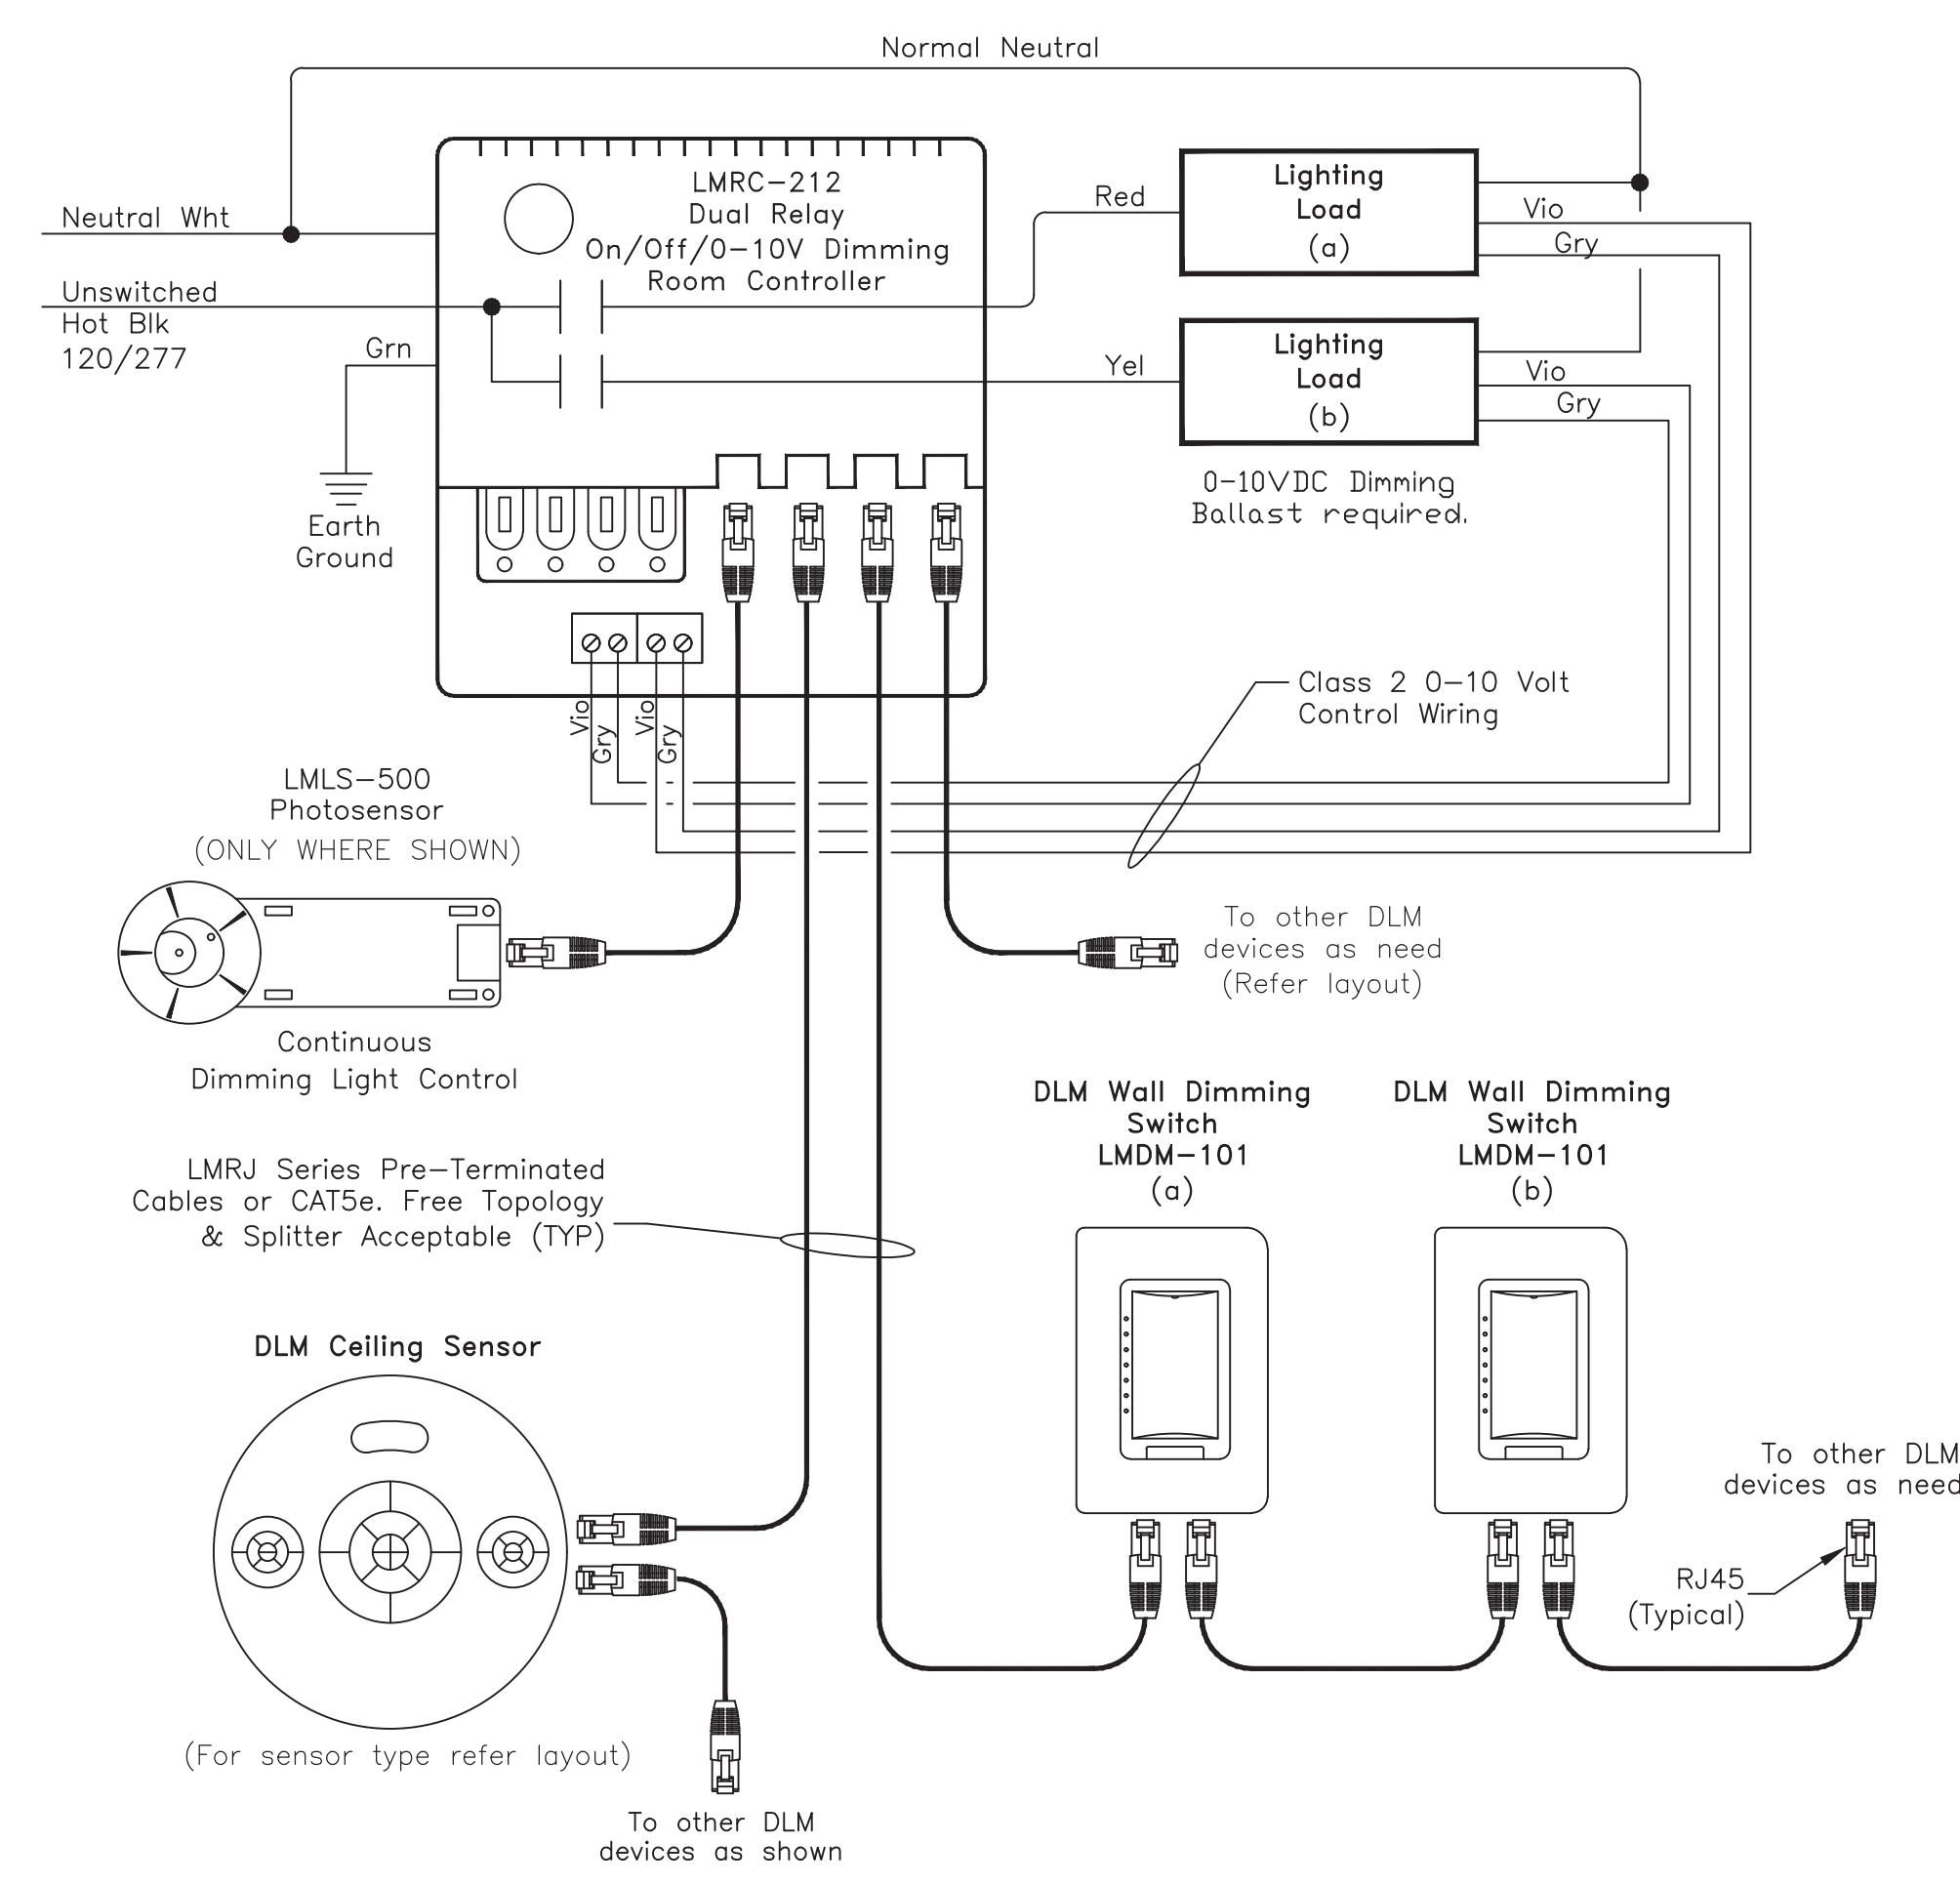

SNS ARCHITECTS & ENGINEERS
DRAFTED: M.J.R.
CHECKED: —
PROJ. NO: 5593
DATE: 08.11.2024







ENGINEERING REVIEW
DEPT. SIGNATURE DATE
CIVIL
METERING
RELAY
TRANS. & SUB.
DESIGN REVIEW DATE
DRAWING NUMBER SHEET REV
AS NOTED E-503 77 OF 95

1 ISSUED FOR BUILDING DEPARTMENT FILING & BIDDING 04-28-2025





ORANGE AND ROCKLAND UTILITIES, INC.
SPRING VALLEY NEW YORK

SVOC NEW OFFICE ADDITION
TAX ID # 56.52-1-2
300 W. MAIN ST.
VILLAGE OF SPRING VALLEY
TOWN OF RAMAPO
ROCKLAND COUNTY, NEW YORK



John Lignos, AIA
Lorin J. Sonenshine, AIA
Steven Napolitano, PE, PP
Lorin J. Sonenshine, AIA
Cert./Lic. No. NY 018401
SNS Architects & Engineers, PC
ONE PARAGON DRIVE . MONTVALE . NEW JERSEY . 07645 . Robert Nocella, AIA

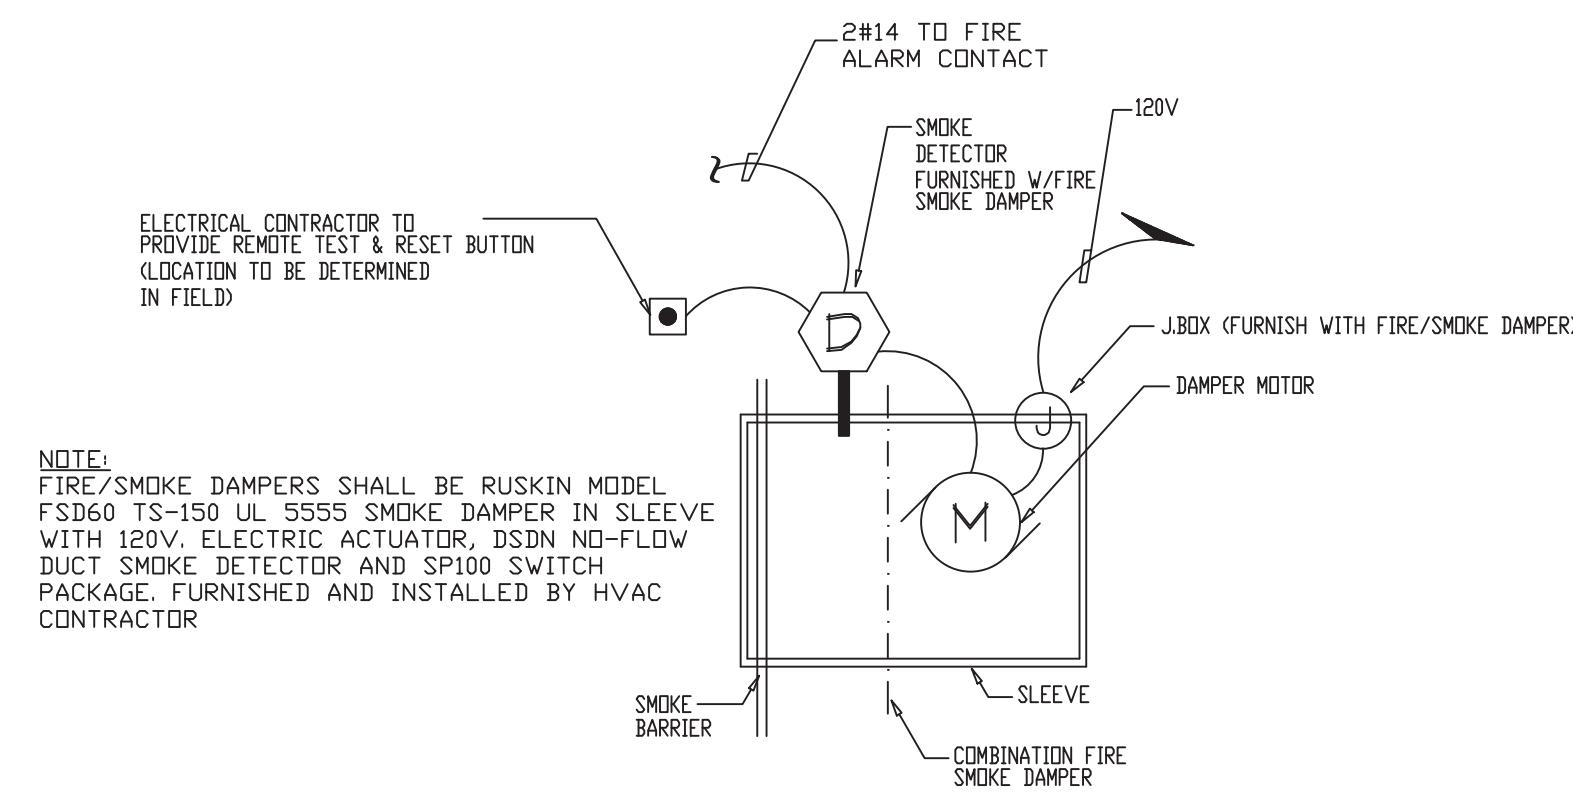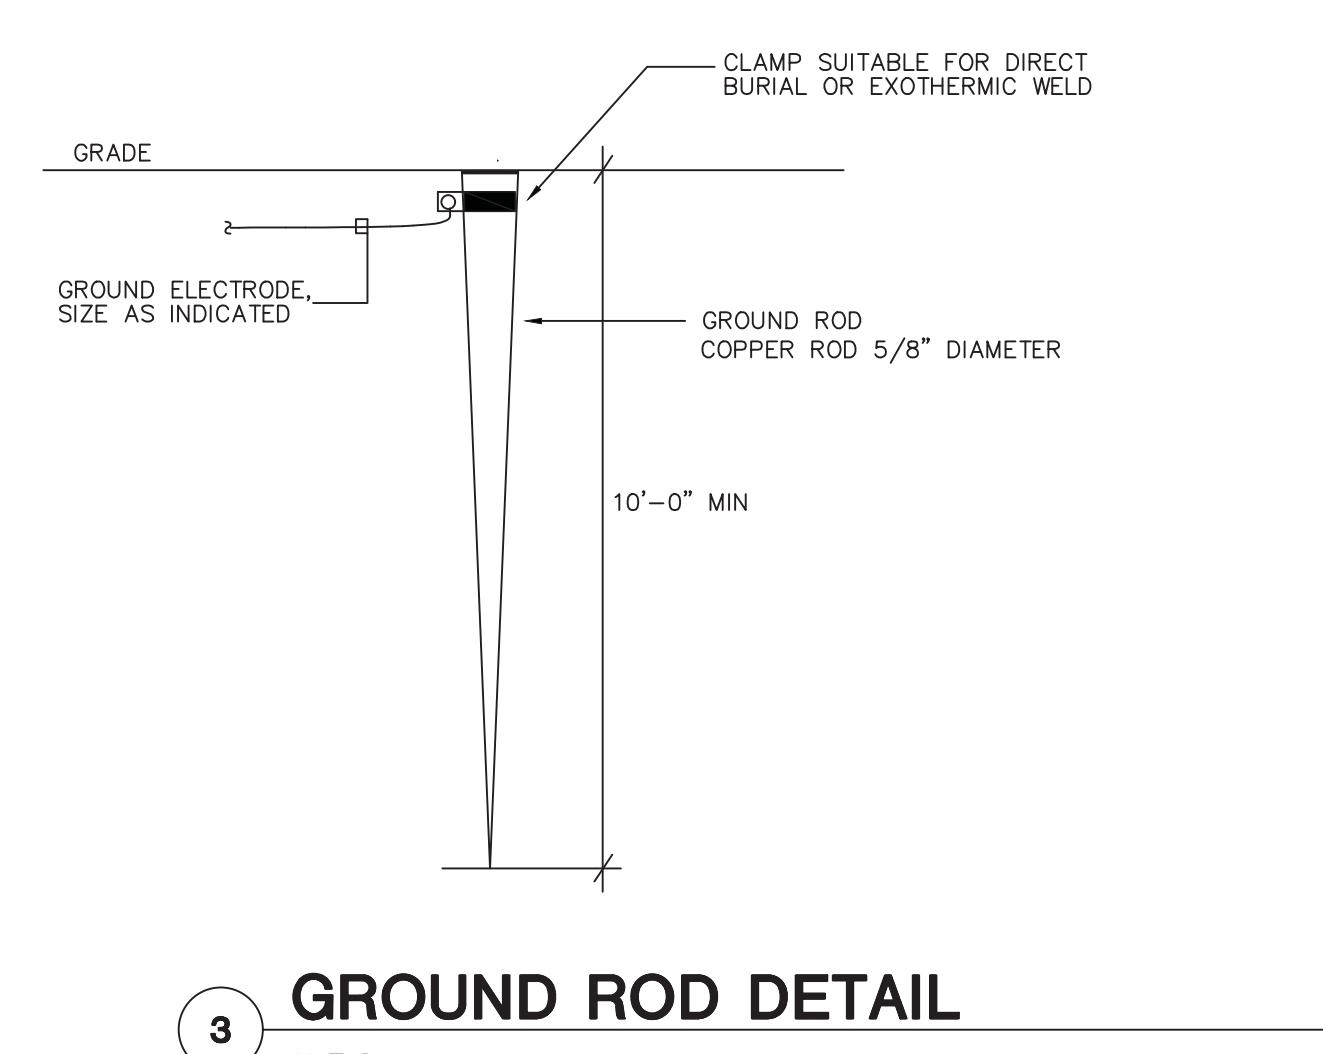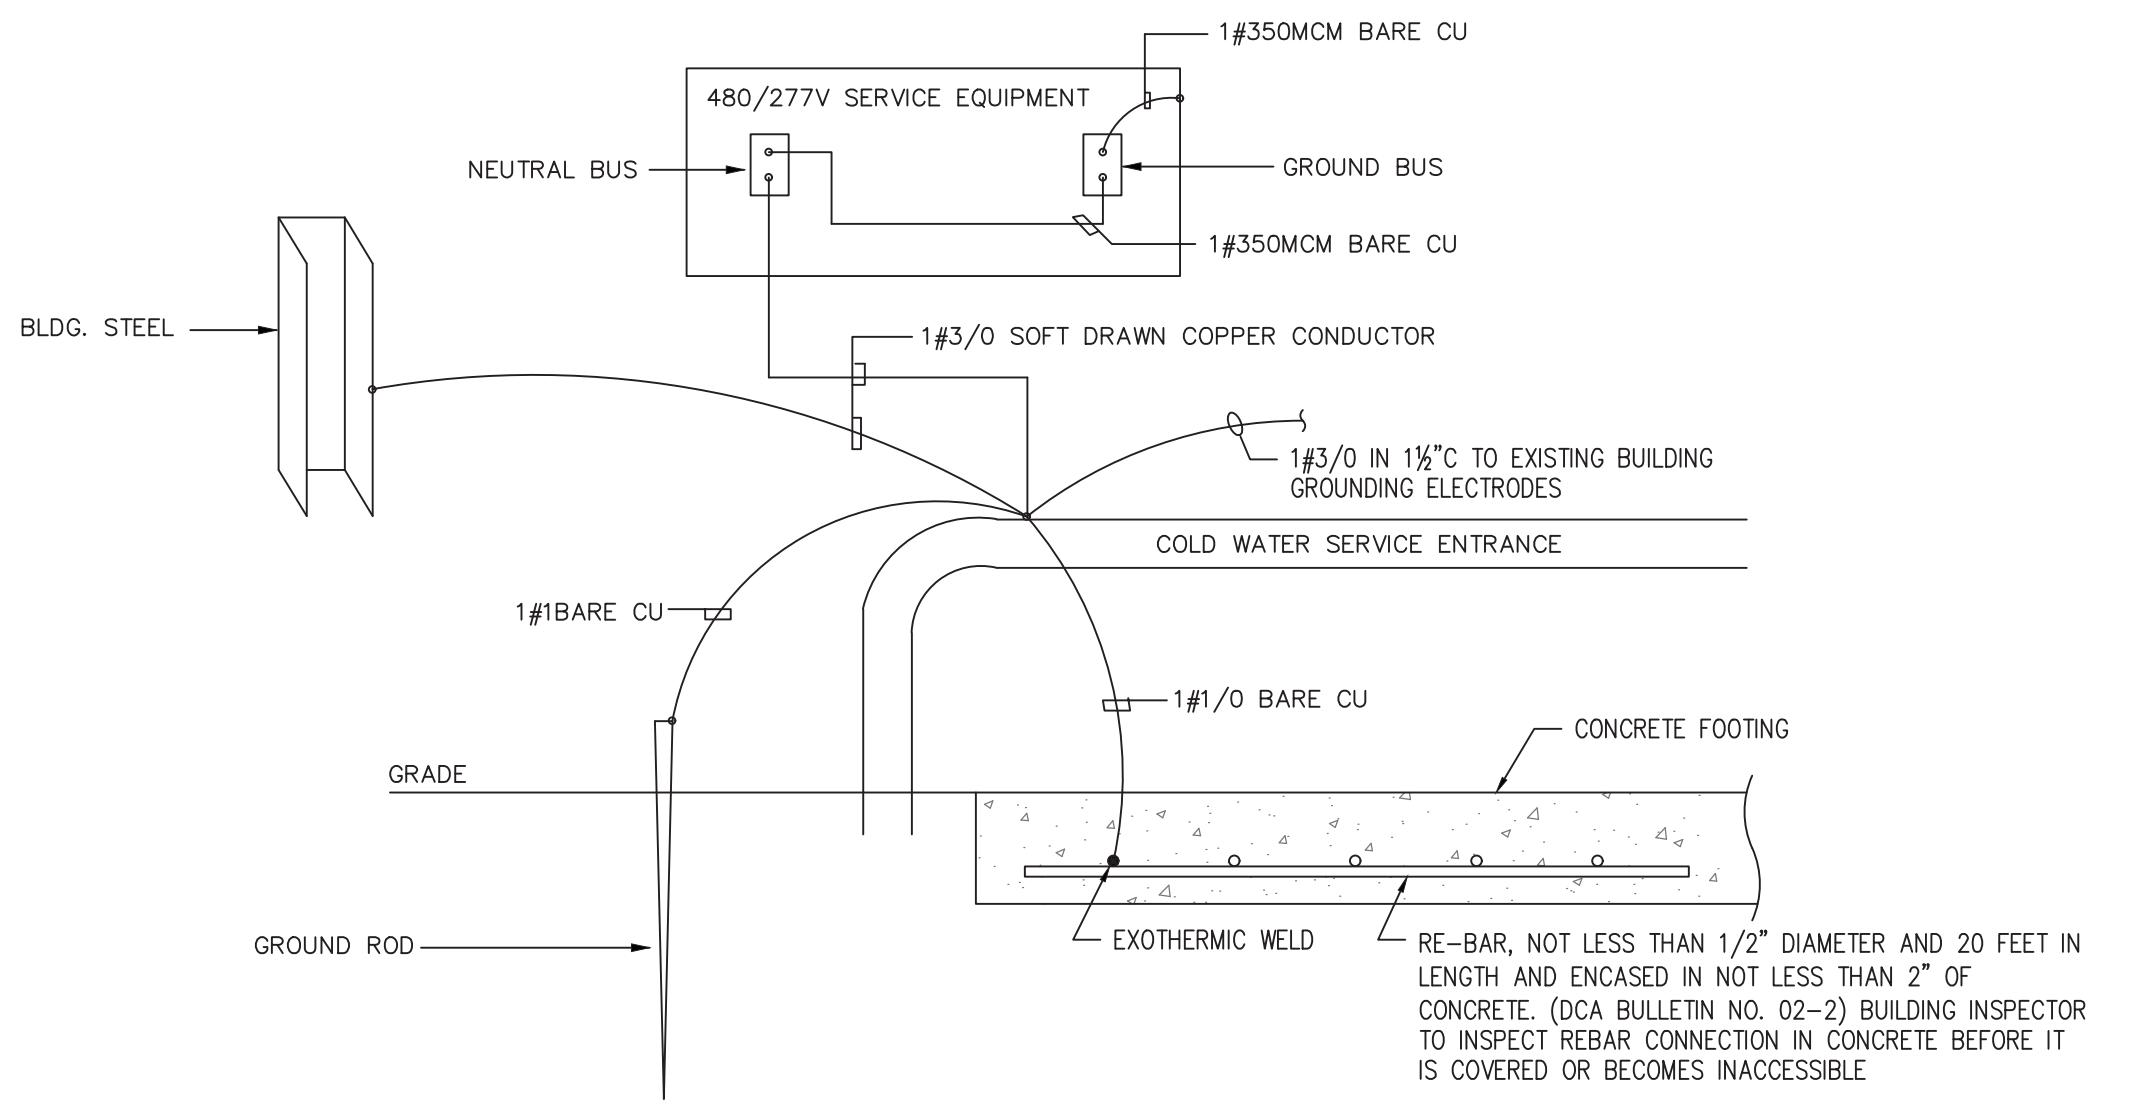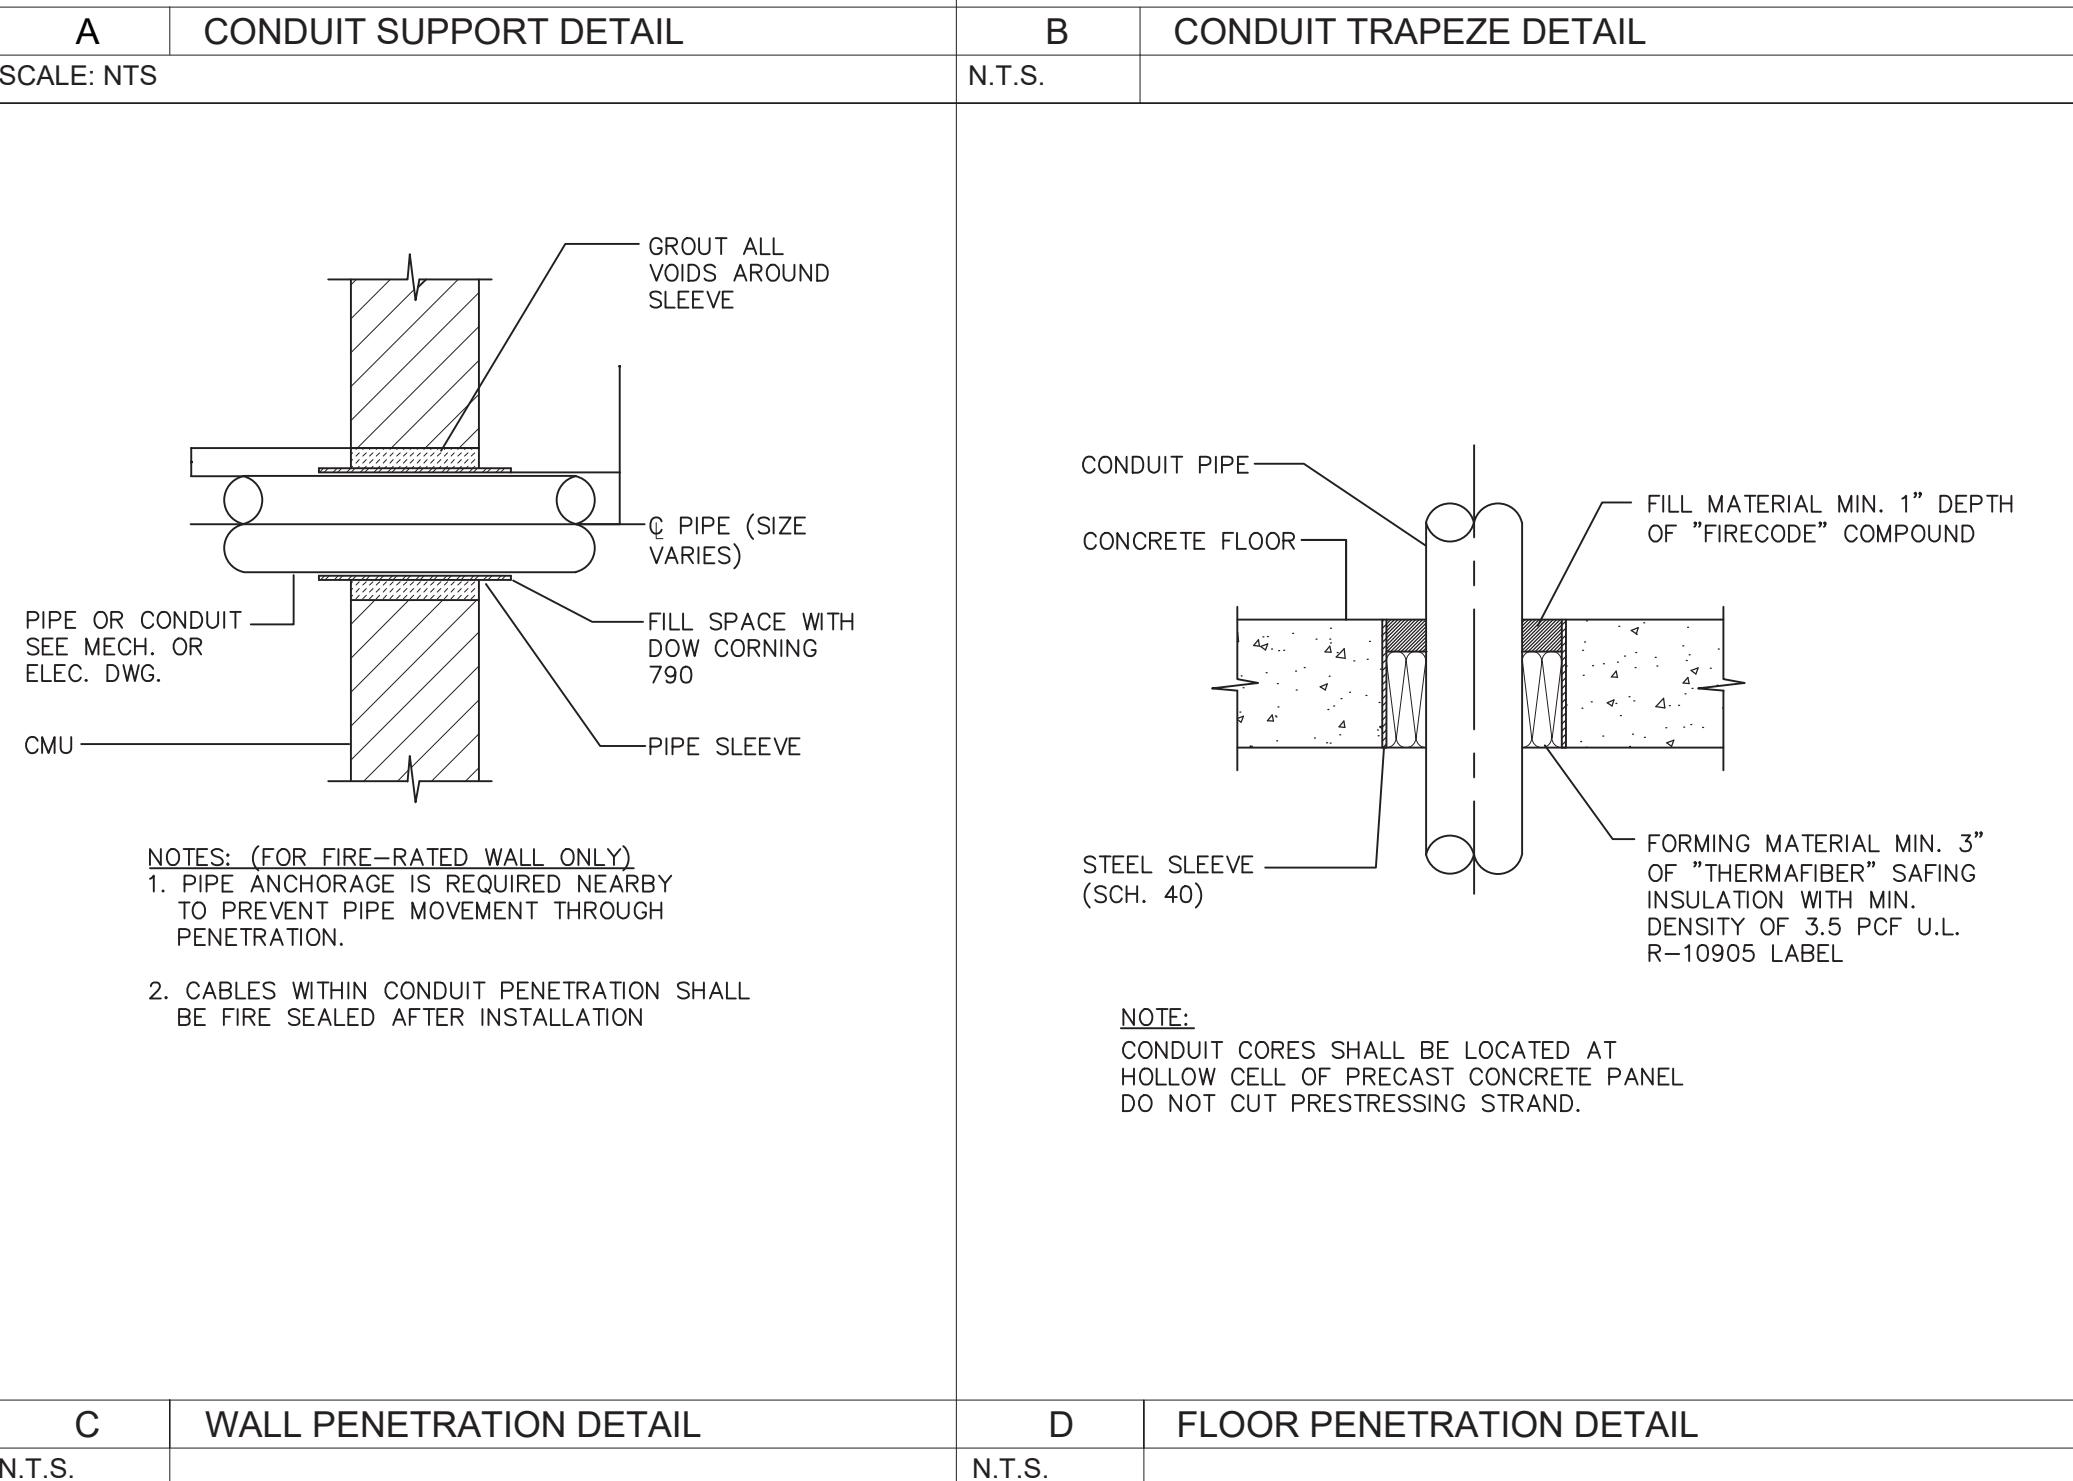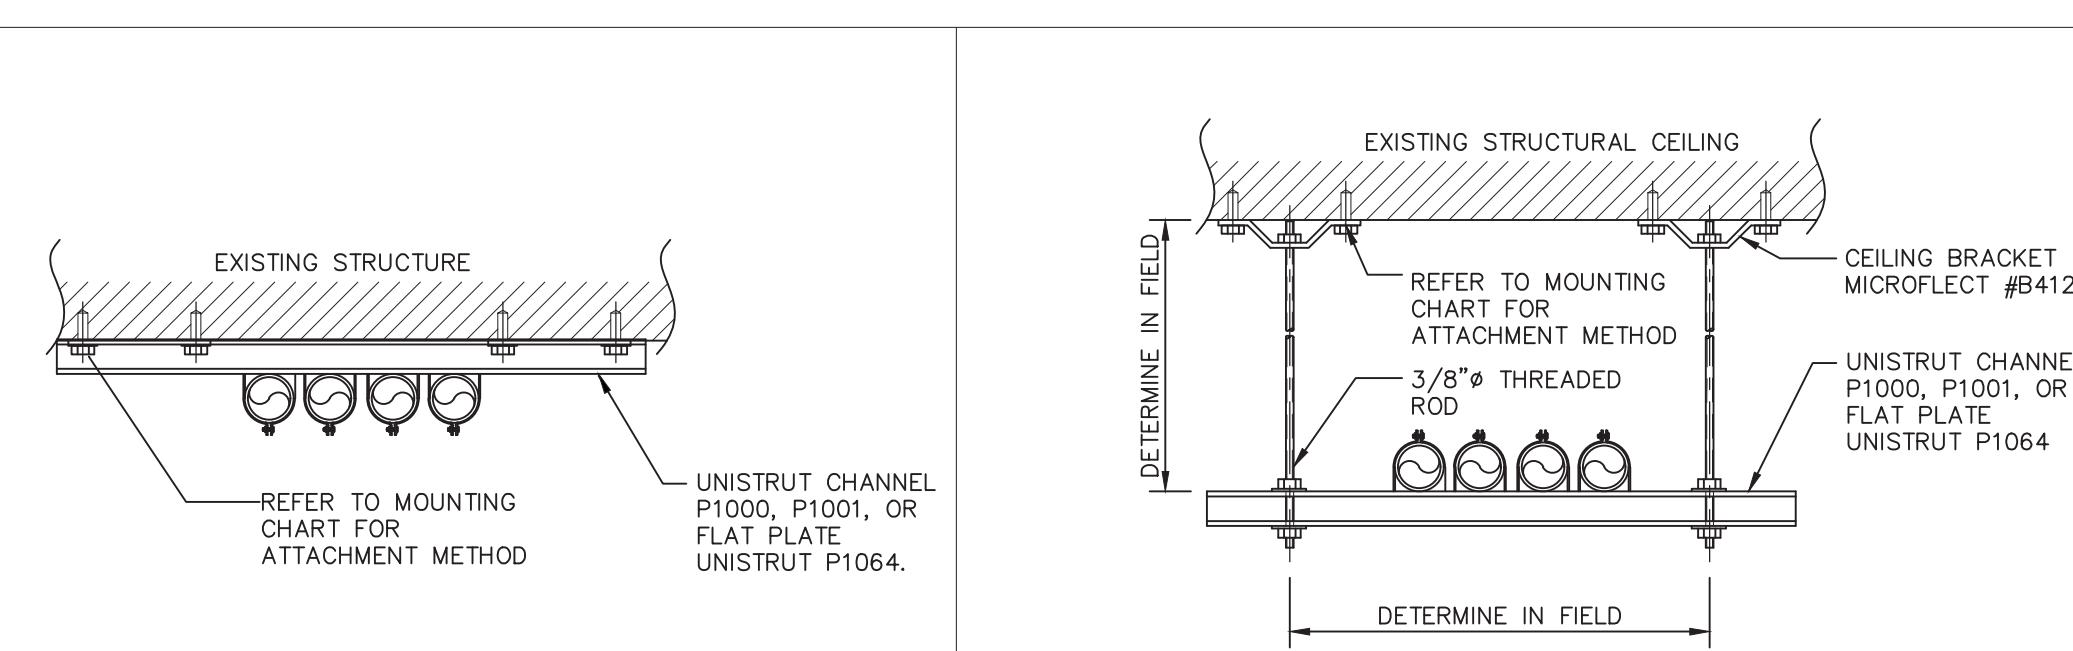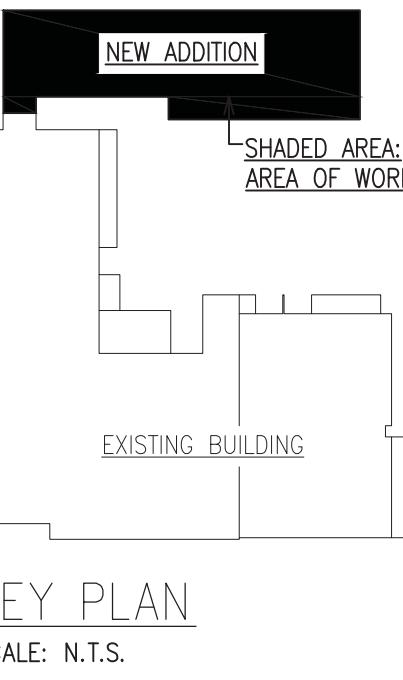

5 TYPICAL ROOF TOP UNIT DETAIL
N.T.S.

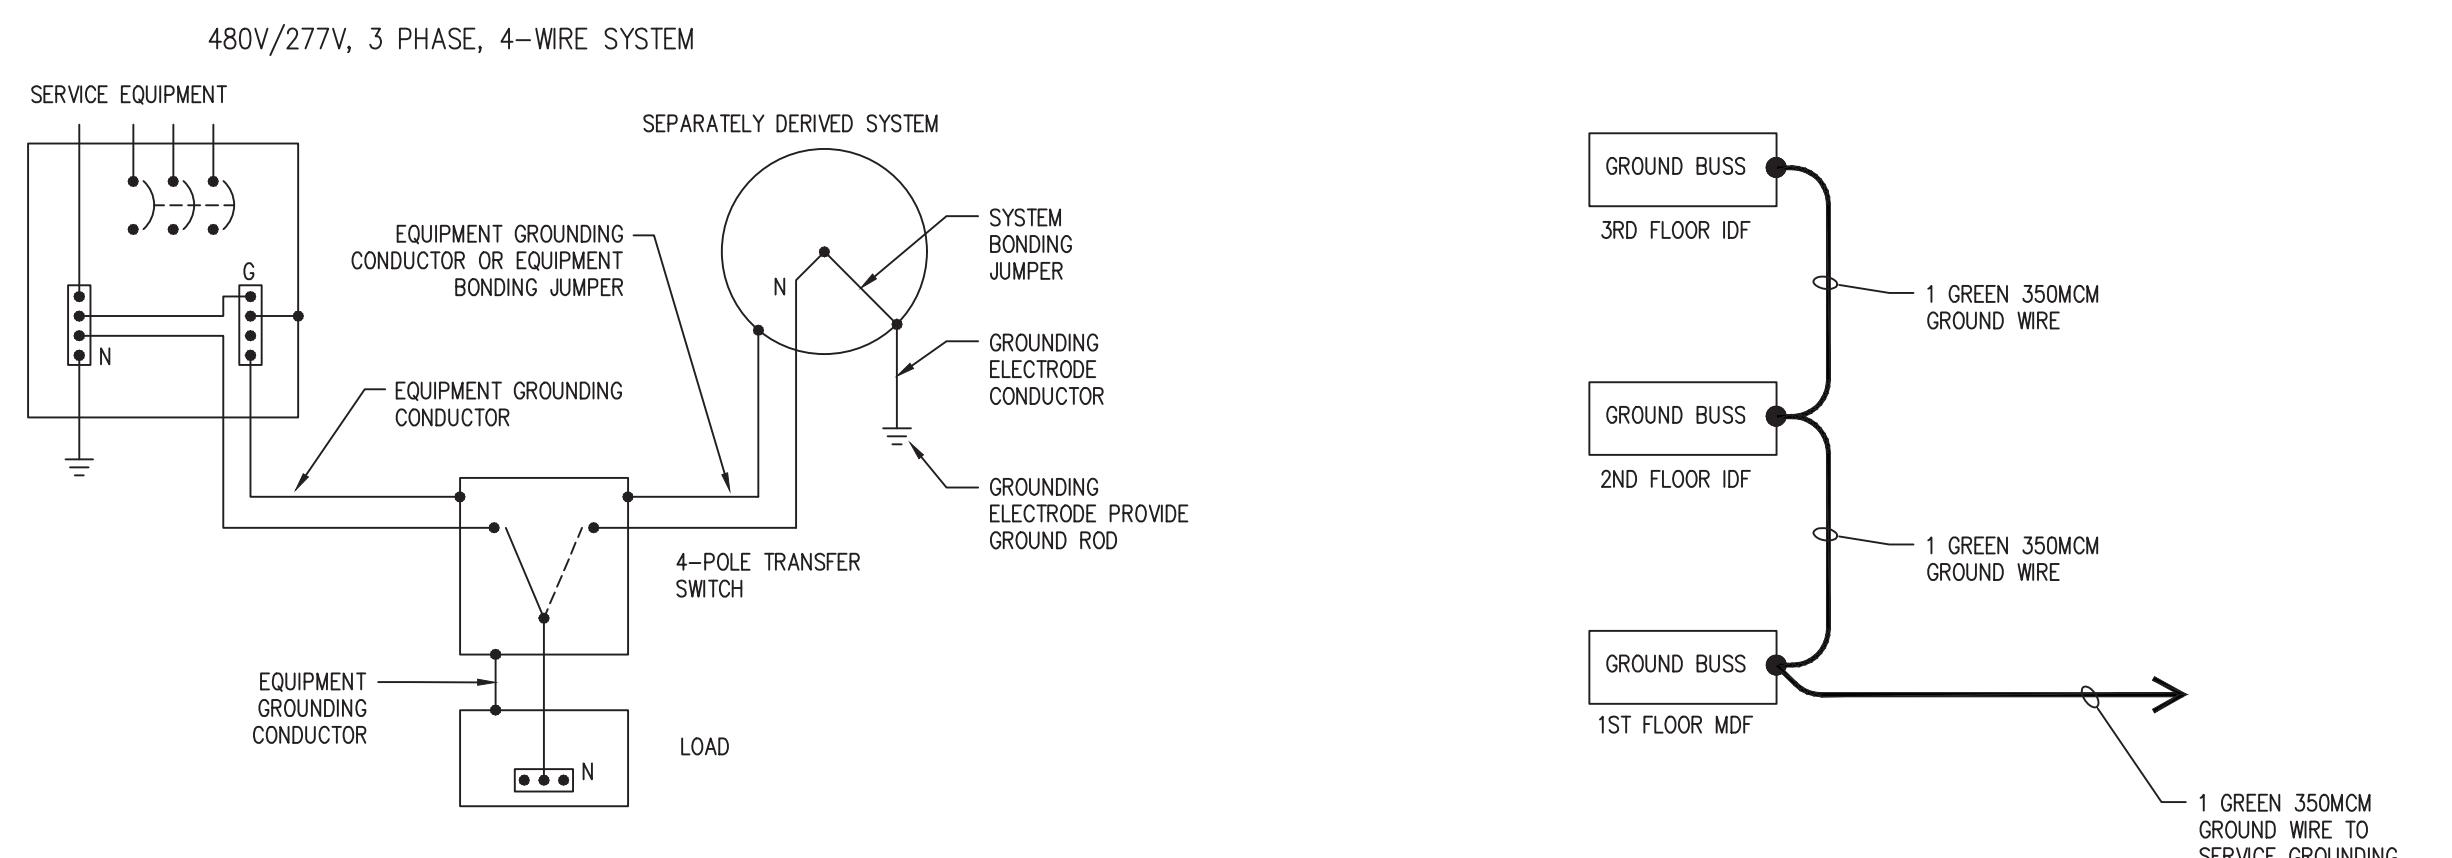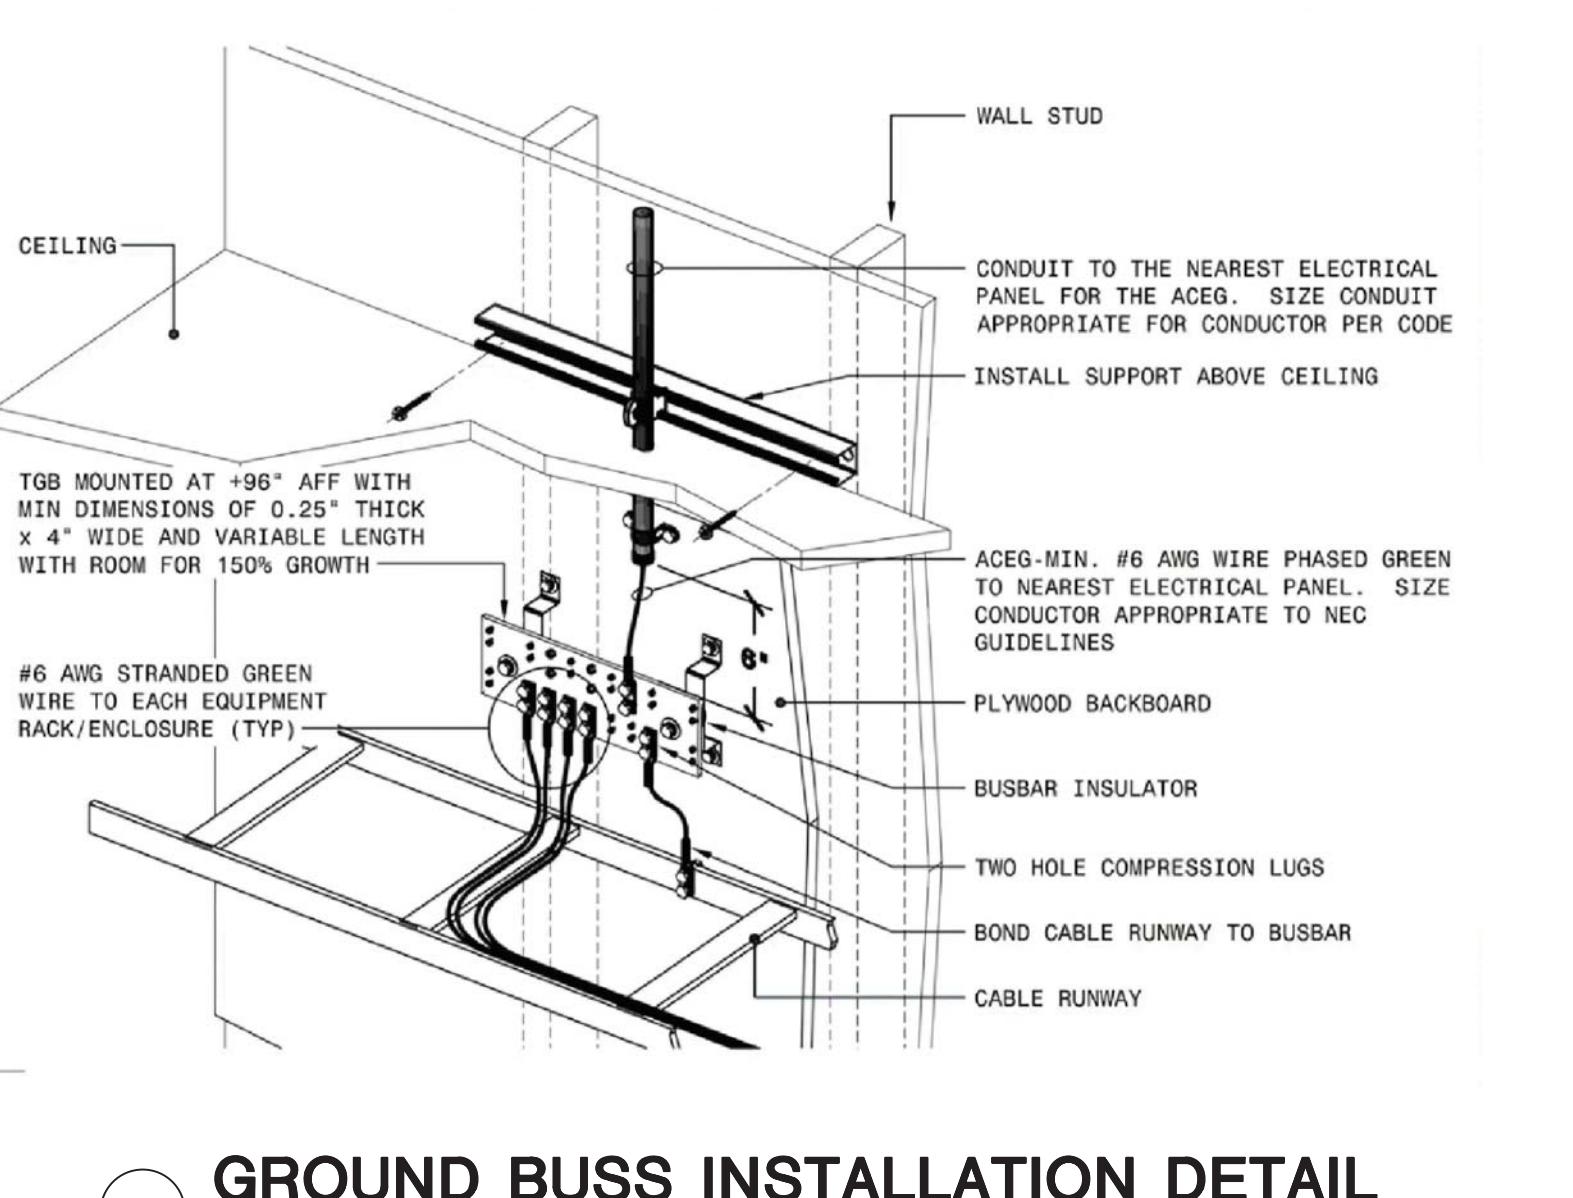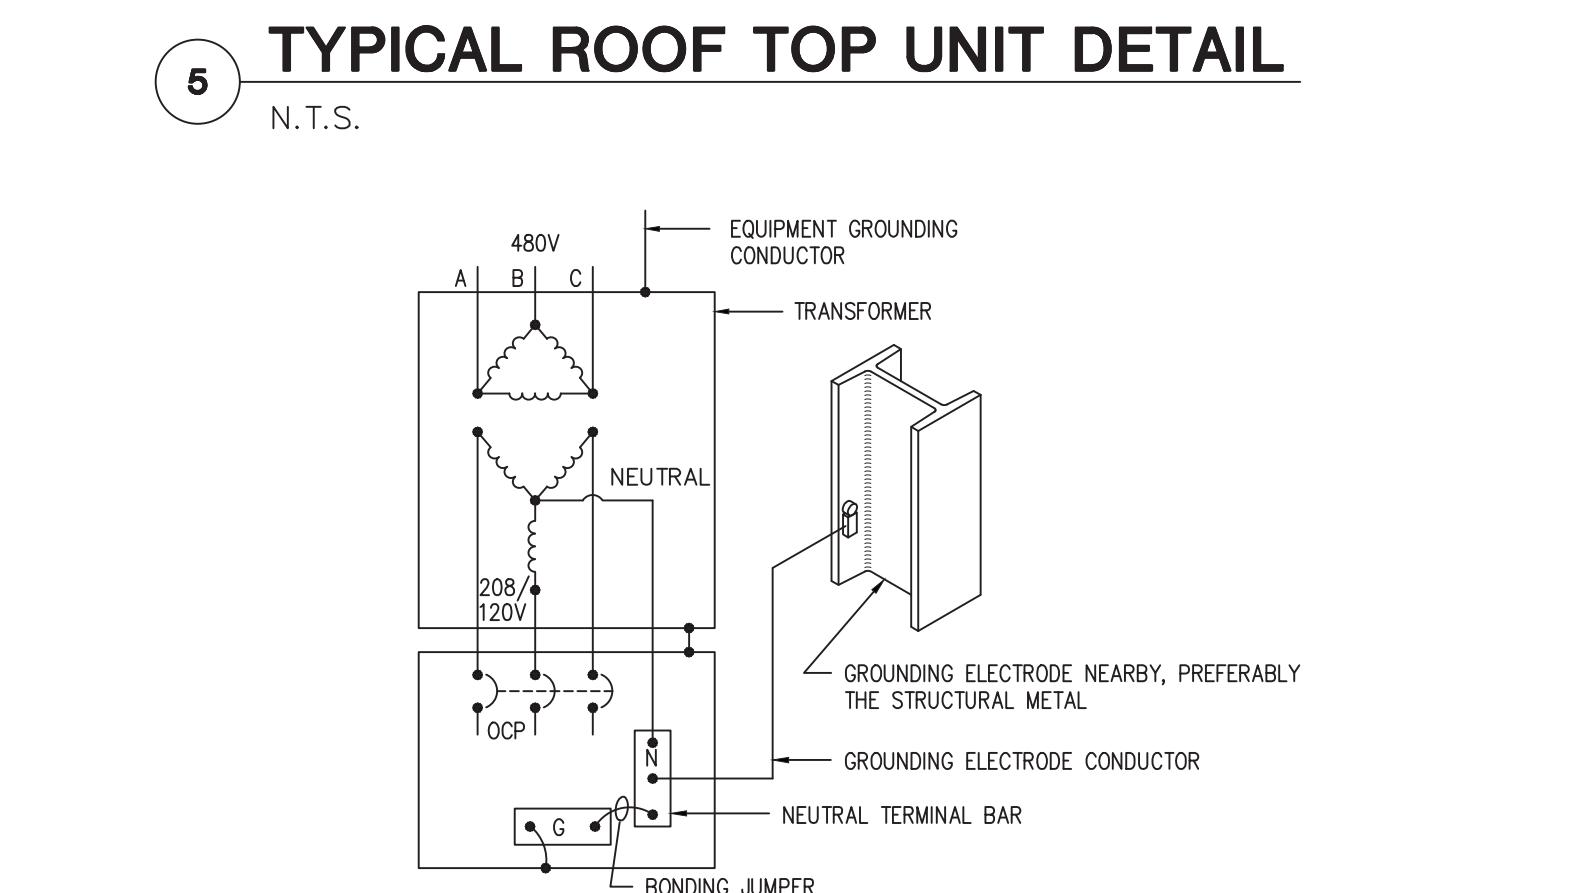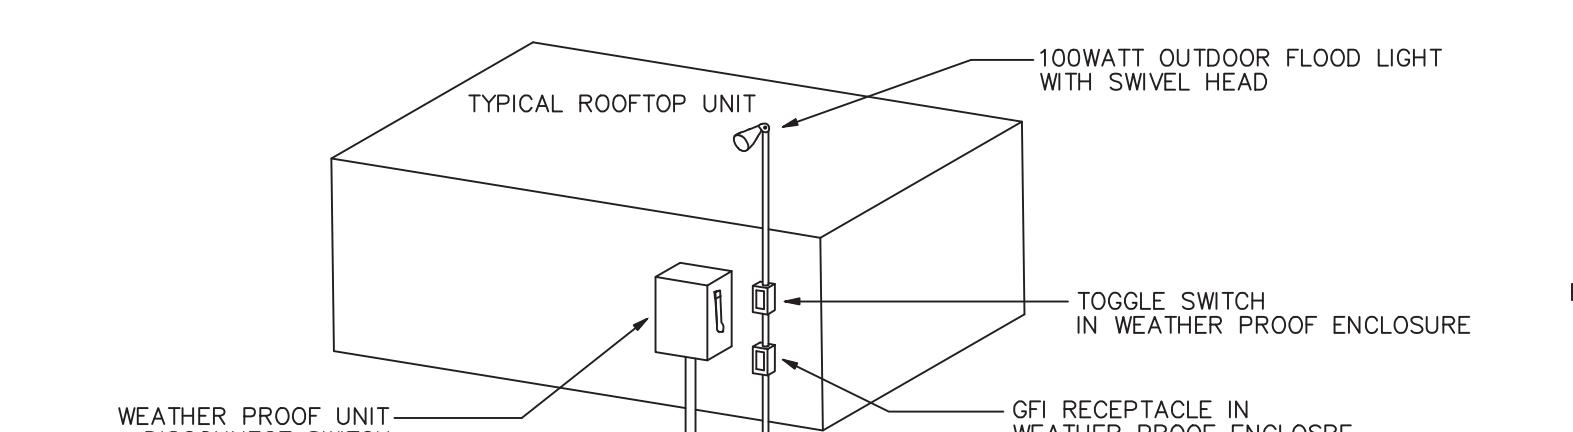

10 ELECTRICAL PANEL MOUNTING DETAILS
N.T.S.

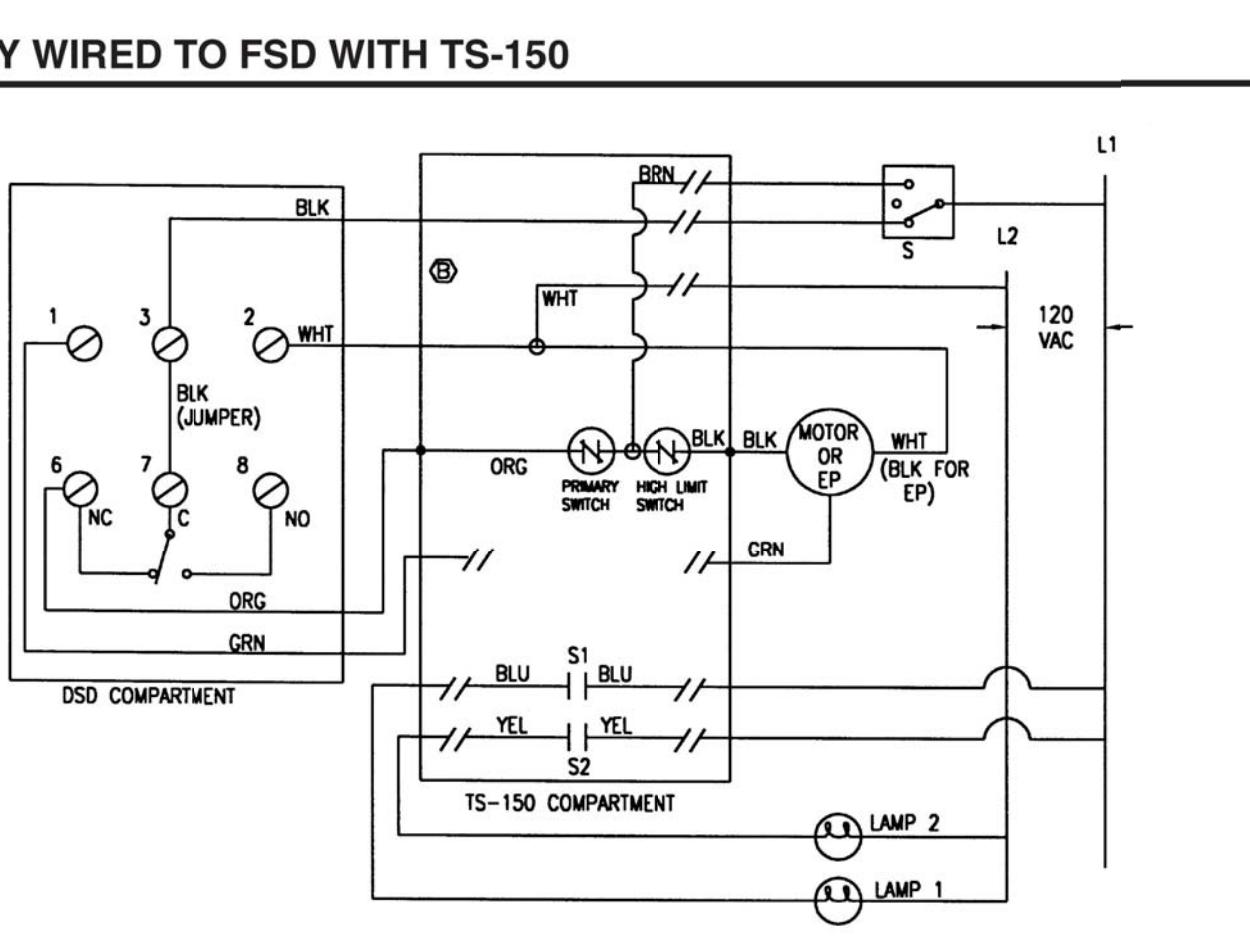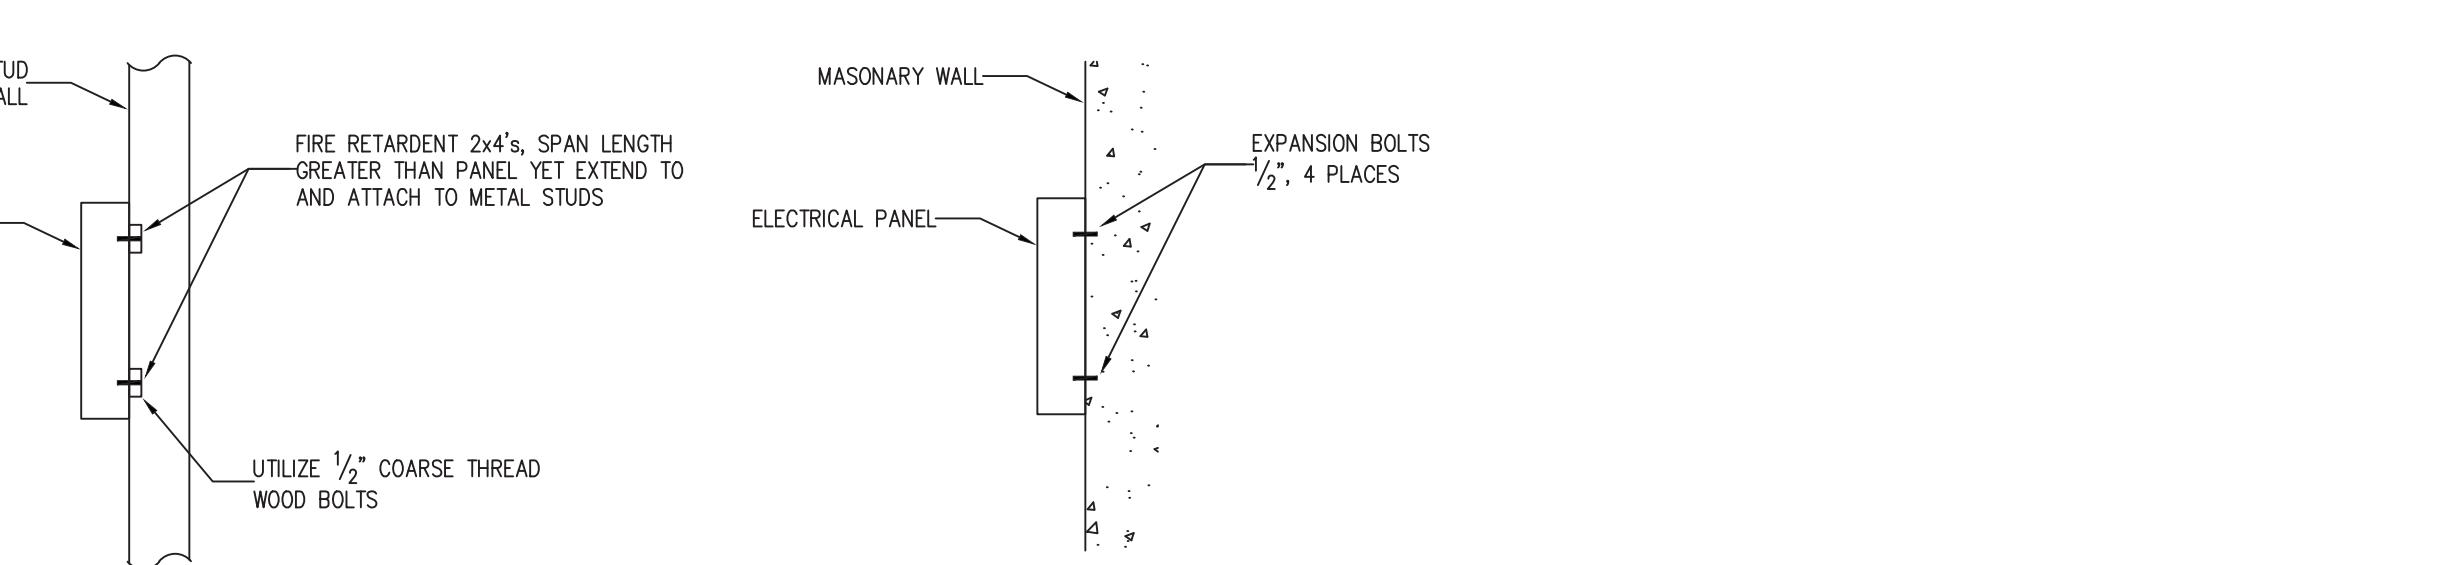

NOTES
 1. NOT ALL SCREW TERMINALS \diamond IN THE DSD COMPARTMENT ARE SHOWN, FOR CLARITY.
 2. CONNECTORS BETWEEN SCREW TERMINALS 6, 7 & 8 ARE PRE-WIRED BY THE DSD MANUFACTURER. AT MODELE CONDITION, CONTACT BETWEEN 6 & 7 BREAKS: CONTACT BETWEEN 6 & 8 MAKES.
 3. THREE POSITION SWITCH "S" LAMP 1 AND LAMP 2 ARE BY DAMPER MANUFACTURER.
 4. THESE WIRING DIAGRAMS APPLY TO MODEL DH-98 SMOKE DETECTOR (MADE BY HOKI) WITH PHOTOCELIC DETECTOR HEAD.
 5. // INDICATED CONNECTIONS NEEDED TO BE MADE IN THE FIELD BY QUALIFIED ELECTRICIAN.

SMOKE DAMPER WIRING DIAGRAM
N.T.S.



ENGINEERING REVIEW		
APPROVED	ELECTRICAL DETAILS	
INFORMATION COMMENTS		BID
METERING		CONSTRUCTION
TRANS SUB		
DESIGN REVIEW		
AS NOTED	FILE NO.	DRAWING NUMBER
	E-601	78 OF 95

1 ISSUED FOR BUILDING DEPARTMENT FILING & BIDDING	04-28-2025
ORANGE AND ROCKLAND UTILITIES, INC.	
SPRING VALLEY NEW YORK	
SVOC NEW OFFICE ADDITION	
TAX ID # 56.52-1-2 300 W. 1ST ST. VILLAGE OF SPRING VALLEY TOWN OF RAMAPO ROCKLAND COUNTY, NEW YORK	
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Architects & Engineers, PC
ONE PARAGON DRIVE MONTVALE NEW JERSEY 07645

