




D.1 ROOF FRAMING PLAN - TOP OF STEEL = 117'-9 1/4"
S200 SCALE: 1/8" = 1'-0"

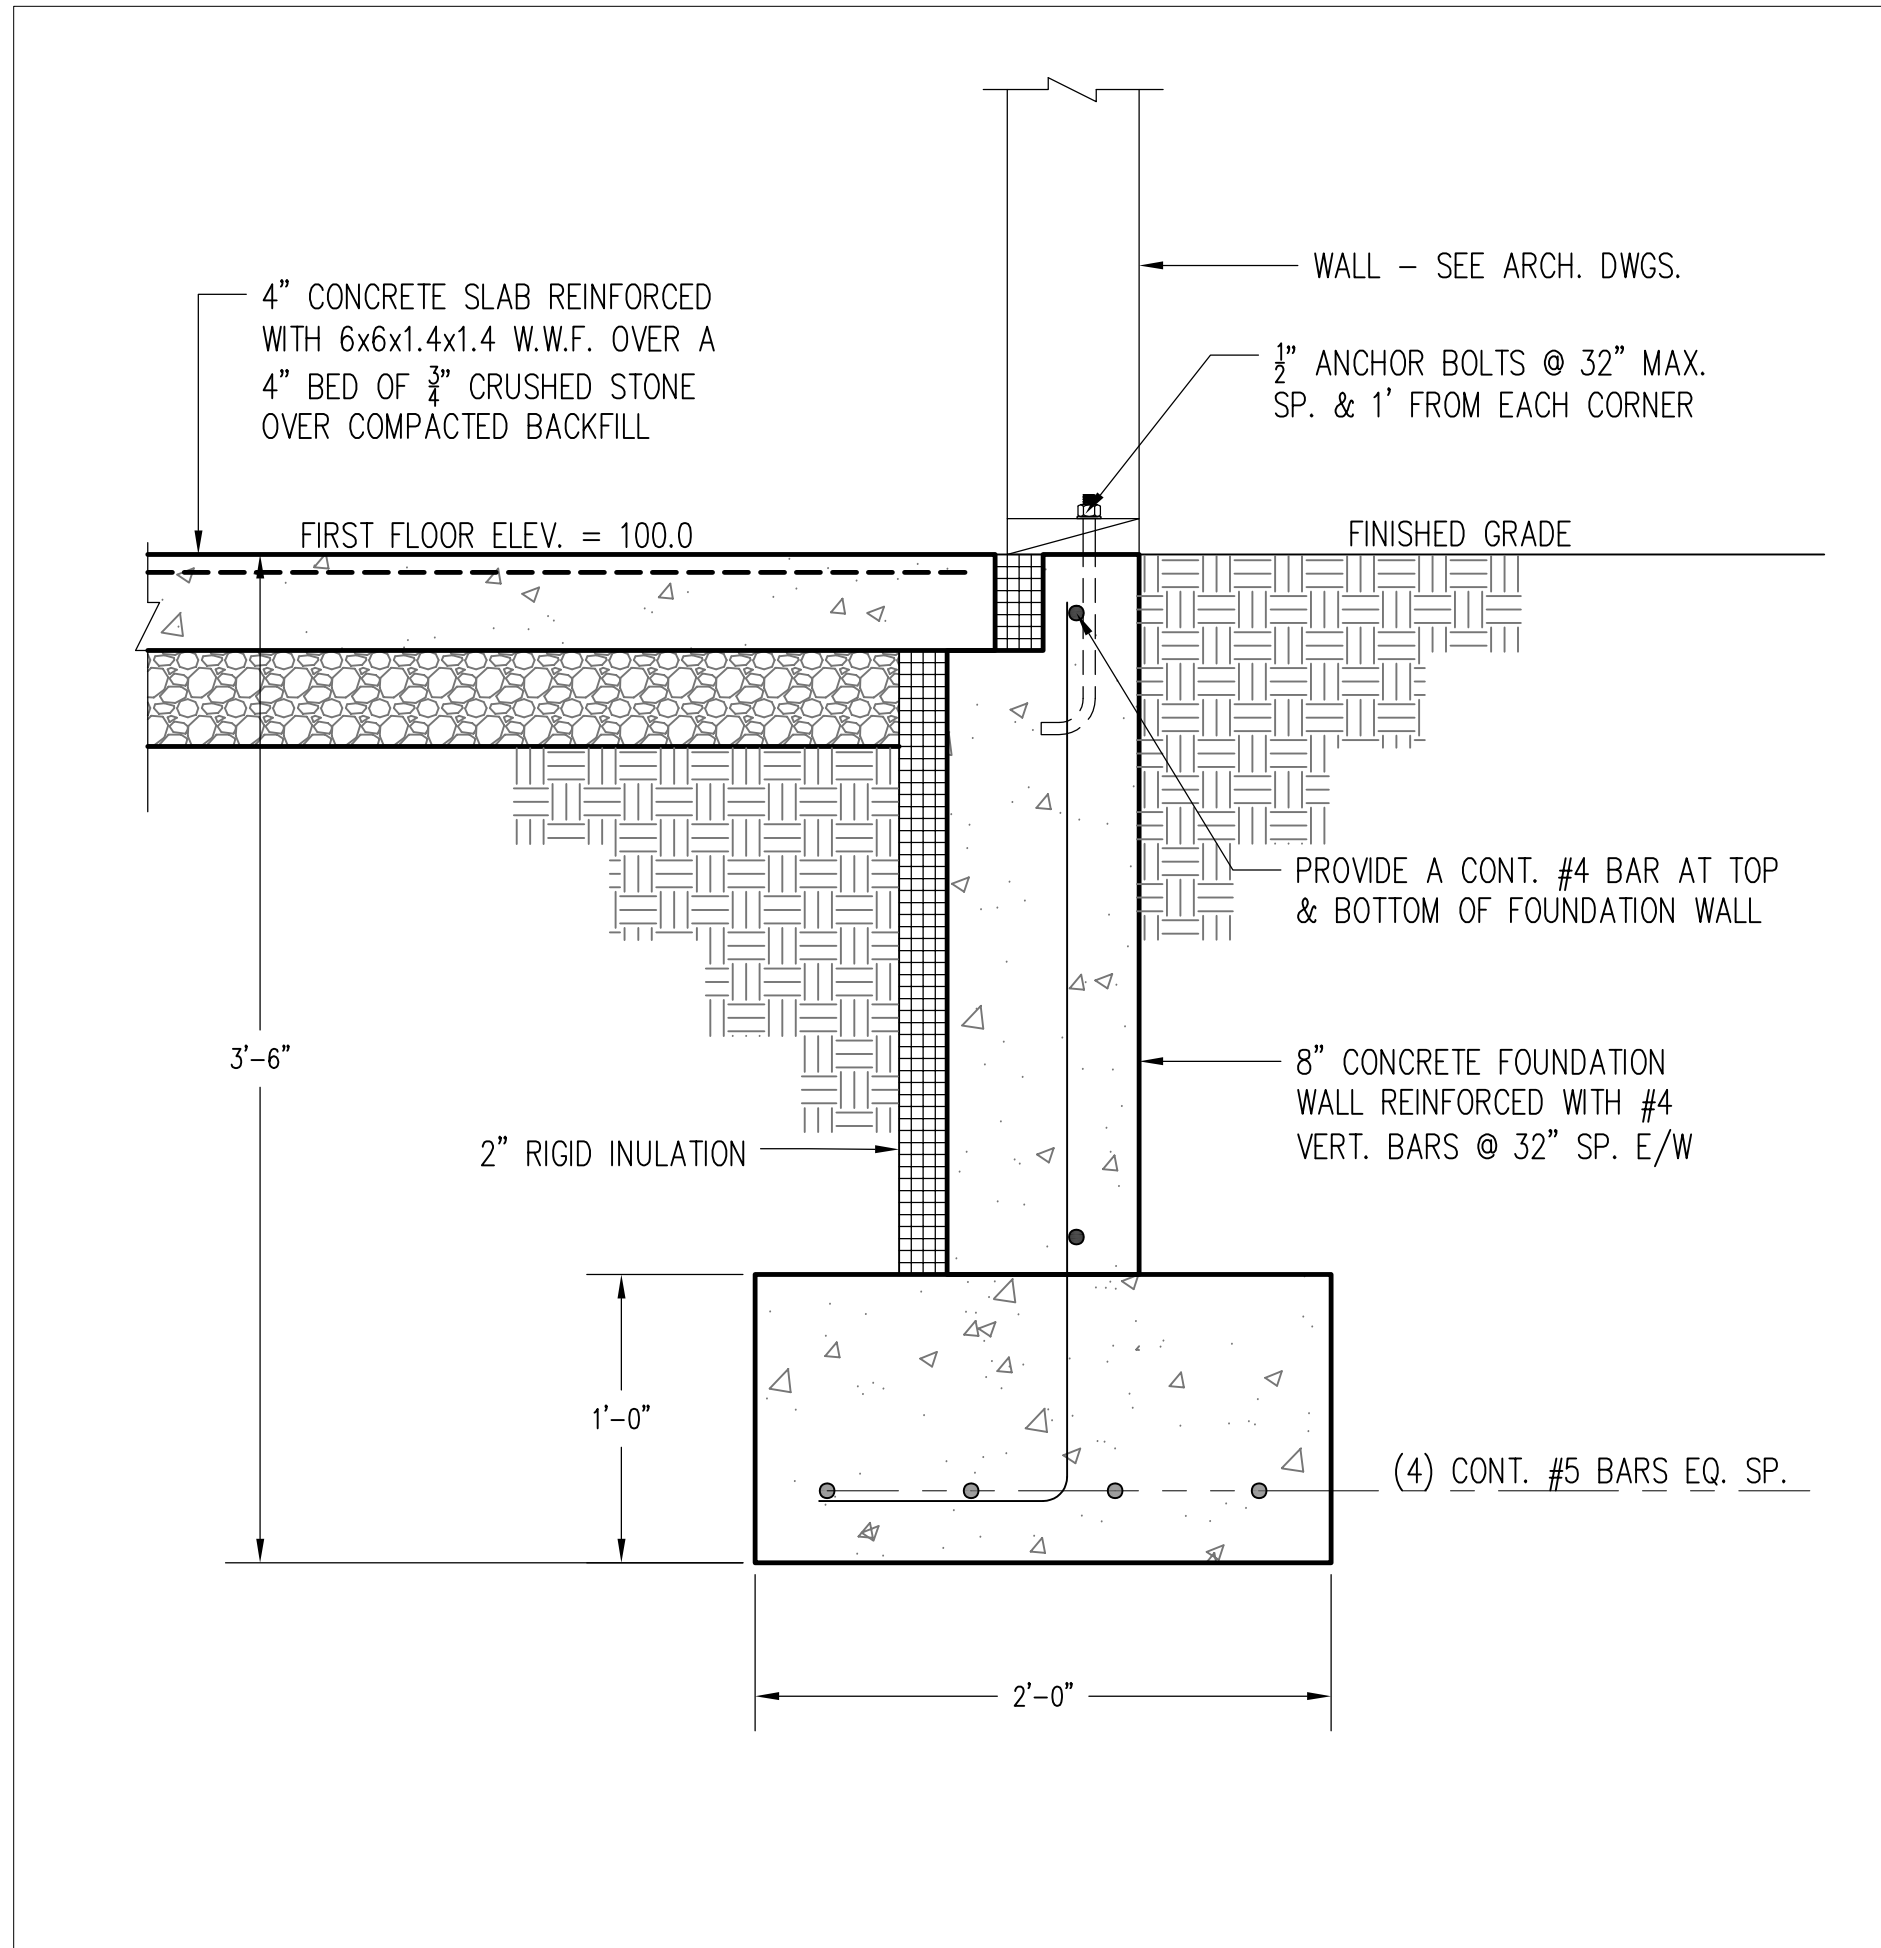

S.1 COOLING AREA FOUNDATION DETAIL
S200 SCALE: 1-1/2" = 1'-0"

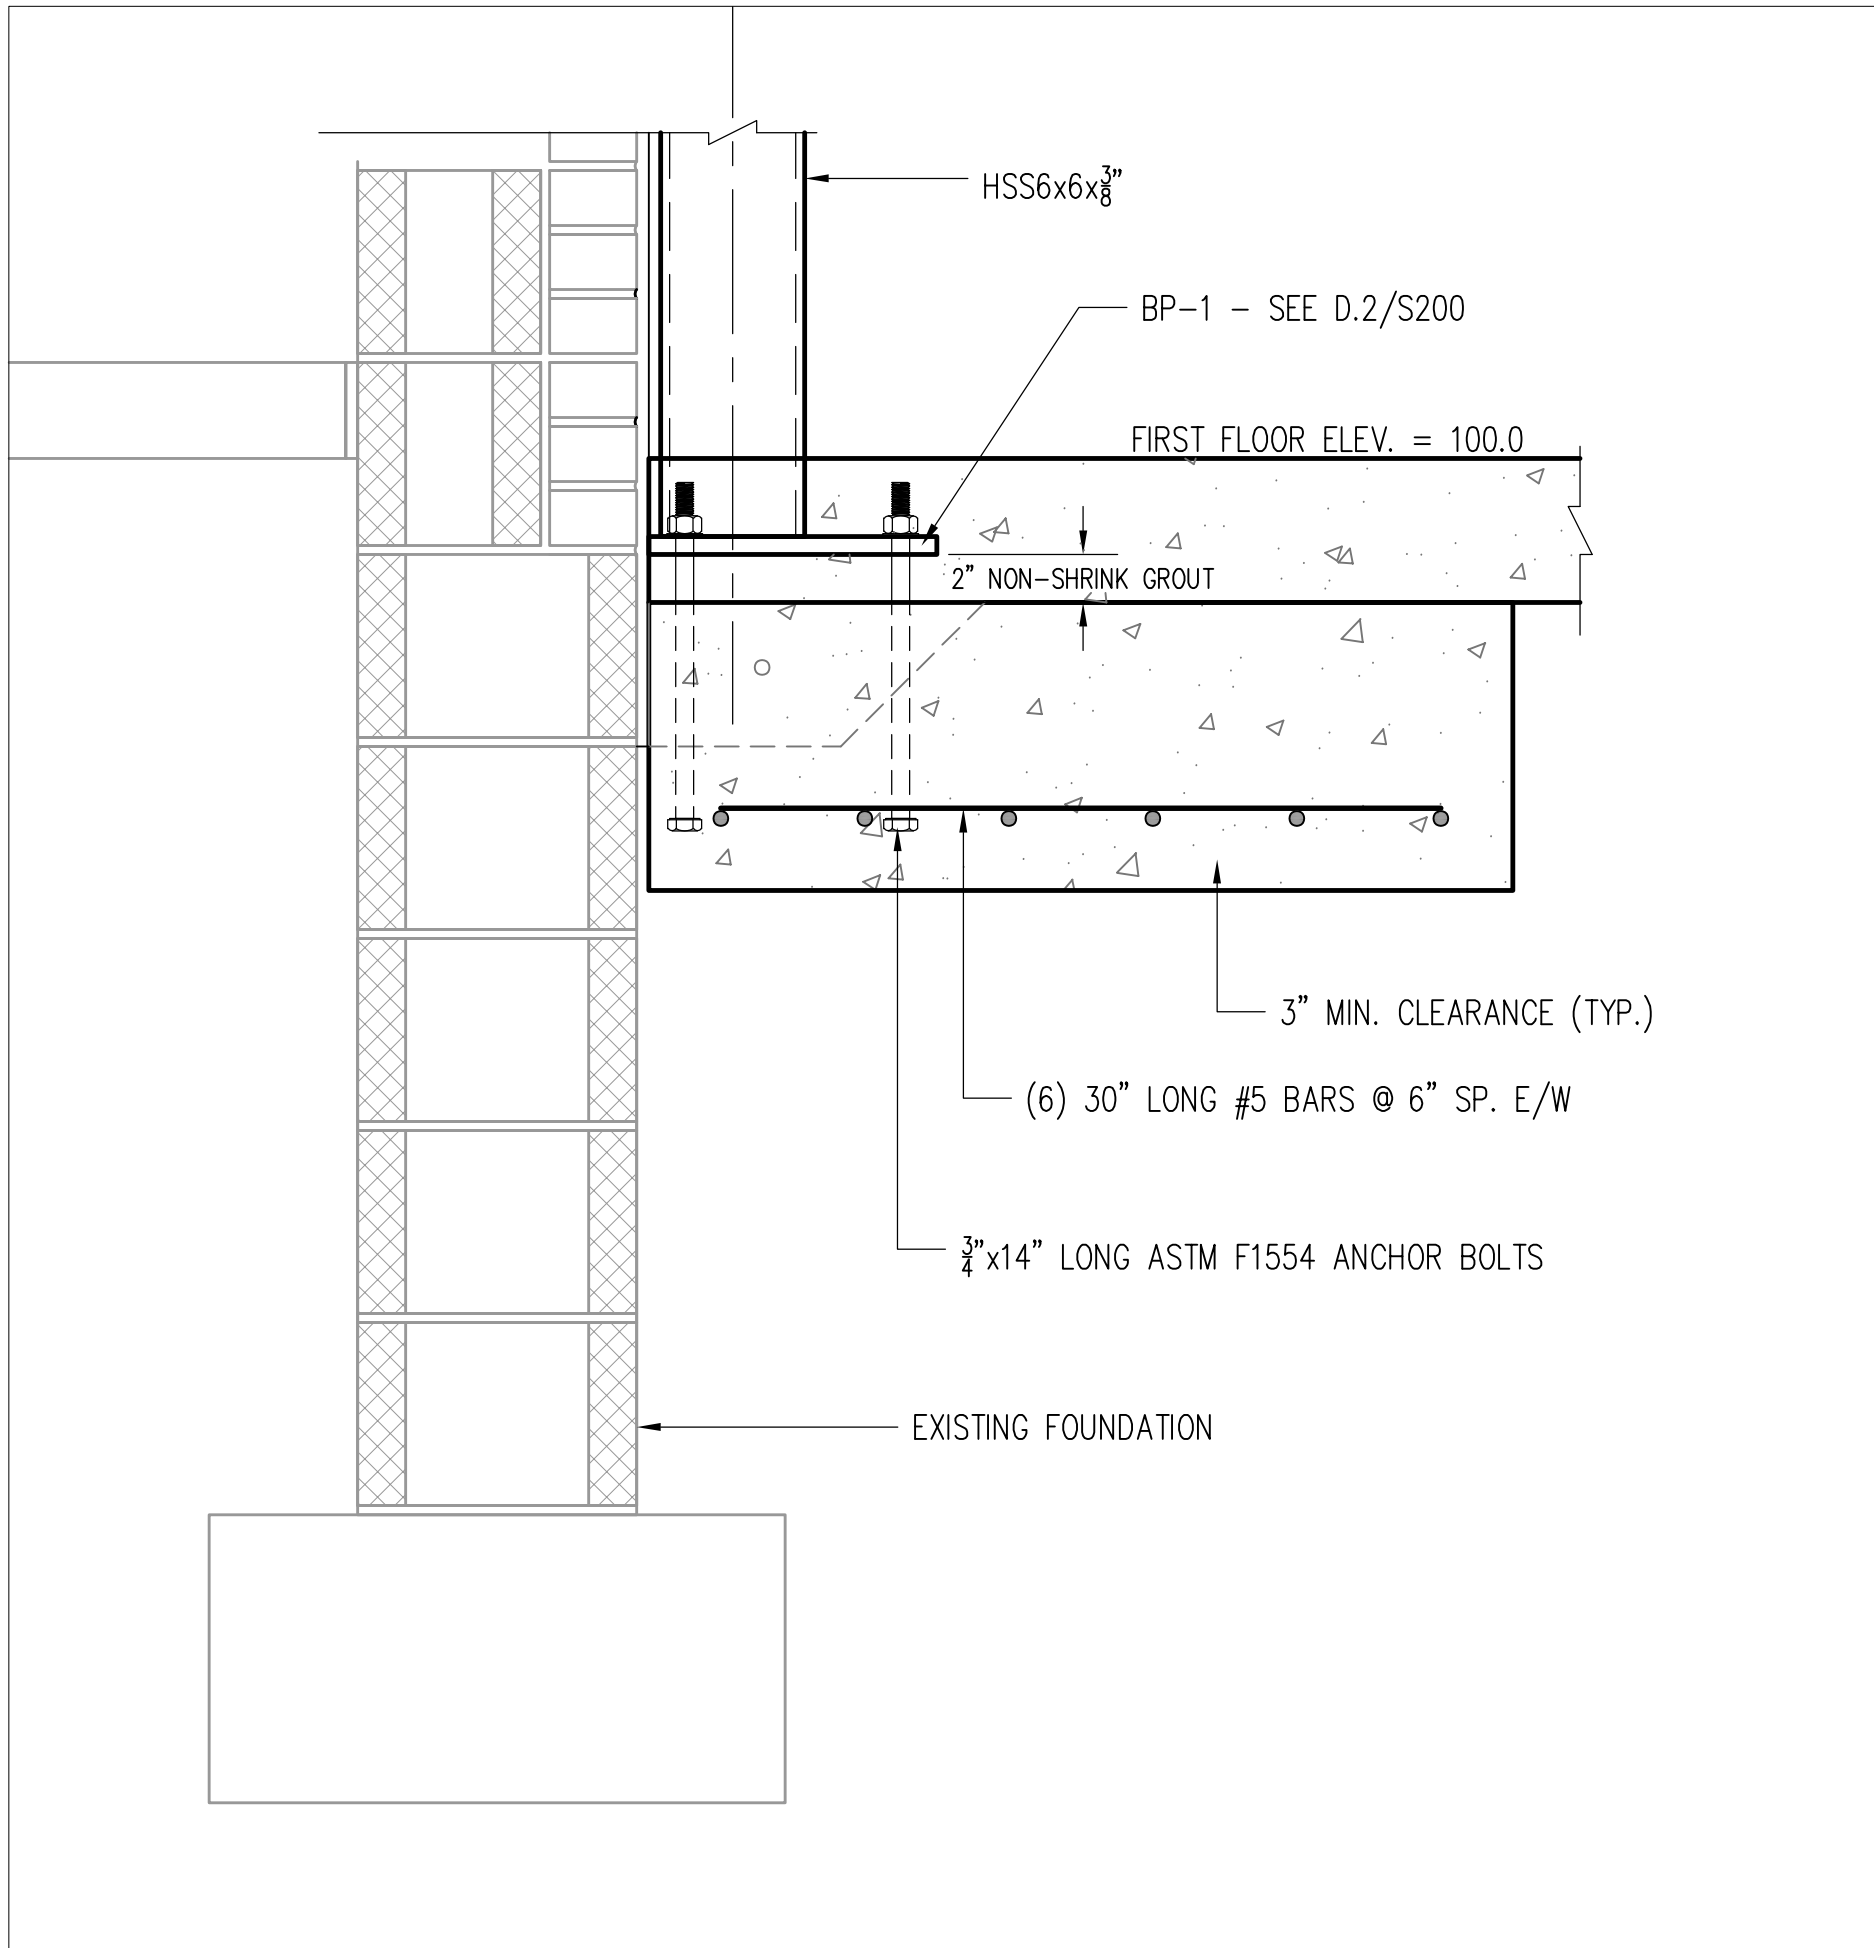

S.2 COLUMN - TO - FOOTING DETAIL
S200 SCALE: 1-1/2" = 1'-0"

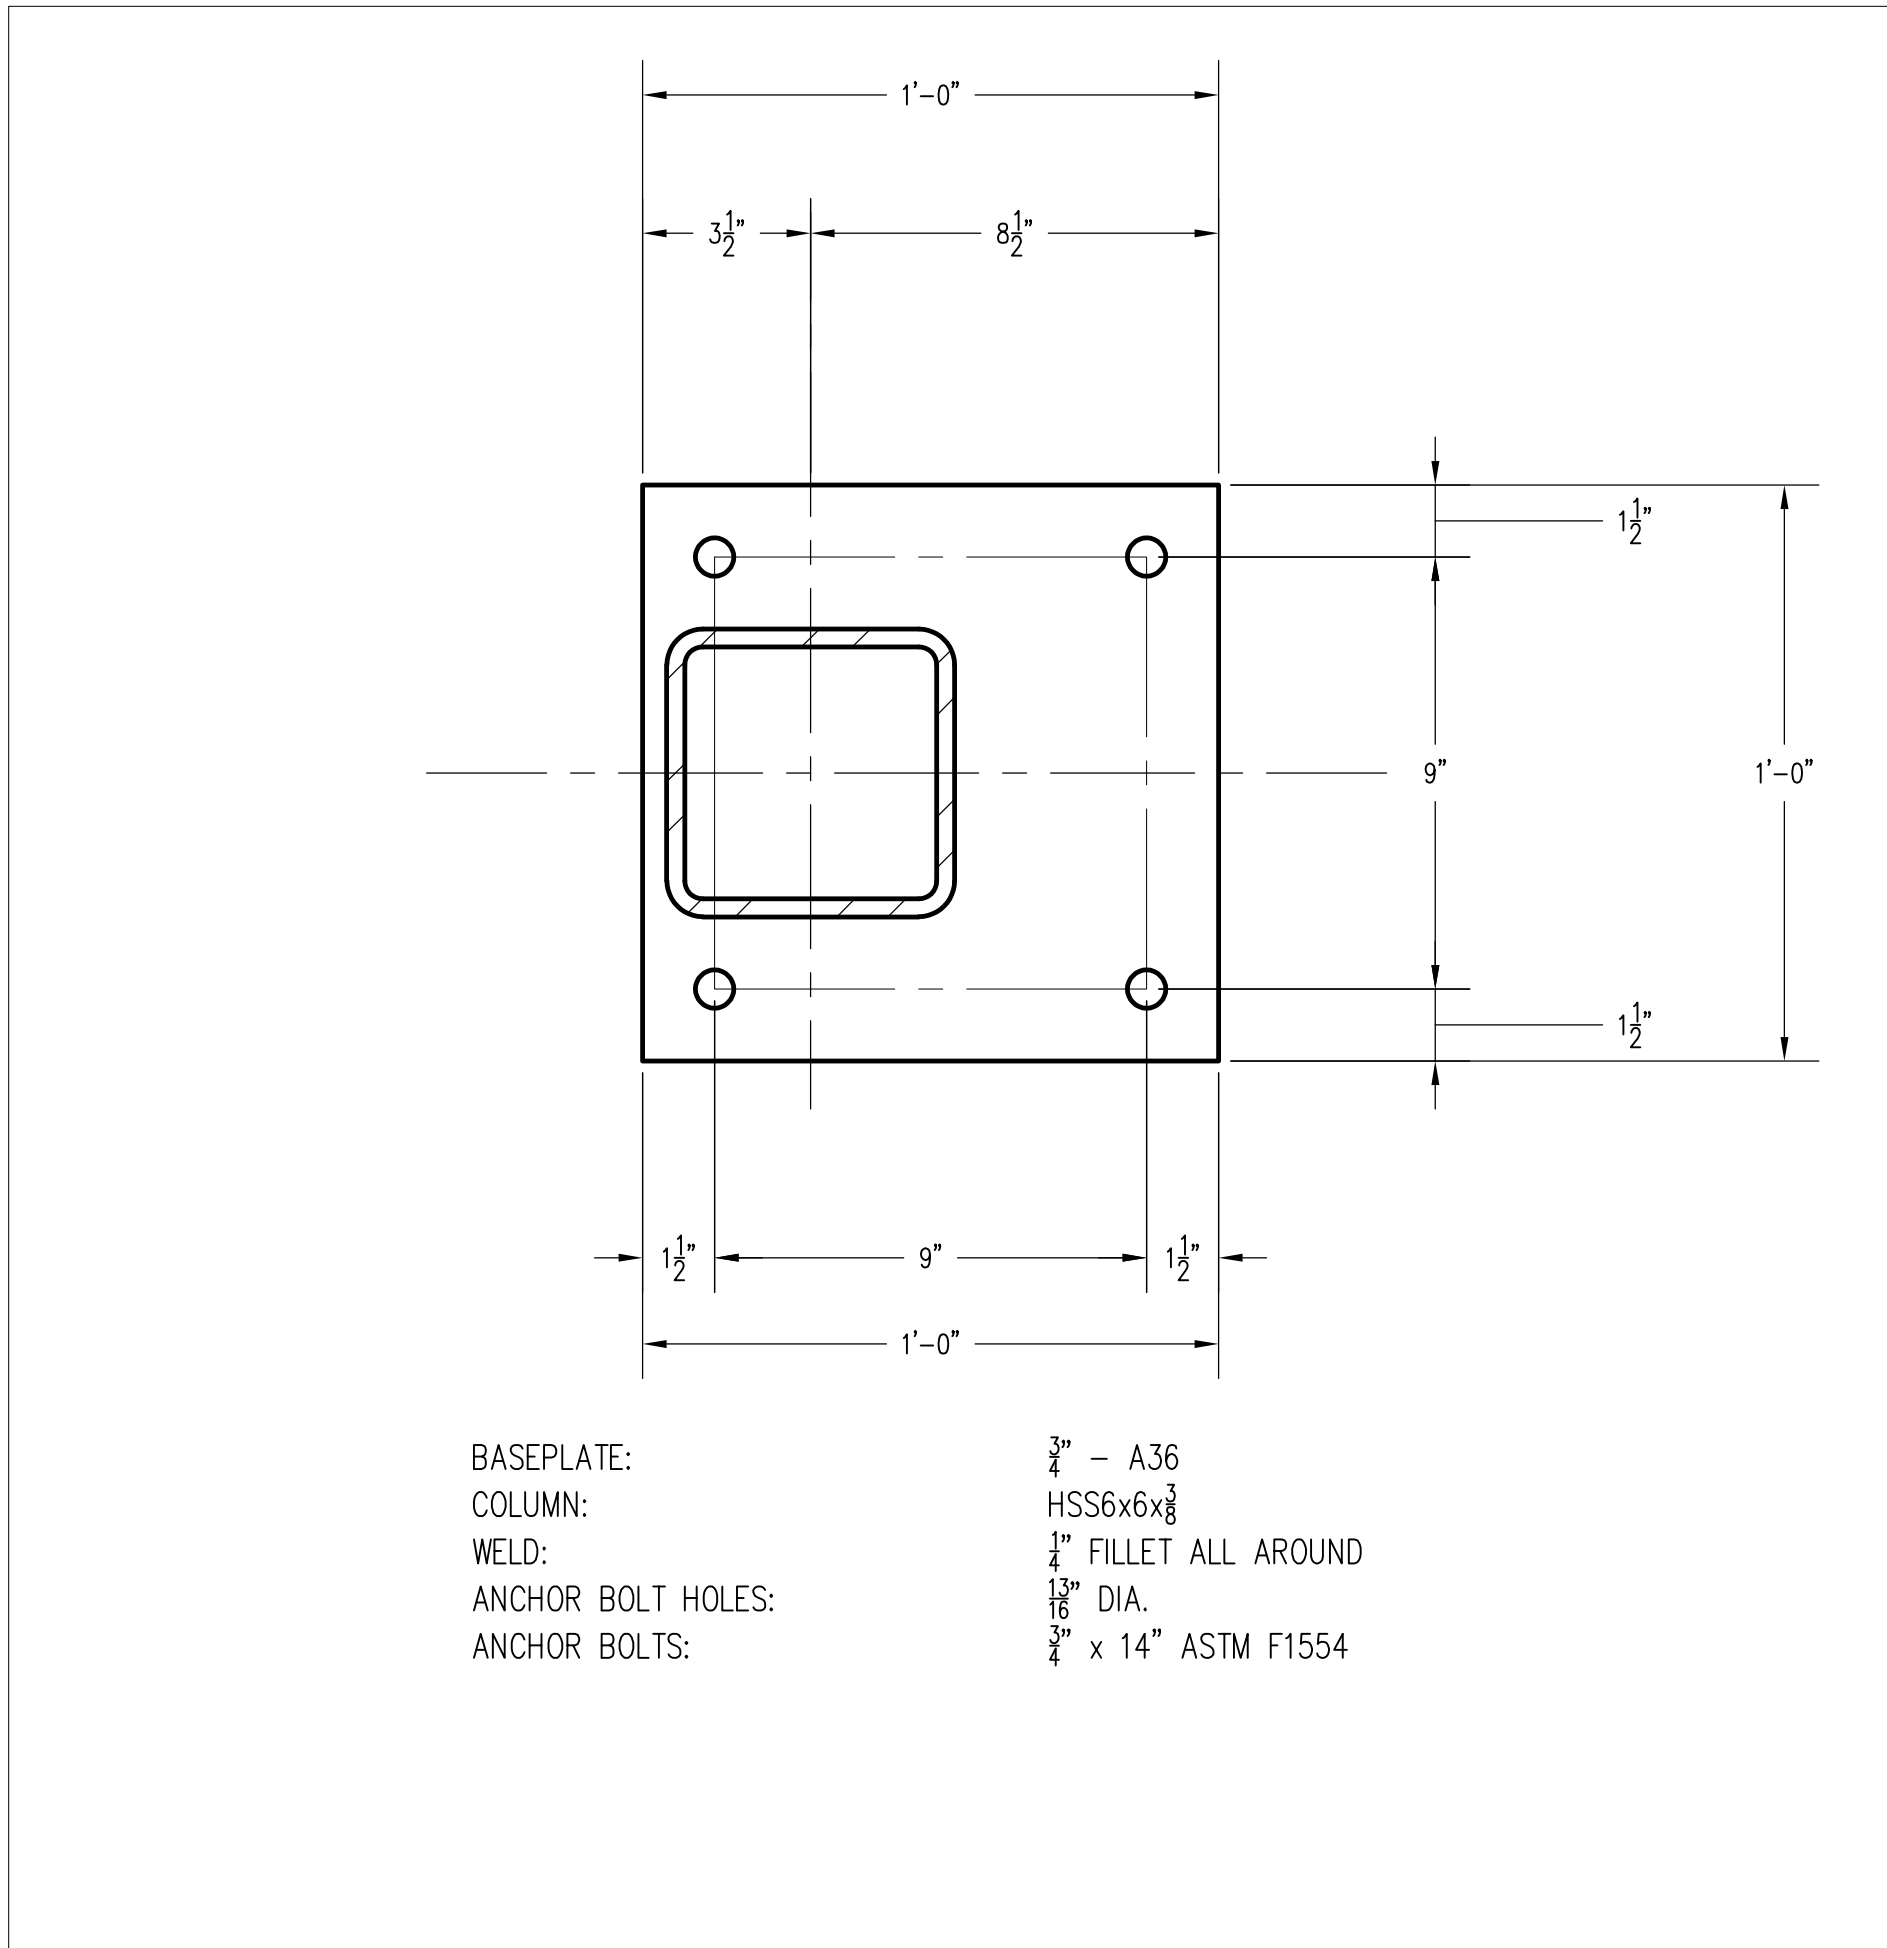

D.2 BP-1 BASEPLATE DETAIL
S200 SCALE: 3" = 1'-0"

- FRAMING NOTES:
- ALL TOP OF STEEL ELEVATIONS SHOWN ON THE FRAMING PLANS.
 - DENOTES SPAN OF 1-1/2" TYPE B, 22 GA. DECK.
 - ALL DECKING TO BE INSTALLED WITH HILTI X-HSN 24 PAF USING A 3/8" CONNECTION PATTERN TO ROOF FRAMING OR OTHER SUPPORTS WITH #10 SIDELAP SCREWS. THERE SHALL BE A MIN. OF 2" OF DECK END BEARING LENGTH.
 - ALL WIDE FLANGE BEAMS SHALL BE ASTM-A572 OR ASTM A992 GRADE 50 (50 KSI).
 - PROVIDE FRAME AROUND ALL OPENINGS LARGER THAN 8".
 - THE GC/CM SHALL COORDINATE ALL OPENINGS WITH ARCHITECTURAL, MECHANICAL, ELECTRICAL AND PLUMBING DRAWINGS AND TYPICAL DETAILS.
 - REFER TO ARCHITECTURAL DRAWINGS FOR DIMENSIONS NOT SHOWN.
 - SEE TYPICAL DETAILS FOR INFORMATION NOT REFERENCED ON PLANS.
 - REFER TO GENERAL NOTES FOR ADDITIONAL INFORMATION.

IT IS A VIOLATION OF NEW YORK STATE EDUCATION LAW FOR ANY PERSONS TO ALTER THESE PLANS, SPECIFICATIONS, OR REPORTS IN ANY WAY, UNLESS ACTING UNDER THE DIRECTION OF A LICENSED PROFESSIONAL ENGINEER OR LAND SURVEYOR.

Mark A. Day, PE	
Revisions	
Project No.	JOB No. License No. 069646
DAY STOKOSA ENGINEERING P.C.	
3 Van Wyck Lane Suite 2 Wappingers Falls, New York (845)-223-3202	
PROJECT Peekskill Firehouse Kitchen Incubator 701 Washington Street City of Peekskill Westchester County, New York	
DRAWING Roof Framing Plan	
SCALE As Noted	DRAWN BY MAD
DATE 06-12-24	CHECKED BY MAD
S201	