



WC-1
STORAGE / TELE ROOM 08

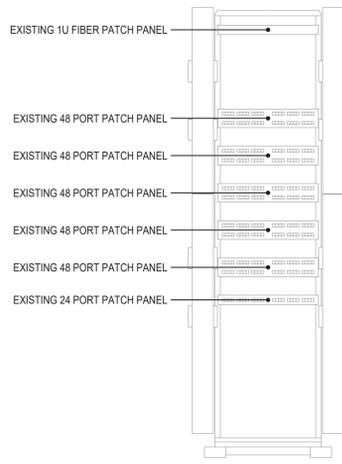


WC-1A
STORAGE / TELE ROOM 08

1 EXISTING DATA RACK LAYOUT
SCALE: NONE

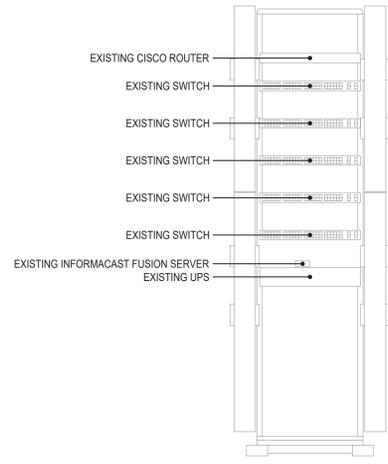

WC-1
STORAGE / TELE ROOM 08

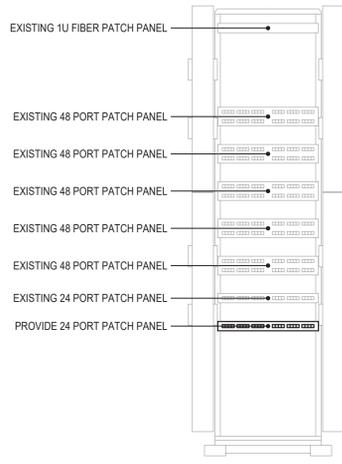

WC-1A
STORAGE / TELE ROOM 08

2 NEW DATA RACK LAYOUT
SCALE: NONE

GENERAL

- (X) REMOVAL NOTE
- (V) CABLING CONTRACT NOTE
- /// OFFSET FOR CLARITY

COMMUNICATIONS

- (D) DATA DROP BEING REMOVED
- (D) EXISTING DATA DROP
- (D) CAT 6 OR 6A DATA DROP
- (E) CONDUIT SLEEVE 1 1/2" UNLESS OTHERWISE NOTED
- (DB) DATA BOX
- (DH) FLOOR MOUNTED DOG HOUSE BOX
- (F) VERTICAL SECTION OF RACEWAY HORIZONTAL SECTION OF RACEWAY REFER TO DETAILS FOR TYPES REQUIRED
- (WAP-1) WIRELESS ACCESS POINT WAP-1 = CEILING MOUNTED WAP-2 = WALL MOUNTED WAP-3 = WALL W/ EXTERIOR ANTENNA
- (4P) 4 POST DATA RACK
- (2P) 2 POST DATA RACK
- (W) WALL MOUNTED CABINET
- (S) PENDANT SPEAKER
- (PB) PUSH BUTTON
- (IC) INTERCOM
- (CR) CARD READER

SECURITY

- (E) EXTERIOR MULTISENSOR IP CAMERA WITH CORNER MOUNT
- (I) INTERIOR MULTISENSOR IP CAMERA
- (E/I) INTERIOR / EXTERIOR MULTISENSOR IP CAMERA
- (IC) INTERIOR CAMERA
- (EC) EXTERIOR CAMERA

GENERAL NOTES - REMOVALS

- A. ALL EQUIPMENT BEING REMOVED BY CABLING CONTRACTOR IS ASSUMED TO BE UNSALVAGEABLE AND IS TO BE PROPERLY DISPOSED OF BY CABLING CONTRACTOR. PRIOR TO REMOVALS, COORDINATE WITH OWNER FOR ANY EQUIPMENT OWNER MAY DESIRE TO BE TURNED OVER FOR THE OWNER USE.
- B. EVERY EFFORT HAS BEEN MADE TO INDICATE ALL DEVICES THAT ARE BEING REMOVED THROUGH EXISTING DRAWINGS AND FIELD OBSERVATIONS. HOWEVER THE CONTRACTOR IS TO VISIT THE SITE PRIOR TO BIDDING AND VERIFY ALL REMOVALS. SOME DIFFERENCES MAY OCCUR.
- C. REMOVAL ALL CABLING SUPPORT SYSTEMS FOR CURRENT CABLING. ALL J-HOOKS D-RINGS AND SIMILAR EQUIPMENT SHALL BE REMOVED FROM THE STRUCTURE AND ABOVE ALL CEILINGS. ALL NEW WILL BE PROVIDED FOR NEW CABLING.
- D. ALL CABLING FROM DEVICES BEING REMOVED MUST BE REMOVED BACK TO POINT OF ORIGIN. NO CABLES CAN BE ABANDON IN THE CEILING SPACE PER INTERNATIONAL FIRE CODE SECTION 315.6. UNLESS PHYSICALLY UNABLE TO BE REMOVED DUE TO FIELD CONDITIONS THAT PROHIBIT WORKING IN AN AREA WHERE THE CABLE IS ROUTED. IN THIS CASE, REMOVE CABLE FROM BOTH SIDES OF THE PROHIBITED AREA AND BACK TO POINT OF ORIGIN.

SPECIAL NOTES - REMOVALS

- 1. FOR ALL HARDWARE BEING REMOVED BY THIS CONTRACTOR, THIS CONTRACTOR SHALL RECORD ON A SPREADSHEET THE FOLLOWING: SERIAL NUMBER OF DEVICE AND THE ASSET TAG OF THE DEVICE. THIS DOCUMENT SHALL BE SUBMITTED AS PART OF THE CLOSEOUT DOCUMENTS. THIS IS A DISTRICT REQUIREMENT FOR THE DISPOSAL OF ALL EQUIPMENT AND REMOVAL FROM INVENTORY.

GENERAL NOTES - COMMUNICATIONS


- A. PROVIDE ALL CATEGORY 6, 6A AND FIBER OPTIC CABLE TERMINATIONS AND TESTING.
- B. "DATA DROP" OR "DATA OUTLET" INCLUDES CATEGORY 6 & 6A CABLE, TERMINATION HARDWARE, RACEWAY, CABLE TERMINATION AND CABLE TESTING.
- C. PROVIDE ONE GREEN CATEGORY 6A CABLE FOR ALL ACCESS POINTS.
- D. PROVIDE A ORANGE CATEGORY 6 CABLE FOR ALL NEW IP CAMERAS.
- E. PROVIDE CONDUIT SLEEVES THROUGH ALL WALLS. CONDUIT SLEEVES SHALL BE A MINIMUM OF 1-1/2". PROVIDE OTHER SIZES AS NOTED ON PLANS.
- F. PROVIDE RE-PENETRATABLE FIRE STOPPING AROUND ALL SLEEVES AND INSIDE SLEEVE AFTER CABLE IS INSTALLED.
- G. WHEN SIZES ARE NOT NOTED OR SLEEVES ARE NOT SHOWN BUT REQUIRED FOR THE INSTALLATION SLEEVES SHALL BE SIZED AS FOLLOWS.

CABLE	1"	1.25"	1.5"	2"	2.5"	3"	3.5"	4"
Cat 6A	4	7	10	18	24	41	56	73
CAT 6	7	9	14	24	28	55	75	98


- H. PROVIDE LADDER RACK WITH WATERFALLS ABOVE ALL NEW CABLE RACKS.
- I. PROVIDE HORIZONTAL WIRE MANAGEMENT BELOW ALL NEW PATCH PANELS.
- J. EXACT LOCATION OF CABLES FOR WIRELESS ACCESS POINTS SHALL BE VERIFIED DURING A BUILDING WALK THROUGH PRIOR TO BEGINNING INSTALLATION.
- K. TEST ALL EXISTING FIBER OPTIC CABLES THAT ARE SCHEDULED TO BE USED ON THE NEW 10GB BACKBONE. PROVIDE TEST RESULTS INCLUDING CABLE LENGTHS.
- L. PROVIDE CABLE HANGERS FOR ALL UTP CABLE AND FIBER RUNS ON THE PROJECT. HANGERS FOR MAIN RUNS SHALL BE A MINIMUM OF 2". CABLE HANGERS FOR CABLE RUNS FROM MAIN RUNS TO THE STATION OUTLET SHALL BE A MINIMUM OF 3/4". INSTALL CABLE HANGERS FOUR FOOT ON CENTER FOR THE ENTIRE LENGTH OF RUN. SEE DETAIL 2 ON EW 603.
- M. PROVIDE SURFACE RACEWAY FOR A CABLE LOCATED IN FINISHED SPACE. PROVIDE CONDUIT FOR CABLES INSTALLED IN MECHANICAL AND UTILITY SPACES. PROVIDE OPEN TOP CABLE HANGERS FOR CABLE INSTALLED ABOVE FINISHED CEILINGS.
- N. PROVIDE ADHESIVE LABEL ON ALL BOXES.
- O. CABLES SHALL CONFORM TO THE FOLLOWING COLOR SCHEME
 1. DATA - BLUE
 2. WIRELESS ACCESS POINTS - GREEN
 3. SECURITY CAMERAS AND CONTROLLERS - ORANGE
 4. VOIP and IP SPEAKER - YELLOW
 5. FIRE ALARM - RED
- P. COORDINATE DATA RACK ELEVATIONS AND LAYOUTS WITH THE NETWORK HARDWARE CONTRACTOR AND THE OWNERS IT STAFF. ELEVATIONS SHOWN ON PLANS ARE APPROXIMATE. OBTAIN THE ENGINEERS AND OWNERS APPROVAL PRIOR TO INSTALLING PATCH PANELS.
- Q. GROUND ALL NEW EQUIPMENT RACKS.
- R. INSTALL WALL AND CEILING MOUNTED ACCESS POINTS FURNISHED BY THE NETWORK HARDWARE/WIRELESS CONTRACTOR.
- S. INSTALL EXTERIOR ANTENNAS FURNISHED BY NETWORK HARDWARE/WIRELESS CONTRACTOR. CORE WALLS AND SEAL OPENINGS AFTER ANTENNAS ARE INSTALLED AND TESTED. INSTALL SURGE PROTECTOR AND GROUND TO BUILDING STEEL.
- T. INSTALL LEXAN BOXES FURNISHED BY THE NETWORK HARDWARE/WIRELESS CONTRACTOR IN ALL GYMNASIUMS.
- U. REPAIR AND PAINT ALL FINISHED WALLS, FLOORS ETC. DAMAGED DURING INSTALLATION.
- V. PROVIDE NEW CEILING TILES MATCHING THE EXISTING IF DAMAGED DURING THE INSTALLATION. PRIOR TO BEGINNING WORK NOTIFY THE OWNER OF ALL EXISTING DAMAGED TILES IN THE WORK AREA. IF EXISTING DAMAGED TILES ARE NOT NOTED THE CABLING CONTRACTOR WILL BE RESPONSIBLE FOR REPLACEMENT.
- W. DISCONNECT AND REMOVE ALL EXISTING CABLES THAT ARE ABANDONED AS PART OF THE COMMUNICATION SYSTEM UPGRADE.
- X. PROVIDE TEST REPORTS AND AS BUILT DRAWINGS AT THE COMPLETION OF WORK PRIOR TO PROJECT CLOSE OUT.

ABBREVIATIONS

A	AMPERE
AC	ABOVE COUNTER
AFF	ABOVE FINISHED FLOOR
AFG	ABOVE FINISHED GRADE
AFCI	ARC FAULT CIRCUIT INTERRUPTER
AIC	AMPERES INTERRUPTING CAPACITY
AL	ALUMINUM
ASYM	ASYMMETRICAL
AUX	AUXILIARY CONTACTS
AV	AUDIO/VIDEO
AWG	AMERICAN WIRE GAUGE
BD	BUS DUCT
BR	BRANCH
C	CONDUIT
CB	CIRCUIT BREAKER
CD	CANDELA
CH	CABINET HEATER
CKT	CIRCUIT
CT	CURRENT TRANSFORMER
CU	COPPER
CATV	CABLE TELEVISION
CCTV	CLOSED CIRCUIT TELEVISION
CLG	CEILING
CONT	CONTRACTOR
CP	CONTROL PANEL
DC	DIRECT CURRENT
Δ	DELTA CONNECTED
DISC	DISCONNECT
DP	DRINKING FOUNTAIN
DPS1	DOUBLE POLE, SINGLE THROW
DPDT	DOUBLE POLE, DOUBLE THROW
EBB	ELECTRIC BASEBOARD
ECC	ELECTRICAL CONTRACTOR
EGS	EQUIPMENT GROUND
EGC	EQUIPMENT GROUND CONDUCTOR
EM	EMERGENCY
EP	EXPLSION PROOF
EPR	ETHYLENE PROPYLENE RUBBER
EQUIP	EQUIPMENT
EXR	EXISTING TO REMAIN
EXRL	EXISTING TO BE RELOCATED
EXIST	EXISTING
EXST	EXISTING
EXP	EXPLSION PROOF
ELECT	ELECTRIC
EMT	ELECTRIC METALLIC TUBING
FA	FIRE ALARM
FACP	FIRE ALARM CONTROL PANEL
FARAP	FIRE ALARM REMOTE ANNUNCIATOR PANEL
FBO	FURNISHED BY OWNER
FOOTCANDLE	FOOTCANDLE
FCAN	FULL CAPACITY ABOVE NORMAL
FCBN	FULL CAPACITY BELOW NORMAL
FLA	FULL LOAD AMPERES
FLUOR	FLUORESCENT
FVNR	FULL VOLTAGE, NON-REVERSING
FVR	FULL VOLTAGE, REVERSING
G	GUARD
GC	GENERAL CONTRACTOR
GEN	GENERATOR
GF	GROUND FAULT
GFI	GROUND FAULT CIRCUIT INTERRUPTER
GFP	GROUND FAULT PROTECTION
GND	GROUND
GRS	GALVANIZED RIGID STEEL
H	HOSPITAL GRADE
HOA	HAND-OFF-AUTOMATIC
HP	HORSEPOWER
HPS	HIGH PRESSURE SODIUM
HV	HIGH VOLTAGE
HZ	HERTZ
IC	INTERCOM
IG	ISOLATED GROUND
INCAD	INCANDESCENT
IMC	INTERMEDIATE METAL CONDUIT
JB	JUNCTION BOX
KAIC	THOUSAND AMPERE INTERRUPTING CAPACITY
KV	KILOVOLT
KVA	KILOVOLT-AMPERE
KW	KILOWATT
K	KILO (THOUSAND)
KCM	THOUSAND CIRCULAR MILS
KCMIL	THOUSAND CIRCULAR MILS
LTG	LIGHTING
LSIG	LONG TIME-SHORT TIME-INSTANTANEOUS-GROUND FAULT
LV	LOW VOLTAGE
M	MEGA (MILLION)
MATV	MASTER ANTENNA TELEVISION
MFS	MAIN FUSED SWITCH
MC	MECHANICAL CONTRACTOR
MCB	MAIN CIRCUIT BREAKER
MCC	MOTOR CONTROL CENTER
MH	METAL HALIDE
MLO	MARK LUSSE ONLY
MM	MULTI MODE FIBER
MV	MEDIUM VOLTAGE
MVA	MEGAVOLT-AMPERE
NEC	NATIONAL ELECTRICAL CODE
NC	NORMALLY CLOSED
NO	NORMALLY OPEN
NL	NIGHT LIGHT
N	NEUTRAL
NF	NONFUSED
NIC	NOT IN CONTRACT
N/S	NOT TO SCALE
OCPD	OVER CURRENT PROTECTION DEVICE
OH	OVERHEAD
OL	OVERLOAD
PB	PULLBOX
PC	PLUMBING CONTRACTOR
PF	POWER FACTOR
PH	PANEL
PT	POTENTIAL TRANSFORMER
PVC	POLYVINYL CHLORIDE
Ø	PHASE
PH	PHASE
P	POLE
PL	PILOT LIGHT
PM	PLUG/MOLD
PP	POWER PANEL
PWR	POWER
RVNR	REDUCED VOLTAGE, NON-REVERSING
RM	ROOM
RMS	ROOT MEAN SQUARED
RTU	ROOF TOP UNIT
SM	SINGLE MODE FIBER
SS	SURGE SUPPRESSION
SST	SOLID-STATE TRIP DEVICE
ST	SHUNT-TRIP
SW	SWITCH
SWBD	SWITCHBOARD
SYM	SYMMETRICAL
T	TAMPER RESISTANT
TDR	TIME DELAY RELAY
TYP	TYPICAL
TCP	TEMPERATURE CONTROL PANEL
TSTAT	THERMOSTAT
TV	TELEVISION
UG	UNDERGROUND
UH	UNIT HEATER
USB	UNIVERSAL SERIAL BUS
V	VOLT
VR	VOLT-AMPERE
V	VAPORPROOF
W	WATT
WG	WIRE GUARD
WM	WIREMOLD
WP	WEATHERPROOF
XFMR	TRANSFORMER
XP	CROSS LINKED POLYETHYLENE
XP	EXPLSION PROOF
Y	WYE CONNECTED

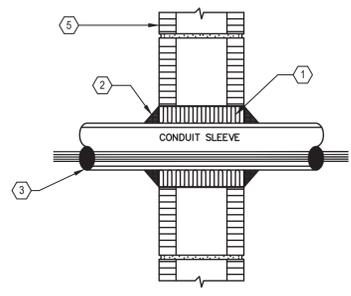


MASONRY WALL

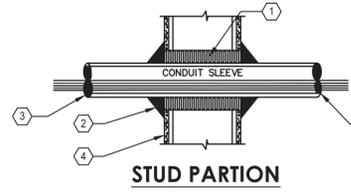

STUD PARTION

- 1 1/2- TO 5/8-IN SPACE, PACK WITH FS CEREBLANKET PER SPECIFICATIONS.
- 2 SEAL ALL OPENING WITH FLAME STOP V PER SPECIFICATIONS.
- 3 FOR EXISTING PENETRATIONS CONTRACTOR IS TO REMOVE THE EXISTING FIRESTOPPING MATERIAL TO INSTALL NEW CABLING AND REINSTALL FIRE STOP V PER THE SPECIFICATION AFTER ALL WORK IS COMPLETED.
- 4 PARTITION WITH WOOD OR METAL STUDS AND GYPSUMBOARD OR PLASTERBOARD BOTH SIDES.
- 5 CONCRETE BLOCK OR POURED CONCRETE WALLS.
- 6 CONCRETE FLOOR SLAB.

3 NEW AND EXISTING CONDUIT FIRE SLEEVE DETAIL
SCALE: NONE

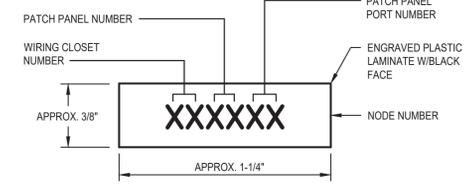

DATA DROP LEGEND PLATE

- NOTES:**
1. PROVIDE (1) LEGEND PLATE FOR EACH DATA CONNECTION.
 2. SECURELY MOUNT PLATE TO RACEWAY/POWER POLE WITH EPOXY STYLE ADHESIVE.
- GENERAL:**
- REFER TO SPEC. SECTION 270310, 1.19 IDENTIFICATION & NAMEPLATE PUNCH TAPE LABELS ARE NOT ACCEPTABLE TO OWNER

4 DATA DEVICE AND LEGEND PLATE DETAIL
SCALE: NONE

SED NUMBERS: Administration Building, 66-15-001-0009-013
 BEFORE WORK IS STARTED, CONTRACTOR SHALL VERIFY ALL THE DIMENSIONS AT THE SITE AND IMMEDIATELY NOTIFY THE ARCHITECT OF ALL DISCREPANCIES. ALTERATION OF THIS DOCUMENT BY OTHER THAN AN AUTHORIZED LICENSED REGISTERED ARCHITECT IS ILLEGAL AND A VIOLATION OF SECTION 7207 OF THE NEW YORK STATE EDUCATION LAW.

Drawing Title: **LEGEND AND GENERAL NOTES**
 Drawing Number: **T 001**

Date: 10/11/2024
 Drawn by: CNB

Revision: 02/01/2024



Alterations to Administration Building
 Peekskill City School District
 Peekskill, New York

MOSAIC ASSOCIATES
 Mosaic Associates Architects, PC
 The First Building, 2 Third Street, Suite 440, Troy, NY 12180

engineered solutions
 648 Plank Road #104
 Clifton Park, NY 12065
 Phone: (518) 280-2410
 Fax: (518) 280-2481
 www.esigned.com
 ES # 24088

REMOVAL NOTES: ○

1. REMOVE THE EXISTING CEILING OR WALL MOUNTED SPEAKER WITH BRACKET ALONG WITH ALL ASSOCIATED CABLING.
2. REMOVE THE EXISTING CEILING MOUNTED SECURITY CAMERA AND MOUNTING BRACKET. STORE THE CAMERA AND BRACKET IN INDIVIDUAL CARDBOARD BOX FOR REINSTALLATION BY SECURITY VENDOR IN NEW WORK.
3. COIL AND PROTECT THIS DATA CABLE IN CORRIDOR CEILING FOR REUSE IN NEW WORK.
4. REMOVE EXISTING VOICE CABLE BACK TO POINT OF ORIGIN.

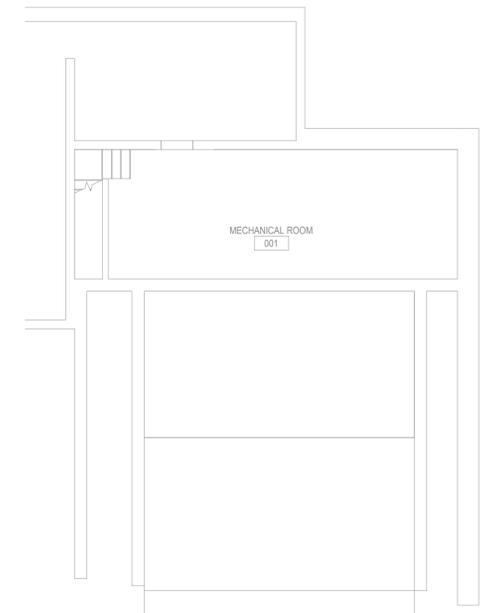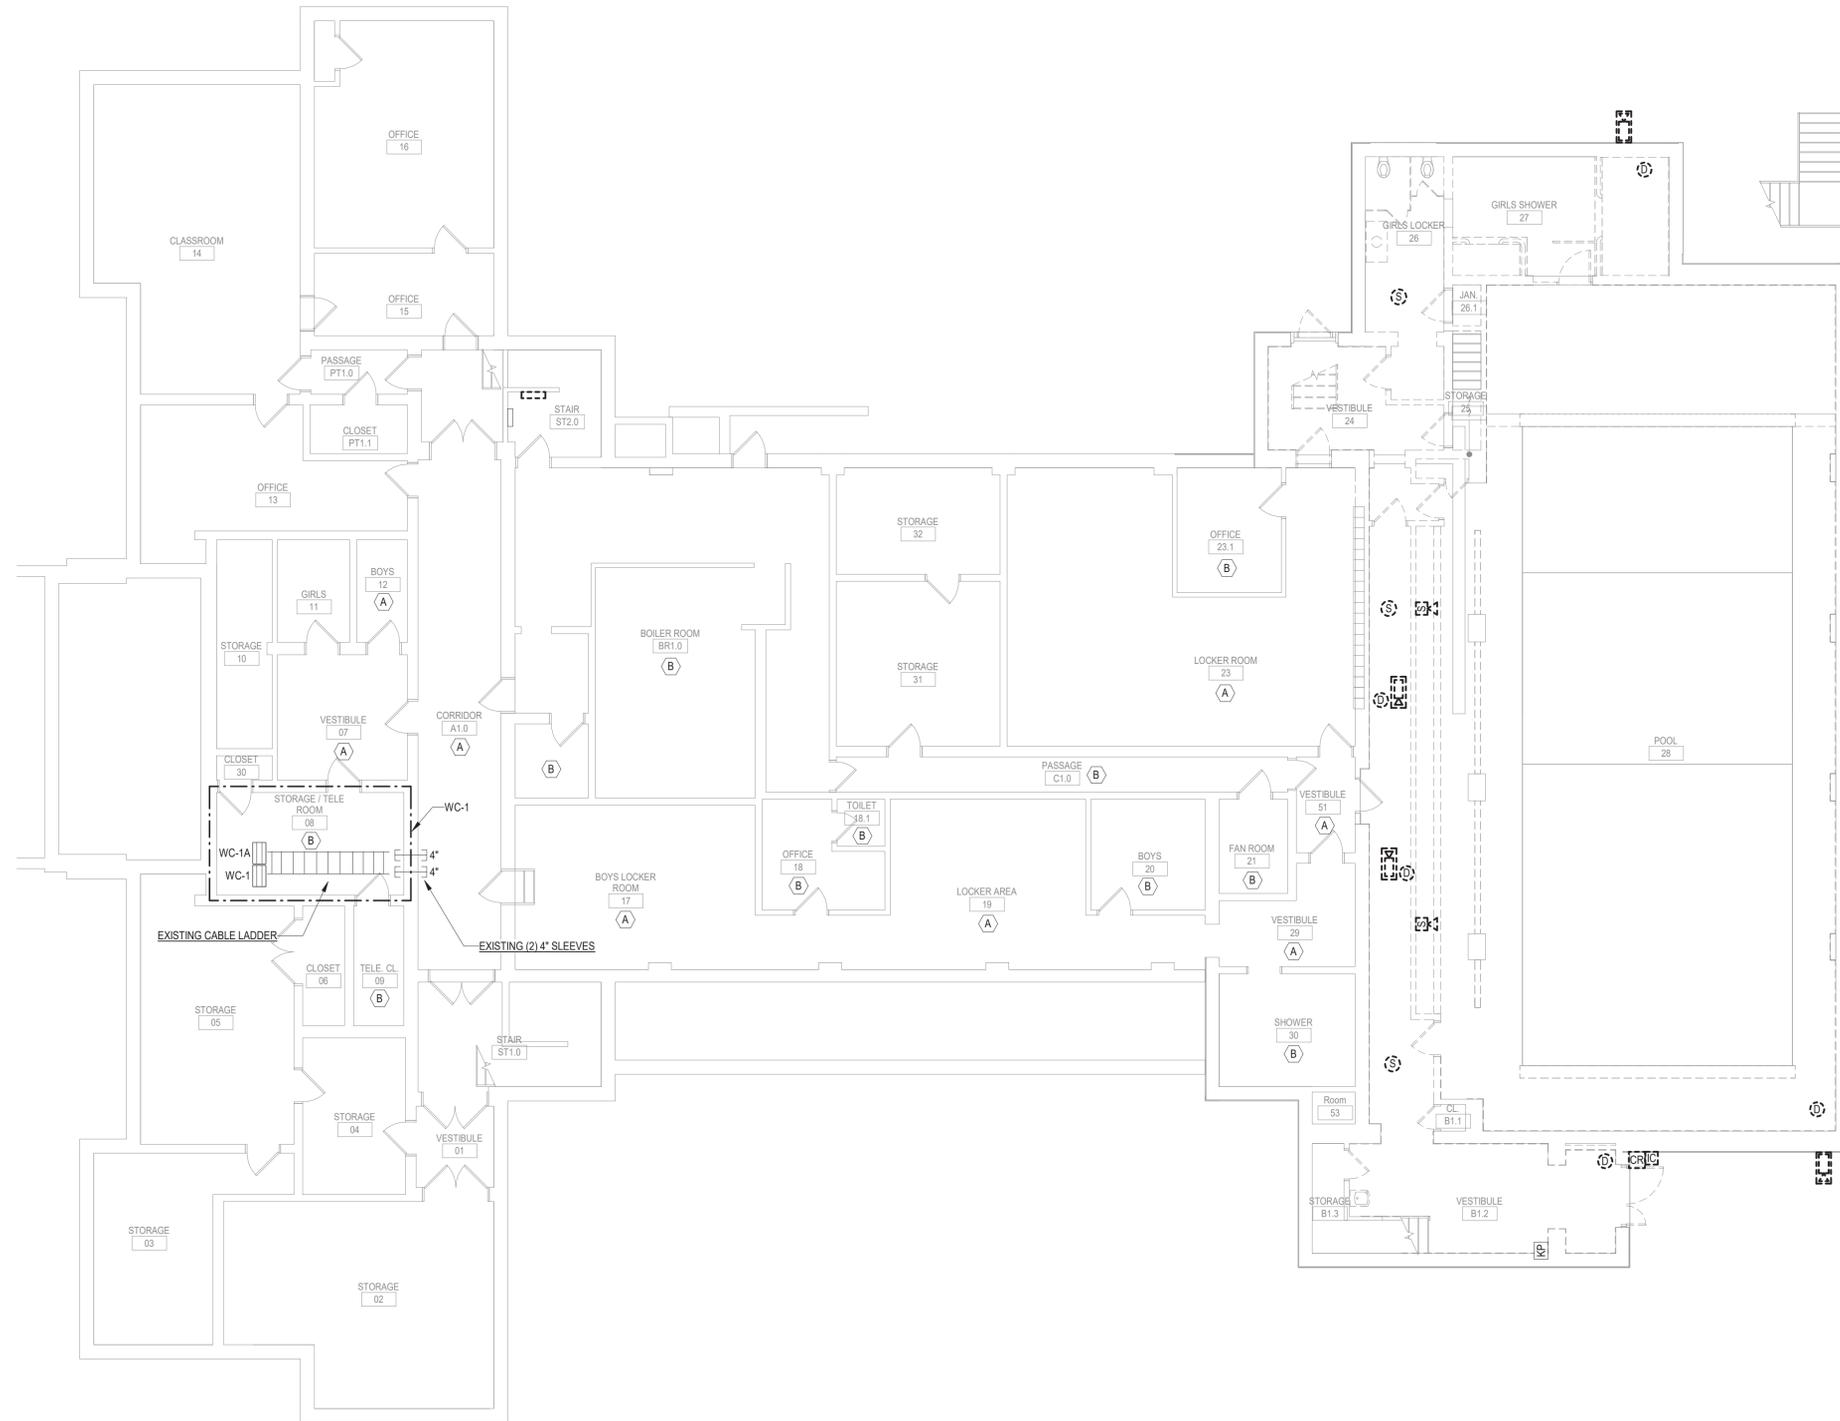

2 BASEMENT TECHNOLOGY REMOVAL PLAN
SCALE: 1/8" = 1'-0"

1 LOWER LEVEL TECHNOLOGY REMOVAL PLAN
SCALE: 1/8" = 1'-0"


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T
201
 Drawing Number:
 Drawing Title:
 Revision: 05/21/2024
 APN: 2226-2A Date: 10/11/2024 Drawn by: C.B.

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MOSAIC ASSOCIATES



1 LOWER LEVEL TECHNOLOGY PLAN
SCALE: 1/8" = 1'-0"


- DRAWING NOTES:**
- PROVIDE CEILING MOUNTED CAT 6A CABLE FOR WIRELESS ACCESS POINT. REFER TO DETAIL 4 ON DRAWING T601.
 - MOUNT OWNER SUPPLIED WIRELESS ACCESS POINT AND MOUNTING BRACKET. CONNECT WAP TO DATA DROP IN CEILING.
 - INSTALL OWNER SUPPLIED LED INTERACTIVE DISPLAY WITH MOUNTING BRACKET AS DIRECTED BY OWNER.
 - PROVIDE CAT 6 AND AVP CABLES IN DATA BOX BEHIND LED BOARD. AVP CABLES FROM WALL BOX WILL BE RUN FROM WALL BOX TO THIS LOCATION. REFER TO DETAIL 2 AND DETAIL 7 ON DRAWING T601.
 - PROVIDE CAT 6 CABLE AND AVP-1 CABLES IN THIS LOCATION. REFER TO DETAIL 2 AND DETAIL 8 ON DRAWING T601.
 - PROVIDE CAT 6 CABLE IN DATA BOX PROVIDED BY E.C. REFER TO DETAIL 3 AND DETAIL 5 ON DRAWING T601.
 - PROVIDE CEILING MOUNTED CAT 6 CABLE FOR SECURITY CAMERA. REFER TO DETAIL 4 ON DRAWING T601.
 - PROVIDE SURGE PROTECTION DEVICE ON THIS DATA DROP. REFER TO DETAIL 1 ON DRAWING T601.

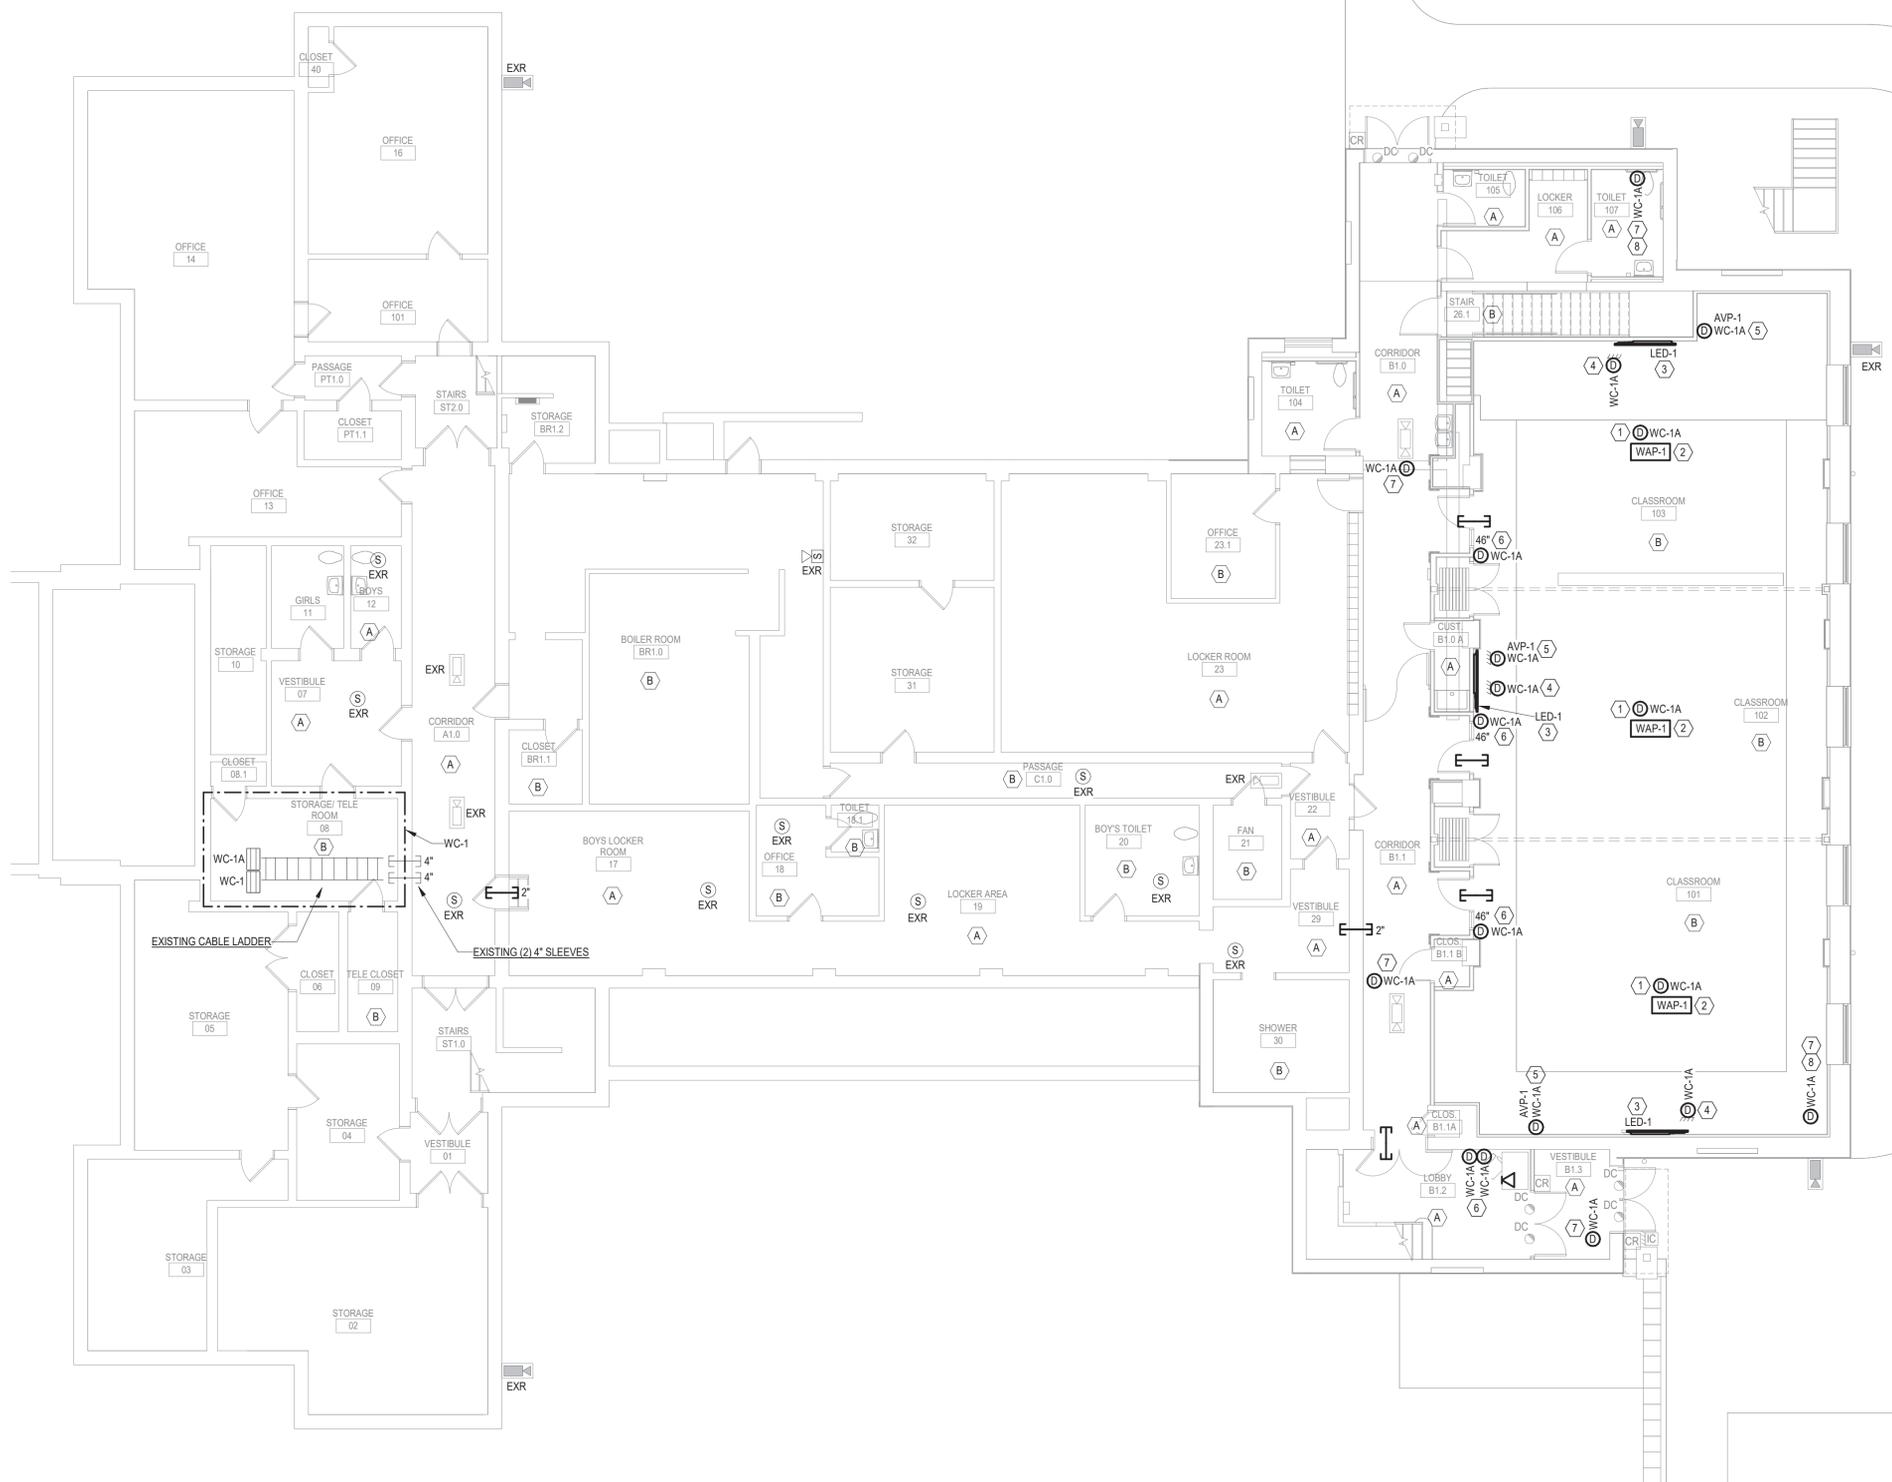CEILING SCHEDULE

DESIGNATION	DESCRIPTION
(A)	ACCESSIBLE CEILING (DROP CEILING)
(B)	INACCESSIBLE CEILING (HARD CEILING)
(C)	EXPOSED STRUCTURE
(D)	SPLINE CEILING (1X1 TILES)

CABLE SCHEDULE

CABLE TYPE	CABLE AND JACK COLOR	APPLICATION
CAT 6	BLUE	DATA
CAT 6	GREEN	SECURITY/DOOR ACCESS
CAT 6	YELLOW	VOIP PHONE AND SPEAKERS
CAT 6A	YELLOW	ALL WIRELESS ACCESS POINTS

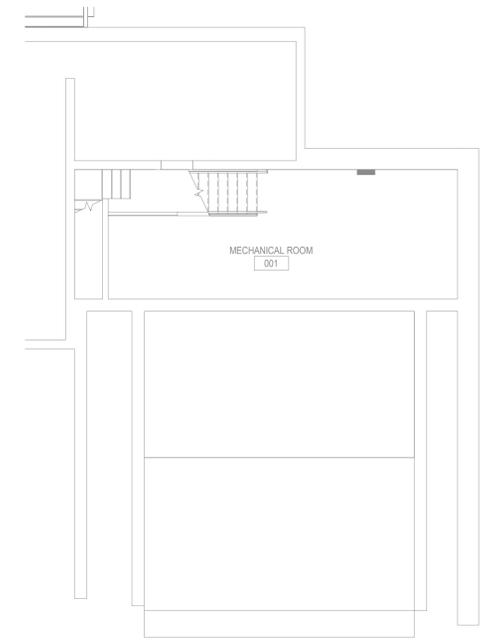

2 BASEMENT TECHNOLOGY PLAN
SCALE: 1/8" = 1'-0"

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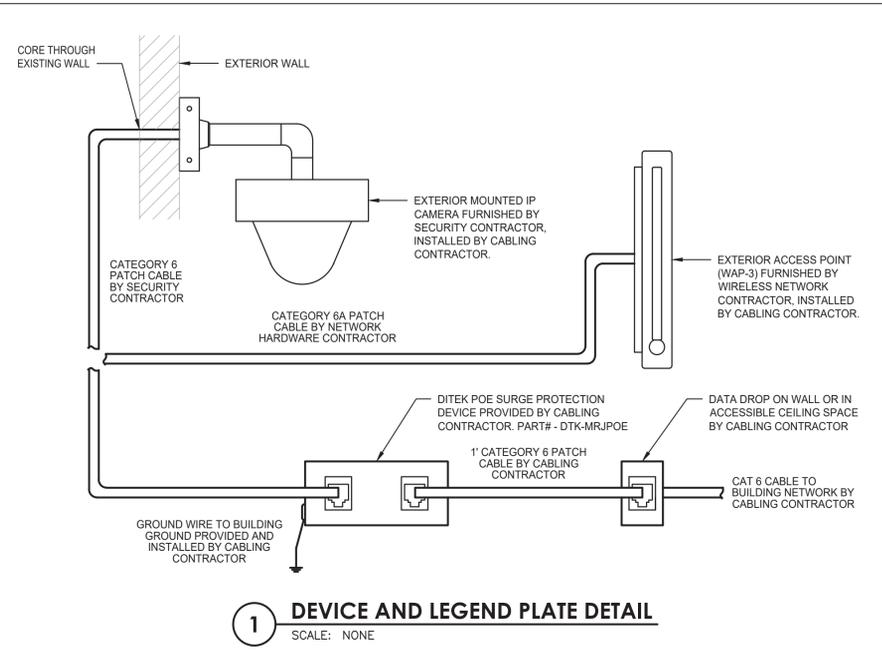
Drawing Title: **BASEMENT & LOWER LEVEL TECHNOLOGY PLAN**
 Drawing Number: **T 301**

Consultant: **engineered solutions**
 646 Plank Road #104
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 Phone: (518) 280-2410
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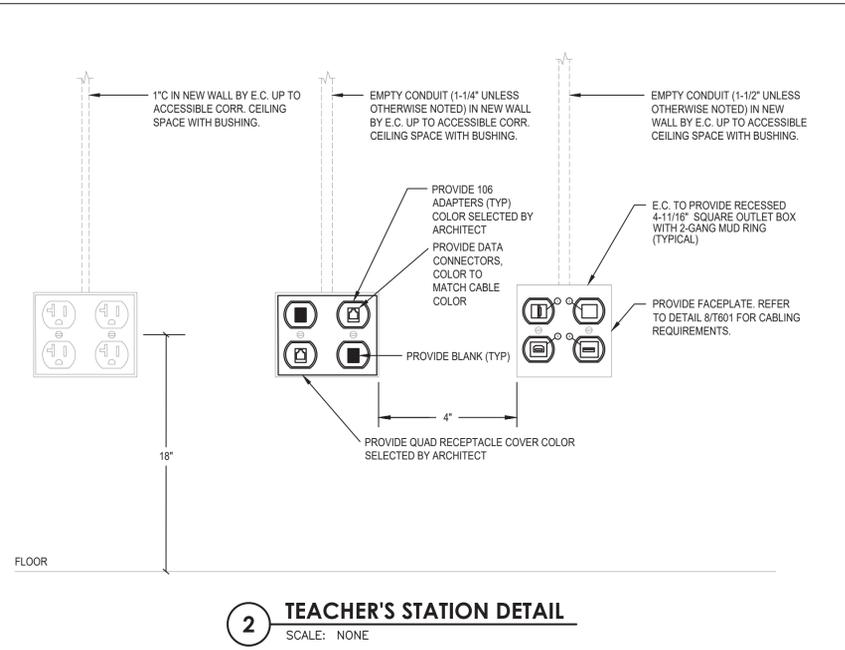
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Alterations to Administration Building
 Peekskill City School District
 Peekskill, New York


Revision: 05/21/2024
 Date: 10/11/2024
 Drawn by: C.B.




1 DEVICE AND LEGEND PLATE DETAIL
SCALE: NONE




2 TEACHER'S STATION DETAIL
SCALE: NONE

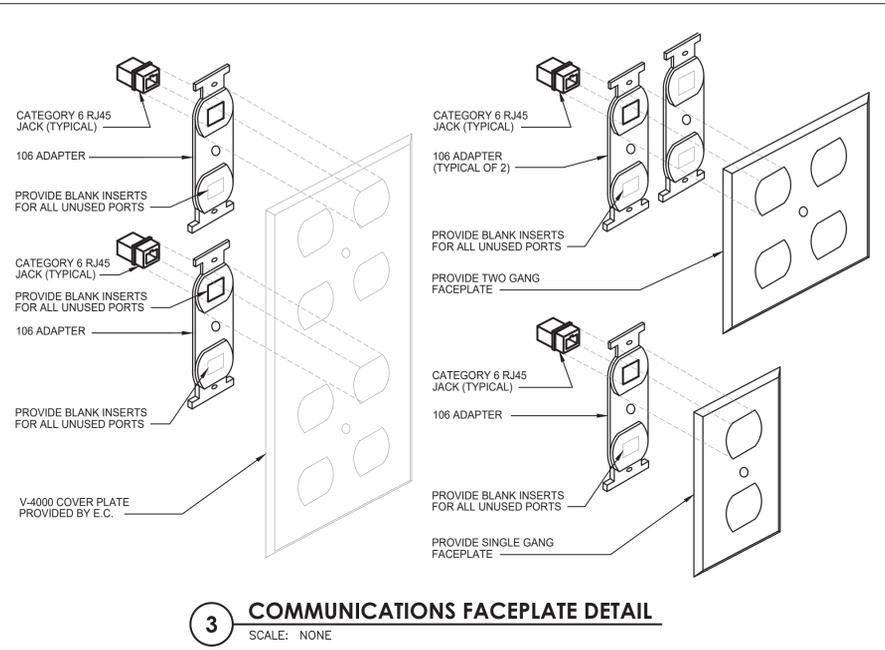


3 COMMUNICATIONS FACEPLATE DETAIL
SCALE: NONE

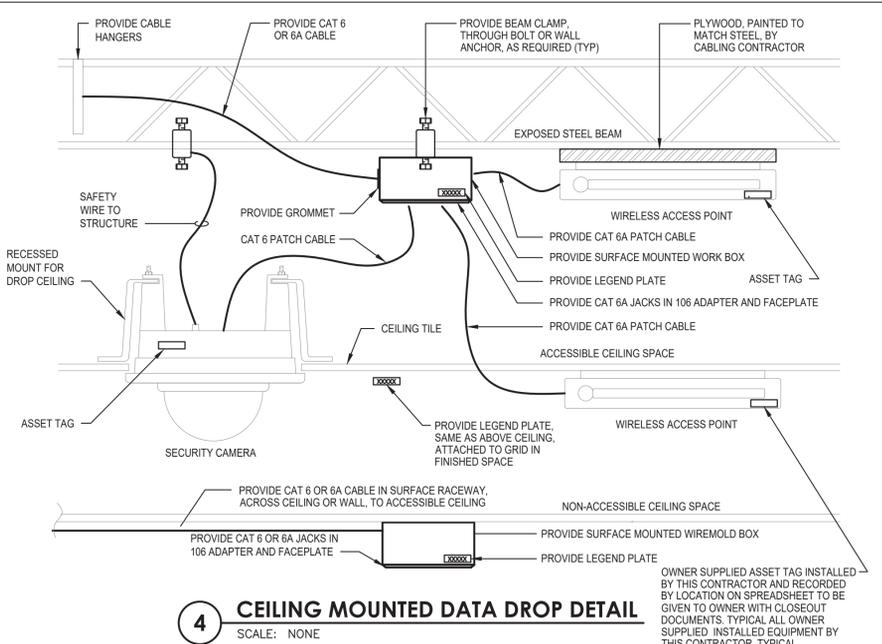


4 CEILING MOUNTED DATA DROP DETAIL
SCALE: NONE

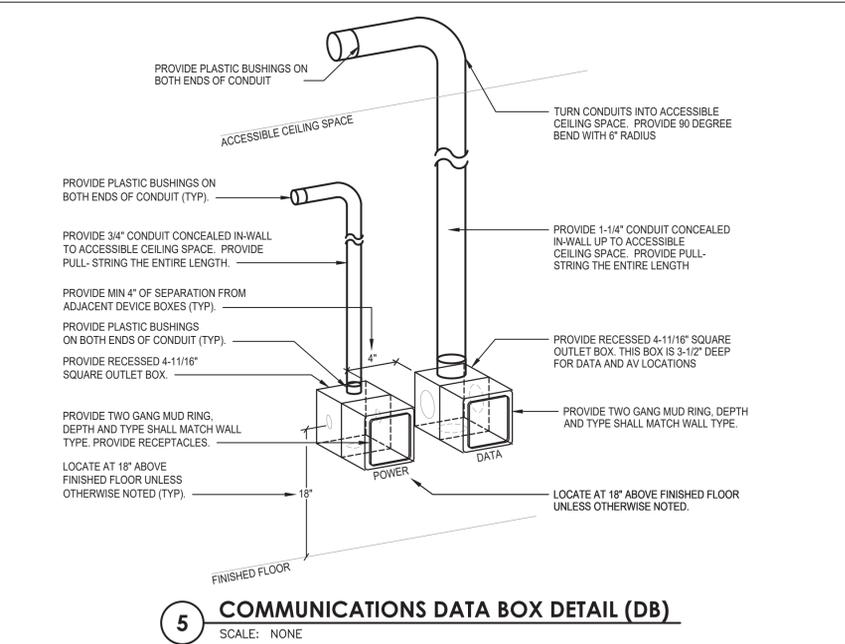


5 COMMUNICATIONS DATA BOX DETAIL (DB)
SCALE: NONE

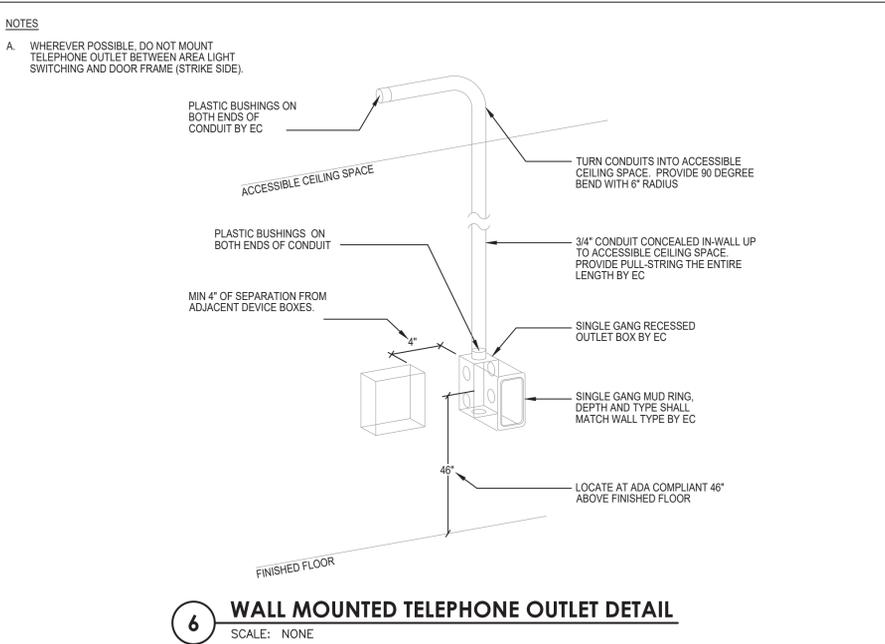

6 WALL MOUNTED TELEPHONE OUTLET DETAIL
SCALE: NONE

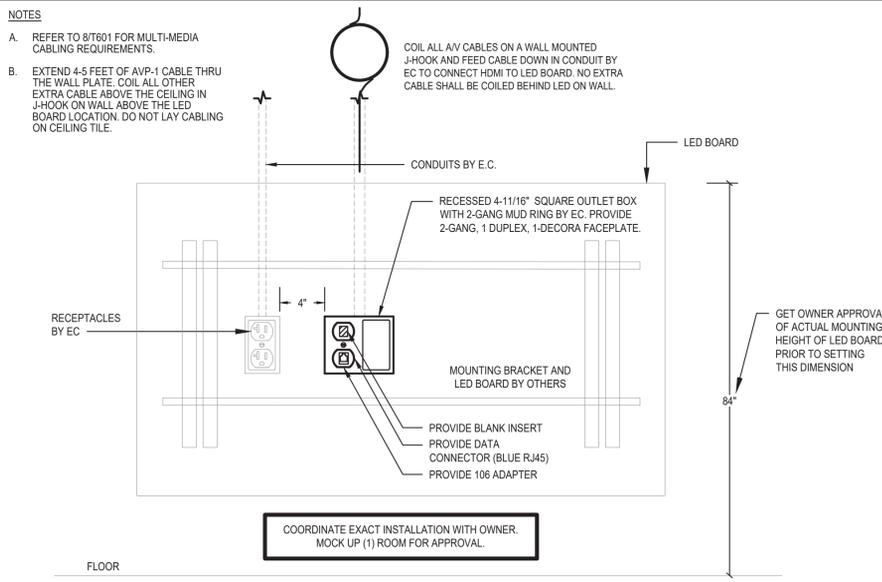

7 INTERACTIVE LED BOARD NEW WALL CONSTRUCTION DETAIL
SCALE: NONE

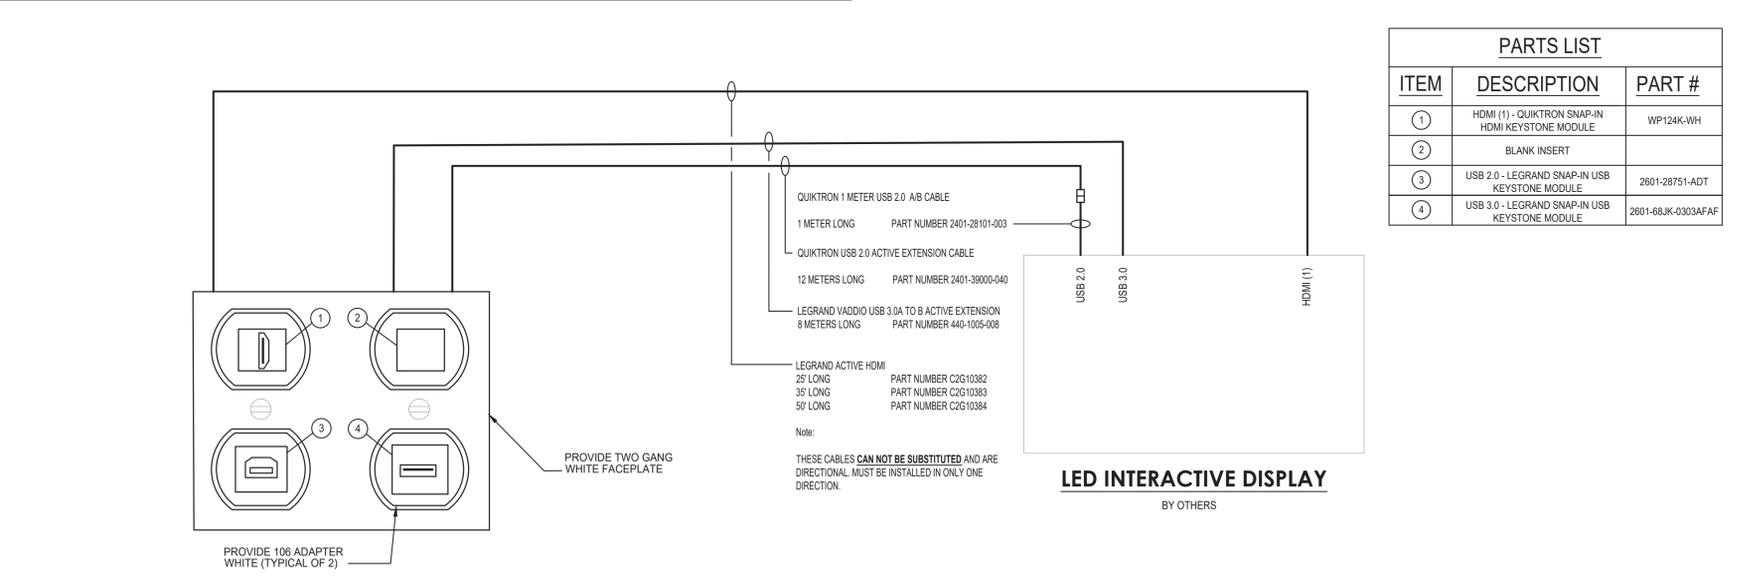

8 AVP-1 CABLING DIAGRAM
SCALE: NONE

NOTES


- A. WHEREVER POSSIBLE, DO NOT MOUNT TELEPHONE OUTLET BETWEEN AREA LIGHT SWITCHING AND DOOR FRAME (STRIKE SIDE).

PARTS LIST		
ITEM	DESCRIPTION	PART #
1	HDMI (1) - QUIKTRON SNAP-IN HDMI KEYSTONE MODULE	WP124K-WH
2	BLANK INSERT	
3	USB 2.0 - LEGRAND SNAP-IN USB KEYSTONE MODULE	2601-28751-ADT
4	USB 3.0 - LEGRAND SNAP-IN USB KEYSTONE MODULE	2601-68JK-0303AF-FAF


DRAWING NOTES: ○

1. PROVIDE CARD READER AND DOOR CONTACTS FOR THIS DOOR. CONNECT TO EXISTING DOOR ACCESS CONTROL.
2. REINSTALL AND RECONNECT EXISTING SECURITY CAMERA TO DATA DROP PROVIDED AFTER NEW CEILING WORK IS COMPLETED.
3. DISCONNECT EXISTING DOOR ACCESS CONTROL AND RECONNECT TO NEW DOOR ACCESS SYSTEM CONTROLLED BY IP PHONE ON DESK.
4. CONNECT IP PHONE TO CONTROL DOOR ACCESS.
5. PROVIDE NEW CEILING MOUNTED IP SECURITY CAMERA. PROVIDE ATTACHMENT CABLE AS REQUIRED.

CEILING SCHEDULE	
DESIGNATION	DESCRIPTION
(A)	ACCESSIBLE CEILING (DROP CEILING)
(B)	INACCESSIBLE CEILING (HARD CEILING)
(C)	EXPOSED STRUCTURE
(D)	SPLINE CEILING (1X1 TILES)

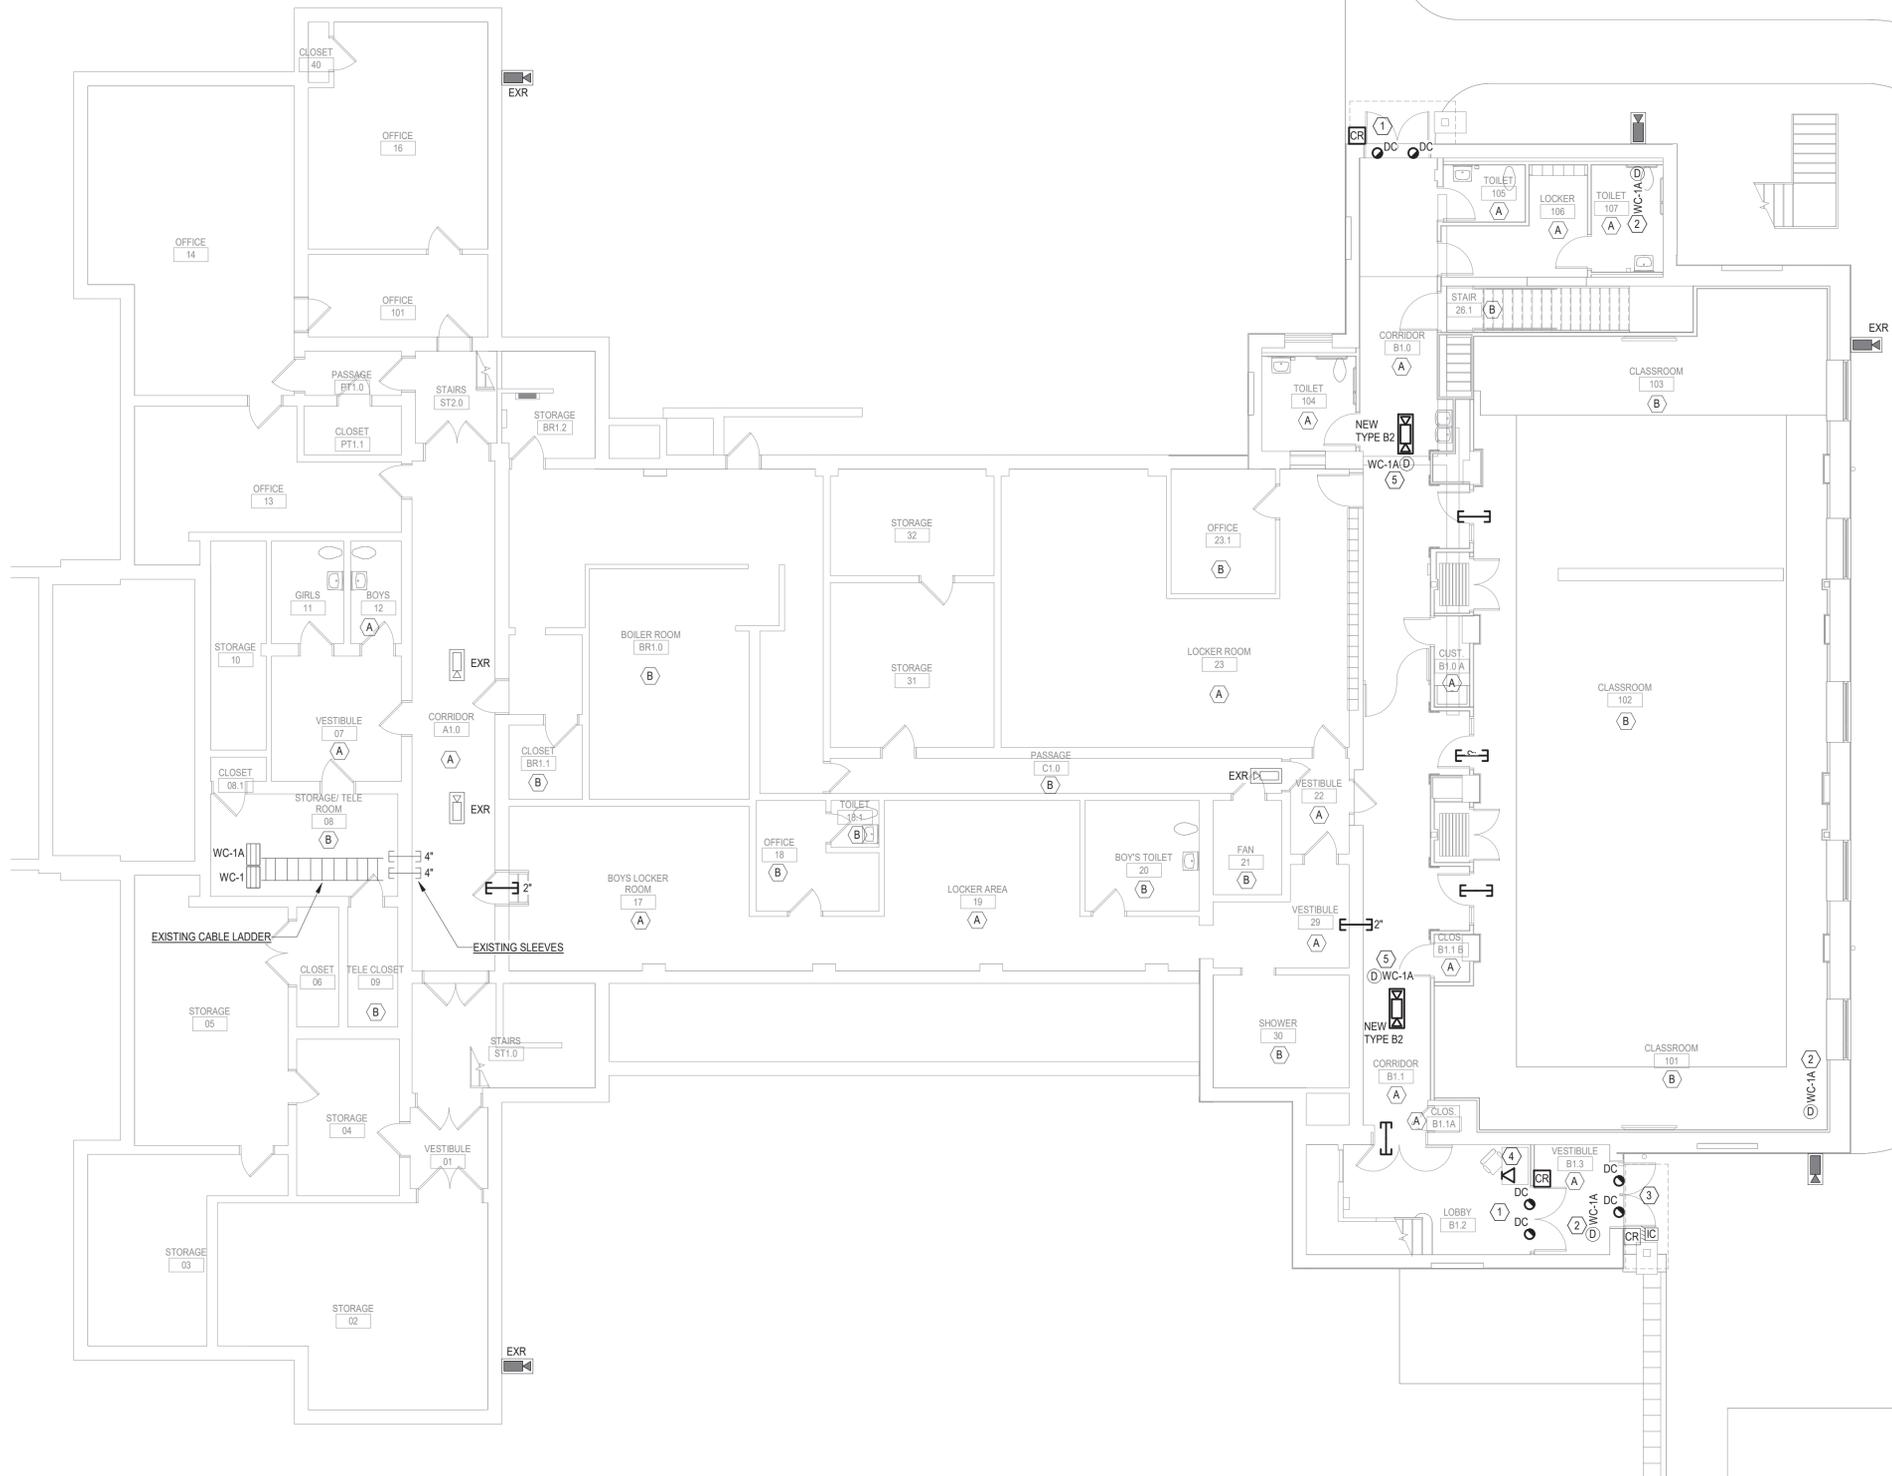

1 LOWER LEVEL SECURITY PLAN
SCALE: 1/8" = 1'-0"

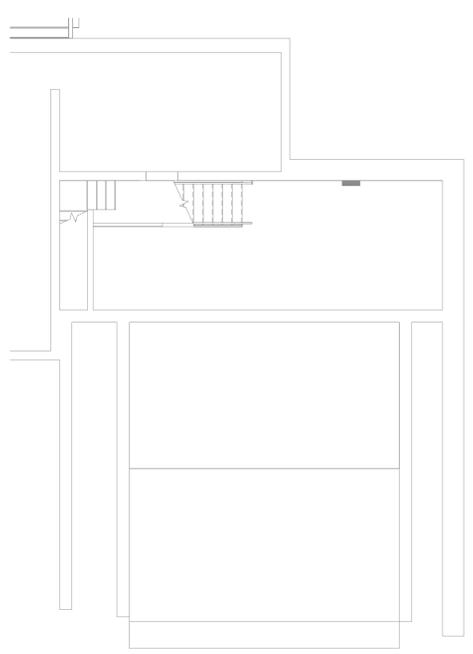

2 BASEMENT SECURITY PLAN
SCALE: 1/8" = 1'-0"

SED NUMBERS: Administration Building: 64-15-001-0-009-013
 BEFORE WORK IS STARTED, CONTRACTOR SHALL VERIFY ALL THE DIMENSIONS AT THE SITE, AND IMMEDIATELY NOTIFY THE ARCHITECT OF ALL DISCREPANCIES. ALTERATION OF THIS DOCUMENT BY OTHER THAN AN AUTHORIZED LICENSED REGISTERED ARCHITECT IS ILLEGAL AND A VIOLATION OF SECTION 2307 OF THE NEW YORK STATE EDUCATION LAW.

Drawing Title: **BASEMENT & LOWER LEVEL SECURITY PLAN**
 Drawing Number:

Revision: 05/21/2024
 Date: 10/11/2024
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 Drawn by: C.B.

Alterations to Administration Building
 Peekskill City School District
 Peekskill, New York

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