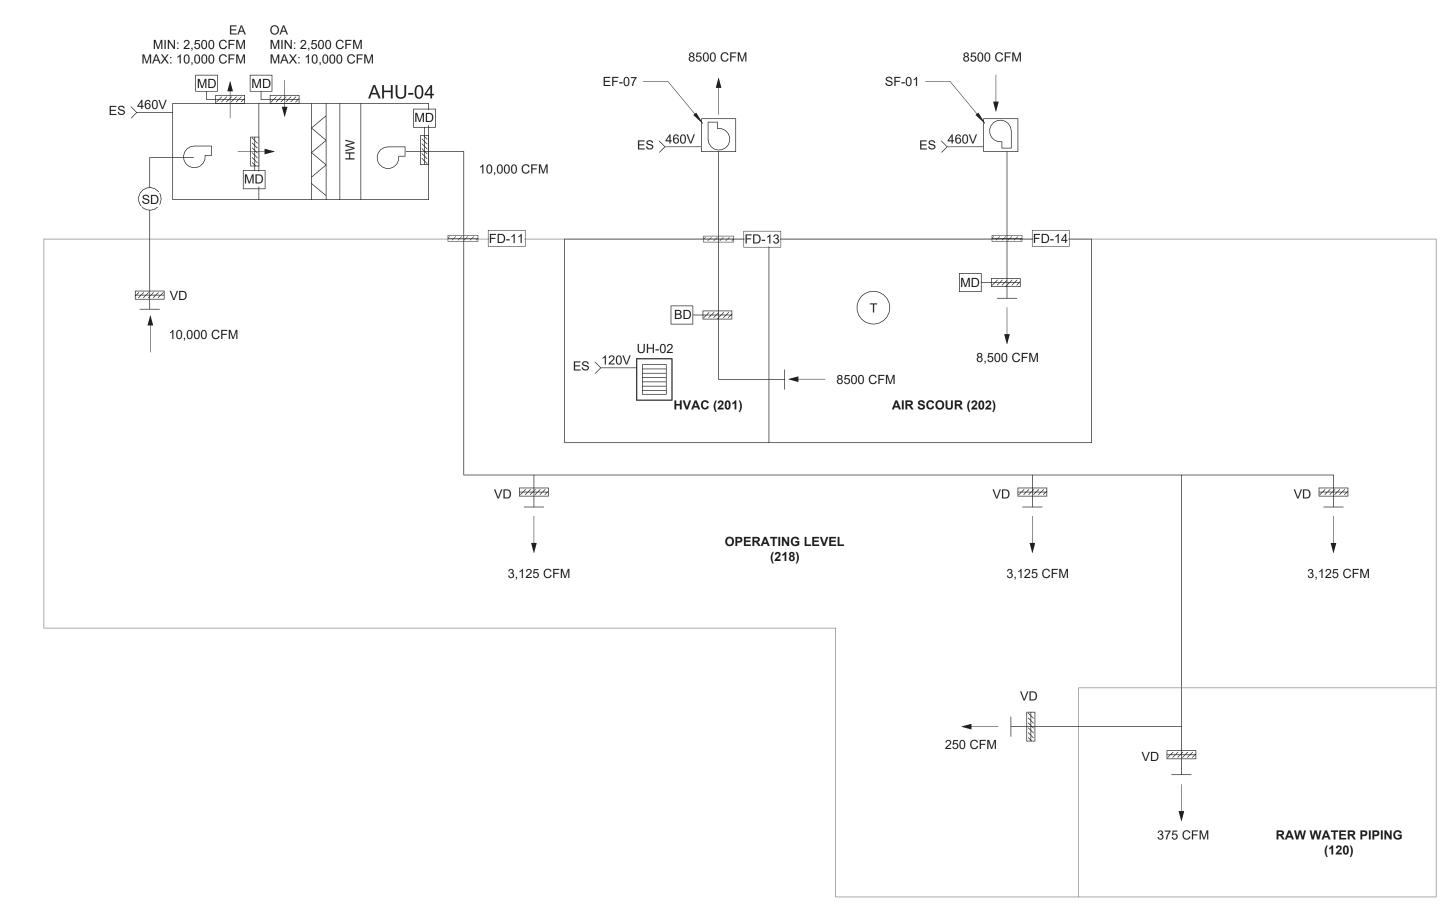


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WARNING
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PROFESSIONAL ENGINEER, TO ALTER IN ANY WAY PLANS, SPECIFICATIONS, PLATS
OR REPORTS TO WHICH THE SEAL OF A PROFESSIONAL ENGINEER HAS BEEN
APPLIED. IF AN ITEM BEARING THE SEAL OF A PROFESSIONAL ENGINEER IS ALTERED,
THE ALTERING ENGINEER SHALL AFFIX TO THE ITEM HIS SEAL AND THE NOTATION
"ALTERED BY" FOLLOWED BY HIS SIGNATURE, THE DATE, AND A SPECIFIC

ion/9		BY" FOLLOWED BY HIS SIGNATURE, THE DATE, AN TION OF THE ALTERATION	ID A SPECIFIC				
Lake_Filtration/9					PROJECT ENGINEER:	R. FROST	
					DESIGNED BY:	M. GIORDANO	
Docs://90388-000_Rye 2:42:17 PM					DRAWN BY:	R. CHIN	
s://9038a					CHECKED BY:	R. VAN DYKE	
esk Docs 025 2:42:					IF THIS BAR DOES NOT MEASURE 1" THEN DRAWING	0 1/2" 1"	
Autodesk I 2/18/2025	REV	ISSUED FOR	DATE	BY	IS NOT TO FULL SCALE		

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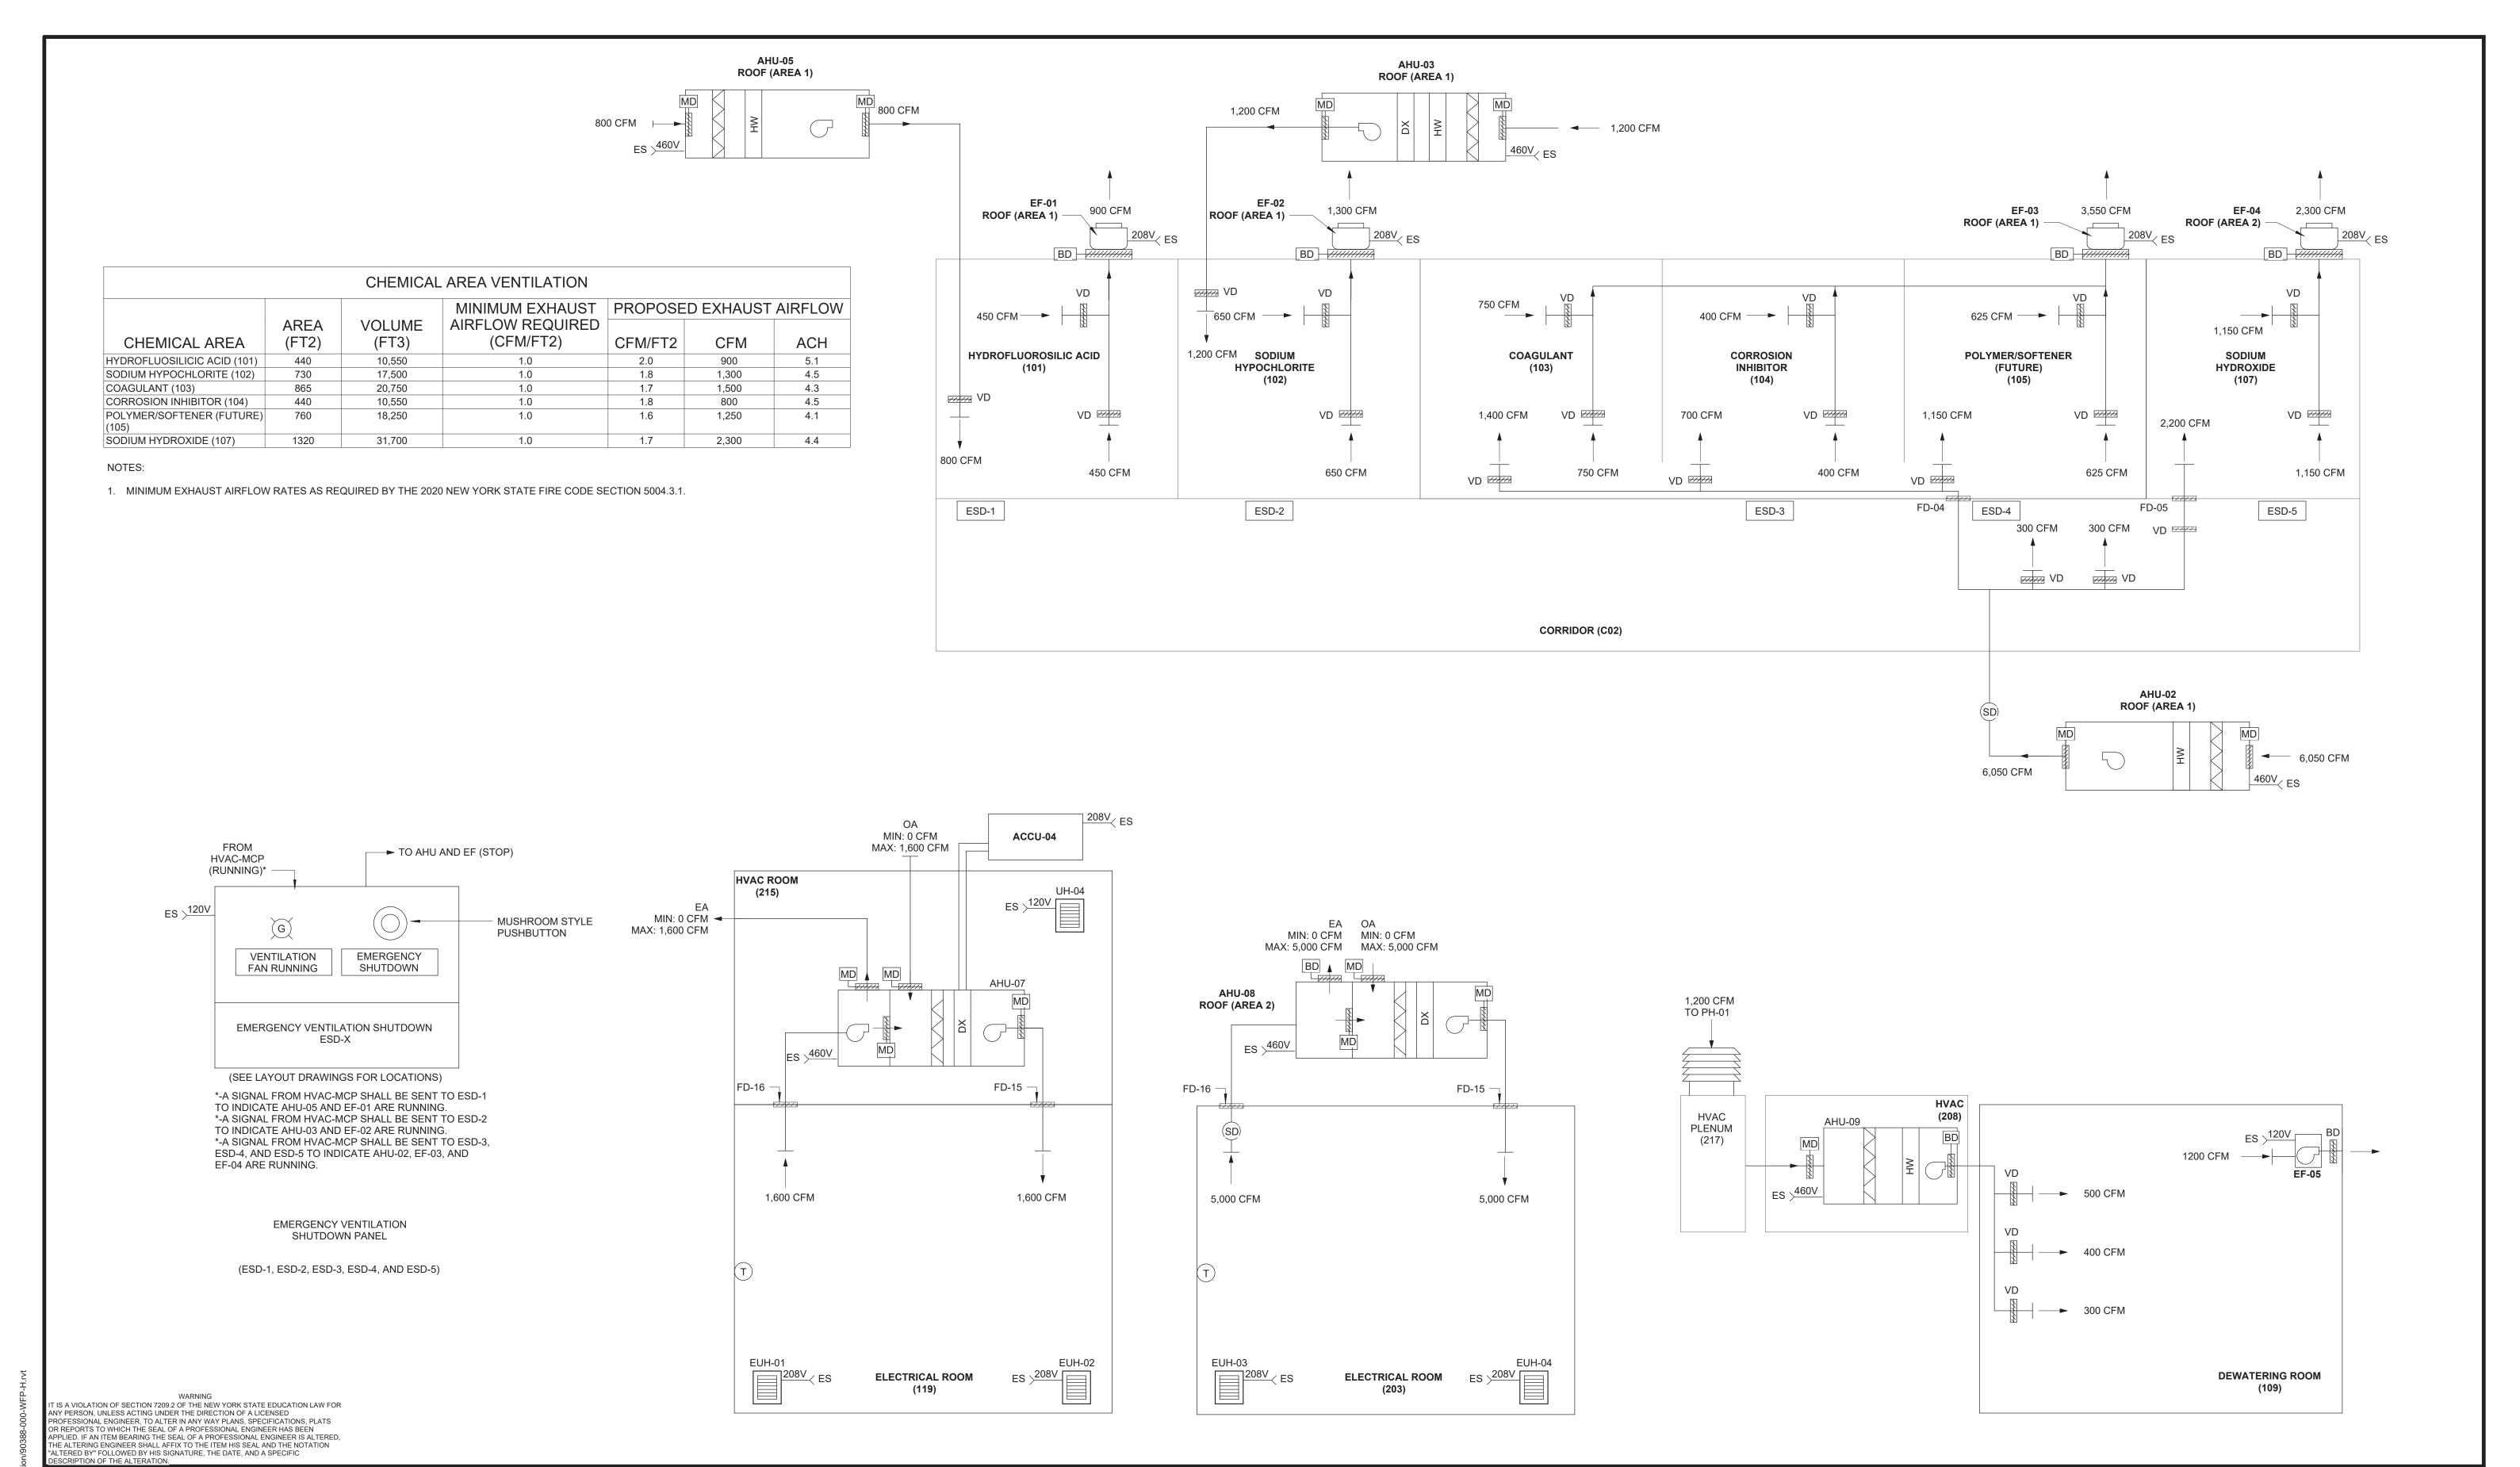
HAZEN AND SAWYER
498 SEVENTH AVENUE, 11th FLOOR
NEW YORK, NEW YORK 10018

WESTCHESTER JOINT WATER WORKS MAMARONECK, NY

RYE LAKE WATER FILTRATION PLANT HARRISON, NY

FILTRATION PLANT HVAC CONTROL DIAGRAMS - SHEET 1

DATE:	FEB 2025
HAZEN NO.:	90388-000
CONTRACT NO.:	A1364-A
DRAWING NUMBER:	
	H-002



"ALTERED BY" FOLLOWED BY HIS SIGNATURE, THE DATE, AND A SPECIFIC DESCRIPTION OF THE ALTERATION.

PROJECT ENGINEER:

DESIGNED BY:

M. GIORDANO

DRAWN BY:

R. CHIN

CHECKED BY:

R. VAN DYKE

IF THIS BAR DOES NOT MEASURE 1" THEN DRAWING IS NOT TO FULL SCALE

REV ISSUED FOR DATE BY

BID SET



HAZEN AND SAWYER
498 SEVENTH AVENUE, 11th FLOOR

NEW YORK, NEW YORK 10018

WESTCHESTER JOINT WATER WORKS MAMARONECK, NY


RYE LAKE WATER FILTRATION PLANT HARRISON, NY

FILTRATION PLANT HVAC CONTROL DIAGRAMS - SHEET 2 DATE: FEB 2025

HAZEN NO.: 90388-000

CONTRACT NO.: A1364-A

DRAWING NUMBER: H-003

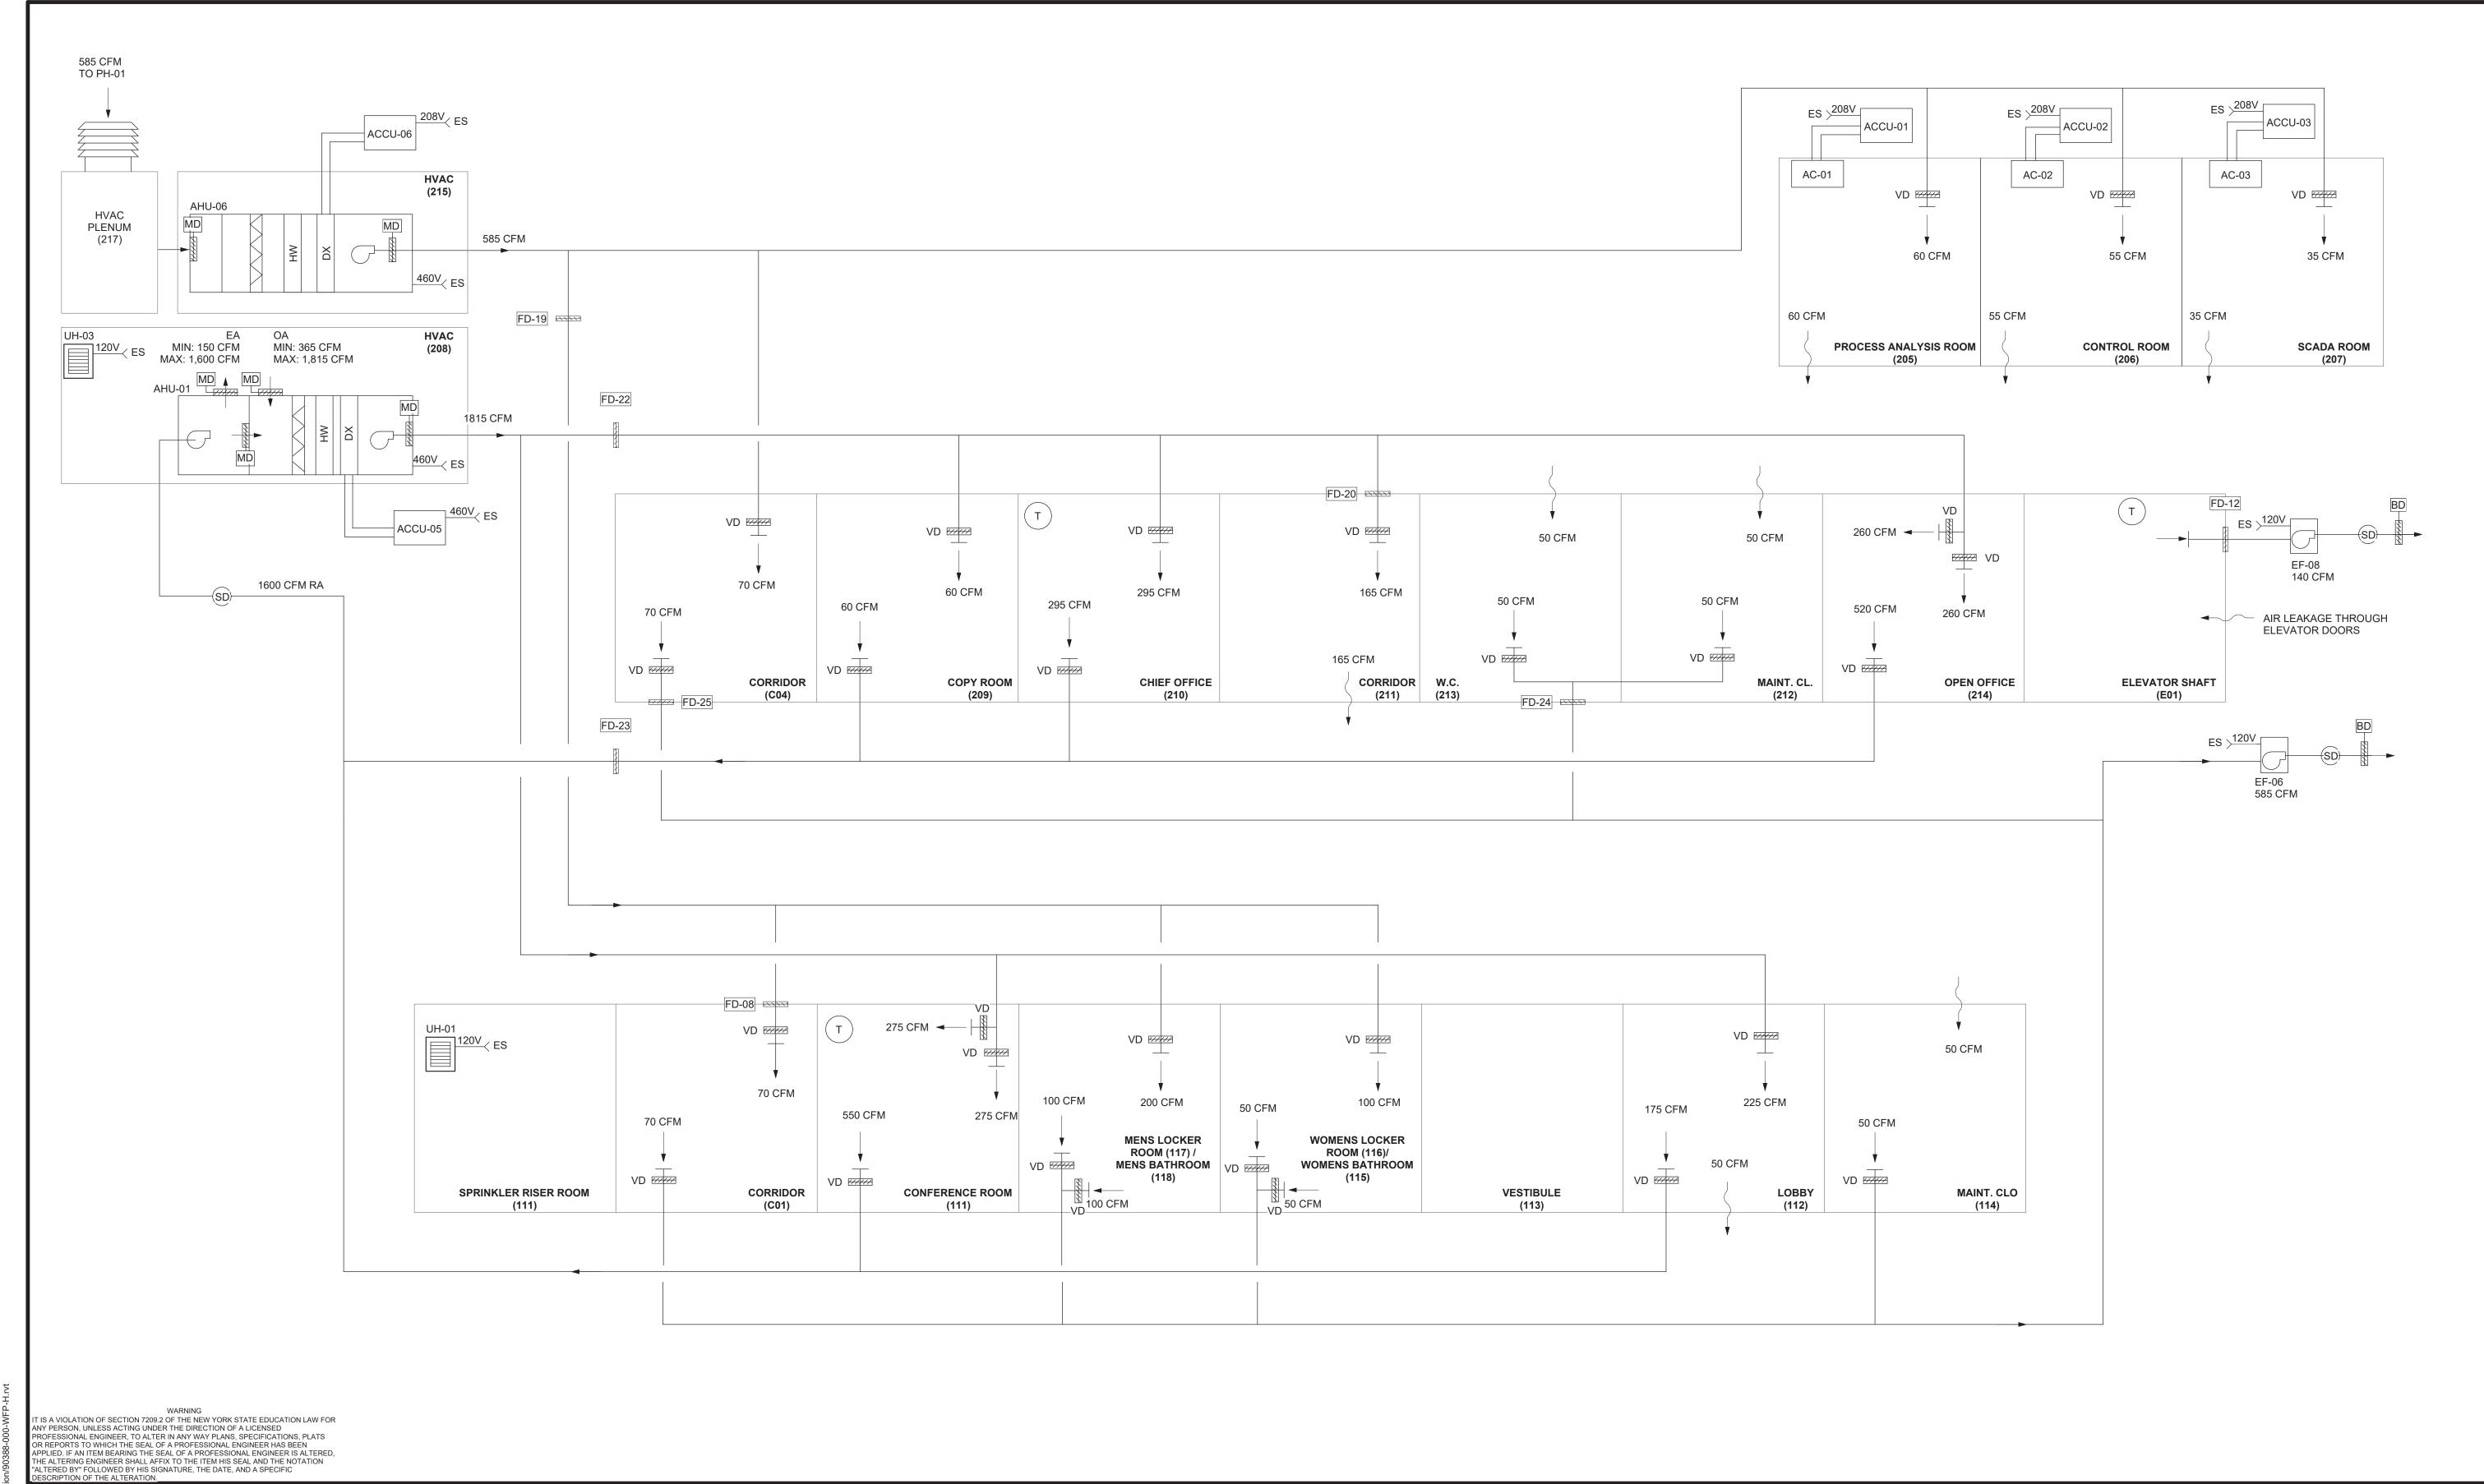

PROJECT ENGINEER: R. FROST M. GIORDANO **DESIGNED BY** R. CHIN DRAWN BY: **BID SET** CHECKED BY: R. VAN DYKE 1/2" IF THIS BAR DOES NOT MEASURE 1" THEN DRAWING IS NOT TO FULL SCALE DATE ISSUED FOR

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498 SEVENTH AVENUE, 11th FLOOR

NEW YORK, NEW YORK 10018

WESTCHESTER JOINT WATER WORKS MAMARONECK, NY


RYE LAKE WATER FILTRATION PLANT HARRISON, NY FILTRATION PLANT HVAC CONTROL DIAGRAMS - SHEET 3 DATE: FEB 2025


HAZEN NO.: 90388-000


CONTRACT NO.: A1364-A

DRAWING NUMBER:

H-004

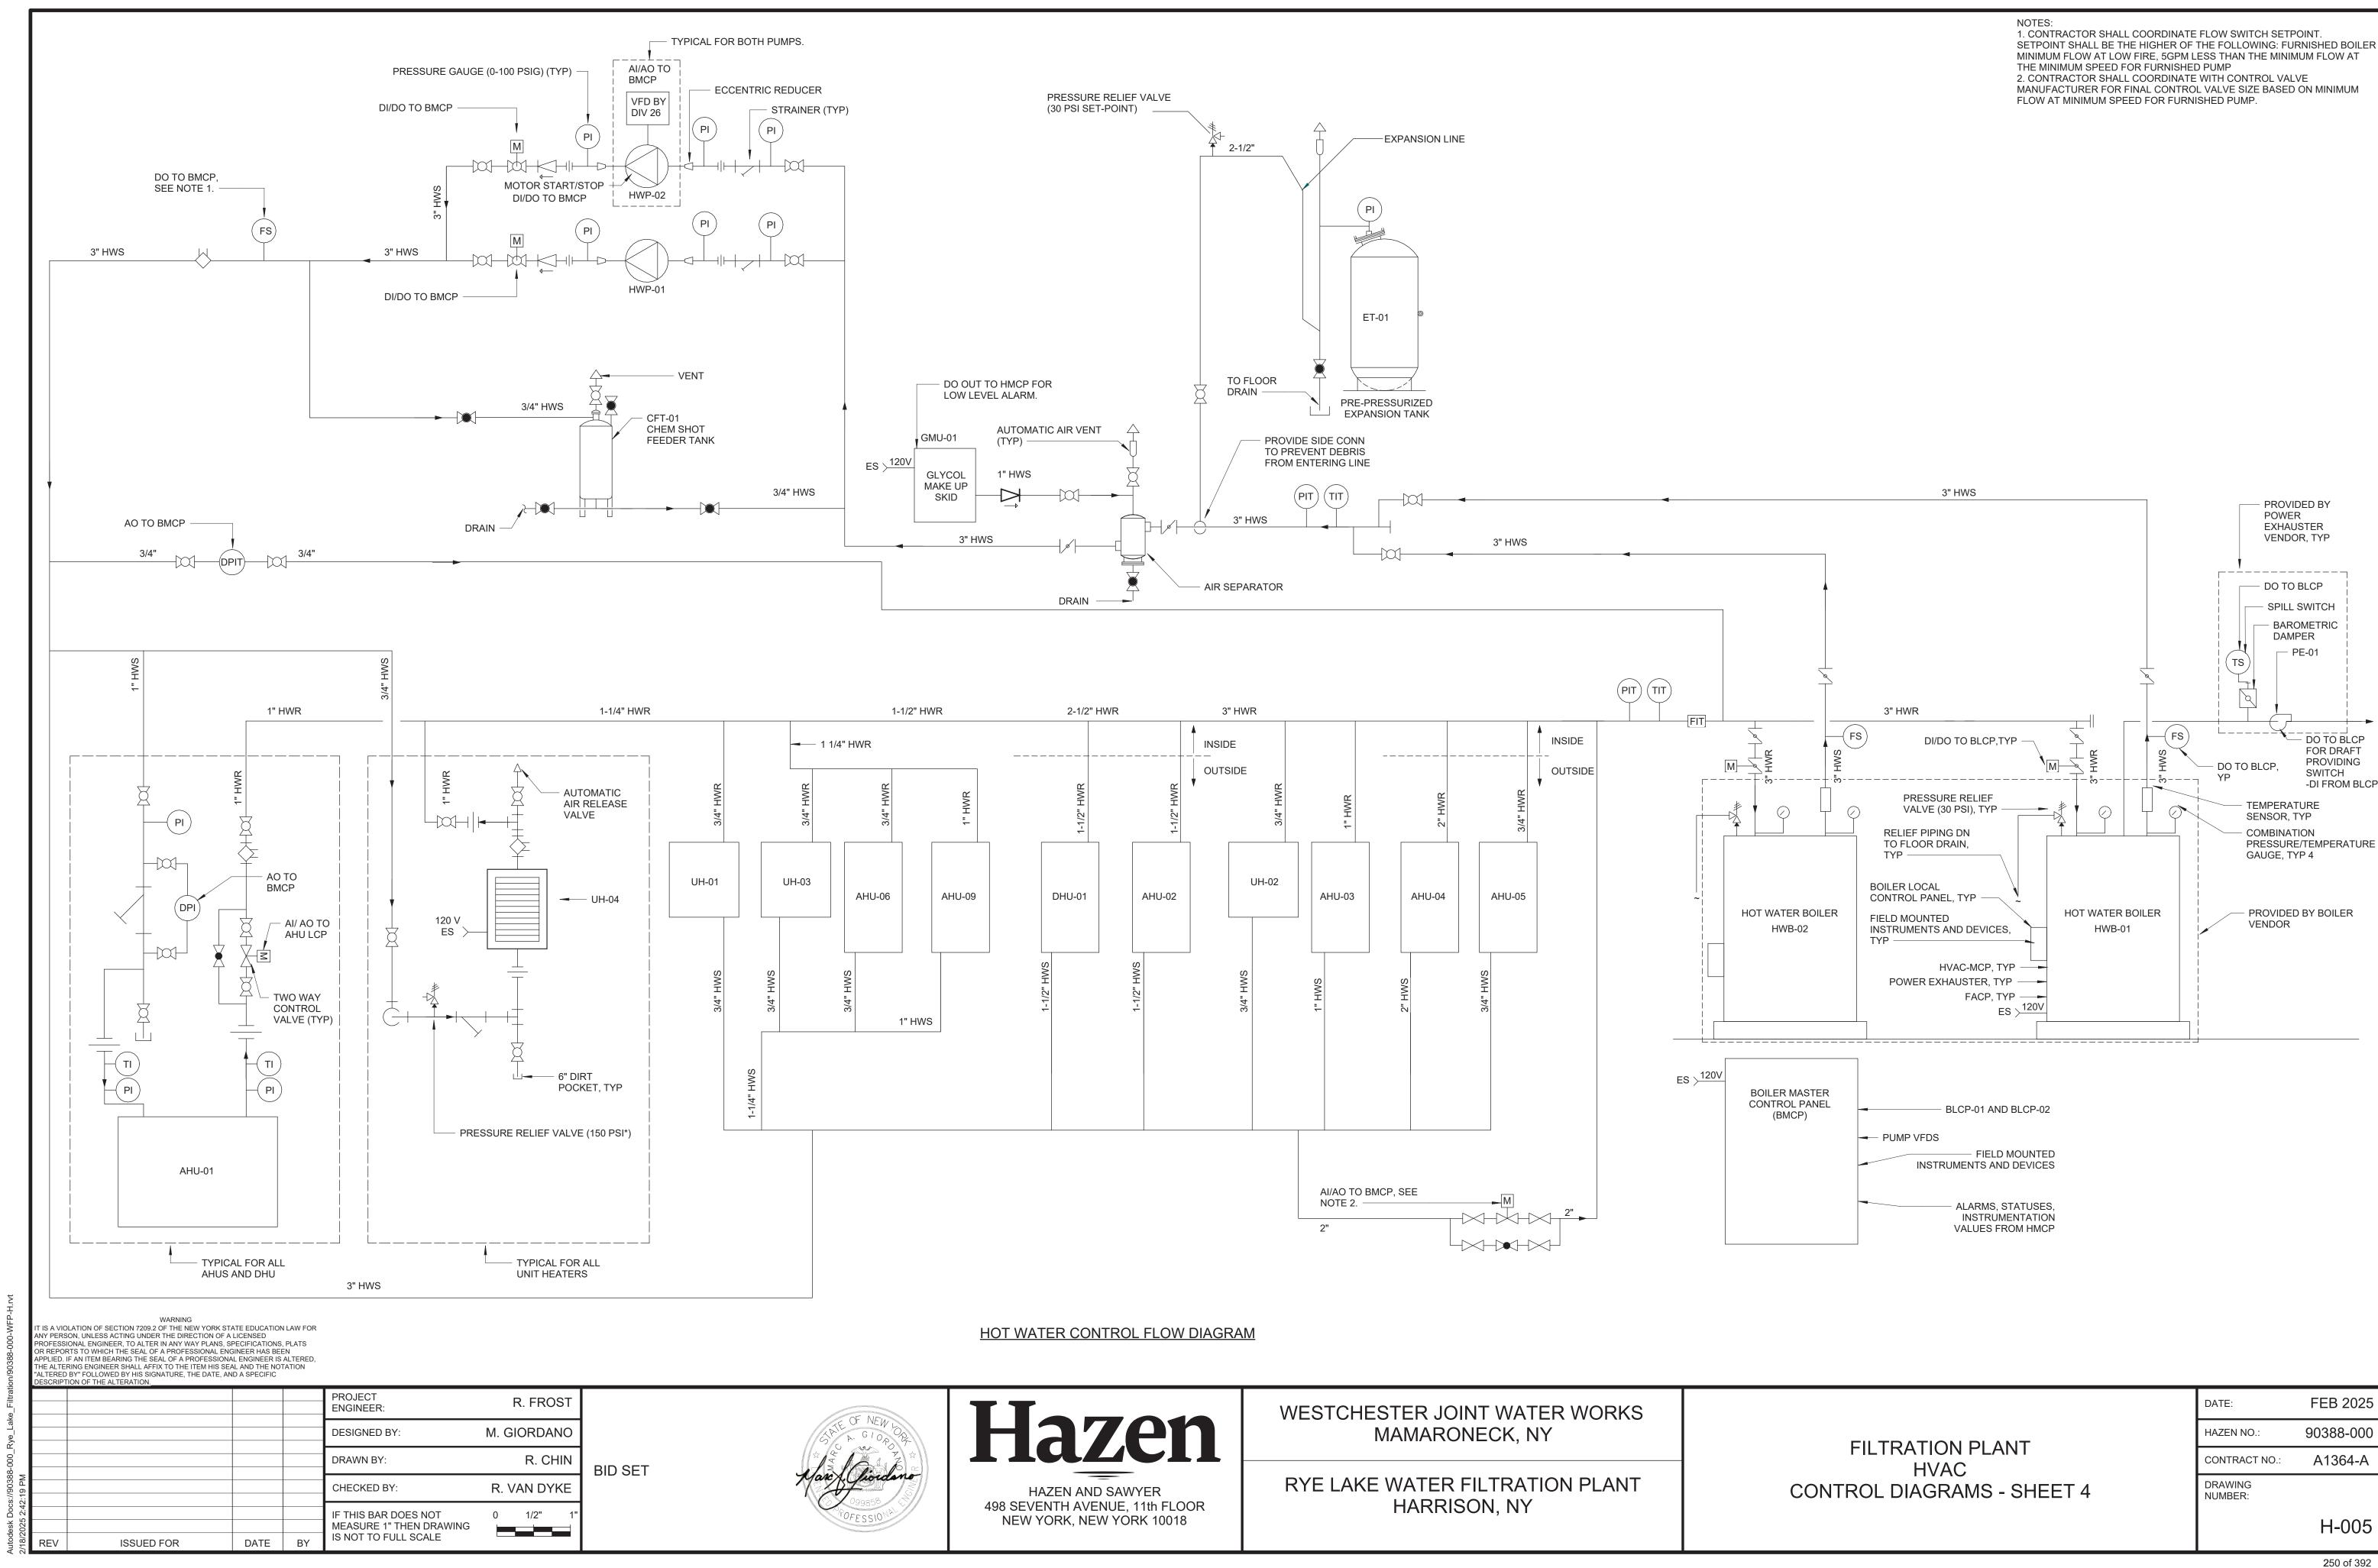

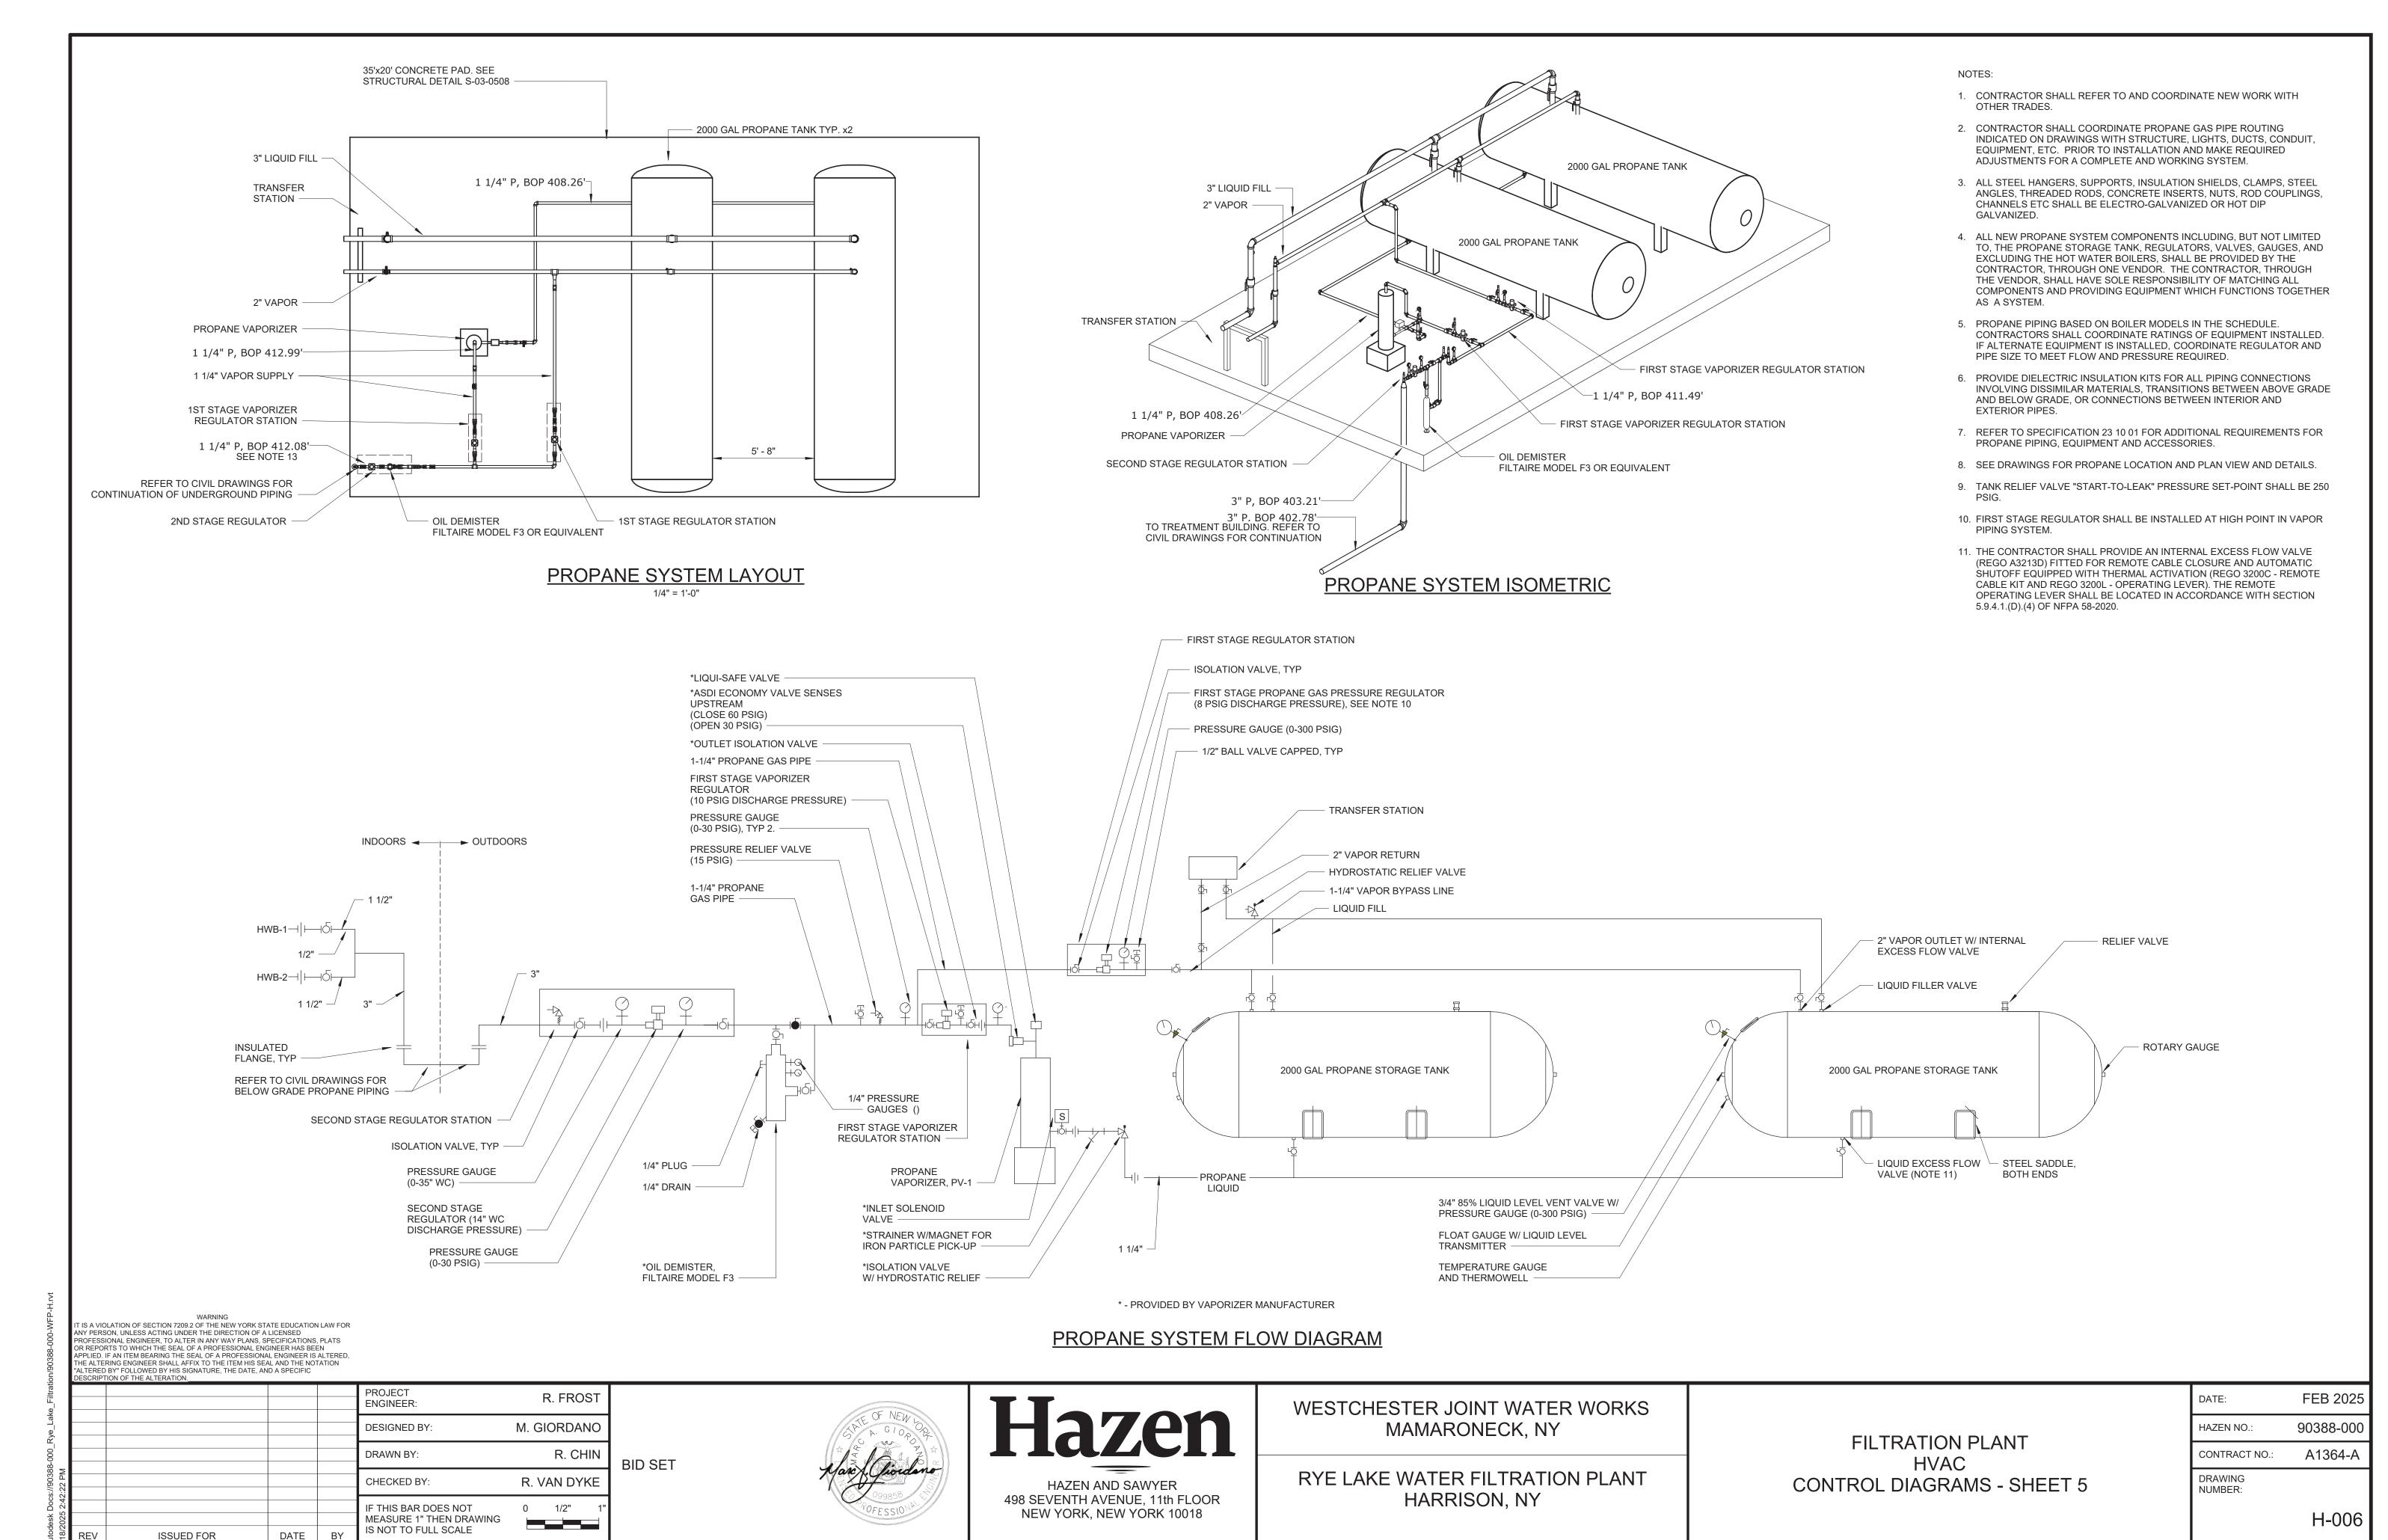

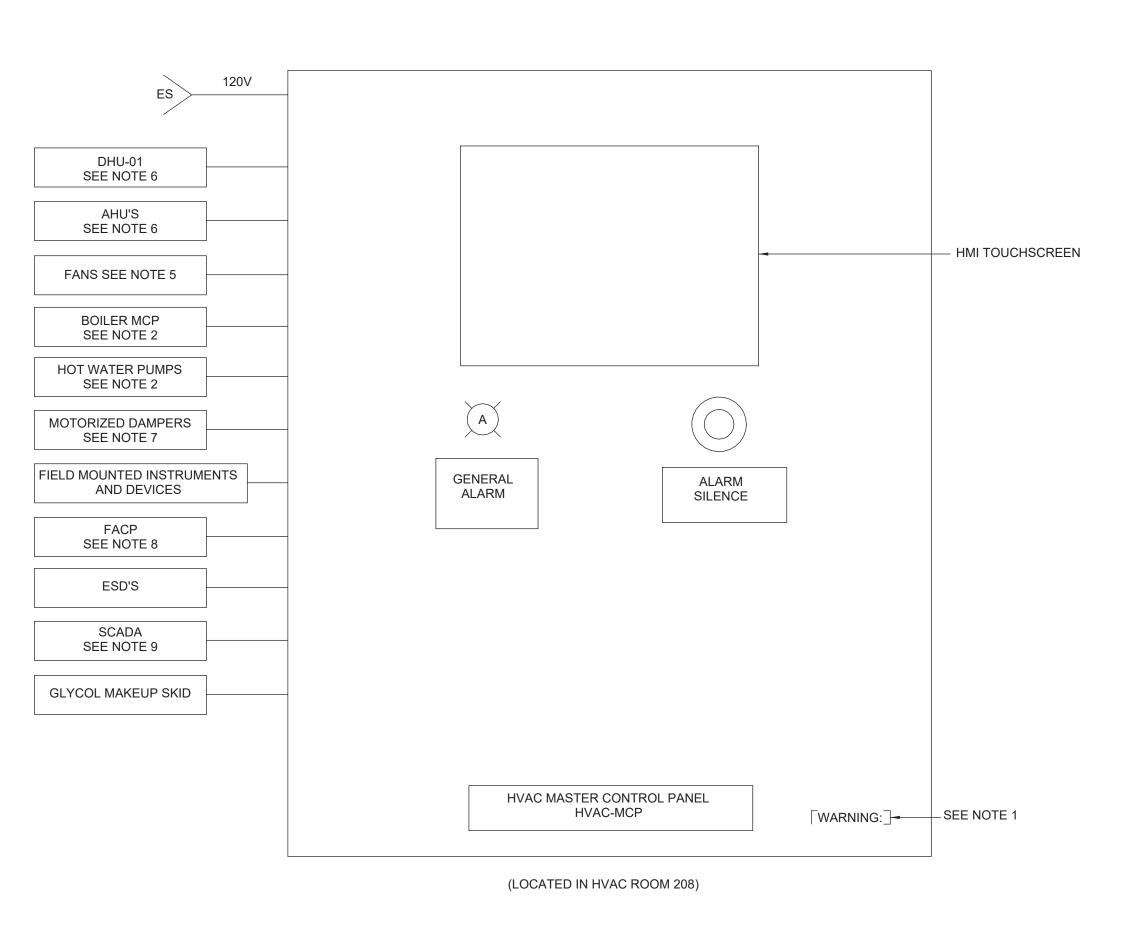

HVAC MASTER CONTROL PANEL

NOTES:

1. PLACE A RED WARNING SIGN CONSPICUOUSLY ON THE FACE OF EACH HVAC CONTROL PANEL WHICH READS AS FOLLOWS:

> WARNING THIS PANEL CONNECTED TO MULTIPLE SOURCES OF POWER

2. FOR SEQUENCE OF OPERATION SEE

SPECIFICATION 23 09 02.

3. SIGNALS SHOWN IN CONTROL DIAGRAMS, UNLESS OTHERWISE STATED, TERMINATE AT OR ORIGINATE FROM THE HVAC MASTER CONTROL PANEL.

4. POWER SIGNALS FOR DAMPERS AND INSTRUMENTS ARE NOT SHOWN ON THE CONTROL DIAGRAM. POWER AND CONTROL TO ACTUATORS SHALL BE FROM THE CONTROL

PANEL THE DEVICE IS CONNECTED TO. 5. THE FOLLOWING SIGNALS SHALL BE HARDWIRED:

5.2. FAN MCC READY - DO 5.3. FAN MCC RUNNING - DO

5.4. FAN MCC FAULT - DO

5.1. FAN MCC START/STOP - DI

6. BACNET DATALINK COMMUNICATION. SEE

SPECIFICATION 23 09 02 FOR DETAILS. 7. THE FOLLOWING SIGNALS SHALL BE HARDWIRED:

7.1. DAMPERS OPEN END SWITCH - DI 8. THE FOLLOWING SIGNALS SHALL BE HARDWIRED:

8.1. VENT SYSTEM SHUTDOWN - DI 8.2. VENT SYSTEM PURGE - DI

9. THE FOLLOWING SIGNALS SHALL BE HARDWIRED:

9.1. GENERAL ALARM - DO

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.o	DESCRIPT	TION OF THE ALTERATION.						
_Lake_Filtration					PROJECT ENGINEER:		R. FRO	ST
					DESIGNED BY:	M. G	IORDAI	NO
8-000_F					DRAWN BY:		R. Ch	IIN
Docs://90388-000_Rye_ 2:42:23 PM					CHECKED BY:	R. \	/AN DY	KE
					IF THIS BAR DOES NOT MEASURE 1" THEN DRAWING	0	1/2"	1" ===
itodesk 18/2025	REV	ISSUED FOR	DATE	BY	IS NOT TO FULL SCALE			

BID SET





WESTCHESTER JOINT WATER WORKS MAMARONECK, NY

RYE LAKE WATER FILTRATION PLANT HARRISON, NY

FILTRATION PLANT HVAC CONTROL DIAGRAMS - SHEET 6

DATE:	FEB 2025
HAZEN NO.:	90388-000
CONTRACT NO.:	A1364-A
DRAWING NUMBER:	
	H-007

NOTES:

1. THE WORK OF OTHER DISCIPLINES IS HALF-TONE OR HIDDEN FOR CLARITY. REFER TO CONTRACT DRAWINGS OF OTHER DISCIPLINES FOR ADDITIONAL WORK BY

10" x 10" SA_ 12" x 12" SA BOD 402.27 BOD 402.19 (A)-WD-A - 10"x10" WD-A - 10"x10" 400 CFM 400 CFM 12" x 12" SA UV DISINFECTION RESIDUALS STORAGE BOD 399.50 **BACKWASH TANK** FILTERED WATER TANKS <u>SYSTEM</u> TRANSFER TANKS 004 FLOATED SOLIDS TRANSFER PUMPS 12" x 12" SA 1,000 CFM BOD 399.50 В STORAGE CLO STAIR C −36"x36" RA 18" x 18" SA 24" x 24" SA 006 BOD 391.25 BOD 393.25 24" x 24" SA 20" x 20" SA WD-A - 20"x20" BOD 393.25 BOD 391.17 PIPE GALLERY 1,500 CFM FD-01 FD-02 STAIR A VD <u>o</u> DAF RECYCLE PUMPS VD 36"x36" D 5,300 CFM ELEV − WD-A - 16"x16", 10'-6" AFF − 1000 CFM WD-A - 24"x24", 10'-6" AFF CORRIDOR 2500 CFM ----

EL 383.00 - OVERALL PLAN
3/32" = 1'-0"

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"ALTERED BY" FOLLOWED BY HIS SIGNATURE, THE DATE, AND A SPECIFIC
DESCRIPTION OF THE ALTERATION.

PLANT NORTH

LDESCRIPT	ION OF THE ALTERATION.					
				PROJECT ENGINEER:	R. FROST	
				DESIGNED BY:	M. GIORDANO	
				DRAWN BY:	R. CHIN	BID SET
				CHECKED BY:	R. VAN DYKE	
				IF THIS BAR DOES NOT MEASURE 1" THEN DRAWING	0 1/2" 1"	
REV	ISSUED FOR	DATE	BY	IS NOT TO FULL SCALE		

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498 SEVENTH AVENUE, 11th FLOOR
NEW YORK, NEW YORK 10018


WESTCHESTER JOINT WATER WORKS MAMARONECK, NY


RYE LAKE WATER FILTRATION PLANT HARRISON, NY


	FILTRATION PLANT
	HVAC
EL.	383.00 - OVERALL PLAN

DATE:	FEB 2025
HAZEN NO.:	90388-000
CONTRACT NO.:	A1364-A
DRAWING NUMBER:	
	H-100

10 8 6 4 2 0

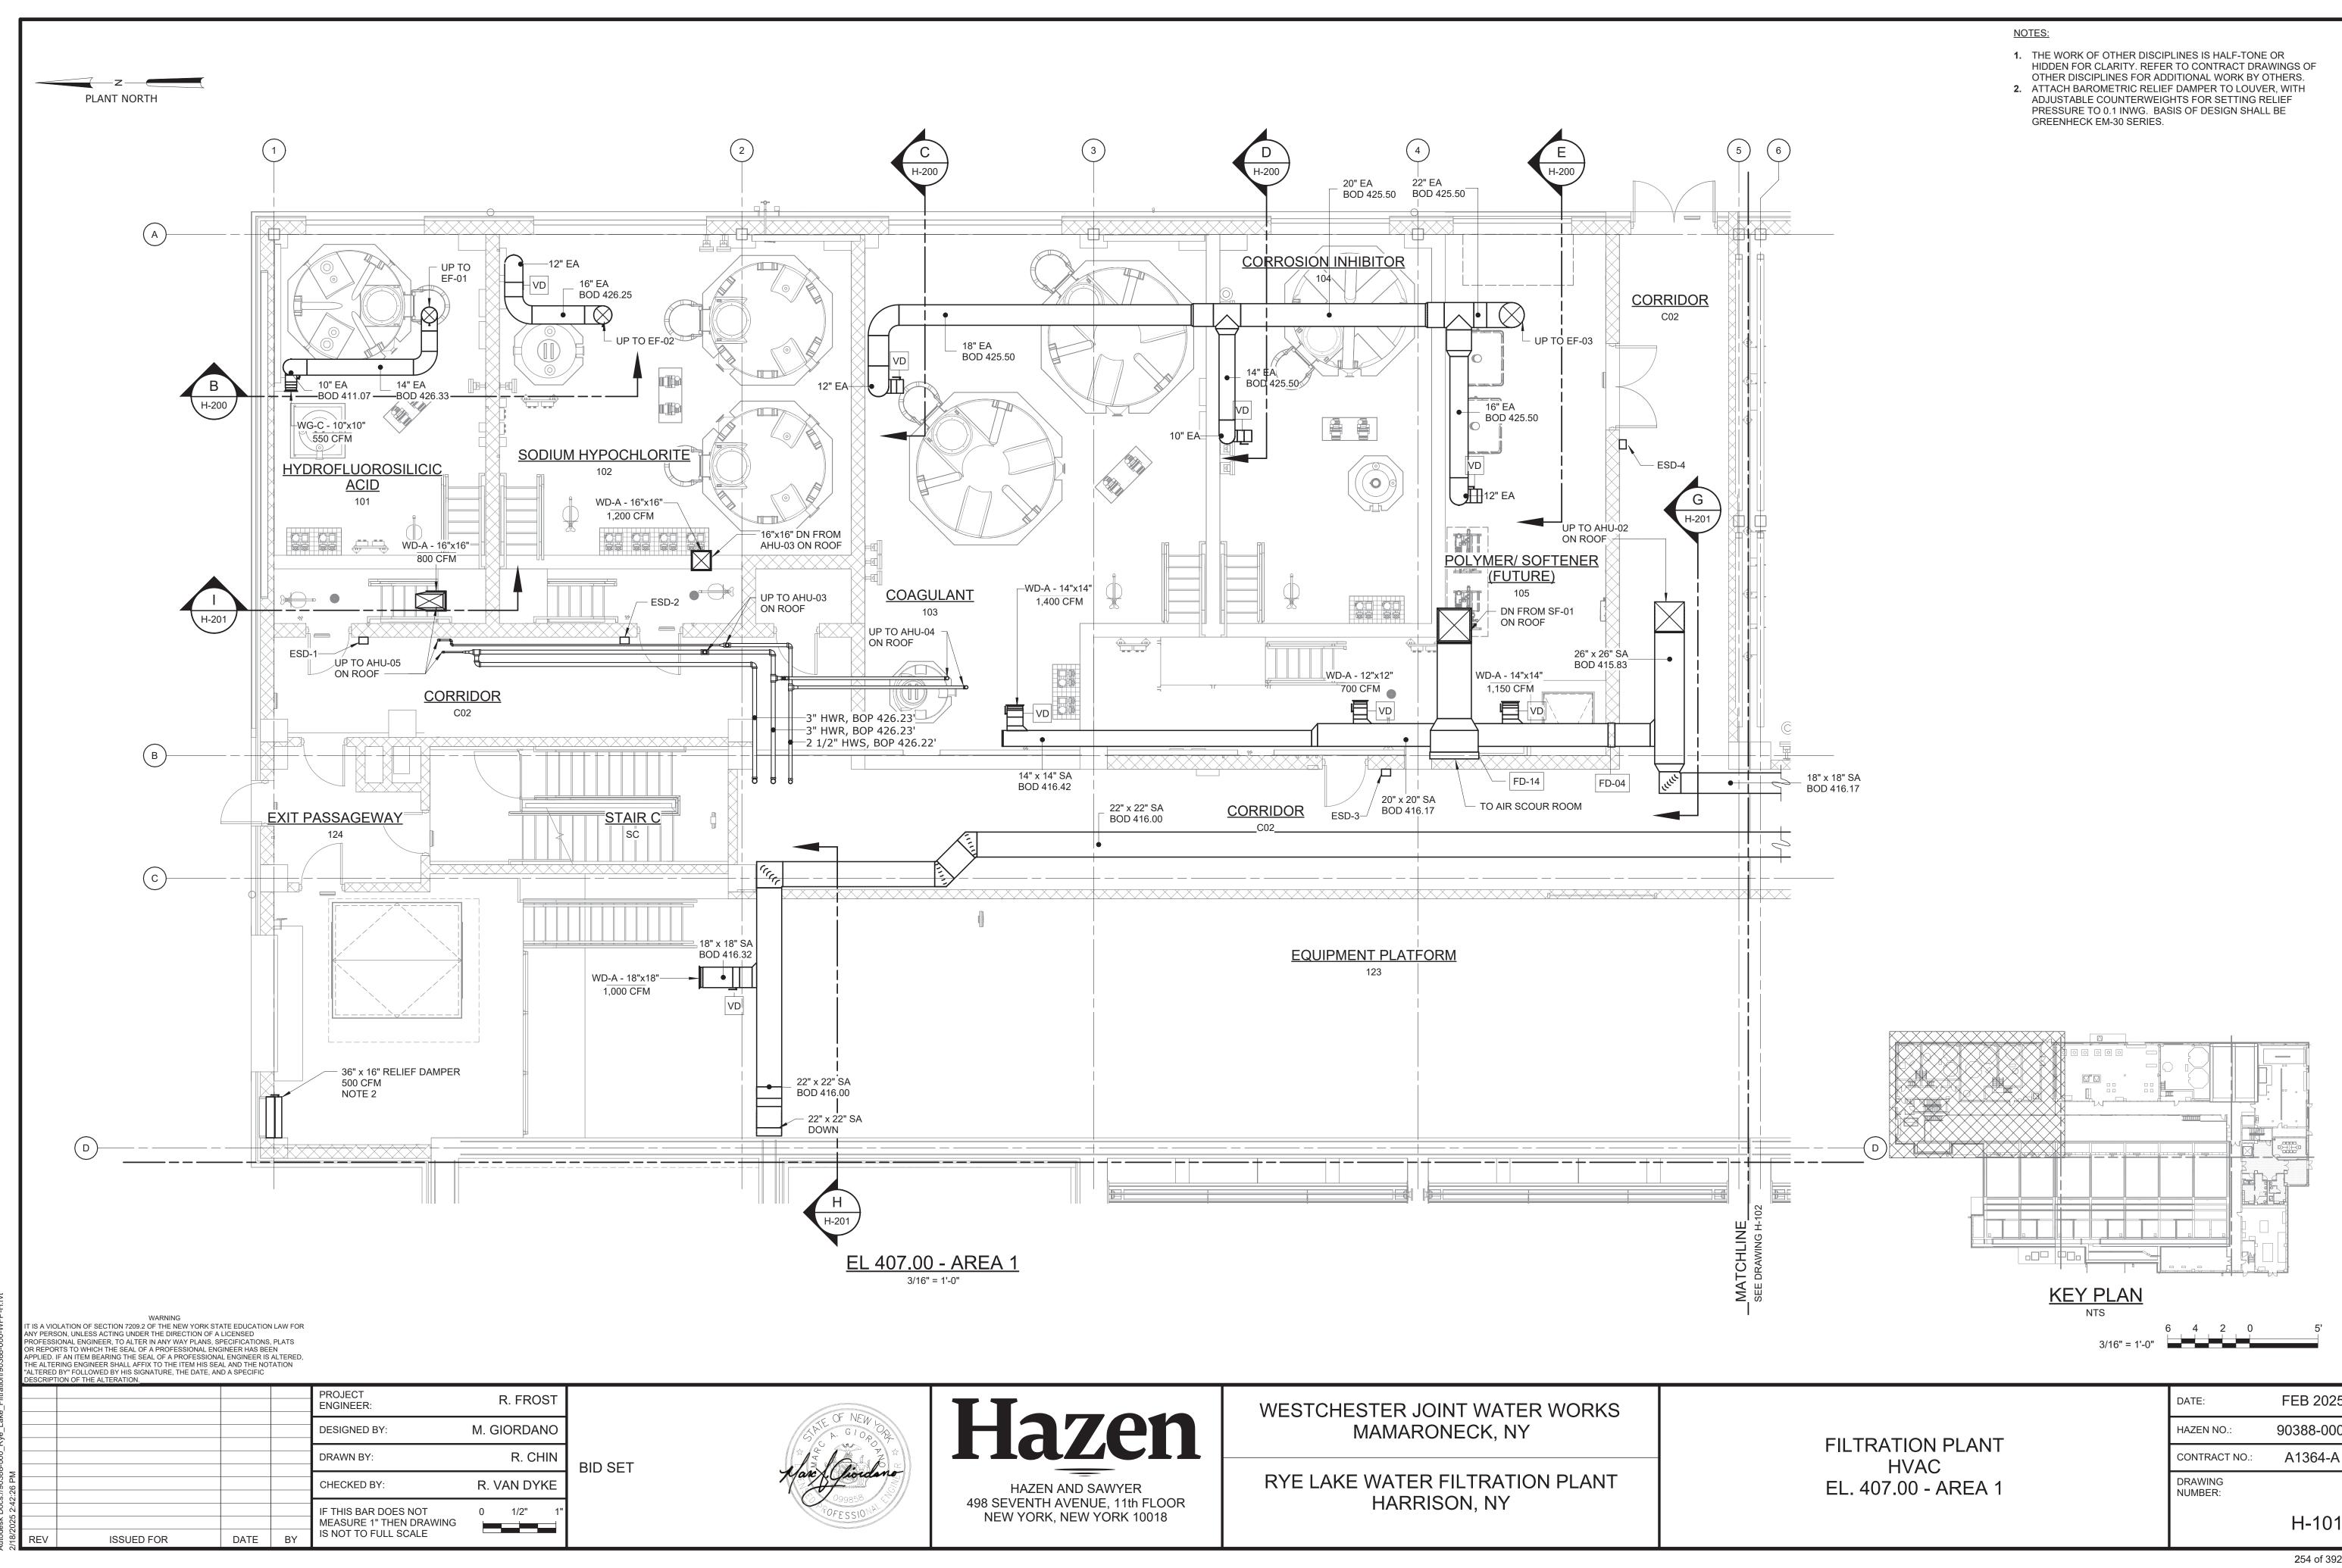

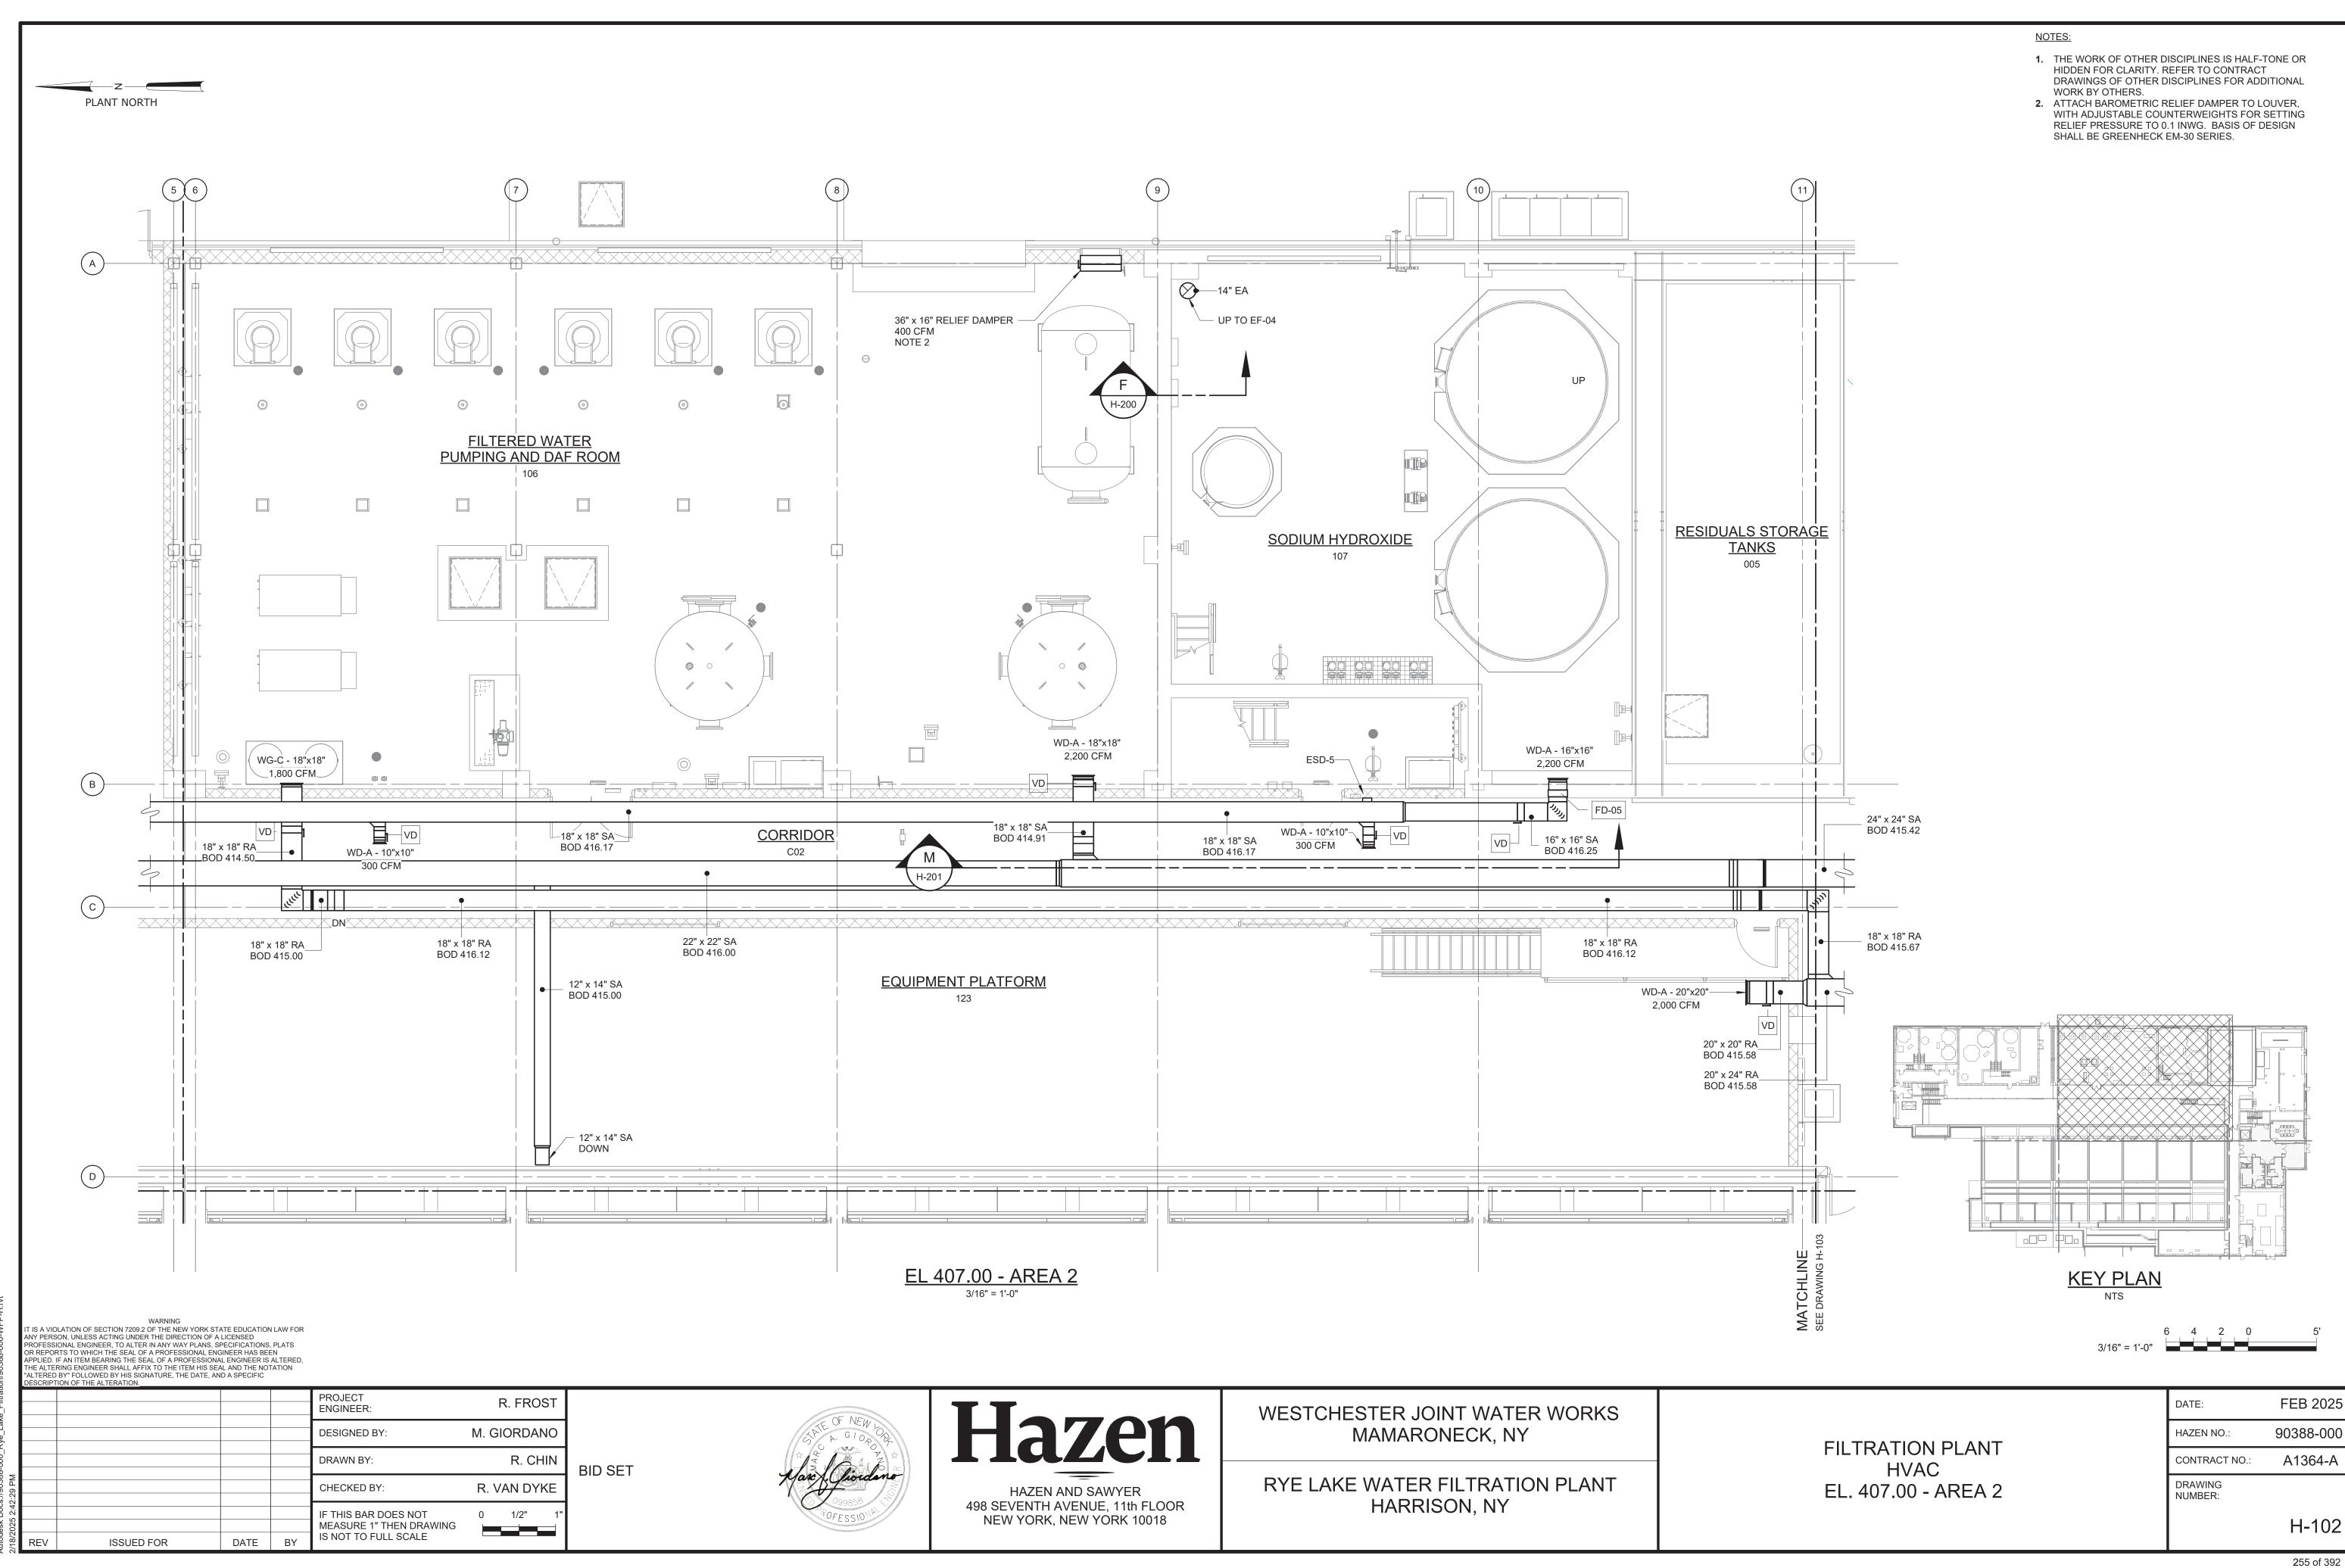

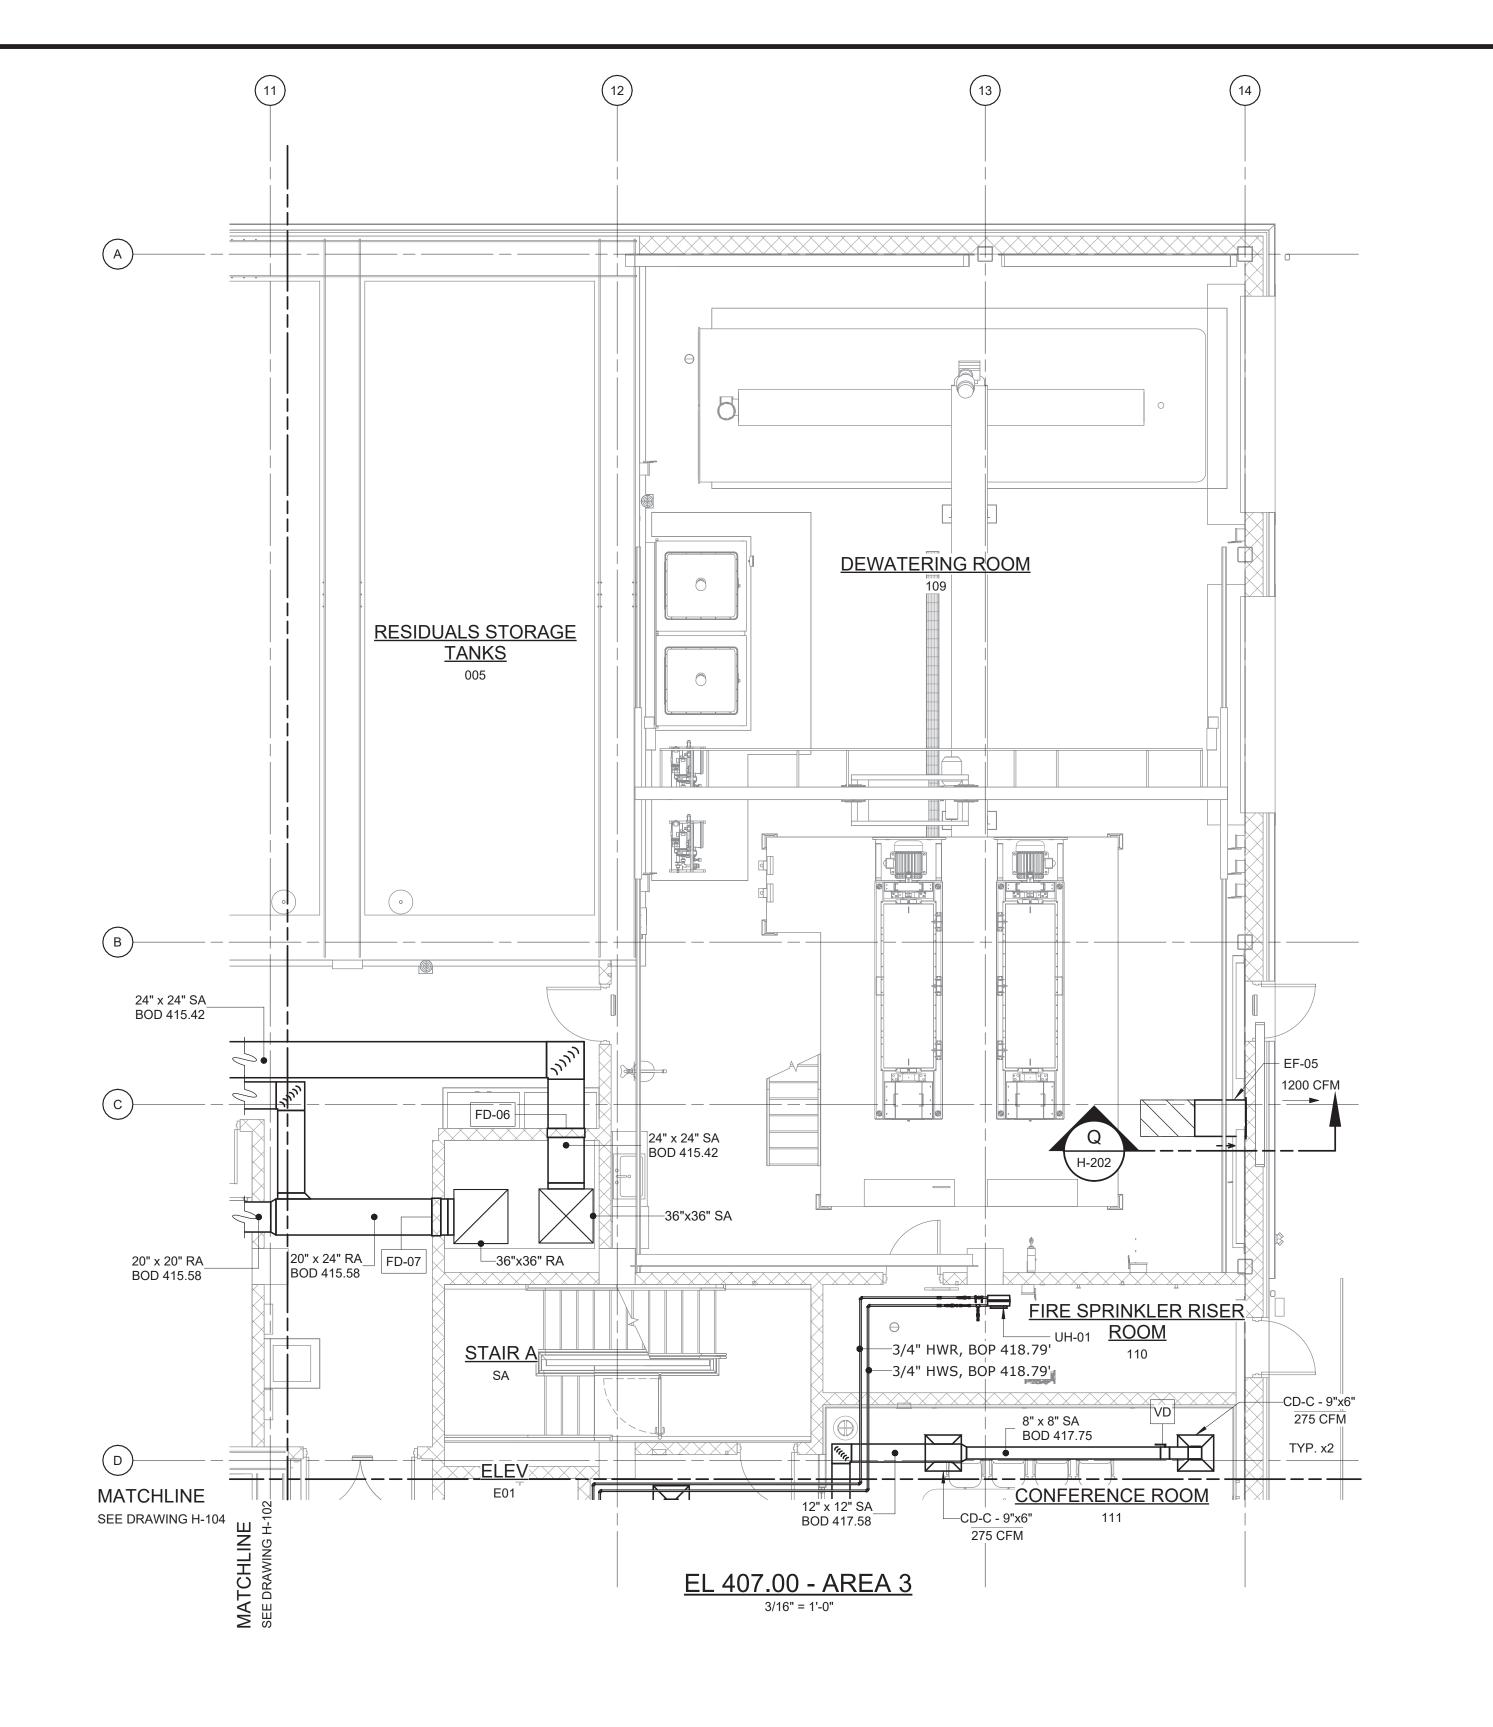

NOTES:

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- COORDINATE ALL CEILING DIFFUSERS WITH REFLECTED CEILING PLAN ON THE ARCHITECTURAL DRAWINGS.

KEY PLAN

6 4 2 0

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PLANT NORTH

	DESCRIPT	TION OF THE ALTERATION.						
					PROJECT ENGINEER:		R. FRO	ST
					DESIGNED BY:	M. G	IORDAI	NO
					DRAWN BY:		R. CH	IIN
2:42:33 PM					CHECKED BY:	R. V	'AN DYI	KE
18/2025 2:42					IF THIS BAR DOES NOT MEASURE 1" THEN DRAWING	0	1/2"	1"
18/2	REV	ISSUED FOR	DATE	BY	IS NOT TO FULL SCALE			

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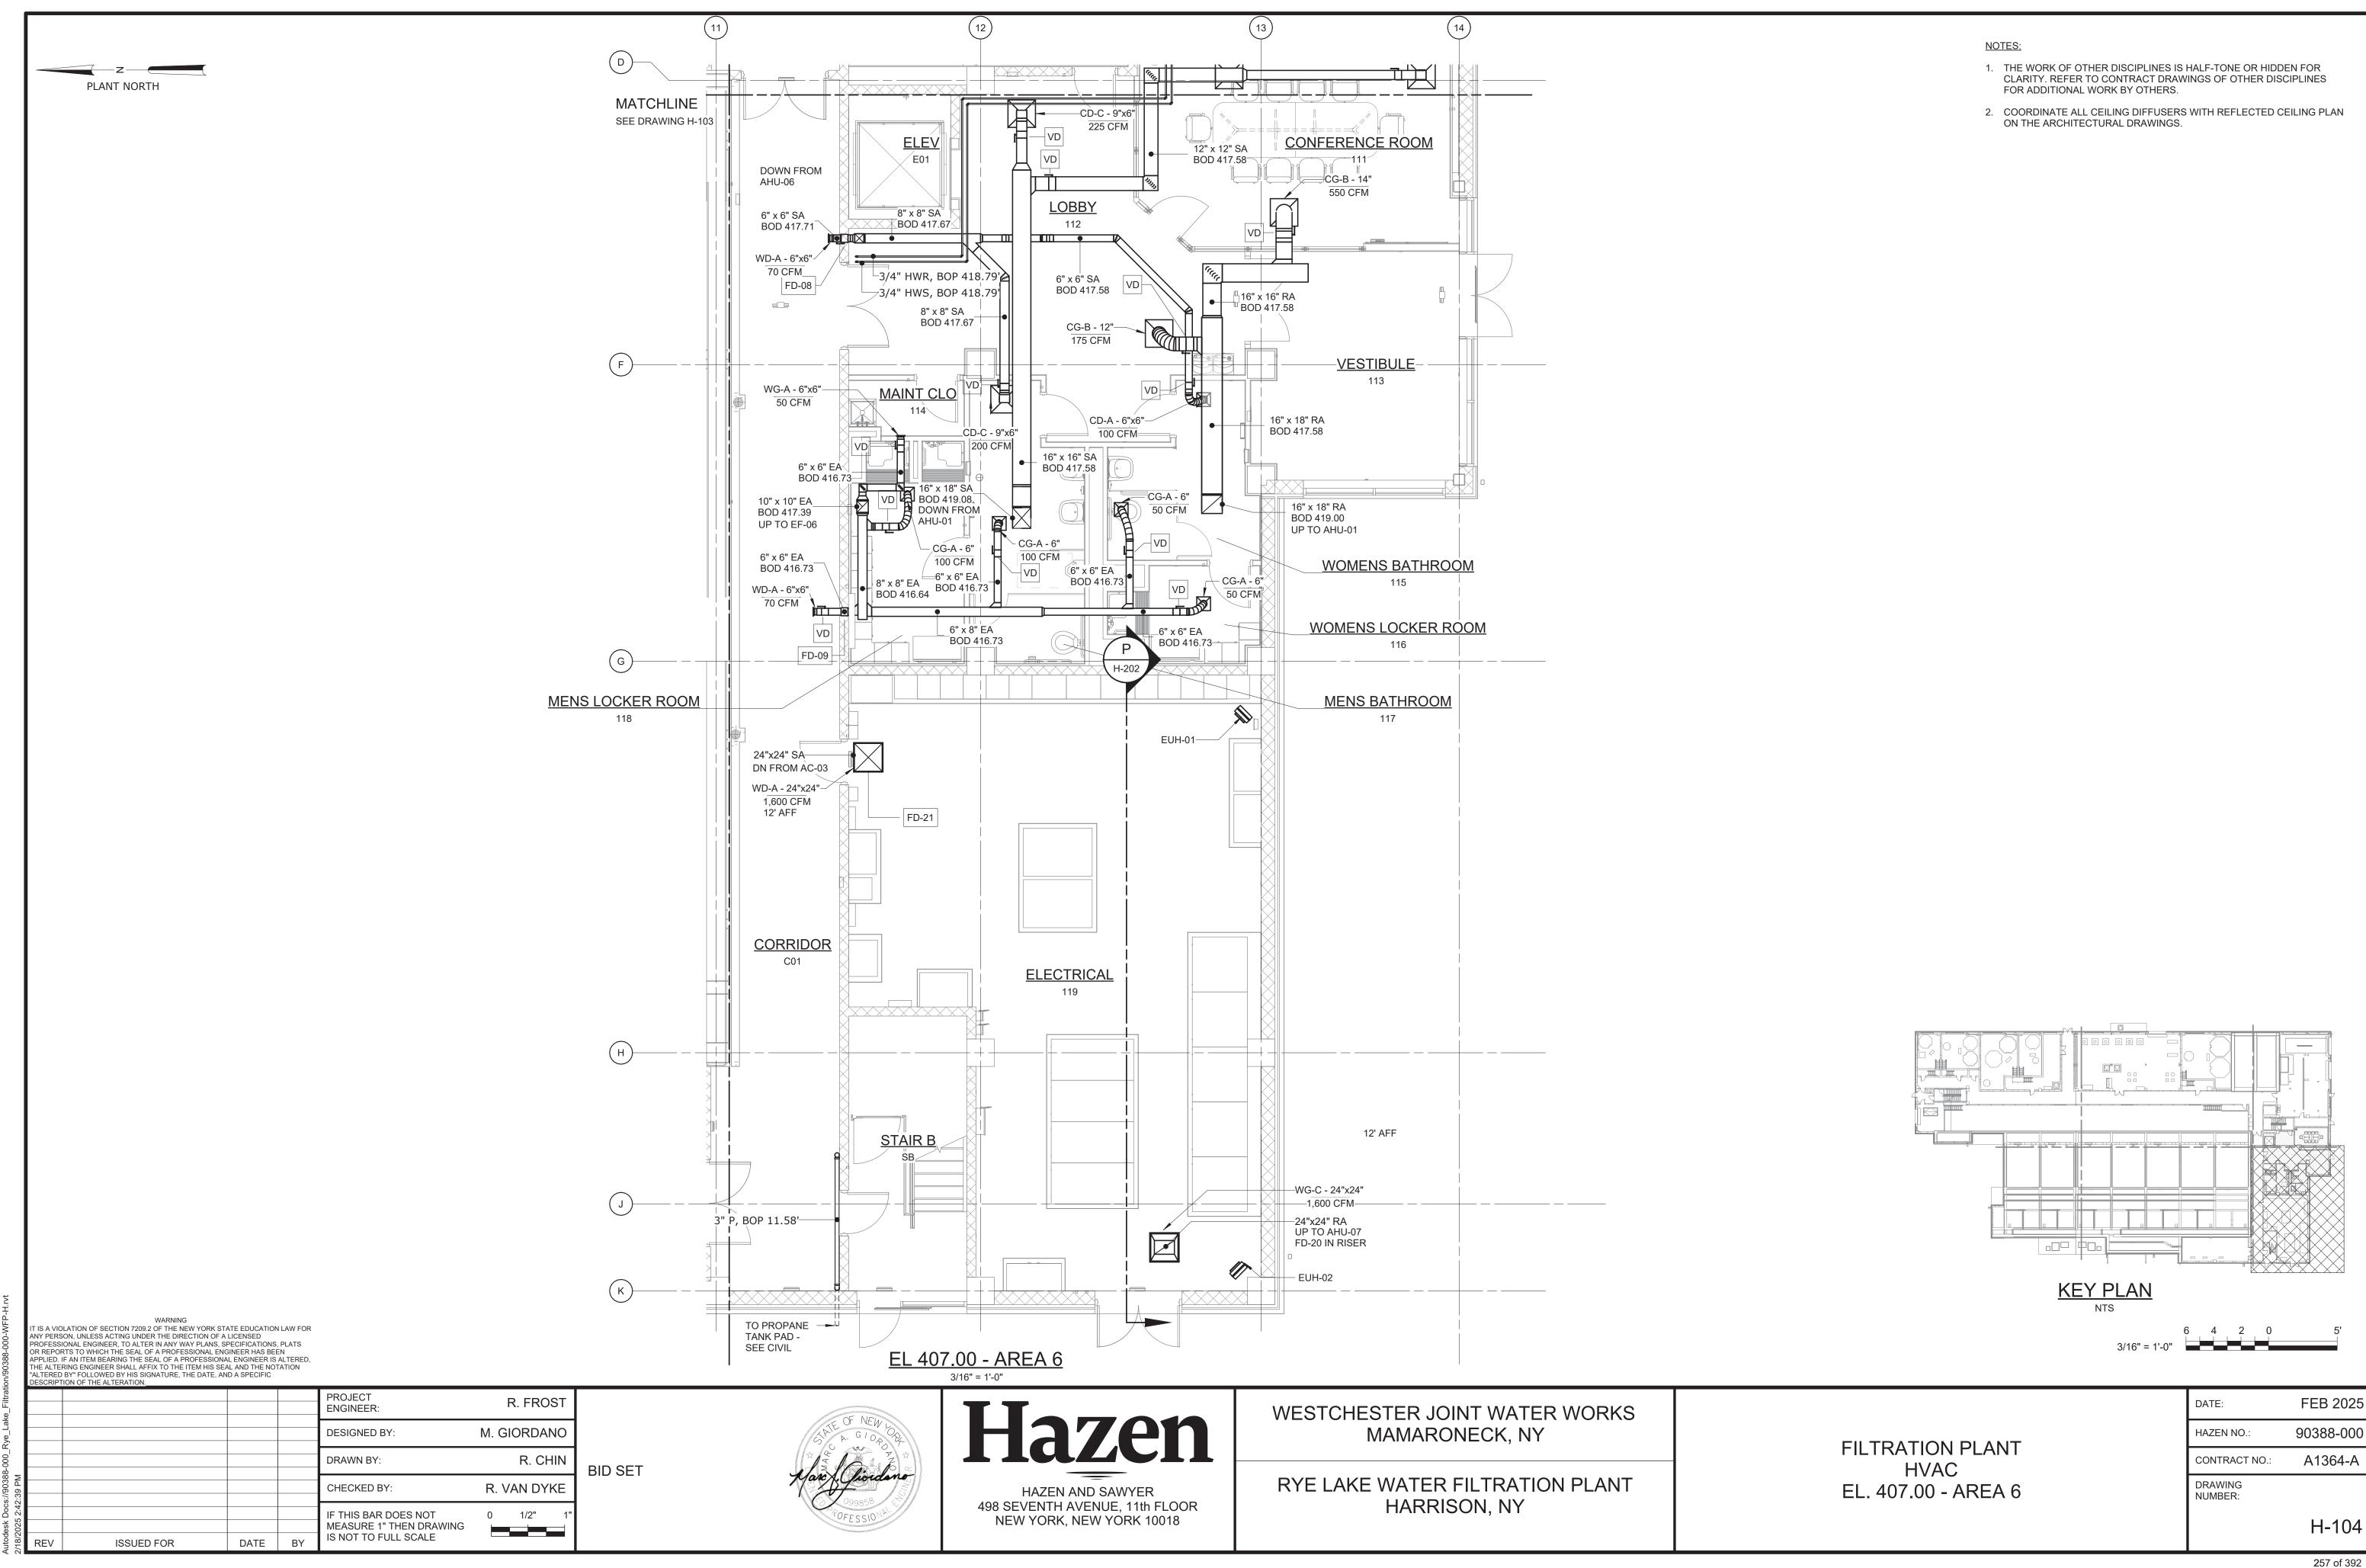
HAZEN AND SAWYER
498 SEVENTH AVENUE, 11th FLOOR
NEW YORK, NEW YORK 10018


WESTCHESTER JOINT WATER WORKS MAMARONECK, NY


RYE LAKE WATER FILTRATION PLANT HARRISON, NY


FILTRATION PLANT HVAC EL. 407.00 - AREA 3

DATE:	FEB 2025
HAZEN NO.:	90388-000
CONTRACT NO.:	A1364-A
DRAWING NUMBER:	
	H-103



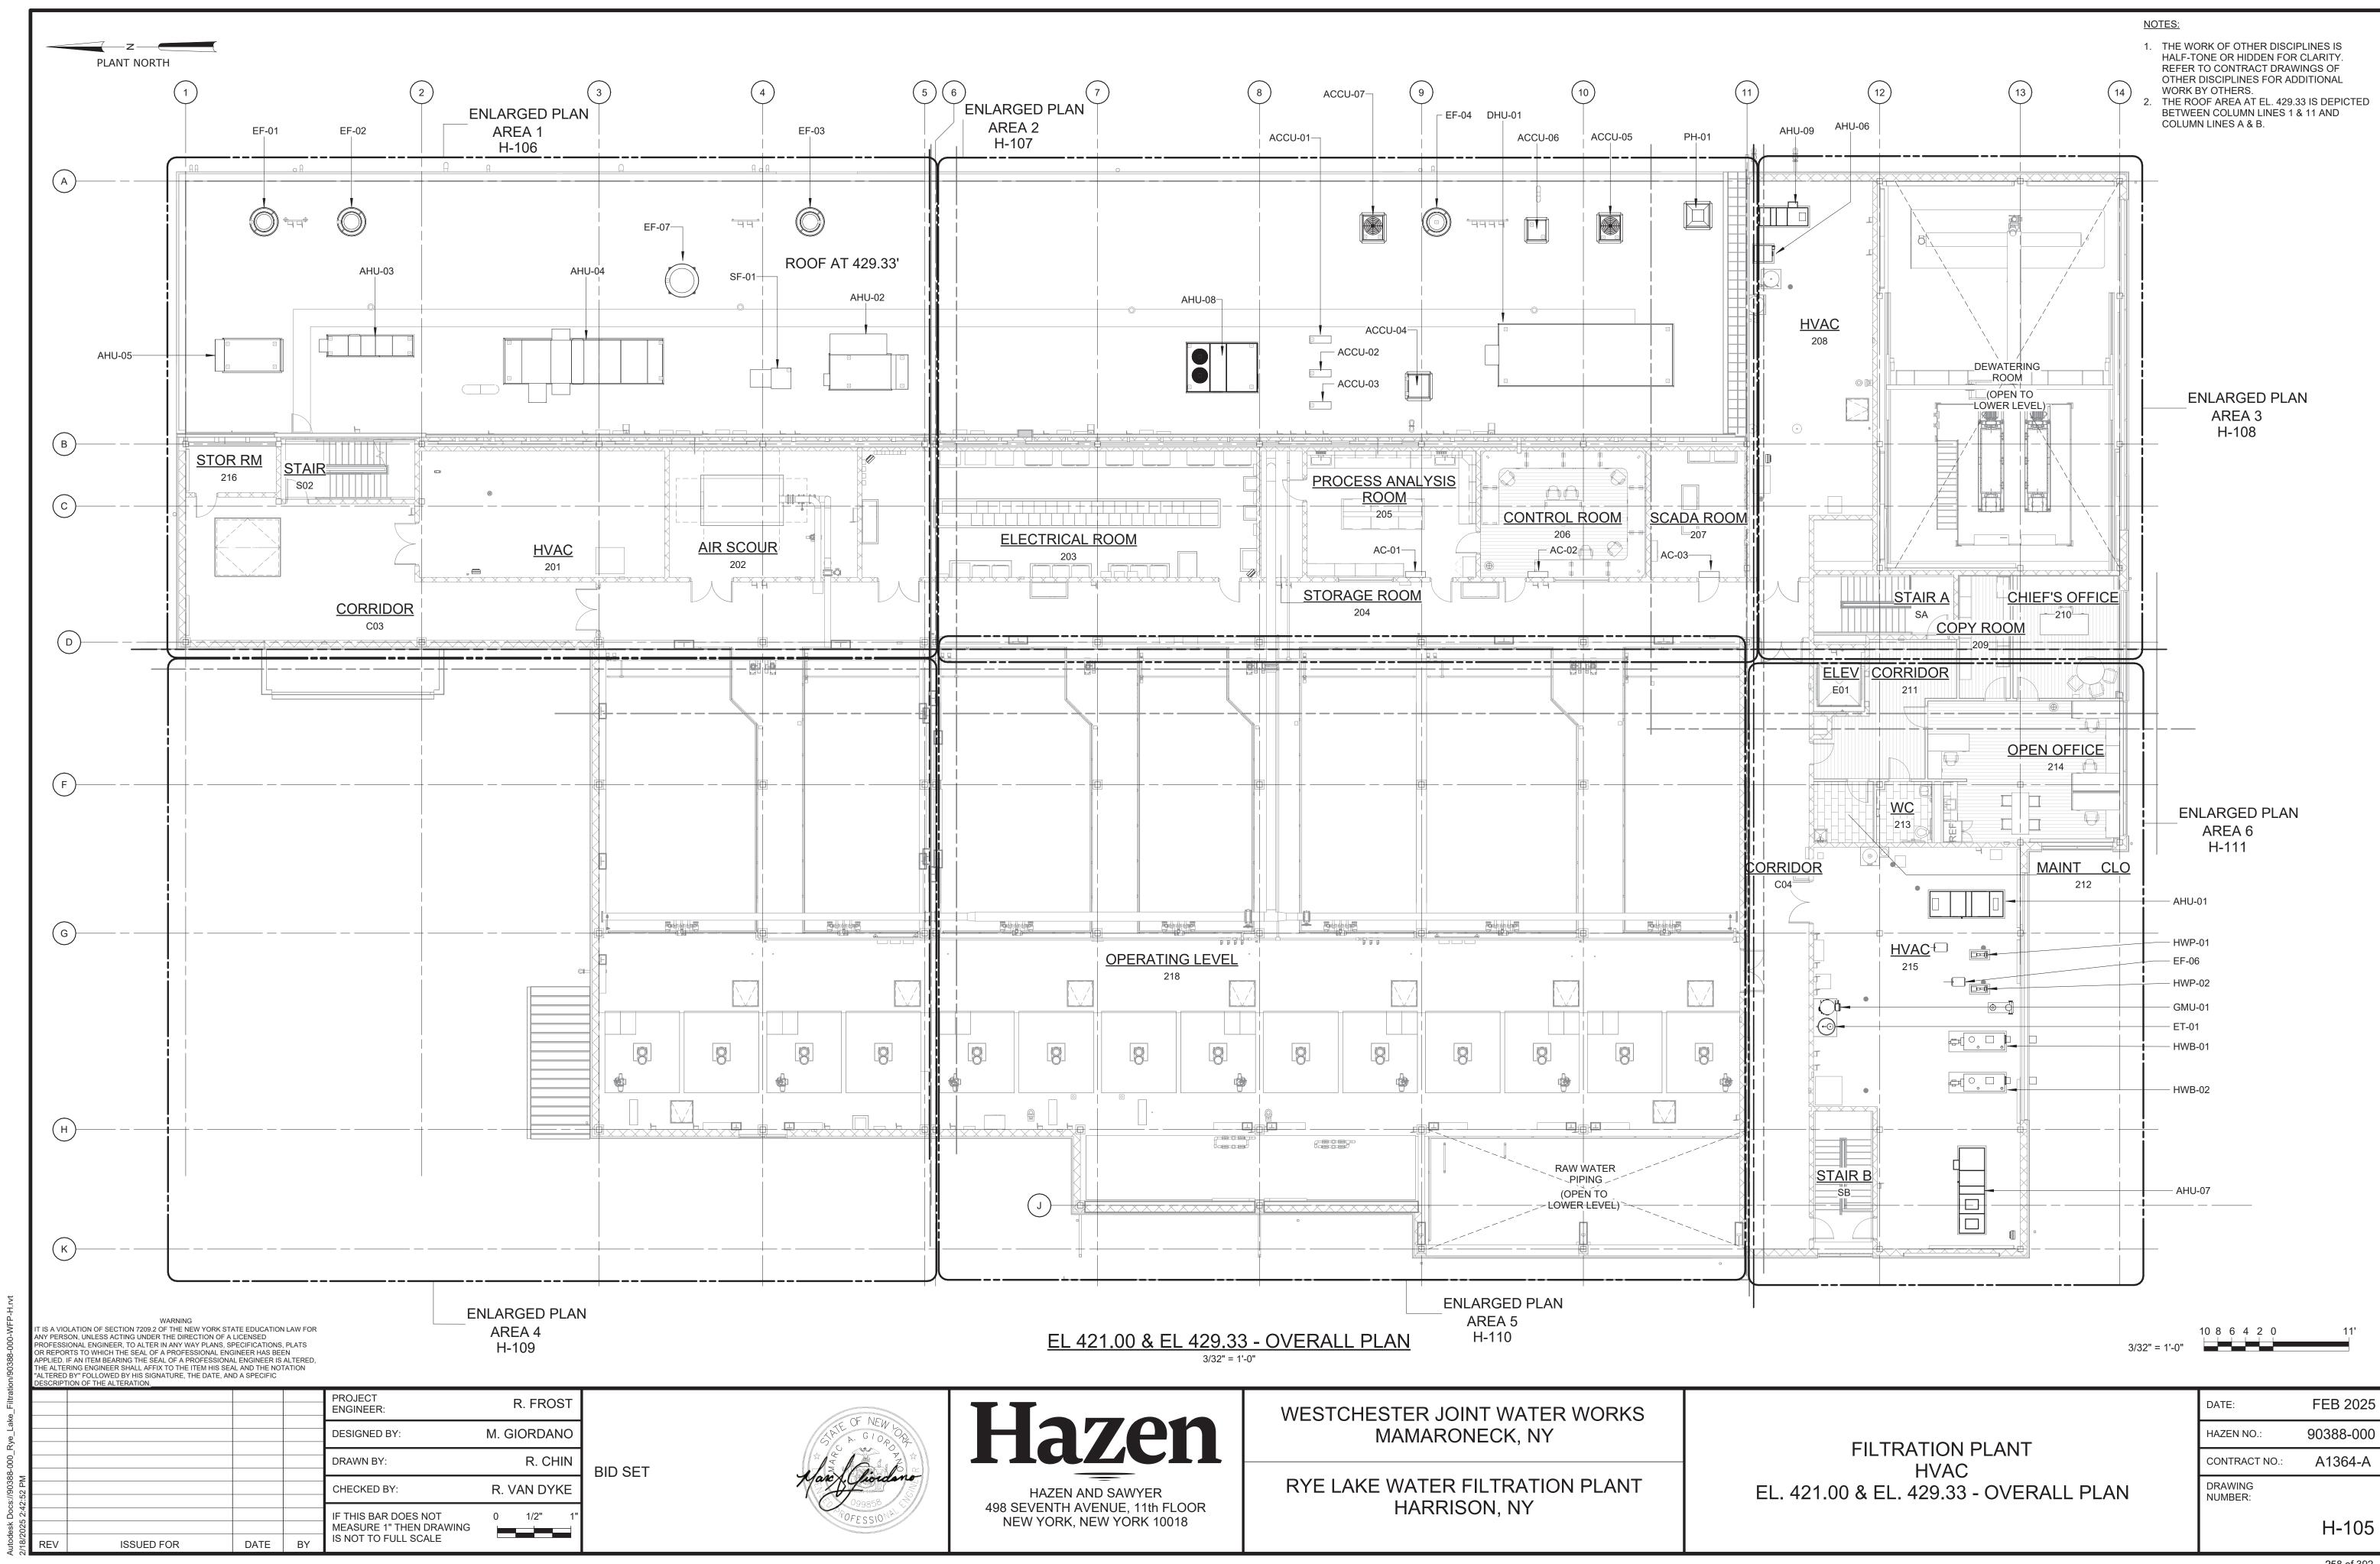


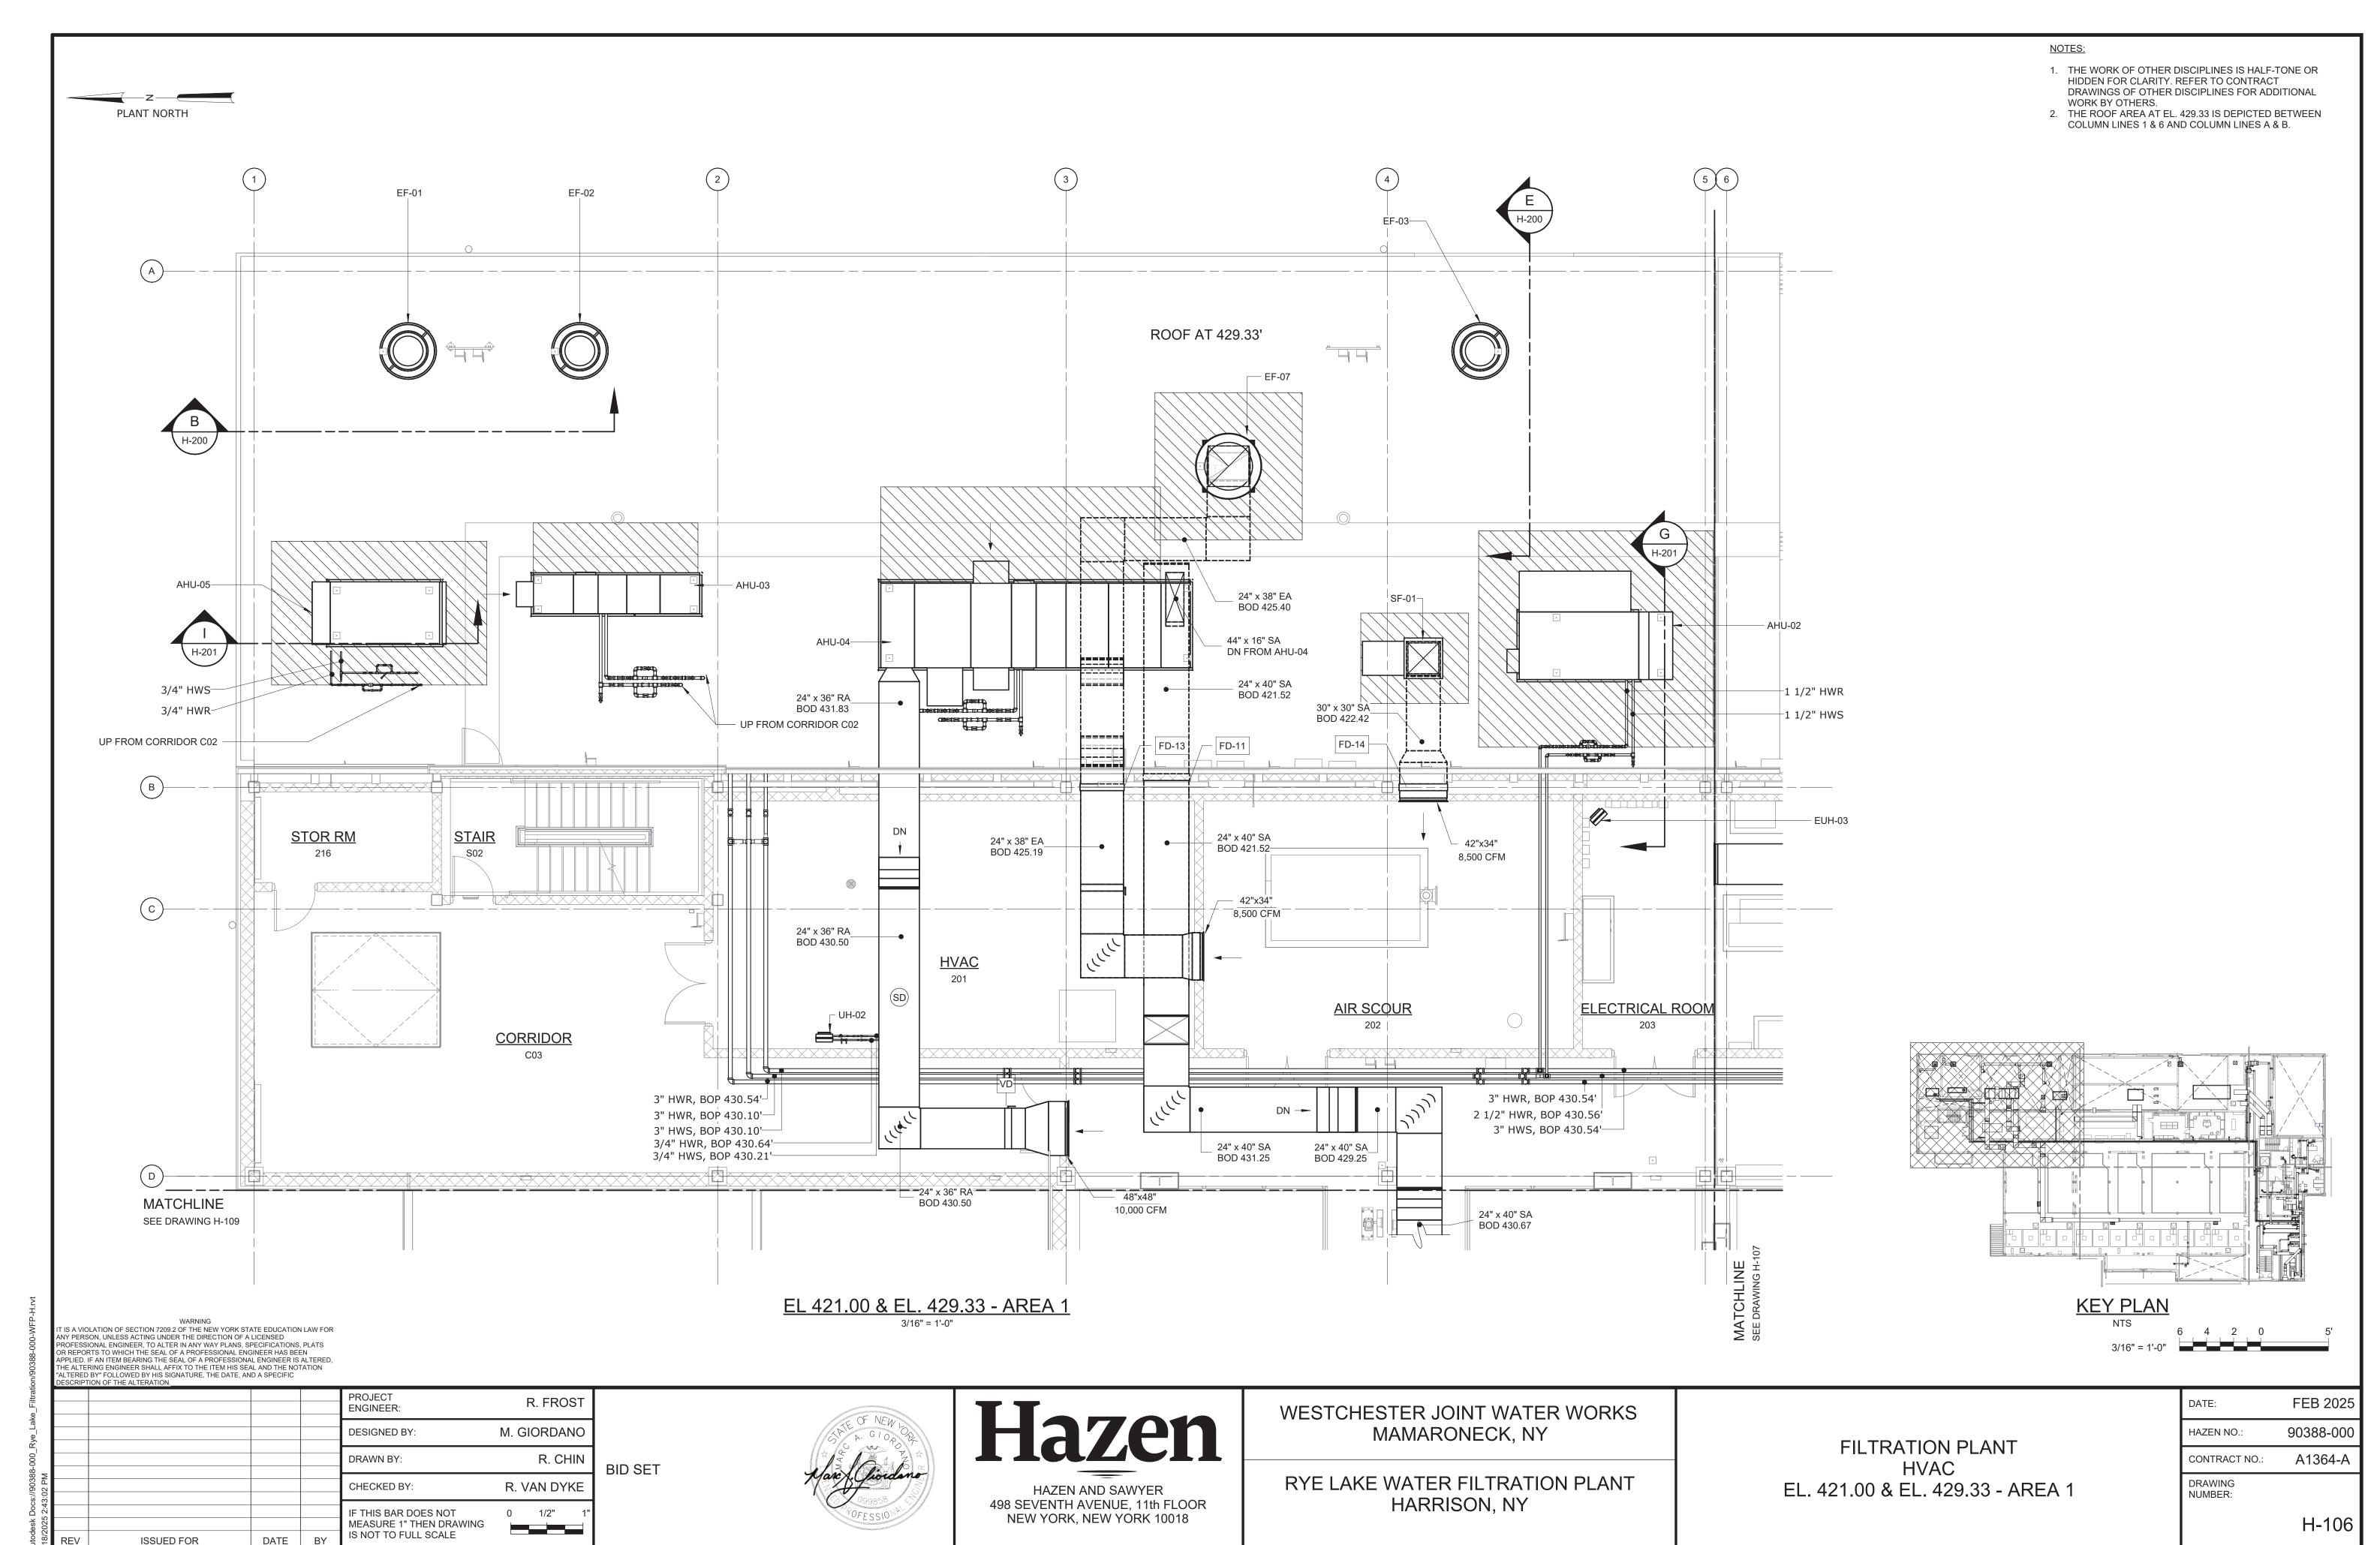


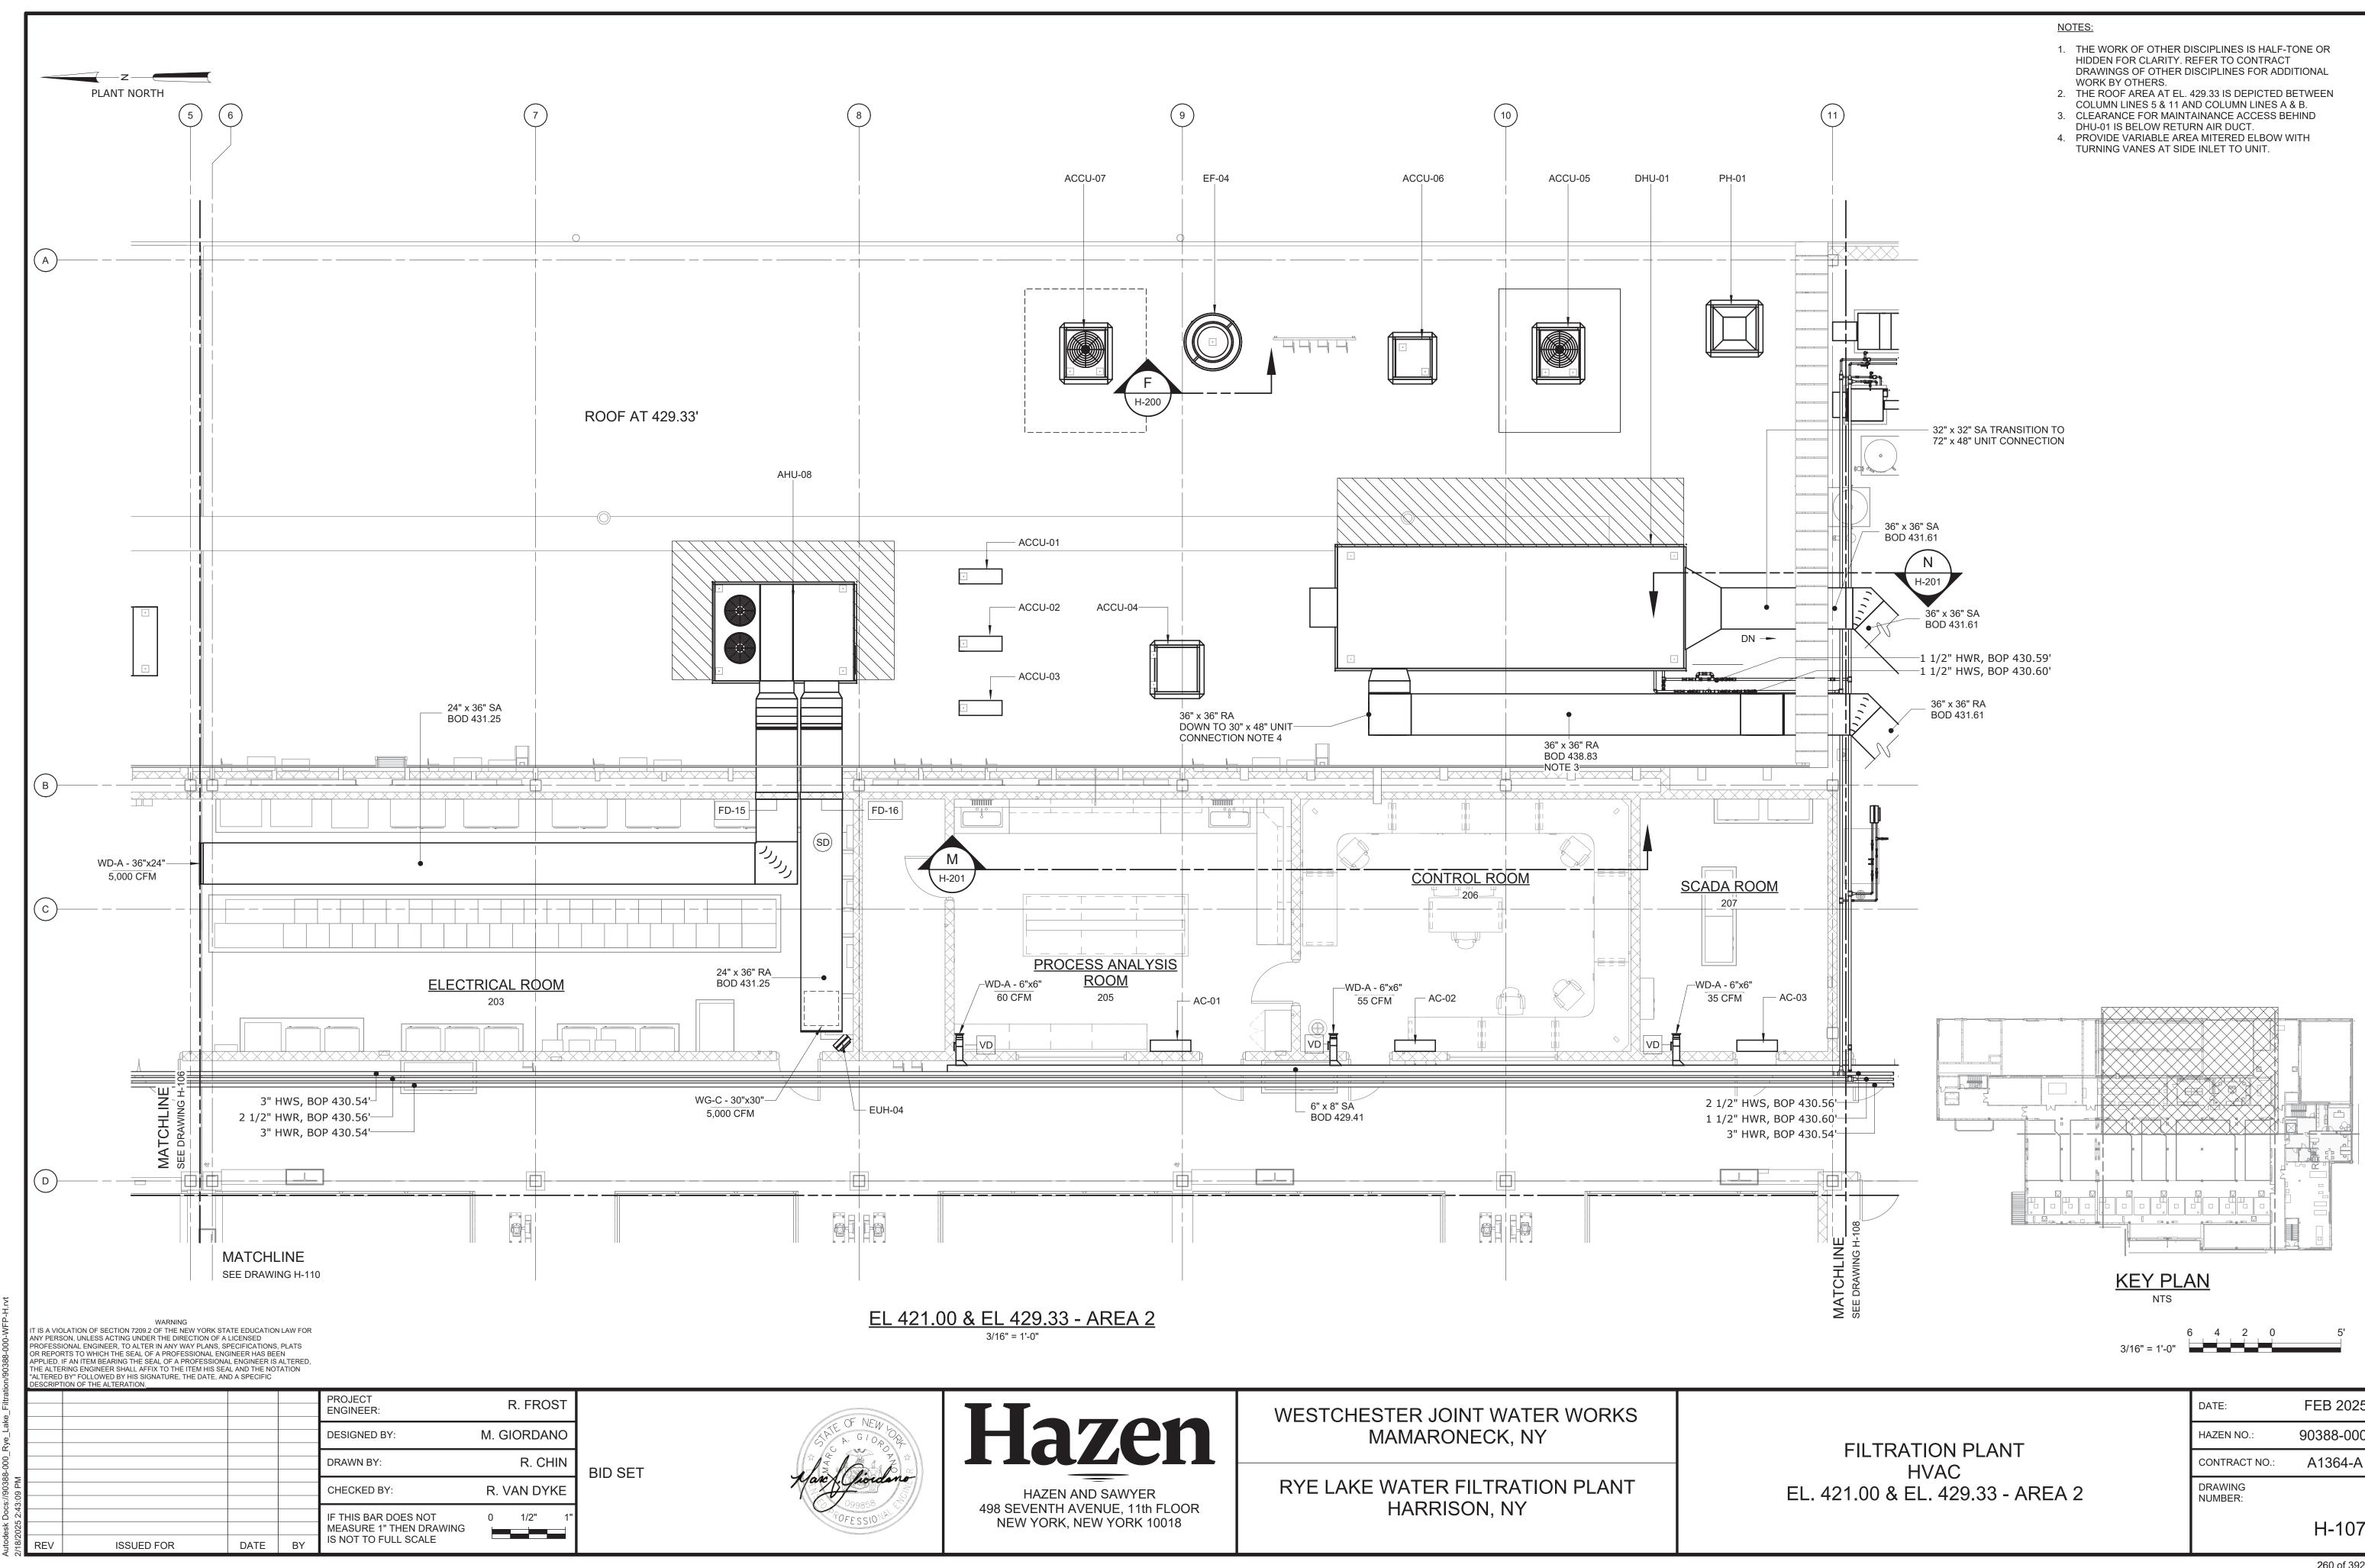

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PLANT NORTH

2		TION OF THE ALTERATION.	AND A SPECIFIC				
					PROJECT ENGINEER:	R. FROST	
, ye					DESIGNED BY:	M. GIORDANO	
					DRAWN BY:	R. CHIN	BID SET
2:43:14 PM					CHECKED BY:	R. VAN DYKE	J.J 3
025 2:43					IF THIS BAR DOES NOT MEASURE 1" THEN DRAWING	0 1/2" 1"	
18/2025	REV	ISSUED FOR	DATE	BY	IS NOT TO FULL SCALE		

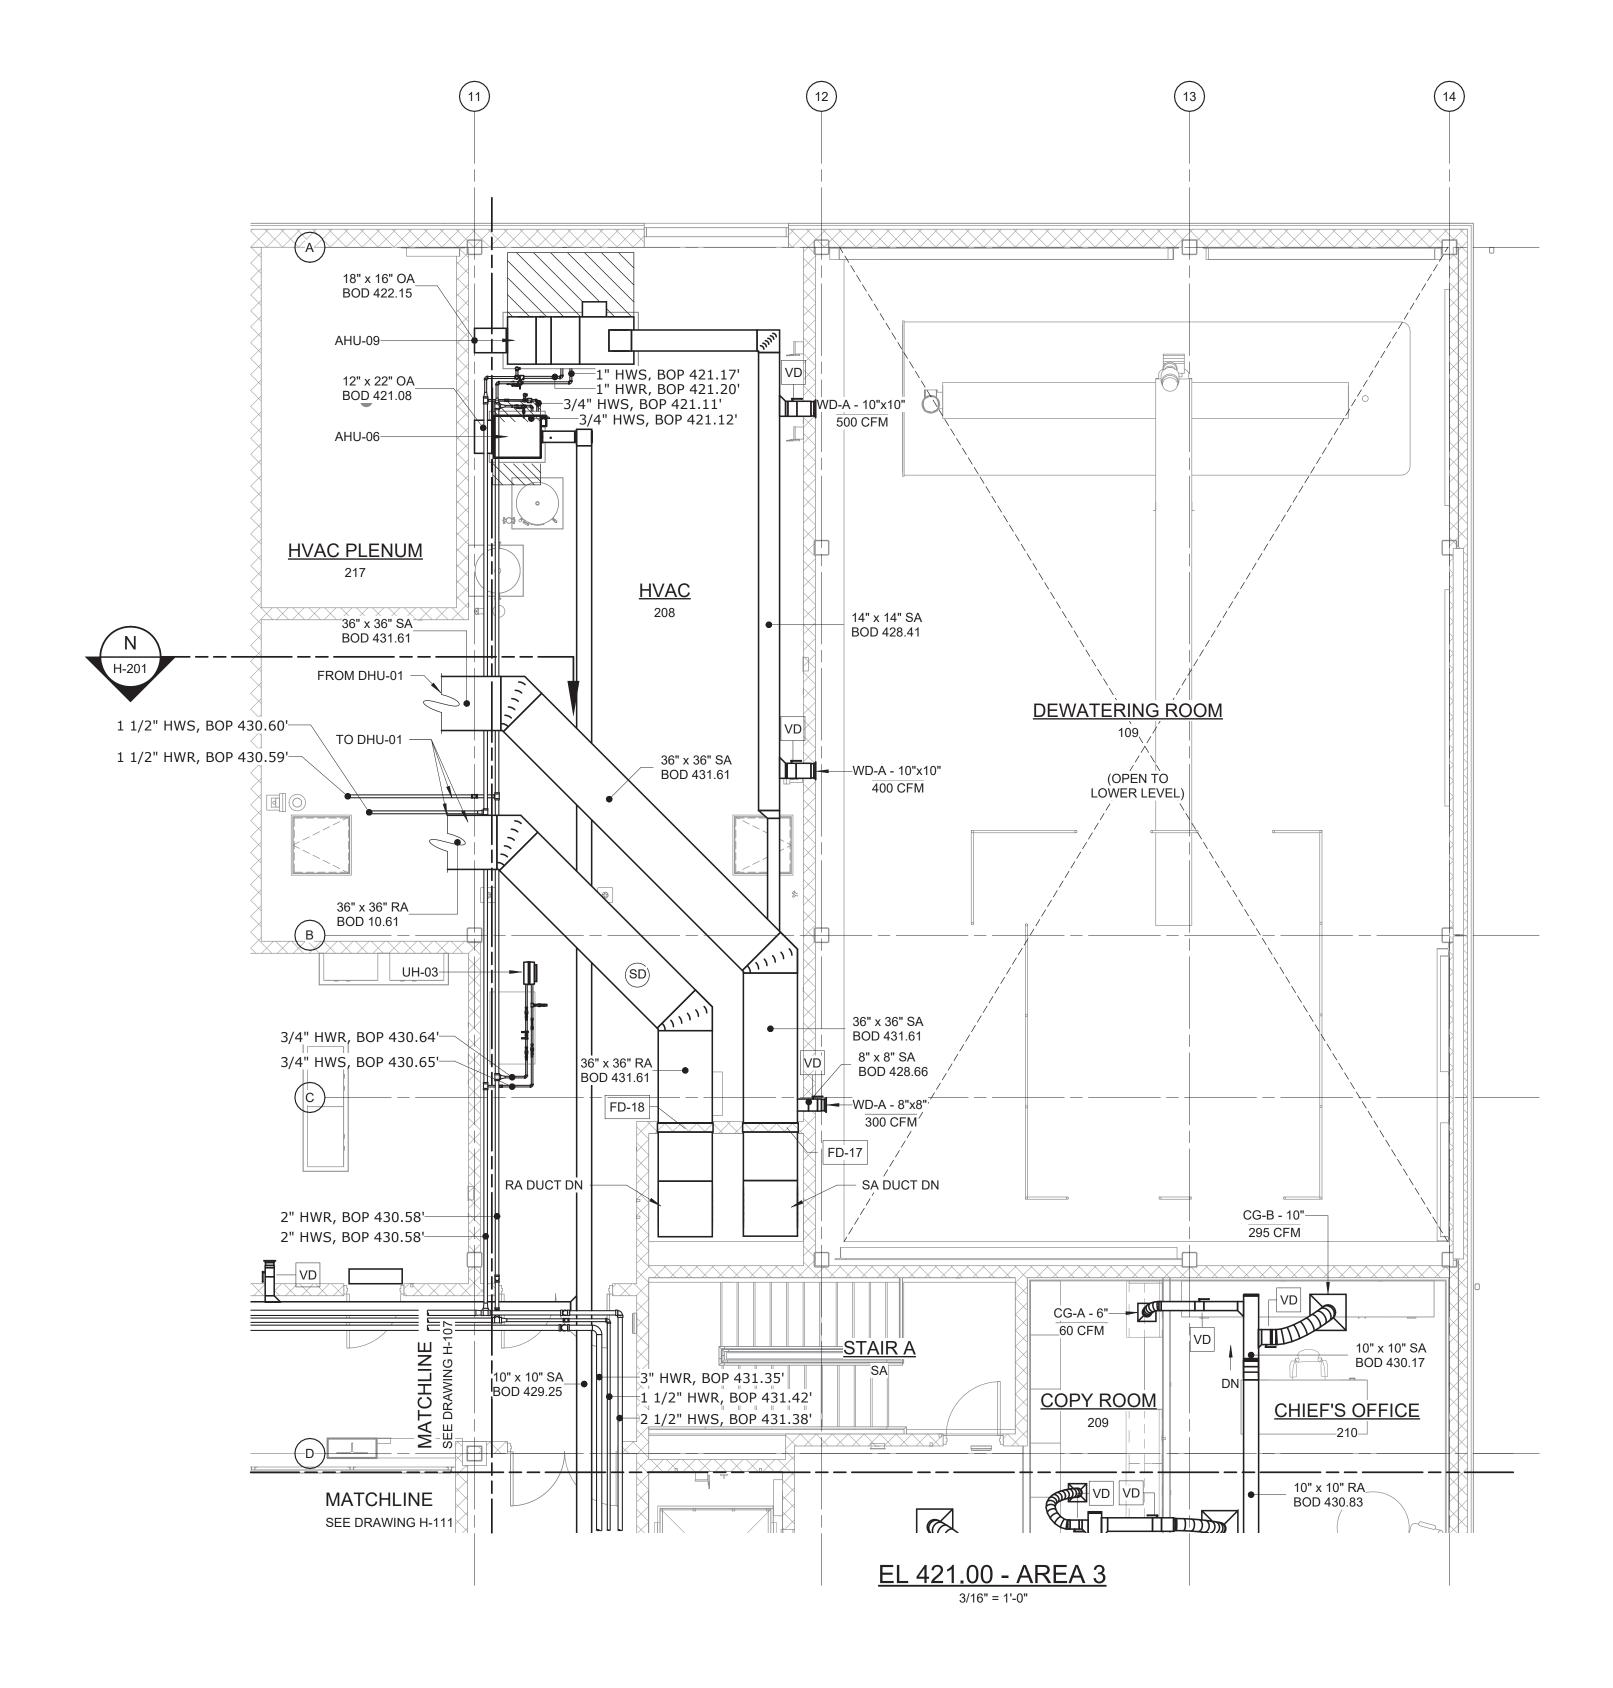
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498 SEVENTH AVENUE, 11th FLOOR

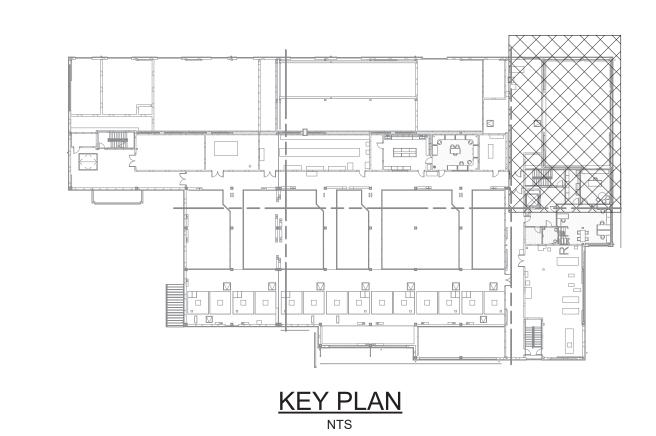
NEW YORK, NEW YORK 10018


WESTCHESTER JOINT WATER WORKS MAMARONECK, NY


RYE LAKE WATER FILTRATION PLANT HARRISON, NY FILTRATION PLANT HVAC EL. 421.00 - AREA 3


DATE:	FEB 2025
HAZEN NO.:	90388-000
CONTRACT NO.:	A1364-A
DRAWING NUMBER:	
	H-108

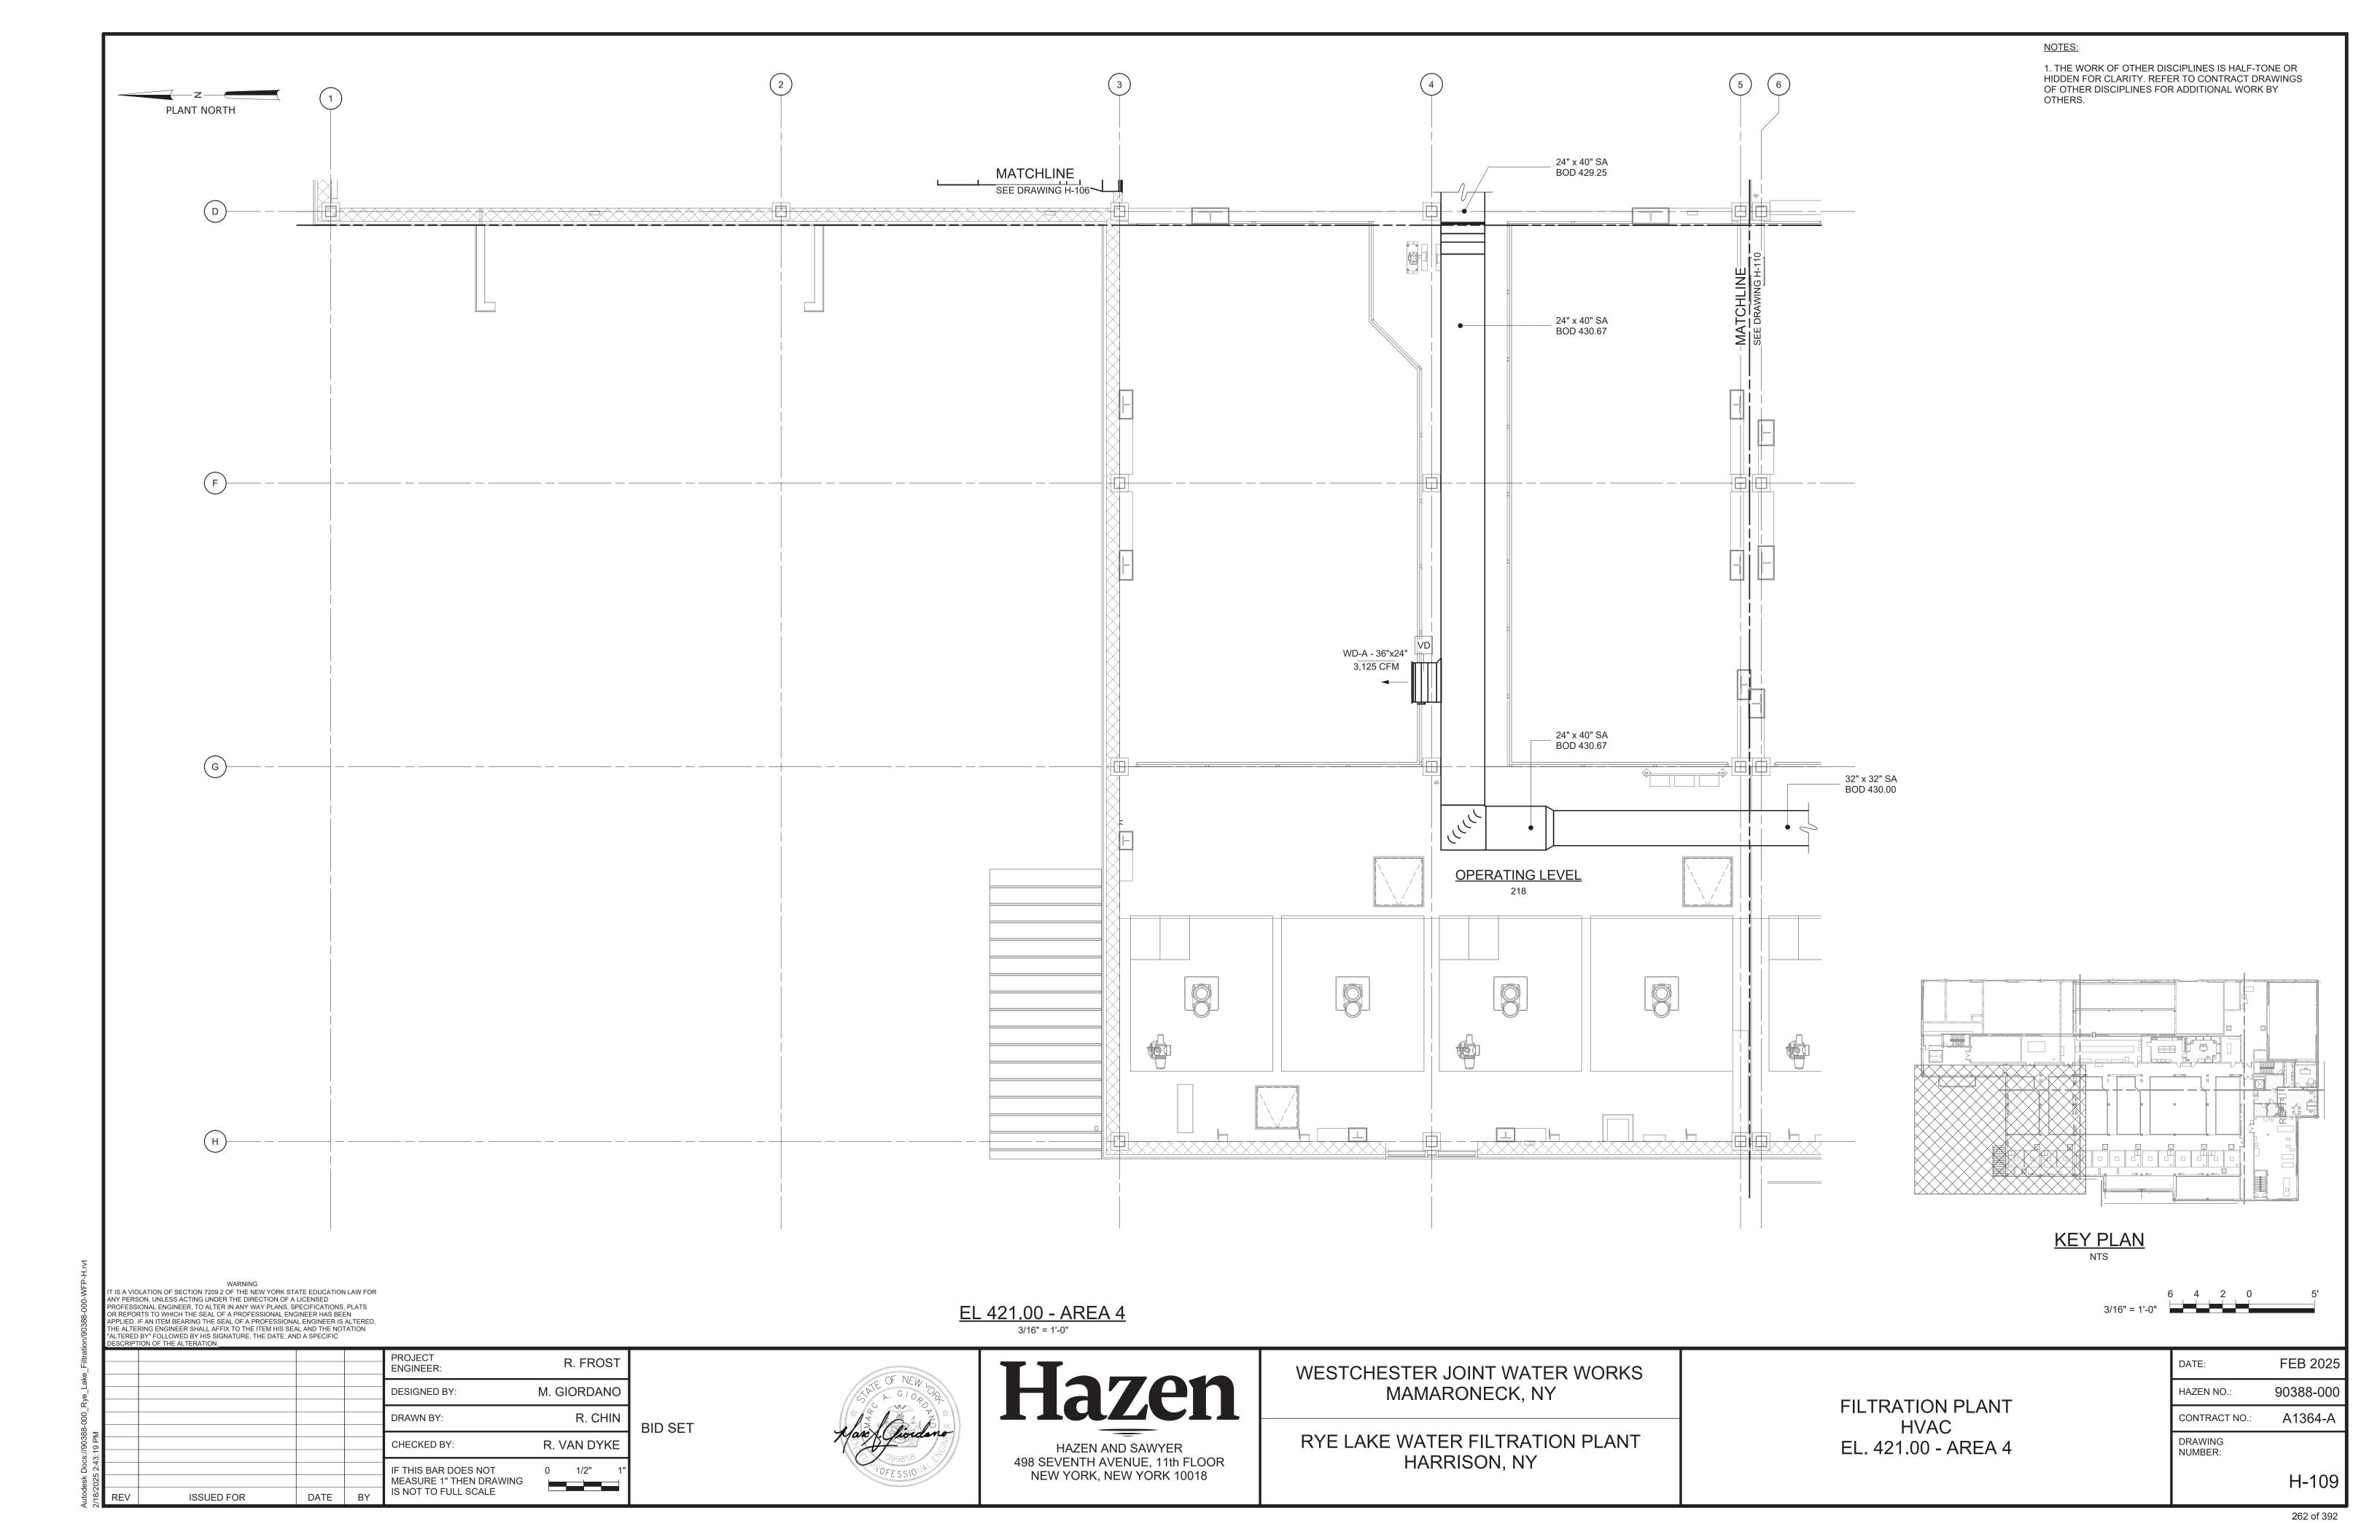


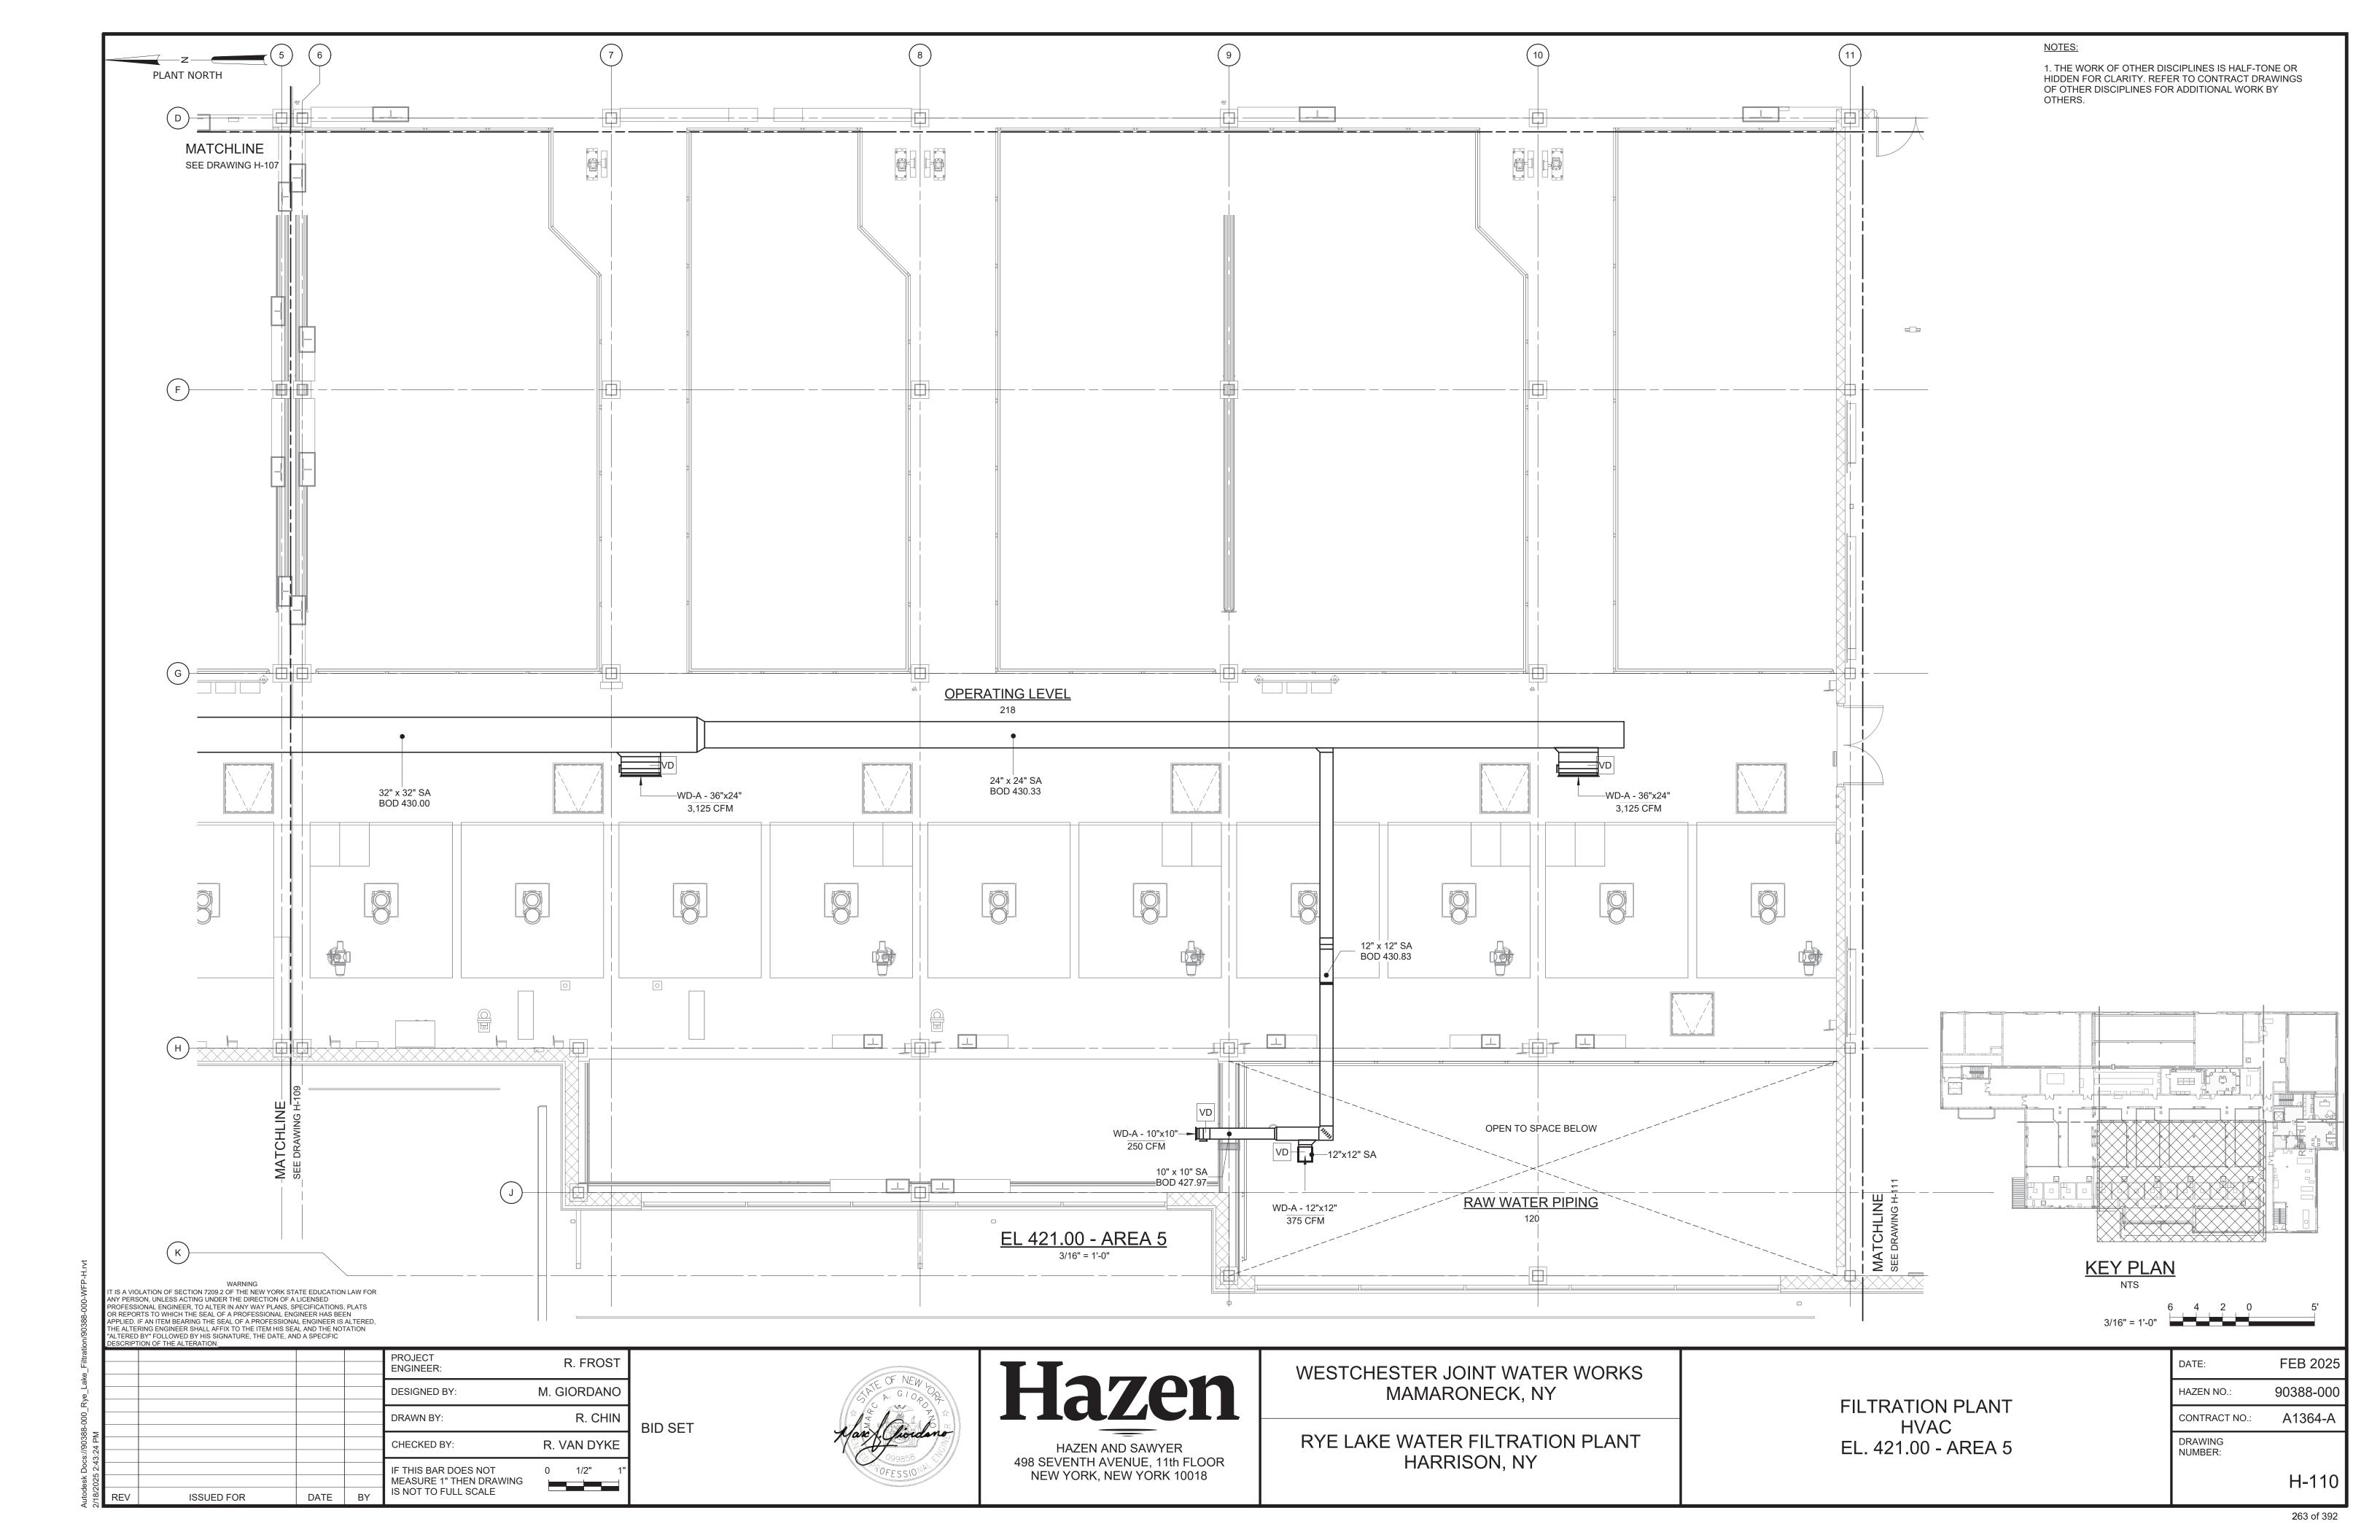

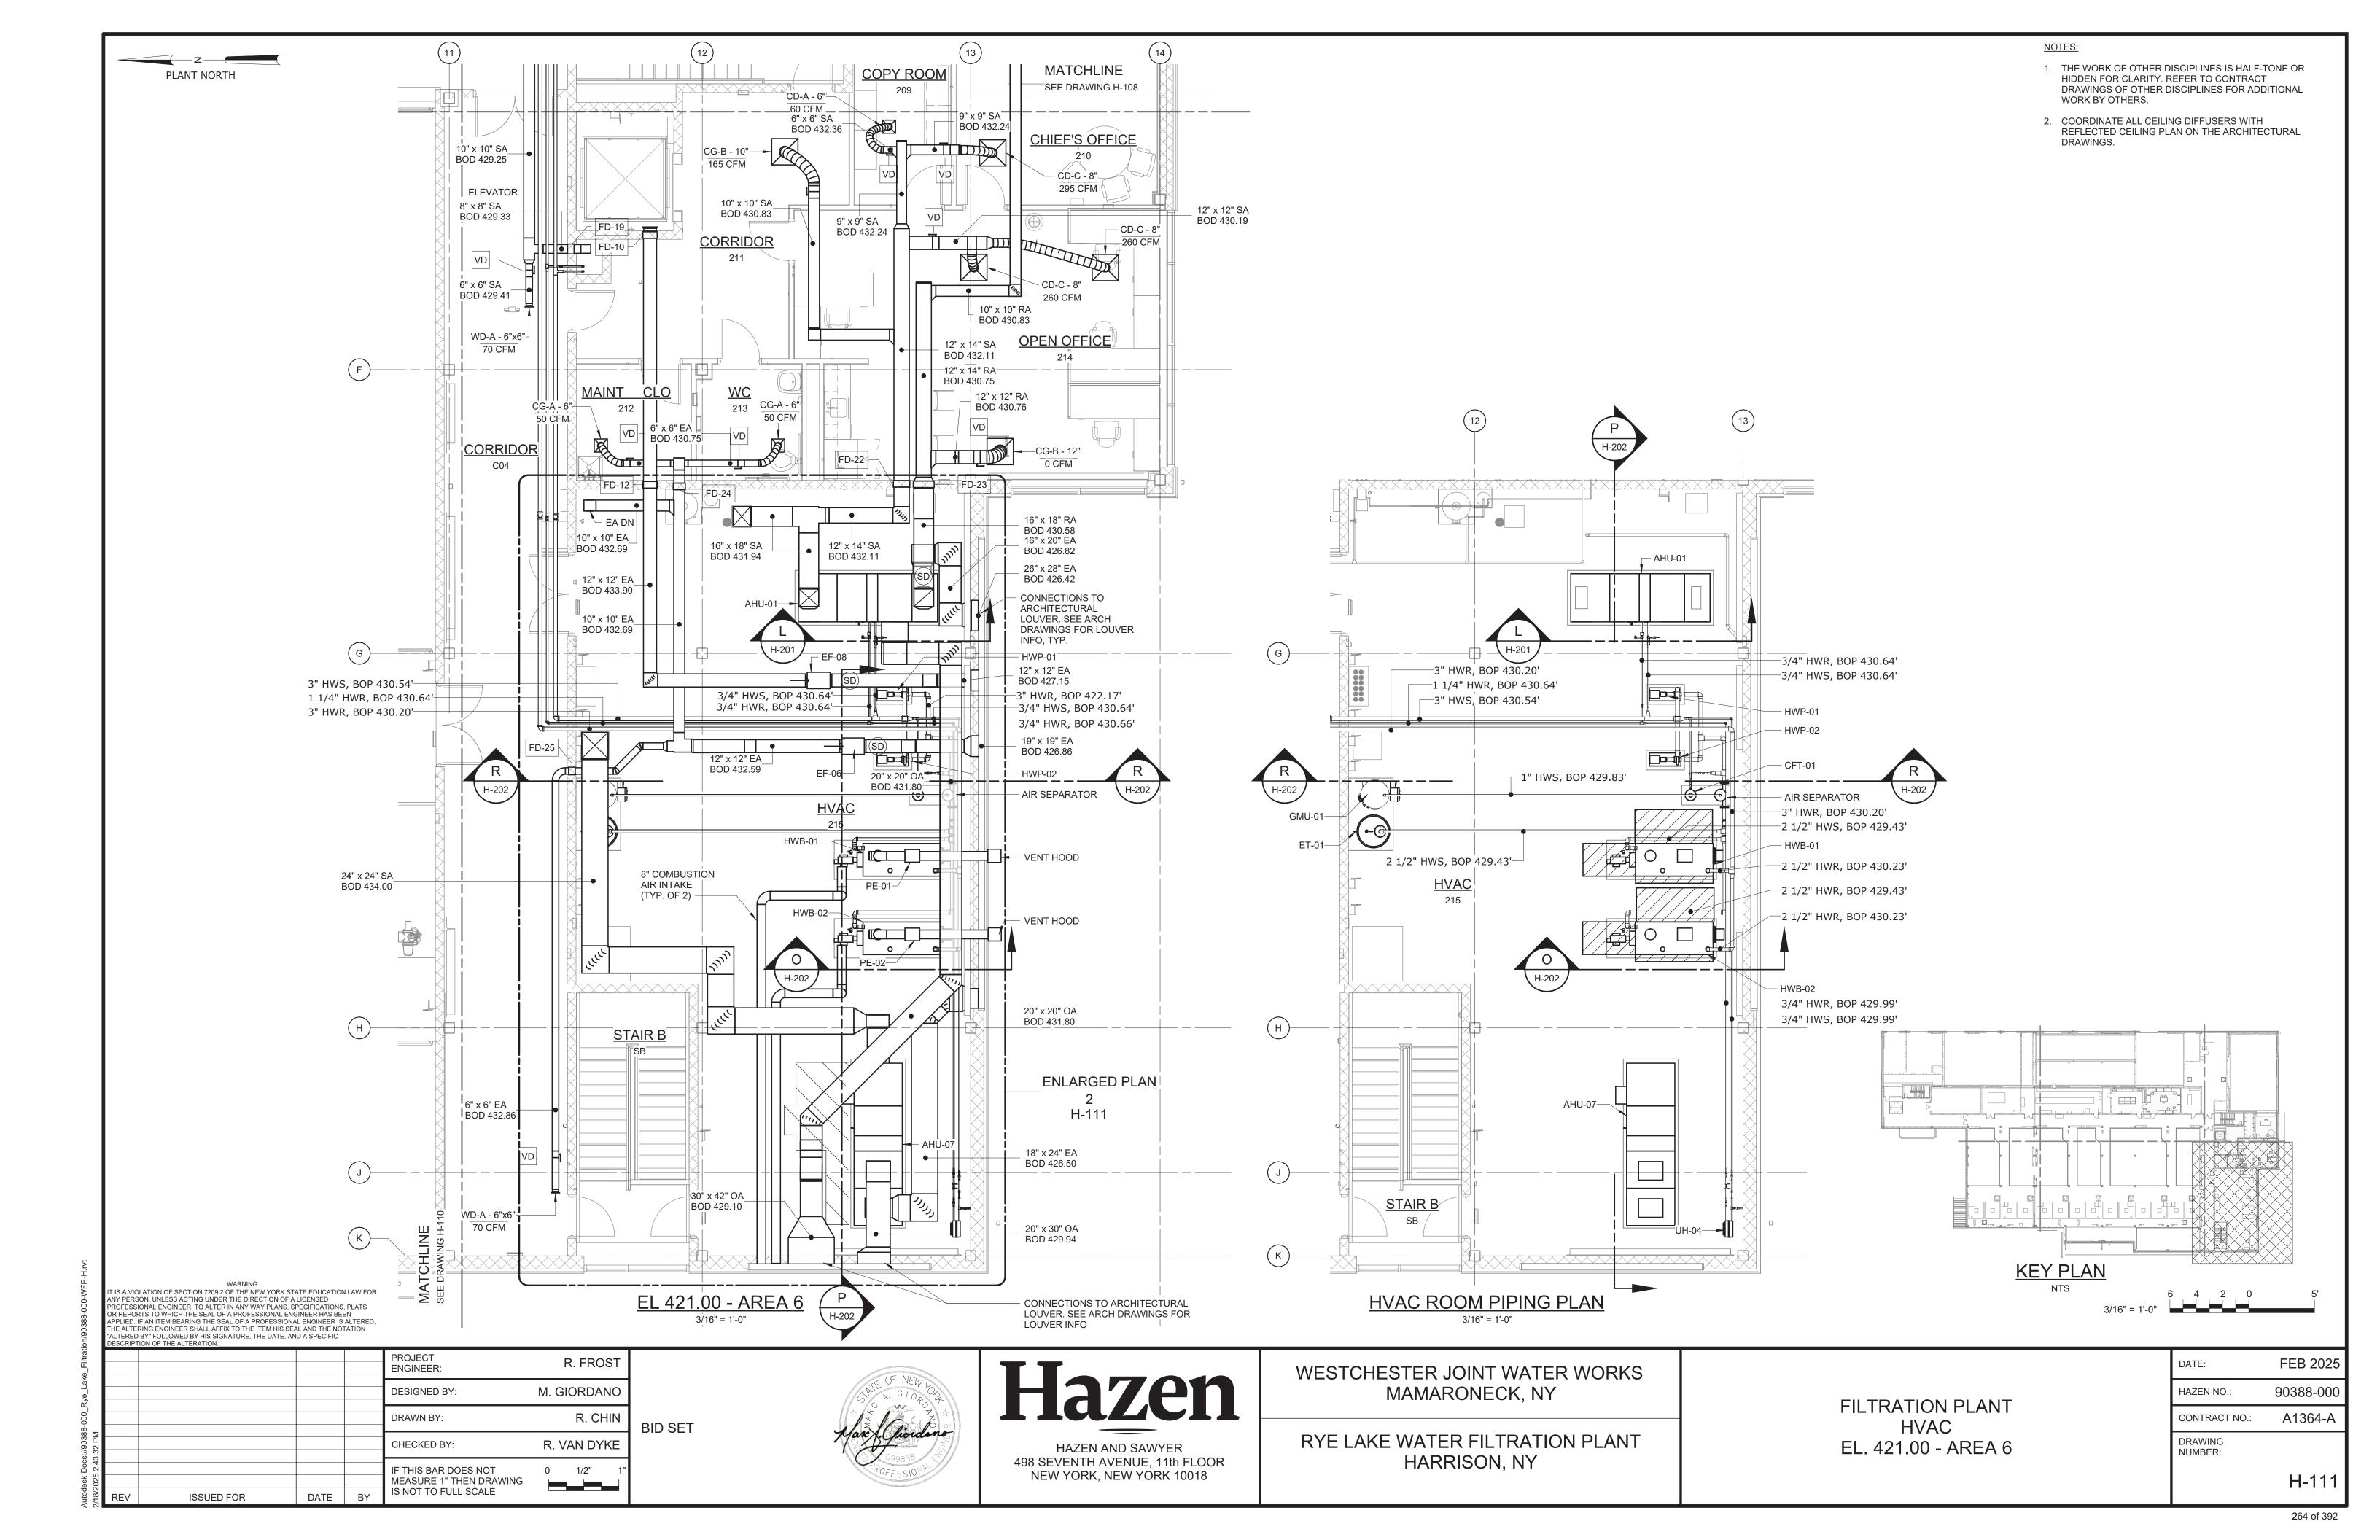

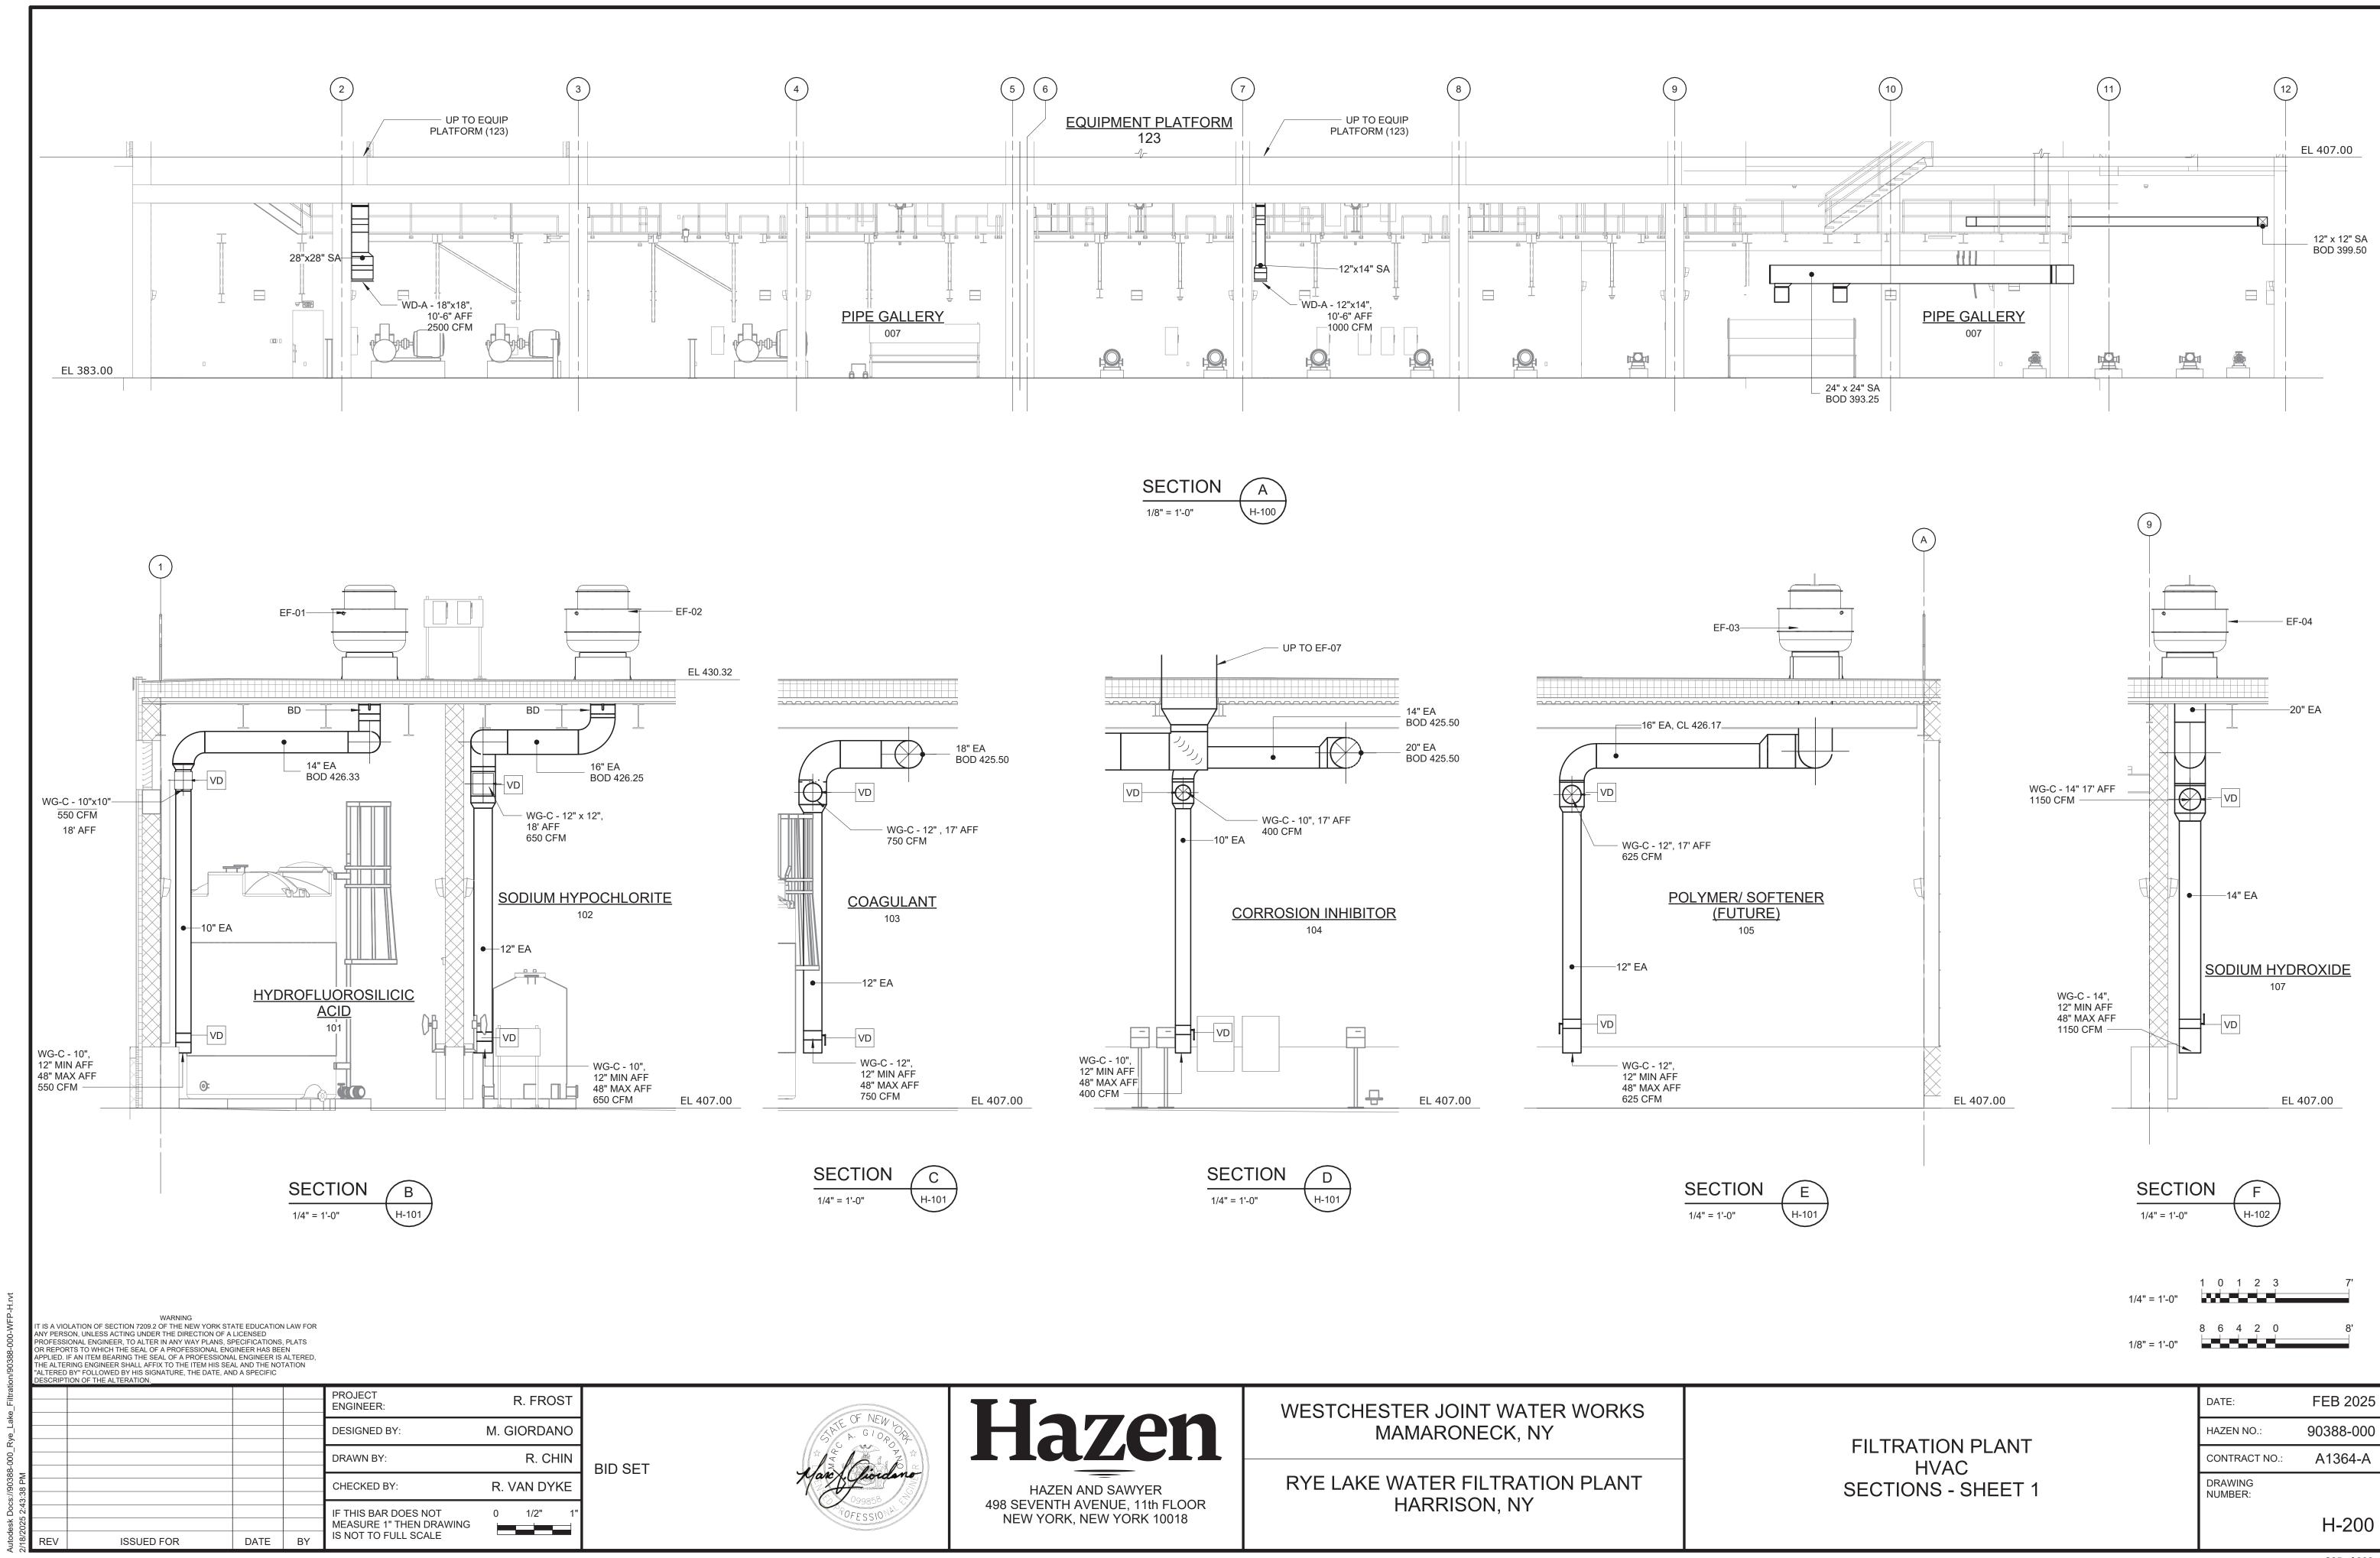

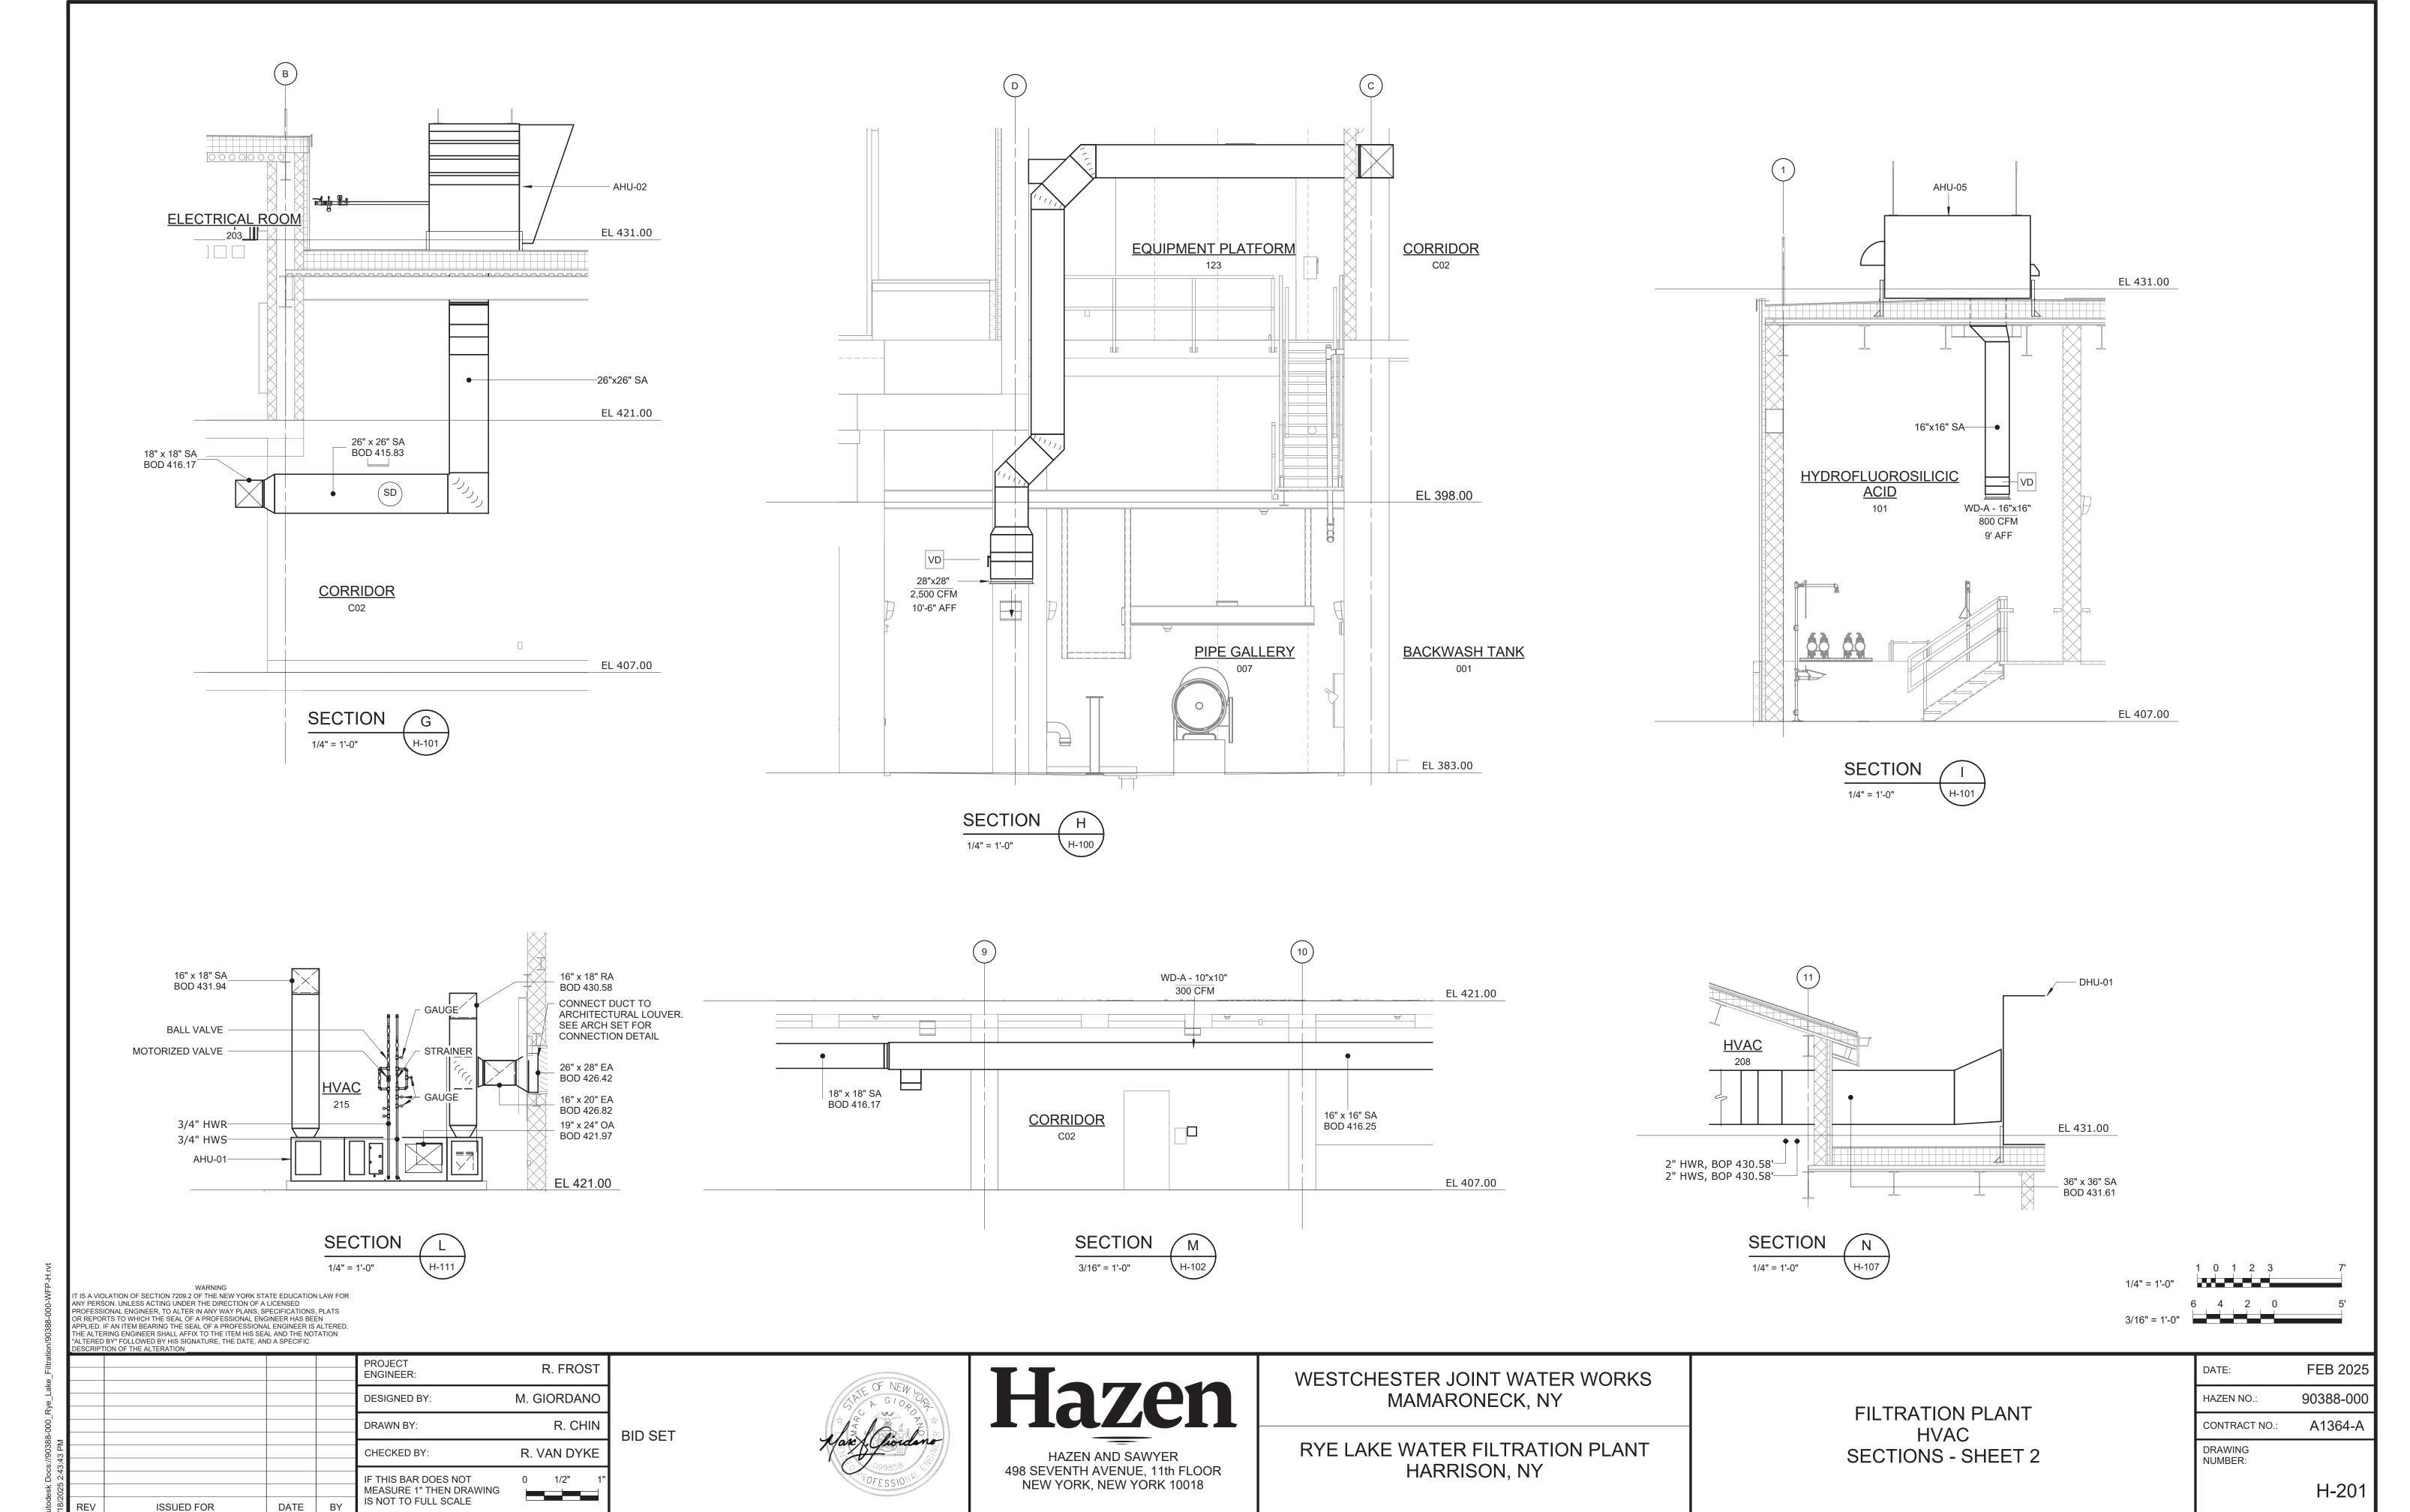

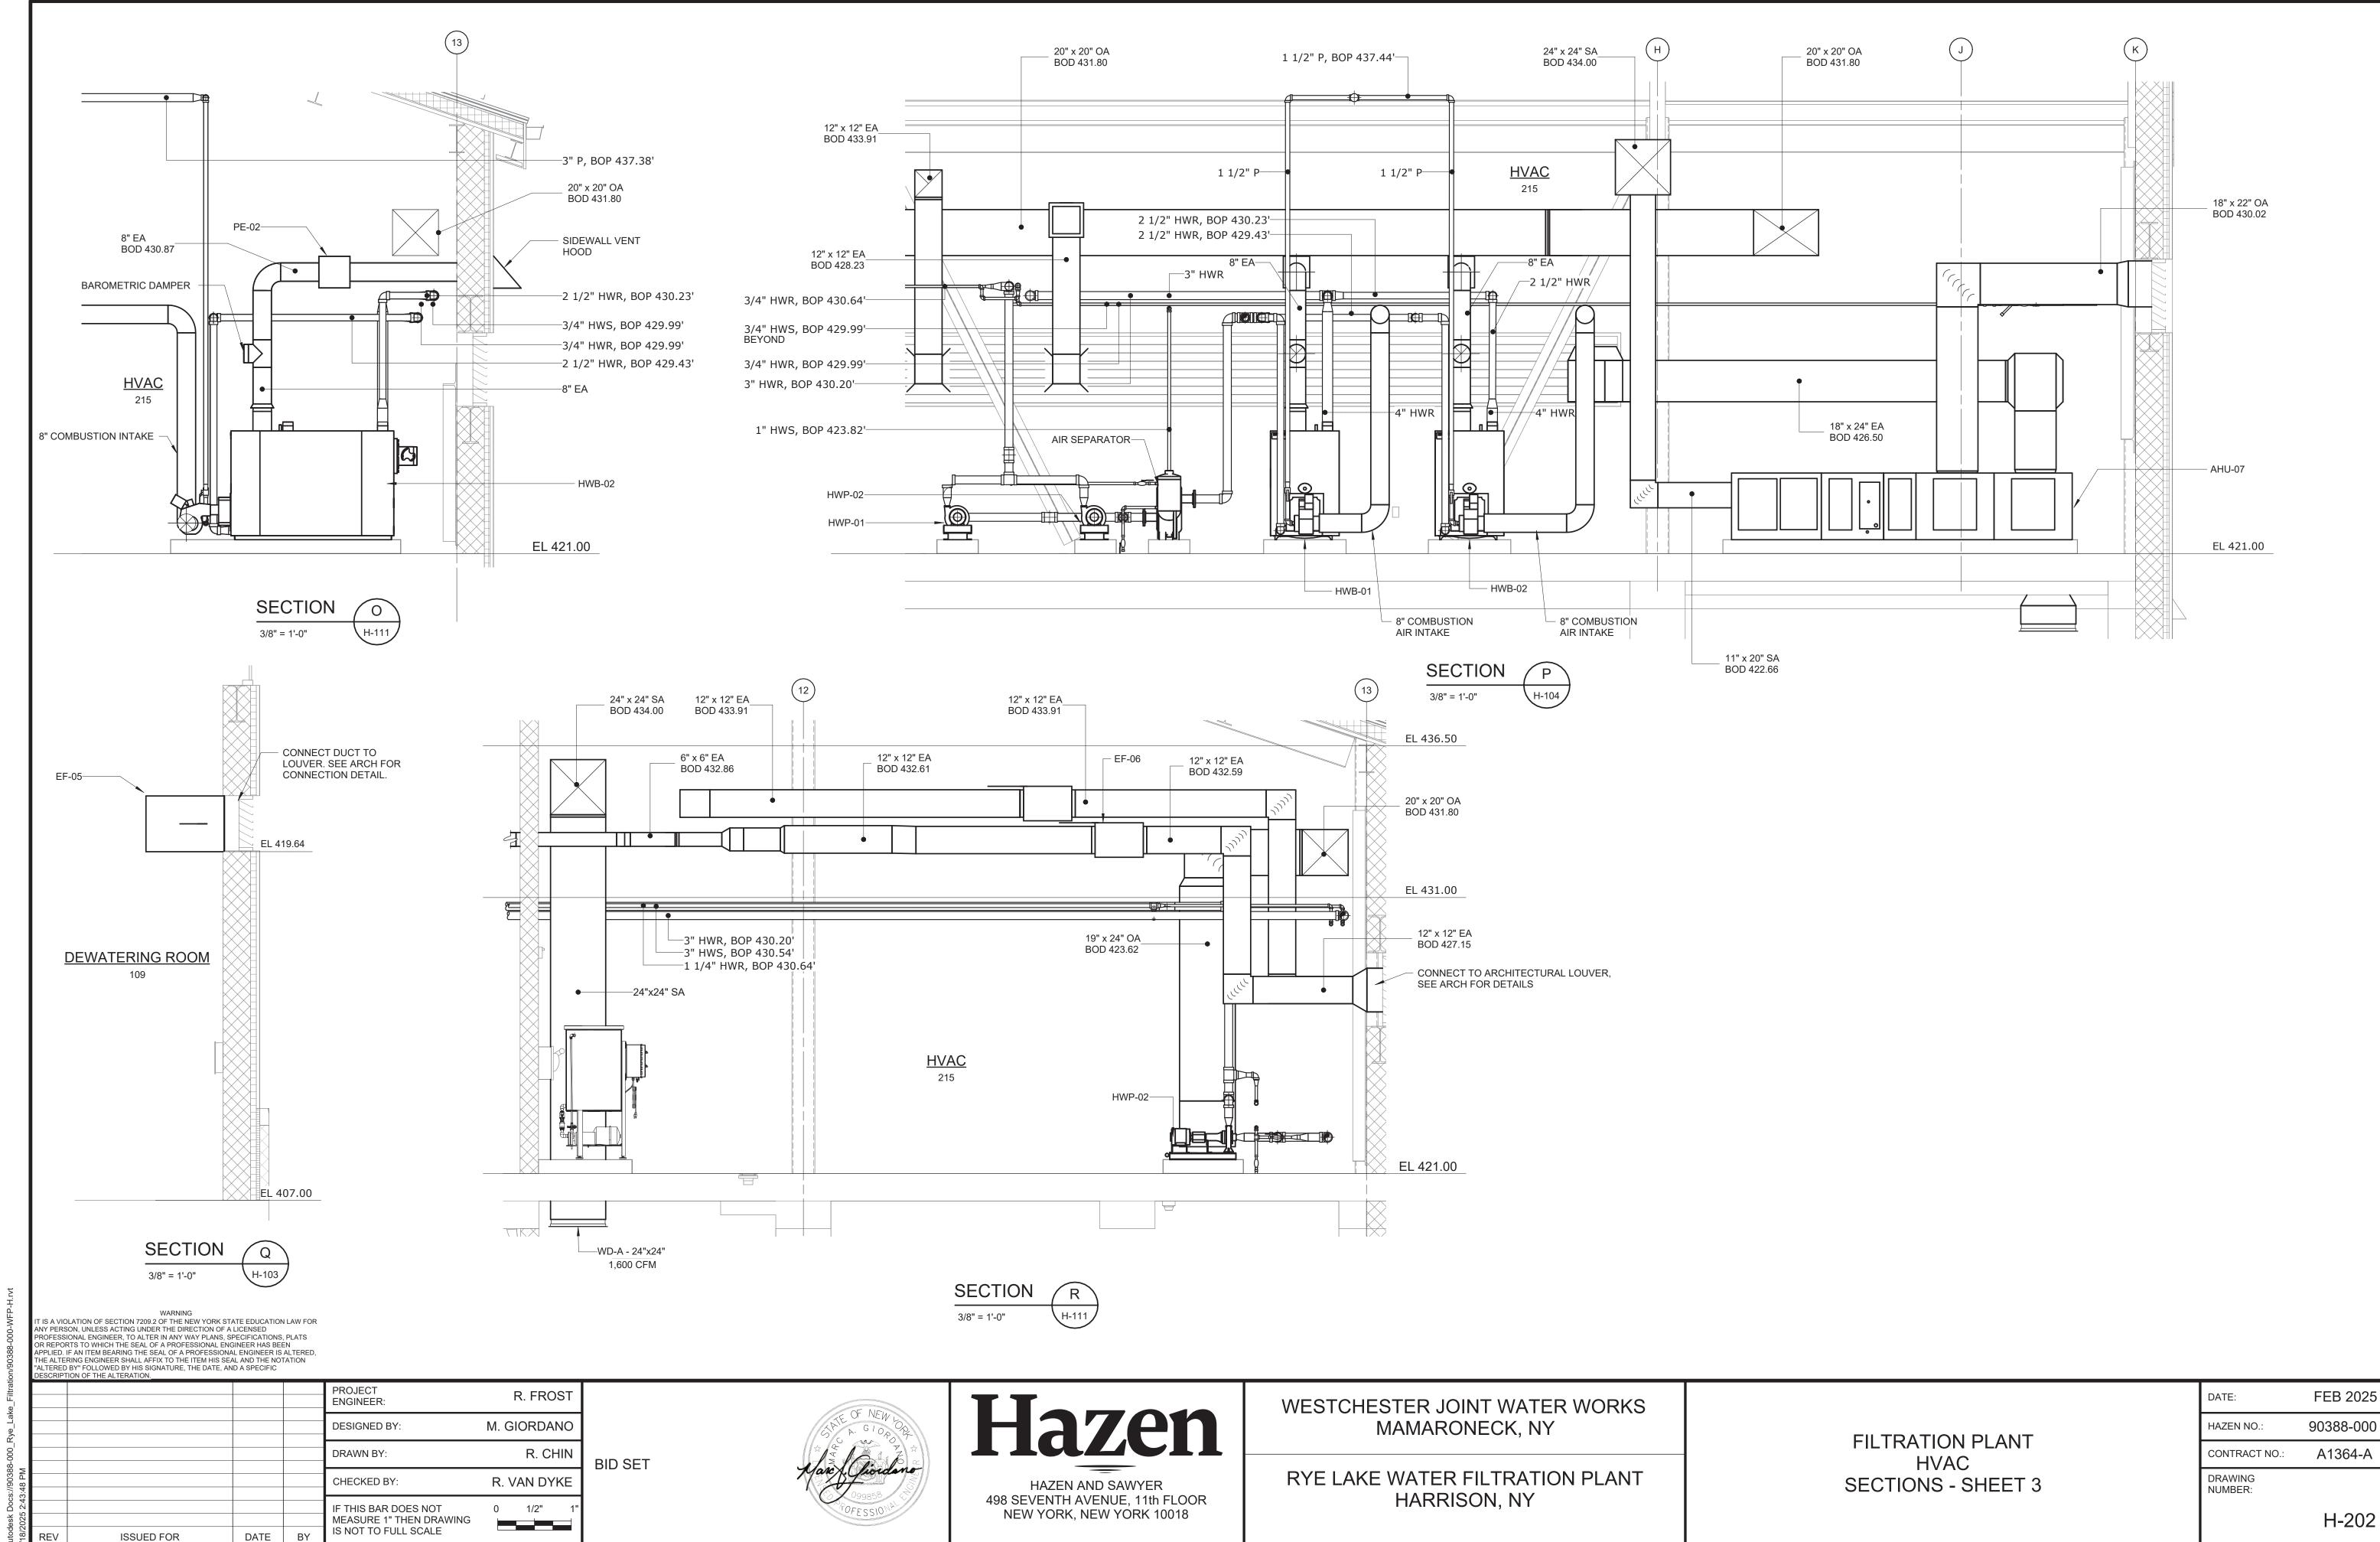

AREA	AREA NAME	DESIGN DE	. ,
IUMBER		MINIMUM	MUMIXAM
001	BACKWASH TANK	UNCOND	
002	FILTERED WATER TRANSFER TANKS	UNCOND	
003	FLOATED SOLIDS BUFFER TANK	UNCOND	
004	UV DISINFECTION SYSTEM	50	104
005	RESIDUALS STORAGE TANKS	UNCOND	
006	STORAGE CLOSET	50	104
007	PIPE GALLERY	50	104
800	CORRIDOR	50	104
101	HYDROFLUOROSILICIC ACID	50	104
102	SODIUM HYPOCHLORITE (12.5%)	50	65
103	COAGULANT	50	104
104	CORROSION INHIBITOR	50	104
105	POLYMER/SOFTENER (FUTURE)	50	104
106	FILTERED WATER PUMPING AND DAF ROOM	50	104
107	SODIUM HYDROXIDE (25%)	50	104
108	CLOSET	50	104
109	DEWATERING ROOM	50	104
110	FIRE SPRINKLER RISER ROOM	50	104
111	CONFERENCE ROOM	68	72
112	LOBBY	68	72
113	VESTIBULE	65	80
114	MAINTENANCE CLOSET	50	104
115	WOMEN'S BATHROOM	68	72
116	WOMEN'S LOCKER ROOM	68	72
117	MEN'S BATHROOM	68	72
118	MEN'S LOCKER ROOM	68	72
119	ELECTRICAL	50	80
120	RAW WATER PIPING		104
		50	
121	STATIC MIXER AND OVERFLOW	UNCOND	
122	DAF TANKS	UNCOND	
123	EQUIPMENT PLATFORM	50	104
124	EXIT PASSAGEWAY	50	104
201	HVAC (NORTH)	50	104
202	AIR SCOUR	50	104
203	ELECTRICAL ROOM	50	80
204	STORAGE ROOM	50	104
205	PROCESS ANALYSIS ROOM	68	72
206	CONTROL ROOM	68	72
207	SCADA ROOM	68	72
208	HVAC (EAST)	50	104
209	COPY ROOM	68	72
210	CHIEF'S OFFICE	68	72
211	CORRIDOR	68	72
212	MAINTENANCE CLOSET	50	104
213	W.C.	68	72
214	OPEN OFFICE	68	72
215	HVAC (WEST)	50	104
216	STORAGE ROOM	50	104
217	HVAC PLENUM	UNCOND	
218	OPERATING LEVEL	50	104
SA	STAIR A	50	104
SB		50	104
	STAIR B		
SC CO1	STAIR C	50	104
C01	CORRIDOR	50	104
C02	CORRIDOR	50	104
C03	CORRIDOR	68	72

EXPAN:	SION TANK	SCHEDULE	•								
TAG	LOCATION	MANUFACTURER	MODEL	MAXIMUM DESIGN TEMPERATURE (°F)	MAXIMUM DESIGN PRESSURE (PSIG)	TANK VOLUME (GALLONS)	TYPE	MAXIMUM OPERATING TEMPERATURE (°F)	SYSTEM FLUID	WEIGHT (EMPTY)	NOTES
ET-01	HVAC (215)	AMTROL	400-L	240	125	106	BLADDER	200	25% PROPYLENE GLYCOL	343	1,2

1. REFER TO SPECIFICATION 23 21 14 FOR ADDITIONAL REQUIREMENTS.

2. CONTRACTOR SHALL FIELD ADJUST THE EXPANSION TANK PRE-CHARGE TO 12 PSIG PRIOR TO INSTALLATION IN THE SYSTEM.

PROF	PANE VAPO	ORIZER SCHE	DULE						
TAG	LOCATION	MANUFACTURER	MODEL	CAPA BTU/HR	CITY GPH	VAPORIZATION TYPE	INPUT (KW)	VOLTS/PHASE/HERTZ	NOTES
PV-1	OUTDOORS	ALGAS	TORREXX - TX-50	2,200,000	25	INDIRECT DRY ELECTRIC	5.8	208/3/60	1,2
VIOTES:									

1. PROVIDE VALVE AND STRAINER PACKAGE INCLUDING STRAINER WITH MAGNETIC PLUG, INLET SHUTOFF VALVE, HYDROSTATIC RELIEF VALVE, OUTLET SHUTOFF BALL VALVE, AND OUTLET

PRESSURE GAUGE. 2. TORREX STAND - 12"

3. ECONOMY VALVE

4. DRAIN VALVE KIT 5. LIQUID NET SOLENOID VALVE

6. REFER TO SPECIFICATION 23 10 01 FOR CONSTRUCTION AND ACCESSORY DETAILS

OUCT CONS	STRUCTION SCHEDUL	E				
SYSTEM TYPE	AREA DESIGNATION SERVING	DUCTWORK LOCATION	DUCT MATERIAL	PRESSURE CLASS	SEAL CLASS	LEAKAGE CLASS
ALL	ALL	TYPE 1 CHEMICAL STORAGE/TRANSFER AREA	FRP	+ / - 2 INWG.	В	RECTANGULAR: 8 ROUND: 4
ALL	ALL (EXCEPT TYPE 1 OR 2 CHEMICAL STORAGE/TRANSFER AREA)	TYPE 2 CHEMICAL STORAGE/TRANSFER AREA	316SS	+ / - 2 INWG.	В	RECTANGULAR: 8 ROUND: 4
ALL	ALL (EXCEPT TYPE 1 OR 2 CHEMICAL STORAGE/TRANSFER AREA)	INDOOR WET PROCESS AREA	316SS	+ / - 2 INWG.	В	RECTANGULAR: 8 ROUND: 4
ALL	INDOOR DRY NON-PROCESS AREA	INDOOR DRY NON-PROCESS AREA	GALVANIZED STEEL	+ / - 2 INWG.	В	RECTANGULAR: 8 ROUND: 4
ALL	INDOOR WET PROCESS AREA	ALL (EXCEPT TYPE 1 OR 2 CHEMICAL STORAGE/TRANSFER AREA)	316SS	+ / - 2 INWG.	В	RECTANGULAR: 8 ROUND: 4
EXHAUST	TYPE 1 CHEMICAL STORAGE/TRANSFER AREA	ALL	FRP	+ / - 2 INWG.	В	RECTANGULAR: 8 ROUND: 4
SUPPLY	TYPE 1 CHEMICAL STORAGE/TRANSFER AREA	ALL (EXCEPT TYPE 1 OR 2 CHEMICAL STORAGE/TRANSFER AREA)	316SS	+ / - 2 INWG.	В	RECTANGULAR: 8 ROUND: 4
EXHAUST	TYPE 2 CHEMICAL STORAGE/TRANSFER AREA	ALL (EXCEPT TYPE 1 CHEMICAL STORAGE/TRANSFER AREA)	316SS	+ / - 2 INWG.	В	RECTANGULAR: 8 ROUND: 4
SUPPLY	TYPE 2 CHEMICAL STORAGE/TRANSFER AREA	ALL (EXCEPT TYPE 1 CHEMICAL STORAGE/TRANSFER AREA)	316SS	+ / - 2 INWG.	В	RECTANGULAR: 8 ROUND: 4

1. THIS SCHEDULE PROVIDES MINIMUM ACCEPTABLE MATERIAL, PRESSURE CLASS, SEAL CLASS, AND LEAKAGE CLASS REQUIREMENTS IF NO FURTHER GUIDANCE IS GIVEN IN THE

DRAWINGS AND SPECIFICATIONS. ALTERNATE PROPERTIES MAY BE REQUIRED WHERE SPECIFICALLY IDENTIFIED IN THE DRAWINGS OR SPECIFICATIONS.

2. REFER TO DRAWING G-005 FOR AREA/ROOM DESIGNATION TABLE.

3. REFER TO SPECIFICATION 23 31 13 FOR ADDITIONAL REQUIREMENTS FOR METAL DUCTS AND DUCT ACCESSORIES.

4. REFER TO SPECIFICATION 23 31 16 FOR ADDITIONAL REQUIREMENTS FOR NON-METAL DUCTS AND DUCT ACCESSORIES.

GLYCOL	MAKEUP UN	IIT SCHEDULE	Ξ							
TAG	LOCATION	MANUFACTUF MAKE	RER MODEL	STORAGE TANK SIZE (GAL)	MOTOR HP	FLUID	VOLT F	POWER	HZ	NOTES
GMU-01	HVAC ROOM (215)	BELL AND GOSSETT	GMU-60P	55	1/3	25% PROPYLENE GLYCOL	120	1	60	1

1. REFER TO SPECIFICATION 23 21 14 FOR CONSTRUCTION AND ACCESSORY DETAILS

CLIMATIC DESIGN I	NFORMATION
SOURCE	2017 ASHRAE HANDBOOK
STATION	WESTCHESTER COUNTY AIRPORT, N.Y.
DESIGN HEATING	9.2°F DB (99.6%)
DESIGN COOLING	89.6°F DB / 73.4°F MCWB (0.4%)
DESIGN DEHUMIDIFICATION	73.4°F DP/ 79.4°F MCDB (0.4%)

CHE	MICAL FEED T	ANK SCH	EDULE				
TAG	LOCATION	MANUFAC MAKE	TURER MODEL	STORAGE TANK SIZE (GAL)	MATERIAL	WEIGHT (LBS)	NOTES
CF-01	HVAC ROOM (215)	WESSELS	CPFTA-5	5	CARBON STEEL	49	1

1. REFER TO SPECIFICATION 23 21 14 FOR CONSTRUCTION AND ACCESSORY DETAILS

AIR DE	VICES - DIFF	JSERS	, REGIS	STERS,	AND GRILLI	ES SCHEDU	LE
	MANUFACTURER	NECK	FACE	SIZE	MAX. PRESSURE		
TAG	WANDFACTURER	SIZE	W	Н	DROP	TYPE	MATERIAL
	MAKE MODEL	(IN)	(IN)	(IN)	("WG)		

TAG	MANUFA MAKE	MODEL	SIZE (IN)	W (IN)	H (IN)	DROP ("WG)	TYPE	MATERIAL	MOUNTING TYPE	NOTES
CD-A	TITUS	TMS-AA	SEE TAG	12	12	0.1	SUPPLY DIFFUSER	ALUMINUM	LAYIN	1
CD-B	TITUS	TMS-AA	SEE TAG	12	24	0.1	SUPPLY DIFFUSER	ALUMINUM	LAYIN	1
CD-C	TITUS	TMS-AA	SEE TAG	24	24	0.1	SUPPLY DIFFUSER	ALUMINUM	LAYIN	1
WD-A	TITUS	300FL	SEE TAG	SEE TAG	SEE TAG	0.1	SUPPLY DIFFUSER	ALUMINUM	SIDEWALL	1
CG-A	TITUS	350FL	SEE TAG	12	12	0.1	RETURN GRILLE	ALUMINUM	LAYIN	1
CG-B	TITUS	350FL	SEE TAG	24	24	0.1	RETURN GRILLE	ALUMINUM	LAYIN	1
WG-A	TITUS	350FL	SEE TAG	SEE TAG	SEE TAG	0.1	RETURN GRILLE	ALUMINUM	SIDEWALL	1
WG-C	-	-	-	-	-	-	OPEN DUCT INTAKE	-	-	2,3
NOTES:						<u> </u>	<u> </u>			

1. REFER TO SPECIFICATION 23 31 13 FOR CONSTRUCTION AND ACCESSORY DETAILS 2. REFER TO SPECIFICATION 23 31 16 FOR CONSTRUCTION AND ACCESSORY DETAILS

3. FOR CHEMICAL ROOM EXHAUST INTAKES, EXPOSED EDGES OF PLAIN END OF DUCT SHALL BE FIELD-CAPPED WITH CORROSION BARRIER. CORROSION BARRIER SHALL BE THE SAME CORROSION BARRIER LAMINATE SEQUENCE AND MATERIALS INDICATED FOR THE DUCT INNER CORROSION BARRIER. THE EXTERIOR PORTION OF THE CAPPING SHALL BE FINISHED AS INDICATED

FOR THE EXTERIOR FINISH OF THE DUCT.

IT IS A VIOLATION OF SECTION 7209.2 OF THE NEW YORK STATE EDUCATION LAW FOR ANY PERSON, UNLESS ACTING UNDER THE DIRECTION OF A LICENSED ROFESSIONAL ENGINEER, TO ALTER IN ANY WAY PLANS, SPECIFICATIONS, PLATS OR REPORTS TO WHICH THE SEAL OF A PROFESSIONAL ENGINEER HAS BEEN APPLIED. IF AN ITEM BEARING THE SEAL OF A PROFESSIONAL ENGINEER HAS BEEN APPLIED. IF AN ITEM BEARING THE SEAL OF A PROFESSIONAL ENGINEER IS ALTERED, THE ALTERING ENGINEER SHALL AFFIX TO THE ITEM HIS SEAL AND THE NOTATION "ALTERED BY" FOLLOWED BY HIS SIGNATURE, THE DATE, AND A SPECIFIC

ù O	DESCRIPT	TION OF THE ALTERATION.					
ake_riitrat					PROJECT ENGINEER:	R. FROST	
≺ye_Lak					DESIGNED BY:	M. GIORDANO	
3-000_F					DRAWN BY:	R. CHIN	BID SET
Docs://90388					CHECKED BY:	R. VAN DYKE	J.J 3
esk Doce 025 2:43					IF THIS BAR DOES NOT MEASURE 1" THEN DRAWING	0 1/2" 1"	
utodesk I 18/2025	REV	ISSUED FOR	DATE	BY	IS NOT TO FULL SCALE		

Hazen HAZEN AND SAWYER 498 SEVENTH AVENUE, 11th FLOOR

NEW YORK, NEW YORK 10018

WESTCHESTER JOINT WATER WORKS MAMARONECK, NY

RYE LAKE WATER FILTRATION PLANT HARRISON, NY

FILTRATION PLANT **HVAC** SCHEDULES - SHEET 1

DATE:	FEB 2025
HAZEN NO.:	90388-000
CONTRACT NO.:	A1364-A
DRAWING NUMBER:	
	H-600

AIR HANDLING UNIT SCHEDULE

TAG	LOCATION	MANUF	ACTURER	AREA	AIR FLOW	MIN.		SUPPLY F	λN		RETU	JRN FAI	N			F	EATING CO	IL							COOLING C	OIL			SYSTI	M EFF.	WEIGHT		POWER		NOTES
		MAKE	MODEL	SERVED	(CFM)		E.S.P. ("WG)	MOT BHP H		E.S.F D ("WG	P. BHP	MOTO		TYPE	EAT (°F)	LAT (°F)	CAPACITY (MBH)	WATER FLOW	EWT (F)		MAX. FACE	EAT (°		LAT (°F) DB WB	MAX. FINS/INC			(TOTAL)	RATING	UNIT	(LBS)	VOLT F	PH HZ M	CA MOCP	-
																		(GPM)			VEL. (FPM)					VEL. (FPM)	P.D. ("WG)	(MBH)							
AHU-01	HVAC (215)	TRANE	CSAA004	ADMIN & OCCUPIED AREAS	1,815	365	1	1.6 2	YE	S 1	0.6	1	YES	25% PG	57.9	95.5	70.6	7.3	200	180	575	77.9	65	53 52.2	8	510	0.79	64	14.8	IEER	1,650	460	3 60 6.	35 15	1,2,5-8
AHU-02	ROOF	TRANE	HORIZON OAK144	CHEMICAL ROOMS	6,050	6,050	1	2.7 5	YE	S -	-	-	-	25% PG	7.7	60	341.7	34.1	200	180	875	-	-		-	-	-	-	-	-	3,023	460	3 60 8	9 15	1-8
AHU-03	ROOF	TRANE	HORIZON OAB084	SODIUM HYPOCHLORITE (102)	1,200	1,200	1	0.4	YE	S -	-	-	-	25% PG	7.7	60	67.8	6.8	200	180	400	90	75 5	54.5 53.6	14	200	0.2	82.9	14.8	IEER	1,395	460		0 60	1-8
AHU-04	ROOF	TRANE	CSAA025	DAF/FILTER BASIN AREA	10,000	2,500	1	4.8 5	YE	S 0.5	3.2	5	YES	25% PG	39.4	69.4	325	32.4	200	180	405	-	-		-	-	-	-	-	-	5,820	460	3 60 40	.25 60	1,2,5-8
AHU-05	ROOF	TRANE	HORIZON OAB072	FLUORIDE (101)	800	800	1	0.2	YE		-	-	-	25% PG	7.7	60	45.2	4.5	200	180	261	-			-	-	-	-	-	-	1,177	460	3 60 3		1-8
AHU-06	HVAC (208)	TRANE	BCHE018	ADMIN & OCCUPIED AREAS	585	585		0.37	YE		-	-	-	25% PG	7.7	71	40	4.1	200	180	527			5.08 53.55		527	0.5	40.2	14	SEER	119	460		63 15	1,2,5-8
AHU-07	HVAC (215)	TRANE	CSAA004	ELECTRICAL ROOM (119)	1,600	0		1.37 2	YE		5 0.5	1	YES	-	-	-	-	-	-	-	-			59 57.6		354	0.5	48	14	SEER	1,658	460		35 15	1,2,5-8
AHU-08	ROOF	TRANE	PRECEDENT TSK 150A4S0	ELECTRICAL ROOM (203)	5,000	0		2.5 4.			-	-	-	-	-	-	-	-	-	-		80	67 5	57.4 56.6	-	-	-	150	14.6	IEER	1,398	460	3 60 3	33 45	1-8
AHU-09	HVAC (208)	TRANE	CSAA003	DEWATERING ROOM	1,250	1,250	2	1.2 1.	5 YE	S -	-	-	-	25% PG	7.7	72.4	87.7	9	200	180	500	-	-		-	-	-	-	-	-	693	460	3 60 2.	63 15	1,2,5-8

1. REFER TO 23 74 00 FOR CONSTRUCTION AND ACCESSORY DETAILS 4. PROVIDE THROUGH THE BASE ELECTRICAL

2. PROVIDE WIRED REMOTE THERMOSTAT

5. PROVIDE WITH HINGED ACCESS PANELS

7. PROVIDE WITH FROSTAT 8. PROVIDE WITH STAINLESS STEEL DRAIN PAN

3. PROVIDE ROOF CURB

6. PROVIDE MERV 8 FILTERS

AIR CONDITIONING UNIT SCHEDULE

TAG	LOCATION	AREA SERVED	MAN	NUFACTURER	TYPE	AIR FLOW	CC	OOLING COIL		MIN.	MIN.	WEIGHT	SYSTEM	ΛEFF.			POWER			NOTES
			MAKE	MODEL		(CFM)	EAT (F)	CAPA	CITY	SYSTEM	CIRCUITS	(LBS)	RATING	UNIT	VOLT	PH	HZ	MCA	MOCP	
							DB	NOMINAL	ACTUAL	EER										
								(TONS)	(MBH)											
AC-01	PROCESS ANALYSIS ROOM (205)	PROCESS ANALYSIS ROOM (205)	MITSUBISHI	PKA-A18HA7	WALL MOUNTED	370	72	1.5	18	14.4	1	46	18.5	SEER	AC POWERED	O FROM COND	DENSING UNIT	INTERCONNECT	TING WIRING	1-3
AC-02	CONTROL ROOM (206)	CONTROL ROOM (206)	MITSUBISHI	PKA-A18HA7	WALL MOUNTED	370	72	1.5	18	14.4	1	46	18.5	SEER	AC POWERED	D FROM CONE	DENSING UNIT	INTERCONNEC	TING WIRING	1-3
AC-03	SCADA ROOM (207)	SCADA ROOM (207)	MITSUBISHI	PKA-A18HA7	WALL MOUNTED	370	72	1.5	18	14.4	1	46	18.5	SEER	AC POWERED	O FROM COND	DENSING UNIT	INTERCONNEC	TING WIRING	1-3

- 1. REFER TO SPECIFICATION 23 81 26 FOR CONSTRUCTION AND ACCESSORY DETAILS
- 2. PROVIDE WIRED REMOTE THERMOSTAT
- 3. ATC CONTRACTOR TO PROVIDE INTERCONNECTING WIRING

AIR COOLED CONDENSING UNIT SCHEDULE

TAG	LOCATION	AREA	MANU	JFACTURER	NOMINAL COOLING	NOMINAL HEATING	REFRIGERANT	AMBIEN	NT TEMP.	COMPRESSOR	ASSOCIATED			POWER			NOTES
		SERVED	MAKE	MODEL	CAPACITY (MBH)	CAPACITY (MBH)		MIN.	MAX.	TYPE	UNIT	VOLT	PH	HZ	MCA	MOCP	
ACCU-01	ROOF	PROCESS ANALYSIS ROOM (205)	MITSUBISHI	PUZ-A18NKA7	18	11.3	R410A	12	115	INVERTER-DRIVEN TWIN ROTARY	AC-01	208	1	60	11	28	1
ACCU-02	ROOF	CONTROL ROOM (206)	MITSUBISHI	PUZ-A18NKA7	18	11.3	R410A	12	115	INVERTER-DRIVEN TWIN ROTARY	AC-02	208	1	60	11	28	1
ACCU-03	ROOF	SCADA ROOM (207)	MITSUBISHI	PUZ-A18NKA7	18	11.3	R410A	12	115	INVERTER-DRIVEN TWIN ROTARY	AC-03	208	1	60	11	28	1
ACCU-04	ROOF	ELECTRICAL ROOM (119)	TRANE	5TTA4048A3000A	48	-	R454B	55	115	SCROLL	AHU-07	208	3	60	16	25	1
ACCU-05	ROOF	ADMIN SPACES	TRANE	TTA072K4AA	72	-	R454B	55	115	SCROLL	AHU-01	460	3	60	16	25	1
ACCU-06	ROOF	ADMIN SPACES	TRANE	5TTA4048A3000A	48	-	R454B	55	115	SCROLL	AHU-06	208	3	60	16	25	1
ACCU-07	ROOF	PIPE GALLERY, EQUIPMENT PLATFORM, DAF AND FILTER ROOM	BRY-AIR OR MUNTERS	BY MANUF.	10	-	R454B	40	115	SCROLL	DHU-01	460	3	60	22	25	1

1. REFER TO SPECIFICATION 23 81 26 FOR CONSTRUCTION AND ACCESSORY DETAILS

HOT WATER BOILER SCHEDULE

TAG	LOCATION	MANUFACT	URER AND MODEL	TYPE	RATED CAPACITY	NET INPUT E	THERMAL	FUEL	WATER TEMPERATURE	WATER TEMPERATURE	WATER FLOW	GAS INLET PRESSURE RANGE	BURNER EL	ECTRICAL DATA	NOTES
IAG	LOCATION	BOILER	BURNER	1176	OUTPUT (BTU/HR)	(BTU/HR)	%	TOLL	OUT (°F)	DROP (°F)	RATE (GPM)	(IN. WC)	MOTOR HP	VOLT/PHASE/HZ	NOTES
HWB-01	HVAC ROOM (215)	WEIL MCCLAIN - 780	POWER FLAME - WCR1-G-12	CAST IRON	753	935	80	PROPANE	200	20	70	4.6 - 14	1/2	120/1/60	1-2
HWB-02	HVAC ROOM (215)	WEIL MCCLAIN - 780	POWER FLAME - WCR1-G-12	CAST IRON	753	935	80	PROPANE	200	20	70	4.6 - 14	1/2	120/1/60	1-2

- 1. REFER TO SPECIFICATION 23 52 23 FOR CONSTRUCTION AND ACCESSORY DETAILS
- 2. BOILERS TO OPERATE IN LEAD/LAG CONFIGURATION. EACH BOILER IS SIZED FOR 50% OF THE TOTAL DESIGN HEATING LOAD.

IT IS A VIOLATION OF SECTION 7209.2 OF THE NEW YORK STATE EDUCATION LAW FOR ANY PERSON, UNLESS ACTING UNDER THE DIRECTION OF A LICENSED ANY PERSON, UNLESS ACTING UNDER THE DIRECTION OF A LICENSED PROFESSIONAL ENGINEER, TO ALTER IN ANY WAY PLANS, SPECIFICATIONS, PLATS OR REPORTS TO WHICH THE SEAL OF A PROFESSIONAL ENGINEER HAS BEEN APPLIED. IF AN ITEM BEARING THE SEAL OF A PROFESSIONAL ENGINEER IS ALTERED, THE ALTERING ENGINEER SHALL AFFIX TO THE ITEM HIS SEAL AND THE NOTATION "ALTERED BY" FOLLOWED BY HIS SIGNATURE, THE DATE, AND A SPECIFIC

	OF THE ALTERATION.	, AND A SPECIFIC				
				PROJECT ENGINEER:	R. FRO	ST
				DESIGNED BY:	M. GIORDAI	NO
				DRAWN BY:	R. Ch	IIN
				CHECKED BY:	R. VAN DY	KE
2.2020				IF THIS BAR DOES NOT MEASURE 1" THEN DRAWING	0 1/2"	1"
REV	ISSUED FOR	DATE	BY	IS NOT TO FULL SCALE		-

BID SET



Hazen HAZEN AND SAWYER 498 SEVENTH AVENUE, 11th FLOOR

NEW YORK, NEW YORK 10018

WESTCHESTER JOINT WATER WORKS MAMARONECK, NY

RYE LAKE WATER FILTRATION PLANT HARRISON, NY

FILTRATION PLANT HVAC SCHEDULES - SHEET 2

DATE:	FEB 2025
HAZEN NO.:	90388-000
CONTRACT NO.:	A1364-A
DRAWING NUMBER:	
	H-601

FAN SCHEDULE AREA AIRFLOW FAN LOCATION MANUFACTURER MODEL NOTES DRIVE VOLT HZ SERVED (CFM) ("WG) TYPE BHP PH CENTRIFUGAL UPBLAST EF-01 ROOF BELT 1-4 FLUORIDE ROOM (101) HARTZELL A88-0-151FE100FGFCD3 900 0.65 0.20 1/4 208 60 EF-02 ROOF SODIUM HYPOCHLORITE (102) HARTZELL A88-0-181-FE-66FGFCD3 1,300 0.65 CENTRIFUGAL UPBLAST BELT 0.23 1/4 208 60 1-4 3 EF-03 ROOF CHEMICAL AREAS HARTZELL A88-0-301-FE100FGFCF3 3,650 0.5 CENTRIFUGAL UPBLAST BELT 0.47 1/2 208 60 1-4 EF-04 ROOF SODIUM HYDROXIDE (109) HARTZELL A88-0-181-FE100FGFCF3 2,300 0.5 BELT 0.36 1/2 208 60 1-4 CENTRIFUGAL UPBLAST EF-05 DEWATERING ROOM (109) DEWATERING ROOM (110) **GREENHECK** SE1-16-436-VG 1,200 0.5 SIDEWALL PROPELLER DIRECT 0.33 3/4 115 60 1,3 EF-06 HVAC (215) **ADMIN AREAS** GREENHECK SQ-99 585 0.75 INLINE CENTRIFUGAL DIRECT 1/2 115 60 1,3 0.22 EF-07 ROOF AIR SCOUR (202) GREENHECK CUBE-360-VG 8,500 0.5 CENTRIFUGAL UPBLAST BELT 1.33 460 3 60 1-4 **ELEVATOR SHAFT** EF-08 HVAC (215) GREENHECK SQ-97-VG 140 0.75 ALUMINUM INLINE DIRECT 1/4 115 60 1,3 0.12 SF-01 ROOF AIR SCOUR (202) GREENHECK KSQ-22-M2-VG 8,500 0.5 ROOF SUPPLY FAN DIRECT 2.9 7.5 460 3 60 1,2,4

NOTES:

1. REFER TO SPECIFICATION 23 34 00 FOR CONSTRUCTION AND ACCESSORY DETAILS

2. PROVIDE WITH PREFABRICATED ROOF CURB

3. PROVIDE WITH GRAVITY BACKDRAFT DAMPER

4. PROVIDE WITH CONTINUOUS BIRD SCREEN

ı	Ρl	JN	1 P	SC	HF	:חו	JI I	F
	_	<i>-</i> 1 V				. L	-	-

TAG	LOCATION	MANUFACT	ΓURER	TYPE	ELLIID.	FLOW	HEAD	SHUT OFF	MIN. NPSH	MIN. EFF.		МОТ	OR			POWER		NOTES
TAG	LOCATION	MAKE	MODEL	TYPE	FLUID	RATE (GPM)	(FT)	HEAD (FT)	REQ'D (FT)	(%)	ВНР	HP	RPM	VFD	VOLT	PH	HZ	NOTES
HWP-01	HVAC ROOM (215)	BELL AND GOSSETT	E-1510 - 1.5BC	CENTRIFUGAL END SUCTION	25% PROPYLENE GLYCOL	126	80	92.8	7.74	60	4.71	5	1800	YES	460	3	60	1
HWP-02	HVAC ROOM (215)	BELL AND GOSSETT	E-1510 - 1.5BC	CENTRIFUGAL END SUCTION	25% PROPYLENE GLYCOL	126	80	92.8	7.74	60	4.71	5	1800	YES	460	3	60	1

NOTES:

1. REFER TO SPECIFICATION 23 21 23 FOR CONSTRUCTION AND ACCESSORY DETAILS

HOT WA	TER UNIT HEATER SCH	IEDULE															
TAG	LOCATION	MANUFA	ACTURER	TYPE	AIRFLOW	CAPACITY	WATER	EWT	LWT	WATER			POWER				NOTES
		MAKE	MODEL	_	(CFM)	(MBH)	FLOW	(°F)	(°F)	P.D.	VOLT	PH	HZ	MCA	MOCP		
UH-01	FIRE SPRINKLER RISER ROOM (111)	TRANE	UHSBA008	HORIZONTAL	245	8.03	0.8	200	180	0.8	115	1	60	1	1.8	1	
UH-02	HVAC ROOM (201)	TRANE	UHSBA008	HORIZONTAL	245	8.03	0.8	200	180	0.8	115	1	60	1	1.8	1	
UH-03	HVAC ROOM (208)	TRANE	UHSBA008	HORIZONTAL	245	8.03	0.8	200	180	0.8	115	1	60	1	1.8	1	
UH-04	HVAC ROOM (215)	TRANE	LIHSBA008	HORIZONTAL	245	8.03	0.8	200	180	0.8	115	1	60	1	1.8	1	

NOTES:

1. REFER TO SPECIFICATION 23 82 39 FOR CONSTRUCTION AND ACCESSORY DETAILS

ELECTRIC	UNIT	HEATER	SCHEDULE

TAG	LOCATION	MANUFA	CTURER	TYPE	CAPACITY	AIRFLOW	[DIMENSION:	S	WEIGHT		POWER		NOTES
		MAKE	MODEL		(KW)	(CFM)	WIDTH	HEIGHT	DEPTH	(LBS)	VOLT	PH	HZ	
							(IN)	(IN)	(IN)					
EUH-01	ELECTRICAL (119)	INDEECO	UHIR	VERTICAL	5	350	13	18	8	25	208	1	60	1
EUH-02	ELECTRICAL (119)	INDEECO	UHIR	VERTICAL	5	350	13	18	8	25	208	1	60	1
EUH-03	ELECTRICAL (203)	INDEECO	UHIR	VERTICAL	5	350	13	18	8	25	208	1	60	1
EUH-04	ELECTRICAL (203)	INDEECO	UHIR	VERTICAL	5	350	13	18	8	25	208	1	60	1

NOTES:

1. REFER TO SPECIFICATION 23 82 39 FOR CONSTRUCTION AND ACCESSORY DETAILS

POW	ER EXHAUSTER SO	CHEDULE									
TAG	LOCATION	MANUFACTURER	MODEL	FAN		MO	TOR		POWER		NOTES
IAG	LOCATION	WANDFACTURER	MODEL	TYPE	DRIVE	BHP	HP	VOLT	PH	HZ	NOTES
PE-01	HVAC (215)	FIELD CONTROLS	PVE-1200	INLINE CENTRIFUGAL	BELT	0.1	1/4	115	1	60	1-4
PE-02	HVAC (215)	FIELD CONTROLS	PVE-1200	INLINE CENTRIFUGAL	BELT	0.1	1/4	115	1	60	1-4

NOTES

1. PROVIDE WITH 4" MG-1 DRAFT CONTROL DAMPER

2. PROVIDE WITH 4" VENT HOOD

3. PROVIDE WITH SPILL SWITCH

4. PROVIDE WITH CK KIT

WARNING
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	DESCRIP1	TION OF THE ALTERATION.						
I					PROJECT ENGINEER:	I	R. FRO	ST
I					DESIGNED BY:	M. G	IORDAI	OV
I					DRAWN BY:		R. CH	IIN
3:55 PM					CHECKED BY:	R. V	AN DY	KE
18/2025 2:43:55					IF THIS BAR DOES NOT MEASURE 1" THEN DRAWING	0	1/2"	1"
18/2	REV	ISSUED FOR	DATE	BY	IS NOT TO FULL SCALE			_

BID SET



HAZEN AND SAWYER
498 SEVENTH AVENUE, 11th FLOOR

NEW YORK, NEW YORK 10018

WESTCHESTER JOINT WATER WORKS MAMARONECK, NY

RYE LAKE WATER FILTRATION PLANT HARRISON, NY FILTRATION PLANT HVAC SCHEDULES - SHEET 3 DATE: FEB 2025

HAZEN NO.: 90388-000

CONTRACT NO.: A1364-A

DRAWING NUMBER: H-602

TAG	AREA	UNIT SERVED	MANUFACTURER	MODEL	TYPE	MATERIAL	RATING		DIMENSIONS	NOTES
FD-1	SERVED PIPE GALLERY (007)	DHU-01	RUSKIN	DFD35SS	MULTI-BLADE	316 SS	(HRS) 1.5	(CFM) 3500	(IN) 36"x36"	1,2
FD-2	PIPE GALLERY (007)	DHU-01	RUSKIN		MULTI-BLADE		1.5	5300	36"x36"	1,2
FD-3	NOT USED	D110-01	TOOKIN		WOLTI-DEADE	310 00	1.0	3300	30 230	1,2
		-		-	-	-	-	-	-	-
FD-4	POLYMER/SOFTENER (105)	AHU-02	RUSKIN		MULTI-BLADE		1.5	3350	20"x20"	1,2
FD-5	SODIUM HYDROXIDE (107)	AHU-02	RUSKIN	DFD60-3	MULTI-BLADE	316 SS	1.5	2200	16"x16"	1,2
FD-6	CORRIDOR (C02)	DHU-01	RUSKIN	DFD35SS	MULTI-BLADE	316 SS	1.5	6700	24"x24"	1,2
FD-7	CORRIDOR (C02)	DHU-01	RUSKIN	DFD35SS	MULTI-BLADE	316 SS	1.5	3800	24"x20"	1,2
FD-8	CORRIDOR (C01)	AHU-06	RUSKIN	DFD35SS	MULTI-BLADE	316 SS	1.5	70	8"x6"	1,2
FD-9	CORRIDOR (C01)	EF-06	RUSKIN	DFD35SS	MULTI-BLADE	316 SS	1.5	70	8"x6"	1,2
FD-10	ELEVATOR SHAFT	EF-08	RUSKIN	DFD35SS	MULTI-BLADE	316 SS	1.5	150	10"x10"	1,2
FD-11	HVAC (201)	AHU-04	RUSKIN	DFD35SS	MULTI-BLADE	316 SS	1.5	10000	38"x24"	1,2
FD-12	ELEVATOR SHAFT	EF-08	RUSKIN	DFD35SS	MULTI-BLADE	316 SS	1.5	150	10"x10"	1,2
FD-13	AIR SCOUR (202)	EF-07	RUSKIN	DFD35SS	MULTI-BLADE	316 SS	1.5	8500	42"x34"	1,2
FD-14	AIR SCOUR (202)	SF-01	RUSKIN	DFD35SS	MULTI-BLADE	316 SS	1.5	8500	42"x34"	1,2
FD-15	ELECTRICAL ROOM (203)	AHU-08	RUSKIN	DFD35SS	MULTI-BLADE	316 SS	1.5	5000	36"x24"	1,2
FD-16	ELECTRICAL ROOM (203)	AHU-08	RUSKIN	DFD35SS	MULTI-BLADE	316 SS	1.5	5000	36"x24"	1,2
FD-17	HVAC (208)	DHU-01	RUSKIN	DFD60-3	MULTI-BLADE	316 SS	1.5	10000	36"x36"	1,2
FD-18	HVAC (208)	DHU-01	RUSKIN	DFD60-3	MULTI-BLADE	316 SS	1.5	9100	36"x36"	1,2
FD-19	CORRIDOR (C04)	AHU-06	RUSKIN	DFD35SS	MULTI-BLADE	316 SS	1.5	370	8"x8"	1,2
FD-20	ELECTRICAL ROOM (119)	AHU-07	RUSKIN	DFD35SS	MULTI-BLADE	316 SS	1.5	1600	24"x24"	1,2
FD-21	ELECTRICAL ROOM (119)	AHU-07	RUSKIN	DFD35SS	MULTI-BLADE	316 SS	1.5	1600	24"x24"	1,2
FD-22	HVAC (215)	AHU-01	RUSKIN	DFD35SS	MULTI-BLADE	316 SS	1.5	1040	14"x12"	1,2
FD-23	HVAC (215)	AHU-01	RUSKIN	DFD35SS	MULTI-BLADE	316 SS	1.5	875	14"x12"	1,2
FD-24	HVAC (215)	EF-06	RUSKIN	DFD35SS	MULTI-BLADE	316 SS	1.5	100	10"x10"	1,2
FD-25	CORRIDOR (C04)	EF-06	RUSKIN	DFD35SS	MULTI-BLADE	316 SS	1.5	70	6"x6"	1,2

NOTE

1. REFER TO SPECIFICATION 15810 FOR CONSTRUCTION AND ACCESSORY DETAILS

2. INSTALL ACCORDING TO MANUFACTURER REQUIREMENTS

FIRE DAMPERS SCHEDULE

DEHUMIDIFICATION UNIT SCHEDULE - PART 1

		MANUFAC	TURER				S	SUPPLY F	AN	DRY		ER CONDI DX PRE-CO	TIONS: OOL COIL C	NLY			MER COND VITH DESIC		.Y			NG CONDIT	TONS: CANT ONLY	,			ER CONDIT				PO	WER			
TAG	LOCATIO	N MANUFACTURER	MODEL	AREA SERVED	OUTSIDE AIR (CFM)	AIR FLOW (CFM)	ESP	ВНР	MOTOR HP	OUTSIDE AIR DP TEMP (°F)	OUTSIDE AIR DB TEMP (°F)	SUPPLY AIR DP TEMP (°F)	SUPPLY AIR DB TEMP (°F)	SPACE TARGET DP TEMP2 (°F)	OUTSIDE AIR DP TEMP (°F)	OUTSIDE AIR DB TEMP (°F)	SUPPLY AIR DP TEMP (°F)		SPACE TARGET DP TEMP2 (°F)	OUTSIDE AIR DP TEMP	OUTSIDE AIR DB TEMP (°F)	SUPPLY AIR DP TEMP (°F)	SUPPLY AIR DB TEMP (°F)	SPACE TARGET DP TEMP2 (°F)	OUTSIDE AIR DP TEMP (°F)	OUTSIDE AIR DB TEMP (°F)	SUPPLY AIR DP TEMP (°F)	SUPPLY AIR DB TEMP (°F)	SPACE TARGET DP TEMP VO	T PH	HZ	FLA	MCA MOCP	WEIGHT (LBS)	NOTES
DHU-	01 ROOF	BRYAIR OR MUNTERS	VFB SERIES OR ICA SERIES	PIPE GALLERY & FILTERED WATER PUMPING AND DAF ROOM	900	10,000	1.7	10.3	15	73.5	79.4	55	< 95	56	73.5	79.4	52.6	< 95	53.6	45.0	50	35.4	< 95	36.4	-	9	-	65	50 46	3	60	138	146 150	8,500	1-4

DEHUMIDIFICATION UNIT SCHEDULE - PART 2

		Ol	JTDOOR /	AIR PRE-0	COOLING	DX COIL1				POST	-HEATING (COIL				DESIG	CCANT REA	ACTIVATION	SYSTEM			WHEEL: SUM	IMER DES	SICCANT-ON	NLY PERFO	ORMANCE			WHEEL: SPR	ING DESIG	CCANT-ON	LY PERFOR	RMANCE	
TAG	AIR FLOW	DP TEMP	DB TEMP	DP TEMP	DB TEMP	TOTAL COOLING LOAD	SENSIBLE COOLING LOAD	AIR FLOW	ENTERING AIR DB TEMP	LEAVING AIR DB TEMP	HEATING LOAD	FLUID	ENTERING FLUID TEMP	FLUID FLOW	AIR FLOW3	FAN ESP	MOTOR SIZE	ENTERING AIR DB TEMP	LEAVING AIR DB TEMP3	ELECTRIC HEAT3	AIR FLOW THROUGH WHEEL4	AIR FLOW BYPASSING WHEEL4	DP TEMP5	RING AIR DB TEMP5	SUPPLY AIR DP TEMP4	SUPPLY AIR DB TEMP4,5	MOISTURE REMOVAL	AIR FLOW THROUGH WHEEL	AIR FLOW BYPASSING WHEEL	ENTER DP TEMP	ING AIR DB TEMP	SUPPLY AIR DP TEMP	SUPPLY AIR DB TEMP	MOISTURE REMOVAL
	(CFM)	(°F)	(°F)	(°F)	(°F)	(MBH)	(MBH)	(CFM)	(°F)	(°F)	(MBH)		(°F)	(GPM)	(CFM)	(INWG)	(HP)	(°F)	(°F)	(KW)	(CFM)	(CFM)	(°F)	(°F)	(°F)	(°F)	(GR/HR)	(CFM)	(CFM)	(°F)	(°F)	(°F)	(°F)	(GR/HR)
DHU-0	1 900	74	79	45	45	84.6	33.5	10,000	46.3	65	202	25% PG	200	30	1,000	0.25	3	80	285	65	1,500	8,500	55.4	APPROX 85	53.6	APPROX 90	189,000	3,000	7000	37.2	APPROX 85	35.4	APPROX 90	117,000

- 1. CONTROLLER SHALL MAXIMIZE DEHUMIDIFICATION FROM THE OUTDOOR AIR STREAM WITH THE DX PRE-COOLING COIL, THEN SUPPLEMENT OR UTILIZE DESICCANT DHUMIDIFICATION WHEN DX-ONLY PRE-COOLING CANNOT MEET THE SUPPLY AIR DEWPOINT TARGET.
- 2. SPECIFIED SUPPLY AIR AND SPACE DEWPOINT TARGETS ARE SELECTED TO MITIGATE CONDENSATION ON PIPES DUE TO COLD WATER WITHIN PIPING. UNIT SHALL CONTROL DISCHARGE AIR DEWPOINT BASED A TEMPERATURE TRANSMITTER INSTALLED ON PROCESS PIPE.
- 3. AIRFLOW RATE AND DISCHARGE TEMPERATURE FOR DESICCANT REACTIVATION SHALL BE DETERMINED BY MANUFACTURER TO MAXIMIZE EFFICIENCY. VALUES SHOWN IN SCHEDULE ARE UTILIZED FOR ELECTRICAL DESIGN PURPOSES.
- 4. AIRFLOW RATES FOR DESICCANT WHEEL BYPASS SHALL BE DETERMINED BY MANUFACTURER TO PROVIDE TARGET SUPPLY AIR DEWPOINT TEMPERATURE AT SPECIFIED CONDITIONS. UNIT DISCHARGE AIR TEMPERATURE RESULTING FROM WHEEL/BYPASS AIRFLOWS SHWALL NOT EXCEED 95 DEG-F.
- 5. DESICCANT WHEEL ENTERING AIR CONDITIONS ARE BASED ON MIXING OF RETURN AIR AT THE SPECIFIED SPACE CONDITIONS AND OUTDOOR AIR AT THE SPECIFIED OUTDOOR AIR AT THE SPECIFIED OUTDOOR AIR AT THE SPECIFIED SPACE CONDITIONS. DEWPOINT TEMPERATURES ARE PRE-DETERMINED HOWEVER RETURN AIR DRY BULB TEMPERATURES WILL DEPEND ON HEAT IMPARTED BY DESICCANT WHEEL AS WELL AS COOLING IN SPACE BY TANK WALLS.
- 6. POST-HEATING ENTERING TEMPERATURE IS BASED ON MIXING OF RETURN AIR AT MINIMUM ALLOWABLE SPACE TEMPERATURE (50 °F) AND OUTDOOR AIR.
- 7. FOR BIDDING PURPOSES, IT IS ASSUMED THAT A 10-TON CONDENSING UNIT FOR THE PRE-COOLING COIL WILL BE FURNISHED SEPARATELY FROM THE DHU ENCLOSURE AND USE OF SINGLE-POINT POWER IS ACCEPTABLE.

PENTH	OUSE LOUVERS	SCHEDUI	_E										
TAG	LOCATION	MAN	UFACTURER	TYPE	MATERIAL	AIRFLOW		SIZE		FREE	MAX	STATIC	NOTES
		MAKE	MODEL			(CFM)	WIDTH	HEIGHT	HEIGHT	AREA	FACE	P.D.	
							(IN)	(IN)	(IN)	(SQFT)	VEL.	("WG)	
											(FPM)		
PH-01	HVAC PLENUM (217)	RUSKIN	PHB - ELF375DXH	INTAKE	ALUMINUM	1,835	28	28	28	9.8	200	0.01	1

1. REFER TO SPECIFICATION 23 31 13 FOR CONSTRUCTION AND ACCESSORY DETAILS

IT IS A VIOLATION OF SECTION 7209.2 OF THE NEW YORK STATE EDUCATION LAW FOR ANY PERSON, UNLESS ACTING UNDER THE DIRECTION OF A LICENSED ROFESSIONAL ENGINEER, TO ALTER IN ANY WAY PLANS, SPECIFICATIONS, PLATS OR REPORTS TO WHICH THE SEAL OF A PROFESSIONAL ENGINEER HAS BEEN APPLIED. IF AN ITEM BEARING THE SEAL OF A PROFESSIONAL ENGINEER IS ALTERED, THE ALTERING ENGINEER SHALL AFFIX TO THE ITEM HIS SEAL AND THE NOTATION "ALTERED BY" FOLLOWED BY HIS SIGNATURE, THE DATE, AND A SPECIFIC

. <u>o</u>	DESCRIPT	ION OF THE ALTERATION.					
ke_Filtration					PROJECT ENGINEER:	R. FROST	
_Rye_Lake_					DESIGNED BY:	M. GIORDANO	
8-000_F					DRAWN BY:	R. CHIN	BID SET
s://9038					CHECKED BY:	R. VAN DYKE	
utodesk Docs://90388-000_ 18/2025 2:43:56 PM					IF THIS BAR DOES NOT MEASURE 1" THEN DRAWING	0 1/2" 1"	
itode 18/2	REV	ISSUED FOR	DATE	BY	IS NOT TO FULL SCALE		


Hazen HAZEN AND SAWYER 498 SEVENTH AVENUE, 11th FLOOR NEW YORK, NEW YORK 10018

WESTCHESTER JOINT WATER WORKS MAMARONECK, NY

RYE LAKE WATER FILTRATION PLANT HARRISON, NY


FILTRATION PLANT **HVAC** SCHEDULES - SHEET 4


DATE:	FEB 2025
HAZEN NO.:	90388-000
CONTRACT NO.:	A1364-A
DRAWING NUMBER:	
	H-603

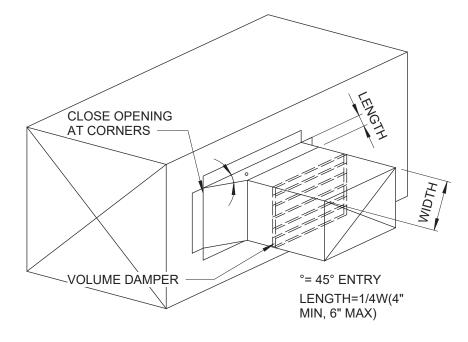


450EG DUCT BRANCH CONNECTION


H-23-0102

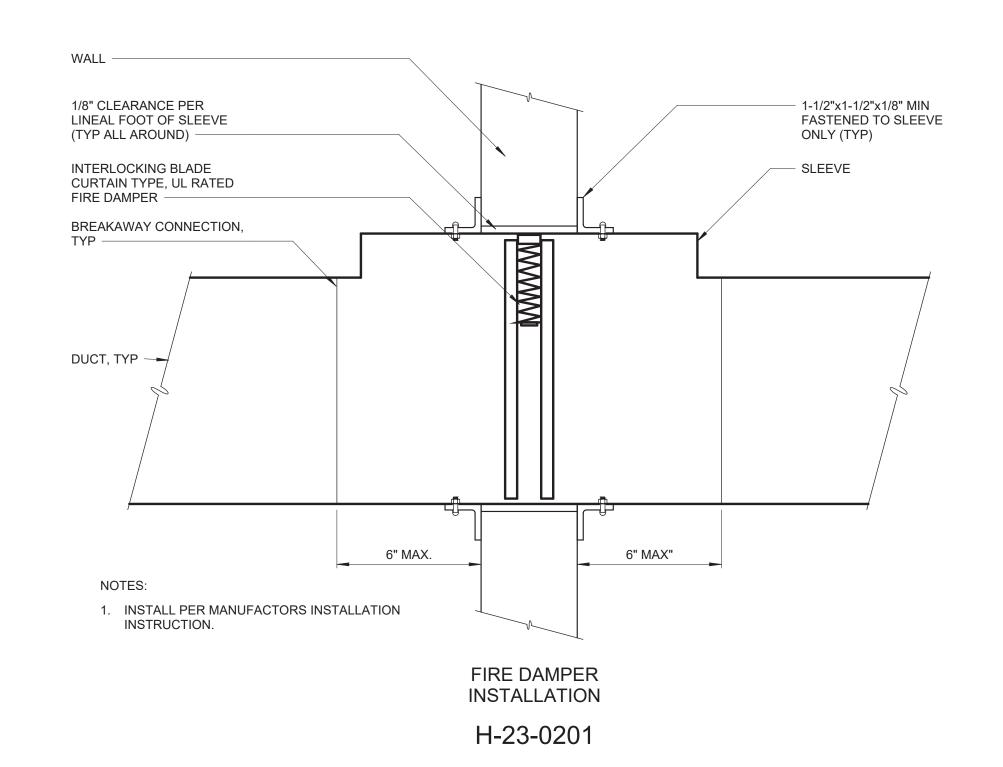

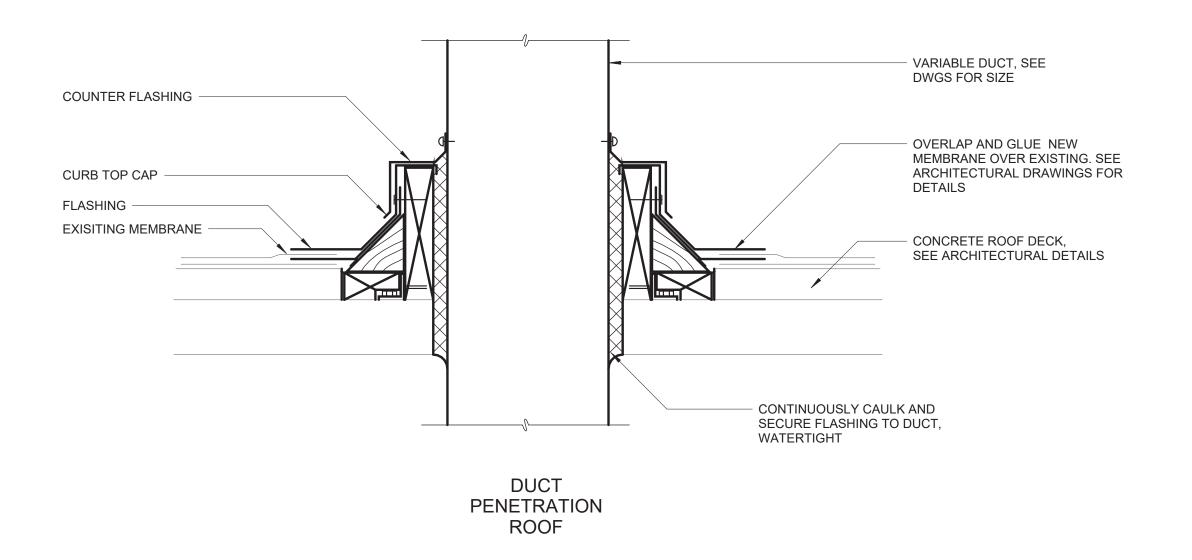

H-23-0203

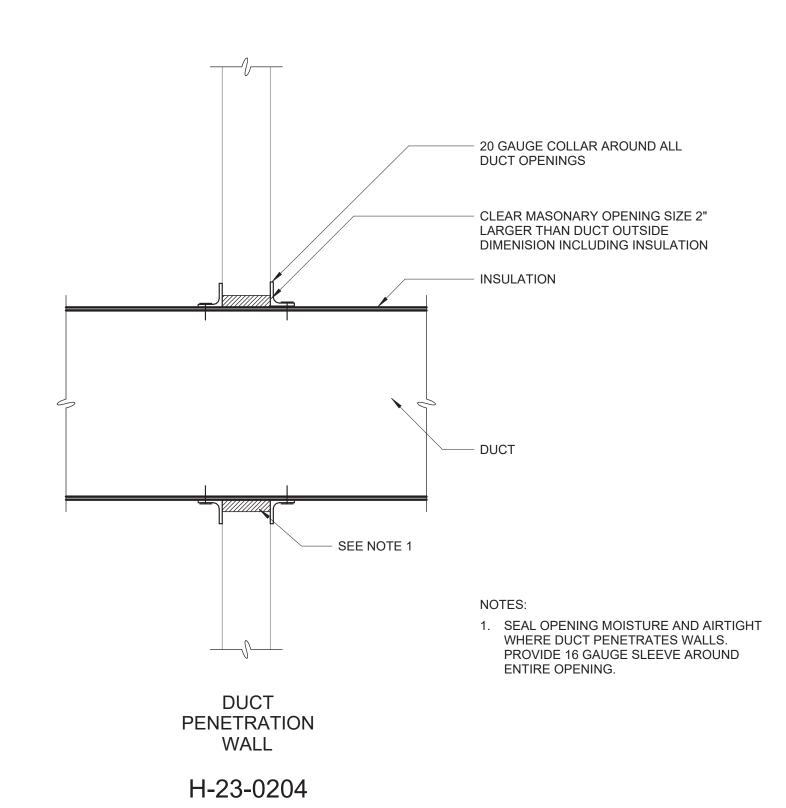

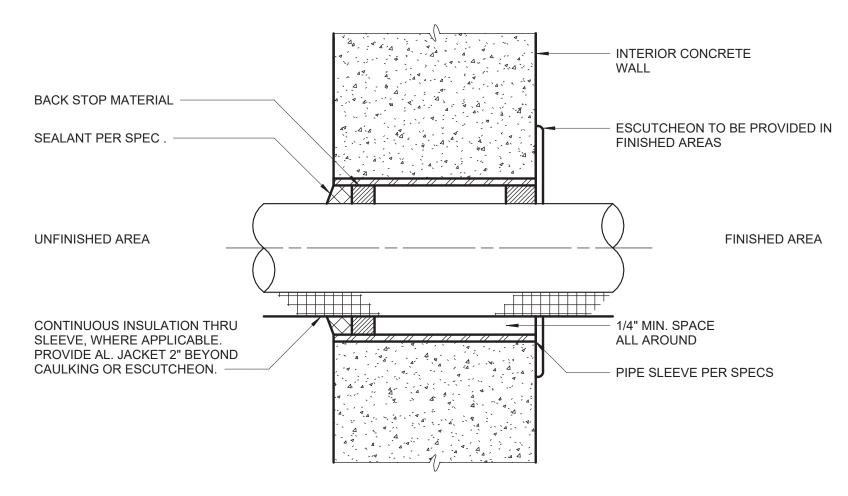

PIPE SLEEVE WALL PENETRATION
P-22-0217

WARNING
IT IS A VIOLATION OF SECTION 7209.2 OF THE NEW YORK STATE EDUCATION LAW FOR
ANY PERSON, UNLESS ACTING UNDER THE DIRECTION OF A LICENSED
PROFESSIONAL ENGINEER, TO ALTER IN ANY WAY PLANS, SPECIFICATIONS, PLATS
OR REPORTS TO WHICH THE SEAL OF A PROFESSIONAL ENGINEER HAS BEEN
APPLIED. IF AN ITEM BEARING THE SEAL OF A PROFESSIONAL ENGINEER IS ALTERED,
THE ALTERING ENGINEER SHALL AFFIX TO THE ITEM HIS SEAL AND THE NOTATION
"ALTERED BY" FOLLOWED BY HIS SIGNATURE, THE DATE, AND A SPECIFIC

ion/9		BY" FOLLOWED BY HIS SIGNATURE, THE DATE, AN TION OF THE ALTERATION	D A SPECIFIC			
ake_Filtration/9					PROJECT ENGINEER:	R. FROST
Rye_Lak					DESIGNED BY:	M. GIORDANO
					DRAWN BY:	R. CHIN
Docs://90388-000 2:43:57 PM					CHECKED BY:	R. VAN DYKE
					IF THIS BAR DOES NOT MEASURE 1" THEN DRAWING	0 1/2" 1"
hutodesk 1/18/2025	REV	ISSUED FOR	DATE	BY	IS NOT TO FULL SCALE	

BID SET




HAZEN AND SAWYER
498 SEVENTH AVENUE, 11th FLOOR
NEW YORK, NEW YORK 10018


WESTCHESTER JOINT WATER WORKS MAMARONECK, NY


RYE LAKE WATER FILTRATION PLANT HARRISON, NY

FILTRATION PLANT HVAC DETAILS - SHEET 1

DATE:	FEB 2025
HAZEN NO.:	90388-000
CONTRACT NO.:	A1364-A
DRAWING NUMBER:	
	H-604

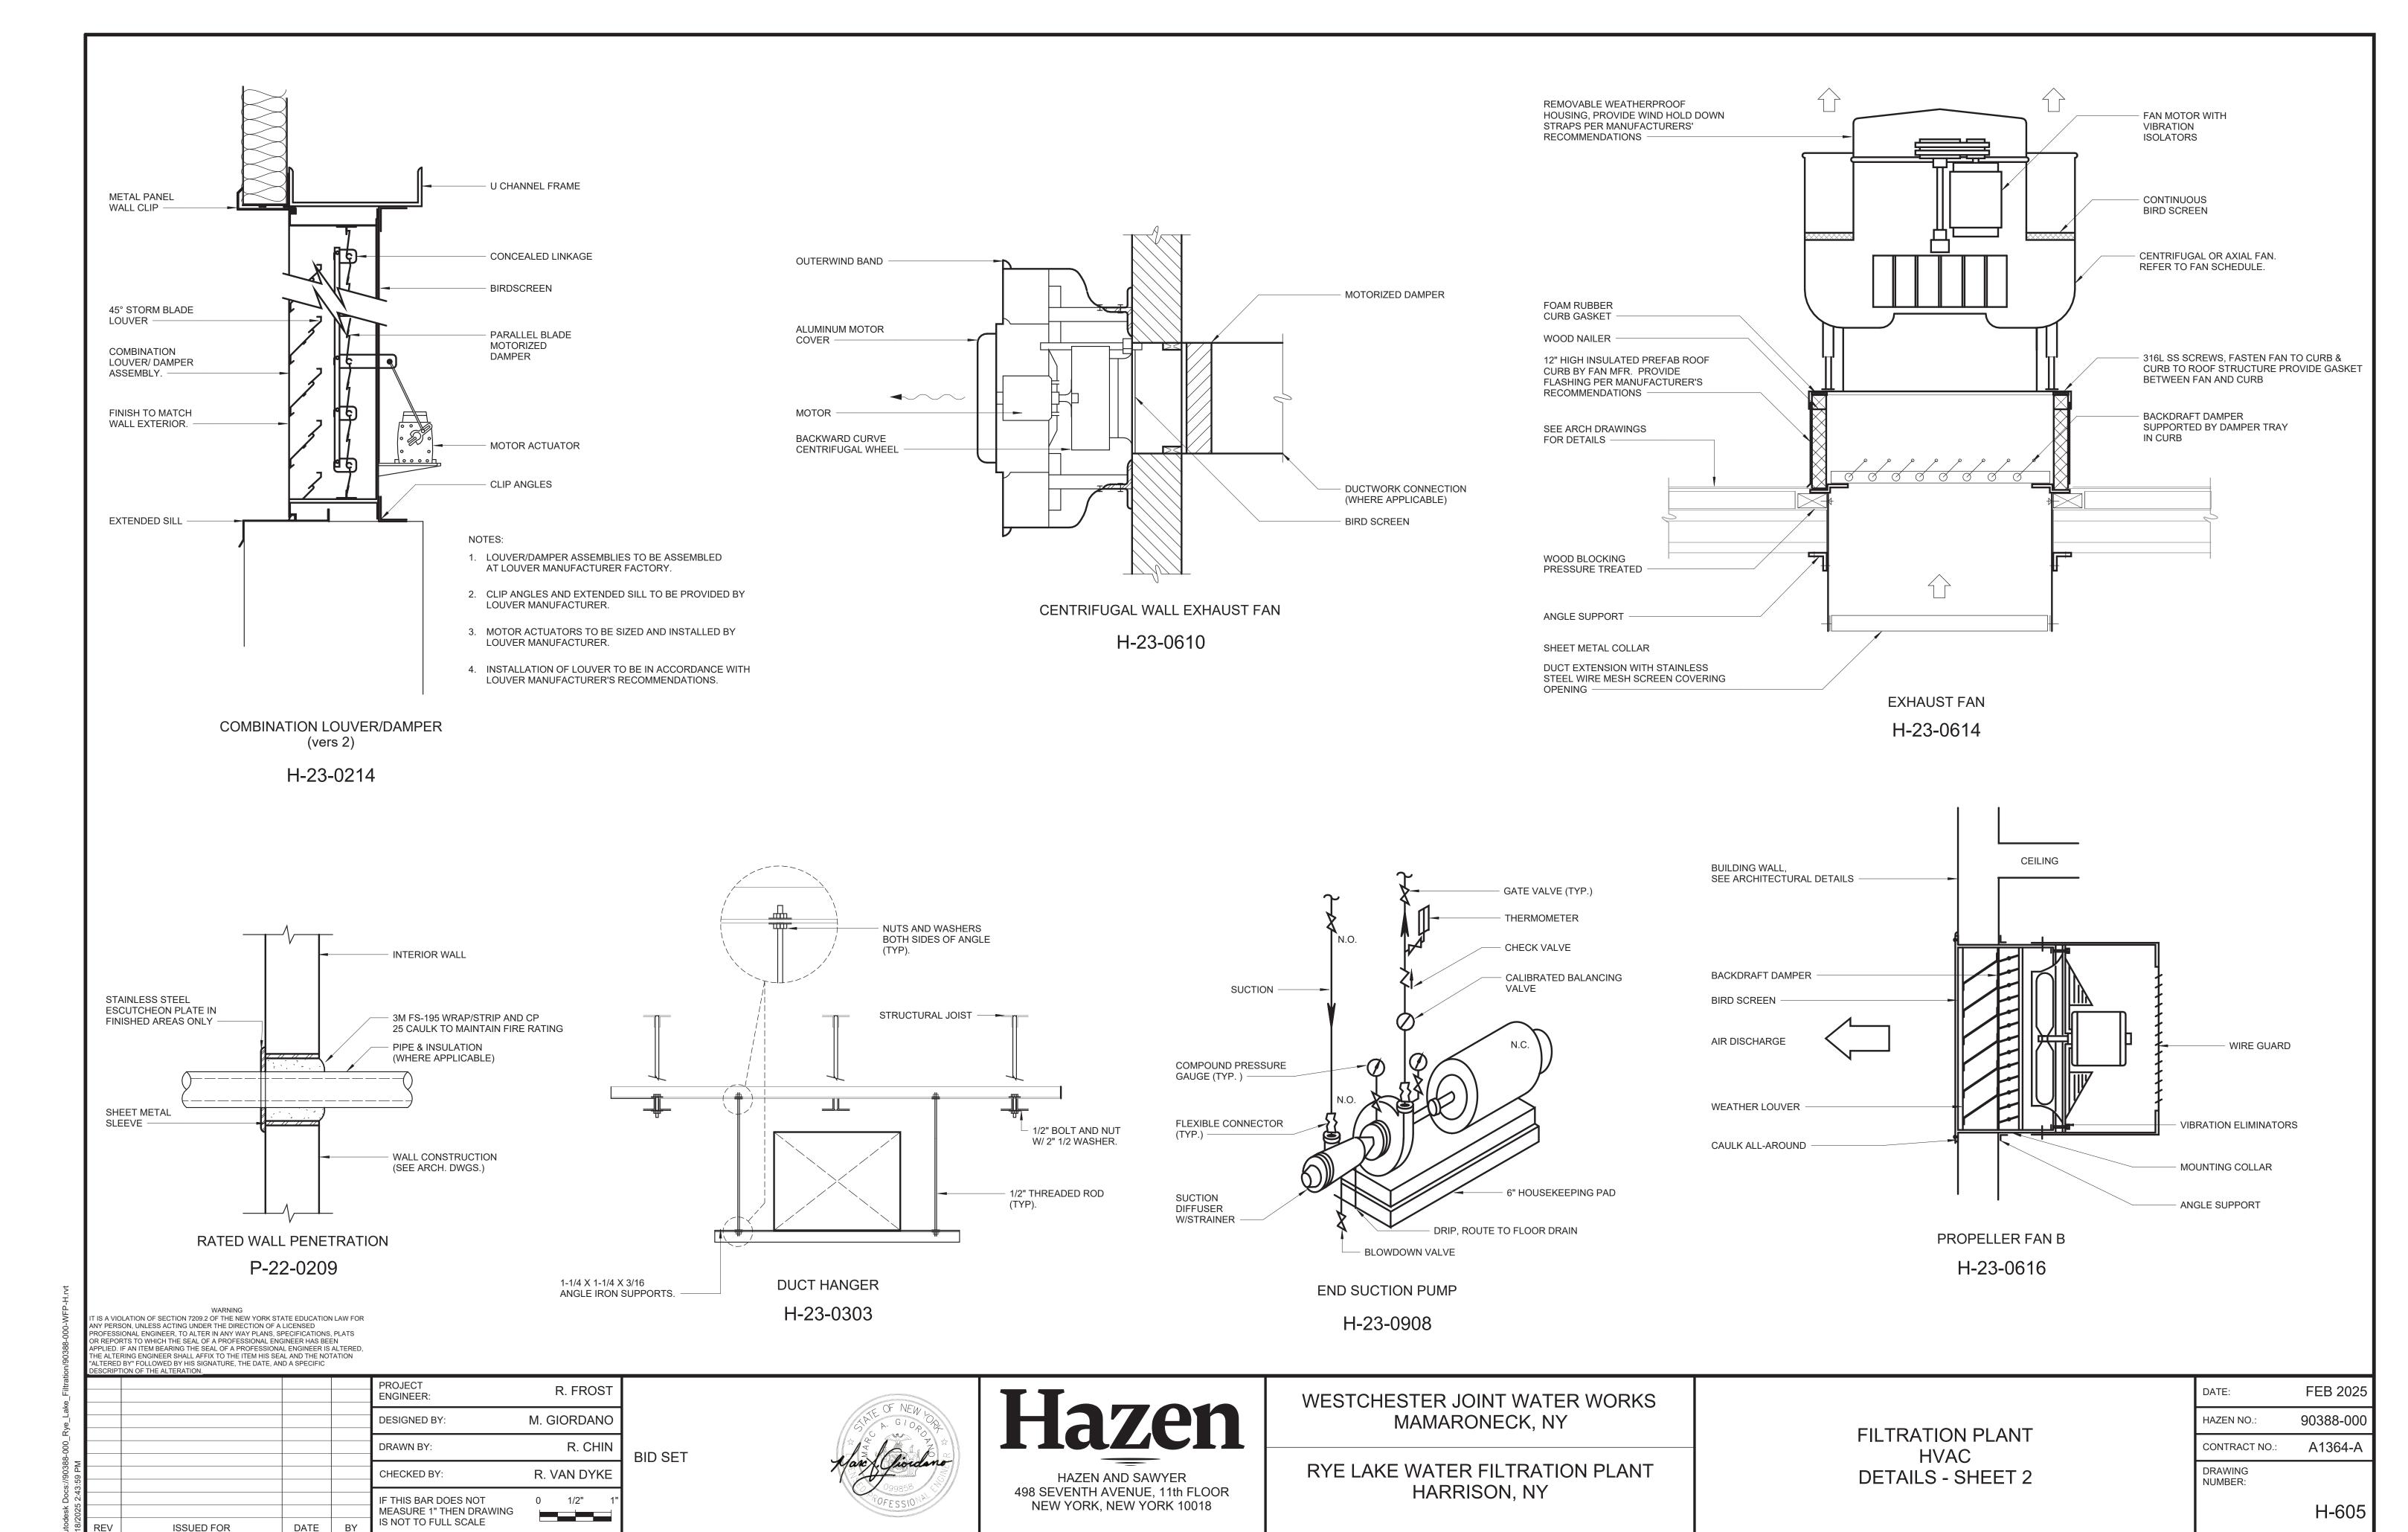

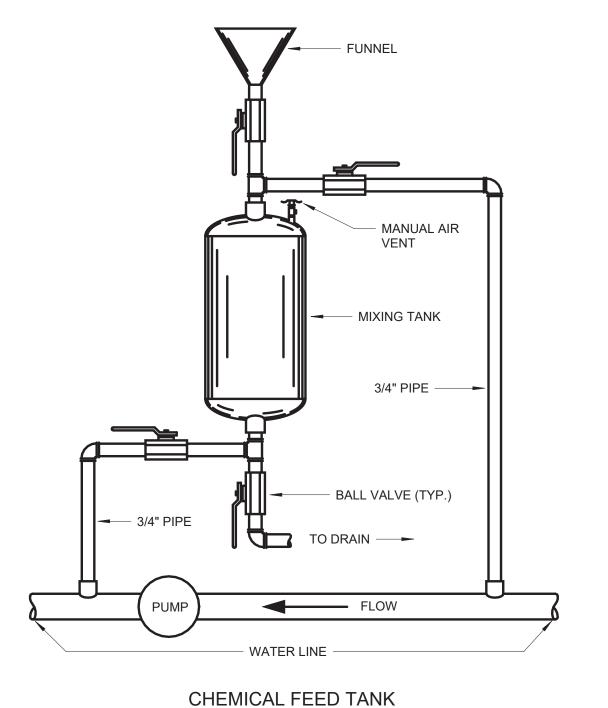

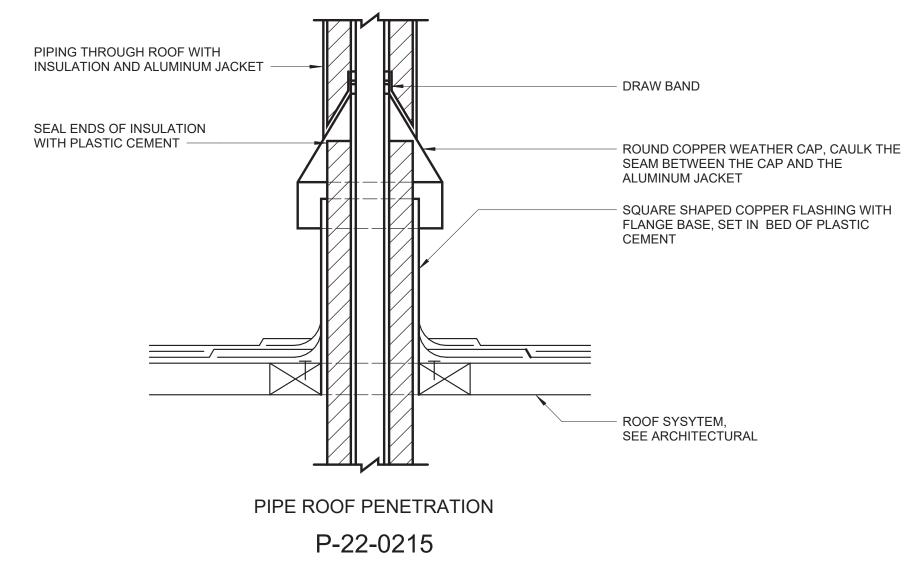

CLEANOUT - VENT LINE PERFORATED CAP CAP (TYP) A/C UNIT PITCH DRAIN PAN DRAIN PIPE TO MATCH CRAIN OUTLET SIZE NOTES: 1. ALLOW SUFFICIENT SPACE BELOW DRAIN PAN FOR TRAP. 2. PITCH DRAIN FOR PROPER RUNOFF. MANUALLY PRIME FILL TRAP BEFORE START-UP TO FORM INITIAL DRAIN SEAL. SUPPORT LENGTHY DRAIN LINES TO PREVENT SAG. DRAW THROUGH COIL (NEGATIVE PRESSURE):

H-23-0635


A. 1 INCH FOR EACH OF NEGATIVE PRESSURE PLUS 1 INCH (NEGATIVE STATIC PRESSURE IN INCHES WG WITH DIRTY FILTERS, COILS, AND MAXIMUM AIR FLOW.)

B. THIS DIMENSION IN INCHES MUST BE EQUAL TO MIN 1/2 OF THE (A) ABOVE.

C. EQUALS (A) + (B) + PIPE DIAMETER + INSULATION

CONDITIONER COIL TRAP


H-23-0401

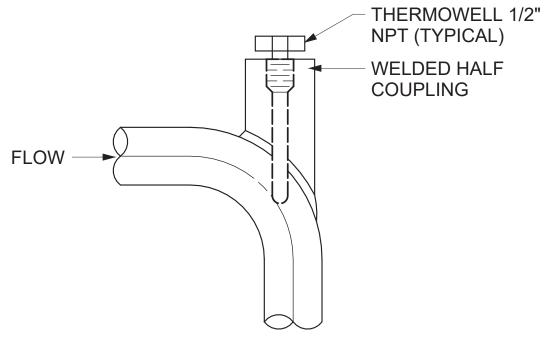

LINE SIZE 3 INCH


OR LARGER


LINE SIZE 3 INCH OR LARGER

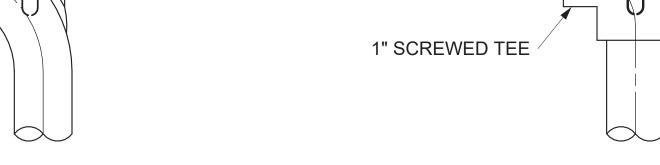



FLOW



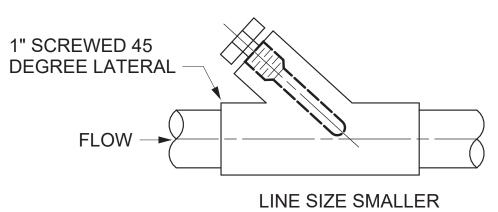

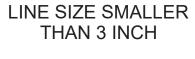


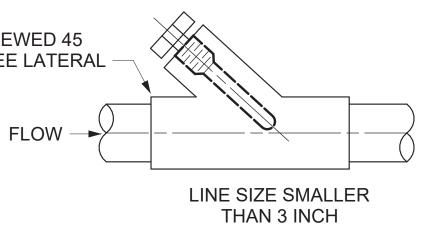

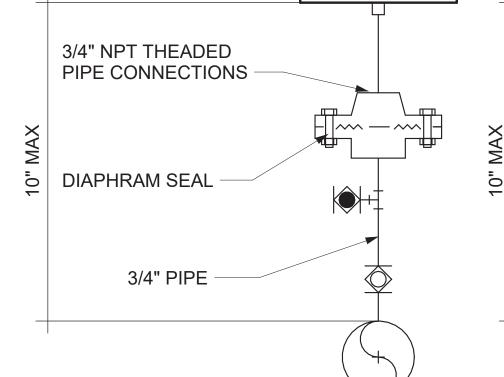

PRESSURE INSTRUMENTS

NOT TO SCALE

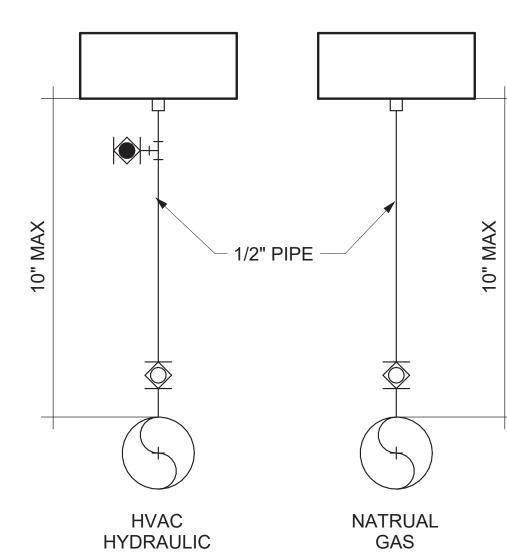

NOTE:

FLOW

INSTALL THERMOWELL AT 1/2 THE INSIDE DIAMETER OF THE PROCESS PIPE.



IF THIS BAR DOES NOT

IS NOT TO FULL SCALE

MEASURE 1" THEN DRAWING

WELDED HALF

COUPLING

PROCESS LINE TAP THERMOWELLS

NOT TO SCALE

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ISSUED FOR

PROJECT ENGINEER: **DESIGNED BY** DRAWN BY: CHECKED BY:

DATE

M. GIORDANO R. CHIN **BID SET** R. VAN DYKE

R. FROST

1/2"



Hazen HAZEN AND SAWYER 498 SEVENTH AVENUE, 11th FLOOR

NEW YORK, NEW YORK 10018

WESTCHESTER JOINT WATER WORKS MAMARONECK, NY

PRESSURE INSTRUMENT

RYE LAKE WATER FILTRATION PLANT HARRISON, NY

FILTRATION PLANT HVAC DETAILS - SHEET 3

DATE:	FEB 2025
HAZEN NO.:	90388-000
CONTRACT NO.:	A1364-A
DRAWING NUMBER:	
	H-606