

"ALTERED BY" FOLLOWED BY HIS SIGNATURE, THE DATE, AND A SPECIFIC DESCRIPTION OF THE ALTERATION.

PROJECT ENGINEER:

DESIGNED BY:

M. GIORDANO

DRAWN BY:

J. LURIE

CHECKED BY:

R. FROST

BY TOLLOWED BY HIS SIGNATURE, THE DATE, AND A SPECIFIC DESCRIPTION OF THE ALTERATION.

PROJECT ENGINEER:

DESIGNED BY:

M. GIORDANO

DRAWN BY:

J. LURIE

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MEASURE 1" THEN DRAWING

DATE BY

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HAZEN AND SAWYER
498 SEVENTH AVENUE, 11th FLOOR


NEW YORK, NEW YORK 10018


WESTCHESTER JOINT WATER WORKS MAMARONECK, NY

RYE LAKE WATER FILTRATION PLANT HARRISON, NY FILTRATION PLANT
PLUMBING
GENERAL NOTES, SYMBOLS AND ABBREVIATIONS


	DATE:	FEB 2025
	HAZEN NO.:	90388-000
	CONTRACT NO.:	A1364-A
•	DRAWING NUMBER:	

P-001

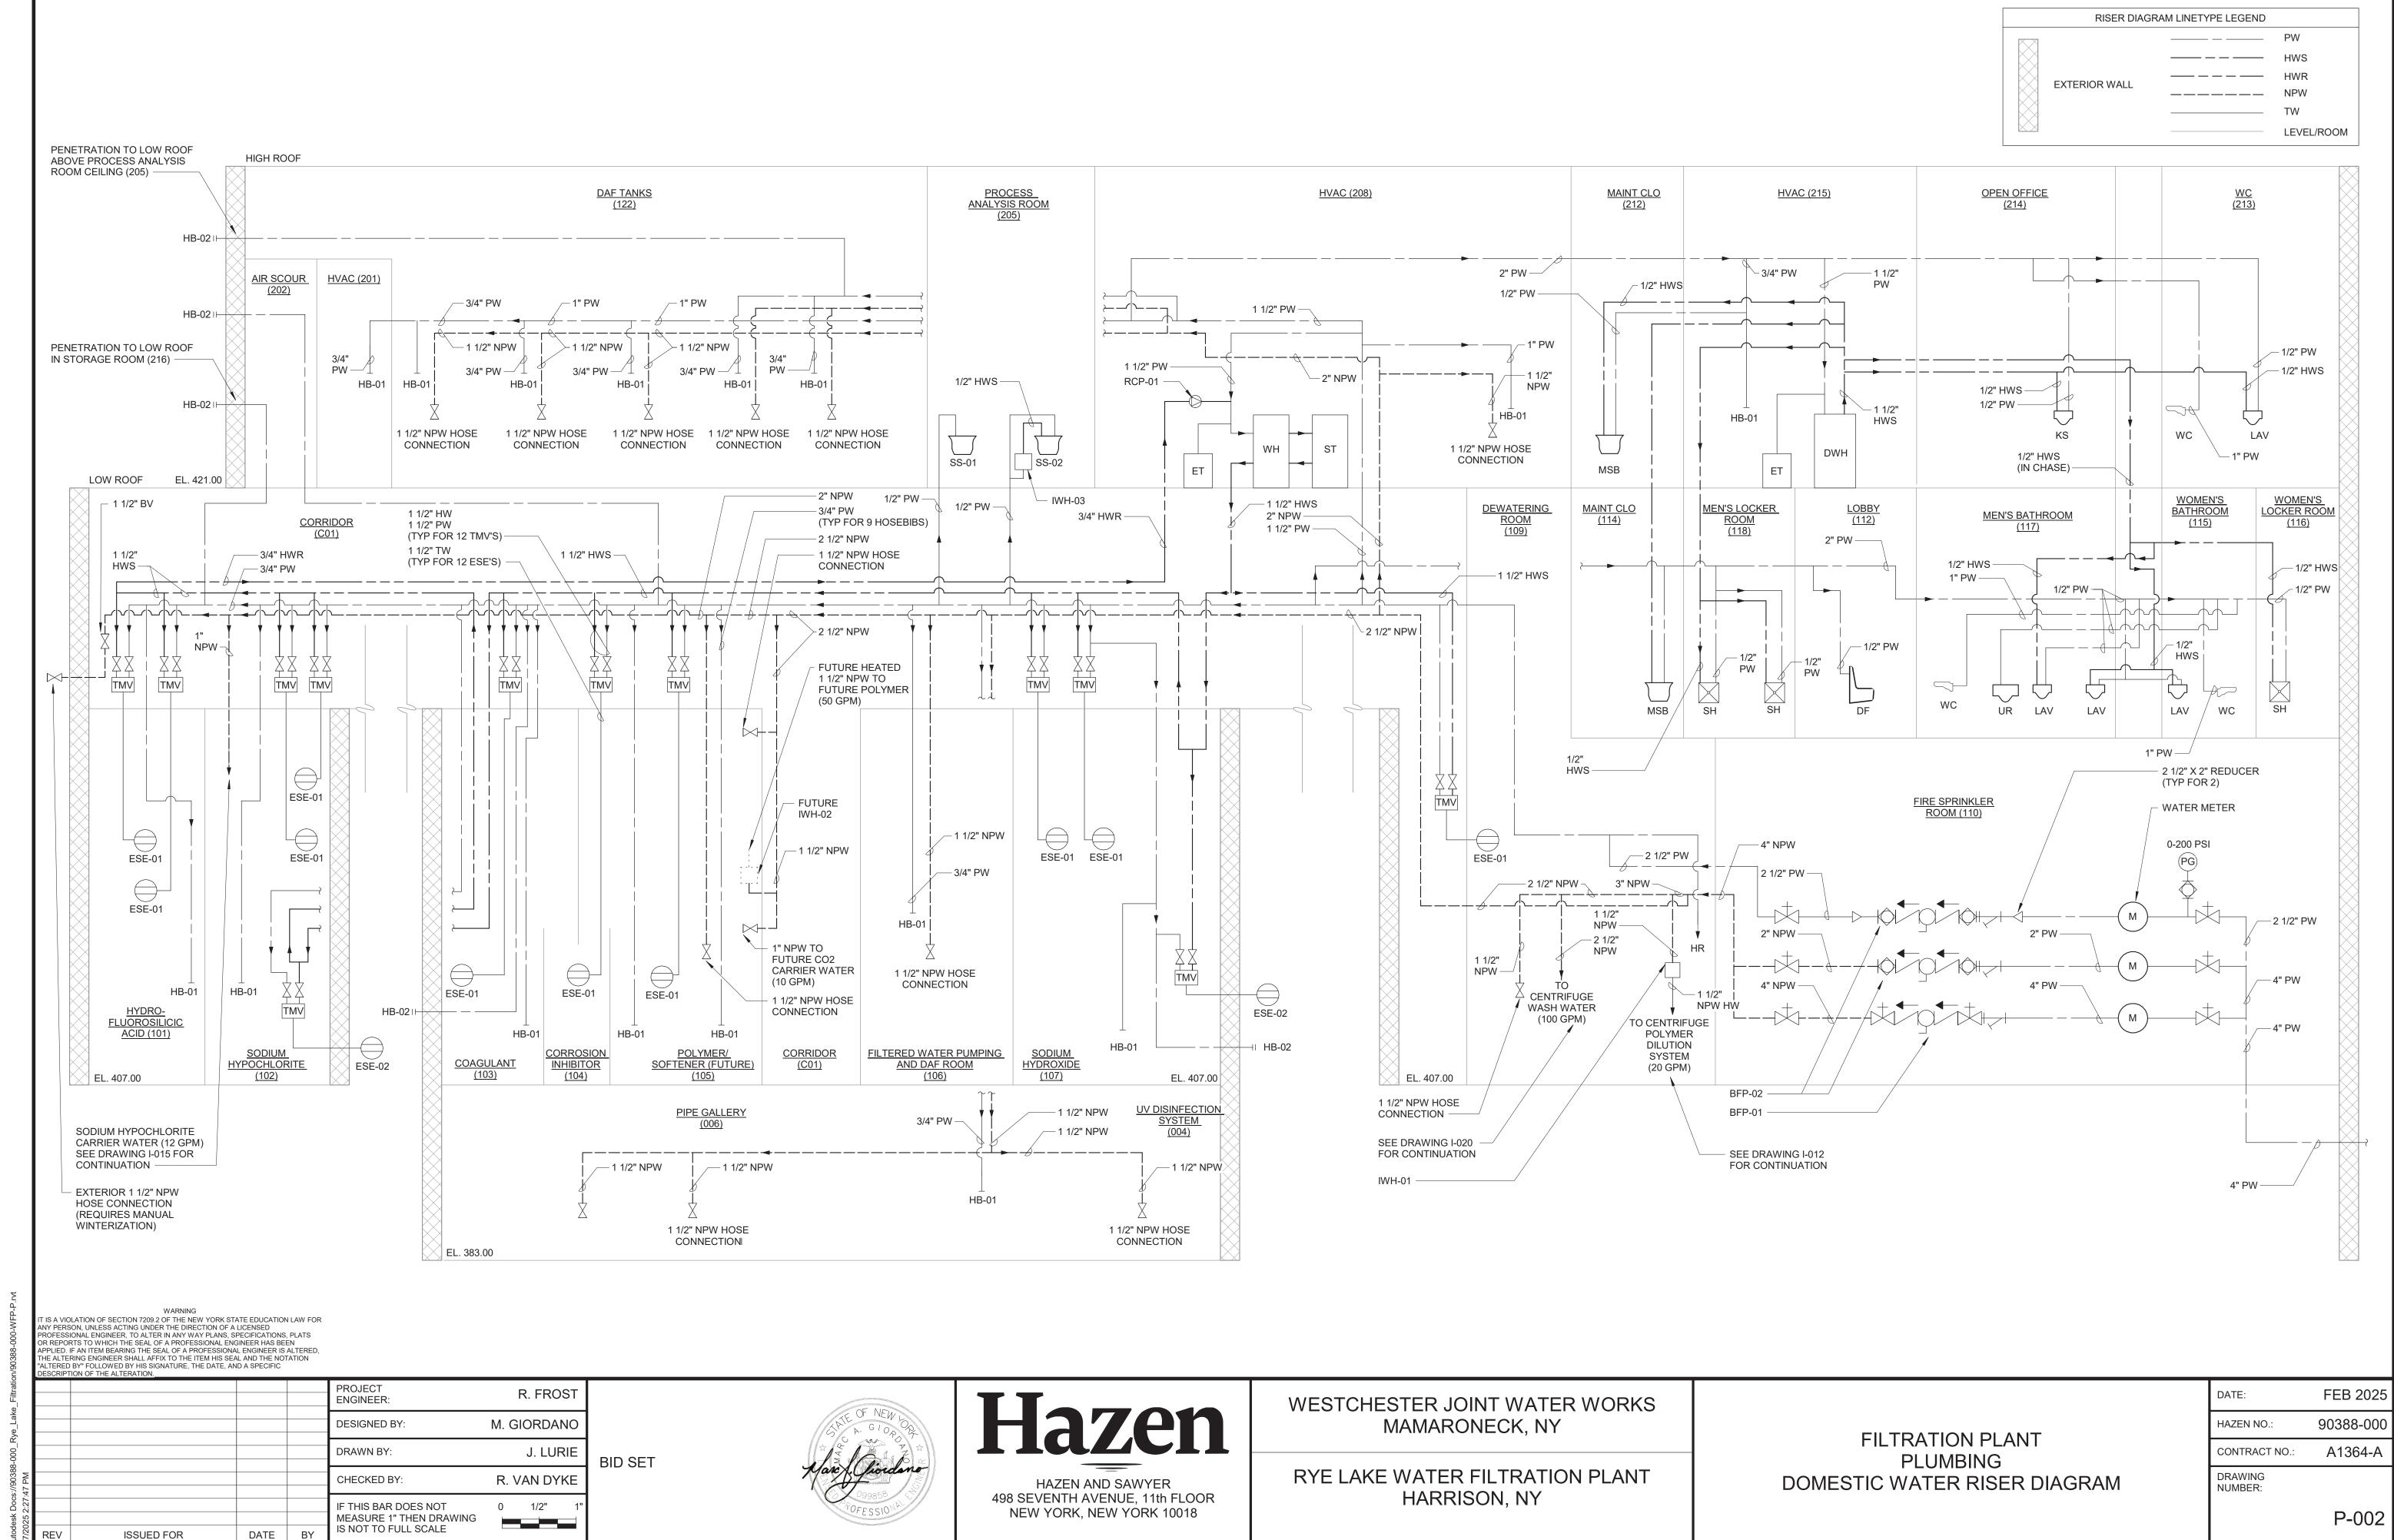

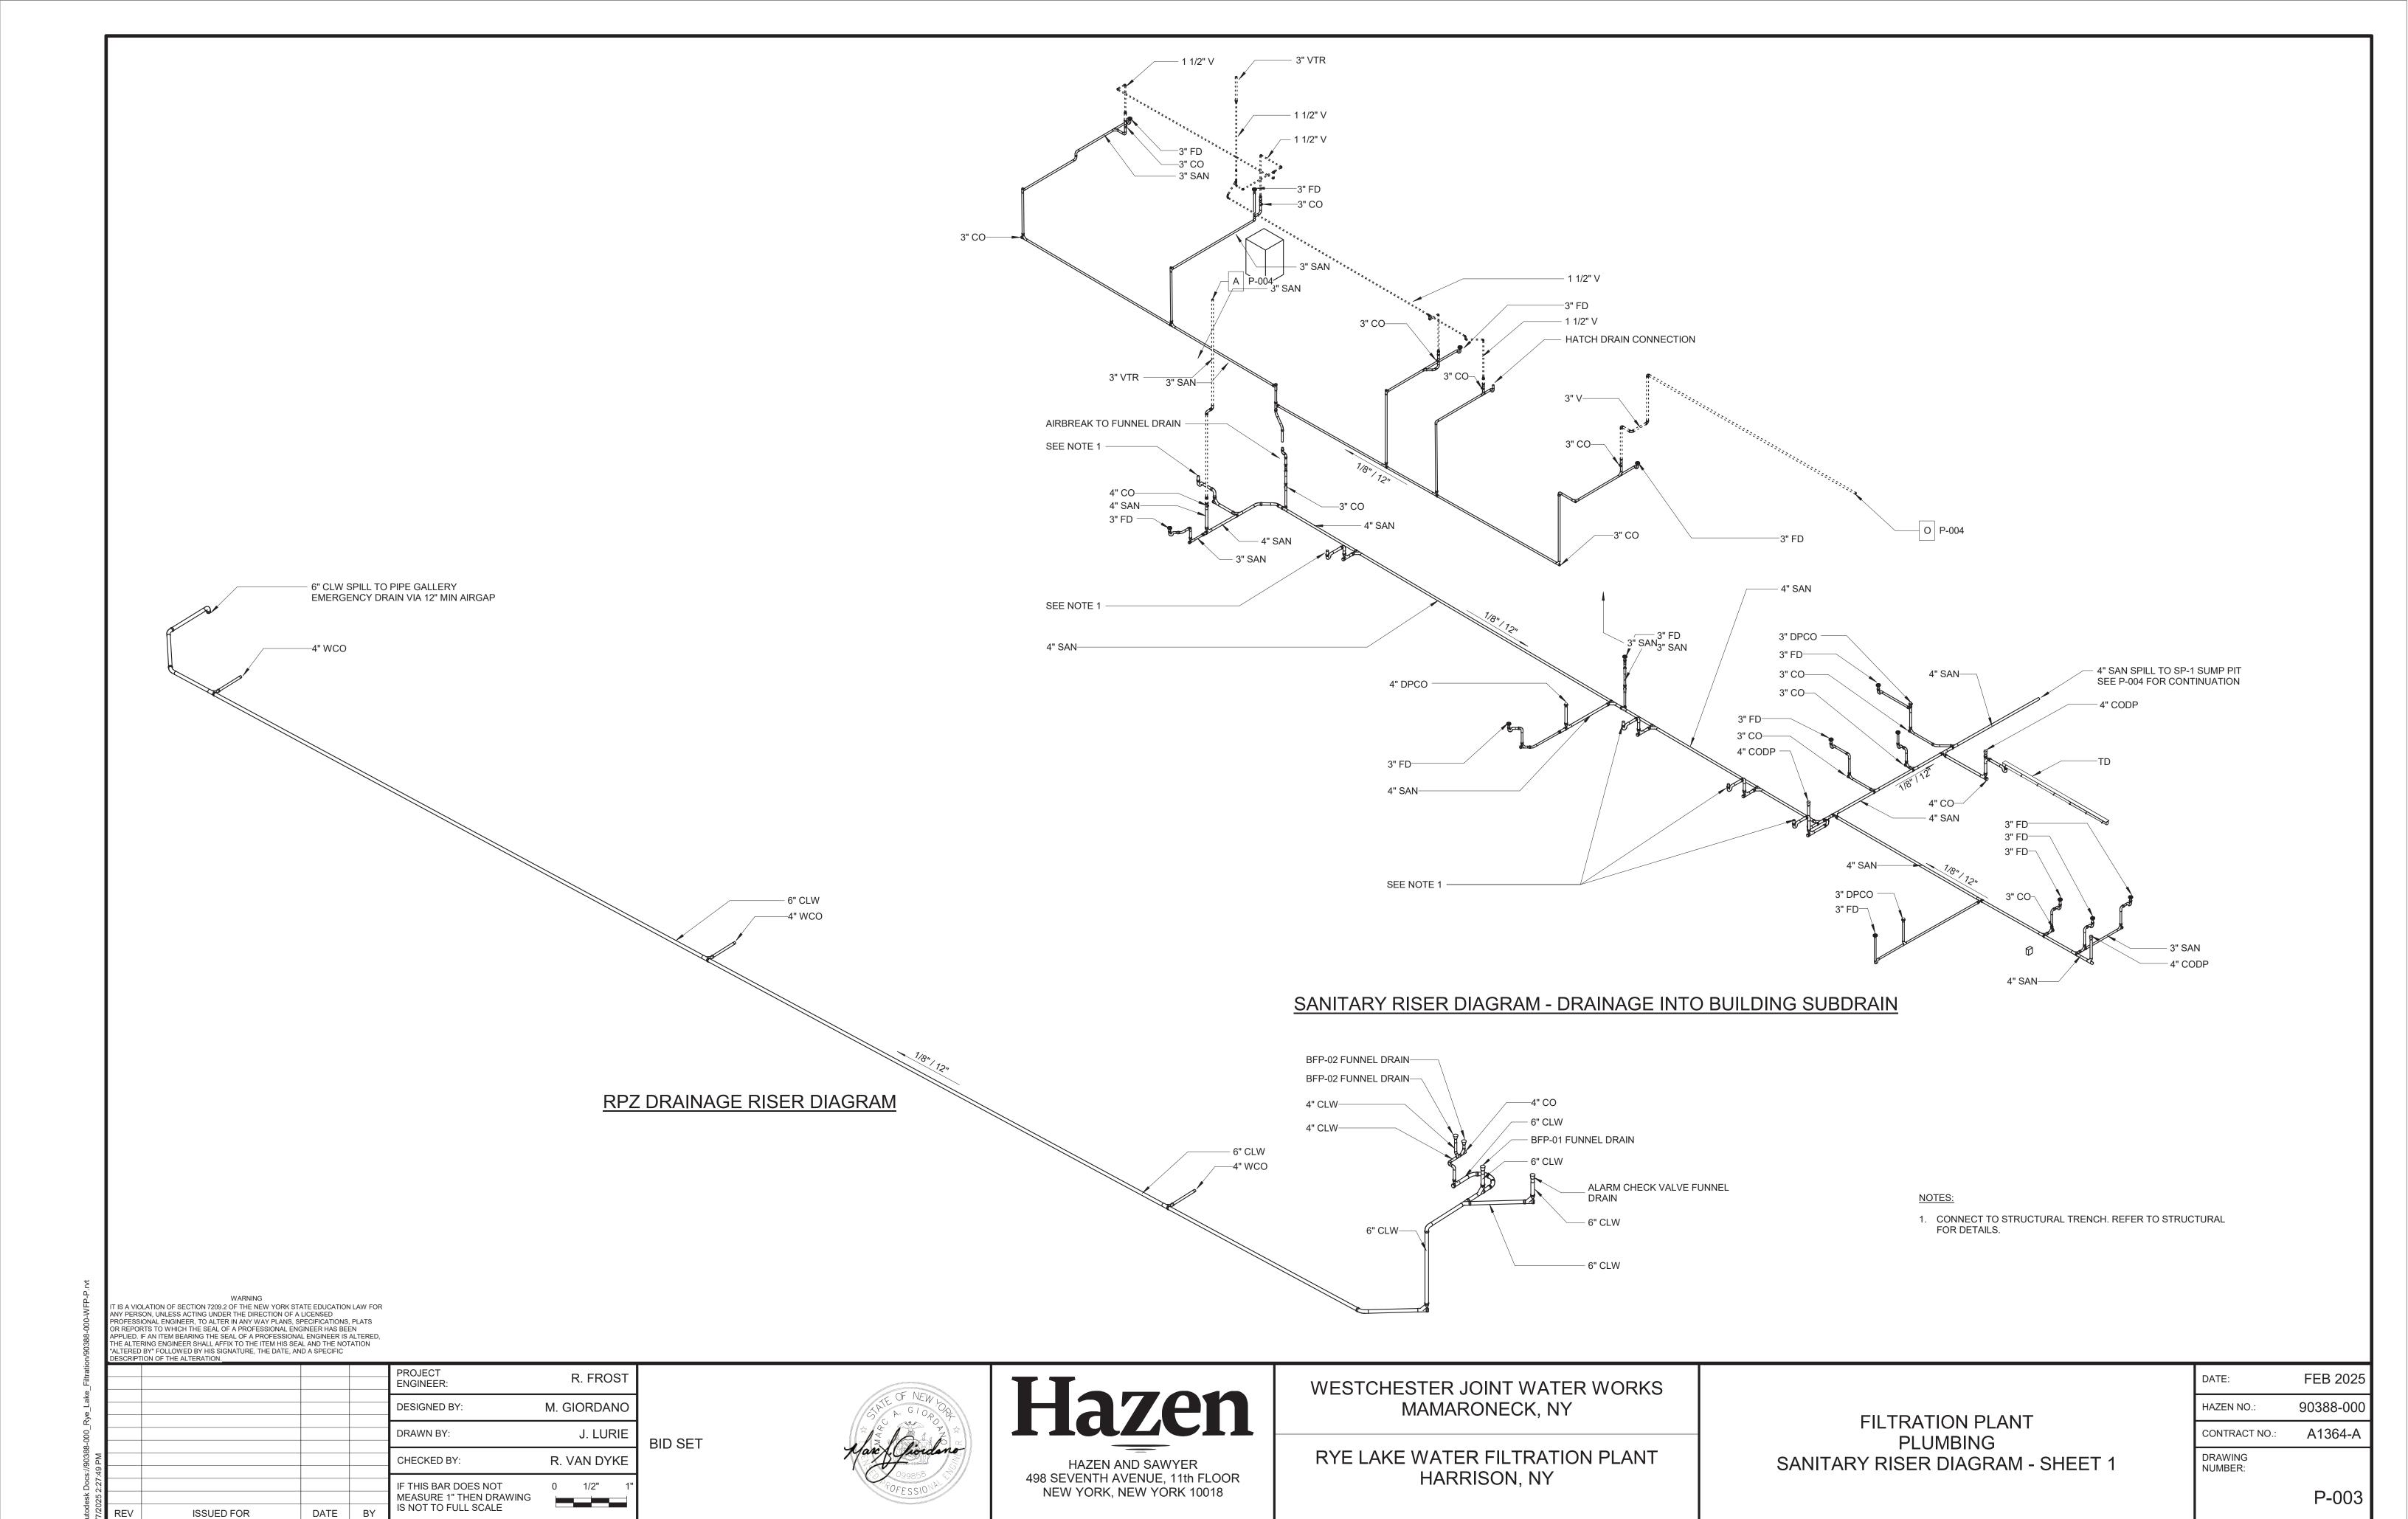

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NEW YORK, NEW YORK 10018
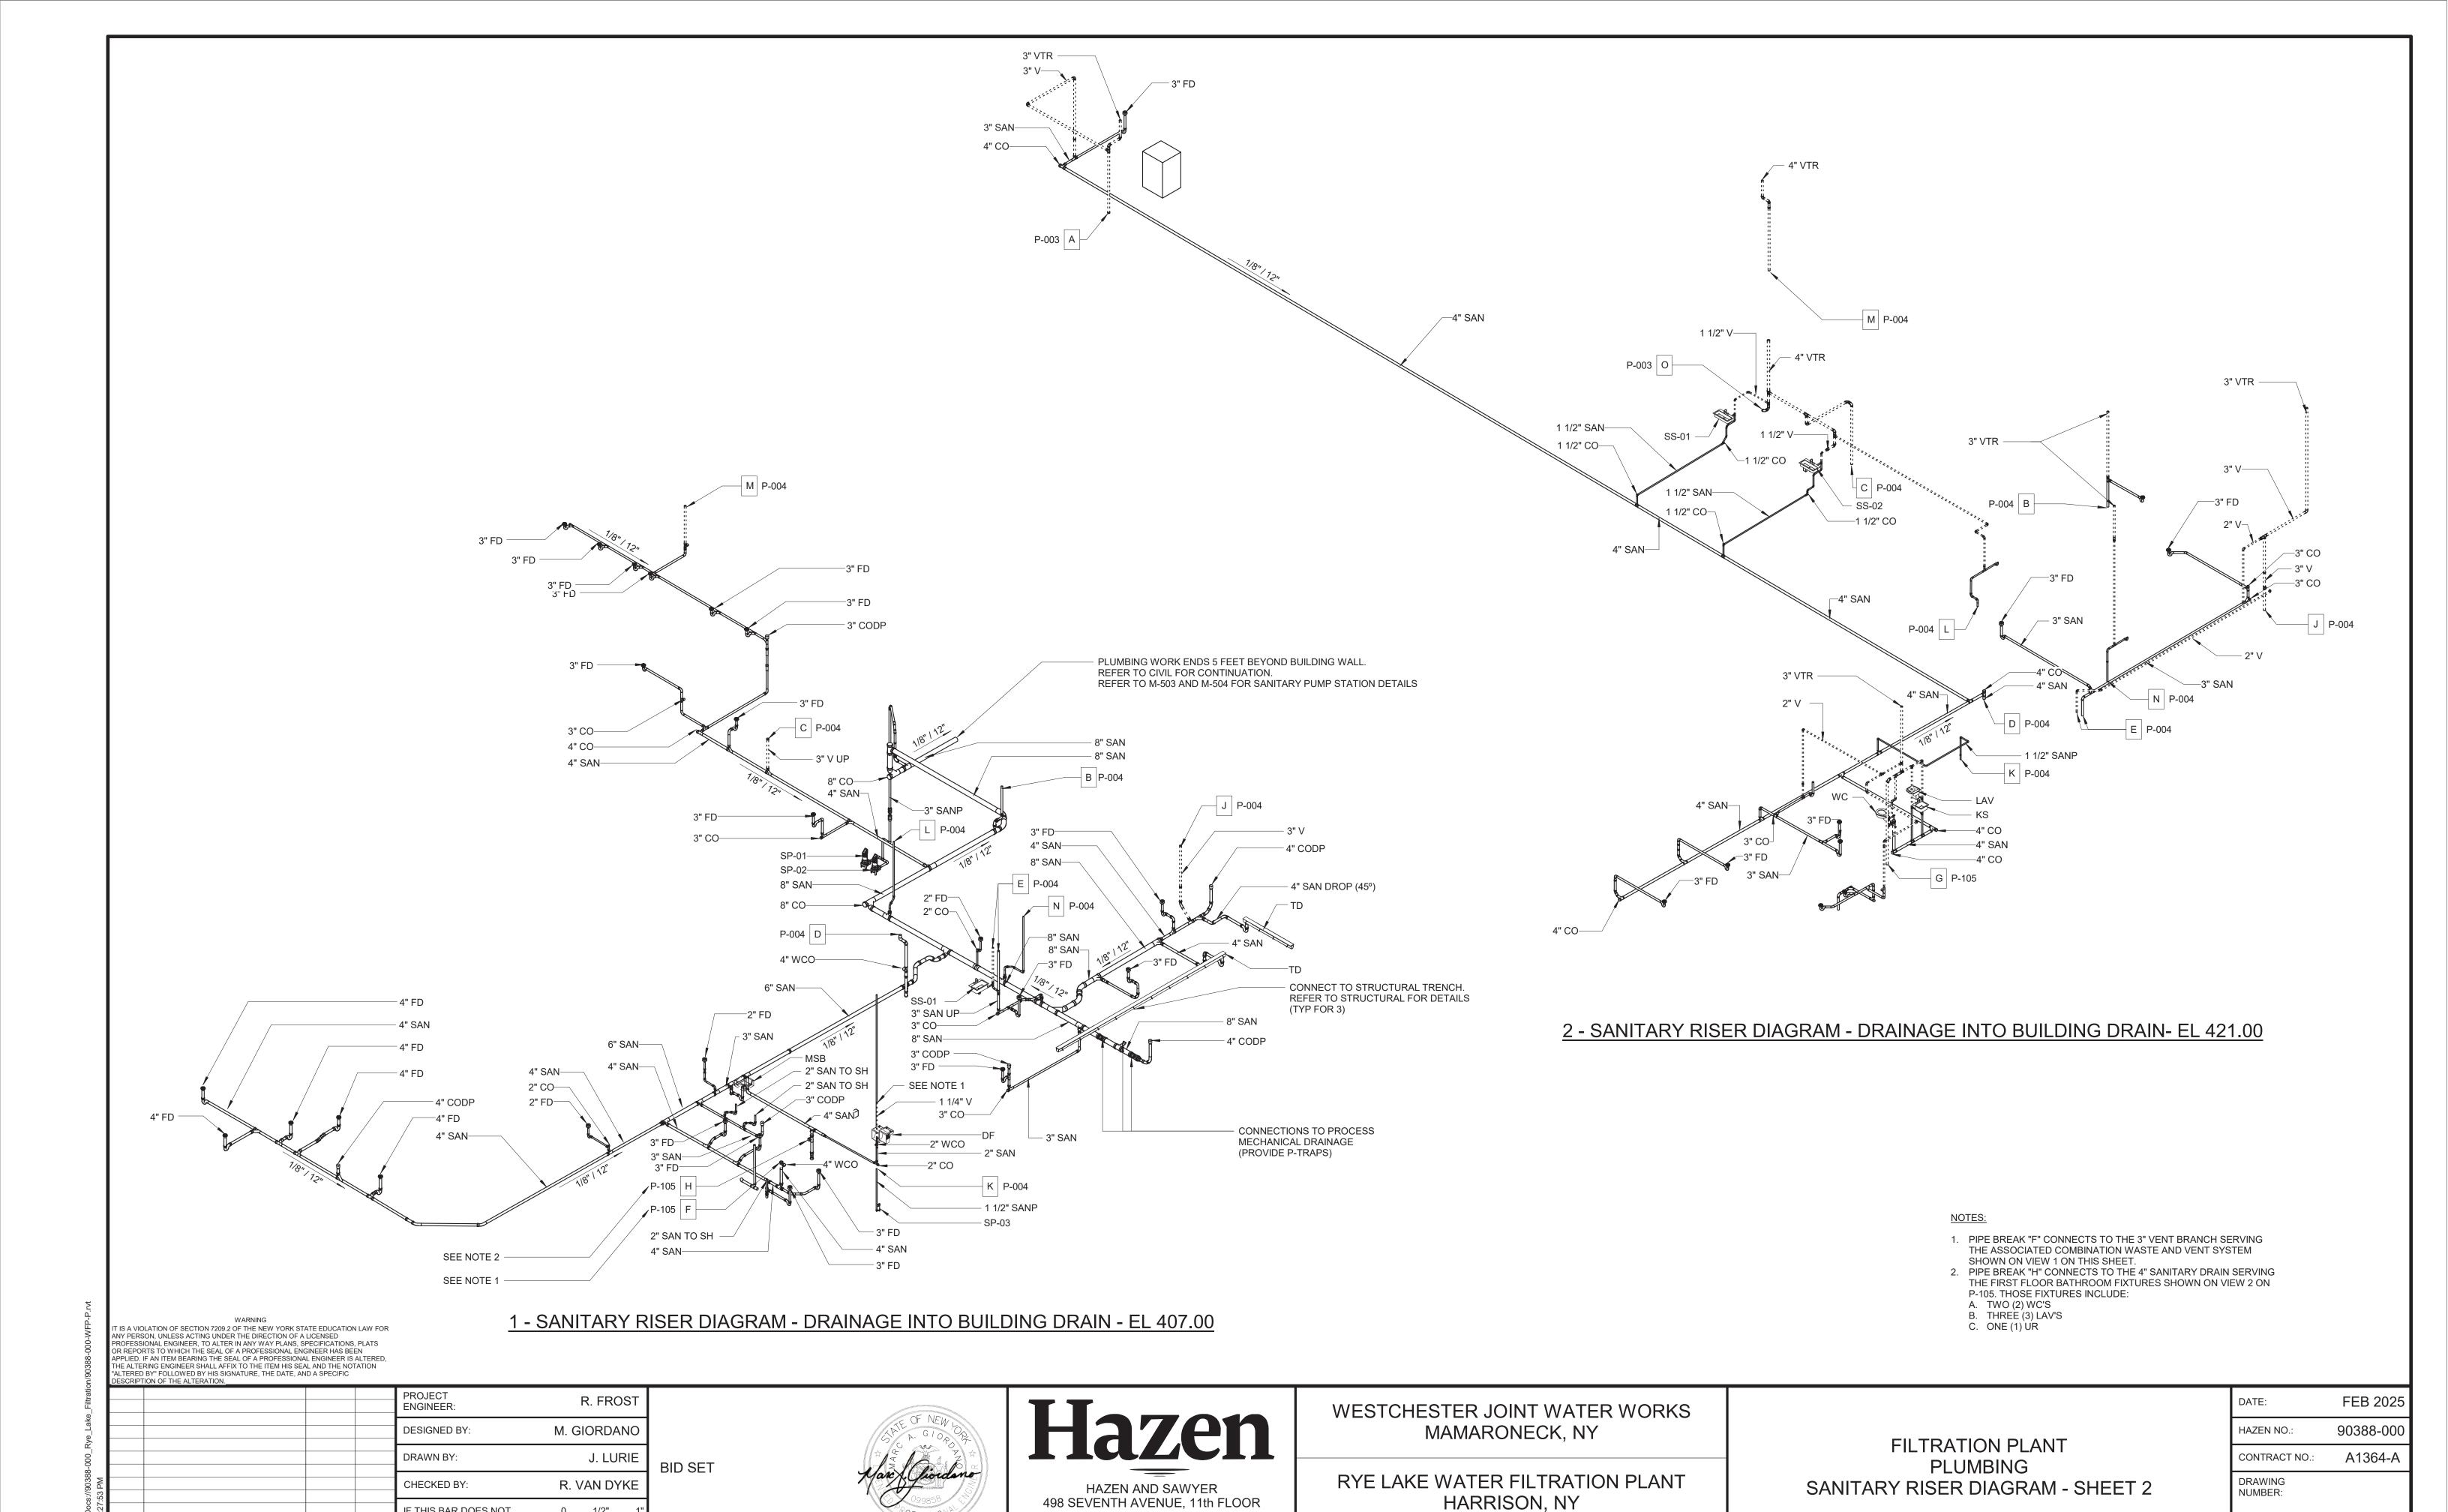
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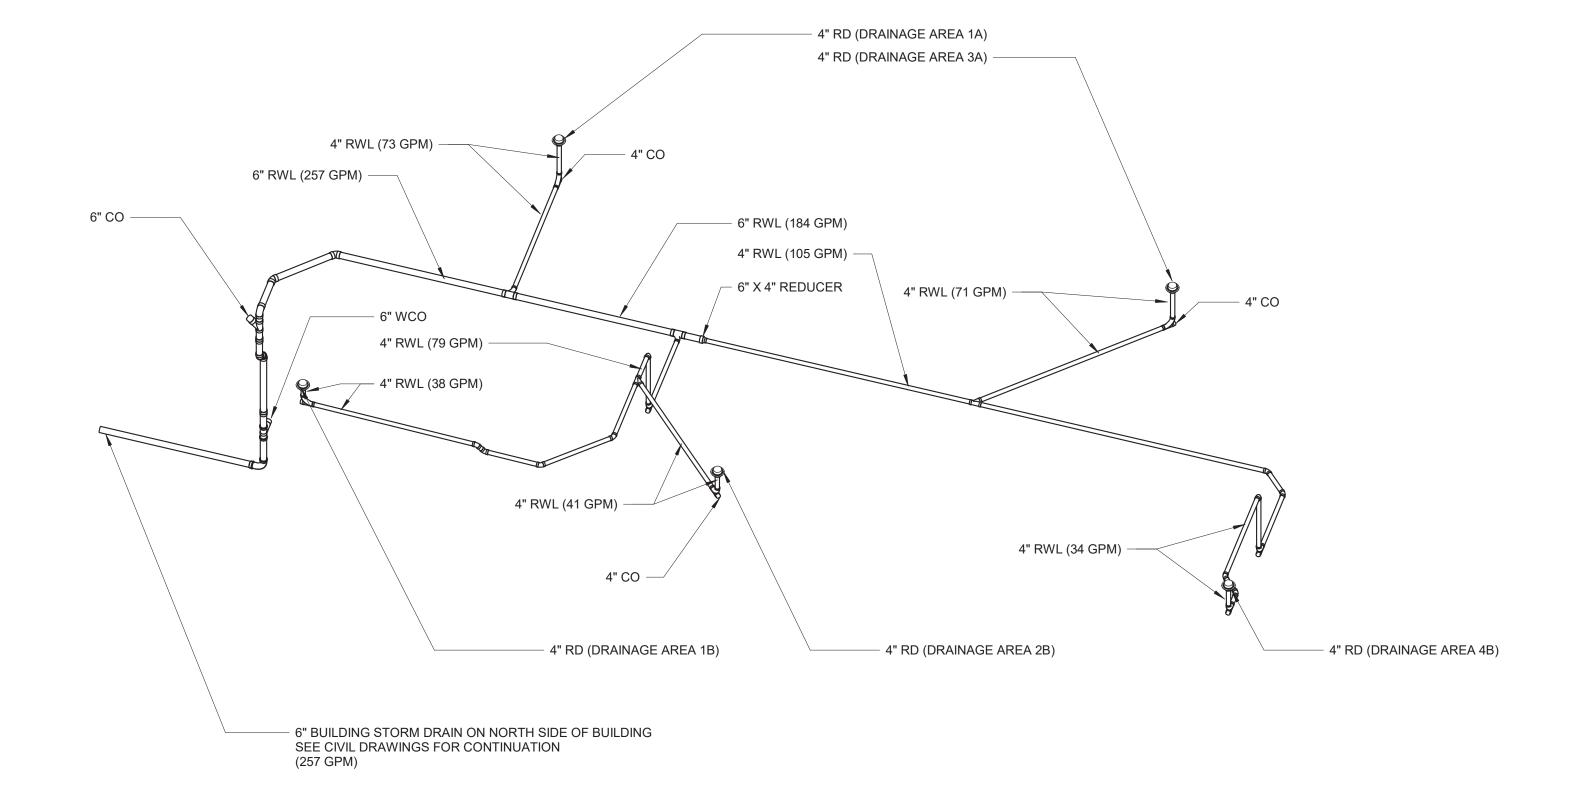
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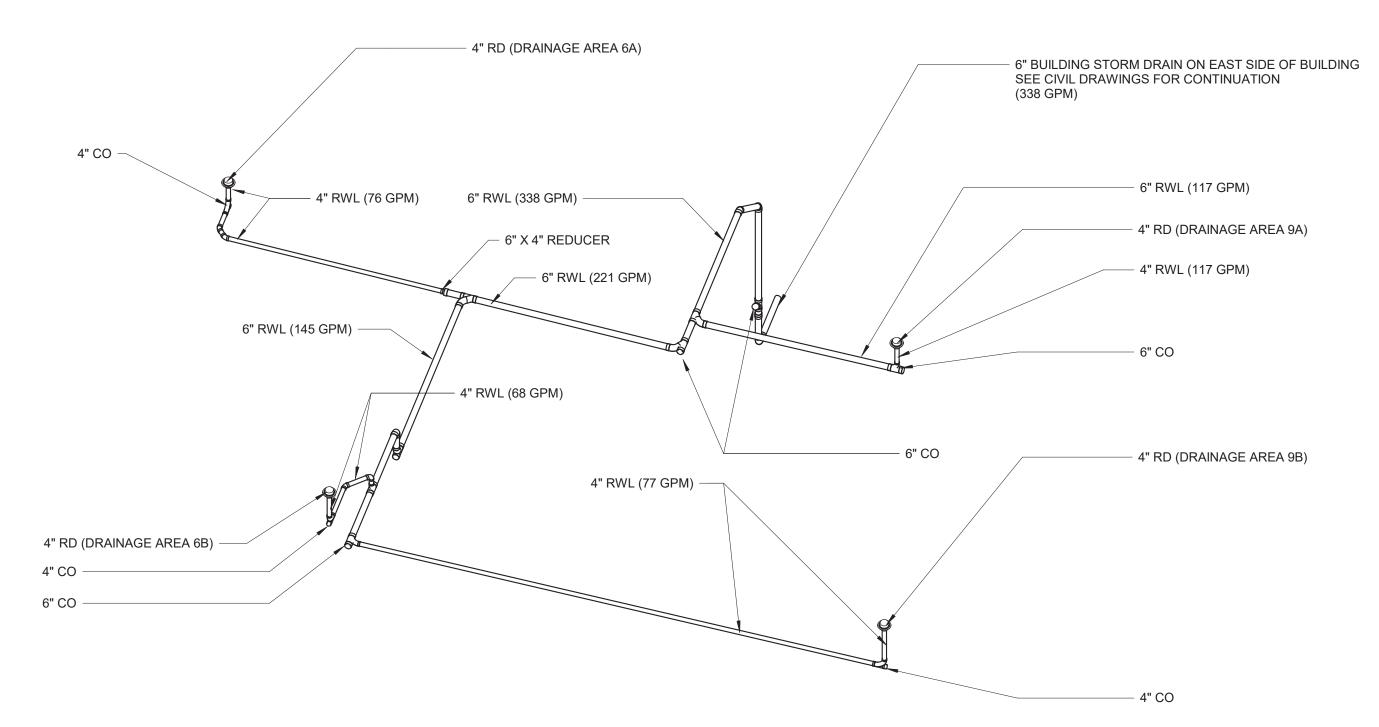
278 of 392

P-004

1. ALL HORIZONTAL STORM PIPING SHALL BE SLOPED AT 1/8" PER FOOT.



BID SET



WARNING
IT IS A VIOLATION OF SECTION 7209.2 OF THE NEW YORK STATE EDUCATION LAW FOR ANY PERSON, UNLESS ACTING UNDER THE DIRECTION OF A LICENSED PROFESSIONAL ENGINEER, TO ALTER IN ANY WAY PLANS, SPECIFICATIONS, PLATS OR REPORTS TO WHICH THE SEAL OF A PROFESSIONAL ENGINEER HAS BEEN APPLIED. IF AN ITEM BEARING THE SEAL OF A PROFESSIONAL ENGINEER IS ALTERED, THE ALTERING ENGINEER SHALL AFFIX TO THE ITEM HIS SEAL AND THE NOTATION "ALTERED BY" FOLLOWED BY HIS SIGNATURE, THE DATE, AND A SPECIFIC DESCRIPTION OF THE ALTERATION.

riitratio					PROJECT ENGINEER:	R. FROST		
_Kye_Lake_					DESIGNED BY:	M. GIORDANO		
					DRAWN BY:	J. LURIE		
Docs://90368-000_ 2:27:54 PM					CHECKED BY:	R. VAN DYKE		
					IF THIS BAR DOES NOT MEASURE 1" THEN DRAWING	0 1/2" 1"		
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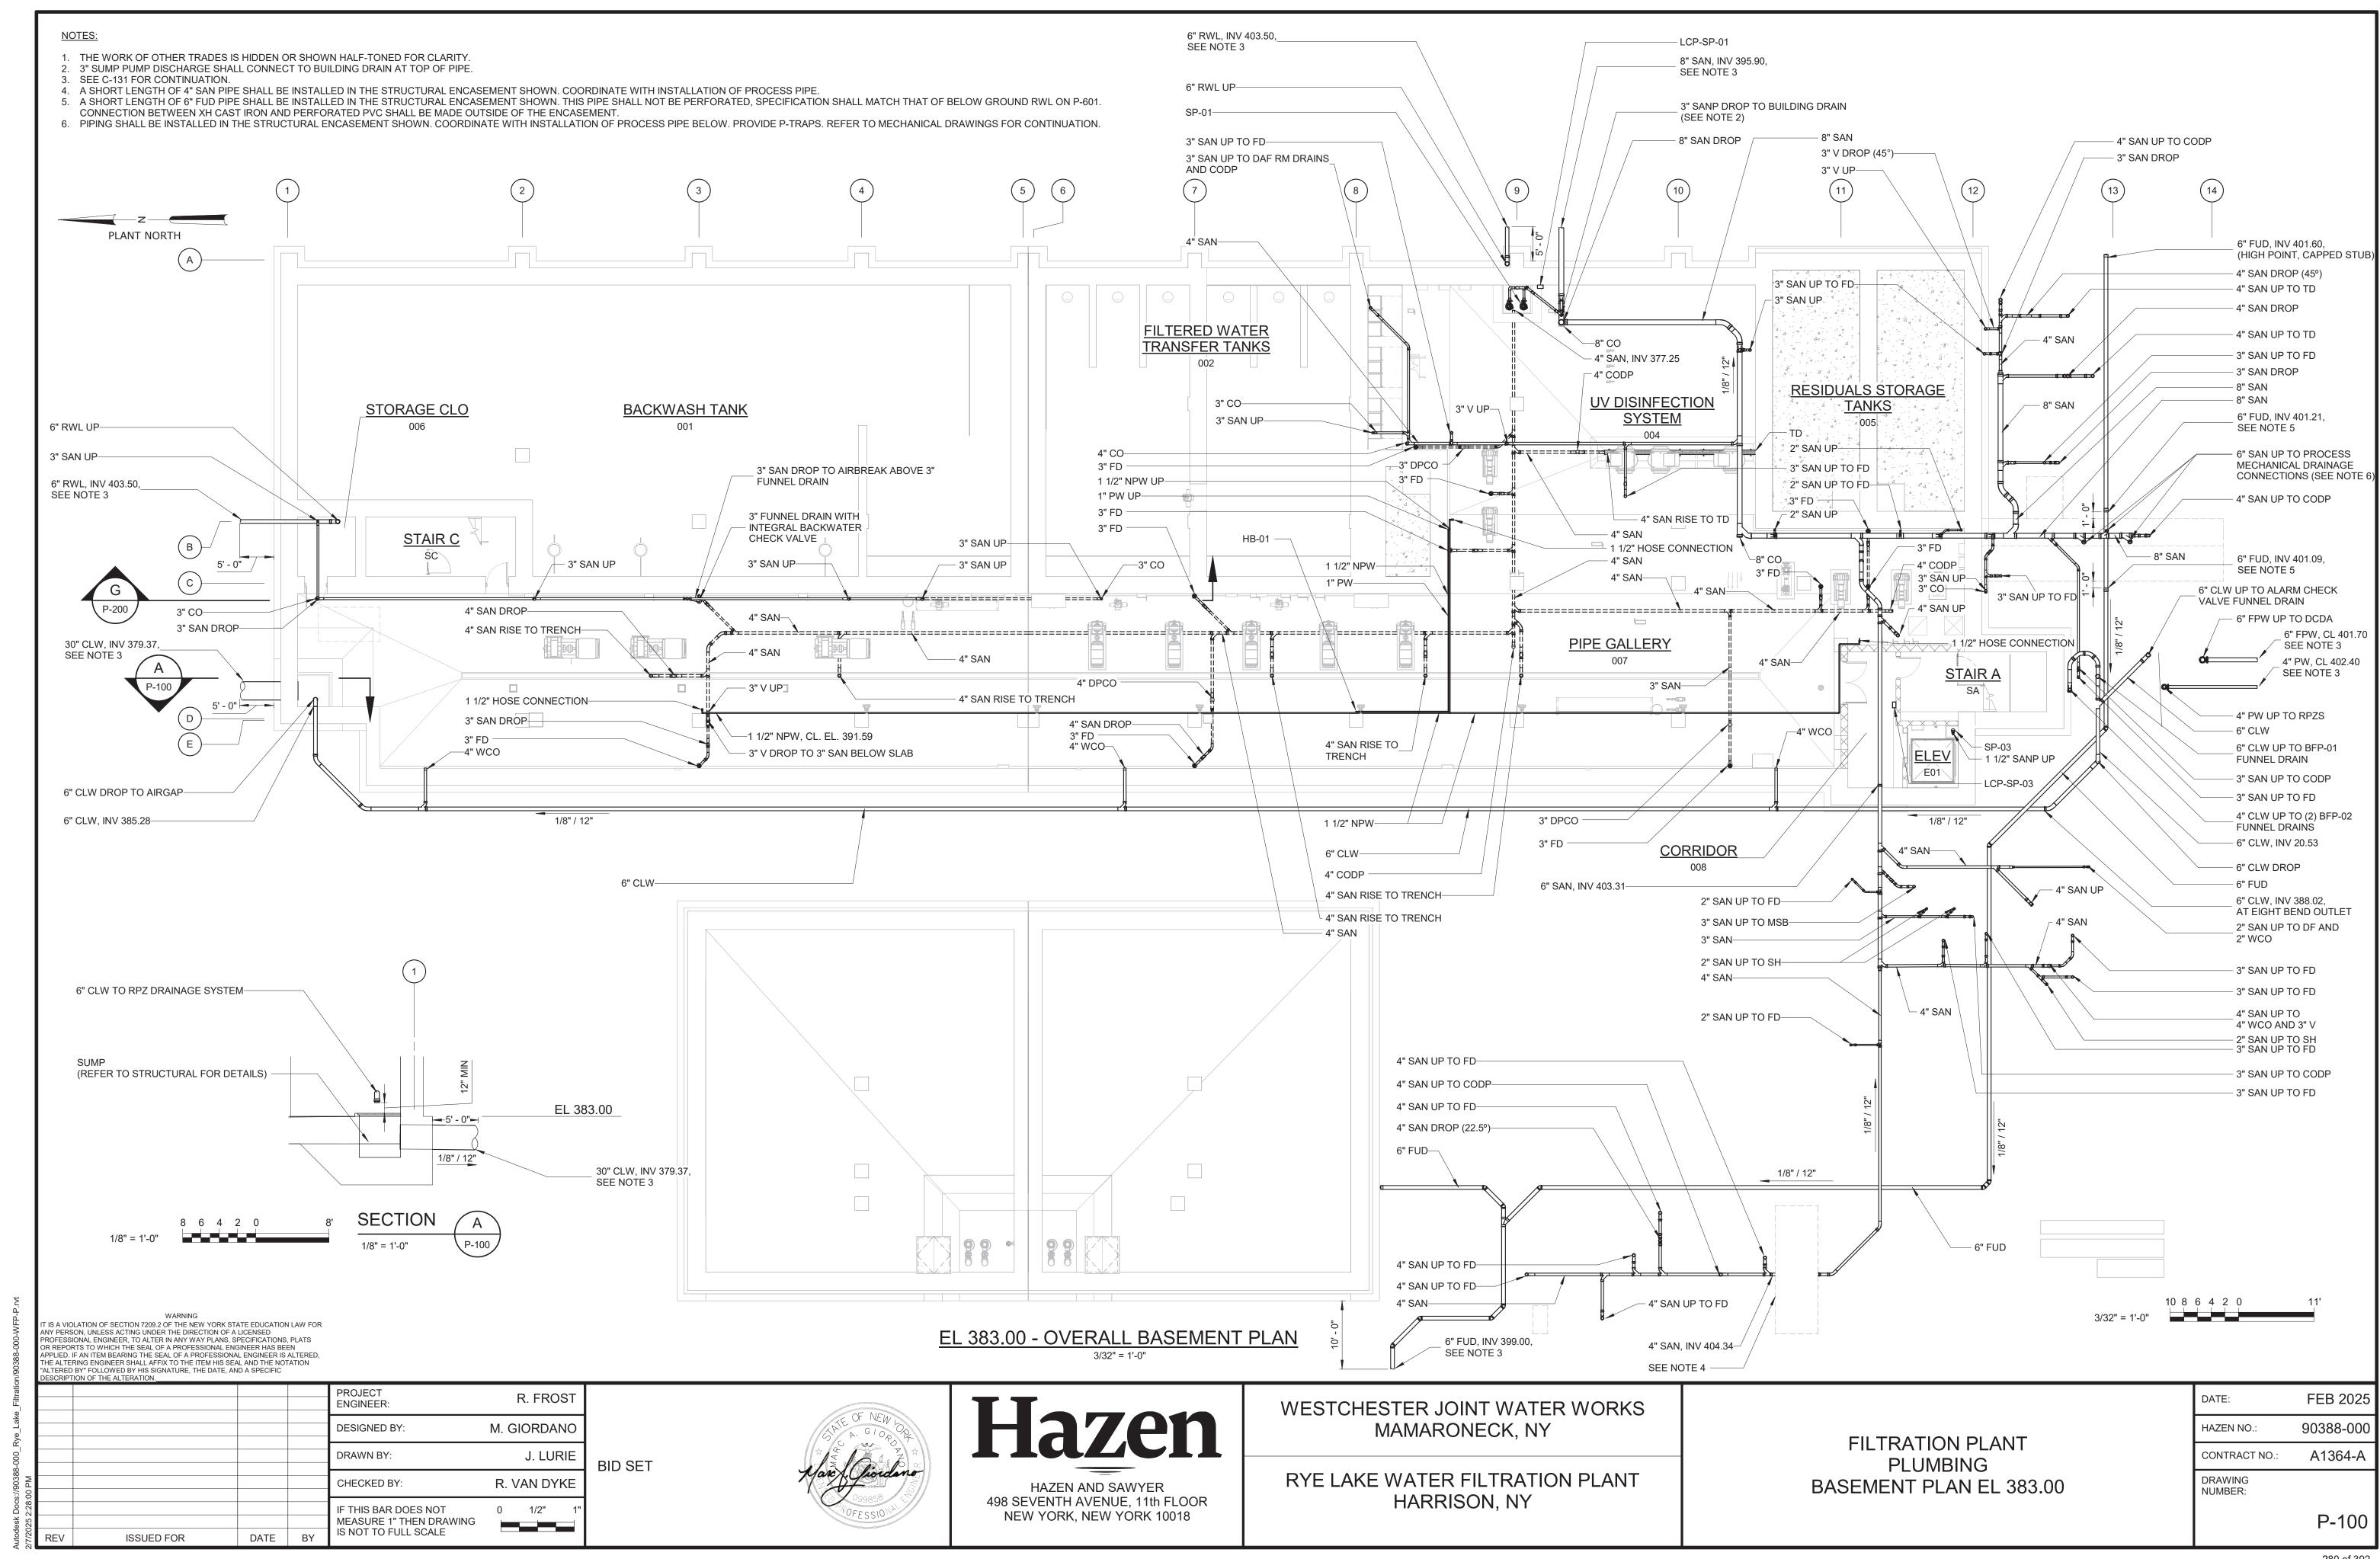
HAZEN AND SAWYER
498 SEVENTH AVENUE, 11th FLOOR
NEW YORK, NEW YORK 10018


WESTCHESTER JOINT WATER WORKS MAMARONECK, NY


RYE LAKE WATER FILTRATION PLANT HARRISON, NY

FILTRATION PLANT
PLUMBING
STORM RISER DIAGRAM

DATE:	FEB 2025
HAZEN NO.:	90388-000
CONTRACT NO.:	A1364-A
DRAWING NUMBER:	
	P-005



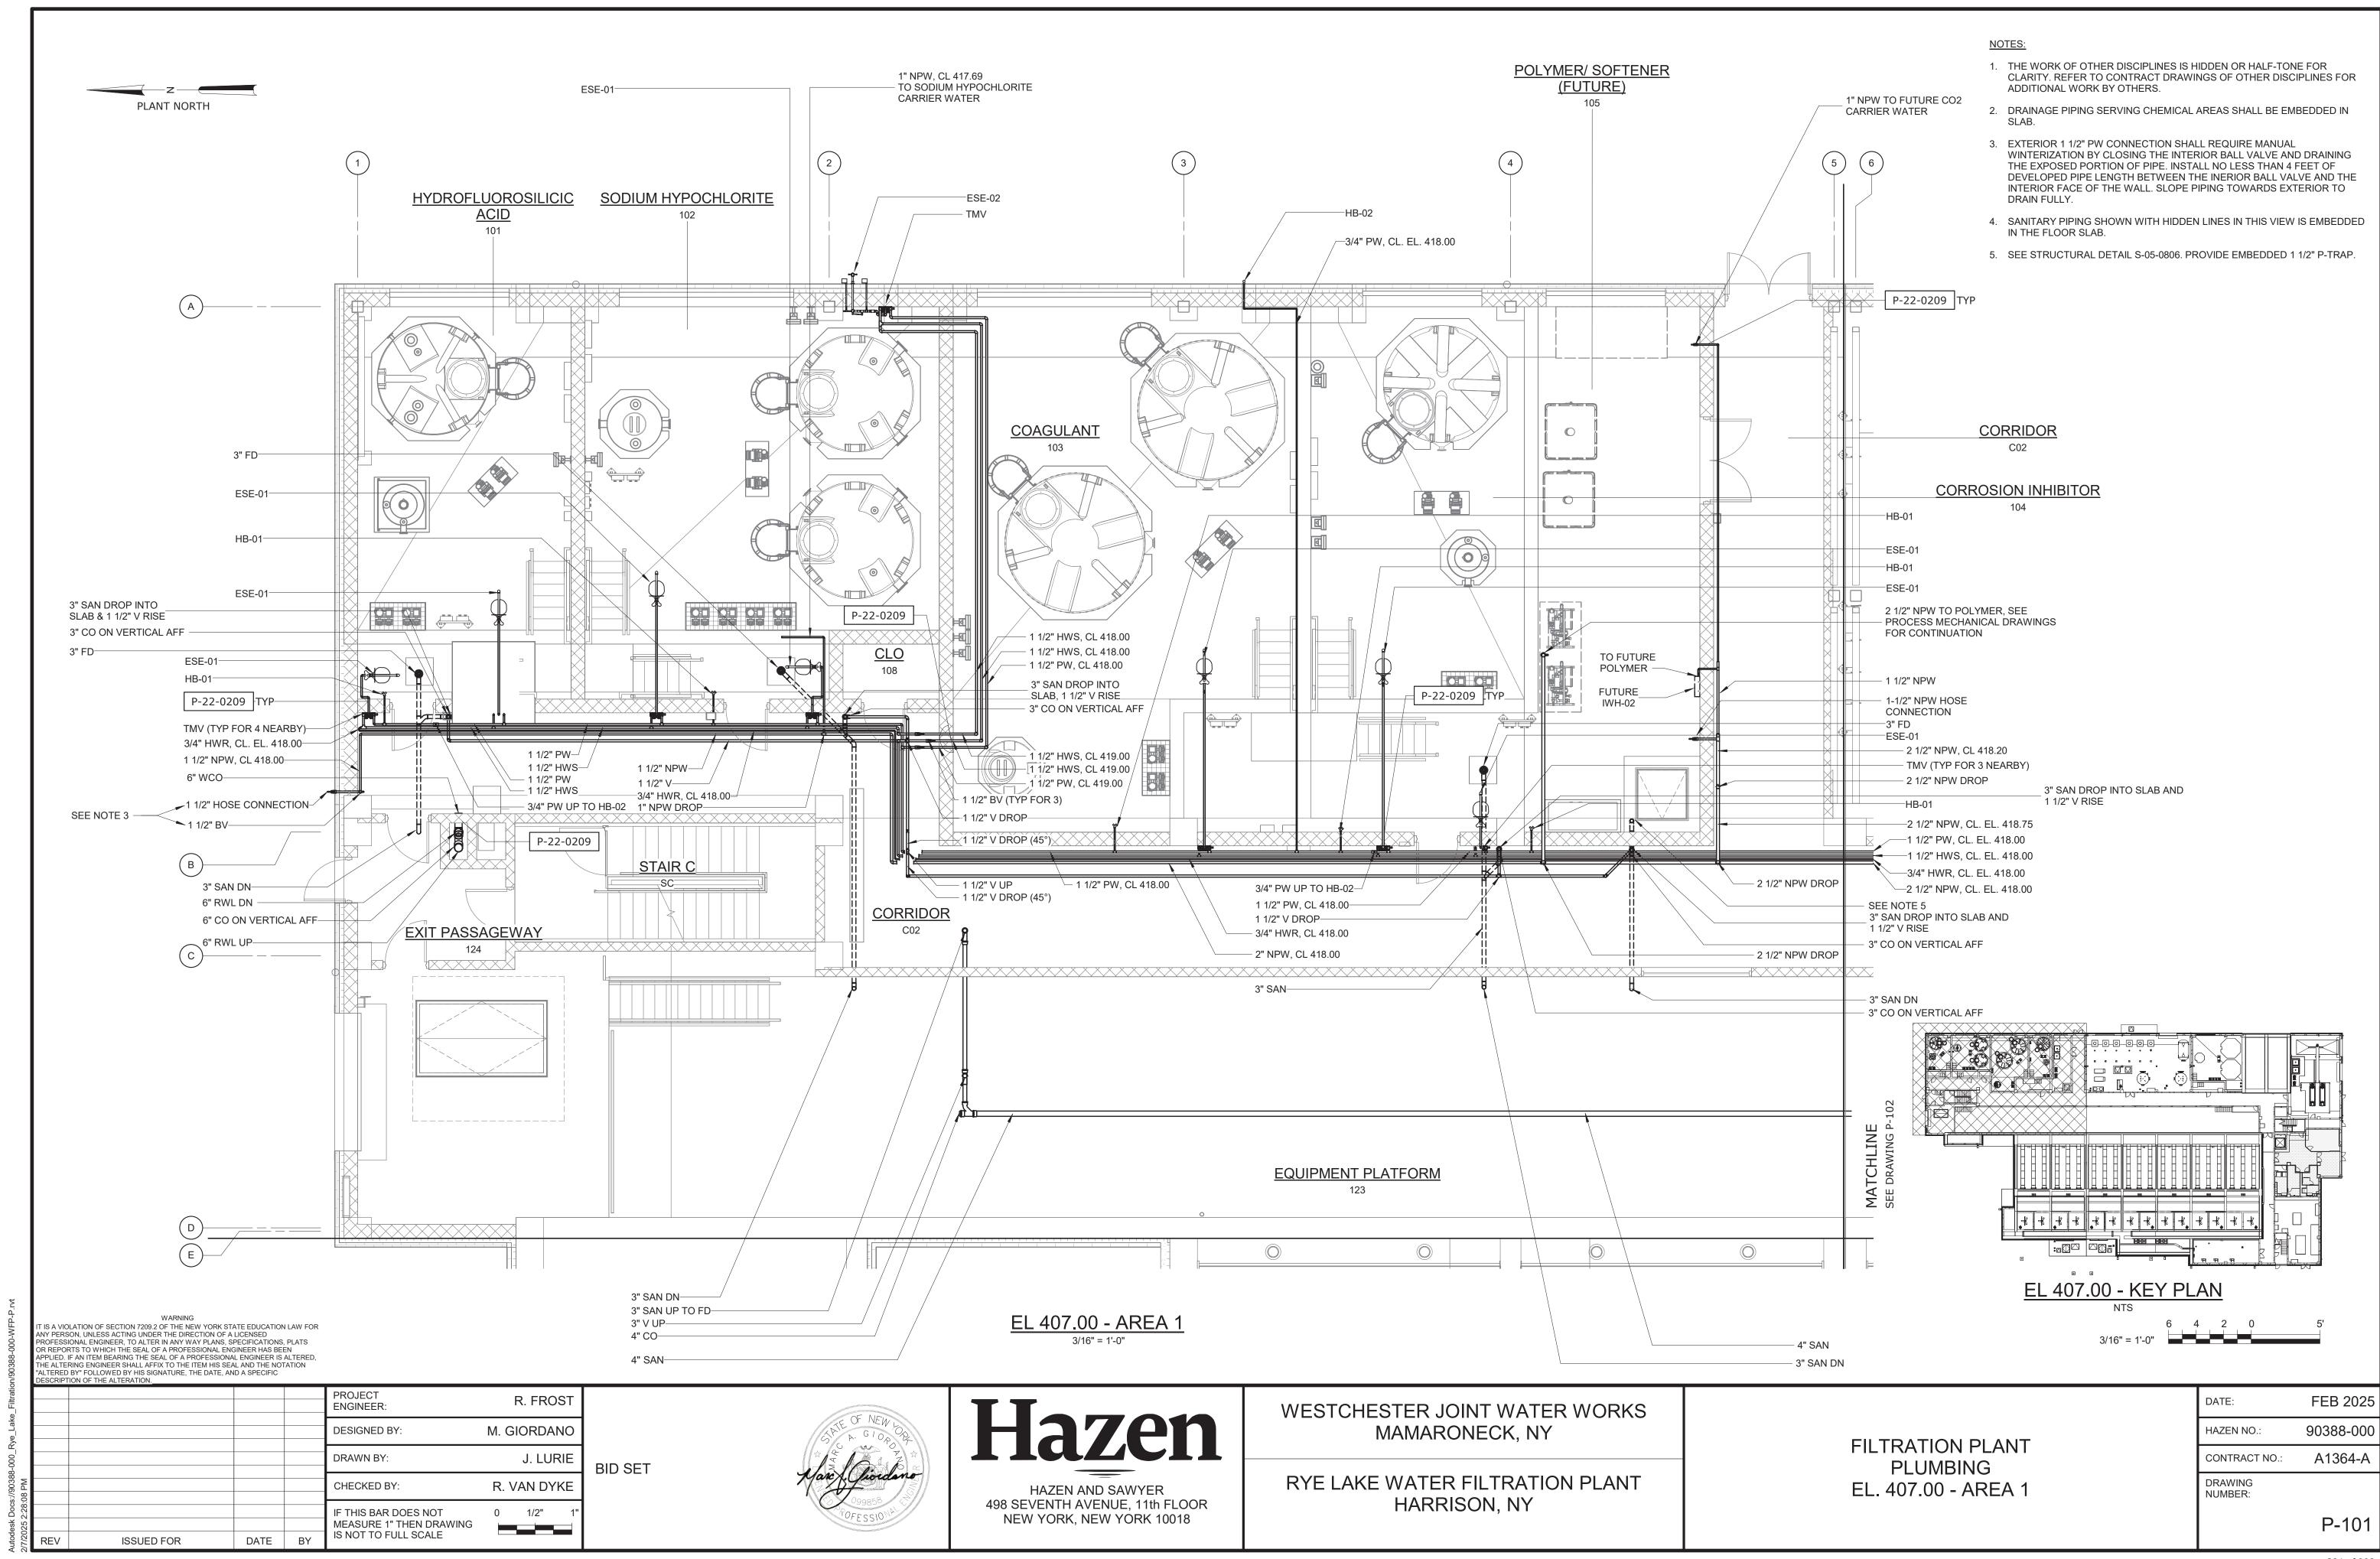

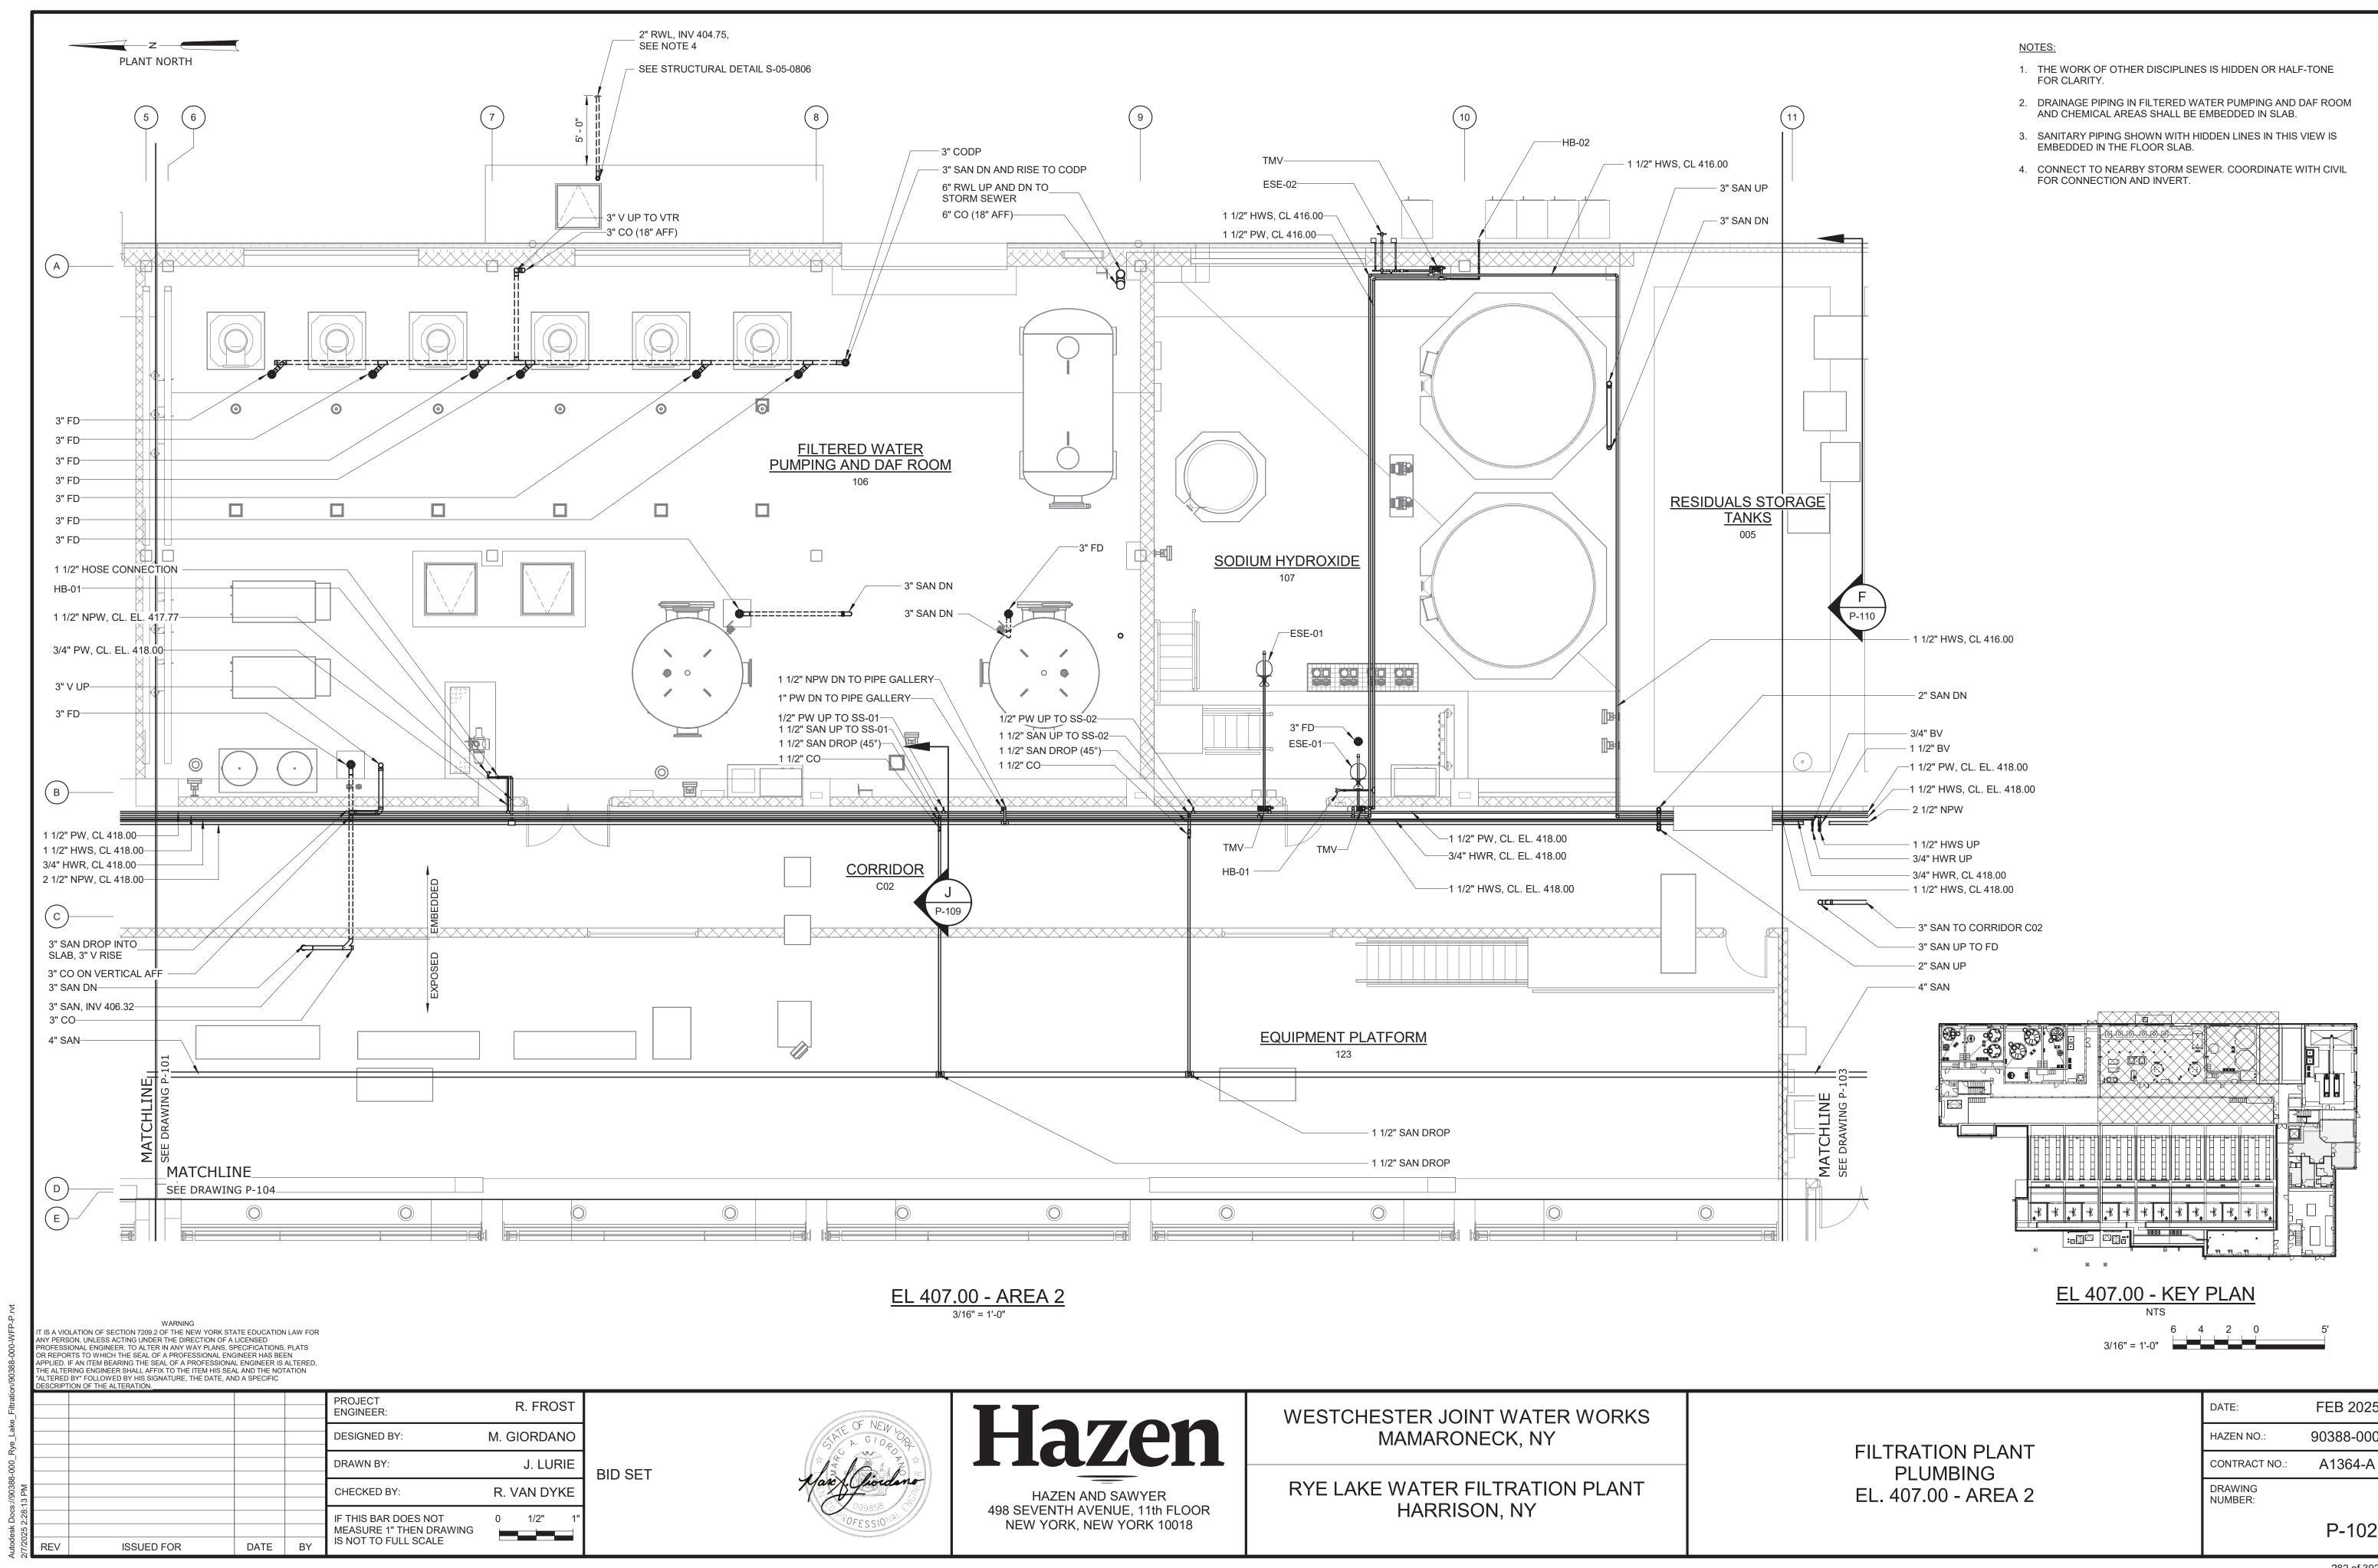

1. THE WORK OF OTHER DISCIPLINES IS HIDDEN OR HALF-TONE PLANT NORTH FOR CLARITY. REFER TO CONTRACT DRAWINGS OF OTHER DISCIPLINES FOR ADDITIONAL WORK BY OTHERS. DEWATERING ROOM 3" SAN TO CORRIDOR C02-- 1 1/2" NPW DROP - 1 1/2" NPW CONNECTION / 4" CODP 3" V UP AND DN-4" NPW (BACK)— - 2 1/2" NPW TO CENTRIFUGE WASH WATER 2 1/2" PW (FRONT)-(SEE PROCESS MECHANICAL DRAWINGS 2 1/2" NPW TO CORRIDOR C02 FOR CONTINUATION) 2 1/2" PW TO CORRIDOR C02 3" SAN (FRONT) 1 1/2" NPW HW CONNECTION TO POLYMER SKID, (SEE MECHANICAL DRAWINGS FOR 2" V (BACK) -CONTINUATION) 2" V----EL 407.00 3" SAN UP-ESE-01 3" FD---**DEWATERING ROOM** POLYMER SKID 2" V UP-─IWH-01 TD-- 1 1/2" NPW RESIDUALS STORAGE SECTION **TANKS** 005 3/16" = 1'-0" 2 1/2" NPW DROP-1 1/2" NPW, CL 418.00-2 1/2" NPW DROP-TO CENTRIFUGE POLYMER DILUTION P-110 SYSTEM (SEE PROCESS MECHANICAL DRAWINGS FOR CONTINUATION) -- 2 1/2" NPW TO CENTRIFUGE WASH WATER (SEE PROCESS MECHANICAL DRAWINGS FOR 1 1/2" NPW HW DROP-CONTINUATION, PROVIDE BALL VALVES) 3" SAN-1 1/2" NPW HW, CL. EL. 416.00-IWH-01-1 1/2" NPW HW DROP-1 1/2" NPW DROP-— 4" CODP 2" SAN UP AND DN-2 1/2" NPW 2" PW, CL 415.25<u></u> ∠ r∪ — 1 1/2" NPW DROP 1 1/2" PW, CL 418.00-— 3" NPW 1 1/2" HWS, CL 418.00-2 1/2" PW-ESE-01 3/4" HWR, CL 418.00-2 1/2" NPW, CL 418.00-3" FD – 2" SAN DROP AND 2" V RISE — 3" SAN DN AND RISE - 2 1/2" PW, CL 418.00 1 1/2" PW UP-- 4" NPW, CL 418.00 2" NPW UP-- 2 1/2" PW DROP - 3/4" PW, CL 418.00 - 3/4" PW DROP 4" SAN DN-- BFP-03 2" PW DROP-4" SAN DROP (45°)-6" FPW DN TO SERVICE 4" SAN UP-P-106 - 4" PW DN TO SERVICE CORRIDOR 4" SAN-C02 STAIR A FIRE SPRINKLER RISER MATCHLINE ROOM SEE DRAWING P-105 110 BFP-02 (TYP FOR 2)-**EL 407.00 - KEY PLAN** EL 407.00 - AREA 3 **CONFERENCE ROOM** ---- 2" PW, CL 417.67 IT IS A VIOLATION OF SECTION 7209.2 OF THE NEW YORK STATE EDUCATION LAW FOR ANY PERSON, UNLESS ACTING UNDER THE DIRECTION OF A LICENSED PROFESSIONAL ENGINEER, TO ALTER IN ANY WAY PLANS, SPECIFICATIONS, PLATS OR REPORTS TO WHICH THE SEAL OF A PROFESSIONAL ENGINEER HAS BEEN APPLIED. IF AN ITEM BEARING THE SEAL OF A PROFESSIONAL ENGINEER IS ALTERED, THE ALTERING ENGINEER SHALL AFFIX TO THE ITEM HIS SEAL AND THE NOTATION LTERED BY" FOLLOWED BY HIS SIGNATURE, THE DATE, AND A SPECIFIC ESCRIPTION OF THE ALTERATION. PROJECT ENGINEER: R. FROST FEB 2025 Hazen WESTCHESTER JOINT WATER WORKS 90388-000 M. GIORDANO MAMARONECK, NY HAZEN NO. DESIGNED BY:

> HAZEN AND SAWYER 498 SEVENTH AVENUE, 11th FLOOR

NEW YORK, NEW YORK 10018

RYE LAKE WATER FILTRATION PLANT

HARRISON, NY

J. LURIE

R. VAN DYKE

0 1/2"

BID SET

DRAWN BY:

DATE BY

ISSUED FOR

CHECKED BY:

IF THIS BAR DOES NOT

MEASURE 1" THEN DRAWING IS NOT TO FULL SCALE

P-103

A1364-A


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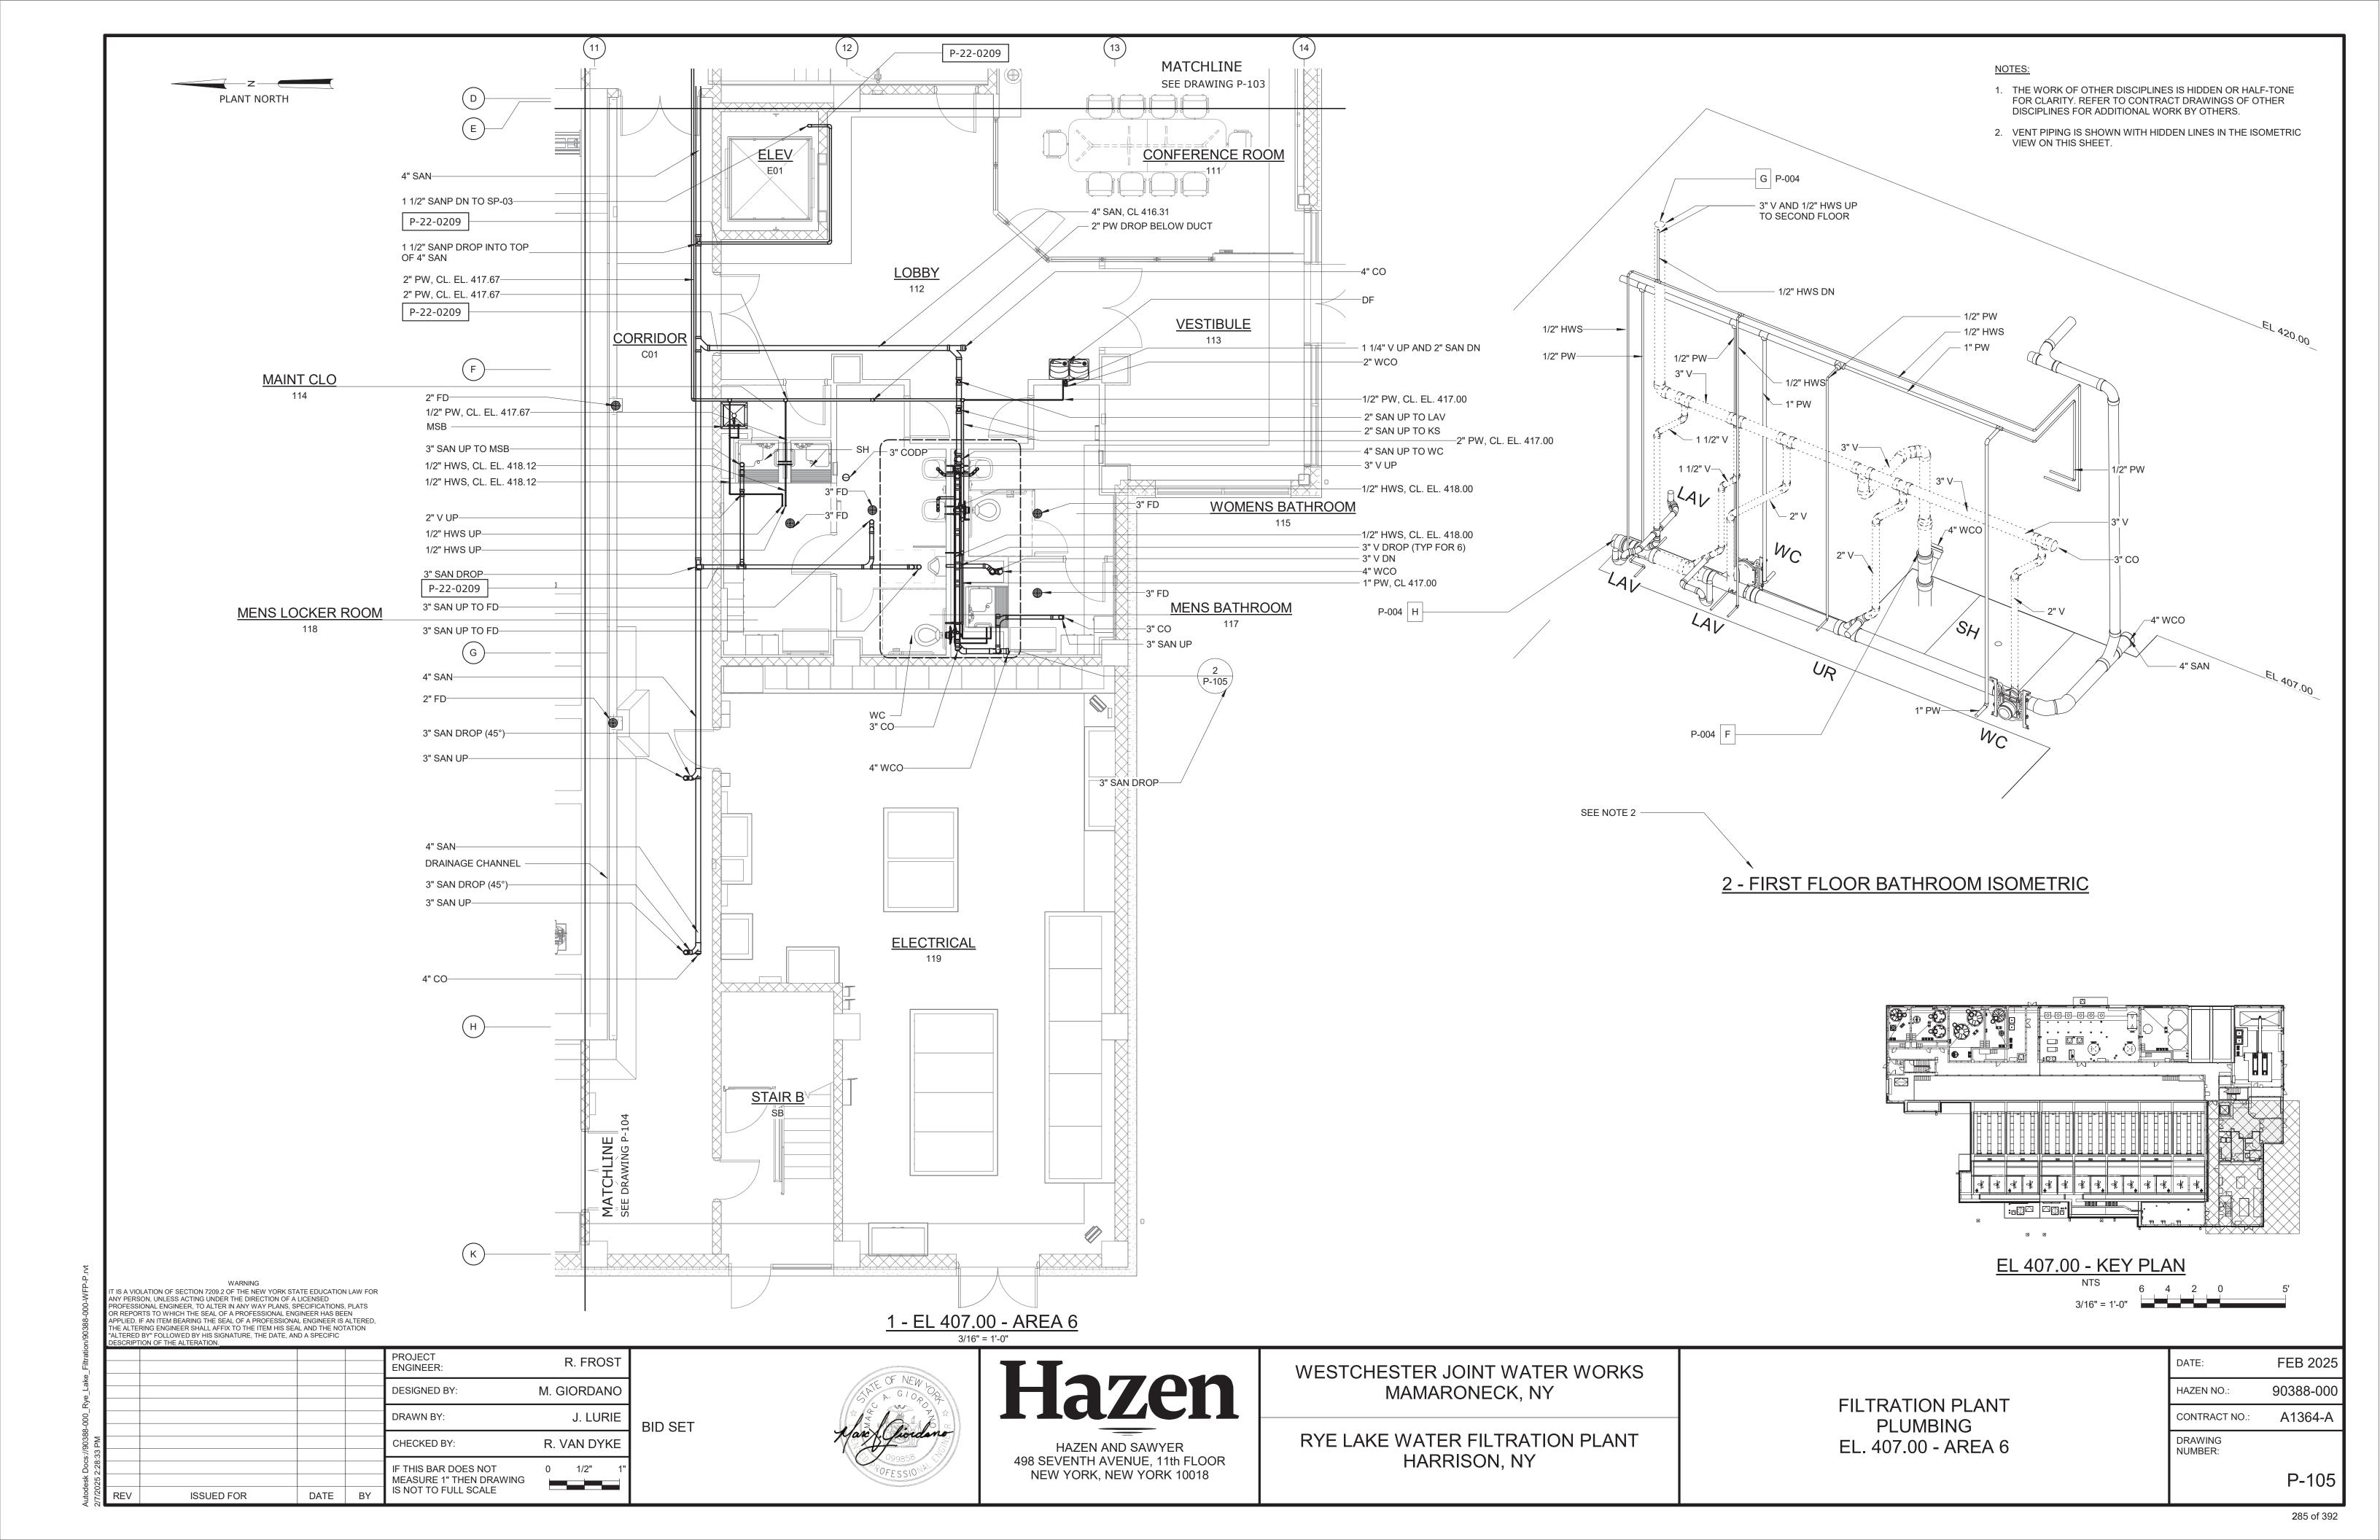
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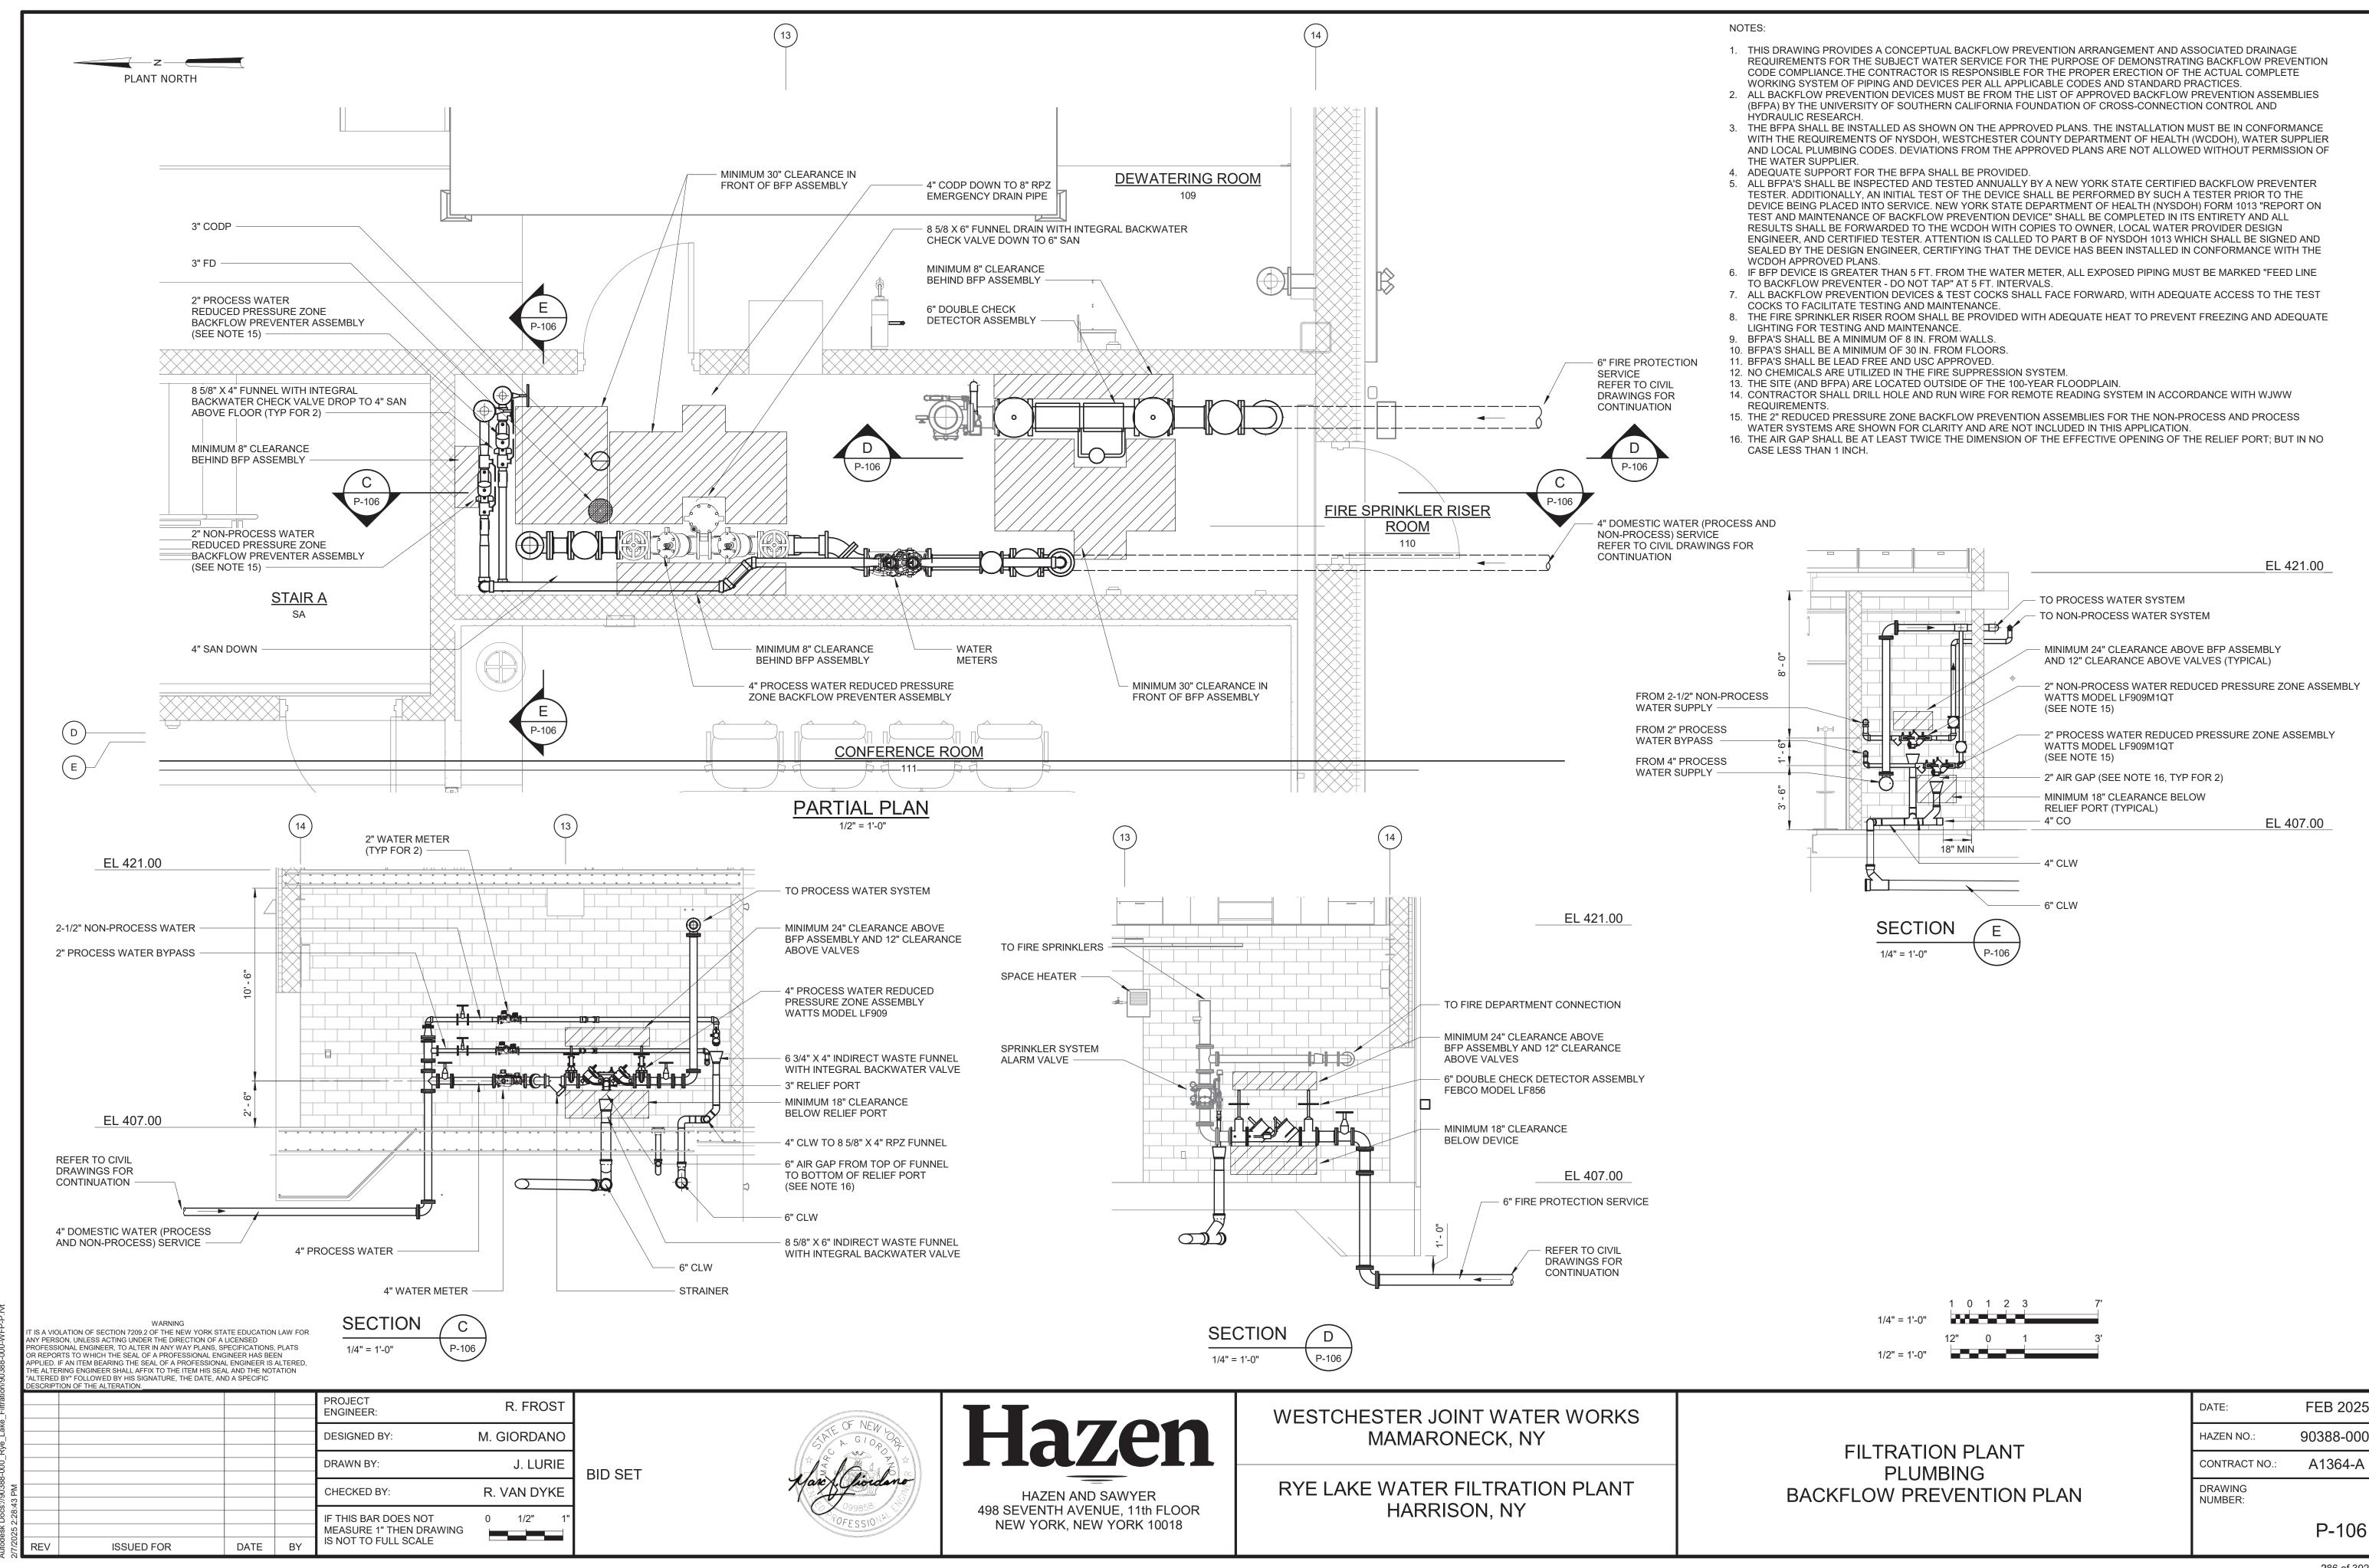
FILTRATION PLANT


PLUMBING


EL. 407.00 - AREA 3






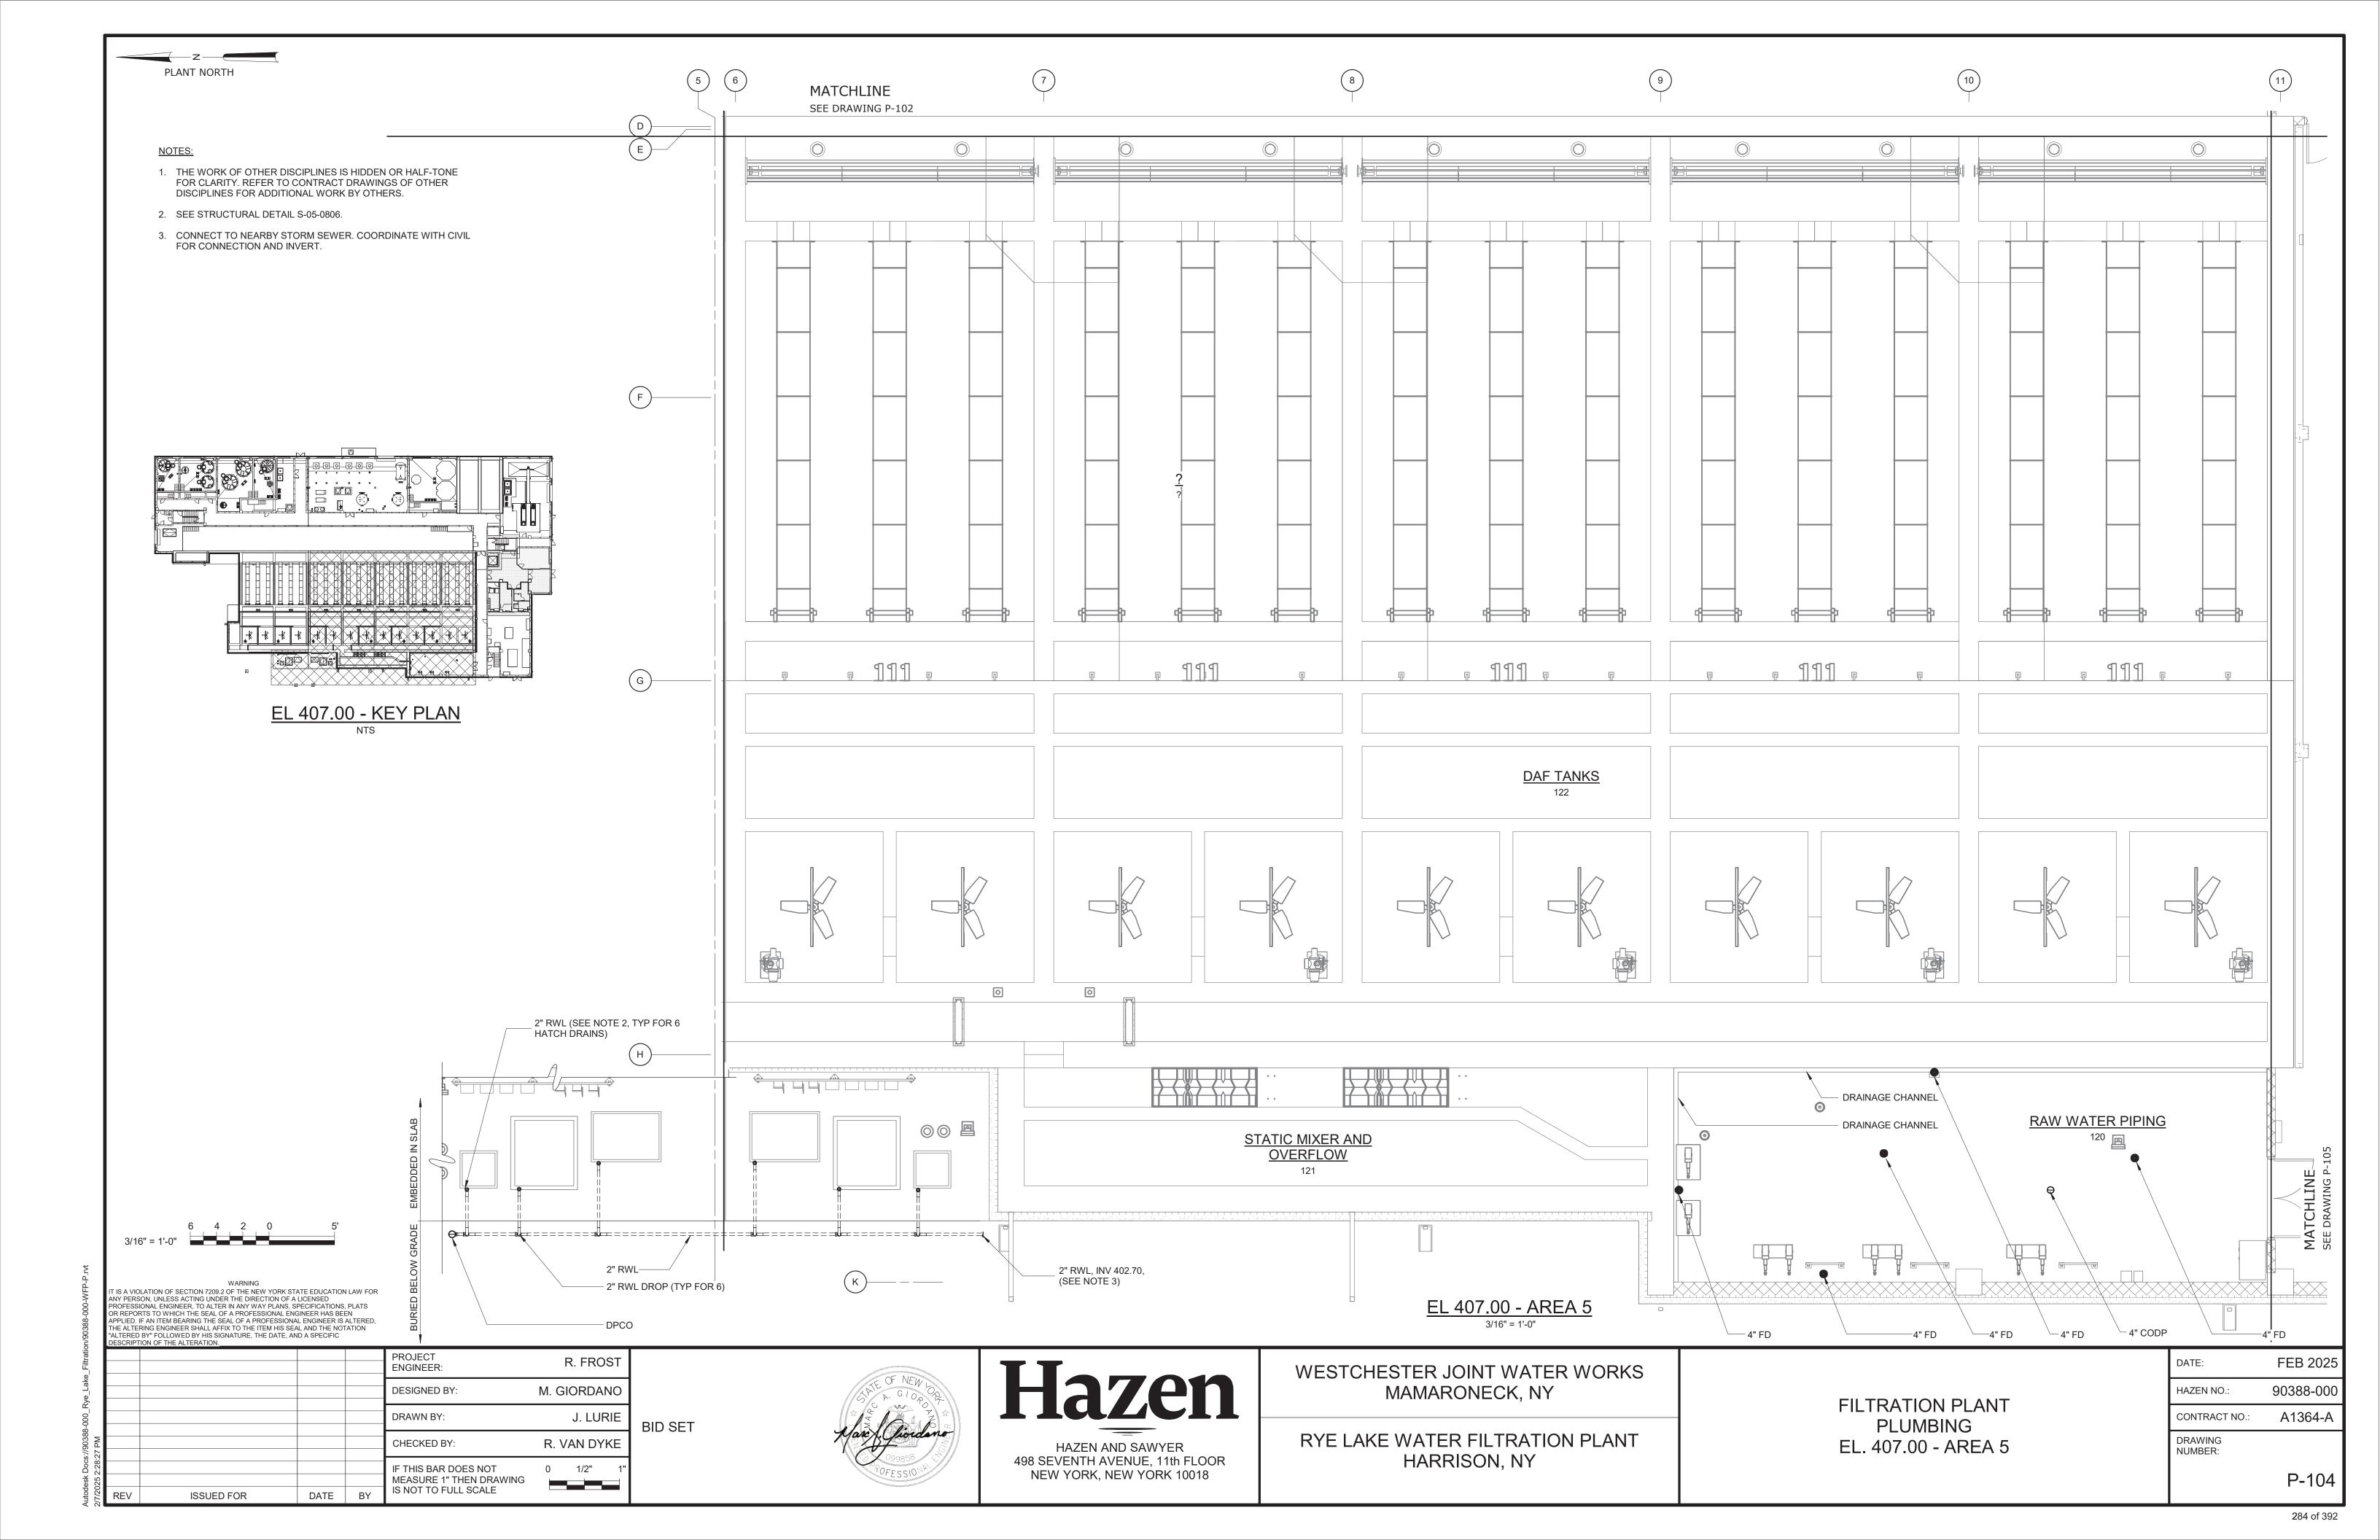

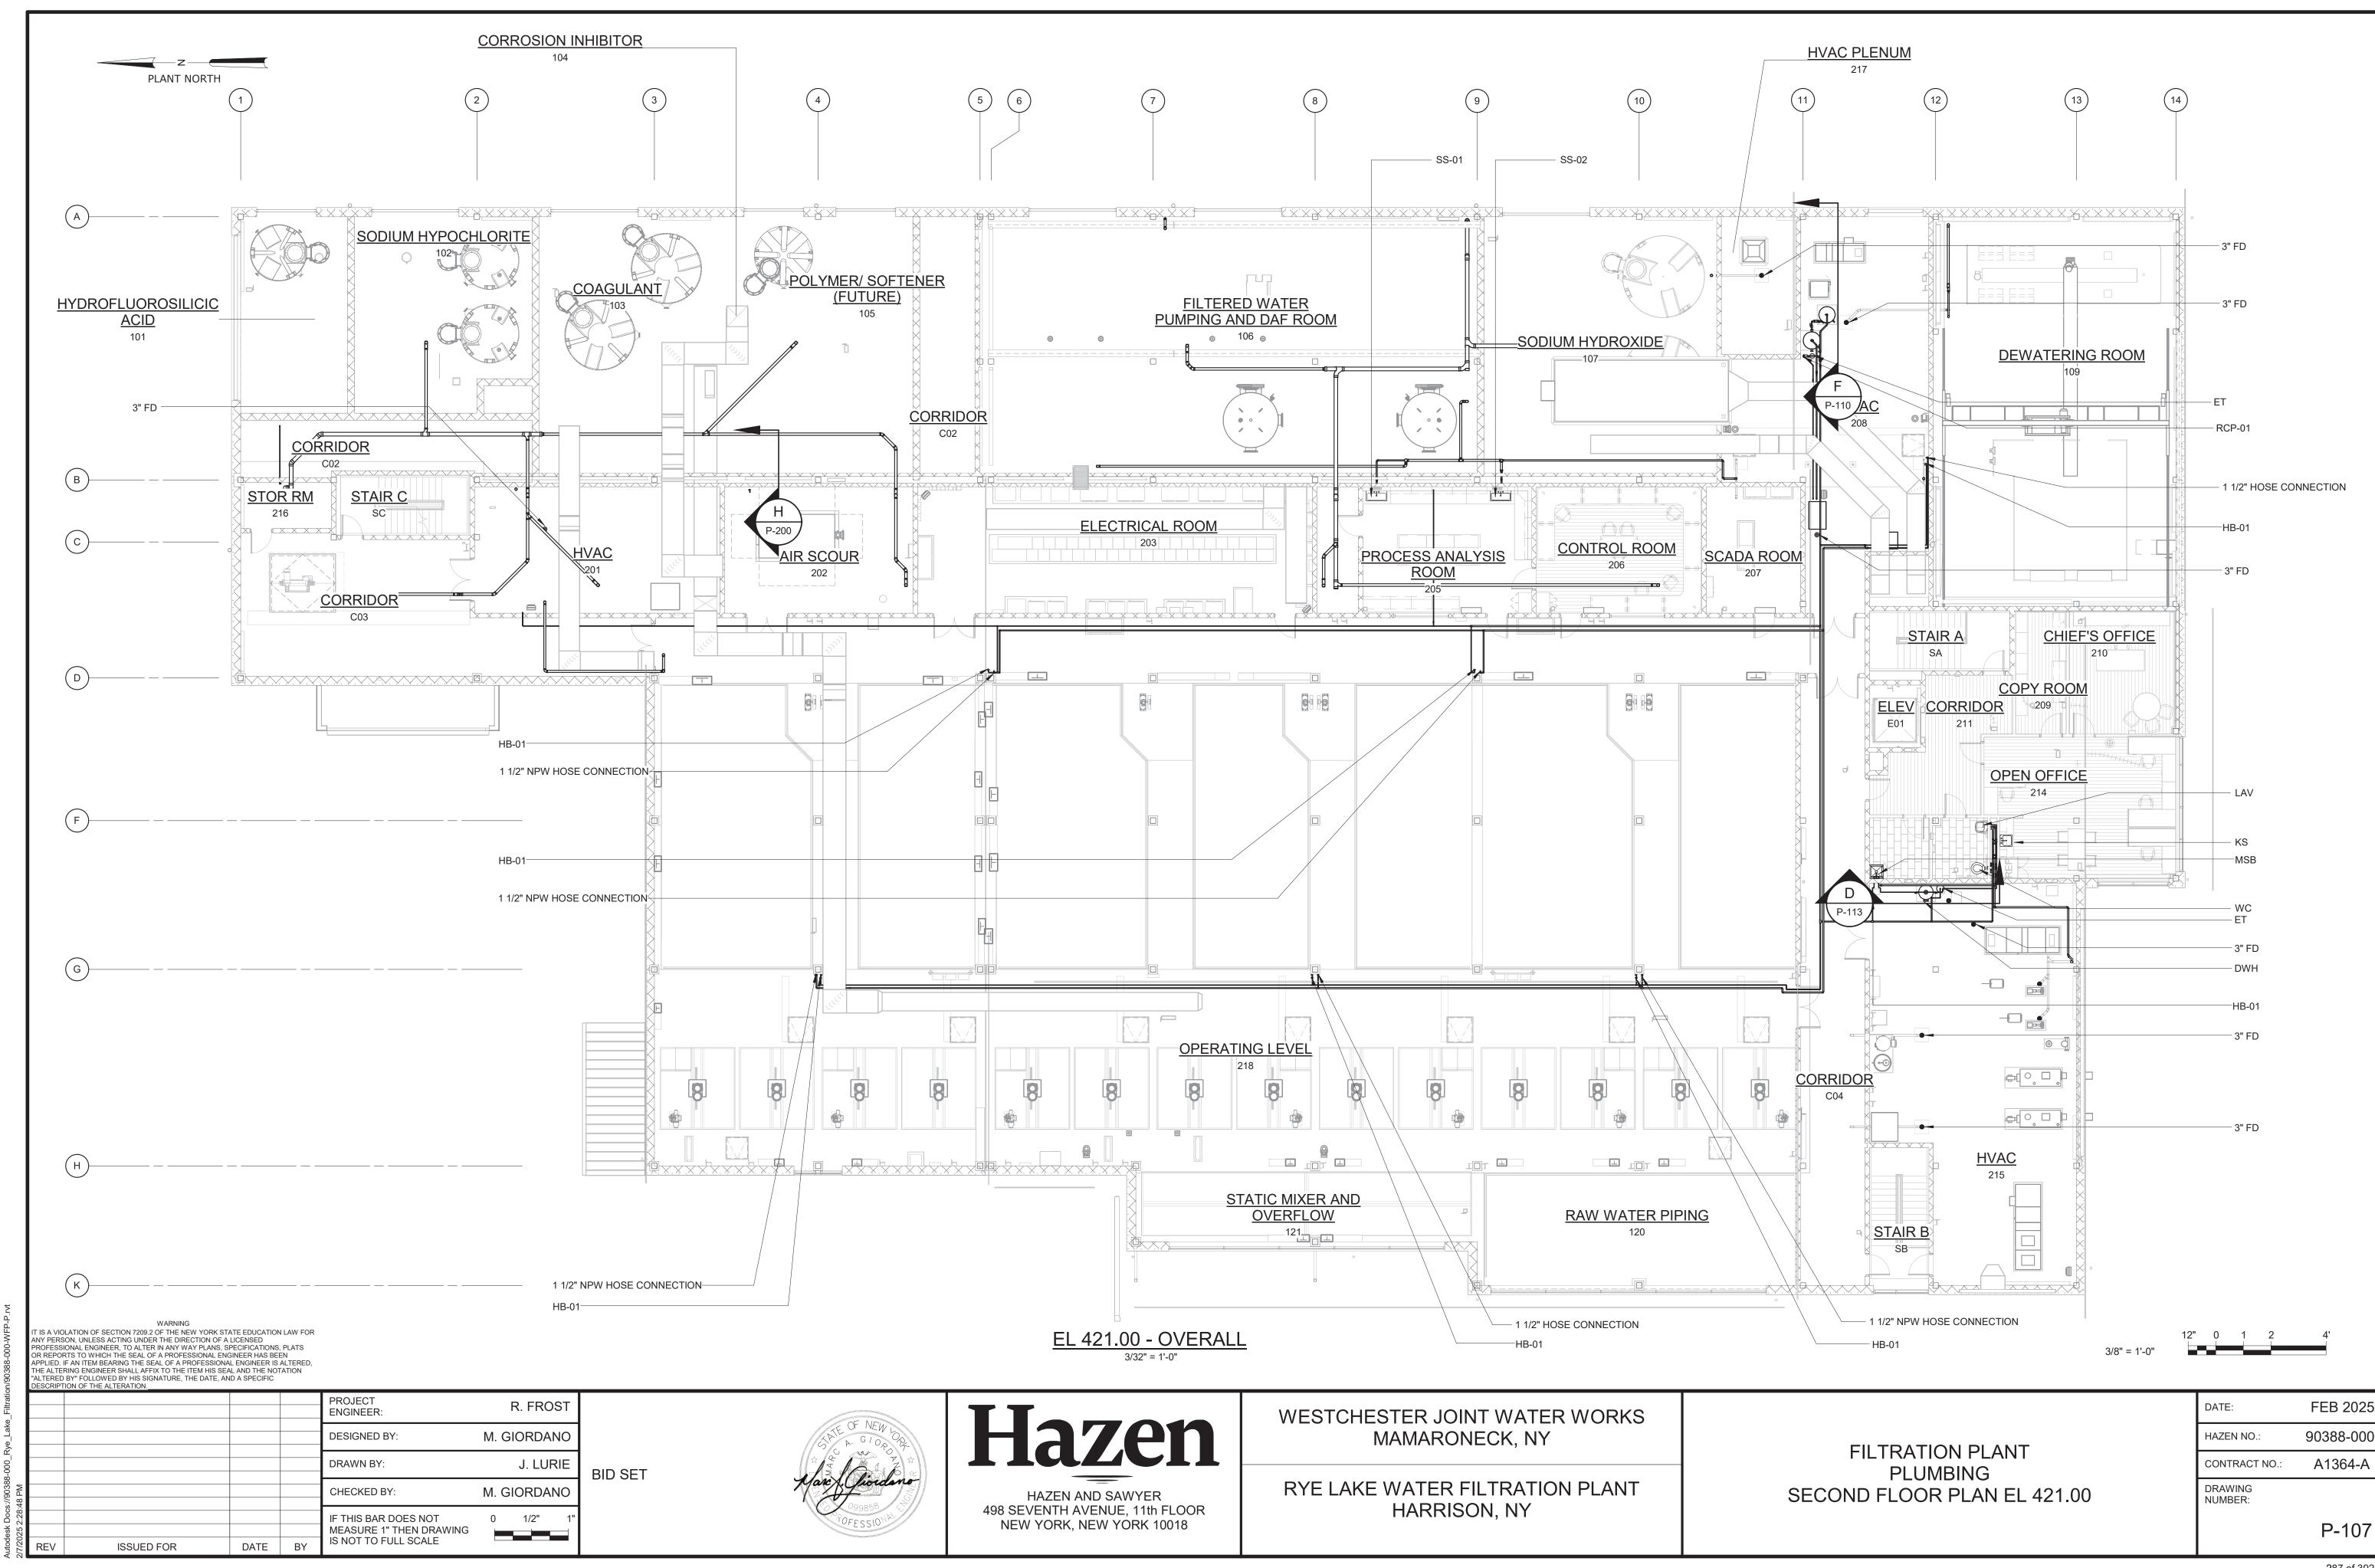

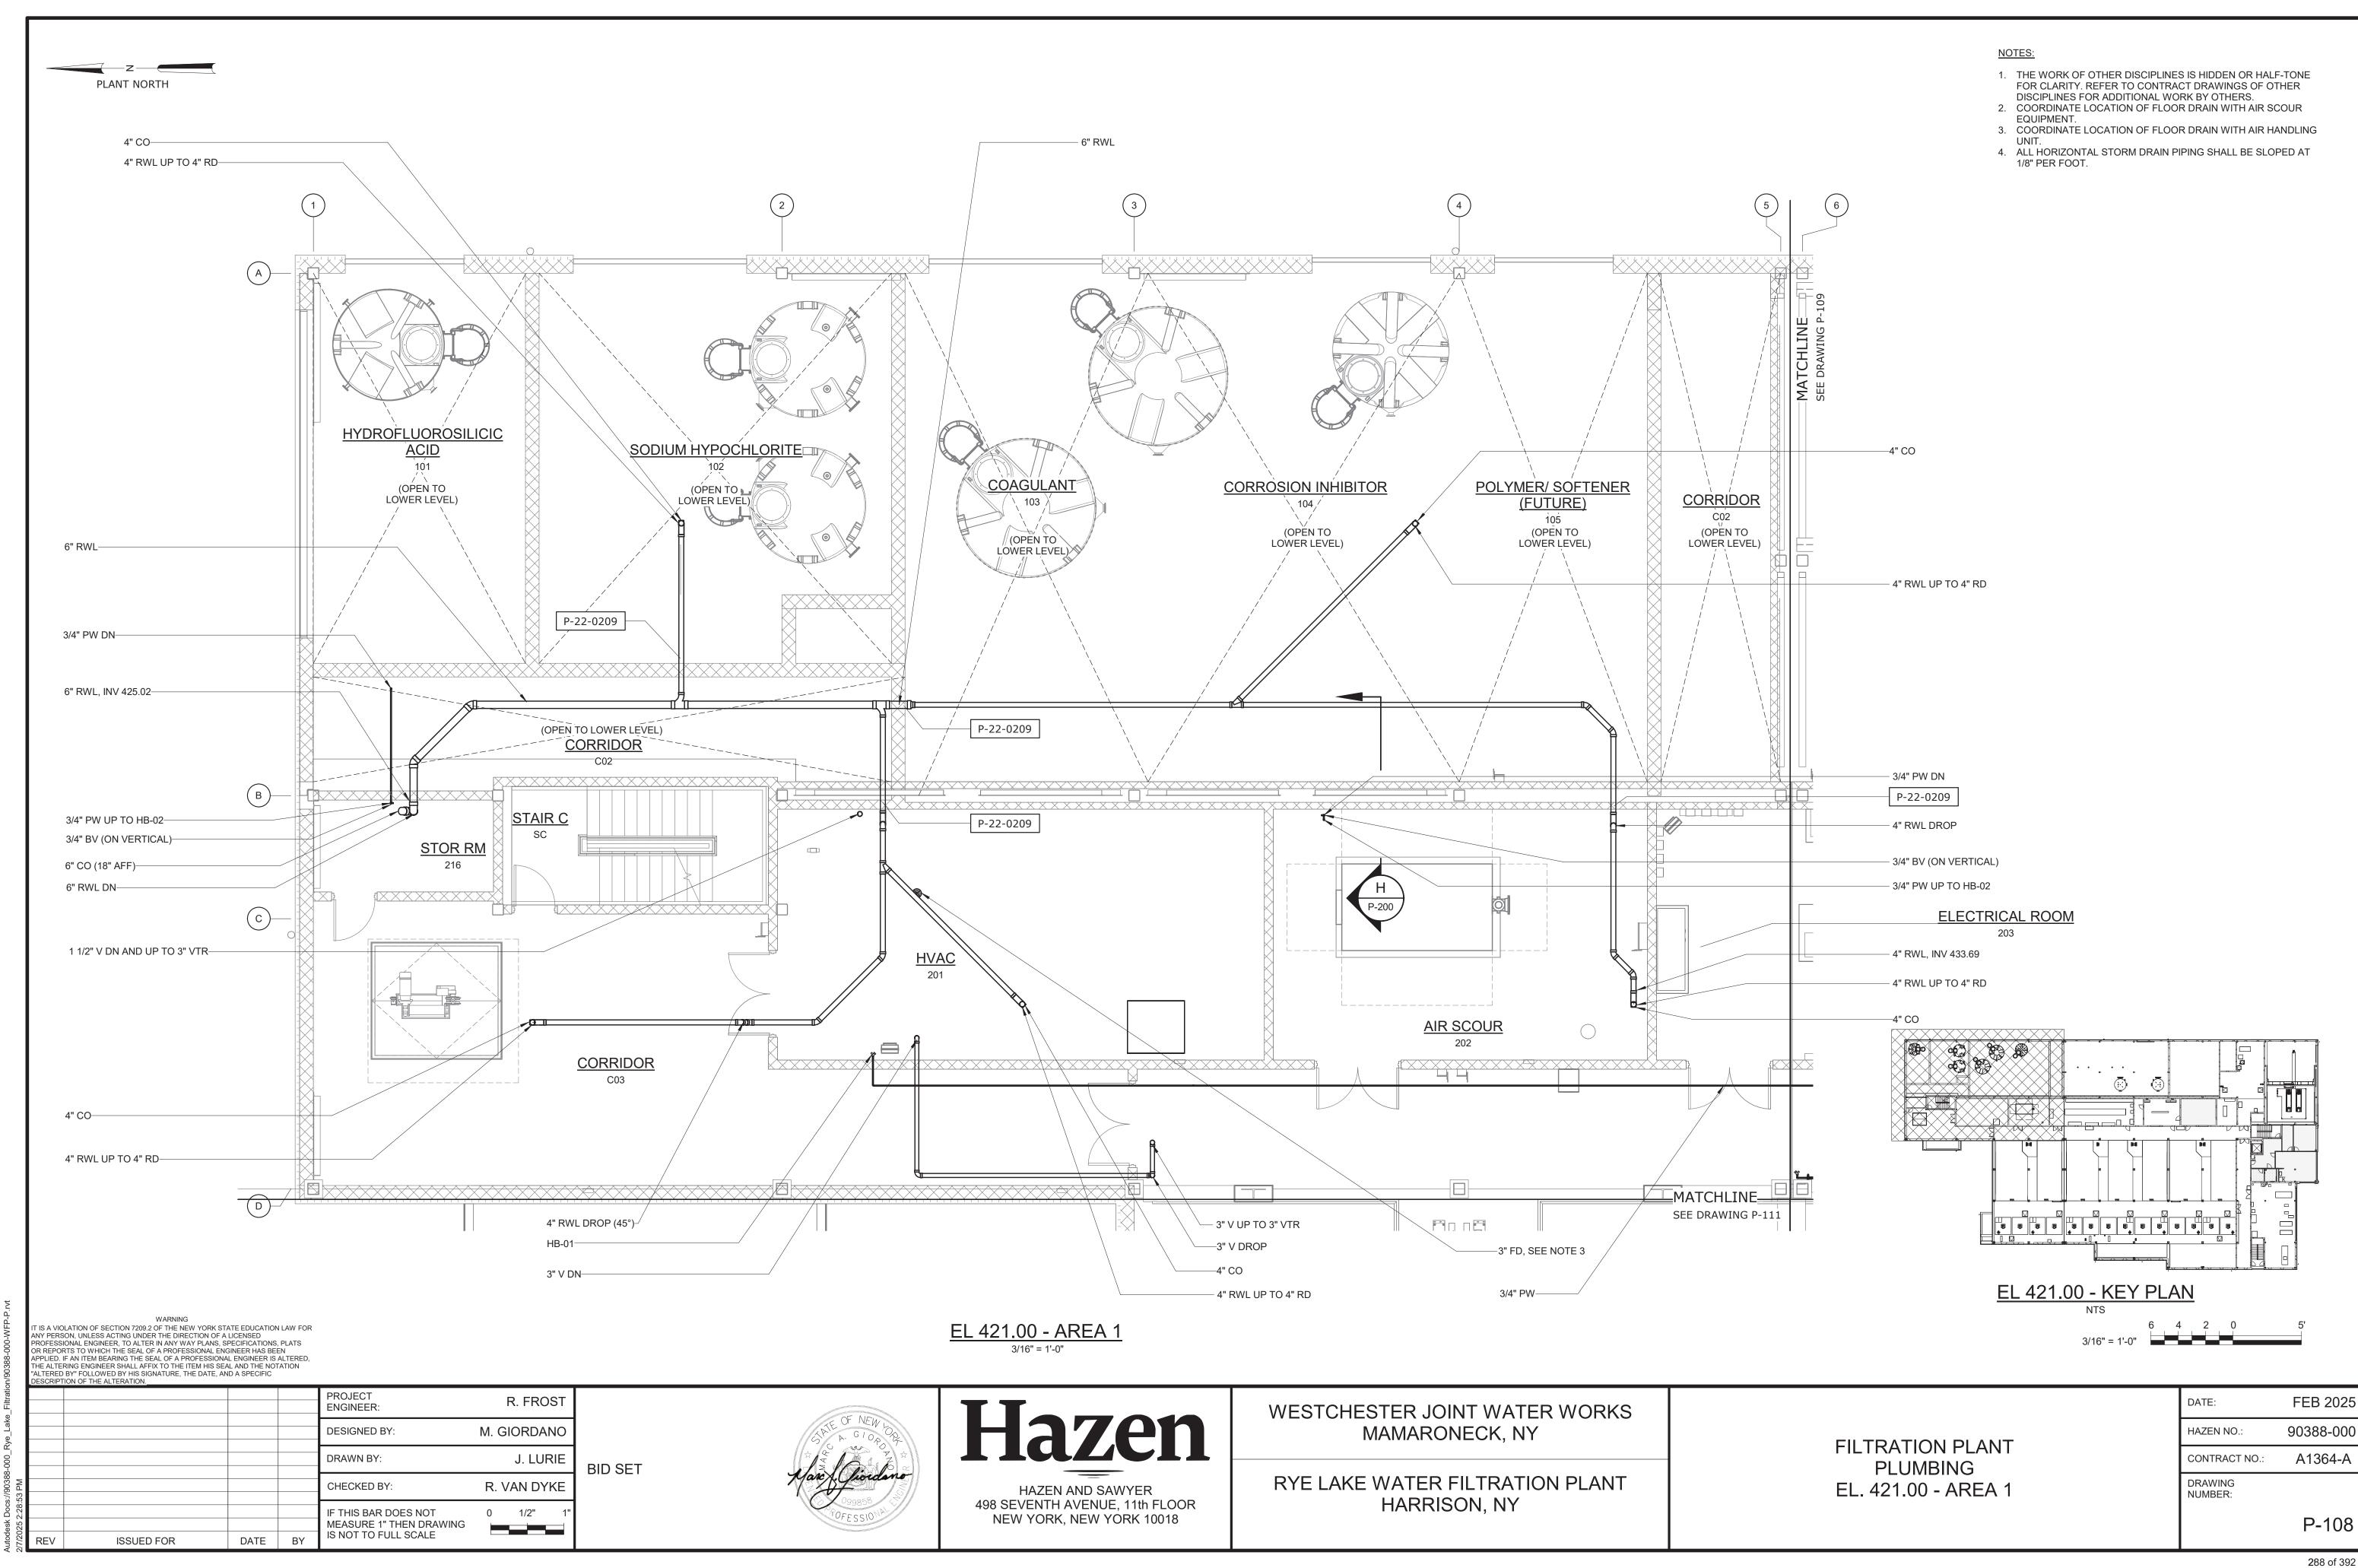


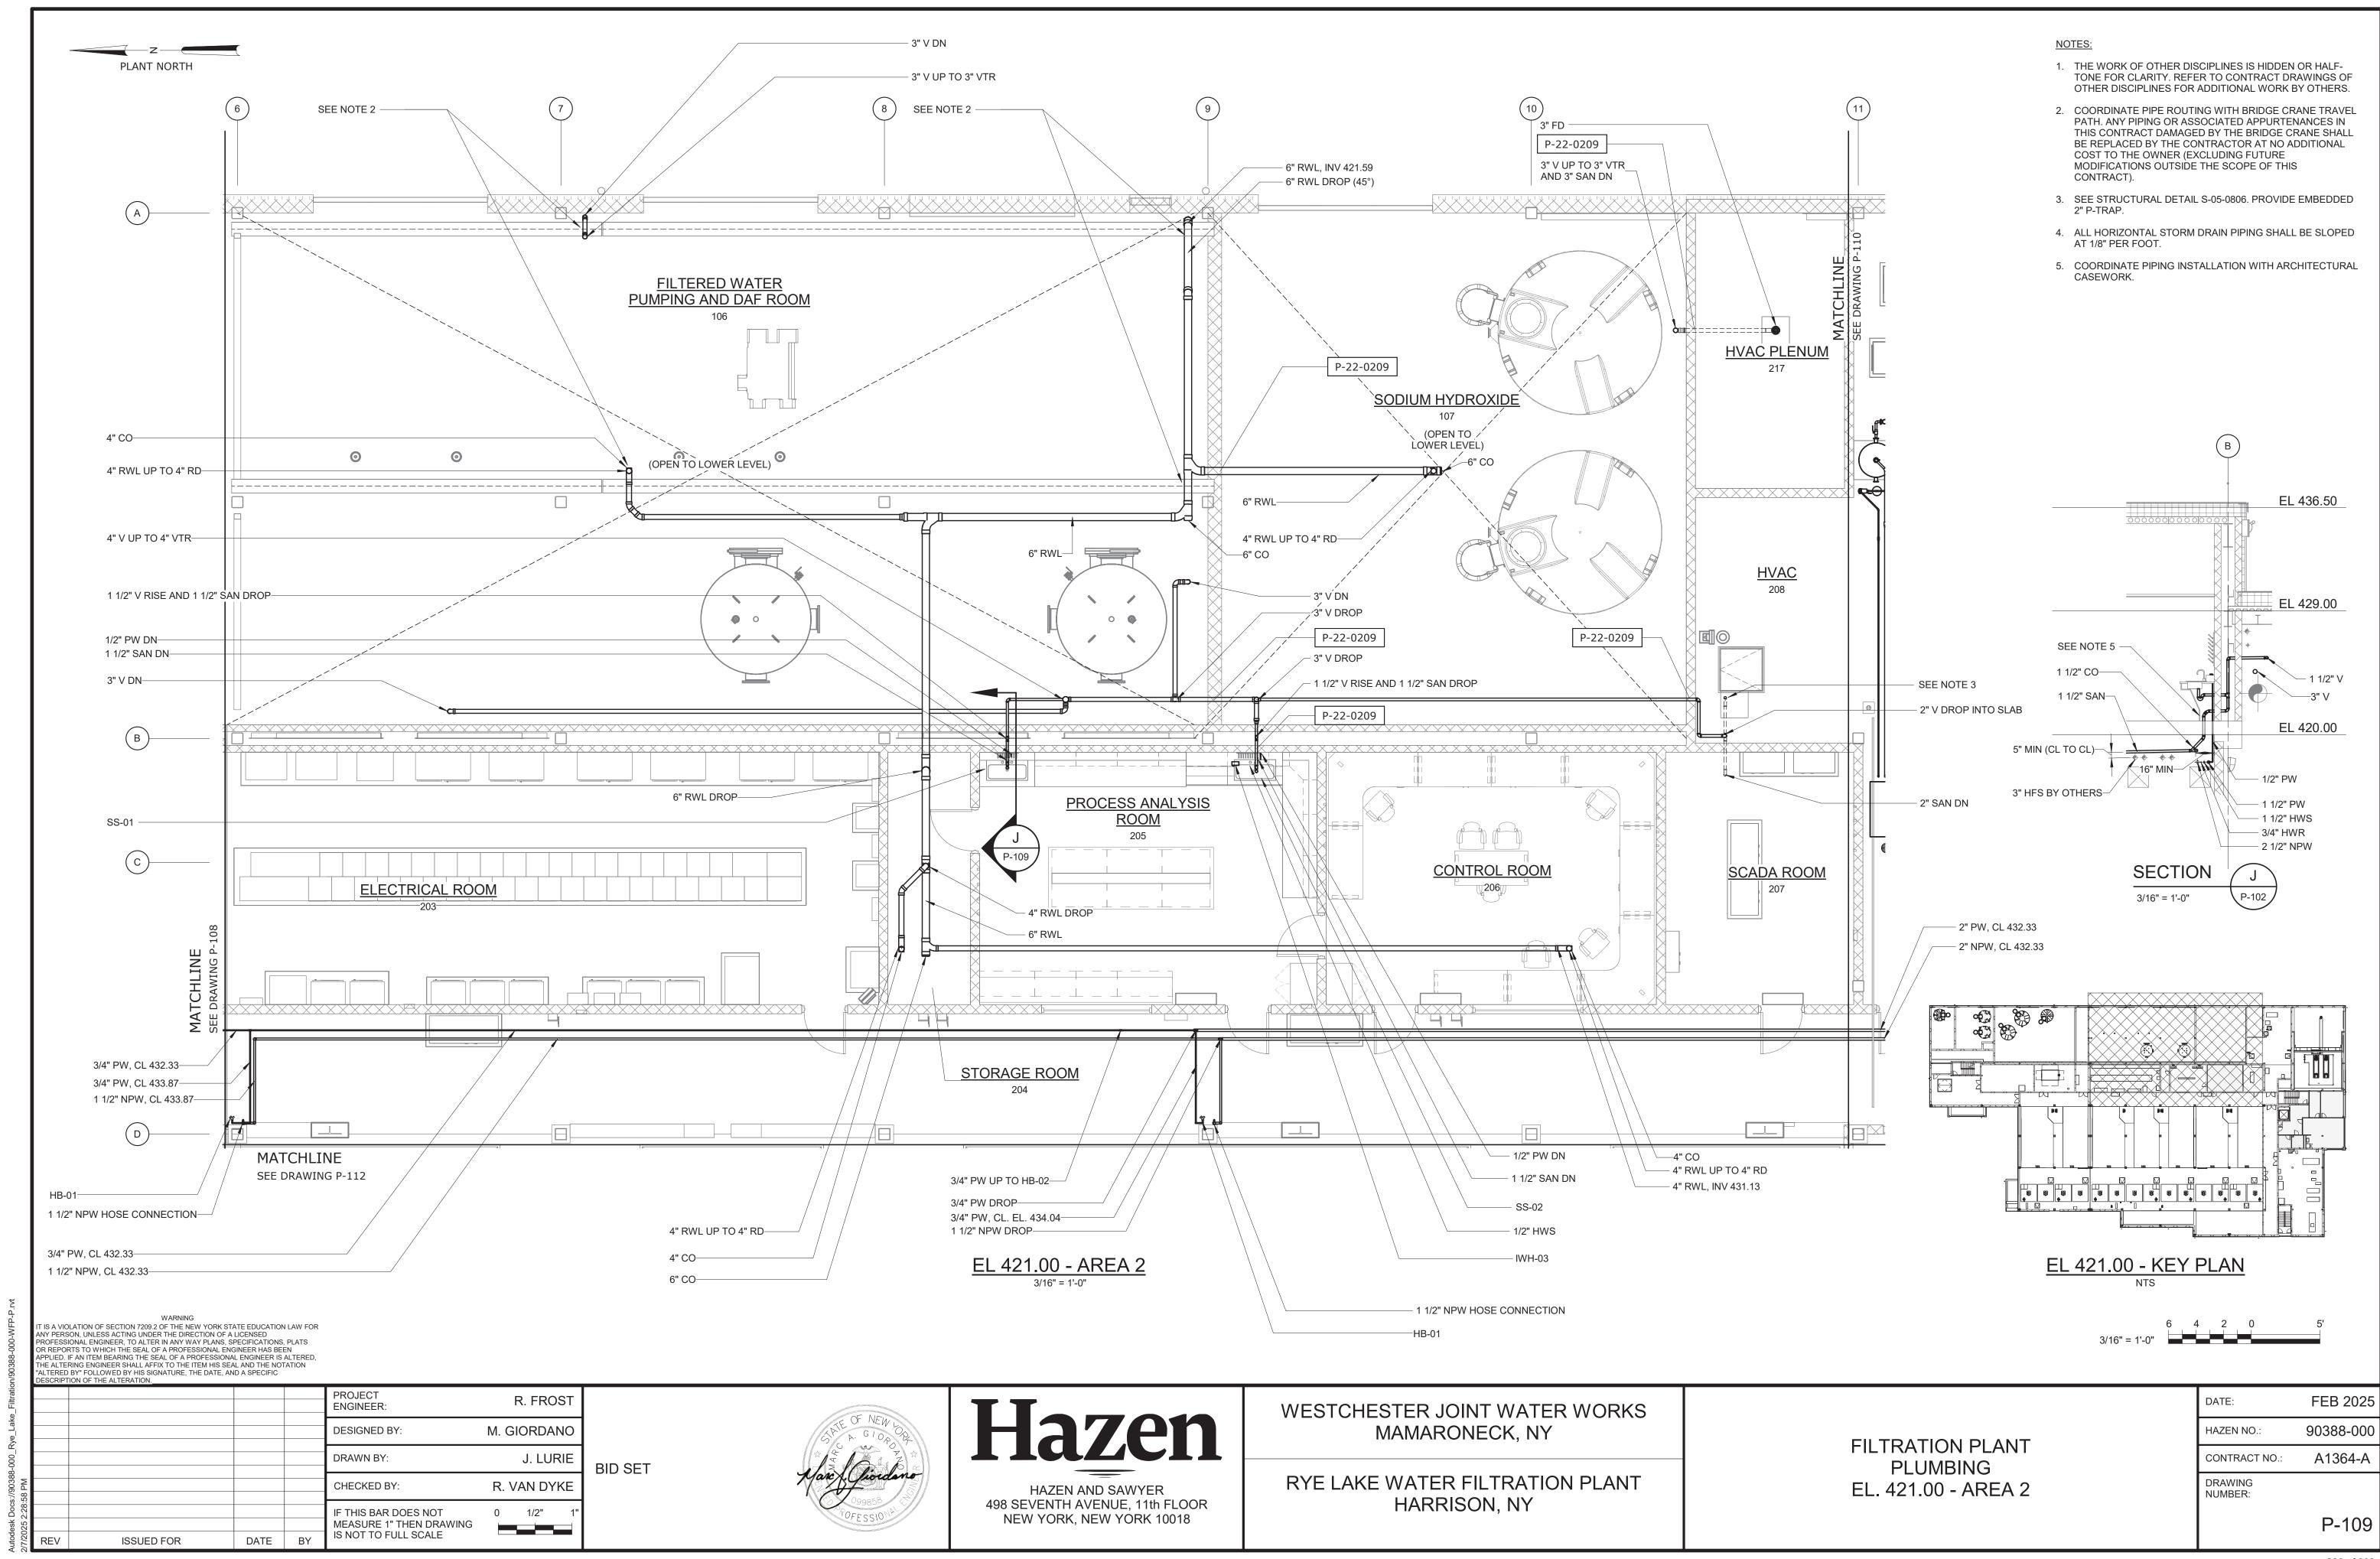

PLANT NORTH

−3" V UP TO VTR

- 1. THE WORK OF OTHER DISCIPLINES IS HIDDEN OR HALF-TONE FOR CLARITY. REFER TO CONTRACT DRAWINGS OF OTHER DISCIPLINES FOR ADDITIONAL WORK BY OTHERS.
- 2. DRAINAGE PIPING IN HVAC ROOMS (208 AND 215) SHALL BE EMBEDDED IN SLAB.
- 3. SEE STRUCTURAL DETAIL S-05-0806. PROVIDE EMBEDDED 2" P-TRAP.
- 4. COORDINATE FLOOR DRAIN LOCATION WITH ASSOCIATED

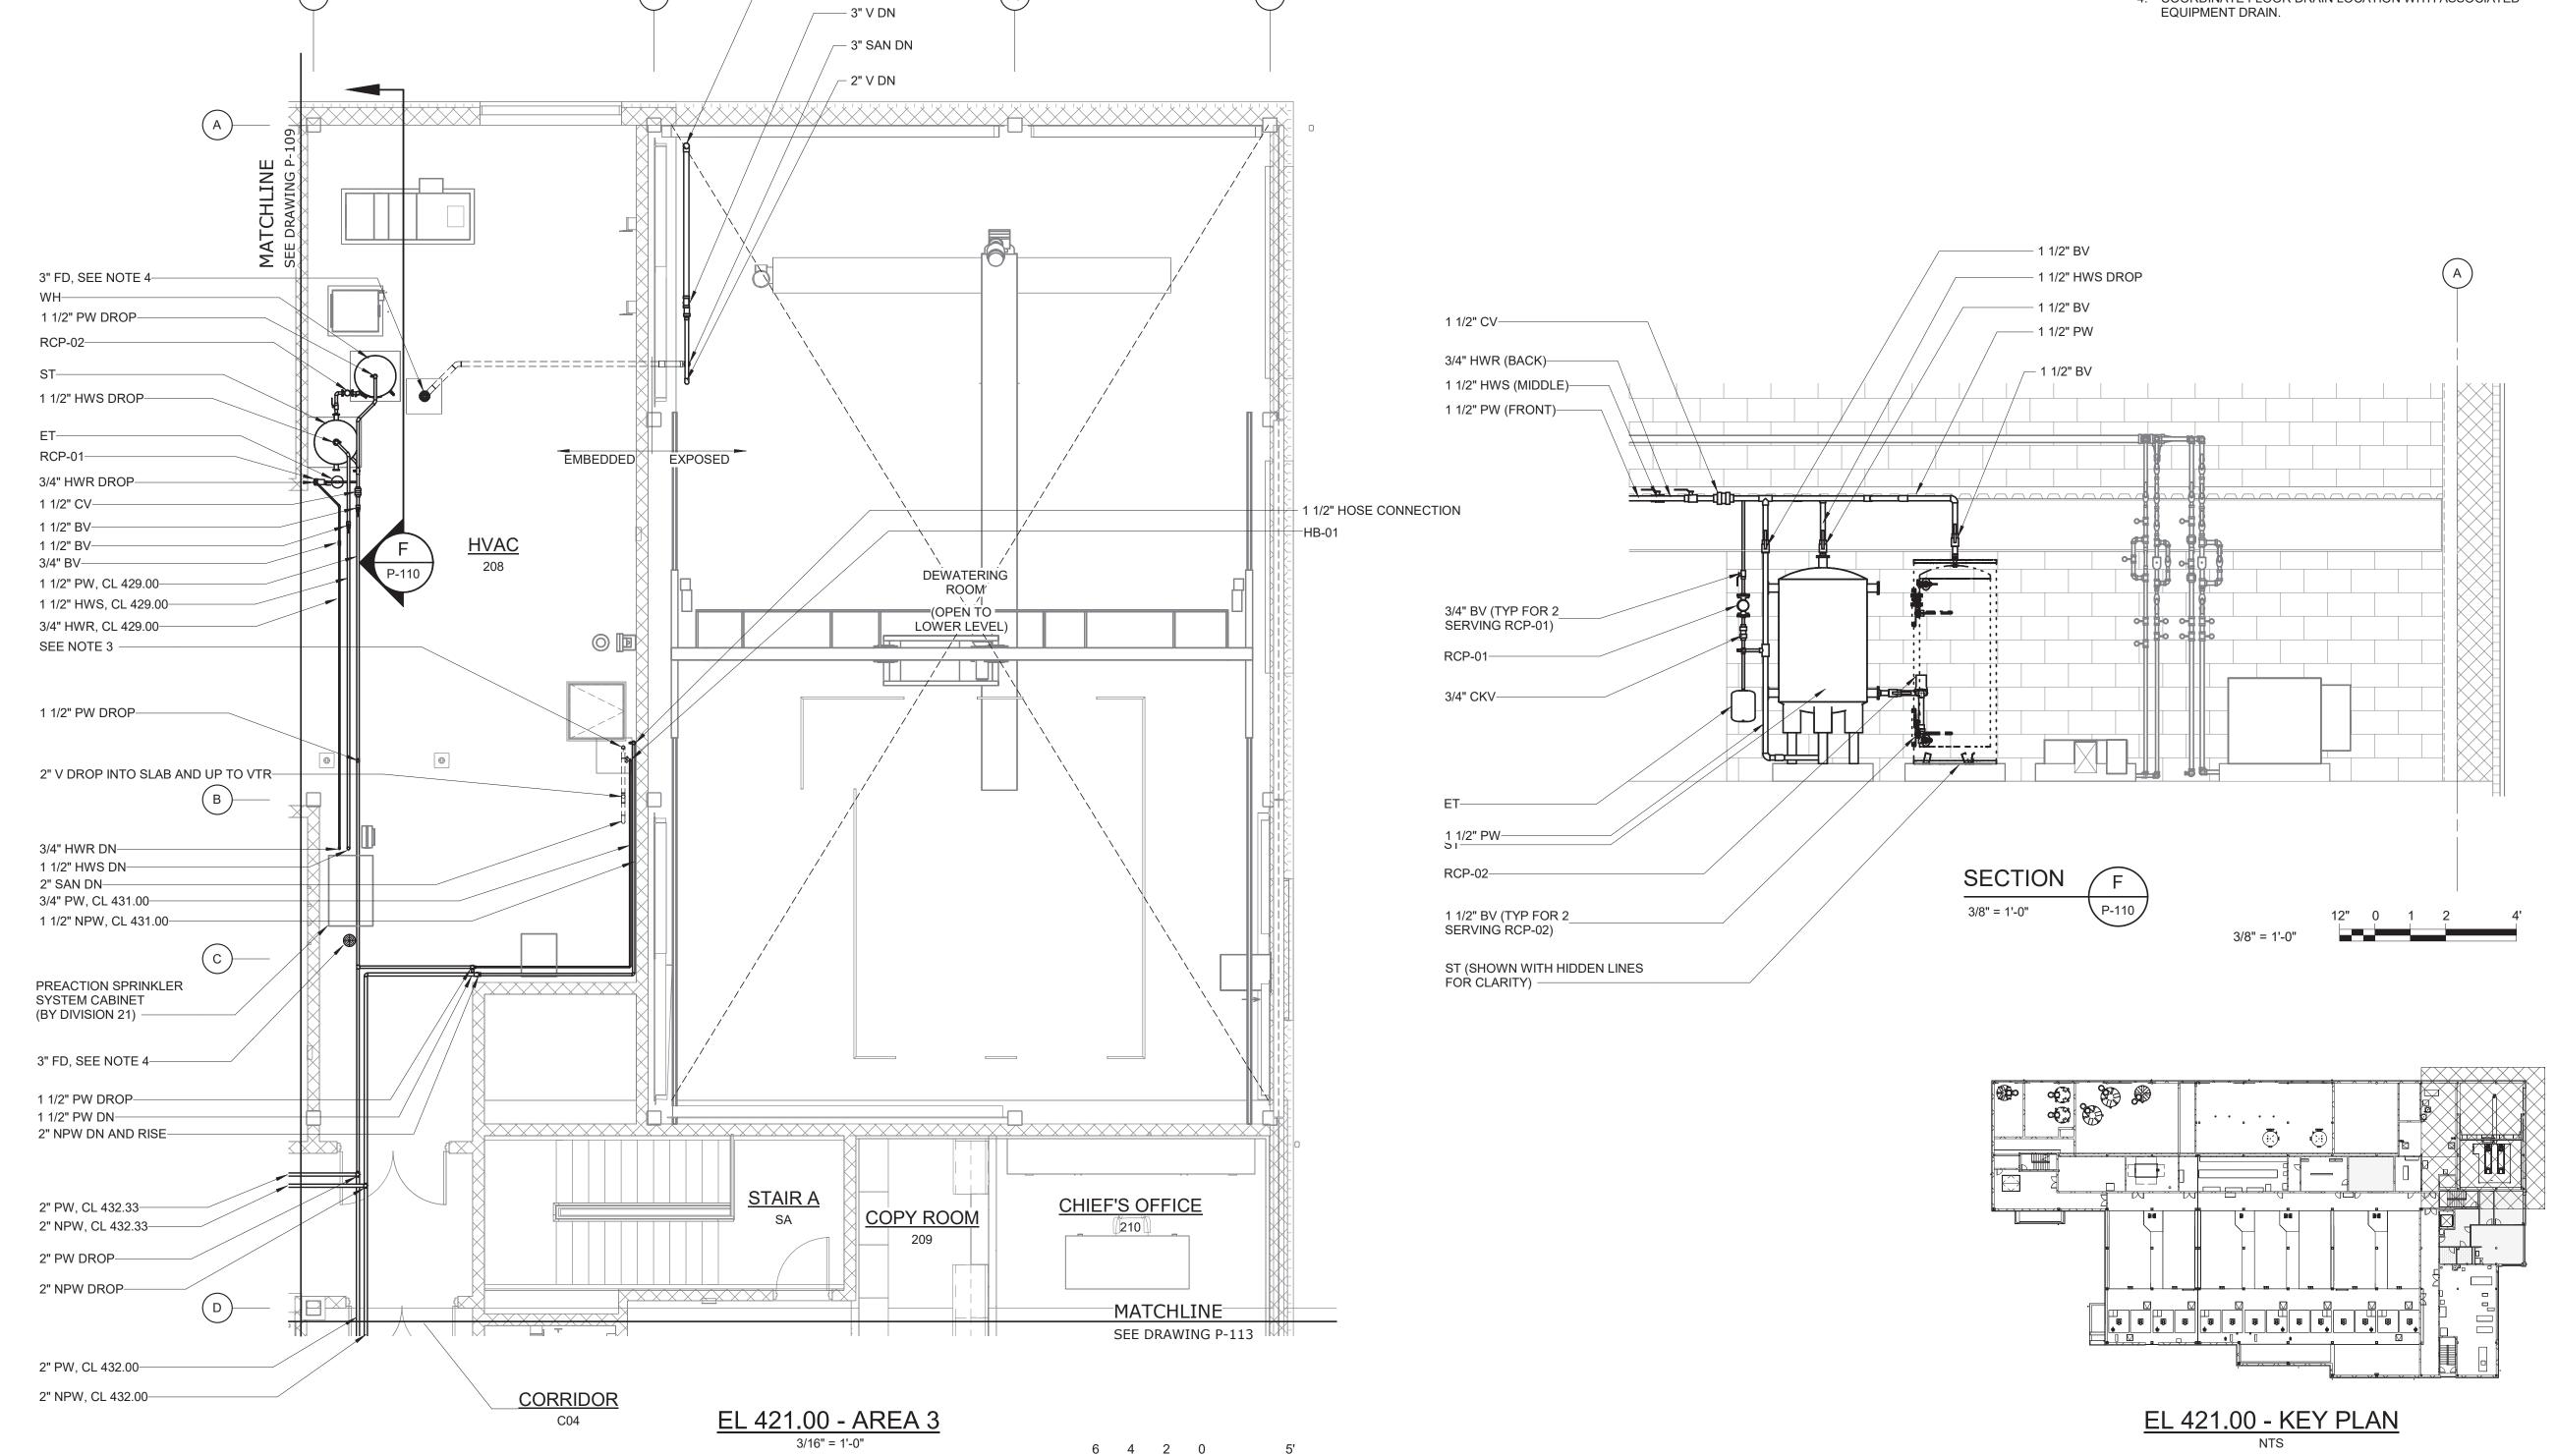

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)L	DESCRIPTI	ON OF THE ALTERATION.					
e_Filtration					PROJECT ENGINEER:	R. FROST	
Rye_Lake_					DESIGNED BY:	M. GIORDANO	
					DRAWN BY:	J. LURIE	BID SET
:://90388					CHECKED BY:	R. VAN DYKE	
utodesk Docs://90388-000_7/2025 2:29:06 PM					IF THIS BAR DOES NOT MEASURE 1" THEN DRAWING	0 1/2" 1"	
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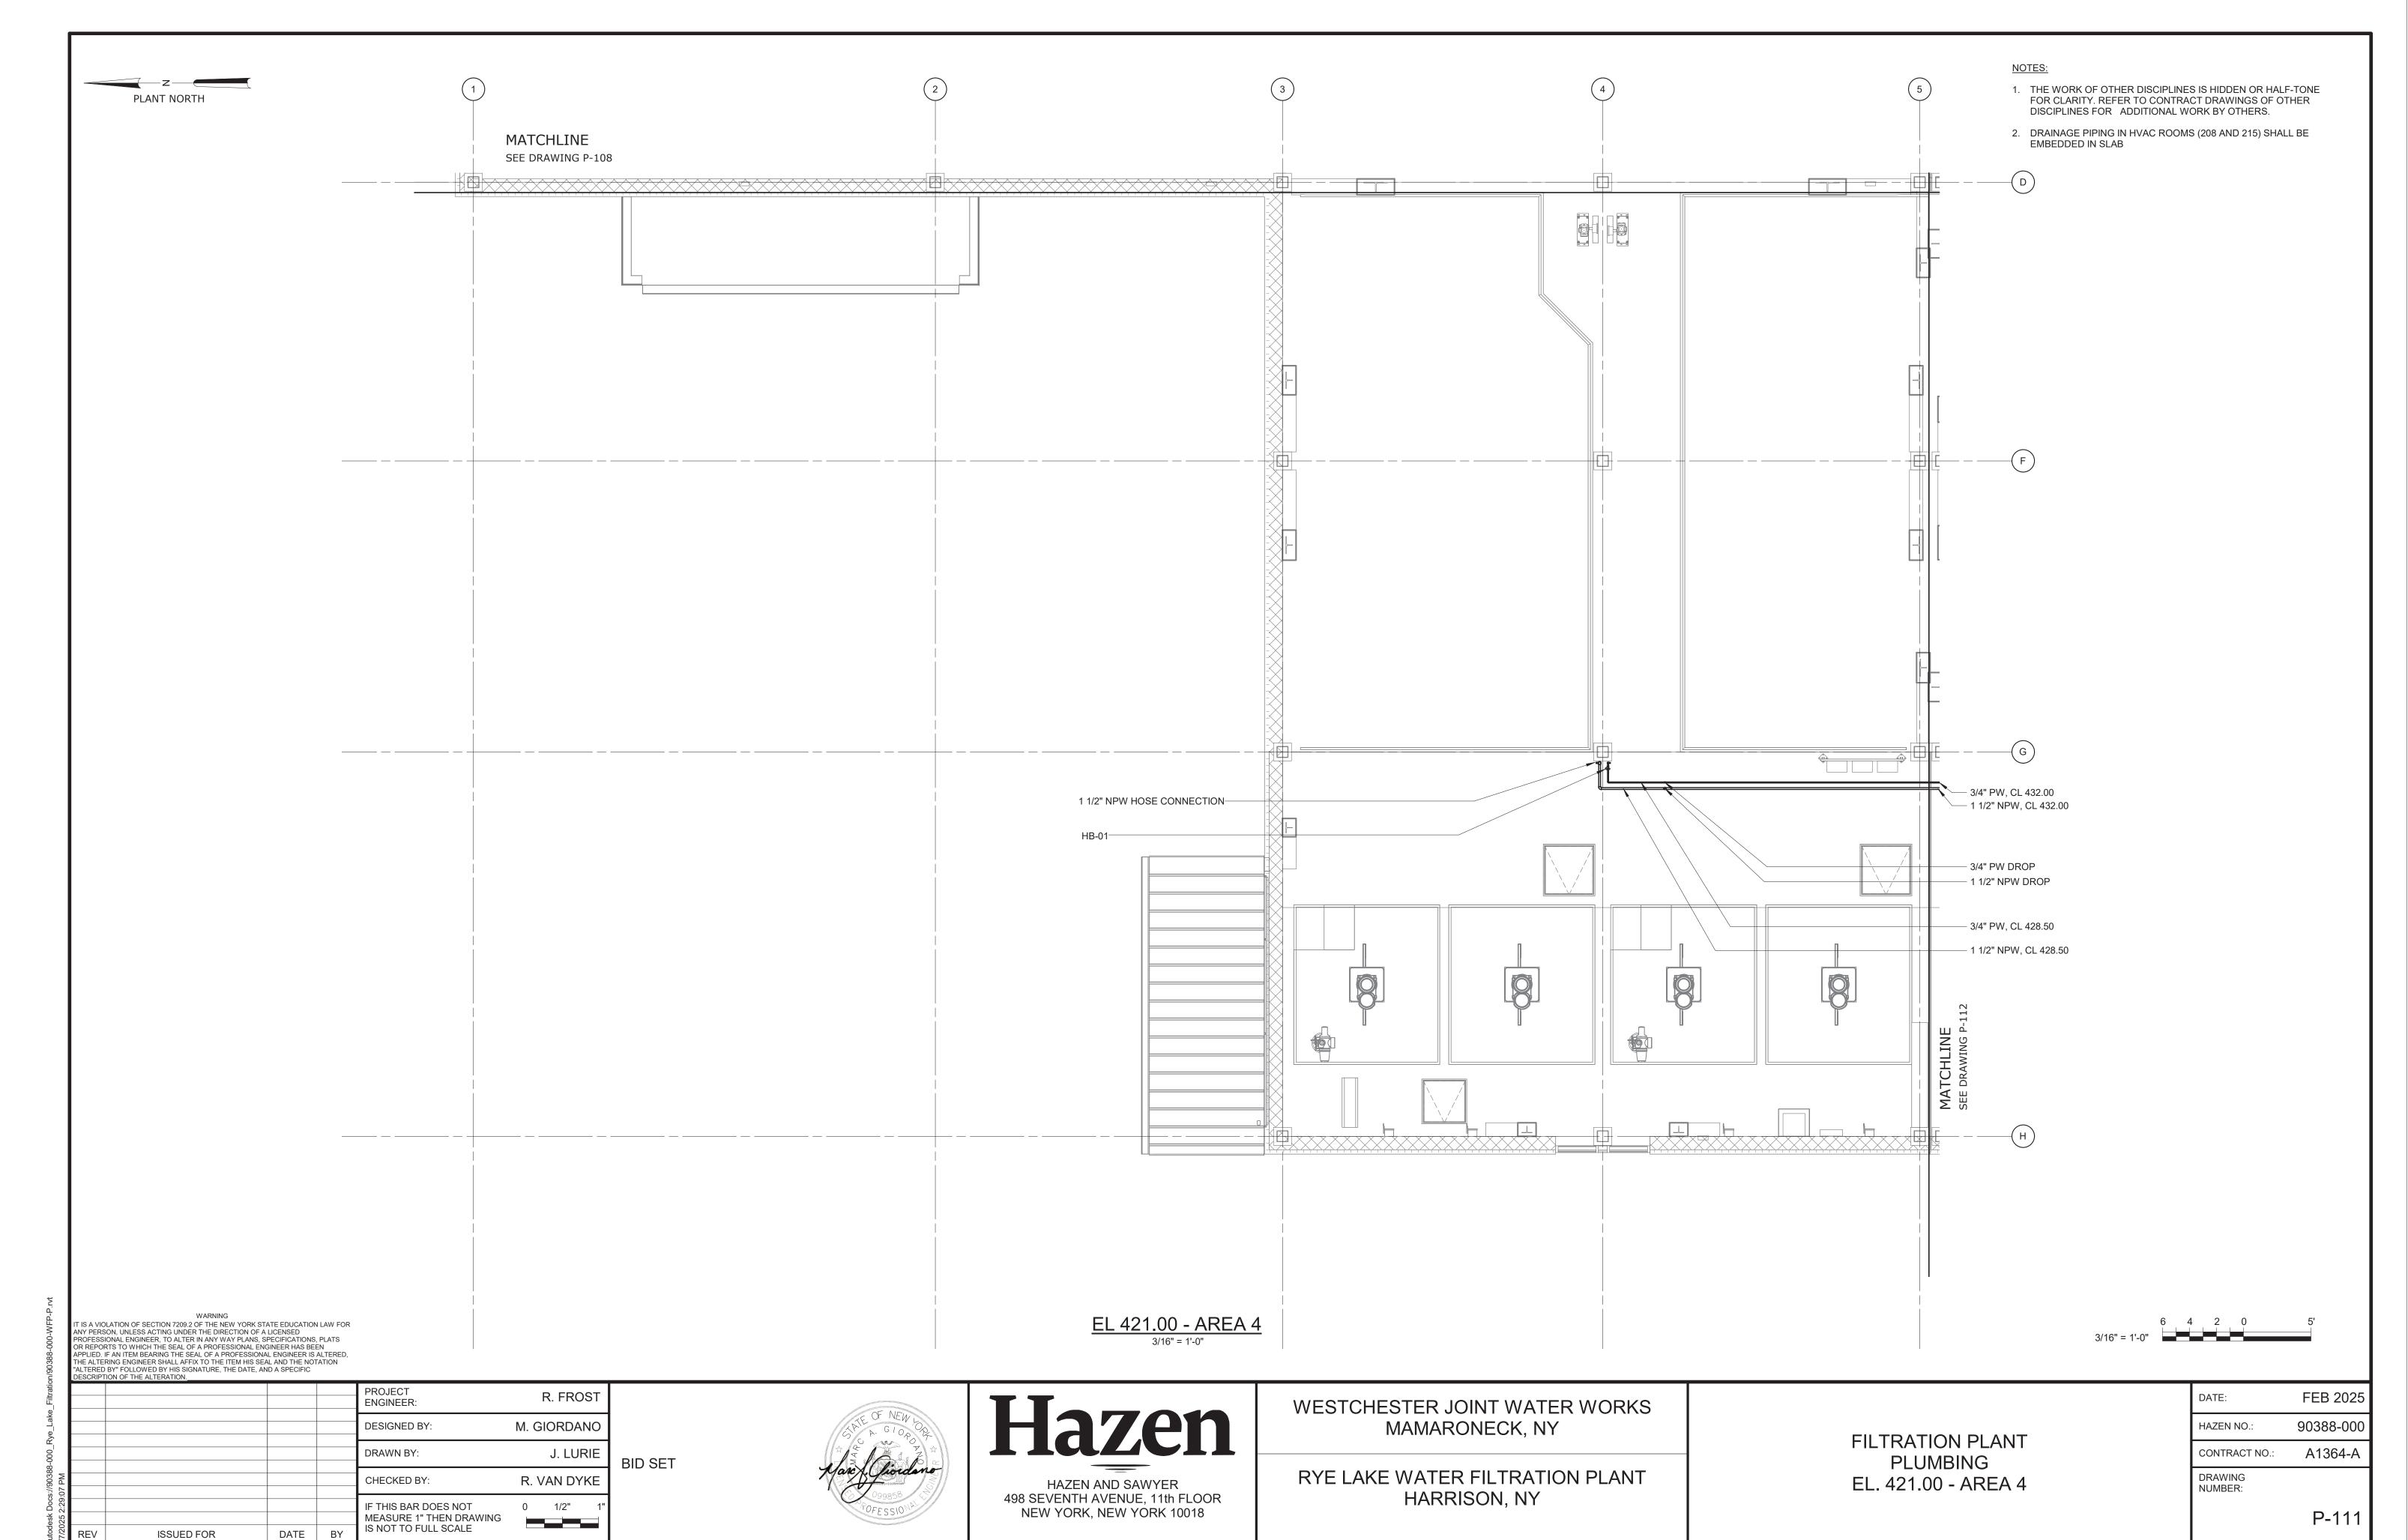
Hazen HAZEN AND SAWYER 498 SEVENTH AVENUE, 11th FLOOR NEW YORK, NEW YORK 10018


WESTCHESTER JOINT WATER WORKS MAMARONECK, NY


RYE LAKE WATER FILTRATION PLANT HARRISON, NY


FILTRATION PLANT **PLUMBING** EL. 421.00 - AREA 3


DATE:	FEB 2025
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CONTRACT NO.:	A1364-A
DRAWING NUMBER:	
	P-110




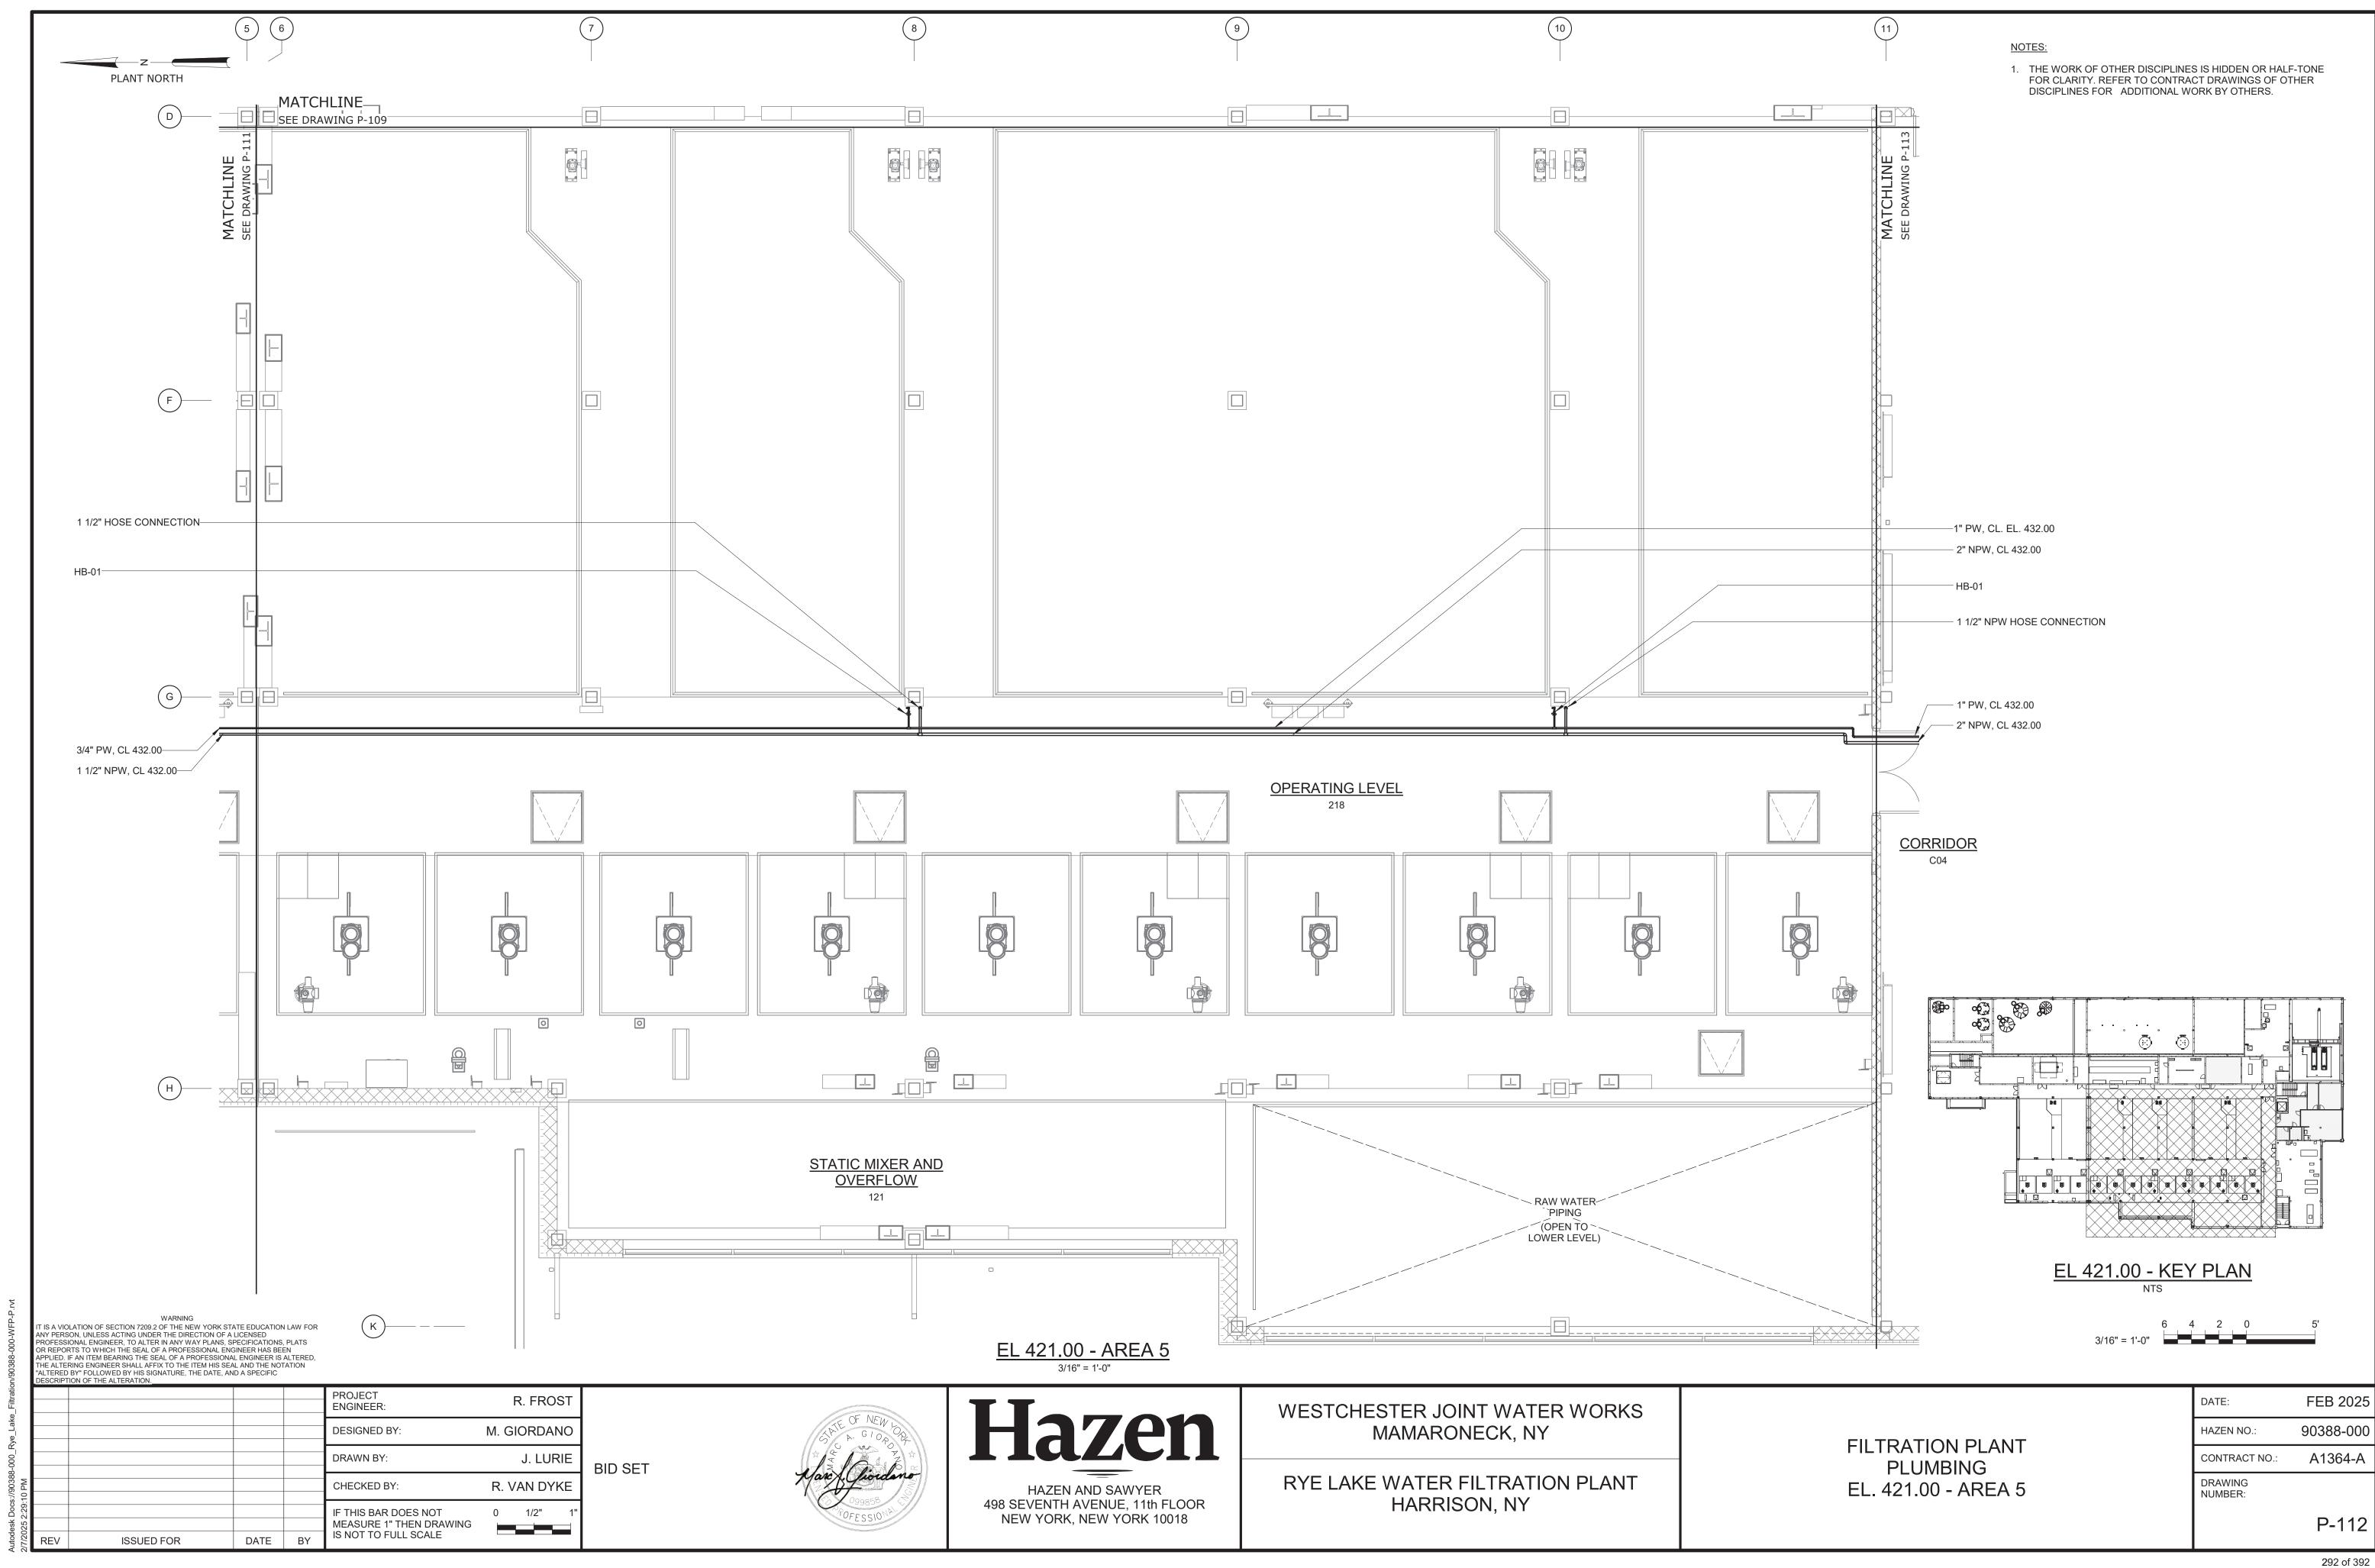

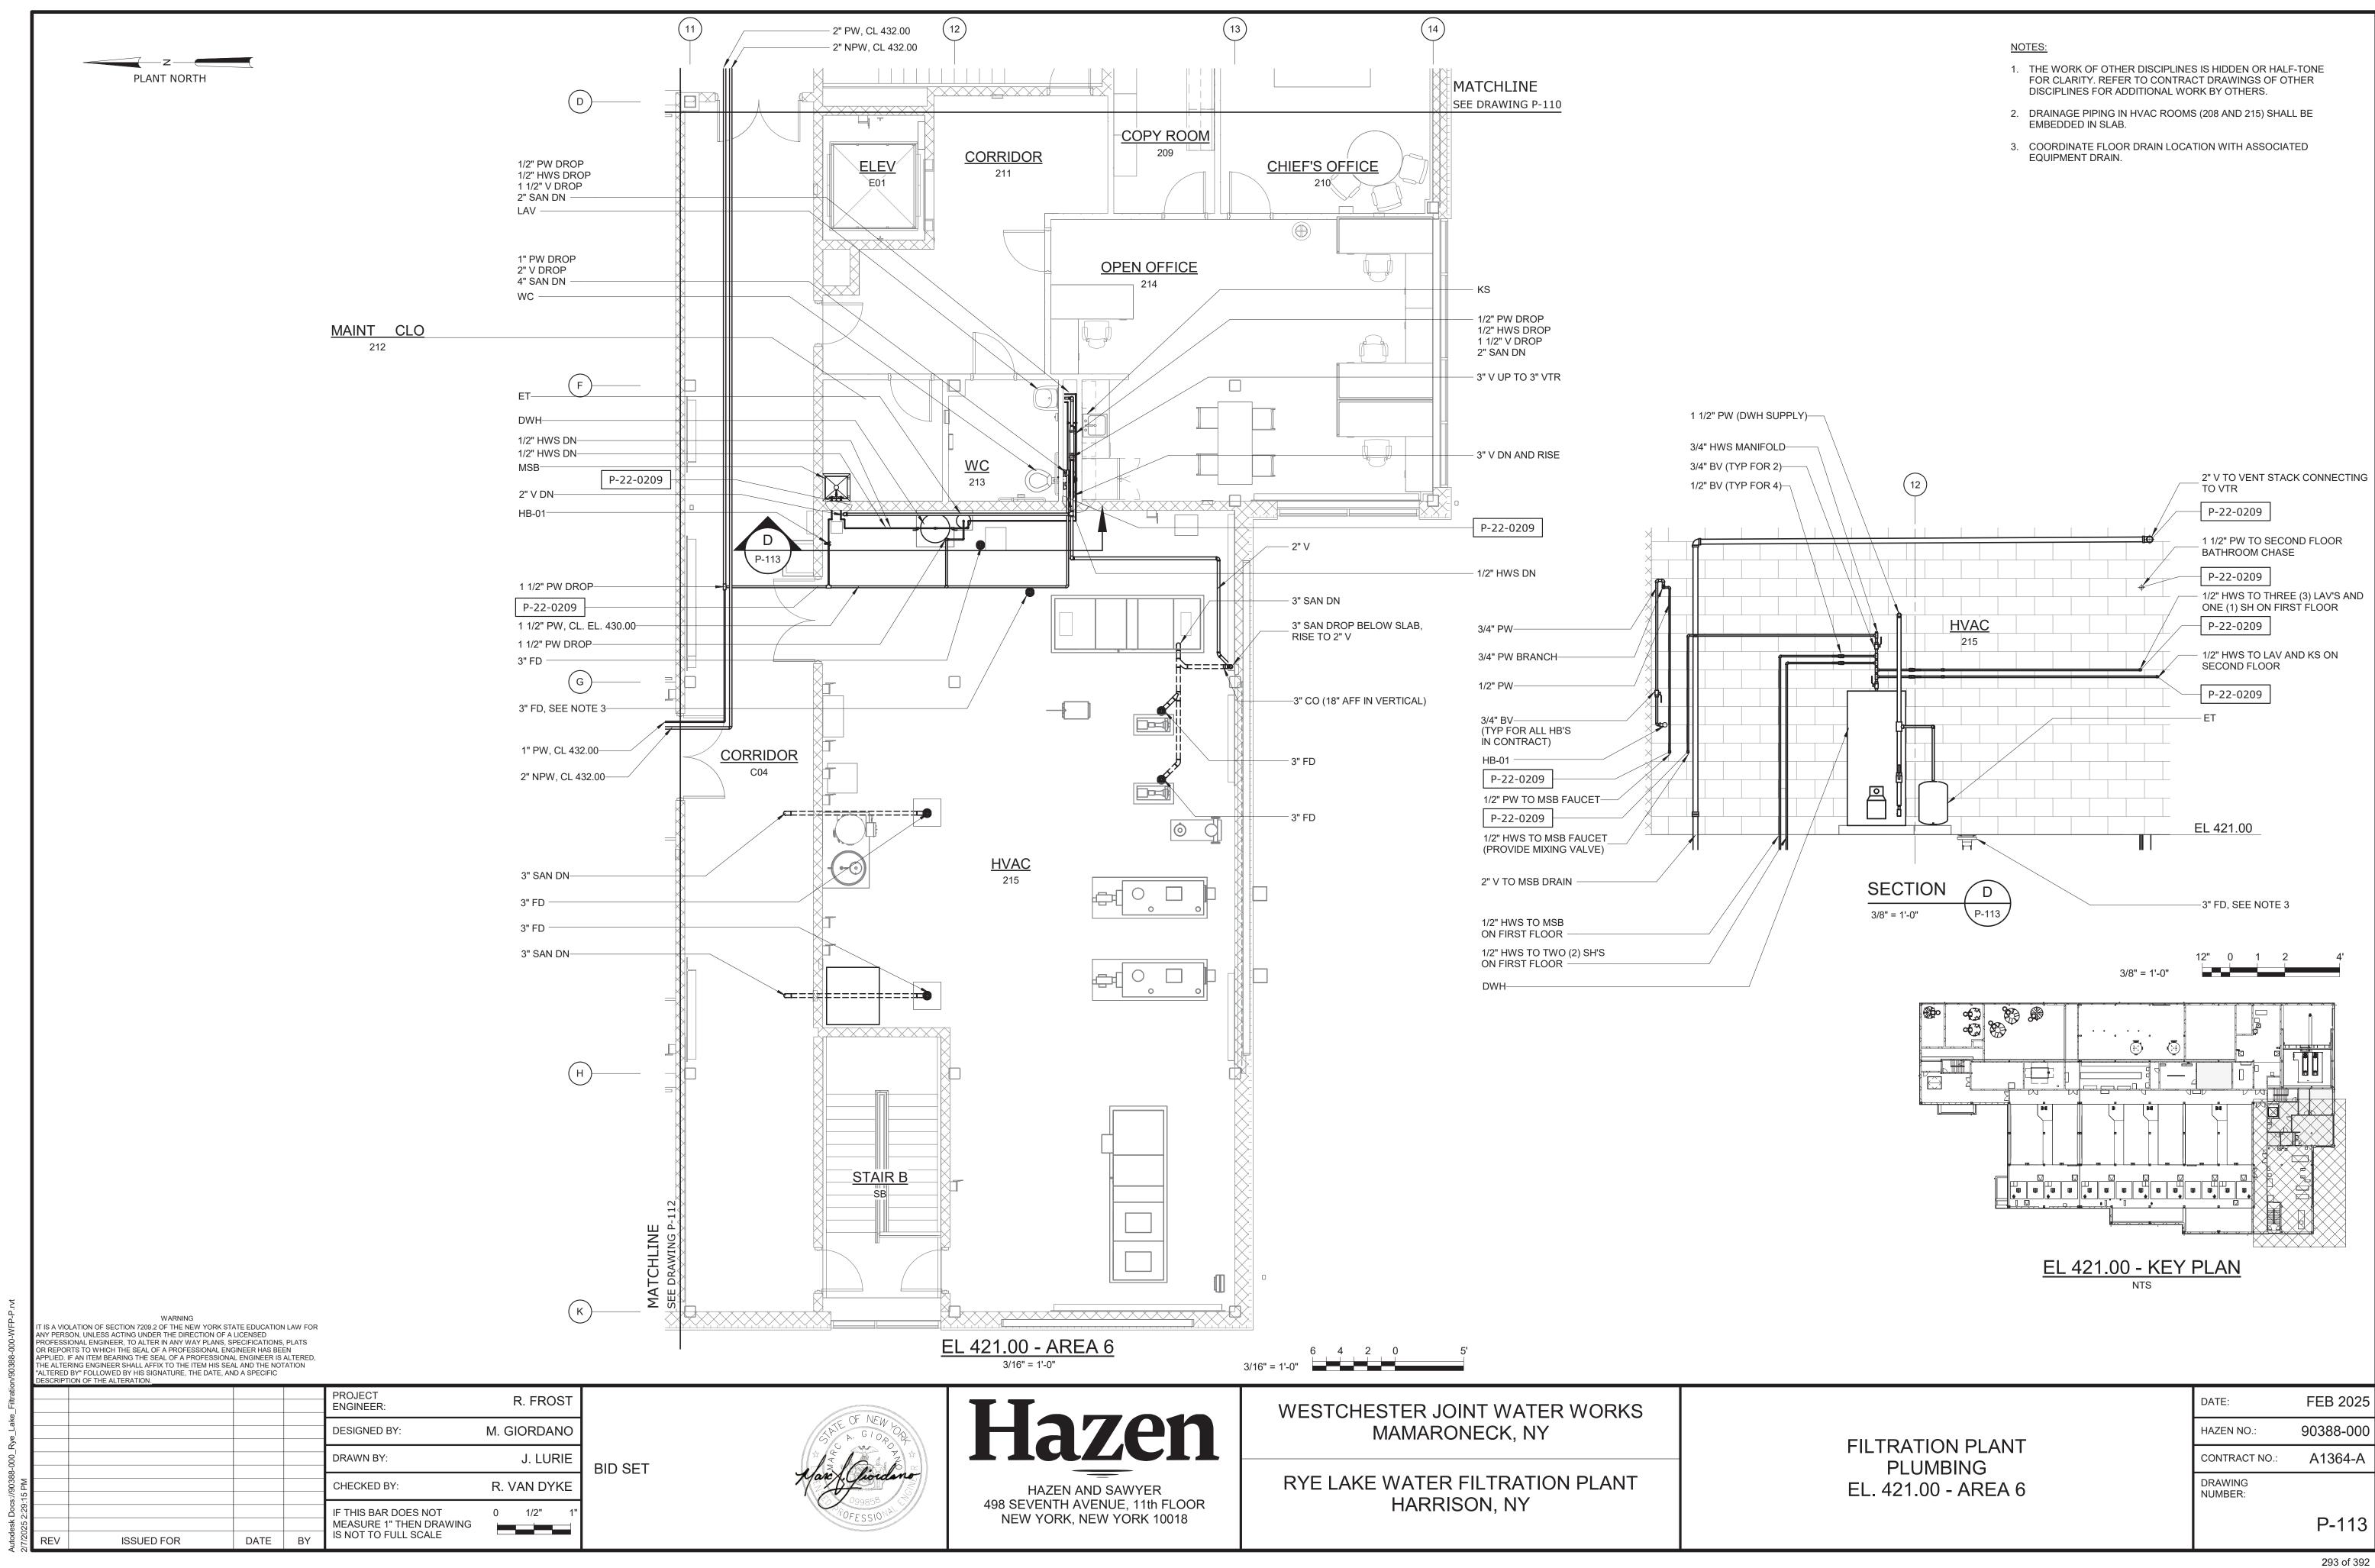

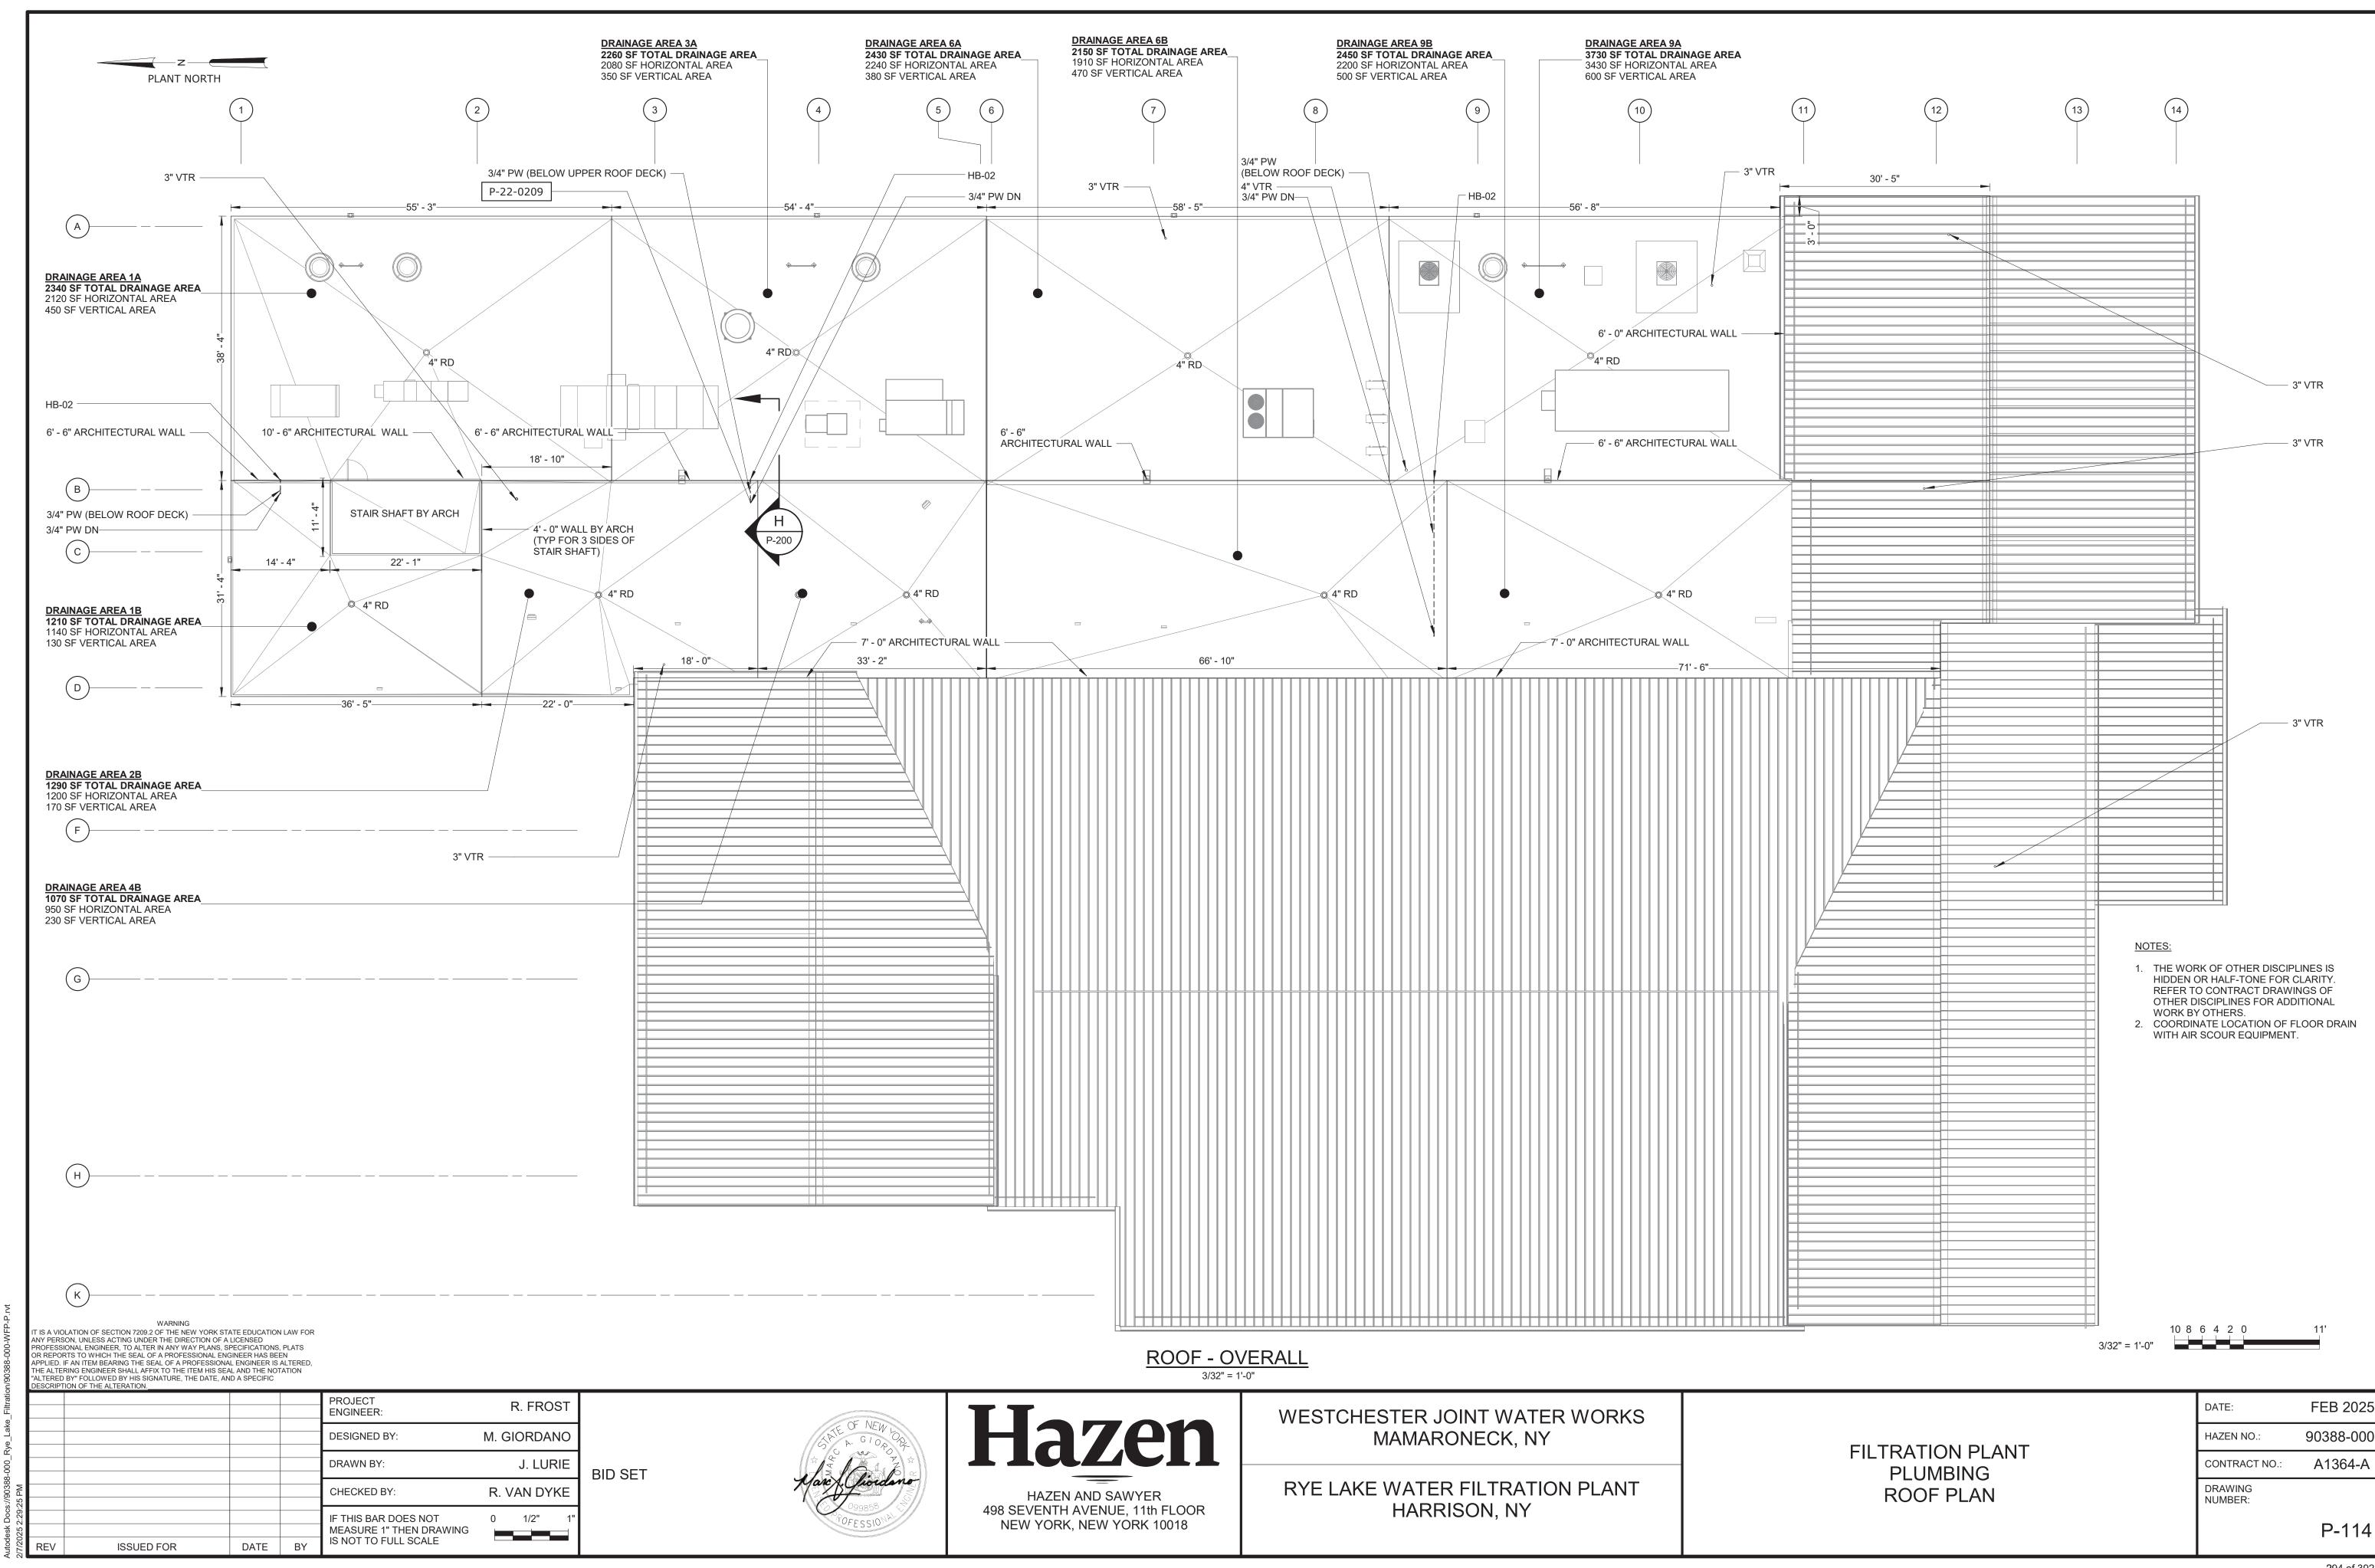

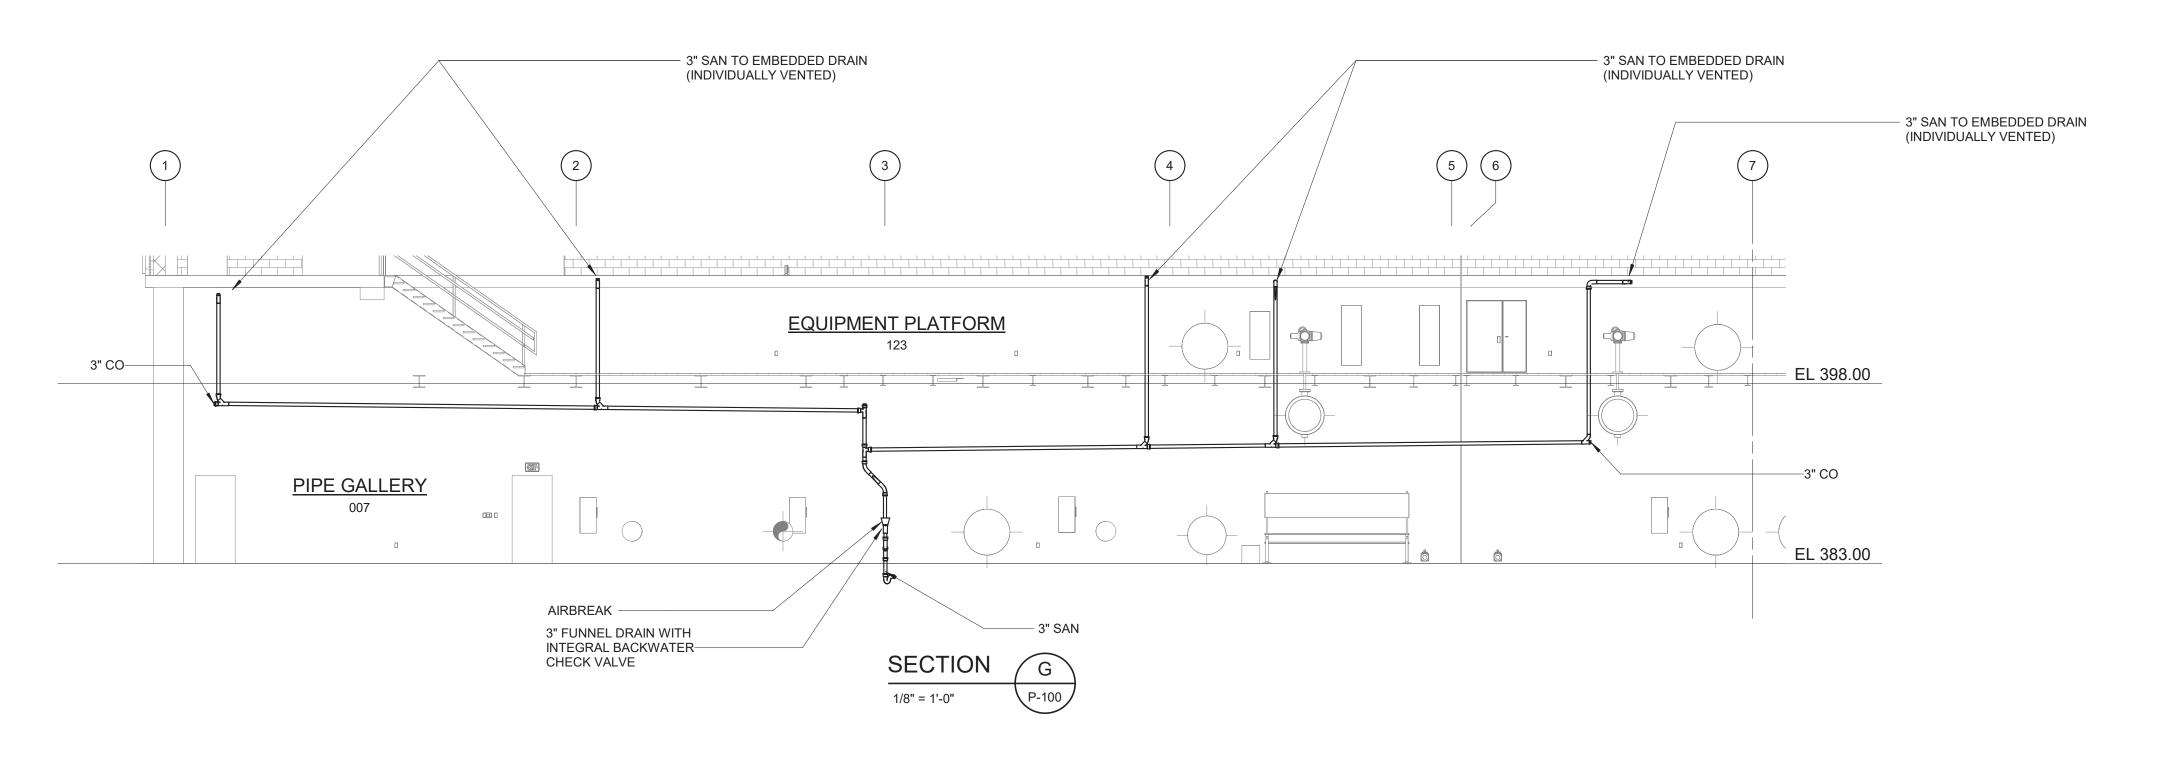

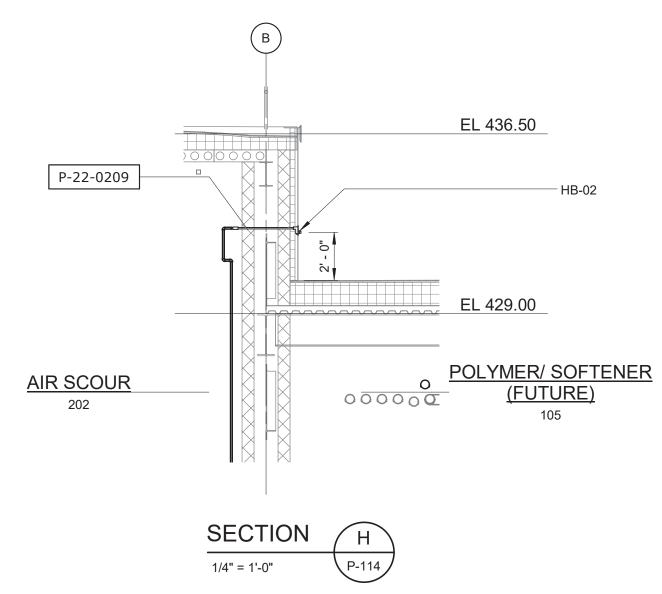

WARNING	
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GNATURE, THE DATE, AND A SPECIFIC	

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					PROJECT ENGINEER:	R. FROST	
					DESIGNED BY:	M. GIORDANO	
					DRAWN BY:	J. LURIE	BID SET
27 PM					CHECKED BY:	R. VAN DYKE	5.5 02.
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/7/202		ISSUED FOR	DATE	BY	IS NOT TO FULL SCALE		

Hazen HAZEN AND SAWYER 498 SEVENTH AVENUE, 11th FLOOR NEW YORK, NEW YORK 10018

WESTCHESTER JOINT WATER WORKS MAMARONECK, NY

RYE LAKE WATER FILTRATION PLANT HARRISON, NY

FILTRATION PLANT **PLUMBING** SECTIONS

DATE:	FEB 2025
HAZEN NO.:	90388-000
CONTRACT NO.:	A1364-A
DRAWING NUMBER:	
	P-200

1 0 1 2 3

8 6 4 2 0

1/4" = 1'-0"

1/8" = 1'-0"

		PLUMBIN	IG FIXTURE SCH	EDULE												
TAG	LOCATION	FIXTURE	MANUFAG		GALLONS PER	FAUCET/FLUSH VALVE	FAUCET/VALVE	PW	HW	TW	DRAIN				TRICAL	NOTES
BFP-01	FIRE SPRINKLER RISER ROOM (110)	REDUCED PRESSURE PRINCIPLE BACKFLOW PREVENTER	MAKE WATTS	MODEL LF909 LARGE	FLUSH/MIN	MANUFACTURER	MODEL	(IN)	(IN)	(IN)	(IN)	(IN)		PHASE	HZ AMI	1, 9, 12, 14, 18, 19
BFP-02	· · · · · · · · · · · · · · · · · · ·		WATTS	LF909 SMALL	<u>-</u>	-	-	4	-	-	-	-	-			
	FIRE SPRINKLER RISER ROOM (110)	REDUCED PRESSURE PRINCIPLE BACKFLOW PREVENTER			-	-	-	2	-	-	-	-	-			1, 9, 12, 14, 18, 19
BFP-03	FIRE SPRINKLER RISER ROOM (110)	DOUBLE CHECK DETECTOR BACKFLOW PREVENTER	WATTS	LF856	-	-	-	6	-	-	- SEE	-	-	-		1, 10, 12, 13
CODP	SEE PLANS	EXTRA HEAVY DUTY FLOOR CLEANOUT	ZURN	ZS1400-AR	-	-	-	-	-	-	PLANS	-	-	-		2, 15, 16
ESE-01	CHEMICAL AREAS	EMERGENCY SHOWER/EYEWASH	BRADLEY CORPORATION	S19314DCBF	22	-	-	-	-	1-1/4	-	-	115	1	60 3.0	5, 30, 17
ESE-02	FILL STATIONS	FROSTPROOF EMERGENCY SHOWER/EYEWASH	BRADLEY CORPORATION	S19-310TW18	22	-	-	-	-	1-1/4	-	-	115	1	60 3.0	5, 30
ET	HVAC ROOM (208)	EXPANSION TANK	AMTROL	THERM X TROL	-	-	-	1	-	-	-	_	-	-		1, 18
FD	REFER TO DRAWINGS	FLOOR DRAIN	ZURN	Z508-AR	-	-	-	-	-	-	SEE PLANS	-	-	-		2, 15, 16, 29
DF	LOBBY (112)	DRINKING FOUNTAIN	ELKAY	EMABFT	0.75	-	-	3/8	-	-	1-1/4	1-1/4	115	1	60 -	1, 18, 19
HB-01	REFER TO DRAWINGS	HOSE BIBB	ZURN	Z1341XL	5	-	-	3/4	-	-	-	-	-	-		1, 4, 19, 20
HB-02	REFER TO DRAWINGS	FROSTPROOF HOSE BIBB	ZURN	Z1321XL	5	-	-	3/4	-	-	-	-	-	-		1, 4, 19, 21
HR	DEWATERING ROOM (109)	HOSE REEL	STEEL EAGLE	K01-0105-1-SS	5	-	-	1/2	-	-	-	-	-	-		1, 23
KS	OPEN OFFICE (214)	KITCHEN SINK	JUST	SL-1921-A-GR	1.75	CHICAGO	786-CP	1/2	1/2	-	1-1/2	1-1/4	-	-		1, 18, 19, 25
LAV	REFER TO DRAWINGS	WALL HUNG LAVATORY	AMERICAN STANDARD	MURRO 0954004EC.020	0.4	AMERICAN STANDARD	7755.3.5	1/2	1/2	-	1-1/4	1-1/4	-	-		1, 18, 19, 24, 25, 31
MSB	MAINT CLO (114) & MAINT. CLO (212)	MOP SINK BASIN	WESTERN WILLIAMS	SS-2424	3	T & S BRASS	B-0665-BSTR	1/2	1/2	-	3	1-1/2	-	-		1, 18, 19, 22, 25
RD	ROOF	ROOF DRAIN	ZURN	Z-121-AR-C	-	-	-	-	-	-	4	-	-	-		11
SH	MENS LOCKER ROOM (118) AND WOMENS LOCKER ROOM (116)	SHOWER	STERN WILLIAMS	WDA-3410 TERRAZO 60 X 30 ADA SHOWER PAN	2.5	SYMMONS	S5998	1/2	1/2	-	2	2	-	-		1, 24, 26
SS-01	PROCESS ANALYSIS ROOM (205)	SAMPLING SINK	ELKAY	LRAD291855	3	ELKAY	LK535GN05L2	1/2	-	-	1-1/2	-	-	-		1, 18, 19, 22, 24, 25
SS-02	PROCESS ANALYSIS ROOM (205)	SERVICE SINK	ELKAY	LRAD291855	3	ELKAY	LK406GN08L2	1/2	1/2	-	1-1/2	1-1/4	-	-		1, 18, 19, 22, 24, 25
TD	REFER TO DRAWINGS	TRENCH DRAIN	ABT DRAINS	POLYDRAIN	-	-	-	-	-	-	4	2	-	-		2
TMV	REFER TO DRAWINGS	THERMOSTATIC MIXING VALVE	LAWLER	911-84701	-	-	-	1-1/4	1-1/4	1-1/4	-	-	-	-		1, 7, 27
UR	MENS BATHROOM (117)	FLUSH VALVE URINAL	KOHLER	K-4991-ET	0.125	KOHLER	K-7528	3/4	-	-	2	1-1/2	-	-		1, 24, 28
WC	REFER TO DRAWINGS	FLUSH VALVE WATER CLOSET	KOHLER	K-4325-0	1.28	KOHLER	K-10956-SV	1	-	-	4	2	-	-		1, 6, 24

- 1. REFER TO SPECIFICATION 22 40 00 FOR CONSTRUCTION AND ACCESSORY DETAILS.
- 2. REFER TO SPECIFICATION 22 13 16 FOR CONSTRUCTION AND ACCESSORY DETAILS.
- 3. REFER TO SPECIFICATION 22 14 13 FOR CONSTRUCTION AND ACCESSORY DETAILS.
- 4. REFER TO SPECIFICATION 22 11 19 FOR CONSTRUCTION AND ACCESSORY DETAILS. 5. REFER TO SPECIFICATION 22 45 00 FOR CONSTRUCTION AND ACCESSORY DETAILS.
- 6. PROVIDE WATER CLOSET WITH WALL CARRIER AND SOLID PLASTIC SEAT.
- 7. UNIT TO INCLUDE ROUGH BRONZE FINISH, INLET CHECK VALVES, DIAL THERMOMETERS, LOCKABLE BALL VALVES, 70-90 DEGREE SET POINT.
- 8. PROVIDE ZURN Z41B-V (BACKWATER VALVE) WHERE SPECIFIED ON DRAWINGS. 9. PROVIDE WITH SENTRYPLUS ALERT UNIVERSAL UPGRADE KIT INCLUDING FLOOD SENSOR AND CONTROL BOX (ONE SHARED SENSOR FOR BOTH 2" RPZS).
- 10. INSTALL TWO (2) TAMPER SWITCH MONITORS ON INTEGRAL OS & Y VALVES.
- 11. THREADED OUTLET, FACTORY-APPLIED ACID-RESISTANT EPOXY COATED FINISH, MEMBRANE CLAMP AND UNDERDECK CLAMP. 12. FIXTURE SHALL BE UL LISTED AND APPROVED BY THE FOUNDATION FOR CROSS-CONNECITON CONTROL AND HYDRAULIC REASEARCH OF SOUTHERN CALIFORNIA.
- 13. FIXTURE SHALL BE FM APPROVED AND MEET THE REQUIRMENTS OF ASSE 1048 AND AWWA C510.
- 14. FIXTURE SHALL MEET THE REQUIRMENTS OF ASSE 1013 AND AWWA C511-92. 15. FIXTURE SHALL INCLUDE AN ANSI A112.21.1M H-20 EXTRA-HEAVY DUTY STAINLESS STEEL OR POLISHED NICKEL TOP AND ACID-RESISTANT EPOXY-COATED CAST IRON BODY.
- 16. INSIDE-CAULK CONNECTION FOR XH CAST IRON PIPE, NH CONNECTION FOR NH CAST IRON PIPE, NEO-LOC (OR EQUIVALENT) FOR PVC PIPE.
- 17. FIXTURE SHALL BE BARRIER-FREE WITH DUST COVER. 18. FIXTURE OR FAUCET SHALL BE CERTIFIED TO NSF-61.
- 19. FIXTURE SHALL BE CERTIFIED TO NSF-372 OR SHALL BE MANUFACTURED IN ACCORDANCE WITH THE FEDERAL SAFE WATER DRINKING ACT SECTION 1417. 20. FIXTURE SHALL INCLUDE ASSE 1011 VACUUM BREAKER.
- 21. FIXTURE SHALL INCLUDE ASSE 1019 VACUUM BREAKER.
- 22. FIXTURE SHALL INCLUDE ASSE 1001 VACUUM BREAKER.
- 23. FIXTURE SHALL BE ALL STAINLESS STEEL CONSTRUCTION.
- 24. FIXTURE SHALL MEET THE AMERICANS WITH DISABILITIES ACT GUIDELINES AND ANSI A117.1.
- 25. PROVIDE ASSE 1070 APPROVED POINT-OF-USE MIXING VALVE. 26. PROVIDE ASSE 1016 APPROVED SHOWER MIXING VALVE.
- 27. MIXING VALVE SHALL BE ASSE 1071 APPROVED.
- 28. PROVIDE URINAL WITH WALL CARRIER.
- 29. PROVIDE FLOOR DRAIN OUTLETS WITH BARRIER TYPE TRAP SEAL MEETING THE REQUIREMENTS OF ASSE 1072. ZURN Z1072 OR EQUAL.
- 30. PROVIDE WITH S19-324 NEMA 4X SIGNAL SYSTEM WITH STAINLESS STEEL FLOW SWITCH AND 12 FT CABLE. 31. PROVIDE LAVATORY WITH WALL CARRIER, ANGLE STOPS, FLEX TUBE RISERS, STRAINER, AND P TRAP.

	PLUMBING PUMP SCHEDULE																
TAG	LOCATION	MANUF MAKE	ACTURER MODEL	TYPE	CONTROLS	CAPACITY (GPM)	HEAD (FT)	SHUTOFF HEAD (FT)	SUCTION SIZE (IN)	DISCHARGE SIZE (IN)	IMPELLER TYPE		TOR RPM		POWER		NOTES
SP-01	PIPE GALLERY (007)	LIBERTY PUMPS	LGS203M	SUMP PUMP	DUPLEX PANEL, ANALOG FLOAT	50	35	110	-	1 1/4"	-	2	3450	208	3	60	1, 3, 6
SP-02	PIPE GALLERY (007)	LIBERTY PUMPS	LGS203M	SUMP PUMP	DUPLEX PANEL, ANALOG FLOAT	50	35	110	-	1 1/4"	-	2	3450	208	3	60	1, 4, 6
SP-03	ELEVATOR (E01)	LIBERTY PUMPS	FL63M-5	SUMP PUMP	SIMPLEX PANEL, ANALOG FLOAT	50	45	-	-	2"	VORTEX	3/5	3450	208	3	60	1, 6, 7
RCP-01	HVAC ROOM (203)	XYLEM	ECOCIRC XLN20-35	RECIRCULATION PUMP	INTEGRAL DIGITAL LOGIC CONTROLLER, EXTERNAL TEMPERATURE SENSOR	3.3	10.6	-	1 1/2"	1 1/2"	-	1/12	VAR	115	1	60	2, 5, 6
RCP-02	HVAC ROOM (208)	XYLEM	ECOCIRC XLN20-35	RECIRCULATION PUMP	INTEGRAL DIGITAL LOGIC CONTROLLER, EXTERNAL TEMPERATURE SENSOR	3.3	10.6	-	1 1/2"	1 1/2"	-	1/12	VAR	115	1	60	2, 5, 6

NOTES:

- 1. REFER TO SPECIFICATION 22 33 00 FOR CONSTRUCTION AND ACCESSORY DETAILS.
- 2. REFER TO SPECIFICATION 22 11 23 FOR CONSTURCTION AND ACCESSORY DETAILS.
- 4. STANDBY PUMP
- 5. PUMP SHALL HAVE STAINELSS STEEL HOUSRING, AND SHALL BE CERTIFIED TO NSF-372.
- 6. PUMP SHALL BE UL LISTED.
- 7. PUMP SHALL COMPLY WITH ALL APPLICABLE REQUIREMENTS OF ASME A17.1-2022.

WARNING
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PROFESSIONAL ENGINEER, TO ALTER IN ANY WAY PLANS, SPECIFICATIONS, PLATS
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APPLIED. IF AN ITEM BEARING THE SEAL OF A PROFESSIONAL ENGINEER IS ALTERED,
THE ALTERING ENGINEER SHALL AFFIX TO THE ITEM HIS SEAL AND THE NOTATION
"ALTERED BY" FOLLOWED BY HIS SIGNATURE, THE DATE, AND A SPECIFIC

DESCRIPT	TION OF THE ALTERATION.						
				PROJECT ENGINEER:		R. FRO	ST
				DESIGNED BY:	M. C	SIORDAI	NO
				DRAWN BY:		J. LUF	RIE
<u> </u>				CHECKED BY:	R. '	VAN DY	KE
07:87:7				IF THIS BAR DOES NOT MEASURE 1" THEN DRAWING		1/2"	1" ——
REV	ISSUED FOR	DATE	BY	IS NOT TO FULL SCALE			-

BID SET

Hazen HAZEN AND SAWYER 498 SEVENTH AVENUE, 11th FLOOR

NEW YORK, NEW YORK 10018

WESTCHESTER JOINT WATER WORKS MAMARONECK, NY

RYE LAKE WATER FILTRATION PLANT HARRISON, NY

FILTRATION PLANT **PLUMBING** SCHEDULES - SHEET 1

DATE:	FEB 2025
HAZEN NO.	90388-000
CONTRACT	NO.: A1364-A
DRAWING NUMBER:	
	P-600

296 of 392

				PIPING SYSTEM SCHEDULE	≣					
YSTEM	SYSTEM TYPE	LOCATION	PIPE	FITTING	JOINT	COATING	INSULATION	JACKET	SPECIFICATION REFERENCE	NOTE
CLW	CLEARWATER DRAIN	ABOVE GROUND	CAST IRON - NH - ASTM A888 AND CISPI 301	CAST IRON - NH - ASTM A888 AND CISPI 301	HUBLESS COUPLING - CISPI 301	OIL-BASED ENAMEL	-	-	22 13 16	-
CLW	CLEARWATER DRAIN	BELOW GROUND	CAST IRON - XH - ASTM A74	CAST IRON - XH - ASTM A74	POURED LEAD AND OAKUM	OIL-BASED ENAMEL	-	-	22 13 16	-
FPW	FIRE PROTECTION	ABOVE GROUND	CARBON STEEL - ASTM A795 - SCH 40	DUCTILE IRON - ASTM A536	GROOVED COUPLING - DUCTILE IRON - ASTM A536	FUSION-BONDED EPOXY	-	-	21 13 13	1, 2
FPW	FIRE PROTECTION	BELOW GROUND	DUCTILE IRON - AWWA C151	DUCTILE IRON - AWWA C110	FLANGE - ASME B16.1 - CLASS 125	FUSION-BONDED EPOXY	-	-	21 13 13	1
FPW	FIRE PROTECTION	CHEMICAL AREAS	AUSTENTITIC STAINLESS STEEL - ASTM A312 - GRADE 304, 304L, 316 OR 316L - SCH 40	WROT AUSTENTITIC STAINLESS STEEL - ASTM A403 - GRADE 304, 304L, 316 OR 316L	THREADED - ASME B1.20.1	-	-	-	21 13 13	1
FUD	SUBSOIL DRAIN	ALL	PVC PERFORATED SEWER PIPE - ASTM D2729	PVC - ASTM D2665	TWO-PART SOLVENT CEMENT - ASTM F656 AND D2855	-	-	-	22 13 16	-
HWR	HOT WATER RETURN	ALL	COPPER TUBE - TYPE L - ASTM B88			FUSION-BONDED EPOXY	CELLULAR GLASS - ASTM C 552, TYPE II, CLASS 2	PVC - ASTM C 921, TYPE I	22 11 13	3, 4
HWS	HOT WATER SUPPLY	CHEMICAL AREAS	CPVC - ASTM F441 - SCH 40	CPVC - ASTM F438 - SCH 40	TWO-PART SOLVENT CEMENT - ASTM F493 AND D2846	-	CELLULAR GLASS - ASTM C 552, TYPE II, CLASS 2	PVC -	22 11 13	3, 4
HWS	HOT WATER SUPPLY	NON-CHEMICAL AREAS	COPPER TUBE - TYPE L - ASTM B88	WROT COPPER - ASME B16.22	SOLDER	FUSION-BONDED EPOXY	CELLULAR GLASS - ASTM C 552, TYPE II, CLASS 2	PVC - ASTM C 921, TYPE I	22 11 13	3, 4
NPW	NON-POTABLE WATER	CHEMICAL AREAS	CPVC - ASTM F441 - SCH 40	CPVC - ASTM F438 - SCH 40	TWO-PART SOLVENT CEMENT - ASTM F493 AND D2846	-	CELLULAR GLASS - ASTM C 552, TYPE II, CLASS 2	PVC - ASTM C 921, TYPE I	22 11 13	3, 4
NPW	NON-POTABLE WATER	NON-CHEMICAL AREAS	COPPER TUBE - TYPE L - ASTM B88	WROT COPPER - ASME B16.22	SOLDER	FUSION-BONDED EPOXY	CELLULAR GLASS - ASTM C 552, TYPE II, CLASS 2	PVC - ASTM C 921, TYPE I	22 11 13	3, 4
IPW HW	NON-POTABLE HOT WATER	ALL	COPPER TUBE - TYPE L - ASTM B88	WROT COPPER - ASME B16.22	SOLDER	FUSION-BONDED EPOXY	CELLULAR GLASS - ASTM C 552, TYPE II, CLASS 2	PVC - ASTM C 921, TYPE I	22 11 13	3, 4
PW	POTABLE WATER	ABOVE GROUND (NON-CHEMICAL AREAS)	COPPER TUBE - TYPE L - ASTM B88	WROT COPPER - ASME B16.22	SOLDER	FUSION-BONDED EPOXY	CELLULAR GLASS - ASTM C 552, TYPE II, CLASS 2	PVC - ASTM C 921, TYPE I	22 11 13	3, 4
PW	POTABLE WATER	BELOW GROUND	COPPER TUBE - TYPE K - ASTM B88	WROT COPPER - ASME B16.22	SOLDER	FUSION-BONDED EPOXY	CELLULAR GLASS - ASTM C 552, TYPE II, CLASS 2	PVC - ASTM C 921, TYPE I	22 11 13	3, 4
PW	POTABLE WATER	CHEMICAL AREAS	CPVC - ASTM F441 - SCH 40	CPVC - ASTM F438 - SCH 40	TWO-PART SOLVENT CEMENT - ASTM F493 AND D2846	-	CELLULAR GLASS - ASTM C 552, TYPE II, CLASS 2	PVC - ASTM C 921, TYPE I	22 11 13	3, 4
RWL	STORM DRAINAGE	ABOVE GROUND	PVC - ASTM D2665	PVC - ASTM D2665	TWO-PART SOLVENT CEMENT - ASTM F656 AND D2855	-	FIBERGLASS - ASTM C1393	PVC - ASTM C 921, TYPE I	22 14 13	4, 5
RWL	STORM DRAINAGE	BELOW GROUND AND IN PIPE GALLERY	CAST IRON - XH - ASTM A74	CAST IRON - XH - ASTM A74	POURED LEAD AND OAKUM	OIL-BASED ENAMEL	-	-	22 14 13	-
SAN	SANITARY DRAINAGE	ABOVE GROUND	PVC - ASTM D2665	PVC - ASTM D2665	TWO-PART SOLVENT CEMENT - ASTM F656 AND D2855	-	-	-	22 13 16	-
SAN	SANITARY DRAINAGE	BELOW GROUND AND IN PIPE GALLERY	CAST IRON - XH - ASTM A74	CAST IRON - XH - ASTM A74	POURED LEAD AND OAKUM	OIL-BASED ENAMEL	-	-	22 13 16	-
SAN	SANITARY DRAINAGE	EMBEDDED IN SLAB	CAST IRON - NH - ASTM A888 AND CISPI 301	CAST IRON - NH - ASTM A888 AND CISPI 301	HUBLESS COUPLING - CISPI 301	-	-	-	22 13 16	6
SANP	SUMP PUMP DISCHARGE	ALL	PVC PRESSURE PIPE - ASTM D1784 - SCH 80	PVC PRESSURE FITTINGS - ASTM D2467 - SCH 80	TWO-PART SOLVENT CEMENT - ASTM F656 AND D2855	-	-	-	22 11 13	-
TW	TEPID WATER	ALL	CPVC - ASTM F441 - SCH 40	CPVC - ASTM F438 - SCH 40	TWO-PART SOLVENT CEMENT - ASTM F493 AND D2846	-	-	-	22 11 13	-
V	SANITARY VENT	ABOVE GROUND	PVC - ASTM D2665	PVC - ASTM D2665	TWO-PART SOLVENT CEMENT - ASTM F656 AND D2855	-	-	-	22 13 16	-
V	SANITARY VENT	BELOW GROUND AND IN PIPE GALLERY	CAST IRON - XH - ASTM A74	CAST IRON - XH - ASTM A74	POURED LEAD AND OAKUM	OIL-BASED ENAMEL	-	-	22 13 16	-

- 1. PIPING, FITTINGS AND JOINTS SHALL BE UL LISTED AND FM APPROVED FOR USE AS FIRE SPRINKLER PIPING. SYSTEM SHALL CONFORM TO NFPA 13 AND NFPA 24.
- 2. HOT-DIPPED GALVANIZED CONFORMING TO ASTM A123.
- 3. PIPING, FITTINGS, JOINTS AND BRAZE MATERIALS SHALL BE CERTIFIED TO NSF 61 AND ANNEX G. 4. REFER TO SPECIFICATION 22 07 19 FOR INSULATION AND JACKET REQUIREMENTS.

- 4. REPER TO SPECIFICATION 22 07 19 FOR INSULATION AND JACKET REQUIREMENTS.
 5. INSULATE ALL HORIZONTAL PIPES.
 6. COUPLINGS SHALL BE HEAVY DUTY (CHARLOTTE PIPE PART NO SDC 4 OR EQUIVALENT), AND SHALL BE EXPLICITLY SPECIFIED BY THE MANUFACTURER AS SUITABLE FOR CONCRETE-ENCASEMENT. WRAP ALL COUPLINGS IN POLYETHYLENE SHEET MIN 3" BEYOND COUPLING EDGES. WRAP SHALL BE VIRGIN POLYETHYLENE CONFORMING TO THE REQUIREMENTS OF ASTM D WITH A MINIMUM THICKNESS OF .008" FOR LOW-DENSITY WRAP AND .004" FOR HIGH-DENSITY CROSS-LAMINATED WRAP. VISUALLY INSPECT FOR ANY RIPS OR TEARS AND REPLACE ACCORDINGLY BEFORE THE SLAB IS POURED. REFER TO THE LATEST EDITION OF THE CISPI CAST IRON SOIL PIPE AND FITTINGS HANDBOOK HANDBOOK.

	WATER HEATER SCHEDULE																
TAG	LOCATION	MANUFA	CTURER	TYPE	PW	HW	INPUT	DESIGN FLOW	ELEMENT	ELEMENT	STORAGE	RECOVERY RATE @ 100	STORAGE		POWER		NOTES
		MAKE	MODEL		(IN)	(IN)	(KW)	RATE	(QTY)	(KW)	TEMPERATURE (°F)	DEGREE RISE	(GALLONS)	VOLT	PH	HZ	
								(GPM)				(GPH)					
WH	HVAC ROOM (208)	HUBBELL	SEA120	ELECTRIC	1 1/2"	1 1/2"	18	25	3	6	160	74	120	460	3	60	1-4
DWH	HVAC ROOM (215)	HUBBELL	E40	ELECTRIC	3/4	3/4	4.5	5	2	4.5	160	12	40	208	3	60	1-4

- 1. REFER TO SPECIFICATION 22 33 00 FOR CONSTRUCTION AND ACCESSORY DETAILS
- 2. ALL WATER HEATERS SHALL MEET OR EXCEED STANDBY LOSS REQUIREMENTS PER US DEPT OF ENERGY AND ASHRAE 90.1-2016
- 3. RATED FOR 150 PSIG WORKING PRESSURE
- 4. INSTALL DIELECTRIC UNIONS AND SHUT OFF ISOLATION VALVES AT EACH WATER CONNECTION

WARNING	
S A VIOLATION OF SECTION 7209.2 OF THE NEW YORK STATE EDUCATION LAW FOR	
Y PERSON, UNLESS ACTING UNDER THE DIRECTION OF A LICENSED	
OFESSIONAL ENGINEER, TO ALTER IN ANY WAY PLANS, SPECIFICATIONS, PLATS	
REPORTS TO WHICH THE SEAL OF A PROFESSIONAL ENGINEER HAS BEEN	
PLIED. IF AN ITEM BEARING THE SEAL OF A PROFESSIONAL ENGINEER IS ALTERED,	
E ALTERING ENGINEER SHALL AFFIX TO THE ITEM HIS SEAL AND THE NOTATION	
TERED BY" FOLLOWED BY HIS SIGNATURE, THE DATE, AND A SPECIFIC	
SCRIPTION OF THE ALTERATION.	

		TON OF THE ALTERATION	ID A SPECIFIC				
ı					PROJECT ENGINEER:	R. FROST	
					DESIGNED BY:	M. GIORDANO	
					DRAWN BY:	J. LURIE	BID SET
29 PM					CHECKED BY:	R. VAN DYKE	
25 2:29:29					IF THIS BAR DOES NOT MEASURE 1" THEN DRAWING	0 1/2" 1"	
2/7/2025	REV	ISSUED FOR	DATE	BY	IS NOT TO FULL SCALE		

Hazen HAZEN AND SAWYER 498 SEVENTH AVENUE, 11th FLOOR

NEW YORK, NEW YORK 10018

WESTCHESTER JOINT WATER WORKS MAMARONECK, NY

> RYE LAKE WATER FILTRATION PLANT HARRISON, NY

FILTRATION PLANT **PLUMBING** SCHEDULES - SHEET 2

DATE:	FEB 2025
HAZEN NO.:	90388-000
CONTRACT NO.:	A1364-A
DRAWING NUMBER:	
	P-601


	INSTANTANEOUS WATER HEATER SCHEDULE																
	TAG	LOCATION	MANUFACTURER		TYPE	PW	HW	INPUT	ΔΤ	FLOW		FLOW		РО	WEF	3	NOTES
			MAKE	MODEL		(IN)	(IN)	(KW)	(°F)	(G	PM)	VOLT	PH	HZ			
L										DESIGN	TURN-ON						
	IWH-01	DEWATERING ROOM (109)	EEMAX	AP054480	ELECTRIC	1-1/4	1-1/4	54	18	20	1.5	480	3	60	1		
	IWH-02	POLYER ROOM (107)	EEMAX	AP054480	ELECTRIC	1-1/4	1-1/4	54	18	20	1.5	480	3	60	1, 2		
	IWH-03	PROCESS ANALYSIS ROOM (205)	EEMAX	SPEX3208	ELECTRIC	3/8	3/8	3	41	.5	.25	208	1	60	1, 3		

NOTES:


- 1. REFER TO SPECIFICATION 22 33 00 FOR CONSTRUCTION AND ACCESSORY DETAILS
- 2. FOR FUTURE USE. DO NOT CONNECT WATERSIDE CONNECTIONS. 3. COORDINATE WITH ARCHITECT FOR INSTALLATION IN CASEWORK.

	STORAGE TANK SCHEDULE									
TAG	LOCATION	MANUFA MAKE	CTURER MODEL	CAPACITY (GAL)	LINING MATERIAL	INSULATION	WEIGHT (LBS)	NOTES		
ST	HVAC ROOM (208)	HUBBELL	SH120SL	120	HYDRASTONE CEMENT	2" POLYURETHANE FOAM	900	1-3		


- 1. REFER TO SPECIFICATION 22 33 00 FOR CONSTRUCTION AND ACCESSORY DETAILS
- 2. MAXIMUM PRESSURE 150 PSI
- 3. TANK MATERIAL SHALL BE CARBON STEEL

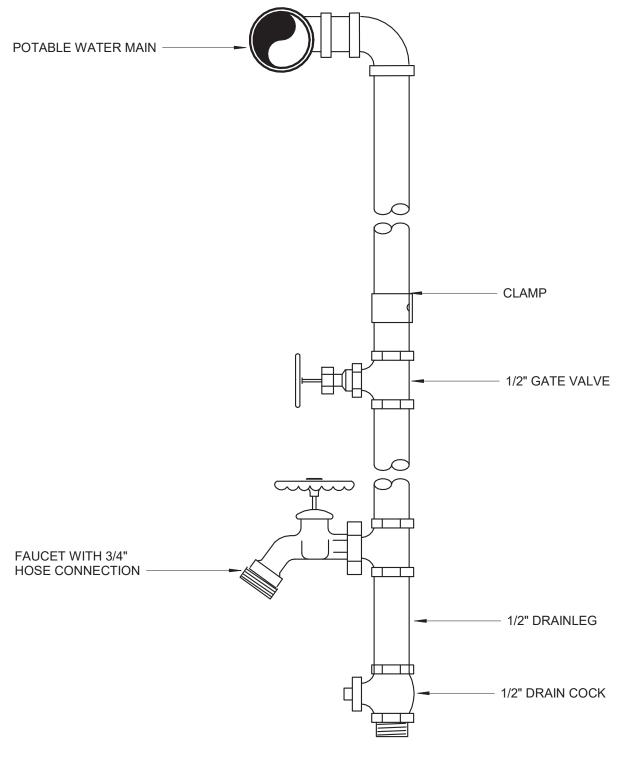


TYPICAL WATER DROP P-22-0304

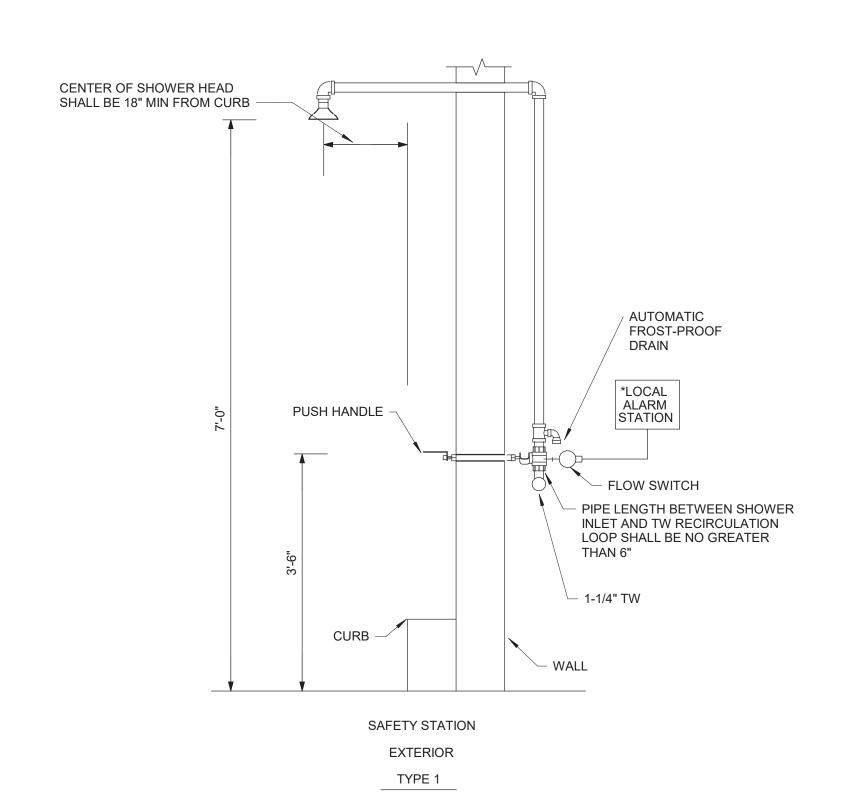



EMERGENCY DRENCH SHOWER P-22-0402

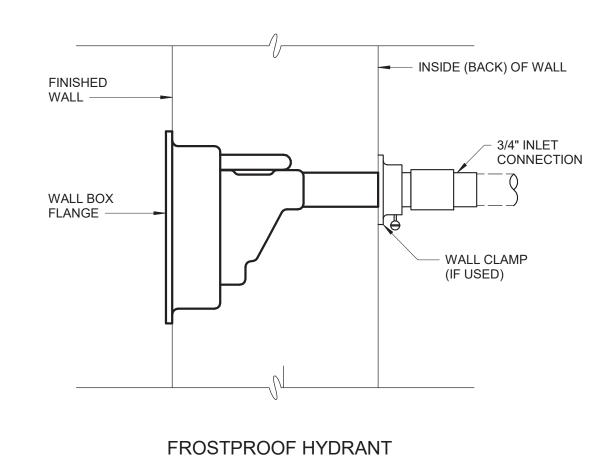


P-22-0302

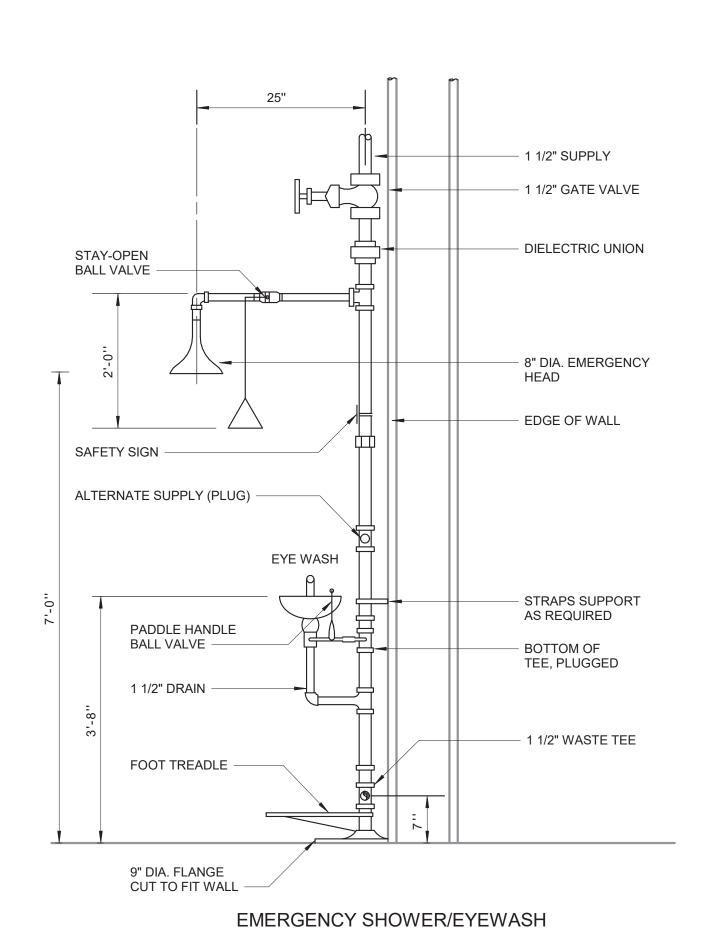

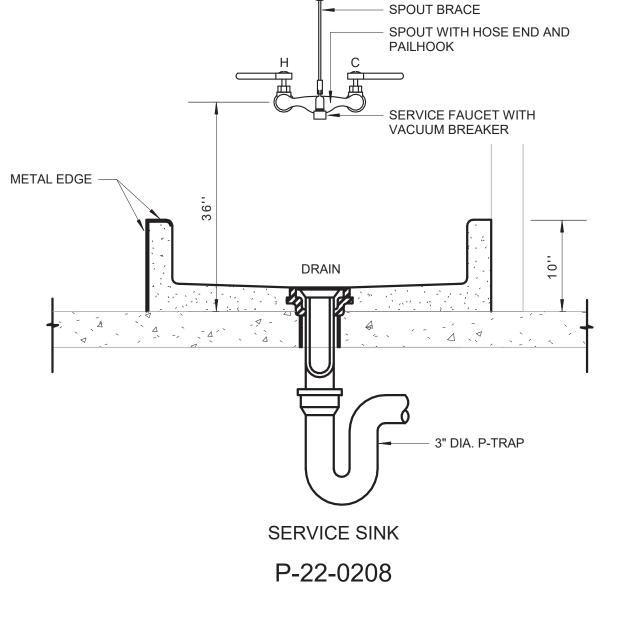

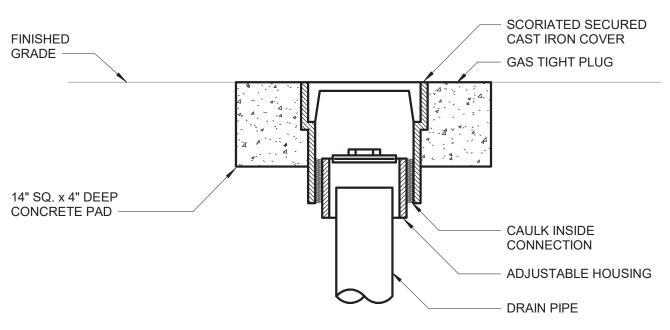

CLEANOUT TO GRADE P-22-0203

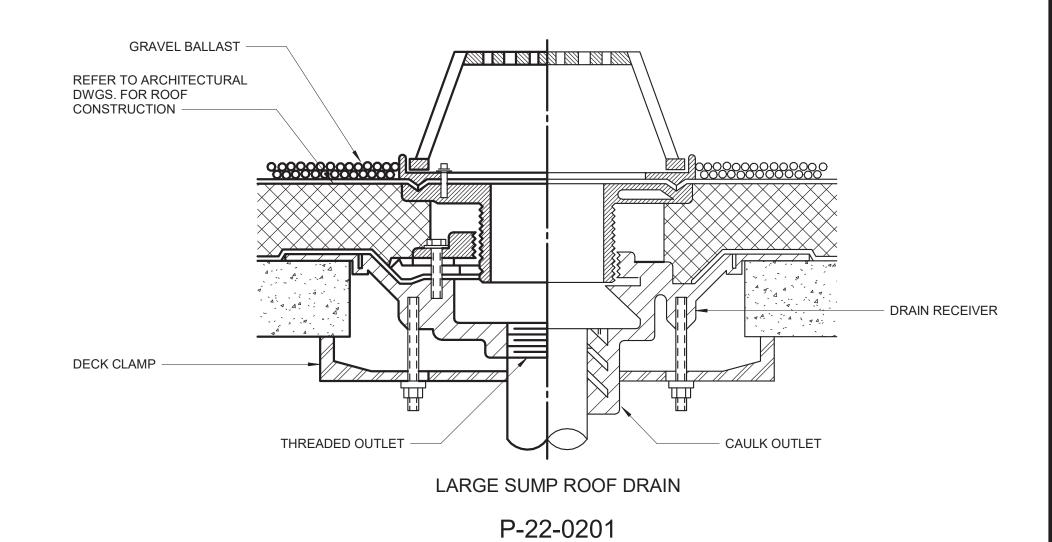

$D \sim 2$	2-040
/	-U4U

	ANY PERS PROFESS OR REPOR APPLIED. THE ALTE "ALTERED	WARNING DLATION OF SECTION 7209.2 OF THE NEW YORK STA SON, UNLESS ACTING UNDER THE DIRECTION OF A SIONAL ENGINEER, TO ALTER IN ANY WAY PLANS, S RTS TO WHICH THE SEAL OF A PROFESSIONAL ENG IF AN ITEM BEARING THE SEAL OF A PROFESSIONAL SIRING ENGINEER SHALL AFFIX TO THE ITEM HIS SEA D BY" FOLLOWED BY HIS SIGNATURE, THE DATE, AN TION OF THE ALTERATION.	LICENSED PECIFICATIONS, GINEER HAS BEE AL ENGINEER IS A AL AND THE NOT	PLATS EN ALTERED,	EMERGENCY DRENCH SHOWER P-22-0402				
					PROJECT ENGINEER:	R. FROST			
					DESIGNED BY:	M. GIORDANO			
					DRAWN BY:	J. LURIE	BID SET		
2:29:30 PM					CHECKED BY:	R. VAN DYKE	5.5 02.		
					IF THIS BAR DOES NOT MEASURE 1" THEN DRAWING	0 1/2" 1"			
/7/2025	REV	ISSUED FOR	DATE	BY	IS NOT TO FULL SCALE				




Hazen HAZEN AND SAWYER 498 SEVENTH AVENUE, 11th FLOOR NEW YORK, NEW YORK 10018

WESTCHESTER JOINT WATER WORKS MAMARONECK, NY

RYE LAKE WATER FILTRATION PLANT HARRISON, NY

FILTRATION PLANT **PLUMBING** DETAILS - SHEET 1

DATE:	FEB 2025
HAZEN NO.:	90388-000
CONTRACT NO.:	A1364-A
DRAWING NUMBER:	
	P-602

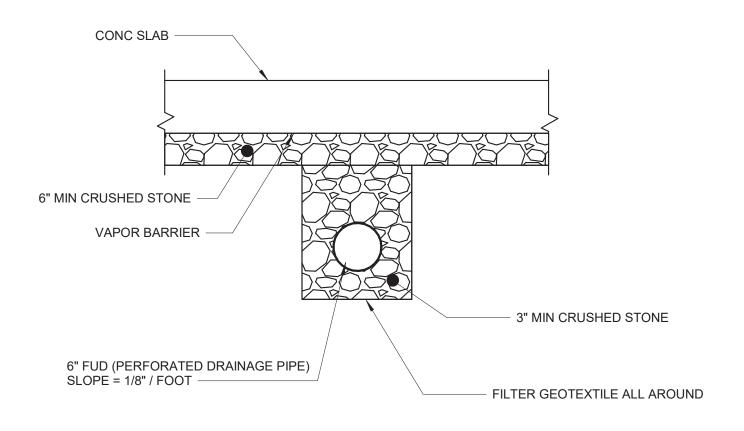


NOTES:

- 1. SEE PIPING SCHEDULE ON P-601 FOR PIPE, FITTING AND JOINT MATERIAL
- AND SPECIFICATIONS.
 2. SEE P-100 FOR ROUTING.
- 3. SEE CIVIL DRAWINGS FOR MANHOLE CONNECTION.

SUB-SLAB PERFORATED DRAINAGE PIPE INSTALLATION



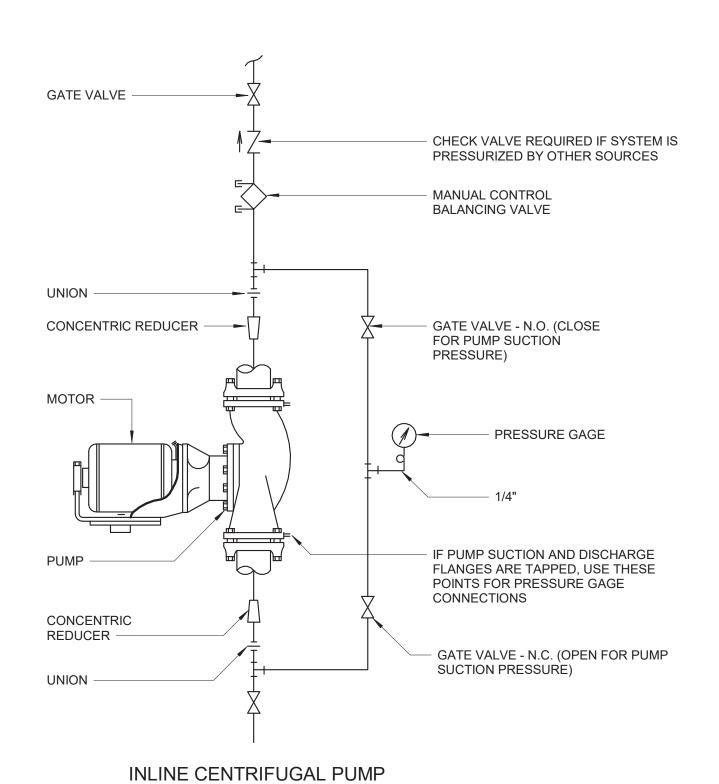

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PROFESSIONAL ENGINEER, TO ALTER IN ANY WAY PLANS, SPECIFICATIONS, PLATS OR REPORTS TO WHICH THE SEAL OF A PROFESSIONAL ENGINEER HAS BEEN

P-22-0218

OR REPORTS TO WHICH THE SEAL OF A PROFESSIONAL ENGINEER HAS BEEN APPLIED. IF AN ITEM BEARING THE SEAL OF A PROFESSIONAL ENGINEER IS ALTERED, THE ALTERING ENGINEER SHALL AFFIX TO THE ITEM HIS SEAL AND THE NOTATION "ALTERED BY" FOLLOWED BY HIS SIGNATURE, THE DATE, AND A SPECIFIC DESCRIPTION OF THE ALTERATION. PROJECT ENGINEER: R. FROST M. GIORDANO DESIGNED BY: J. LURIE DRAWN BY: **BID SET** R. VAN DYKE CHECKED BY: IF THIS BAR DOES NOT 0 1/2" MEASURE 1" THEN DRAWING IS NOT TO FULL SCALE ISSUED FOR DATE BY

Hazen HAZEN AND SAWYER 498 SEVENTH AVENUE, 11th FLOOR NEW YORK, NEW YORK 10018


WESTCHESTER JOINT WATER WORKS MAMARONECK, NY

> RYE LAKE WATER FILTRATION PLANT HARRISON, NY

FILTRATION PLANT **PLUMBING**

FEB 2025 90388-000 HAZEN NO. CONTRACT NO.: A1364-A DRAWING NUMBER:

DATE:

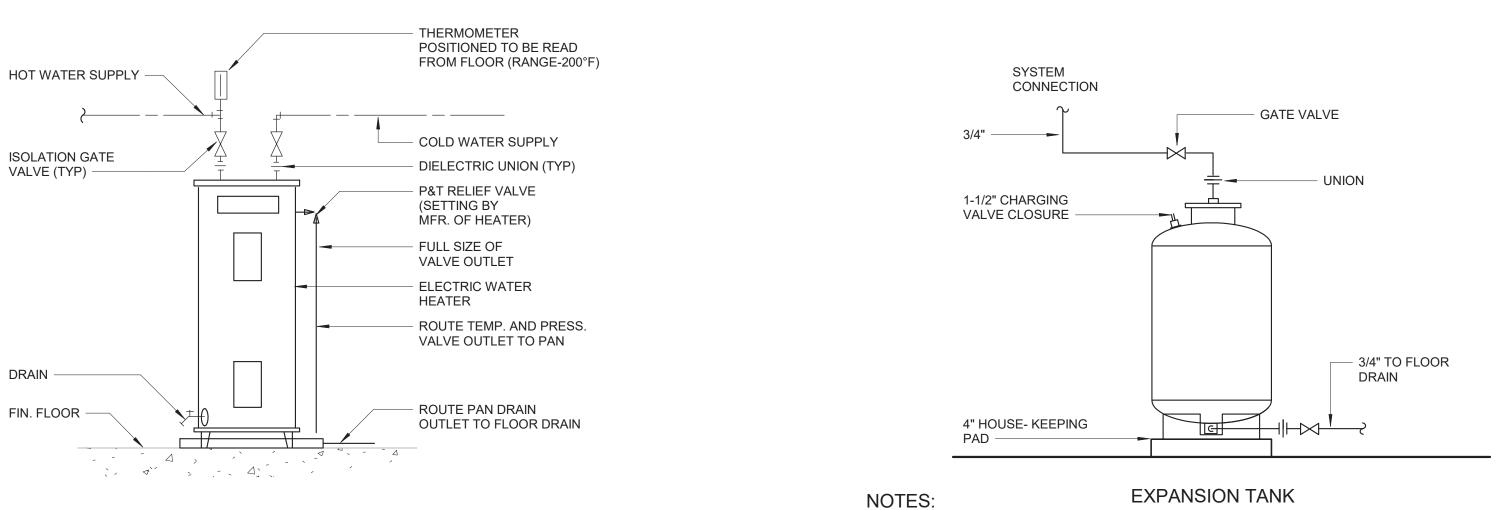

ELECTRIC WATER HEATER

P-22-0404

PUMP POWER SUPPLY -CONTROL AND ALARM ALARM LIGHT POWER SUPPLY (SINGLE PHASE ONLY) INDICATOR LAMPS (INSIDE ENCLOSURE) NEMA 4X ENCLOSURE DISCONNECT, TYP HOA SWITCHES (INSIDE ENCLOSURE) VENT RISER - SEE PLANS FOR SIZING 3" DISCHARGE PIPE, TYP -CHECK VALVE, TYP -FIBERGLASS OR POLYETHYLENE BASIN - WASTE INLET - SEE PLANS FOR SIZING MINIMUM "OFF" LEVEL 5" ABOVE PUMP -SEWAGE PUMP FLOAT SWITCH, TYP

TANK VOLUME - 22 GAL. ACCEPTANCE VOL. - 12 GAL.

P-22-0903

NOTES: 1. THREE PHASSE PANELS SHALL HAVE A TRANSFORMER WITH

SECONDARY FUSING.

2. ALARM-CONTROL CIRCUIT SHALL BE SEPERATE FROM PUMP POWER (SINGLE PHASE ONLY).

DUPLEX SUMP PUMP

P-22-0913

