

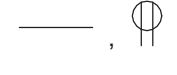


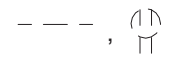









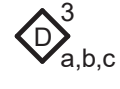




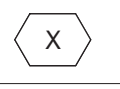











GENERAL NOTES	
(APPLY TO ALL DRAWINGS):	
A.	PROVIDE ALL LABOR, MATERIALS, EQUIPMENT AND SERVICES TO PERFORM ALL OPERATIONS REQUIRED FOR THE COMPLETE INSTALLATION AND RELATED WORK AS SHOWN ON THE DRAWINGS AND AS SPECIFIED HEREIN. ELECTRIC EQUIPMENT SHALL BE INSTALLED IN A NEAT AND WORKMANLIKE MANNER.
B.	PROVIDE ALL ELECTRICAL EQUIPMENT CONNECTIONS.
C.	PROVIDE ALL REQUIRED SUPPORTS AND ACCESSORIES.
D.	PROVIDE ALL WORK IN COMPLIANCE WITH THE NATIONAL ELECTRICAL CODE (NEC) AND THE LATEST EDITION OF THE: 1. BUILDING CODE OF NEW YORK STATE 2. ENERGY CONSERVATION CONSTRUCTION CODE OF NEW YORK STATE 3. OSHA REQUIREMENTS 4. LOCAL MUNICIPAL ORDINANCES AND CODES 5. AUTHORITY HAVING JURISDICTION (AHJ) 6. SERVING UTILITY COMPANIES
E.	PROVIDE ELECTRICAL INSPECTION CERTIFICATE FROM INSPECTION AGENCY RECOGNIZED AS ACCEPTABLE FROM THE AHJ.
F.	ALL RECEPTACLES INDICATED AS GFI TYPE MUST BE A GFI RECEPTACLE. CONNECTING NORMAL RECEPTACLES DOWNSTREAM OF ONE GFI RECEPTACLE IS NOT ACCEPTABLE. PROVIDE TEMPORARY ELECTRICAL SERVICE IN SIZES TO ACCOMMODATE CONSTRUCTION WHERE REQUIRED.
G.	REPAIR OR REPLACE ALL DEFECTS IN MATERIAL OR WORKMANSHIP WITHIN ONE YEAR OF CONSTRUCTION CLOSE OUT DATE AT NO ADDITIONAL COST TO THE OWNER.
H.	PERFORM ALL OPERATIONS REQUIRED FOR A COMPLETE SYSTEM TEST. PRIOR TO CLOSE OUT DATE SUBMIT ALL SATISFACTORY SYSTEM TEST RESULTS FOR RECORD.
J.	SUBMITTALS: 1. ALL ITEMS OF EQUIPMENT AND MATERIALS PROVIDED SHALL BE SUBMITTED FOR ENGINEERING REVIEW. 2. SUBMIT A MINIMUM OF THREE COPIES OF SHOP DRAWINGS/PRODUCT DATA INFORMATION.
K.	CONTRACTOR IS HERE BY CAUTIONED THAT ELECTRIC POWER CHARACTERISTICS (VOLTAGE, PHASE, HORSEPOWER, AMPERAGE, ETC.) OF EQUIPMENT IS BASED ON AVAILABLE INFORMATION AT THE TIME OF PROJECT DESIGN. CONTRACTOR MUST VERIFY CHARACTERISTICS FOR EACH PIECE OF NEW EQUIPMENT PRIOR TO ORDERING ELECTRICAL EQUIPMENT. INDICATE VERIFICATION ON SUBMITTALS.
L.	LOCATIONS INDICATED FOR LIGHTING FIXTURES ARE APPROXIMATE. LOCATE FIXTURES AS REQUIRED TO AVOID INTERFERENCE WITH BUILDING STEEL, PIPING, DUCTWORK, CONDUIT, DIFFUSERS, GRILLES, SPEAKERS, SMOKE DETECTORS, ETC. FIELD COORDINATE EXACT LOCATIONS AS NEAR AS POSSIBLE TO THE LOCATION INDICATED. VERIFY COMPLIANCE WITH NEC ARTICLE 410.16 FOR INSTALLATION OF LIGHT FIXTURES IN CLOTHES CLOSETS. PRIOR TO ROUGH-IN, REFER TO ARCHITECTURAL REFLECTED CEILING PLANS.
M.	EXACT LOCATIONS OF CEILING MOUNTED SMOKE DETECTORS, EXIT SIGNS, ETC. SHALL BE COORDINATED WITH OTHER CEILING MOUNTED EQUIPMENT TO AVOID CONFLICT. LOCATE DEVICES AS NEAR AS POSSIBLE TO THE LOCATION INDICATED. FIRE ALARM SMOKE AND HEAT DETECTORS SHALL BE LOCATED 3'-0" MINIMUM FROM HVAC DIFFUSERS, REGISTERS, GRILLES, ETC. SMOKE DETECTORS AT SMOKE DOORS MUST BE INSTALLED WITHIN 5'-0" OF THE DOORS (REFER TO NFPA 72).
N.	ALL NEW CIRCUITING SHALL BE CONCEALED (EXCEPT IN UNFINISHED SPACES). PROVIDE ALL CUTTING AND PATCHING AS REQUIRED.
O.	CONTRACTOR SHALL REVIEW ALL TRADES' CONTRACT DOCUMENTS TO DETERMINE SPECIFIC MOUNTING LOCATIONS FOR ELECTRICAL EQUIPMENT. COORDINATE EXACT MOUNTING LOCATIONS WITH THE ARCHITECT AND OTHER CONTRACTORS. REFER TO ARCHITECTURAL PLANS FOR CASEWORK LAYOUT, ELEVATIONS, ETC. COORDINATE WITH LOCATIONS OF ELECTRICAL DEVICES AND OUTLETS
P.	EXACT LOCATION OF MECHANICAL AND PLUMBING EQUIPMENT THAT REQUIRE ELECTRICAL CONNECTIONS ARE SHOWN ON THE MECHANICAL AND PLUMBING DRAWINGS.
Q.	PROVIDE CONDUIT/WIRING (CIRCUITING) AND REQUIRED CONNECTIONS TO ALL DEVICES/ EQUIPMENT. CONNECT TO CIRCUIT(S) AS INDICATED.
R.	COORDINATE ALL WORK WITH OTHER TRADES; REFER TO ARCHITECTURAL DRAWINGS FOR COORDINATING LOCATIONS.
S.	RE-INSTALL REMOVED SYSTEM DEVICES REMOVED AS A RESULT IN WALL, PARTITION OR CEILING REPLACEMENT WORK. PROVIDE POWER AND COMMUNICATION WALL AND PARTITION MOUNTED DEVICES AND RECONNECT TO EXISTING SYSTEMS. CLEAN EXISTING CEILING MOUNTED DEVICES. EXTEND EXISTING SYSTEM CIRCUITS AS REQUIRED FOR REINSTALLATION. COORDINATE WITH EXISTING SYSTEM MANUFACTURER.
T.	SLEEVE AND SEAL ALL WALL AND FLOOR PENETRATIONS. PROVIDE APPROPRIATE FIRE STOPPING FOR ALL PENETRATIONS.
U.	SHARED NEUTRAL SHALL NOT BE ALLOWED ON ANY BRANCH CIRCUITS. MAINTAIN SERVICE CLEARANCES OF ALL EQUIPMENT. ADVISE OTHER TRADES OF SERVICE CLEARANCES AND ENSURE NO SERVICES OR TRADES RUN THROUGH SERVICE AREA.
V.	ALL WIRING INDICATED ON PLANS IS TO BE COPPER WIRING UNLESS OTHERWISE NOTED.
W.	REFER TO ONE-LINE DIAGRAM. RATINGS TO MATCH THE RATING OF THE WALL/CEILING. UTILIZE FIRE RATED PUDDY PADS IN THESE LOCATIONS.
X.	REFER TO ARCHITECTURAL DRAWINGS FOR MOUNTING OF RECEPTACLES IN AND NEAR ALL MILLWORK AND CABINERY.
Y.	THE CONTRACTOR MUST FOLLOW FEDERAL AND STATE ELECTRICAL SAFETY PRACTICE INCLUDING LOCK OUT TAG OUT (LOTO). THE CONTRACTOR MUST AFFIX THEIR COMPANY'S INDIVIDUAL LOTO LOCKS AND TAGS TO CONTROL HAZARDOUS ENERGIES AND TO PREVENT INJURIES.
Z.	PROVIDE SURFACE MOUNTED BOXES AND SURFACE METAL RACEWAY FOR ALL DEVICES INDICATED TO BE INSTALLED ON EXISTING WALLS, UNLESS OTHERWISE NOTED; COLOR TO MATCH EXISTING WALL.
AA.	PROVIDE RECESSED BOXES AND RACEWAYS FOR ALL DEVICES INDICATED TO BE INSTALLED ON NEW WALLS, UNLESS OTHERWISE NOTED.









ABBREVIATIONS	
ABBREV.	DESCRIPTION
A	AMPERE
AC	MOUNTED ABOVE COUNTER HEIGHT
AFB	ABOVE FINISHED FLOOR
AFG	ABOVE FINISHED GRADE
AIC	AMPERE INTERRUPTING CURRENT
AL	ALUMINUM
ASD	ADJUSTABLE SPEED DRIVE
ATS	AUTOMATIC TRANSFER SWITCH
AV	AUDIO VISUAL
AWG	AMERICAN WIRE GAUGE
C	CONDUIT
CU	COPPER
EC	ELECTRICAL CONTRACTOR/TRADE
FACP	FIRE ALARM CONTROL PANEL
G	GROUND
GC	GENERAL CONTRACTOR/TRADE
GEN	GENERATOR
GFCI/GFI	GROUND FAULT CIRCUIT INTERRUPTER
HH	HAND HOLE
HP	HORSE POWER
HVAC	HEATING, VENTILATION & AIR CONDITIONING CONTRACTOR/TRADE
JB	JUNCTION BOX
KV	KILOVOLT
KVA	KILOVOLT AMPERES
KW	KILOWATT
LED	LIGHT EMITTING DIODE
MCB	MAIN CIRCUIT BREAKER
MLO	MAIN LUG ONLY
MTS	MANUAL TRANSFER SWITCH
NA	NOT APPLICABLE
NC	NORMALLY CLOSED
NEC	NATIONAL ELECTRIC CODE
NIC	NOT IN CONTRACT
NL	NIGHT LIGHT
NTS	NOT TO SCALE
P	POLE
SMR	SURFACE METAL RACEWAY
SPEC	SPECIFICATION
TYP	TYPICAL
UC	MOUNTED UNDER COUNTER HEIGHT
UL	UNDERWRITER'S LABORATORY
V	VOLT
W	WIRE/WATT
WP	WEATHERPROOF








BASIC MATERIALS AND METHODS	
(E)	EXISTING TO REMAIN - INDICATES EXISTING ITEM SHALL REMAIN. MAINTAIN EXISTING ELECTRICAL CONNECTIONS UNLESS OTHERWISE NOTED.
(ER)	EXISTING TO BE RELOCATED - INDICATES EXISTING ITEM SHALL BE RELOCATED. DISCONNECT AND REMOVE, REINSTALL AT NEW LOCATION AND RECONNECT ITEM AS REQUIRED.
 , 	EXISTING ELECTRICAL WIRING, EQUIPMENT OR DEVICE, DASHED LIGHT IS EXISTING TO BE REMOVED OR RELOCATED
 , 	EXISTING ELECTRICAL WIRING, EQUIPMENT OR DEVICE. SOLID LIGHT IS EXISTING TO REMAIN
 , 	HEAVY SOLID IS NEW
	REFERENCE TO DRAWING NOTE
	KITCHEN EQUIPMENT TAG
	JUNCTION BOX
	SPECIAL PURPOSE RECEPTACLE. PROVIDE PROPER VOLTAGE, CLASS, CURRENT RATING AND NEMA CONFIGURATION AS REQUIRED BY BRANCH CIRCUIT AND/OR MATCH CAP ON EQUIPMENT BEING FURNISHED BY OTHERS. PROVIDE CORD AND CAP.
	DUPLEX RECEPTACLE, 20 AMP, 125 VOLT SUBSCRIPTS INDICATE TYPE: AC - ABOVE THE COUNTER UC - UNDER THE COUNTER WP - WEATHER PROOF G - GROUND FAULT INTERRUPTER T - TAMPER RESISTANT
	QUAD RECEPTACLE 20 AMP, 125 VOLT
	TOGGLE SWITCH, VOLTAGE AS INDICATED ON FIXTURE SCHEDULE. SUBSCRIPTS INDICATE TYPE: 3 - THREE WAY SWITCH 4 - FOUR WAY SWITCH K - KEYED SWITCH LV - LOW VOLTAGE, MOMENTARY CONTACT OS - OCCUPANCY SENSOR VS - VACANCY SENSOR a,b,c - SWITCHING DESIGNATIONS NUMBER OF LETTERS EQUALS NO. OF GANGED SWITCHES
	CEILING MOUNTED VACANCY SENSOR
	CEILING MOUNTED OCCUPANCY SENSOR
	DIMMER SWITCH, SUBSCRIPTS INDICATE TYPE: 3 - THREE WAY DIMMER SWITCH a,b,c - SWITCHING DESIGNATIONS NUMBER OF LETTERS EQUALS NO. OF GANGED SWITCHES
	GENERATOR EMERGENCY POWER OFF BUTTON
	TIME CLOCK




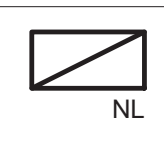



FIRE ALARM	
	SMOKE DETECTOR
	MANUAL PULL STATION
	WALL MOUNTED COMBINATION HORN AND STROBE # INDICATES STROBE CANDELA
	WALL MOUNTED STROBE ONLY # INDICATES STROBE CANDELA
	COMBINATION SET TEMPERATURE AND RATE OF RISE HEAT DETECTOR
	FIRE ALARM CONTROL PANEL
	FIRE ALARM ANNUNCIATION PANEL

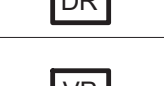POWER DISTRIBUTION AND CONTROL	
	208Y/120 VOLT PANELBOARD.
	EQUIPMENT CONNECTION. REFER TO ELECTRIC EQUIPMENT AND CONTROL SCHEDULE FOR DESCRIPTION. LETTERS AND NUMBERS INDICATE 'ITEM DESIGNATION' ON THE SCHEDULE.
	SINGLE POINT CONNECTION TO EQUIPMENT. SEE DRAWING NOTES FOR REQUIREMENTS. SUBSCRIPT INDICATES ASSOCIATED EQUIPMENT/DEVICE: C - COOK TOP H - RANGE HOOD
	AUTOMATIC TRANSFER SWITCH

GROUNDING	
SYMBOL	DESCRIPTION
	EQUIPMENT GROUND BUSBAR

ONE LINE DIAGRAM SYMBOLS	
	THERMAL MAGNETIC MOLDED CASE CIRCUIT BREAKER
	TRANSFORMER, SIZE AND TYPE AS INDICATED
	GROUND CONNECTION
	FEEDER DESIGNATION, REFER TO FEEDER SCHEDULE
	GENERATOR
	PANELBOARD SYMBOL
	PANEL NAME #0 - A, MLO #0 - A, MLO
	SOLID STATE TRIP BREAKER

SYSTEMS	
	COMBINATION POWER AND TELE/DATA OUTLETS; REFER TO TYPICAL POWER AND TELE/DATA OUTLET DETAIL. SUBSCRIPT INDICATES QUANTITY: #P=QUANTITY OF DUPLEX RECEPTACLES #D=QUANTITY OF DATA PORTS/CABLES. IF NO QUANTITY IS INDICATED, PROVIDE (2).
	FLOOR BOX. SUBSCRIPT INDICATES DEVICES: #P - NUMBER OF DUPLEX RECEPTACLES #D - NUMBER OF DATA BACKBOXES & (1)1" CONDUIT WITH PULLSTRING TO ABOVE ACCESSIBLE CEILING
	TELEVISION OUTLET; PROVIDE (1)DUPLEX RECEPTACLE & (1)EMPTY BACKBOX WITH (1)1" CONDUIT WITH PULLSTRING TO ABOVE ACCESSIBLE CEILING.
	WIRELESS ACCESS POINT. PROVIDE (1) CAT6 CABLE FROM IT ROOM. (ACCESS POINT PROVIDED BY OTHERS).
	DATA RACK.
	VIDEO PROJECTOR (MOUNT AND PROJECTOR PROVIDED BY OTHERS). PROVIDE (1) FLUSH MOUNTED DUPLEX RECEPTACLE & (1) DATA BACKBOX WITH (1)1" CONDUIT AND PULLSTRING TO ABOVE ACCESSIBLE CEILING.
	FLUSH FLOOR POKE THROUGH; SUBSCRIPT INDICATES DEVICES: #P - NUMBER OF DUPLEX RECEPTACLES #D - NUMBER OF DATA BACKBOXES & (1)1" CONDUIT WITH PULLSTRING TO ABOVE ACCESSIBLE CEILING

LUMINAIRES	
	CEILING MOUNTED LUMINAIRE. UPPERCASE LETTERS INDICATE FIXTURE TYPE ON LUMINAIRE SCHEDULE. LOWER CASE LETTER INDICATE LIGHTING ZONE.
	WALL MOUNTED LUMINAIRE. UPPERCASE LETTERS INDICATE FIXTURE TYPE ON LUMINAIRE SCHEDULE. LOWER CASE LETTERS INDICATE LIGHTING ZONE.
	SITE LIGHT. UPPERCASE LETTERS INDICATE FIXTURE TYPE ON LUMINAIRE SCHEDULE.
	LUMINAIRE PROVIDED WITH INTEGRAL 90-MINUTE BATTERY BACKUP. SUBSCRIPT INDICATES TYPE: NL - EMERGENCY LUMINAIRE ILLUMINATED AT ALL TIMES AND NOT CONTROLLED.
	WALL MOUNTED EMERGENCY LUMINAIRE WITH BATTERY PACK
	CEILING MOUNTED EXIT LUMINAIRE
	WALL MOUNTED EXIT LUMINAIRE

GENERAL FIRE ALARM NOTES	
(APPLY TO ALL DRAWINGS):	
A.	THE CONTRACTOR SHALL PROVIDE A COMPLETE TEST OF THE EXISTING SYSTEM PRIOR TO MAKING MODIFICATIONS TO ASSESS THE CONDITION AND CAPABILITY OF DEVICES AND CIRCUITS TO BE REUSED. WHERE POSSIBLE, THE CONTRACTOR SHALL HAVE THE OPTION TO REUSE EXISTING DEVICES, BOXES AND WIRING.
B.	IN GENERAL, EXISTING INITIATION AND NOTIFICATION APPLIANCE CIRCUITS SHALL BE RETAINED AND EXTENDED TO THE NEW CONTROL PANEL FOR DEVICES IN AREAS UNAFFECTED BY THE SCOPE OF WORK. NEW DEVICES SHALL BE TIED INTO EXISTING CIRCUITS, OR NEW CIRCUITS SHALL BE PROVIDED AS REQUIRED TO PROVIDE A COMPLETE SYSTEM AS INDICATED.
C.	ALL WIRING SHALL BE COPPER, INSTALLED IN A DEDICATED/SEGREGATED EMT CONDUIT SYSTEM AND SHALL CONFORM TO THE NEC AND TO NFPA-72, NATIONAL FIRE ALARM CODE. INSTALL IN ACCORDANCE WITH THE MANUFACTURER'S RECOMMENDATIONS.
D.	THE COMPLETE FIRE ALARM SYSTEM SHALL BE FULLY TESTED AFTER THE WORK IS COMPLETE. TESTING SHALL INCLUDE ALL DEVICES, CONTROL PANEL, ANNUNCIATOR PANEL, OTHER PANELS, FEATURES AND FUNCTIONS. TESTING SHALL BE WITNESSED BY THE OWNER'S REPRESENTATIVE AND BE IN ACCORDANCE WITH THE NFPA. PROVIDE A TESTING REPORT TO THE AHJ AND THE ENGINEER AS A SUBMITTAL. REFER TO SPECIFICATION SECTION 283103.



Mechanical/Electrical Engineering Consultants

Capital District | Rochester | Buffalo | Syracuse



433 STATE STREET, 4TH FLOOR
SCHENECTADY, NY 12305

518.533.2171
www.meengineering.com

REVISIONS:

NUM.	DATE	DESCRIPTION

100% BID DOCUMENTS

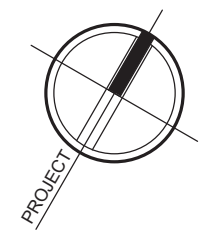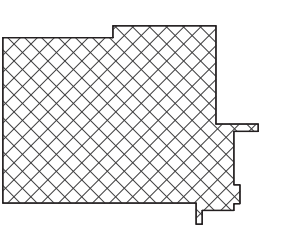	
KEY PLAN	
ADG ARCHITECTS	
ARCHITECTURE • PLANNING • INTERIORS	

Project: TOWN OF MONTGOMERY POLICE STATION
110 BRACKEN ROAD, MONTGOMERY,
NEW YORK 12549

Drawing: ELECTRICAL LEGEND &
ABBREVIATIONS



Project: 23138 Date: 02/24/25

Drawn: KML Scale: AS NOTED

Drawing Number:

E-001

⊗

-

①



Capital District | Rochester | Buffalo | Syracuse



433 STATE STREET, 4TH FLOOR
SCHENECTADY, NY 12305

www.meengineering.com

NUM.	DATE	DESCRIPTION

100%

BID DOCUMENTS

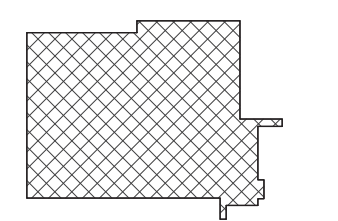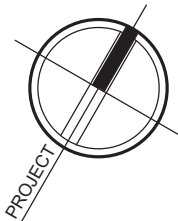

WORK
AREA


A D G ARCHITECTS

25 WALLKILL AVE • MONTGOMERY • NY 12549
O. 845.294.2724 | F. 888.305.6442
WWW.ADGARCHITECT.COM
CONTACT@ADGARCHITECT.COM

ARCHITECTURE • PLANNING • INTERIORS

Project: **TOWN OF MONTGOMERY POLICE STATION**
110 BRACKEN ROAD, MONTGOMERY,
NEW YORK 12549

Drawing: ELECTRICAL SITE PLAN

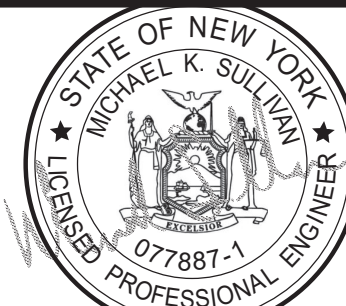

Reg. Exp: 05/31/2027
Cert. of Auth: 0018443

Project: 23138	Date: 02/24/25
Drawn: KML	Scale: AS NOTED
Drawing Number:	


E-002

GENERAL NOTES:

- A. ALL CIRCUITING SHALL BE A MINIMUM OF (2)#12 & (1)#12G IN 3/4" CONDUIT, UNLESS OTHERWISE NOTED.
- B. CIRCUIT ALL EQUIPMENT AND DEVICES TO PANEL "P1" UNLESS OTHERWISE NOTED.

E-101 DRAWING NOTES

1. PROVIDE SINGLE GANG BACKBOX FOR 911 PHONE. ROUTE (1) 1" CONDUIT WITH PULL STRING UNDER SLAB TO JUNCTION BOX IN DISPATCH 105.
2. PROVIDE (1)120V 20A CIRCUIT TO INTERVIEW IN USE LIGHT.

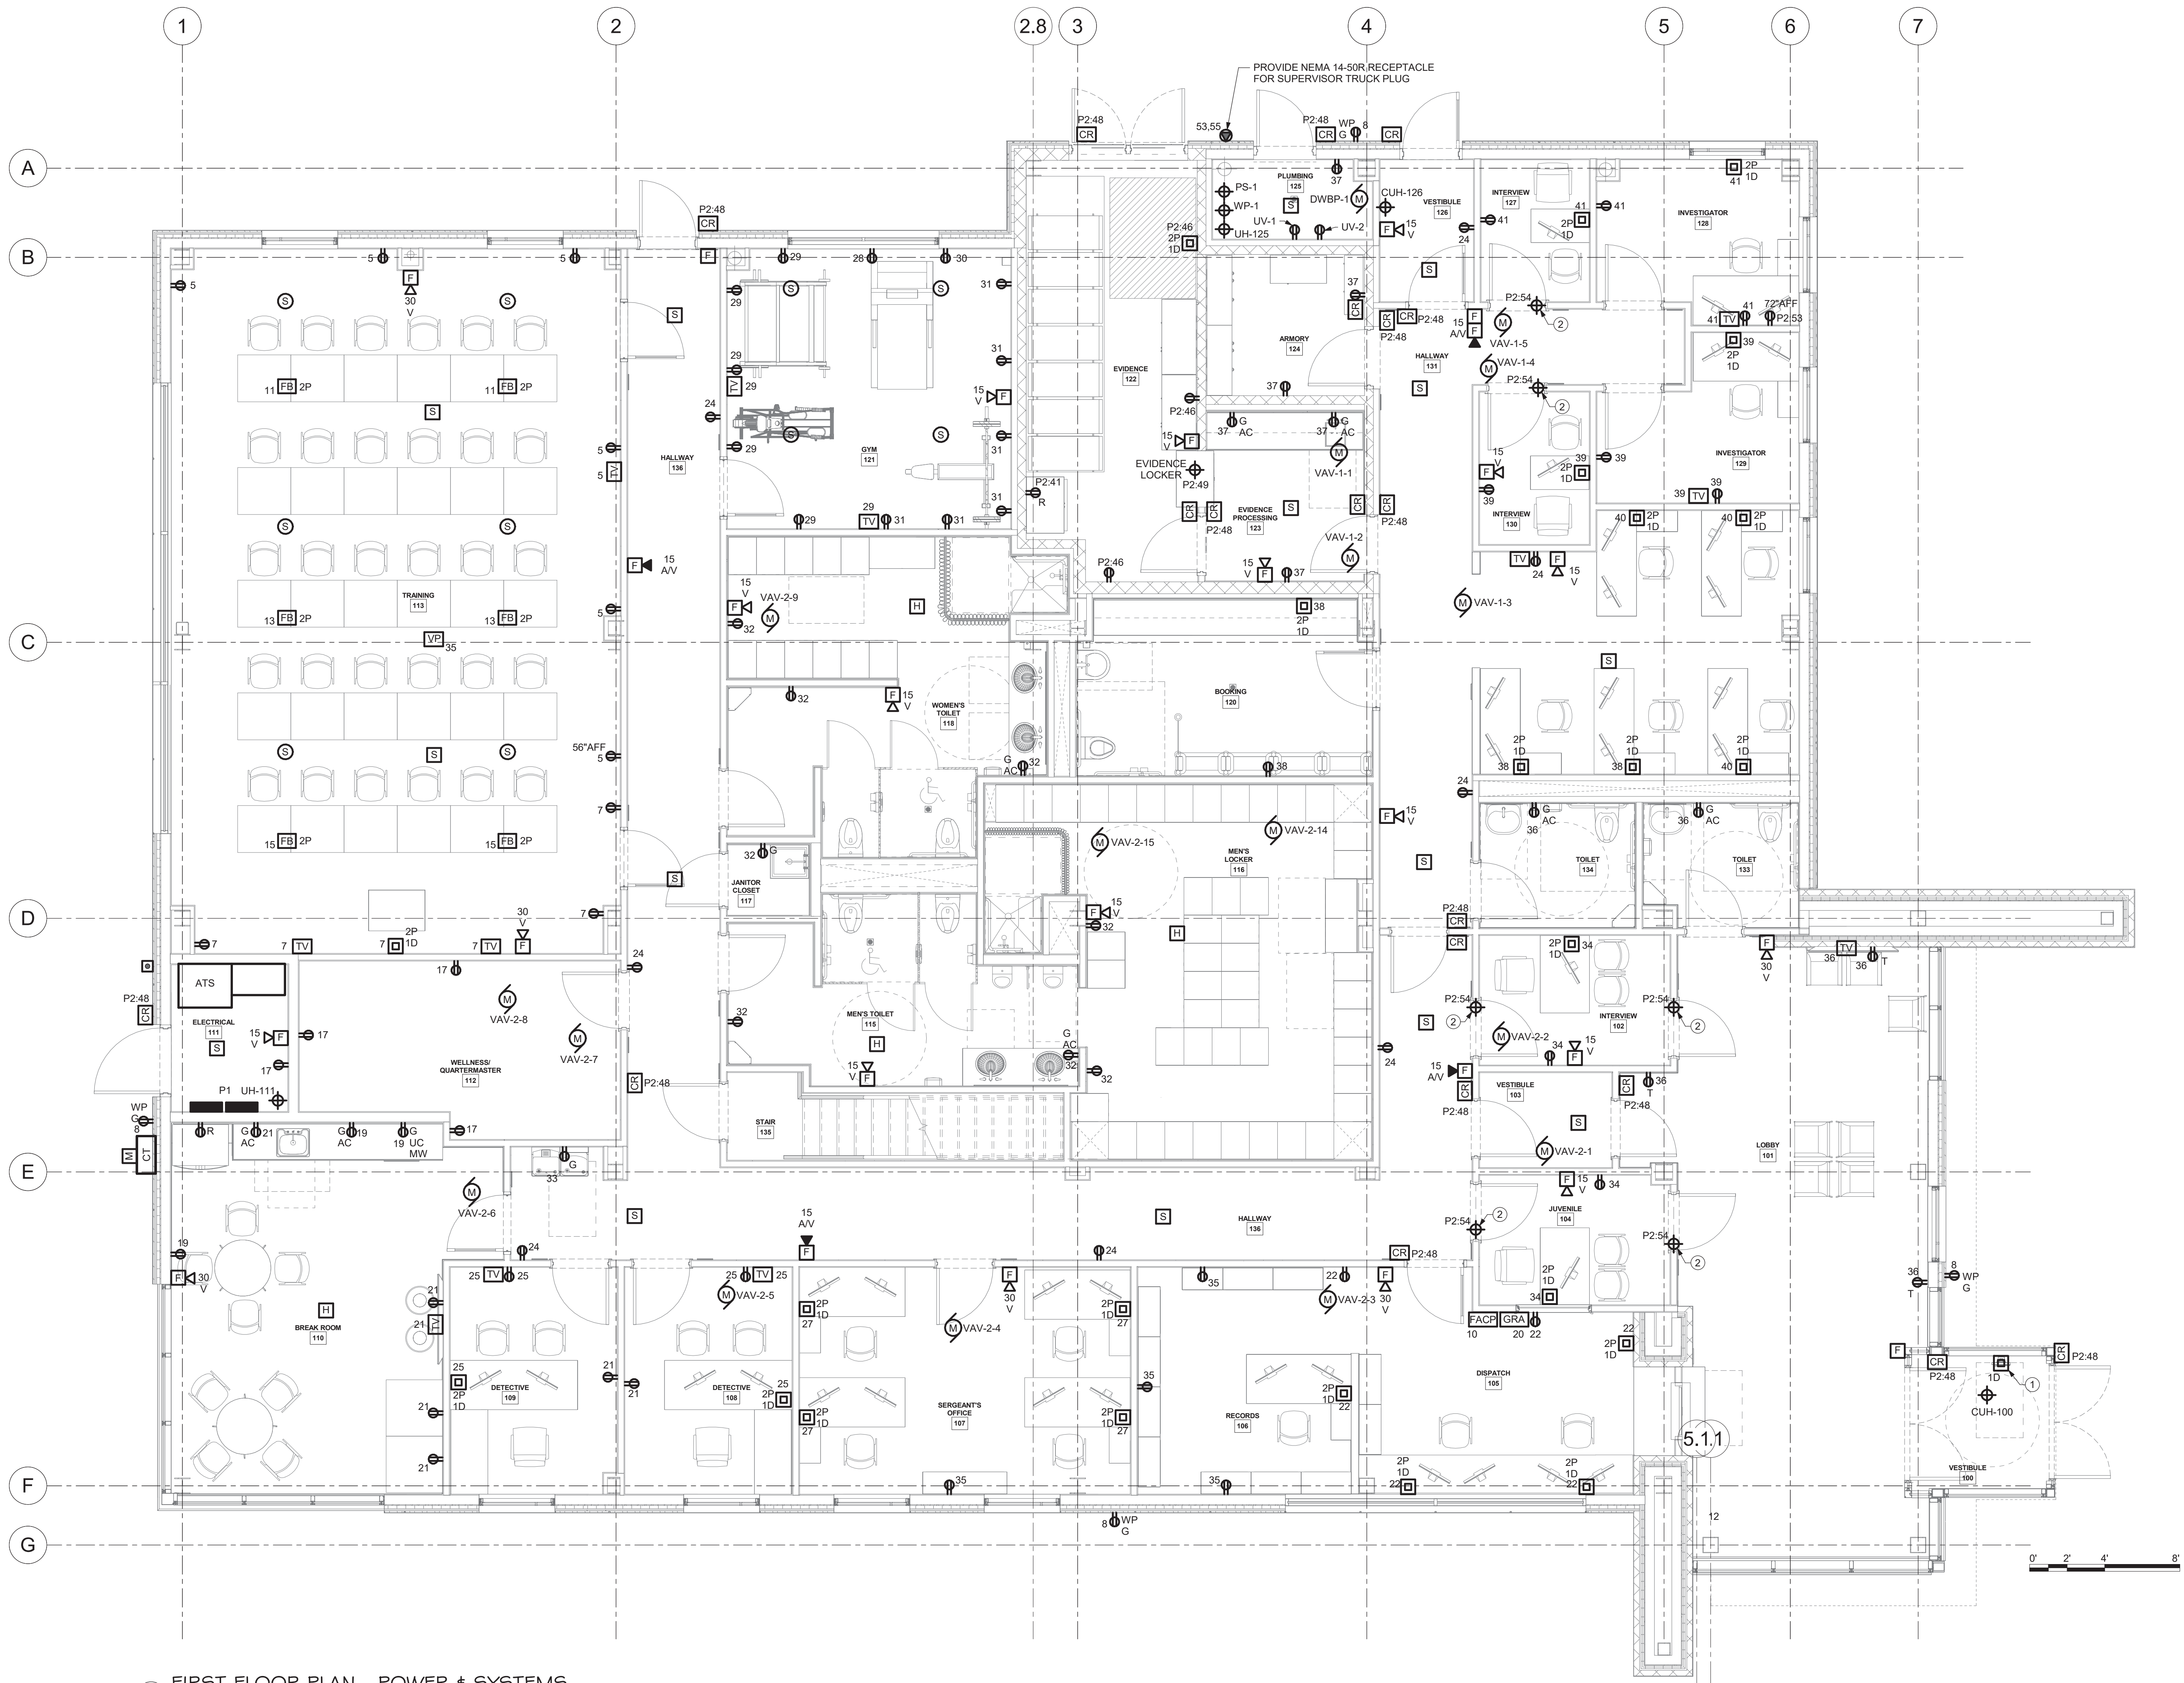

I FIRST FLOOR PLAN - POWER & SYSTEMS
1/4" = 1'-0"



Mechanical/Electrical Engineering Consultants

Capital District | Rochester | Buffalo | Syracuse

433 STATE STREET, 4TH FLOOR
SCHENECTADY, NY 12305
518.533.2171
www.meengineering.com

REVISIONS:

NUM.	DATE	DESCRIPTION

100% BID DOCUMENTS

KEY PLAN

WORK AREA

ADG ARCHITECTS

25 WALLKILL AVE • MONTGOMERY • NY 12549
O. 845.294.2724 | F. 888.305.6442
WWW.ADGARCHITECT.COM
CONTACT@ADGARCHITECT.COM

ARCHITECTURE • PLANNING • INTERIORS

Project: TOWN OF MONTGOMERY POLICE STATION
110 BRACKEN ROAD, MONTGOMERY,
NEW YORK 12549

Drawing: FIRST FLOOR PLAN - POWER & SYSTEMS




Project: 23138 Date: 02/24/25

Drawn: KML Scale: AS NOTED

Drawing Number:

E-101

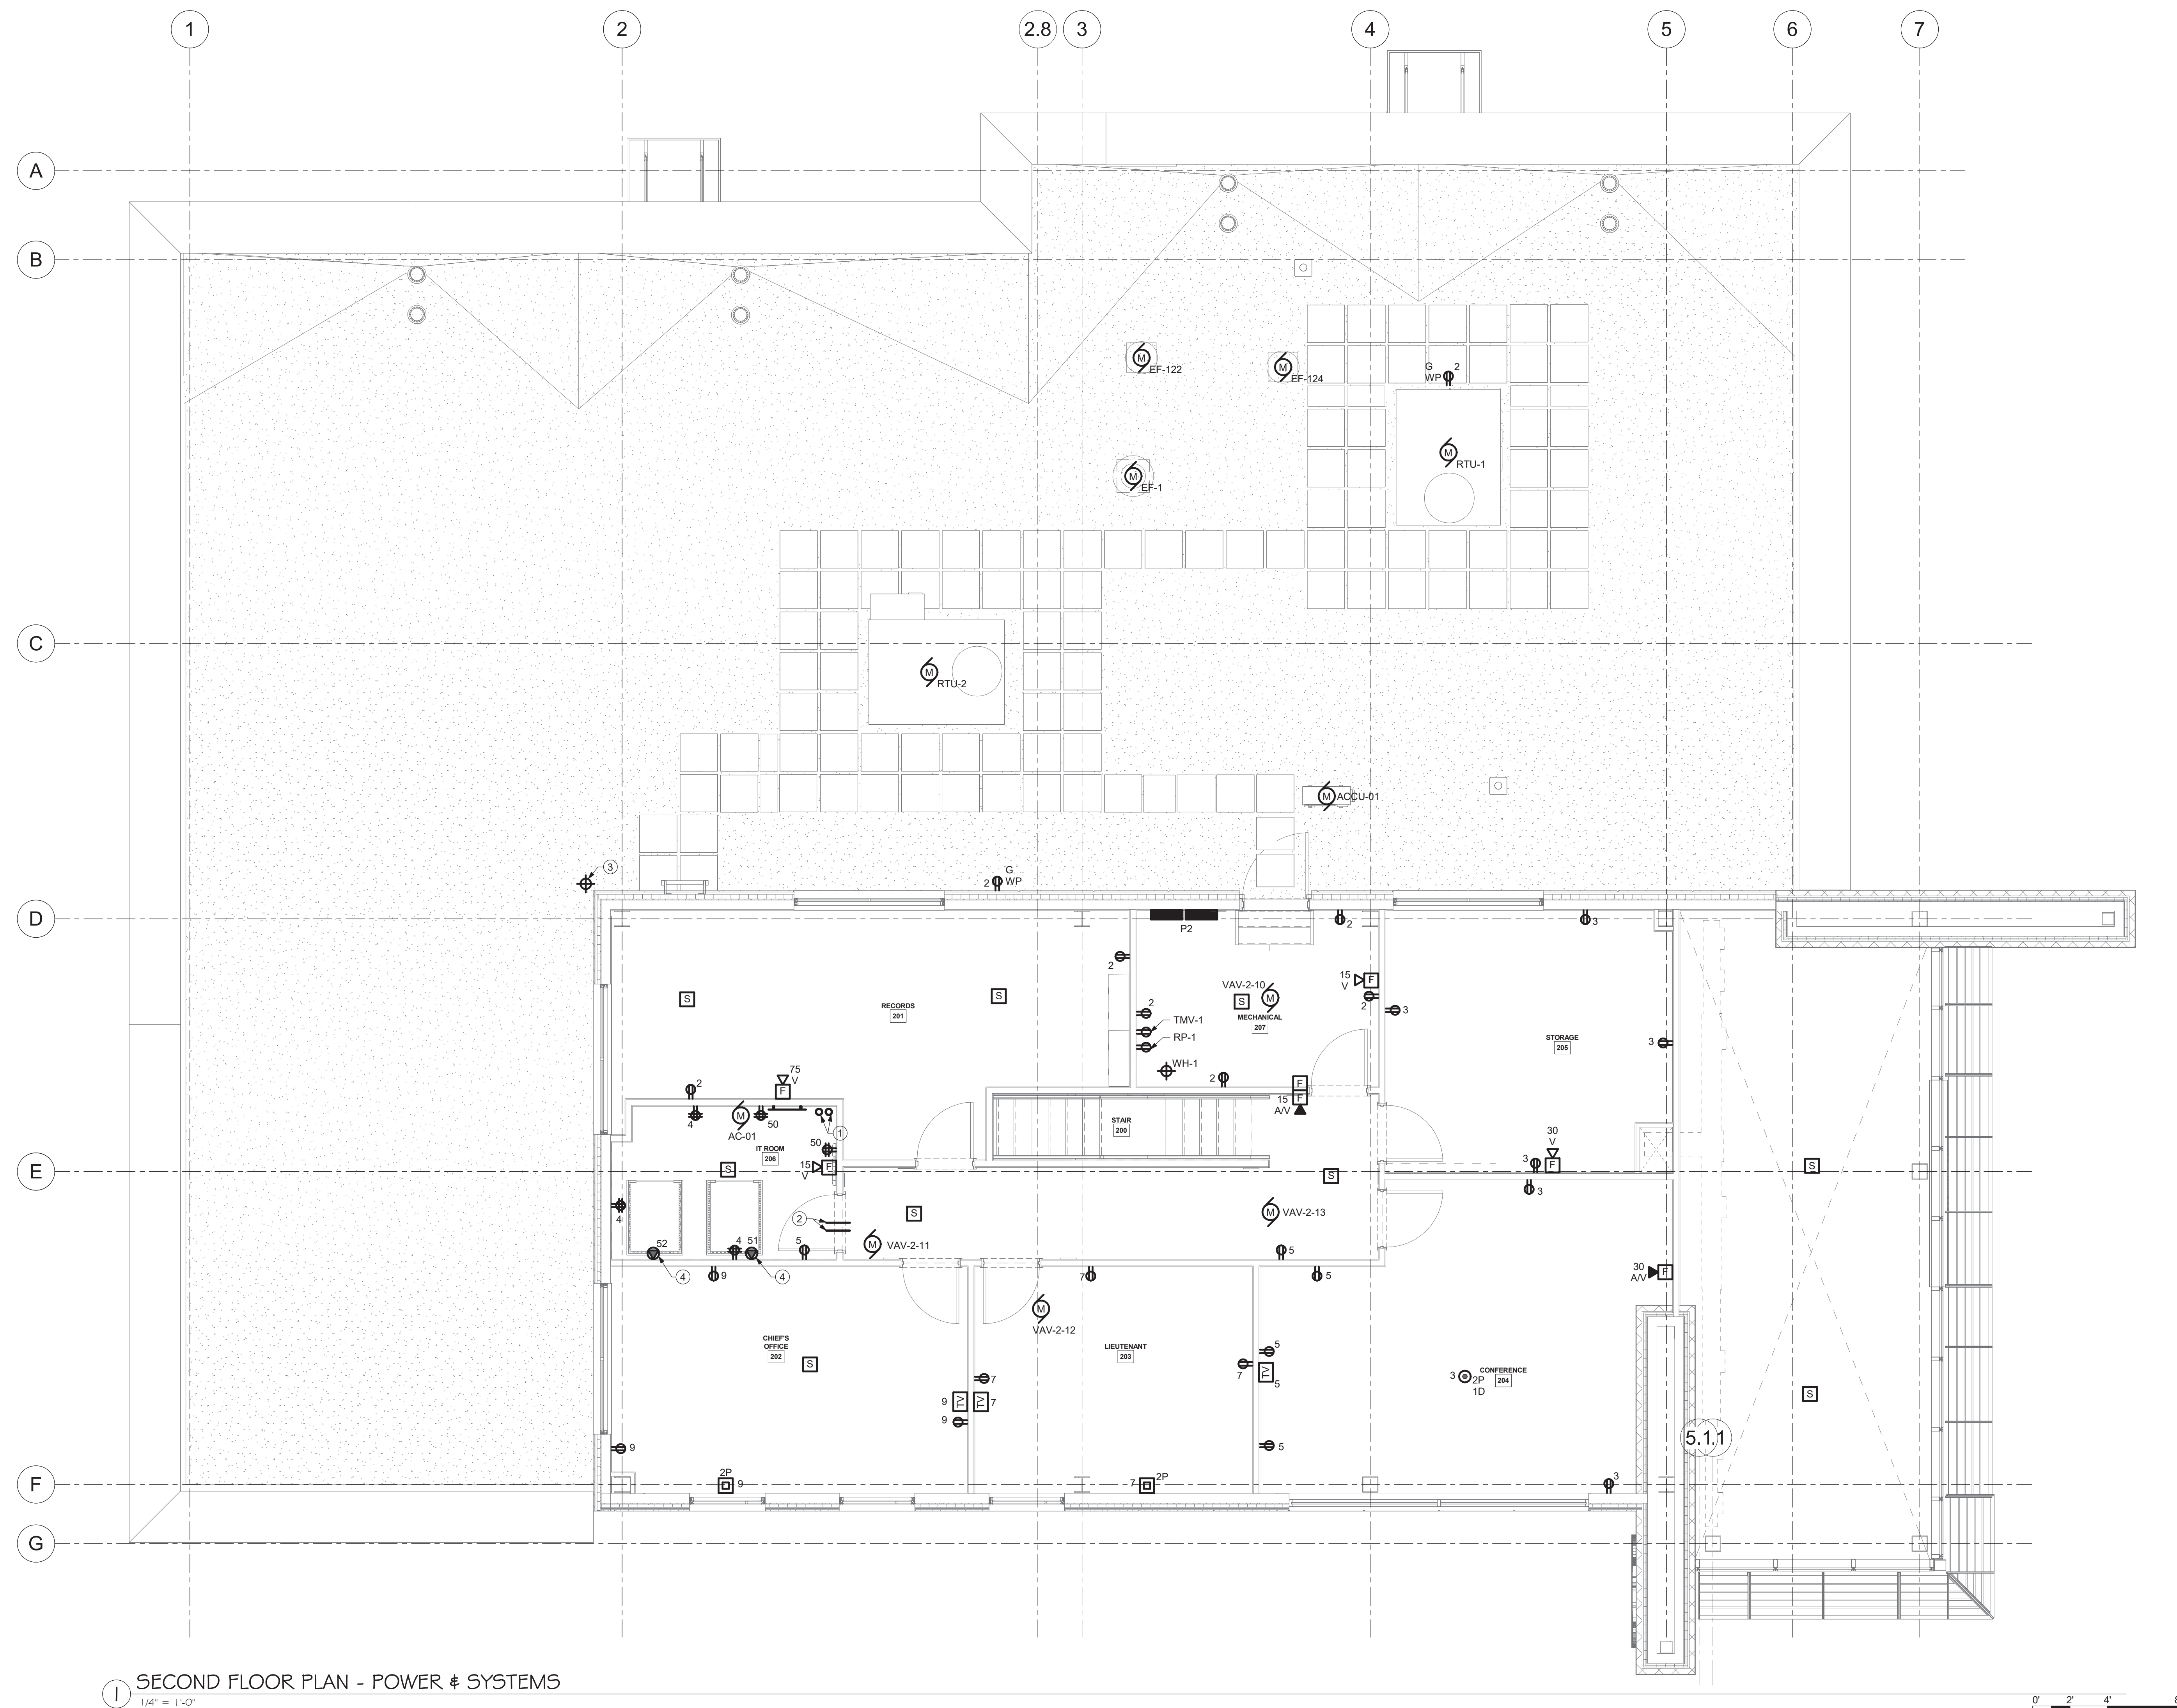

- GENERAL NOTES:**
- A. ALL CIRCUITING SHALL BE A MINIMUM OF (2)#12 & (1)#12G IN 3/4" CONDUIT, UNLESS OTHERWISE NOTED.
- B. CIRCUIT ALL EQUIPMENT AND DEVICES TO PANEL "P2" UNLESS OTHERWISE NOTED.
- E-102 DRAWING NOTES** (X)
1. PROVIDE (2)3" CONDUIT SLEEVES IN FLOOR.
2. PROVIDE (3)3" CONDUIT SLEEVES IN IT CLOSET WALL. CONDUIT SLEEVE INTO CORRIDOR SHALL BE ABOVE ACCESSIBLE CEILING.
3. PROVIDE (1)1" CONDUIT FROM IT ROOM TO ANTENNAS LOCATION, AND (1)1" CONDUIT FROM IT ROOM DOWN TO THE DISPATCH OFFICE. CONFIRM EXACT LOCATION OF ANTENNAS WITH THE OWNER.
4. PROVIDE (1) NEMA 5-30R RECEPTACLE FOR DATA RACK.




Mechanical/Electrical Engineering Consultants

Capital District | Rochester | Buffalo | Syracuse
433 STATE STREET, 4TH FLOOR
SCHENECTADY, NY 12305
518.533.2171
www.meengineering.com


REVISIONS:

NUM.	DATE	DESCRIPTION


100% BID DOCUMENTS

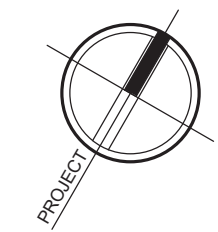

PROJECT

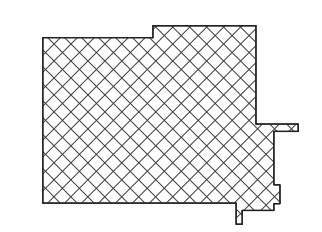

KEY PLAN




ARCHITECTS

25 WALLKILL AVE • MONTGOMERY • NY 12549
O. 845.294.2724 | F. 888.305.6442
WWW.ADGARCHITECT.COM
CONTACT@ADGARCHITECT.COM

ARCHITECTURE • PLANNING • INTERIORS

Project: TOWN OF MONTGOMERY POLICE STATION
110 BRACKEN ROAD, MONTGOMERY,
NEW YORK 12549

Drawing: SECOND FLOOR PLAN - POWER &
SYSTEMS



STATE OF NEW YORK
MICHAEL R. SULLIVAN
077887-
PROFESSIONAL ENGINEER

Reg. Exp. 05/31/2027
Cert. of Auth. 0018443

Project: 23138 Date: 02/24/25
Drawn: KML Scale: AS NOTED
Drawing Number:

E-102

- GENERAL NOTES:**
- A. ALL CIRCUITING SHALL BE A MINIMUM OF (2)#12 & (1)#12G IN 3/4" CONDUIT, UNLESS OTHERWISE NOTED.
 - B. CIRCUIT ALL EQUIPMENT AND DEVICES TO PANEL "P1" UNLESS OTHERWISE NOTED.
 - C. CIRCUIT ALL EXIT SIGNS AND EMERGENCY WALL PACKS AHEAD OF ANY LIGHTING CONTROLS. EXIT SIGNS SHALL ALL BE CIRCUITED TO (1)20A/1P CIRCUIT.



1 FIRST FLOOR PLAN - LIGHTING
1/4" = 1'-0"



Mechanical/Electrical Engineering Consultants

Capital District | Rochester | Buffalo | Syracuse
433 STATE STREET, 4TH FLOOR
SCHENECTADY, NY 12305
518.533.2171
www.meengineering.com

REVISIONS:		
NUM.	DATE	DESCRIPTION

100% BID DOCUMENTS

ADG ARCHITECTS

25 WALLKILL AVE • MONTGOMERY • NY 12549
O. 845.294.2724 | F. 888.305.6442
WWW.ADGARCHITECT.COM
CONTACT@ADGARCHITECT.COM

ARCHITECTURE • PLANNING • INTERIORS

Project: **TOWN OF MONTGOMERY POLICE STATION**
110 BRACKEN ROAD, MONTGOMERY,
NEW YORK 12549


Drawing: **FIRST FLOOR PLAN - LIGHTING**

Project: 23138 Date: 02/24/25
Drawn: KML Scale: AS NOTED
Drawing Number:

E-201

GENERAL NOTES:

- A. ALL CIRCUITING SHALL BE A MINIMUM OF (2)#12 & (1)#12G IN 3/4" CONDUIT, UNLESS OTHERWISE NOTED.
- B. CIRCUIT ALL EQUIPMENT AND DEVICES TO PANEL 'P2' UNLESS OTHERWISE NOTED.
- C. CIRCUIT ALL EXIT SIGNS AND EMERGENCY WALL PACKS AHEAD OF ANY LIGHTING CONTROLS. EXIT SIGNS SHALL ALL BE CIRCUITED TO (1)20A/1P CIRCUIT.

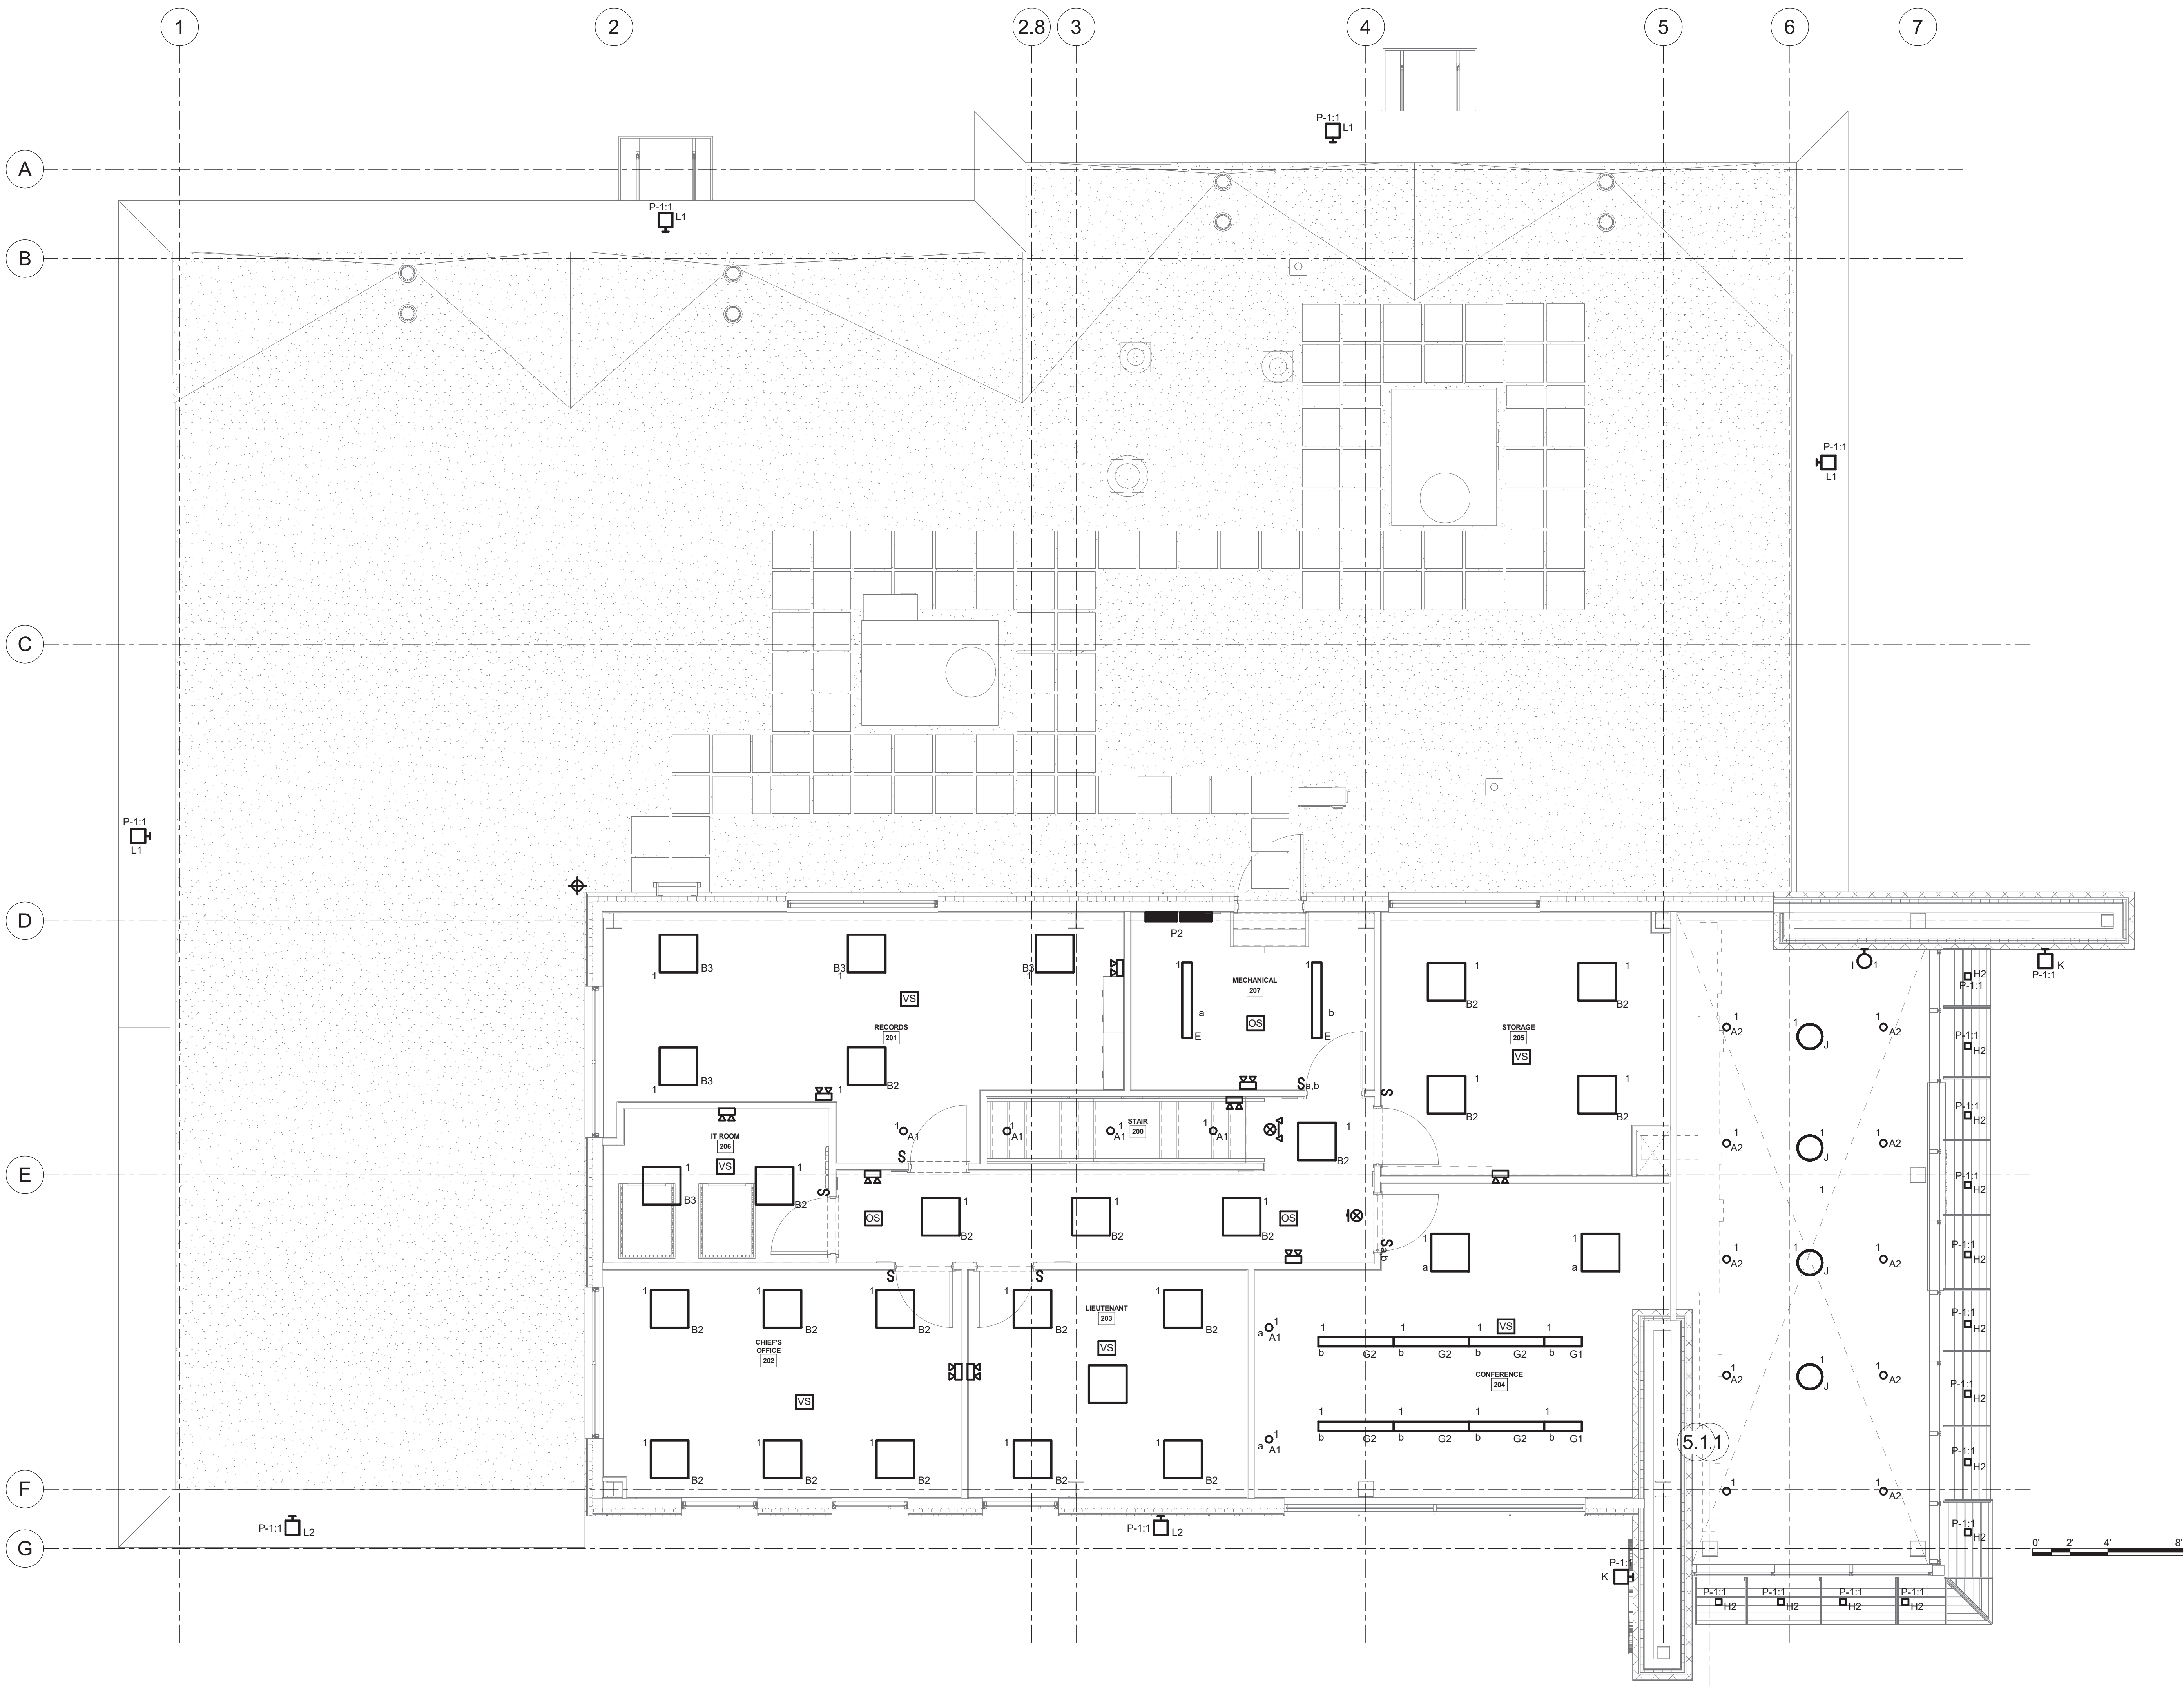

1 SECOND FLOOR PLAN - LIGHTING
1/4" = 1'-0"



Mechanical/Electrical Engineering Consultants

Capital District | Rochester | Buffalo | Syracuse

433 STATE STREET, 4TH FLOOR
SCHENECTADY, NY 12305
518.533.2171
www.meengineering.com

REVISIONS:

NUM.	DATE	DESCRIPTION

100% BID DOCUMENTS

ADG ARCHITECTS

25 WALLKILL AVE • MONTGOMERY • NY 12549
O. 845.294.2724 | F. 888.305.6442
WWW.ADGARCHITECT.COM
CONTACT@ADGARCHITECT.COM

ARCHITECTURE • PLANNING • INTERIORS

Project: TOWN OF MONTGOMERY POLICE STATION
110 BRACKEN ROAD, MONTGOMERY,
NEW YORK 12549

Drawing: SECOND FLOOR PLAN - LIGHTING



Project: 23138 Date: 02/24/25


Drawn: KML Scale: AS NOTED

Drawing Number:

E-202

ELECTRIC EQUIPMENT AND CONTROL SCHEDULE										ABBREVIATIONS										GENERAL NOTES													
										AU	AT UNIT	IU	INTEGRAL WITH UNIT					A.	REFER TO SPECIFICATIONS FOR EQUIPMENT REQUIREMENTS														
										B	ASD WITH BYPASS	M	MULTIPLE MOTOR ASD					B.	PROVIDE CONTROLLER SIZED PER HP/AMPS.														
										ECB	ENCLOSED CIRCUIT BREAKER	NF	NON-FUSED					C.	LOCATIONS/QUANTITIES OF FIRE ALARM DUCT DETECTORS ARE SHOWN ON PLANS.														
										F	FUSED	R	ASD WITH REDUNDANT ASD																				
										HOA	HAND-OFF-AUTO WITH RELAY	RE	REMOTE																				
EQUIPMENT										POWER SOURCE, PROTECTION & WIRING										MOTOR CONTROLLER				DISCONNECTING MEANS				CONNECTIONS				EQUIPMENT	
ITEM ID	NAME	ROOM LOCATION	HP	KW	AMPERAGE	PHASE	VOLTAGE	SOURCE	OCPD RATING	WIRING FROM SOURCE TO EQUIPMENT VIA CONTROLLER / DISCONNECTING MEANS			MANUAL MOTOR STARTER	MAGNETIC MOTOR STARTER	COMBINATION DAMPER AND SAFETY SWITCH	ADJUSTABLE SPEED DRIVE	PACKAGED CONTROL UNIT	NEMA ENCLOSURE TYPE	NEMA STARTER SIZE	LOCATION	SAFETY SWITCH	SAFETY SWITCH AMPERE RATING	EQUIPMENT AMPERE RATING	NEMA ENCLOSURE TYPE	LOCATION	FIRE ALARM SHUTDOWN	FIRE ALARM DUCT DETECTOR(S)	MOTORIZED DAMPER	LINE VOLTAGE TEMPERATURE CONTROL	REFERENCE NOTES	ITEM ID		
										PHASE	GROUND	CONDUIT																					
RTU-1	ROOFTOP HANDLING UNIT	ROOF			60.7	3	208	P-2	80A/3P	3#3	1#8	1-1/4"C					X			IU											RTU-1		
RTU-2	ROOFTOP HANDLING UNIT	ROOF			132.2	3	208	P-2	175A/3P	3#2/0	1#6	2"					X			IU						X	X				RTU-2		
VAV-1-1	AIR TERMINAL UNIT	EVIDENCE 123			8.4	1	208	P-1	15A/2P	2#12	1#12	3/4"C					X			IU											VAV-1-1		
VAV-1-2	AIR TERMINAL UNIT	EVIDENCE 123			8.4	1	208	P-1	15A/2P	2#12	1#12	3/4"C					X			IU											VAV-1-2		
VAV-1-3	AIR TERMINAL UNIT	CORRIDOR			10.8	1	208	P-1	15A/2P	2#12	1#12	3/4"C					X			IU											VAV-1-3		
VAV-1-4	AIR TERMINAL UNIT	CORRIDOR			6.0	1	208	P-1	15A/2P	2#12	1#12	3/4"C					X			IU											VAV-1-4		
VAV-1-5	AIR TERMINAL UNIT	CORRIDOR			8.4	1	208	P-1	15A/2P	2#12	1#12	3/4"C					X			IU											VAV-1-5		
VAV-2-1	AIR TERMINAL UNIT	CORRIDOR 103			45.1	3	208	P-2	50A/3P	3#6	1#10	3/4"C					X			IU											VAV-2-1		
VAV-2-2	AIR TERMINAL UNIT	CORRIDOR			4.8	1	208	P-1	15A/2P	2#12	1#12	3/4"C					X			IU											VAV-2-2		
VAV-2-3	AIR TERMINAL UNIT	CORRIDOR			13.2	1	208	P-1	15A/2P	2#12	1#12	3/4"C					X			IU											VAV-2-3		
VAV-2-4	AIR TERMINAL UNIT	CORRIDOR			10.8	1	208	P-1	15A/2P	2#12	1#12	3/4"C					X			IU											VAV-2-4		
VAV-2-5	AIR TERMINAL UNIT	CORRIDOR			10.8	1	208	P-1	15A/2P	2#12	1#12	3/4"C					X			IU											VAV-2-5		
VAV-2-6	AIR TERMINAL UNIT	BREAK ROOM 110			36.1	1	208	P-1	40A/2P	2#8	1#10	3/4"C					X			IU											VAV-2-6		
VAV-2-7	AIR TERMINAL UNIT	QUARTERMASTER 112			12.0	1	208	P-1	15A/2P	2#12	1#12	3/4"C					X			IU											VAV-2-7		
VAV-2-8	AIR TERMINAL UNIT	QUARTERMASTER 112			34.7	3	208	P-1	35A/3P	2#8	1#10	3/4"C					X			IU											VAV-2-8		
VAV-2-9	AIR TERMINAL UNIT	GYM 2-9			13.2	1	208	P-1	15A/2P	2#12	1#12	3/4"C					X			IU											VAV-2-9		
VAV-2-10	AIR TERMINAL UNIT	MECHANICAL 207			16.8	1	208	P-2	20A/2P	2#12	1#12	3/4"C					X			IU											VAV-2-10		
VAV-2-11	AIR TERMINAL UNIT	CORRIDOR			13.2	1	208	P-2	15A/2P	2#12	1#12	3/4"C					X			IU											VAV-2-11		
VAV-2-12	AIR TERMINAL UNIT	LIEUTENANT 204			8.4	1	208	P-2	15A/2P	2#12	1#12	3/4"C					X			IU											VAV-2-12		
VAV-2-13	AIR TERMINAL UNIT	CORRIDOR			22.8	1	208	P-2	25A/2P	2#10	1#10	3/4"C					X			IU											VAV-2-13		
VAV-2-14	AIR TERMINAL UNIT	MENS LOCKER 116			15.6	1	208	P-1	20A/2P	2#12	1#12	3/4"C					X			IU											VAV-2-14		
VAV-2-15	AIR TERMINAL UNIT	MENS LOCKER 116			9.6	1	208	P-1	15A/2P	2#12	1#12	3/4"C					X			IU											VAV-2-15		
CUH-100	CABINET UNIT HEATER	VESTIBULE 100		4	19.2	1	208	P-1	30A/2P	2#10	1#10	3/4"C					X			IU											CUH-100		
CUH-126	CABINET UNIT HEATER	CORRIDOR		4	19.2	1	208	P-1	30A/2P	2#10	1#10	3/4"C					X			IU											CUH-126		
UH-111	UNIT HEATER	ELECTRICAL 111		5	24.0	1	208	P-1	35A/2P	2#8	1#10	3/4"C					X			IU											UH-111		
UH-125	UNIT HEATER	PLUMBING 125		5	24.0	1	208	P-2	35A/2P	2#8	1#10	3/4"C					X			IU											UH-125		
EF-1	EXHAUST FAN	ROOF	1/4			3	208	P-2	15A/3P	3#12	1#12	3/4"C				X	X			AU								2			EF-1		
EF-122	EXHAUST FAN	ROOF			1.3	1	120	P-2	15A/1P	2#12	1#12	3/4"C					X			IU											EF-122		
EF-124	EXHAUST FAN	ROOF			1.3	1	120	P-2	15A/1P	2#12	1#12	3/4"C					X			IU											EF-124		
AC-01	AIR CONDITIONING UNIT	IT CLOSET 202			1.0	1	208	ACCU-01	-	2#12	1#12	3/4"C					X			IU											AC-01		
ACCU-01	AIR CONDITIONING UNIT	ROOF			19.0	1	208	P-2	20A/2P	2#12	1#12	3/4"C					X			IU											ACCU-01		
TMV-1	THERMOSTATIC MIXING VALVE	MECHANICAL 207			5.0	1	120	P-2	20A/1P	2#12	1#12	3/4"C					X			IU											TMV-1		
RP-1	RECIRC PUMP	MECHANICAL 207			1.8	1	120	P-2	20A/1P	2#12	1#12	3/4"C					X			IU											RP-1		
WH-1	WATER HEATER	MECHANICAL 207		5.5	26.4	1	208	P-2	35A/2P	2#8	1#10	3/4"C					X			IU											WH-1		
UV-1	ULTRAVIOLET FILTER	PLUMBING 125		0.23	1.9	1	120	P-2	20A/1P	2#12	1#12	3/4"C					X			IU											UV-1		
UV-2	ULTRAVIOLET FILTER	PLUMBING 125		0.23	1.9	1	120	P-2	20A/1P	2#12	1#12	3/4"C					X			IU											UV-2		
WP-1	WELL PUMP	PLUMBING 125	10		30.8	3	208	P-2	70A/3P	3#8	1#8	3/4"C					X			IU											WP-1		
DWBP-1	DOMESTIC WATER PUMP	PLUMBING 125	2		13.2	1	208	P-2	20A/2P	2#12	1#12	3/4"C					X			IU											DWBP-1		
PS-1	PRESSURE SWITCH	PLUMBING 125			1.0	1	120	P-2	20A/1P	2#12	1#12	3/4"C					X			IU											PS-1		

REFERENCE NOTES	
1	PLUG SERVES AS DISCONNECTING MEANS.
2	SAFETY DISCONNECT FURNISHED BY MC AND INSTALLED BY EC.

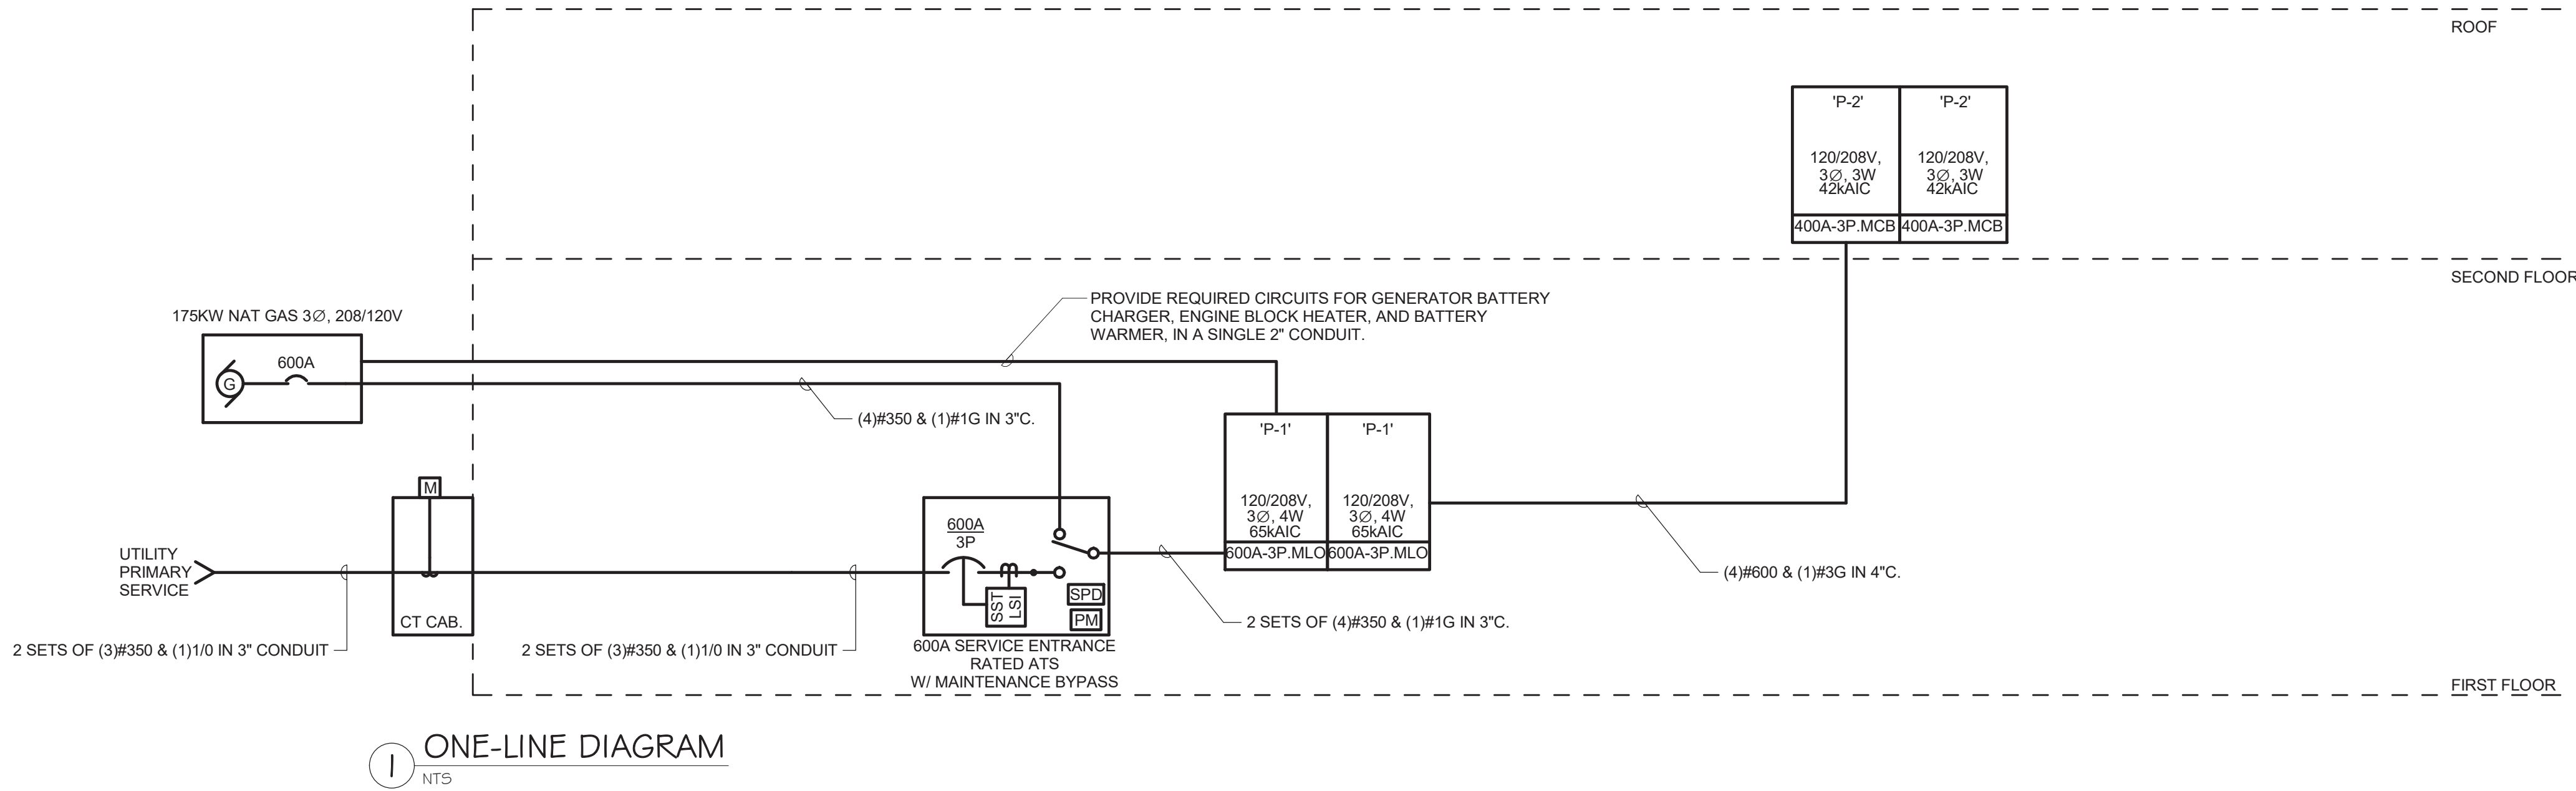

Mechanical/Electrical Engineering Consultants

Capital District | Rochester | Buffalo | Syracuse


433 STATE STREET, 4TH FLOOR
SCHENECTADY, NY 12305

518.533.2171
www.meengineering.com


REVISIONS:

NUM.	DATE	DESCRIPTION


100% BID DOCUMENTS

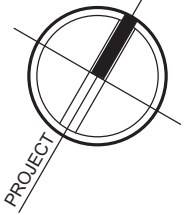

PROJECT

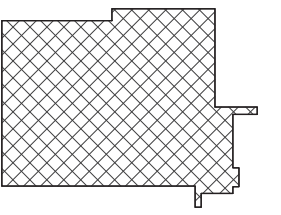

KEY PLAN



ARCHITECTS

25 WALLKILL AVE • MONTGOMERY • NY 12549
O. 845.294.2724 | F. 888.305.6442
WWW.ADGARCHITECT.COM
CONTACT@ADGARCHITECT.COM

ARCHITECTURE • PLANNING • INTERIORS

Project: TOWN OF MONTGOMERY POLICE STATION
110 BRACKEN ROAD, MONTGOMERY,
NEW YORK 12549

Drawing: ELECTRICAL ONELINE DIAGRAM



Project: 23138 Date: 02/24/25

Drawn: KML Scale: AS NOTED


Drawing Number:

E-601

LUMINAIRE SCHEDULE							
TYPE	DESCRIPTION	MFR. & CATALOG No.	LAMP	VOLTAGE	MOUNTING	UNIT WATTS	REFERENCE NOTES
A1	6" RECESSED DOWNLIGHT SEMI-SPECULAR REFLECTOR	LITHONIA LIGHTING LDN6 OR APPROVED EQUAL	LED 4000K 1000 LUMENS	120V	RECESSED	10.44W	
A2	SAME AS A1 EXCEPT LUMEN OUTPUT		LED 4000K 2000 LUMENS			22.52W	
B1	2X2 TROFFER WITH CURVED OPAL LENS	HOLOPHANE HVTS OR APPROVED EQUAL	LED 4000K 2000 LUMENS	120-277V	RECESSED	16.78W	
B2	SAME AS B1 EXCEPT LUMEN OUTPUT		LED 4000K 3000 LUMENS			24.15W	
B3	SAME AS B1 EXCEPT LUMEN OUTPUT		LED 4000K 4000 LUMENS			33.31W	
B4	SAME AS B1 EXCEPT LUMEN OUTPUT		LED 4000K 5000 LUMENS			42.62W	
C	WALL SCONCE VISUAL COMFORT FORWAR OPTIC	LITHONIA LIGHTING WDGE1 OR APPROVED EQUAL	LED 4000K 2000 LUMENS	120V	WALL	15W	
D	2X4 RECESSED ELEMENT LAY-IN	HOLOPHANE HVTS OR APPROVED EQUAL	LED 4000K 5000 LUMENS	120-277V	RECESSED	41.92W	
E	48" LINEAR SUSPENDED FIXTURE	HOLOPHANE EH2L1D OR APPROVED EQUAL	LED 4000K 7000 LUMENS	120V	SUSPENDED	59.23W	
G1	2'-0" RECESSED LINEAR SLOT LED FIXTURE WITH FLUSH LENS	MARK LIGHTING SL4L OR APPROVED EQUAL	LED 4000K 400 LUMENS/FT	120V	SUSPENDED	4W/FT	
G2	SAME AS G1 EXCEPT 4'-0" LENGTH						
H1	6" RECESSED SQUARE DOWNLIGHT SEMI-SPECULAR REFLECTOR	LITHONIA LIGHTING LDN6SQ OR APPROVED EQUAL	LED 4000K 1000 LUMENS	120V	RECESSED	10.44W	
H2	SAME AS H1 EXCEPT LUMEN OUTPUT		LED 4000K 2000 LUMENS			22.52W	
I	EXTERIOR LED WALL CYLINDER UP & DOWN LIGHT	LITHONIA LIGHTING OLLWU OR APPROVED EQUAL	LED 4000K 1086 LUMENS	120V	WALL	13.8W	
J	LED HIGH BAY WITH MEDIUM GLASS REFRACTOR AND ACRYLIC REFLECTOR	HOLOPHANE PHG OR APPROVED EQUAL	LED 4000K 9000 LUMENS	120V		58.89W	
K	RUGGED EXTERIOR LED WALLPACK FIXTURE, SING-VUE OPTIC	HOLOPHANE SVLED3 OR APPROVED EQUAL	LED 4000K 9513 LUMENS	MVOLT	WALL	72.2W	
L1	FULL CUTOFF LED WALLPACK WITH TYPE FOUR MEDIUM DISTRIBUTION	HOLOPHANE HLWPC2 OR APPROVED EQUAL	LED 4000K 9882 LUMENS	MVOLT	WALL	95W	
L2	SAME AS L1 EXCEPT LUMEN PACKAGE AND FORWARD THROW MEDIUM DISTRIBUTION	HOLOPHANE HLWPC2 OR APPROVED EQUAL	LED 4000K 12125 LUMENS	MVOLT	WALL	115W	
⊗	EXIT SIGN	ISOLITE TL2 SERIES OR APPROVED EQUAL	LED		CEILING		
⊗	EXIT SIGN W/ BATTERY BACKUP LIGHTING UNIT	ISOLITE DCL SERIES OR APPROVED EQUAL	LED		CEILING		
⊗	EMERGENCY LIGHTING UNIT W/ BATTERY BACKUP	ISOLITE BUG SERIES OR APPROVED EQUAL	LED		WALL		

PANELBOARD DIRECTORY																									
M/E PROJECT: MONTGOMERY POLICE STATION PROJECT NO.: 233326.00 FACILITY: LOCATION: ELECTRICAL 111						PANEL NAME: P-1 VOLTAGE: 208 / L - L A/C: 65 k SOURCE: UTILITY						TYPE: MOUNTING: P-1 OCP TYPE: MLO BUS RATING: 600				BRANCH SURFACE									
DESCRIPTION	CKT NO.	TRIP	LTG. VA	RECEPT. VA	MOTOR VA	EQUIP. VA	HVAC VA	KIT VA	KIT VA	HVAC VA	EQUIP. VA	MOTOR VA	RECEPT. VA	LTG. VA	TRIP	CKT NO.	DESCRIPTION								
EXTERIOR LTG	1a	20/1	500											1000	20/1	2a	LIGHTING								
POLE LTG	3b	20/1	500											1000	20/1	4b	LIGHTING								
REC 113	5c	20/1		1440										1000	20/1	6c	LIGHTING								
REC 113	7a	20/1		1440										720	20/1	8a	EXTERIOR REC								
REC 113	9b	20/1		720										500	20/1	10b	FACP								
FLOOR BOX 113	11c	20/1		720										500	20/1	12c	FAAP								
FLOOR BOX 113	13a	20/1		720									1200		20/1	14a	GEN CHARGER								
FLOOR BOX 113	15b	20/1		720									1200		20/1	16b	GEN WARMER								
REC 112	17c	20/1		720									1200		20/1	18c	GEN HEATER								
KITCHEN REC	19a	20/1						720					500		20/1	20a	GRA								
KITCHEN REC	21b	20/1						1080					1080		20/1	22b	DISPATCH REC								
REFRIGERATOR	23c	20/1						1000					1440		20/1	24c	CORRIDOR REC								
OFFICE REC	25a	20/1		1440									500		20/1	26a	ACCESS CNTRL								
OFFICE REC	27b	20/1		1440									1080		20/1	28b	TREADMILL								
GYM REC	29c	20/1		1260									1200		20/1	30c	TREADMILL								
GYM REC	31a	20/1		1080									1440		20/1	32a	BATH REC								
WATER COOLER	33b	20/1			1000								1080		20/1	34b	OFFICE REC								
DISPATCH REC	35c	20/1		720									1080		20/1	36c	LOBBY REC								
RECEPTACLES	37a	20/1		1080									1260		20/1	38a	OFFICE REC								
OFFICE REC	39b	20/1		1440									1080		20/1	40b	OFFICE REC								
OFFICE REC	41c	20/1		1440											20/1	42c									
VAV-1-1	43a	15/2					874				1123				15/2	44a	VAV-1-3								
	45b						874				624				15/2	46b	VAV-1-4								
VAV-1-2	47c	15/2					874				624				15/2	48c	VAV-1-5								
	49a						874				874				15/2	50a	VAV-1-5								
DOG KENNEL	51b	30/1									874				15/2	52b									
	53c										499				15/2	54c	VAV-2-2								
TRUCK REC	55a	50/2									499				15/2	56a									
VAV-2-4	57b	15/2					1123				1373				15/2	58b	VAV-2-3								
	59c						1123				1373				15/2	60a	VAV-2-3								
VAV-2-5	61a	15/2					1123				3754				40/2	62a	VAV-2-6								
	63b						1123				3754				40/2	64b									
VAV-2-7	65c	15/2					1248				1622				20/2	66c	VAV-2-14								
	67a						1248				1622				20/2	68a									
VAV-2-9	69b	15/2					1373				998				15/2	70b	VAV-2-15								
	71c						1373				998				15/2	72c									
VAV-2-8	73a	35/3					4164				1997				30/2	74a	CUH-100								
	75b						4164				1997				30/2	76b									
	77c						4164				1997				30/2	78c	CUH-126								
	79a		1000	2340	5479	0	35953	0			1997				30/2	80a									
PANEL P-2	81b	400/3	0	3780	6562	0	37076	0			2496				35/2	82b									
	83c		0	1900	7988	0	35576	0			2496				35/2	84c	UH-111								


PANELBOARD DIRECTORY																									
M/E PROJECT: MONTGOMERY POLICE STATION PROJECT NO.: 233326.00 FACILITY: LOCATION: IT CLOSET 202						PANEL NAME: P-2 VOLTAGE: 208 /L - L A/C: 42/k SOURCE: P-1						TYPE: MOUNTING: P-2 OCP TYPE: MCB BUS RATING: 400				BRANCH SURFACE MCB 400									
DESCRIPTION	CKT NO.	TRIP	LTG. VA	RECEPT. VA	MOTOR VA	EQUIP. VA	HVAC VA	KIT VA	KIT VA	HVAC VA	EQUIP. VA	MOTOR VA	RECEPT. VA	LTG. VA	TRIP	CKT NO.	DESCRIPTION								
LIGHTING	1a	20/1	1000										1440		20/1	2a	RECEPTACLES								
RECEPTACLES	3b	20/1		1440									720		20/1	4b	DATA REC								
RECEPTACLES	5c	20/1		900						15864					175/3	6c	RTU-2								
RECEPTACLES	7a	20/1		900						15864					175/3	8a									
RECEPTACLES	9b	20/1		900						15864					175/3	10b									
RTU-1	11c						7284			300						12c									
	13a	80/3					7284			300					15/3	14a	EF-1								
	15b						7284			300					15/3	16b									
TMV-1	17c	20/1			600					351					15/1	18c	EF-122, 124								
RP-1	19a	20/1			324					1976					20/2	20a	ACCU-01								
WH-1	21b	35/2			2746					1976					22b	22b									
	23c				2746							3696			24c	24c									
UV-1, 2	25a	20/1			513							3696			70/3	26a	WP-1								
PS-1	27b	20/1			120							3696			70/3	28b									
VAV-2-12	29c	15/2					874			1747					15/2	30c	VAV-2-10								
	31a						874			1747					15/2	32a									
	33b	25/2					2371			1373					15/2	34b	VAV-2-11								
VAV-2-13	35c						2371			1373					15/2	36c									
	37a						2496								20/1	38a	911 ANTENNA								
UH-125	39b	35/2					2496								20/1	40b	WTHR ANTENNA								
EVIDENCE REF	41c	20/1		1000								946			20/2	42c	DWBP-1								
	43a						5412					946			20/1	44a									
VAV-2-1	45b	50/3					5412						720		20/1	46b	EVIDENCE REC								
	47c						5412								20/1	48c	ELEC STRIKES								
EVID LOCKER	49a	20/1											720		20/1	50a	DATA REC								
SPARE	51b	20/1													20/1	52b	SPARE								
SPARE	53c	20/1													20/1	54c	SPARE								
SPARE	55a	20/1													20/1	56a	SPARE								
SPARE	57b	20/1													20/1	58b	SPARE								
SPARE	59c	20/1													20/1	60c	SPARE								

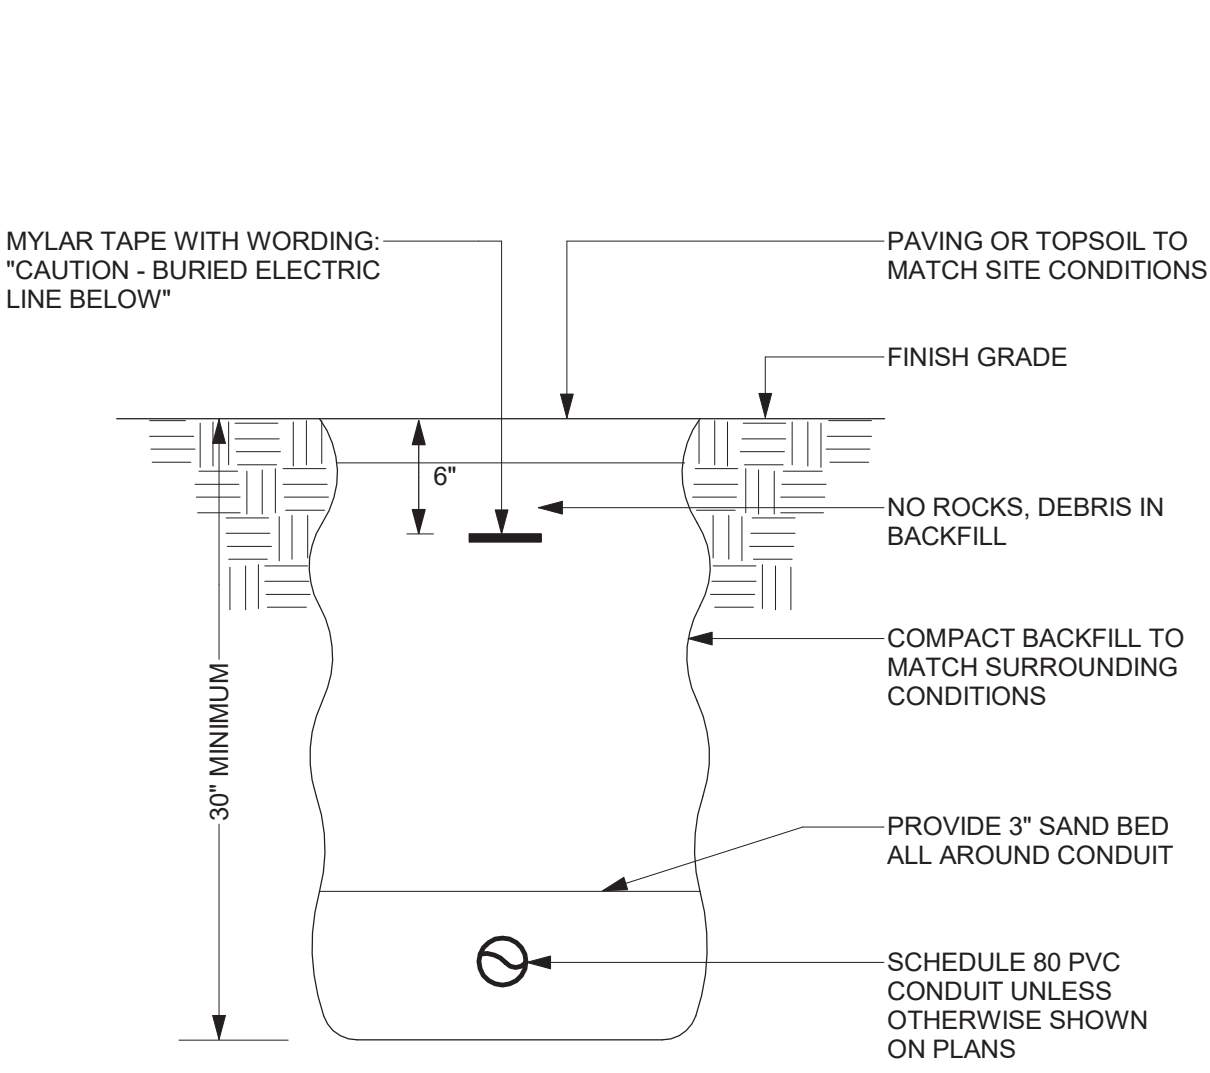

DETAIL NOTES:

- READ THE SPECIFICATIONS.
- REPAIR ALL SETTLEMENT.
- MINIMUM TOP SOIL - 6".
- WHERE ADDITIONAL CONDUITS ARE REQUIRED, INCREASE TRENCH WIDTH AND INSTALL CONDUITS WITH 3" MINIMUM SPACING.


1 TYPICAL DIRECT BURIED CONDUIT DETAIL

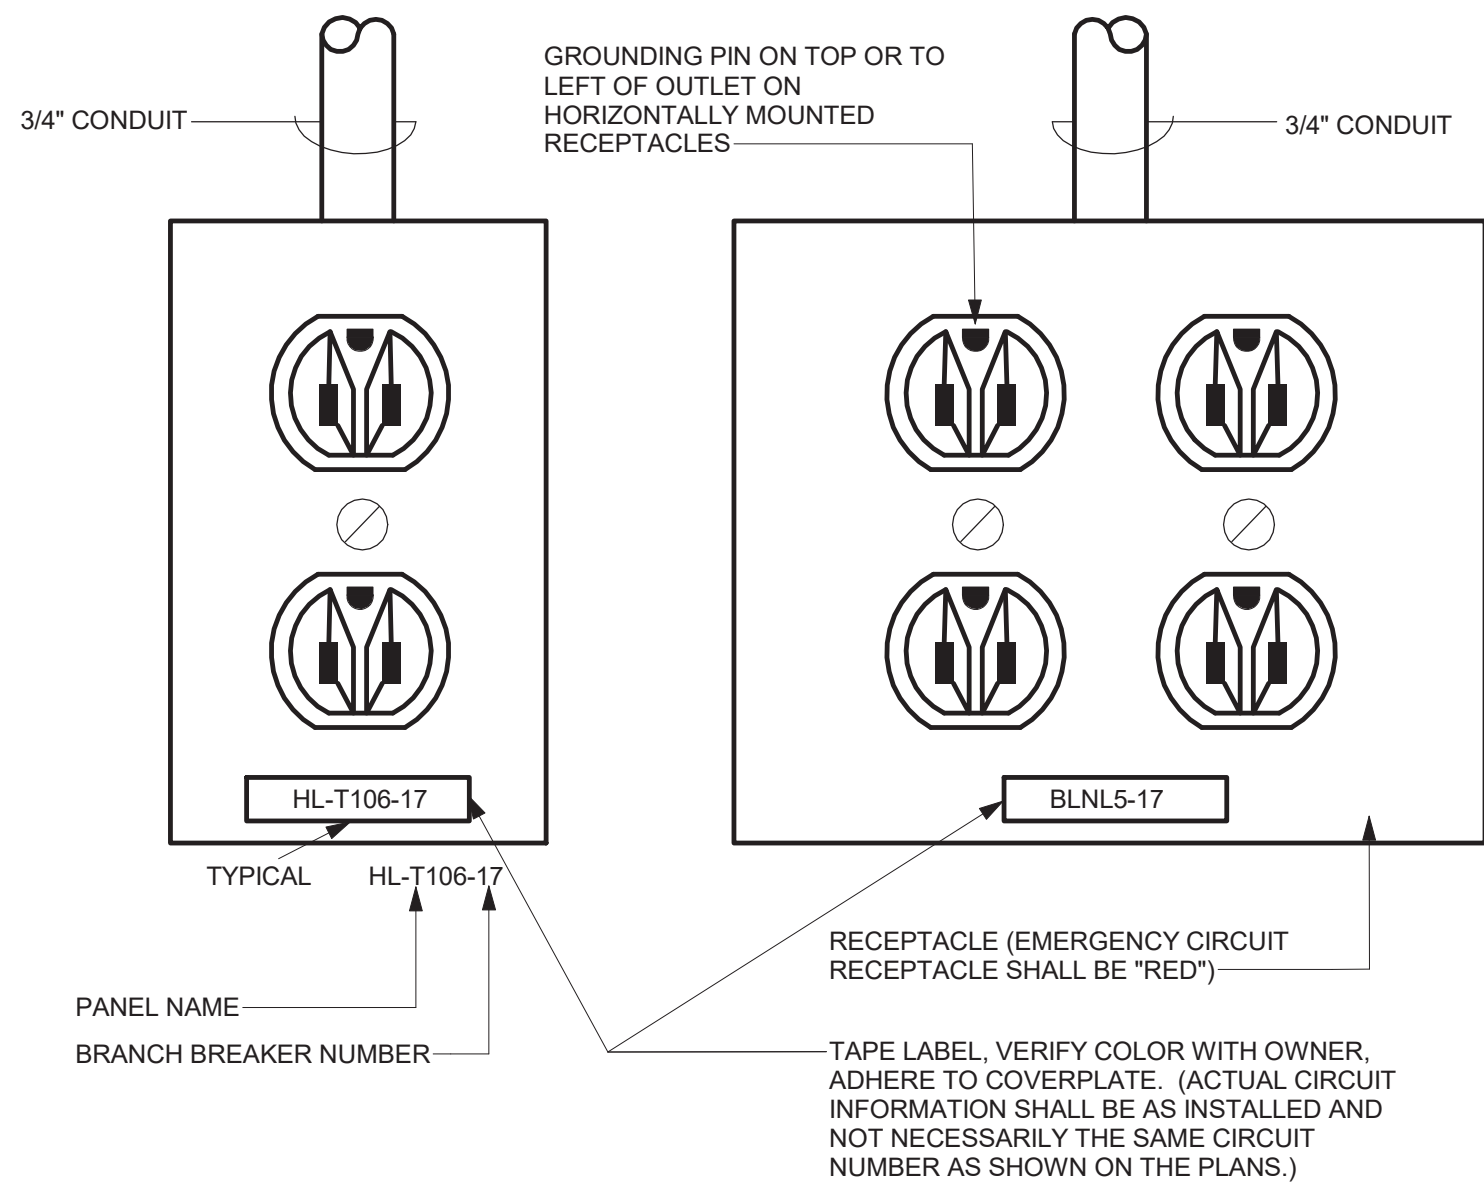

GENERAL DETAIL NOTES:

- PROVIDE GREEN GROUND WIRE IN ALL RECEPTACLE CIRCUITS. CONNECT TO GROUND BUS IN PANEL.
- DO NOT INSTALL RECEPTACLES, COMPUTER OR TELEPHONE OUTLETS BACK TO BACK. INSTALL IN ADJACENT STUD CAVITIES, TO REDUCE SOUND TRANSMISSION.

2 TYPICAL RECEPTACLE IDENTIFICATION REQUIREMENTS

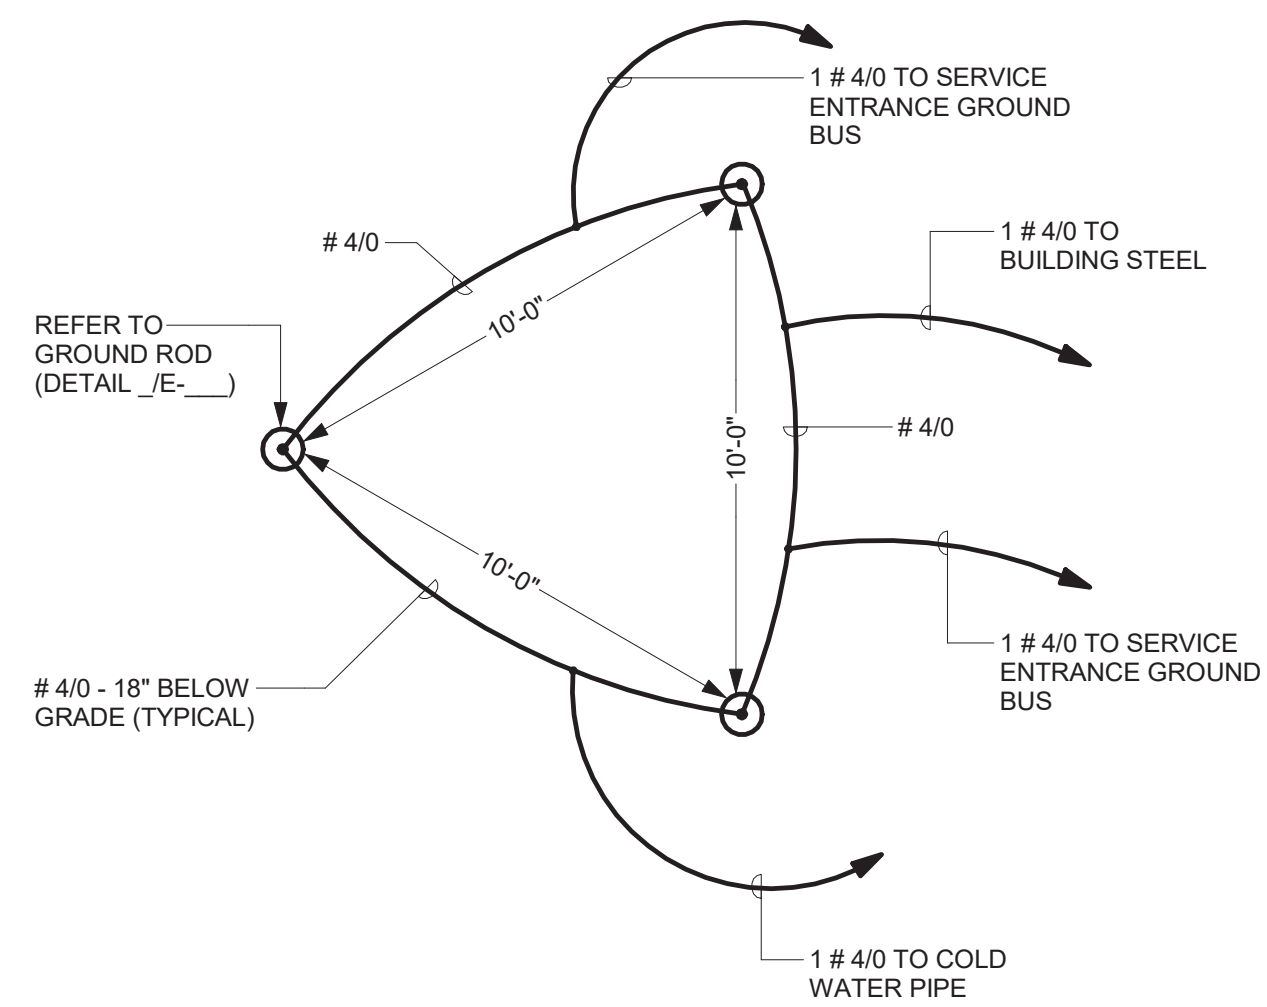

4 GROUNDING SYSTEM DETAIL

NTS



Mechanical/Electrical Engineering Consultants

Capital District | Rochester | Buffalo | Syracuse

- ① GROUNDING ELECTRODE CONDUCTOR. PROVIDE INSULATED COPPER CONDUCTOR PER SPECIFICATIONS. (IF NO SIZE IS SPECIFIED, PROVIDE INSULATED COPPER CONDUCTOR SIZED PER N.E.C. TABLE 250-68. INSTALL IN RIGID, SCHEDULE 40, PVC RACEWAY).
- ② METAL UNDERGROUND WATER PIPE IN DIRECT CONTACT WITH EARTH FOR 10 FEET OR MORE. SHALL BE SUPPLEMENTED BY ITEMS 3 & 4.
- ③ BUILDING STRUCTURAL STEEL.
- ④ MAKE GROUNDING ELECTRODE. REFER TO MAKE GROUNDING ELECTRODE-GROUND GRID' DETAIL & SPECIFICATIONS.
- ⑤ MAIN BONDING JUMPER. PROVIDE INSULATED COPPER CONDUCTOR PER N.E.C. ARTICLE 250-28.
- ⑥ BOND GROUND BUS TO EQUIPMENT ENCLOSURE WITH BARE COPPER BONDING JUMPER PER N.E.C. ARTICLE 250-28.

① SERVICE ENTRANCE GROUNDING

NTS

- ① ANCHOR BOLT, SIZE & LOCATION AS REQUIRED TO MATCH EQUIPMENT BASE.
- ② PLASTIC SLEEVE & ANCHOR.
- ③ #3 REINFORCING BARS, 12" O.C. EACH WAY.
- ④ #4 DOWEL, 12" O.C.
- ⑤ CHAMFER.
- ⑥ CONCRETE PAD 3,000 PSI CONCRETE, LENGTH & WIDTH, 6" GREATER THAN THE EQUIPMENT BASE PLATE.

④ CONCRETE EQUIPMENT BASE DETAIL (ELEC)

NTS

(c) TYPICAL GROUND ROD DETAIL

NTS

1. MOUNTING HEIGHTS TO CENTER OF OUTLETS UNLESS OTHERWISE NOTED. IN MASONRY CONSTRUCTION THE ABOVE MOUNTING HEIGHTS SHALL BE USED FOR REFERENCE TO NEAREST BLOCK OR BRICK COURSING.
2. THE ABOVE MOUNTING HEIGHTS SHALL BE ADHERED TO UNLESS SPECIFICALLY NOTED OR DETAILED OTHERWISE ON THE DRAWINGS.

2 TYPICAL EQUIPMENT AND WIRING DEVICES MOUNTING HEIGHTS

2 NTS

② FIRE ALARM BLOCK DIAGRAM

5 NOM

- A. ALL GROUND CONDUCTORS SHALL BE #4/0 BARE STRANDED COPPER INSTALLED IN A 1" PVC CONDUIT

(F) ELECTRICAL ROOM GROUNDING TERMINAL BAR DETAIL

5 NT

7 STEEL CONDUIT RISER AT POWER COMPANY POLE - 02

7 NTS

- A. TERMINATIONS AND TESTING BY OTHERS.
- B. COORDINATE ALL WORK WITH THE GENERAL CONTRACTOR AND DOOR INSTALLER.
- C. REFER TO FLOOR PLANS FOR ADDITIONAL INFORMATION AND REQUIREMENTS

② TYPICAL DOOR ACCESS CONTROL

NT

- ① 24" x 24" x 24" PRECAST POLYMER CONCRETE STACKABLE ENCLOSURE, OPEN BOTTOM.
- ② 24" x 24" x 14" STACKABLE EXTENSION, OPEN BOTTOM.
- ③ BOLTED COVER.
- ④ 6" OF #2 CRUSHED STONE BELOW HANDHOLE. EXTEND MINIMUM OF 6" AROUND OUTSIDE EDGE.
- ⑤ SLOPE FINISHED GRADE AWAY FROM COVER.

② HANDHOLE DETAIL

NT


[illegible]

100%	BID DOCUMENTS
------	---------------

The image contains three architectural drawings. On the left is a compass rose with a circle and a vertical line, with the word 'PROJECT' written vertically along the line. In the center is a 'KEY PLAN' showing a rectangular area with a cross-hatch pattern, with a small inset showing a larger context map. On the right is a site plan showing a rectangular area with a cross-hatch pattern, with a small inset showing a larger context map. Below the site plan is a legend with a cross-hatch pattern and the text 'WORK AREA'.

Project: **TOWN OF MONTGOMERY POLICE STATION**
110 BRACKEN ROAD, MONTGOMERY,
NEW YORK 12549

Drawing: ELECTRICAL DETAILS



Reg. Exp: 05/31/2027
 ID Num: 0018443

Project: 23138	Date: 02/24/25
Drawn: KML	Scale: AS NOTED

Drawing Number:

E-702