ELECTRIC WATER HEATER SCHEDULE - TANK TYPE TYPE NOM. RATED INPUT RECOVERY TEMP RISE CAPACITY... STORAGE... KW GAL./HR DEG F **DESIGN MAKE** VOLT HZ PHASE 1 BRADFORD WHITE RE255T3-3 DOMESTIC HW

DHW R	DHW RECIRC PUMP SCHEDULE										
NO.	LOCATION	SERVICE	GPM	HEAD FT WATER	MOTOR HP	VOLTAGE	PHASE	AMP	RPM	TYPE	DESIGN MAKE
RP-1	MECH	DHW RECIRC	0-33	0-29	1/6	115	1	1.8	-	INLINE	ENOVATIVE AUTOHOT DR099A

1. AUTOHOT CONTROLLER DEMAND RECIRCULATION COMPLIANT WITH IECC 2020

THERMOSTATIC MIXING VALVE SCHEDULE									
	VALVE PRESS	. DROP & FLOW	NAINI	(CONNECTION	S			
NO.	5 PSI	20 PSI	MIN. GPM	HW INLET	CW INLET	MIXED OUTLET	DESIGN MAKE	NOTES	
TMV-1	50 GPM	101 GPM	5.0	1-1/2"	1-1/2"	1-1/2"	POWERS LFIS150VL	DIGITAL MIXING VALVE	
NOTES:									

1. MINIMUM GPM IS TO COMPLY WITH ASSE 1017.

IXTURE AND EQUIPMENT CONNECTION SCHEDULE										
DESIGNATION	DESCRIPTION	COLD WATER	HOT WATER	WASTE/ SANITARY/ STORM	VENT	REMARKS				
FD-A	FLOOR DRAIN	-	-	4"	2"	JAY R. SMITH FIG. #2010				
LAV-A	LAVATORY - WALL HUNG	1/2"	1/2"	2"	1-1/2"	AS SPECIFIED				
LAV-B	LAVATORY - DROP IN	1/2"	1/2"	2"	1-1/2"	AS SPECIFIED				
LAV-C	LAVATORY - WALL HUNG	1/2"	1/2"	2"	1-1/2"	ANTI-LIGATURE. SEE SPECIFICATION				
MB-A	MOP BASIN	1/2"	1/2"	3"	2"	AS SPECIFIED				
SH-A	SHOWER	1/2"	1/2"	2"	1-1/2"	ROLL-IN, ADA				
SK-A	SINK	1/2"	1/2"	2"	1-1/2"	AS SPECIFIED				
SK-B	SINK	1/2"	1/2"	2"	1-1/2"	AS SPECIFIED				
UR-A	URINAL	3/4"	-	2"	1-1/2"	AS SPECIFIED				
UR-B	URINAL (ADA)	3/4"	-	2"	1-1/2"	AS SPECIFIED				
WC-A	WATER CLOSET - WALL HUNG	1"	-	4"	MIN 2"	PROVIDE SHOCK ABSORBER				
WC-B	WATER CLOSET - WALL HUNG (ADA)	1"	-	4"	MIN 2"	PROVIDE SHOCK ABSORBER				
WC-C	WATER CLOSET - WALL HUNG	1"	-	4"	2"	ANTI-LIGATURE. SEE SPECIFICATION				
RD-A	ROOF DRAIN - PRIMARY	-	-	SEE PLAN	-	AS SPECIFIED				
RD-B	ROOF DRAIN - SECONDARY	-	-	SEE PLAN	-	AS SPECIFIED				
WH-A	WALL HYDRANT	3/4"	-	-	-	AS SPECIFIED				

SHOCK ABSORBER SCHEDULE							
NO.	FIXTURE UNIT RATING	SIZE IN INCHES	PDI SYMBOL				
SA-A	1 - 11	1/2"	А				
SA-B	12 - 32	3/4"	В				
SA-C	33 - 60	1"	С				
SA-D	61 - 113	1 1/4"	D				
SA-E	114 - 154	1 1/2"	Е				
SA-F	155 - 330	2"	F				

	PLUMBING SYMBOL LIST						
SYMBOL	DESCRIPTION						
•	POINT OF CONNECTION						
NTS	NOT TO SCALE						
(E)	EXISTING						
(ETR)	EXISTING TO REMAIN						
AFF	ABOVE FINISHED FLOOR						
BFF	BELOW FINISHED FLOOR						
VTR	VENT THRU ROOF						
GC	GENERAL CONTRACTOR						
MC	MECHANICAL CONTRACTOR						
PC	PLUMBING CONTRACTOR						
EC	ELECTRICAL CONTRACTOR						
—— (E) ——	EXISTING PIPING						
()	NEW PIPING LOCATED ABOVE FLOOR/SLAB						
	NEW PIPING LOCATED BELOW FLOOR/SLAB						
	COLD WATER PIPING (CW)						
	HOT WATER PIPING (HW)						
TW	HOT WATER RECIRCULATING PIPING (HWR)						
	TEMPERED HOT WATER PETURN DIDING (TWR)						
TWR	TEMPERED HOT WATER RETURN PIPING (TWR)						
	WATER SERVICE - EXTERIOR						
	SANITARY SEWER PIPING						
GW	GREASE WASTE PIPING (GW)						
IW	INDIRECT WASTE PIPING (IW)						
ST	VENT PIPING (V)						
	STORM WATER SEWER PIPING (ST)						
	SECONDARY STORM WATER SEWER PIPING (ST(2))						
	NATURAL GAS PIPING (G)						
	ELBOW DOWN						
	45°OFFSET						
O	ELBOW UP						
	BOTTOM/TEE CONNECTION						
	TOP TEE CONNECTION						
	"P" TRAP						
	PIPE CONTINUATION						
	CAP OR PLUG						
—ф	DECK PLATE CLEANOUT (DPCO)						
<u>——</u> сн	WALL PLATE CLEANOUT (WPCO)						
	CLEANOUT (CO)						
	FLOOR DRAIN (FD) / FLOOR SINK (FS)						
<u> </u>	ROOF DRAIN						
	WALL HYDRANT (WH) / HOSE BIBB (HB)						
	STRAINER						
T	WATER METER						
•	SHUT OFF VALVE						
<u></u>	BALANCING VALVE						
	CHECK VALVE						
4	SOLENOID VALVE						
	PRESSURE REDUCING VALVE						
<u></u>	RELIEF VALVE						
\$	SHUT-OFF SWITCH						
	PIPE ANCHOR						
=	PIPE GUIDE						
	UNION						
	BACKFLOW PREVENTER (BFP)						
<u> </u>	SHOWER HEAD						
	SHOCK ABSORBER (SA)						
	RECIRCULATION PUMP						
<u> </u>	THERMOMETER						
- • • • • • • • • • • • • • • • • • • •	PRESSURE GAUGE						
X	DRAWING KEYNOTE						
X	PIPE RISER CALLOUT						
X	I II E NIGEN OALLOOT						





Mechanical/Electrical Engineering Consultants Capital District | Rochester | Buffalo | Syracuse

433 STATE STREET, 4TH FLOOR SCHENECTADY, NY 12305 www.meengineering.com

	REVISIONS:						
NUM.	DATE	DESCRIPTION					

100	%	BID DOCUMENTS

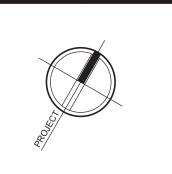

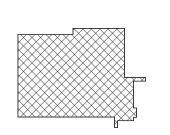

518.533.2171

KEY PLAN

25 WALLKILL AVE • MONTGOMERY • NY 12549 O. 845.294.2724 | F. 888.305.6442 WWW.ADGARCHITECT.COM CONTACT@ADGARCHITECT.COM

ARCHITECTS | ARCHITECTURE • PLANNING • INTERIORS Project: TOWN OF MONTGOMERY POLICE STATION 110 BRACKEN ROAD, MONTGOMERY,

Drawing: GENERAL NOTES & SYMBOLS LIST



NEW YORK 12549

Project:	23138	Date: 02/24/25
Drawn:	CES	Scale: AS NOTEI
Drawing	Number:	

PLUMBING GENERAL NOTES

THESE NOTES ARE APPLICABLE TO THE FULL SET OF CONTRACT DOCUMENTS.

- A. SLEEVE AND SEAL ALL WALL AND FLOOR PENETRATIONS. PROVIDE FIRESTOPPING FOR ALL PENETRATIONS.
- B. MAINTAIN SERVICE CLEARANCES OF ALL EQUIPMENT. ADVISE OTHER TRADES OF THE REQUIRED SERVICE CLEARANCES.
- C. PROVIDE FOR THE DRAINING AND REFILLING OF PIPING SYSTEMS, INCLUDING AIR REMOVAL, RESETTING OF FLUSH VALVES, FLUSHING SYSTEMS OF DIRT AND SCALE CAUSED BY SHUTDOWNS AND
- D. REFER TO EQUIPMENT/ FIXTURE SCHEDULE FOR FINAL CONNECTION
- E. PROVIDE CLEANOUTS AT THE BASE OF ALL STORM, SANITARY

AND WASTE STACKS.

- F. PITCH 4" AND LARGER SANITARY AND WASTE PIPING AT 1/8" PER FOOT UNLESS OTHERWISE NOTED. FOR SANITARY AND WASTE PIPING 3" AND SMALLER PITCH AT 1/4" PER FOOT UNLESS OTHERWISE NOTED.
- G. COORDINATE LOCATION AND ELEVATION OF STORM AND SANITARY LATERALS AND WATER SERVICE WITH THE SITE CONTRACTOR. NO ALLOWANCE WILL BE MADE FOR ADDITIONAL COSTS DUE TO THE CONTRACTORS FAILURE TO COORDINATE TERMINATION POINTS. THE PLUMBING CONTRACTOR IS RESPONSIBLE FOR THE FINAL CONNECTION TO THE SITE UTILITIES.
- H. MINIMUM SIZE OF WASTE PIPING BELOW SLAB SHALL BE 3". MINIMUM SIZE OF VENT PIPING BELOW SLAB SHALL BE 2".
- I. PITCH 4" AND LARGER STORM PIPING AT 1/8" PER FOOT UNLESS NOTED OTHERWISE.



Copyright © all rights reserved - Jason T. Anderson Architect, P.C. / DBA / ADG Architects and Anderson Design Group - Architecture - Planning - Interiors / Unauthorized addition or alteration of this document is a violation of the New York State Education Law.

P-002 DRAWING NOTES

1 GAS GENERATOR BY OTHERS. 2400 CFH. GAS METER BY CENTRAL HUDSON. SEE DETAIL

2 PROVIDE PIPE BOLLARDS AROUND GAS METER PER CENTRAL HUDSON STANDARDS. SEE DETAIL 2/P-504.





Mechanical/Electrical Engineering Consultants Capital District | Rochester | Buffalo | Syracuse

518.533.2171 433 STATE STREET, 4TH FLOOR SCHENECTADY, NY 12305 www.meengineering.com

REVISIONS:						
NUM.	DATE	DESCRIPTION				

100	0%	BID DOCUMENTS

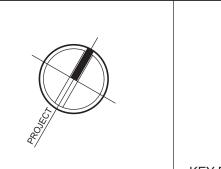

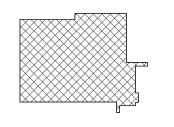

KEY PLAN 25 WALLKILL AVE • MONTGOMERY • NY 12549 O. 845.294.2724 | F. 888.305.6442

WWW.ADGARCHITECT.COM CONTACT@ADGARCHITECT.COM

110 BRACKEN ROAD, MONTGOMERY,

ARCHITECTS | ARCHITECTURE • PLANNING • INTERIORS Project: TOWN OF MONTGOMERY POLICE STATION


Drawing: PLUMBING SITE PLAN


NEW YORK 12549



Project:	23138	Date: 02/24/25
Drawn:	CES	Scale: AS NOTED
Drawing	Number:	



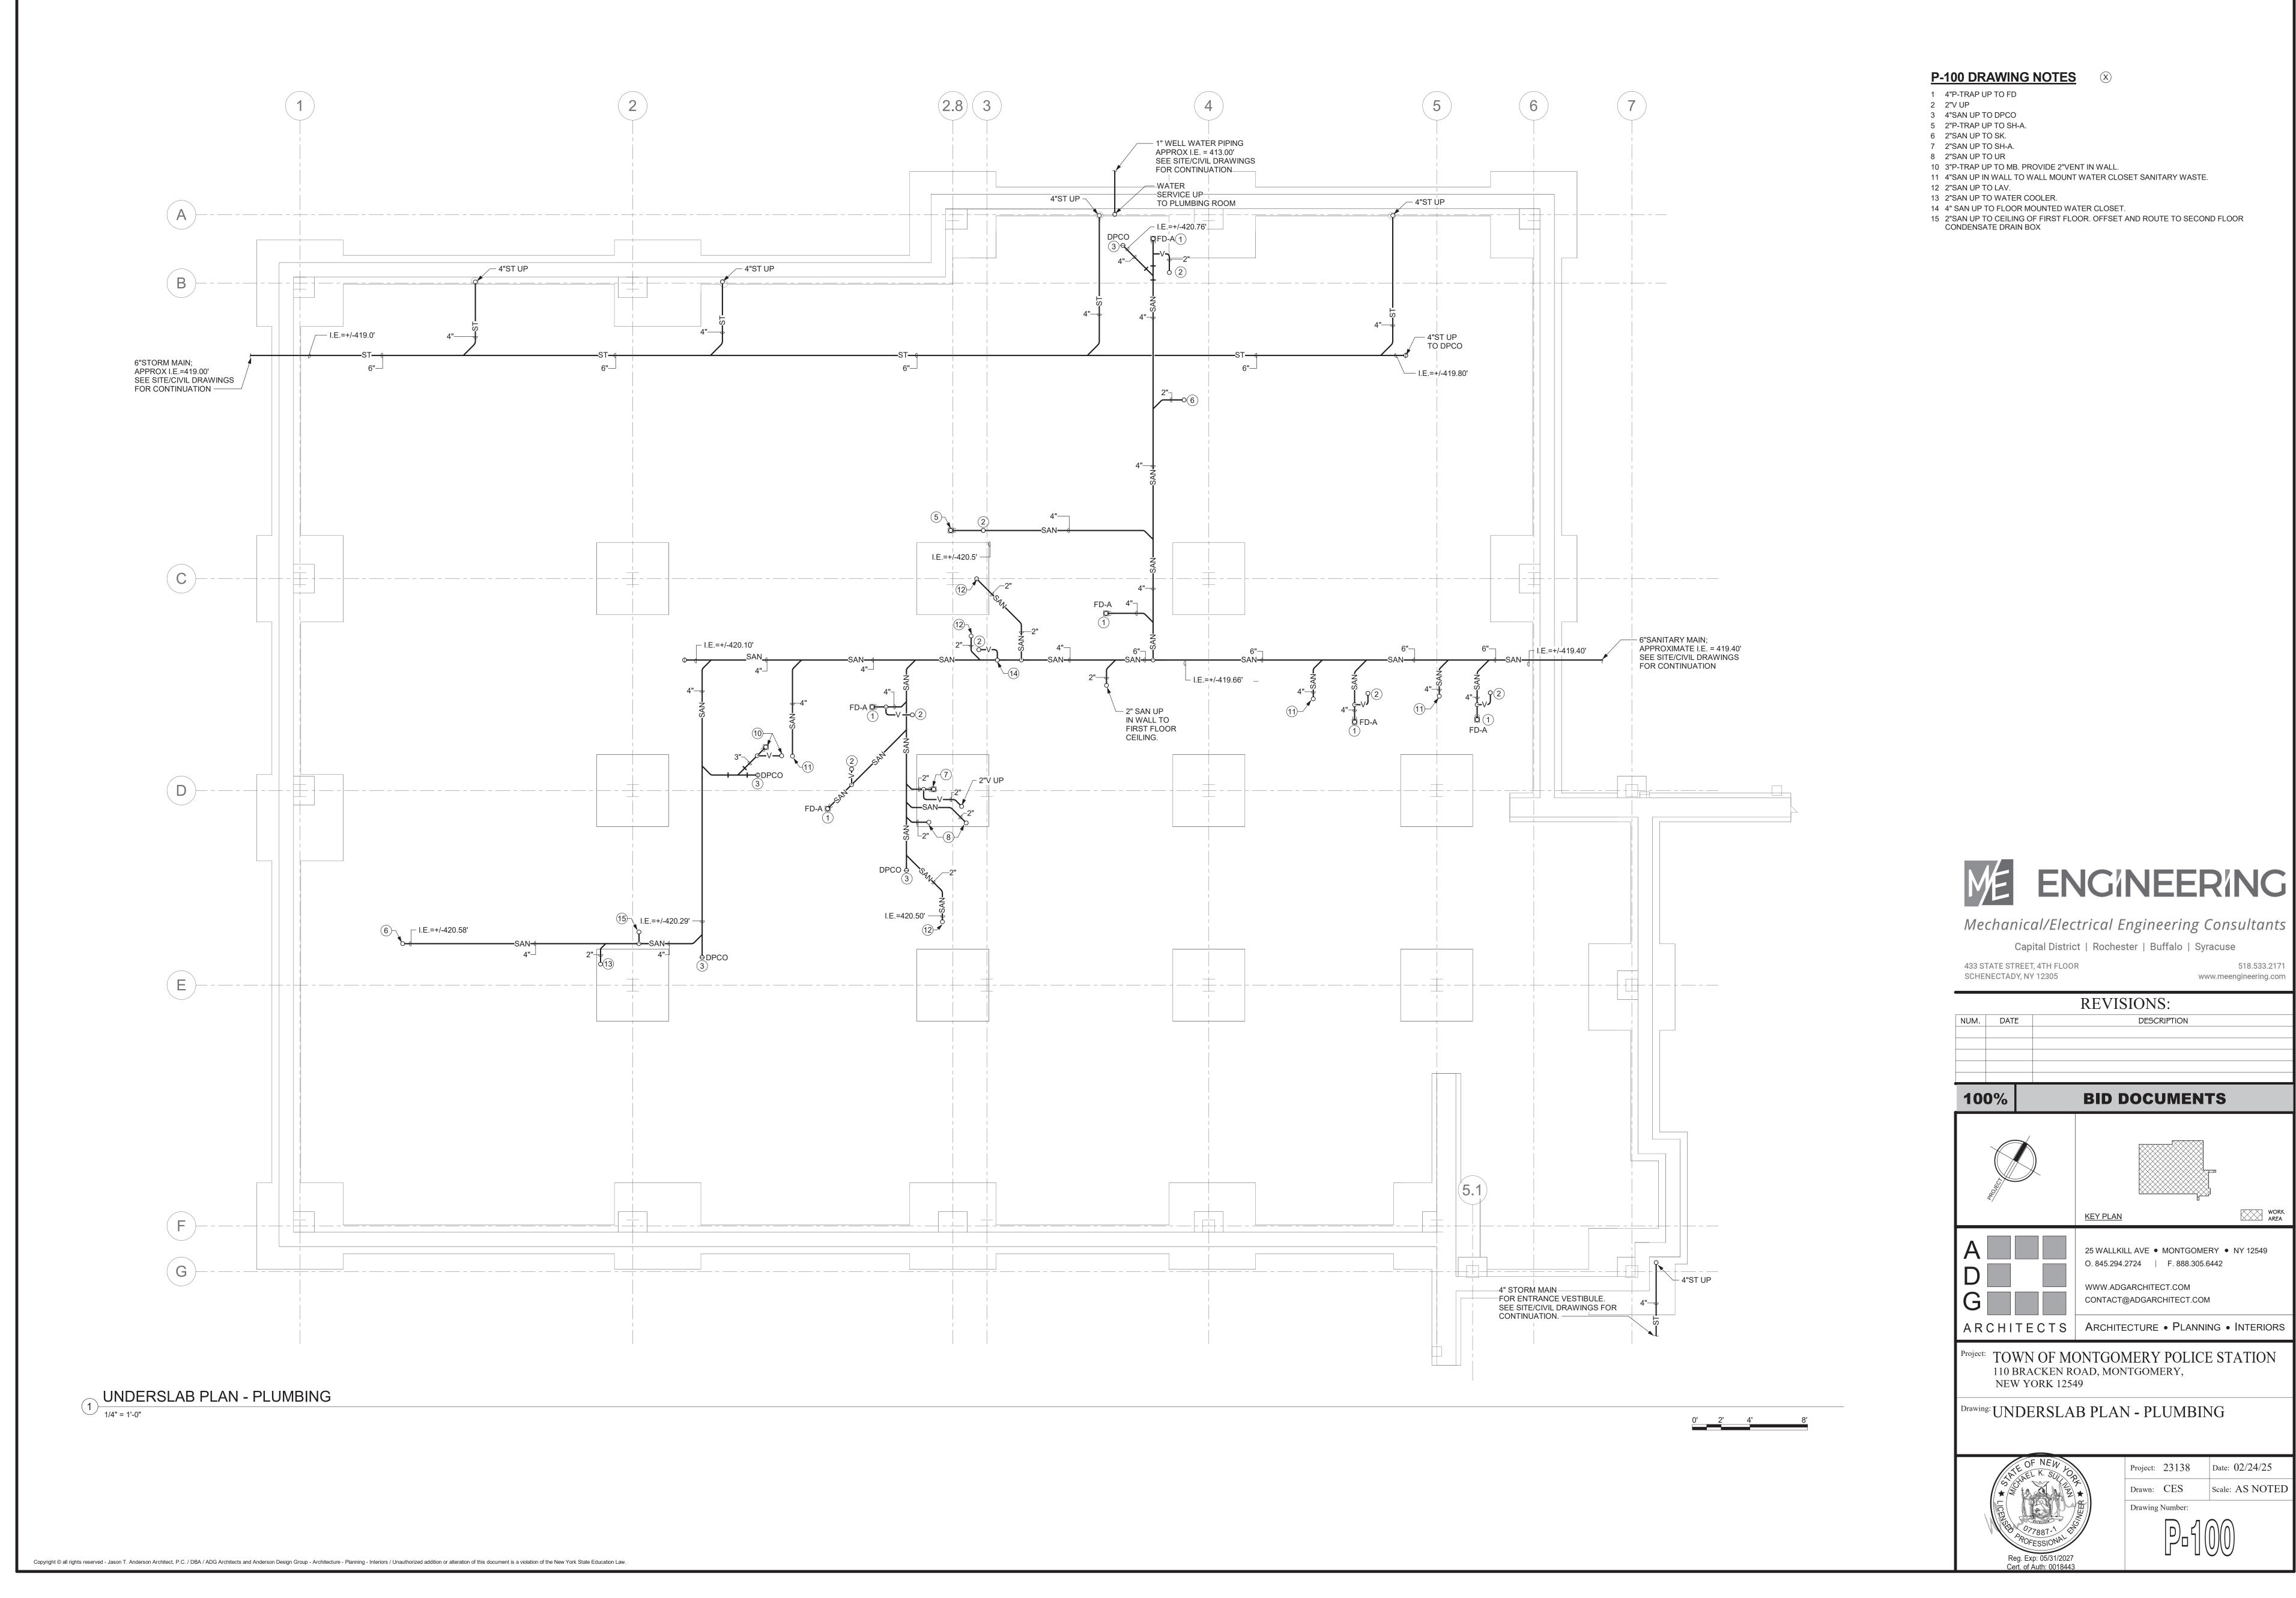

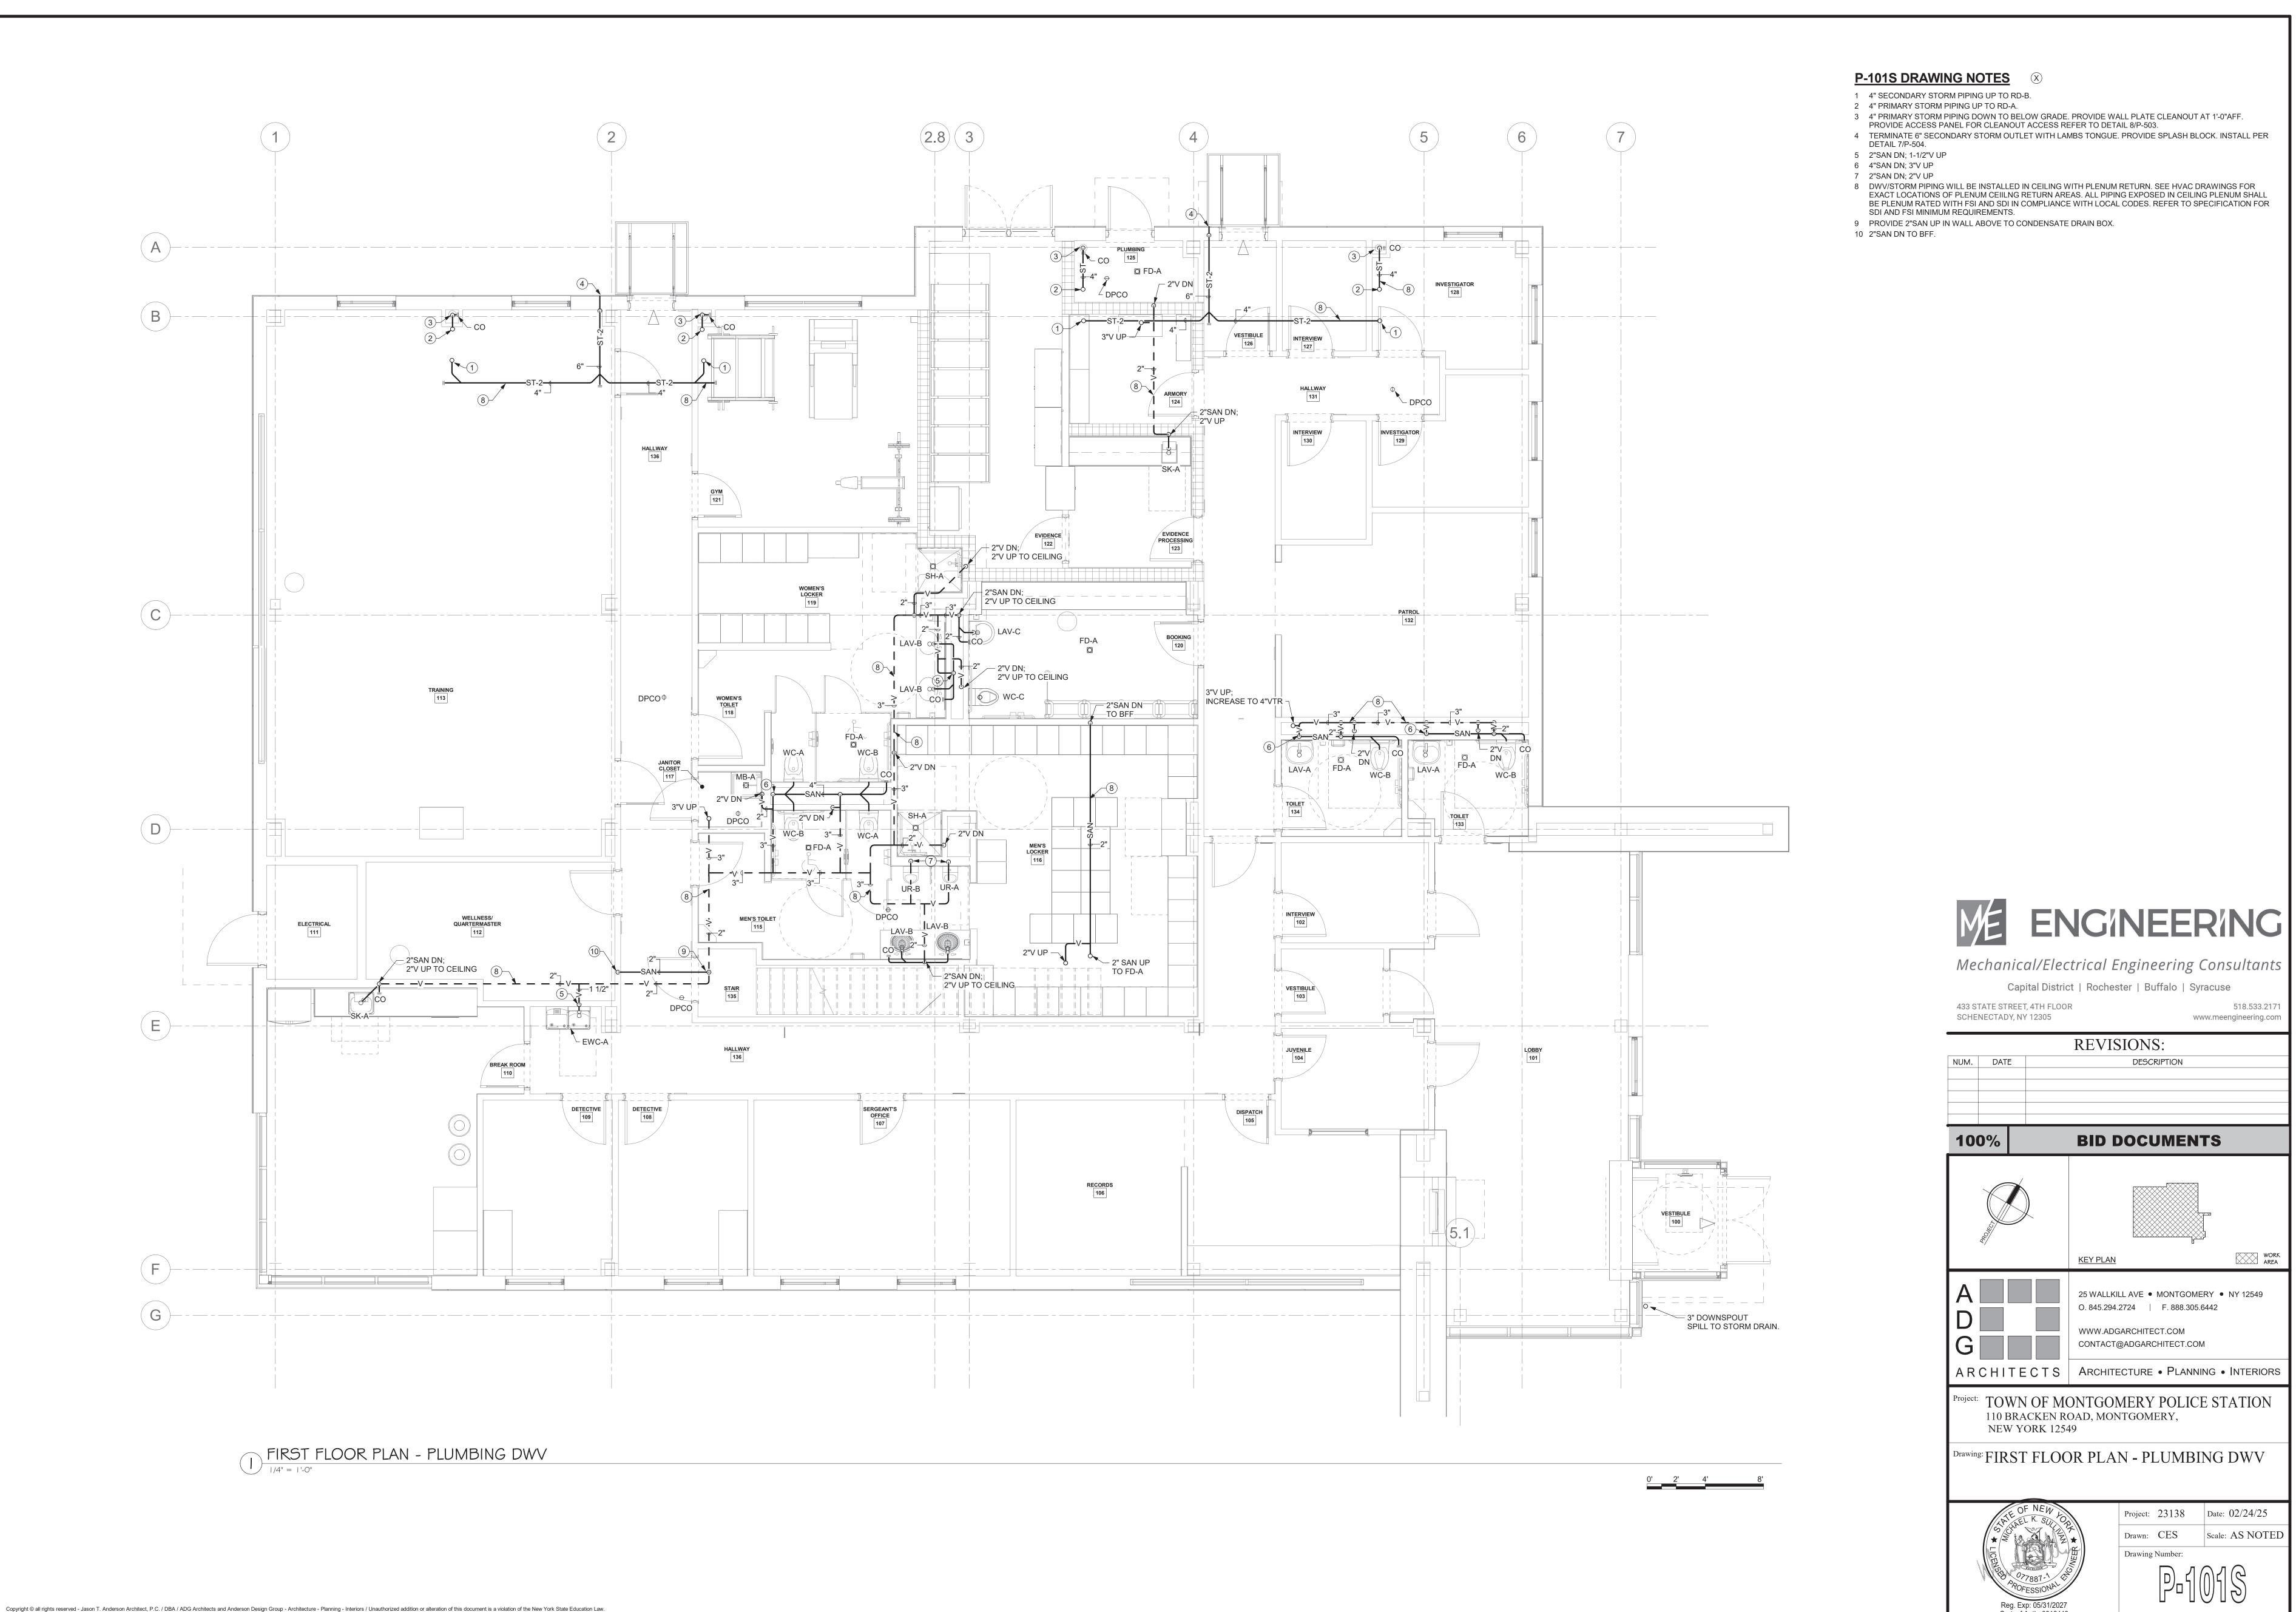

518.533.217

www.meengineering.com


DESCRIPTION

Project: 23138 Date: 02/24/25

Scale: AS NOTED

Drawn: CES

Drawing Number:

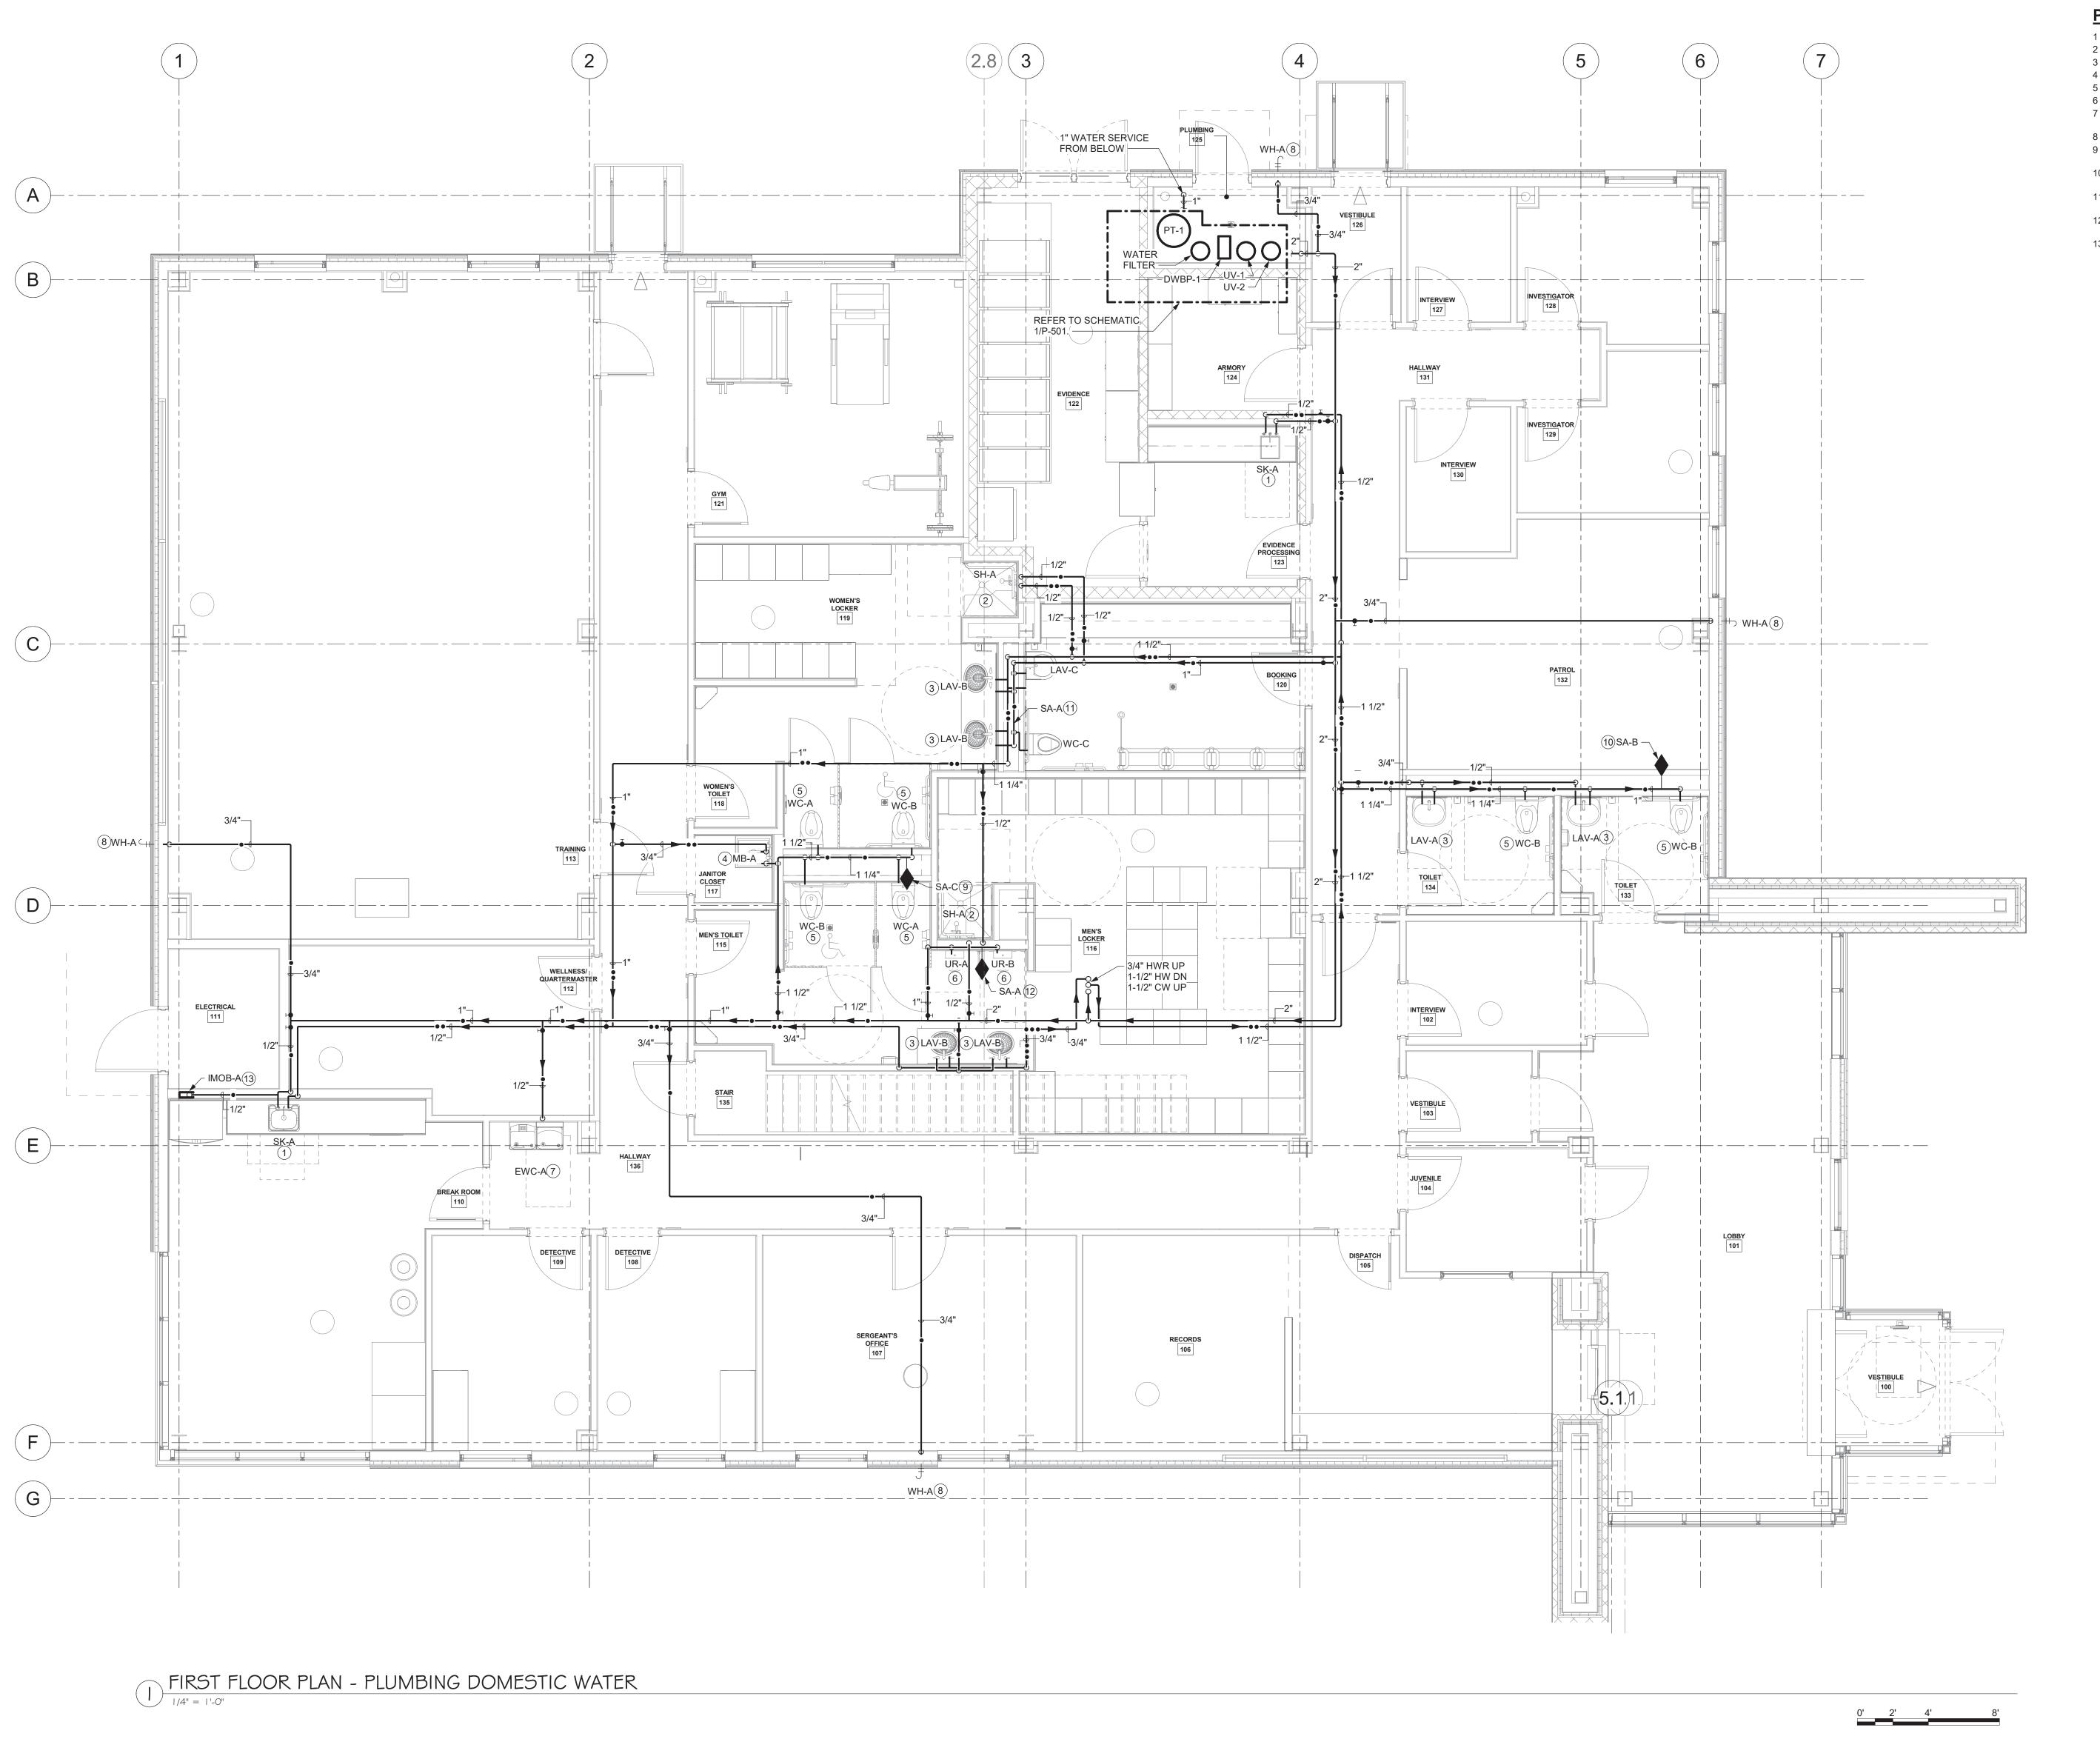

Copyright © all rights reserved - Jason T. Anderson Architect, P.C. / DBA / ADG Architects and Anderson Design Group - Architecture - Planning - Interiors / Unauthorized addition or alteration of this document is a violation of the New York State Education Law.

P-101W DRAWING NOTES

- 1 SK-A: PROVIDE 1/2" HW & 1/2"CW DN. 2 SH-A: PROVIDE 1/2" HW & 1/2"CW DN TO SHOWER VALVE.
- 3 LAV: PROVIDE 1/2" HW & 1/2"CW TO FIXTURE.
- 4 MB: PROVIDE 1/2" HW & 1/2"CW TO FIXTURE. 5 WC: PROVIDE 1"CW TO FIXTURE FLUSH VALVE.
- 6 UR: PROVIDE 3/4"CW TO FIXTURE FLUSH VALVE
- 7 EWC-A: PROVIDE 1/2"CW TO FIXTURE. COORDINATE EXACT LOCATION WITH SPECIFIED FIXTURE MANUFACTURER'S IOM.
- 8 WH-A: PROVIDE 3/4"CW DN TO WALL HYDRANT. REFER TO DETAIL 9/P-503. 9 INSTALL SHOCK ARRESTOR FOR 20 FLUSH VALVE FIXTURE UNITS AT THIS LOCATION. PROVIDE 8"X8"
- ACCESS PANEL FOR SHOCK ARRESTOR SERVICING. 10 INSTALL SHOCK ARRESTOR FOR 16 FLUSH VALVE FIXTURE UNITS AT THIS LOCATION. PROVIDE 8"X8" ACCESS PANEL FOR SHOCK ARRESTOR SERVICING.
- 11 INSTALL SHOCK ARRESTOR FOR 5 FLUSH VALVE FIXTURE UNITS AT THIS LOCATION. PROVIDE 8"X8"
- ACCESS PANEL FOR SHOCK ARRESTOR SERVICING. 12 INSTALL SHOCK ARRESTOR FOR 8 FLUSH VALVE FIXTURE UNITS AT THIS LOCATION. PROVIDE 8"X8"
- ACCESS PANEL FOR SHOCK ARRESTOR SERVICING.
- 13 PROVIDE 1/2" CW TO RECESSED REFRIGERATOR SUPPLY BOX IN WALL. PROVIDE WATERLINE TO REFRIGERATOR.




Mechanical/Electrical Engineering Consultants


Capital District | Rochester | Buffalo | Syracuse

433 STATE STREET, 4TH FLOOR SCHENECTADY, NY 12305

REVISIONS: DESCRIPTION

BID DOCUMENTS

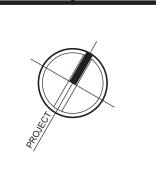

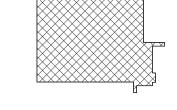

KEY PLAN

www.meengineering.com



25 WALLKILL AVE • MONTGOMERY • NY 12549 O. 845.294.2724 | F. 888.305.6442 WWW.ADGARCHITECT.COM

CONTACT@ADGARCHITECT.COM ARCHITECTS | ARCHITECTURE • PLANNING • INTERIORS


Project: TOWN OF MONTGOMERY POLICE STATION 110 BRACKEN ROAD, MONTGOMERY,


Drawing: FIRST FLOOR PLAN - PLUMBING




NEW YORK 12549


Project: 23138 Date: 02/24/25 Drawn: CES Scale: AS NOTED Drawing Number:

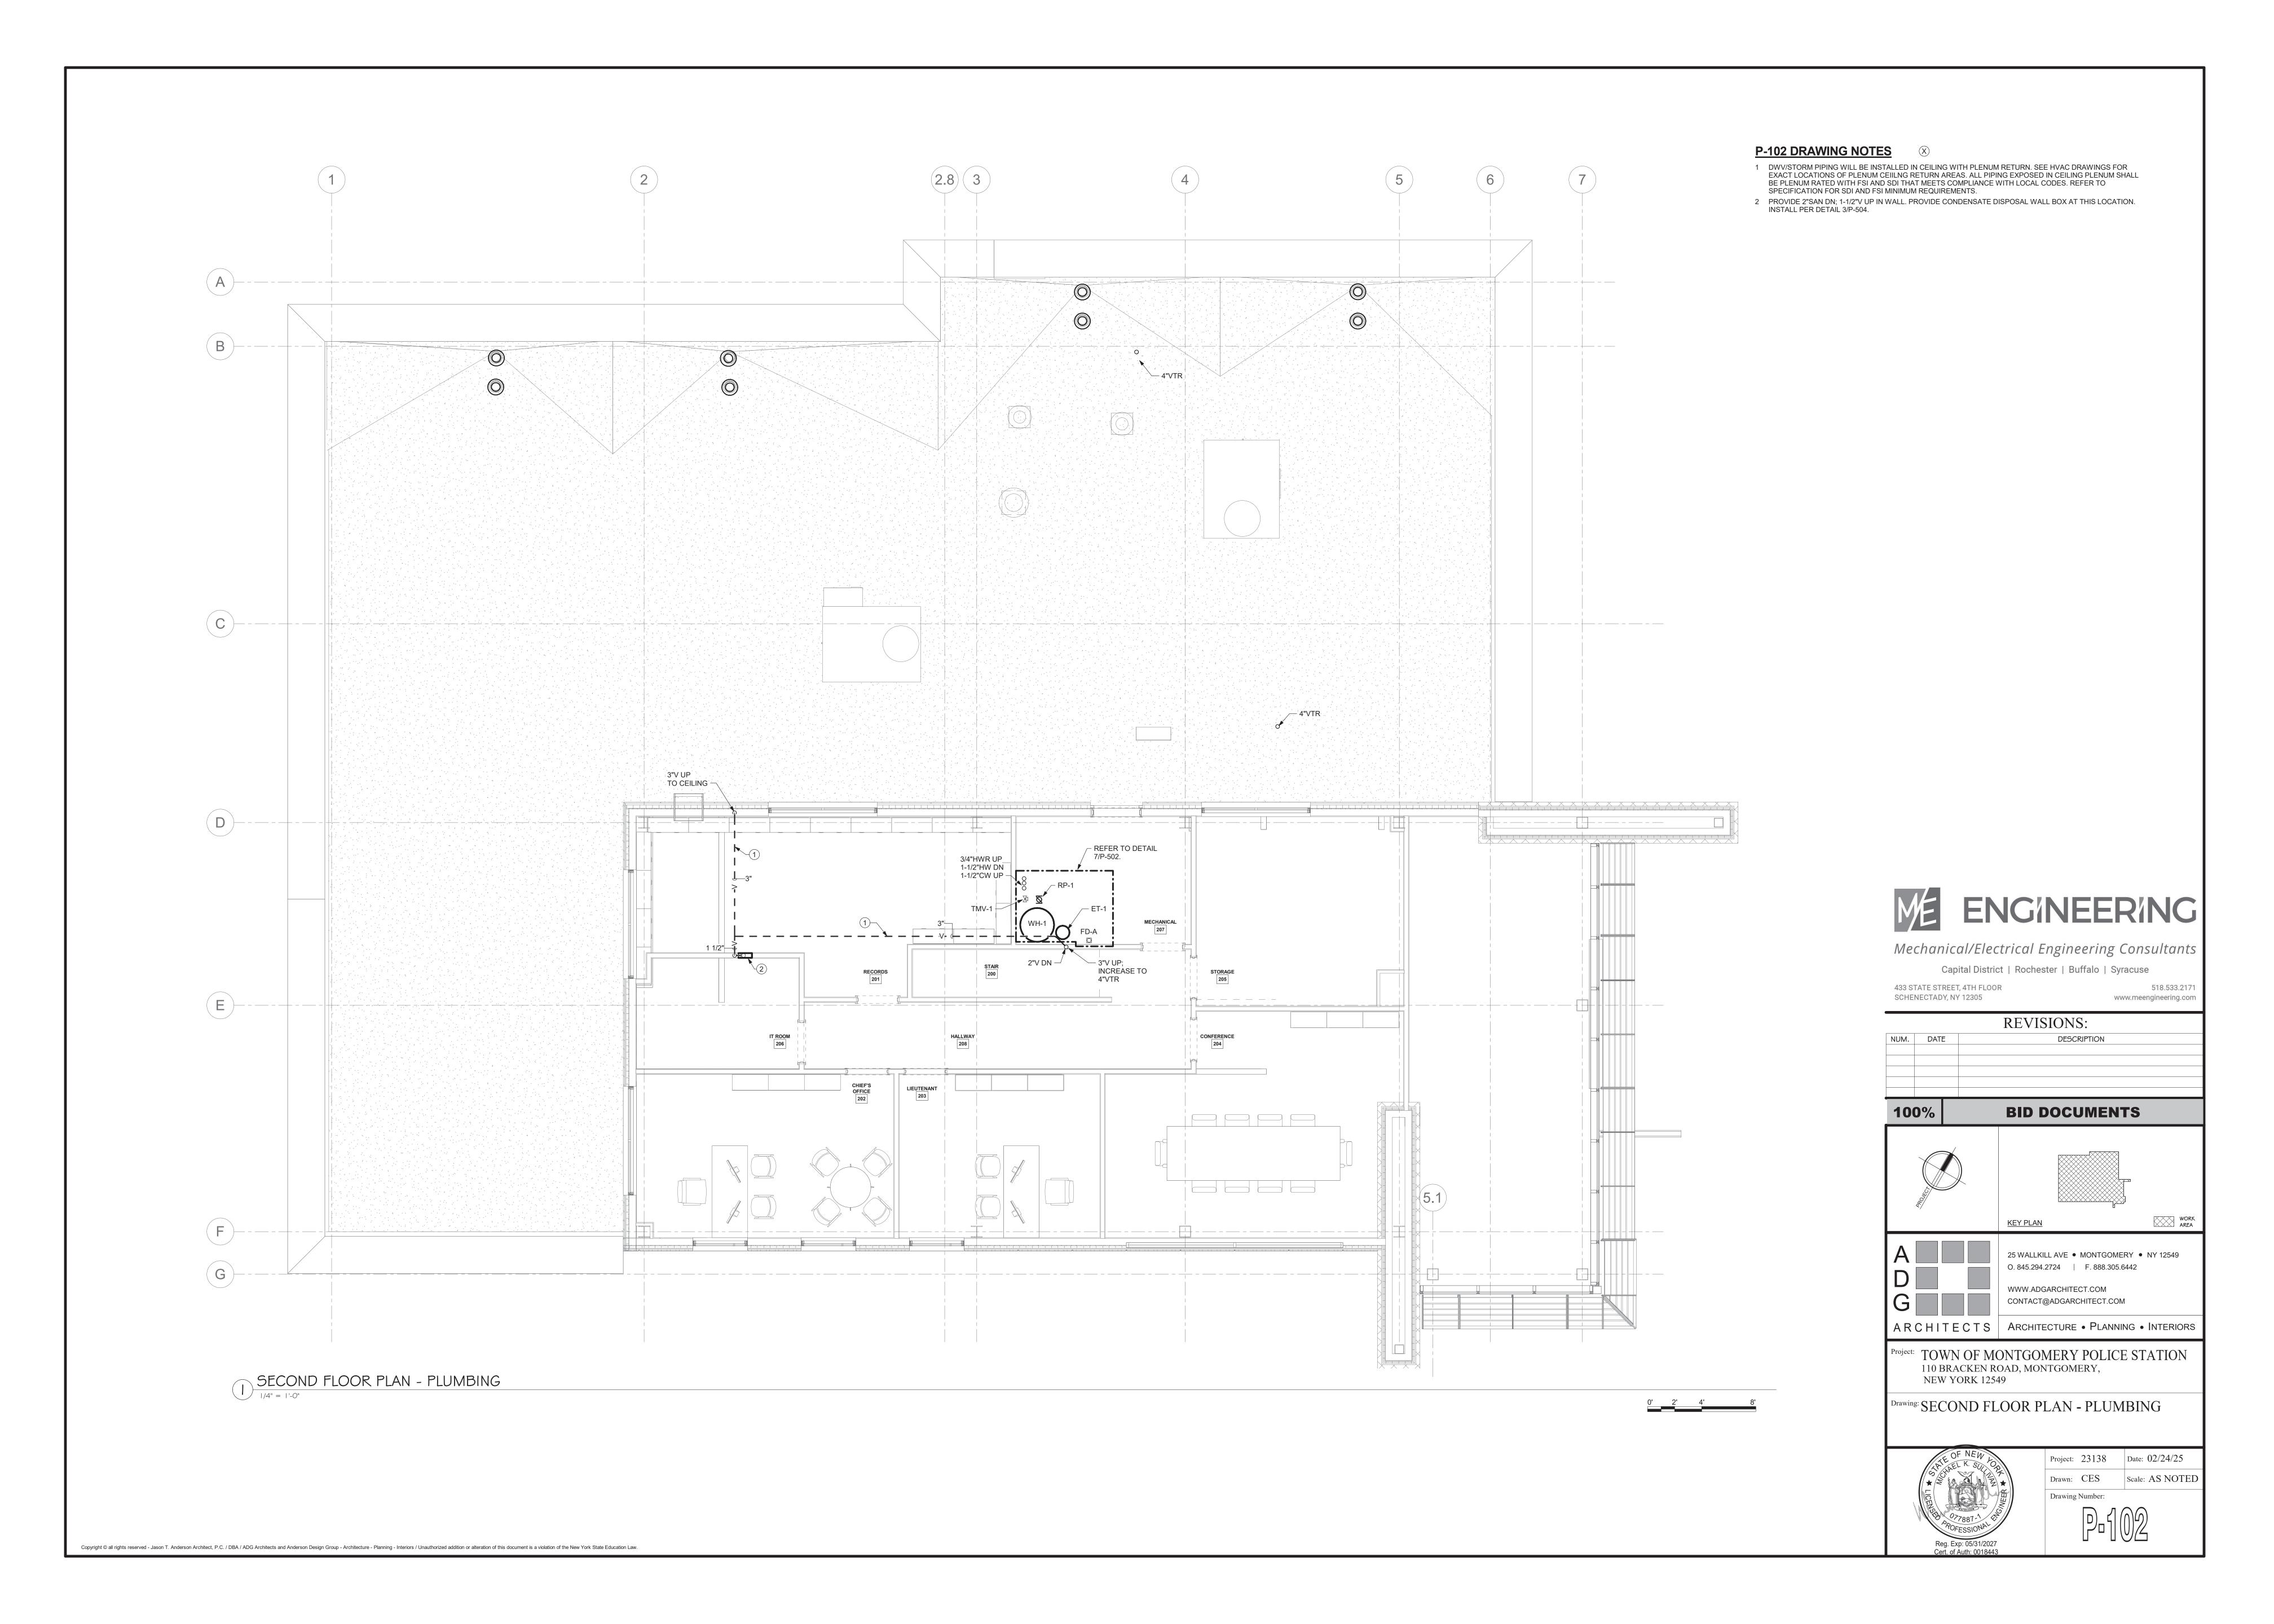

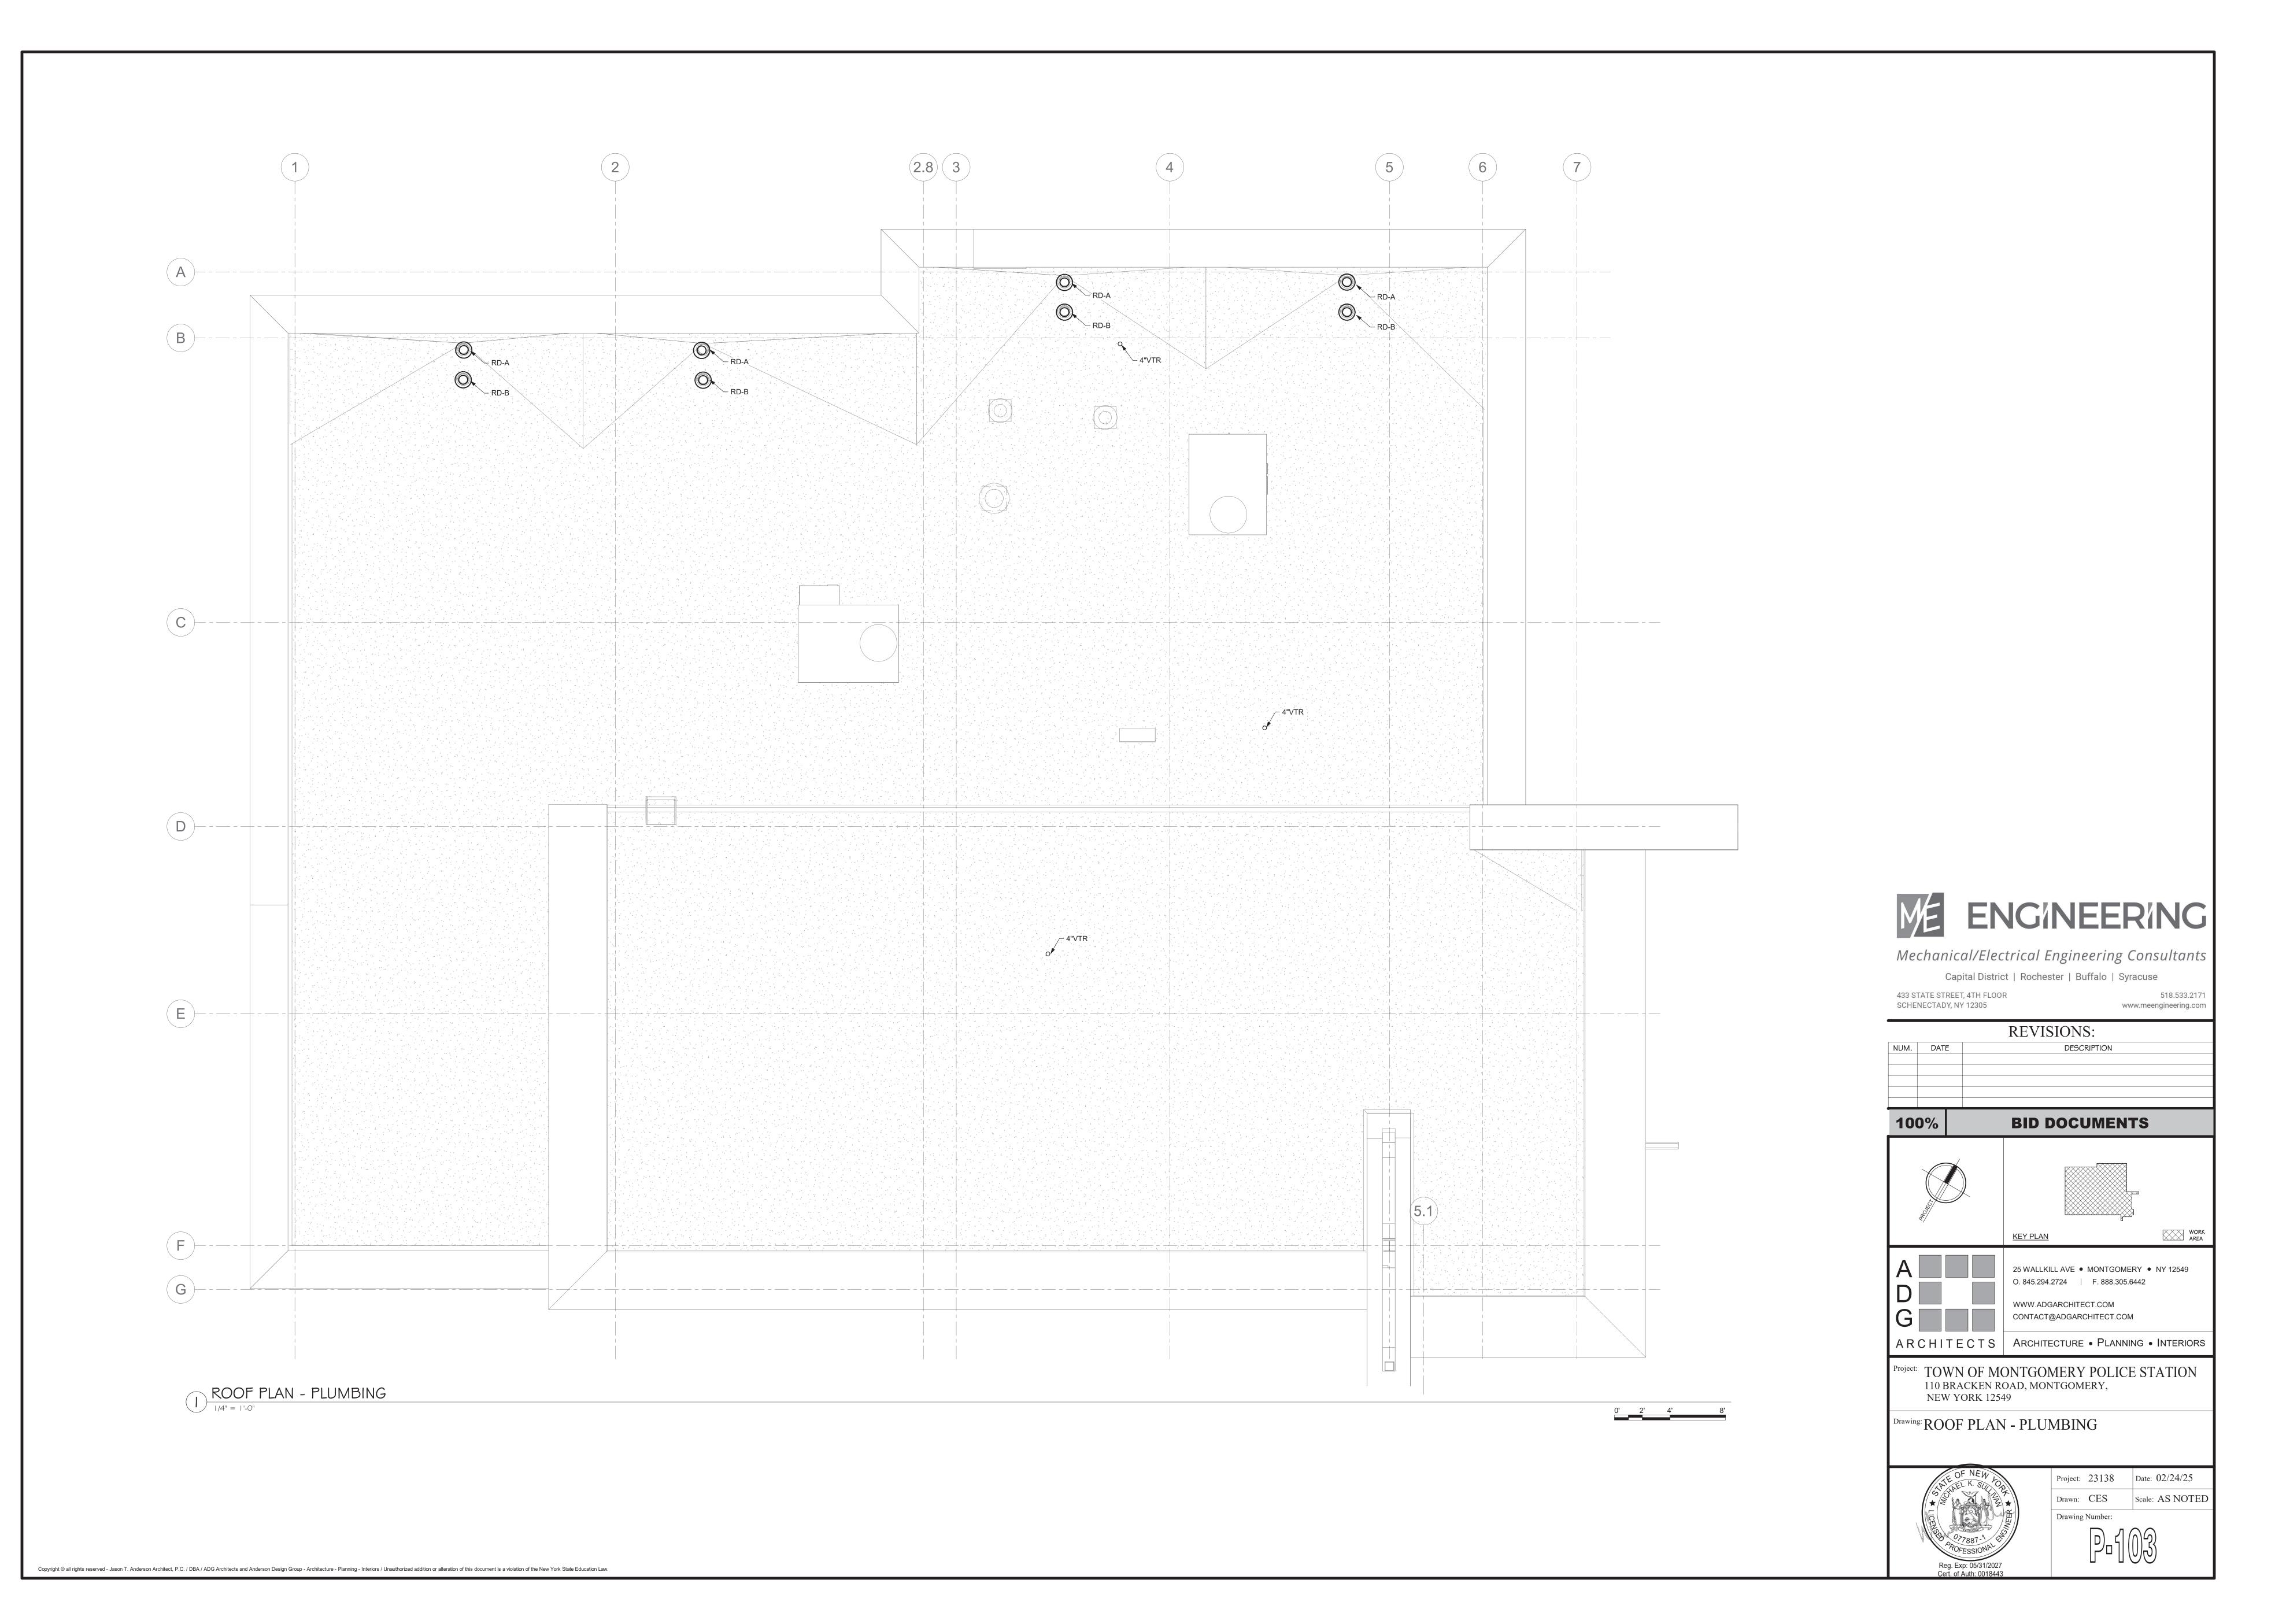

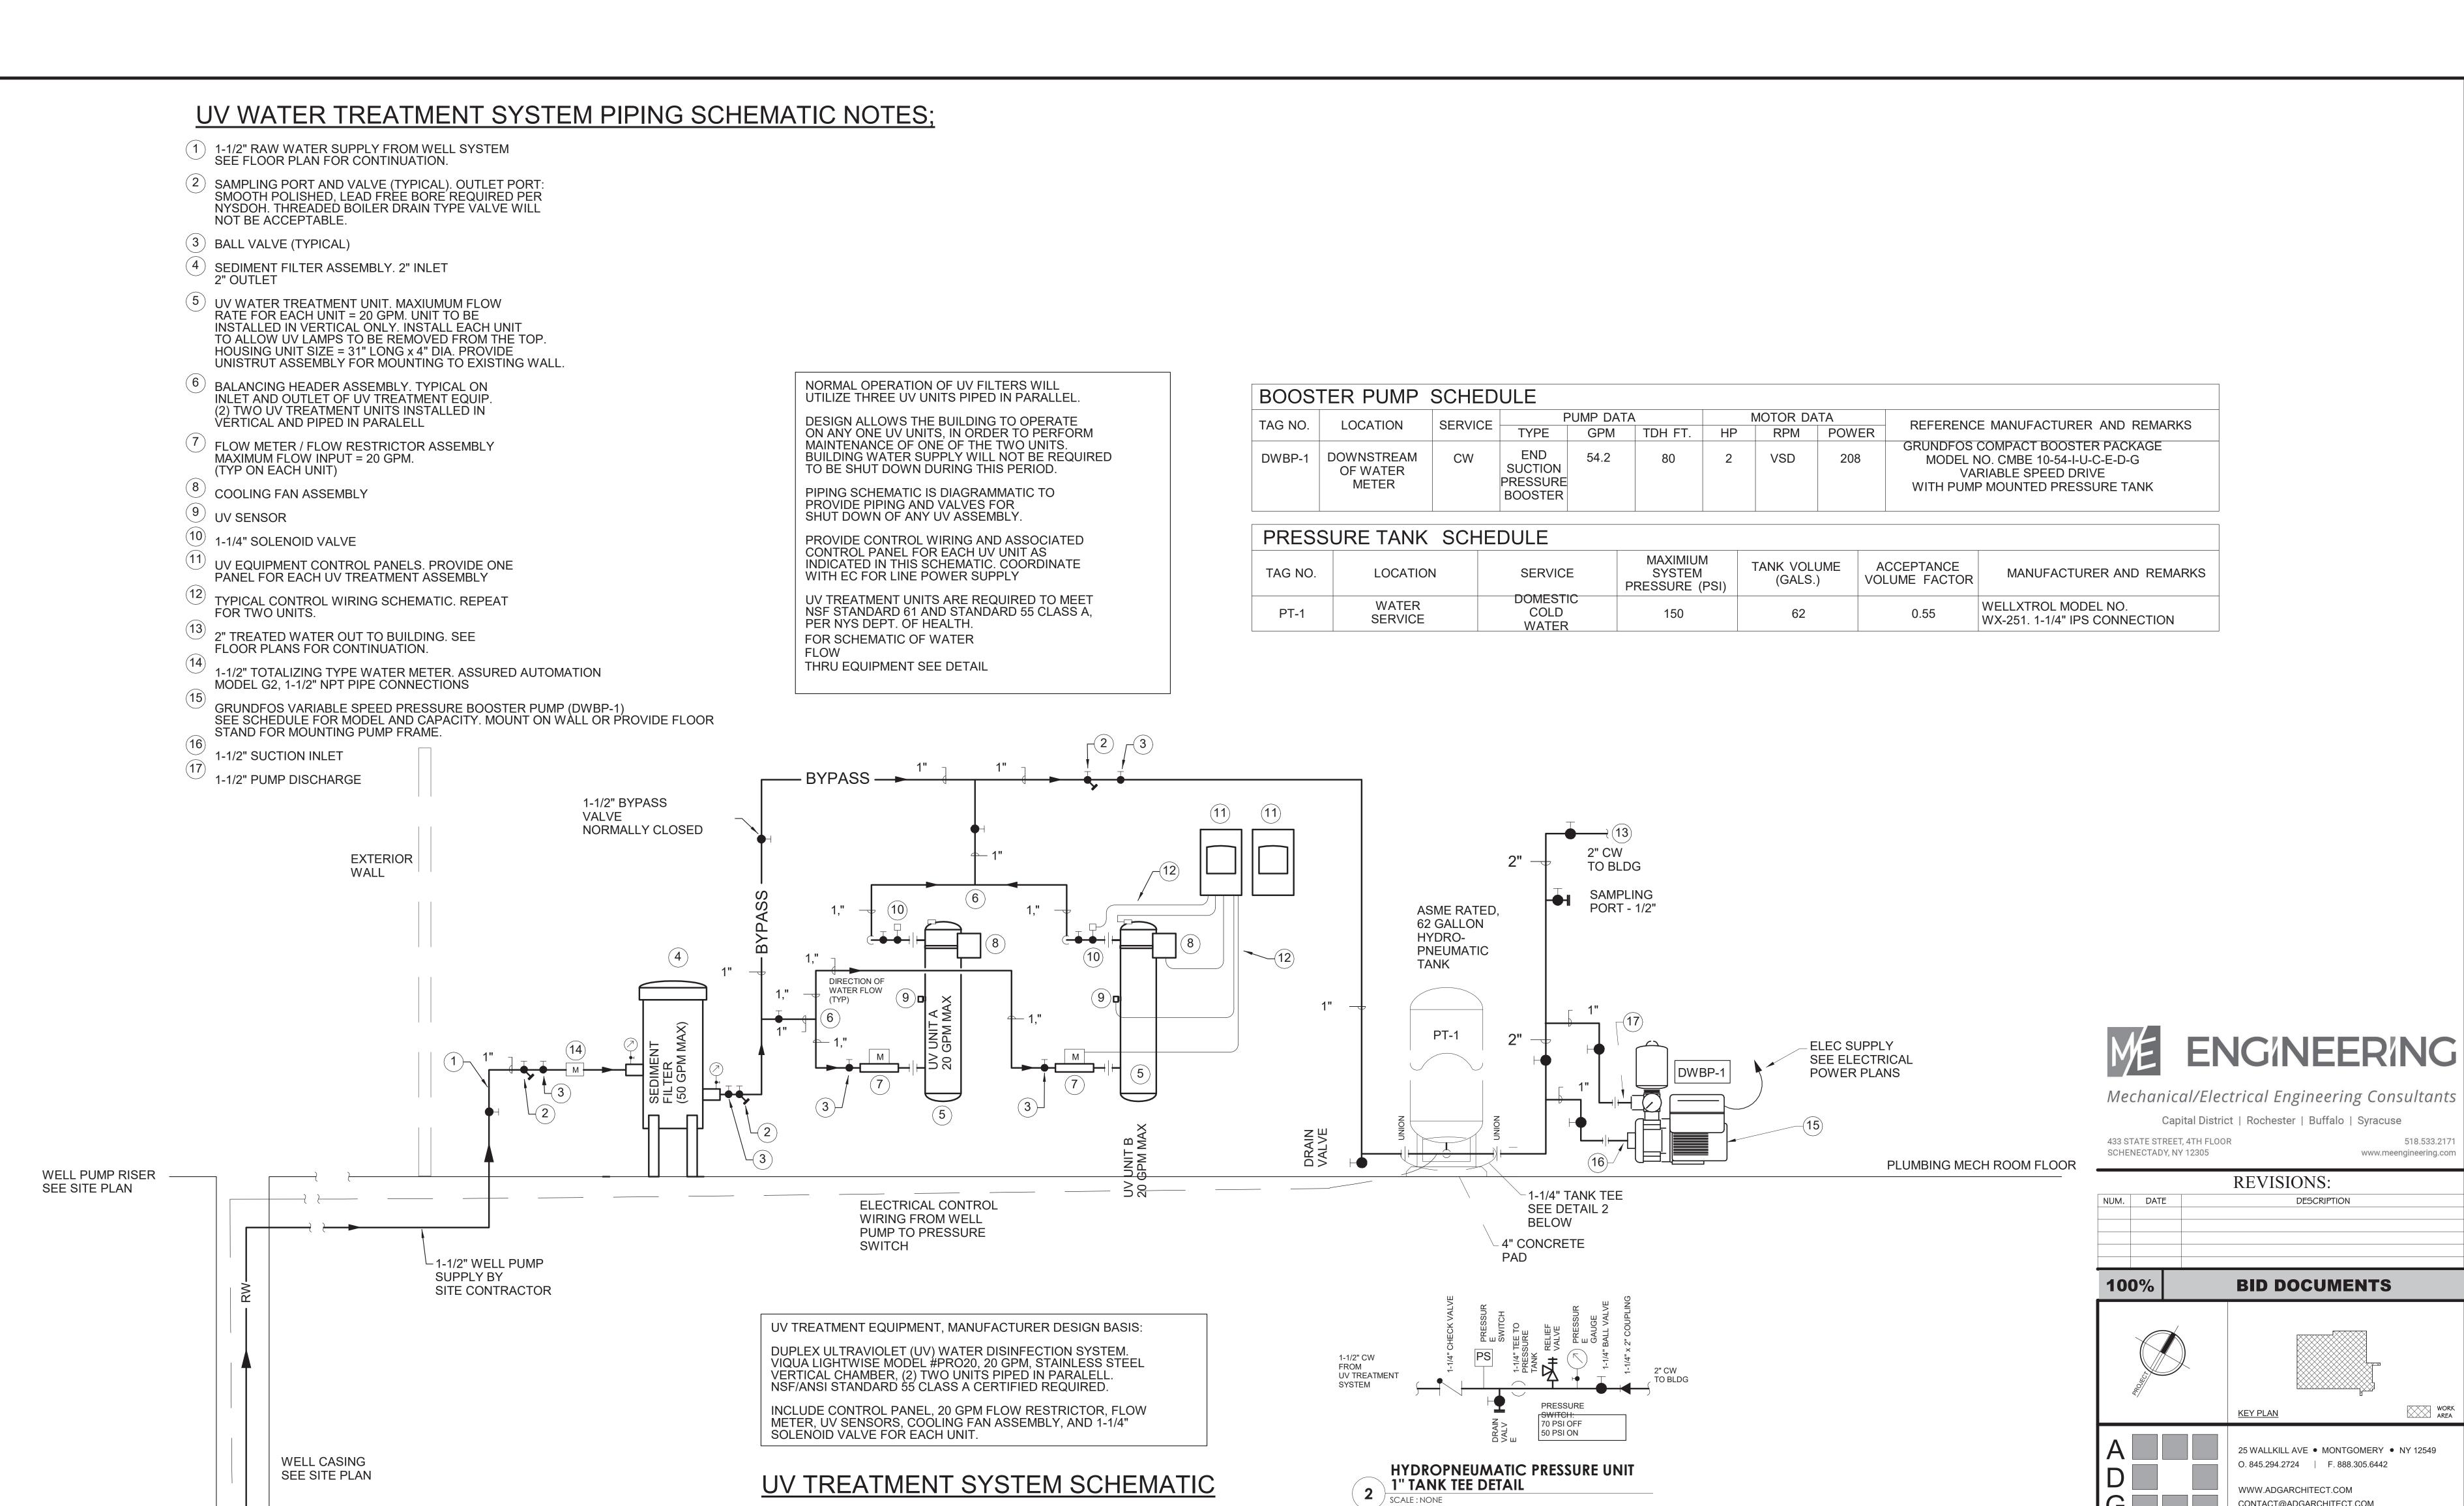

DOMESTIC WATER SERVICE / TREATMENT SCHEMATIC DETAIL ELEVATION

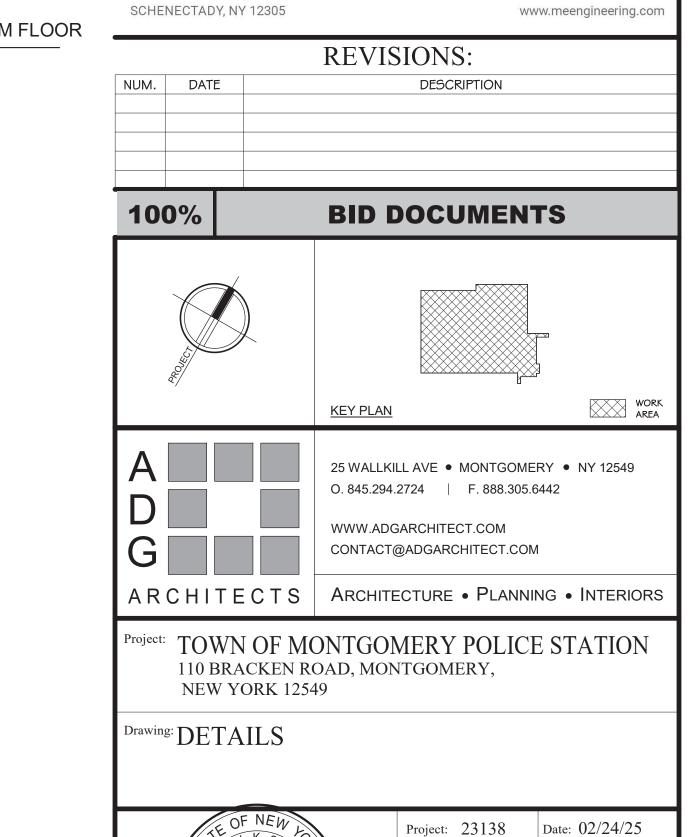

Reg. Exp: 05/31/202

Drawn: CES

Drawing Number:

Scale: AS NOTED

WELL PUMP

BY SITE CONTRACTOR

SEE SITE UTILITY PLANS


SUBMERSIBLE


MINIMUM 30 GPM

NO SCALE

TYPE WELL

DISCHARGE

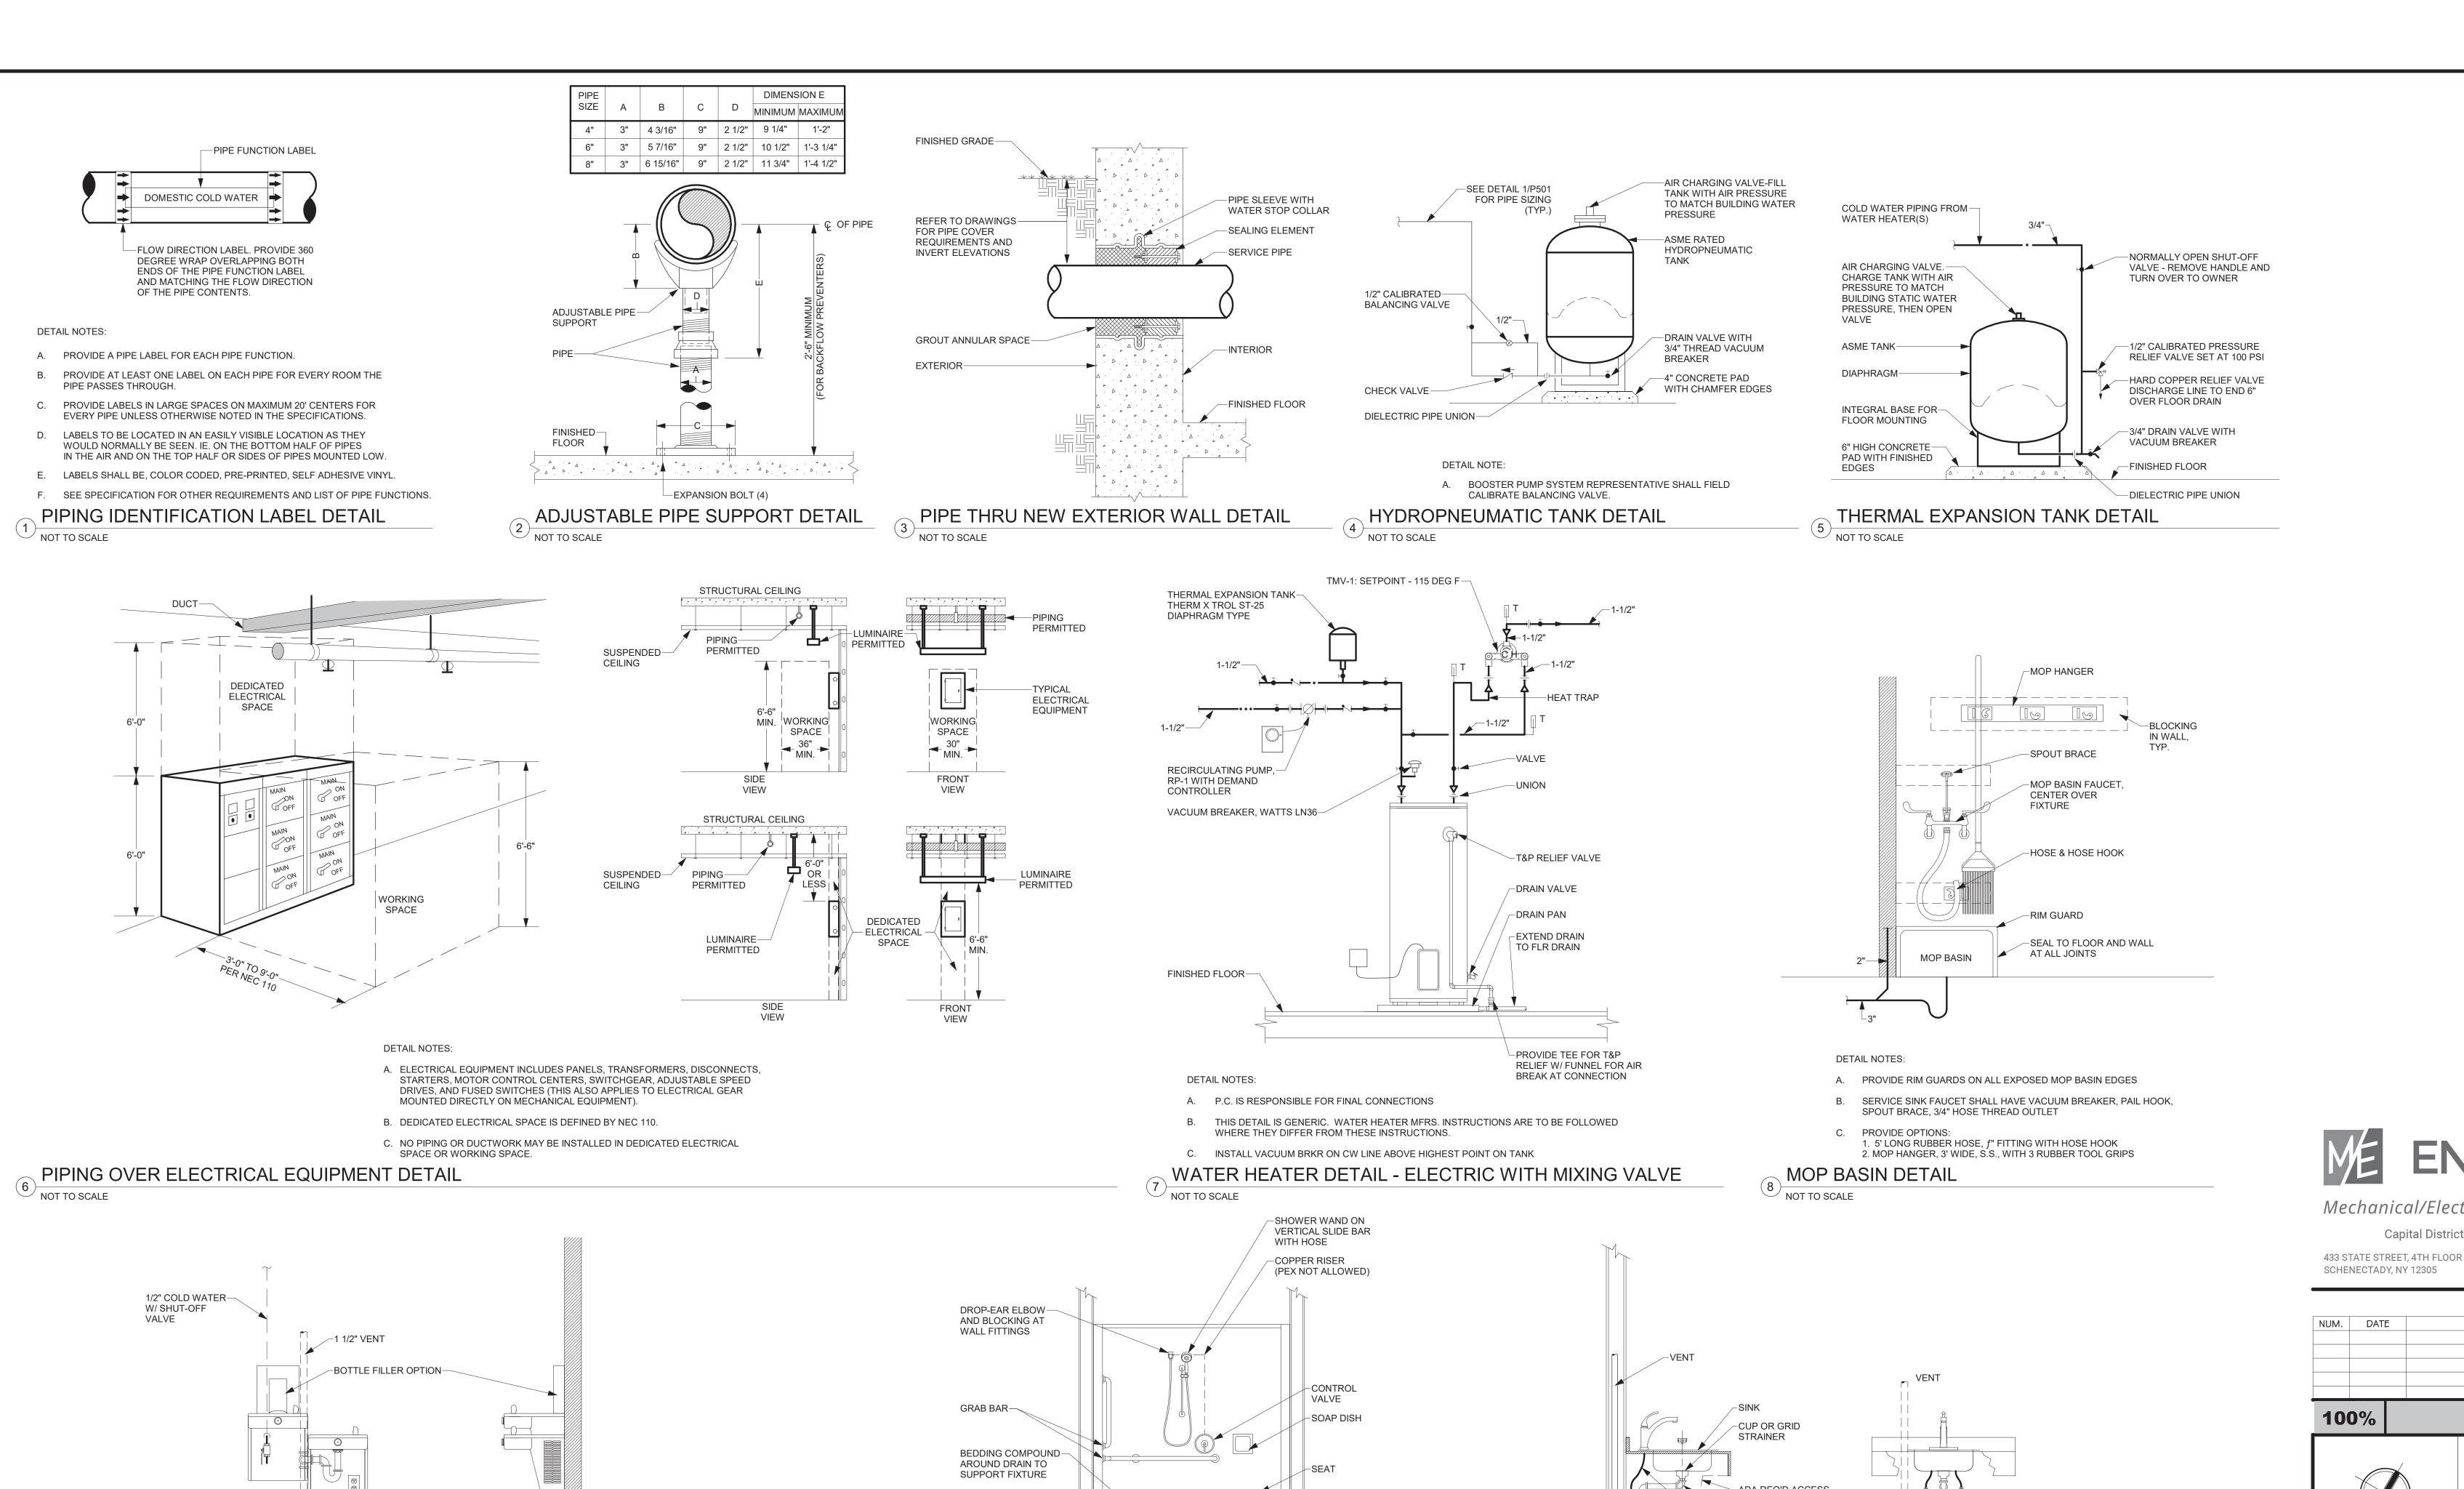

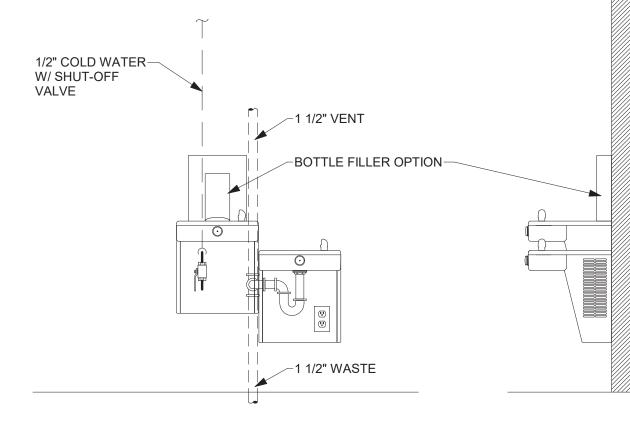

DETAIL NOTES:


A. COORDINATE PIPING WITH ELECTRICAL OUTLET LOCATION

FRONT ELEVATION

- B. CONFIRM TRAP QUANTITY AND ARRANGEMENT WITH EQUIPMENT MFR.
- C. WHEN PROVIDING BOTTLE FILLER OPTION PROVIDE PVC TRAP FOR ELECTRICAL ISOLATION PER MFR.

BI-LEVEL WATER COOLER, ADA WITH BOTTLE FILLER - SURFACE MOUNTED


RIGHT SIDE

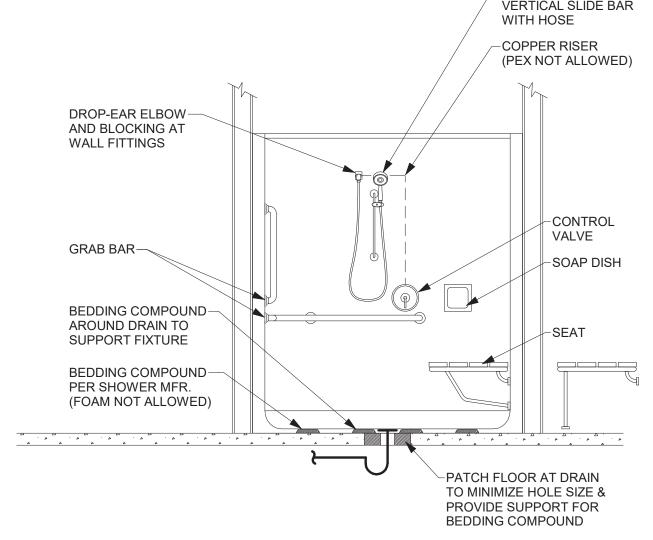

DETAIL NOTES:

- A. FITTING LOCATIONS TO BE PER ARCHITECTURAL DWGS. I.E. SHOWER BAR WITH WAND, VALVE, SOAP DISH
- B. PROVIDE FLOOR DRAIN IN FRONT OF SHOWER
- C. SEE SPECIFICATIONS FOR SHOWER ACCESSORIES D. SET SHOWER VALVE TEMPERATURE STOP FOR 120^F MAXIMUM.

SHOWER INSTALLATION DETAIL - ADA TRANSFER WITH SEAT & BACKWALL HEAD NOT TO SCALE

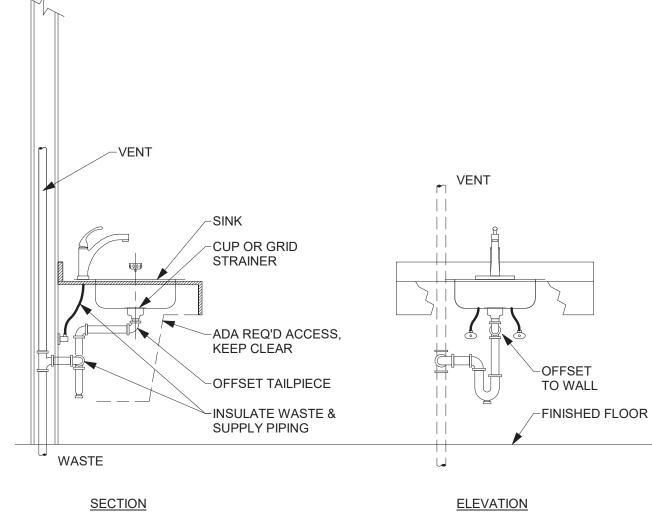

DETAIL NOTES:


- A. PROVIDE ESCUTCHEON AT EACH WALL PENETRATION.
- B. P-TRAP SHALL BE INSTALLED TIGHT TO WALL, AND PARALLEL TO WALL AS SHOWN.
- C. WHERE PIPING IS COVERED BY A KNEE SHIELD PIPE INSULATION MAY BE OMITTED.

SINK INSTALLATION DETAILS - EXPOSED PIPING - ADA NOT TO SCALE



Mechanical/Electrical Engineering Consultants Capital District | Rochester | Buffalo | Syracuse

518.533.217 www.meengineering.com

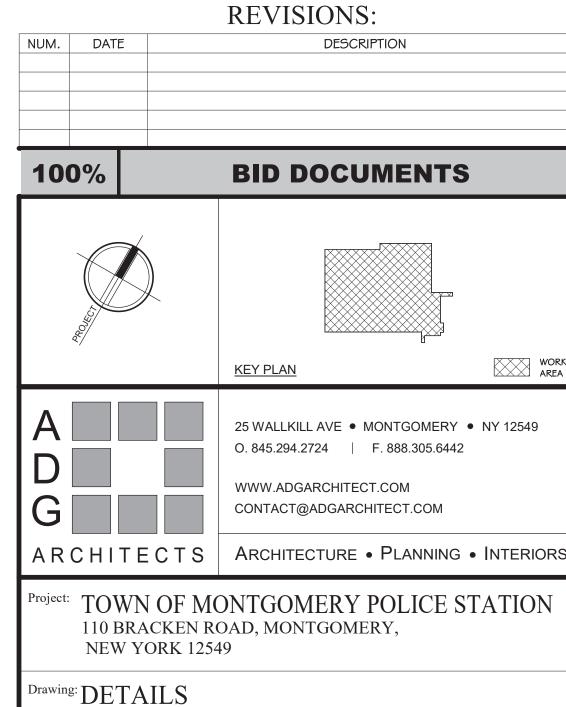


Project: 23138 Date: 02/24/25

Scale: AS NOTED


Drawn: CES

Drawing Number:

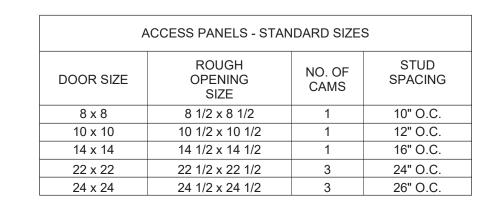

1. SIZES BASED ON MILCOR MODEL DW SERIES

2. ADD 2 INCHES TO DOOR SIZE FOR DIMENSIONS W/ PLASTER FLANGE 3. DOOR IS 16 GAUGE STEEL W/ POWDER COAT PRIMER

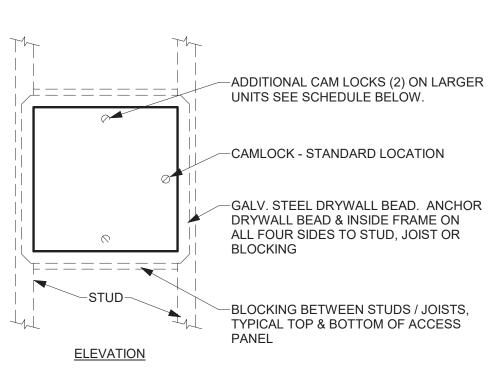


DETAIL NOTES:

- A. ANCHOR PLASTER FLANGE AND INTERIOR FRAME TO STRUCTURE PER MFR
- B. PROVIDE BLOCKING WHERE THERE IS NO STRUCTURAL MEMBER TO ANCHOR FLANGE OR INTERIOR FRAME

NOT TO SCALE

MILCOR - MODEL DW W/ PLASTER FRAME (SHOWN ABOVE) MILCOR - MODEL UFRAD FIRE RATED W/ TRIM FRAME (KEY LOCK OPTIONAL)

ACCESS PANEL DETAIL - FLUSH WITH GYP BOARD WALL/CEILING

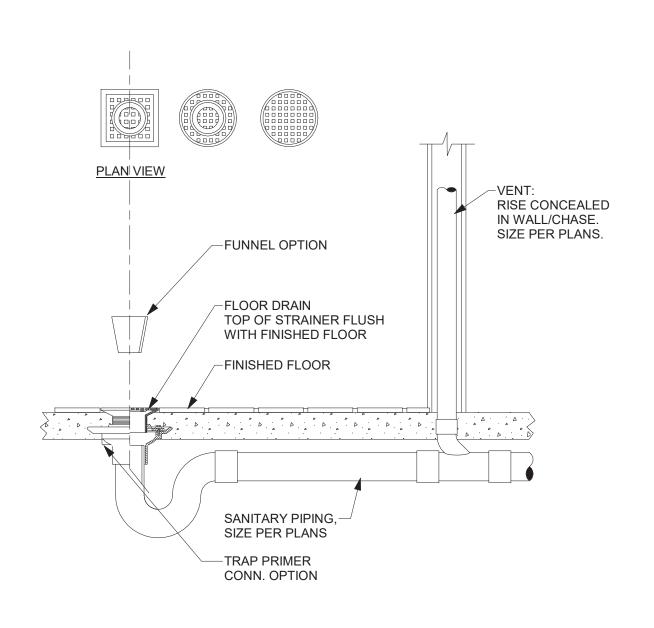


DETAIL NOTES:

 $^{\cdot}$ NOT TO SCALE

- A. PROVIDE TRAP GUARD FITTING.
- B. SEE SPECIFICATIONS FOR: GRATE PATTERN - ROUND, SQUARE
- OPTIONS FUNNEL, TRAP PRIMER CONNECTION
- C. SEE ARCHITECTURAL PLANS FOR FLOOR FINISHES AND SLOPES
- D. DESIGN BASIS: J.R. SMITH #2005, 2010 ROUND OR SQUARE TOP, NICKEL BRONZE RIM AND ADJUSTABLE STRAINER

FLOOR DRAIN DETAIL

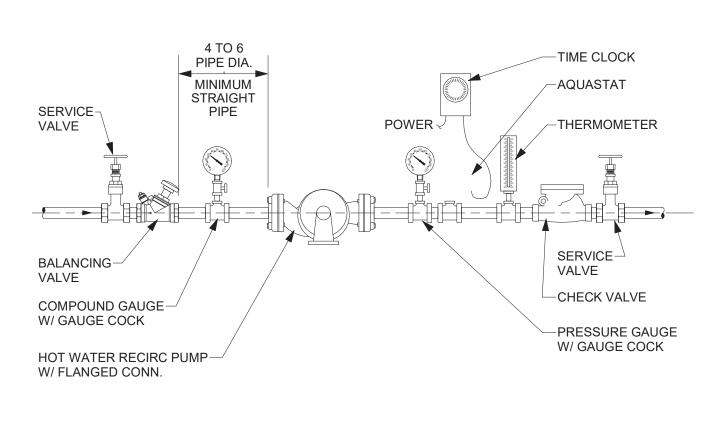


DETAIL NOTES:

- A. PRESSURE GAUGES SELECT GAUGE RANGE TO PLACE MAXIMUM SYSTEM OPERATING PRESSURE IN MIDDLE ONE THIRD OF RANGE.
- B. PROVIDE UNION ON PUMP INLET AND OUTLET IF PUMP IS NOT FLANGED.
- C. PROVIDE TAPERED REDUCER AT PUMP INLET & OUTLET IF REQUIRED. DO NOT USE REDUCING FLANGES.
- D. INSTALL PUMP WITH SHAFT HORIZONTAL. PIPING MAY BE INSTALLED VERTICAL OR HORIZONTAL DEPENDING ON SITE CONDITIONS.
- E. INSTALL CHECK VALVE HORIZONTALLY, OR VERTICALLY WITH FLOW UPWARD.
- F. BALANCING VALVE: SET FLOW TO MATCH PUMP DESIGN.

HOT WATER RECIRCULATION PUMP DETAIL - HORIZONTAL


 $\overset{\cdot}{\smile}$ NOT TO SCALE

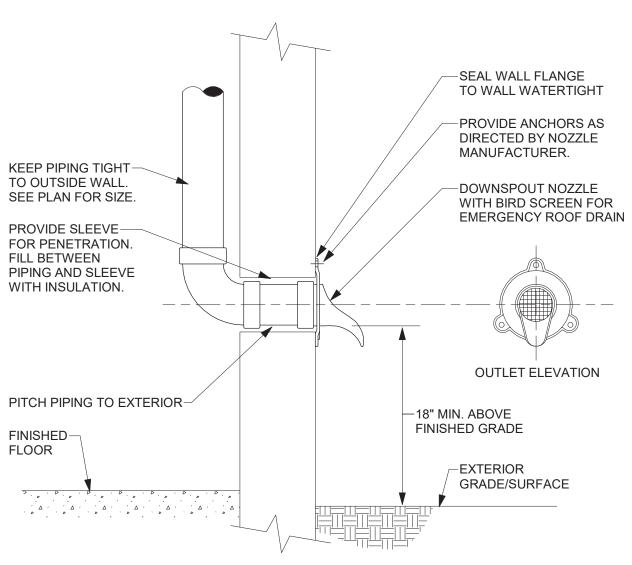

DETAIL NOTES:

- A. OUTLET DESIGN BASIS: JAY R. SMITH #1770 OR ZURN #Z199 BOTH W/ BIRD SCREEN OPTION
- B. CONFIRM FINAL LOCATION AND ELEVATION WITH ARCHITECT BEFORE STARTING INSTALLATION OF OUTLETS.

SECONDARY ROOF DRAIN OUTLET DETAIL 4 NOT TO SCALE

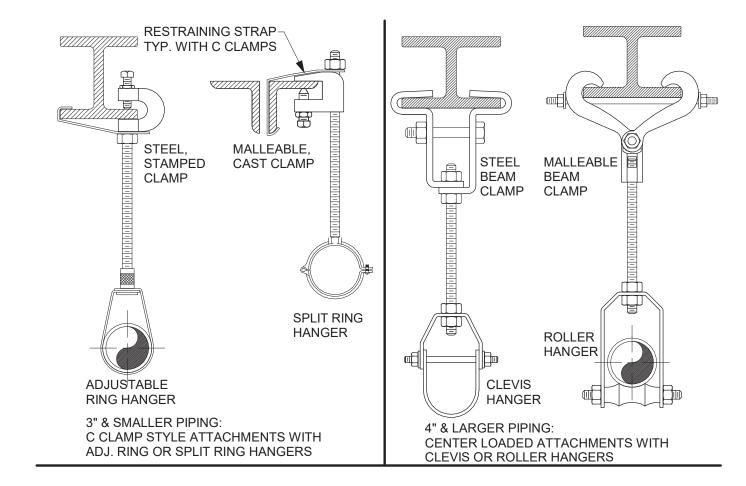


SUPPORT S	CHEDULE						
	PIPE MA	PIPE MATERIAL & SUPPORT SPACING					
PIPE SIZE	STEEL	COPPER	PLASTIC	CAST IRON	ROD SIZE		
3/4" TO 1"	8 FT.	6 FT.	3 FT.	EACH	3/8 IN.		
1 1/4" TO 2"	10 FT.	6 FT.	3 FT.	HORIZONTAL	3/8 IN.		
2 1/2" TO 4"	12 FT.	10 FT.	4 FT.	JT., 5 FT. MAXIMUM	1/2 IN.		
5" TO 6"	12 FT.	10 FT.	4 FT.	SPACING	5/8 IN.		
8"	12 FT.	10 FT.	4 FT.		3/4 IN.		
OVER 8" TO SUIT LOADING CONDITIONS							

DETAIL NOTES:

HORIZONTAL PIPING SUPPORT WITHIN 18 INCHES OF EACH COUPLING JOINT FOR 10 FT. PIPE LENGTHS SUPPORT AT 5 FT. INTERVALS FOR 5 FT. PIPE LENGTHS

- 4 INCH AND LARGER PIPE BRACE AT CHANGES IN DIRECTION TO PREVENT HORIZONTAL MOVEMENT
- INSTALLATIONS REQUIRING MULTIPLE JOINTS WITHIN A FOUR FOOT DEVELOPED LENGTH SHALL BE SUPPORTED AT EVERY OTHER OR ALTERNATING COUPLINGS.
- TYPICAL ELECTROPLATED ZINC OR CADMIUM FINISH
- COPPER PIPING, UNINSULATED COPPER PLATED OR PVC COATED EXTERIOR & WET LOCATIONS, HOT DIPPED GALVANIZED HARDWARE & HANGERS

PIPE HANGER AND SPACING DETAILS - STEEL STRUCTURE NOT TO SCALE

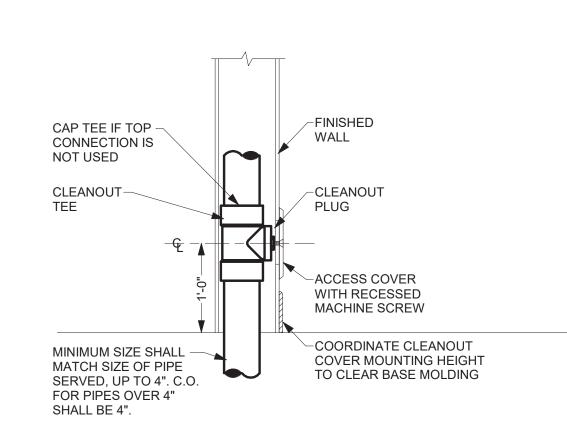


DETAIL NOTES:


- A. ALL CLEANOUTS SHALL BE WALL PLATE TYPE AS SHOWN UNLESS NOTED OTHERWISE ON PLANS.
- B. PROVIDE THICKENED WALL OR CHASE WHERE REQUIRED TO CONCEAL

C. APPROXIMATE CLEANOUT CENTERLINE SHOWN ABOVE.

- STACK / CONDUCTOR.
- WALL CLEANOUT DETAIL

NOT TO SCALE

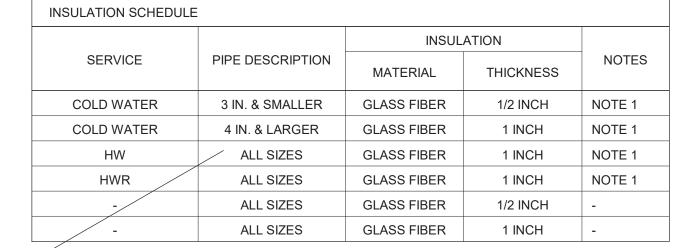


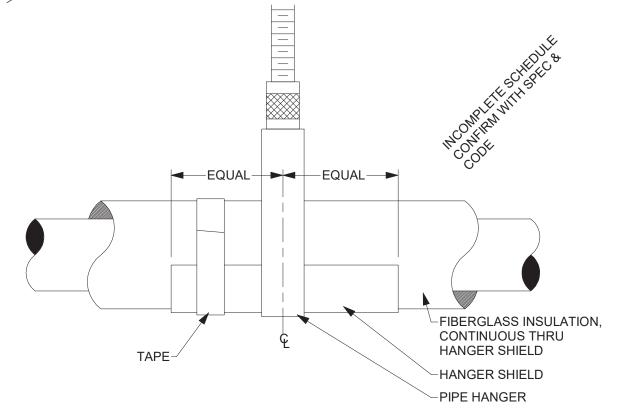

DETAILS NOTES:

- A. PIPE HANGERS SHALL BE ON THE OUTSIDE OF THE HANGER SHIELDS
- B. HANGER SHIELDS SHALL BE 18 GAUGE, GALVANIZED STEEL, 12" LONG x 120° ARC MINIMUM. CENTER SHIELD ON HANGER AND TAPE SHIELD TO INSULATION TO ANCHOR IN PLACE.
- C. GLASS FIBER INSULATION PREFORMED RIGID PIPE COVERING, 4 LB. NOMINAL DENSITY. MAX. THERMAL CONDUCTIVITY (K), OF 0.25 BTU/SQ. FT. HR. 33#64F/IN. AT 7533#64F MEAN TEMP.WHITE KRAFT OUTER BONDED TO ALUMINUM FOIL AND REINFORCED WITH FIBERGLASS YARN. SEAL ALL JOINTS & ENDS.


PIPE HANGER WITH INSULATED PIPING DETAIL - FIBERGLASS INSULATION NOT TO SCALE

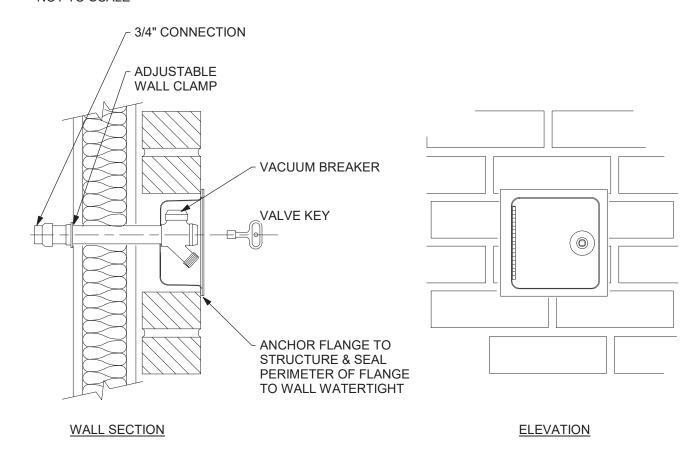

DETAIL NOTES:

- A. KEYLESS FITTING SHOWN. PROVIDE KEYED OR KEYLESS PER SPECIFICATIONS.
- B. SEE ARCHITECTURAL PLANS FOR WALL MATERIALS & THICKNESS. WALL HYDRANT CASING LENGTH TO MATCH WALL THICKNESS.
- C. PIPE SIZE PER PLANS

WALL HYDRANT DETAIL - RECESSED

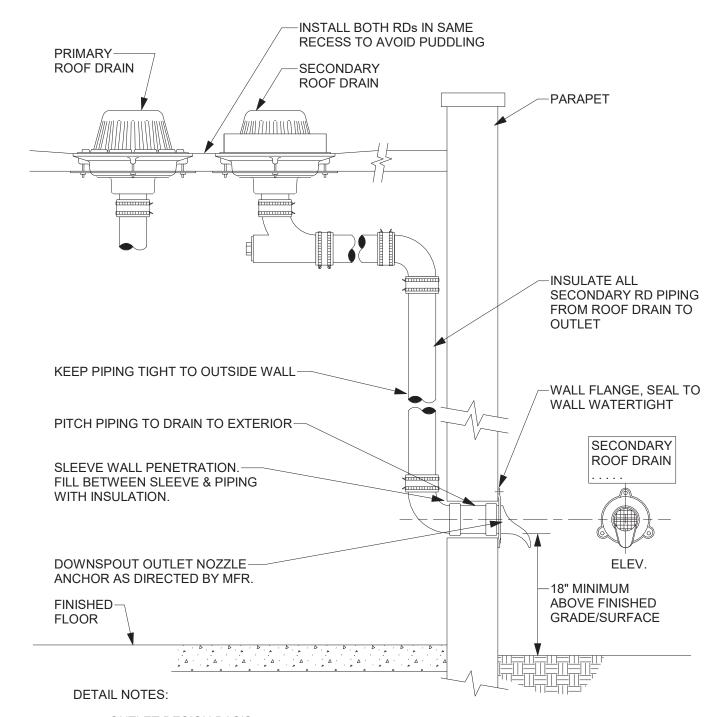

- A. OUTLET DESIGN BASIS: JAY R. SMITH #1770, JOSAM 25010 OR ZURN #Z199 BOTH W/ BIRD SCREEN OPTION
- CONFIRM FINAL LOCATION AND ELEVATION WITH ARCHITECT BEFORE STARTING INSTALLATION OF OUTLETS.
- PROVIDE ENGRAVED SIGN OVER SECONDARY DRAIN OUTLET; "SECONDARY ROOF DRAIN, CONTACT BLDG MAINTENANCE IF WATER IS FLOWING FROM THIS OUTLET"
- SECONDARY ROOF DRAINAGE SYSTEM DETAIL





Mechanical/Electrical Engineering Consultants Capital District | Rochester | Buffalo | Syracuse

433 STATE STREET, 4TH FLOOR 518.533.217 SCHENECTADY, NY 12305 www.meengineering.com

	REVISIONS:						
NUM.	DATE	DATE DESCRIPTION					

BID DOCUMENTS

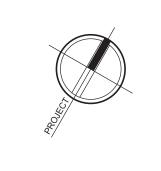

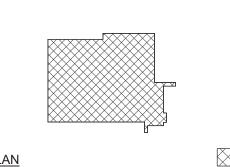




ARCHITECTS | ARCHITECTURE • PLANNING • INTERIORS

Project: TOWN OF MONTGOMERY POLICE STATION 110 BRACKEN ROAD, MONTGOMERY, **NEW YORK 12549**

Drawing: DETAILS

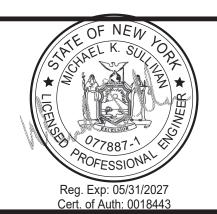


Project: 23138 Date: 02/24/25 Drawn: CES Scale: AS NOTED Drawing Number:



Copyright @ all rights reserved - Jason T. Anderson Architect, P.C. / DBA / ADG Architects and Anderson Design Group - Architecture - Planning - Interiors / Unauthorized addition or alteration of this document is a violation of the New York State Education Law.

NATURAL	GAS PRESSURE	REGULATORS			
EQUIP. NO.	DESCRIPTION	INLET PRESSURE IN. W.C. (PSI)	OUTLET PRESSURE IN. W.C.	CAPACITY (CFH)	COMMENT
REG-1	BY UTILITY	-	-	-	-
REG-2	EMERGENCY GENERATO	R -	7-11"	2400	LOCK-UP TYPE

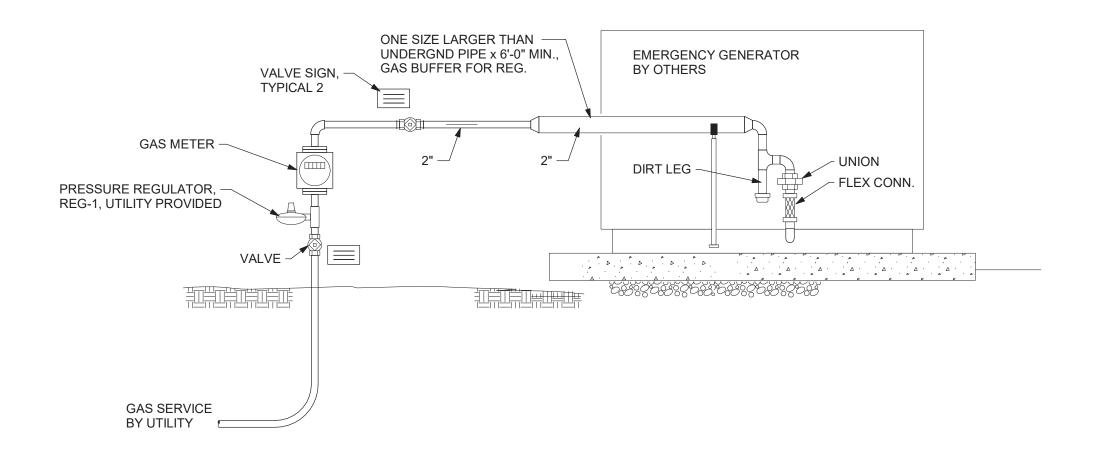

DETAIL NOTES:

- A. P.C. SHALL PAINT ALL EXPOSED P.C. INSTALLED PIPING. COLOR TO BE SELECTED BY ARCHITECT.
- B. PROVIDE BOLLARDS WHERE REQUIRED.
- C. UNDERGROUND PIPING MATERIALS: PE2406 POLYETHYLENE, YELLOW - NYSEG, NATIONAL FUEL, CON ED
- COATED STEEL PIPE, OVER _".


 D. REGULATORS SHALL BE INSTALLED WITH VENT MORE THAN 18" ABOV

PE3408 POLYETHYLENE, BLACK W/ YELLOW STRIPE - NIMO, RG&E, CON ED

- D. REGULATORS SHALL BE INSTALLED WITH VENT MORE THAN 18" ABOVE FINISHED GRADE.
- E. TRACER WIRE 10 AWG, SOLID, THHN YELLOW INSULATION. WIRE SHALL BE CONTINUOUS, SOLDERED OR CRIMPED JOINTS ONLY. WIRE NUTS ARE NOT ALLOWED. A SEPARATE TRACER WIRE IS NOT REQUIRED WHERE PROVIDED AS PART OF LOCATOR TAPE.
- F. PROVIDE SIGNS ON VALVES AT METER: "EMERGENCY GENERATOR GAS SUPPLY VALVE" & "MAIN BLDG. GAS VALVE SEPARATE VALVE FOR EMERGENCY GENERATOR"
- G. WALL PENETRATIONS:
 NON-MASONRY WALL: PROVIDE COATING OR WRAP ON PIPING AT WALL PENETRATION TO PREVENT CORROSION AND SEAL TO WALL WATERTIGHT.
 MASONRY WALL: PROVIDE NON-CORROSIVE SLEEVE THRU WALL & SEAL TO WALL WATERTIGHT. FILL SPACE BETWEEN SLEEVE AND PIPE.


GAS METER & EMERGENCY GENERATOR DETAIL - PLASTIC PIPE

NOT TO SCALE

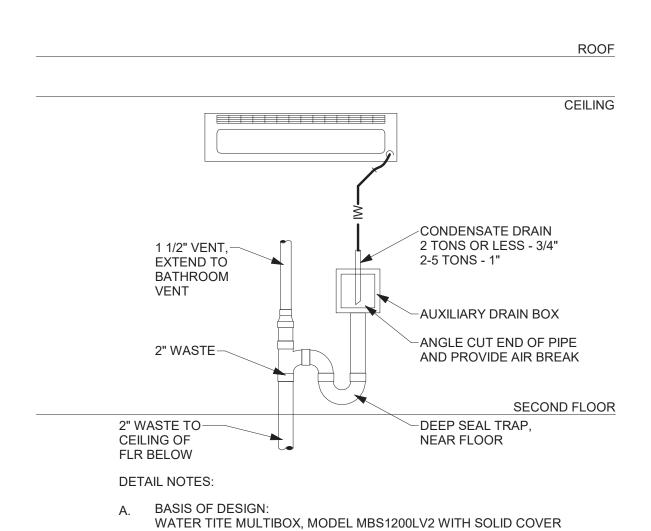

INDIRECT WASTE - CONDENSATE - DSS OR A/C

NOT TO SCALE

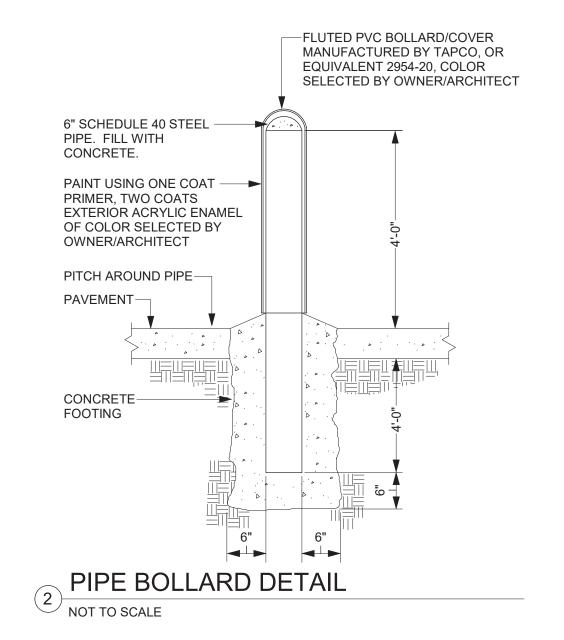




Mechanical/Electrical Engineering Consultants


Capital District | Rochester | Buffalo | Syracuse

433 STATE STREET, 4TH FLOOR 518.533.2171 SCHENECTADY, NY 12305 www.meengineering.com


REVISIONS:						
NUM.	DATE	DESCRIPTION				

100% BID DOCUMENTS

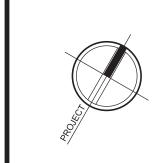

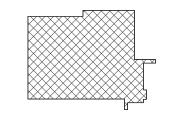

KEY PLAN

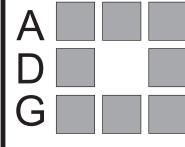

25 WALLKILL AVE • MONTGOMERY • NY 12549
O. 845.294.2724 | F. 888.305.6442

WWW.ADGARCHITECT.COM

G CONTACT@ADGARCHITECT.COM

ARCHITECTS ARCHITECTURE • PLANNING • INTERIORS

Project: TOWN OF MONTGOMERY POLICE STATION 110 BRACKEN ROAD, MONTGOMERY, NEW YORK 12549

DETAILS



