

NOTES:

1. REFER TO CONTRACT DRAWING E-001 FOR ELECTRICAL LEGEND, ABBREVIATIONS, GENERAL NOTES, AND DRAWING LIST.
2. REFER TO CONTRACT DRAWINGS E-701, E-702 AND E-703 FOR ELECTRICAL ONE-LINE DIAGRAM AND ELECTRICAL REQUIREMENTS OF EQUIPMENT.
3. ALL BRANCH CIRCUIT HOMERUNS SHOWN IN 10 DUNNIGAN JANITOR'S CLOSET & TOILET ROOMS SHALL BE FED FROM PANEL 'LP-10A'.
3. ALL BRANCH CIRCUIT HOMERUNS SHOWN IN 20 DUNNIGAN JANITOR'S CLOSET & TOILET ROOMS SHALL BE FED FROM PANEL 'LP-ASRS'.
4. REFER TO ARCHITECTURAL CONTRACT DRAWINGS FOR EXACT LOCATION OF RECEPTACLES.
5. REFER TO MECHANICAL AND PLUMBING CONTRACT DRAWINGS FOR EXACT LOCATION OF MECHANICAL AND PLUMBING EQUIPMENT.

ARCHITECT

di Domenico + Partners LLP

Architecture
Landscape Architecture
Planning

3743 Crescent Street, 3rd Floor
Long Island City, New York 11101
Tel 212-337-0400
Fax 212-337-3567

CIVIL PLANNING ENGINEER

JMC

JMC Planning Engineering Landscape
Architecture & Land Surveying, PLLC
120 Bedford Road
Armonk, New York 10504
Tel 914-273-5225
Fax 914-273-2102

MEP ENGINEER

Burns

BURNS ENGINEERING, PC.
1261 Broadway, Suite 708
New York, New York 10001
Tel 212-962-3503

STRUCTURAL ENGINEER

GEI

GEI50
1385 Broadway, 20th FL
New York, New York 10018
Tel 212-687-8282



MANHATTAN BEER DISTRIBUTORS
20 DUNNIGAN DRIVE
SUFFERN, NEW YORK

KEY PLAN


REV	DESCRIPTION	DATE
	ISSUED FOR DOB SUBMISSION	09/10/2021
	ISSUED FOR BID	10/15/2021
	ISSUED FOR PROGRESS	01/18/2022
	ISSUED FOR BID	08/30/2022

DRAWN BY :	M.DIMATTIA
CHECKED BY :	B.NEMCHEK
APPROVED BY :	J.MIZRAHI
DATE :	09/10/21
SCALE :	AS NOTED


DRAWING TITLE :
ELECTRICAL POWER PART
PLAN - JANITOR'S CLOSET &
TOILET ROOMS

DWG NUMBER :

E-406

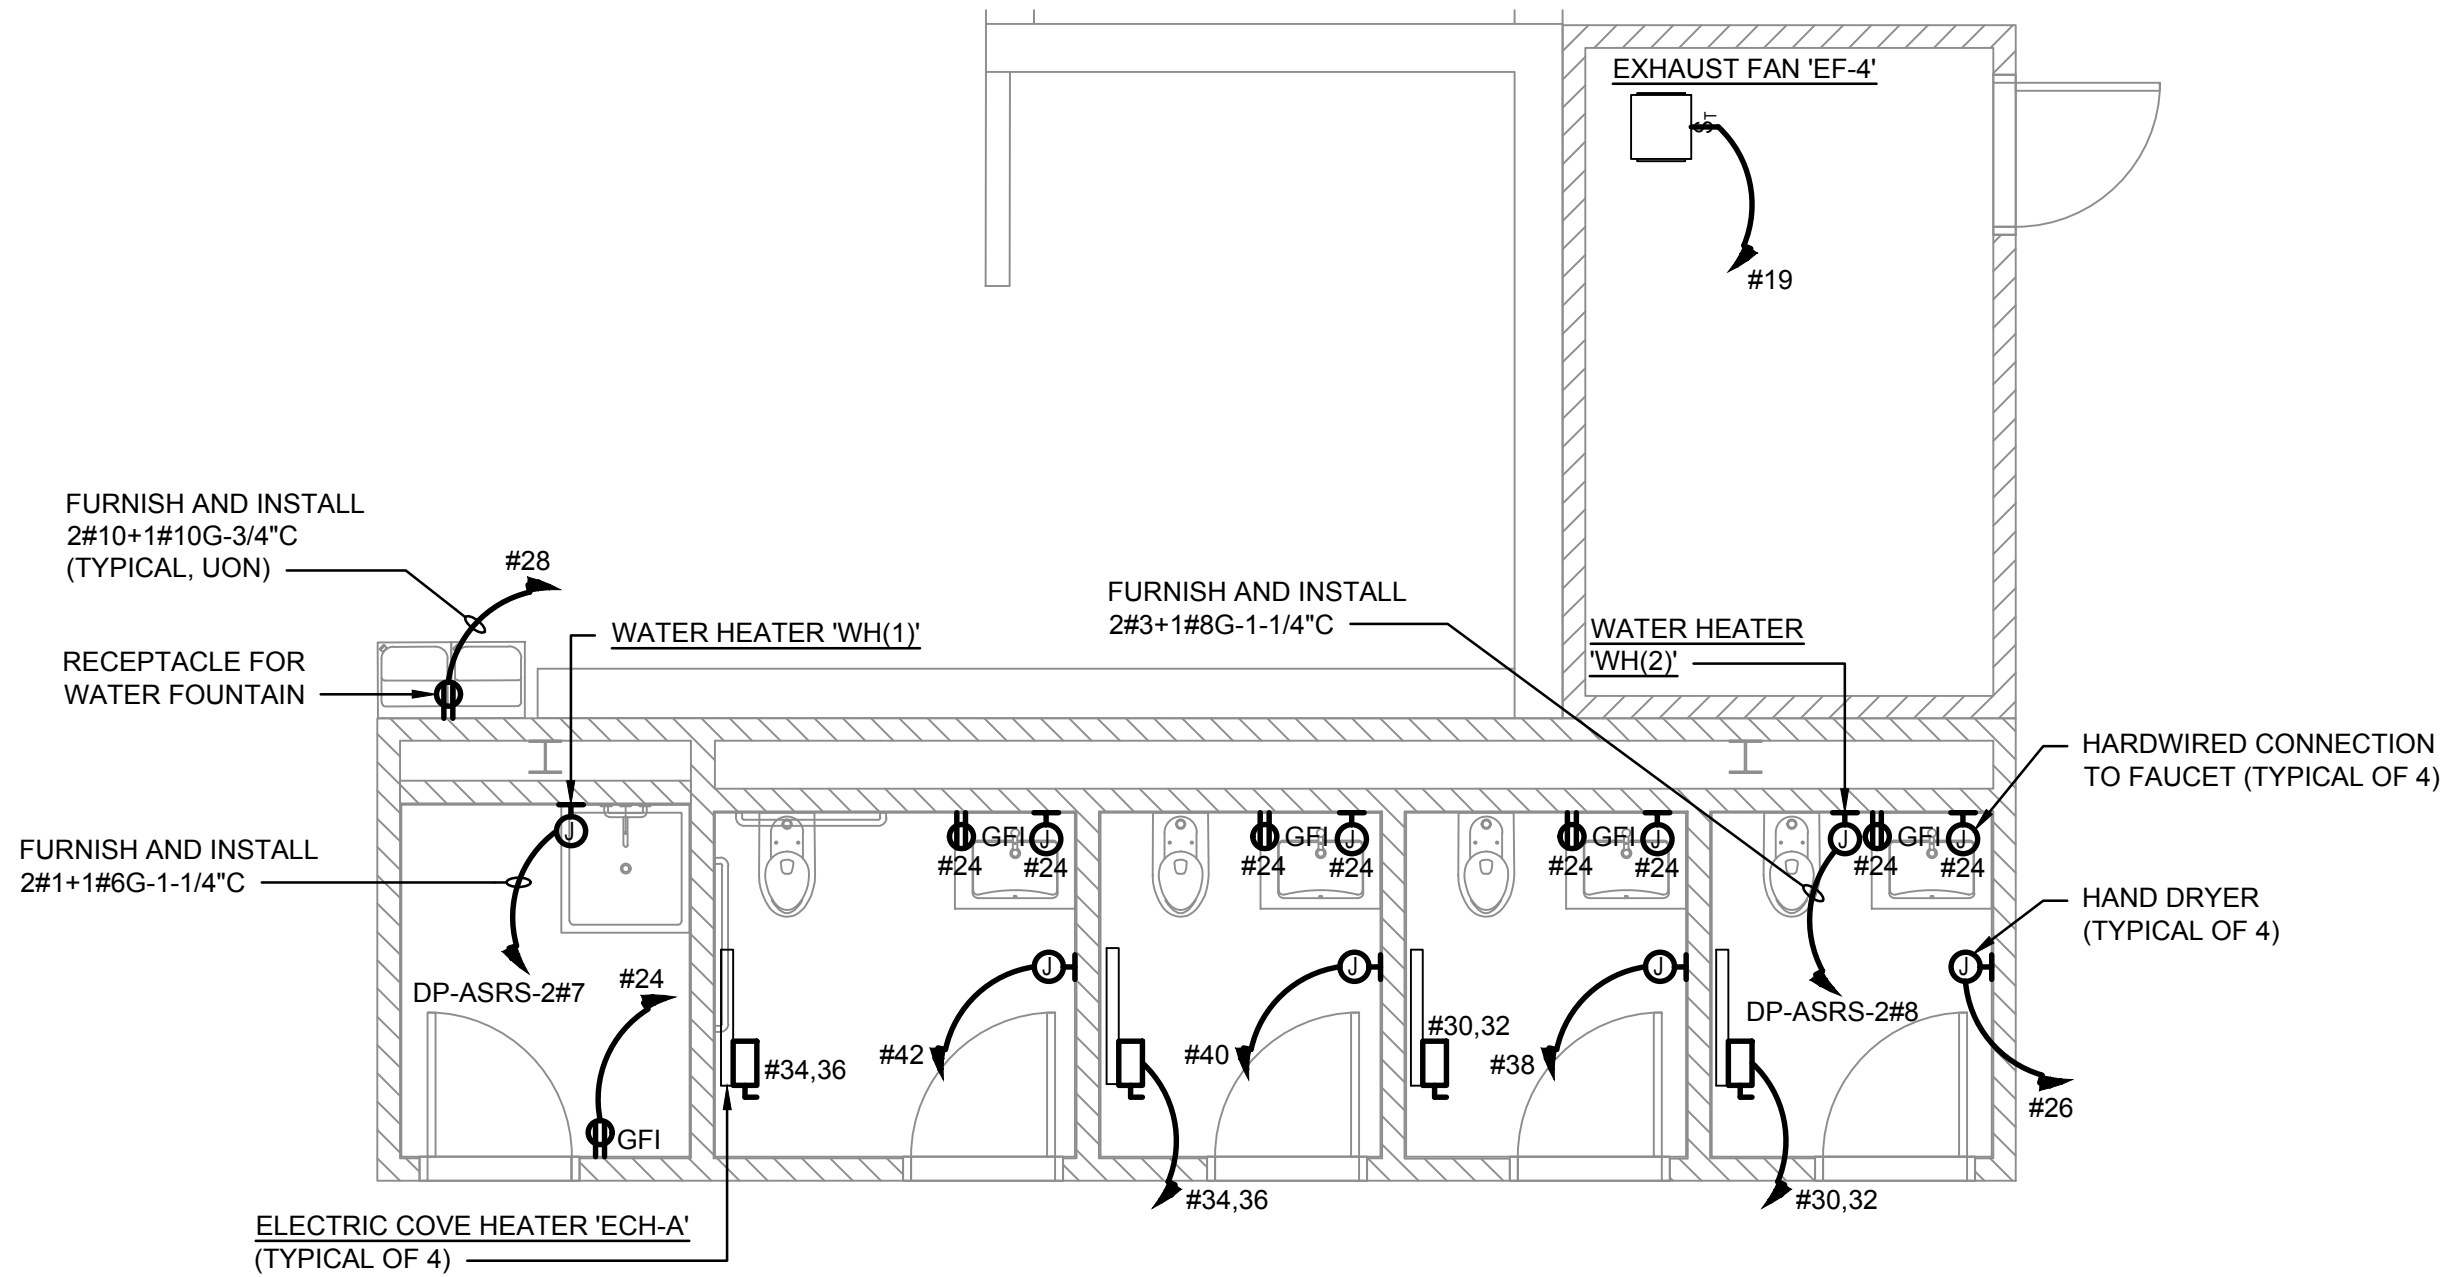

1
E-406
20 DUNNIGAN - JANITOR'S CLOSET & TOILET ROOMS POWER PART PLAN
SCALE: 1/4" = 1'-0"
0 4 8
SCALE IN FEET

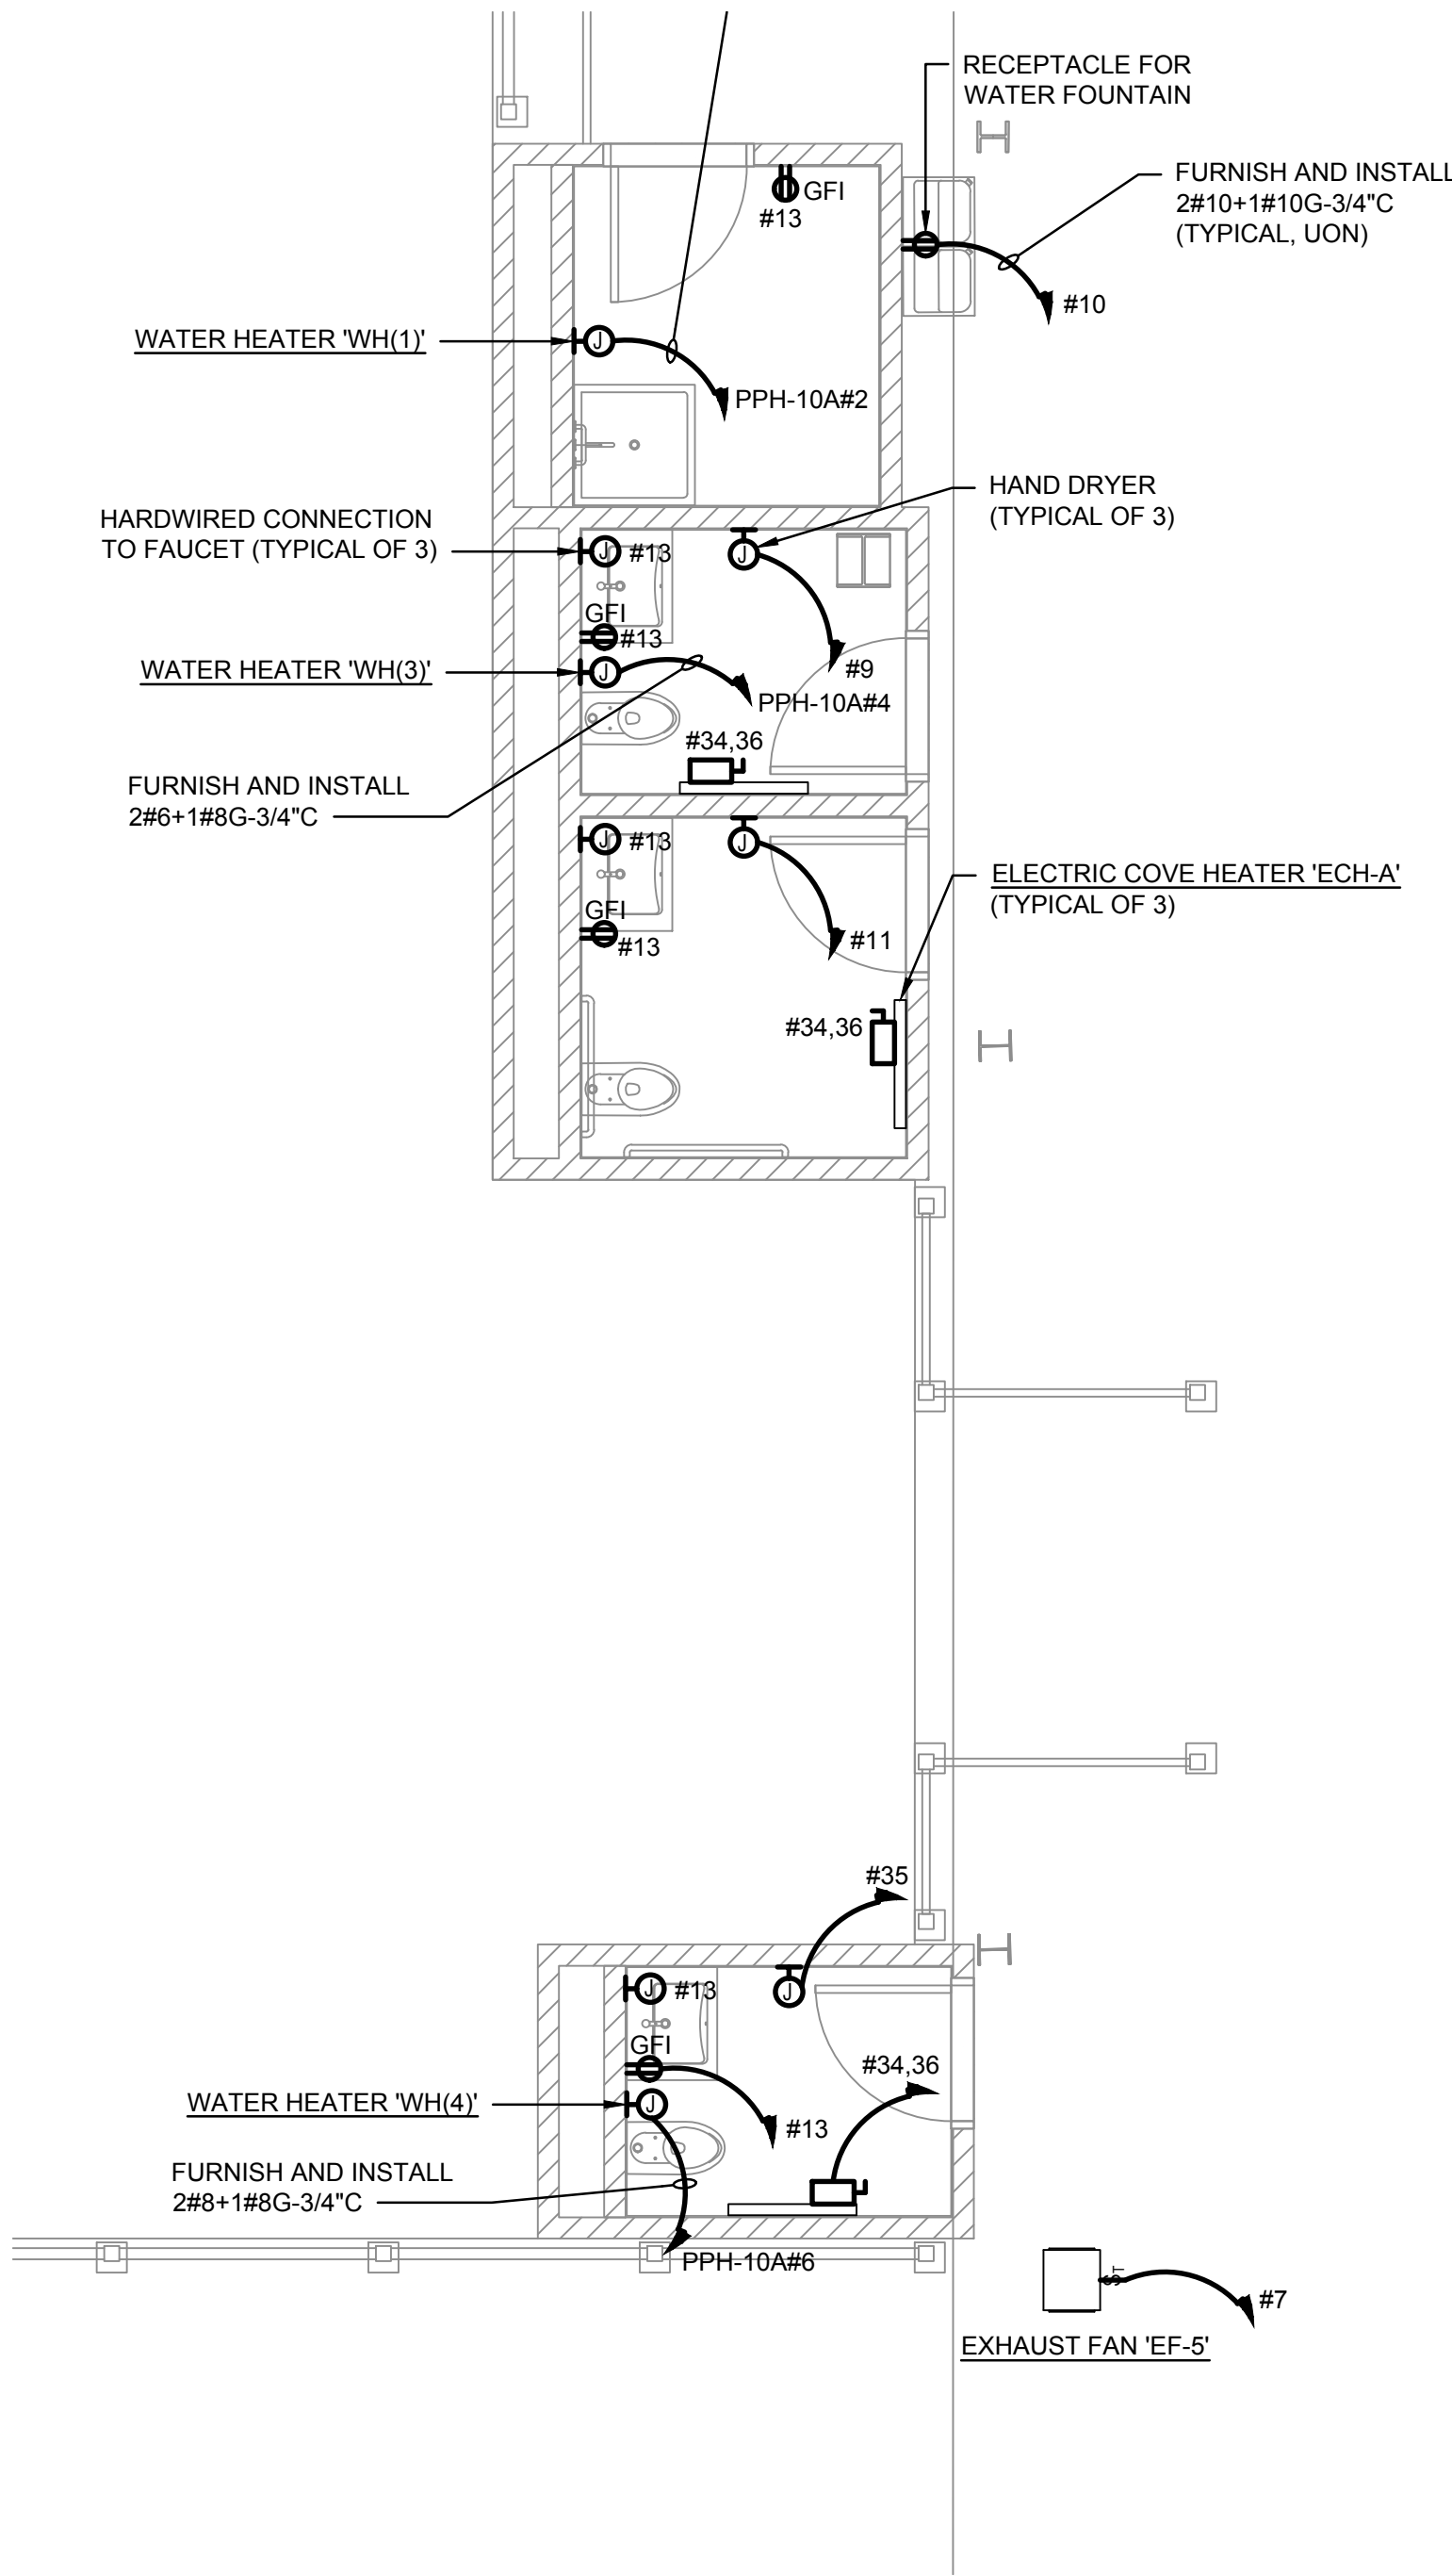

2
E-406
10 DUNNIGAN - JANITOR'S CLOSET & TOILET ROOMS POWER PART PLAN
SCALE: 1/4" = 1'-0"
0 4 8
SCALE IN FEET



TO THE BEST KNOWLEDGE, BELIEF AND PROFESSIONAL JUDGEMENT,
THESE PLANS AND SPECIFICATIONS ARE IN COMPLIANCE WITH THE 2020
ENERGY CONSERVATION CONSTRUCTION CODE OF NEW YORK STATE.