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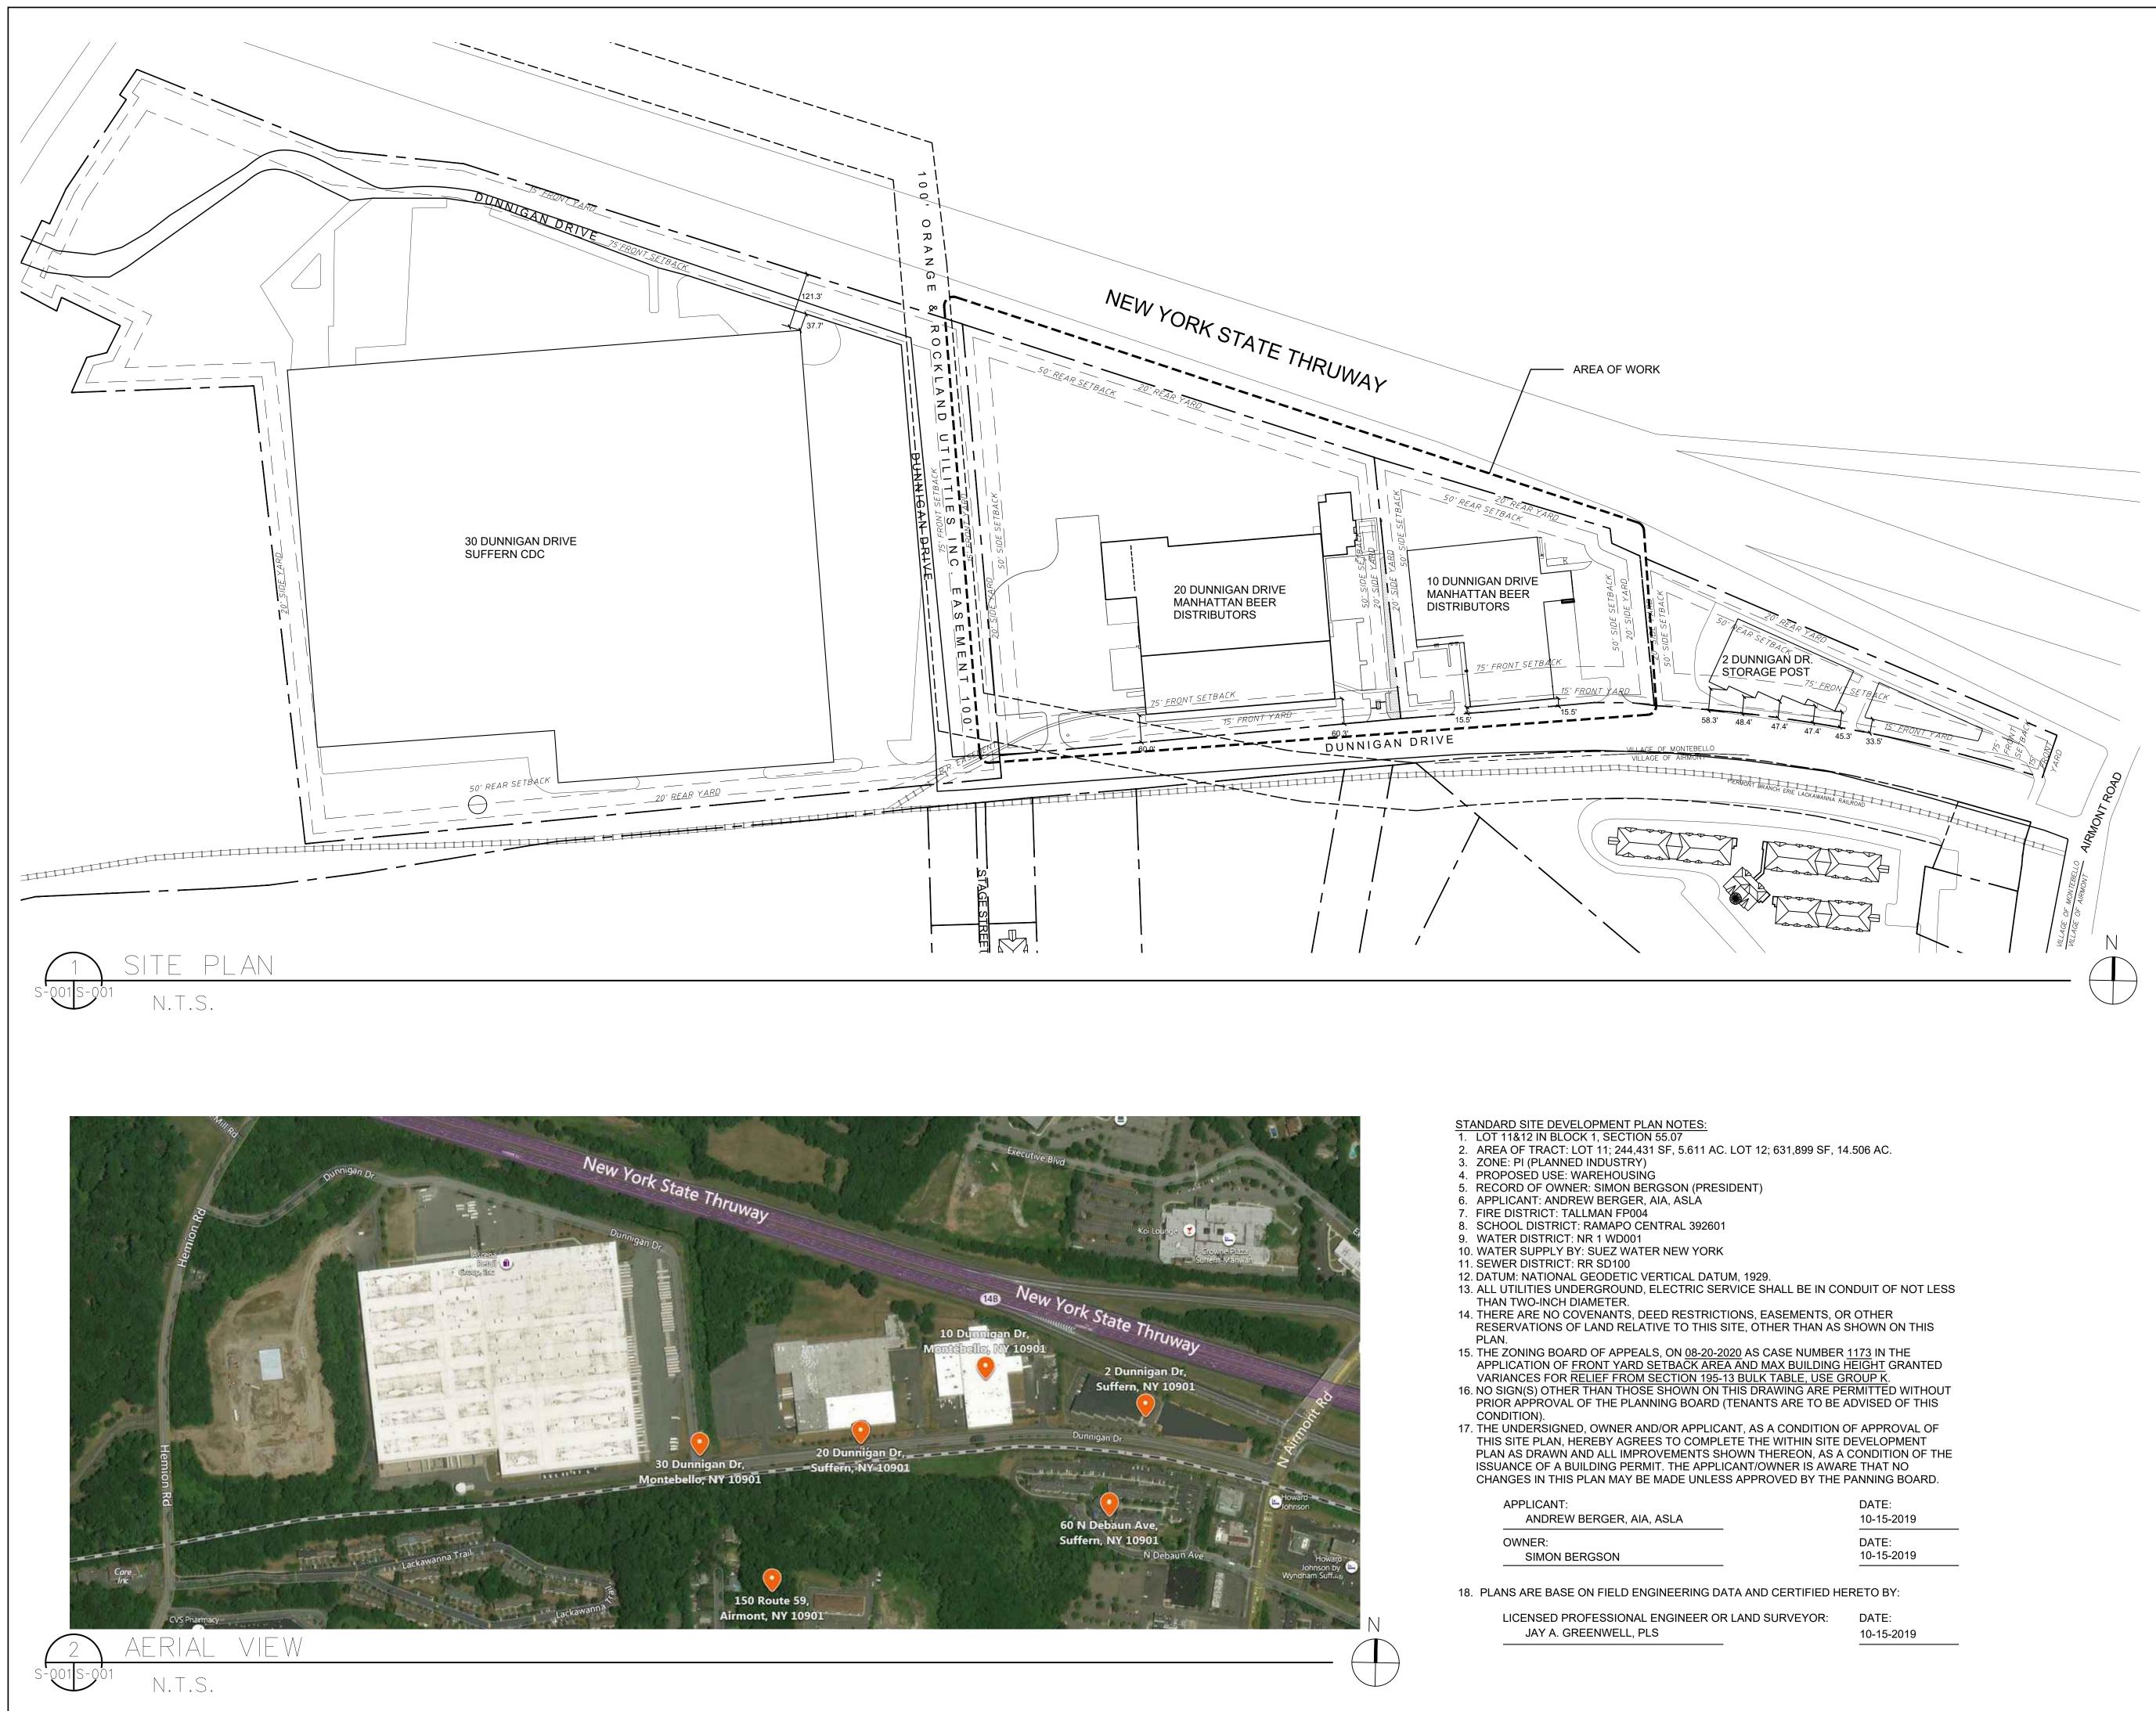
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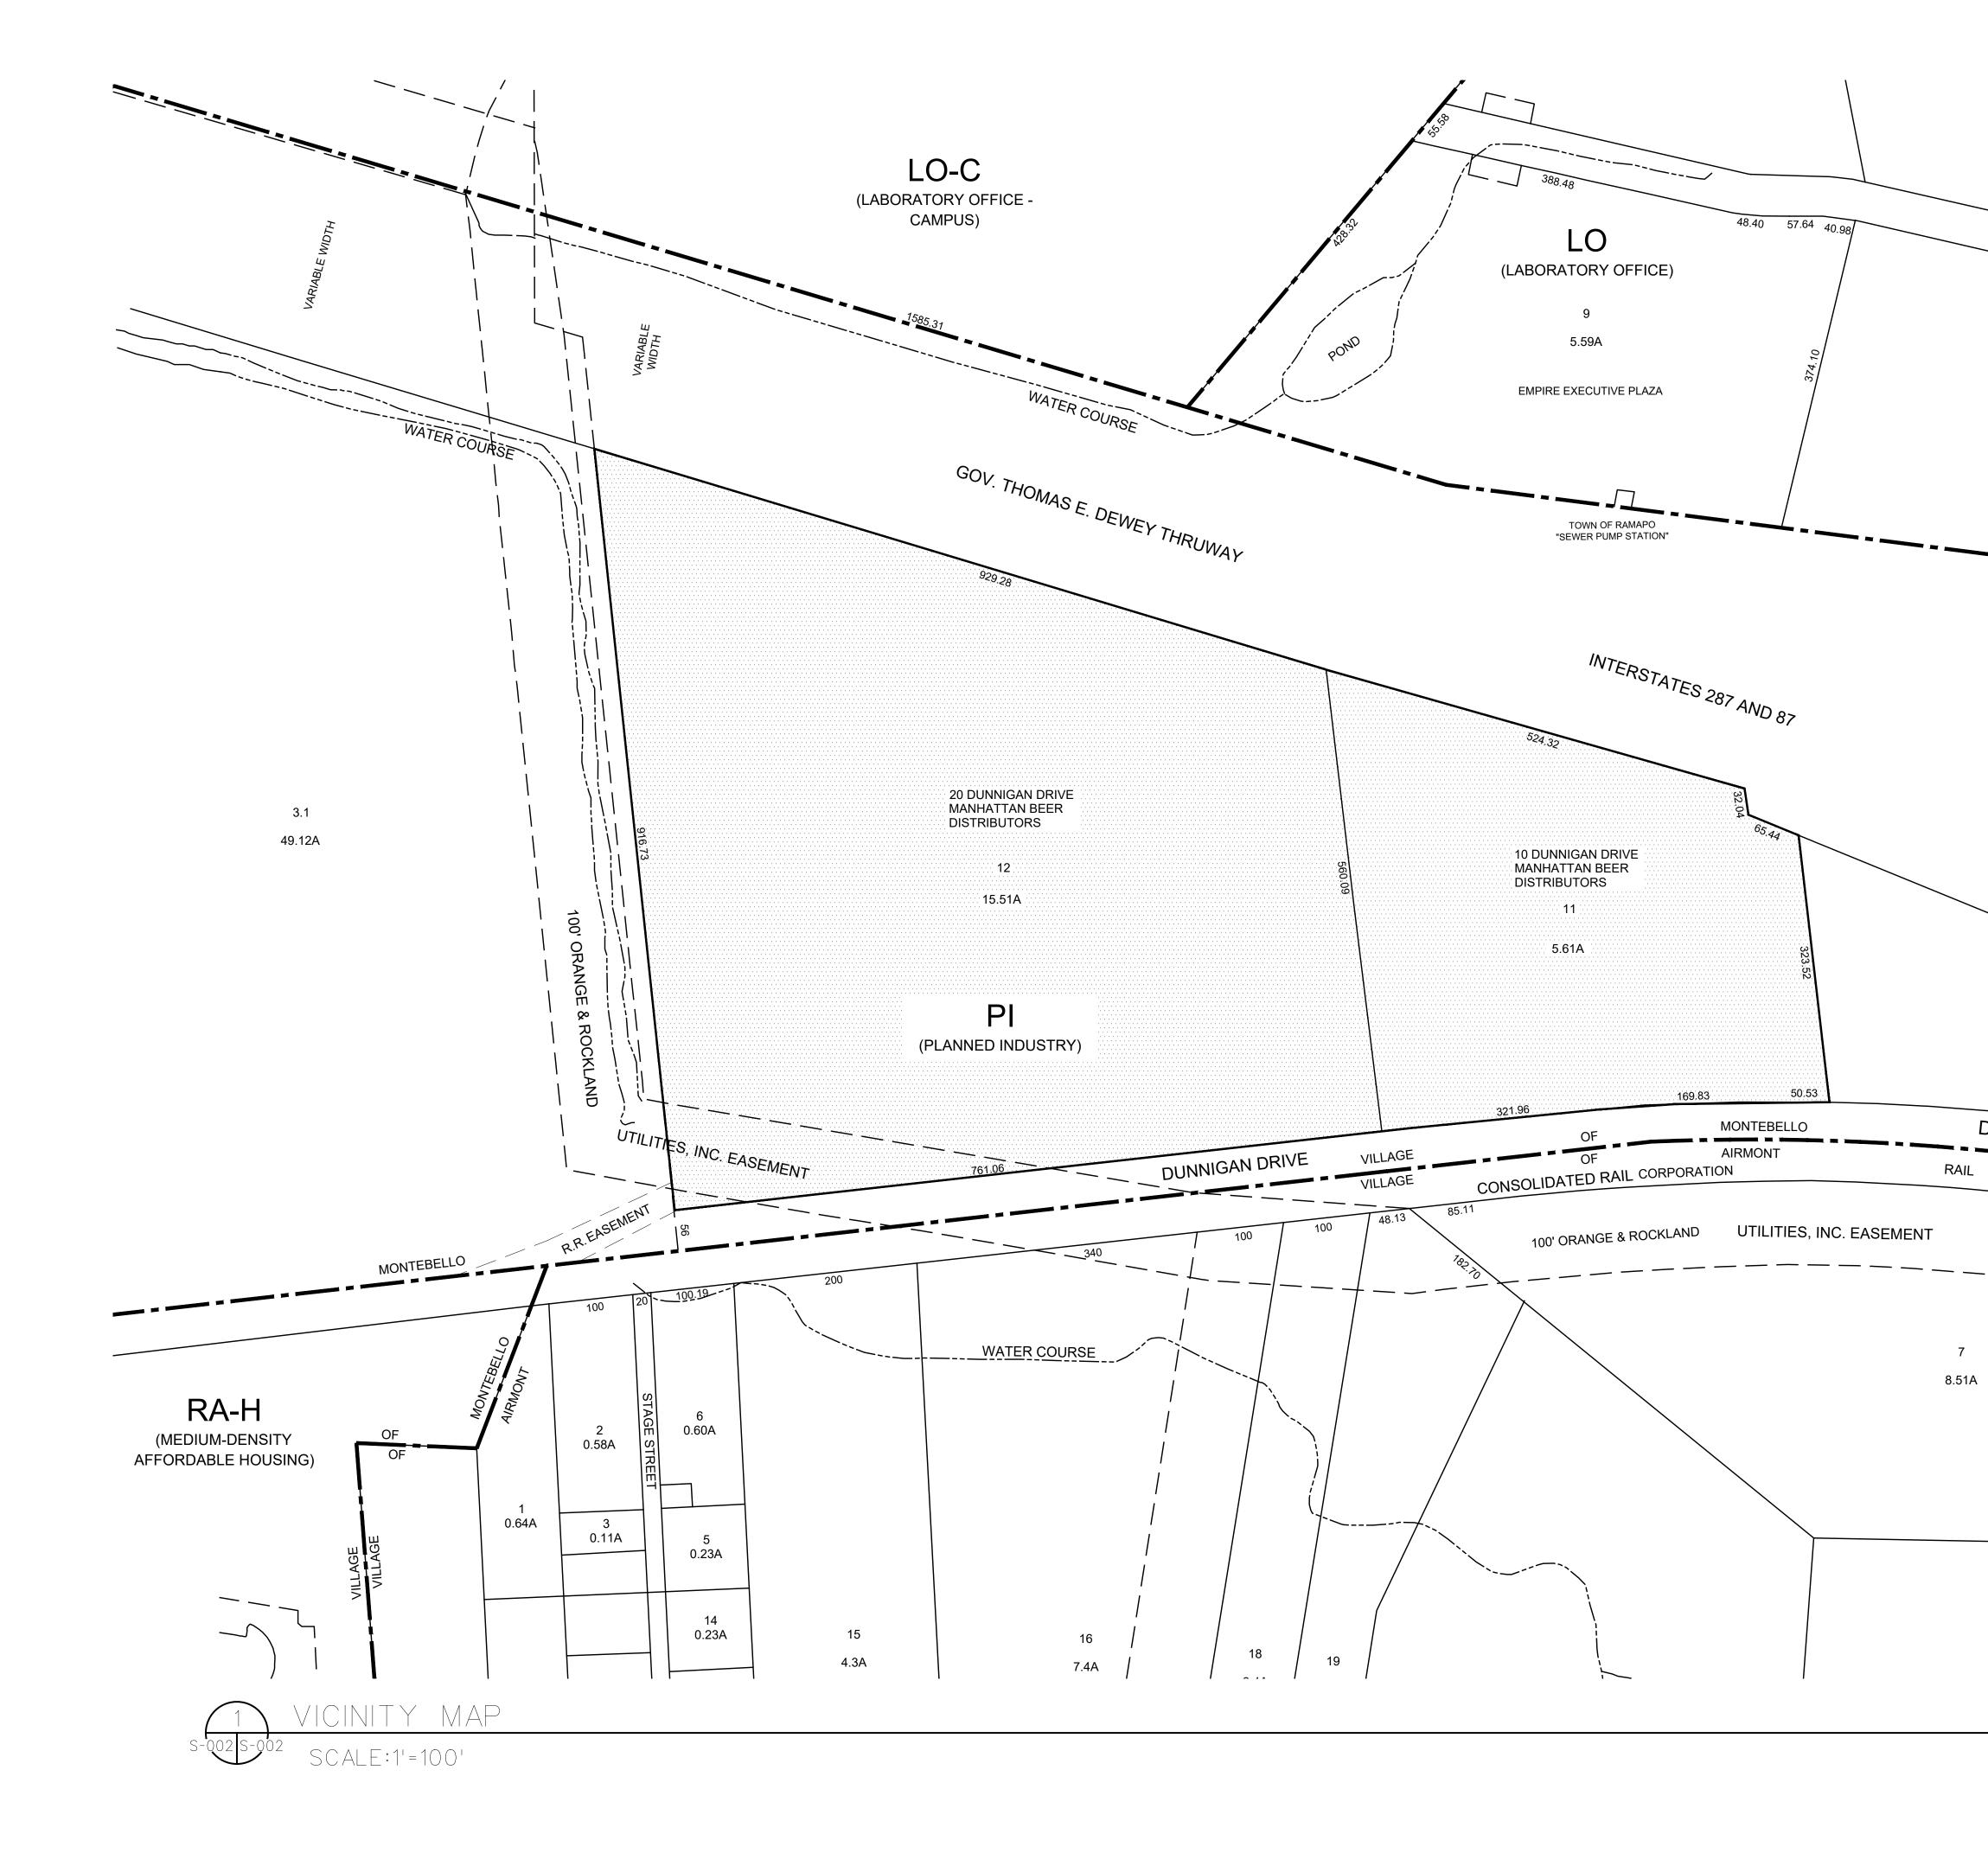
ARCHITECT	
d1 Dome Architecture	enico + Partners LLP
	Architecture
	cent Street, 3rd Floor I City, New York 11101
Tel 212-3 Fax 212-3	37-0400
CIVIL PLANNING ENGINEER	
Architecture	ing Engineering Landscape e & Land Surveying, PLLC
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Tel 914-2 Fax 914-2	
MEP ENGINEER	
- 12	JRNS ENGINEERING, PC. 61 Broadway, Suite 708
	ew York, New York 10001 el 212-962-3503
STRUCTURAL ENGINEER	
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	Landscape Architecture Planning
	Planning 3743 Crescent Street, 3rd Floor Long Island City, New York 11101
	Tel 212-337-0400 Fax 212-337-3567
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	New York, New York 10001 Tel 212-962-3503
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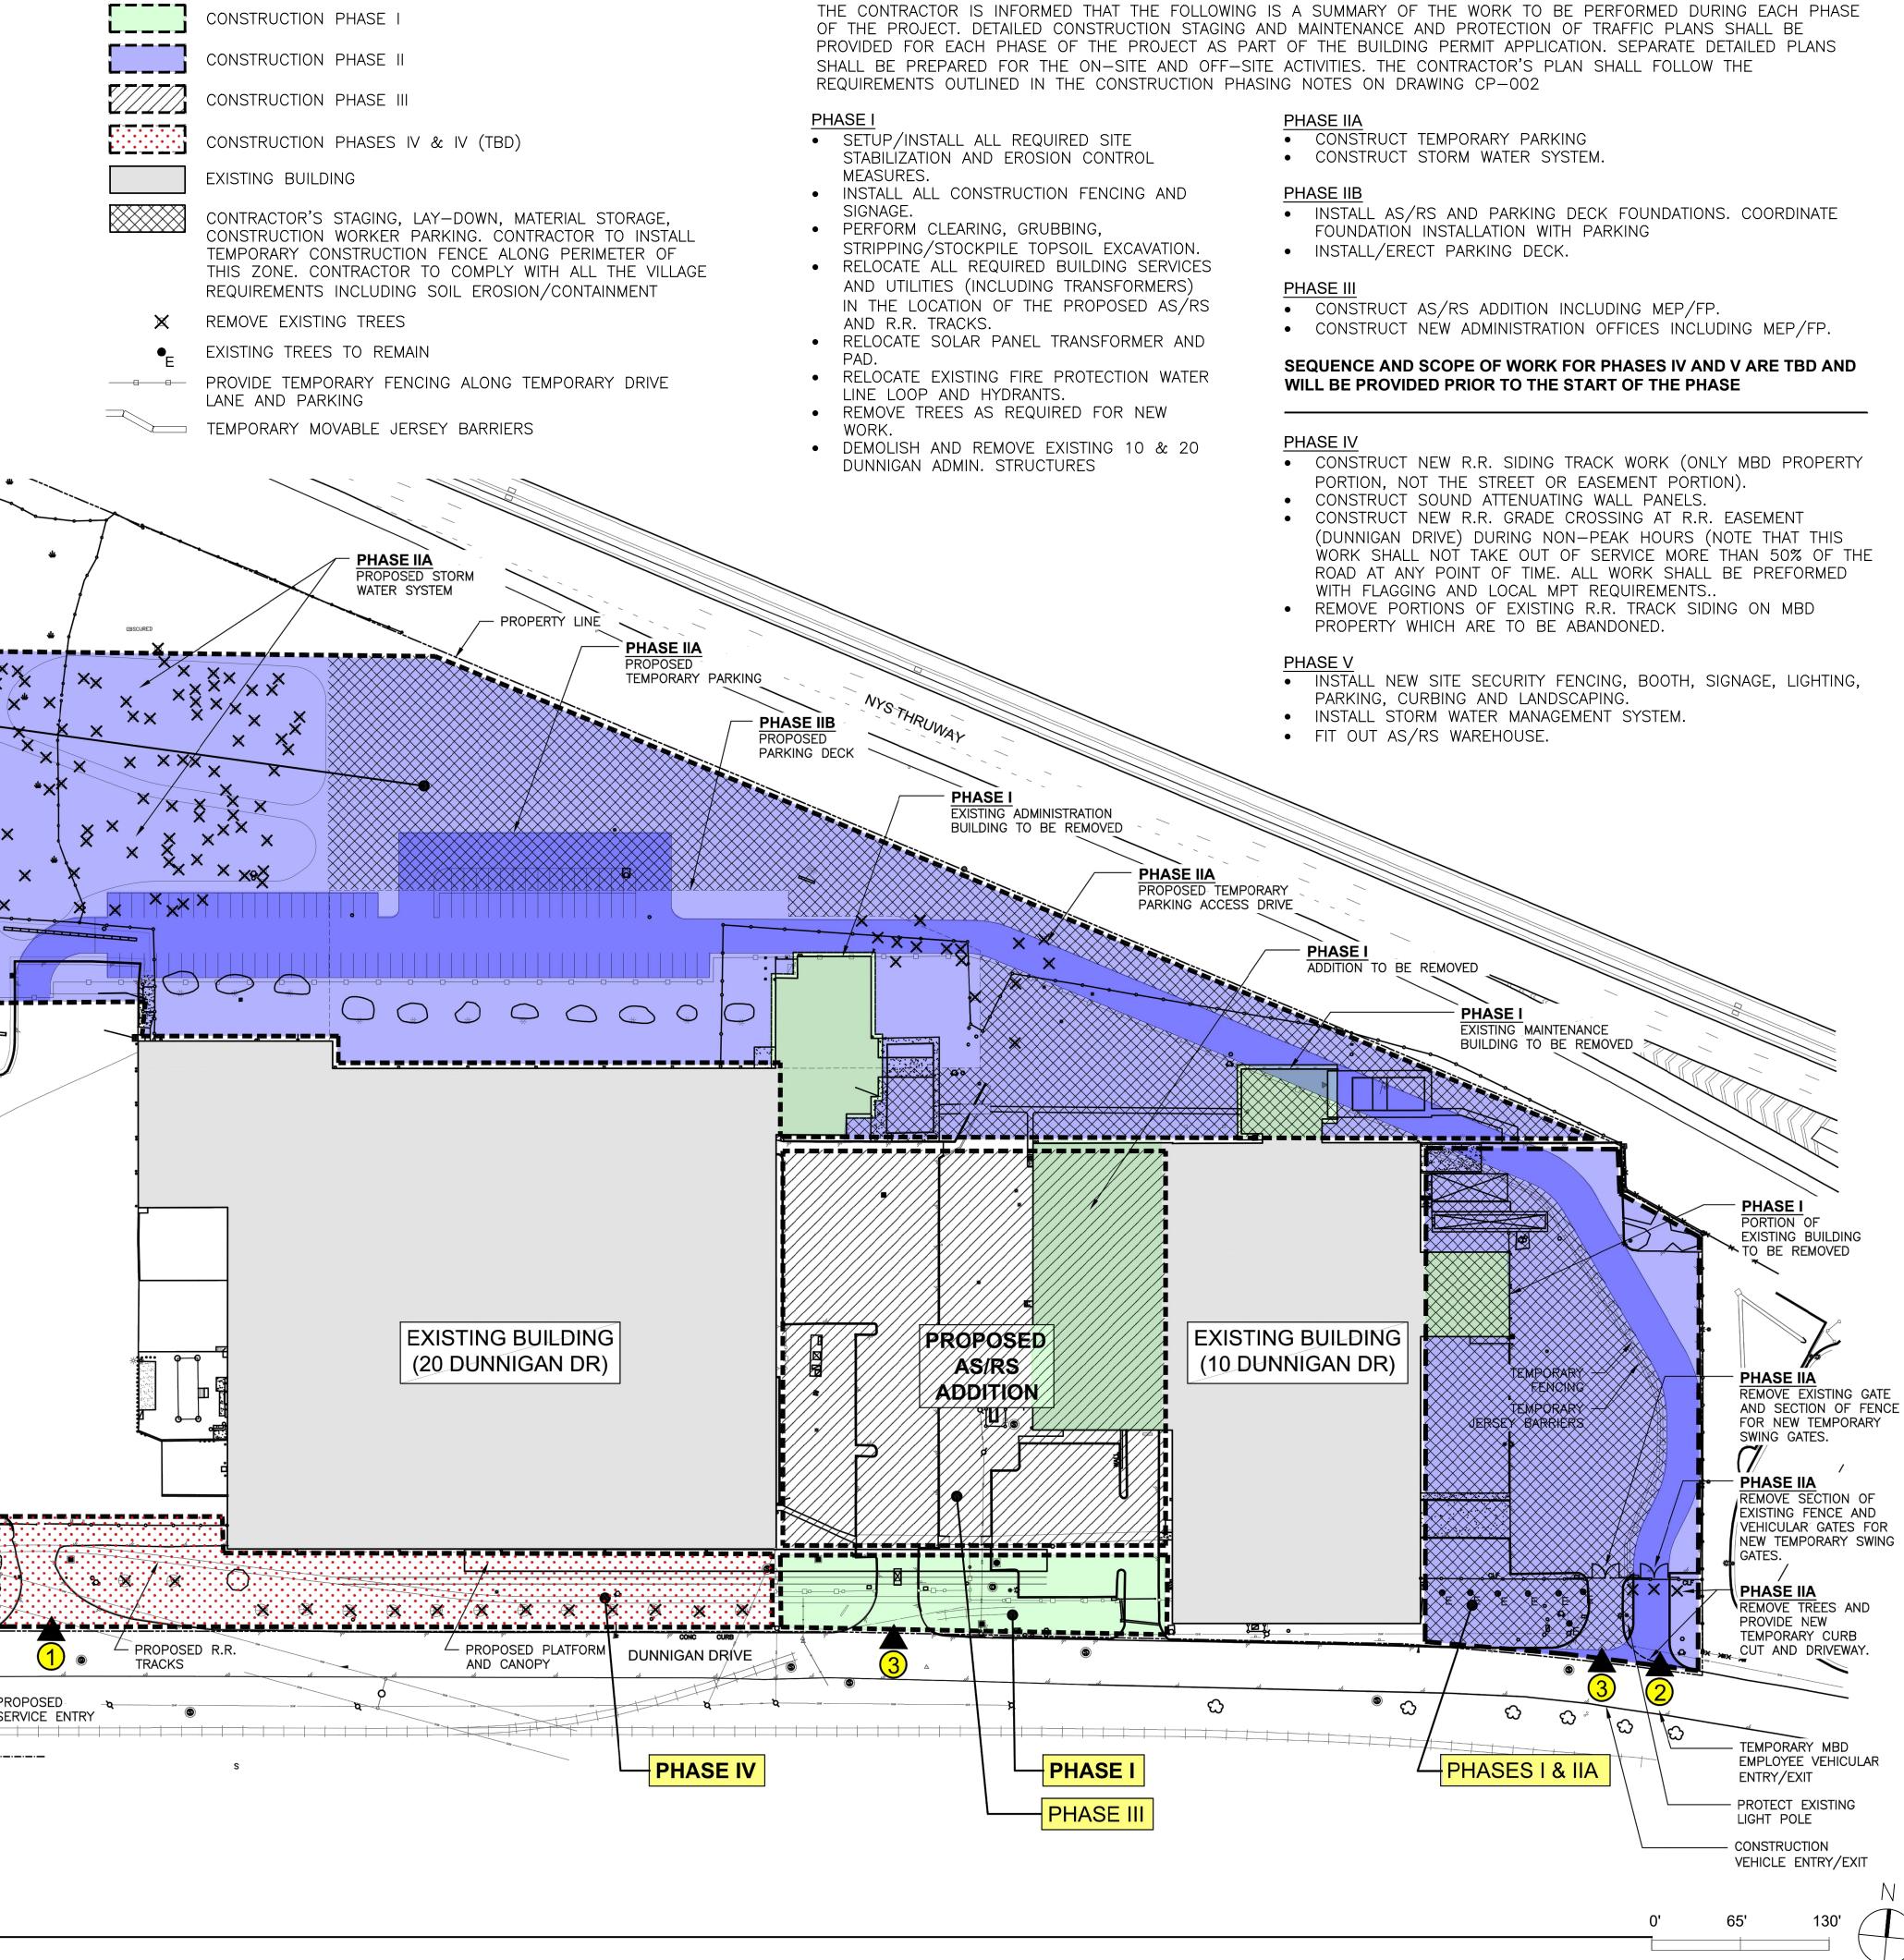


	ARCHITECT di Domenico + Partners LLP Architecture Landscape Architecture Planning 3743 Crescent Street, 3rd Floor Long Island City, New York 11101 Tel 212-337-0400 Fax 212-337-3567 CIVIL PLANNING ENGINEER JMC Planning Engineering Landscape Architecture & Land Surveying, PLLC 120 Bedford Road Armonk, New York 10504 Tel 914-273-5225 Fax 914-273-2102 MEP ENGINEER BURNS ENGINEERING, PC. 1261 Broadway, Suite 708 New York, New York 10001 Tel 212-962-3503 STRUCTURAL ENGINEER
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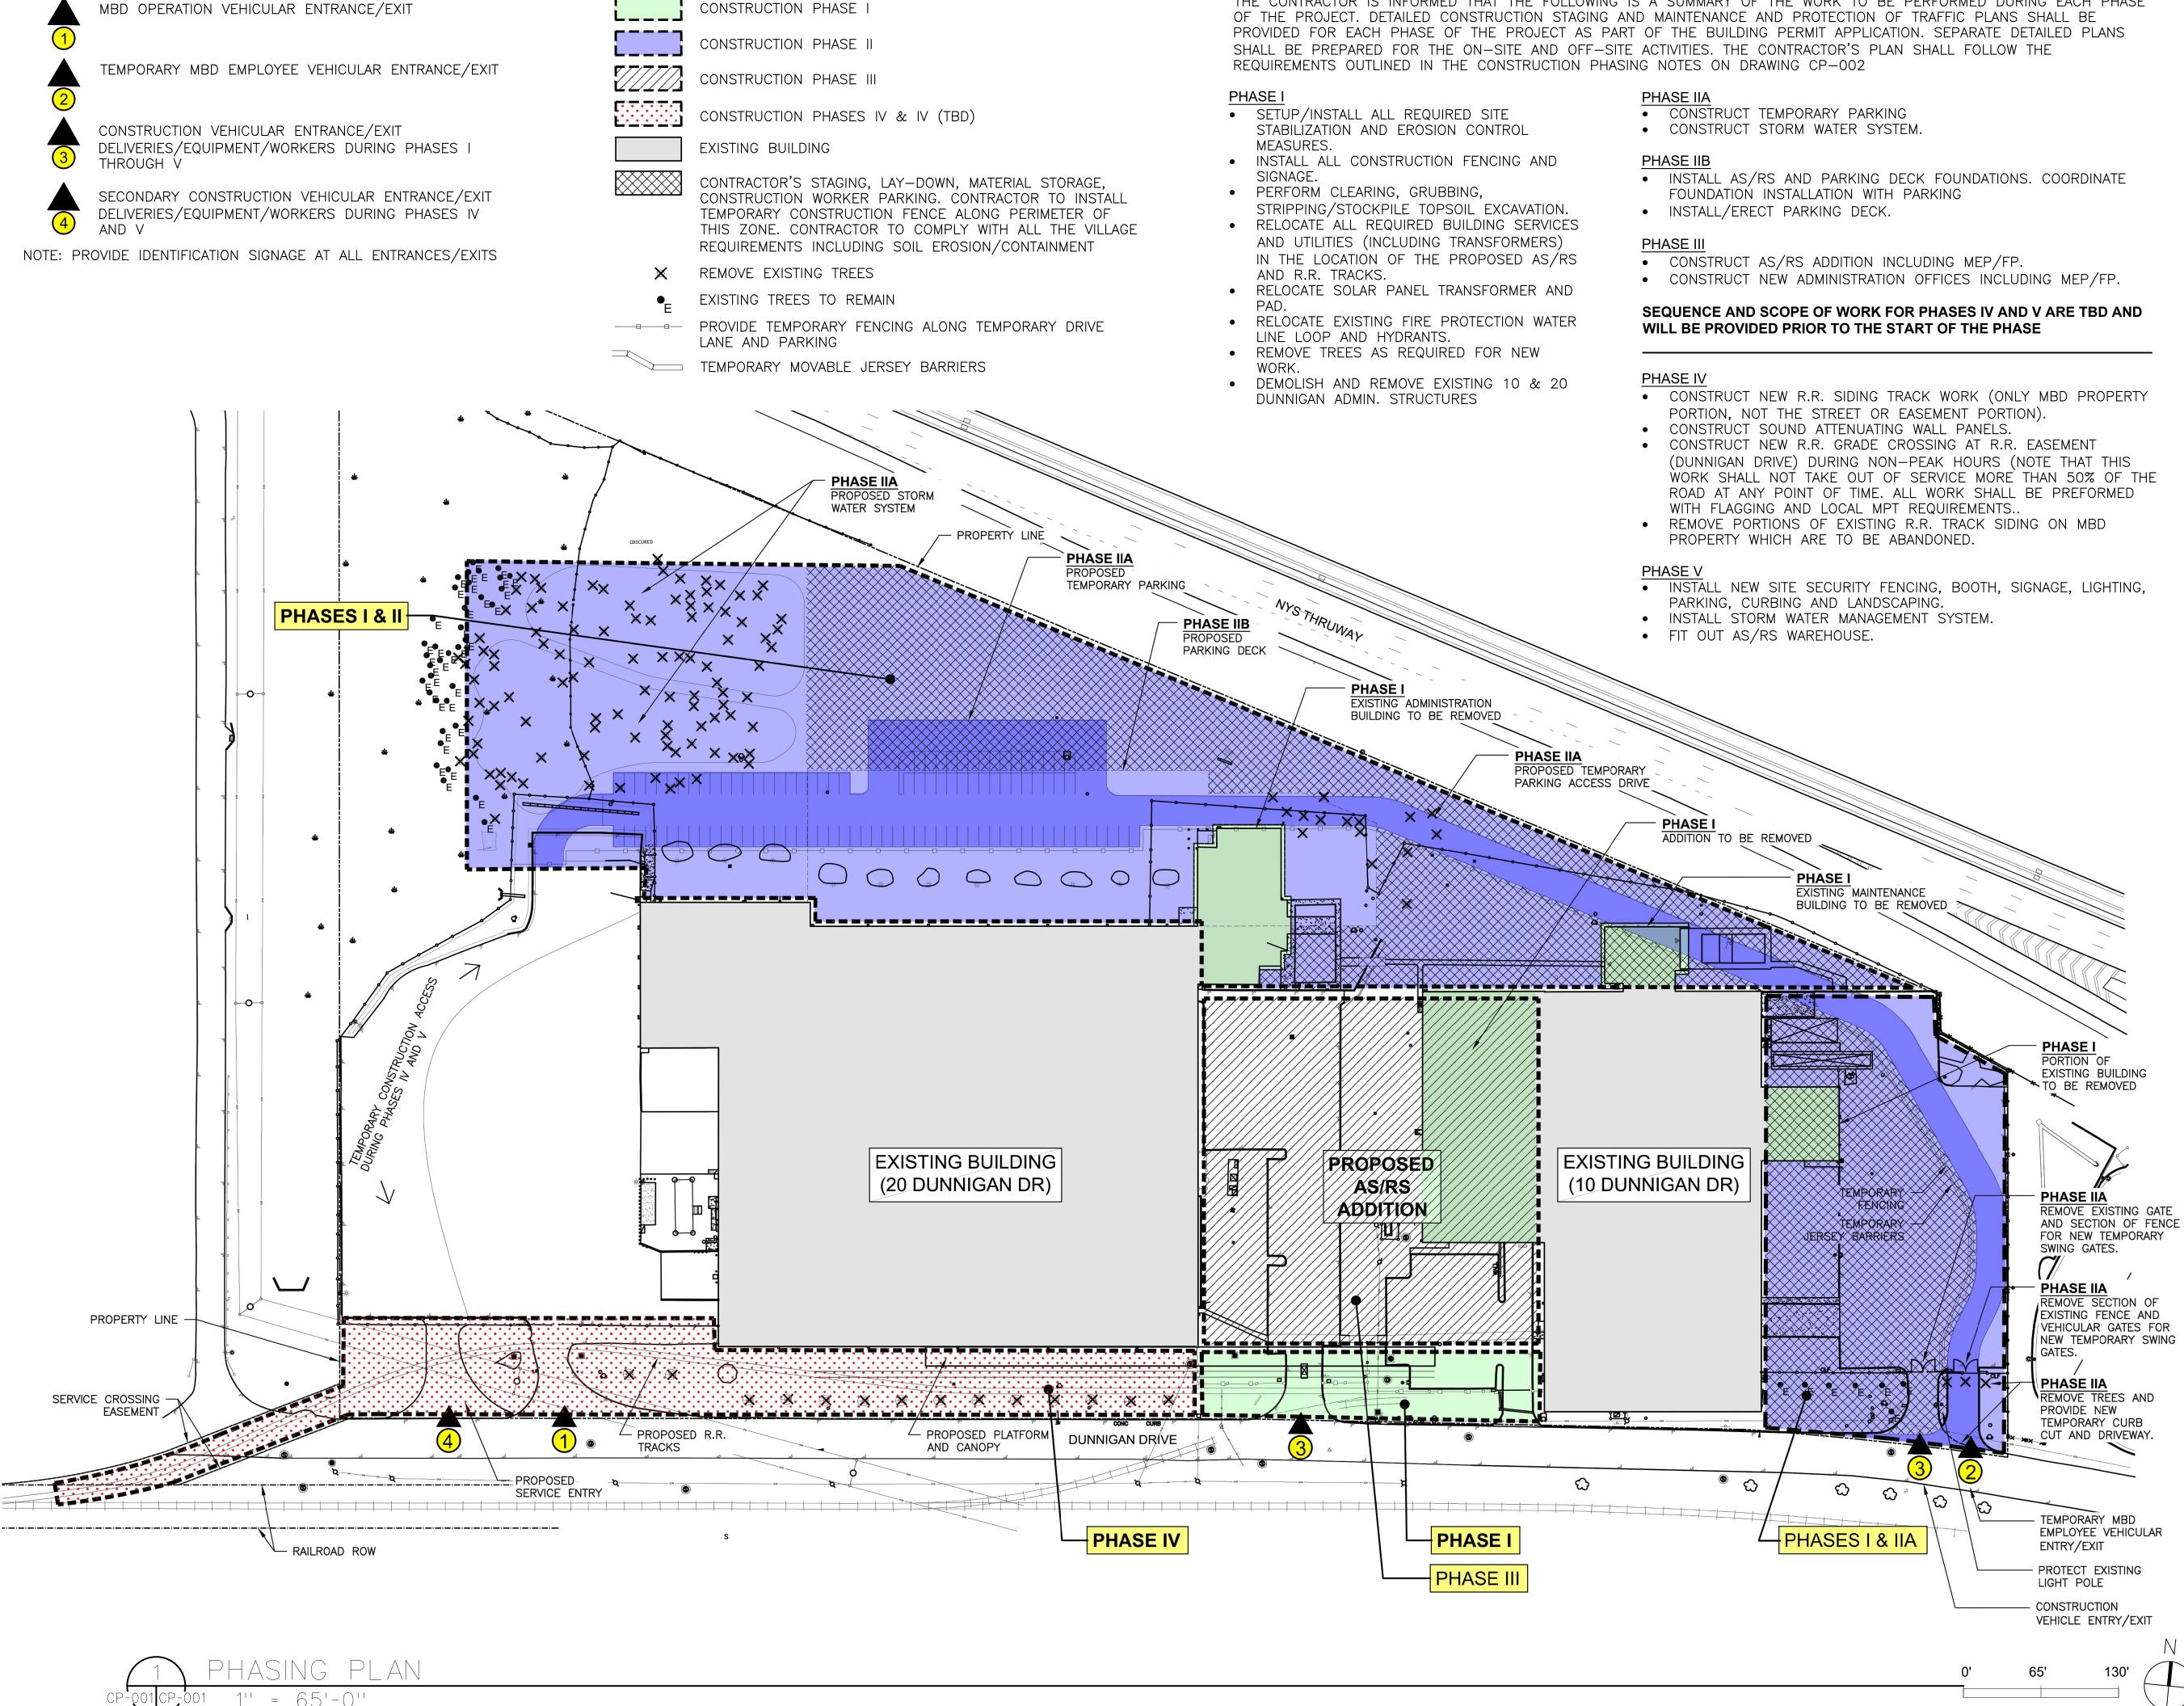
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PHASING (SEQUENCES) NOTES





ARCHITECT



di Domenico + Partners LLP

Landscape Architecture Planning 3743 Crescent Street. 3rd Floor Long Island City, New York 11101 Tel 212-337-0400 Fax 212-337-3567

CIVIL PLANNING ENGINEER

Architecture



JMC Planning Engineering Landscape Architecture & Land Surveying, PLLC 120 Bedford Road Armonk, New York 10504 Tel 914-273-5225 Fax 914-273-2102

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New York, New York 10001

Tel 212-962-3503




MANHATTAN BEER DISTRIBUTORS 20 DUNNIGAN DRIVE SUFFERN, NEW YORK

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CONSTRUCTION PHASING PLAN



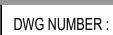

CONSTRUCTION PHASING NOTES

- 1. THE CONSTRUCTION PHASING PLANS ARE PROVIDED TO SHOW THE GENERAL/INTENDED PHASING FOR THE MANHATTAN BEER DISTRIBUTORS (MBD) EXPANSION PROJECT. DETAILED CONSTRUCTION STAGING PLANS AND MAINTENANCE AND PROTECTION OF TRAFFIC PLANS FOR EACH IDENTIFIED PHASE OF THE PROJECT SHALL BE PREPARED BY A PROFESSIONAL ENGINEER LICENSED IN THE STATE OF NEW YORK. THESE PLANS SHALL BE PREPARED IN CLOSE COORDINATION WITH MBD AND THE SELECTED CONTRACTOR. UPON COMPLETION, THEY SHALL BE SUBMITTED TO THE VILLAGE AS PART OF THE BUILDING PERMIT APPLICATION FOR REVIEW AND APPROVAL OF THE VILLAGE ENGINEER. THE PLANS SHALL INCORPORATE THE REQUIREMENTS OUTLINED BELOW AND ANY FURTHER SPECIAL REQUIREMENTS OUTLINED IN A RESOLUTION OF APPROVAL
- 2. THE CONTRACTOR IS INFORMED THAT MANHATTAN BEER DISTRIBUTORS (MBD) WILL REMAIN IN OPERATION THROUGHOUT THE COURSE OF CONSTRUCTION. IT SHALL BE THE CONTRACTORS RESPONSIBILITY TO PERFORM THE ON SITE CONSTRUCTION, WHILE PROVIDING SAFE, WELL-LIGHTED, VEHICULAR AND PEDESTRIAN CIRCULATION THROUGH THE SITE, AS WELL AS PARKING FACILITIES FOR MBD STAFF AND VISITORS.
- 3. THE CONTRACTOR IS INFORMED THAT DUNNIGAN DRIVE PROVIDES VEHICULAR AND PEDESTRIAN ACCESS TO THE PROJECT SITE, AS WELL AS ADJACENT PARCELS AND IS TO REMAIN IN OPERATION THROUGHOUT THE COURSE OF CONSTRUCTION. IT SHALL BE THE CONTRACTORS RESPONSIBILITY TO PERFORM THE CONSTRUCTION WITHIN DUNNIGAN WHILE MAINTAINING SAFE, WELL-LIGHTED, VEHICULAR AND PEDESTRIAN CIRCULATION ALONG DUNNIGAN DRIVE.
- 4. THE CONSTRUCTION STAGING PLANS SHALL, AT A MINIMUM, SHOW AREAS FOR CONSTRUCTION TRAILERS, STORAGE OF CONSTRUCTION MATERIALS, PARKING FOR CONTRACTORS, PARKING FOR MBD, AND VEHICULAR AND PEDESTRIAN CIRCULATION. ALL TRAILERS, DELIVERY/STORAGE OF MATERIALS, PARKING, ETC., SHALL BE PROVIDED/PERFORMED WITHIN THE PROJECT SITE, NOT ALONG DUNNIGAN DRIVE. SHOULD THE CONTRACTOR REQUIRE ADDITIONAL SPACE FOR PARKING, THEY MAY ELECT TO FIND AN OFF SITE LOCATION AND SHUTTLE THE CONSTRUCTION STAFF TO/FROM THE SITE. ON-SITE PARKING SHALL BE PROVIDED FOR ALL MBD STAFF AND VISITORS THROUGHOUT CONSTRUCTION, UNLESS OTHERWISE APPROVED BY MBD. CONTRACTOR SHALL BE RESPONSIBLE FOR ALL COSTS ASSOCIATED WITH OFF-SITE PARKING AND SHUTTLE SERVICES THE VILLAGE SHALL BE INFORMED OF THE LOCATION OF THE OFF SITE PARKING.
- 5. ALL WORK SALLY BE PERFORMED AT TIMES PERMITTED BY VILLAGE CODE SECTION 118-4(C), EXCEPT THAT THE CONTRACTOR MAY ELECT TO PERFORM THE OFF SITE IMPROVEMENTS DURING OFF HOURS TO MINIMIZE IMPACTS TO THE VEHICULAR AND PEDESTRIAN OPERATIONS ALONG DUNNIGAN DRIVE. ANY WORK TO BE PERFORMED OUTSIDE THE HOURS PERMITTED BY VILLAGE CODE SECTION 118-4(C) SHALL BE SUBJECT TO THE REVIEW AND APPROVAL OF THE VILLAGE BUILDING INSPECTOR.
- 6. ALL WORK SHALL BE PERFORMED IN ACCORDANCE WITH THE RULES AND REGULATIONS OF ALL AUTHORITIES HAVING JURISDICTION. THE CONTRACTOR SHALL BE RESPONSIBLE FOR OBTAINING ALL PERMITS AND APPROVALS.
- 7. TEMPORARY CLOSURES OF DUNNIGAN DRIVE SHALL BE LIMITED TO ONE LANE (DIRECTION) AT A TIME. ALL CLOSURES SHALL BE CONTROLLED BY TRAINED FLAG PERSONS. LANE CLOSURES SHALL NOT TAKE PLACE DURING THE PEAK HOURS OF 7 AM TO 9 AM AND/OR 4 PM TO 6 PM. PER NOTE 5 ABOVE, THE CONTRACTOR MAY REQUEST APPROVAL OF THE VILLAGE BUILDING DEPARTMENT TO PERFORM WORK WITHIN DUNNIGAN DRIVE OUTSIDE THE HOURS PERMITTED BY VILLAGE CODE SECTION 118-4(C). AT ANY POINT DURING CONSTRUCTION, THE VILLAGE MAY REQUIRE THE USE OF POLICE OFFICERS TO PROVIDE TRAFFIC CONTROL. THE COST OF THE POLICE OFFICERS, IF REQUIRED, SHALL BE THE RESPONSIBILITY OF THE CONTRACTOR AND AT NO EXPENSE TO THE VILLAGE.
- 8. THE CONTRACTOR SHALL SCHEDULE A PRE-CONSTRUCTION MEETING PRIOR TO THE START OF CONSTRUCTION, WHICH SHALL HAVE ALL INVOLVED PARTIES PRESENT. INVOLVED PARTIES SHALL INCLUDE BUT NOT BE LIMITED TO MBD, THE CONTRACTOR, THE DESIGN TEAM, VILLAGE OF MONTEBELLO, TOWN OF RAMAPO, COUNTY OF ROCKLAND, TRAIN TRACK OWNER/OPERATOR.
- 9. SITE ACCESS BY CONSTRUCTION VEHICLES AND CONTRACTOR STAFF SHALL BE LIMITED TO ENTRANCE #2, AS IDENTIFIED ON THE CONSTRUCTION PHASING PLAN. ENTRANCES #1 AND #3 SHALL BE DEDICATED TO THE ONGOING OPERATIONS OF MBD. STAGING PLANS SHALL INCLUDE TEMPORARY SIGNAGE TO DIRECT MBD STAFF/VISITORS AND CONTRACTORS TO APPROPRIATE SITE ENTRANCES.
- 10. ALL FIRE AND LIFE SAFETY SYSTEMS SHALL REMAIN IN PLACE AND OPERATIONAL DURING THE COURSE OF CONSTRUCTION. ANY TEMPORARY SHUT DOWNS SHALL REQUIRE THE APPROVAL OF THE VILLAGE OF MONTEBELLO AND SHALL BE SUBJECT TO ANY REQUIREMENTS SET FORTH BY THE BUILDING INSPECTOR AND/OR FIRE INSPECTOR.

MANHATTAN BEER DISTRIBUTORS CONSTRUCTION OPERATION NOTES


WILL BE MAINTAINED AND OPERATED.

2. MANHATTAN BEER DISTRIBUTORS PLANS TO MINIMIZE VEHICULAR TRIPS ON DUNNIGAN DRIVE DURING CONSTRUCTION PERIOD BY IMPLEMENTING THE FOLLOWING: ALL ADMINISTRATION AND OFFICE STAFF (APPROX. 26 PEOPLE) WILL WORK REMOTELY OR FROM OTHER MBD FACILITIES IN NYC DURING THE CONSTRUCTION PERIOD THEREBY MINIMIZING VEHICLES COMING TO 10 AND 20 DUNNIGAN DRIVE. • MBD WILL SHIFT APPROXIMATELY 25% OF WAREHOUSE DISTRIBUTION ACTIVITY TO OTHER WAREHOUSE FACILITIES WITHIN THE 5 BOROUGHS OF NEW YORK CITY. THIS WILL REDUCE TRUCK ACTIVITY DURING THIS PERIOD BY 25%. THE TRANSFERRING OF 25% ROUTES WILL RESULT IN 15 DELIVERY ROUTES BEING TRANSFERRED. THE RESULT WILL EQUAL (APPROX.):

1. MBD SHALL PREPARE A BUSINESS OPERATIONS PLAN, WHICH SHALL SHOW HOW THE PORTIONS OF THE BUILDINGS AND SITE AVAILABLE TO THEM DURING CONSTRUCTION

> • 15 LESS DRIVERS WITH THEIR CARS • 15 LESS TRUCKS LEAVING IN THE MORNING • 15 LESS TRUCKS RETURNING IN THE AFTERNOON

- 5 LESS LOADERS AND THEIR CARS IN THE EVENING SHIFT
- 2 LESS SUPERVISORS AND THEIR CARS • 1 LESS MANAGER AND HIS CAR

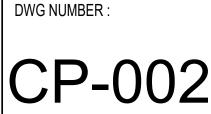

CONSTRUCTION PHASING NOTES

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DRAWN BY :	S. WOO
CHECKED BY :	D. TOBAR, R.A.
APPROVED BY :	A. BERGER, R.A.
DATE :	07.30.2021
SCALE :	AS NOTED

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MANHATTAN BEER DISTRIBUTORS 20 DUNNIGAN DRIVE

SUFFERN, NEW YORK

GEI Consultants

GEI50

Fax 212-337-3567

ARCHITECT

JMC Planning Engineering Landscape Architecture & Land Surveying, PLLC 120 Bedford Road Armonk. New York 10504 Tel 914-273-5225 Fax 914-273-2102

Tel 212-962-3503

1385 Broadway, 20th FL

Tel 212-687-8282

New York, New York 10018



STRUCTURAL ENGINEER

CIVIL PLANNING ENGINEER

Architecture Landscape Architecture Planning 3743 Crescent Street, 3rd Floor Long Island City, New York 11101 Tel 212-337-0400

di Domenico + Partners LLP

DEFINITIONS

- 1. OWNER MANHATTAN BEER DISTRIBUTORS OR ITS AUTHORIZED REPRESENTATIVES
- 2. ARCHITECT DI DOMENICO + PARTNERS, LLP
- 3. CONTRACTOR- CLARIS DESIGN BUILD

ARCHITECTURAL GENERAL NOTES

- 1. CODES AND STANDARDS
 - 1.1. 2020 BUILDING CODE OF NEW YORK STATE
 - 1.2. 2020 ENERGY CONSERVATION CODE OF NEW YORK STATE
 1.3. 2020 FIRE CODE OF NEW YORK STATE
- 2. ALL WORK SHALL BE OF HIGHEST QUALITY, PERFORMED IN A NEAT WORKMANLIKE MANNER, EXECUTED IN ACCORDANCE WITH THE BEST ACCEPTED TRADE PRACTICES AND AS PER MANUFACTURERS' RECOMMENDATIONS.
- 3. THE CONTRACTOR SHALL NOTIFY THE ARCHITECT OF ANY AND ALL DISCREPANCIES BETWEEN EXISTING CONDITIONS AND THE CONTRACT DOCUMENTS BEFORE SUBMITTING SHOP DRAWINGS OR PLACING ORDERS OR PROCEEDING WITH THAT PORTION OF THE WORK DURING THE COURSE OF THE CONTRACT. FAILURE TO NOTIFY THE ARCHITECT WILL NOT RELIEVE THE CONTRACTOR OF RESPONSIBILITY TO PERFORM THE WORK AS INTENDED BY THE CONTRACT DOCUMENTS. THE CONTRACTOR SHALL CORRECT ANY AND ALL WORK ARISING FROM SUCH FAILURE TO COORDINATE DISCREPANCIES TO THE SATISFACTION OF THE ARCHITECT.
- 4. THE CONTRACTOR SHALL BE RESPONSIBLE FOR AND SHALL CHECK AND VERIFY ALL DIMENSIONS AND JOB CONDITIONS IN THE FIELD. HE SHALL NOTIFY THE ARCHITECT OF ANY DISCREPANCIES PRIOR TO SUBMITTING SHOP DRAWINGS AND PLACING ORDERS DURING THE COURSE OF THE CONTRACT.
- 5. THE CONTRACTOR SHALL PROTECT AND PRESERVE ALL EXISTING ITEMS TO REMAIN AND SHALL REPAIR OR REPLACE ANY ITEM DAMAGED DURING THE COURSE OF WORK TO THE SATISFACTION AND APPROVAL OF THE ARCHITECT WITHOUT ADDITIONAL COST TO THE OWNER.
- 6. ANY DAMAGE TO INSTALLED FINISHES OR EQUIPMENT CAUSED BY THE WORK OF THE CONTRACT SHALL BE REPLACED AND REINSTALLED BY THE CONTRACTOR AT NO ADDITIONAL EXPENSE TO THE OWNER.
- 7. ALL WORK TO BE IN COMPLIANCE WITH THE 2020 BUILDING CODE OF NEW YORK STATE AND THE 2020 ENERGY CONSERVATION CODE OF NEW YORK STATE. ANY OR ALL DISCREPANCIES SHALL BE CALLED TO THE ATTENTION OF THE ARCHITECT.
- 8. THE CONTRACTOR SHALL BE RESPONSIBLE FOR BUILDING IN ALL RECESSED ITEMS SUCH AS CONCEALED CONDUITS, PIPES, WIRES, JUNCTION BOXES, OUTLET BOXES, ETC. AND ANY OPENINGS REQUIRED IN MASONRY WALLS, CONCRETE WALLS AND CONCRETE SLABS.
- 9. THE CONTRACTOR SHALL EXAMINE ALL DRAWINGS AND COORDINATE WORK OF ALL TRADES AND VERIFY THE LOCATION OF FIXTURES. EQUIPMENT. ROUGHING. ETC.
- 10. DO NOT SCALE DRAWINGS. FOLLOW WRITTEN DIMENSIONS ONLY. DIMENSIONS SHOWN ARE NORMALLY GIVEN TO:
 - A. COLUMN CENTER LINES
 - B. FACES OF CONCRETE AND MASONRY SURFACES
 - C. FACE OF GYPSUM BOARD PARTITIONS AND CEILINGS D. EXTERNAL FACE OF BUILDING
 - E. CURB LINE
- 11. PATCH ALL DAMAGED CONCRETE SURFACES WITH SIMILAR MATERIALS.
- 12. ELEVATIONS INDICATED ON ALL DRAWINGS REFER TO SURVEY DATUM.
- 13. ALL MATERIAL AND WORK REQUIRED OR CALLED OUT ON THE DRAWINGS ARE INTENDED TO BE NEW UNLESS OTHERWISE NOTED.
- 14. ALL DISSIMILAR MATERIALS, INCLUDING METALS IN CONTACT WITH EACH OTHER SHALL BE SEPARATED IN AN APPROVED MANNER.15. ALL DETAILS SHOWN ARE TYPICAL. CONTRACTOR SHALL APPLY
- SAME CONCEPTS FOR CONDITIONS NOT SHOWN TO MAINTAIN UNIFORMITY OF DESIGN AND INTEGRITY OF CONSTRUCTION.
- 16. CONTRACTOR SHALL PROVIDE SECURE PROTECTION FOR ALL OPENINGS IN FLOORS, WALLS AND ROOFS.
- 17. MINIMUM HEADROOM CLEARANCE SHALL BE 80" WITHIN A ROOM OR SPACE ALONG A 36"-WIDE (MIN.) DESIGNATED AISLE LEADING TO THE EGRESS FROM THE SPACE. THE CONTRACTOR SHALL PROVIDE AND INSTALL SIGNS READING: "CAUTION: LOW HEADROOM" AND PROVIDE AND INSTALL SAFETY YELLOW COLOR PADDING ON ALL PIPING, STEEL BRACKETS, ETC., WHERE EQUIPMENT PROJECTS BELOW THAT CLEARANCE WITHIN THE SPACE.
- 18. ALL WOOD SHALL BE FIRE RETARDANT AND TREATED TO COMPLY WITH 2020 BUILDING CODE OF NEW YORK STATE.
- 19. PROVIDE ALL BLOCKING AND ANCHORAGE AS REQUIRED. ANCHOR BOLTS SHALL BE STAINLESS STEEL AS MANUFACTURED BY HILTI-KWIK OR APPROVED EQUAL OR AS OTHERWISE NOTED.
- 20. PROVIDE TEMPORARY STAIR HANDRAILS DURING CONSTRUCTION.
 21. FOR SURFACE PREPARATION AND PAINTING CONTRACTOR MUST REMOVE ALL OIL, DIRT, LOOSE PAINT, RUST, PEELING PAINT AND OTHER CONTAMINANTS TO ENSURE FULL ADHESION.
 SURFACES MUST BE DRY, FREE OF CONCRETE DUST AND LOOSE CEMENT, AND IN SOUND CONDITION.

- 22. SAFETY DURING DEMOLITION AND WITH THE 2020 FIRE CODE OF N BUILDING CODE OF NEW YORK ST
- 23. NO DEBRIS SHALL BE ALLOWED DEBRIS SHALL BE REMOVED DAIL
- 24. ALL DEMOLITION AND REMOVALS EACH TRADE TO ENSURE THE CO THE EXISTING FACILITY. CONTRAC DEMOLITION WORK WITH NEW CON ENSURE THAT ITEMS OR SERVICES NOT DISTURBED.
- 25. THE CONTRACTOR SHALL PROVID (BLUE) COVER AND DUST PARTIT FROM BALANCE OF OCCUPIED SP DIRECTED BY THE ARCHITECT.
- 26. WHERE APPLICABLE, ALL NEWLY SHALL COMPLY WITH THE FLAME 2020 BUILDING CODE OF NEW YC
- 27. ALL EXISTING EXPOSED STEEL SH ON DRAWINGS. MACHINE TOOL C AREAS TO BE PAINTED AND EPO
- 28. THE CONTRACTOR SHALL PROPE FURNISHED BY THE OWNER.
- 29. ALL COLORS ARE TO BE SUBMIT APPROVAL.
- 30. COORDINATE ALL WORK WITH THE DISCIPLINES, INCLUDING BUT NOT MECHANICAL, ELECTRICAL, PLUME DRAWINGS.
- 31. ALL FASTENERS TO COMPLY WITH YORK STATE.
- 32. CONTRACTOR SHALL SUBMIT PRO STORAGE PLANS FOR REVIEW BY STORAGE ACTIVITIES SHALL BE C
- 33. THE CONTRACTOR SHALL COORDI CONTRACT WITH ANY AND ALL R WORK/PROJECTS BY OTHER CON PLANNED OR ONGOING.
- 34. THE CONTRACTOR SHALL VERIFY QUANTITIES IN THE FIELD PRIOR
- 35. DETAILS NOT SHOWN OR SPECIFIE PROPER AND ACCEPTABLE CONST OPERATION OF ANY PART OF THE ARCHITECT, SHALL BE INCLUDED HEREIN SPECIFIED OR INDICATED.
- 36. DURING ALL PHASES OF THE WO SHALL BE MAINTAINED WATERTIGH
- 37. CONTRACTOR SHALL PROVIDE TEM EXISTING BUILDING.
- 38. EXISTING PHOTOVOLTAIC PANELS MAINTAINED & PROTECTED AT AL
- 39. PROVIDE TWO-HOUR RATED FIRES
 - 39.1. PENETRATIONS THROUGH AN
 - 39.2. PENETRATIONS THROUGH AN
- 39.3. PENETRATIONS THROUGH ST FLOORS/LEVELS
- 39.4. PENETRATIONS THROUGH WA TELCO., IT, MECHANICAL CLO
- 39.5. PENETRATIONS THROUGH WA OCCUPANCIES (E.G. ADMINIS WAREHOUSE, ETC.)
- 40. IF ANY FOUNDATION WORK OR OT EXCAVATION WORK IS TO BE DON WITH THE FORCE MAIN, ROCKLAND SHALL BE NOTIFIED AT LEAST FOR ADVANCE. IF REQUIRED, SHORING PRECAUTIONS SHALL BE IMPLEMEN MAIN. THE CONTRACTOR SHALL OF PERMIT(S) AT THE CONTRACTOR'S
- 41. CONTRACTOR SHALL PREVENT ANY TO THE EXISTING FORCE MAIN, TH DISTRICT MUST BE NOTIFIED IF AN WITHIN THE RIGHT-OF-WAY OVER MODIFIED. THIS INCLUDES BUT NO LOWERING/RAISING OF MANHOLE OFFICE MUST APPROVE ANY CHAN
- 42. THE CONTRACTOR MUST OBTAIN F SIGN A WAIVER TO DEFEND, INDE HARMLESS BOTH THE COUNTY OF COUNTY SEWER DISTRICT NO. 1 F FROM PERFORMED WITHIN THE RIM
- 43. PRIOR TO THE REMOVAL OF ABAN THE CONTRACTOR SHALL OBTAIN FOLLOW PROPER REMOVAL PROCE

	SYMBOLS:	ABBREVIATIONS:	ARCHITECT
ND CONSTRUCTION SHALL COMPLY NEW YORK STATE AND THE 2020 STATE.			di Domenico + Partners LLP Architecture Landscape Architecture
D TO ACCUMULATE ON THE SITE. AILY. LS ARE TO BE COORDINATED WITH	EXISTING WALL	CCENTERLINEN.I.C.NOT IN CONTRACTATNO.NUMBERN.T.S.NOT TO SCALE	Planning 3743 Crescent Street, 3rd Floor Long Island City, New York 11101
CONTINUITY OF ALL SERVICES TO RACTOR SHALL COORDINATE CONSTRUCTION DRAWINGS TO ICES WHICH ARE TO REMAIN ARE	— — — WORK TO BE REMOVED — — (demolition work)	AC.PNL.ACCESS PANELA.C.T.ACOUSTICAL CEILING TILEO.C.ON CENTERA/CAIR CONDITIONINGO.D.OUTSIDE DIAMETERA.D.A.AMERICANS WITHO.H.OVERHEADDISABILITIES ACTOPER.OPERABLE	Tel 212-337-0400 Fax 212-337-3567 CIVIL PLANNING ENGINEER JMC Planning Engineering Landscape Architecture & Land Surveying, PLLC
VIDE AND MAINTAIN PAINTED TITIONS CLOSING THE WORK AREA SPACE WITHIN THE BUILDING AS	ASSIGNED SECTION, OR ELEVATION NUMBER	ADJ. ADJUSTABLE OPNG. OPENING A.F.F. ABOVE FINISH FLOOR OPP. OPPOSITE ALUM. ALUMINUM ANOD. ANODIZED APP'D APPROVED P.A. PUBLIC ADDRESS	120 Bedford Road Armonk, New York 10504 Tel 914-273-5225 Fax 914-273-2102
Y INSTALLED INTERIOR FINISHES ME SPREAD REQUIREMENTS OF THE YORK STATE.	DRAWING SECTION OR ELEVATION IS SHOWN	APPROX. APPROXIMATE PART. PARTITION ARCH. ARCHITECT(URAL) PL. PLATE PLBG. PLUMBING PLWD. PLYWOOD	MEP ENGINEER BURNS ENGINEERING, PC. 1261 Broadway, Suite 708 New York, New York 10001
SHALL BE PAINTED AS INDICATED L CLEAN TO SHINY METAL ALL POXY PAINT. PERLY INSTALL ALL ITEMS	ASSIGNED DETAIL NUMBER	BD.BOARDPR.T.PORCELAIN TILEBTW.BETWEENPRE-FABPRE-FABRICATEDBLDG.BUILDINGPSIPOUNDS PER SQUARE INCHBLVD.BOULEVARDPT.POINTPTD.PAINTEDPAINTED	Tel 212-962-3503 STRUCTURAL ENGINEER GEI50 1385 Broadway, 20th FL
ITTED TO THE ARCHITECT FOR	DRAWING WHERE DETAIL IS SHOWN	C.I.P. CAST IN PLACE PVC POLYVINYL CHLORIDE C.J. CONTROL JOINT CLG. CEILING QTY. QUANTITY	GEI Consultants New York, New York 10018 Tel 212-687-8282
THE SCOPE OF WORK OF OTHER IOT LIMITED TO STRUCTURAL, IMBING AND FIRE PROTECTION WITH 2020 BUILDING CODE OF NEW	• T.O. SLAB EL. ##.##' REFERENCE EL. ##.##' ELEVATION	C.M.U. CONCRETE MASONRY UNIT COL. COLUMN R RISER COMM. COMMUNICATION(S) RAD. RADIUS CONC. CONCRETE R.D. ROOF DRAIN CONT. CONTINUE(OUS) REINF. REINFORCEMENT/ CONSTR. CONSTRUCTION REINFORCING C.T. CERAMIC TILE REQ'D REQUIRED	
PROPOSED PROJECT STAGING AND BY THE ARCHITECT. STAGING AND E COORDINATED WITH THE OWNER. RDINATE THE WORK OF THIS	INTERIOR ELEVATION DESIGNATION DRAWING WHERE	C.T. CERAMIC TILE REQ'D REQUIRED REV. REVISE/REVISION RM. ROOM DET. DETAIL R.O. ROUGH OPENING DIA. DIAMETER R.O.W. RIGHT-OF-WAY DIM. DIMENSION DISP. DISPLAY	BEER DISTRIBUTORS
RELATED AND/OR UNRELATED ONTRACTORS THAT IS/ARE	DETAIL IS SHOWN	DIV. DIVISION SCHED. SCHEDULE DWG. DRAWING S.G.F.T. STRUCTURAL GLAZED FACING TILE E.J. EXPANSION JOINT SIM SIMULAD	20 DUNNIGAN DRIVE SUFFERN, NEW YORK
OR TO PERFORMING ANY WORK. CIFIED, BUT NECESSARY FOR NSTRUCTION, INSTALLATION OR THE WORK AS DETERMINED BY THE ED IN THE WORK THE SAME AS IF		E.O.EXTANSION COUNTSIMILEL.ELEVATIONSIM.SIMILARELEC.ELECTRIC(AL)SPEC.SPECIFICATIONELEV.ELEVATORSQ.SQUAREENCL.ENCLOSURES.S.SLOP SINKENG.ENGINEER(ING)S.S.B.STATION SERVICE BOARDE.P.R.ELECTRICAL PANEL ROOMSTA.STATION	
ED. WORK THE BUILDING ENVELOPE IGHT BY THE CONTRACTOR. TEMPORARY PROTECTION OF	COLUMN (20)	EQUIP. EQUIPMENT E.W.C. ELECTRIC WATER COOLER EXH. FN. EXHAUST FAN EXIST. EXISTING EXT EXTERIOR EXT EXT EXTERIOR EXT EXT EXTERIOR EXT EXT EXTERIOR EXT EXT EXTERIOR EXT EXT EXTERIOR EXT EXT EXT EXT EXT EXT EXT EXT EXT EXT	
S TO REMAIN SHALL BE ALL TIMES DURING THE THE WORK. RESTOPPING AT THE FOLLOWING	CENTER LINE	F.D. FLOOR DRAIN FIN. FINISH F F FINISH FLOOR FIN. FINISH FLOOR FINISH FLOOR FINISH FLOOR FINISH FLOOR FINISH FLOOR FINISH FLOOR FINISH FLOOR	
ANY/ALL FLOORS ANY/ALL WALLS STAIR ENCLOSURE WALLS AT ANY	COLUMN (20) CENTER LINE	FL.FLOORTEMP.TEMPORARYF.P.FIREPROOFINGTEL.TELEPHONEF.R.P.FIBERGLASS REINFORCEDT>ONGUE AND GROOVEPLASTICTH.THICK(NESS)FT.FOOT OR FEETT.O.TOP OFTRTRASH RECEPTACLE	
WALLS AT ALL ELECTRICAL, CLOSETS, AND ROOMS. WALLS AND FLOORS BETWEEN INISTRATION OFFICE/SPACES,	LINE(20) EXISTING COLUMN GRID	GA.GAUGET.T.B.TELEPHONETERMINALBOXGALV.GALVANIZEDT.T.Y.TEXT-TYPETELEPHONEG.C.GENERAL CONTRACTORTYP.TYPICALGL.GLASS OR GLAZINGH.O.N.HNLESS OTHERWISE NOTED	
OTHER TYPES OF MAJOR DONE NEAR THE RIGHT—OF—WAY AND COUNTY SEWER DISTRICT	### ROOM NAME ROOM NAME SPACE NUMBER	GYP.BD. GYPSUM BOARD V.B. VINYL BASE VCT VINYL COMPOSITION THE	REVDESCRIPTIONDATE-ISSUED FOR DOB SUBMISSION9.10.21-ISSUED FOR BID10.15.21
FORTY-EIGHT (48) HOURS IN ING OR OTHER TYPES OF MENTED TO PROTECT THE FORCE OBTAIN ALL NECESSARY	ZA- ZA WALL/PARTITION TYPE IDENTIFICATION	HDWR.HARDWAREVERT.VERTICALH.M.HOLLOW METALVERT.VERTICALHOR.HORIZONTALVEST.VESTIBULEHPHIGH POINTV.I.F.VERIFY IN FIELDHR.HOURVIII FIELDVIII FIELD	- ISSUED FOR CONSTRUCTION 11.30.21
R'S EXPENSE. ANY DAMAGES FROM OCCURRING , THE ROCKLAND COUNTY SEWER	(101) WINDOW, LOUVER OR TRANSLUCENT PANEL TYPE IDENTIFIER	HT. HEIGHT W.C. WATER CLOSET HVAC HEATING, VENTILATION W.P. WATERPROOFING AND AIR CONDITIONING W/ WITH W/O WITHOUT	
ANY PORTION OF THE LAND /ER THE FORCE MAIN IS TO BE NOT LIMITED TO REGRADING AND LE FRAMES. THE SEWER DISTRICT	(102) DOOR NUMBER (T33) OVERHEAD DOOR NUMBER	I.D. INSIDE DIAMETER IN INCH OR INCHES INSUL. INSULATION INT. INTERIOR	DRAWN BY : S. WOO CHECKED BY : D. TOBAR, R.A.
HANGES. N REQUIRED INSURANCE AND NDEMNIFY, SAVE AND HOLD	FD FLOOR DRAIN	J. JOINT	APPROVED BY : A. BERGER, R.A.
OF ROCKLAND AND ROCKLAND 1 FROM ANY CLAIMS ARISING	F.E. — FIRE EXTINGUISHER	LAV. LAVATORY	DATE : 07.30.2021 SCALE : AS NOTED
RIGHT-OF-WAY OVER THE FORCE BANDONED MONITORING WELLS,	S.P. 🔶 STARTING POINT	MACH. MACHINE Maint. Maintenance	
IN THE REQUIRED PERMITS AND OCEDURES.	10 PROPOSED KEY NOTES. REFER TO SHEET A-004	MAS. MASONRY MAT. MATERIAL MAX. MAXIMUM MECH. MECHANICAL MEZZ. MEZZANINE	GENERAL NOTES, SYMBOLS, AND
	Q ACCESSORY & FIXTURE TYPE IDENTIFICATION	MFR. MANUFACTURER M.H. MANHOLE MIN. MINIMUM	ABBREVIATIONS DWG NUMBER :
		MISC. MISCELLANEOUS M.O. MASONRY OPENING MTD. MOUNT(ED) MTL. METAL	A-001


ROOFING NOTES:

1. GENERAL

- A. EXISTING ROOFING TO REMAIN SHALL BE PROTECTED AT ALL TIMES DURING THE WORK.
- B. ALL NEW ROOF SYSTEMS SHALL COMPLY WITH UL CLASS 'A' EXTERNAL FIRE RESISTANCE RATING. C. INSULATION FOR NEW ROOFING ASSEMBLIES SHALL HAVE A MINIMUM AGED R-VALUE OF R-30 AND SHALL BE CONTINUOUS AND INSTALLED ABOVE DECK.
- D. DURING ROOF WORK THE CONTRACTOR SHALL PROTECT ALL AIR INTAKES AND WINDOWS FROM CHEMICAL FUMES ENTERING THE BUILDING.
- E. SUBMIT SHOP DRAWINGS FOR ALL ROOF WORK. SHOP DRAWINGS OF AL ROOFS SHALL INDICATE
- EXISTING HIGH AND LOW POINTS, ROOF SLOPES, DRAIN LOCATIONS, PENETRATIONS, AND DETAILS. F. PROVIDE SUBMITTALS FOR ALL ROOFING MATERIALS, INCLUDING BUT NOT LIMITED TO INSULATION, PROTECTION BOARD, ROOF MEMBRANE, FLASHING AND ACCESSORIES.
- 2. REPAIRS/MODIFICATION OF EXISTING ROOFING
- A. PRIOR TO PERFORMING ANY ROOFING REMOVALS THE CONTRACTOR SHALL SUBMIT TO THE ARCHITECT PROOF THAT THE POST WARRANTY ALTERATION NOTIFICATION HAS BEEN SUBMITTED TO THE EXISTING ROOF MANUFACTURER AND THAT THE ROOF MANUFACTURER HAS ACCEPTED THE CONTRACTOR AND WILL EXTEND THE EXISTING ROOF WARRANTY TO INCLUDE ALL ROOFING MODIFICATIONS AND TRANSITIONS PERFORMED UNDER THIS CONTRACT.
- B. MATCH EXISTING INSULATION TYPE AND THICKNESS. ALIGN WITH ADJACENT ROOFING.
- C. THE CONTRACTOR IS RESPONSIBLE FOR PROTECTION OF EXISTING ROOFING AND FACILITY TO REMAIN AT ALL TIMES DURING THE WORK OF THIS CONTRACT. THE CONTRACTOR SHALL PROTECT CUT PORTIONS OF THE ROOF AND MAINTAIN A WATERTIGHT ROOF AT ALL TIMES. REMOVE TEMPORARY PROTECTION BEFORE INSTALLATION OF ROOF MEMBRANE.
- D. WHERE MODIFYING EXISTING ROOFING, THE CONTRACTOR SHALL PERFORM REPAIRS AND TRANSITIONS TO THE NEW WORK OF THIS CONTRACT TO THE SATISFACTION OF THE ROOFING MANUFACTURER WHO HAS ISSUED THE EXISTING ROOF WARRANTY. THE EXISTING MANUFACTURER'S ROOF WARRANTY SHALL BE EXTENDED TO INCLUDE THE ROOFING REPAIRS AND TRANSITIONS OF THIS CONTRACT.
- 3. NEW EPDM ROOF ASSEMBLIES
- A. NEW EPDM ROOF MEMBRANE SHALL BE FIRESTONE RUBBERGARD EPDM LSFR 60 MIL OR APPROVED EQUAL.
- B. INSULATION SHALL BE (2) LAYERS FIRESTONE ISOGARD GL 2.6" THICK (R-30).
- C. COVER BOARD SHALL BE 5/8" THICK GEORGIA PACIFIC DENSDECK PRIME AND SHALL BE MECHANICALLY FASTENED TO THE ROOF DECK.
- 4. NEW COAL TAR ROOF ASSEMBLIES
- A. MAXIMUM ROOF SLOPE SHALL BE 1/8" PER FOOT.
- B. ROOF MEMBRANE SHALL BE THEE-PLY DURAPAX COAL TAR COATED GLASS FIBER FELT WITH DURAPAX COAL TAR PITCH (TYPE I).
- C. INSULATION SHALL BE (2) LAYERS FIRESTONE ISOGARD GL 2.6" THICK (R-30).
- D. COVER BOARD SHALL BE 1/2" THICK GEORGIA PACIFIC DENSDECK. E. BALLAST SURFACING SHALL BLAST FURNACE SLAG, INSTALL PER MANUFACTURER'S RECOMMENDATION.
- F. FINISHED ROOF ASSEMBLY SHALL NOT EXCEED 10 LBS PER SQUARE FOOT.

ALUMINUM FRAMED GLAZING SYSTEMS:

- 1. ALUMINUM FRAMED GLAZING SYSTEMS SHALL BE:
- A. KAWNEER AA4325 EXTERIOR THERMALLY BROKEN ALUMINUM WINDOWS (FIXED AND OPERABLE) WITH INSULATED GAZING UNITS, OR APPROVED EQUAL.
- B. KAWNEER 1600UT SYSTEM 1 CURTAIN WALL EXTERIOR THERMALLY BROKEN ALUMINUM CURTAIN WALL SYSTEM WITH INSULATED GLAZING UNITS, OR APPROVED EQUAL.
- C. KAWNEER 250T EXTERIOR THERMALLY BROKEN ALUMINUM ENTRANCE SYSTEMS, OR APPROVED EQUAL.
- D. KAWNEER TRIFAB 451 INTERIOR NON-THERMALLY BROKEN ALUMINUM STOREFRONT FRAMING WITH INSULATED GLAZING UNITS, OR APPROVED EQUAL.
- F. KAWNEER 190 NARROW STILE INTERIOR NON-THERMALLY BROKEN ALUMINUM DOOR SYSTEMS, OR APPROVED FQUAL
- 2. ALL WORK IS TO CONFORM TO ALL APPLICABLE REQUIREMENTS OF LOCAL GOVERNING CODES, N.Y.S. DEPT. OF LABOR, INDUSTRIAL LABOR CODE, RULE 21, HEALTH CODE, FIRE DEPARTMENT REGULATIONS, NBFU AND UTILITY CODES, OSHA CODES AND NEW YORK STATE BUILDING CODES.
- 3. ALL WORK ON THESE DRAWINGS SHALL BE CONSIDERED NEW WORK WHETHER STATED OR NOT EXCEPT WHERE SPECIFICALLY NOTED AS "EXISTING TO REMAIN".
- 4. DURING CONSTRUCTION, TEMPORARY PROTECTION TO PREVENT DUST
- 5. AND DIRT FROM FILTERING INTO OCCUPIED AREAS SHALL BE
- 6. PROVIDED BY THE CONTRACTOR.
- 7. ALL WORK SHALL BE INSTALLED SO THAT ALL PARTS REQUIRED ARE READILY ACCESSIBLE FOR
- INSPECTION, OPERATION, MAINTENANCE AND REPAIR. 8. CONTRACTOR SHALL REMOVE AND REINSTALL AND/OR RELOCATE/MODIFY AND/OR PATCH ANY EXISTING ITEMS INTERFERING WITH THE INSTALLATION OF NEW WORK WHETHER SHOWN OR NOT ON THESE DRAWINGS. INCLUDING, BUT NOT LIMITED TO, ELECTRICAL AND DATA CONDUITS, RACEWAYS, CABLES, WIRES AND JUNCTION BOXES.
- 9. DO NOT DRIVE ANY FASTENER THROUGH THERMAL BREAKS. SEAL ALL FASTENERS.
- 10. INTERIOR WINDOW SILL STOOLS AND APRONS SHALL HAVE CLOSED END CAPS SAME GAUGE AS STOOLS. 11. DRAWINGS ARE NOT TO BE SCALED. USE DIMENSIONS ONLY. ALL DIMENSIONS AND CONDITIONS SHOWN AND ASSUMED ON THE DRAWINGS MUST BE VERIFIED AT THE SITE BY THE CONTRACTOR BEFORE ORDERING ANY MATERIAL OR DOING ANY WORK. ANY DISCREPANCIES IN THE DRAWINGS SHALL BE REPORTED TO THE ARCHITECT. NO CHANGE IN DRAWINGS IS PERMISSIBLE WITHOUT THE WRITTEN CONSENT OF THE ARCHITECT. 12. CONTRACTOR SHALL PROVIDE AND INSTALL INSULATION IN ALL HEADS, JAMBS, SILLS, MULLIONS AND
- STOOLS. 13. CONTRACTOR MAY ELECT TO REVERSE WINDOW RECEPTOR SYSTEM AS NECESSARY TO FACILITATE
- WINDOW INSTALLATION FROM INTERIOR OR EXTERIOR. RECEPTOR ORIENTATION MUST BE INDICATED ON APPROVED SHOP DRAWINGS.
- 14. ALL WINDOWS IN THERMALLY INSULATED WALLS (INTERIOR AND EXTERIOR WALLS) SHALL BE INSTALLED WITH CONTINUOUS SILL PAN FLASHING USING BLUESKIN AIR-BLOC LF OR APPROVED EQUAL. INSTALL BLUESKIN 50 MIL THICK WITH A MINIMUM 1/8" PER FOOT SLOPE TO EXTERIOR. PROVIDE END DAMS.
- 15. EXTERIOR JOINTS OF ALL WINDOWS INSTALLED IN THERMALLY INSULATED WALLS (INTERIOR AND EXTERIOR) SHALL BE SEALED WITH WILSEAL 600 COMPRESSIBLE JOINT SEALER (SECONDARY SEAL) AND TREMCO SPECTREM1 SILICONE SEALANT (PRIMARY SEAL).

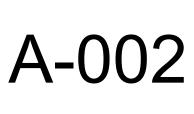

DWG NUMBER

ROOFING AND WINDOW NOTES

DRAWING TITLE :

DRAWN BY :	S. WOO
CHECKED BY :	D. TOBAR, R.A.
APPROVED BY :	A. BERGER, R.A.
DATE :	07.30.2021
SCALE :	AS NOTED

REV	DESCRIPTION	DATE
_	ISSUED FOR DOB SUBMISSION	9.10.21
_	ISSUED FOR BID	10.15.21
_	ISSUED FOR CONSTRUCTION	11.30.21

REV	DESCRIPTION	DATE
_	ISSUED FOR DOB SUBMISSION	9.10.21
_	ISSUED FOR BID	10.15.21

BEER DISTRIBUTORS MANHATTAN BEER DISTRIBUTORS 20 DUNNIGAN DRIVE SUFFERN, NEW YORK



Armonk, New York 10504

JMC Planning Engineering Landscape

di Domenico + Partners LLP

BURNS ENGINEERING, PC. 1261 Broadway, Suite 708 New York, New York 10001

Architecture & Land Surveying, PLLC 120 Bedford Road Tel 914-273-5225 Fax 914-273-2102

Architecture

Planning

Landscape Architecture

Tel 212-337-0400

Fax 212-337-3567

3743 Crescent Street, 3rd Floor

Long Island City, New York 11101



ARCHITECT

CIVIL PLANNING ENGINEER

020 New York Energy Conserv 0 and 20 Dunnigan Drive ddition Owner/Agent: er		n Code /Contractor: Allowed Watts / ft2 0.79 0.79 0.79		D wed Watts 3749
er	B Floor Area (ft2) 4746 5408 10963	C Allowed Watts / ft2 0.79 0.79		wed Watts
	Floor Area (ft2) 4746 5408 10963	Allowed Watts / ft2 0.79 0.79		wed Watts
ory	Floor Area (ft2) 4746 5408 10963	Allowed Watts / ft2 0.79 0.79		wed Watts
	5408 10963	0.79		3749
	102307			4272 8661
	Тс	0.48 otal Allowed W		19107 65790
ver				
A p / Wattage Per Lamp / Ballast	B Lamps/ Fixture	C # of Fixture	D Fixture Watt.	E (C X D)
	1 1	27 10	20 26	540 265
		05		500
	1	25 7	20 26	500 186
	1	11	11	124
	1	76	20	1520
	1	70	11	791
				7806 5051
	1	29	26	768
	1	32	230	7347
	1	14	230	3214
	1			292 28405
		1 1 1 1 1 1 1 1 1 1 1 1	$ \begin{array}{cccccccccccccccccccccccccccccccccccc$	$ \begin{array}{cccccccccccccccccccccccccccccccccccc$

Statement Compliance Statement: The proposed interior lighting design represented in thi specifications, and other calculations submitted with this permit application. The designed to meet the 2020 New York Energy Conservation Construction Code re and to comply with any applicable mandatory requirements listed in the Inspect								
Andrew Berger, AIA, ASLA								
Name - Title	Signature							

INTERIOR LIGHTING COMPLIANCE CERTIFICATE

ENERGY CONSERVATION CODE <u>NOTES</u>

- 1. THE BUILDING THERMAL ENVELOPE SHALL MEET THE REQUIREMENTS OF THE 2020 ENERGY CONSERVATION CODE OF NEW YORK STATE.
- 2. PER TABLE C301.1 SUFFERN, ROCKLAND COUNTY IS CLIMATE ZONE 5A.
- 3. PER TABLE C402.1.3, MINIMUM R VALUES SHALL BE AS FOLLOW 3.1. ROOF INSULATION SHALL BE R-30 MINIMUM, CONTINUOUS INSULATION.
 - 3.2. MASS WALLS (CONCRETE OR CMU) SHALL BE

Project Title: 10 and 20 Dunnigan Drive

Data filename:

ENERGY COMPLIANCE NOTES

	pe Complia			5410			Window: N Energy co
							0.70, [Bldg
Ducie et Information							Window: N Energy co
Project Information							0.70, [Bldg
Energy Code:	2020 New York Energy	y Conservatio	n Constru	ction Code	e		Window: N
Project Title:	10 and 20 Dunnigan D	Drive					Energy co 0.70, [Bldg
Location:	Suffern, New York						Window: N
Climate Zone:	5a Astalitisas						Energy co
Project Type: Vertical Glazing / Wall Area:	Addition 5%						0.70, [Bldg Window: N
vertical Glazing / Wall Area.	570						Energy co
	1. 1. 1. 1.			and a second second			0.70, [Bld Window: N
Construction Site:	Owner/Agent:		Desi	gner/Contra	actor:		Energy co
10 & 20 Dunnigan Drive Suffern, New York 10901							0.70, [Bld
			_				Window: M Energy co
Building Area		Floor	Area				0.70, [Bld
1-Mezzanine 1 (Office) : Nonresid	ential	4	746				Ext. Wall: Administra
2-Mezzanine 2 (Office) : Nonresid			408				Window: N
3-Administration (Office) : Nonresi			963				Energy co
4-ASRS Addition (Warehouse) : N	Ionresidential	102	307				0.70, [Bld Window: N
							Energy co
Envelope Assemblies							0.70, [Bld Ext. Wall:
Asseml	bly	Gross Area	Cavity	Cont.	Proposed	Budget U-	ASRS Add
		or Perimeter	R-Value	R-Value	U-Factor	Factor _(a)	Door: Oth ASRS Add Door: Oth
Roof: Insulation Entirely Above De Administration]	ck, [Bldg. Use 3 -	11955		30.0	0.032	0.048	ASRS Add Door: Oth
Roof: Insulation Entirely Above De Addition]	ck, [Bldg. Use 4 - ASRS	102307		30.0	0.032	0.048	ASRS Add Door: Oth
Floor: Concrete Floor (over uncono Mezzanine 1]		4746		30.0	0.030	0.074	ASRS Add Door: Oth
Floor: Concrete Floor (over uncono Mezzanine 2] Floor: Concrete Floor (over uncono		602		30.0	0.030	0.074	ASRS Add Door: Oth ASRS Add
Administration] Floor: Unheated Slab-On-Grade, [E		11955 1284		30.0	0.030 0.730	0.074 0.730	Door: Oth ASRS Add
Addition] (c) <u>NORTH</u>		1204			0.700	0.100	Door: Oth ASRS Add
Ext. Wall: Steel-Framed, 24in. o.c.	, [Bldg. Use 1 - Mezzanine 1]	1489	13.0	7.5	0.060	0.064	Door: Oth ASRS Add
Door: Insulated Metal, Swinging, [-	21			0.600	0.700	Door: Oth
Door: Insulated Metal, Swinging, [21			0.600	0.700	ASRS Add
Ext. Wall: Steel-Framed, 24in. o.c.		1628	13.0	7.5	0.060	0.064	Door: Oth ASRS Add
Door: Insulated Metal, Swinging, []	-	21			0.600	0.700	Ext. Wall:
Ext. Wall: Steel-Framed, 24in. o.c. Window: Metal Frame with Therma	-	419	13.0	7.5	0.060	0.064	Administra
Energy code default, Double Pane 0.70, [Bldg. Use 2 - Mezzanine 2]		240			0.650	0.450	Ext. Wall: Administra
Ext. Wall: Steel-Framed, 24in. o.c.	-	166	13.0	7.5	0.060	0.064	EAST Ext. Wall
Ext. Wall: Steel-Framed, 24in. o.c. Administration]	, [Bldg. Use 3 -	1231	13.0	7.5	0.060	0.064	Ext. Wall: Window: N
Window: Metal Frame with Therma Energy code default, Double Pane 0.70, [Bldg. Use 3 - Administration	with Low-E, Clear , SHGC	16			0.650	0.450	Energy co 0.70, [Bld Ext. Wall:
							Door: Insu
Project Title: 10 and 20 Dunniga						ate: 09/15/21	Project Tit

Assembly	Gross Area or Perimeter	Cavity R-Value	Cont. R-Value	Proposed U-Factor	Budget U- Factor _(a)	Assembly	Gross Area or Perimeter	Cavity R-Value	Cont. R-Value	Proposed U-Factor	Budget U- Factor _(a)
Window: Metal Frame with Thermal Break: Fixed, Perf. Type: Energy code default, Double Pane with Low-E, Clear , SHGC 0.70, [Bldg. Use 3 - Administration]	16			0.650	0.450	Ext. Wall: Steel-Framed, 24in. o.c., [Bldg. Use 2 - Mezzanine 2] Window: Metal Frame with Thermal Break: Fixed, Perf. Type: Energy code default, Double Pane with Low-E, Clear, SHGC	400 122	13.0	7.5	0.060 0.650	0.064 0.450
Nindow: Metal Frame with Thermal Break: Fixed, Perf. Type: Energy code default, Double Pane with Low-E, Clear , SHGC	16			0.650	0.450	0.70, [Bldg. Use 2 - Mezzanine 2] Ext. Wall: Steel-Framed, 24in. o.c., [Bldg. Use 3 -	406	13.0	7.5	0.060	0.064
ı, [Bldg. Use 3 - Administration] dow: Metal Frame with Thermal Break: Fixed, Perf. Type: 'gy code default, Double Pane with Low-E, Clear , SHGC	16			0.650	0.450	Administration] Window: Metal Frame with Thermal Break: Fixed, Perf. Type: Energy code default: Double Pane with Low F. Clear, SHCC	16			0.650	0.450
D, [Bldg. Use 3 - Administration] dow: Metal Frame with Thermal Break: Fixed, Perf. Type:	16			0.650	0.450	Energy code default, Double Pane with Low-E, Clear , SHGC 0.70, [Bldg. Use 3 - Administration] Window: Metal Frame with Thermal Break: Fixed, Perf. Type:	16			0.650	0.450
rgy code default, Double Pane with Low-E, Clear , SHGC), [Bldg. Use 3 - Administration] dow: Metal Frame with Thermal Break: Fixed, Perf. Type:	40			0.050	0.450	Energy code default, Double Pane with Low-E, Clear , SHGC 0.70, [Bldg. Use 3 - Administration]					
gy code default, Double Pane with Low-E, Clear , SHGC [Bldg. Use 3 - Administration]	16			0.650	0.450	Window: Metal Frame with Thermal Break: Fixed, Perf. Type: Energy code default, Double Pane with Low-E, Clear, SHGC 0.70, [Bldg. Use 3 - Administration]	16			0.650	0.450
low: Metal Frame with Thermal Break: Fixed, Perf. Type: gy code default, Double Pane with Low-E, Clear , SHGC . [Bldg. Use 3 - Administration]	16			0.650	0.450	Ext. Wall: Steel-Framed, 24in. o.c., [Bldg. Use 3 - Administration]	275	13.0	7.5	0.060	0.064
w: Metal Frame with Thermal Break: Fixed, Perf. Type:	16			0.650	0.450	Door: Insulated Metal, Swinging, [Bldg. Use 3 - Administration]	42			0.600	0.700
code default, Double Pane with Low-E, Clear , SHGC 3ldg. Use 3 - Administration]						Ext. Wall: Other Exterior Wall, Heat capacity 0.0, [Bldg. Use 3 - Administration] (b) Ext. Wall: Other Exterior Wall, Heat capacity 0.0, [Bldg. Use 3 -	2600 2960			0.031 0.031	0.064 0.064
/all: Steel-Framed, 24in. o.c., [Bldg. Use 3 - nistration] w: Metal Frame with Thermal Break: Fixed, Perf. Type:	730 292	13.0	7.5	0.060 0.650	0.064 0.450	Administration] (b) SOUTH	2300			0.001	0.004
code default, Double Pane with Low-E, Clear , SHGC	232			0.000	0.400	Ext. Wall: Steel-Framed, 24in. o.c., [Bldg. Use 1 - Mezzanine 1]	1489	13.0	7.5	0.060	0.064
Bldg. Use 3 - Administration] w: Metal Frame with Thermal Break: Fixed, Perf. Type: y code default, Double Pane with Low-E, Clear , SHGC	16			0.650	0.450	Window: Metal Frame with Thermal Break: Fixed, Perf. Type: Energy code default, Double Pane with Low-E, Clear, SHGC 0.70, [Bldg. Use 1 - Mezzanine 1]	16			0.650	0.450
[Bldg. Use 3 - Administration] /all: Other Exterior Wall, Heat capacity 0.0, [Bldg. Use 4 - Addition] (b)	1980			0.031	0.064	Window: Metal Frame with Thermal Break: Fixed, Perf. Type: Energy code default, Double Pane with Low-E, Clear, SHGC	16			0.650	0.450
ldition] Idition]	121			0.330	0.179	0.70, [Bldg. Use 1 - Mezzanine 1] Window: Metal Frame with Thermal Break: Fixed, Perf. Type: Energy code default, Double Pane with Low-E, Clear , SHGC	16			0.650	0.450
ner (U-Factor option), Non-Swinging, [Bldg. Use 4 - dition]	80			1.200	0.179	0.70, [Bldg. Use 1 - Mezzanine 1] Window: Metal Frame with Thermal Break: Fixed, Perf. Type:	16			0.650	0.450
her (U-Factor option), Non-Swinging, [Bldg. Use 4 - dition]	80			1.200	0.179	Energy code default, Double Pane with Low-E, Clear, SHGC 0.70, [Bldg. Use 1 - Mezzanine 1]					
ther (U-Factor option), Non-Swinging, [Bldg. Use 4 - ddition] ther (U-Factor option), Non-Swinging, [Bldg. Use 4 -	80 80			1.200	0.179	Window: Metal Frame with Thermal Break: Fixed, Perf. Type: Energy code default, Double Pane with Low-E, Clear, SHGC 0.70, [Bldg. Use 1 - Mezzanine 1]	16			0.650	0.450
ther (U-Factor option), Non-Swinging, [Bldg. Use 4 -	80			1.200 1.200	0.179 0.179	Window: Metal Frame with Thermal Break: Fixed, Perf. Type: Energy code default, Double Pane with Low-E, Clear, SHGC	16			0.650	0.450
ddition] ther (U-Factor option), Non-Swinging, [Bldg. Use 4 -	80			1.200	0.179	0.70, [Bldg. Use 1 - Mezzanine 1] Window: Metal Frame with Thermal Break: Fixed, Perf. Type: Energy code default, Double Pane with Low-E, Clear , SHGC	16			0.650	0.450
ddition] ther (U-Factor option), Non-Swinging, [Bldg. Use 4 -	80			1.200	0.179	0.70, [Bldg. Use 1 - Mezzanine 1] Window: Metal Frame with Thermal Break: Fixed, Perf. Type:	10			0.050	0.450
ddition] ther (U-Factor option), Non-Swinging, [Bldg. Use 4 - ddition]	80			1.200	0.179	Energy code default, Double Pane with Low-E, Clear , SHGC 0.70, [Bldg. Use 1 - Mezzanine 1]	16			0.650	0.450
Other (U-Factor option), Non-Swinging, [Bldg. Use 4 - Addition]	80			1.200	0.179	Window: Metal Frame with Thermal Break: Fixed, Perf. Type: Energy code default, Double Pane with Low-E, Clear, SHGC 0.70, [Bldg. Use 1 - Mezzanine 1]	16			0.650	0.450
Dther (U-Factor option), Non-Swinging, [Bldg. Use 4 - Addition]	80			1.200	0.179	Window: Metal Frame with Thermal Break: Fixed, Perf. Type: Energy code default, Double Pane with Low-E, Clear , SHGC	16			0.650	0.450
all: Other Exterior Wall, Heat capacity 0.0, [Bldg. Use 3 - istration] (b)	750			0.031	0.064	0.70, [Bldg. Use 1 - Mezzanine 1] Ext. Wall: Steel-Framed, 24in. o.c., [Bldg. Use 2 - Mezzanine 2]	2221	13.0	7.5	0.060	0.064
all: Other Exterior Wall, Heat capacity 0.0, [Bldg. Use 3 - stration] (b)	6150			0.031	0.064	Window: Metal Frame with Thermal Break: Fixed, Perf. Type: Energy code default, Double Pane with Low-E, Clear, SHGC	16			0.650	0.450
all: Steel-Framed, 24in. o.c., [Bldg. Use 1 - Mezzanine 1]	273	13.0	7.5	0.060	0.064	0.70, [Bldg. Use 2 - Mezzanine 2] Window: Metal Frame with Thermal Break: Fixed, Perf. Type:	16			0.650	0.450
Metal Frame with Thermal Break: Fixed, Perf. Type: de default, Double Pane with Low-E, Clear , SHGC	122			0.650	0.084	Energy code default, Double Pane with Low-E, Clear , SHGC 0.70, [Bldg. Use 2 - Mezzanine 2]	0			0.000	0.400
Bildg. Use 1 - Mezzanine 1]		46.5	7.5	0.000	0.004	Window: Metal Frame with Thermal Break: Fixed, Perf. Type: Energy code default, Double Pane with Low-E, Clear, SHGC	16			0.650	0.450
III: Steel-Framed, 24in. o.c., [Bldg. Use 2 - Mezzanine 2] nsulated Metal, Swinging, [Bldg. Use 2 - Mezzanine 2]	276 21	13.0	7.5	0.060 0.600	0.064 0.700	0.70, [Bldg. Use 2 - Mezzanine 2]					
Title: 10 and 20 Dunnigan Drive				Report o	late: 09/15/21	Project Title: 10 and 20 Dunnigan Drive				Report	date: 09/15/21
filename:					ge 2 of 37	Data filename:				Pa	ge 3 of 37

ENVELOPE COMPLIANCE CERTIFICATE

is document is consistent with the building plans, equirements in COMcheck Version COMcheckWeb tion 	Watts /Wattage(ELower Level (Parking area)59100 ft20.04YesYes2nd Mezz (Parking area)10200 ft20.04YesYesUnderside of Mezzanine 1 (Loading dock)4746 ft20.35YesYesCanopy at 20 Dunnigan (Loading dock)7630 ft20.35YesYesElectrical Yard (Illuminated area of facade wall or surface)5816 ft20.07NoNorth Ramp & Truck Access (Parking area)30986 ft20.04YesEast Loading Dock (Parking area)79378 ft20.04Yes6 loading 2 parking (Parking area)22372 ft20.04YesTotal Tradable Watts (a) =1	E E 1	ARCHITECT di Domenico + Partners LLP Architecture Landscape Architecture Planning 3743 Crescent Street, 3rd Floor Long Island City, New York 11101 Tel 212-337-0400 Fax 212-337-3567 CIVIL PLANNING ENGINEER MCC Planning Engineering Landscape Architecture & Land Surveying, PLLC 120 Bedford Road Armonk, New York 10504 Tel 914-273-5225 Fax 914-273-2102 MEP ENGINEER BURNS ENGINEERRING, PC. 1261 Broadway, Suite 708 New York, New York 10001 Tel 212-962-3503 STRUCTURAL ENGINEER GEISO 1385 Broadway, 20th FL New York, New York 10018 Tel 212-687-8282
Report date: 09/15/21 Page 6 of 37	LED: Other:154232nd Mezz (Parking area, 10200 ft2): Tradable Wattage LED: Other:1723Underside of Mezzanine 1 (Loading dock, 4746 ft2): Tradable Wattage LED: C8: Other:11140Canopy at 20 Dunnigan (Loading dock, 7630 ft2): Tradable Wattage LED: C8: Other:13340Electrical Yard (Illuminated area of facade wall or surface, 5816 ft2): Non-tradable Wattage LED: W: Other:1229North Ramp & Truck Access (Parking area, 30986 ft2): Tradable Wattage LED: W: Other:1529LED: W: Other:11154	160 440 1320 58 146	MANHATTAN BEER DISTRIBUTORS 20 DUNNIGAN DRIVE SUFFERN, NEW YORK
R-11.4 MINIMUM, CONTINUOUS 3.3. METAL FRAMED WALLS SHALL R-7.5 CONTINUOUS INSULATION 3.4. WALLS BELOW GRADE SHALL MINIMUM 3.5. MASS FLOORS (CONCRETE SL R-10 CONTINUOUS, MINIMUM. 3.6. JOIST/FRAMED FLOORS SHALL MINIMUM.	BE R-13 + N. FOR 24" BELOW. 4. FENESTRATION SHALL BE AS PER SECTION BE R-7.5 AB) SHALL BE 4.1 . SGHC: PF<0.2 = 0.38, 0.2 \leq PF<0.5, PF \geq 0.5PF 4.2. U-FACTORS 4.2.1 EIXED WINDOWS: 0.38	GREATER THAN 30% OF GROSS WALL AREA. ON C402.4 6. PER C402.5.7, EXCEPTION 4 - ENTRANCE	
16 0.650 0.450 Win 16 0.650 0.450 0.7 16 0.650 0.450 Win 16 0.650 0.450 Ext 16 0.650 0.450 Ext 730 13.0 7.5 0.060 0.064 Ext 4dr 292 0.650 0.450 Ext 16 0.650 0.450 Ext 16 0.650 0.450 Ext 16 0.650 0.450 Ext 16 0.650 0.450 Ext 16 0.650 0.450 Ext	AssemblyGross Area or PerimeterCavity R-ValueCont. R-ValueProposed U-FactorBudget U- FactoruvWall: Steel-Framed, 24in. o.c., [Bldg. Use 2 - Mezzanine 2]40013.07.50.0600.064dow: Metal Frame with Thermal Break: Fixed, Perf. Type: rgy code default, Double Pane with Low-E, Clear, SHGC), [Bldg. Use 2 - Mezzanine 2]40613.07.50.0600.064wall: Steel-Framed, 24in. o.c., [Bldg. Use 3 - inistration]40613.07.50.0600.064dow: Metal Frame with Thermal Break: Fixed, Perf. Type: rgy code default, Double Pane with Low-E, Clear, SHGC), [Bldg. Use 3 - Administration]60.6500.450dow: Metal Frame with Thermal Break: Fixed, Perf. Type: rgy code default, Double Pane with Low-E, Clear, SHGC), [Bldg. Use 3 - Administration]160.6500.450dow: Metal Frame with Thermal Break: Fixed, Perf. Type: rgy code default, Double Pane with Low-E, Clear, SHGC), [Bldg. Use 3 - Administration]27513.07.50.0600.064wall: Steel-Framed, 24in. o.c., [Bldg. Use 3 - inistration]27513.07.50.0600.064wall: Other Exterior Wall, Heat capacity 0.0, [Bldg. Use 3 - walls Steel-Framed, 24in. o.c., [Bldg. Use 3 - Administration]220.0310.064wall: Other Exterior Wall, Heat capacity 0.0, [Bldg. Use 3 - winistration]29600.0310.064wall: Other Exterior Wall, Heat capacity 0.0, [Bldg. Use 3 - winistration] (b)148913.0 <t< th=""><th>AssemblyGross Area or PerimeterCavity R-ValueCont. R-ValueProposed U-FactorBudget U- Factor.Window: Metal Frame with Thermal Break: Fixed, Perf. Type: Emergy code default, Double Pane with Low-E, Clear , SHGC 0.70, [Bldg, Use 2 - Mezzanine 2]160.6500.450Ext. Wall: Steel-Framed, 24in. o.c., [Bldg. Use 3 - Administration]165113.07.50.0600.064Window: Metal Frame with Internal Break: Fixed, Perf. Type: Ext. Wall: Steel-Framed, 24in. o.c., [Bldg. Use 3 - Administration] (b)145500.0310.064WEST Undow: Metal Frame with Thermal Break: Fixed, Perf. Type: Energy code default, Double Pane with Low-E, Clear , SHGC 0.70, [Bldg, Use 1 - Mezzanine 1]27313.07.50.0600.064Window: Metal Frame with Thermal Break: Fixed, Perf. Type: Energy code default, Double Pane with Low-E, Clear , SHGC 0.70, [Bldg, Use 1 - Mezzanine 2]40713.07.50.0600.064Window: Metal Frame with Thermal Break: Fixed, Perf. Type: Energy code default, Double Pane with Low-E, Clear , SHGC 0.70, [Bldg, Use 2 - Mezzanine 2]40713.07.50.0600.064Window: Metal Frame with Thermal Break: Fixed, Perf. Type: Energy code default, Double Pane with Low-E, Clear , SHGC 0.70, [Bldg, Use 2 - Mezzanine 2]26213.07.50.0600.064Window: Metal Frame with Thermal Break: Fixed, Perf. Type: Energy code default, Double Pane with Low-E, Clear , SHGC 0.70, [Bldg, Use 2 - Mezzanine 2]26213.07.50.0600.064Window: Metal Frame w</th><th>REV DESCRIPTION DATE – ISSUED FOR DOB SUBMISSION 9.10.21 – ISSUED FOR BID 10.15.21 – ISSUED FOR CONSTRUCTION 11.30.21 – ISSUED FOR SUBMISSION 9.10.21 – ISSUED FOR BID 10.15.21 – ISSUED FOR CONSTRUCTION 11.30.21 – ISSUED FOR SUBMISSION 9.10.21 – ISSUED FOR SUBMISSION 10.15.21 – ISSUED FOR CONSTRUCTION 11.30.21 – ISSUED FOR SUBMISSION ISSUED DRAWN BY : S. WOO ISSUED CHECKED BY : D. TOBAR, R.A.</th></t<>	AssemblyGross Area or PerimeterCavity R-ValueCont. R-ValueProposed U-FactorBudget U- Factor.Window: Metal Frame with Thermal Break: Fixed, Perf. Type: Emergy code default, Double Pane with Low-E, Clear , SHGC 0.70, [Bldg, Use 2 - Mezzanine 2]160.6500.450Ext. Wall: Steel-Framed, 24in. o.c., [Bldg. Use 3 - Administration]165113.07.50.0600.064Window: Metal Frame with Internal Break: Fixed, Perf. Type: Ext. Wall: Steel-Framed, 24in. o.c., [Bldg. Use 3 - Administration] (b)145500.0310.064WEST Undow: Metal Frame with Thermal Break: Fixed, Perf. Type: Energy code default, Double Pane with Low-E, Clear , SHGC 0.70, [Bldg, Use 1 - Mezzanine 1]27313.07.50.0600.064Window: Metal Frame with Thermal Break: Fixed, Perf. Type: Energy code default, Double Pane with Low-E, Clear , SHGC 0.70, [Bldg, Use 1 - Mezzanine 2]40713.07.50.0600.064Window: Metal Frame with Thermal Break: Fixed, Perf. Type: Energy code default, Double Pane with Low-E, Clear , SHGC 0.70, [Bldg, Use 2 - Mezzanine 2]40713.07.50.0600.064Window: Metal Frame with Thermal Break: Fixed, Perf. Type: Energy code default, Double Pane with Low-E, Clear , SHGC 0.70, [Bldg, Use 2 - Mezzanine 2]26213.07.50.0600.064Window: Metal Frame with Thermal Break: Fixed, Perf. Type: Energy code default, Double Pane with Low-E, Clear , SHGC 0.70, [Bldg, Use 2 - Mezzanine 2]26213.07.50.0600.064Window: Metal Frame w	REV DESCRIPTION DATE – ISSUED FOR DOB SUBMISSION 9.10.21 – ISSUED FOR BID 10.15.21 – ISSUED FOR CONSTRUCTION 11.30.21 – ISSUED FOR SUBMISSION 9.10.21 – ISSUED FOR BID 10.15.21 – ISSUED FOR CONSTRUCTION 11.30.21 – ISSUED FOR SUBMISSION 9.10.21 – ISSUED FOR SUBMISSION 10.15.21 – ISSUED FOR CONSTRUCTION 11.30.21 – ISSUED FOR SUBMISSION ISSUED DRAWN BY : S. WOO ISSUED CHECKED BY : D. TOBAR, R.A.

KE	Y NOTES
1	NEW CONCRETE WALL AT LOADING DOCK
2	CONCRETE REPAIR TO THE FACE OF THE EXPOSED FOUNDATION WALLS AND FOOTING AT NEW
	LOADING DOCKS
3	STEEL COLUMN WITH 2" CONCRETE ENCASEMENT. SEE STRUCTURAL DRAWINGS
4	GENERATOR ON CONCRETE PAD. CONSTRUCT CONCRETE PAD 6" THICK AND REINFORCED
5	MODIFY EXISTING RAMP TO PROVIDE A 22' WIDE RAMP FOR VEHICULAR ENTRANCE TO EXISTING OVERHEAD ENTRANCE DOOR/GATE. AN 8' WIDE SAW-CUT PORTION SHALL BE REMOVED FROM THE CENTER SEPARATING THE NORTH AND SOUTH PORTIONS. A NEW RETAINING WALL SHALL BE BUILT WHERE THE 8' WIDE PORTION WAS REMOVED. THE NORTH PORTION OF THE RAMP SHALL BE EXTENDED TO AND MARRIED TO THE NEW RETAINING WALL. THE EXTENSION SHALL BE REINFORCED AND TIED INTO THE WALL WITH TOWELS/REINFORCEMENT BARS. THE SOUTHERN PORTION OF THE RAMP SHALL BE REMOVED AND DISCARDED
6	INSTALL LIGHTING, SEE LIGHTING SCHEDULE
7	REINSTALLATION OF THE EXISTING SECURITY BOOTH SHALL INCLUDE BUT IS NOT LIMITED TO THE SECURITY BOOTH, NEW CONCRETE PAD, TRAFFIC ARM, AND NEW BOLLARDS
8	REINSTALL MANHATTAN BEER DISTRIBUTORS SIGNAGE
9	CONSTRUCT SOUND ATTENUATING PANEL WALL/FENCE SCREEN, SEE DETAILS
10	CONSTRUCT RETAINING WALL, SEE TRACK DRAWINGS
11	ELECTRICAL YARD, SEE ELECTRICAL DRAWINGS FOR ELECTRICAL EQUIPMENT AND CONCRETE PAD LAYOUT. CONCRETE PAD SHALL BE 6" THICK AND REINFORCED
12	RELOCATED TRACK AND NEW TRACK SIDINGS, SEE TRACK DRAWINGS
13	INSTALL STAIR RISERS, TREADS AND STRINGERS, SEE STAIR DETAILS
14	INSTALL HANDRAILS, SEE DETAILS
15	INSTALL GUARDRAILS, SEE DETAILS
16	CONSTRUCT ELEVATOR SHAFT AND INSTALL ELEVATOR PER MANUFACTURE'S INSTRUCTIONS. SEE DRAWING A-400 FOR ADDITIONAL INFORMATION
17	FURNISH AND INSTALL WATER FOUNTAIN, SEE A-508 & A 509
18	VENDING MACHINE
19	INSTALL REFRIGERATOR
20	FURNISH AND INSTALL DOUBLE TIER LOCKER
21	FURNISH AND INSTALL LOCKER ROOM BENCH 9" WIDE WOOD BENCH WITH STEEL PEDESTALS
22	FURNISH AND INSTALL STOREFRONT GLAZING SYSTEM, SEE DRAWING A-320
23	FURNISH AND INSTALL CURTAIN WALL GLAZING SYSTEM, SEE DRAWING A-321
24	FURNISH AND INSTALL RECEPTION DESK
25	FURNISH AND INSTALL PARKING BLOCK
26	FURNISH AND INSTALL STRUCTURAL STEEL BOLLARD POST AND BASE WITH DECORATIVE STAINLESS STEEL SLEEVE
27	PROVIDE STRIPPING FOR PARKING STALLS, VEHICULAR PATHS, ETC.
28	INTERIOR STEEL COLUMNS WITH FIRE-RATED GYPSUM BOARD ENCLOSURE, SEE DETAILS
29	SPRINKLER RISERS, SEE FIRE PROTECTION DRAWINGS
30	FURNISH AND INSTALL GALVANIZED STEEL LADDER. LADDER SHALL COMPLY WITH OSHA
	REQUIREMENTS, SEE A-503
31	STEEL KING 42" HIGH STEEL GUARD HEAVY DUTY SWING GATE. (2) RAILINGS, 11 GAUGE RAILING WITH 4"x4" POSTS. POWDER COATED SAFETY YELLOW. INSTALL PER MANUFACTURER INSTRUCTIONS
32	GALVANIZED STEEL STAIR ASSEMBLY WITH DIAMOND PLATE TREADS, GUARDRAILS, AND HANDRAILS, SEE A-503
33	CONSTRUCT SLOPED SURFACE AT 1:20
34	EXPANSION JOINT, SEE DETAILS
35	4" THICK INSULATED METAL WALL PANELS SHALL BE VERAWALL BY CENTRIA
36	CONSTRUCT 42" HIGH CONCRETE PARAPET
37	FLOOR DRAIN, SLOPE TO DRAIN 1.5% MINIMUM
38	16'-0" WIDE CONCRETE PLATFORM
39	FURNISH AND INSTALL COUNTER TOP
40	INSTALL OVERHEAD COILING DOOR, SEE COILING DOOR SCHEDULE
41	CONSTRUCT 14'-6" WIDE PLATFORM CANOPY, SEE ARCHITECTURAL DETAILS AND STRUCTURAL FOR FRAMING
42	CONSTRUCT AND MATCH NEW WALL TO ADJACENT EXISTING WALL. MATCH COLOR, STYLE AND WALL ASSEMBLY IN ITS ENTIRETY 4" THICK INSULATED CORPUCATED METAL WALL DANELS SHALL DE VERAMALL BY CENTRIA
43 44	4" THICK INSULATED CORRUGATED METAL WALL PANELS SHALL BE VERAWALL BY CENTRIA RELOCATED GENERAC GENERATOR WITH NEW REINFORCED CONCRETE PAD. PROVIDE MINIMUM
45	3'-0" CLEARANCE AROUND INFILL WITH RELOCATED FILL AT FORMER TRAIN TRACK LOCATION AND CONSTRUCT A STRUCTURAL CONCRETE SLAB, FINISH FLOOR TO MATCH EXISTING ELEVATION AND FINISH, SEE STRUCTURAL DRAWINGS
46	STRUCTURAL DRAWINGS FURNISH AND INSTALL ARDEX SELF-LEVELING UNDERLAYMENT OVER STRUCTURAL SLAB AND PREP FOR FLOORING FINISH MATERIAL. SEE FINISH SCHEDULE
47	STEEL KING 42" HIGH STEEL GUARD HEAVY DUTY GUARD RAILING. (2) RAILINGS, 11 GAUGE RAILING WITH 4"x4" POSTS. POST TYPES SHALL BE CENTER END OFFSET, SIDE OFFSET AND
— — — —	STANDARD OFFSET. RAIL SHALL BE TIGHT TO THE EDGE. POWDER COATED SAFETY YELLOW. INSTALL PER MANUFACTURER INSTRUCTIONS
48	FURNISH AND INSTALL 6' HIGH CHAIN LINK FENCING FURNISH AND INSTALL 8"x8" SOFFIT
1.2	

MEMBRANE - FIRESTONE RUBBERGARD EPDM LSFR 60 MIL STUCCO FINISH

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PROTECTION FOR THE EPDM ROOFING MEMBRANE. ALL METAL SHALL BE GALVANIZED. PROVIDE CONTINUOUS FIXED FABRIC DRAFT CURTAINS WHERE NOTED ON THE PLANS. THE DRAFT CURTAIN SHALL SEPARATE THE AS/RS WAREHOUSE FROM THE EXISTING BUILDINGS AND IN 10 DUNNIGAN SHALL SEPARATE THE ESFR SPRINKLER SYSTEM FROM THE REST OF THE 10 DUNNIGAN WAREHOUSE. DRAFT CURTAINS SHALL BE SECURED TO THE UNDERSIDE OF THE ROOF DECK PER MANUFACTURER'S RECOMMENDED ATTACHMENT METHODS. DRAFT CURTAINS SHALL EXTEND 24" FROM THE UNDERSIDE OF THE ROOF DECK AND SHALL BE SEALED AROUND ALL PENETRATIONS/OBSTRUCTIONS. DRAFT CURTAINS SHALL BE MODEL SD60 FIXED FABRIC DRAFT CURTAINS BY U.S. SMOKE AND FIRE, OR APPROVED EQUAL, AND SHALL MEET THE REQUIREMENTS OF UL 10B, ASTM E84 AND ASTM E136.

- MEP FOR SIZES
- STEEL RODS AND BRACKETS.

FURNISH AND INSTALL KEEGUARD SAFETY RAILING BY KEESAFETY. RAILING SHALL BE OFFSET FROM THE EDGE OF THE ROOF TO ELIMINATE VIEW FROM THE STREET. PROVIDE 24" MIN. CLEARANCE TO THE EXISTING PHOTO VATIC PANELS

ROOF ASSEMBLY: REFER TO STRUCTURAL DRAWINGS FOR METAL DECK; (2) LAYERS 2.6" FIRESTONE ISOGARD GL INSULATION (R-30); (1) 1/2" COVER BOARD GP DENSDECK; ROOF

PROVIDE SCUPPER AND LEADER DOWN TO THE ADJACENT ROOF

INSULATE UNDERSIDE OF FLOOR AT RECEPTION AREA AND MEZZANINE 1: PROVIDE R-30 MINERAL WOOL INSULATION; PROVIDE 'Z' METAL FURRING AT 24" O.C.; PROVIDE 2.6" POLISO R-15 RIGID INSULATION PANELS; PROVIDE BLUESKIN VAPOR BARRIER, 5/8" DENSGLASS SHEATHING, AND

NEW ROOF LEADER, REFER TO PLUMBING DRAWINGS FOR ADDITIONAL INFORMATION

PROVIDE 26' WIDE RAMP AND RETAINING WALL FOR VEHICULAR ENTRANCE TO THE EXISTING TRUCK MAINTENANCE SHOP. SEE STRUCTURAL DRAWINGS FOR DETAILS.


PROVIDE 5'X5' METAL LANDING AND STEPS TO THE ROOF WITH MAX 7" RISERS. AT STAIR TOWER "C", IN ADDITION TO THE LANDING AND STEPS, A METAL RAMP SHALL BE PROVIDED AT A SLOPE OF 1:12. THE METAL ASSEMBLY SHALL BE OVER A 1/2 RUBBER WALKING MAT TO PROVIDE

NEW CANOPY ROOF LEADER +/-40' O.C. AND AVOID CONFLICT WITH OVERHEAD DOORS, REFER TO


PROVIDE ROOF CANOPY AT STAIRS A, B AND C. CANOPY SHALL BE A STEEL CHANNEL FRAMED WITH CORRUGATED METAL DECKING AND EPDM ROOFING. UNDERSIDE OF CANOPY SHALL BE METAL PANEL SOFFIT. CANOPY SHALL BE SUPPORTED FROM THE CONCRETE BULKHEAD BY

RCHITECT	
Architecture	co + Partners LLP
Landscape Arch Planning 3743 Croscopt	
Long Island City Tel 212-337-0	
Fax 212-337-3 IVIL PLANNING ENGINEER	3567
	Engineering Landscape Land Surveying, PLLC
120 Bedford Ro Armonk, New Y	ad ′ork 10504
Tel 914-273-5 Fax 914-273-2	-
	Broadway, Suite 708 ork, New York 10001
Tel 2	12-962-3503
GEI50	Broadway, 20th FL
	ork, New York 10018 12-687-8282
BEER DIST	RIBUTORS
	ER DISTRIBUTORS
20 DUNNIGAN DI	
SUFFERN, NEW	TURK
EV DESCRI	PTION DATE
- ISSUED FOR DOE	B SUBMISSION 9.10.21
- ISSUED FOR BID - ISSUED FOR CON	10.15.21 ISTRUCTION 11.30.21
	S. WOO
CHECKED BY :	D. TOBAR, R.A.
APPROVED BY :	A. BERGER, R.A.
	07.30.2021
	AS NOTED
RAWING TITLE :	
KEY N	IOTES
	DWG NUMBER :

A-004

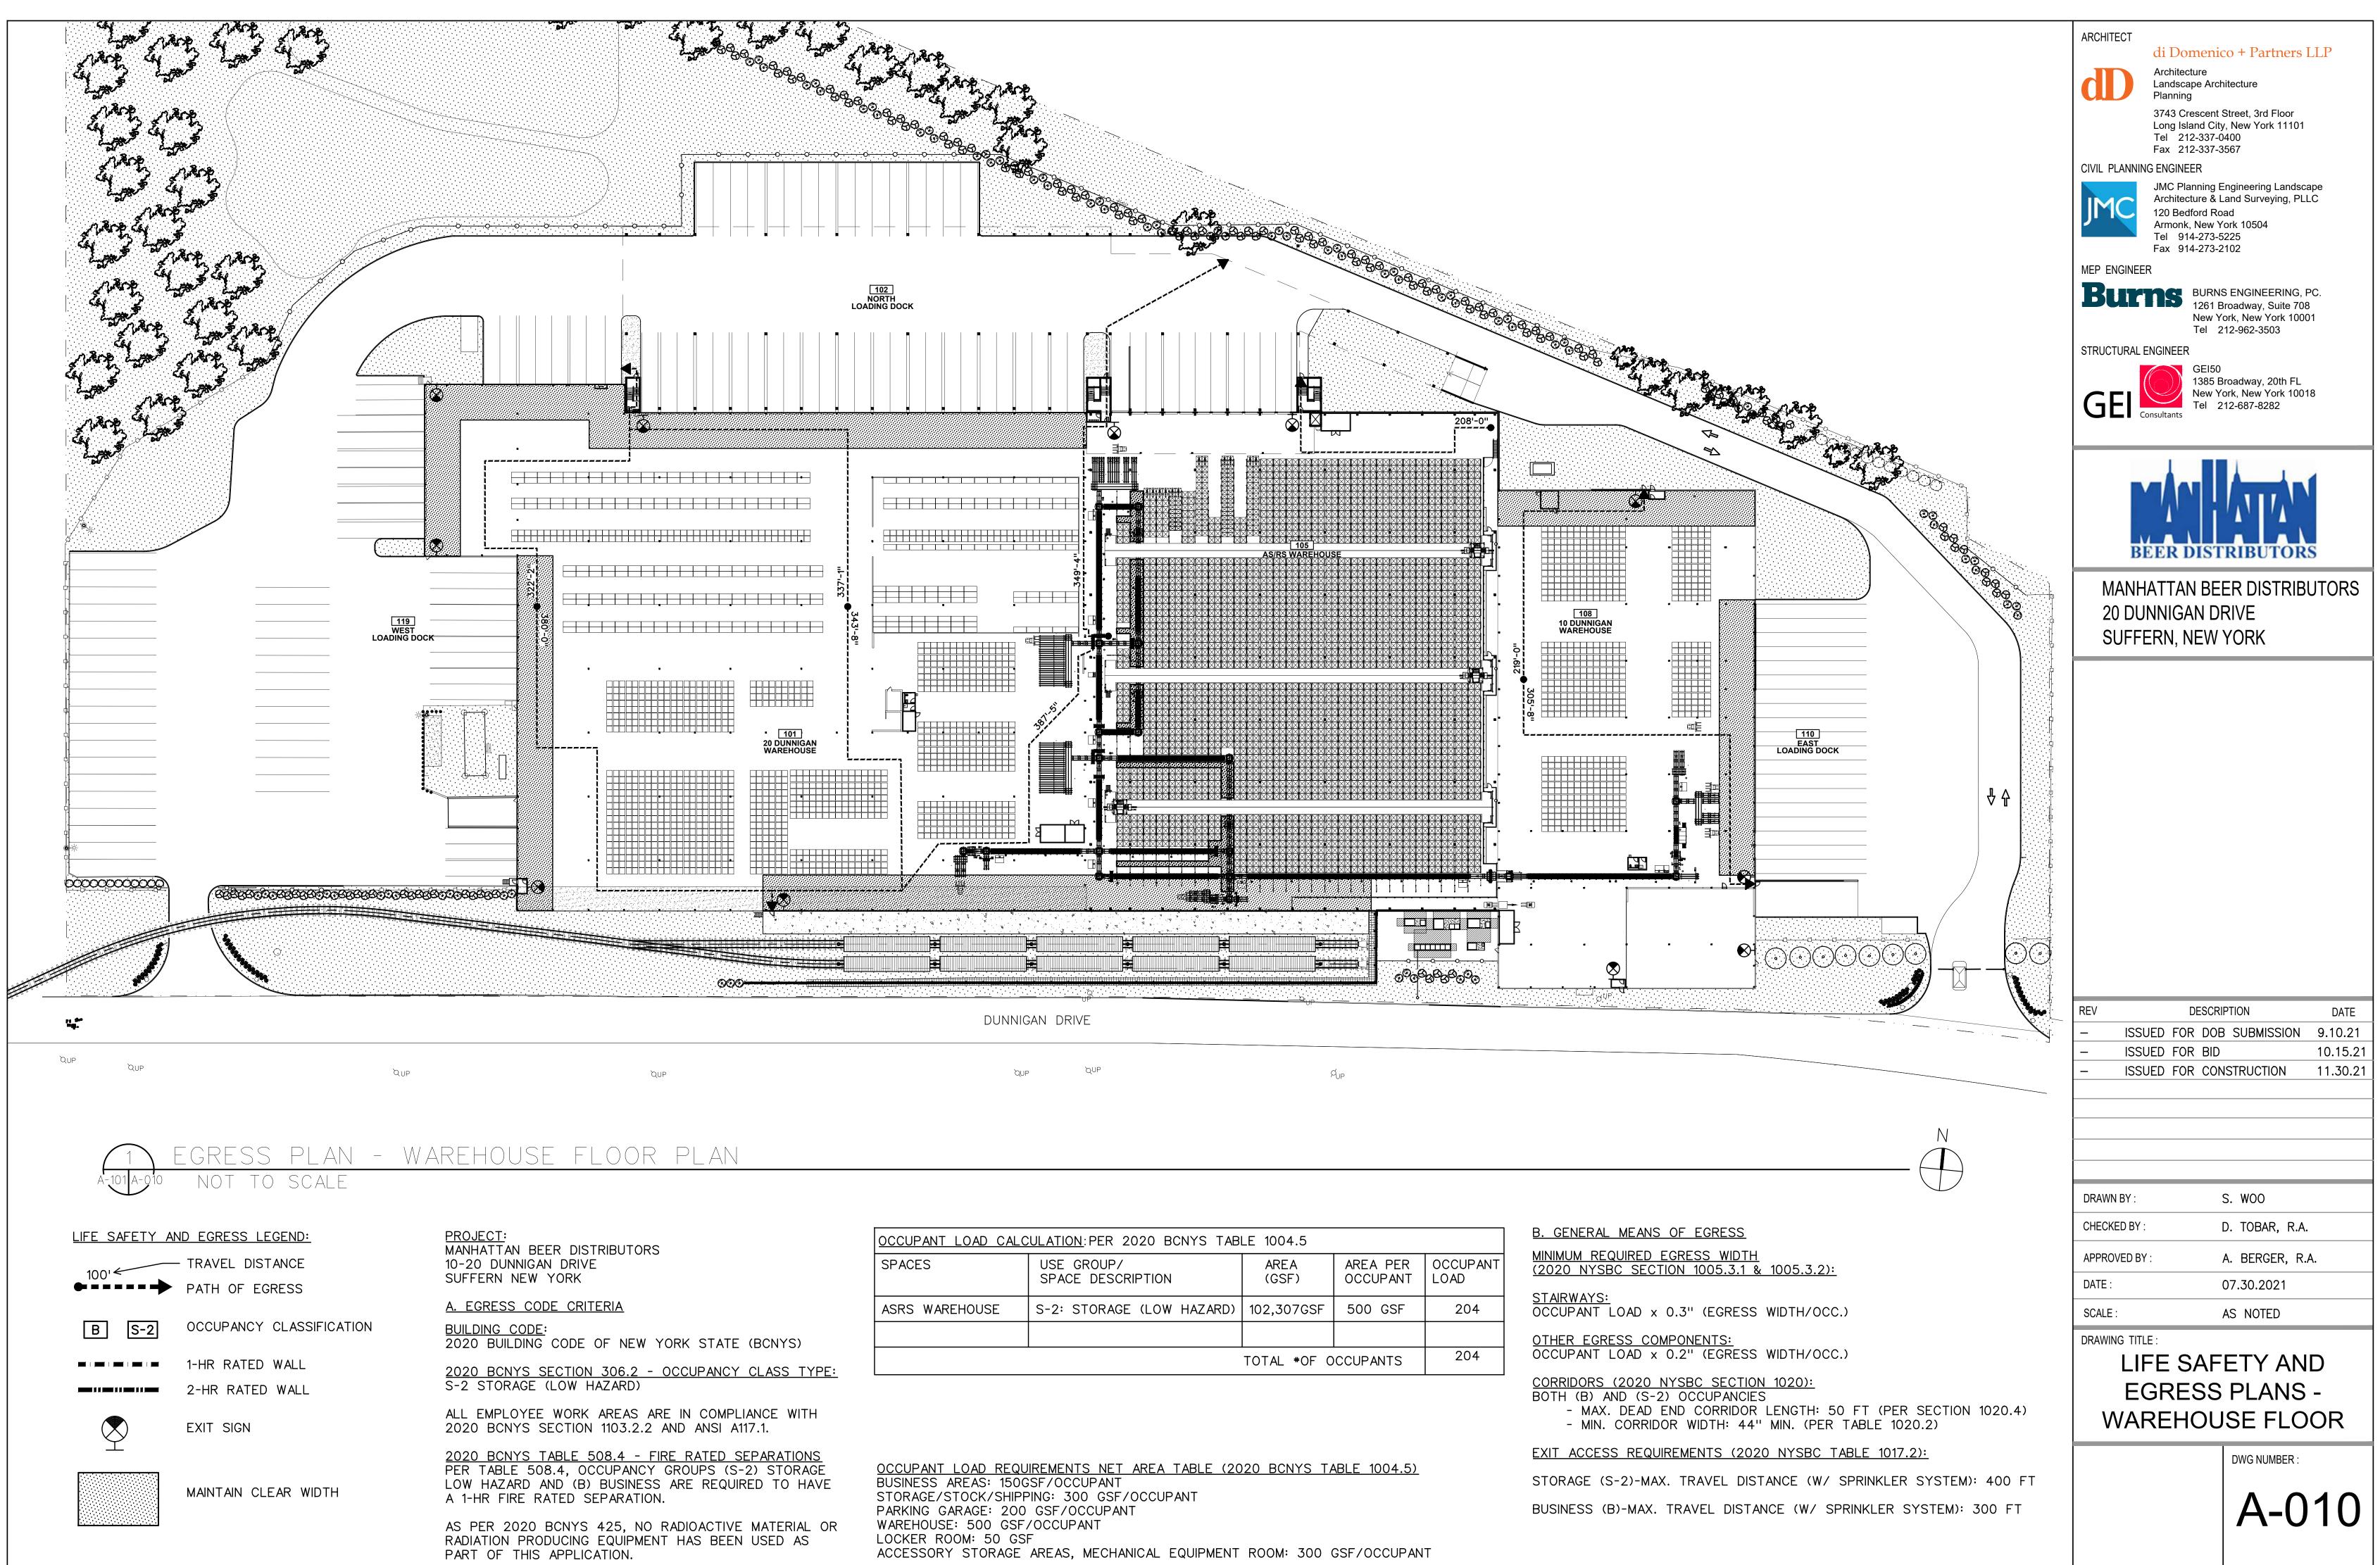

OCCUPANT LOAD CALCULATION: PER 2020 BCNYS TABLE 1004.5							
SPACES	USE GROUP/ SPACE DESCRIPTION	AREA (GSF)	AREA PER OCCUPANT	OCCUPANT LOAD			
ASRS WAREHOUSE	S-2: STORAGE (LOW HAZARD)	102,307GSF	500 GSF	204			
		TOTAL #OF O	CCUPANTS	204			

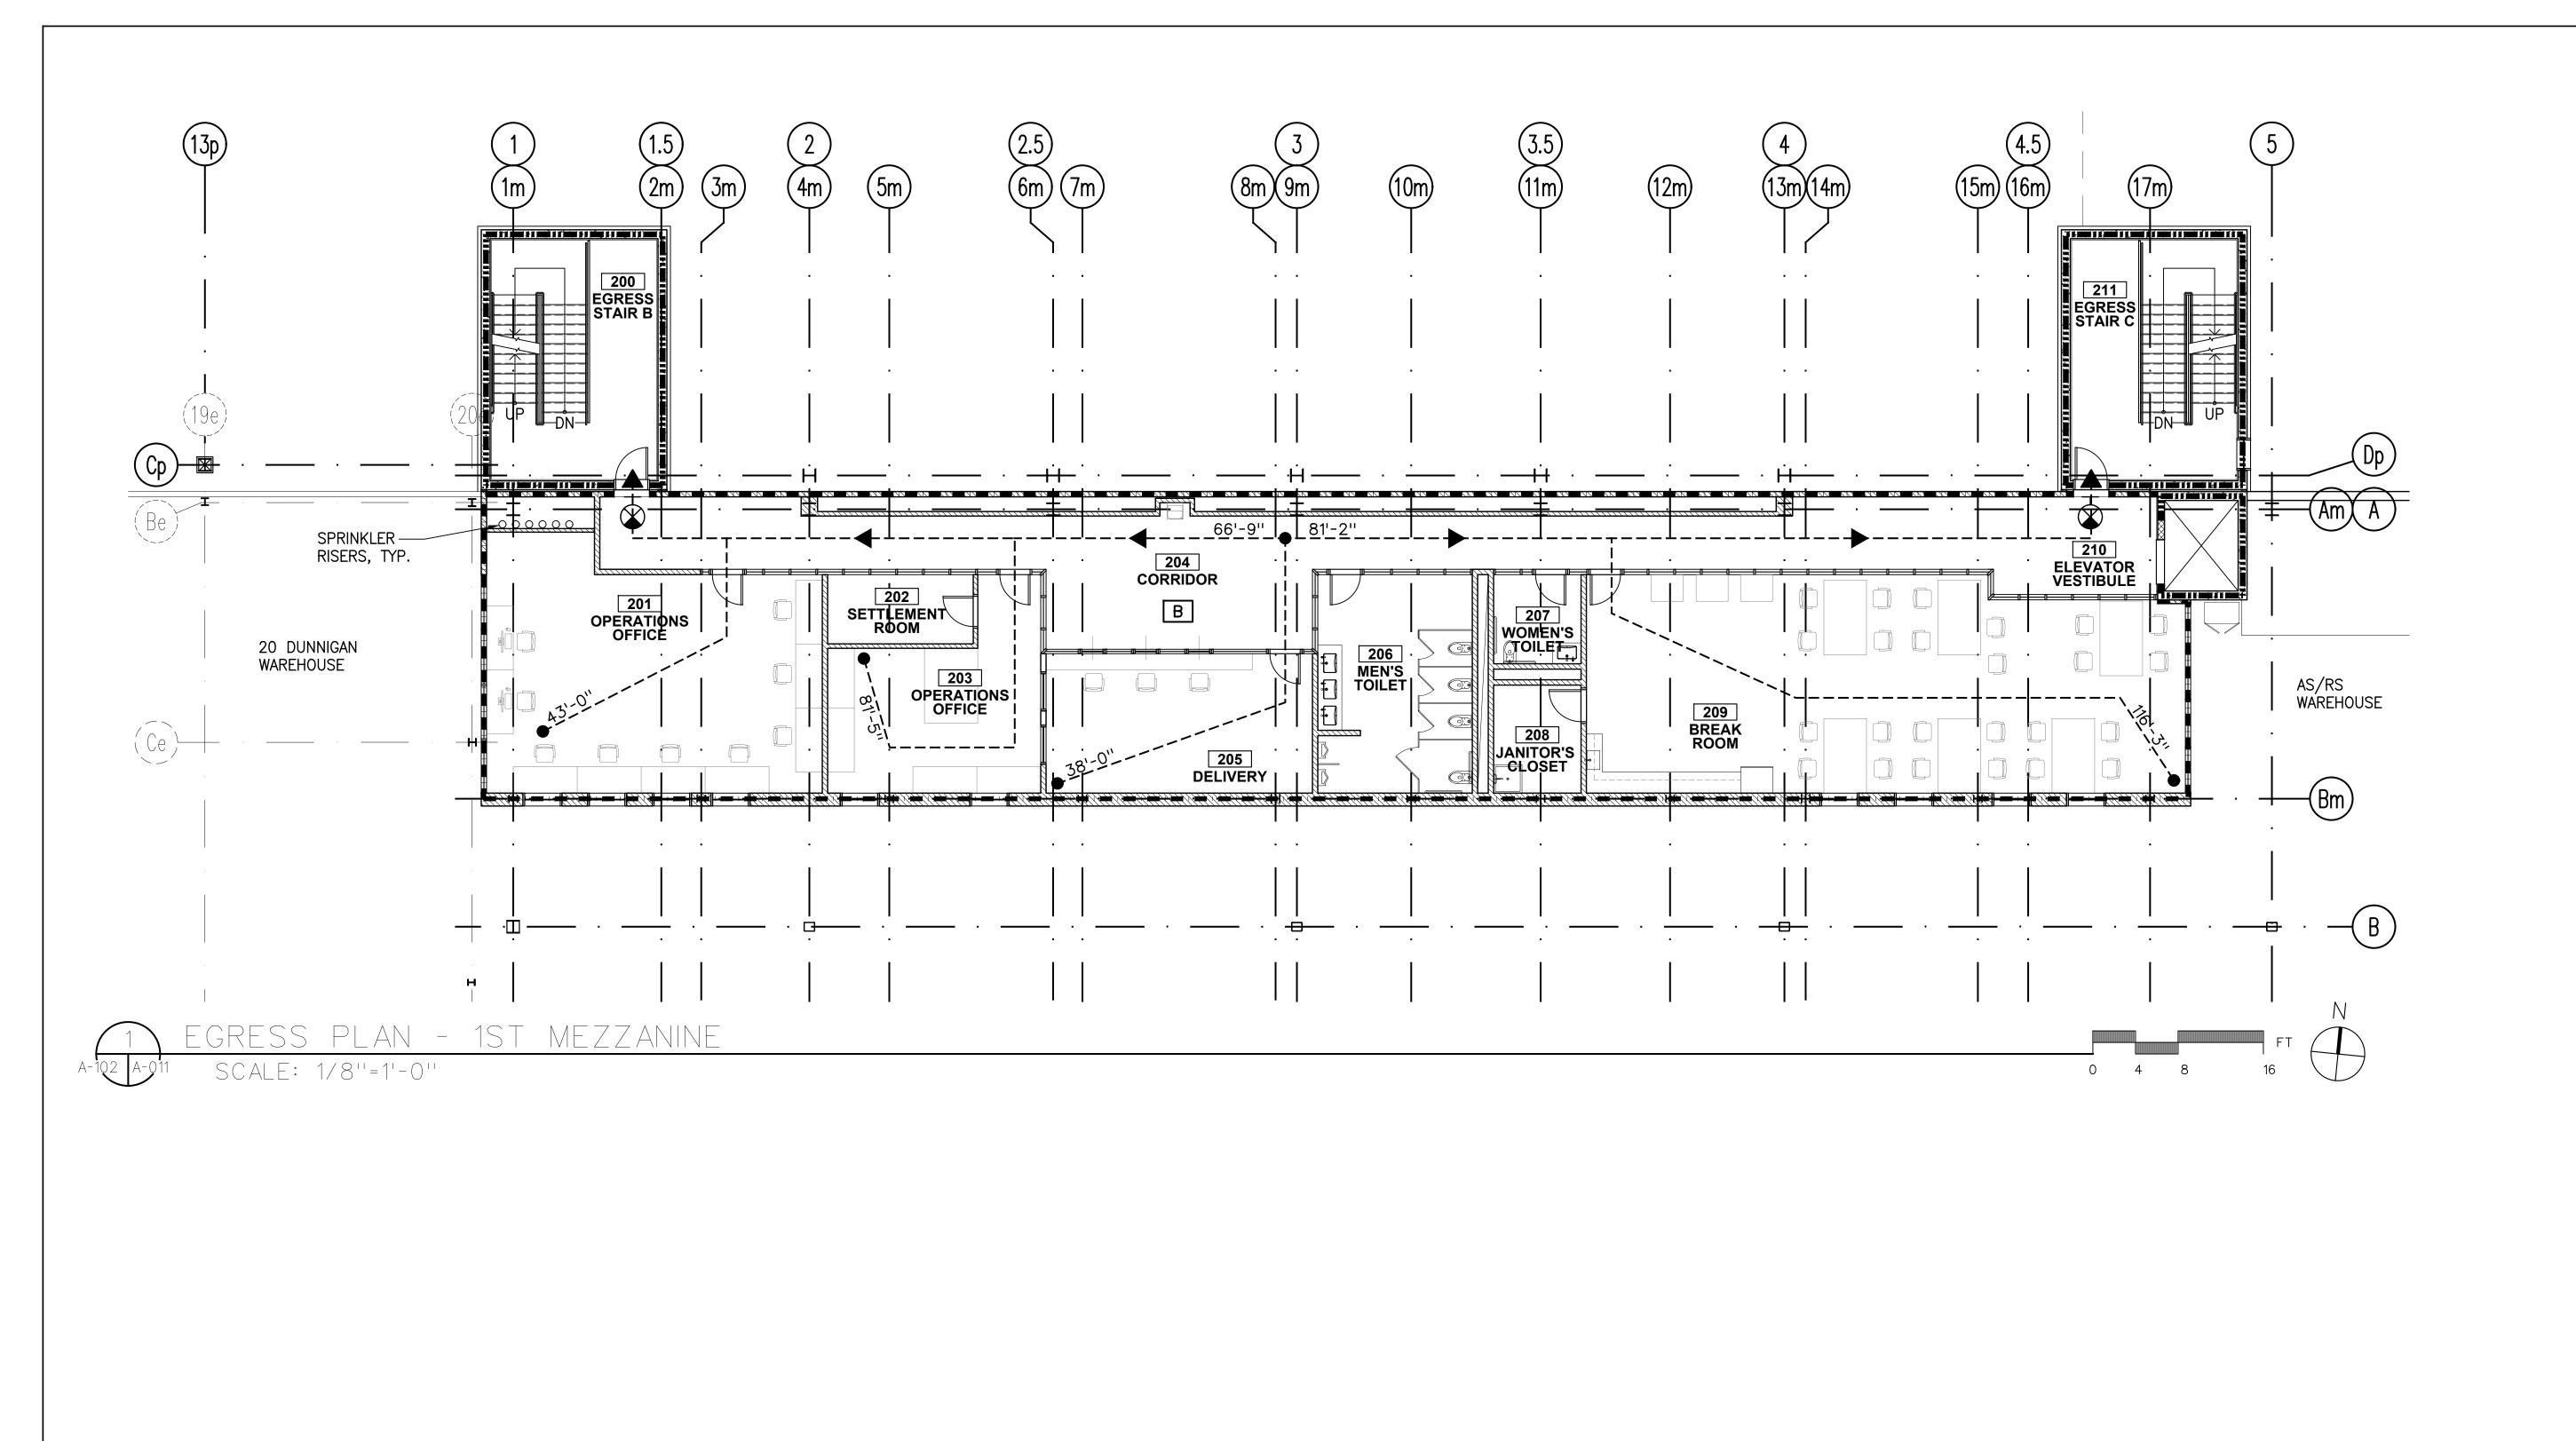

<u>LIFE SAFETY A</u>	ND EGRESS LEGEND:	PROJECT:
100'	- TRAVEL DISTANCE	MANHATTAN BEER DISTRIBUTORS 10-20 DUNNIGAN DRIVE SUFFERN NEW YORK
•	PATH OF EGRESS	A. EGRESS CODE CRITERIA
B S-2	OCCUPANCY CLASSIFICATION	BUILDING CODE: 2020 BUILDING CODE OF NEW YORK STATE (BCNYS)
	1-HR RATED WALL	2020 BCNYS SECTION 306.2 - OCCUPANCY CLASS TYPE
	2-HR RATED WALL	S-2 STORAGE (LOW HAZARD)
\bigotimes	EXIT SIGN	ALL EMPLOYEE WORK AREAS ARE IN COMPLIANCE WITH 2020 BCNYS SECTION 1103.2.2 AND ANSI A117.1.
		2020 BCNYS TABLE 508.4 - FIRE RATED SEPARATIONS PER TABLE 508.4, OCCUPANCY GROUPS (S-2) STORAGE LOW HAZARD AND (B) BUSINESS ARE REQUIRED TO HAVE A 1-HR FIRE RATED SEPARATION.

AS PER 2020 BCNYS 425, NO RADIOACTIVE MATERIAL OR RADIATION PRODUCING EQUIPMENT HAS BEEN USED AS PART OF THIS APPLICATION.

OCCUPANT LOAD CALCULATION: PER 2020 BCNYS TABLE 1004.5								
SPACES	USE GROUP/ SPACE DESCRIPTION	AREA (GSF)	AREA PER OCCUPANT	OCCUPANT LOAD				
1ST MEZZANINE	BUSINESS AREAS	4,223 GSF	150 GSF	28				
		TOTAL #OF C	CCUPANTS	28				

PE:

VF

OCCUPANT LOAD REQUIREMENTS NET AREA TABLE (2020 BCNYS TABLE 1004.5) BUSINESS AREAS: 150GSF/OCCUPANT STORAGE/STOCK/SHIPPING: 300 GSF/OCCUPANT PARKING GARAGE: 200 GSF/OCCUPANT WAREHOUSE: 500 GSF/OCCUPANT LOCKER ROOM: 50 GSF ACCESSORY STORAGE AREAS, MECHANICAL EQUIPMENT ROOM: 300 GSF/OCCUPANT B. GENERAL MEANS OF EGRESS MINIMUM REQUIRED EGRESS WIDTH (2020 NYSBC SECTION 1005.3.1 & 1005.3.2):

OTHER EGRESS COMPONENTS:

CORRIDORS (2020 NYSBC SECTION 1020): BOTH (B) AND (S-2) OCCUPANCIES - MAX. DEAD END CORRIDOR LENGTH: 50 FT (PER SECTION 1020.4) - MIN. CORRIDOR WIDTH: 44" MIN. (PER TABLE 1020.2)


EXIT ACCESS REQUIREMENTS (2020 NYSBC TABLE 1017.2):

STORAGE (S-2)-MAX. TRAVEL DISTANCE (W/ SPRINKLER SYSTEM): 400 FT BUSINESS (B)-MAX. TRAVEL DISTANCE (W/ SPRINKLER SYSTEM): 300 FT

<u>STAIRWAYS:</u> OCCUPANT LOAD x 0.3" (EGRESS WIDTH/OCC.)

OCCUPANT LOAD x 0.2" (EGRESS WIDTH/OCC.)

ARCHITECT di Domenico + Partners LLP
Architecture
Landscape Architecture Planning
3743 Crescent Street, 3rd Floor Long Island City, New York 11101 Tel 212-337-0400
Fax 212-337-3567
CIVIL PLANNING ENGINEER JMC Planning Engineering Landscape
Architecture & Land Surveying, PLLC 120 Bedford Road
Armonk, New York 10504 Tel 914-273-5225
Fax 914-273-2102 MEP ENGINEER
BURNS ENGINEERING, PC. 1261 Broadway, Suite 708
1261 Broadway, Suite 708 New York, New York 10001
Tel 212-962-3503 STRUCTURAL ENGINEER
GEI50
GEI (1385 Broadway, 20th FL New York, New York 10018 Tel 212-687-8282
Consultants
BEER DISTRIBUTORS
MANHATTAN BEER DISTRIBUTORS
20 DUNNIGAN DRIVE
SUFFERN, NEW YORK
REV DESCRIPTION DATE
-ISSUED FOR DOB SUBMISSION9.10.21-ISSUED FOR BID10.15.21
– ISSUED FOR CONSTRUCTION 11.30.21
DRAWN BY : S. WOO
CHECKED BY : D. TOBAR, R.A.
APPROVED BY: A. BERGER, R.A. DATE: 07.30.2021
SCALE: AS NOTED
DRAWING TITLE :
EGRESS PLANS -
1ST MEZZANINE
DWG NUMBER :
A-011

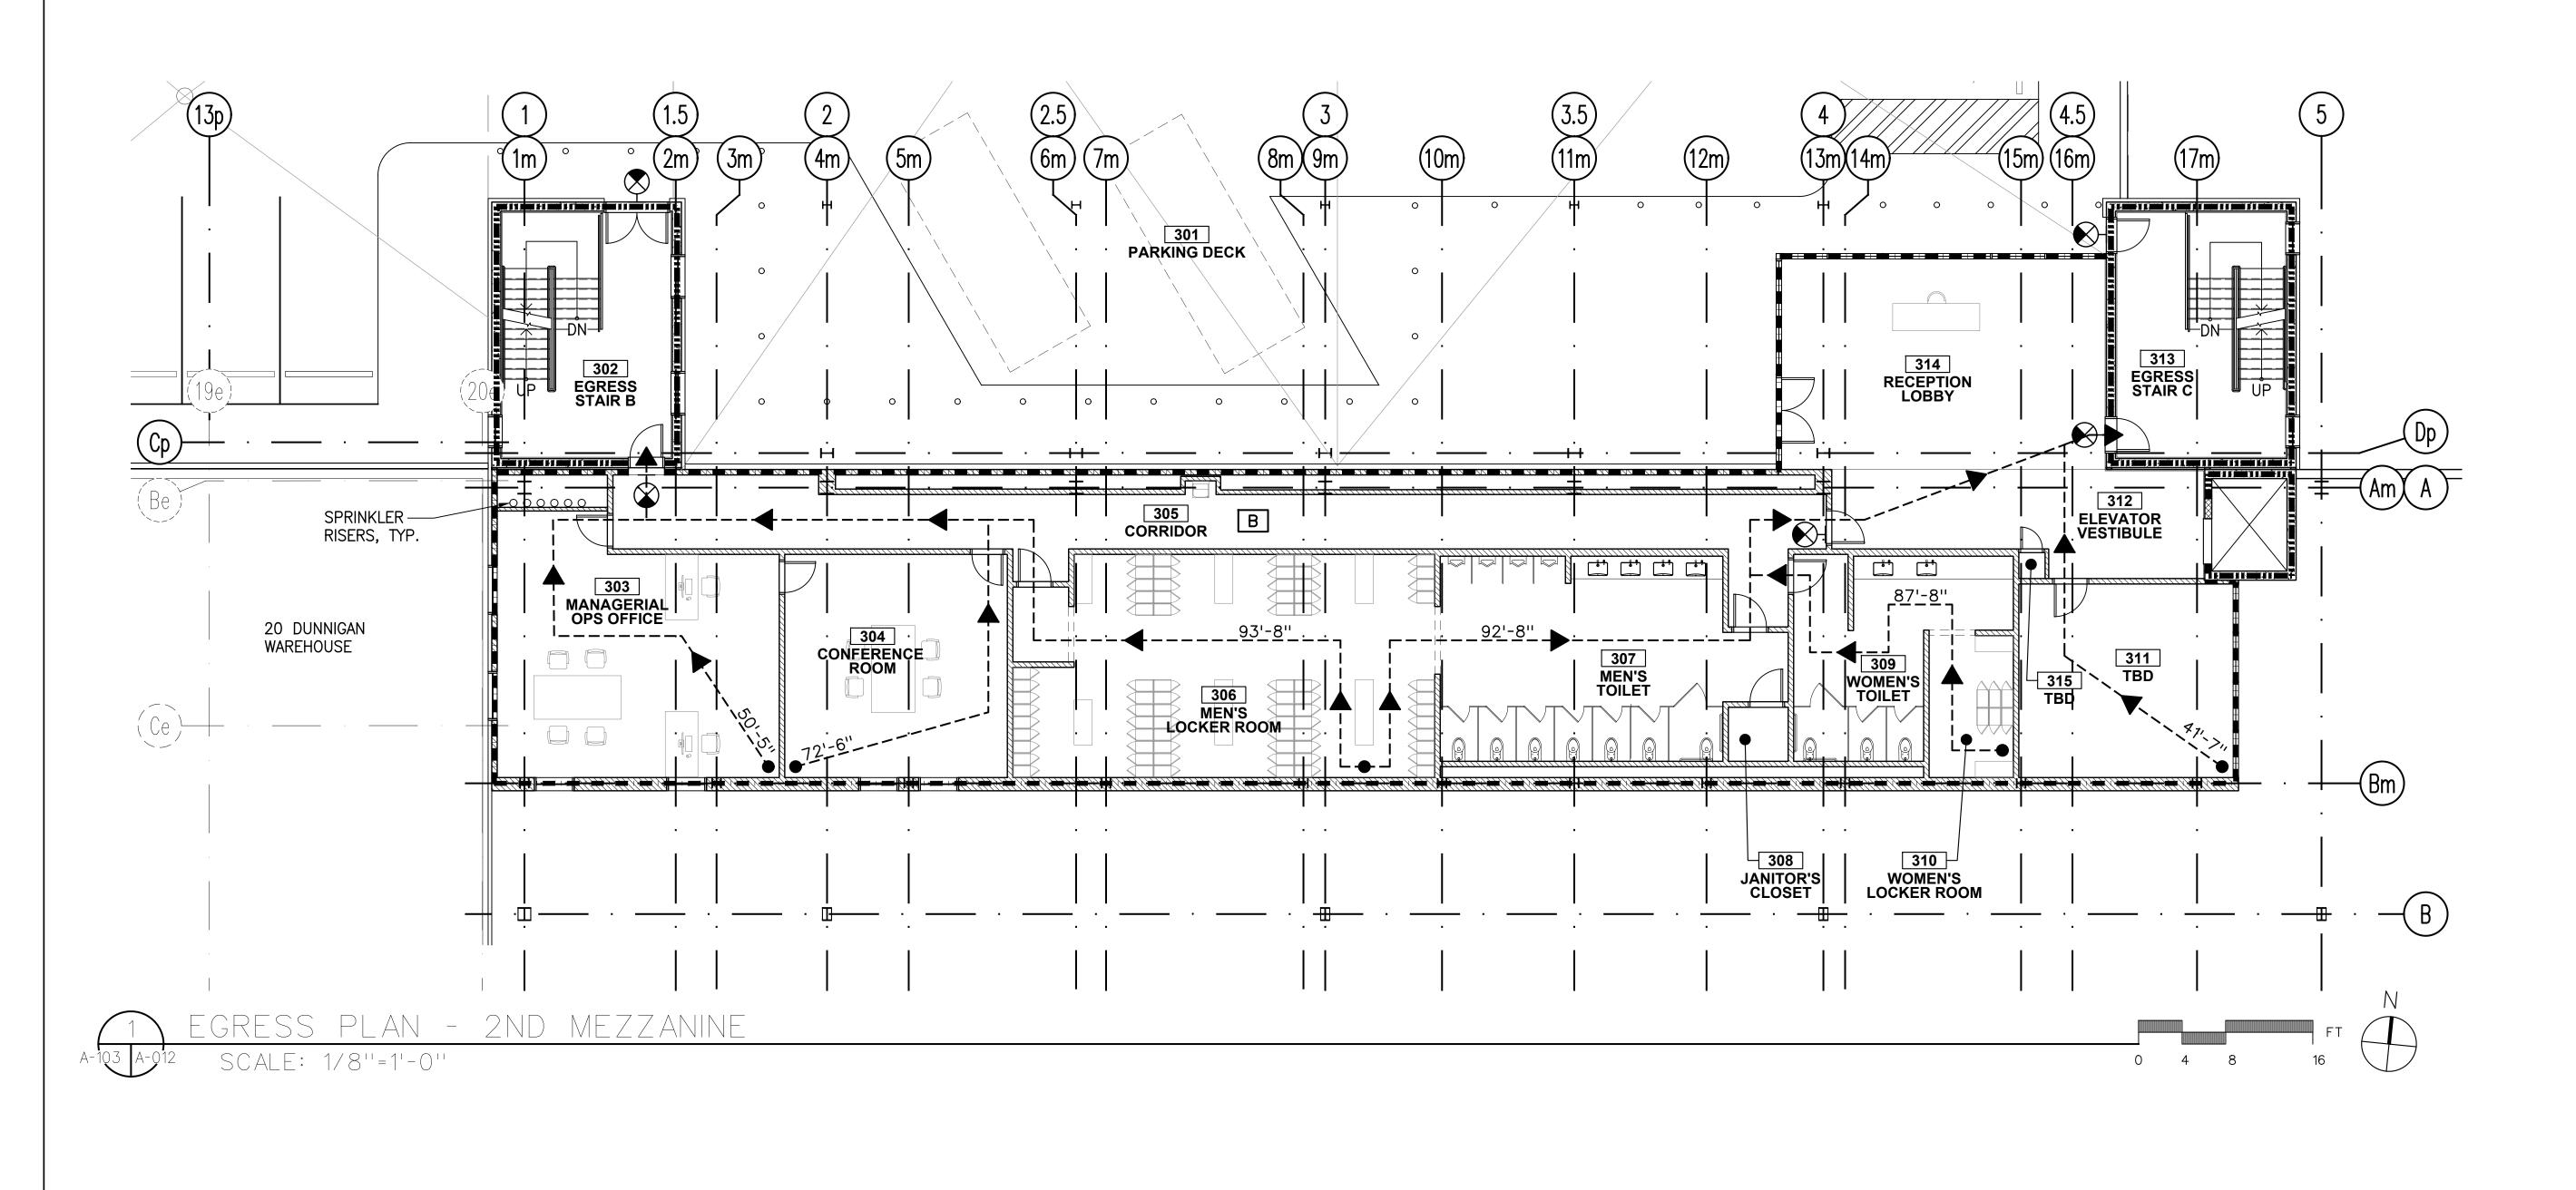

<u>LIFE SAFETY A</u>	ND EGRESS LEGEND:	PROJECT:
100' <	- TRAVEL DISTANCE PATH OF EGRESS	MANHATTAN BEER DISTRIBUTORS 10-20 DUNNIGAN DRIVE SUFFERN NEW YORK
		A. EGRESS CODE CRITERIA
B S-2	OCCUPANCY CLASSIFICATION	<u>BUILDING_CODE</u> : 2020 BUILDING CODE_OF_NEW_YORK_STATE (BCNYS)
	1-HR RATED WALL	<u>2020 BCNYS SECTION 306.2 - OCCUPANCY CLASS TYPE:</u> S-2 STORAGE (LOW HAZARD)
	2-HR RATED WALL	ALL EMPLOYEE WORK AREAS ARE IN COMPLIANCE WITH
\bigotimes	EXIT SIGN	2020 BCNYS SECTION 1103.2.2 AND ANSI A117.1.
		2020 BCNYS TABLE 508.4 - FIRE RATED SEPARATIONS PER TABLE 508.4, OCCUPANCY GROUPS (S-2) STORAGE LOW HAZARD AND (B) BUSINESS ARE REQUIRED TO HAVE A 1-HR FIRE RATED SEPARATION.

AS PER 2020 BCNYS 425, NO RADIOACTIVE MATERIAL OR RADIATION PRODUCING EQUIPMENT HAS BEEN USED AS PART OF THIS APPLICATION.

OCCUPANT LOAD CALCULATION: PER 2020 BCNYS TABLE 1004.5								
SPACES	USE GROUP/ SPACE DESCRIPTION	AREA (GSF)	AREA PER OCCUPANT	OCCUPANT LOAD				
2ND MEZZANINE	BUSINESS AREAS	3,254 GSF	150 GSF	21				
	LOCKER ROOM	993 GSF	50 GSF	19				
UPPER PARKING DECK	PARKING GARAGE	56,617 GSF	200 GSF	283				
		TOTAL #OF O	CCUPANTS	323				

B. GENERAL MEANS OF EGRESS MINIMUM REQUIRED EGRESS WIDTH (2020 NYSBC SECTION 1005.3.1 & 1005.3.2):

<u>STAIRWAYS:</u> OCCUPANT LOAD x 0.3" (EGRESS WIDTH/OCC.)

OTHER EGRESS COMPONENTS: OCCUPANT LOAD x 0.2" (EGRESS WIDTH/OCC.)


CORRIDORS (2020 NYSBC SECTION 1020): BOTH (B) AND (S-2) OCCUPANCIES - MAX. DEAD END CORRIDOR LENGTH: 50 FT (PER SECTION 1020.4) - MIN. CORRIDOR WIDTH: 44" MIN. (PER TABLE 1020.2)

EXIT ACCESS REQUIREMENTS (2020 NYSBC TABLE 1017.2):

STORAGE (S-2)-MAX. TRAVEL DISTANCE (W/ SPRINKLER SYSTEM): 400 FT BUSINESS (B)-MAX. TRAVEL DISTANCE (W/ SPRINKLER SYSTEM): 300 FT

OCCUPANT LOAD REQUIREMENTS NET AREA TABLE (2020 BCNYS TABLE 1004.5) BUSINESS AREAS: 150GSF/OCCUPANT STORAGE/STOCK/SHIPPING: 300 GSF/OCCUPANT PARKING GARAGE: 200 GSF/OCCUPANT WAREHOUSE: 500 GSF/OCCUPANT LOCKER ROOM: 50 GSF ACCESSORY STORAGE AREAS, MECHANICAL EQUIPMENT ROOM: 300 GSF/OCCUPANT

ARCHITECT di Domenico + Partners LLP
Architecture Landscape Architecture
Planning 3743 Crescent Street, 3rd Floor
Long Island City, New York 11101 Tel 212-337-0400
Fax 212-337-3567 CIVIL PLANNING ENGINEER
JMC Planning Engineering Landscape Architecture & Land Surveying, PLLC
120 Bedford Road Armonk, New York 10504 Tel 914-273-5225
Fax 914-273-2102
MEP ENGINEER BURNS ENGINEERING, PC. 1261 Broadway, Suite 708
1261 Broadway, Suite 708 New York, New York 10001 Tel 212-962-3503
STRUCTURAL ENGINEER
GEI50 1385 Broadway, 20th FL
GEI Consultants New York, New York 10018 Tel 212-687-8282
BEER DISTRIBUTORS
MANHATTAN BEER DISTRIBUTORS
20 DUNNIGAN DRIVE
SUFFERN, NEW YORK
REV DESCRIPTION DATE
- ISSUED FOR DOB SUBMISSION 9.10.21
-ISSUED FOR BID10.15.21-ISSUED FOR CONSTRUCTION11.30.21
DRAWN BY : S. WOO
CHECKED BY : D. TOBAR, R.A.
APPROVED BY : A. BERGER, R.A.
DATE: 07.30.2021
SCALE : AS NOTED
DRAWING TITLE :
LIFE SAFETY AND
EGRESS PLANS -
2ND MEZZANINE
DWG NUMBER :
A-012

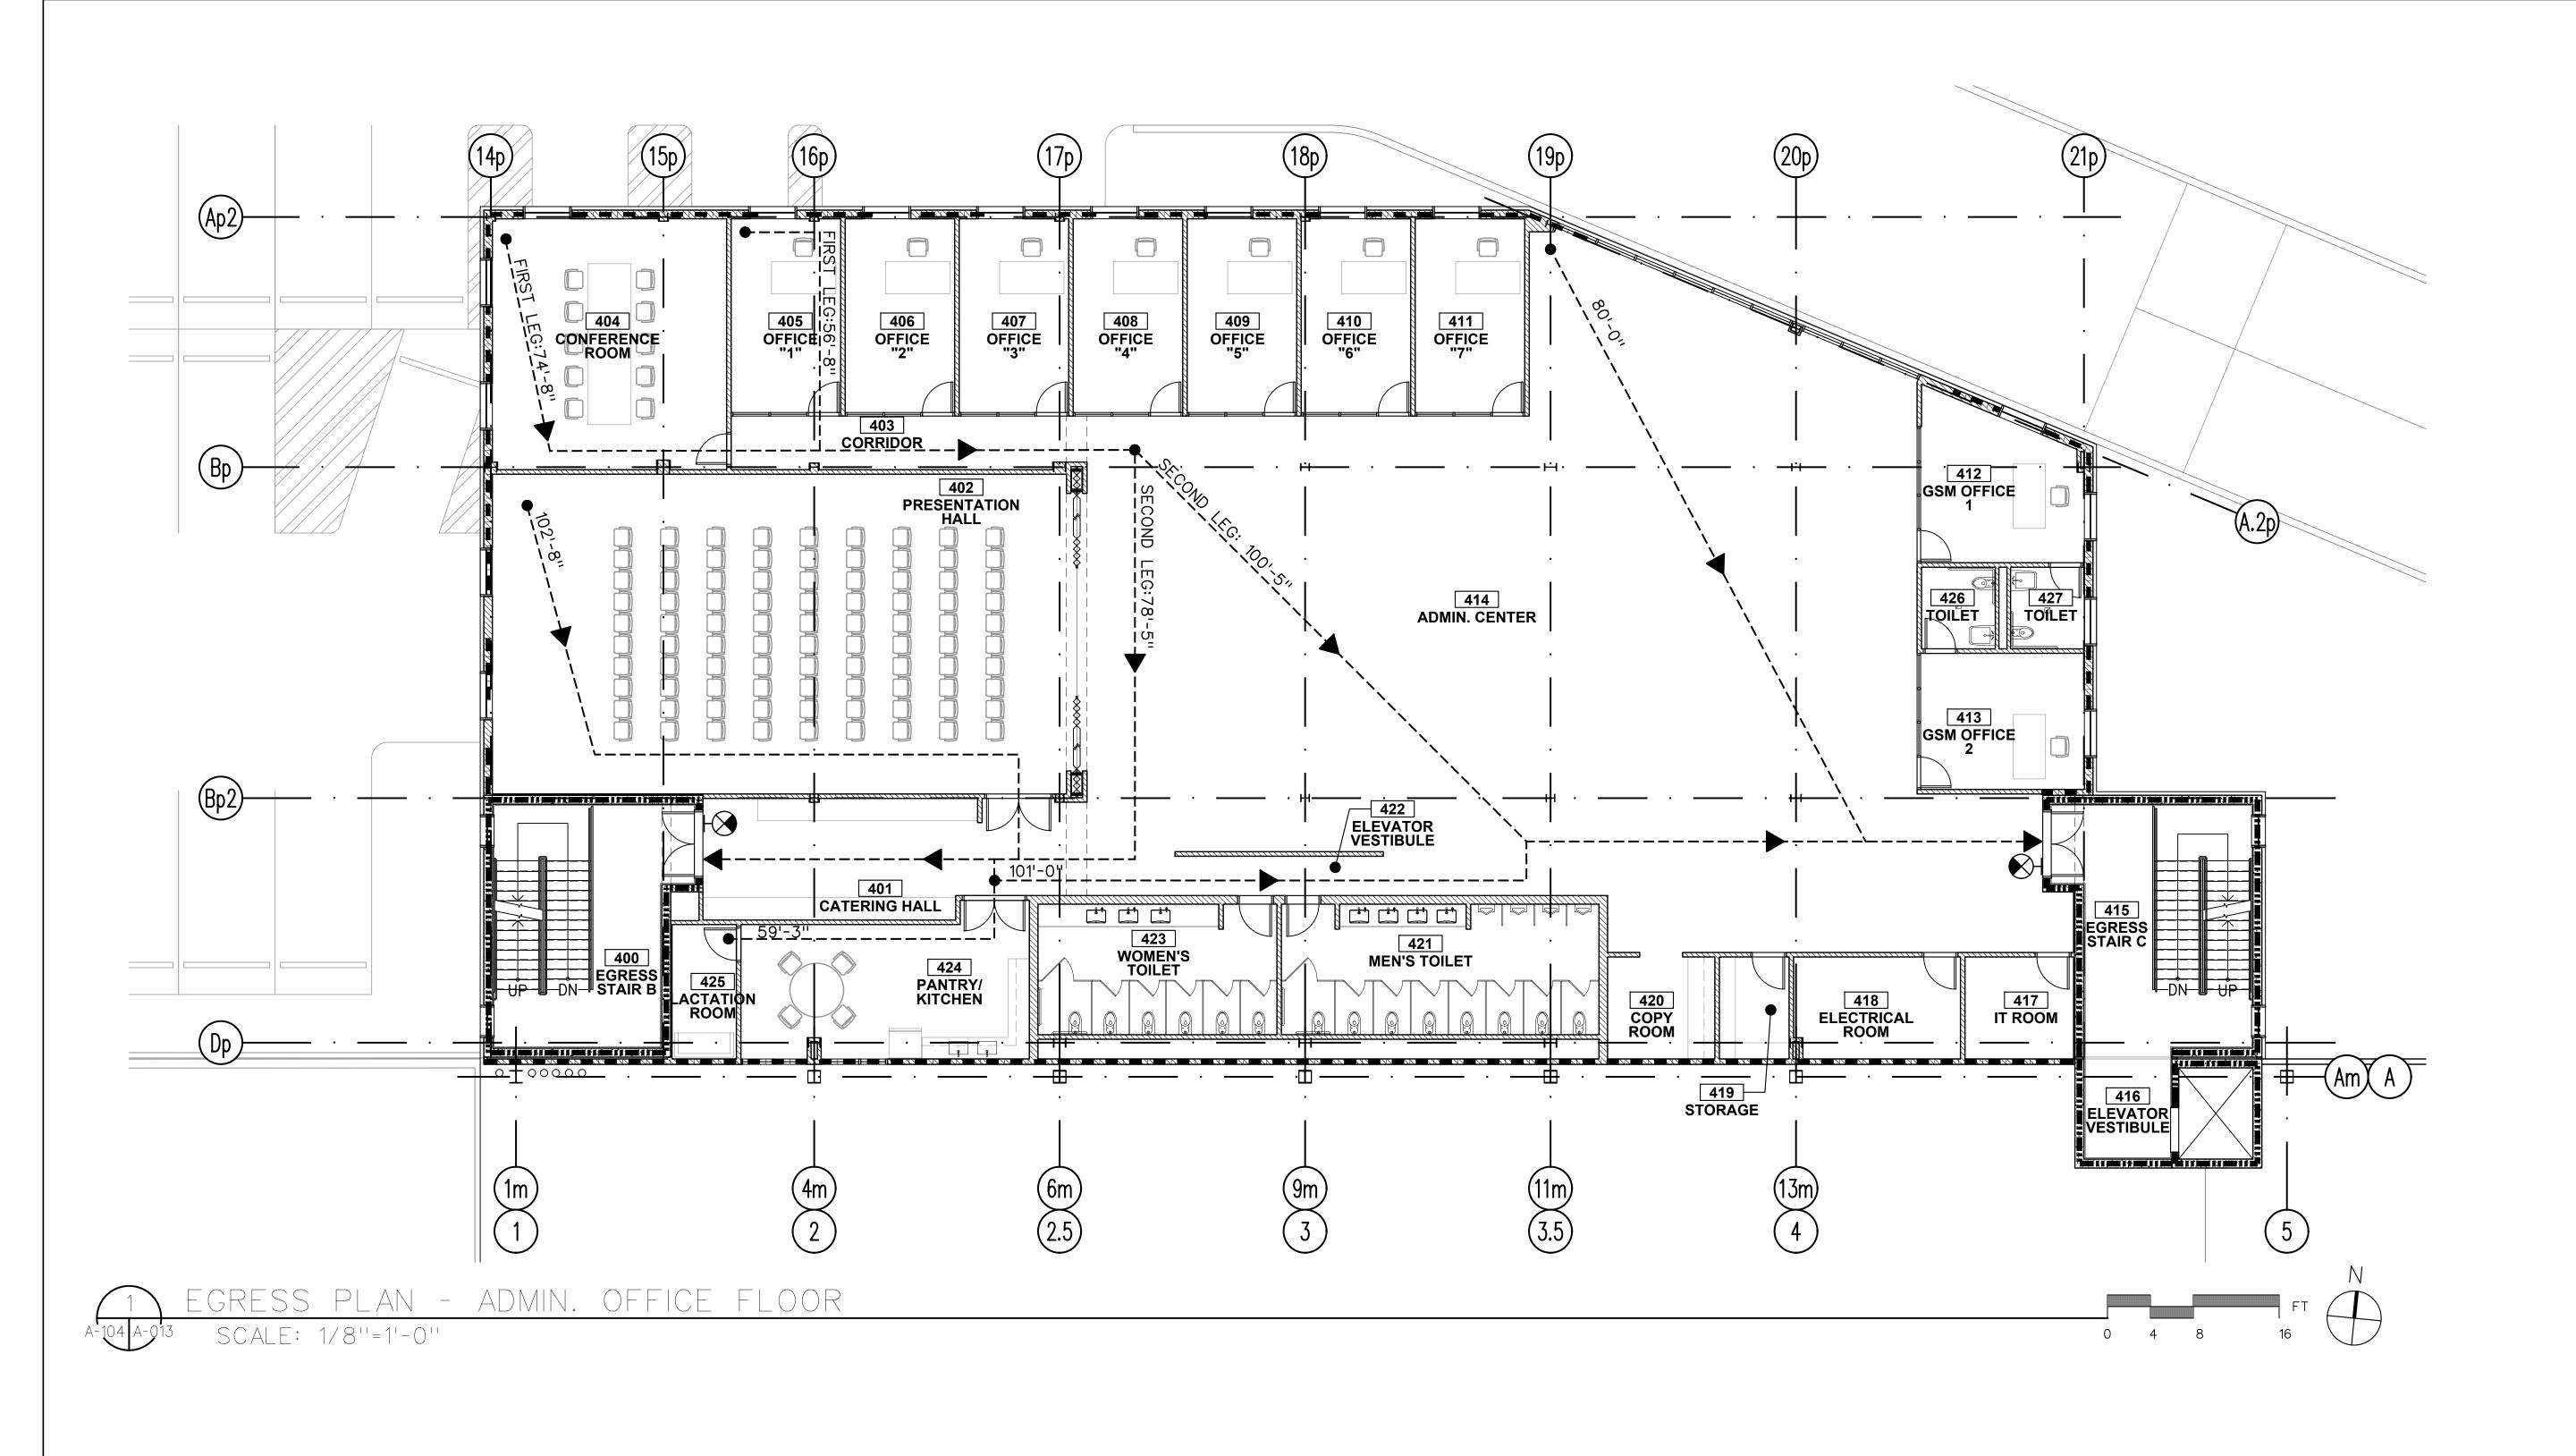

LIFE SAFETY AN	ND EGRESS LEGEND:	PROJECT:
100'	- TRAVEL DISTANCE	MANHATTAN BEER DISTRIBUTORS 10-20 DUNNIGAN DRIVE
	PATH OF EGRESS	SUFFERN NEW YORK
		<u>A. EGRESS CODE CRITERIA</u>
B S-2	OCCUPANCY CLASSIFICATION	<u>BUILDING CODE</u> : 2020 BUILDING CODE OF NEW YORK STATE (BCNYS)
	1-HR RATED WALL	2020 BCNYS SECTION 306.2 - OCCUPANCY CLASS TYP
	2-HR RATED WALL	S-2 STORAGE (LOW HAZARD)
\bigotimes	EXIT SIGN	ALL EMPLOYEE WORK AREAS ARE IN COMPLIANCE WITH 2020 BCNYS SECTION 1103.2.2 AND ANSI A117.1.
		2020 BCNYS TABLE 508.4 - FIRE RATED SEPARATIONS PER TABLE 508.4, OCCUPANCY GROUPS (S-2) STORAGE LOW HAZARD AND (B) BUSINESS ARE REQUIRED TO HAV A 1-HR FIRE RATED SEPARATION.

AS PER 2020 BCNYS 425, NO RADIOACTIVE MATERIAL OR RADIATION PRODUCING EQUIPMENT HAS BEEN USED AS PART OF THIS APPLICATION.

OCCUPANT LOAD CALCULATION: PER 2020 BCNYS TABLE 1004.5				
SPACES	USE GROUP/ SPACE DESCRIPTION	AREA (GSF)	AREA PER OCCUPANT	OCCUPANT LOAD
ADMIN OFFICE	BUSINESS AREAS	9,995 GSF	150 GSF	66
		TOTAL #OF C	CCUPANTS	66

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OCCUPANT LOAD REQUIREMENTS NET AREA TABLE (2020 BCNYS TABLE 1004.5) BUSINESS AREAS: 150GSF/OCCUPANT STORAGE/STOCK/SHIPPING: 300 GSF/OCCUPANT PARKING GARAGE: 200 GSF/OCCUPANT WAREHOUSE: 500 GSF/OCCUPANT LOCKER ROOM: 50 GSF ACCESSORY STORAGE AREAS, MECHANICAL EQUIPMENT ROOM: 300 GSF/OCCUPANT <u>STAIRWAYS:</u> OCCUPANT LOAD x 0.3" (EGRESS WIDTH/OCC.)

OTHER EGRESS COMPONENTS: OCCUPANT LOAD x 0.2" (EGRESS WIDTH/OCC.)


CORRIDORS (2020 NYSBC SECTION 1020): BOTH (B) AND (S-2) OCCUPANCIES - MAX. DEAD END CORRIDOR LENGTH: 50 FT (PER SECTION 1020.4) - MIN. CORRIDOR WIDTH: 44" MIN. (PER TABLE 1020.2)

EXIT ACCESS REQUIREMENTS (2020 NYSBC TABLE 1017.2):


STORAGE (S-2)-MAX. TRAVEL DISTANCE (W/ SPRINKLER SYSTEM): 400 FT BUSINESS (B)-MAX. TRAVEL DISTANCE (W/ SPRINKLER SYSTEM): 300 FT

B. GENERAL MEANS OF EGRESS MINIMUM REQUIRED EGRESS WIDTH (2020 NYSBC SECTION 1005.3.1 & 1005.3.2):

Γ
ARCHITECT di Domenico + Partners LLP
Architecture Landscape Architecture
Planning 3743 Crescent Street, 3rd Floor
Long Island City, New York 11101 Tel 212-337-0400 Fax 212-337-3567
CIVIL PLANNING ENGINEER
JMC Planning Engineering Landscape Architecture & Land Surveying, PLLC
120 Bedford Road Armonk, New York 10504 Tel 914-273-5225
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MEP ENGINEER BURNS ENGINEERING, PC. 1261 Broadway, Suite 708
New York, New York 10001
Tel 212-962-3503 STRUCTURAL ENGINEER
GEI50 1385 Broadway, 20th FL
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Consultants
BEERDISTRIBUTORS
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20 DUNNIGAN DRIVE SUFFERN, NEW YORK
REV DESCRIPTION DATE
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- ISSUED FOR CONSTRUCTION 11.30.21
DRAWN BY : S. WOO
CHECKED BY : D. TOBAR, R.A.
APPROVED BY : A. BERGER, R.A.
DATE : 07.30.2021
SCALE : AS NOTED
EGRESS PLANS -
ADMIN OFFICE FLOOR
DWG NUMBER :
A-013

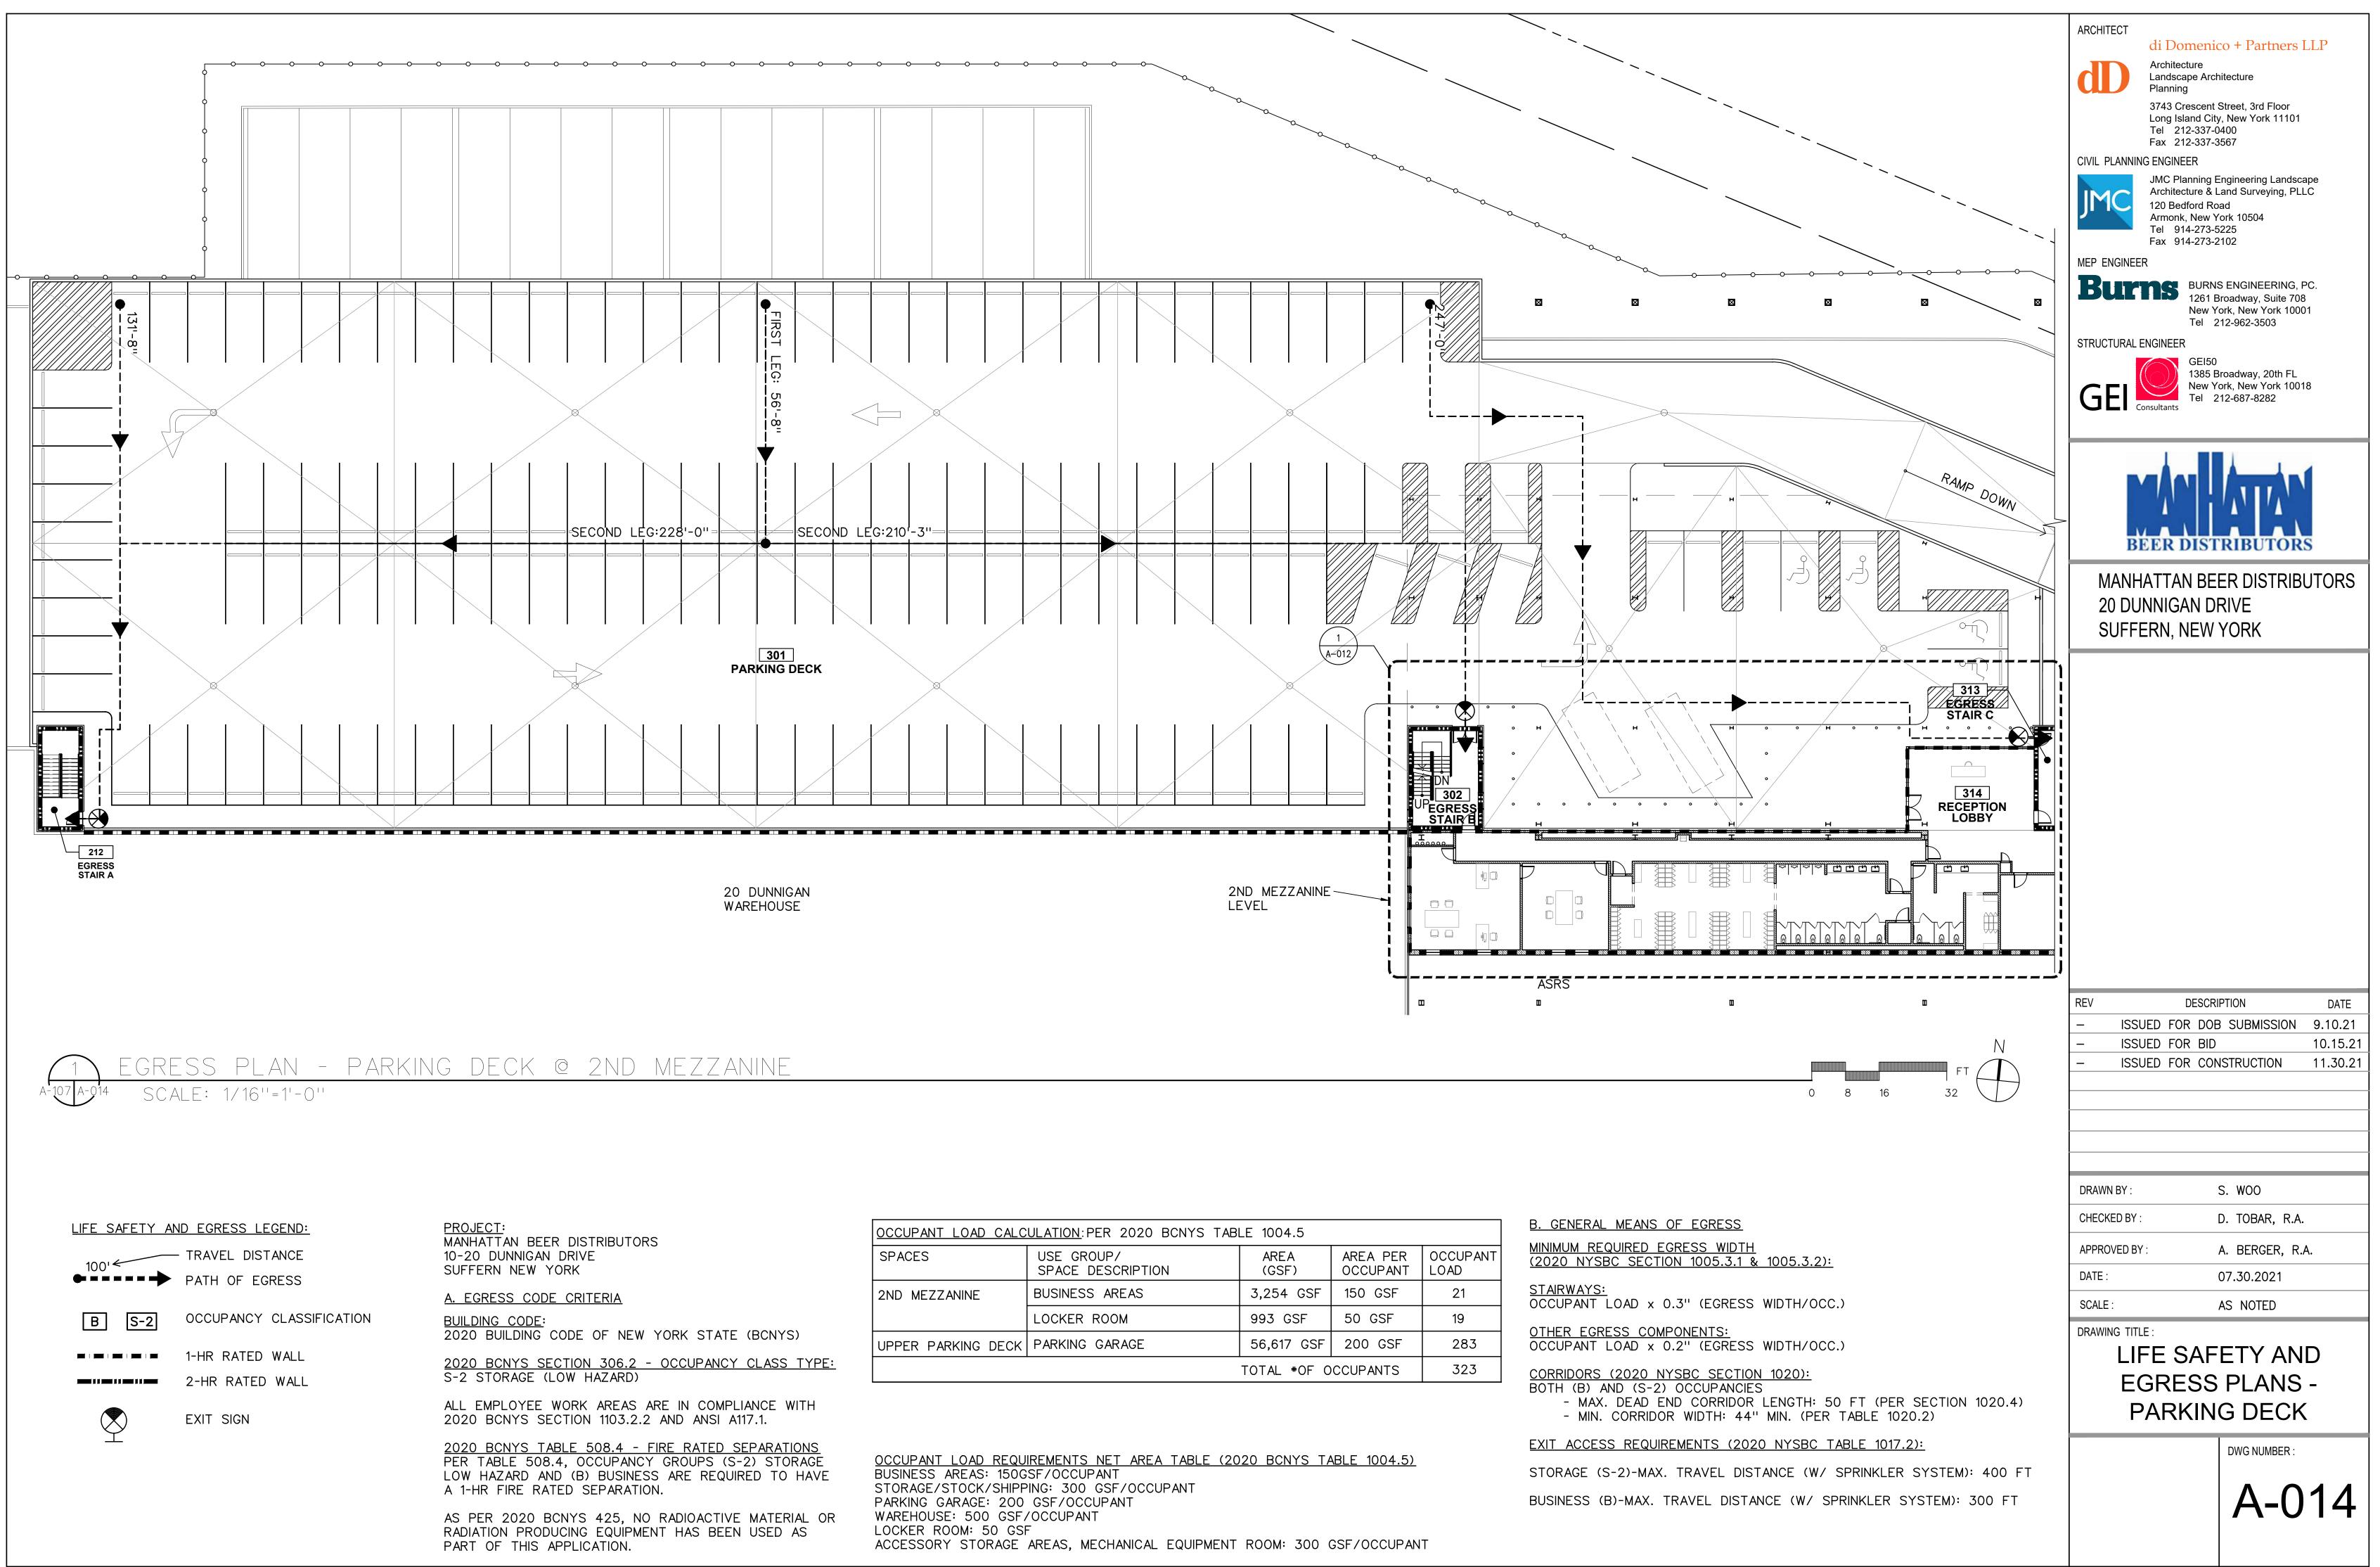

OCCUPANT LOAD CALCULATION: PER 2020 BCNYS TABLE 100				
SPACES	USE GROUP/ SPACE DESCRIPTION	AREA (GSF)	AREA PER OCCUPANT	OCCUPAN ⁻ LOAD
2ND MEZZANINE	BUSINESS AREAS	3,254 GSF	150 GSF	21
	LOCKER ROOM	993 GSF	50 GSF	19
UPPER PARKING DECK	PARKING GARAGE	56,617 GSF	200 GSF	283
		TOTAL #OF O	CCUPANTS	323

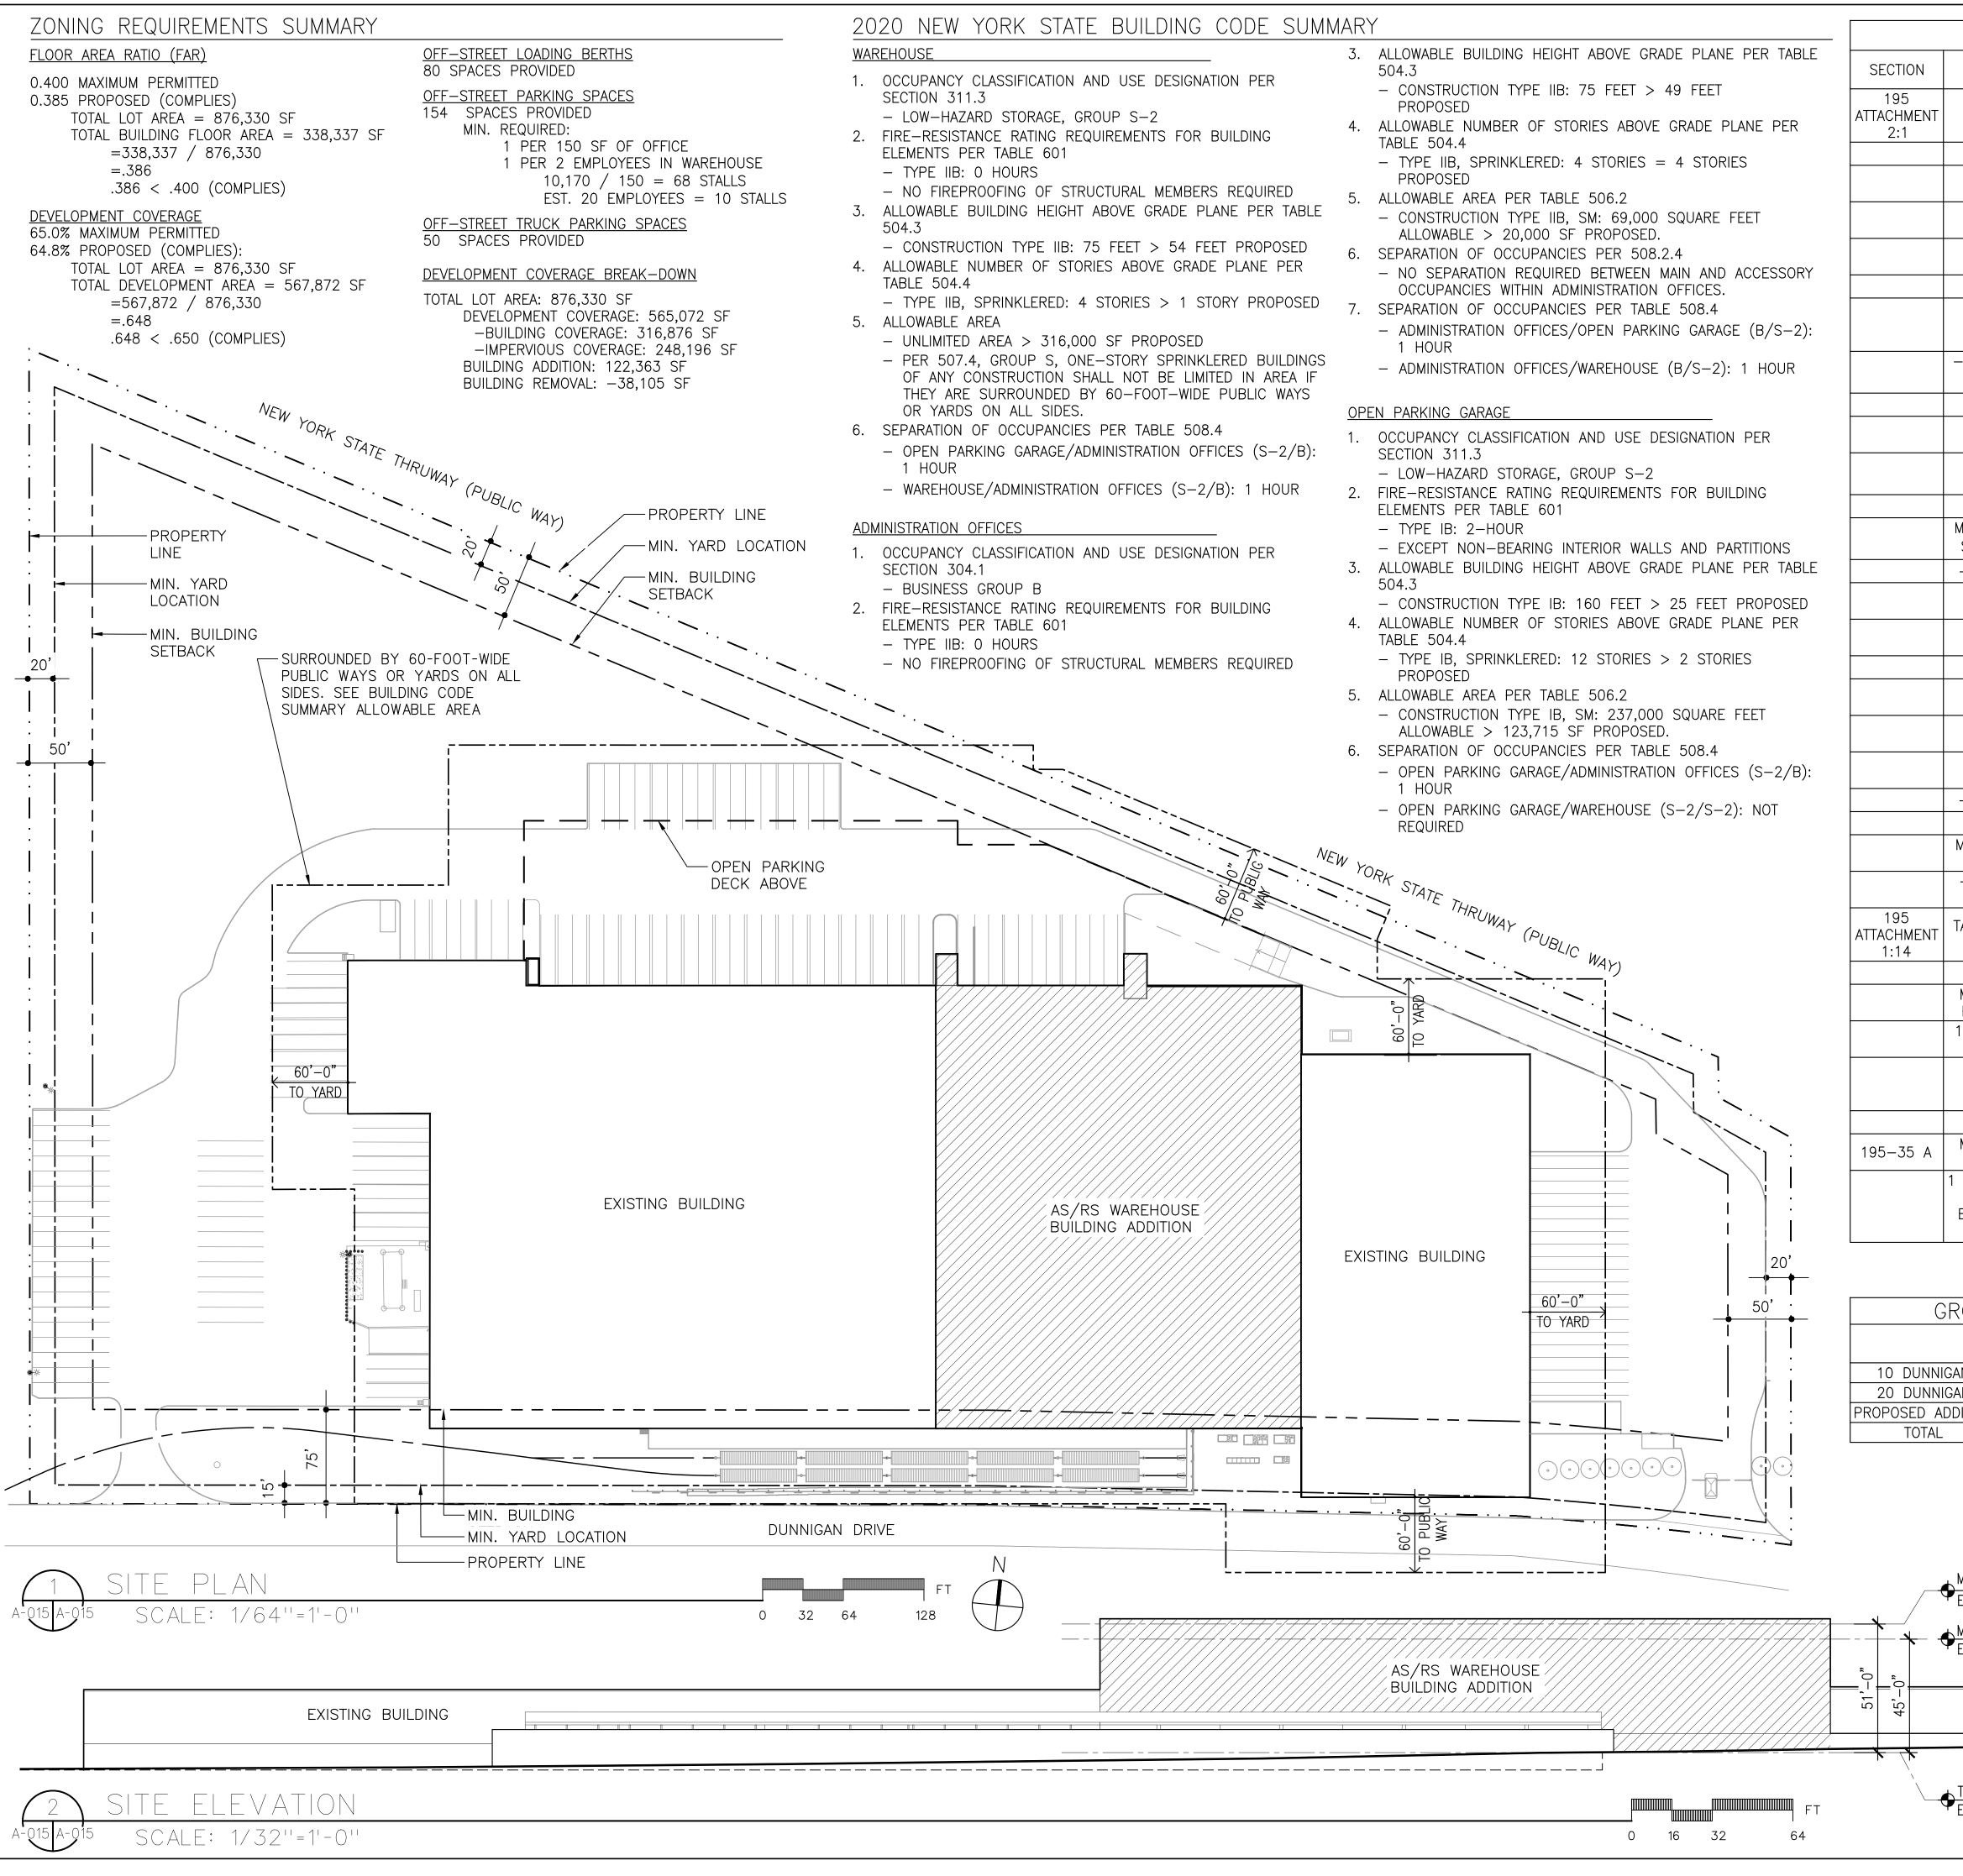

	ZONING				ARCHITECT di Domenico + Partners LLP
ZONING REQUIREMENTS	PERMITTED PI DISTRICT	EXISTING/ COVERAGE	NEW/(TOTAL) COVERAGE	REMARKS	Architecture Landscape Architecture
TABLE OF BULK REQUIREMENTS					Planning 3743 Crescent Street, 3rd Floor Long Island City, New York 11101 Tel 212-337-0400
MINIMUM LOT DIMENSIONS					Fax 212-337-3567 CIVIL PLANNING ENGINEER
-AREA (ACRES)	20.117	20.117	20.117	NO CHANGE	JMC Planning Engineering Landscape Architecture & Land Surveying, PLLC 120 Bedford Road
-AREA (FEET)	876,330	876,330	876,330	NO CHANGE	Armonk, New York 10504 Tel 914-273-5225 Fax 914-273-2102
MAXIMUM DEVELOPMENT COVERAGE	65%	48%	64.8%		MEP ENGINEER BURNS ENGINEERING, PC. 1261 Broadway, Suite 708
-GROSS SITE AREA (SF)	569,614	421,106	567,872	COMPLIES	New York, New York 10001 Tel 212-962-3503 STRUCTURAL ENGINEER
MAXIMUM FLOOR AREA RATIO	.40	.29	.386		GEI50 1385 Broadway, 20th FL New York, New York 10018
–GROSS FLOOR AREA (SF)	350,532	252,757	338,337	COMPLIES	GEI Consultants Tel 212-687-8282
MINIMUM REQUIRED SETBACKS (FEET)					
-FRONT BUILDING	75	11	44	*	
-FRONT YARD	15	11	11	NO CHANGE	
-REAR BUILDING	50	29	50	NO CHANGE	BEER DISTRIBUTORS
-REAR YARD	20	26	50	COMPLIES	MANHATTAN BEER DISTRIBUTORS
-SIDE WEST BUILDING	50	252.5	252.5	NO CHANGE	20 DUNNIGAN DRIVE
-SIDE YARD	20	3	3	NO CHANGE	SUFFERN, NEW YORK
-SIDE EAST BUILDING	50	142	207	COMPLIES	
-SIDE EAST YARD	20	1.5	20	COMPLIES	
MAXIMUM BUILDING HEIGHT –MAX ALLOWABLE HEIGHT	45	28.5	51	*	
TABLE OF GENERAL REQUIREMENTS					
MIN. OFF-STREET PARKING SPACES 1 SPACE PER 150 SF - OFFICE	68	141	144	COMPLIES	
1 FOR EVERY 2 EMPLOYEE – WAREHOUSE	10	10	10	COMPLIES	
MIN. OFF-STREET LOADING BERTHS					
1 FOR FIRST 20,000 SF PLUS 1 FOR EVERY ADDITIONAL 40,000 SF	5	12	80	COMPLIES	REVDESCRIPTIONDATE-ISSUED FOR DOB SUBMISSION9.10.21-ISSUED FOR BID10.15.25
		NEW COVER *VARIANCE	RAGE INCLUDE APPROVED	S EXISTING	– ISSUED FOR CONSTRUCTION 11.30.21
ROSS FLOOR ,	ARFA SU	MMARY			
EXISTING	REMOVAL	BUILDINGS	TO BE		

EXISTING REMOVAL BUILDINGS TO BE /ADDITION COMBINED	
7	
AN 92,836 SF -28,804 SF 64,032 SF	
AN 159,921 SF -9,301 SF 150,620 SF	
DITION 123,725 SF 123,725 SF	
252,757 SF 85,620 SF 338,337 SF	

MAX BUILDING HEIGHT (VARIANCE ADOPTED) EL.: +/- 462.42'

MAX ALLOWABLE BUILDING HEIGHT ♥EL.: +/- 462.42'

EXISTING BUILDING

T.O. AVG GRADE EL.: +/- 411.42' DWG NUMBER :




DATE :

S. WOO DRAWN BY : D. TOBAR, R.A. CHECKED BY A. BERGER, R.A. APPROVED BY 07.30.2021 AS NOTED SCALE :


DRAWING TITLE:

ZONING AND BUILDING CODE SUMMARY

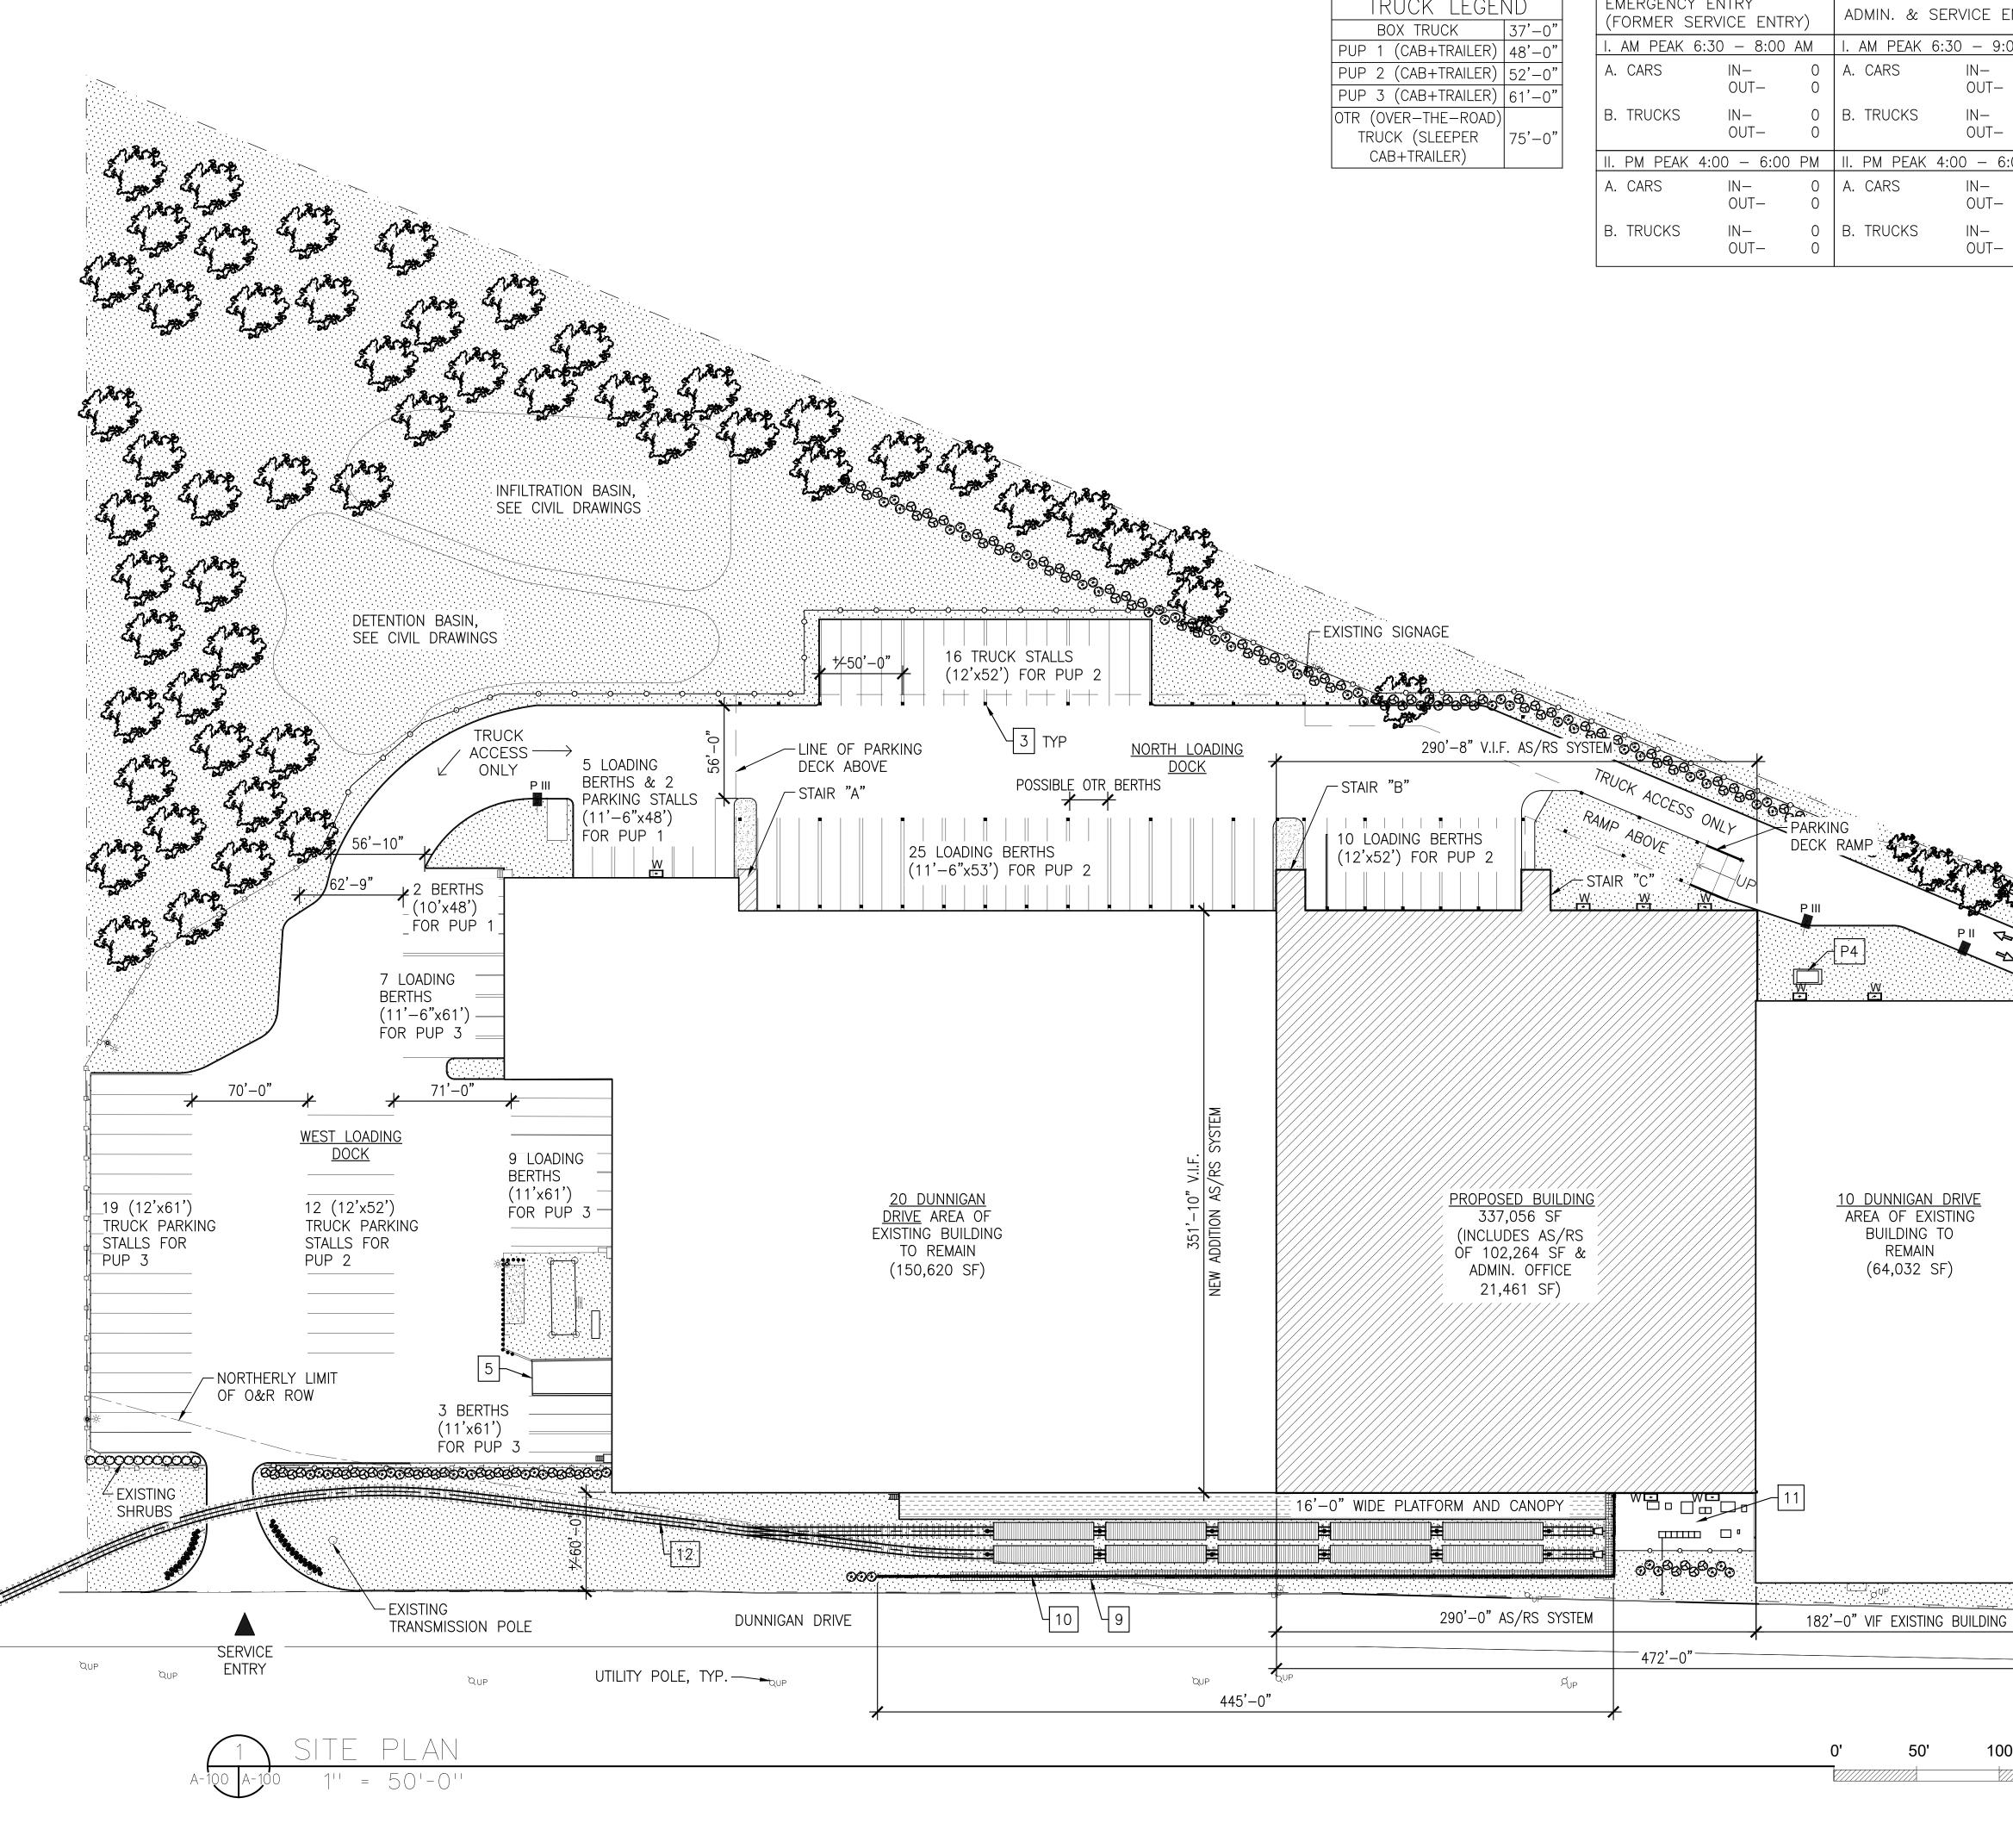


TRUCK LEGEN	٧D		
BOX TRUCK	37'-0"		
PUP 1 (CAB+TRAILER)	48'-0"		
PUP 2 (CAB+TRAILER)	52'-0"		
PUP 3 (CAB+TRAILER)	61'-0"		
OTR (OVER-THE-ROAD) TRUCK (SLEEPER CAB+TRAILER)			

I. AM PEAK 0.30 - 8.00 AM I. AM PEAK 0.30 - 9.00 AM A. CARS IN- 0 OUT- 0 A. CARS IN- 45 OUT- 0 B. TRUCKS IN- 0 OUT- 0 B. TRUCKS IN- 0 B. TRUCKS IN- 0 OUT- 31 II. PM PEAK 4:00 - 6:00 PM II. PM PEAK 4:00 - 6:00 PM II. PM PEAK 4:00 - 6:00 PM IN- 0 O EXIS A. CARS IN- 0 A. CARS IN- 0 O EXIS II. PM PEAK 4:00 - 6:00 PM II. PM PEAK 4:00 - 6:00 PM OUT- 0 O EXIS A. CARS IN- 0 A. CARS IN- 0 O EXIS D. TRUCKO IN- 0 A. CARS IN- 0 O EXIS	LEGEND: CHAIN LINK FENCE TING CHAIN LINK FENCE POSED SHRUB TING TREE TING SHRUB DIRECTION OF TRAVEL CATED ING BASIN, SEE CIVIL CIVIL DRAWINGS.	Architecture Landscape Arch Planning 3743 Crescent & Long Island City Tel 212-337-0 Fax 212-337-3 IL PLANNING ENGINEER JMC Planning E Architecture & L 120 Bedford Roa Armonk, New Yo Tel 914-273-5 Fax 914-273-2 P ENGINEER BURNS 1261 B New Yo Tel 2 COTURAL ENGINEER	Street, 3rd Floor , New York 11101 400 567 ngineering Landscape and Surveying, PLLC ad ork 10504 225
		MANHATTAN BER 20 DUNNIGAN DE SUFFERN, NEW	ER DISTRIBUTORS RIVE
TRUCK ACCESS ONLY PARKING DECK RAMP W W PIII PII PII PII PII PII PII PII P			
G 10 DUNNIGAN DRIVE AREA OF EXISTING BUILDING TO REMAIN (64,032 SF) 10 DUNNIGAN DRIVE W 9 V 9 V 9 V 9 V 9 V 10 DUNNIGAN DRIVE 10 DUNNIGAN DRIVE 10 DUNNIGAN DRIVE 10 DUNNIGAN DRIVE 10 DUNNIGAN DRIVE 10 DUNNIGAN DRIVE 10 DUNNIGAN STATE 10 DUNNIGAN DRIVE 10 DUNNIGAN STATE 10 DUNNIGAN DRIVE 10 DUNNIGAN STATE 10 DUN	-4"	DESCRIF ISSUED FOR DOB ISSUED FOR BID ISSUED FOR CON	SUBMISSION 9.10.21 10.15.21
M 182'-0" VIF EXISTING BUILDING	PIV DRA CHE APP DAT SCA LIGHT POLE DRA	ECKED BY : [PROVED BY : / TE : (ALE : / AWING TITLE :	S. WOO D. TOBAR, R.A. A. BERGER, R.A. D7.30.2021 AS NOTED
472'-0" 0' 50' 100' 150' N 0' 50' 100' 150'	ADMIN. & SERVICE ENTRY		DWG NUMBER :

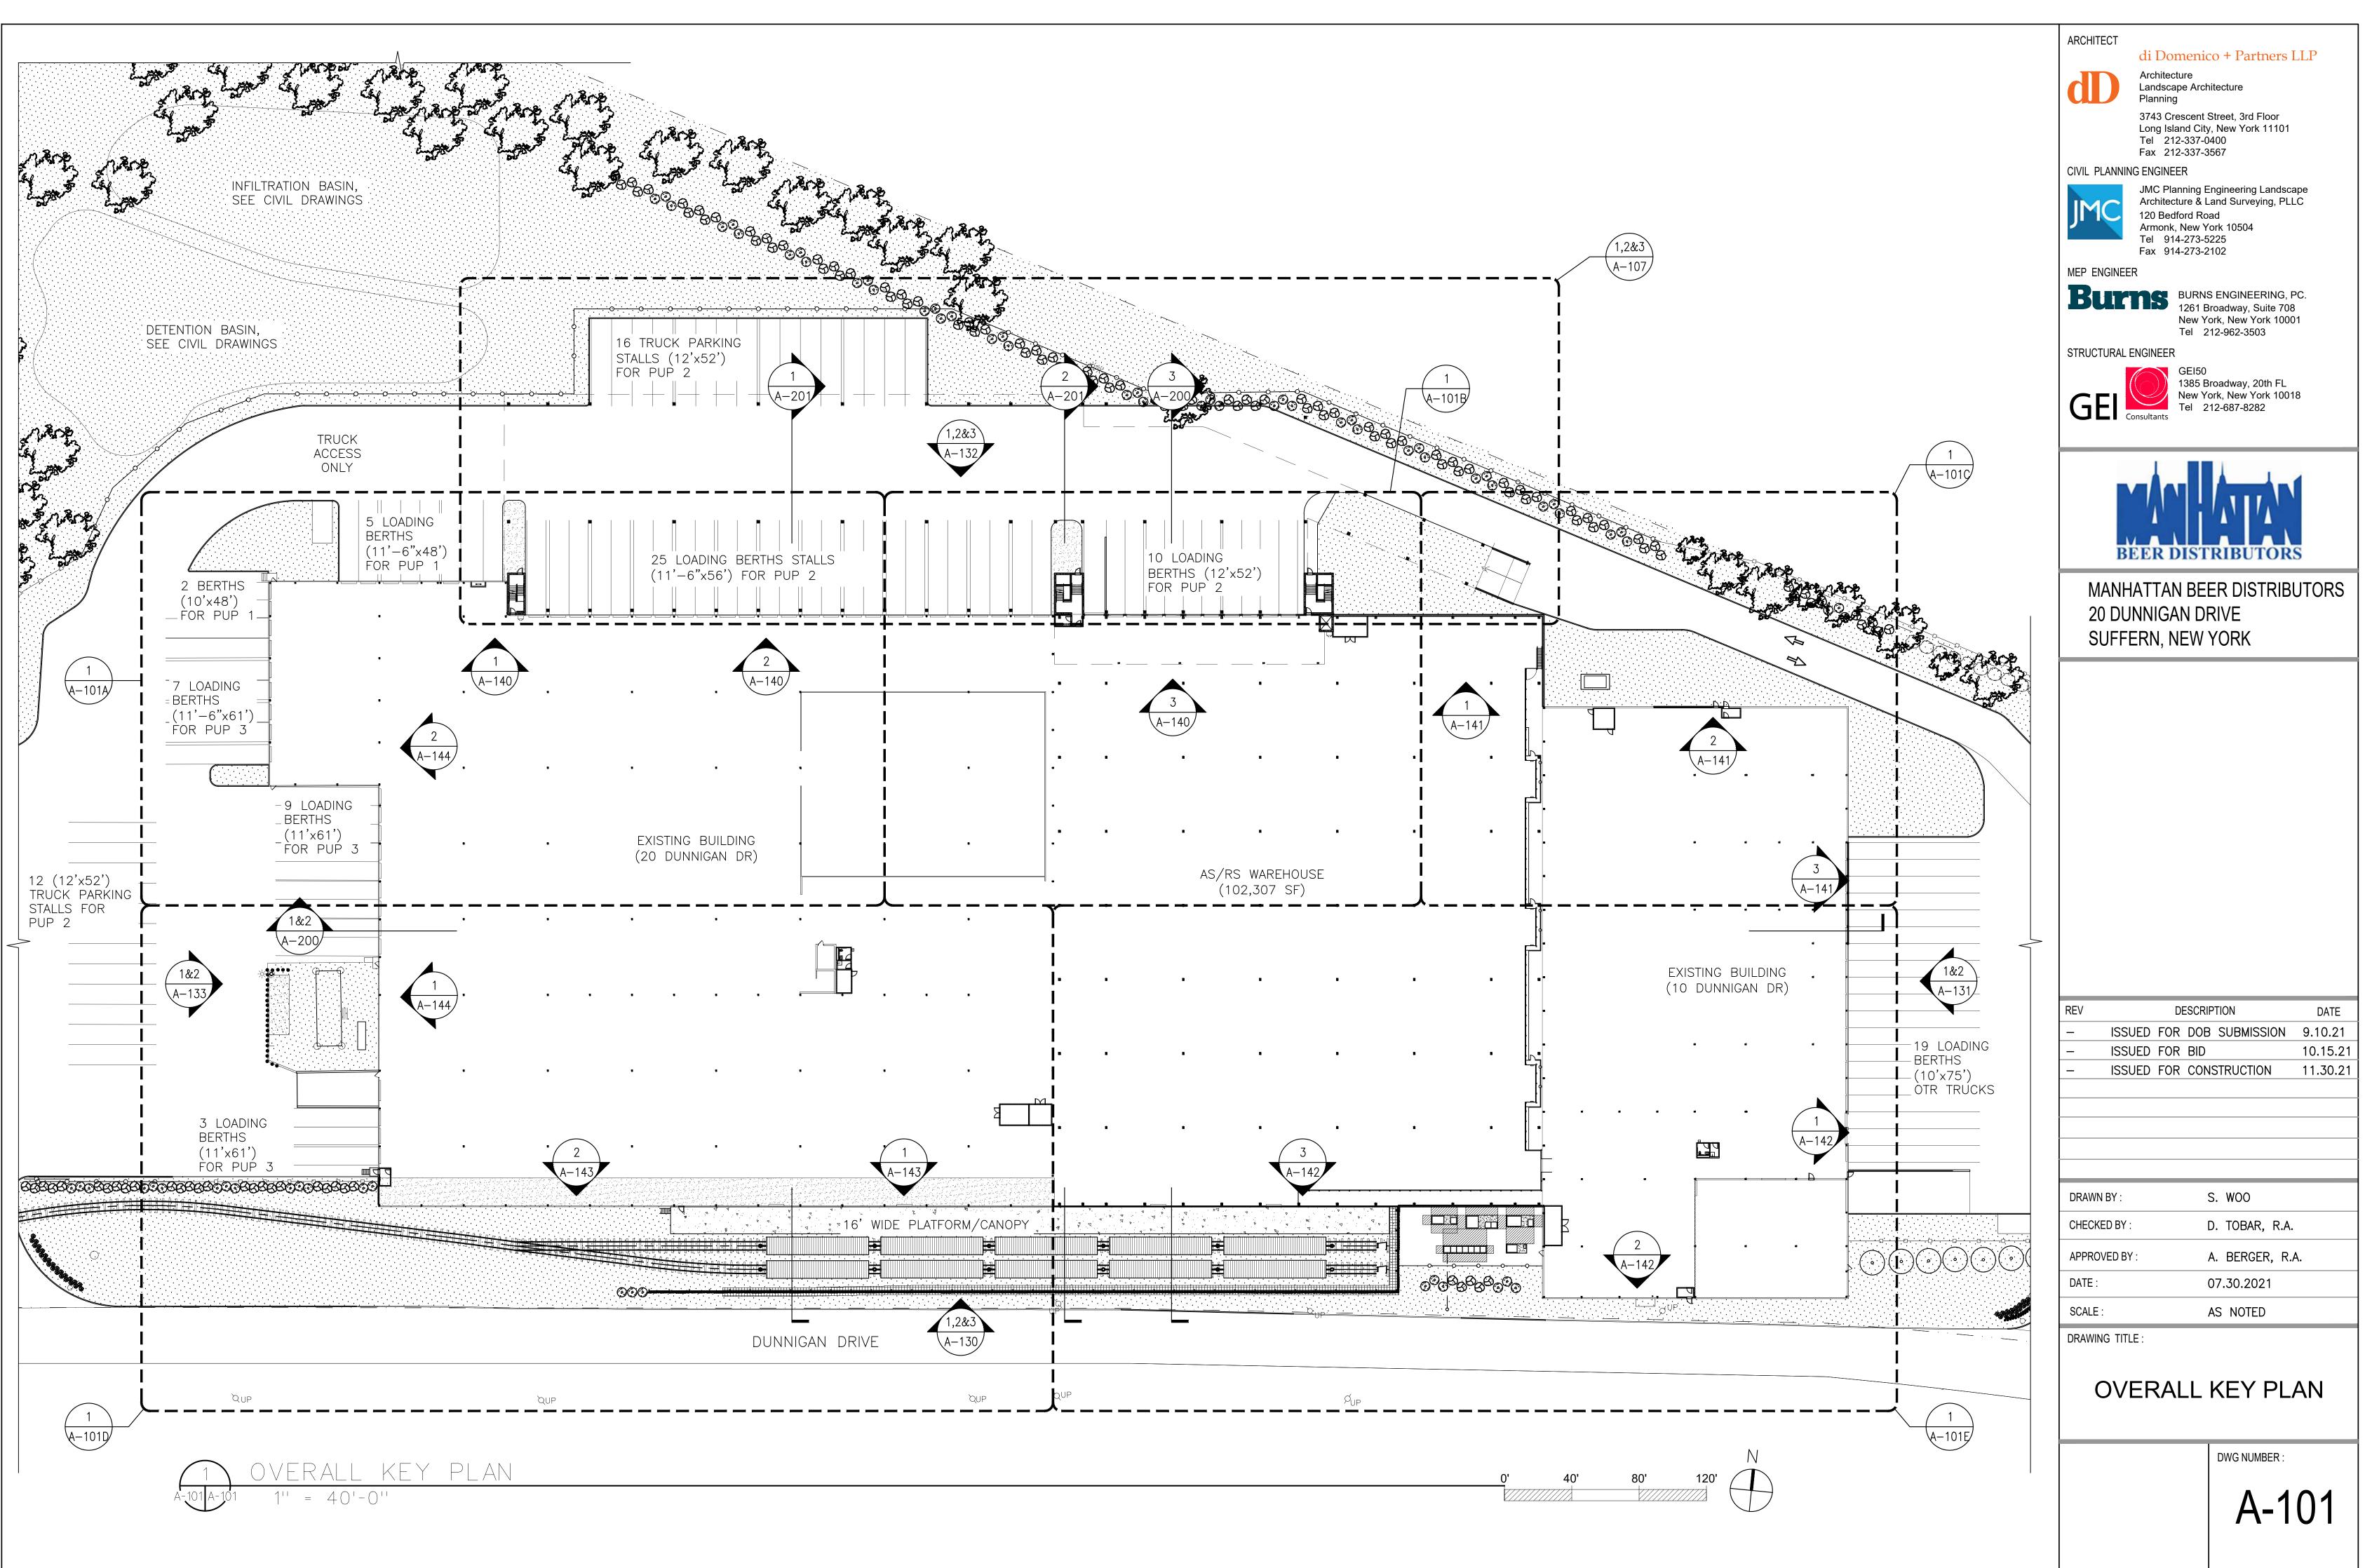


0.	40'	8

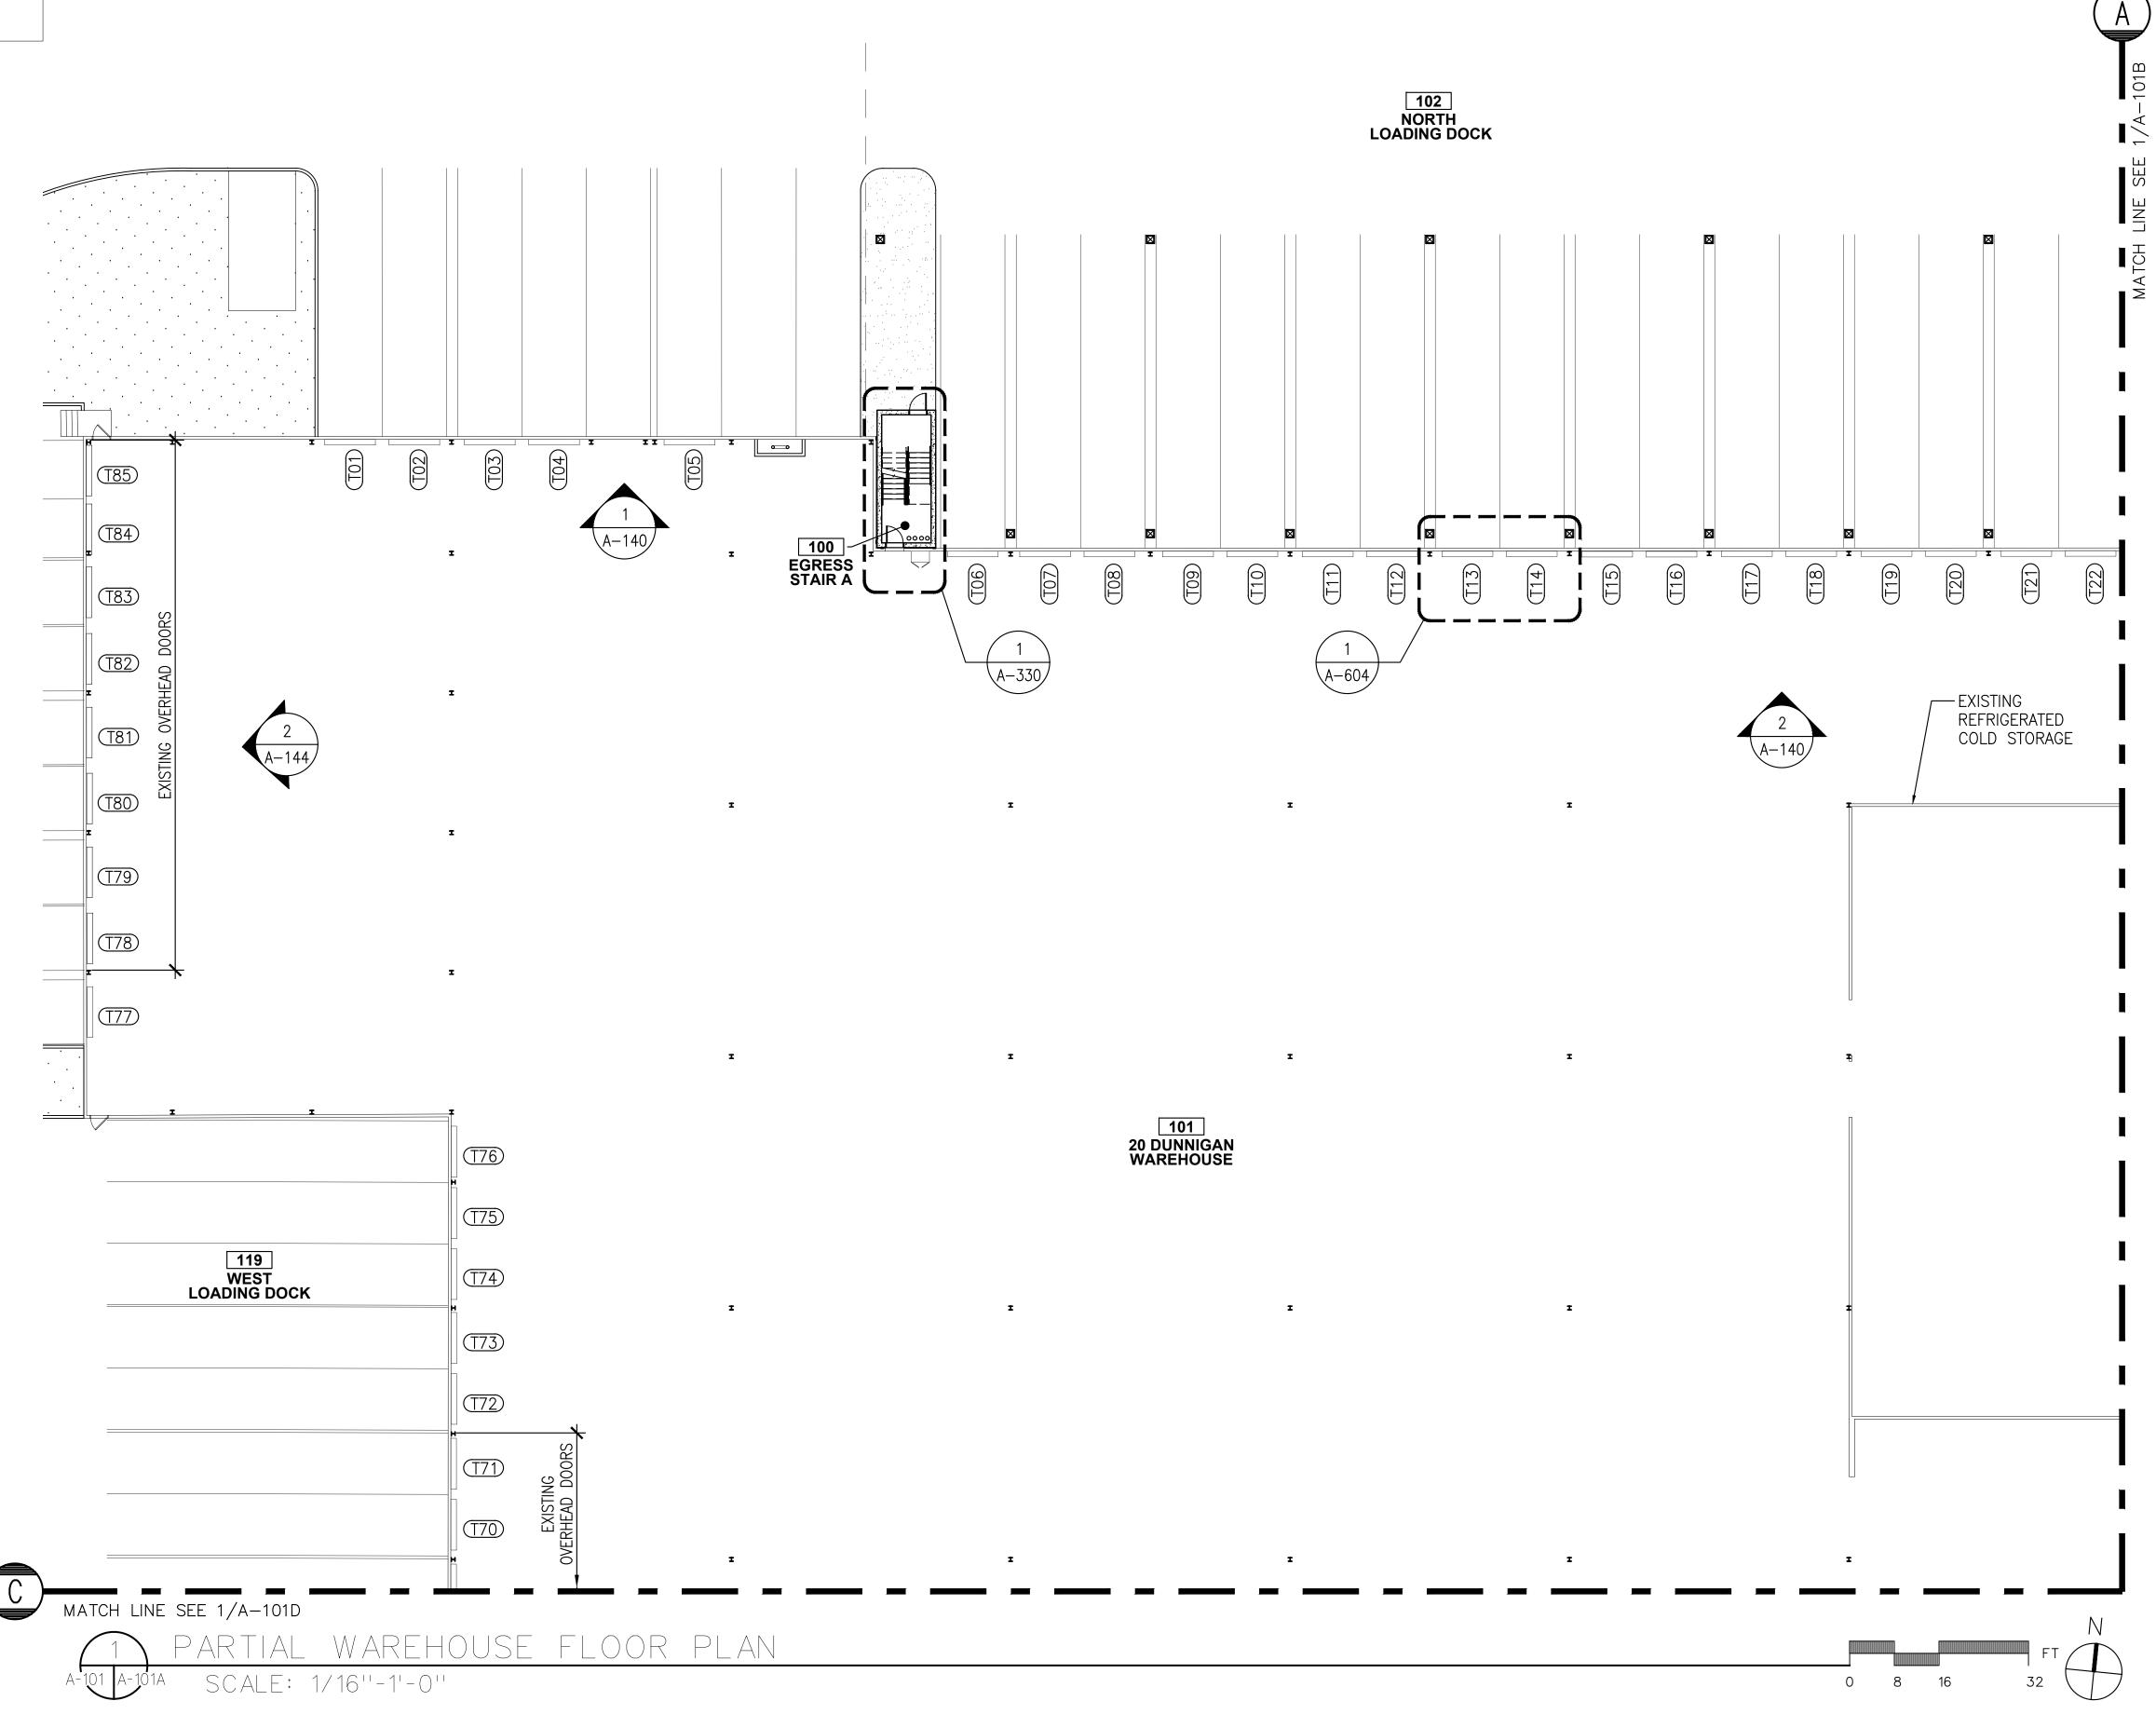



CONSTRUCTION LEGEND:

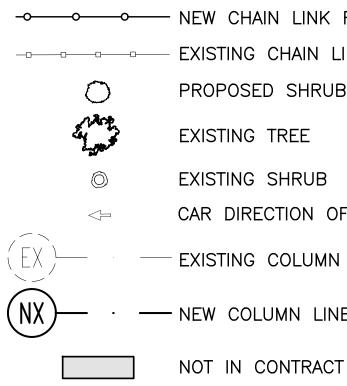

----- EXISTING CHAIN LINK FENCE PROPOSED SHRUB EXISTING TREE EXISTING SHRUB CAR DIRECTION OF TRAVEL ----- EXISTING COLUMN LINE


GENERAL CONSTRUCTION NOTES:

- 1. THE CONTRACTOR SHALL VISIT THE SITE AND VERIFY ALL EXISTING CONDITIONS AND VERIFY IN FIELD ALL DIMENSIONS NOTED PRIOR TO START OF WORK.
- 2. THE CONTRACTOR SHALL NOTIFY THE ARCHITECT OF ANY AND ALL DISCREPANCIES BETWEEN EXISTING CONDITIONS AND PLANS.
- 3. THE CONTRACTOR SHALL PROVIDE SHOP DRAWINGS FOR THE PROPOSED WORK FOR THE REVIEW OF THE ARCHITECT/ENGINEER.
- 4. PROVIDE TEMPORARY STAIRS WITH LANDINGS AND HANDRAILS WHERE ELEVATION CHANGE OCCURS IN RELATION TO THE INTERIOR AND EXTERIOR GRADE. GUARD RAILINGS ARE REQUIRED WHERE THE ELEVATION CHANGE IS 30" OR GREATER.
- 5. THE CONTRACTOR SHALL COMPLY WITH OSHA STANDARDS/REQUIREMENTS AND SECURE PROTECTION FOR ALL OPENINGS IN FLOORS, WALLS AND ROOFS.
- 6. THE CONTRACTOR SHALL EXAMINE THE DRAWINGS OF ALL DISCIPLINES AND SHALL COORDINATE THE WORK OF ALL TRADES.


ARCHITECT	
	di Domenico + Partners LLP
	Architecture Landscape Architecture
	Planning 3743 Crescent Street, 3rd Floor
	Long Island City, New York 11101 Tel 212-337-0400
CIVIL PLANNIN	Fax 212-337-3567 NG ENGINEER
	JMC Planning Engineering Landscape Architecture & Land Surveying, PLLC
JMC	120 Bedford Road Armonk, New York 10504
	Tel 914-273-5225 Fax 914-273-2102
MEP ENGINEE	
Bur	BURNS ENGINEERING, PC. 1261 Broadway, Suite 708
	New York, New York 10001 Tel 212-962-3503
STRUCTURAL	ENGINEER GEI50
	1385 Broadway, 20th FL New York, New York 10018
GEL	Tel 212-687-8282
В	EER DISTRIBUTORS
	ATTAN BEER DISTRIBUTORS
	INNIGAN DRIVE
	ERN, NEW YORK
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	LIED FOR BID 10.15.21
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CONSTRUCTION LEGEND:



------ EXISTING CHAIN LINK FENCE PROPOSED SHRUB EXISTING TREE EXISTING SHRUB CAR DIRECTION OF TRAVEL ----- EXISTING COLUMN LINE

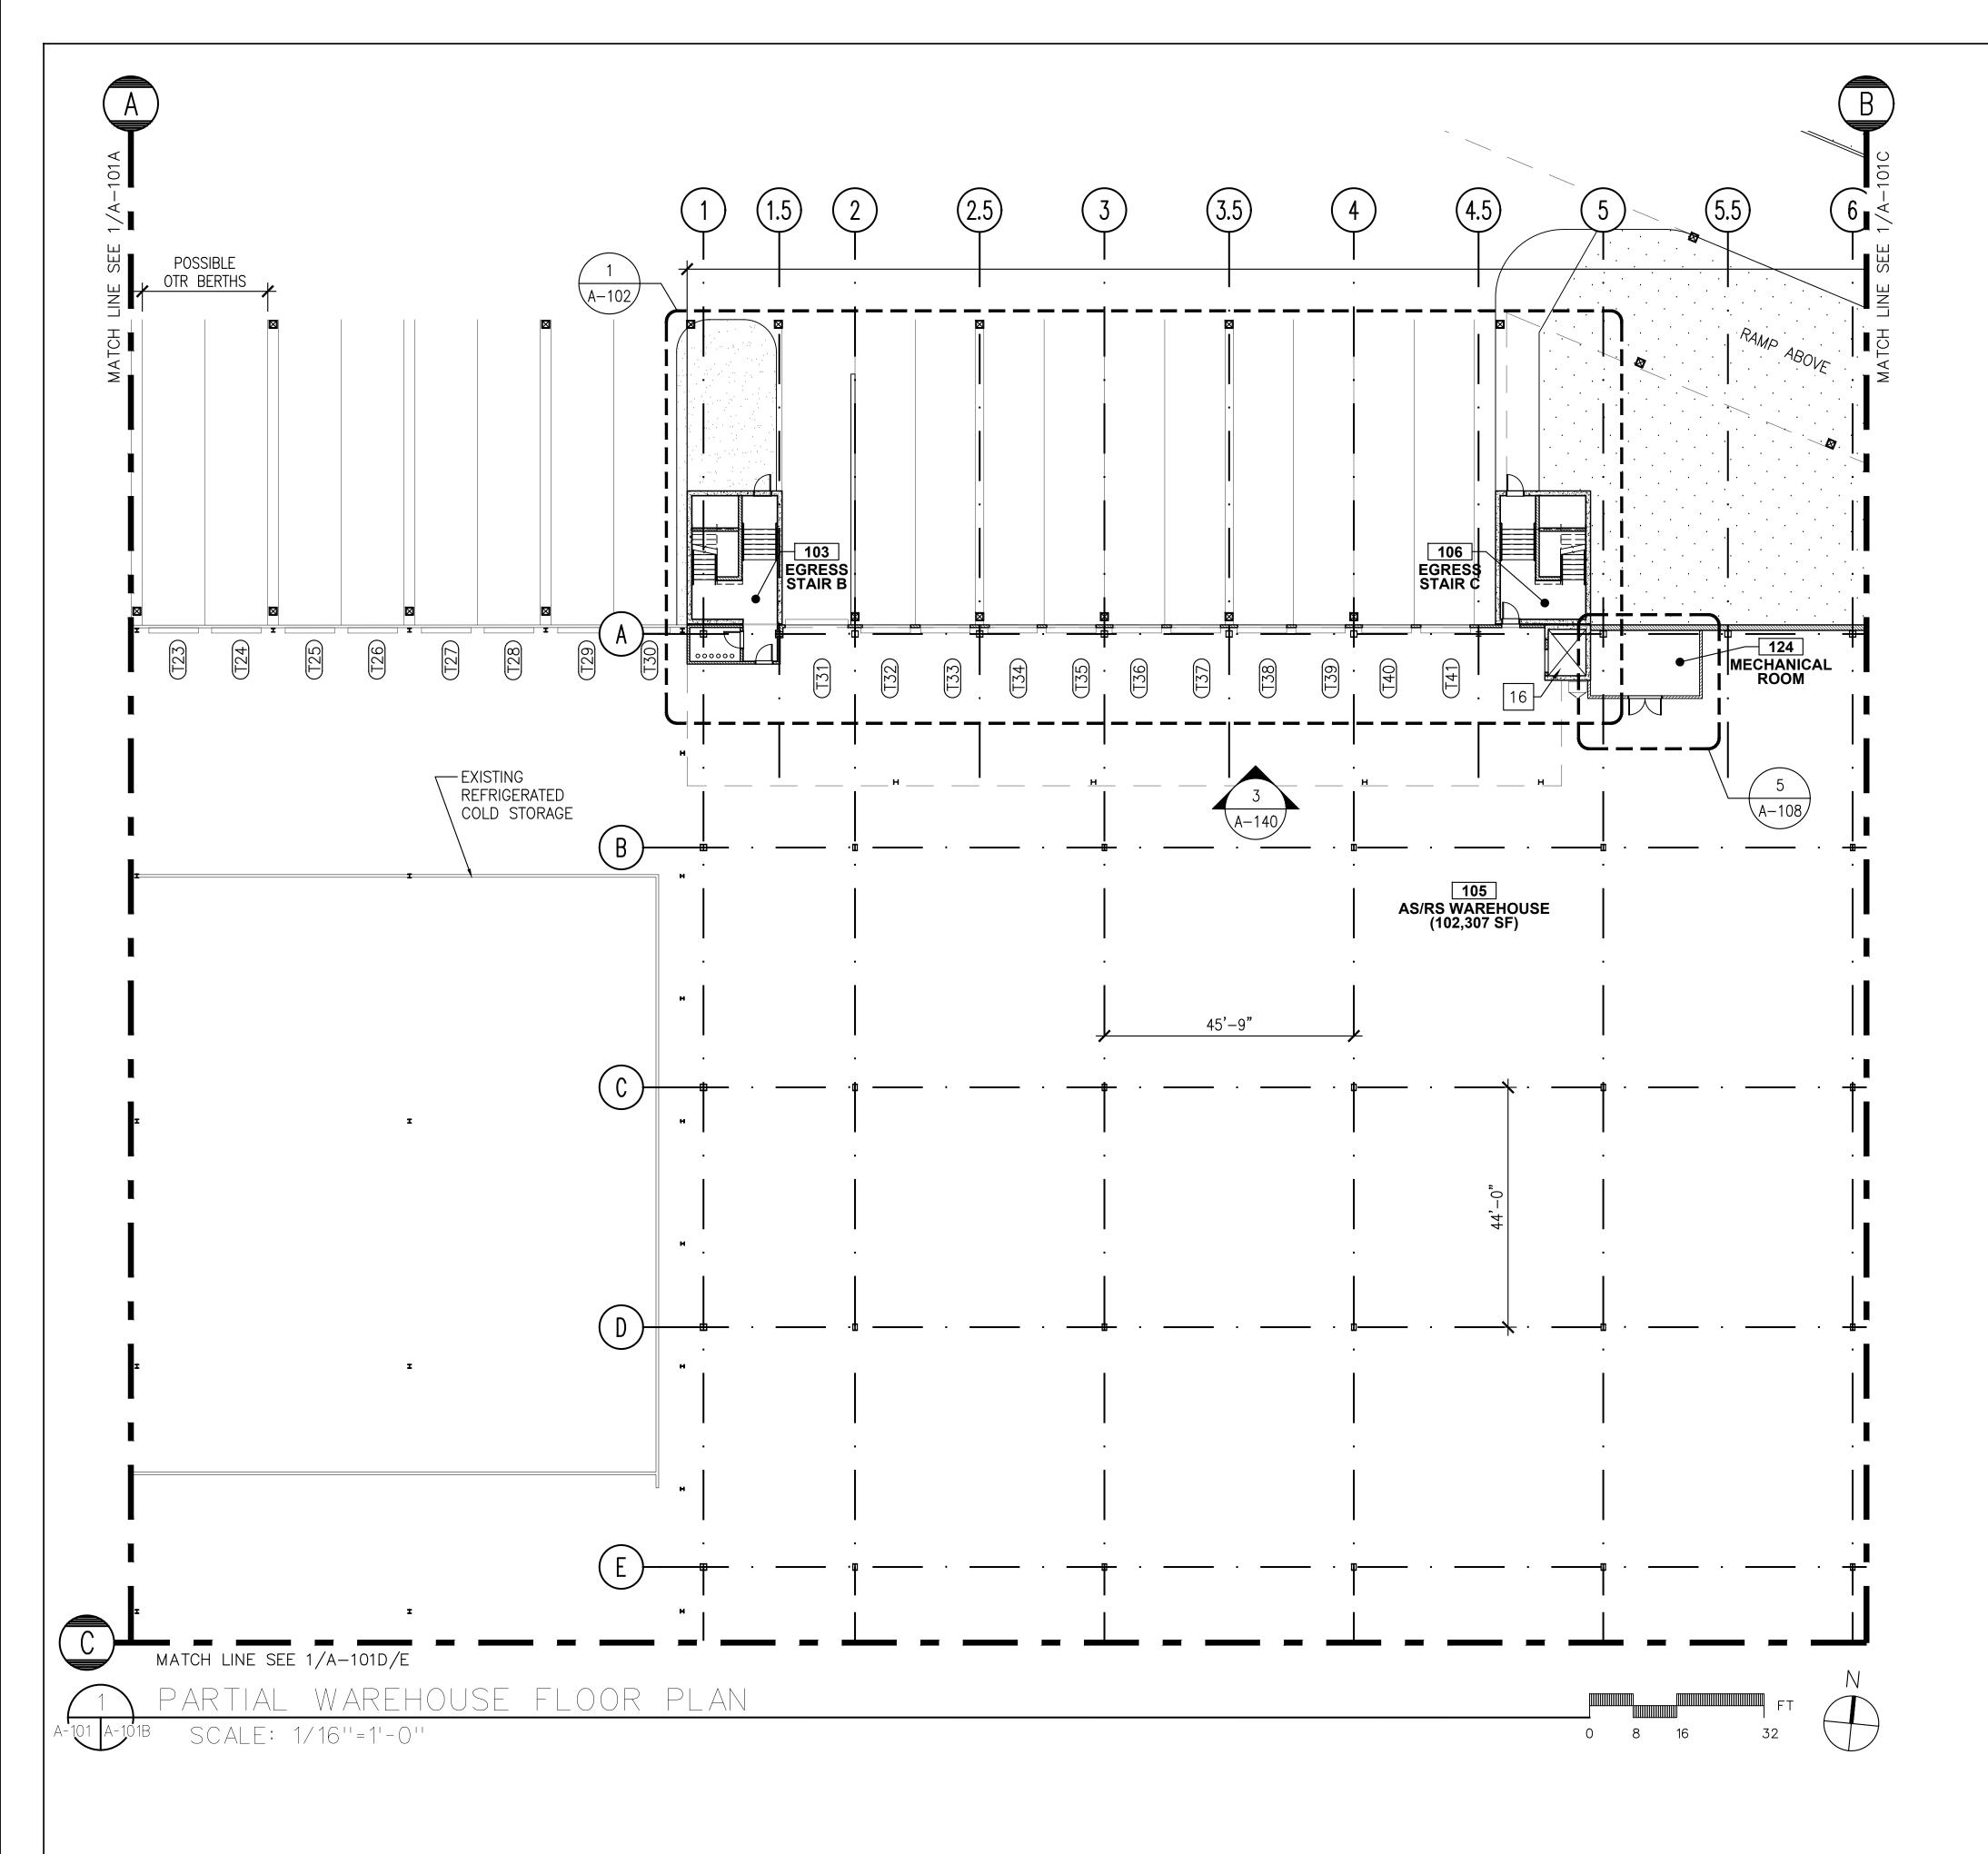NOT IN CONTRACT


GENERAL CONSTRUCTION NOTES:

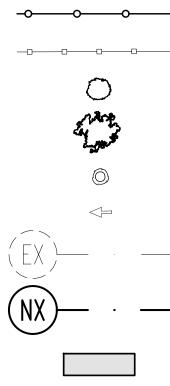- 1. THE CONTRACTOR SHALL VISIT THE SITE AND VERIFY ALL EXISTING CONDITIONS AND VERIFY IN FIELD ALL DIMENSIONS NOTED PRIOR TO START OF WORK.
- 2. THE CONTRACTOR SHALL NOTIFY THE ARCHITECT OF ANY AND ALL DISCREPANCIES BETWEEN EXISTING CONDITIONS AND PLANS.
- 3. THE CONTRACTOR SHALL PROVIDE SHOP DRAWINGS FOR THE PROPOSED WORK FOR THE REVIEW OF THE ARCHITECT/ENGINEER.
- 4. PROVIDE TEMPORARY STAIRS WITH LANDINGS AND HANDRAILS WHERE ELEVATION CHANGE OCCURS IN RELATION TO THE INTERIOR AND EXTERIOR GRADE. GUARD RAILINGS ARE REQUIRED WHERE THE ELEVATION CHANGE IS 30" OR GREATER.
- 5. THE CONTRACTOR SHALL COMPLY WITH OSHA STANDARDS/REQUIREMENTS AND SECURE PROTECTION FOR ALL OPENINGS IN FLOORS, WALLS AND ROOFS.
- 6. THE CONTRACTOR SHALL EXAMINE THE DRAWINGS OF ALL DISCIPLINES AND SHALL COORDINATE THE WORK OF ALL TRADES.


ARCHITECT	di Domenico + Partners LLP
dD	Architecture Landscape Architecture Planning
	Planning 3743 Crescent Street, 3rd Floor Long Island City, New York 11101
	Tel 212-337-0400 Fax 212-337-3567
CIVIL PLANNIN	NG ENGINEER JMC Planning Engineering Landscape
IMC	Architecture & Land Surveying, PLLC 120 Bedford Road
	Armonk, New York 10504 Tel 914-273-5225 Fax 914-273-2102
Bur	BURNS ENGINEERING, PC. 1261 Broadway, Suite 708
	New York, New York 10001 Tel 212-962-3503
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GEL	1385 Broadway, 20th FL New York, New York 10018 Tel 212-687-8282
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	OR PLAN (2 OF 5)

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CONSTRUCTION LEGEND:

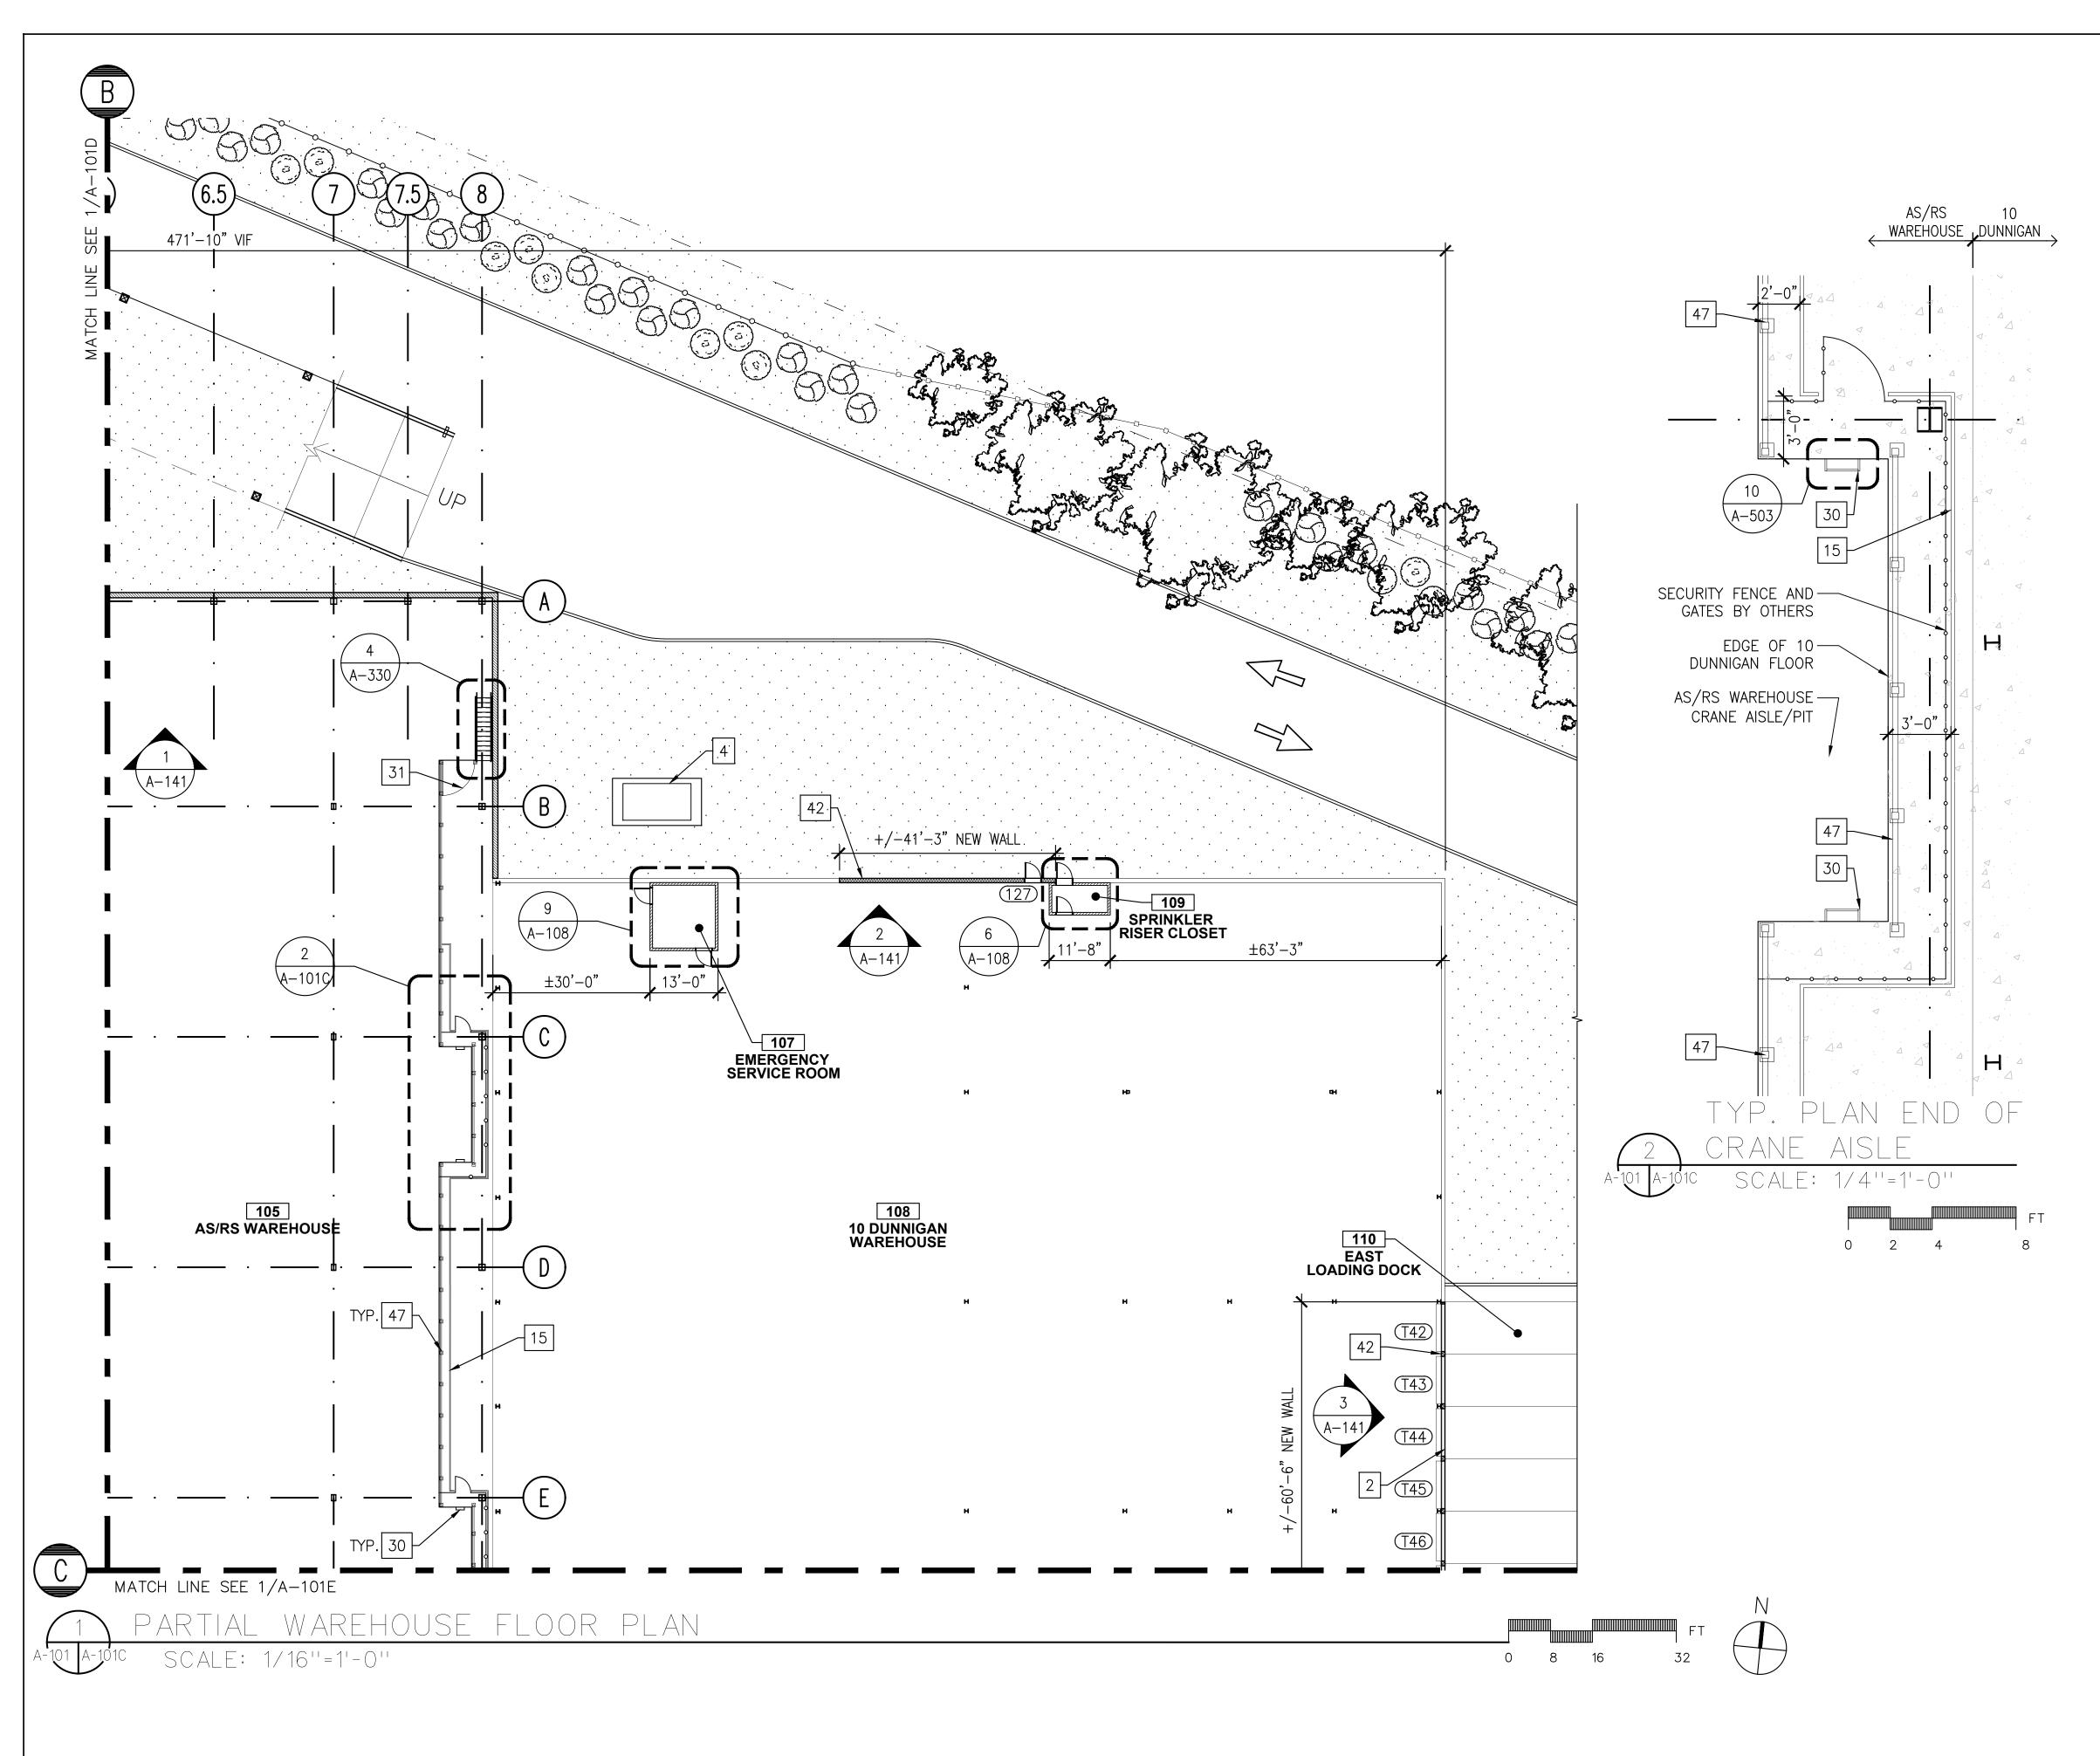

NEW CHAIN LINK FENCE
 EXISTING CHAIN LINK FENCE
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NOT IN CONTRACT

GENERAL CONSTRUCTION NOTES:

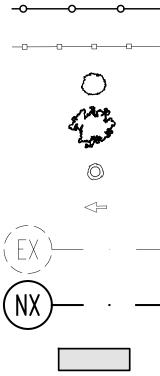
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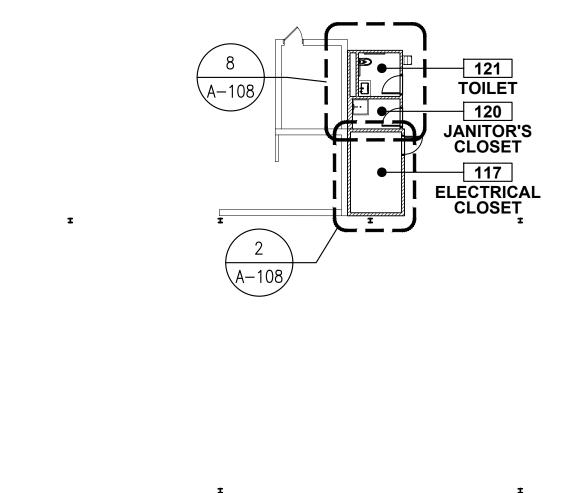
ARCHITECT di Domenico + Partners LLP Architecture Landscape Architecture Planning 3743 Crescent Street, 3rd Floor Long Island City, New York 11101 Tel 212-337-0400 Fax 212-337-3567 CIVIL PLANNING ENGINEER JMC Planning Engineering Landscape Architecture & Land Surveying, PLLC IMC 120 Bedford Road Armonk, New York 10504 Tel 914-273-5225 Fax 914-273-2102 MEP ENGINEER **BURNS ENGINEERING, PC.** 1261 Broadway, Suite 708 New York, New York 10001 Tel 212-962-3503 STRUCTURAL ENGINEER GEI50 1385 Broadway, 20th FL New York, New York 10018 GEI Tel 212-687-8282 Consultants BEER DISTRIBUTORS MANHATTAN BEER DISTRIBUTORS 20 DUNNIGAN DRIVE SUFFERN, NEW YORK DESCRIPTION REV DATE ISSUED FOR DOB SUBMISSION 9.10.21 ISSUED FOR BID 10.15.21 ISSUED FOR CONSTRUCTION 11.30.21 S. WOO DRAWN BY : CHECKED BY : D. TOBAR, R.A. A. BERGER, R.A. APPROVED BY : DATE : 07.30.2021 SCALE : AS NOTED DRAWING TITLE : ENLARGED PLAN -PARTIAL WAREHOUSE

FLOOR PLAN (3 OF 5) DWG NUMBER :

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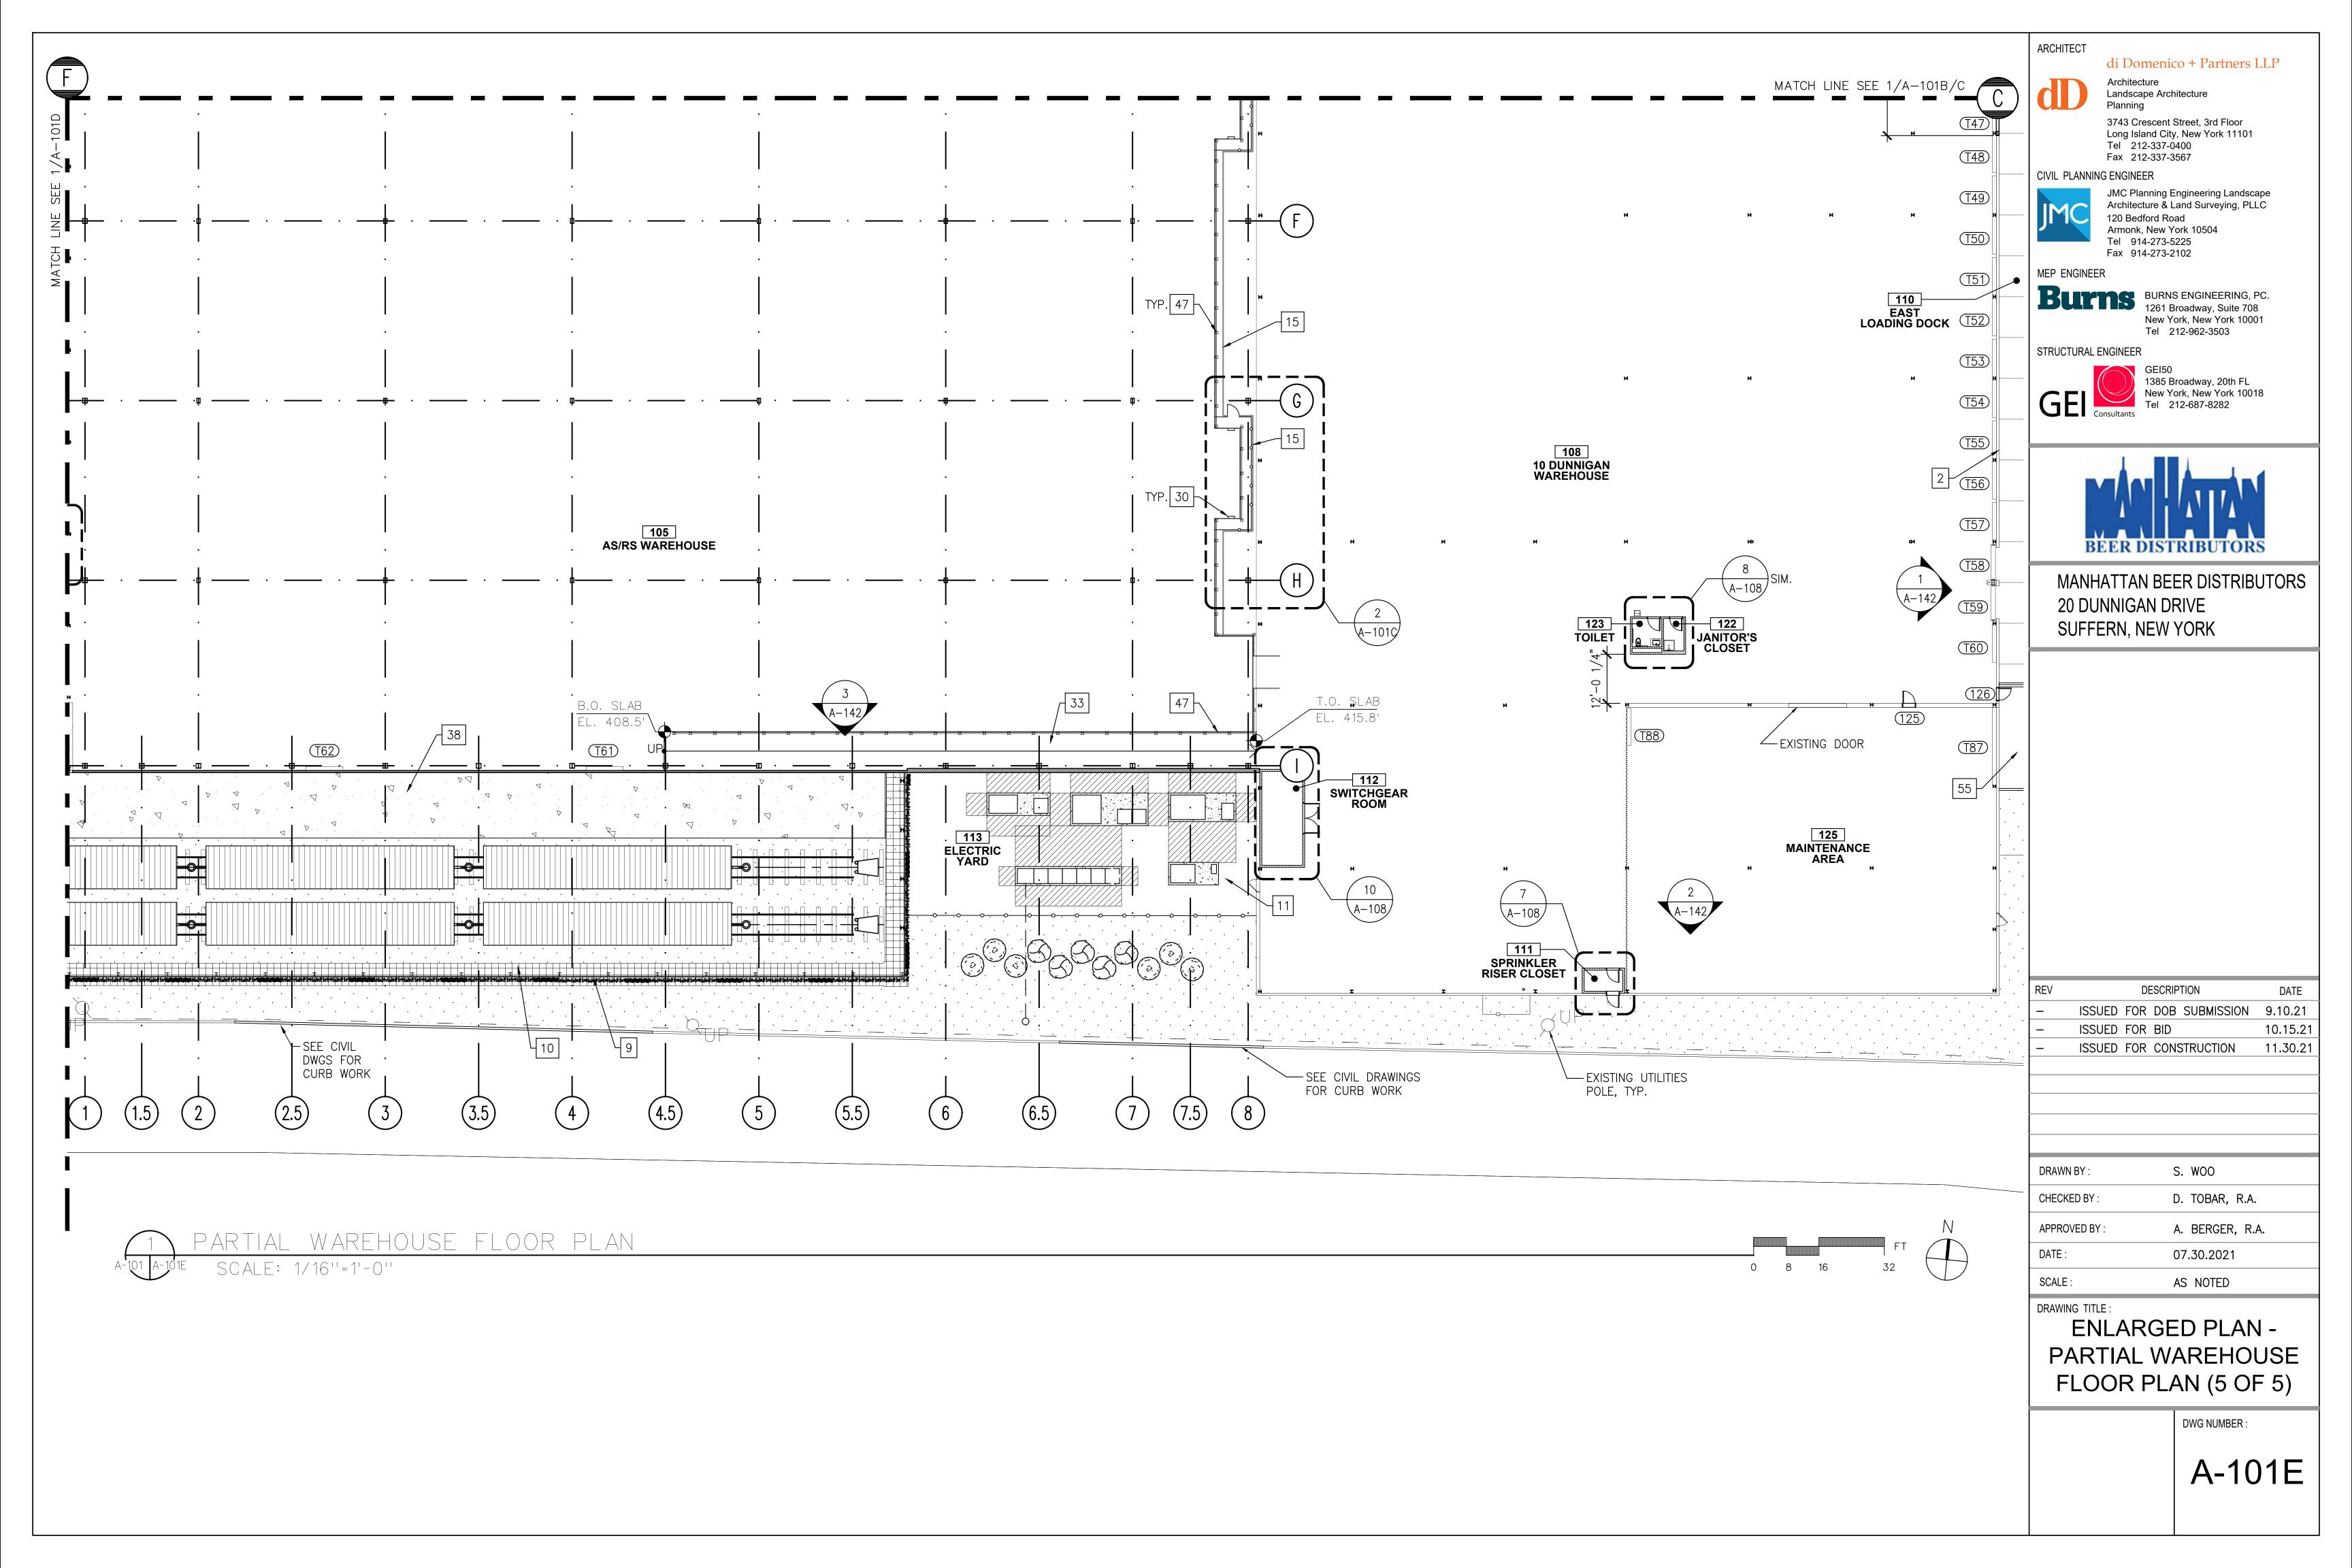





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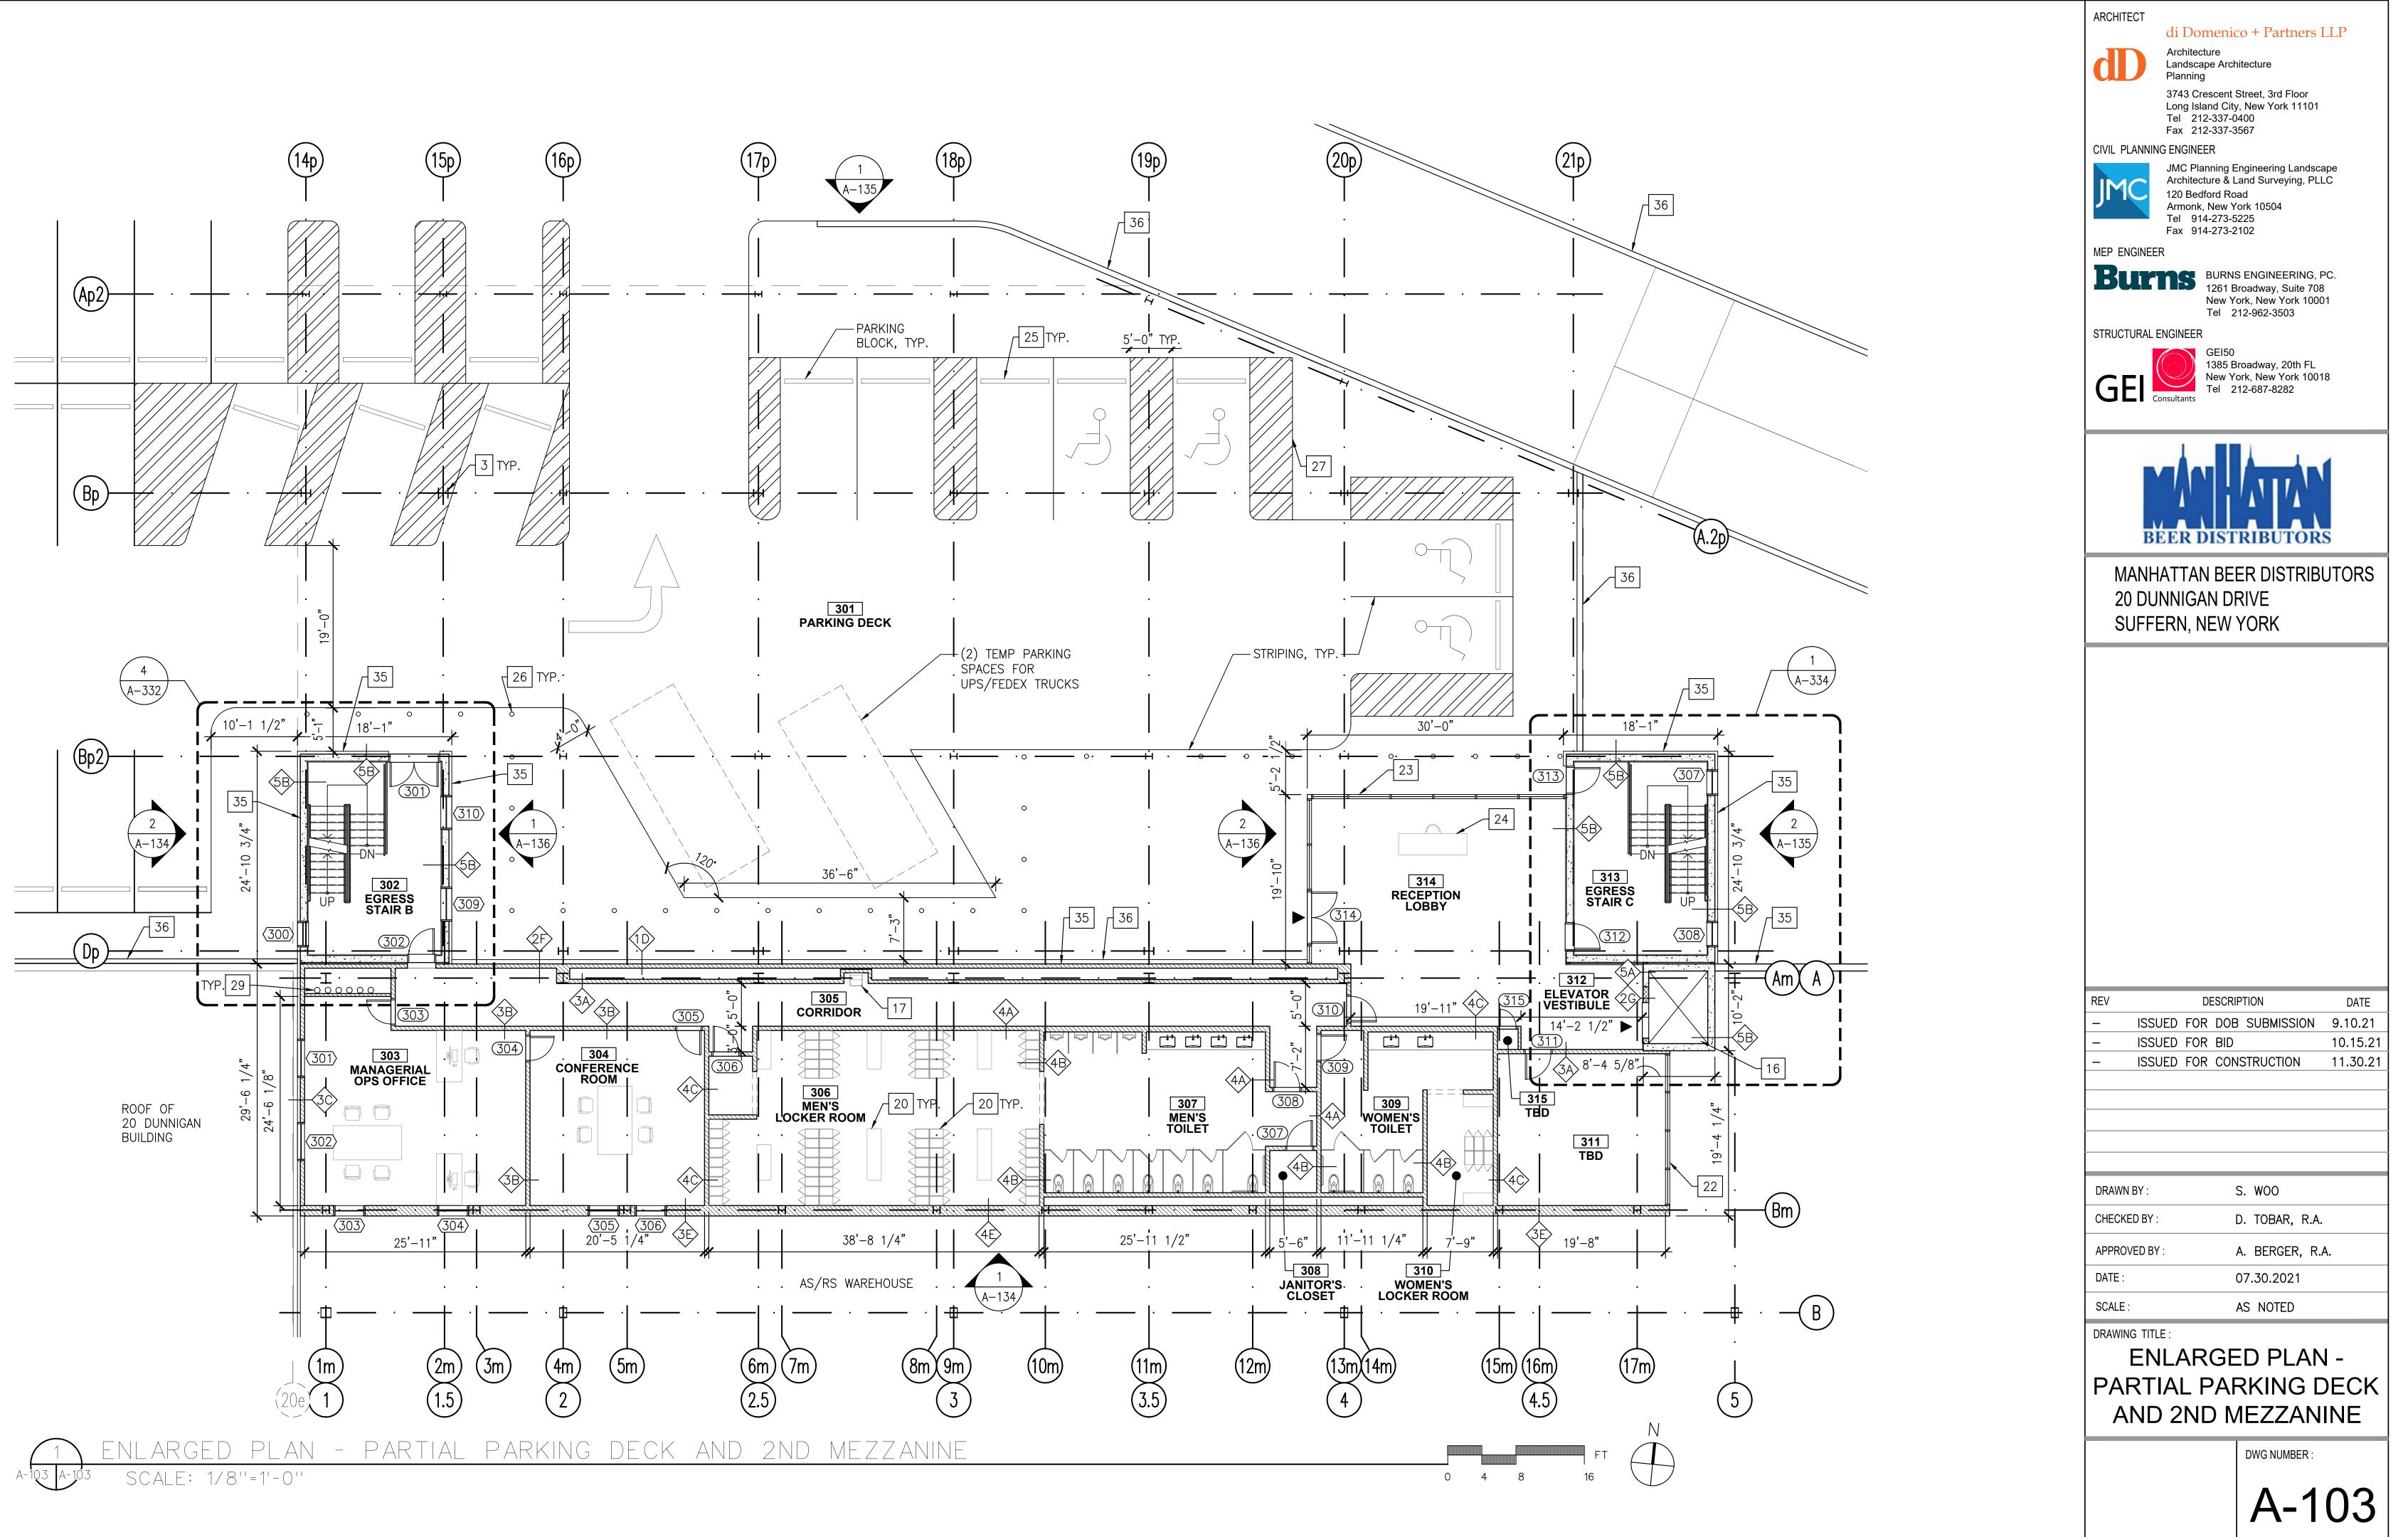
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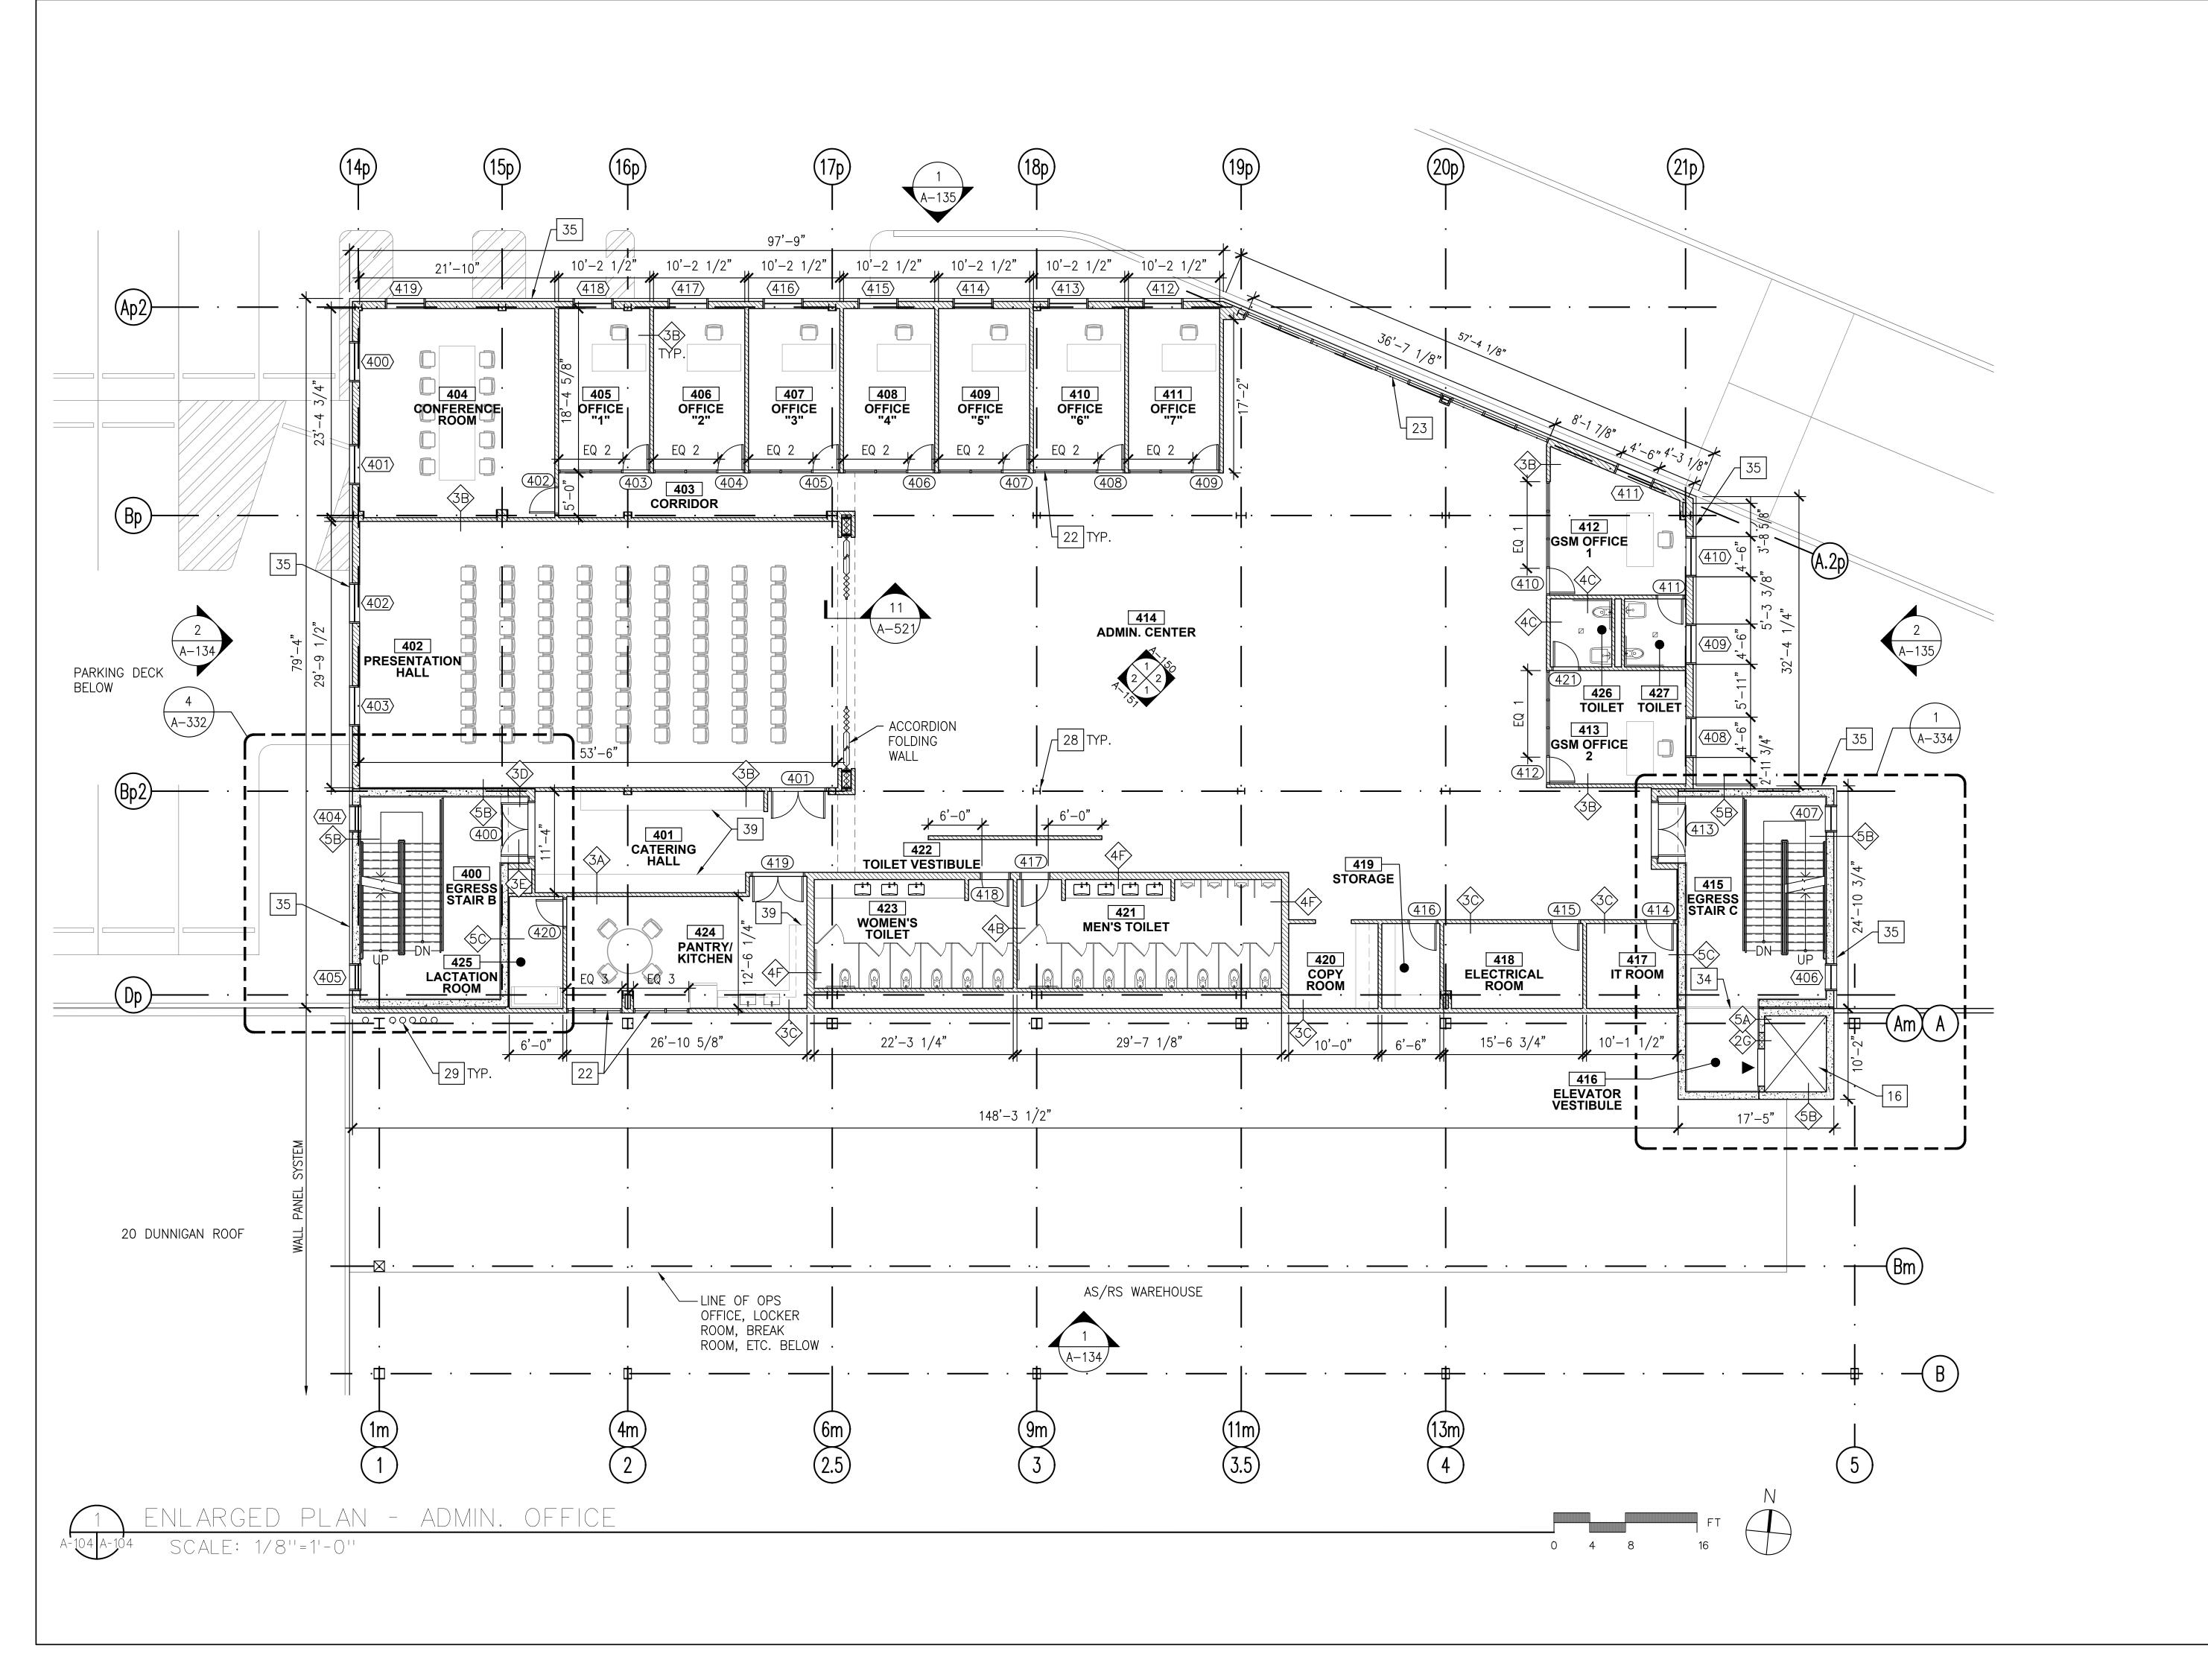
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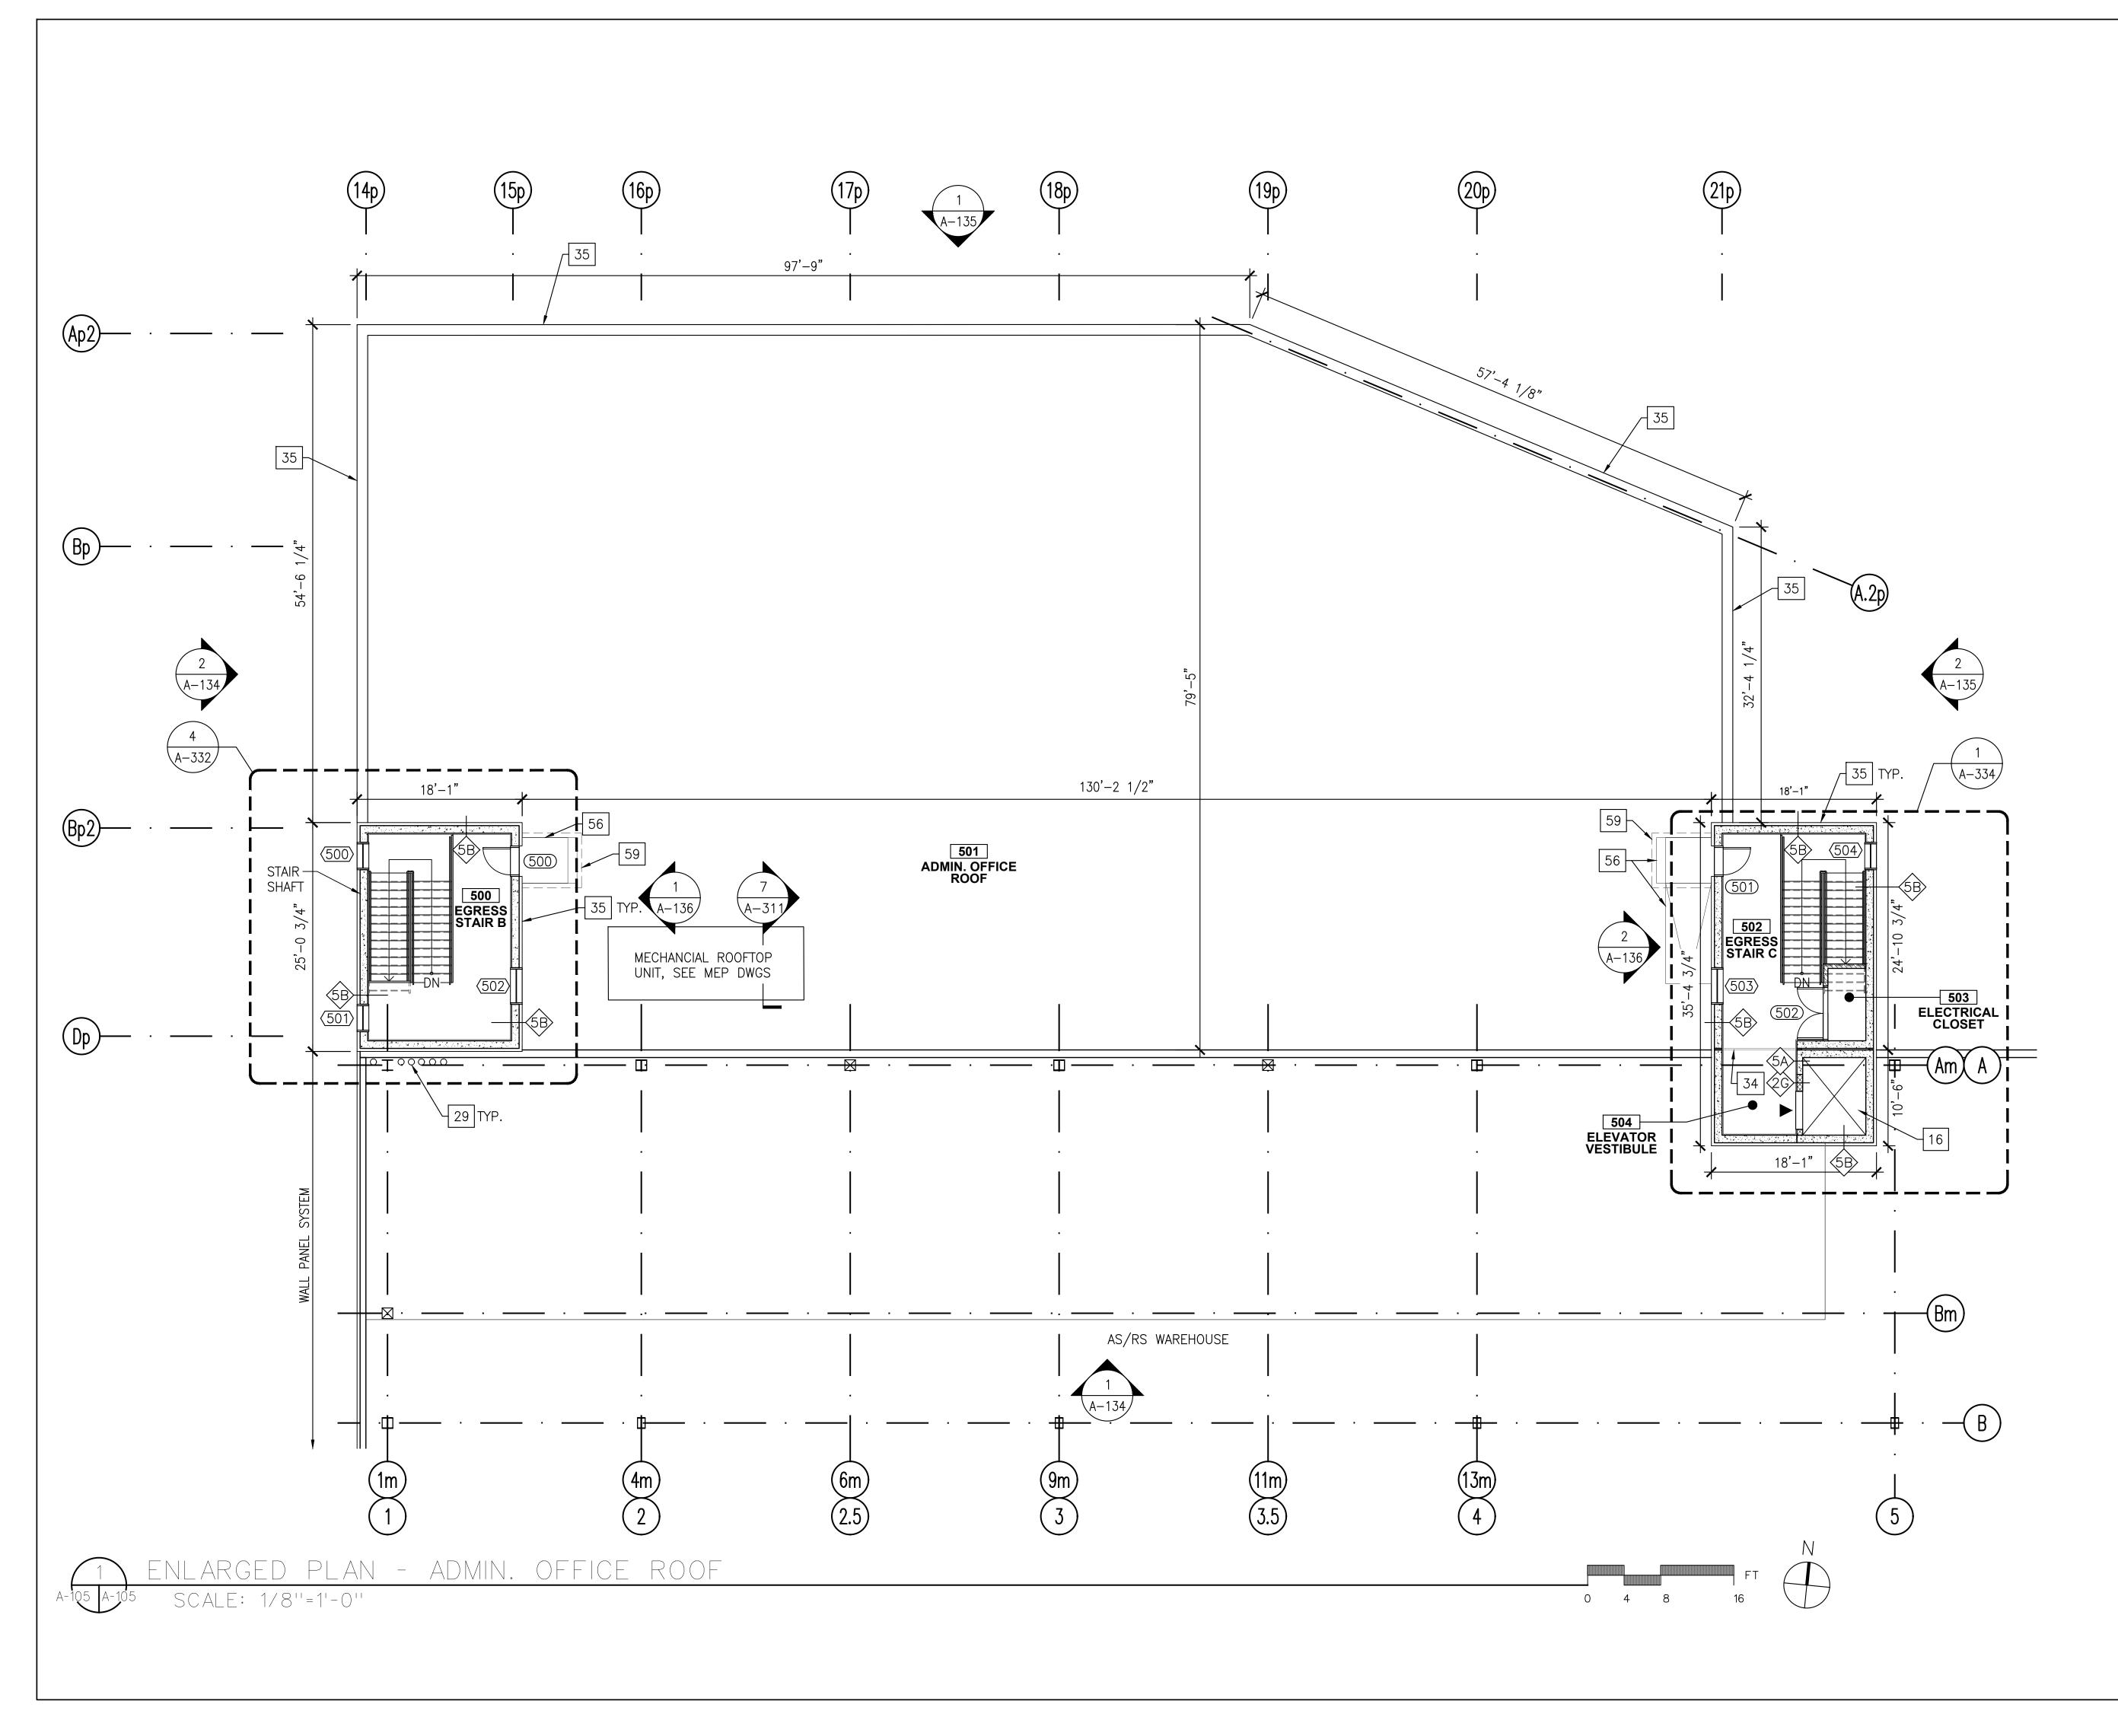
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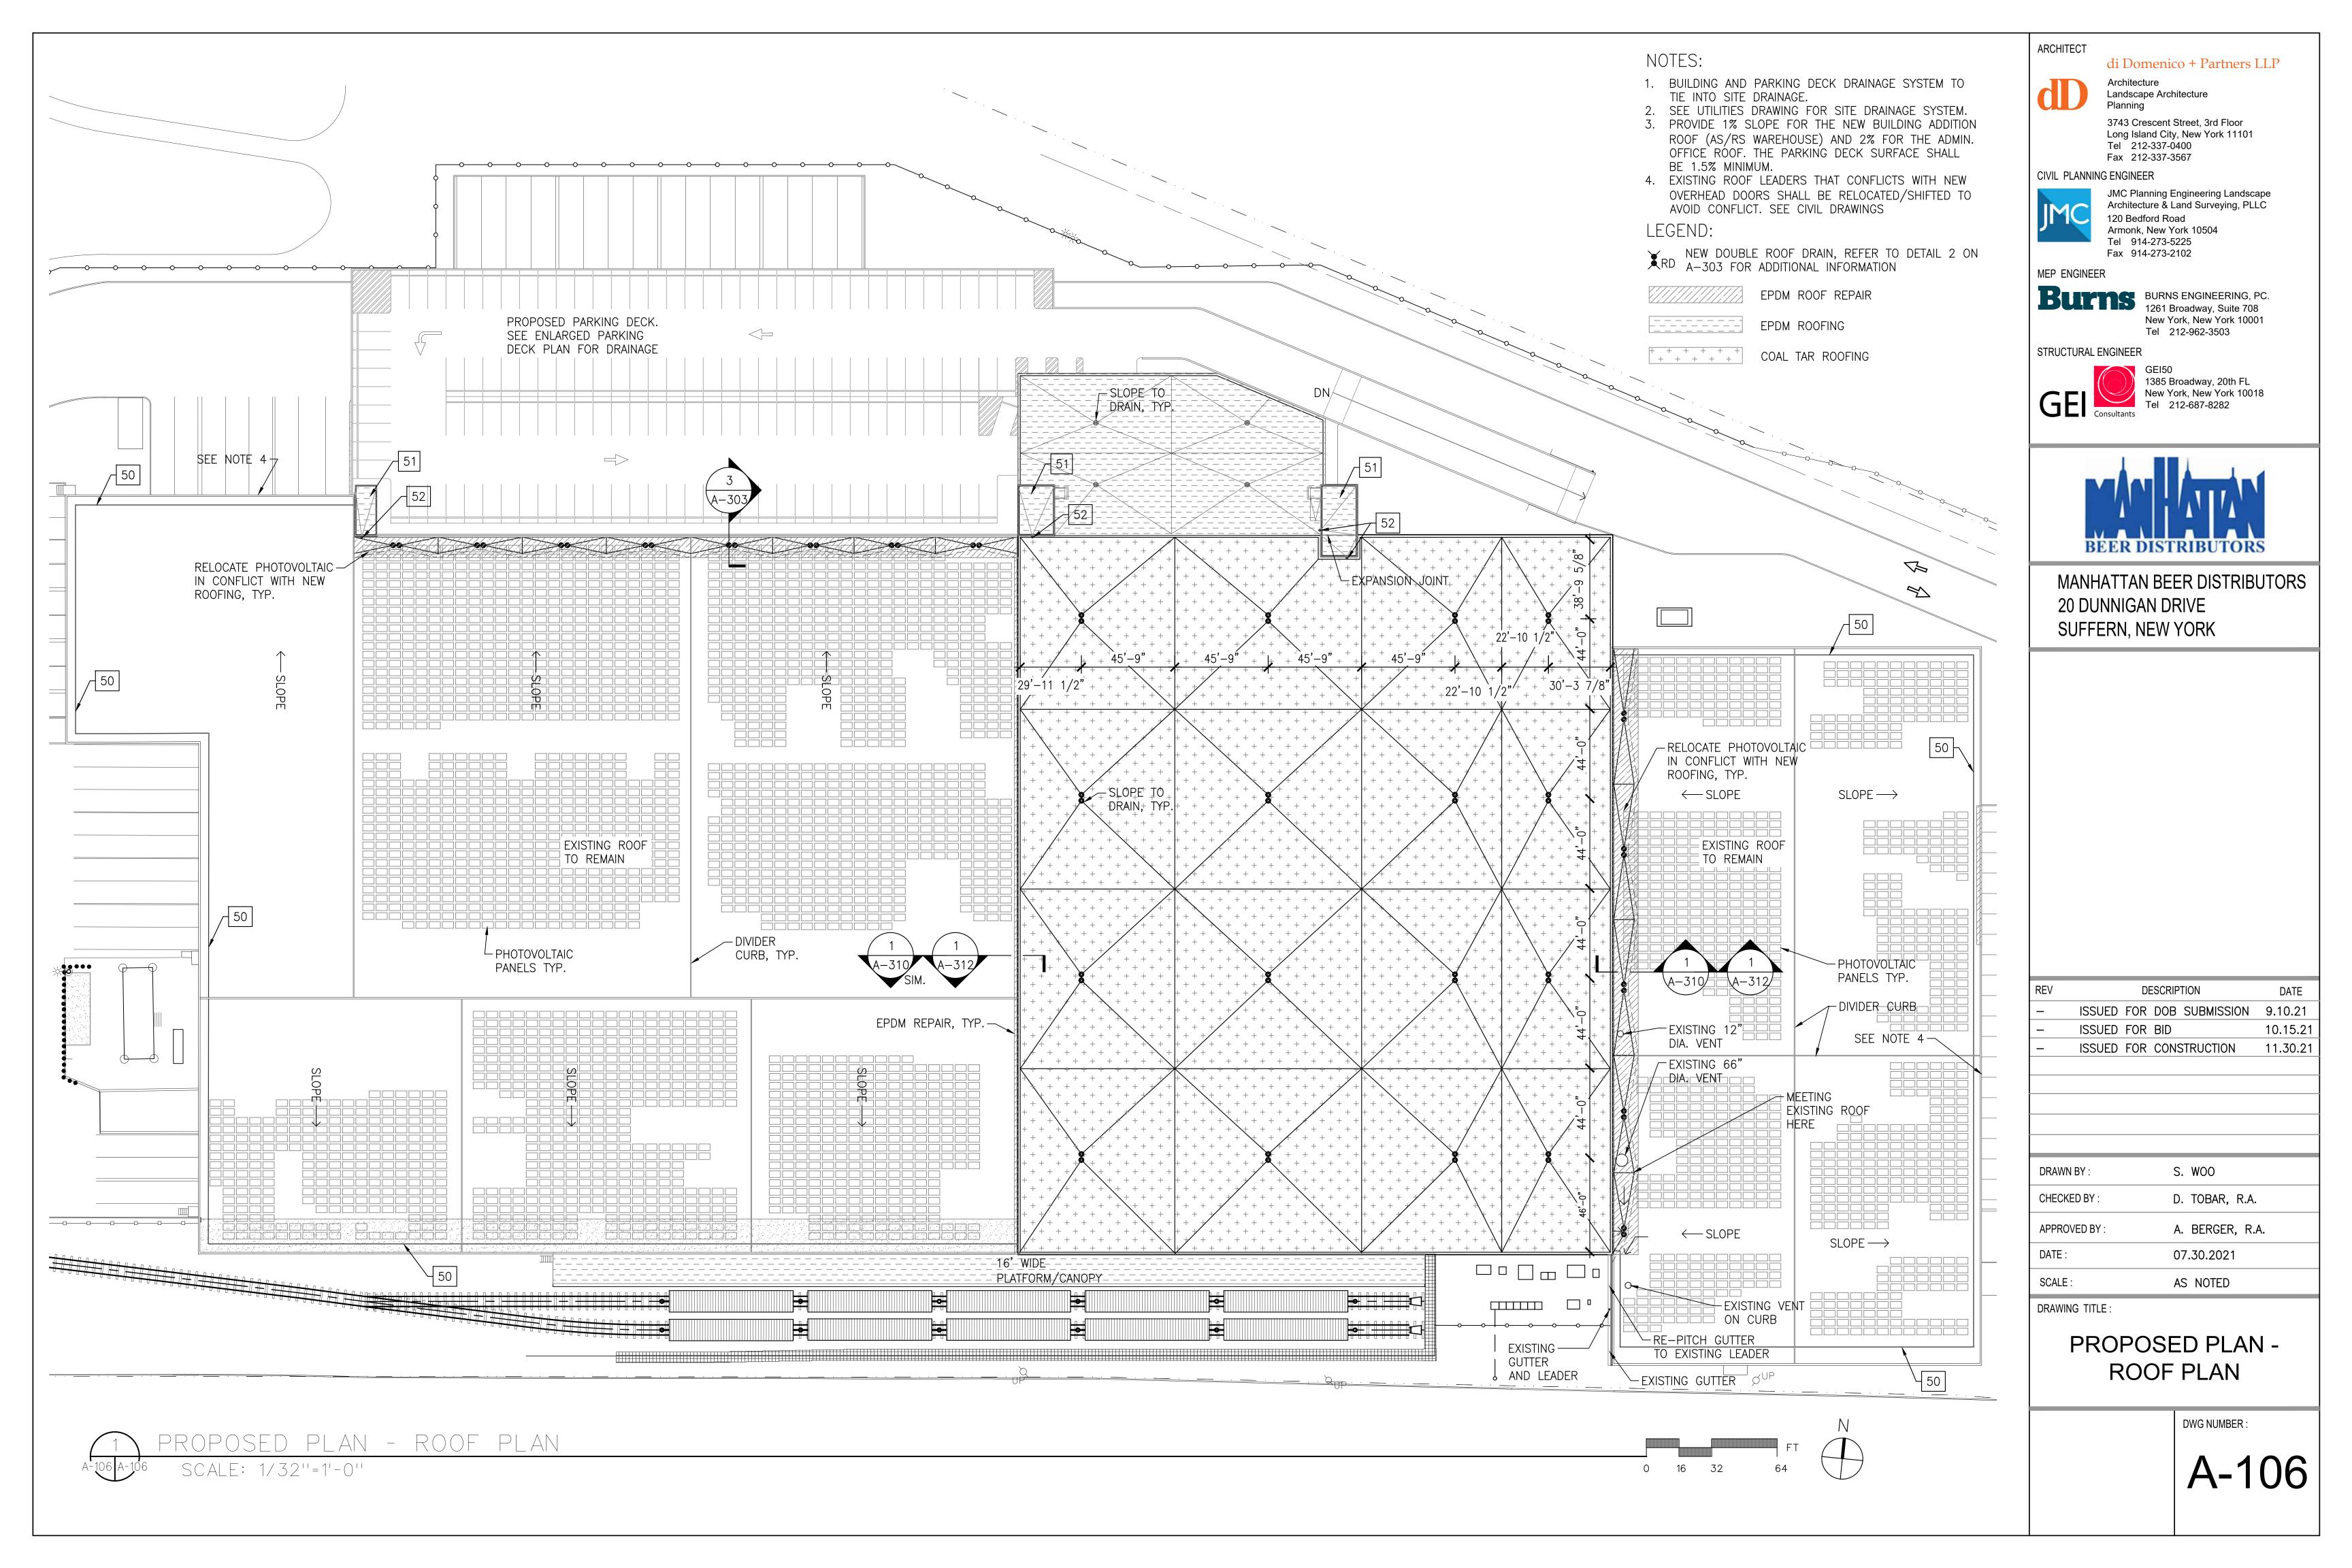
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GEI Consultants	New York, New York 10018 Tel 212-687-8282
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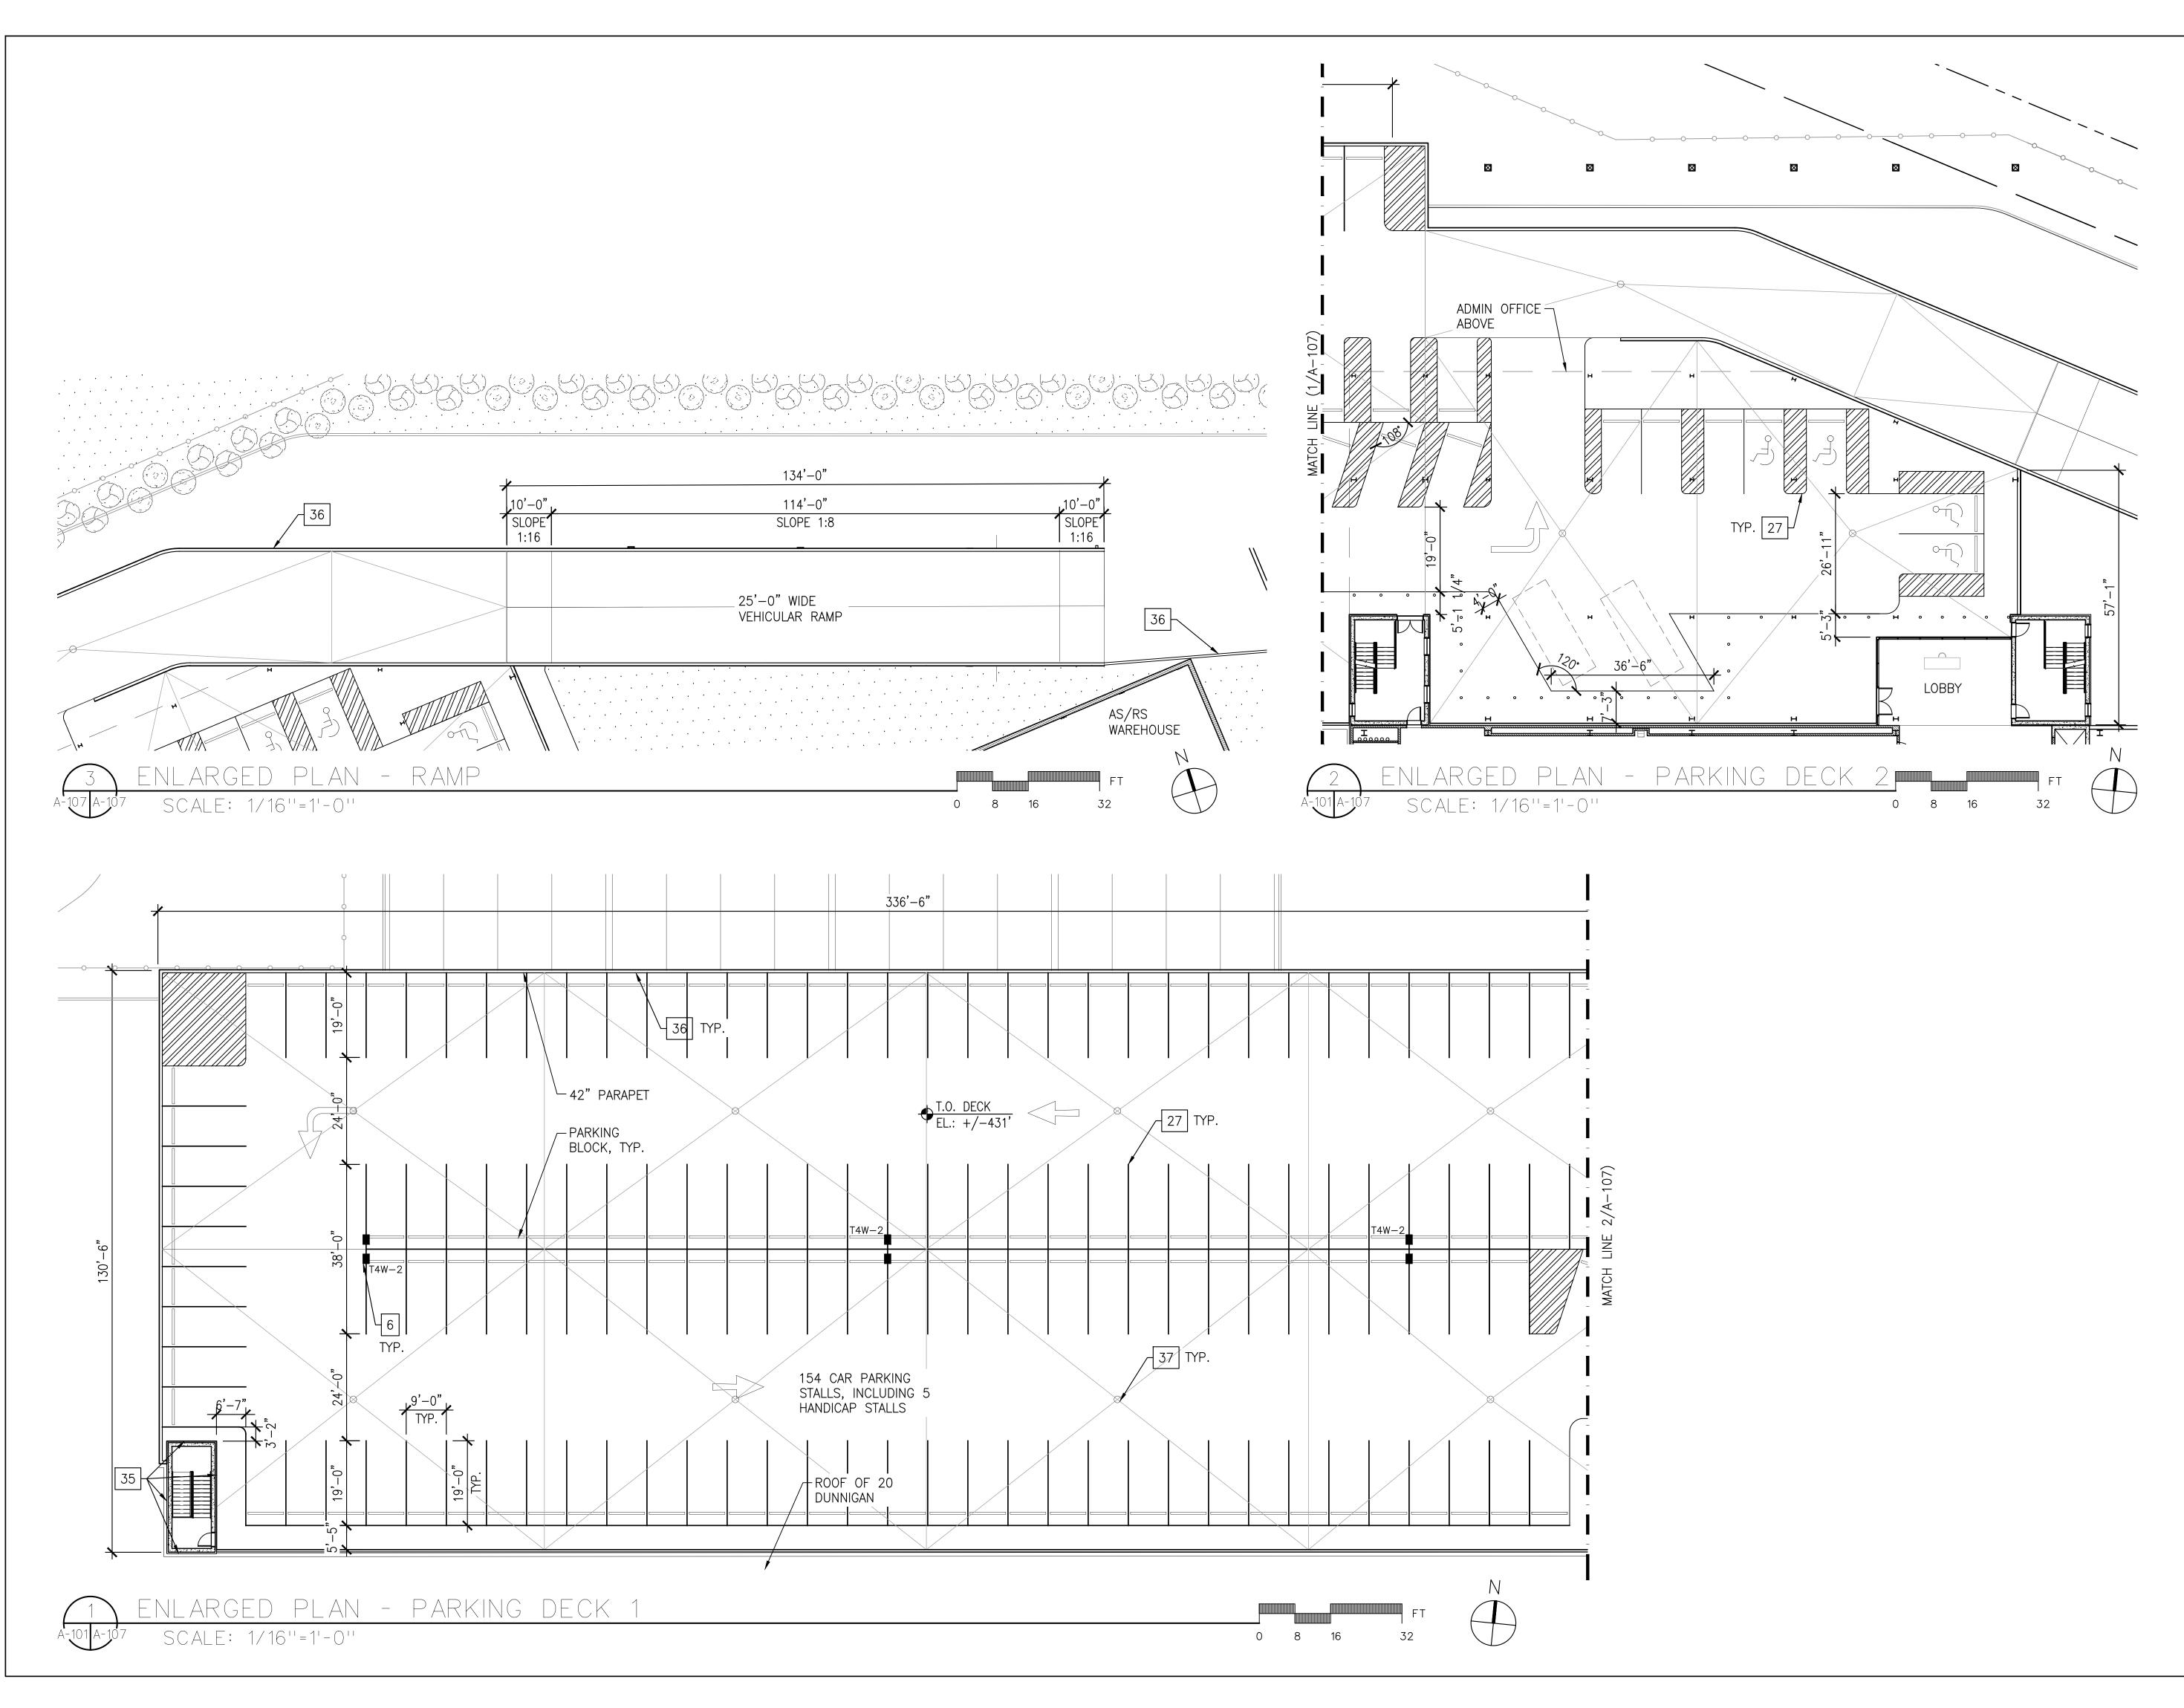
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	Planning 3743 Crescent Street, 3rd Floor
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	120 Bedford Road Armonk, New York 10504
	Tel 914-273-5225 Fax 914-273-2102
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di Domenico + Partners LLP Architecture
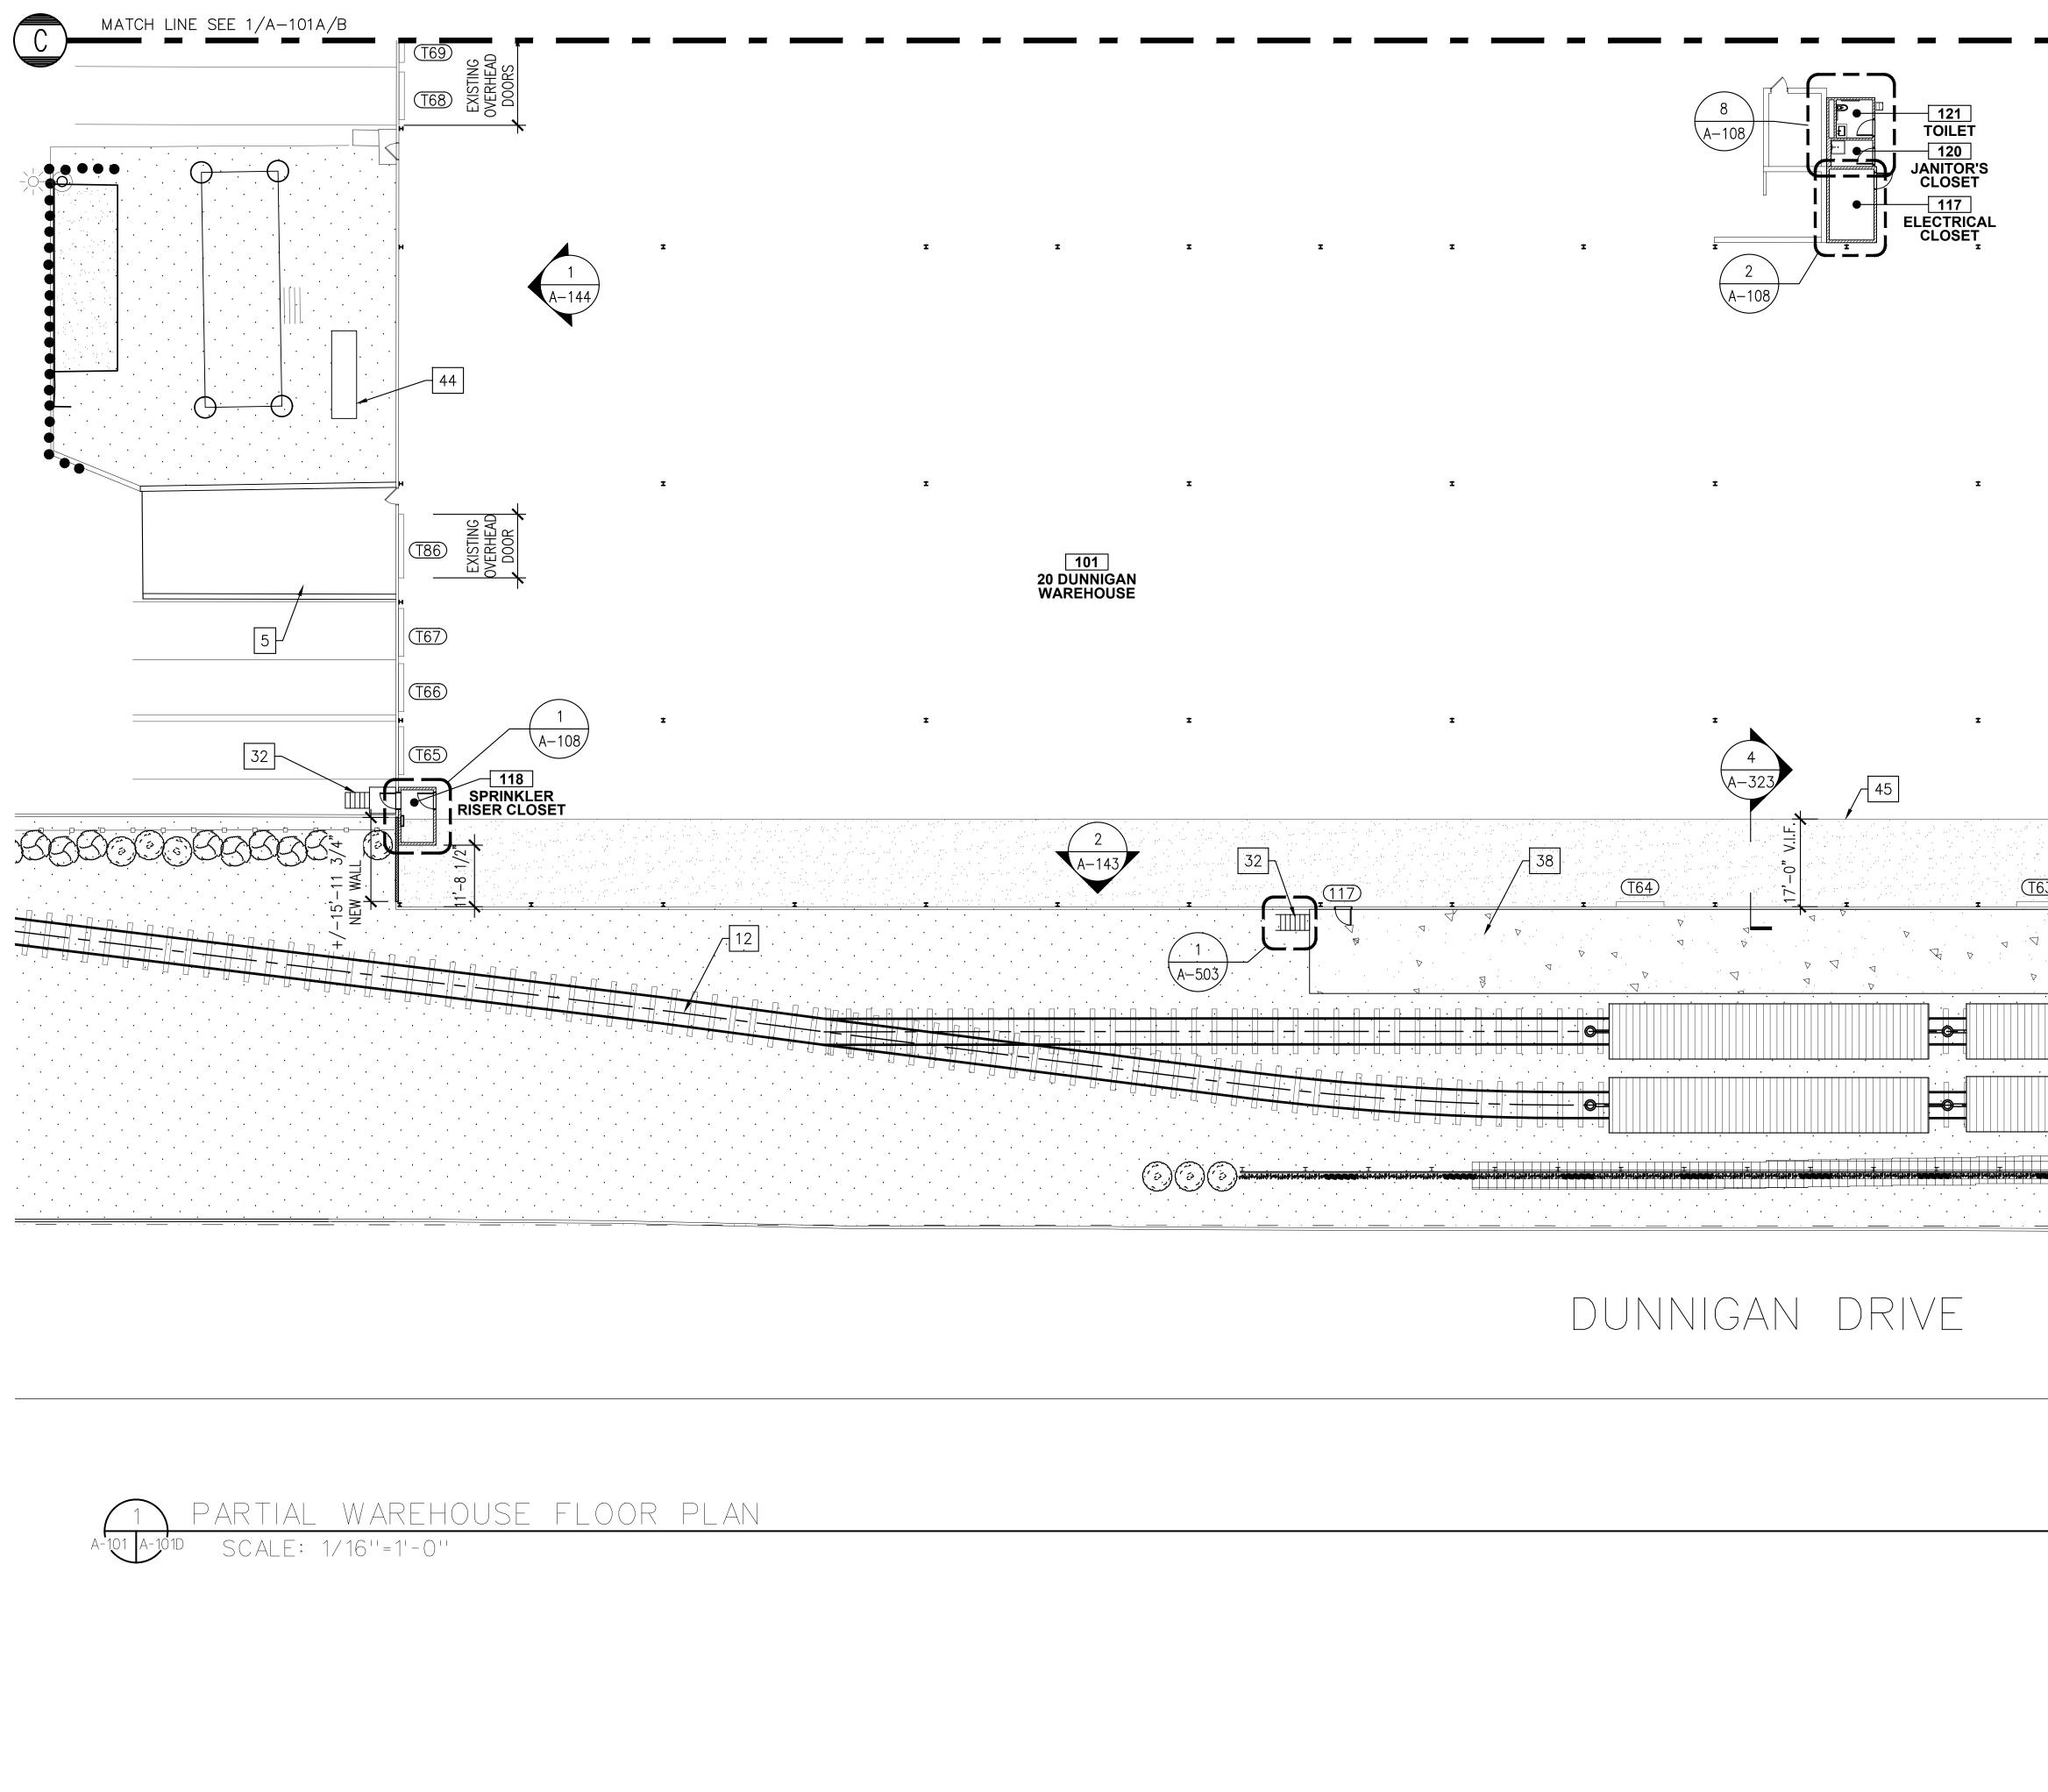
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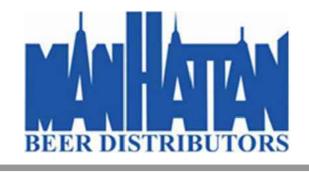


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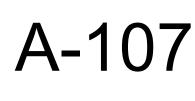
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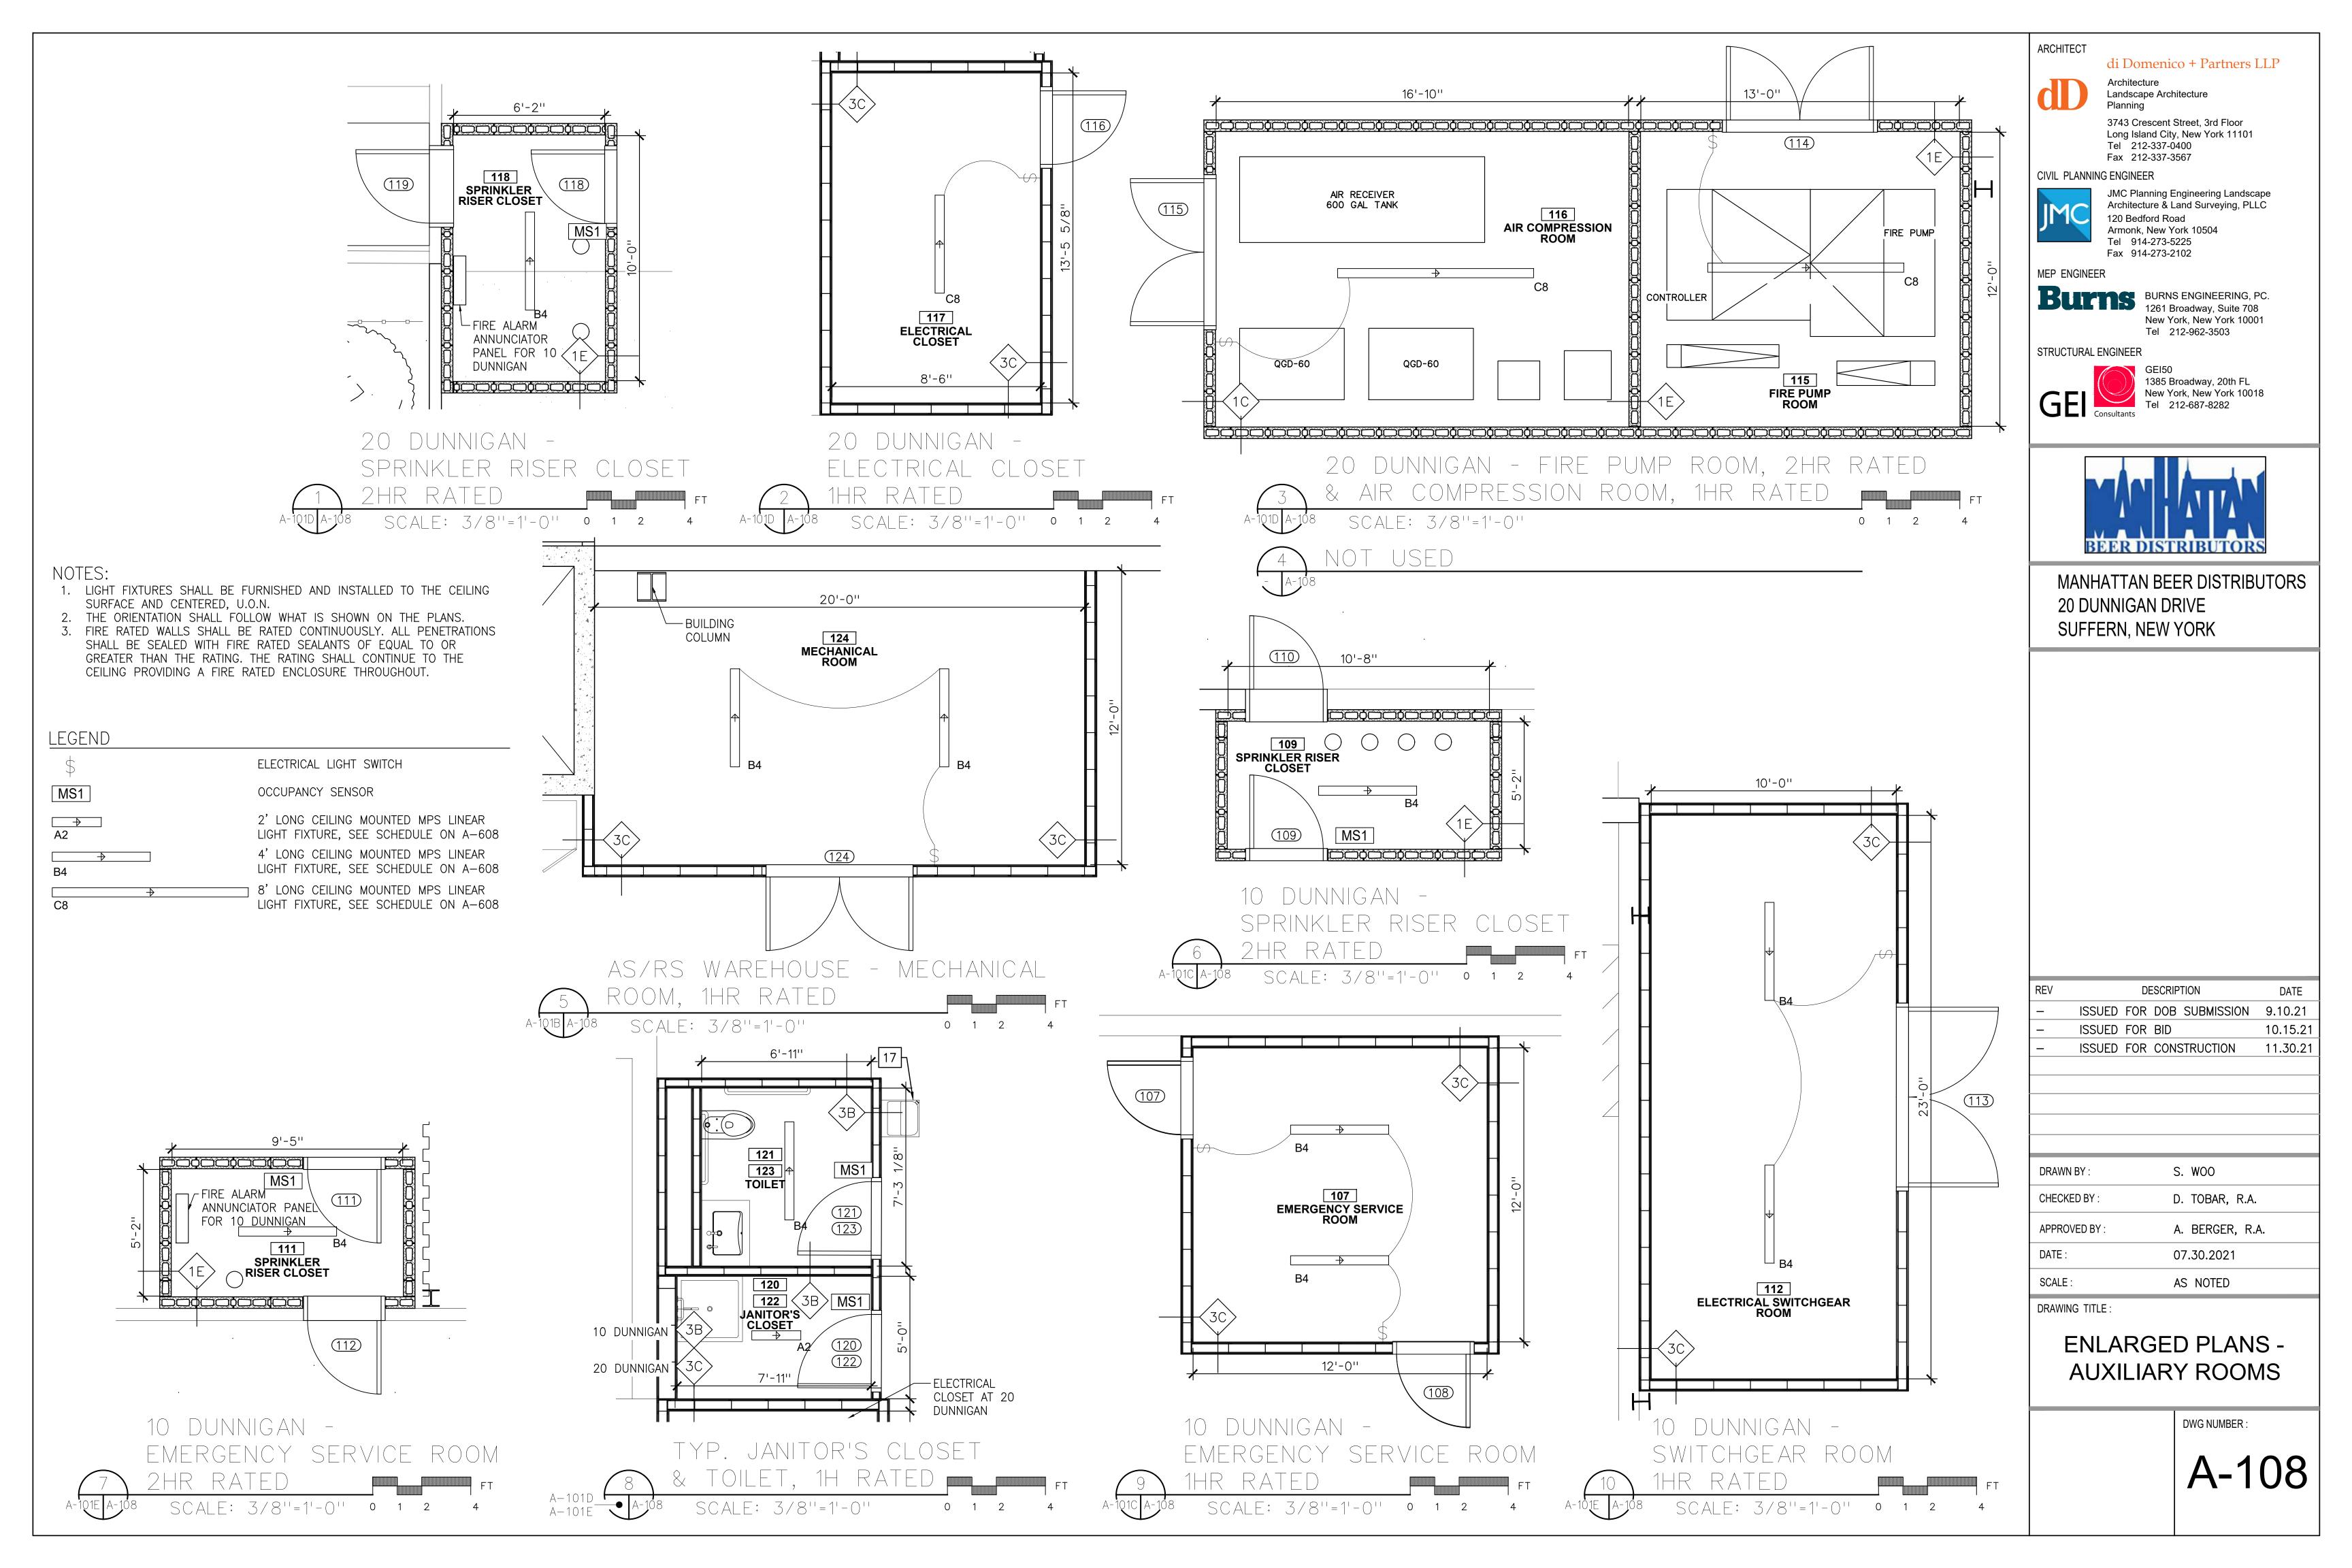
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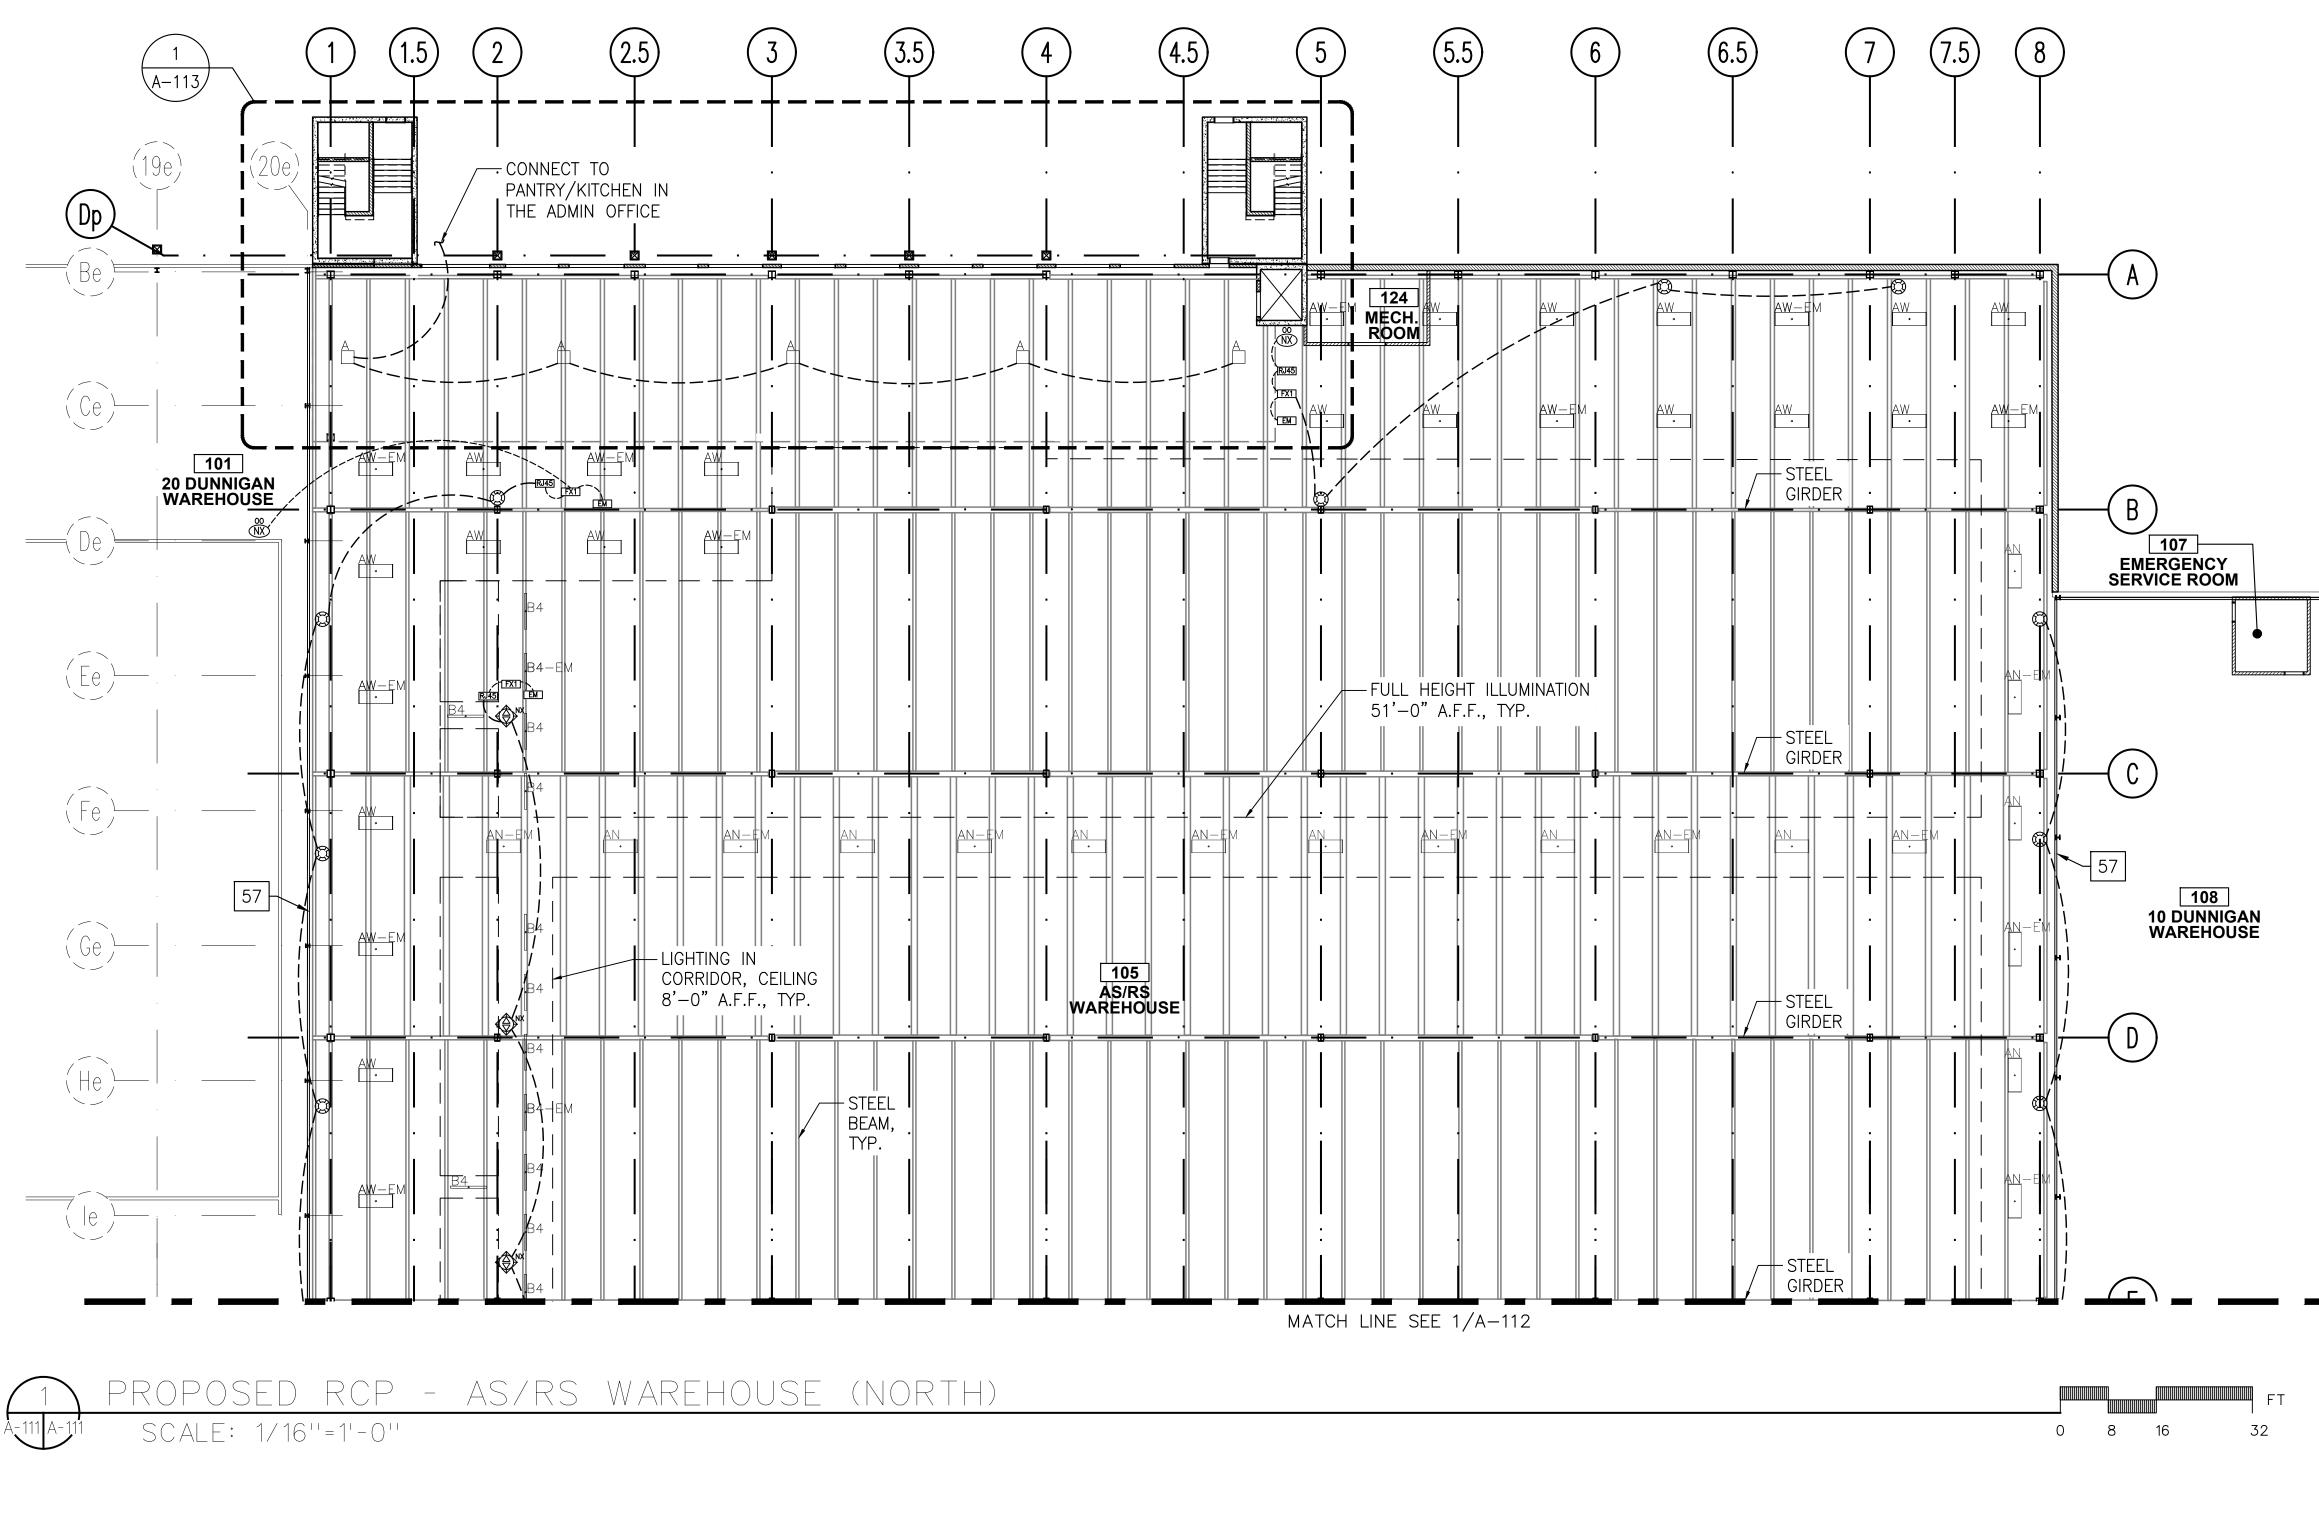
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ENLARGED PLANS -PARKING DECK AND RAMP

DWG NUMBER :

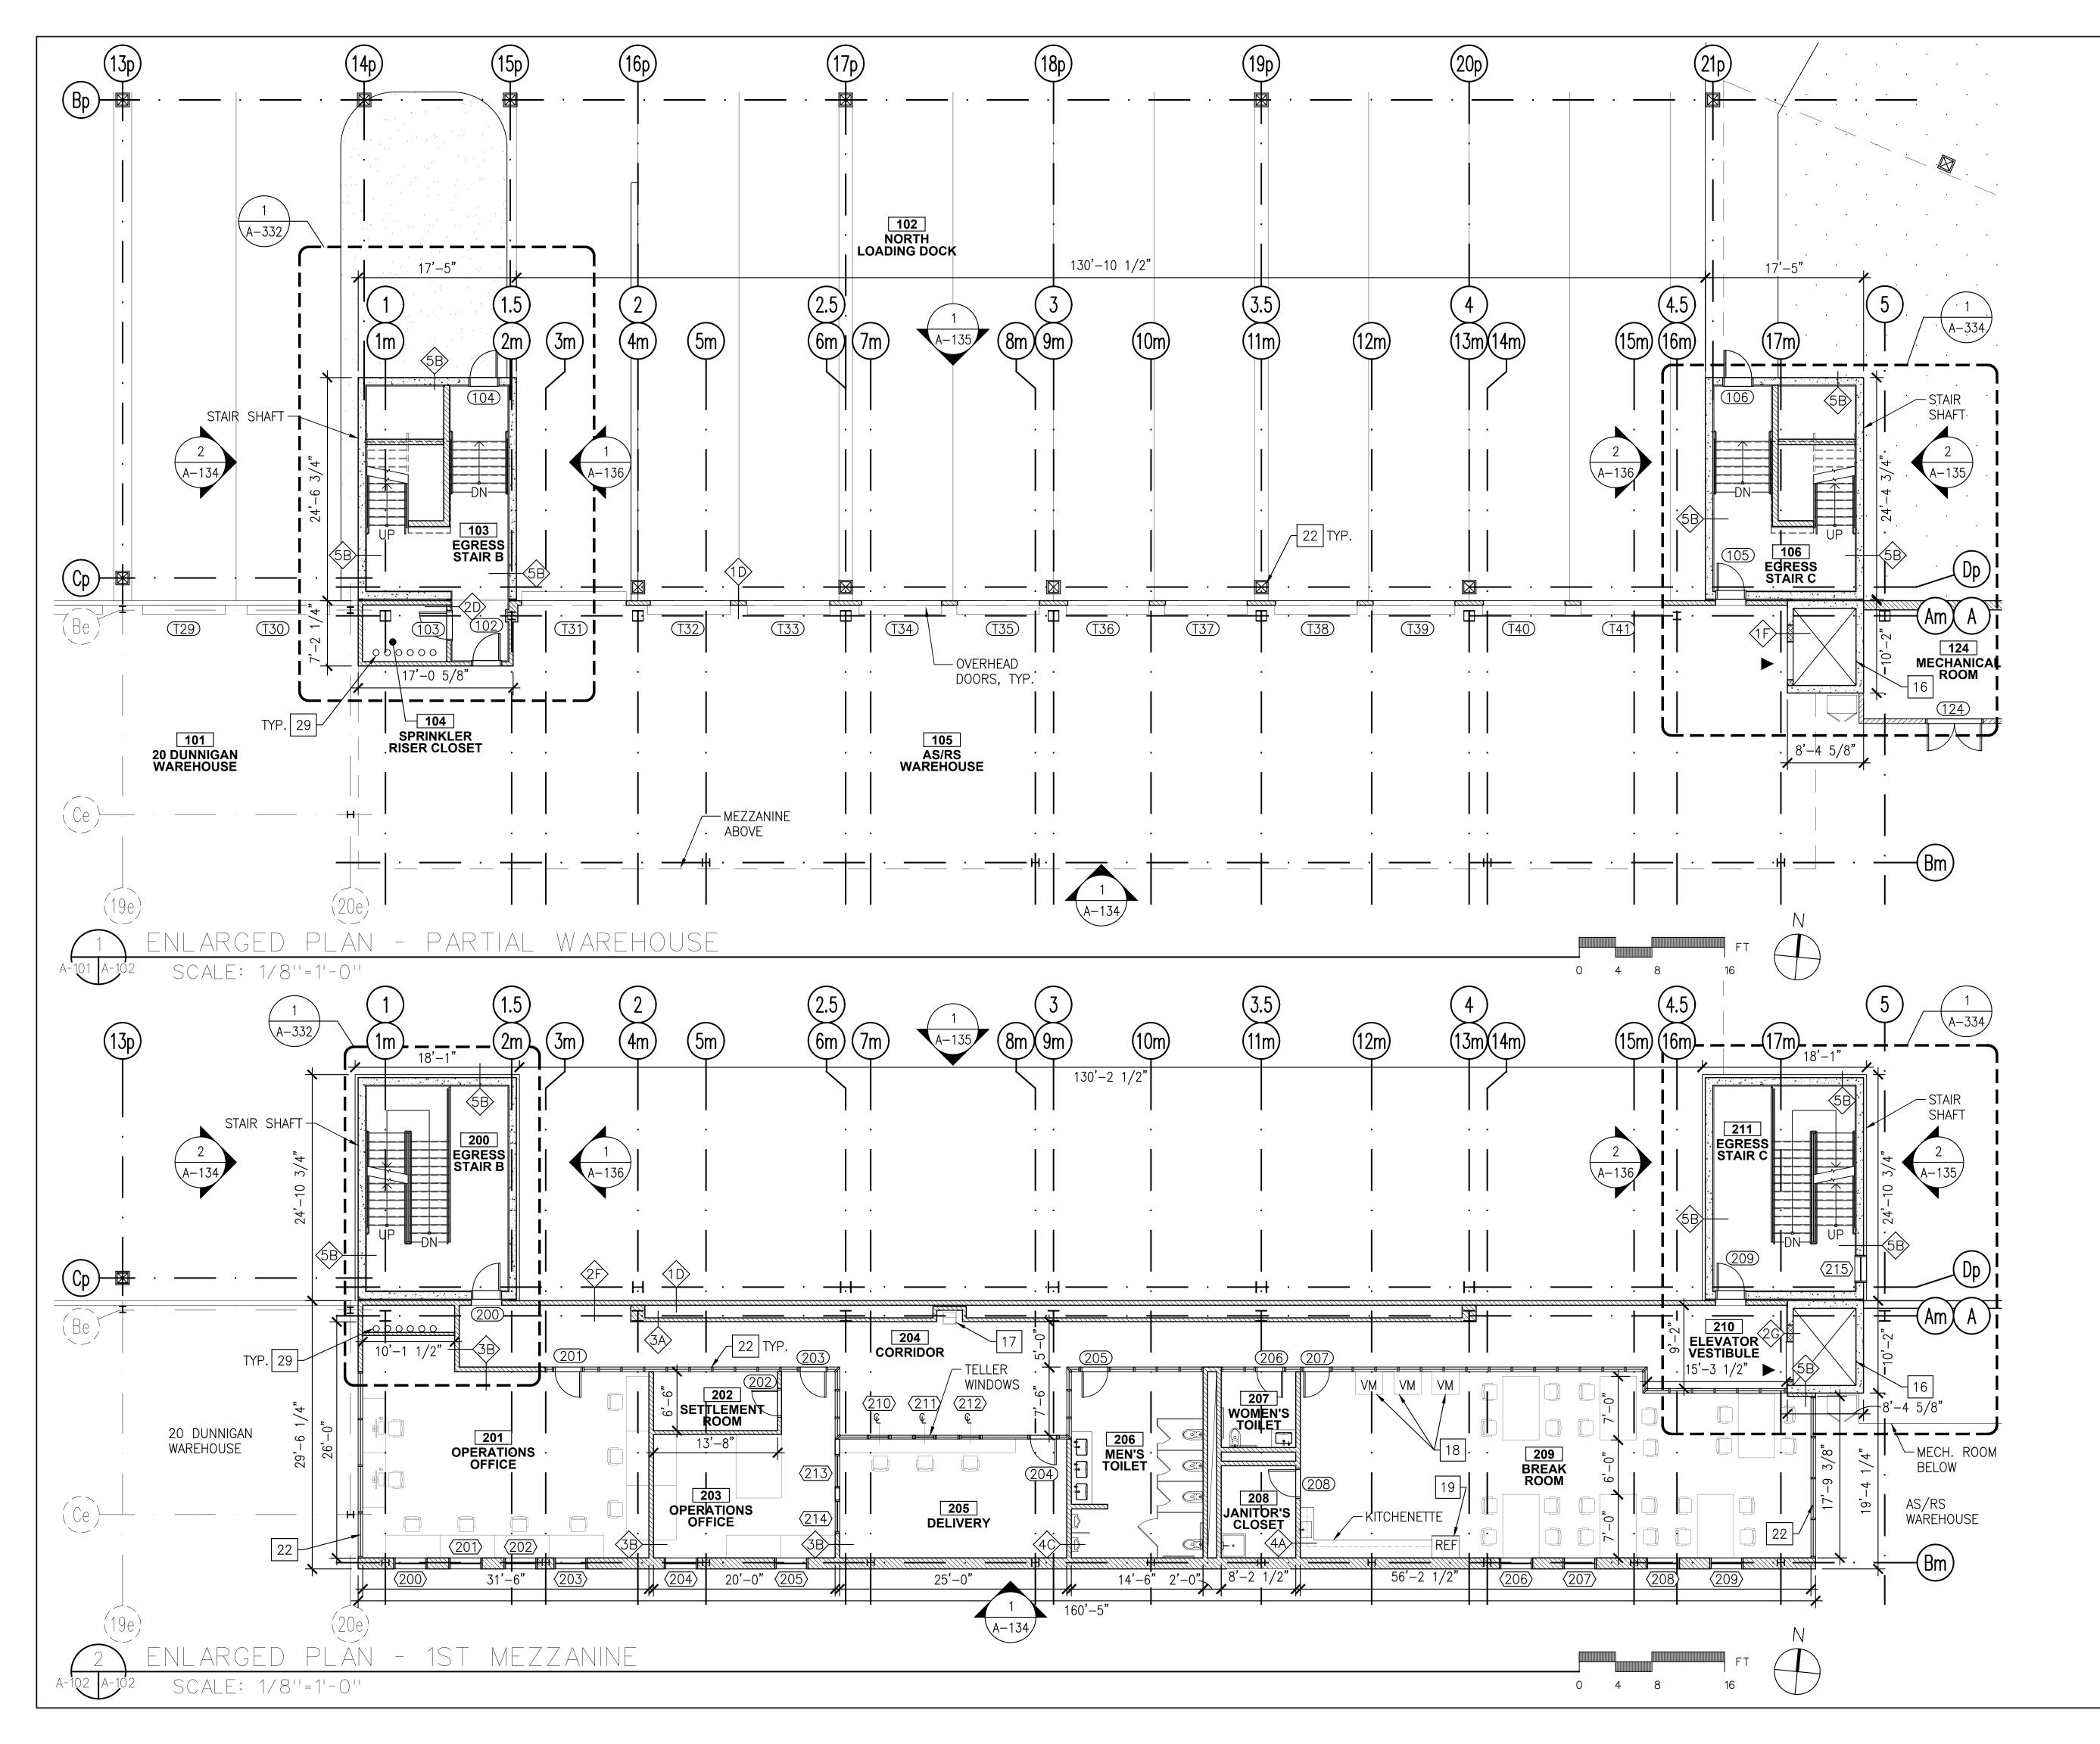





<u>RCP KEY NOTES:</u>

- 1. SEE A-608 FOR LIGHTING AND CONTROL SCHEDULES.
- 2. SEE A-108 FOR LIGHTING LAYOUT IN AUXILIARY ROOMS.


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ARCHITECT	di Domenico + Partners LLP
	Architecture Landscape Architecture
u)	Planning 3743 Crescent Street, 3rd Floor
	Long Island City, New York 11101 Tel 212-337-0400
CIVIL PLANNIN	Fax 212-337-3567 G ENGINEER
IMC	JMC Planning Engineering Landscape Architecture & Land Surveying, PLLC
	120 Bedford Road Armonk, New York 10504 Tel 914-273-5225
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APPROVED BY	
DATE :	07.30.2021
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	DWG NUMBER :

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RCP KEY NOTES:

- 1. SEE A-608 FOR LIGHTING AND CONTROL
- SCHEDULES. 2. SEE A-108 FOR LIGHTING LAYOUT IN
- AUXILIARY ROOMS.



ARCHITECT

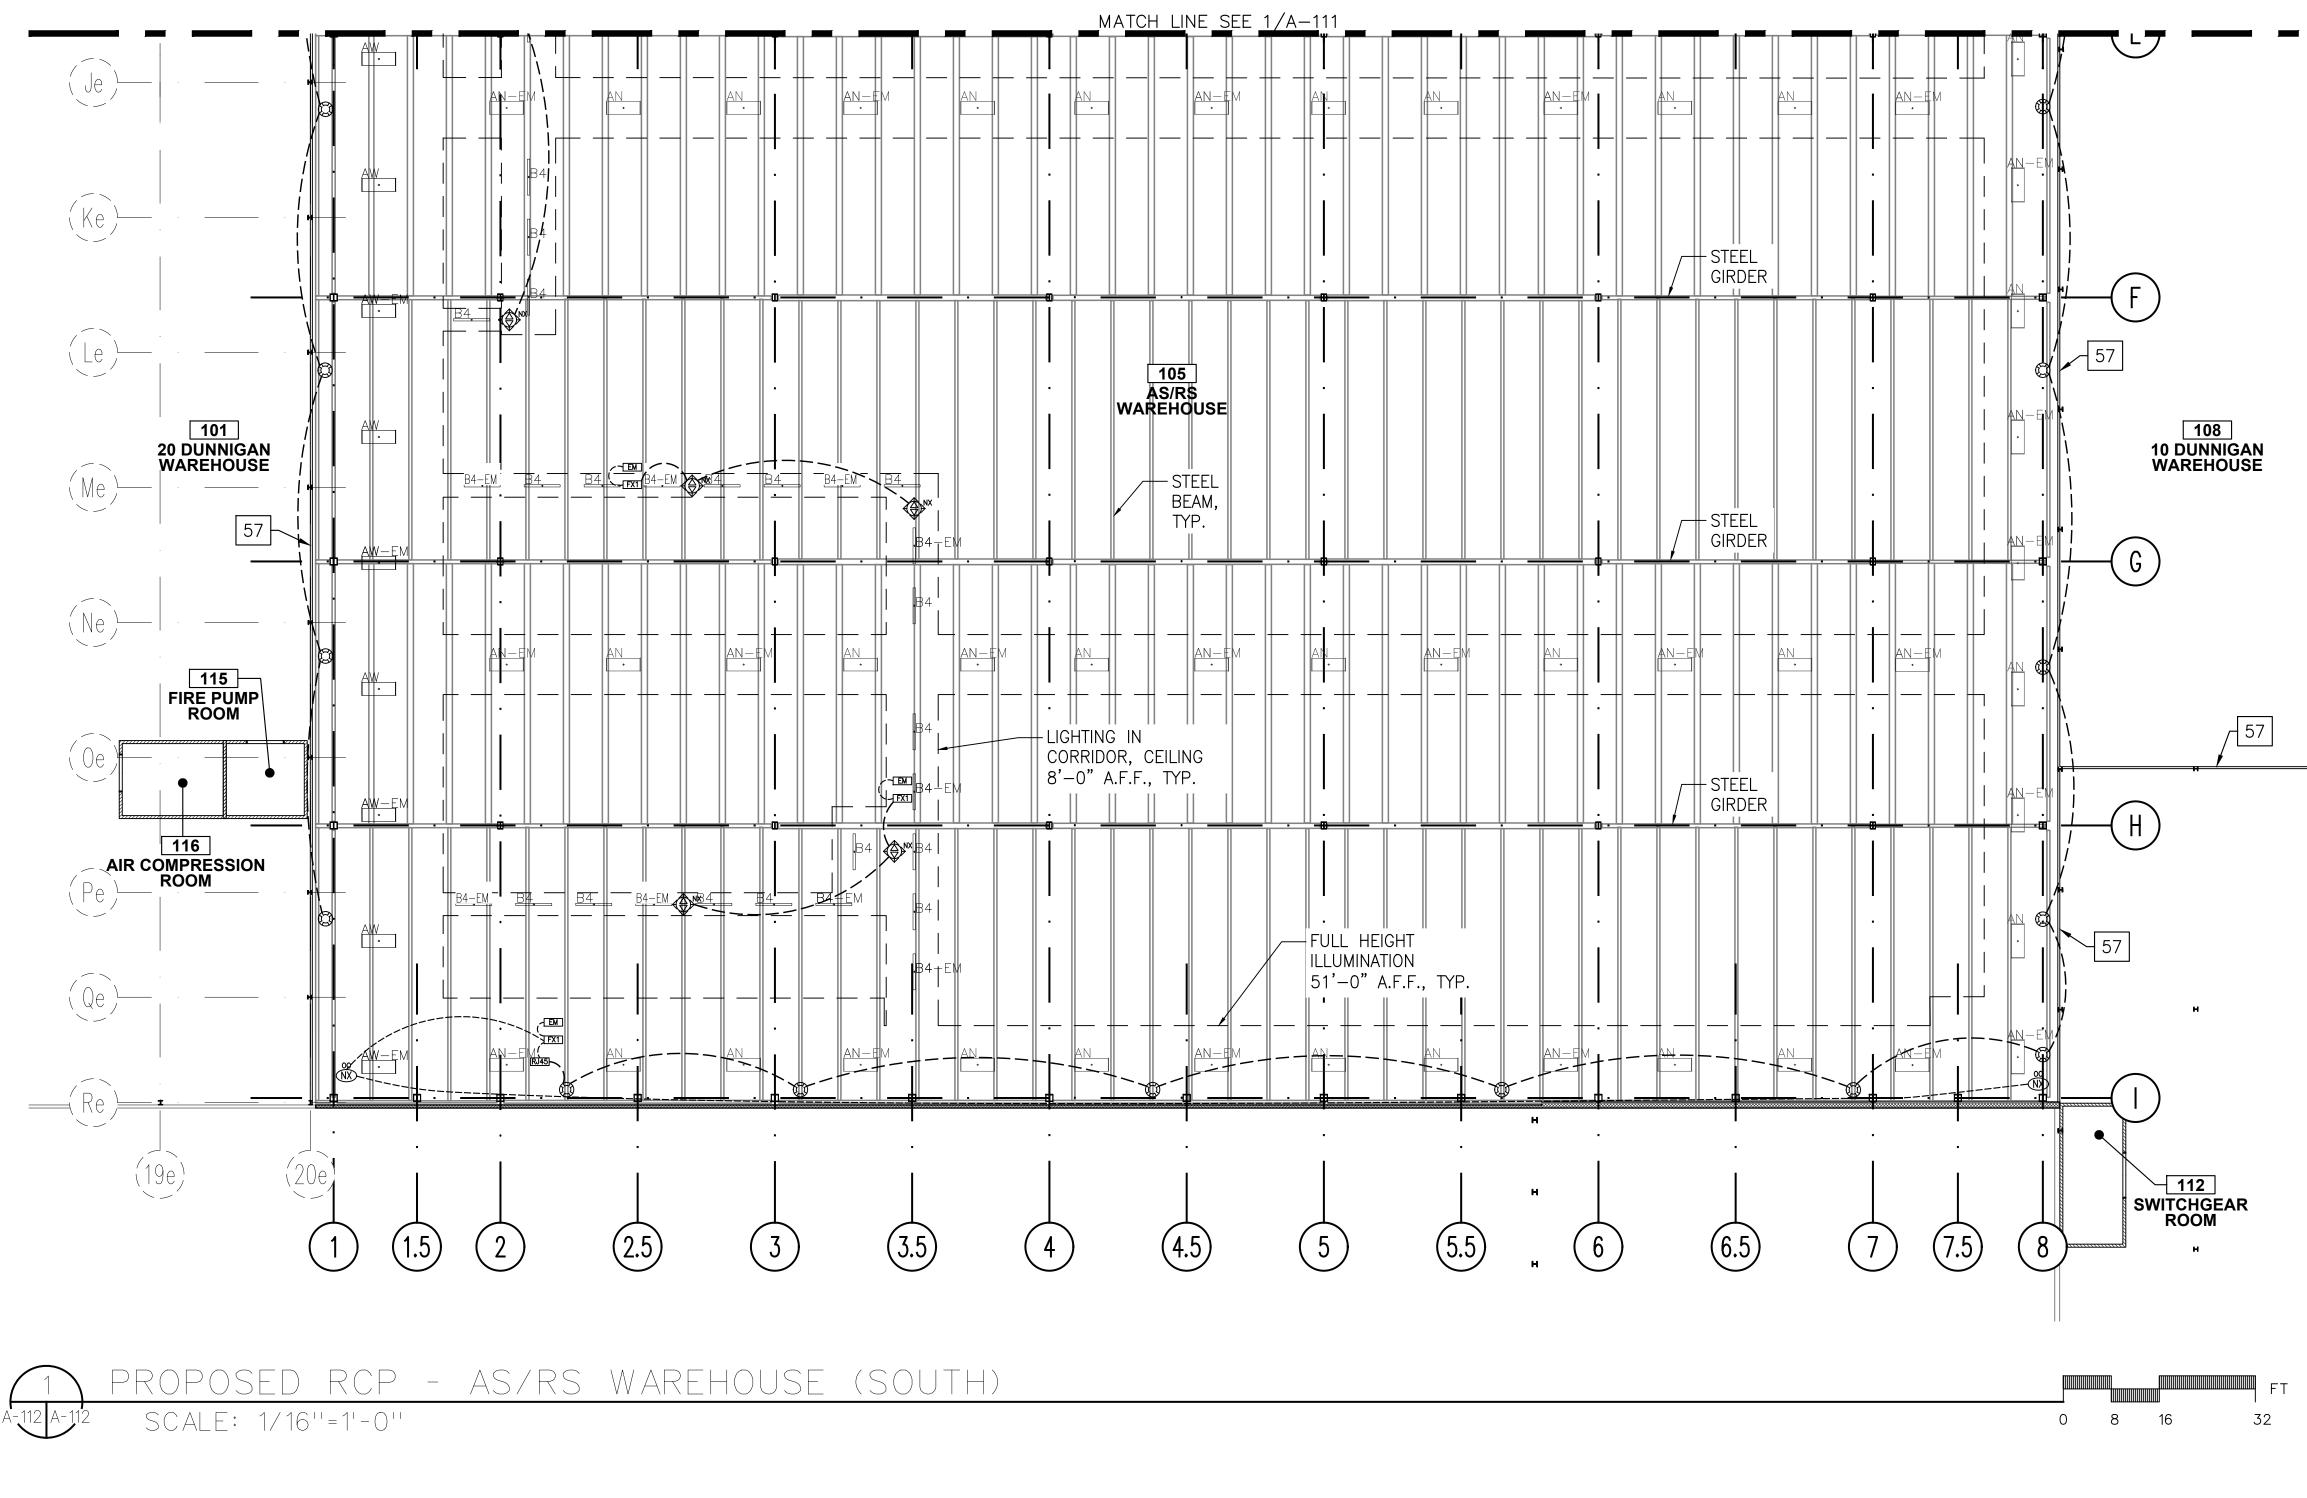di Domenico + Partners LLP



3743 Crescent Street, 3rd Floor Long Island City, New York 11101 Tel 212-337-0400 Fax 212-337-3567

CIVIL PLANNING ENGINEER



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New York, New York 10001 Tel 212-962-3503 STRUCTURAL ENGINEER



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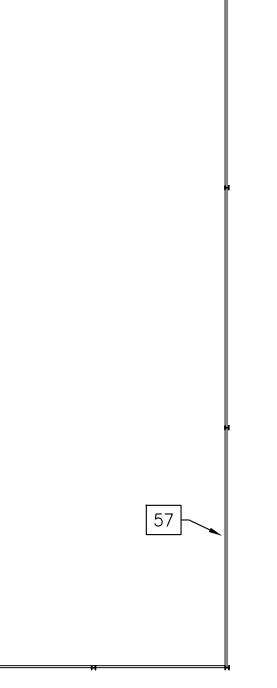
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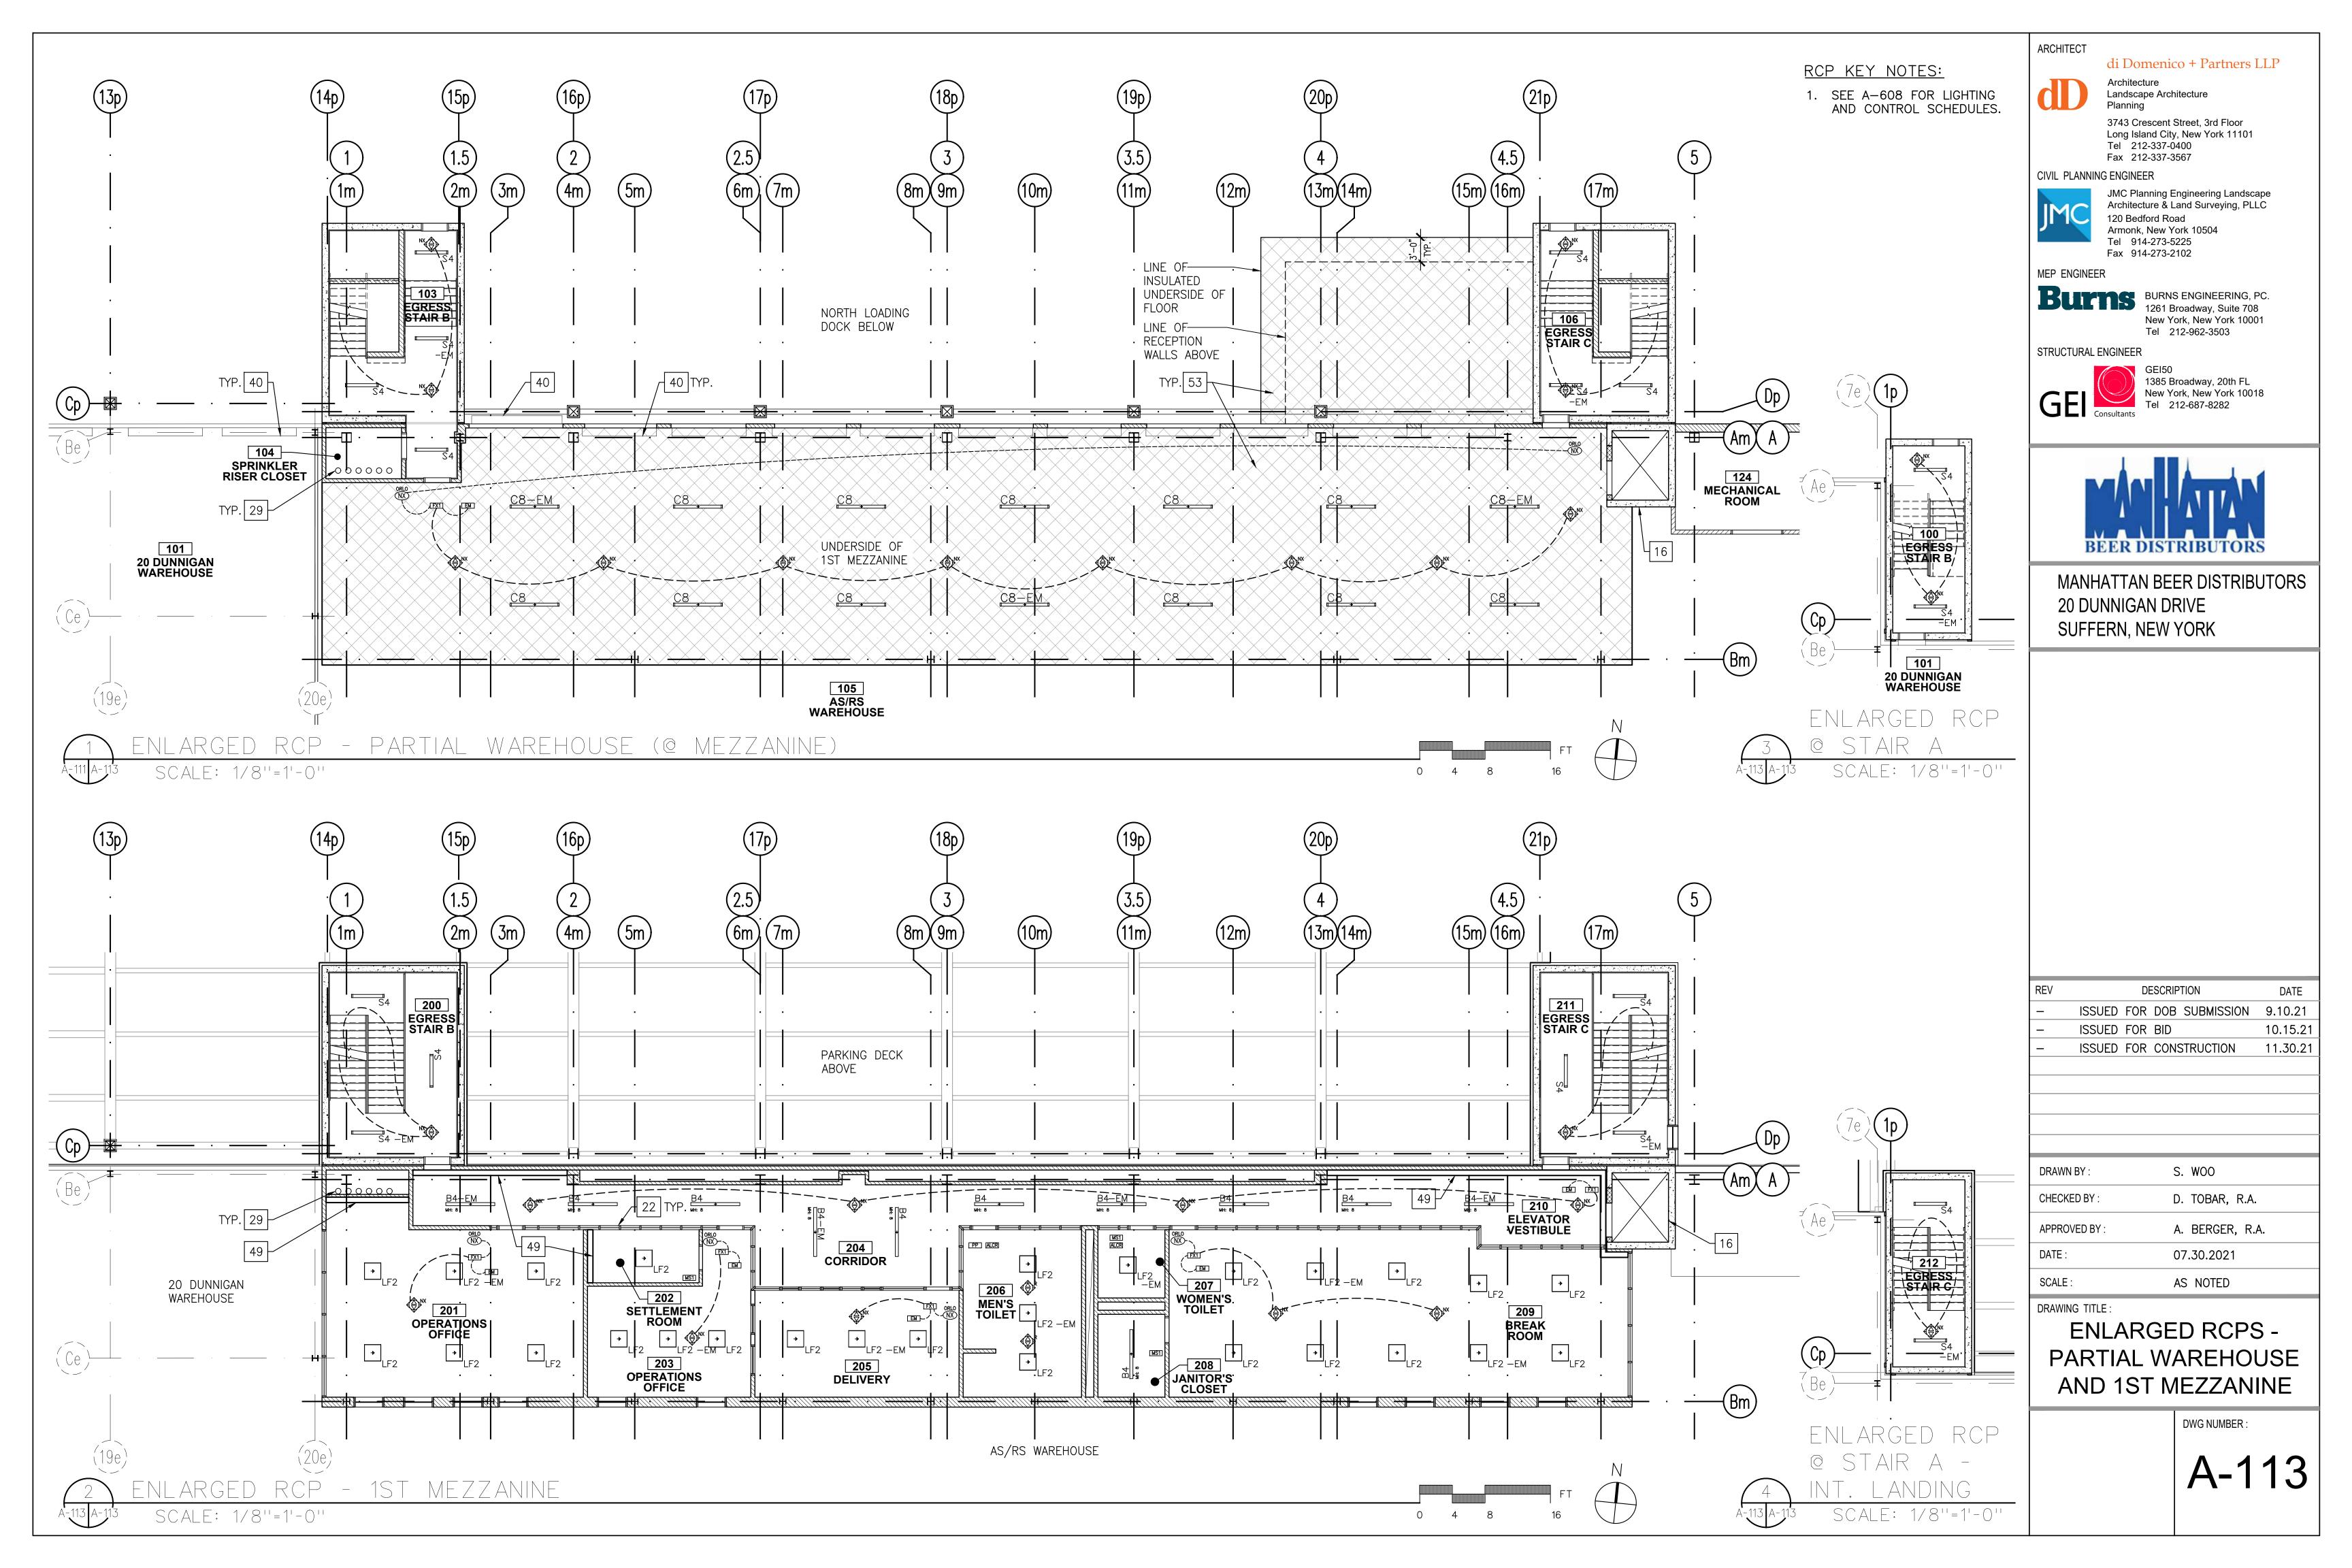





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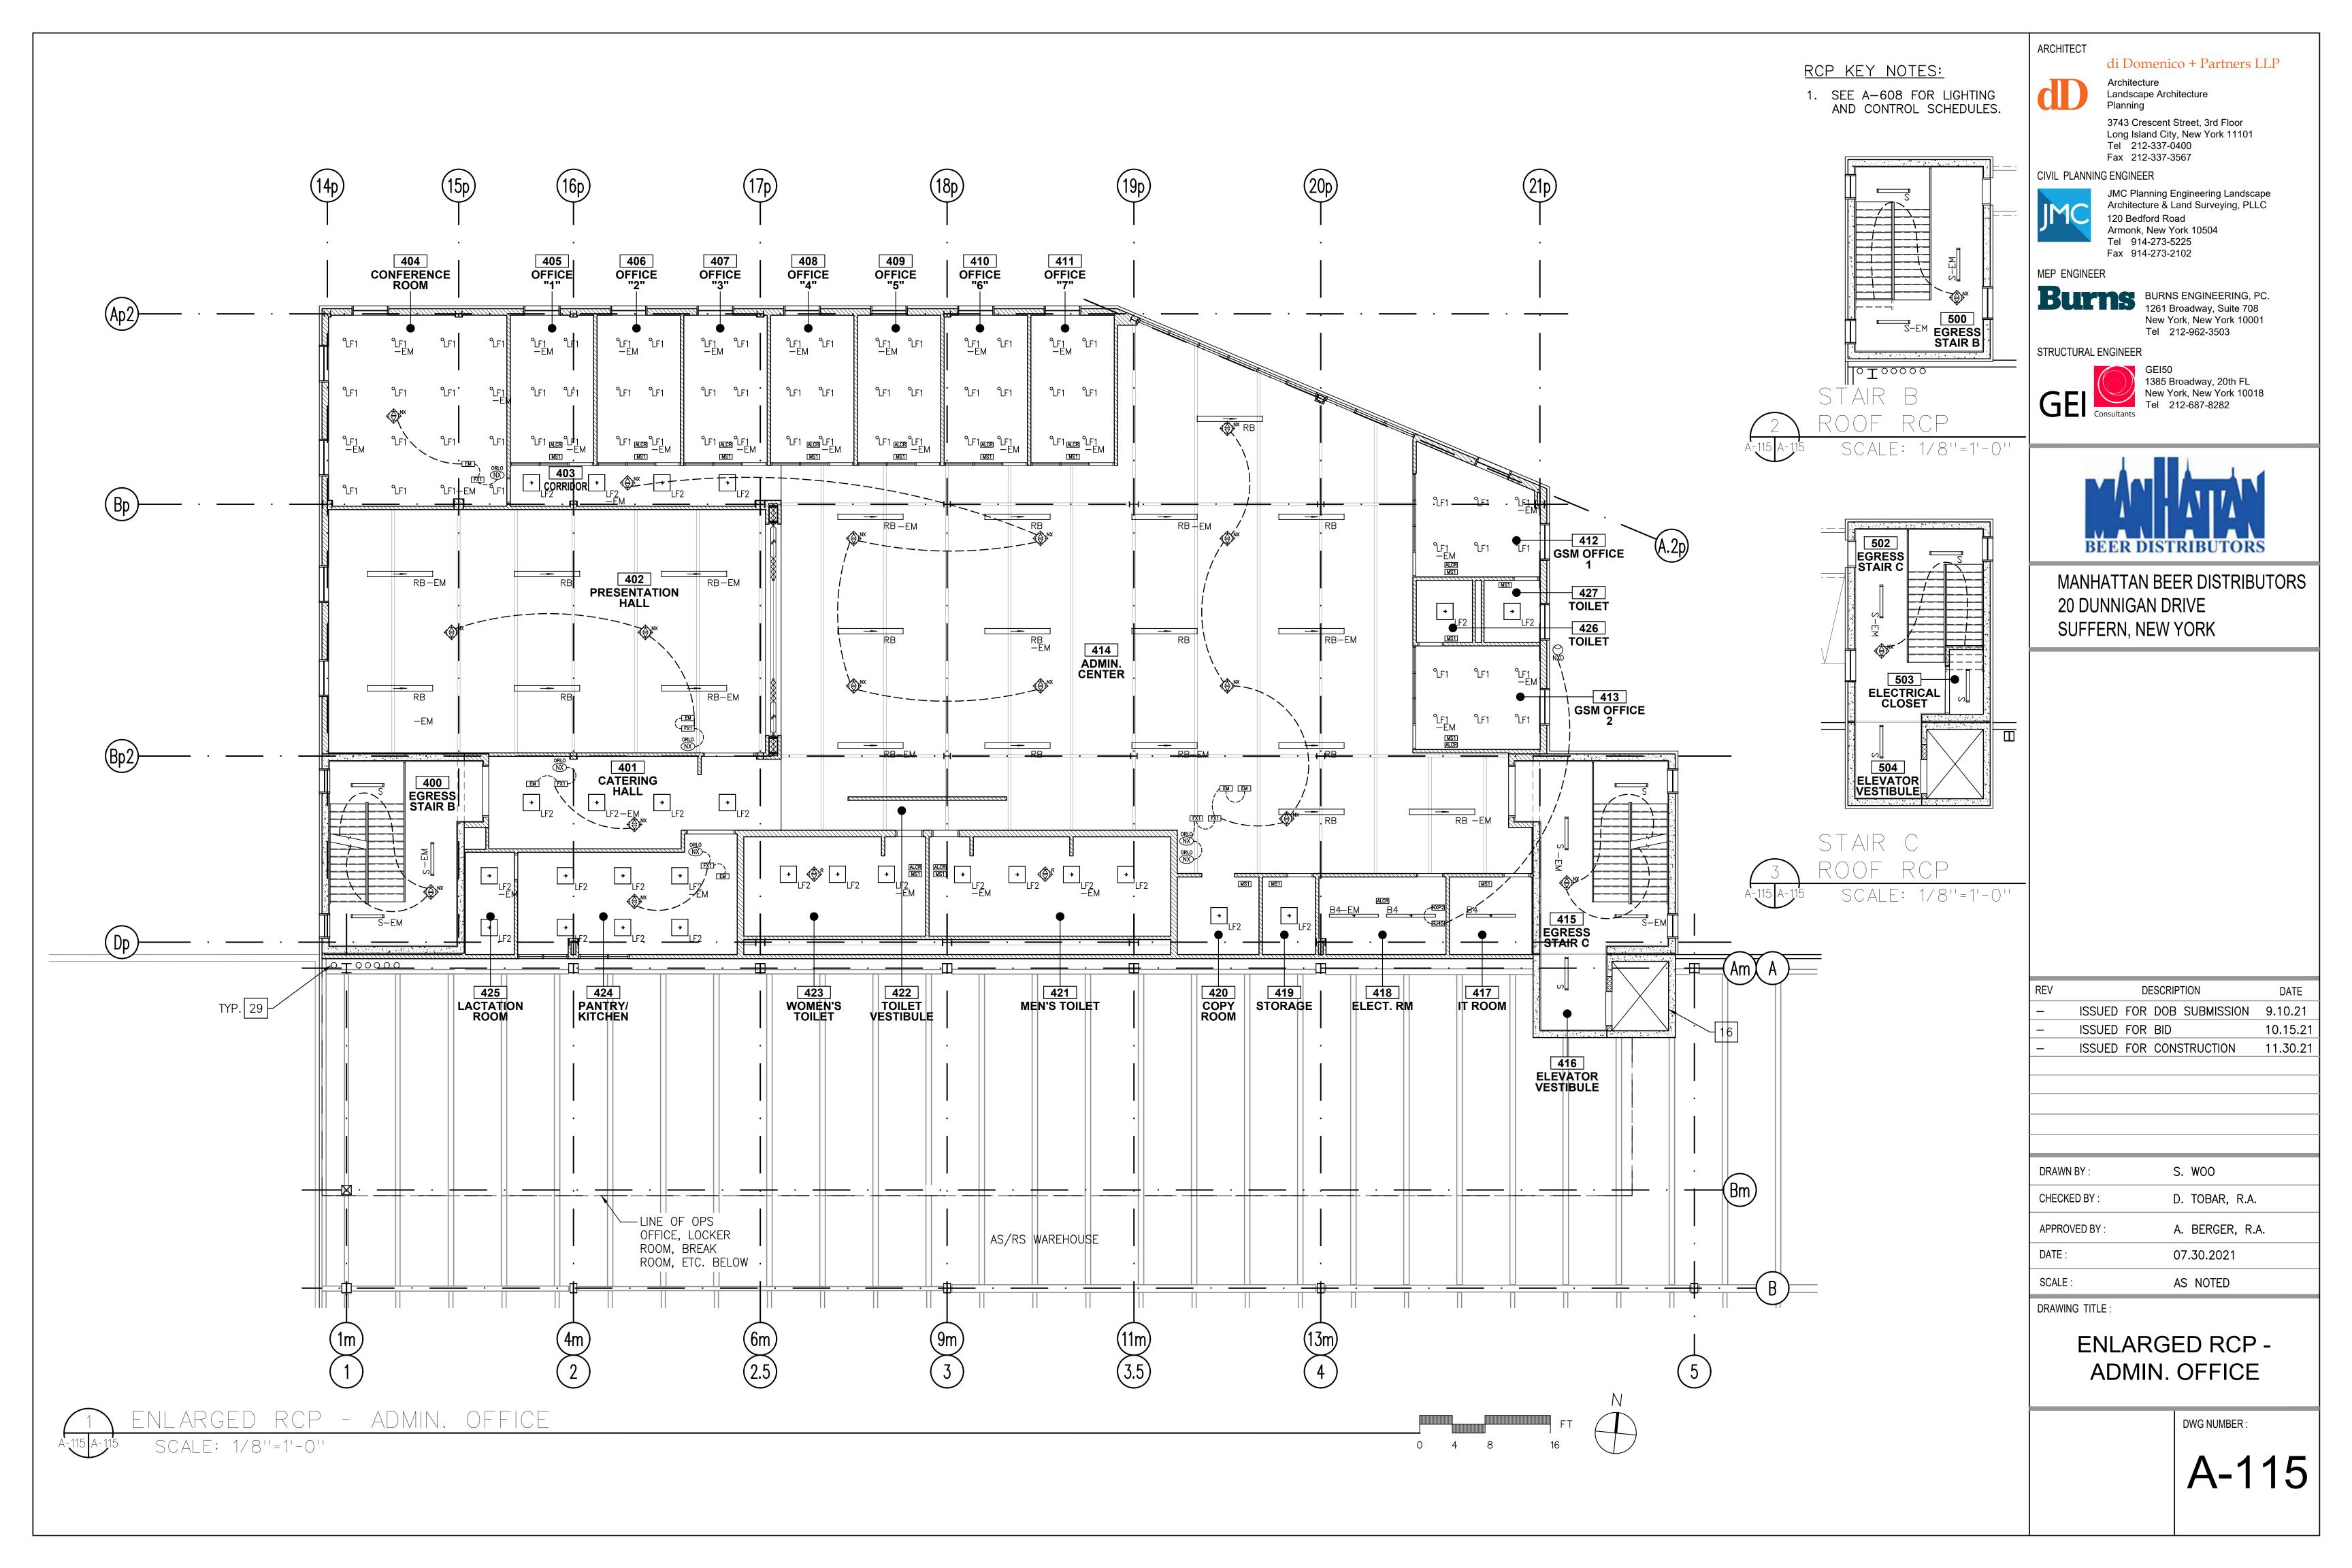
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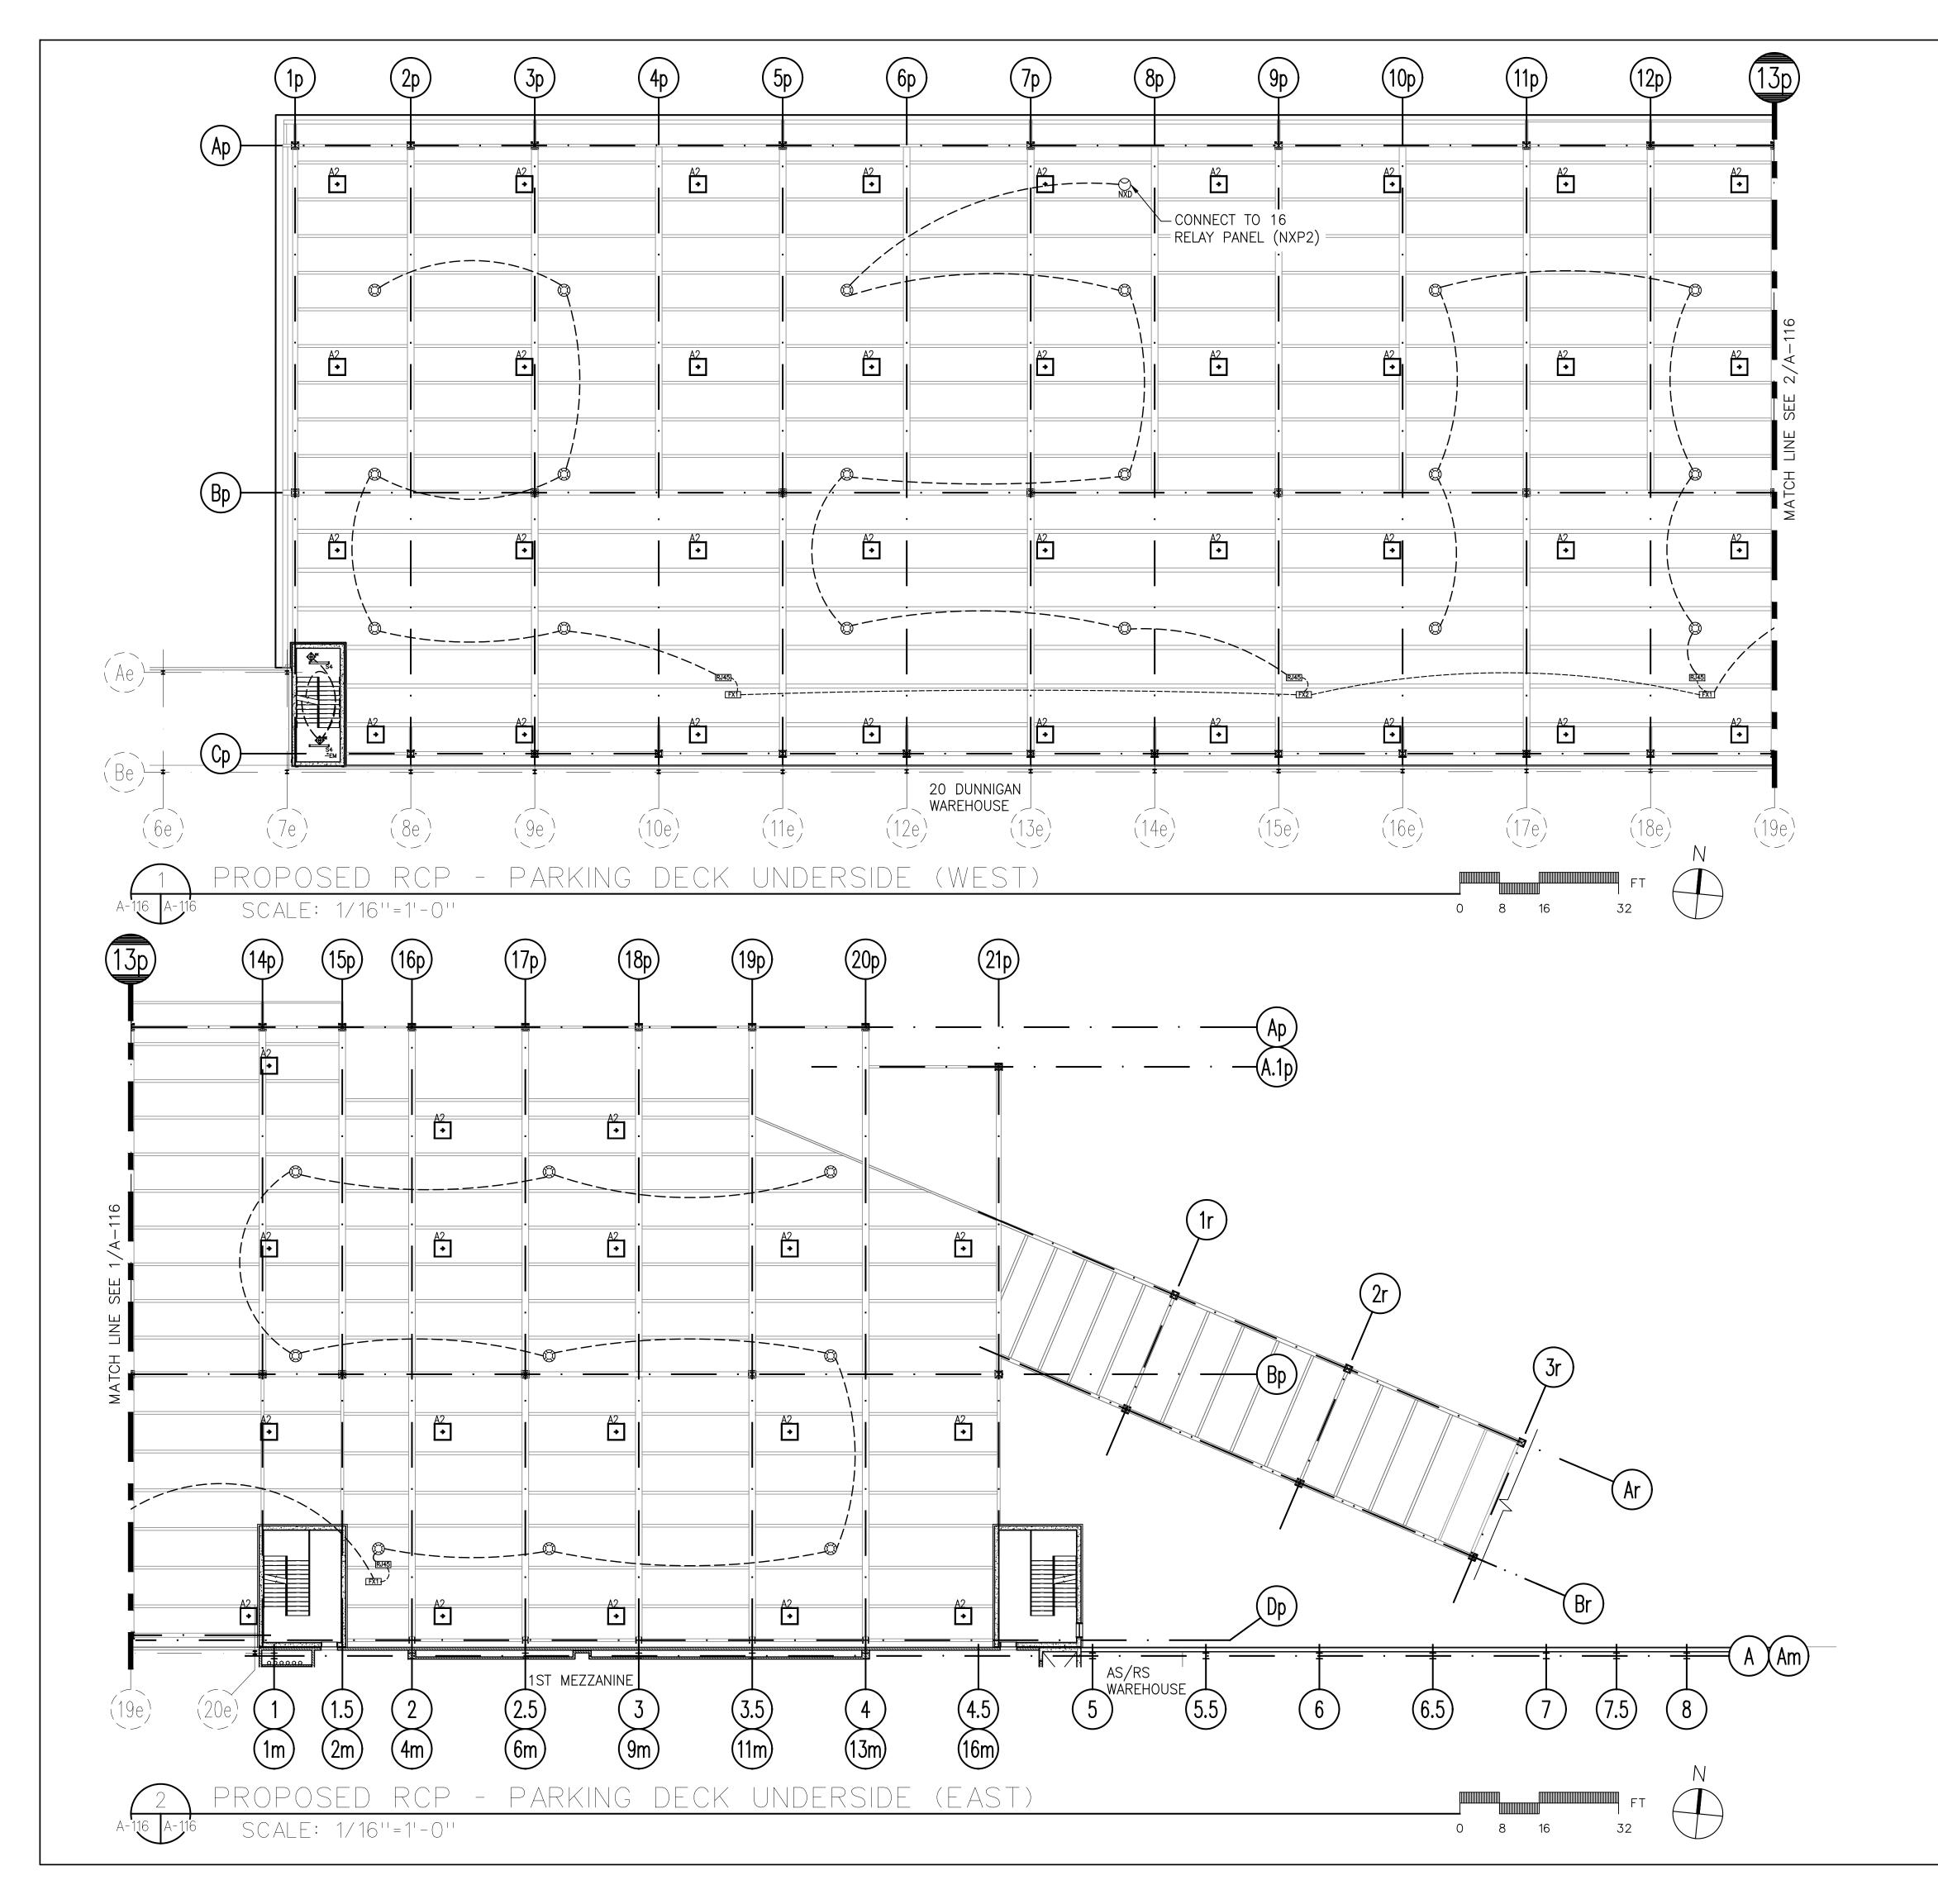
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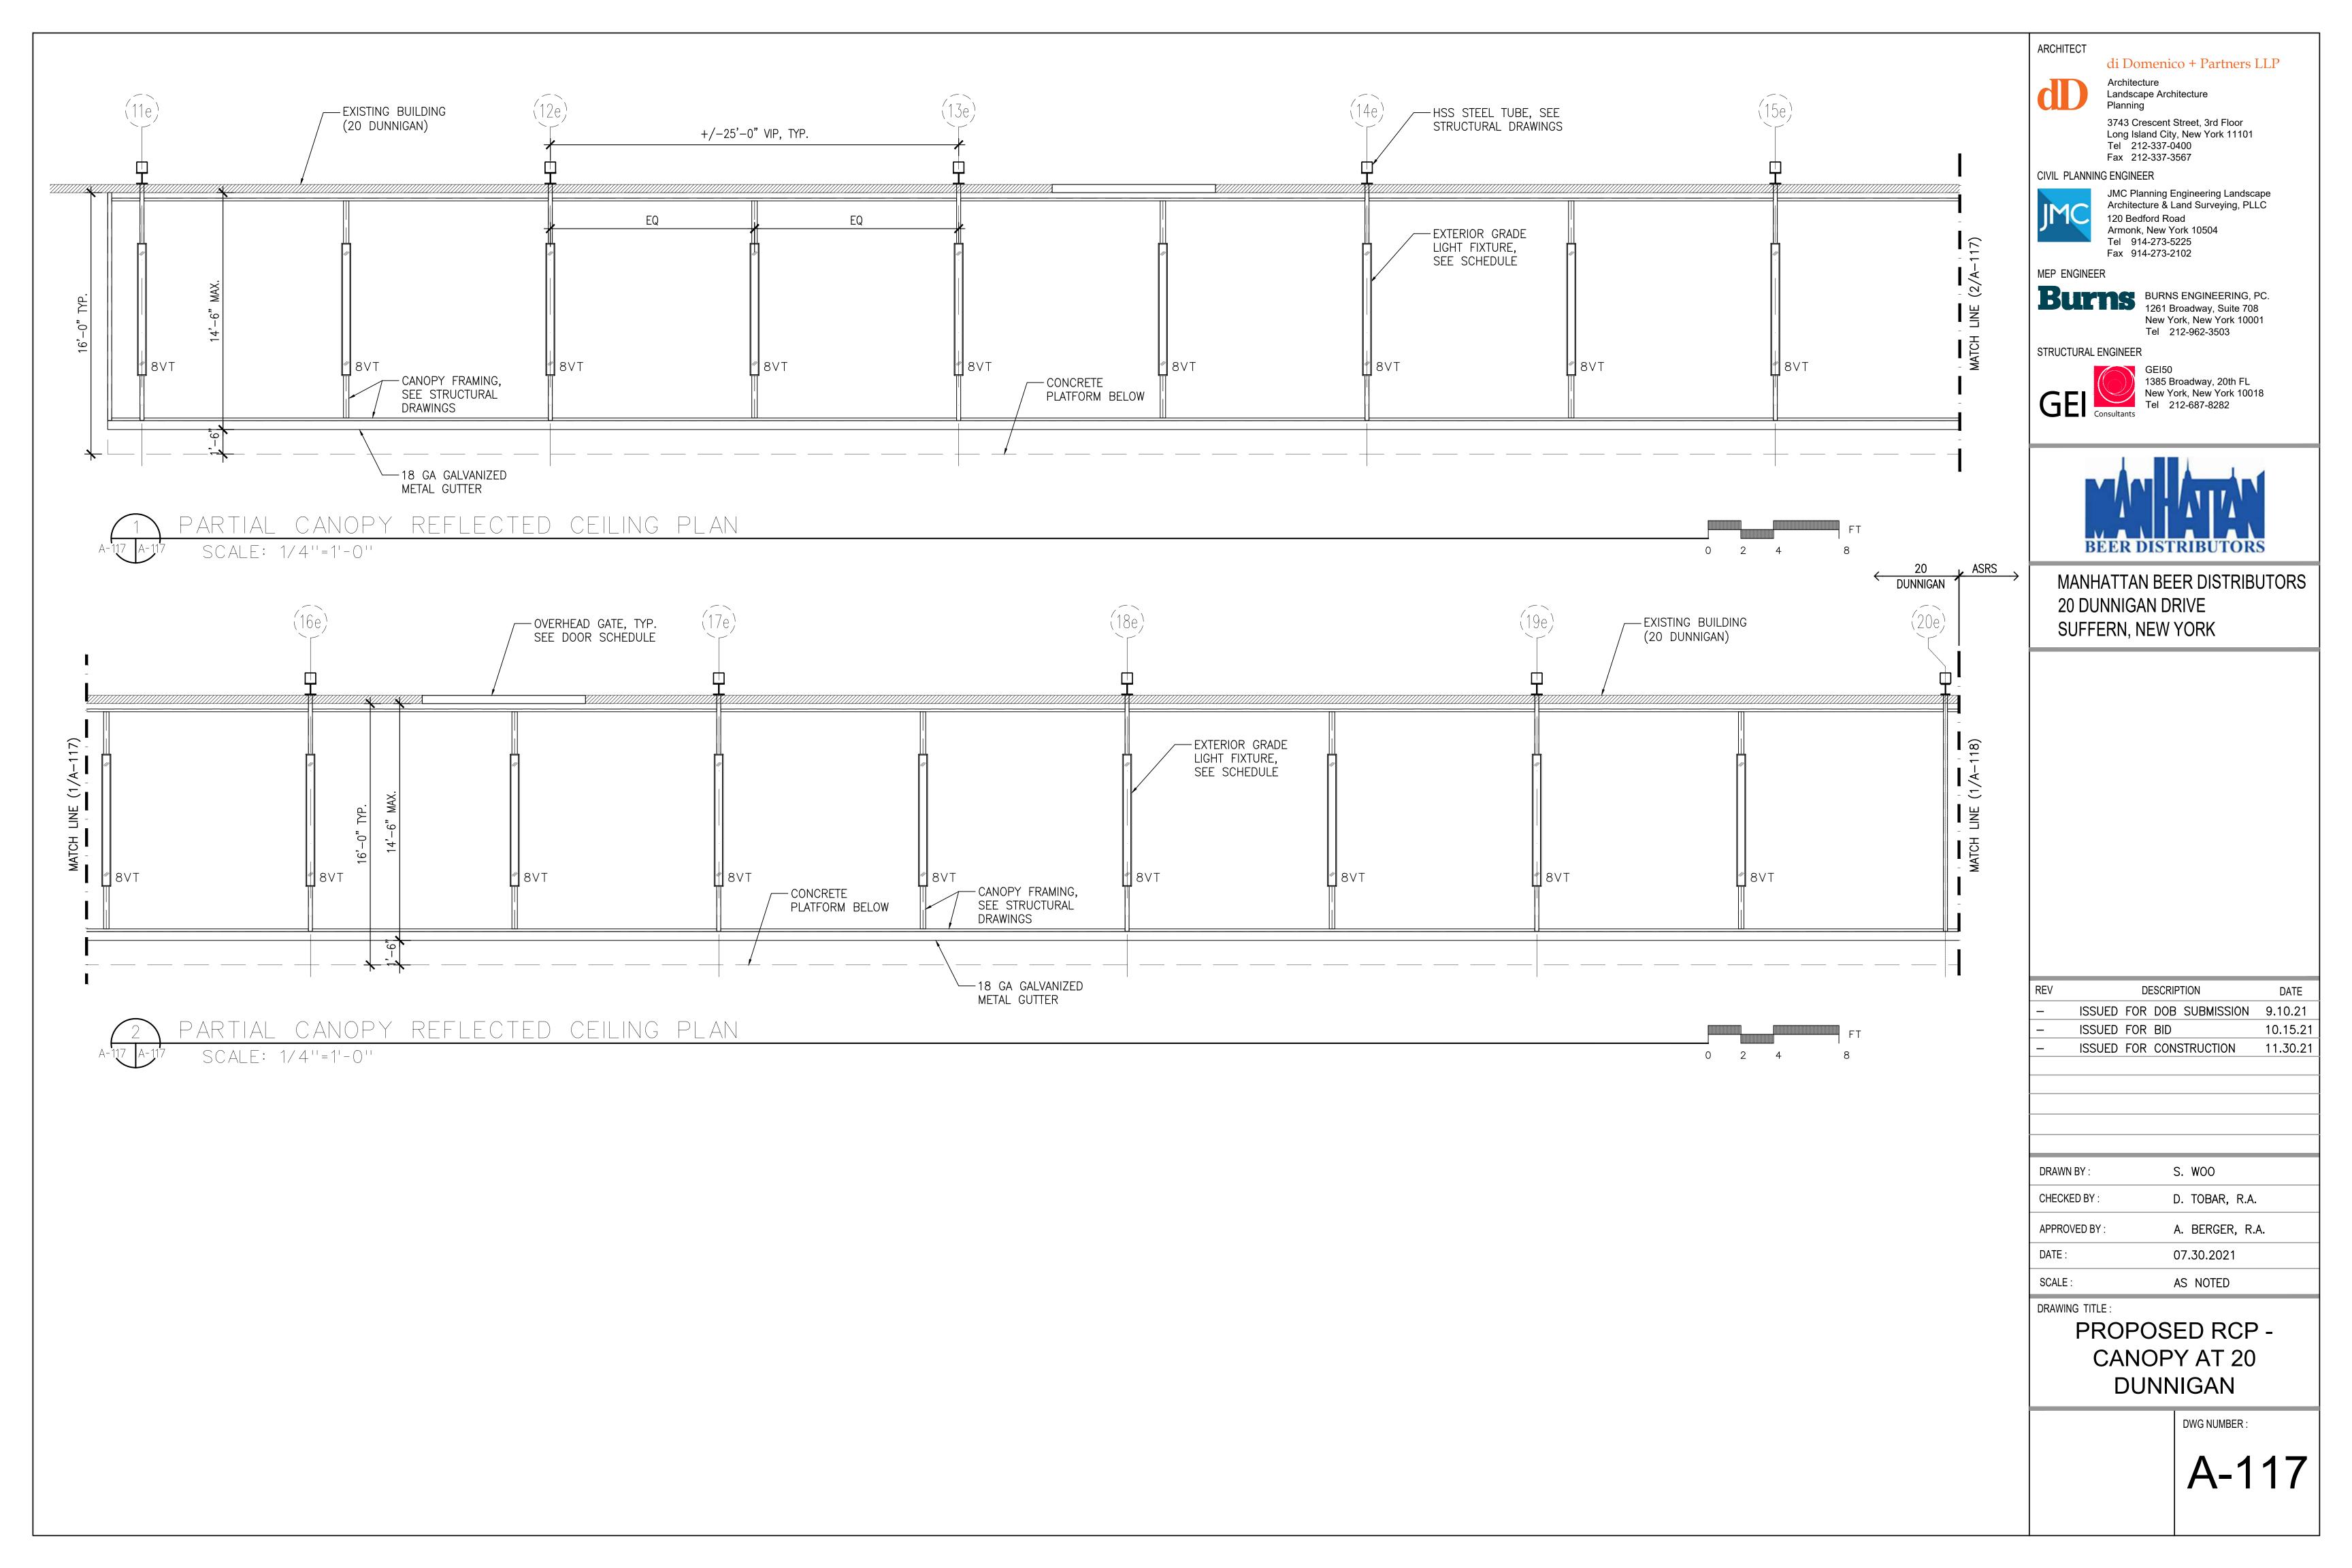



<u>RCP KEY NOTES:</u>	ARCHITECT di Domenico + Partners LLP
1. SEE A-608 FOR LIGHTING	Architecture Landscape Architecture
AND CONTROL SCHEDULES.	Planning 3743 Crescent Street, 3rd Floor
	Long Island City, New York 11101 Tel 212-337-0400
	Fax 212-337-3567 CIVIL PLANNING ENGINEER
	JMC Planning Engineering Landscape Architecture & Land Surveying, PLLC
	120 Bedford Road Armonk, New York 10504
	Tel 914-273-5225 Fax 914-273-2102
< · · · · · · · · · · · · · · · · · · ·	MEP ENGINEER
	BURNS ENGINEERING, PC. 1261 Broadway, Suite 708 New York, New York 10001
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	BEER DISTRIBUTORS
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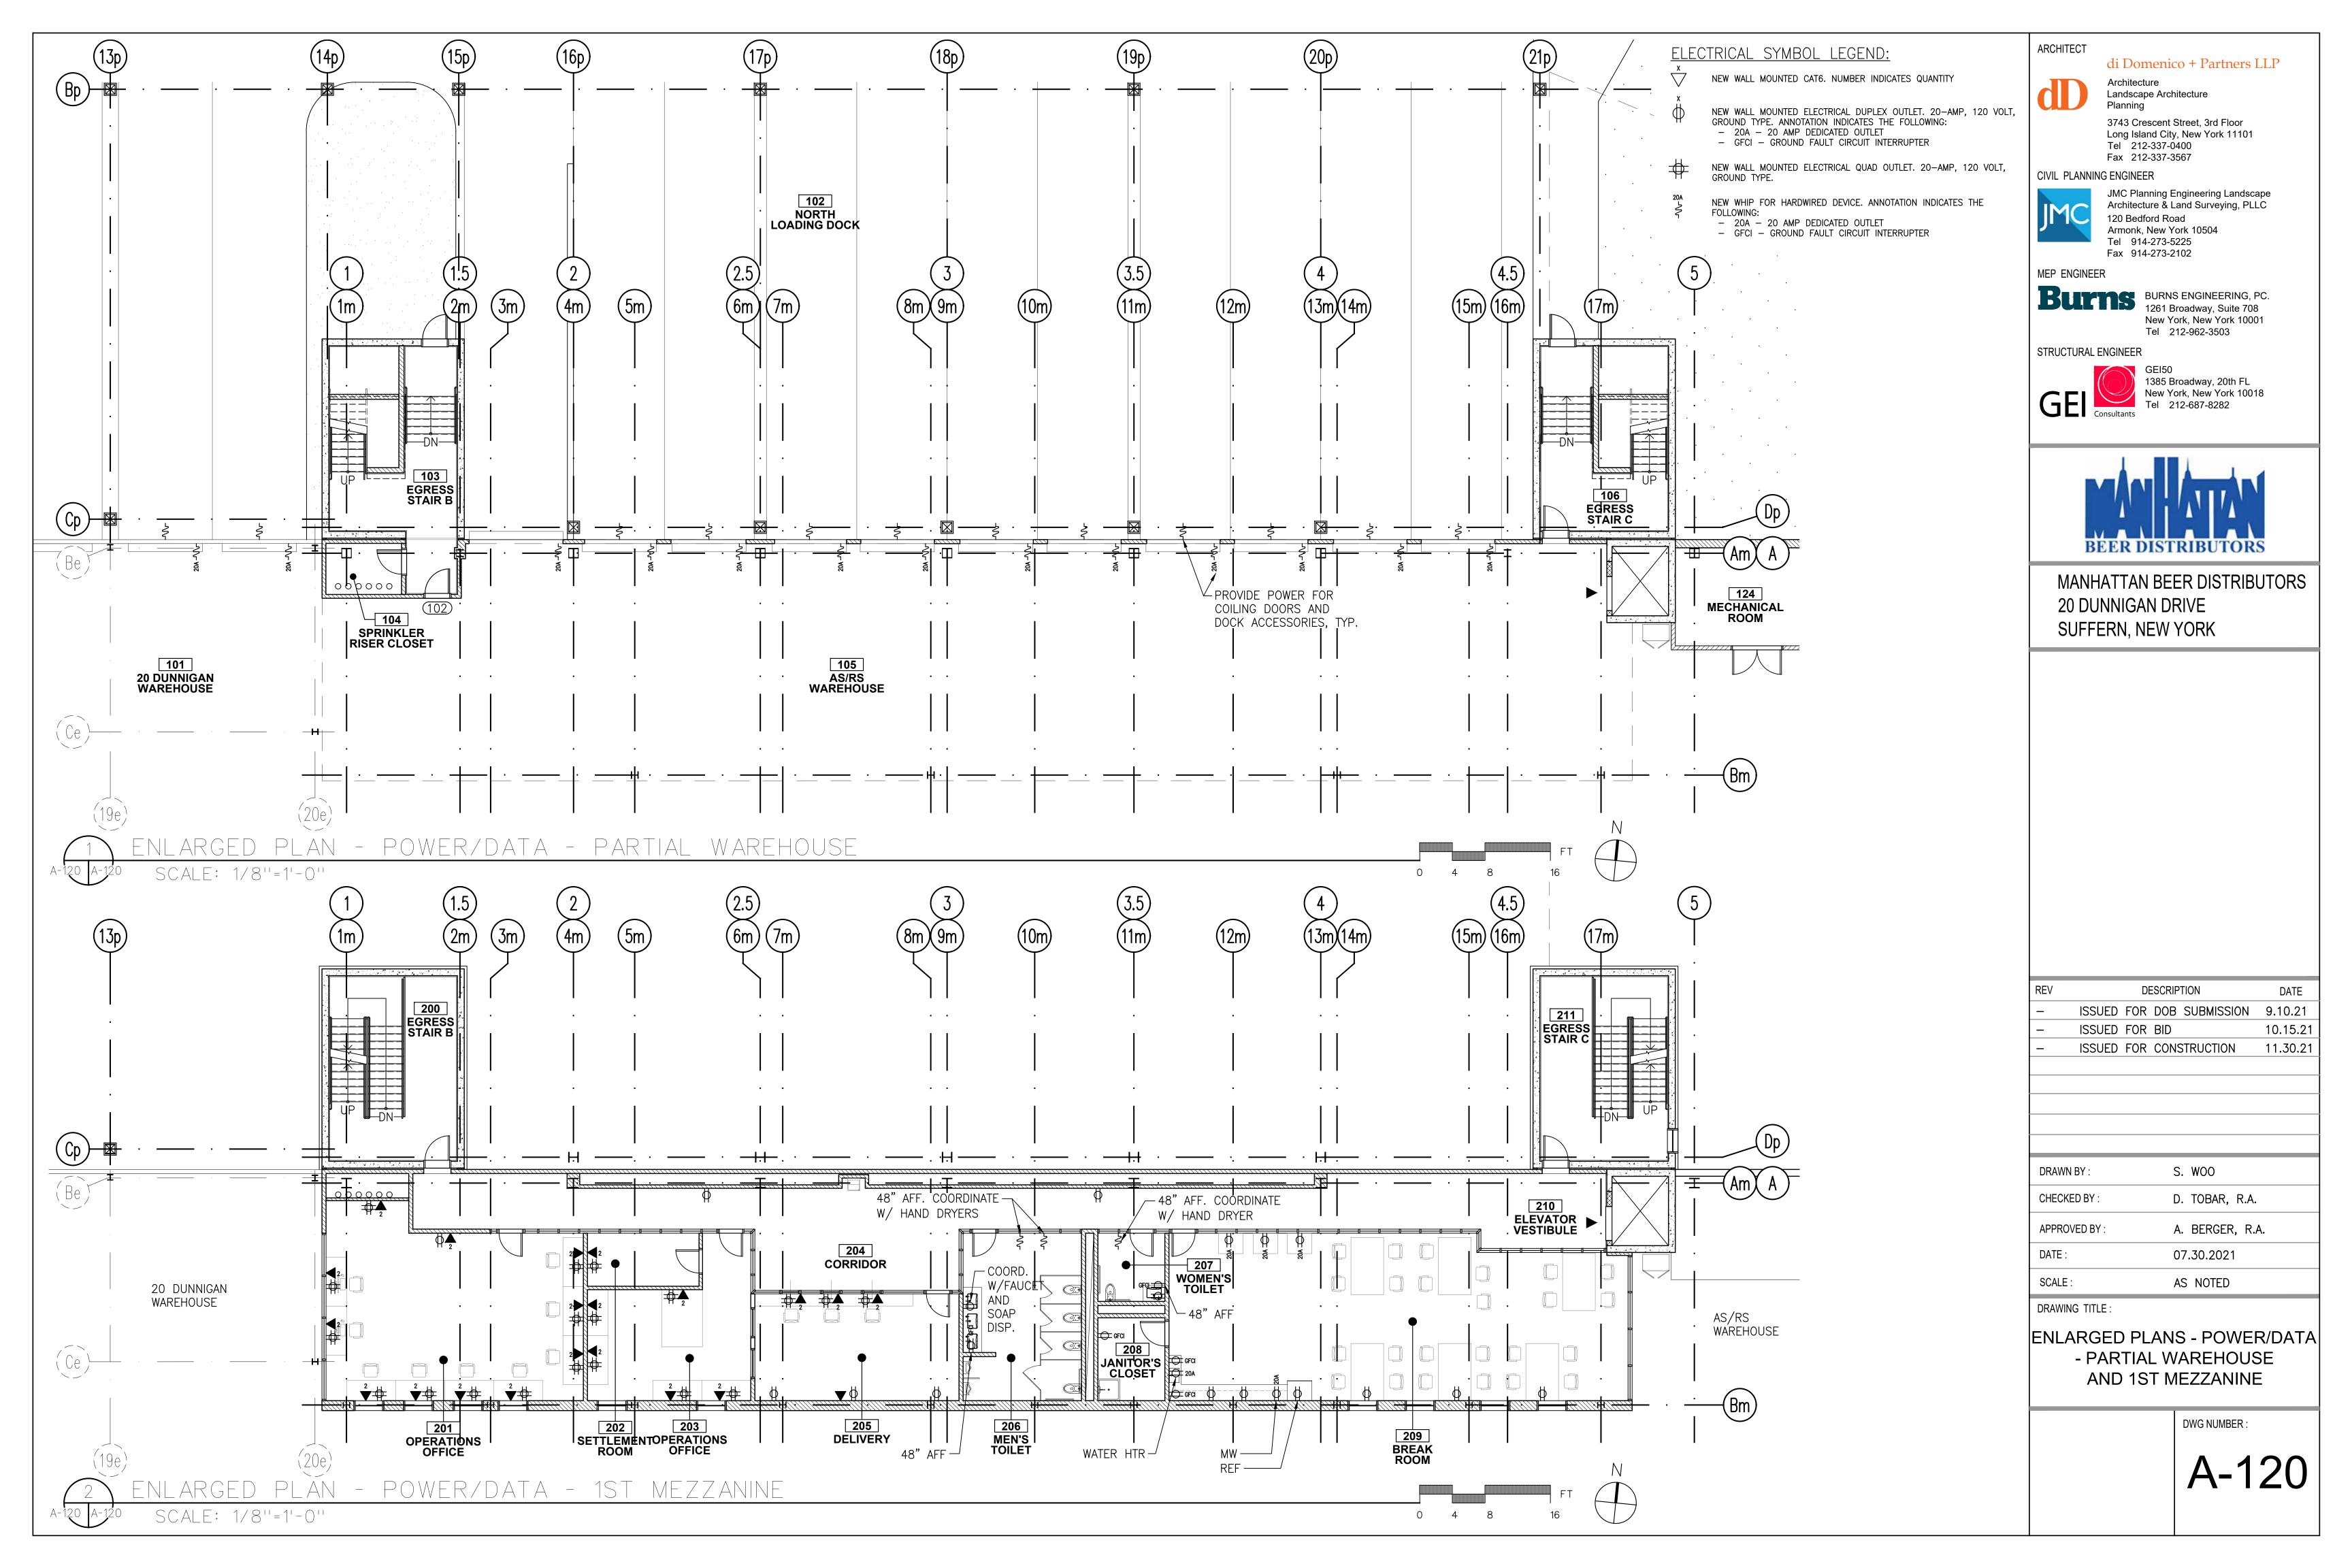



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<u>RCP KEY NOTES:</u>	Architecture
1. SEE A-608 FOR LIGHTING AND CONTROL SCHEDULES.	Landscape Architecture Planning
	3743 Crescent Street, 3rd Floor Long Island City, New York 11101
	Tel 212-337-0400 Fax 212-337-3567
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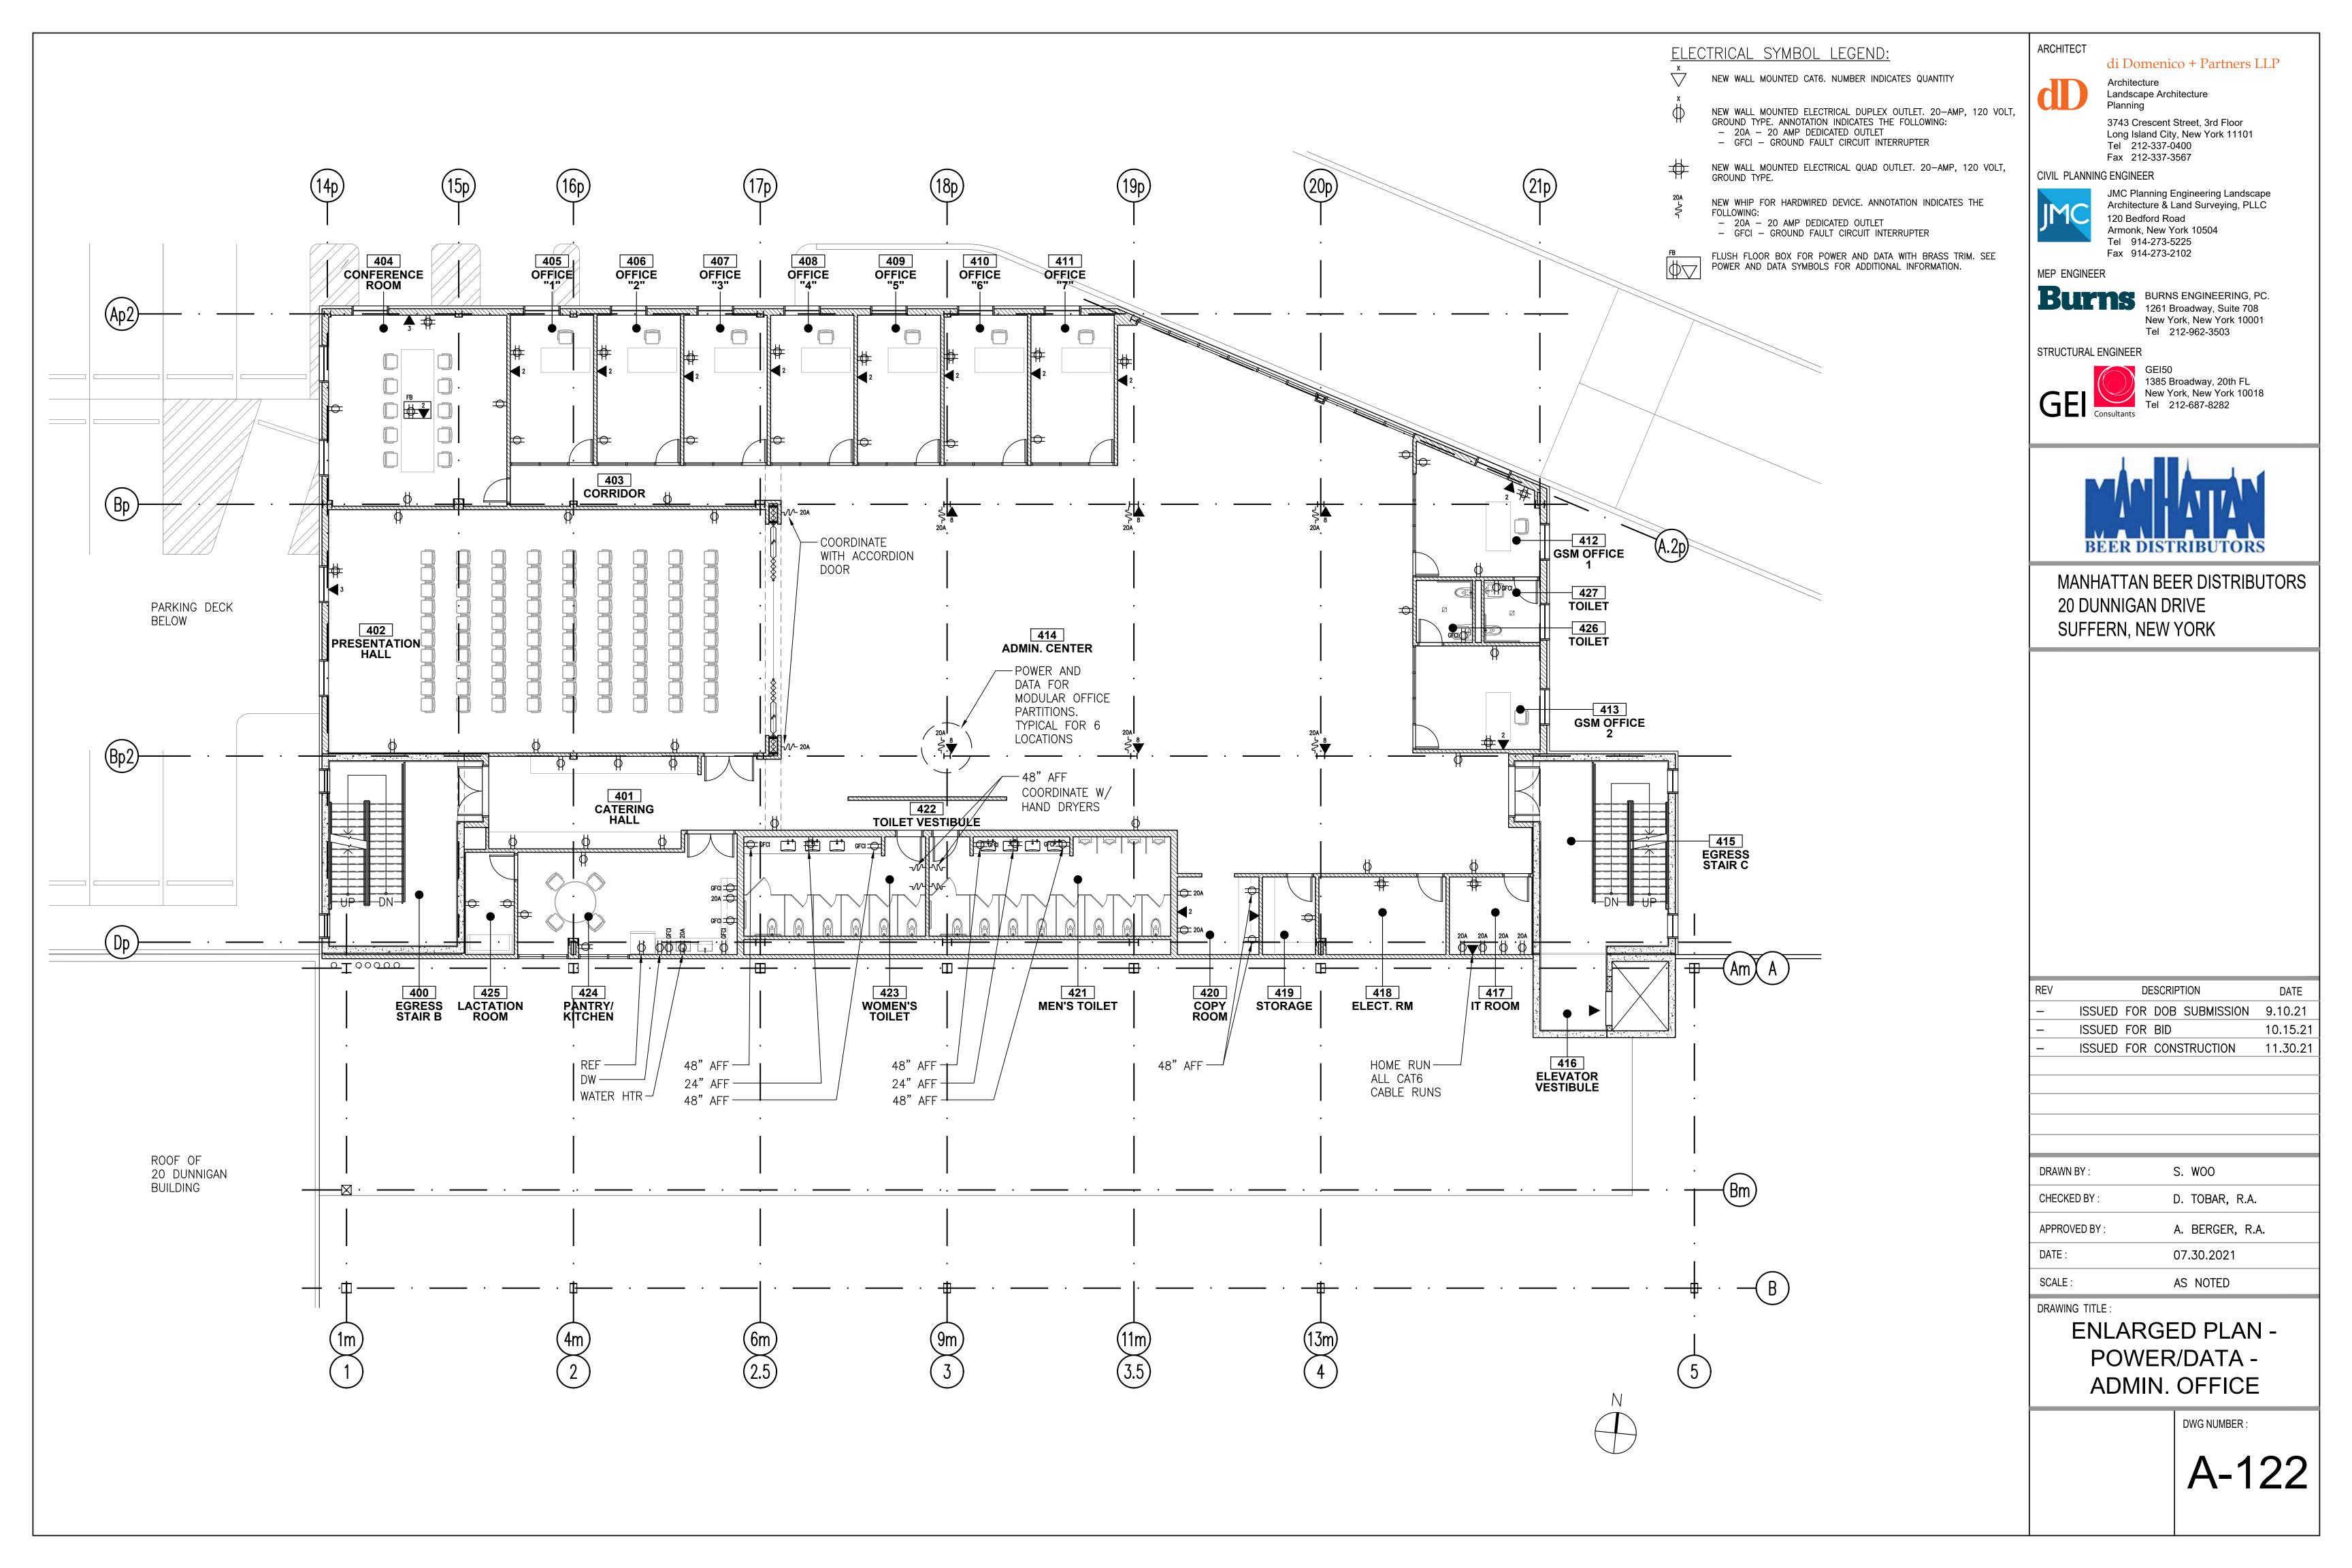


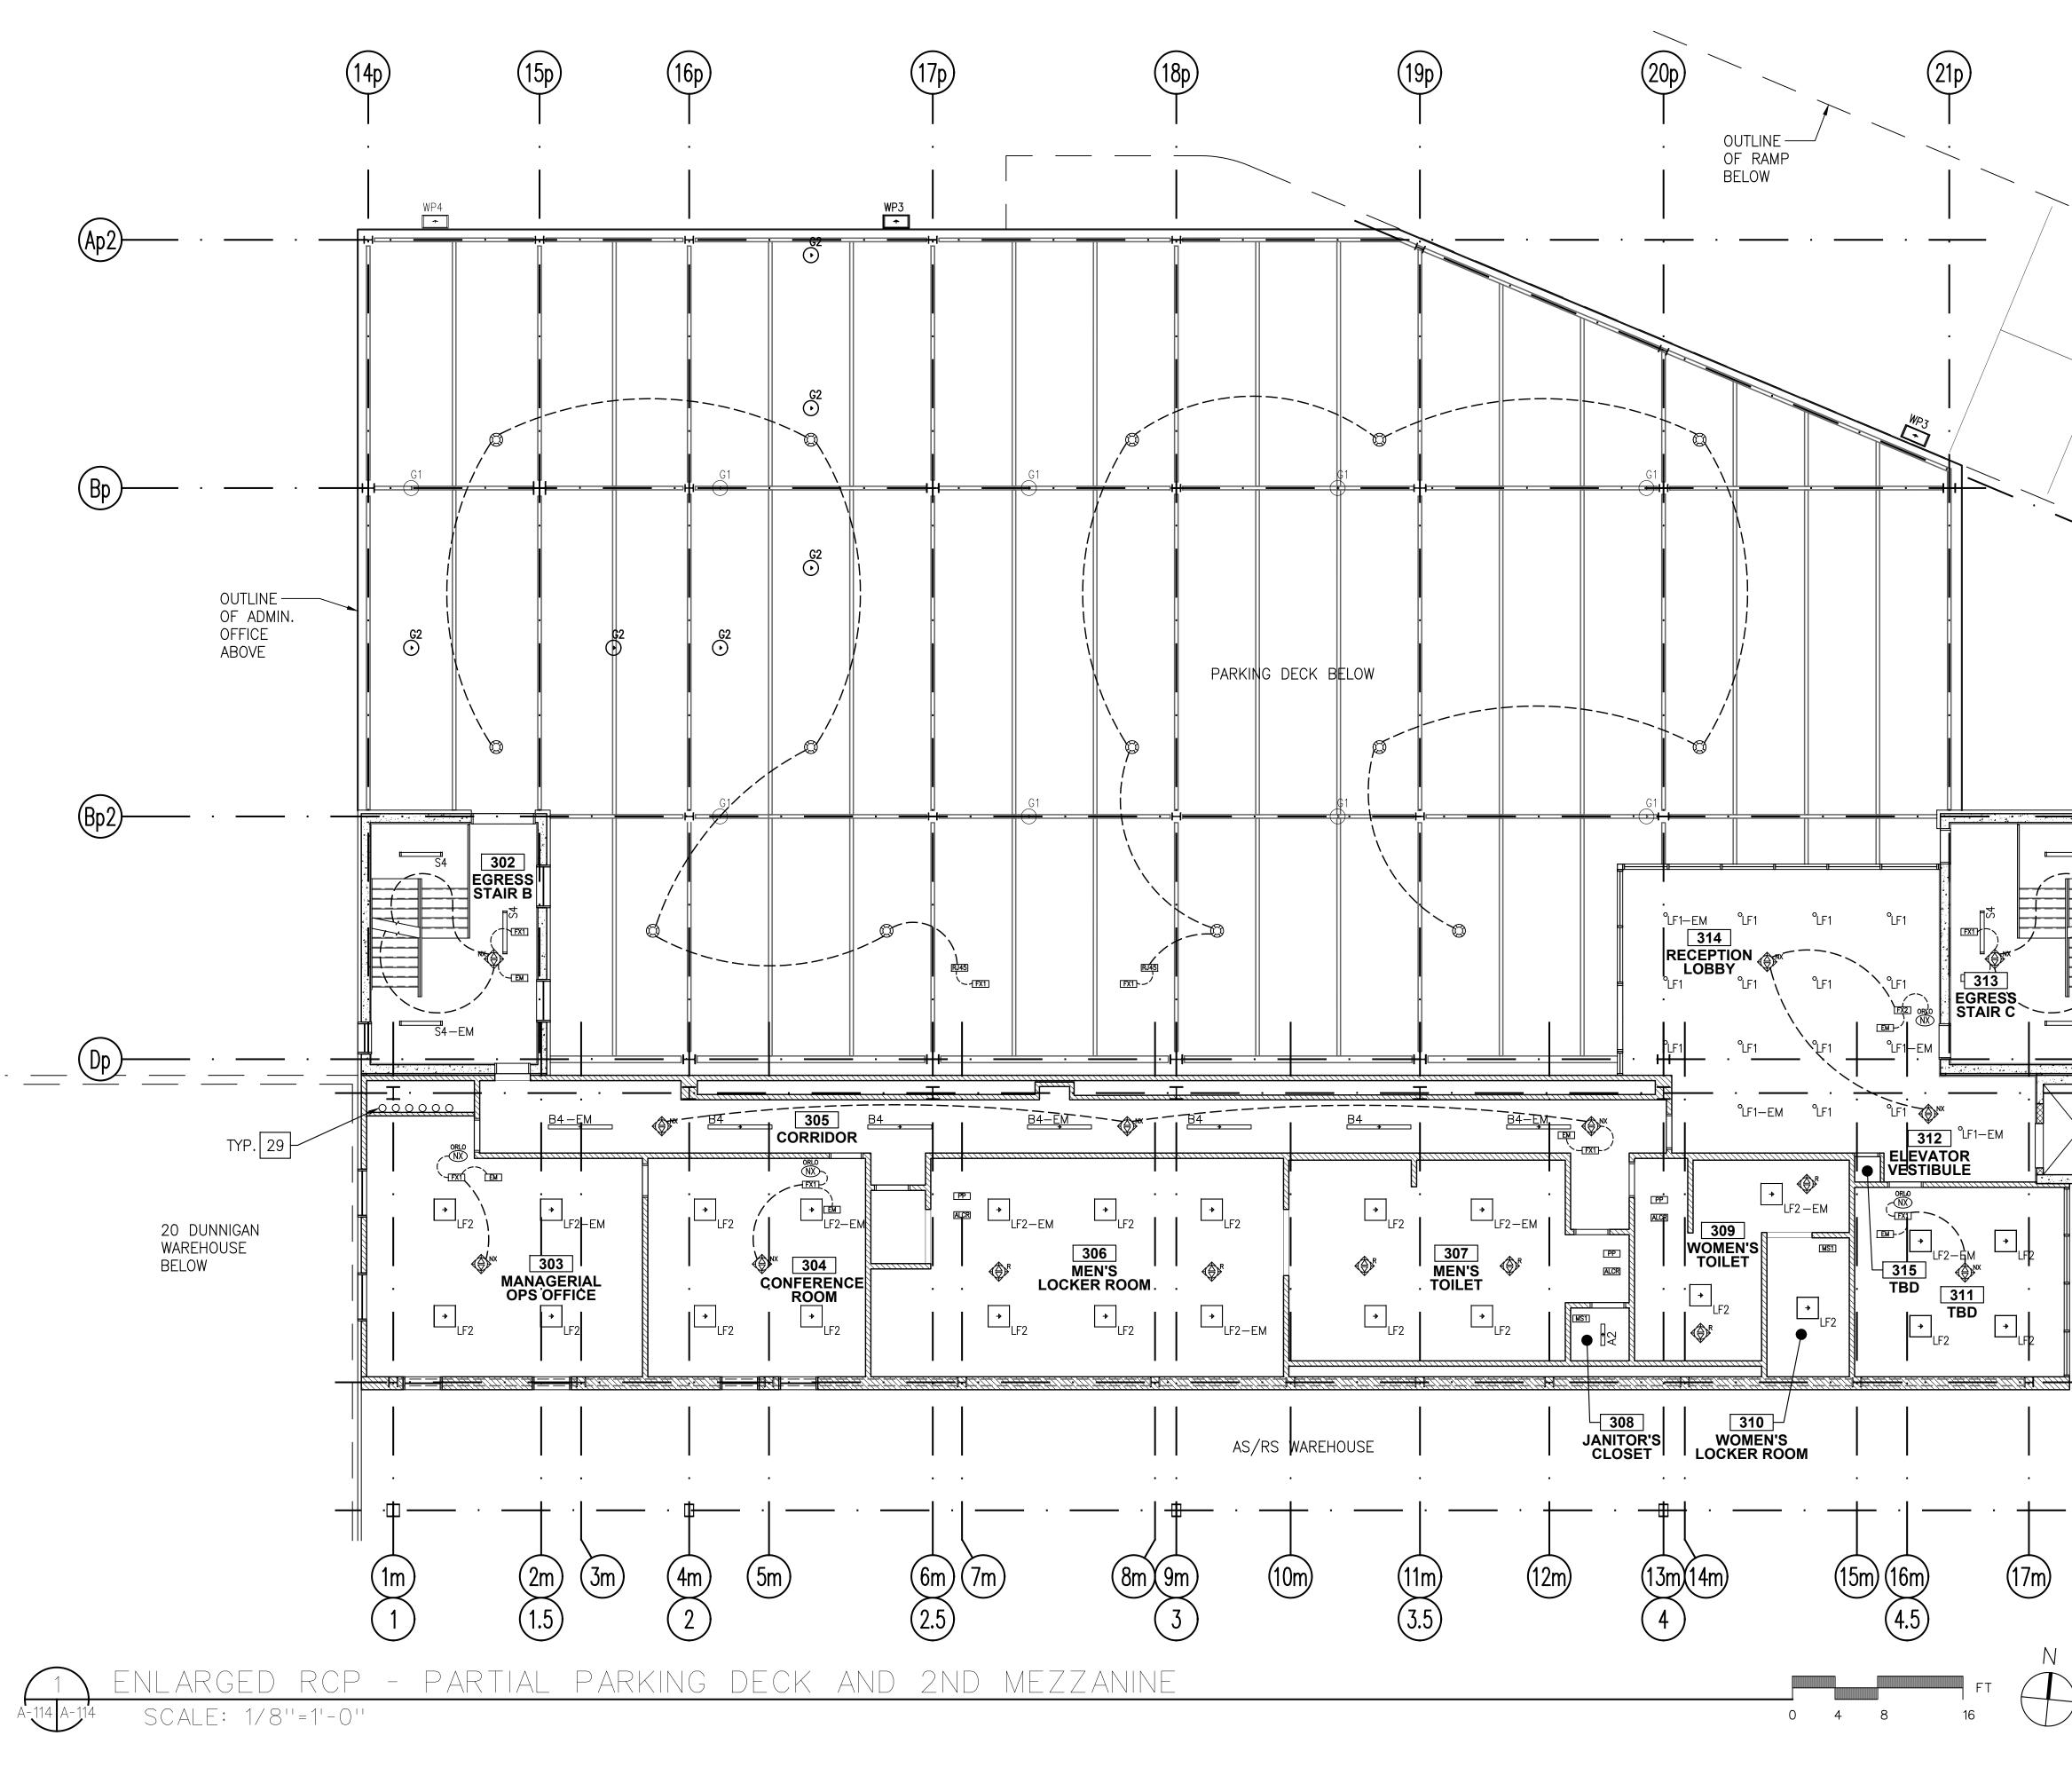



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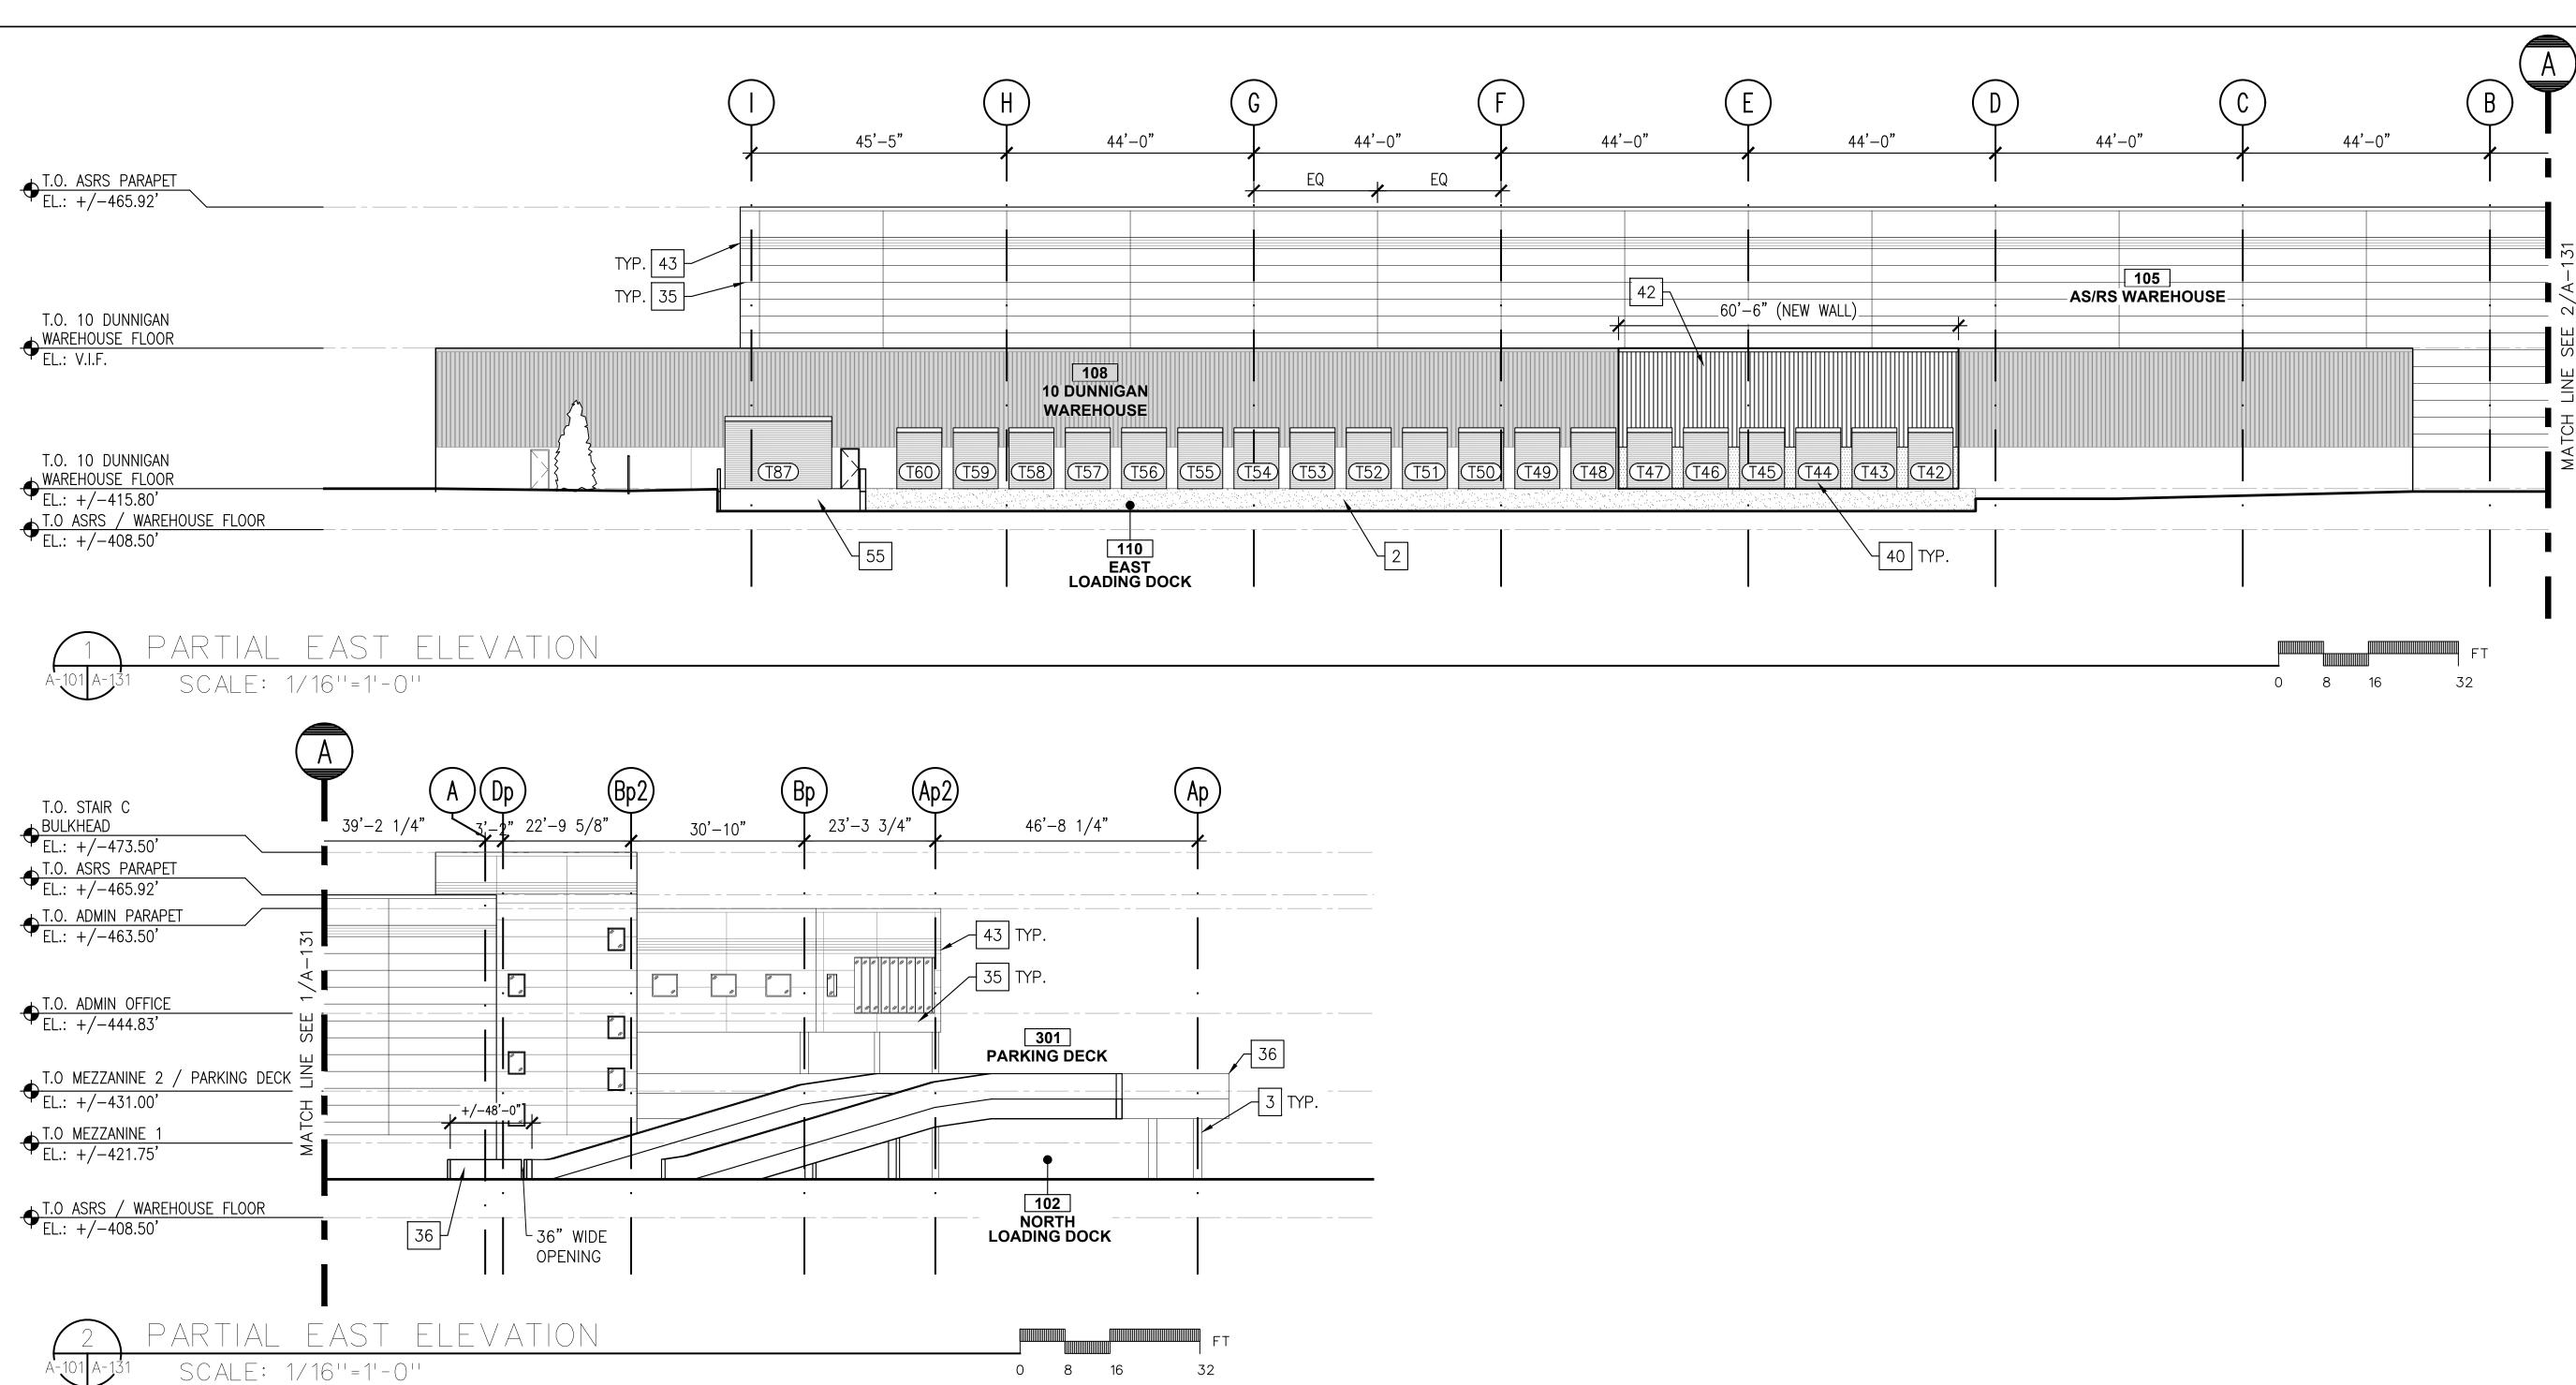




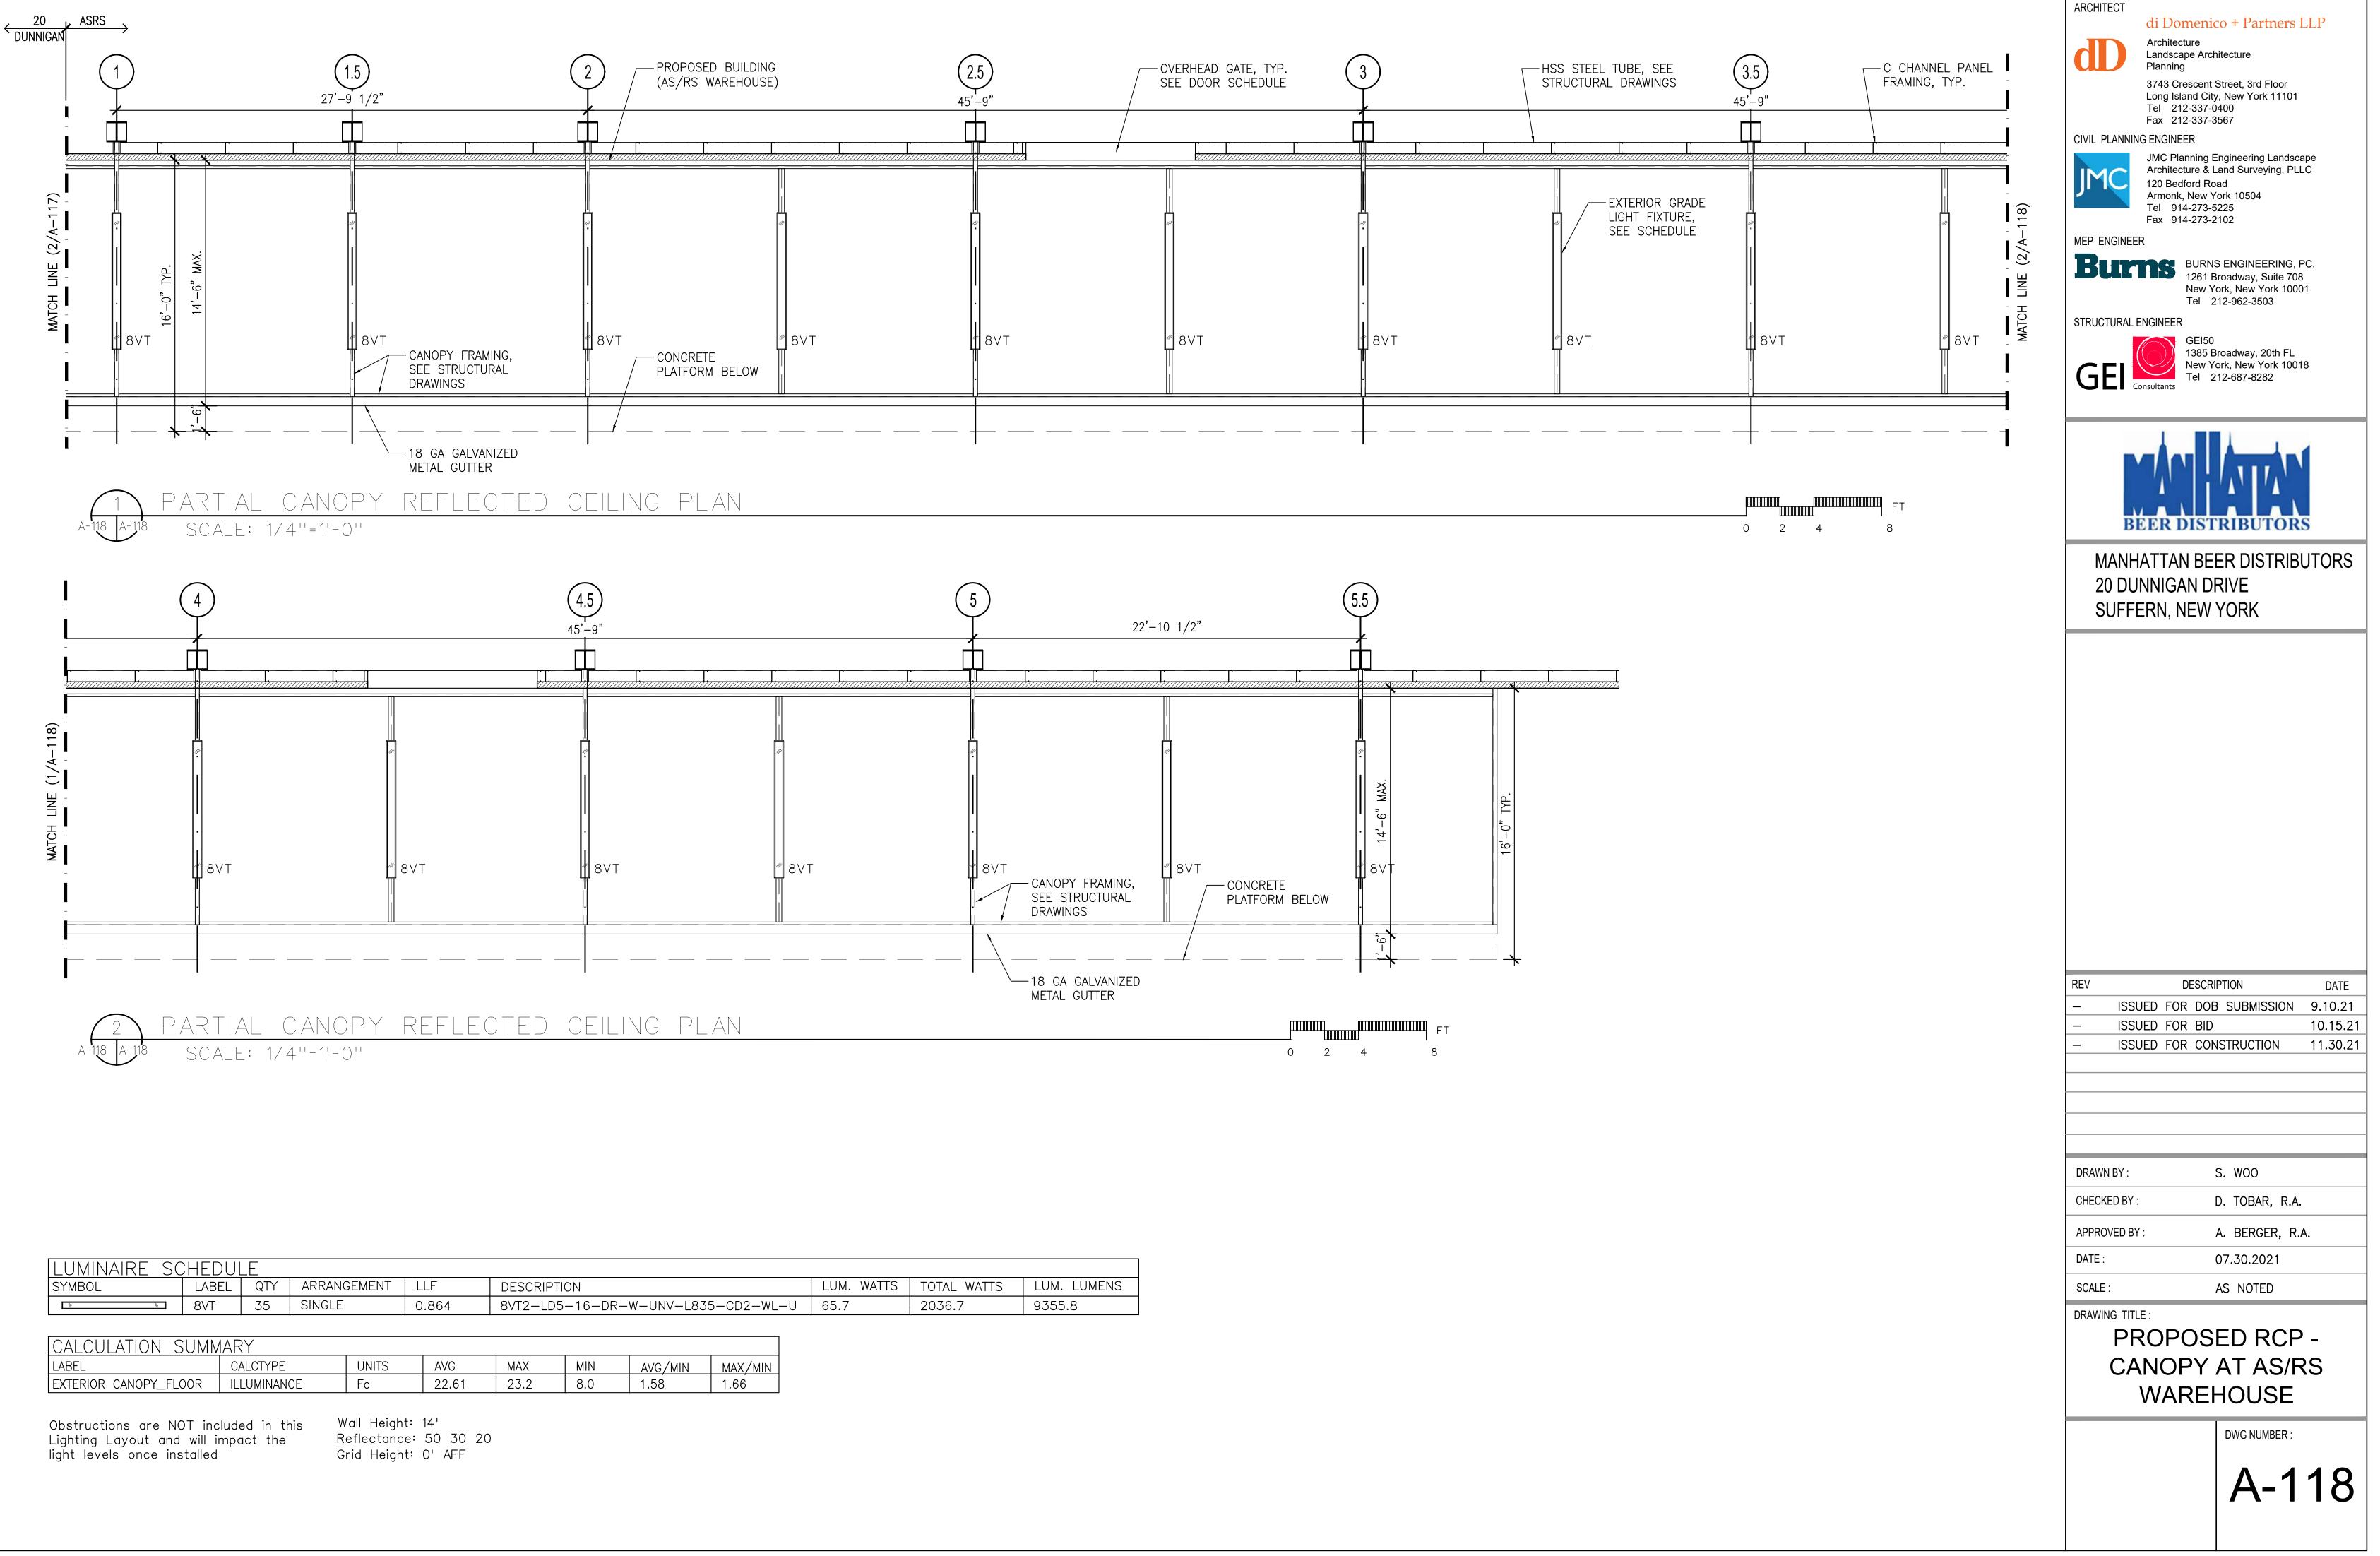

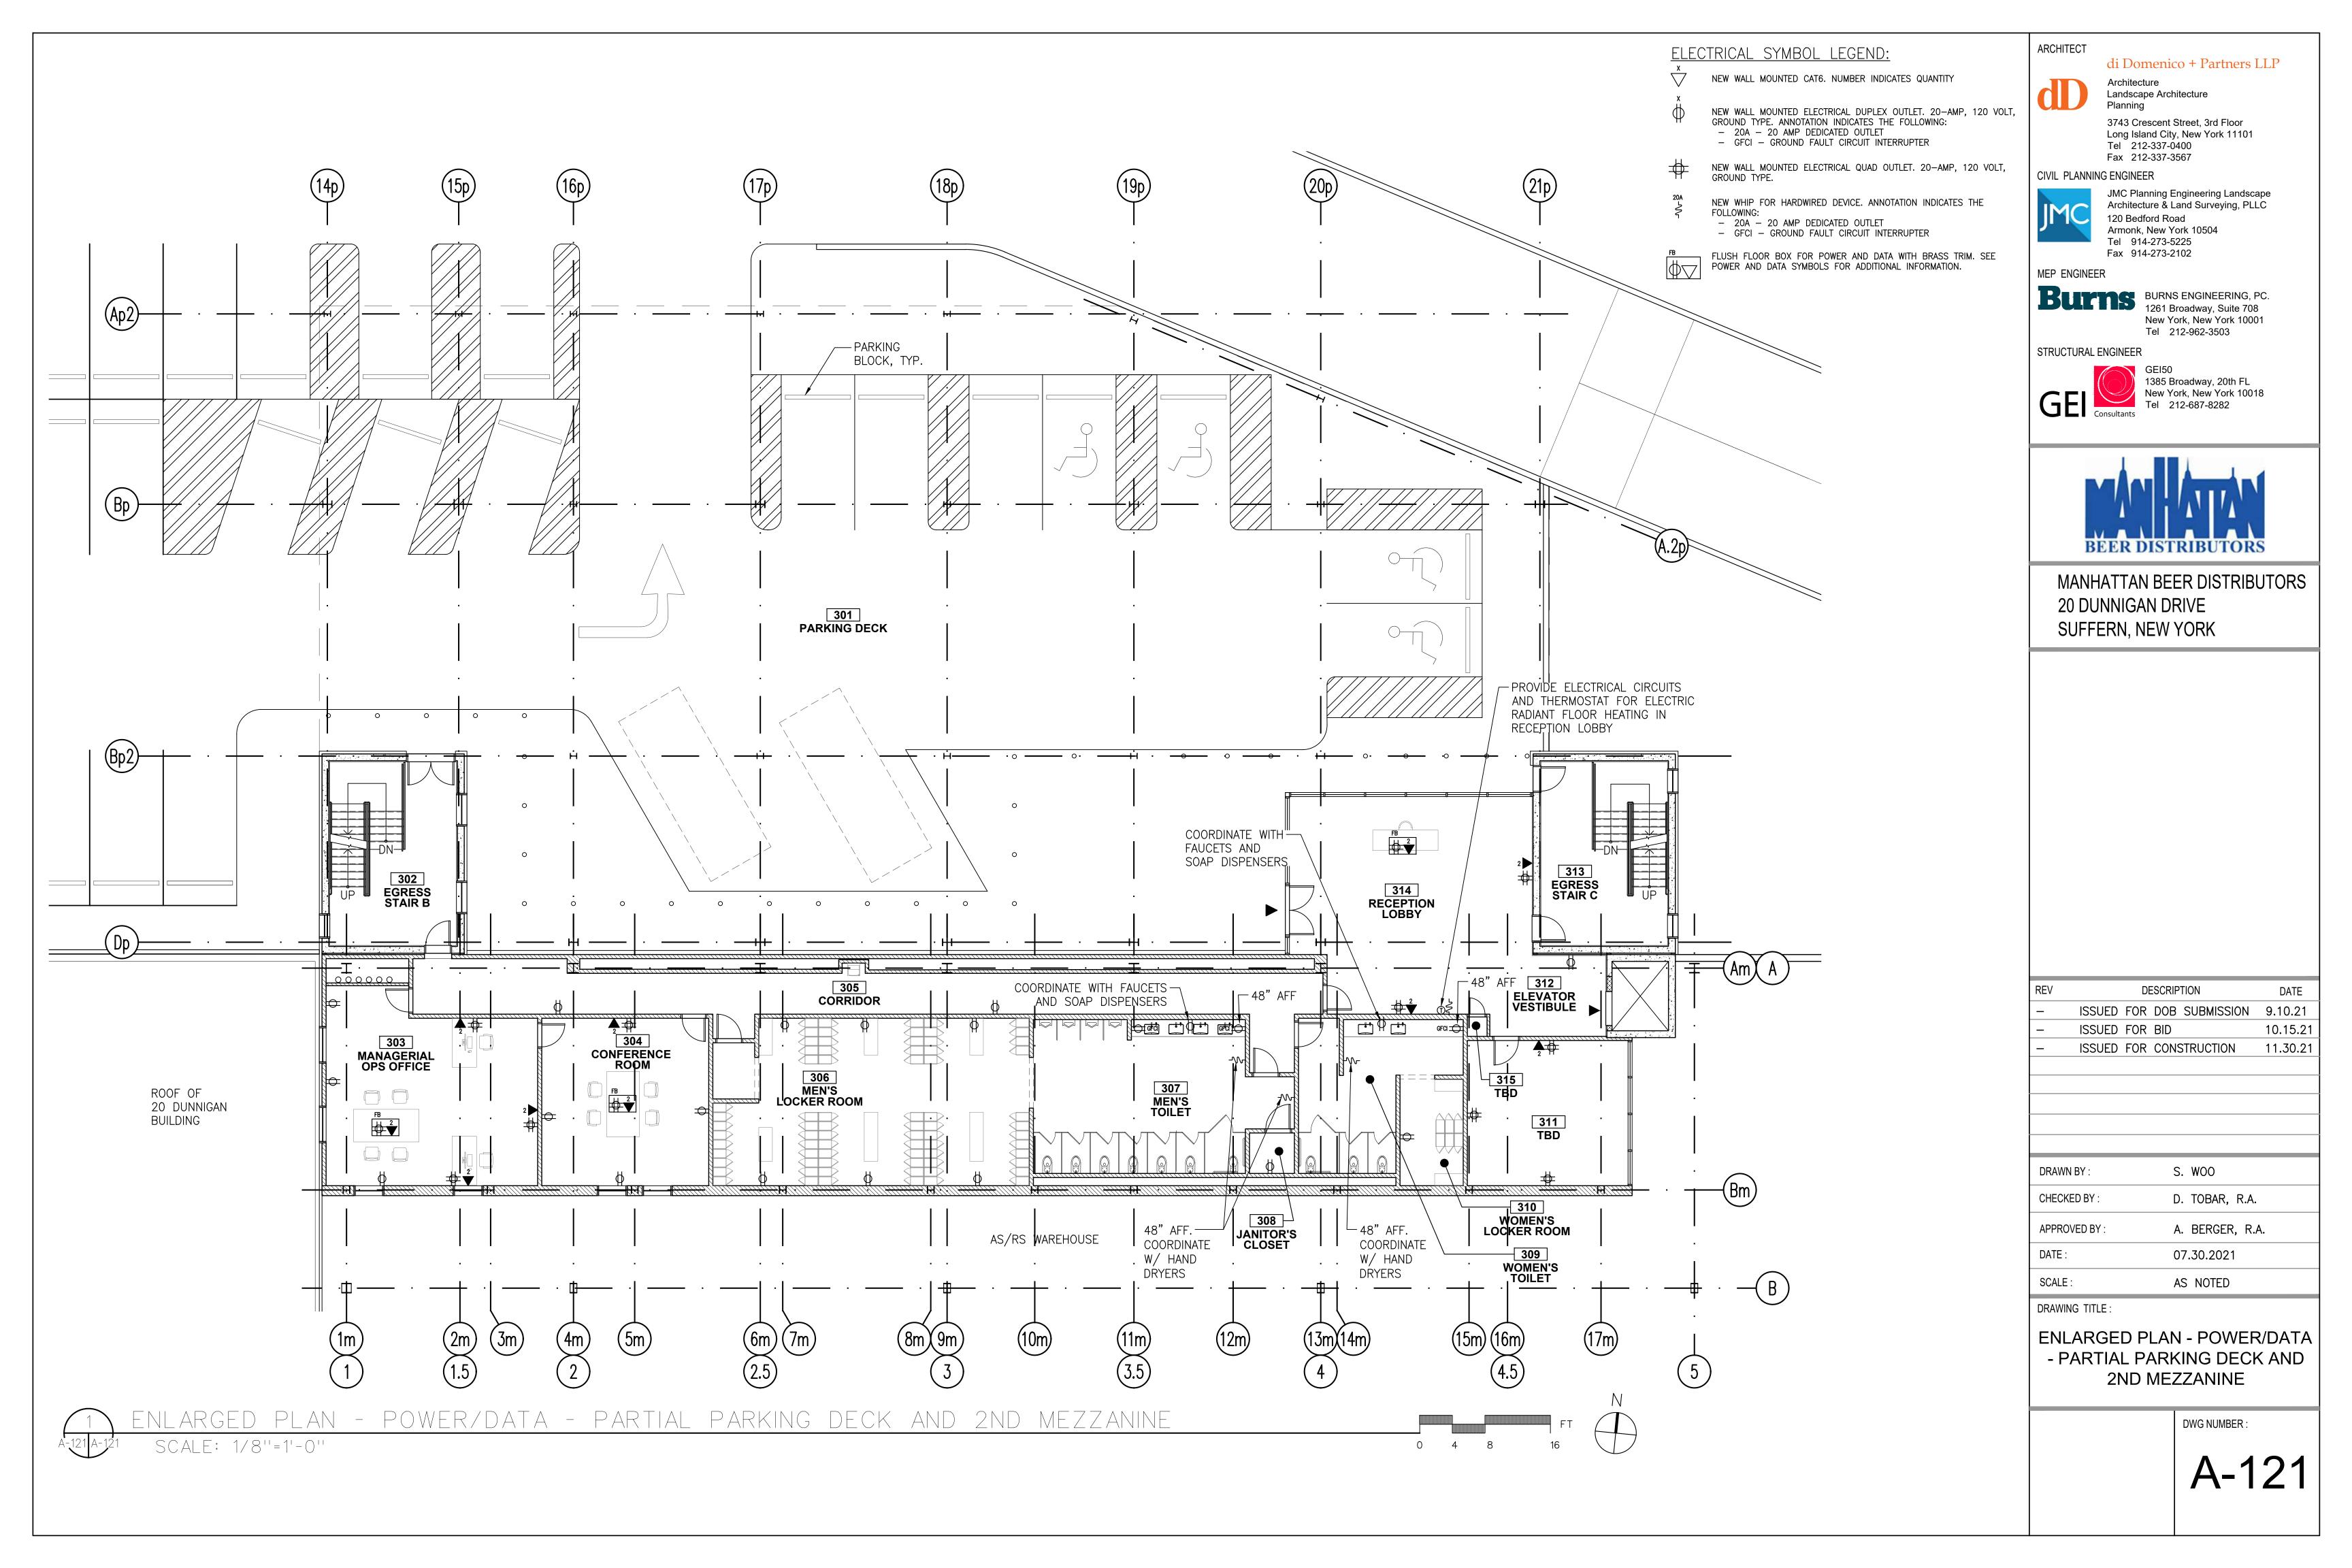

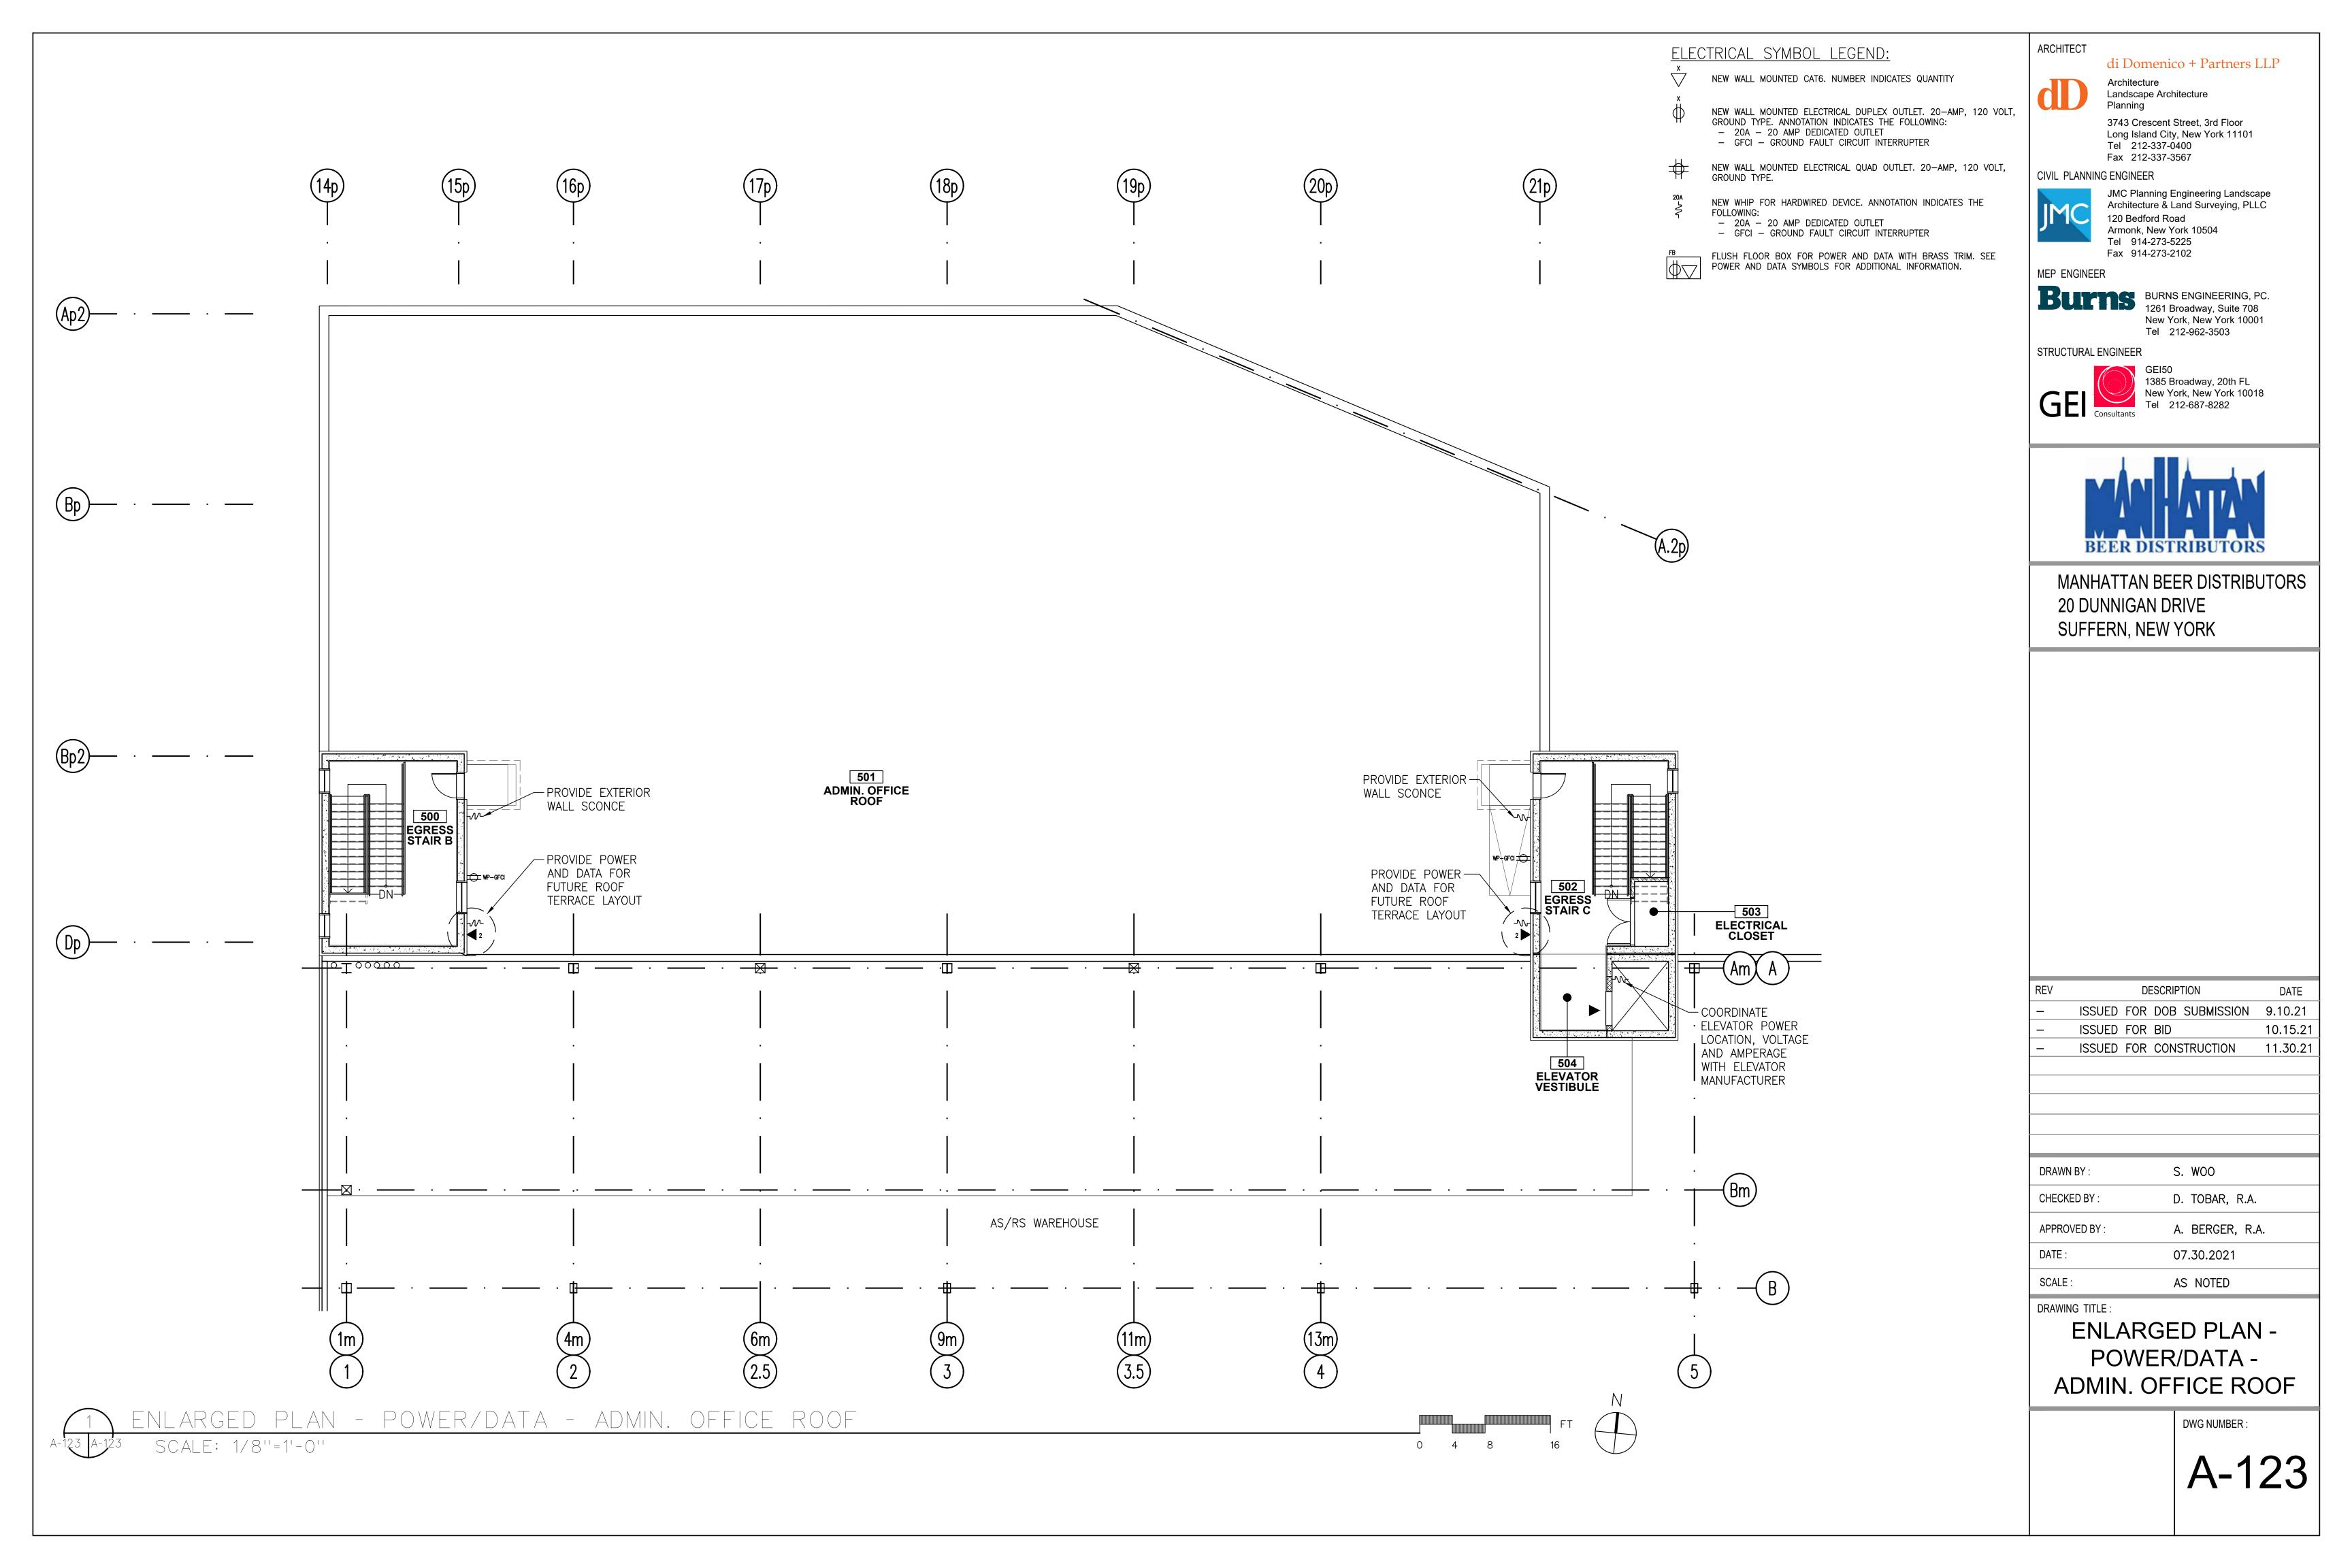

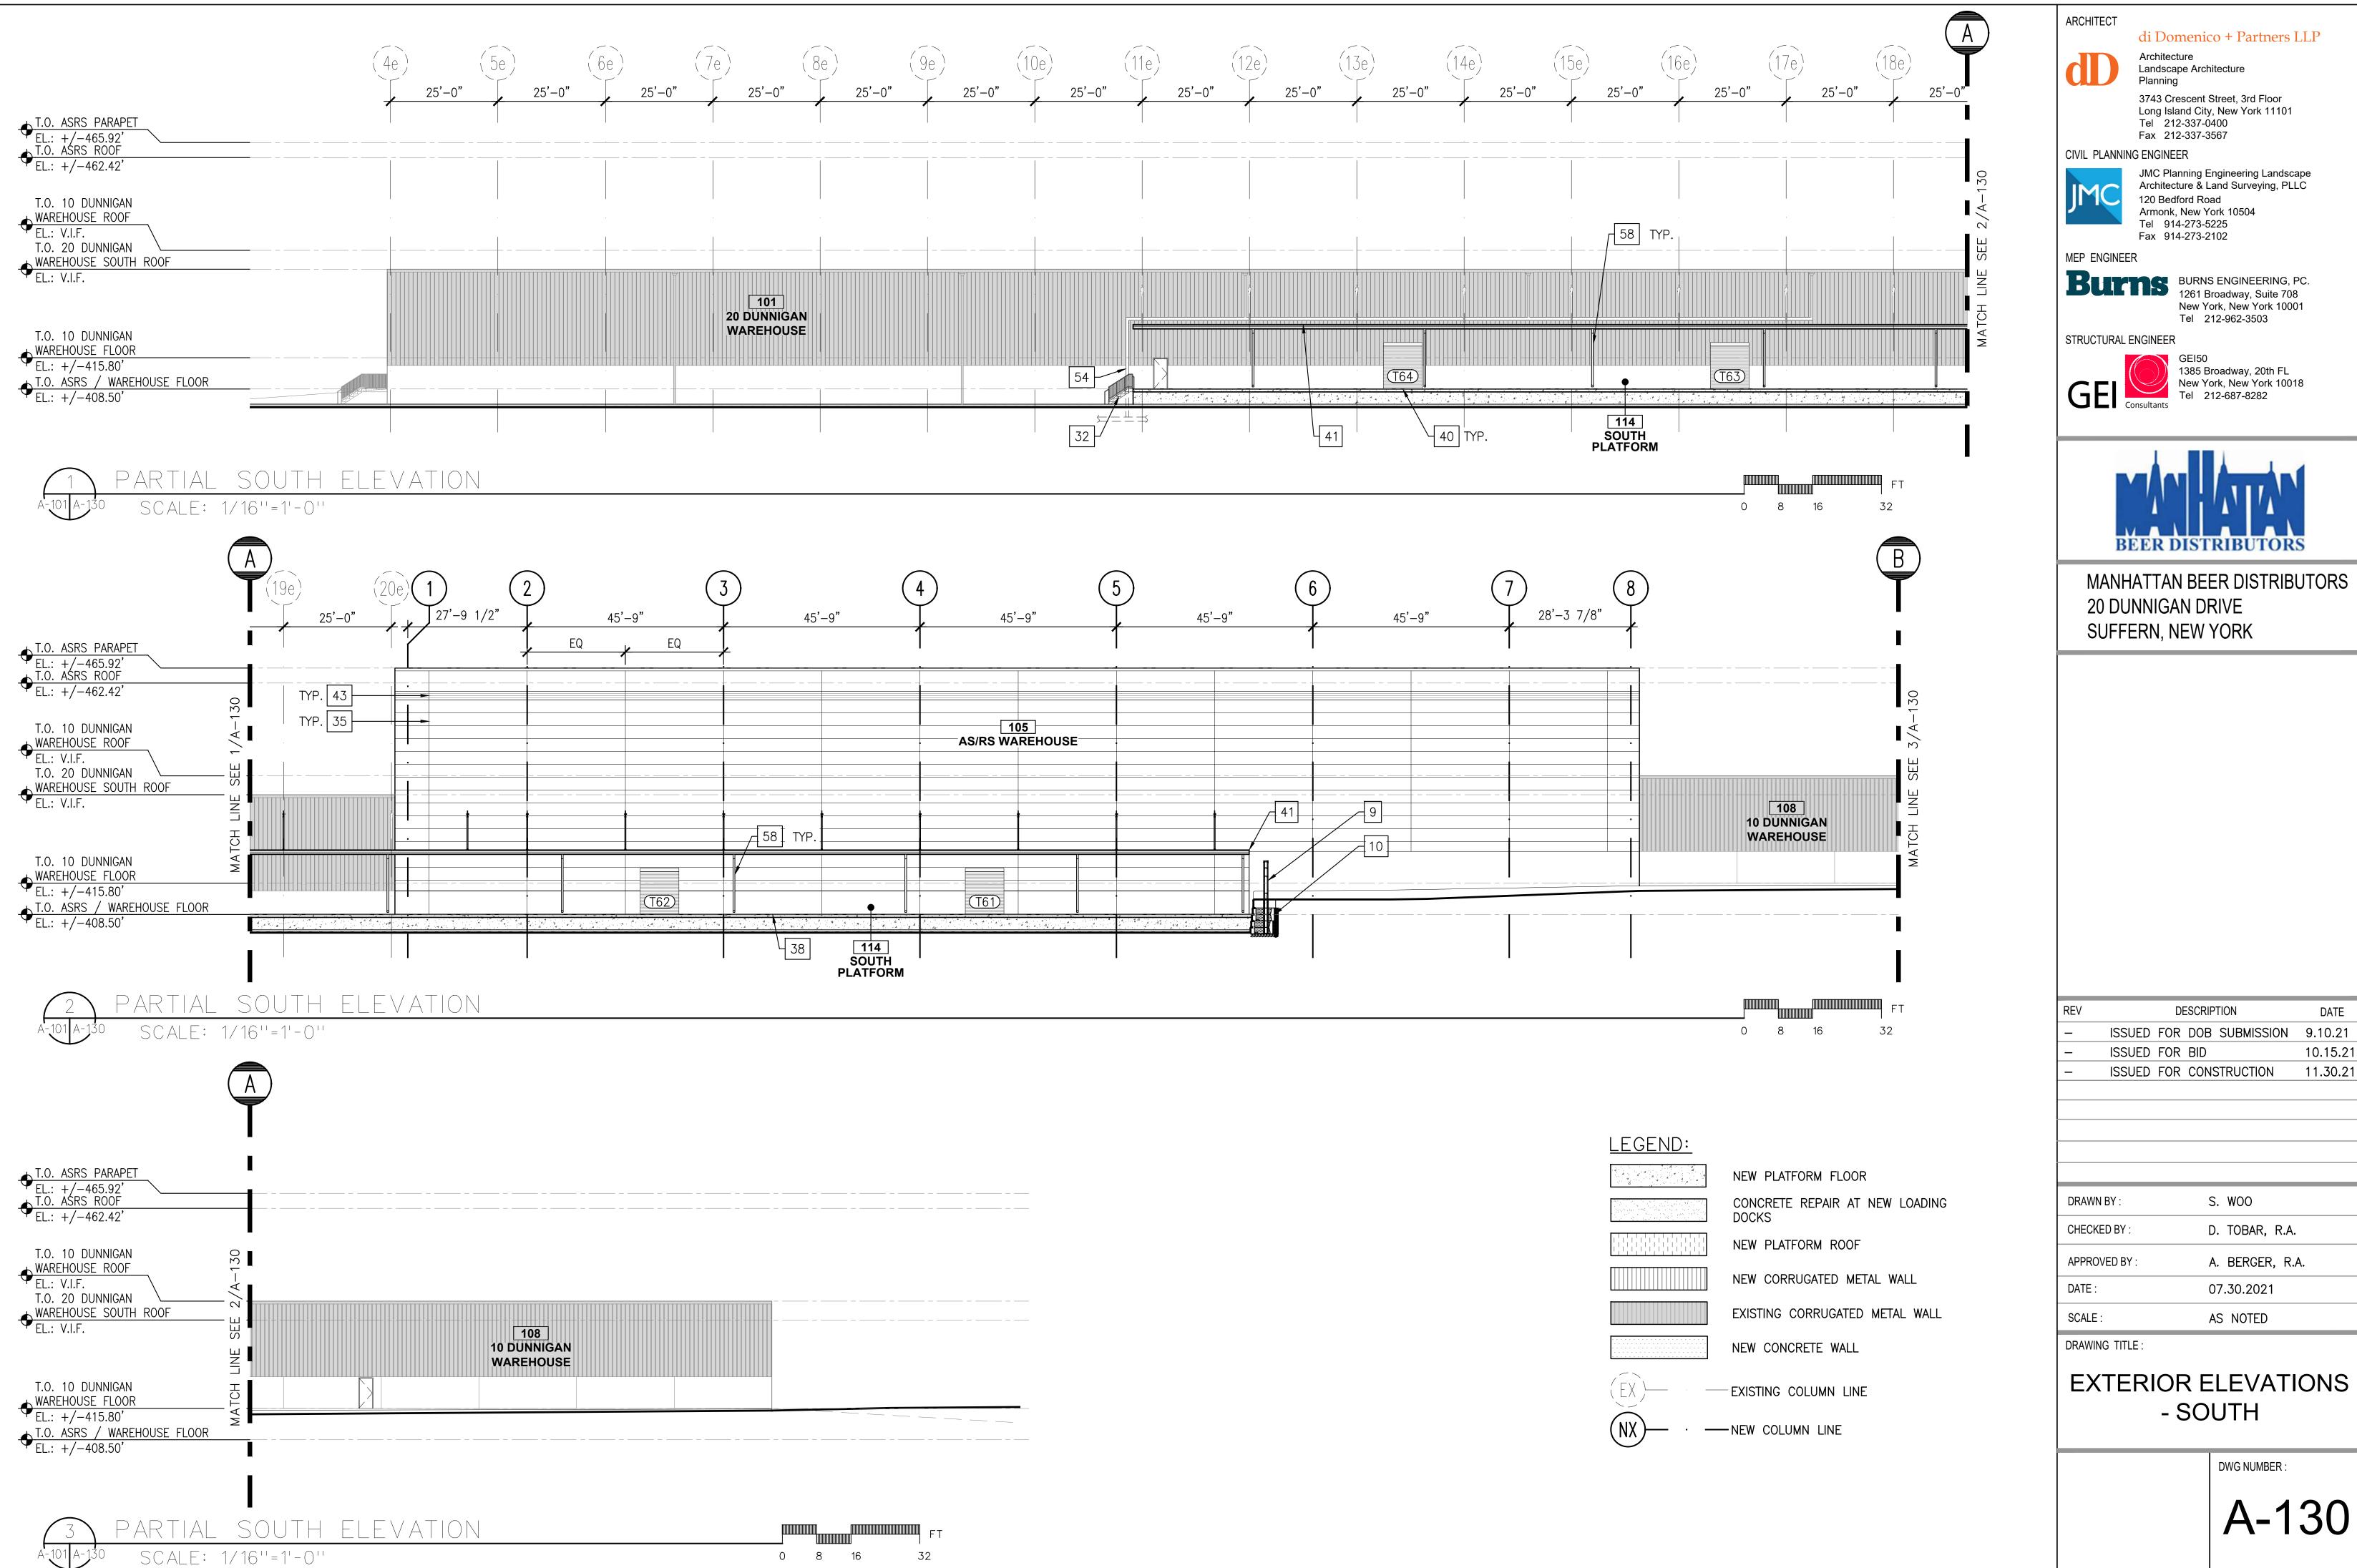

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NEW PLATFORM FLOOR

NEW PLATFORM ROOF

NEW CONCRETE WALL


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DOCKS

CONCRETE REPAIR AT NEW LOADING

NEW CORRUGATED METAL WALL

EXISTING CORRUGATED METAL WALL

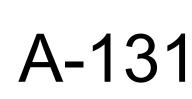

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di Domenico + Partners LLP

3743 Crescent Street, 3rd Floor Long Island City, New York 11101 Tel 212-337-0400

JMC Planning Engineering Landscape Architecture & Land Surveying, PLLC

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Planning

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Landscape Architecture

Fax 212-337-3567

120 Bedford Road Armonk, New York 10504

Tel 914-273-5225


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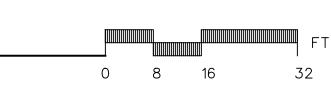



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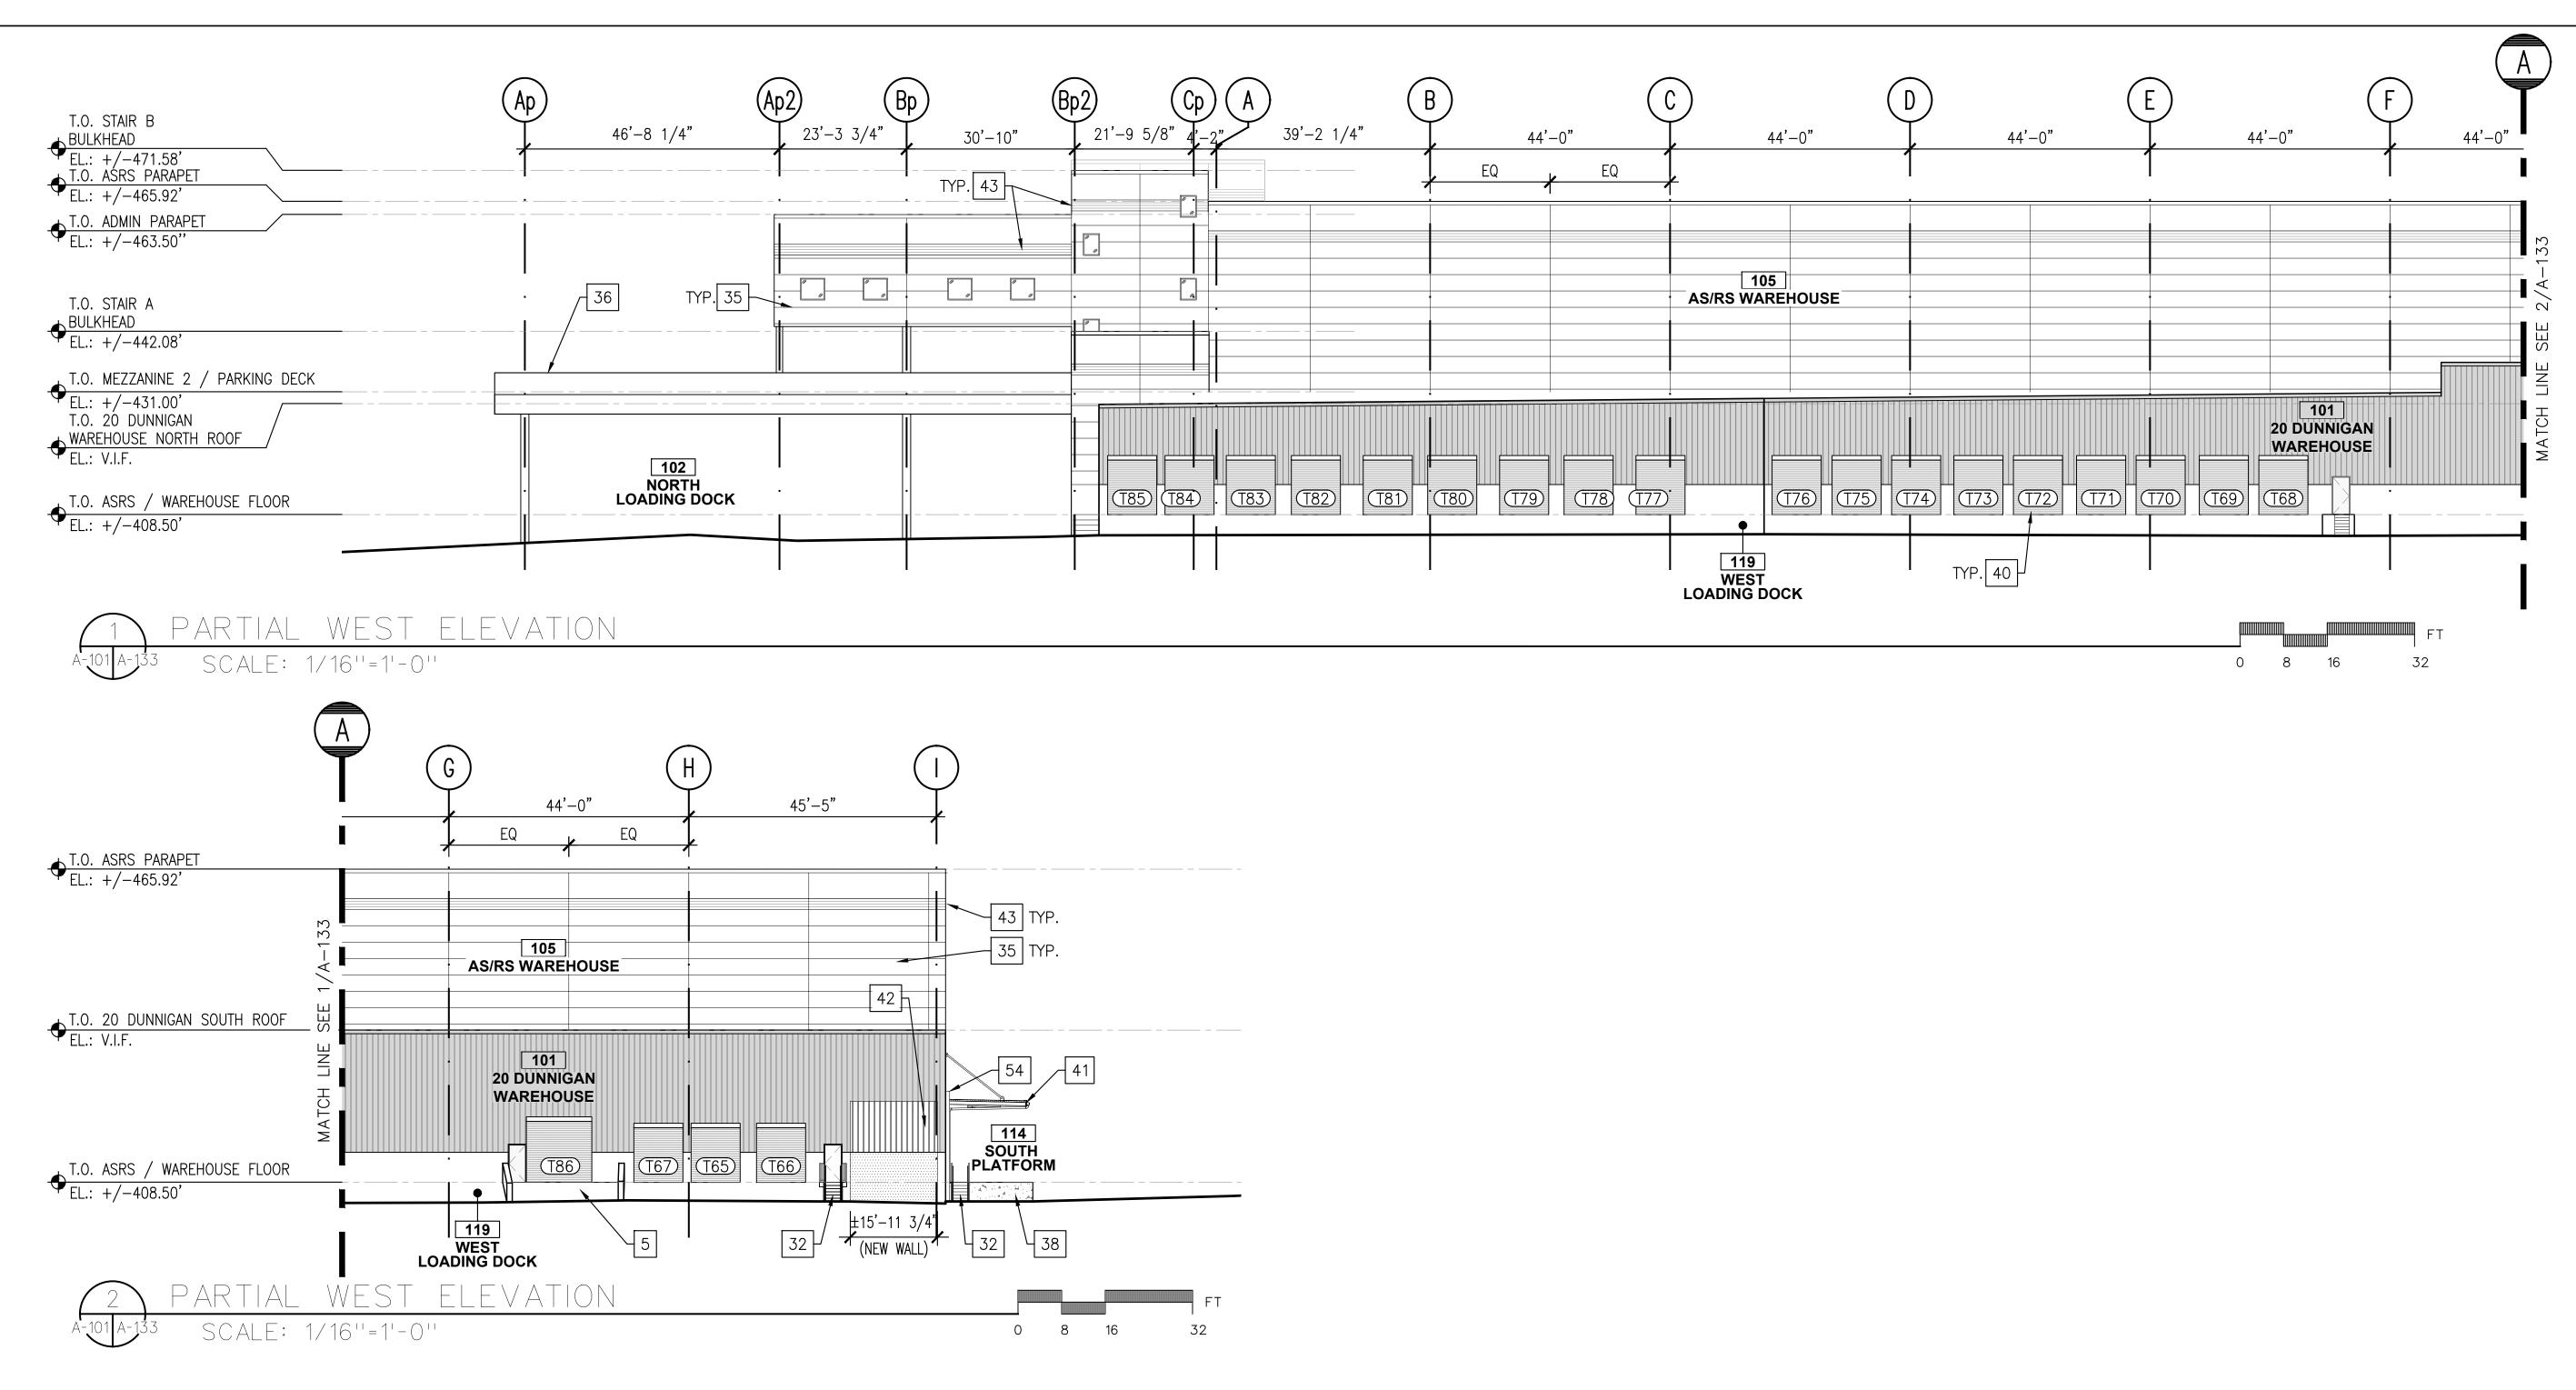






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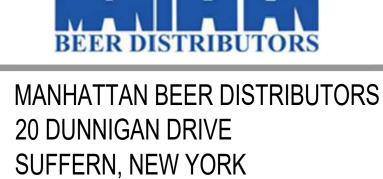

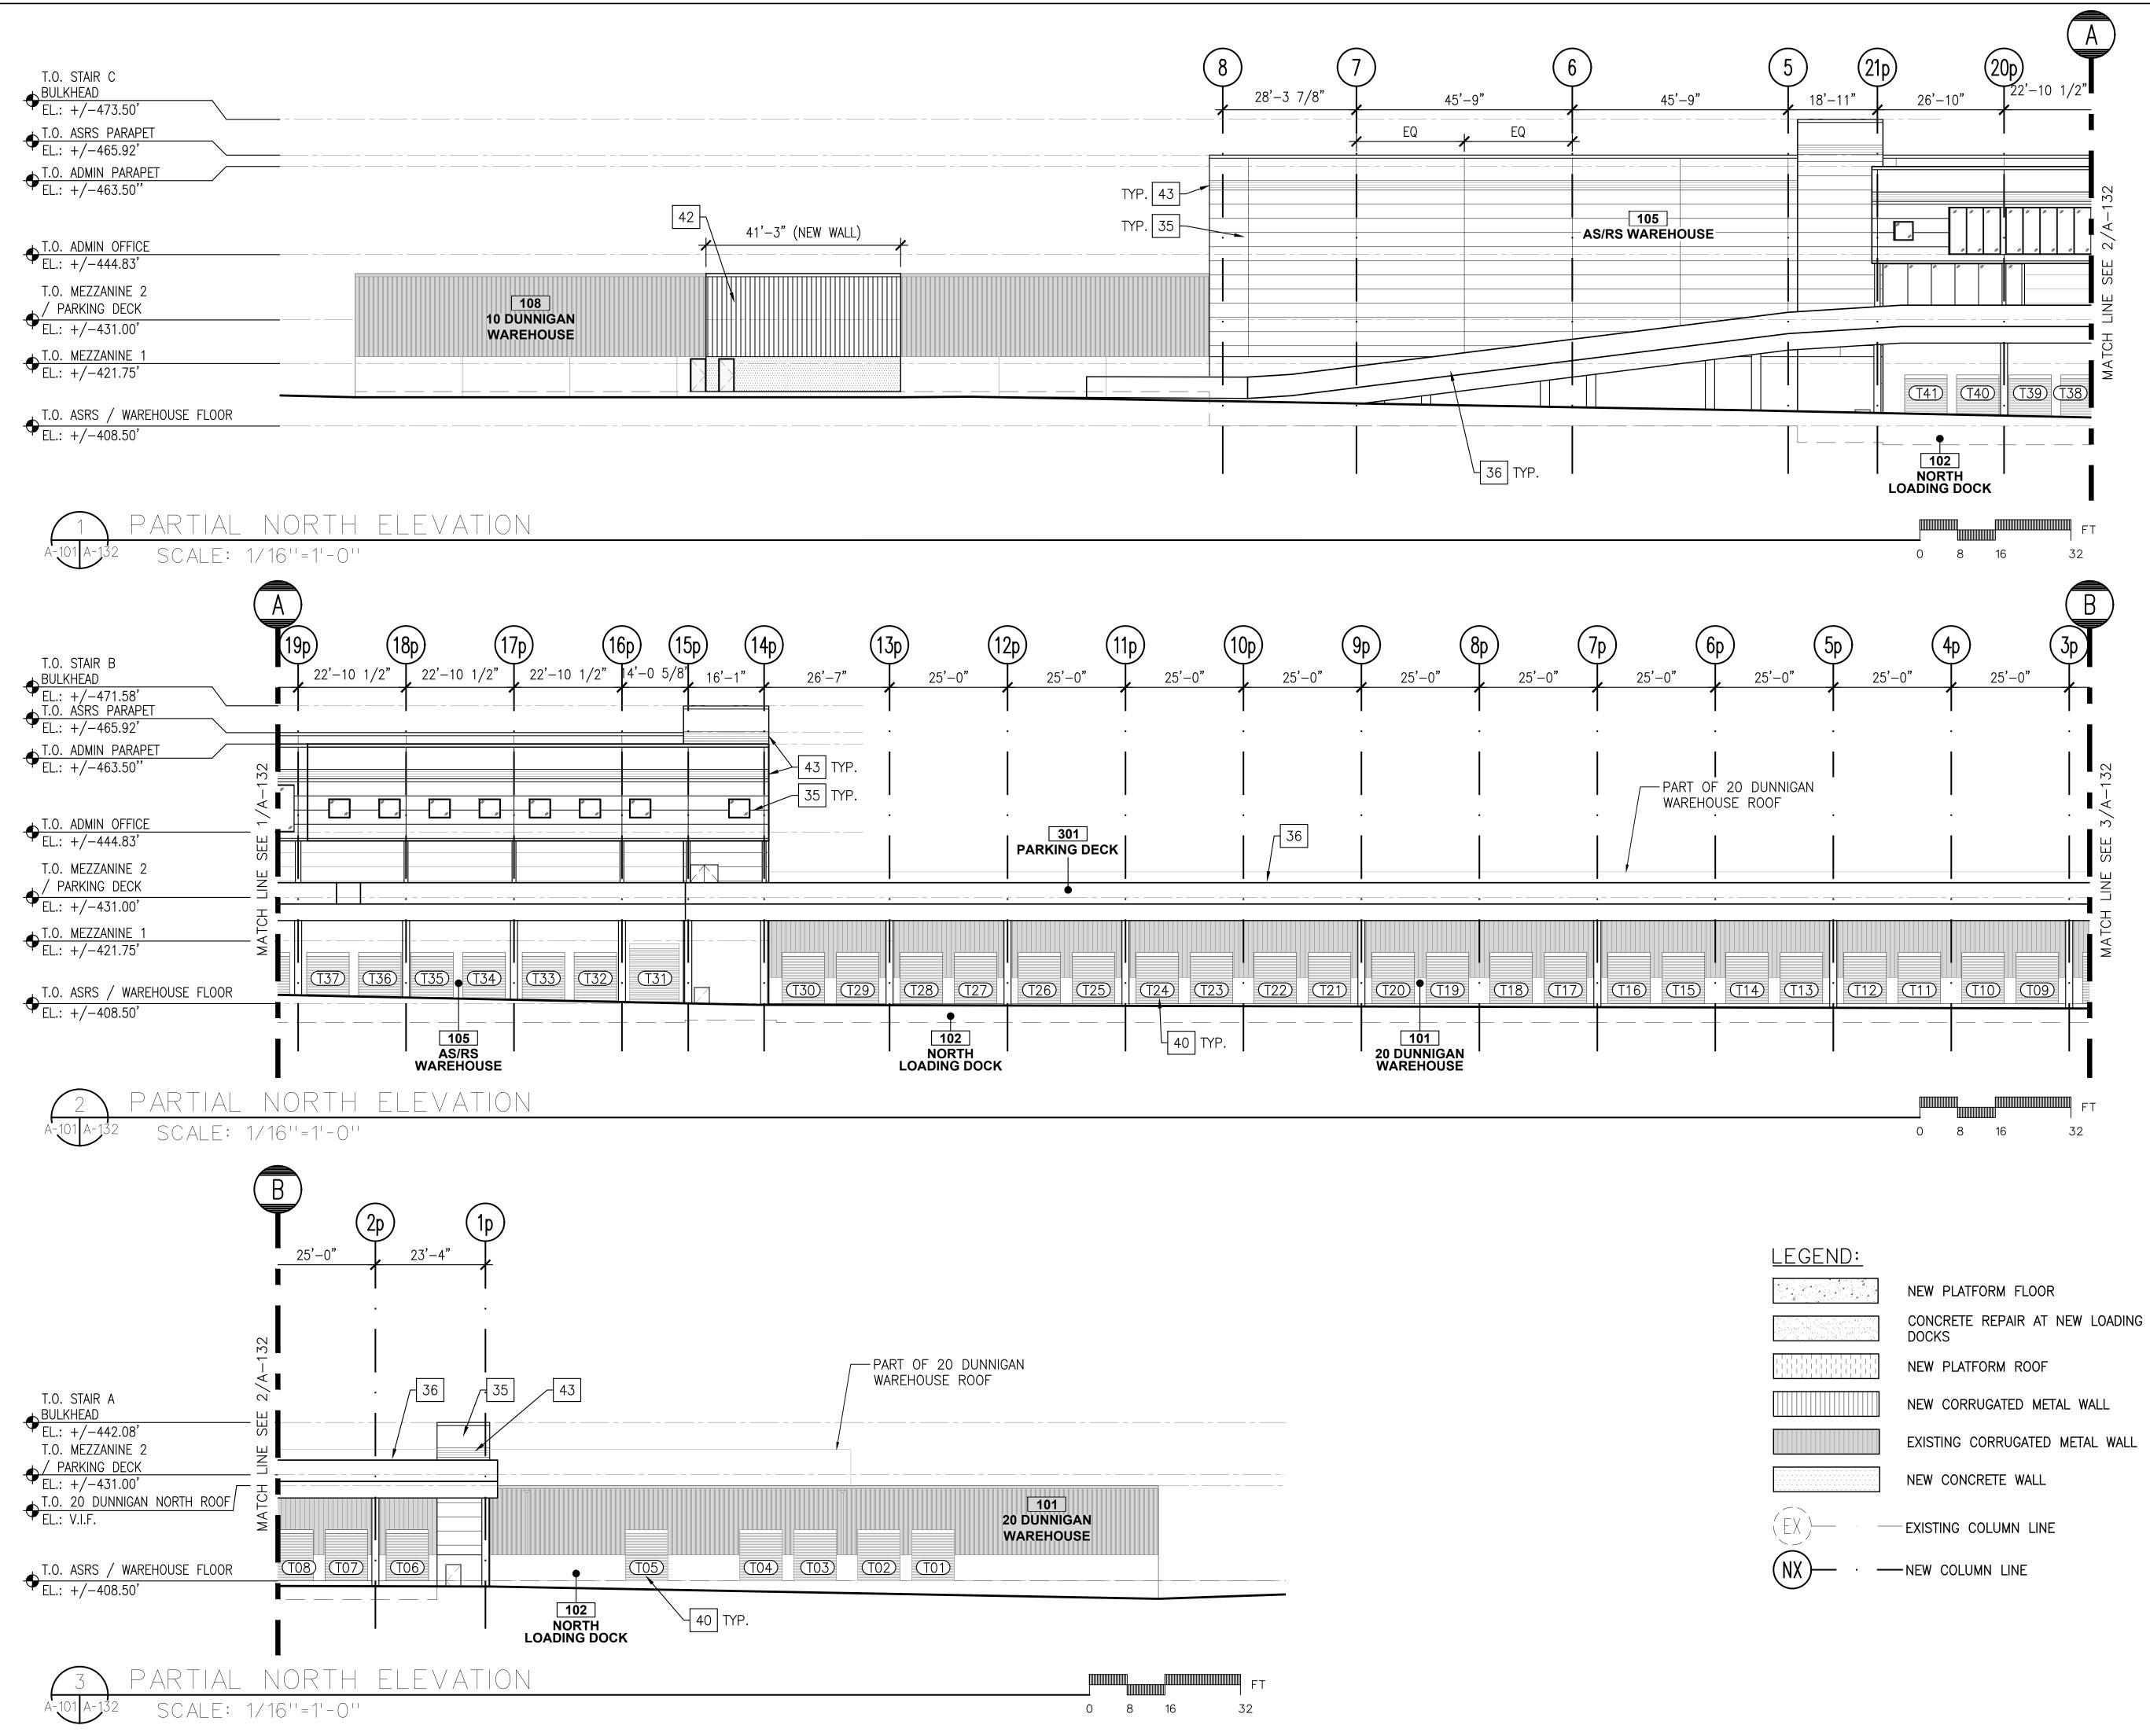
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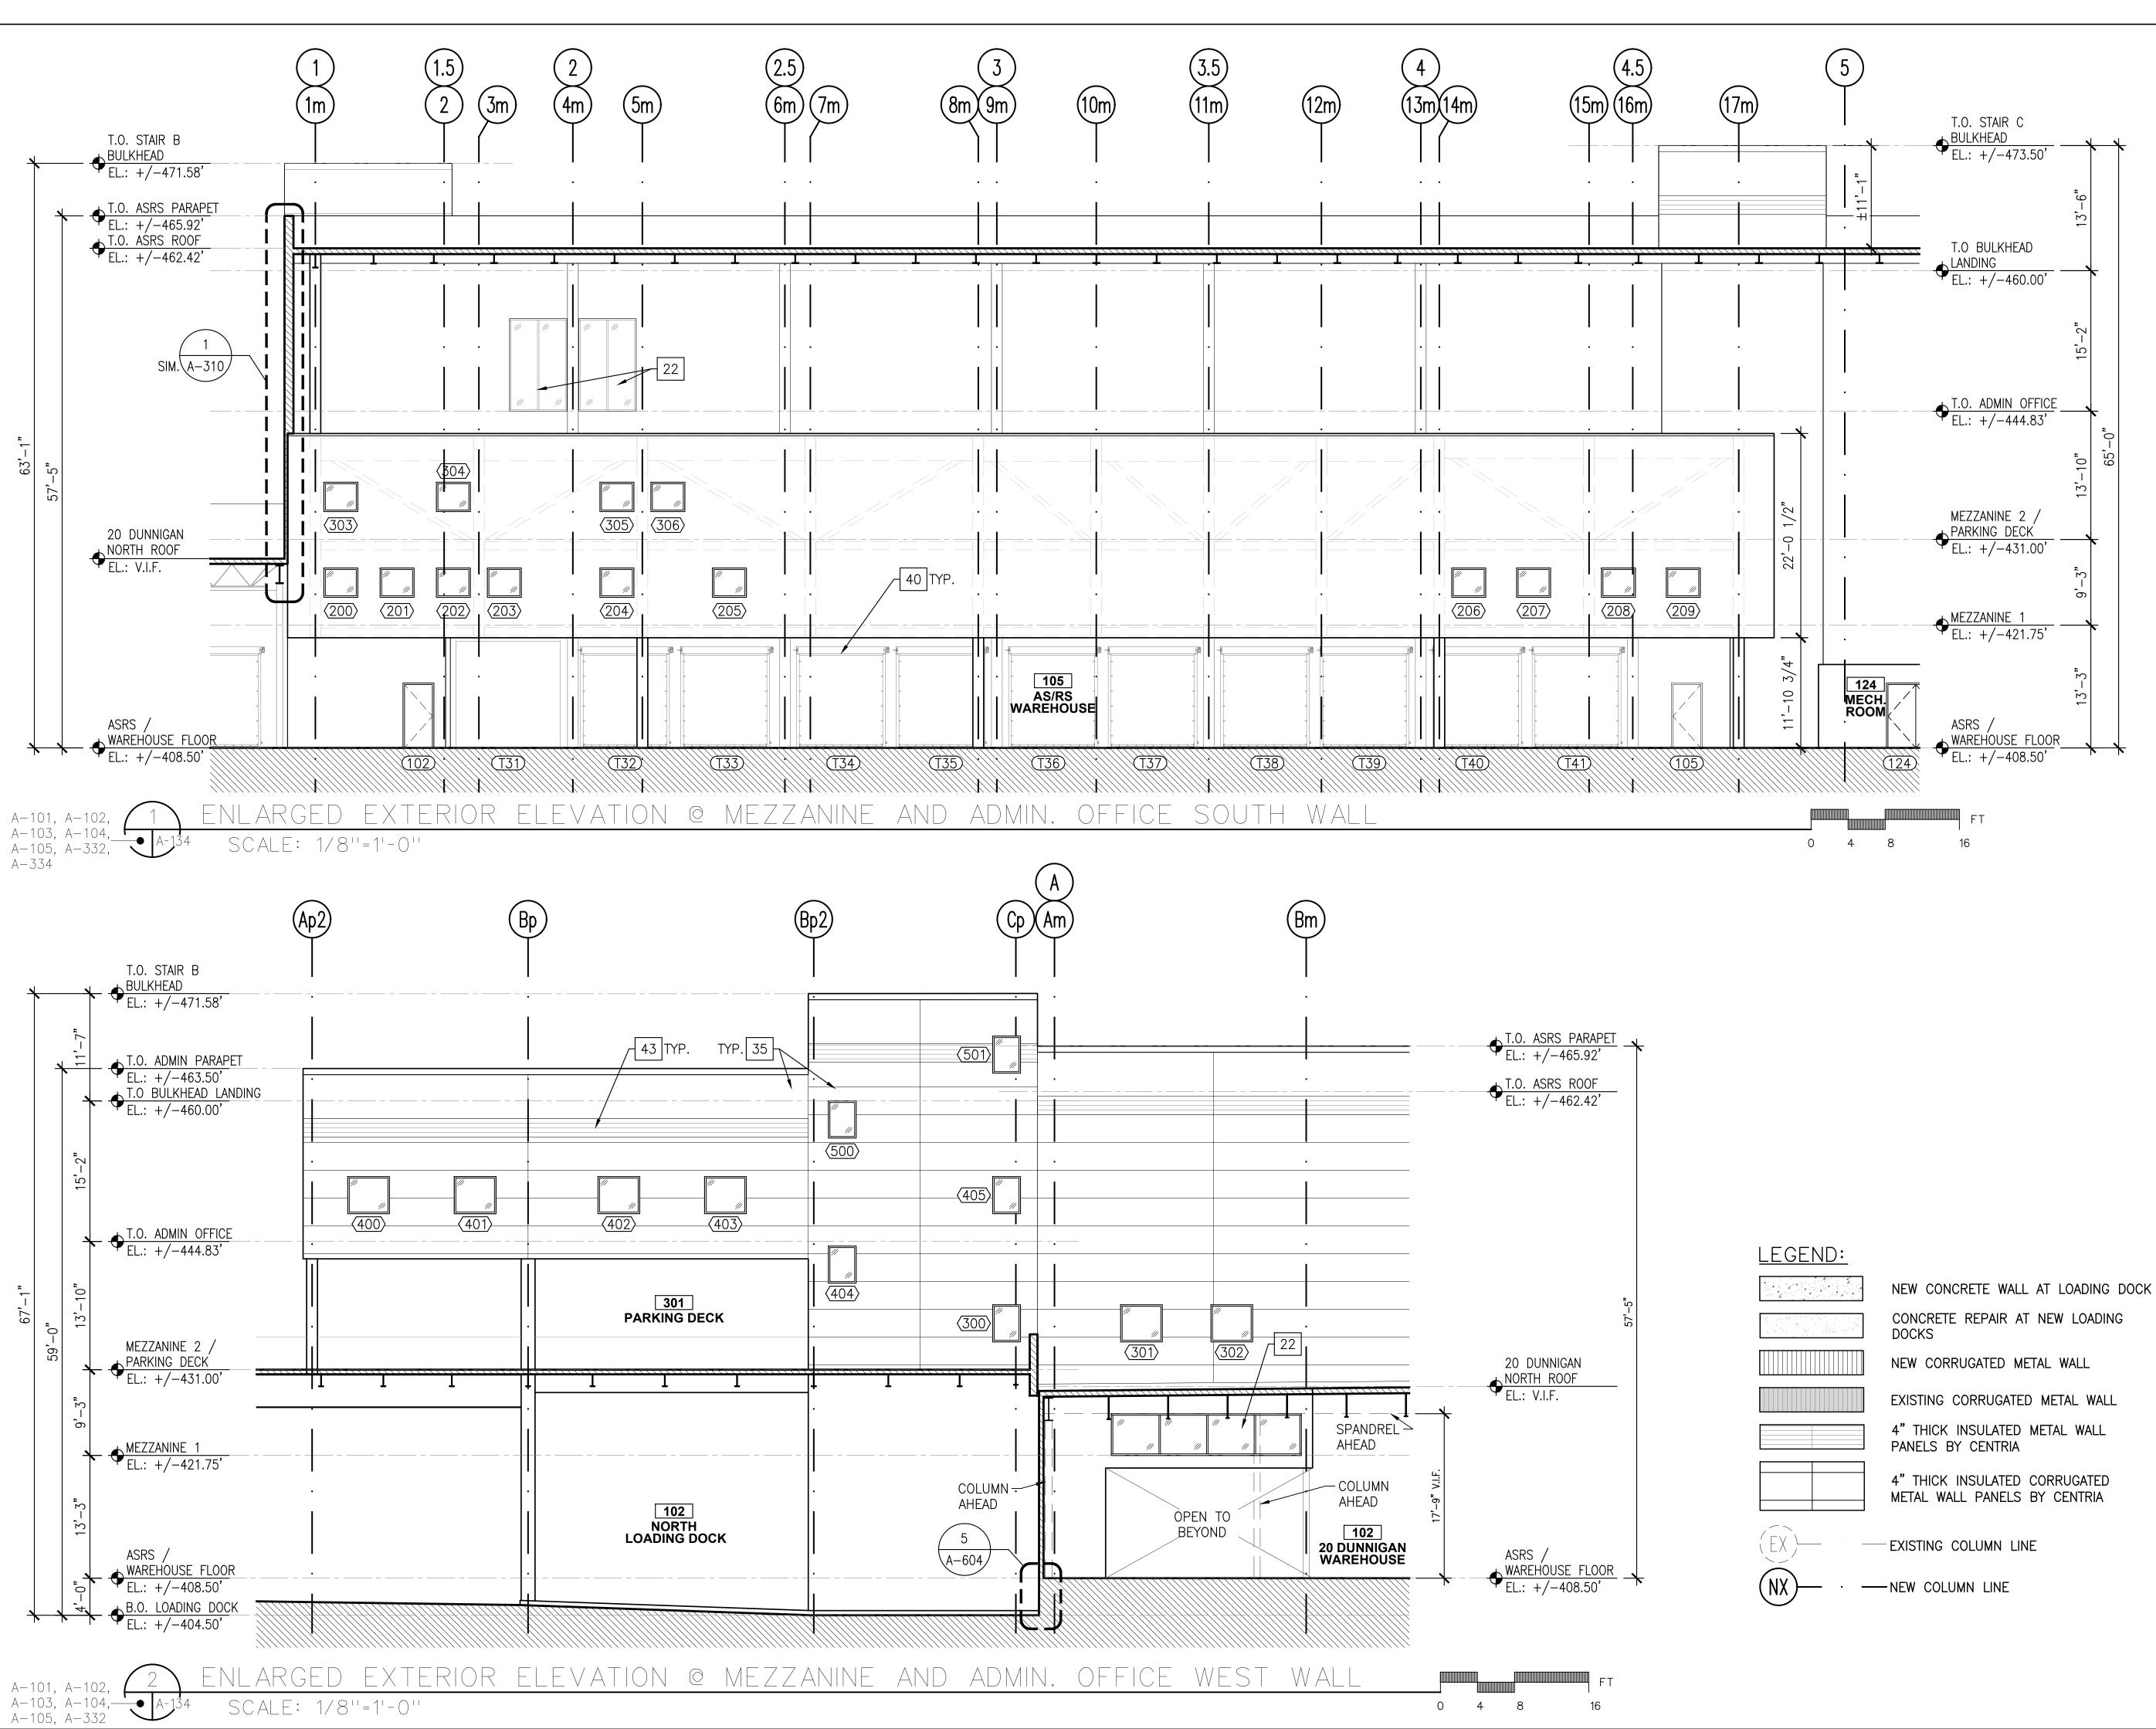
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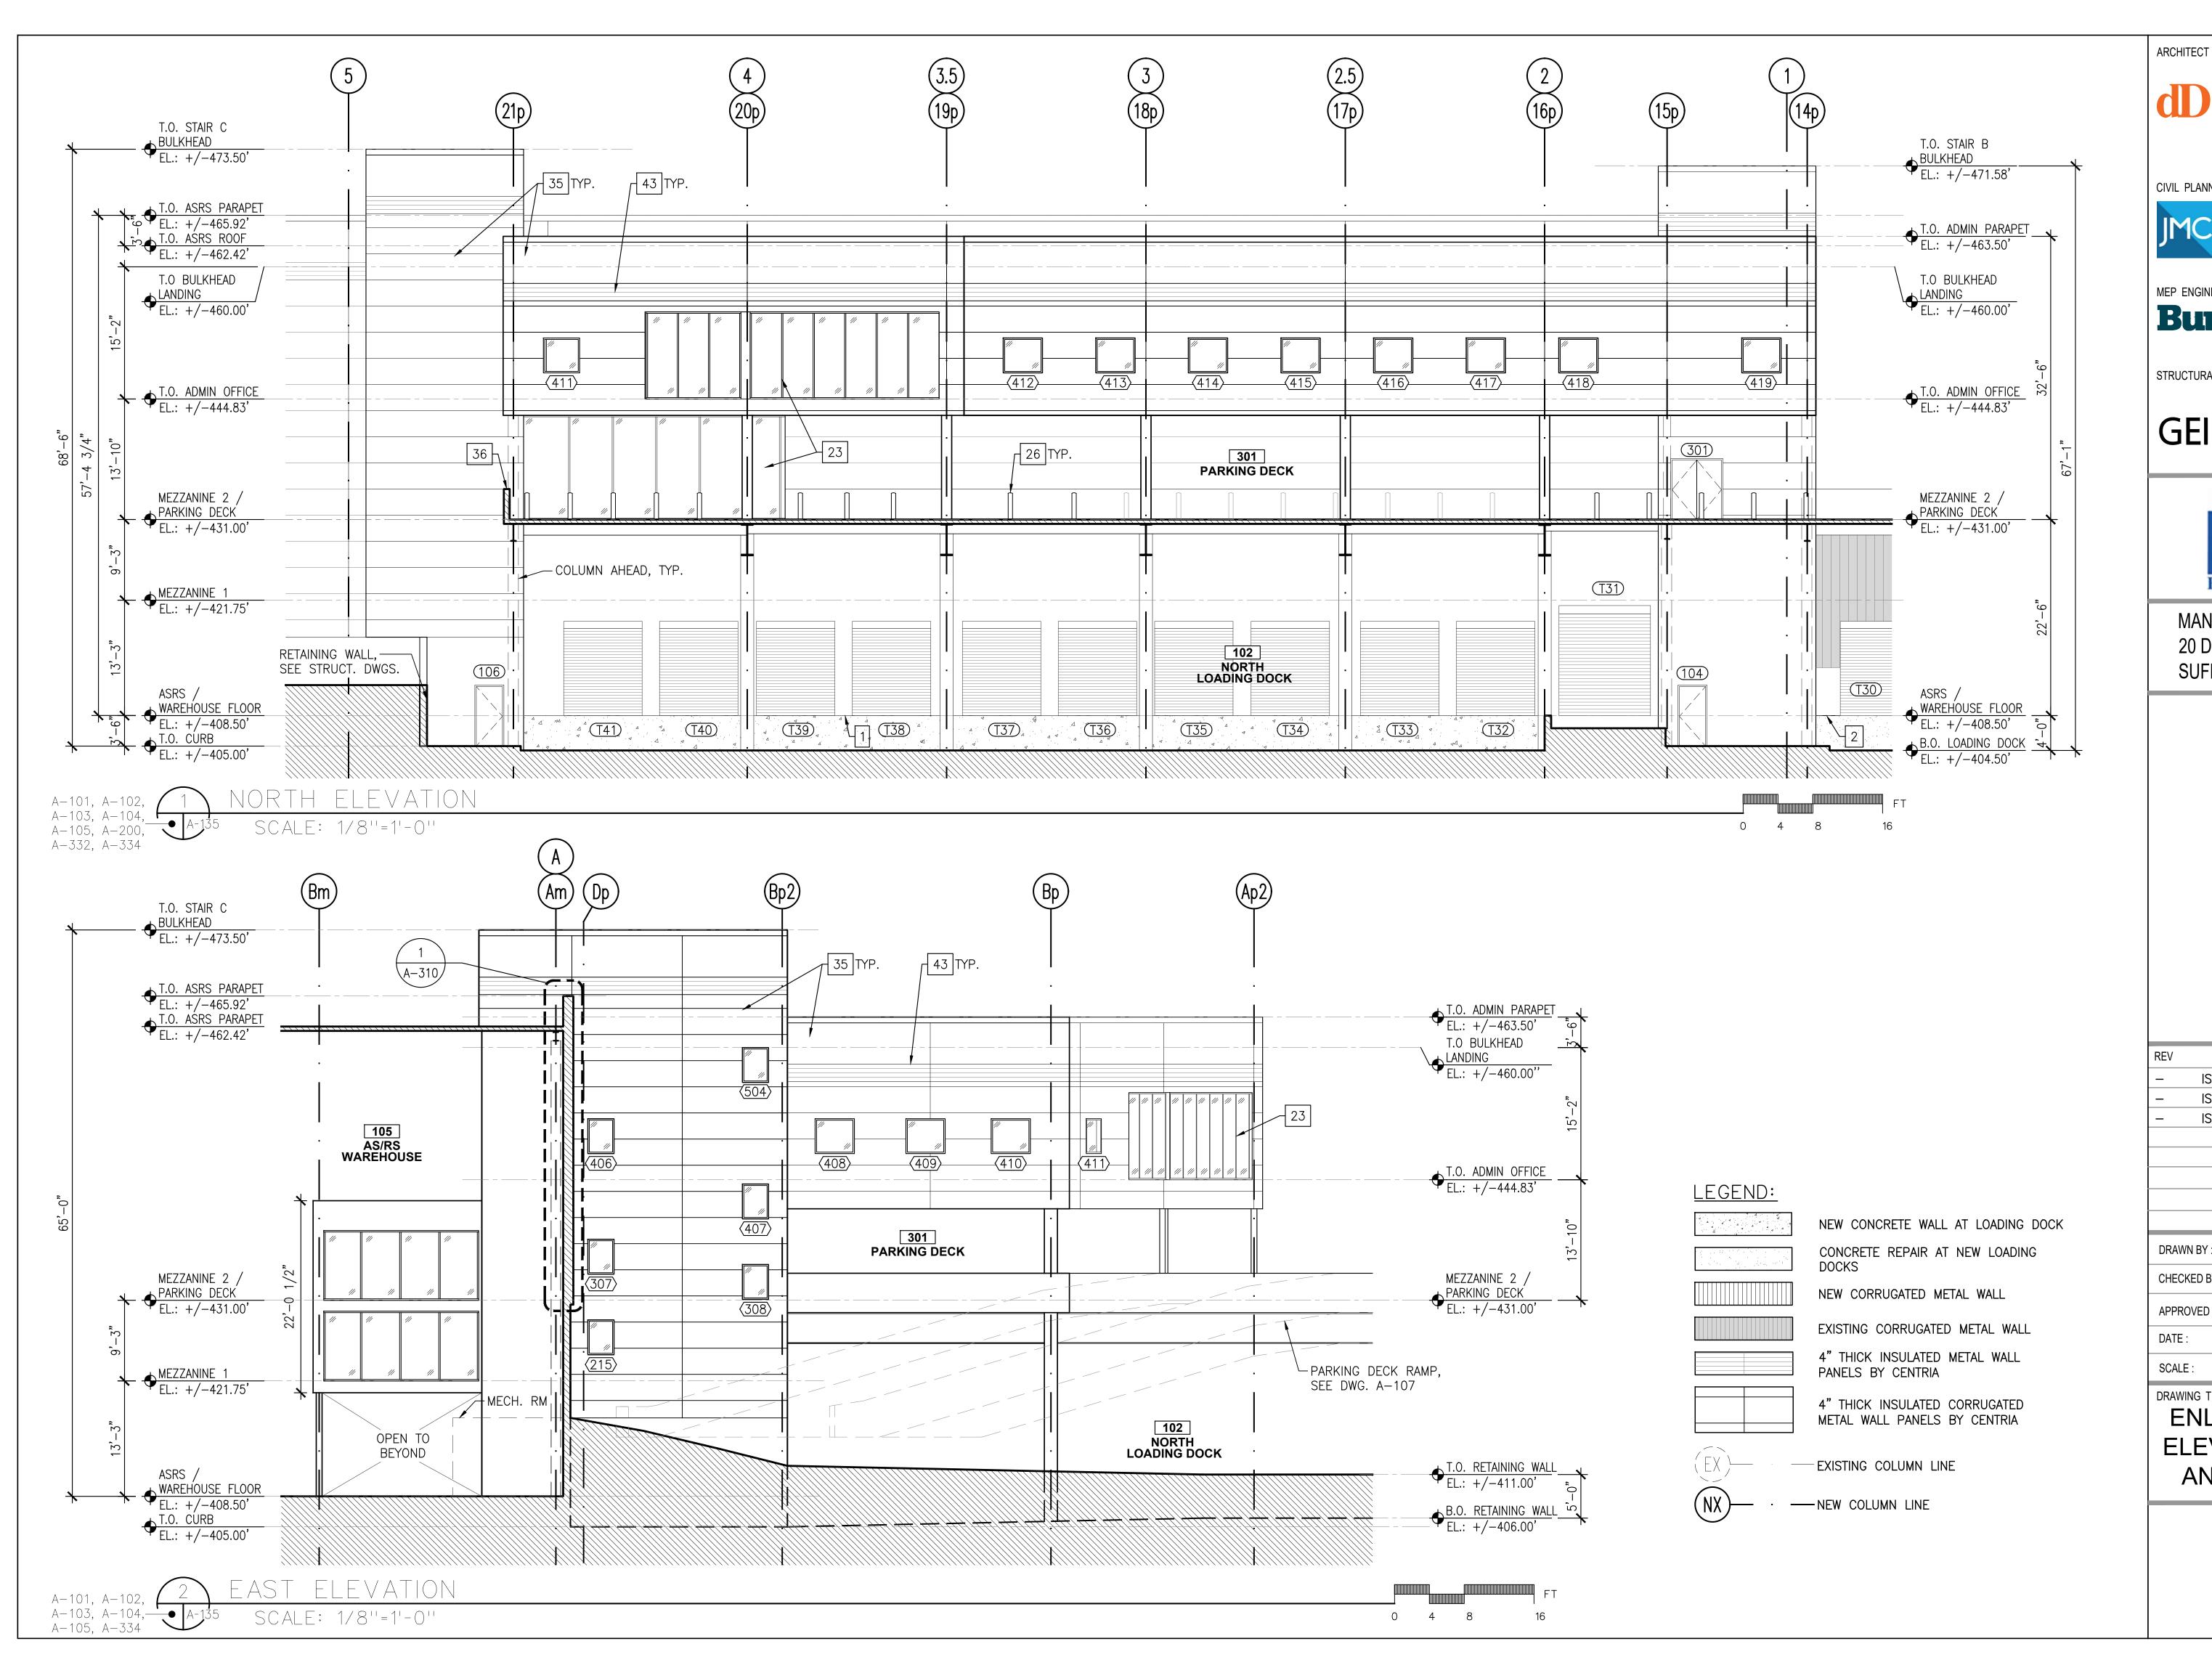
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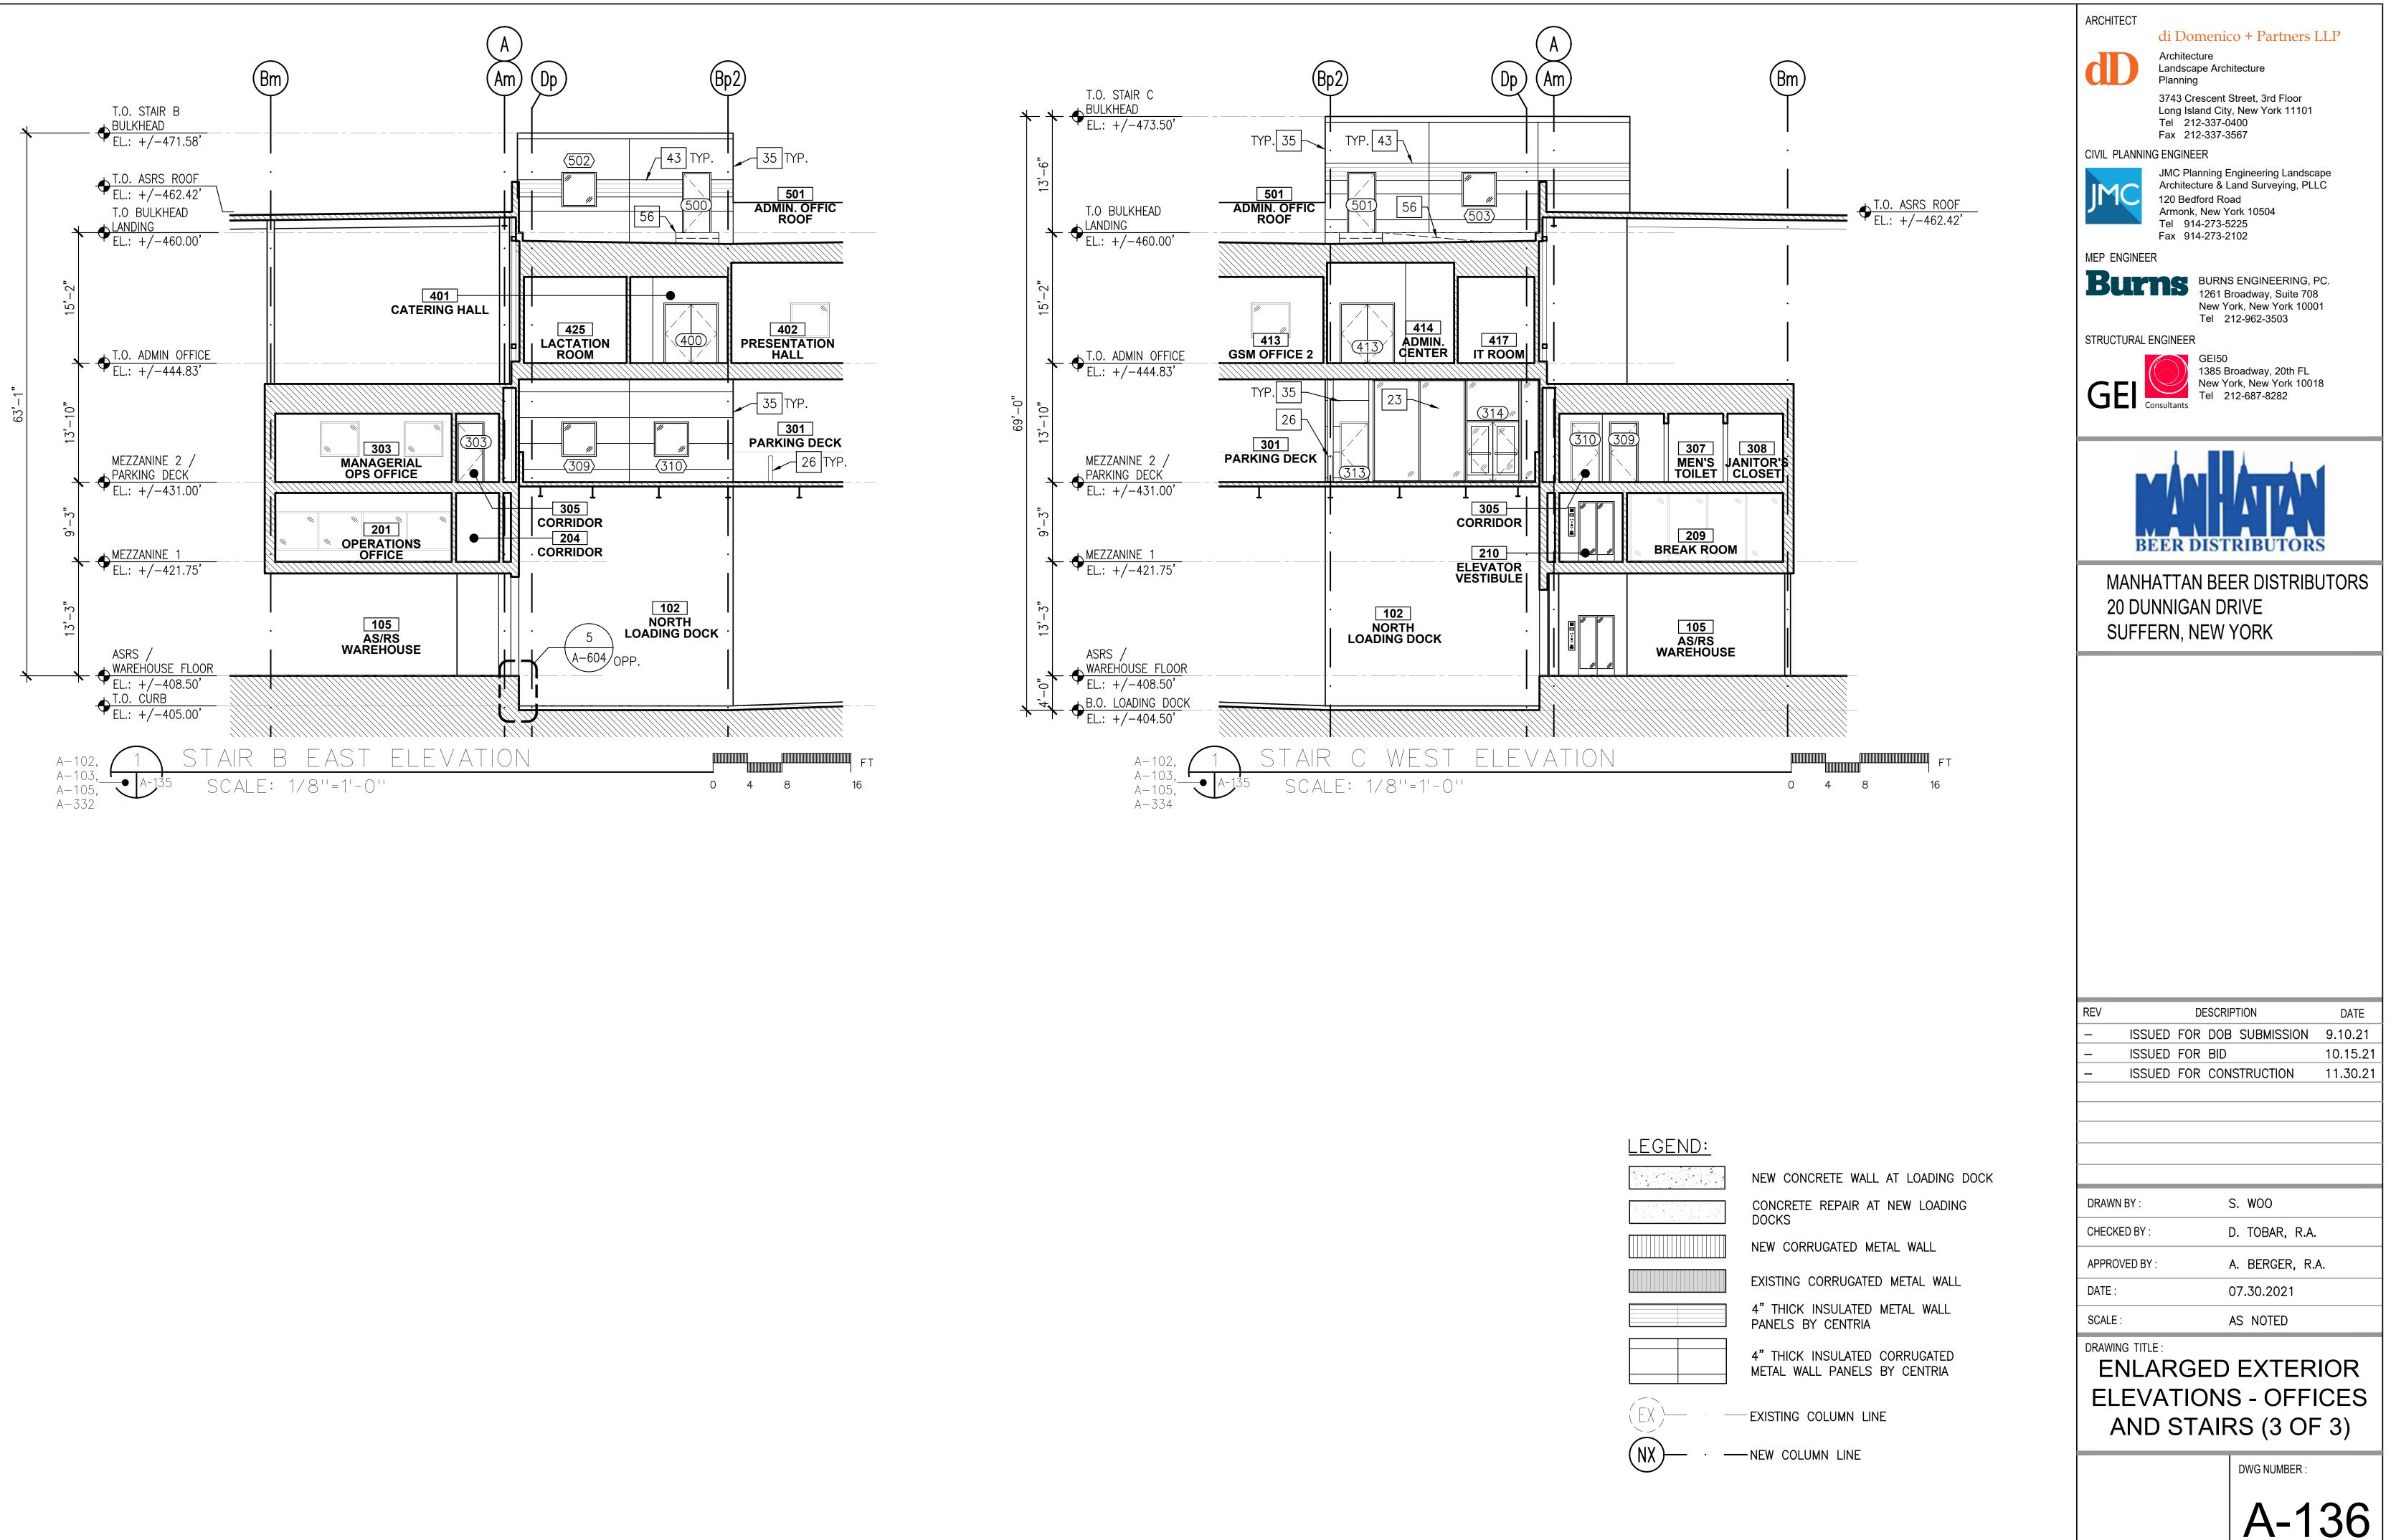
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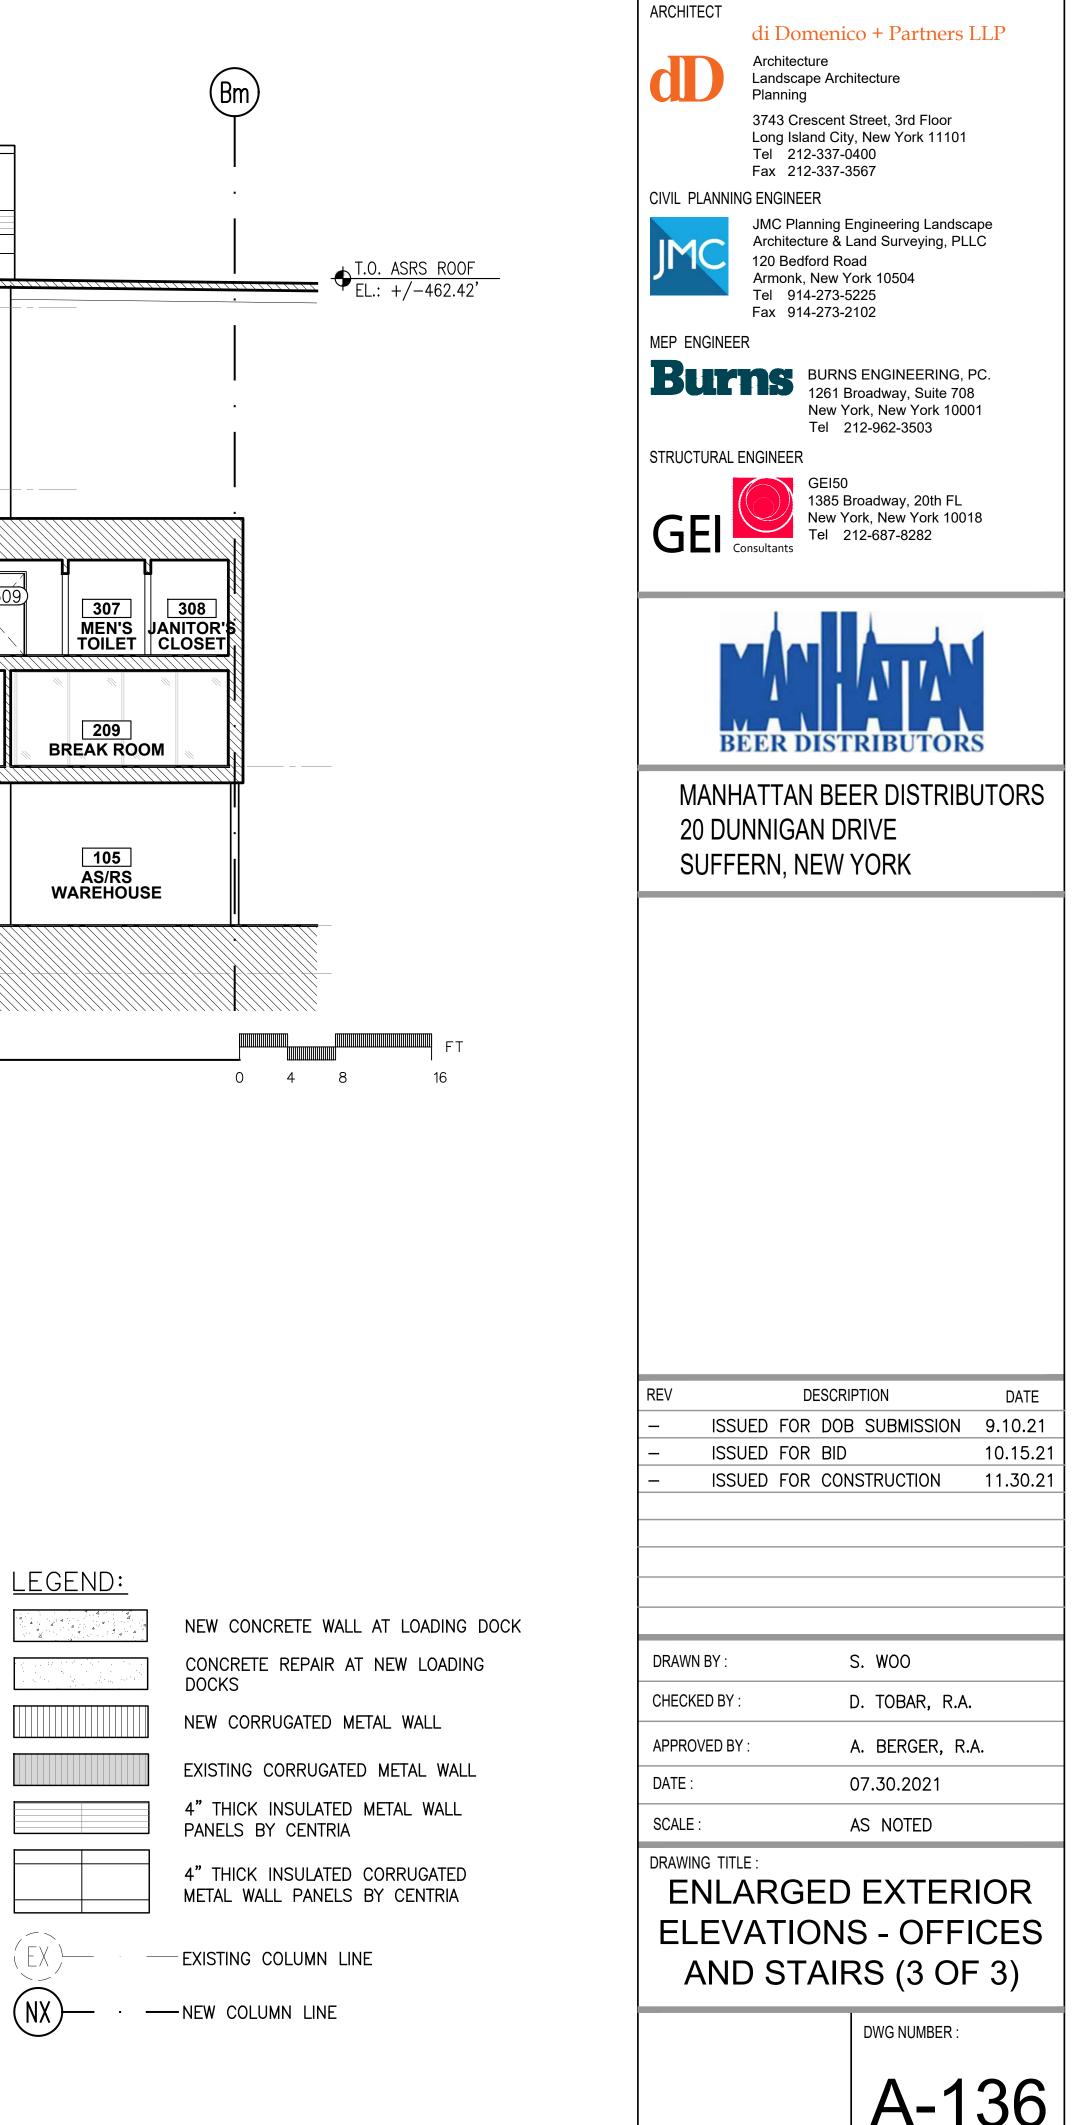
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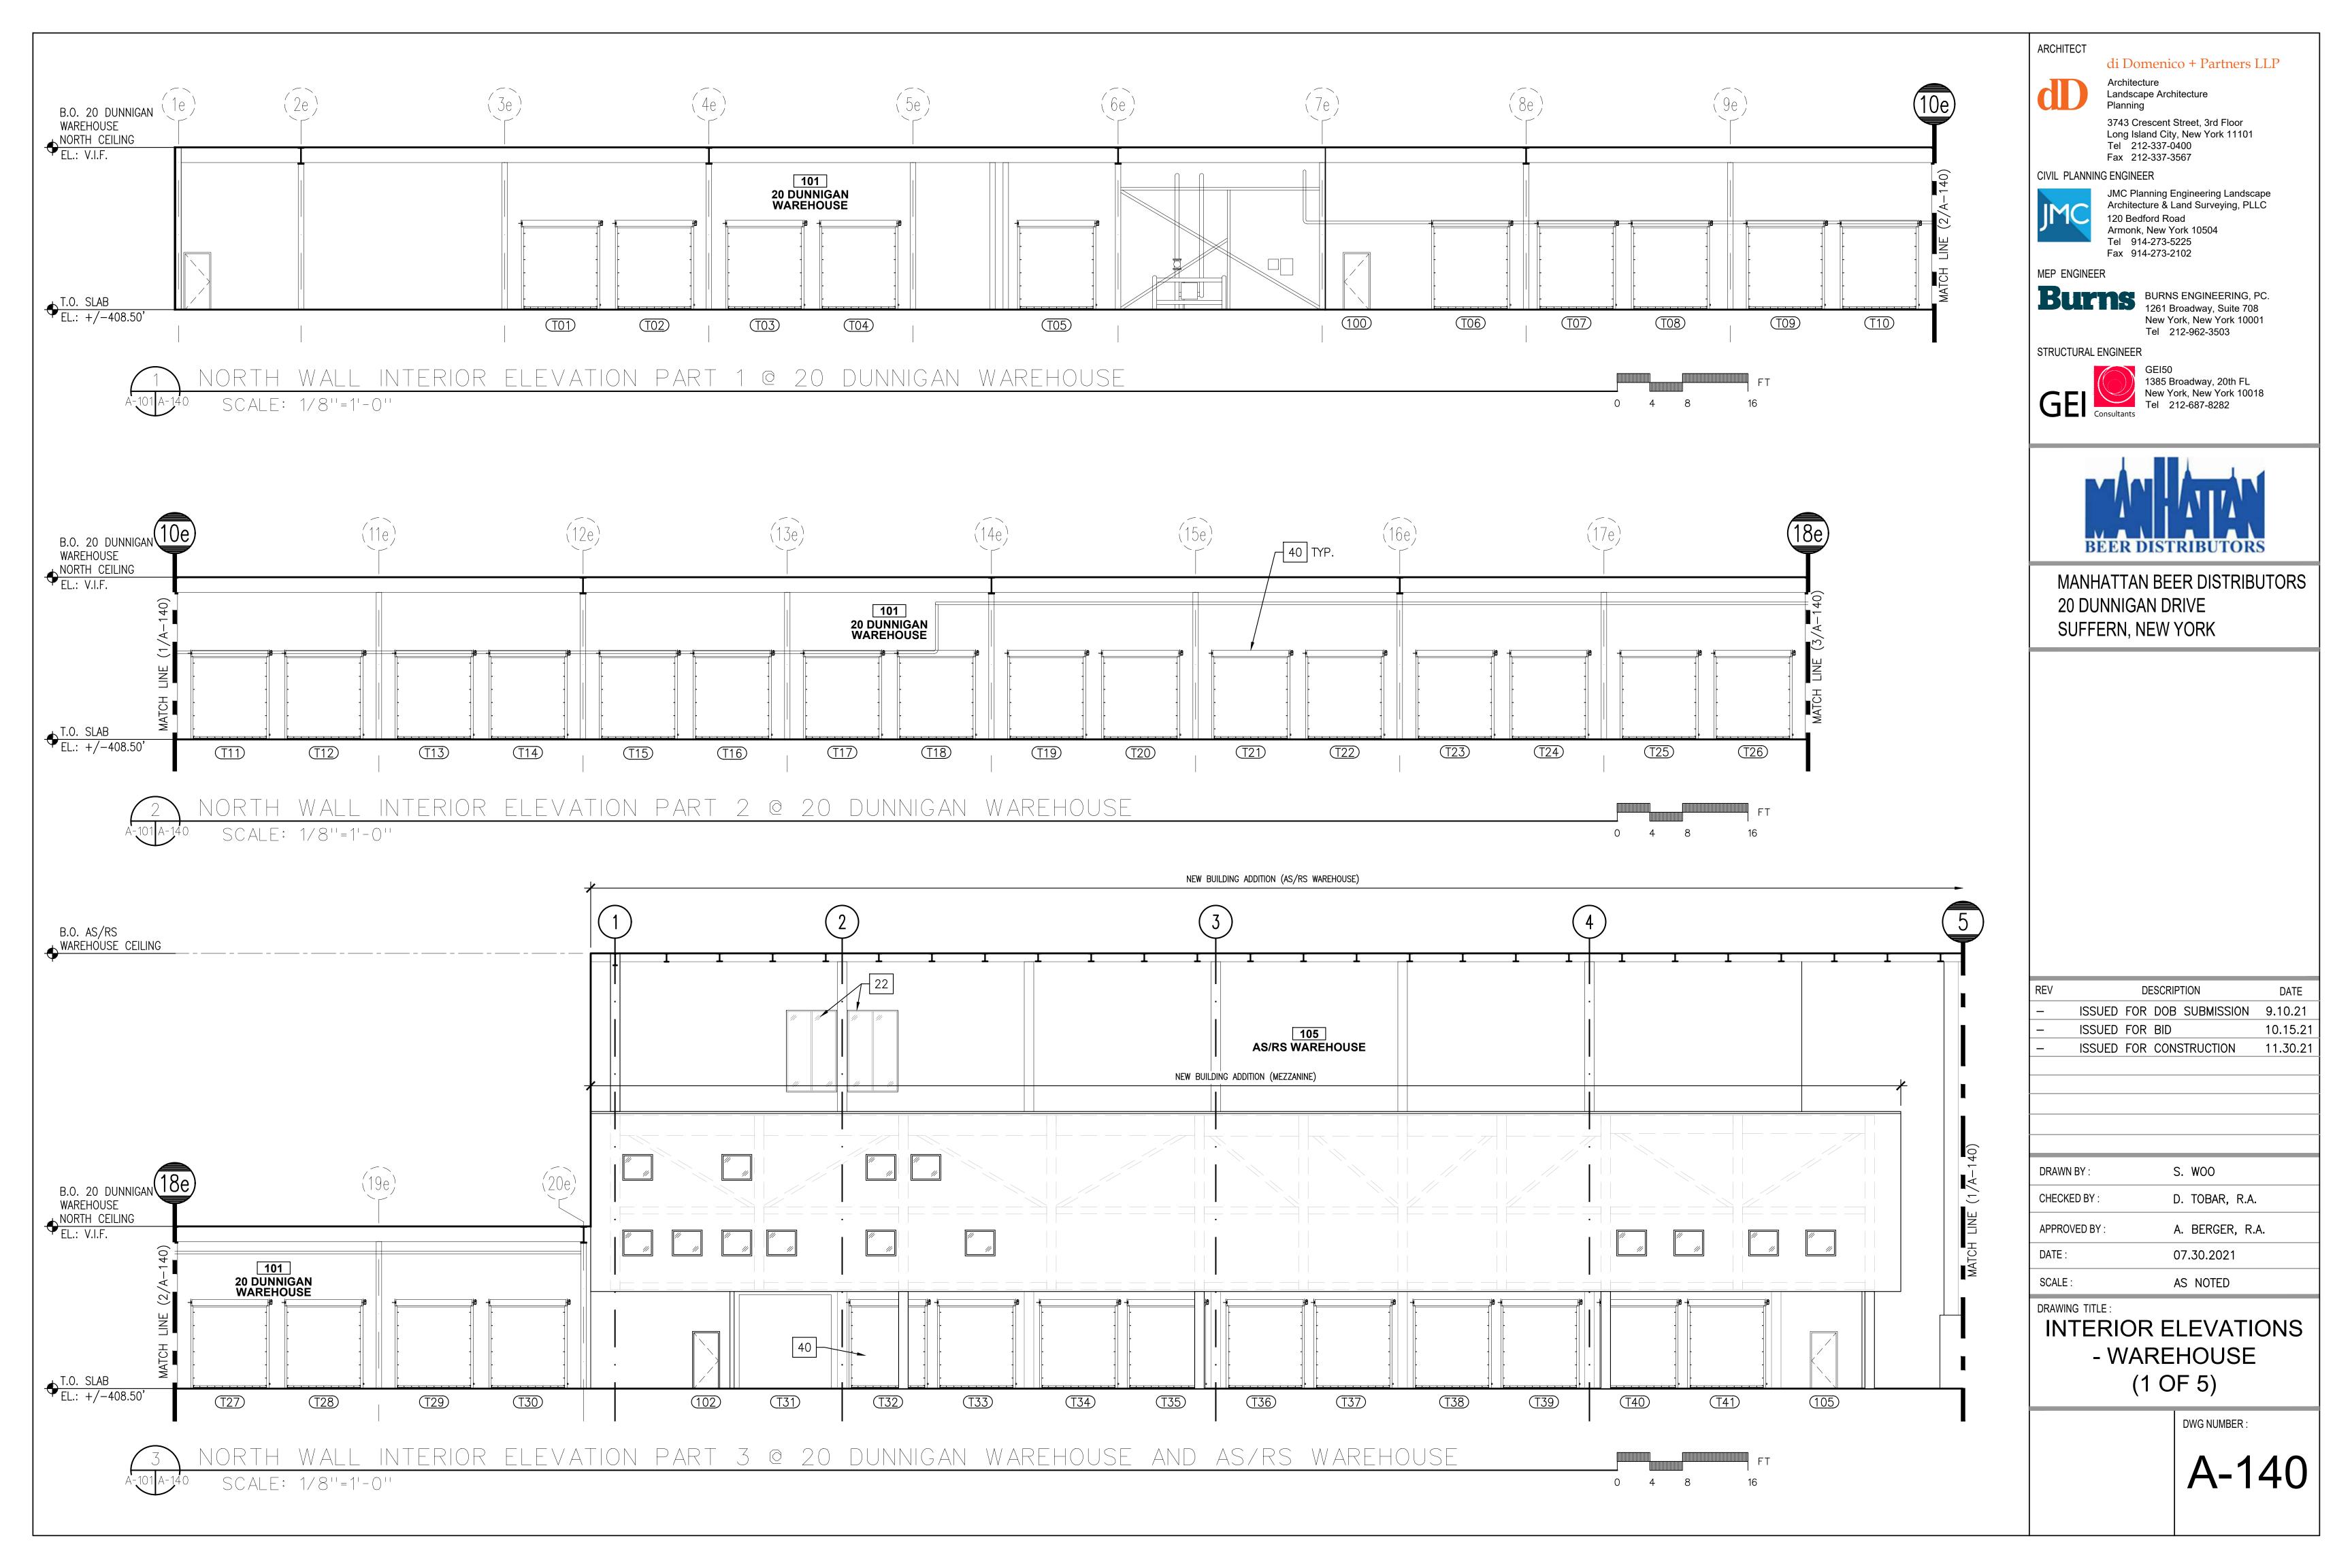
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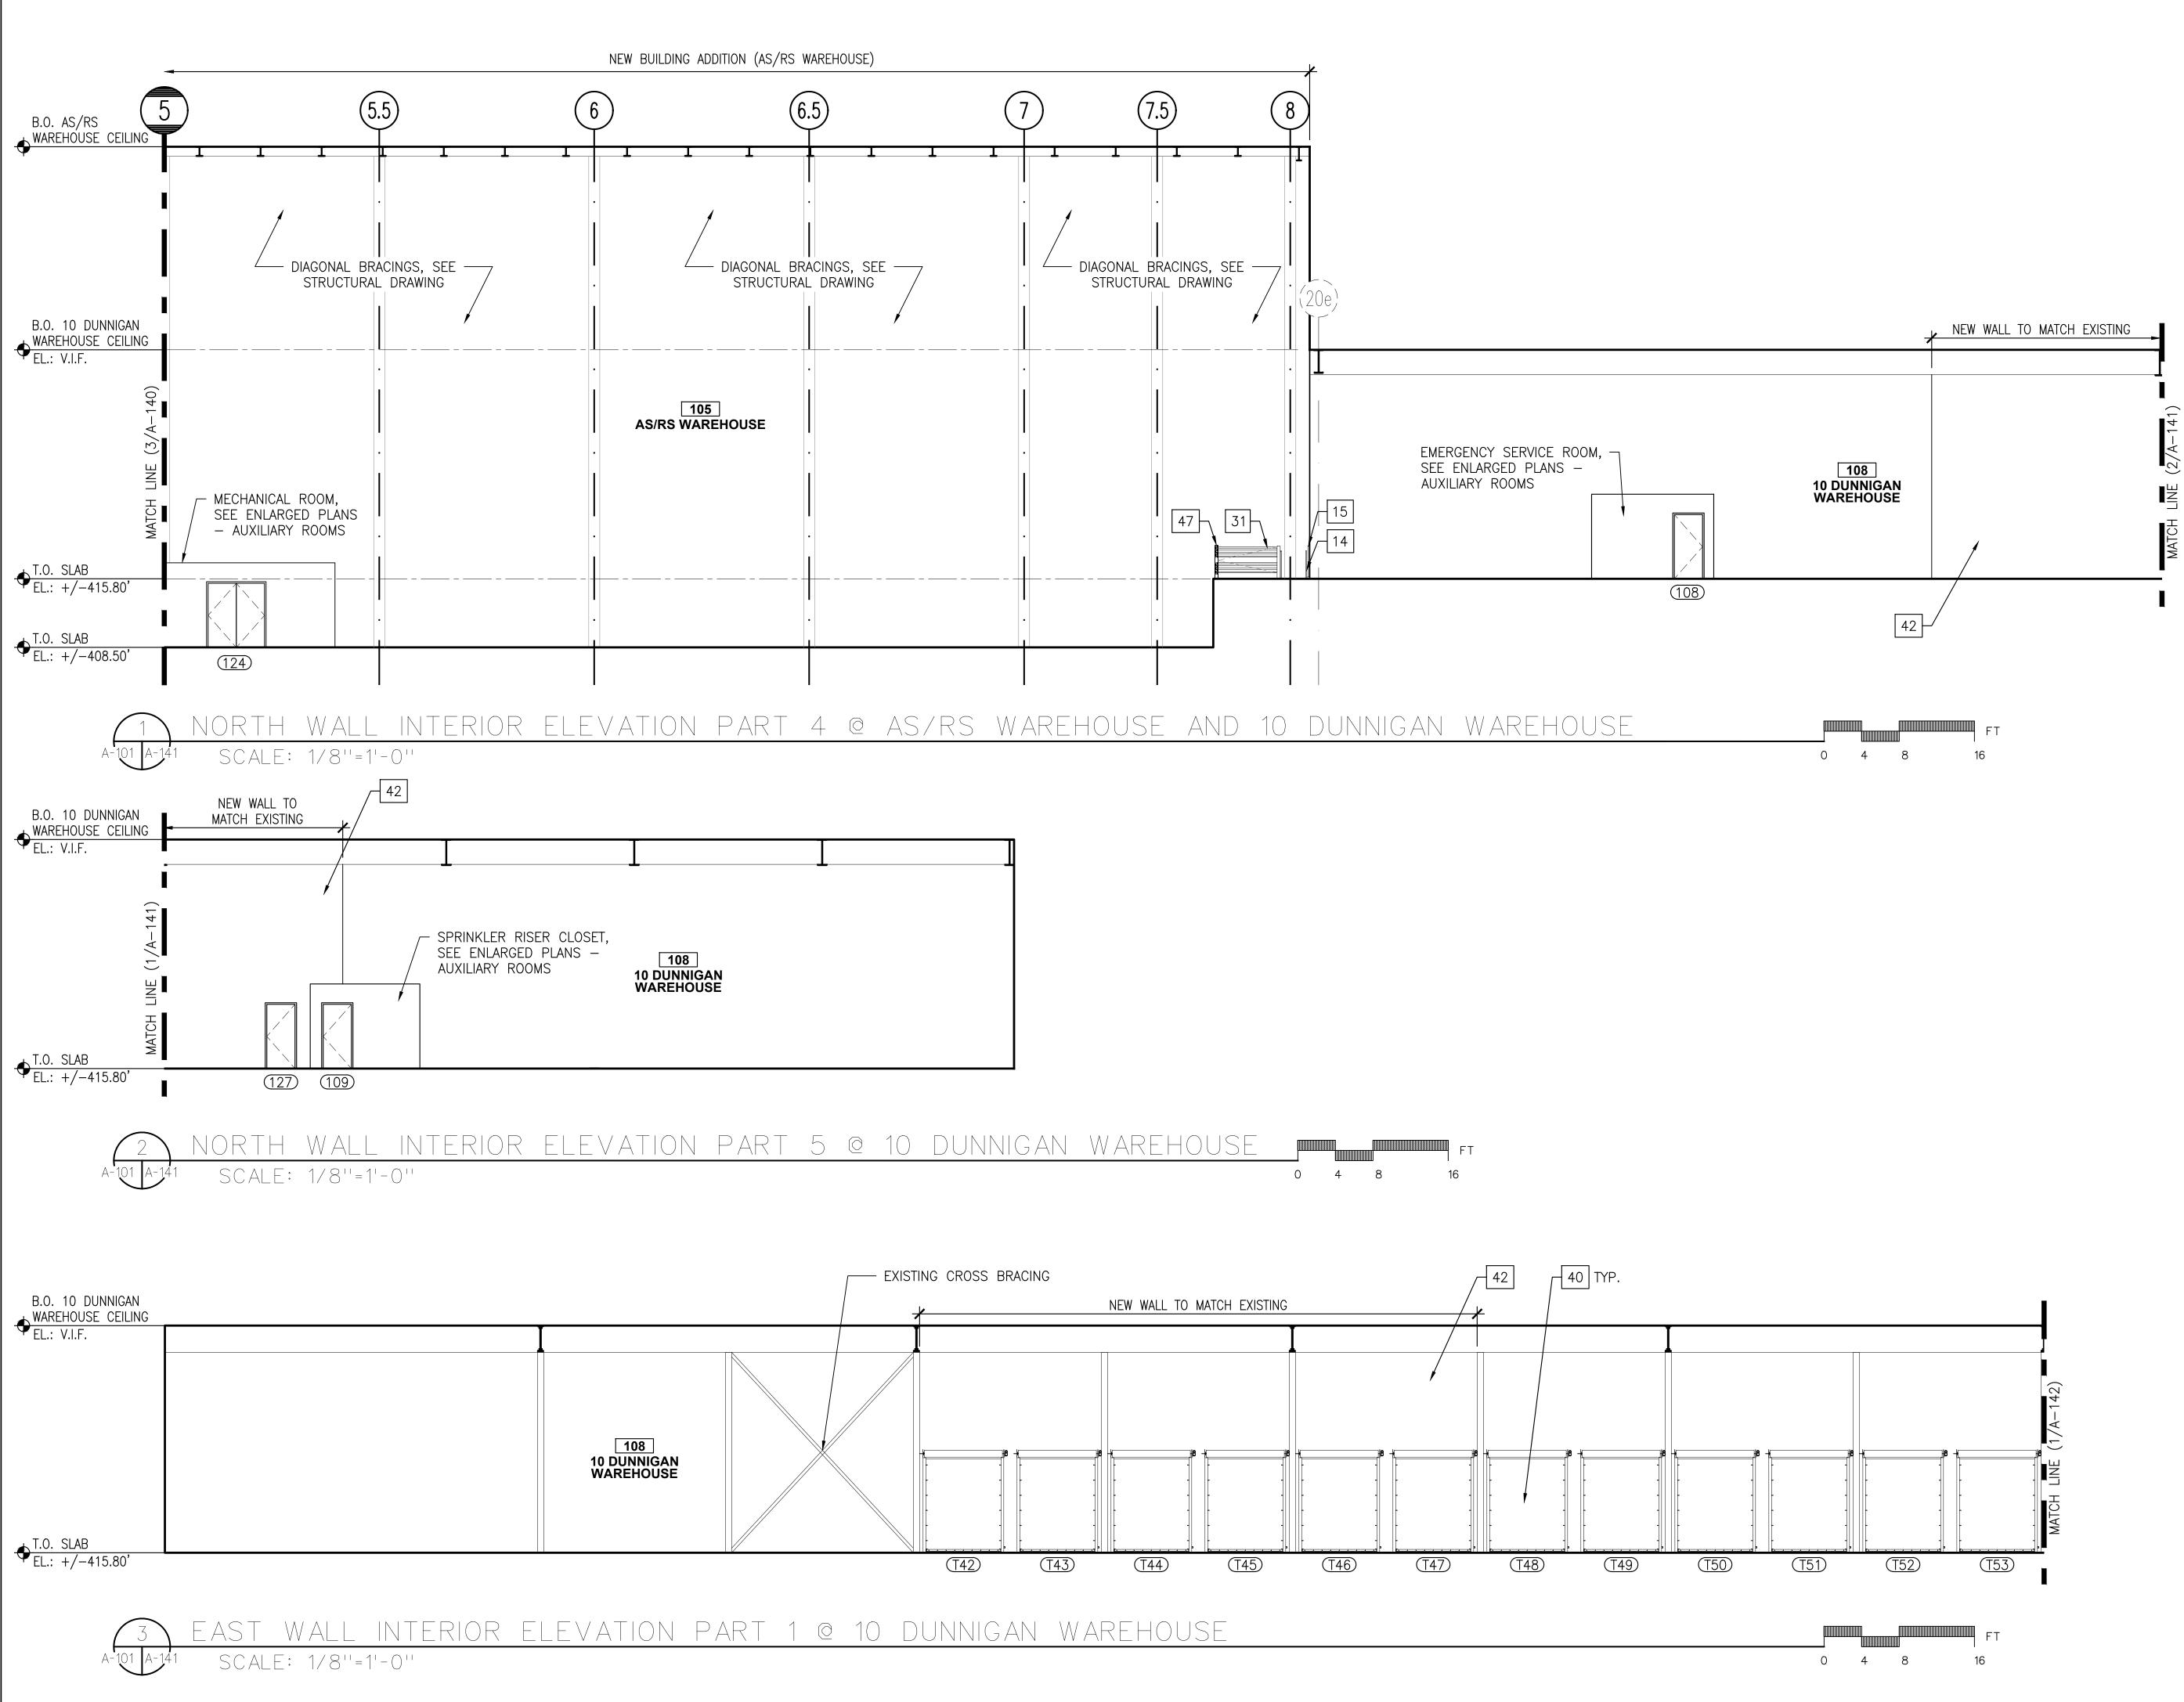

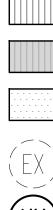
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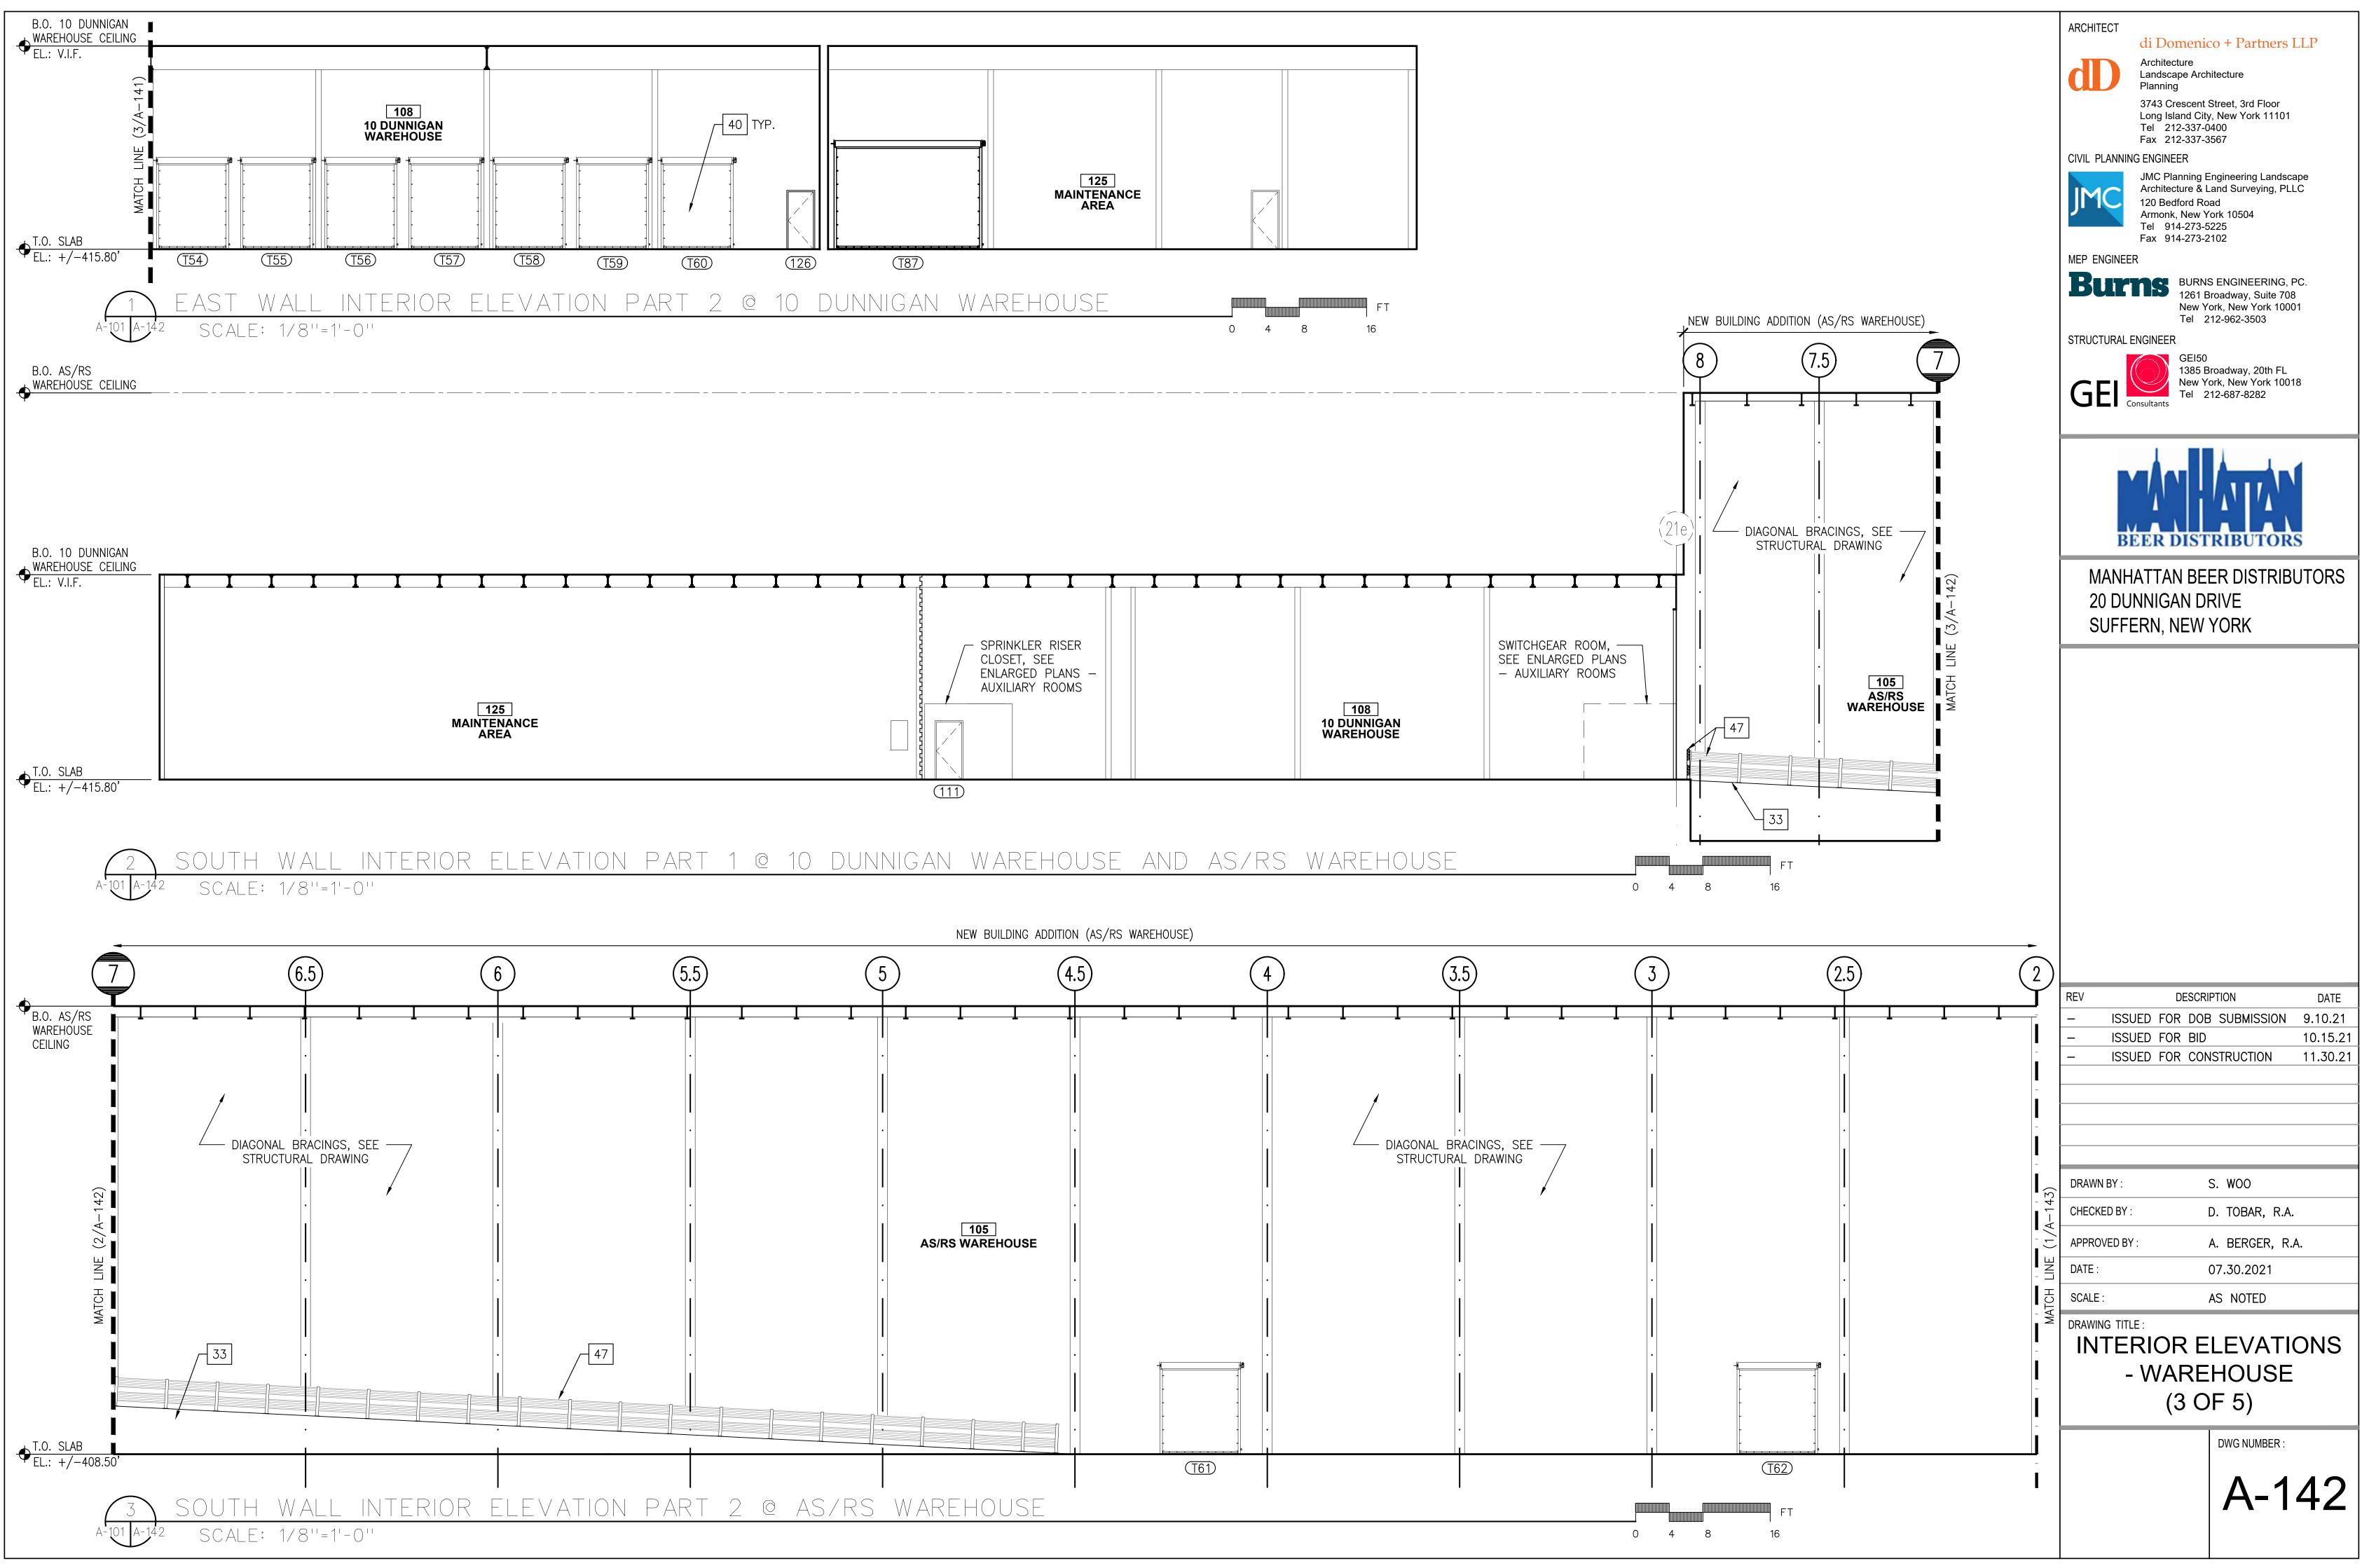










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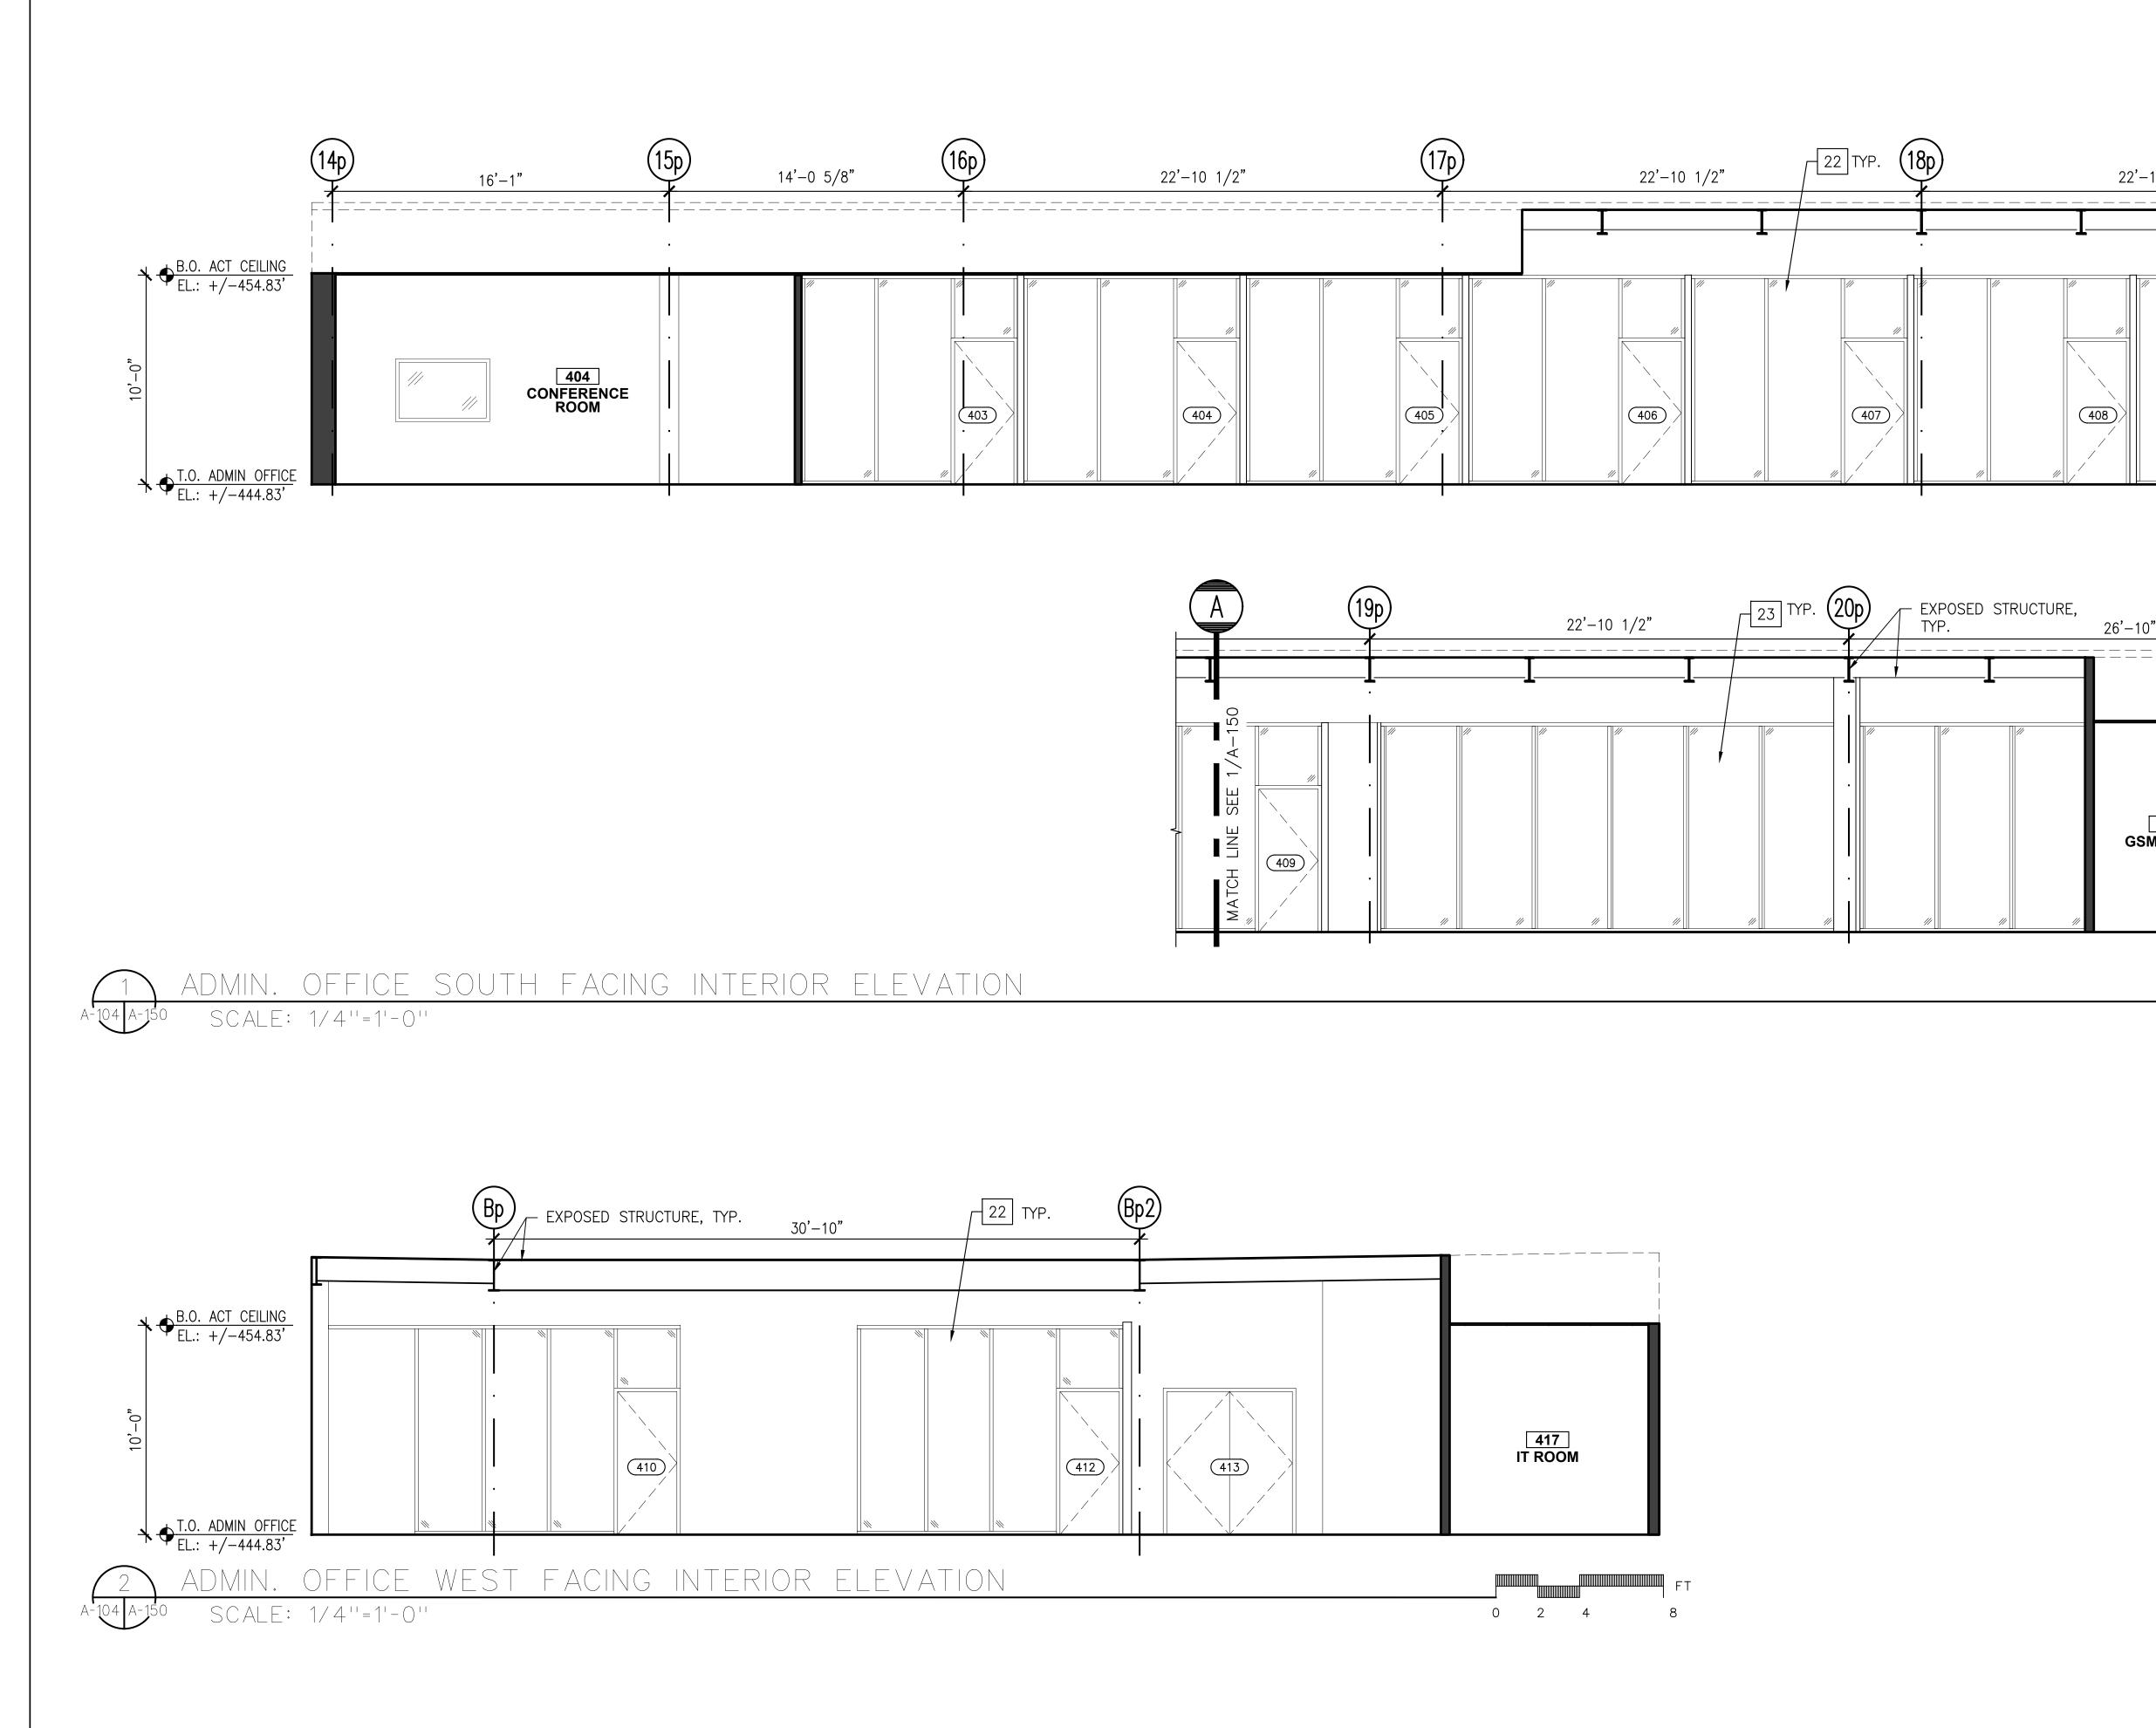
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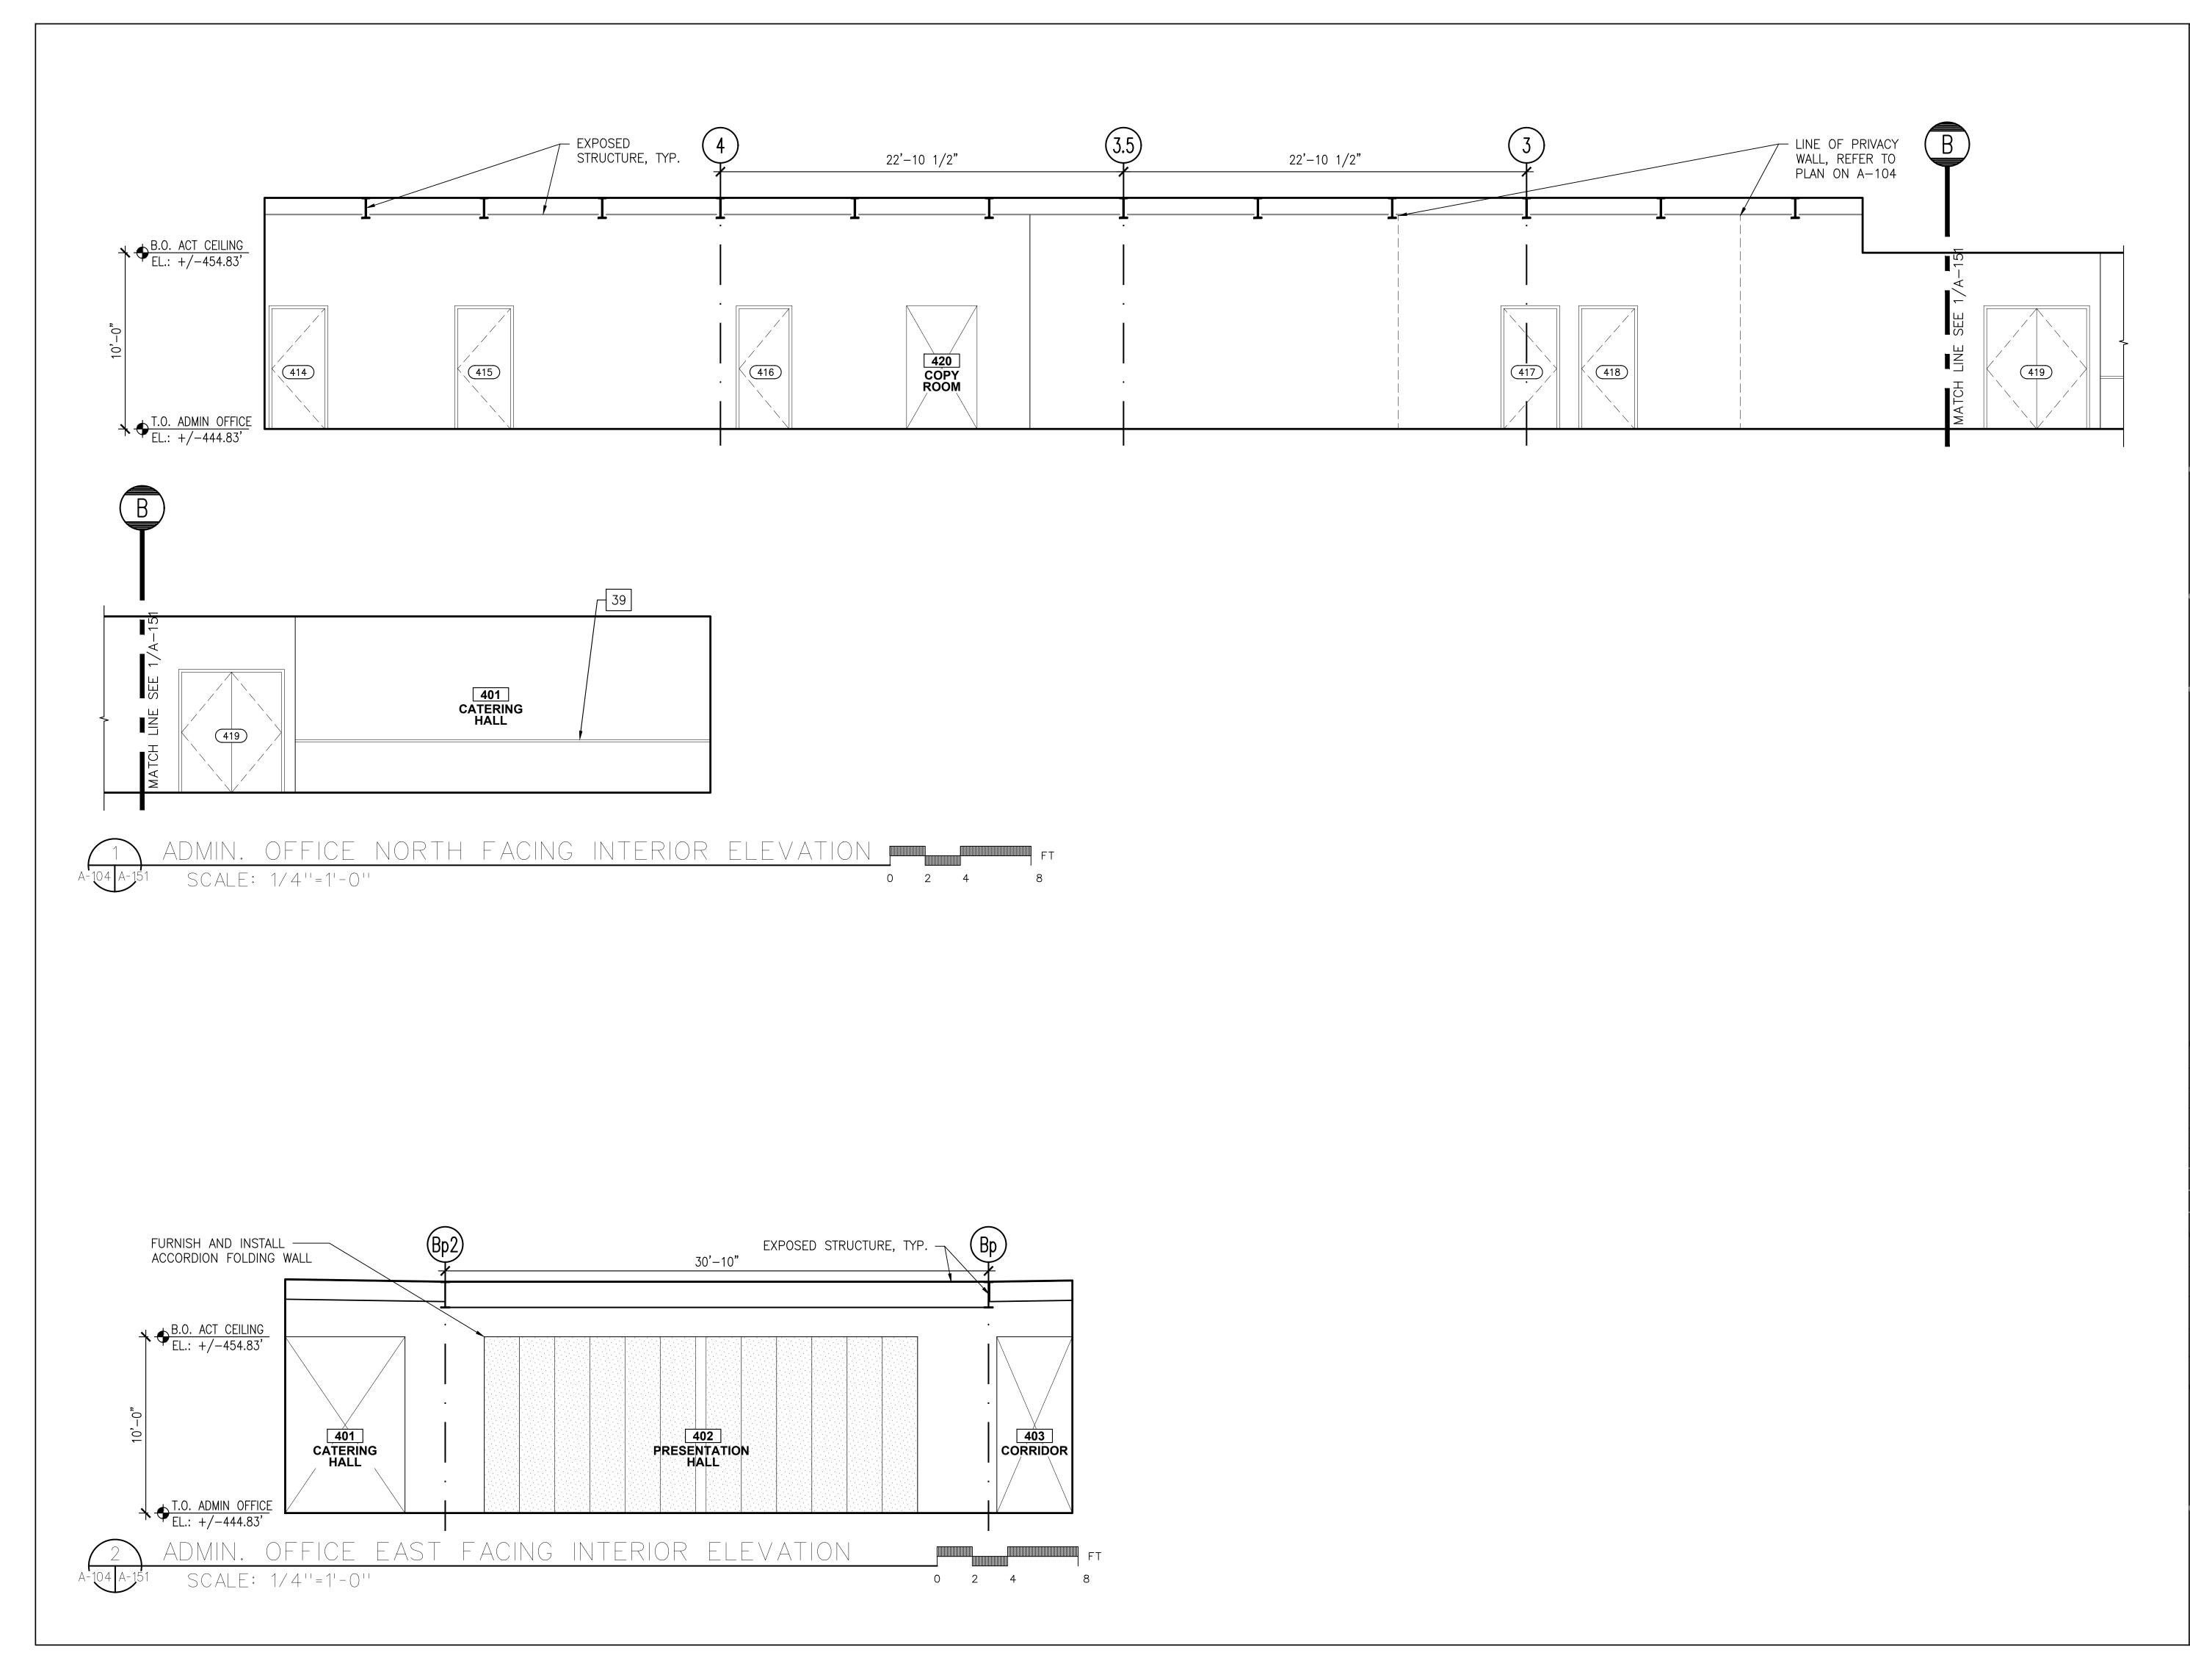
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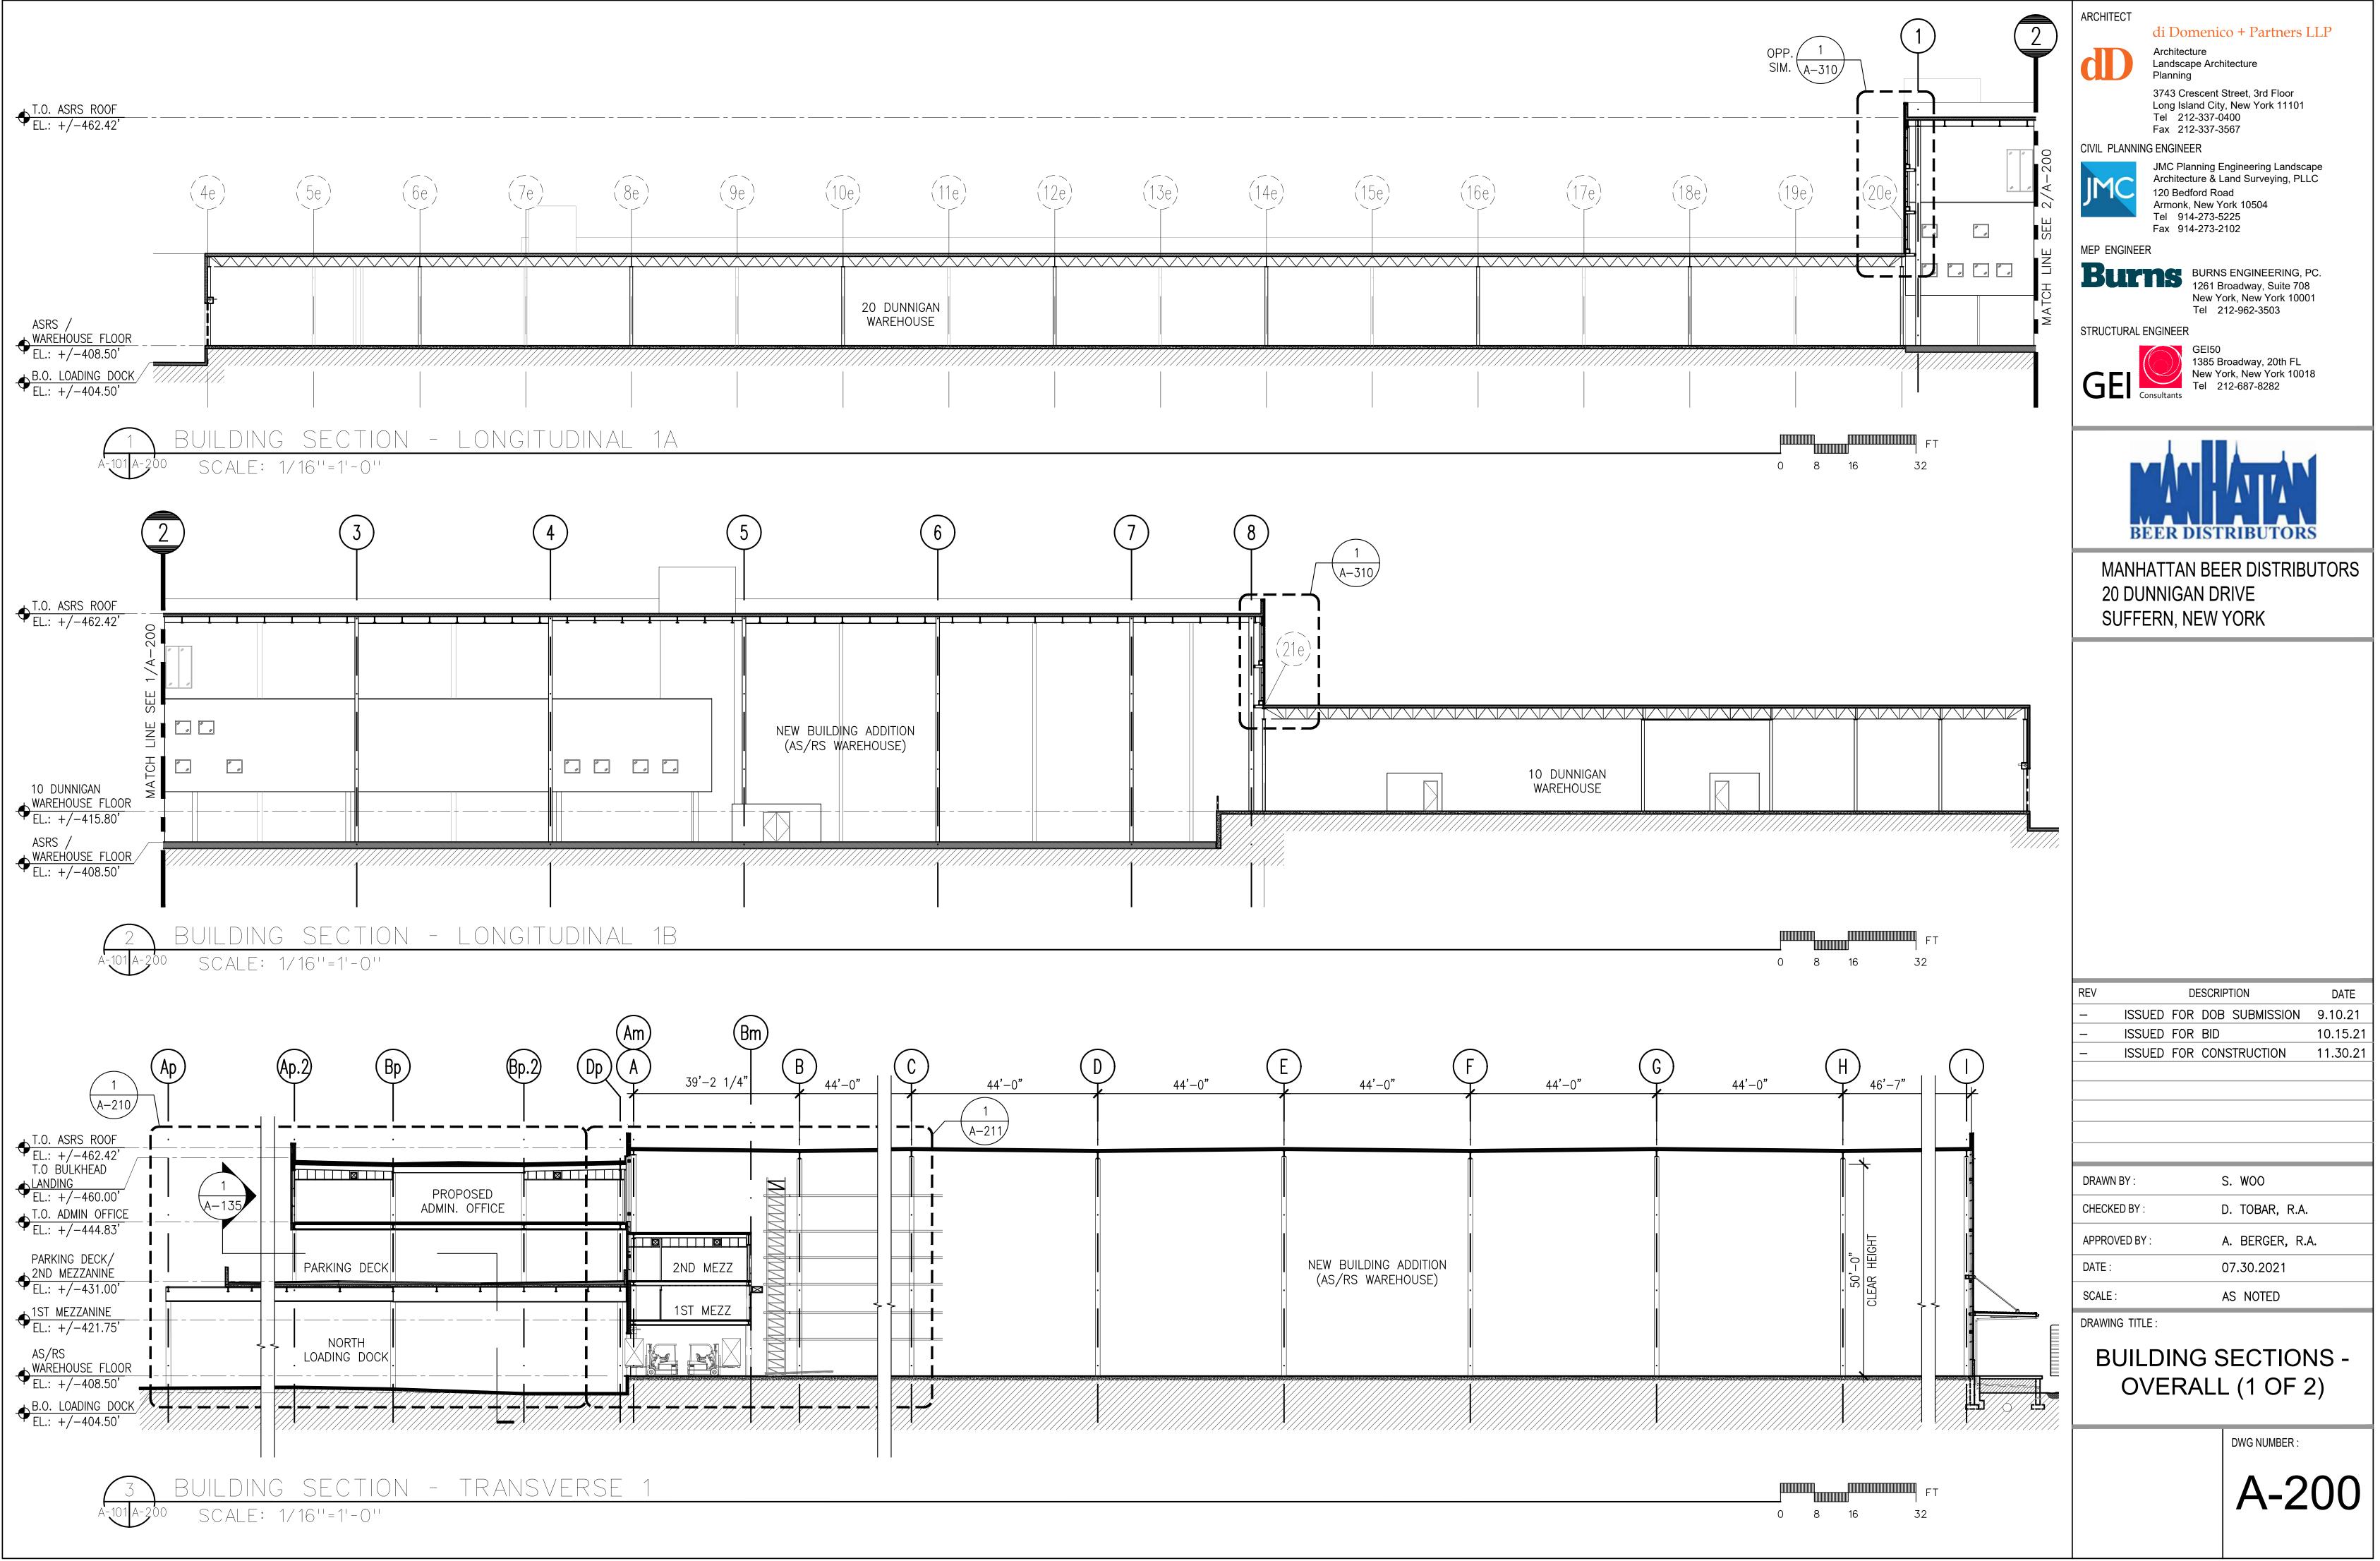
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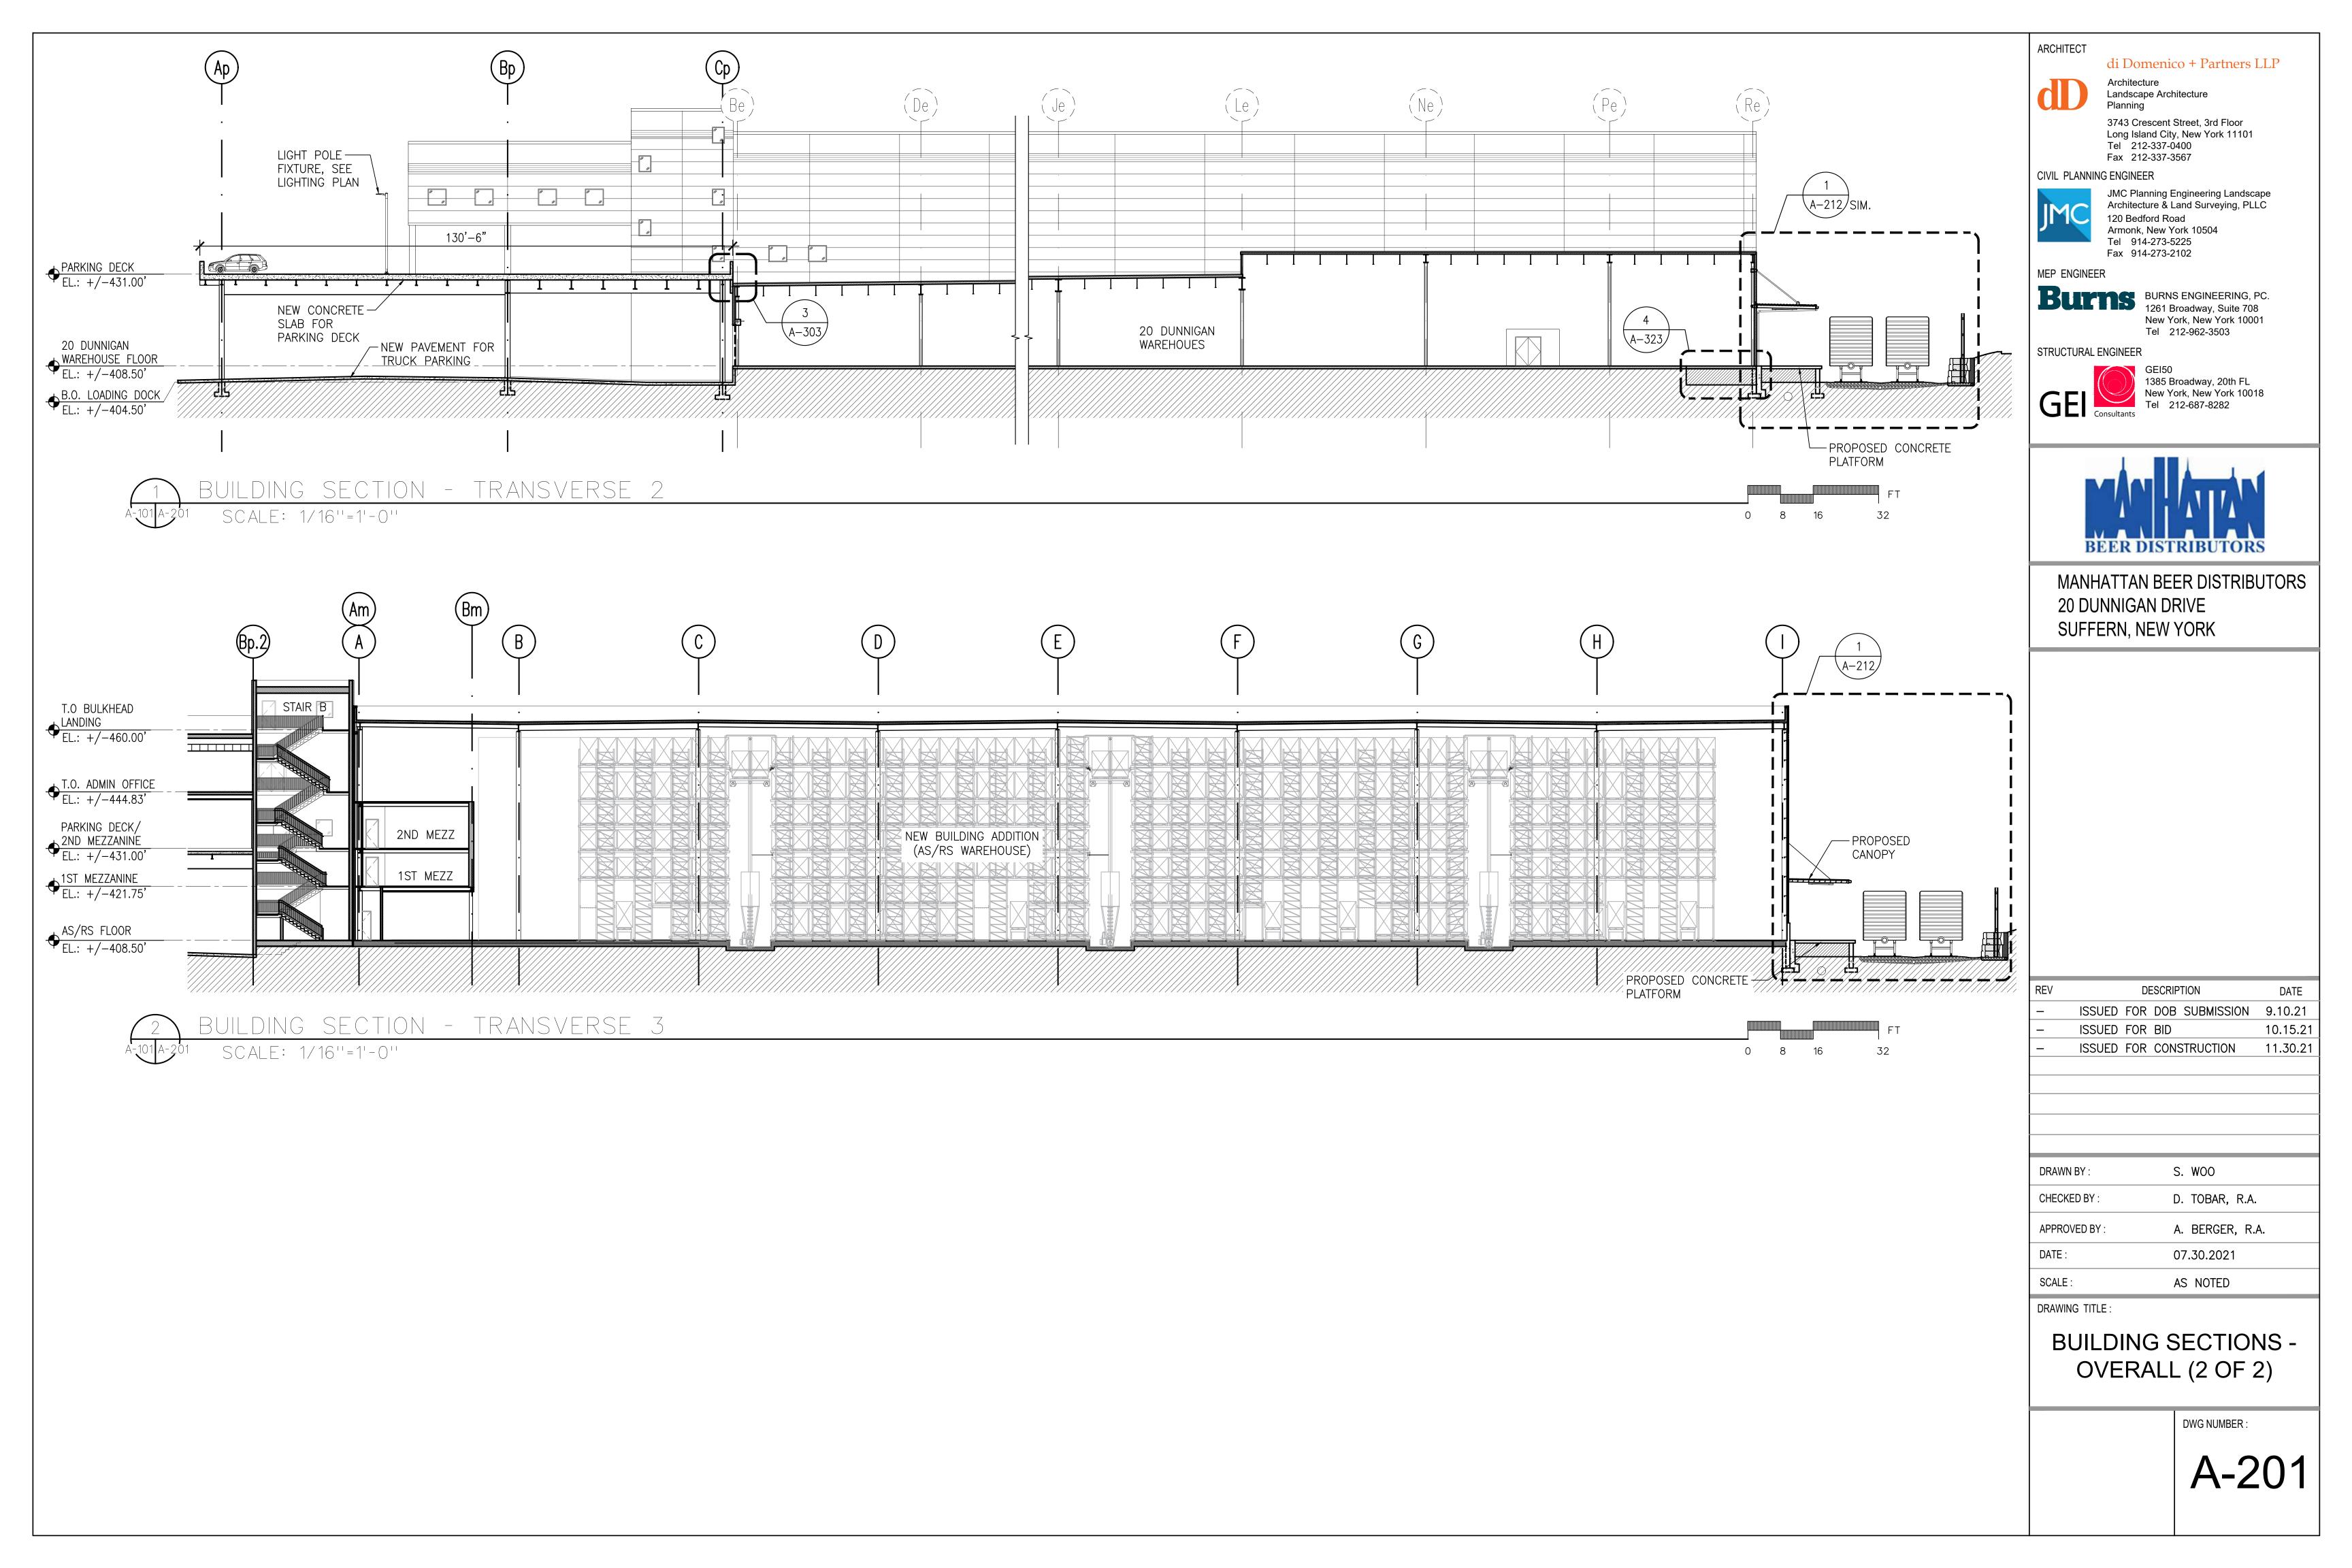
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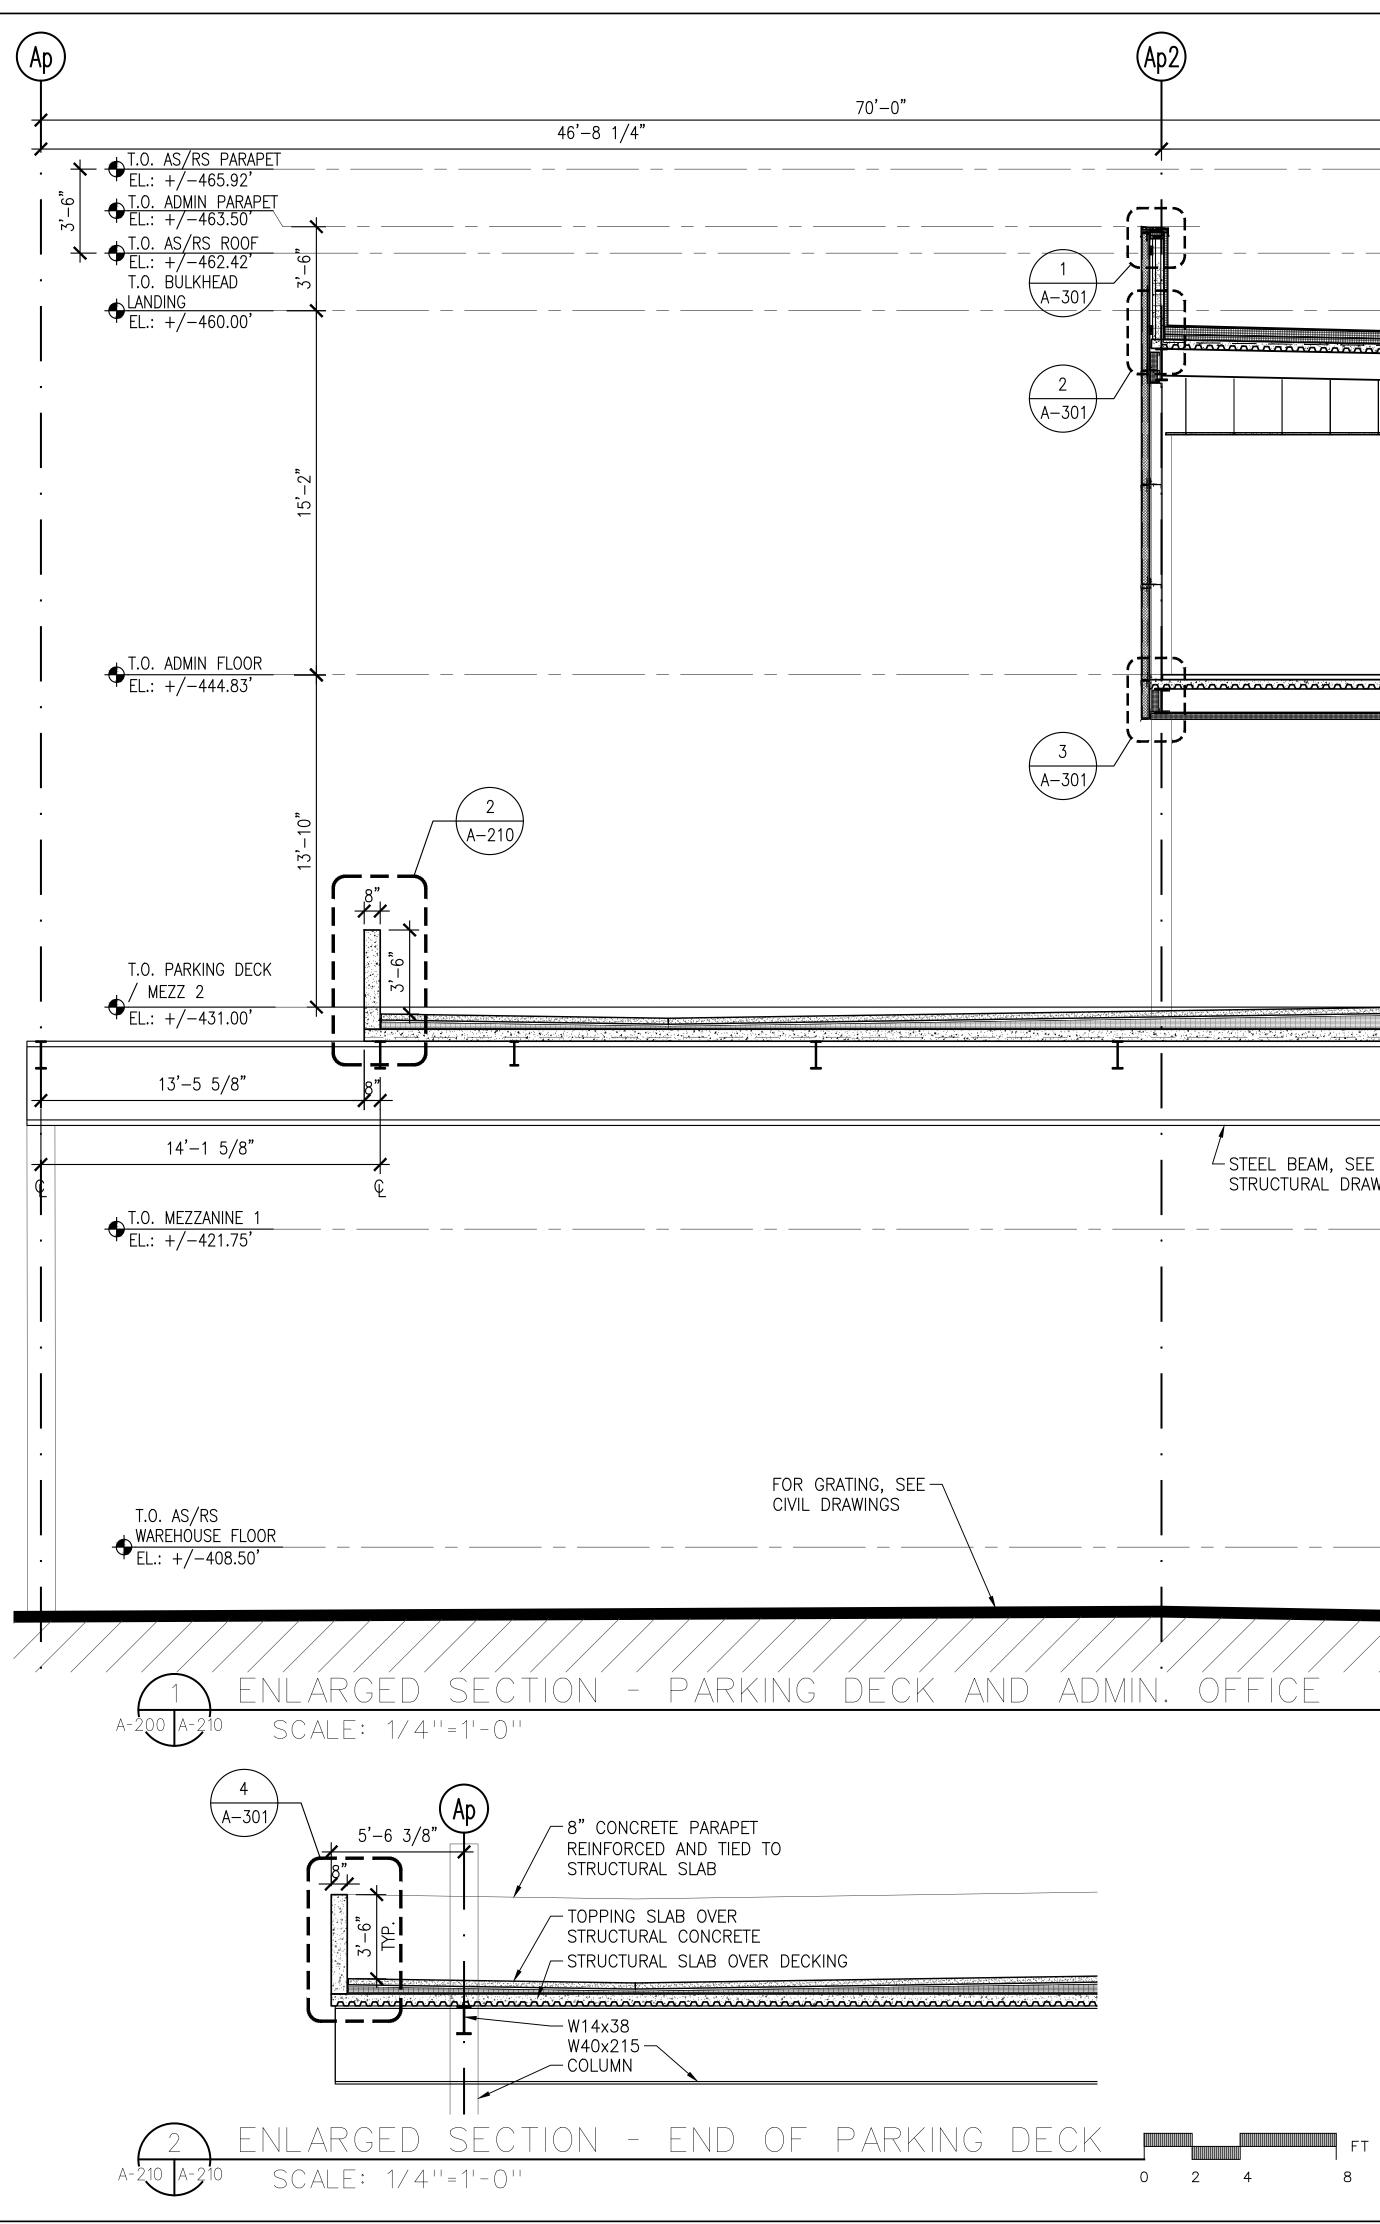
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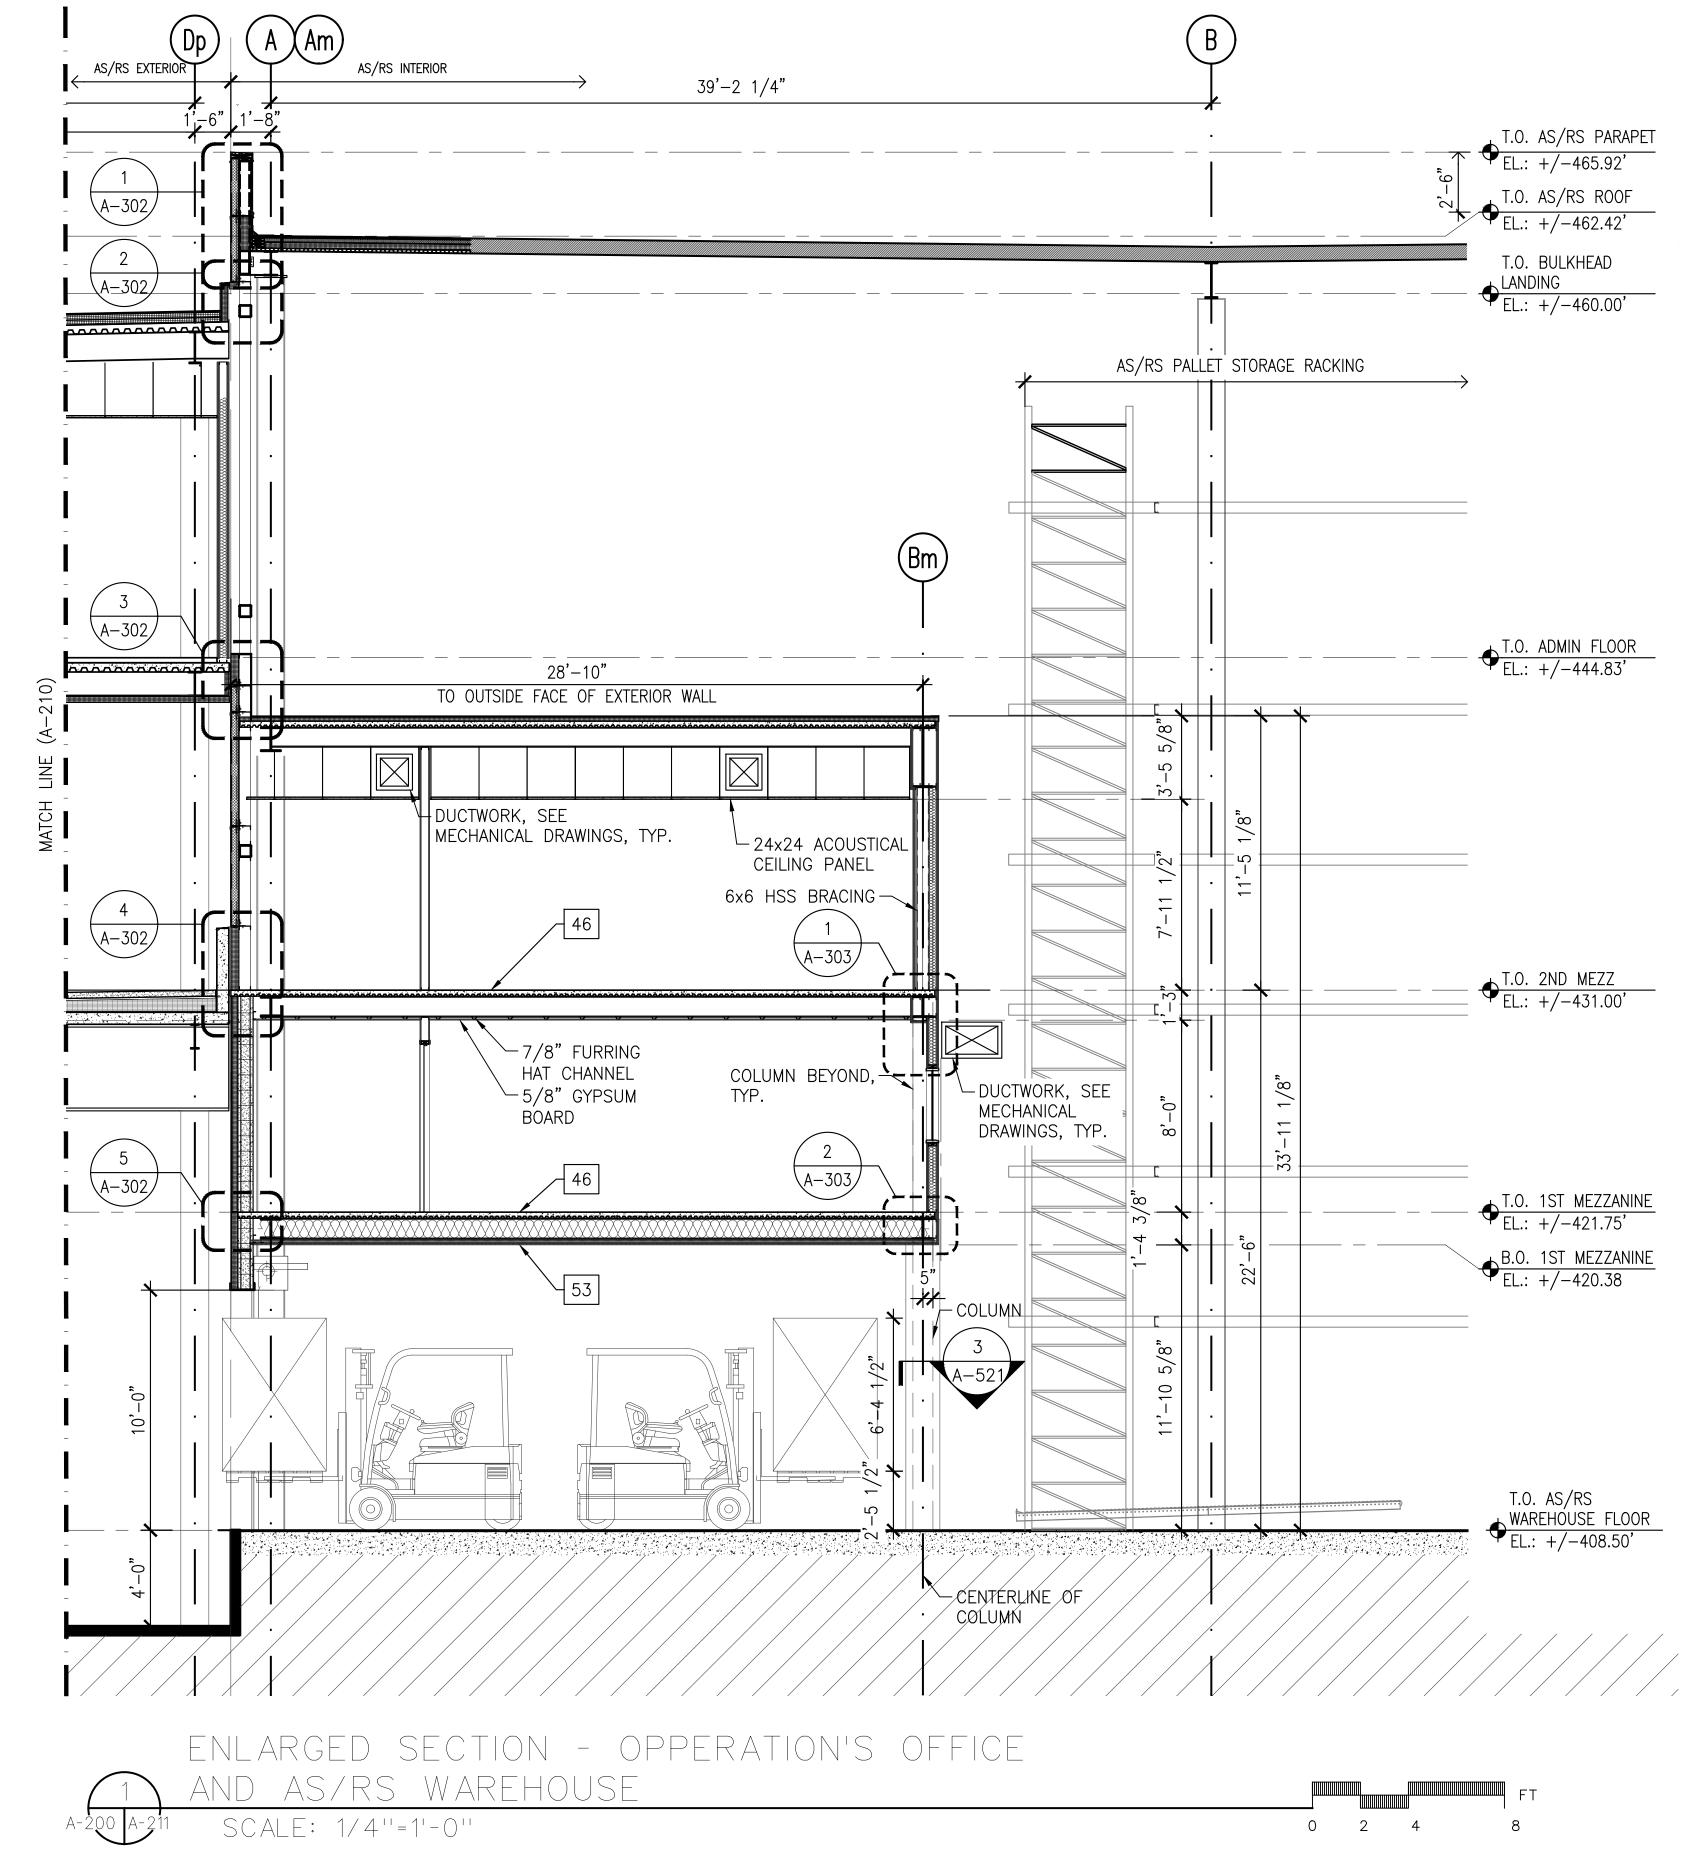
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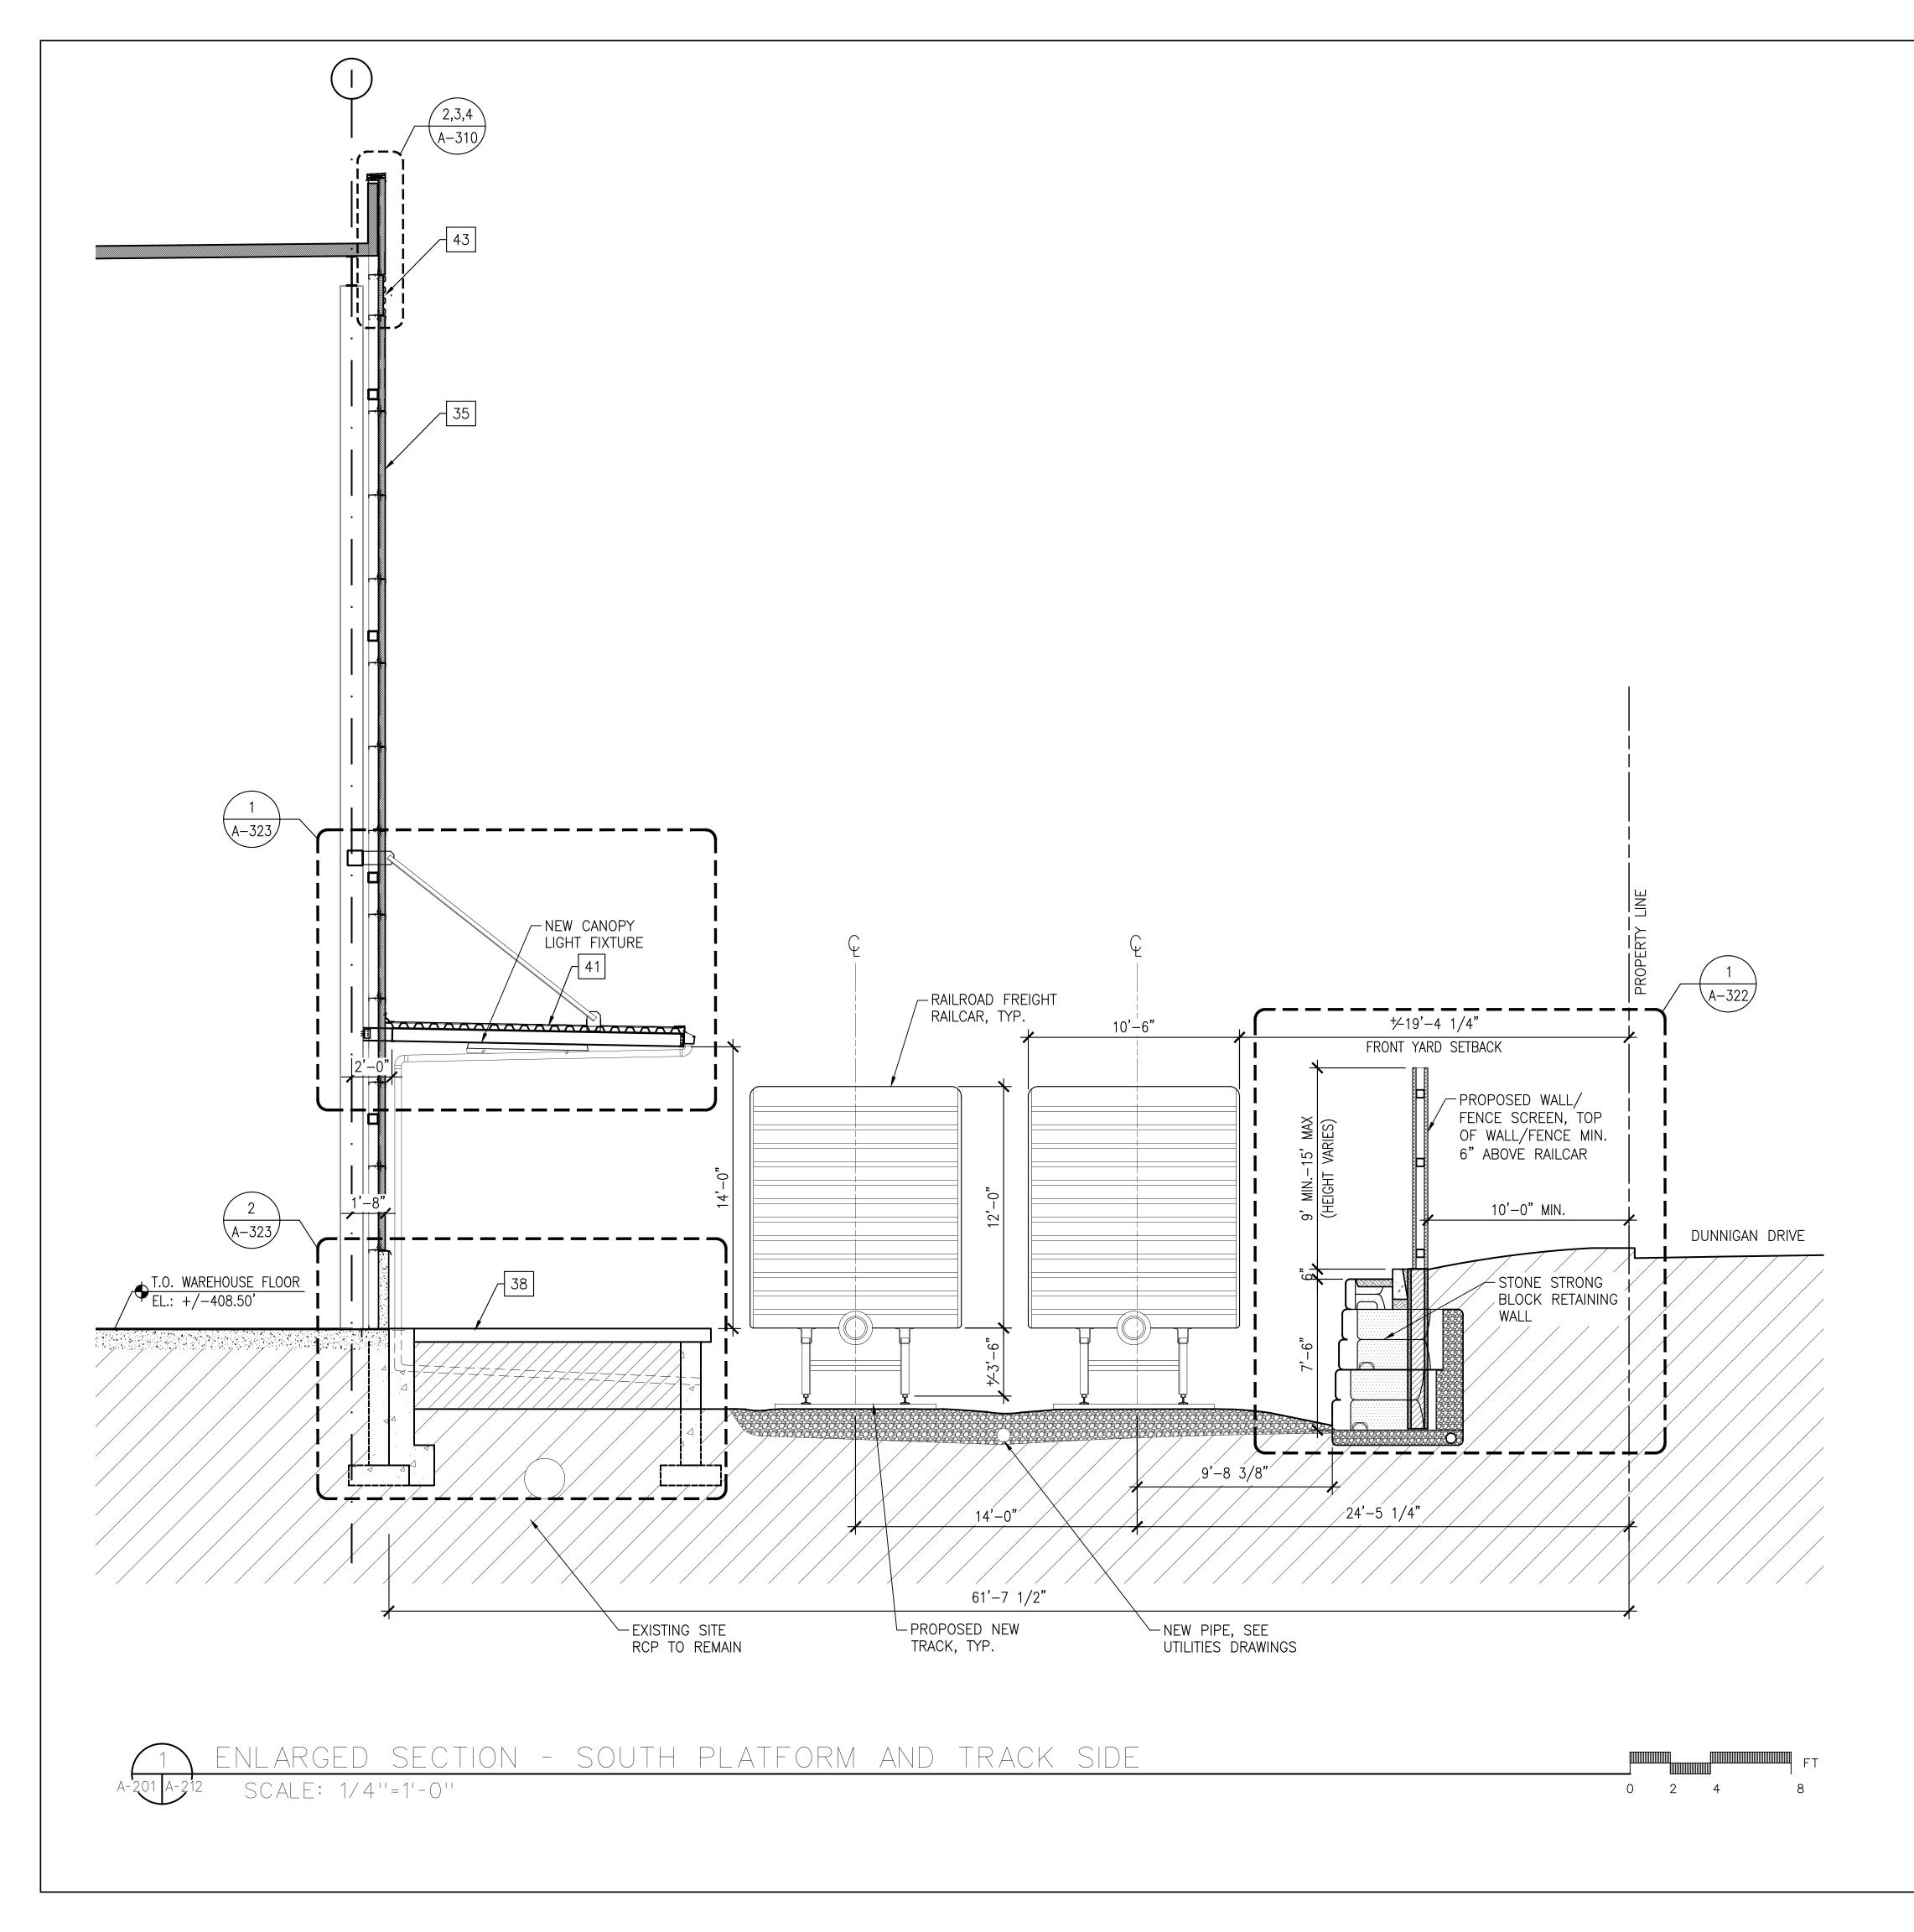


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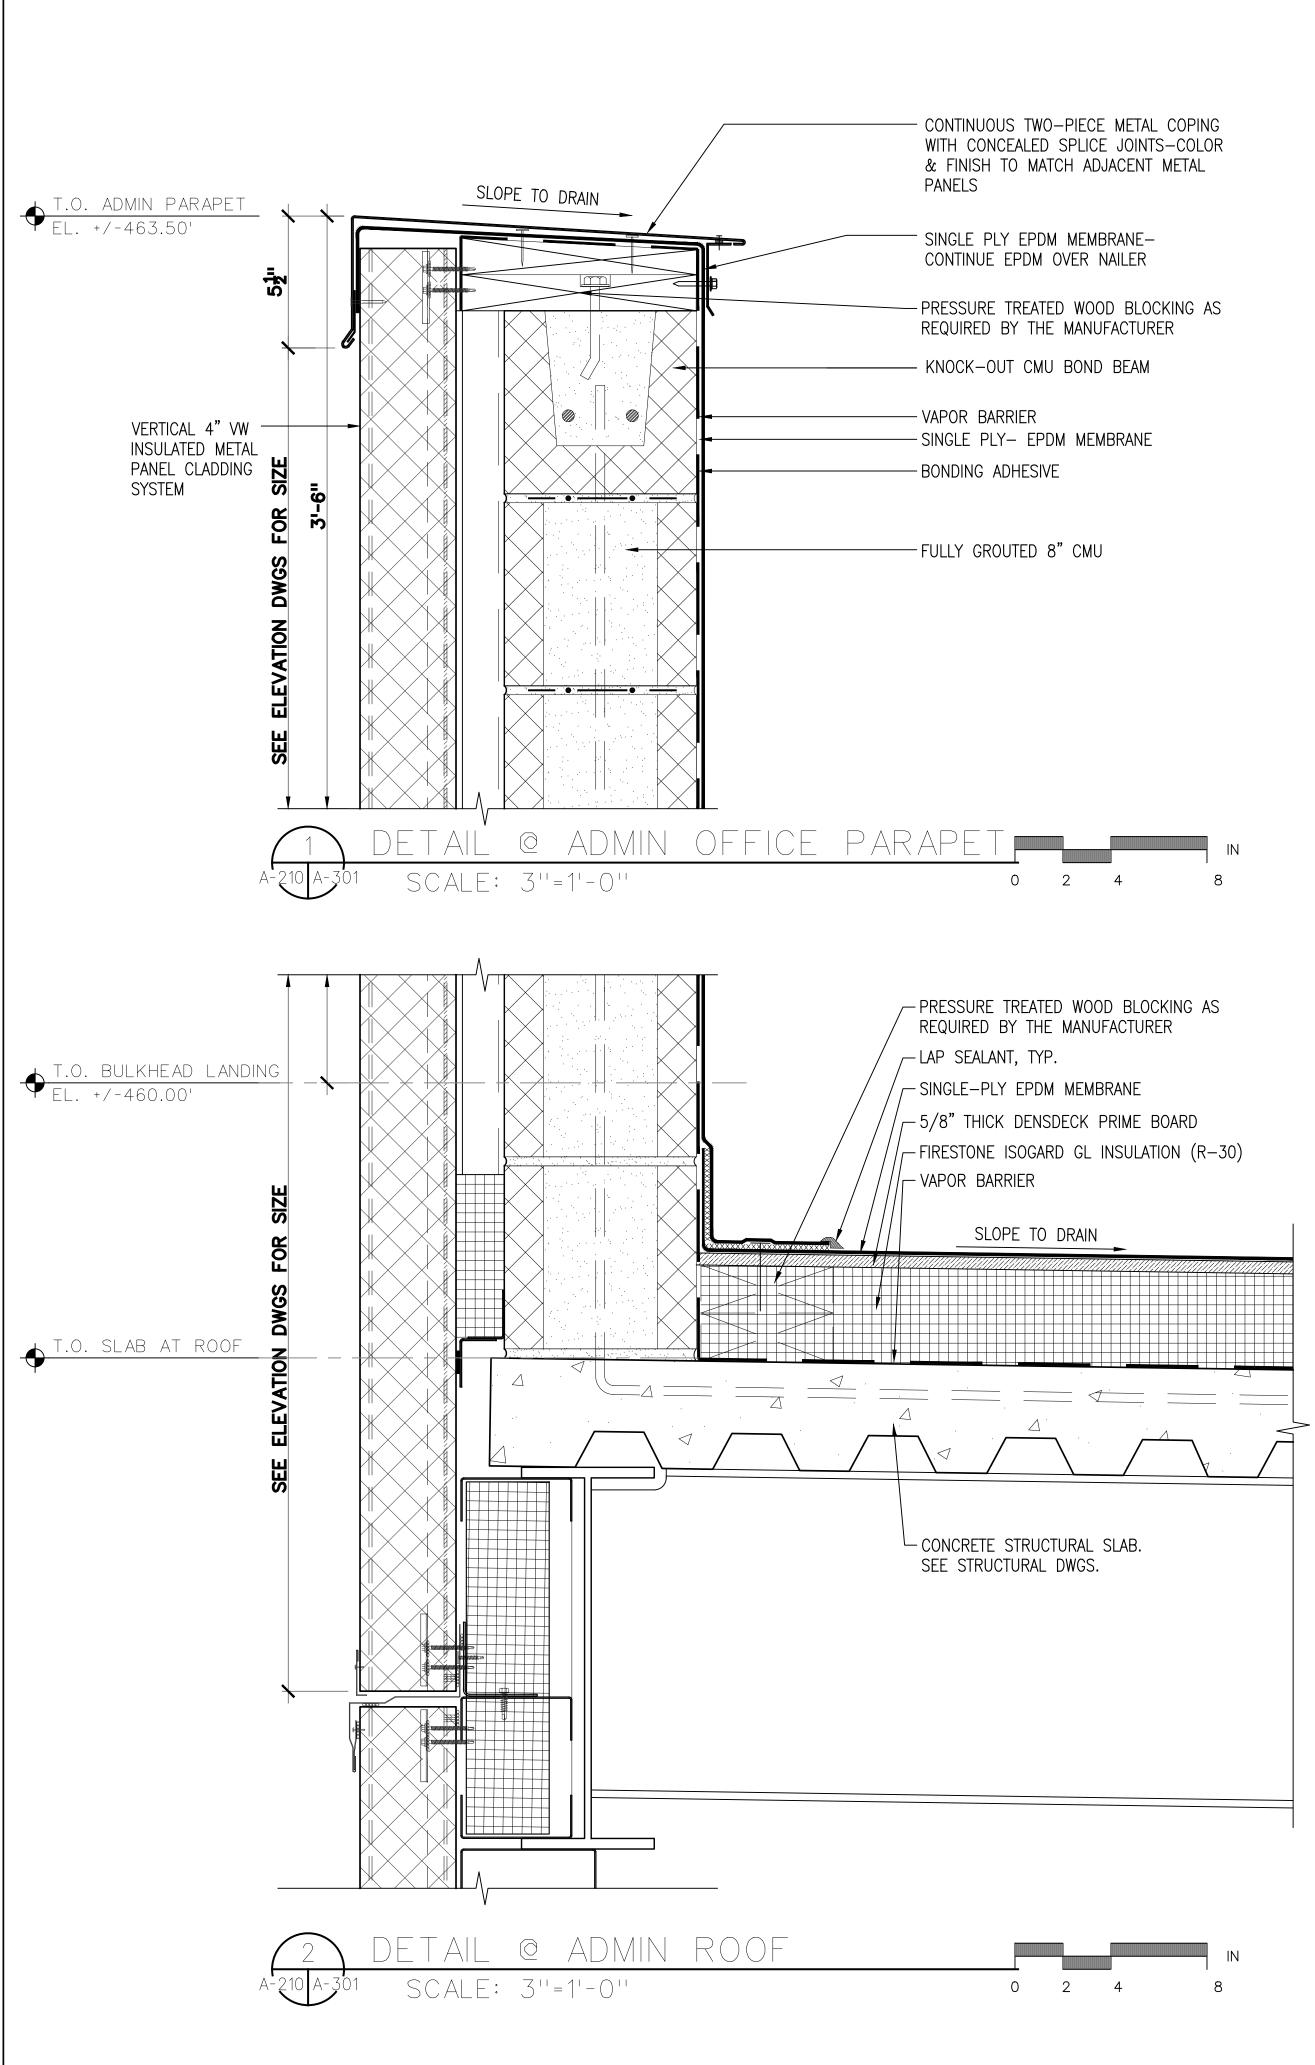
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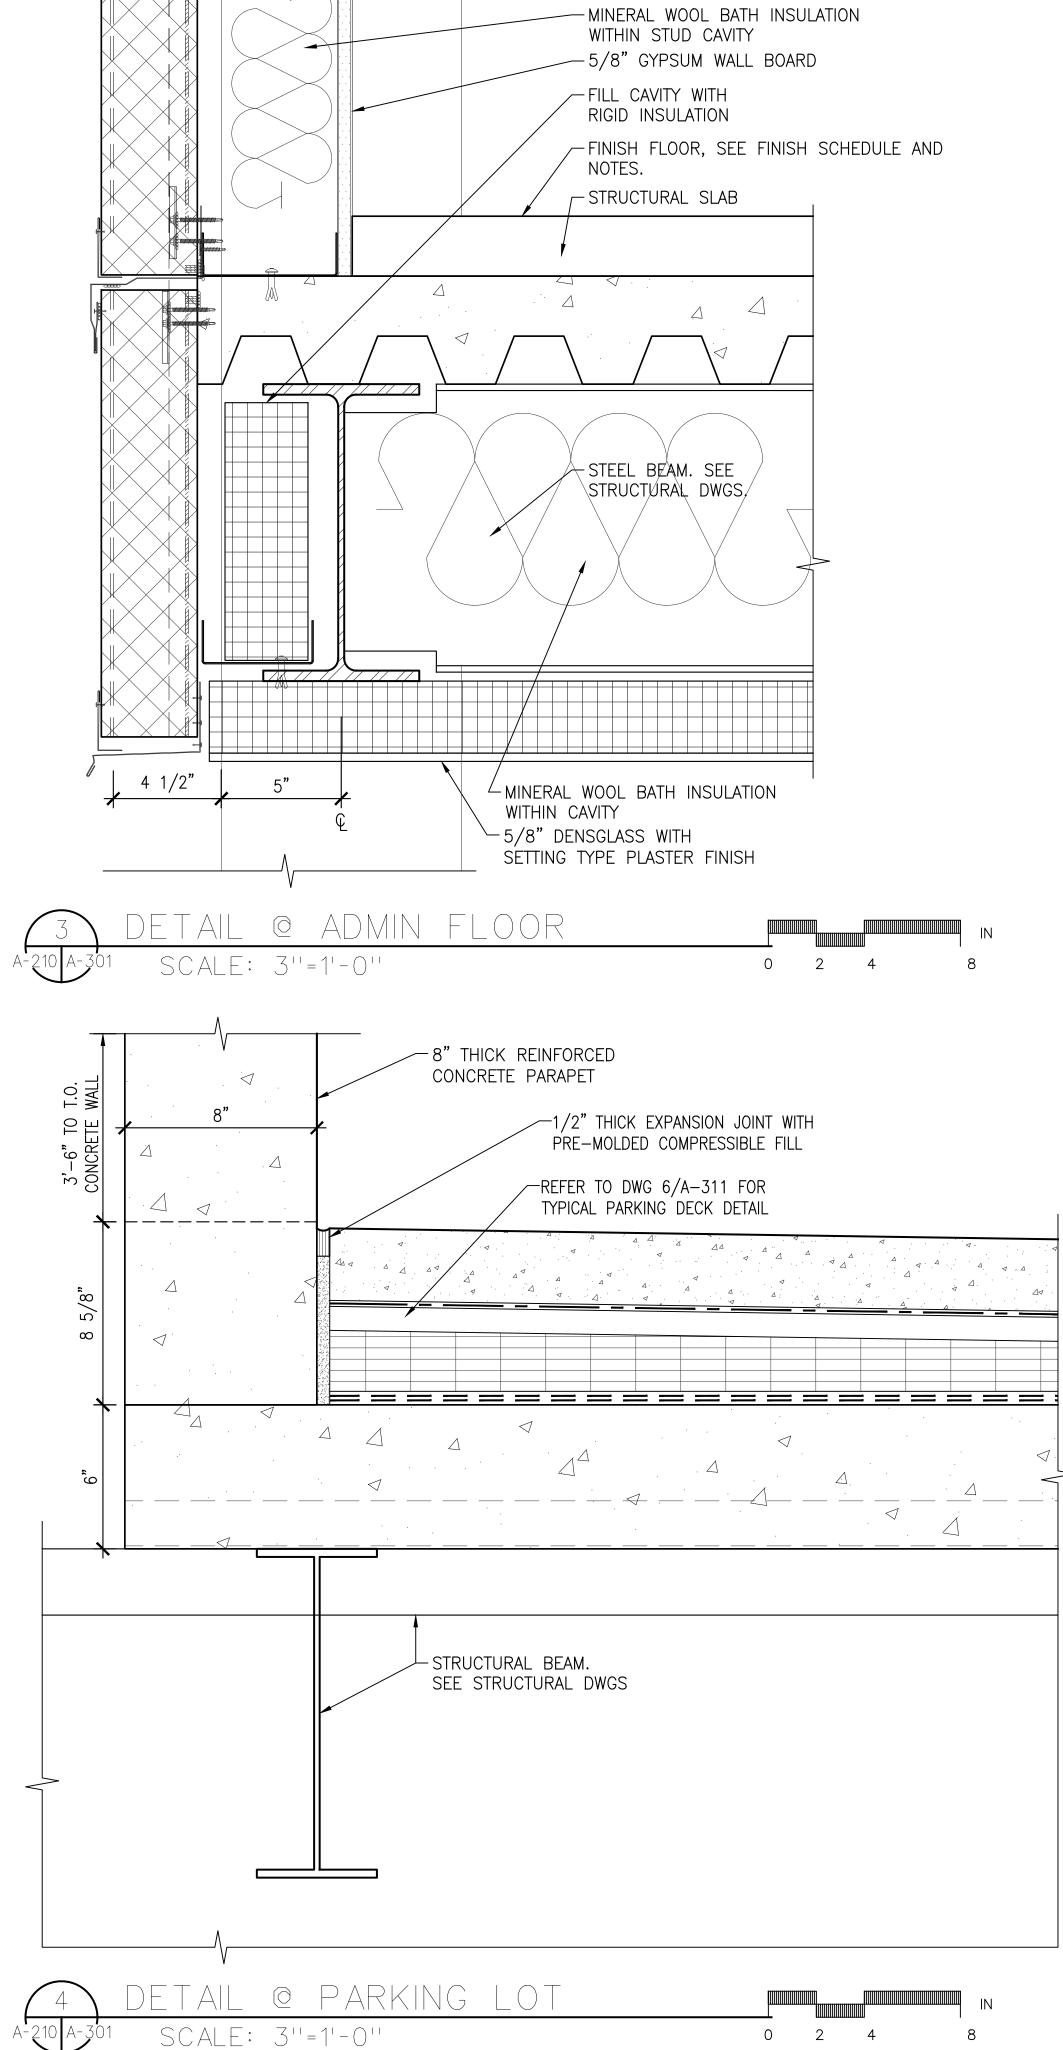
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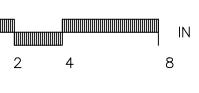
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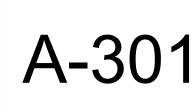
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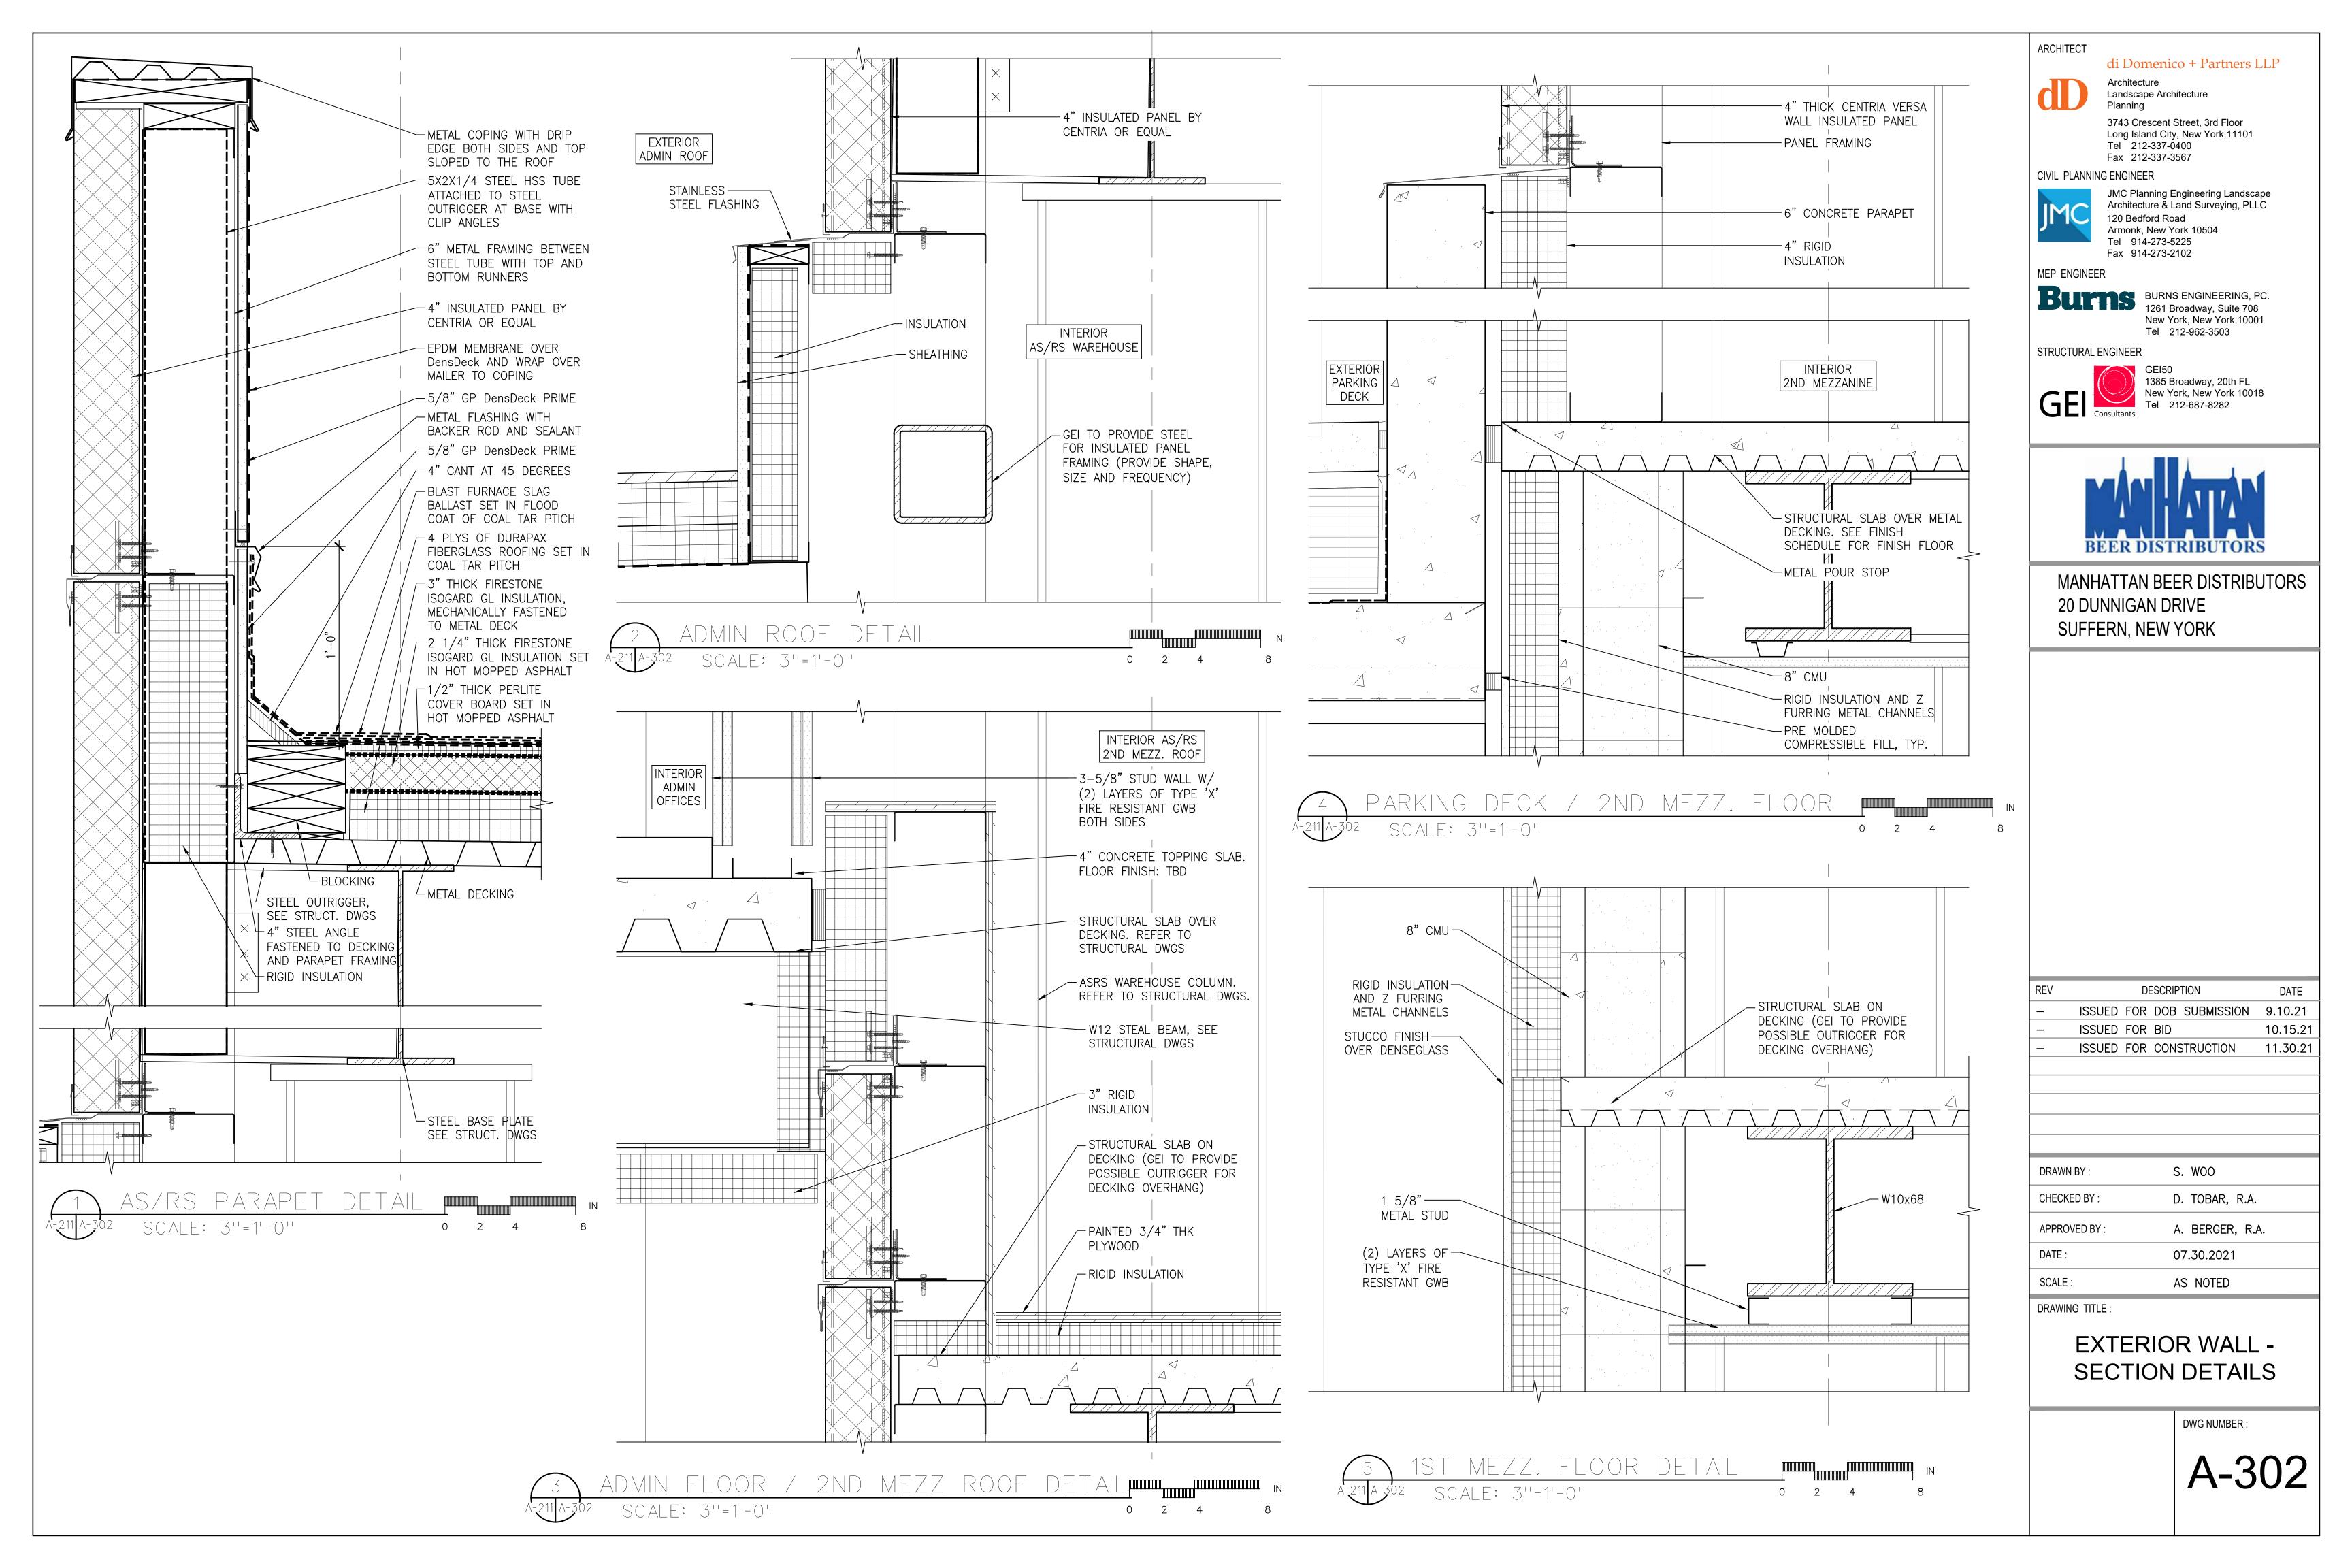
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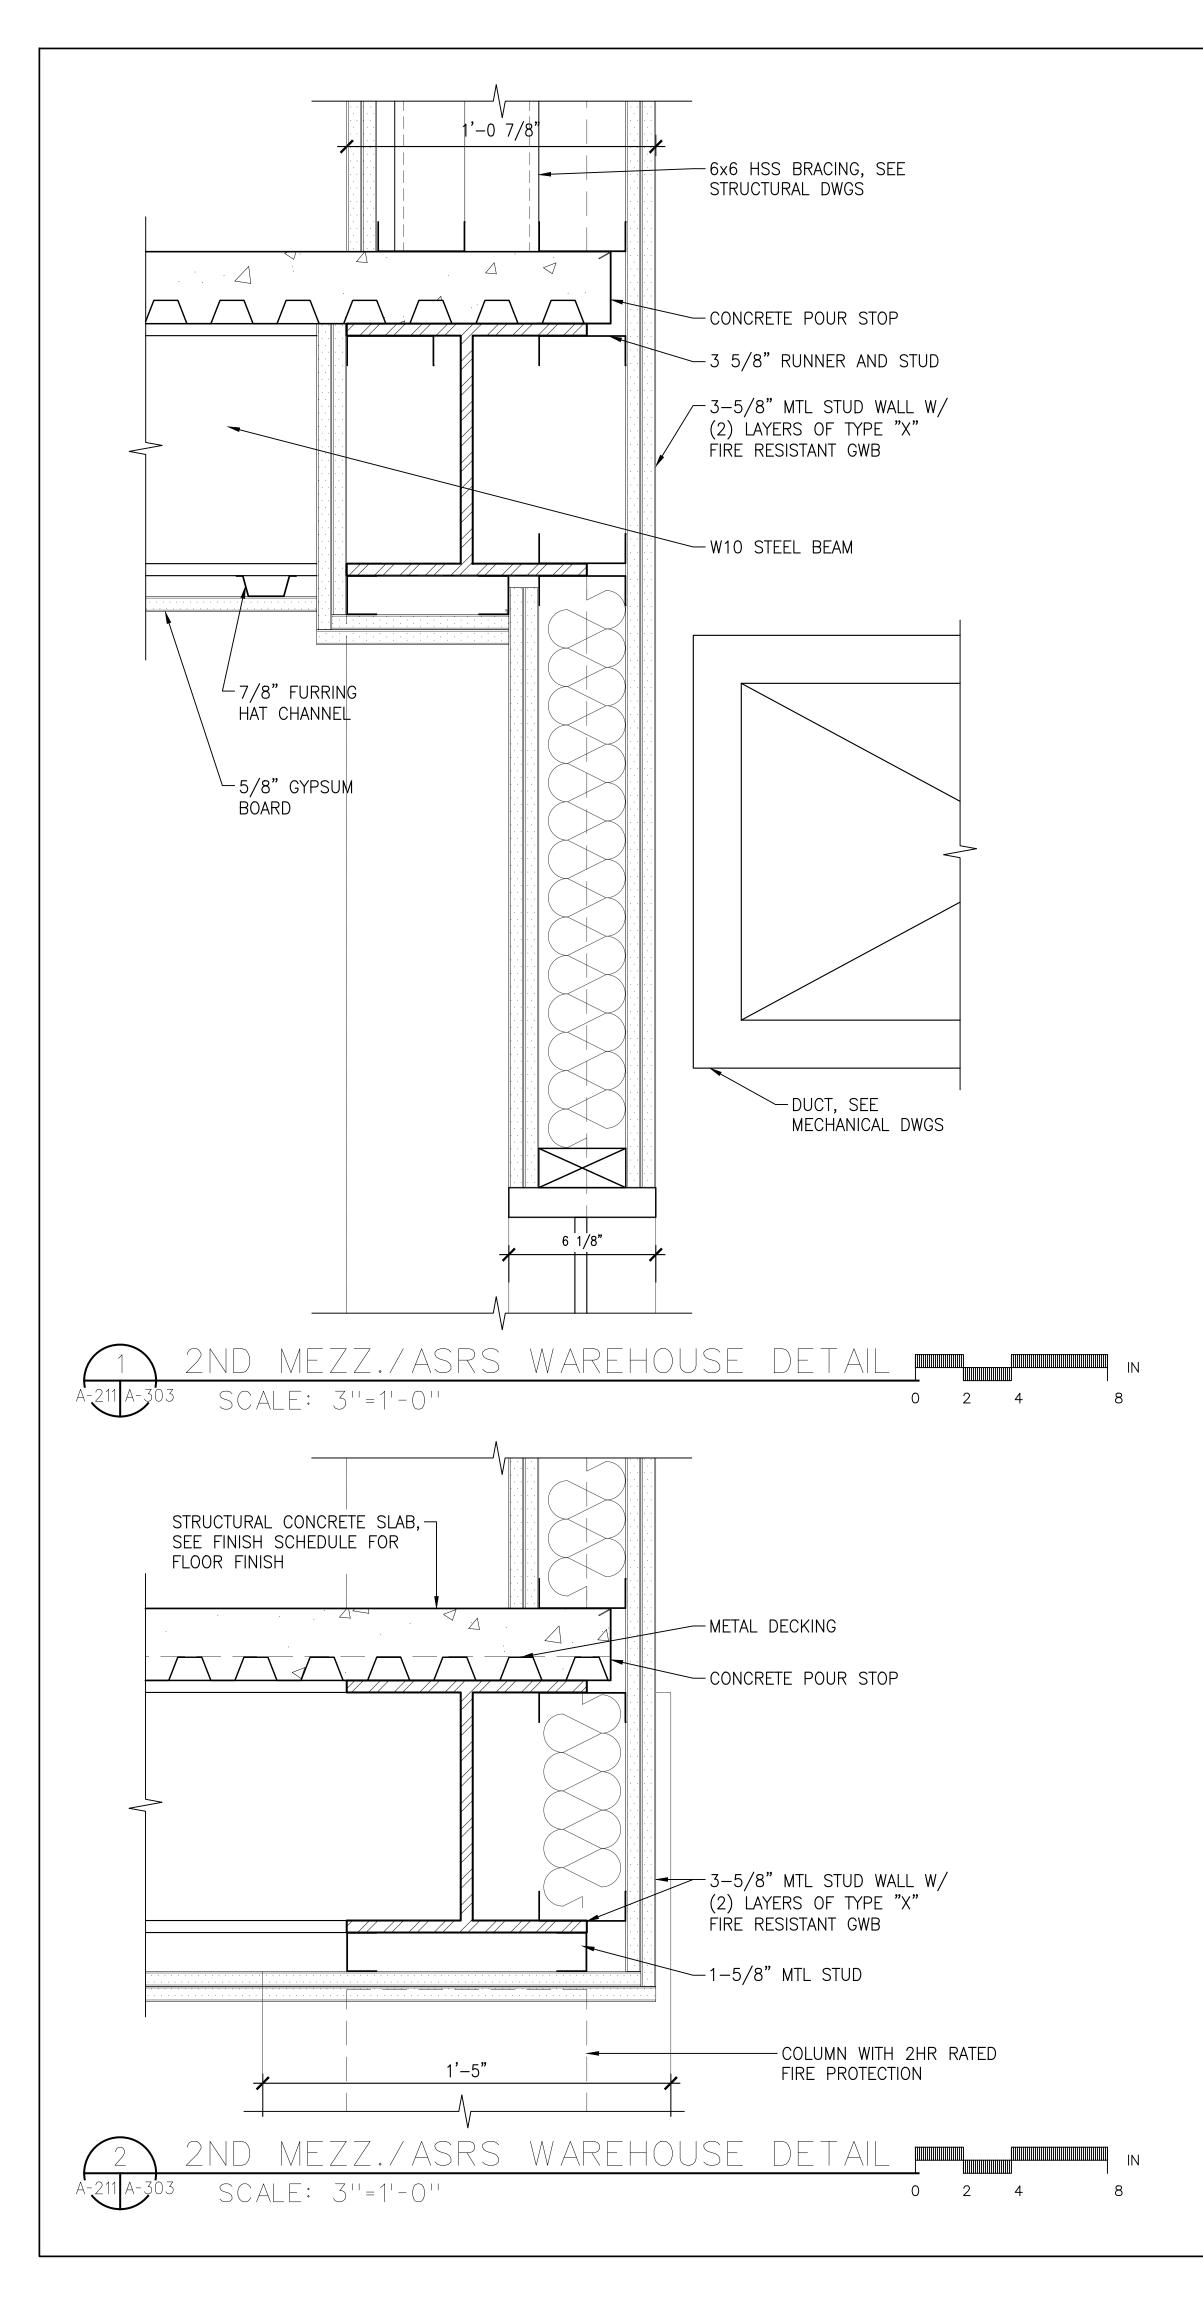


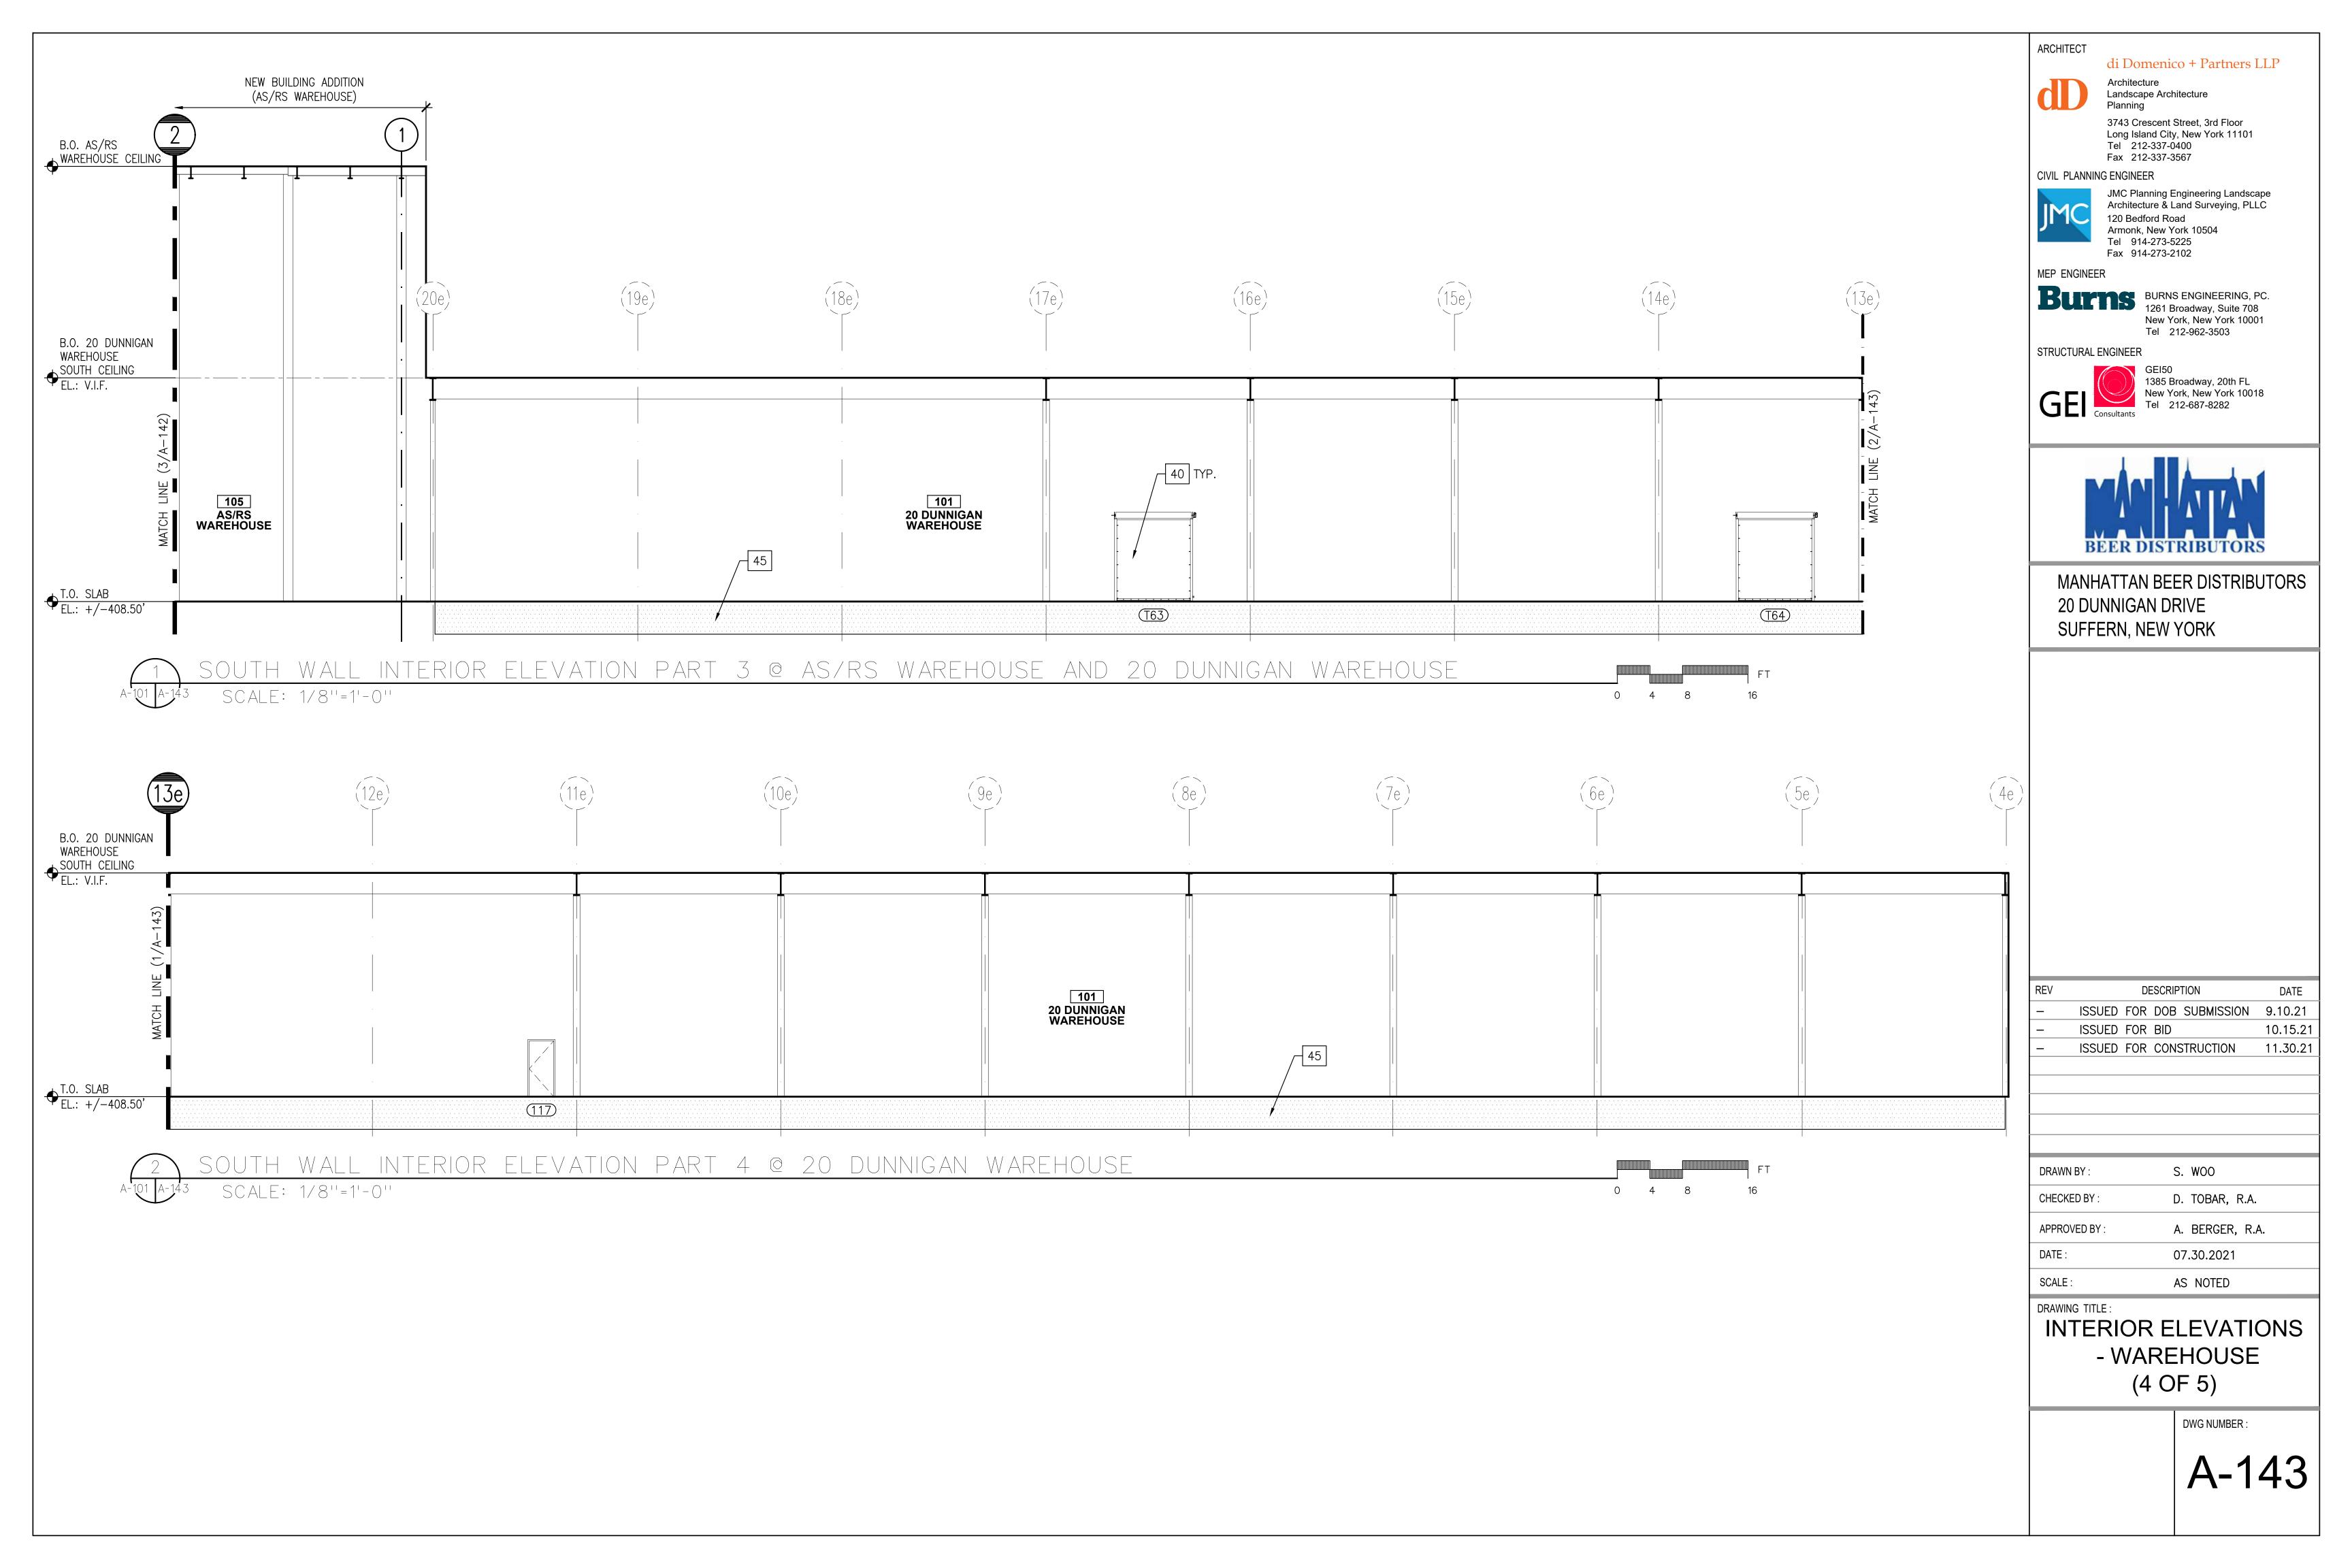
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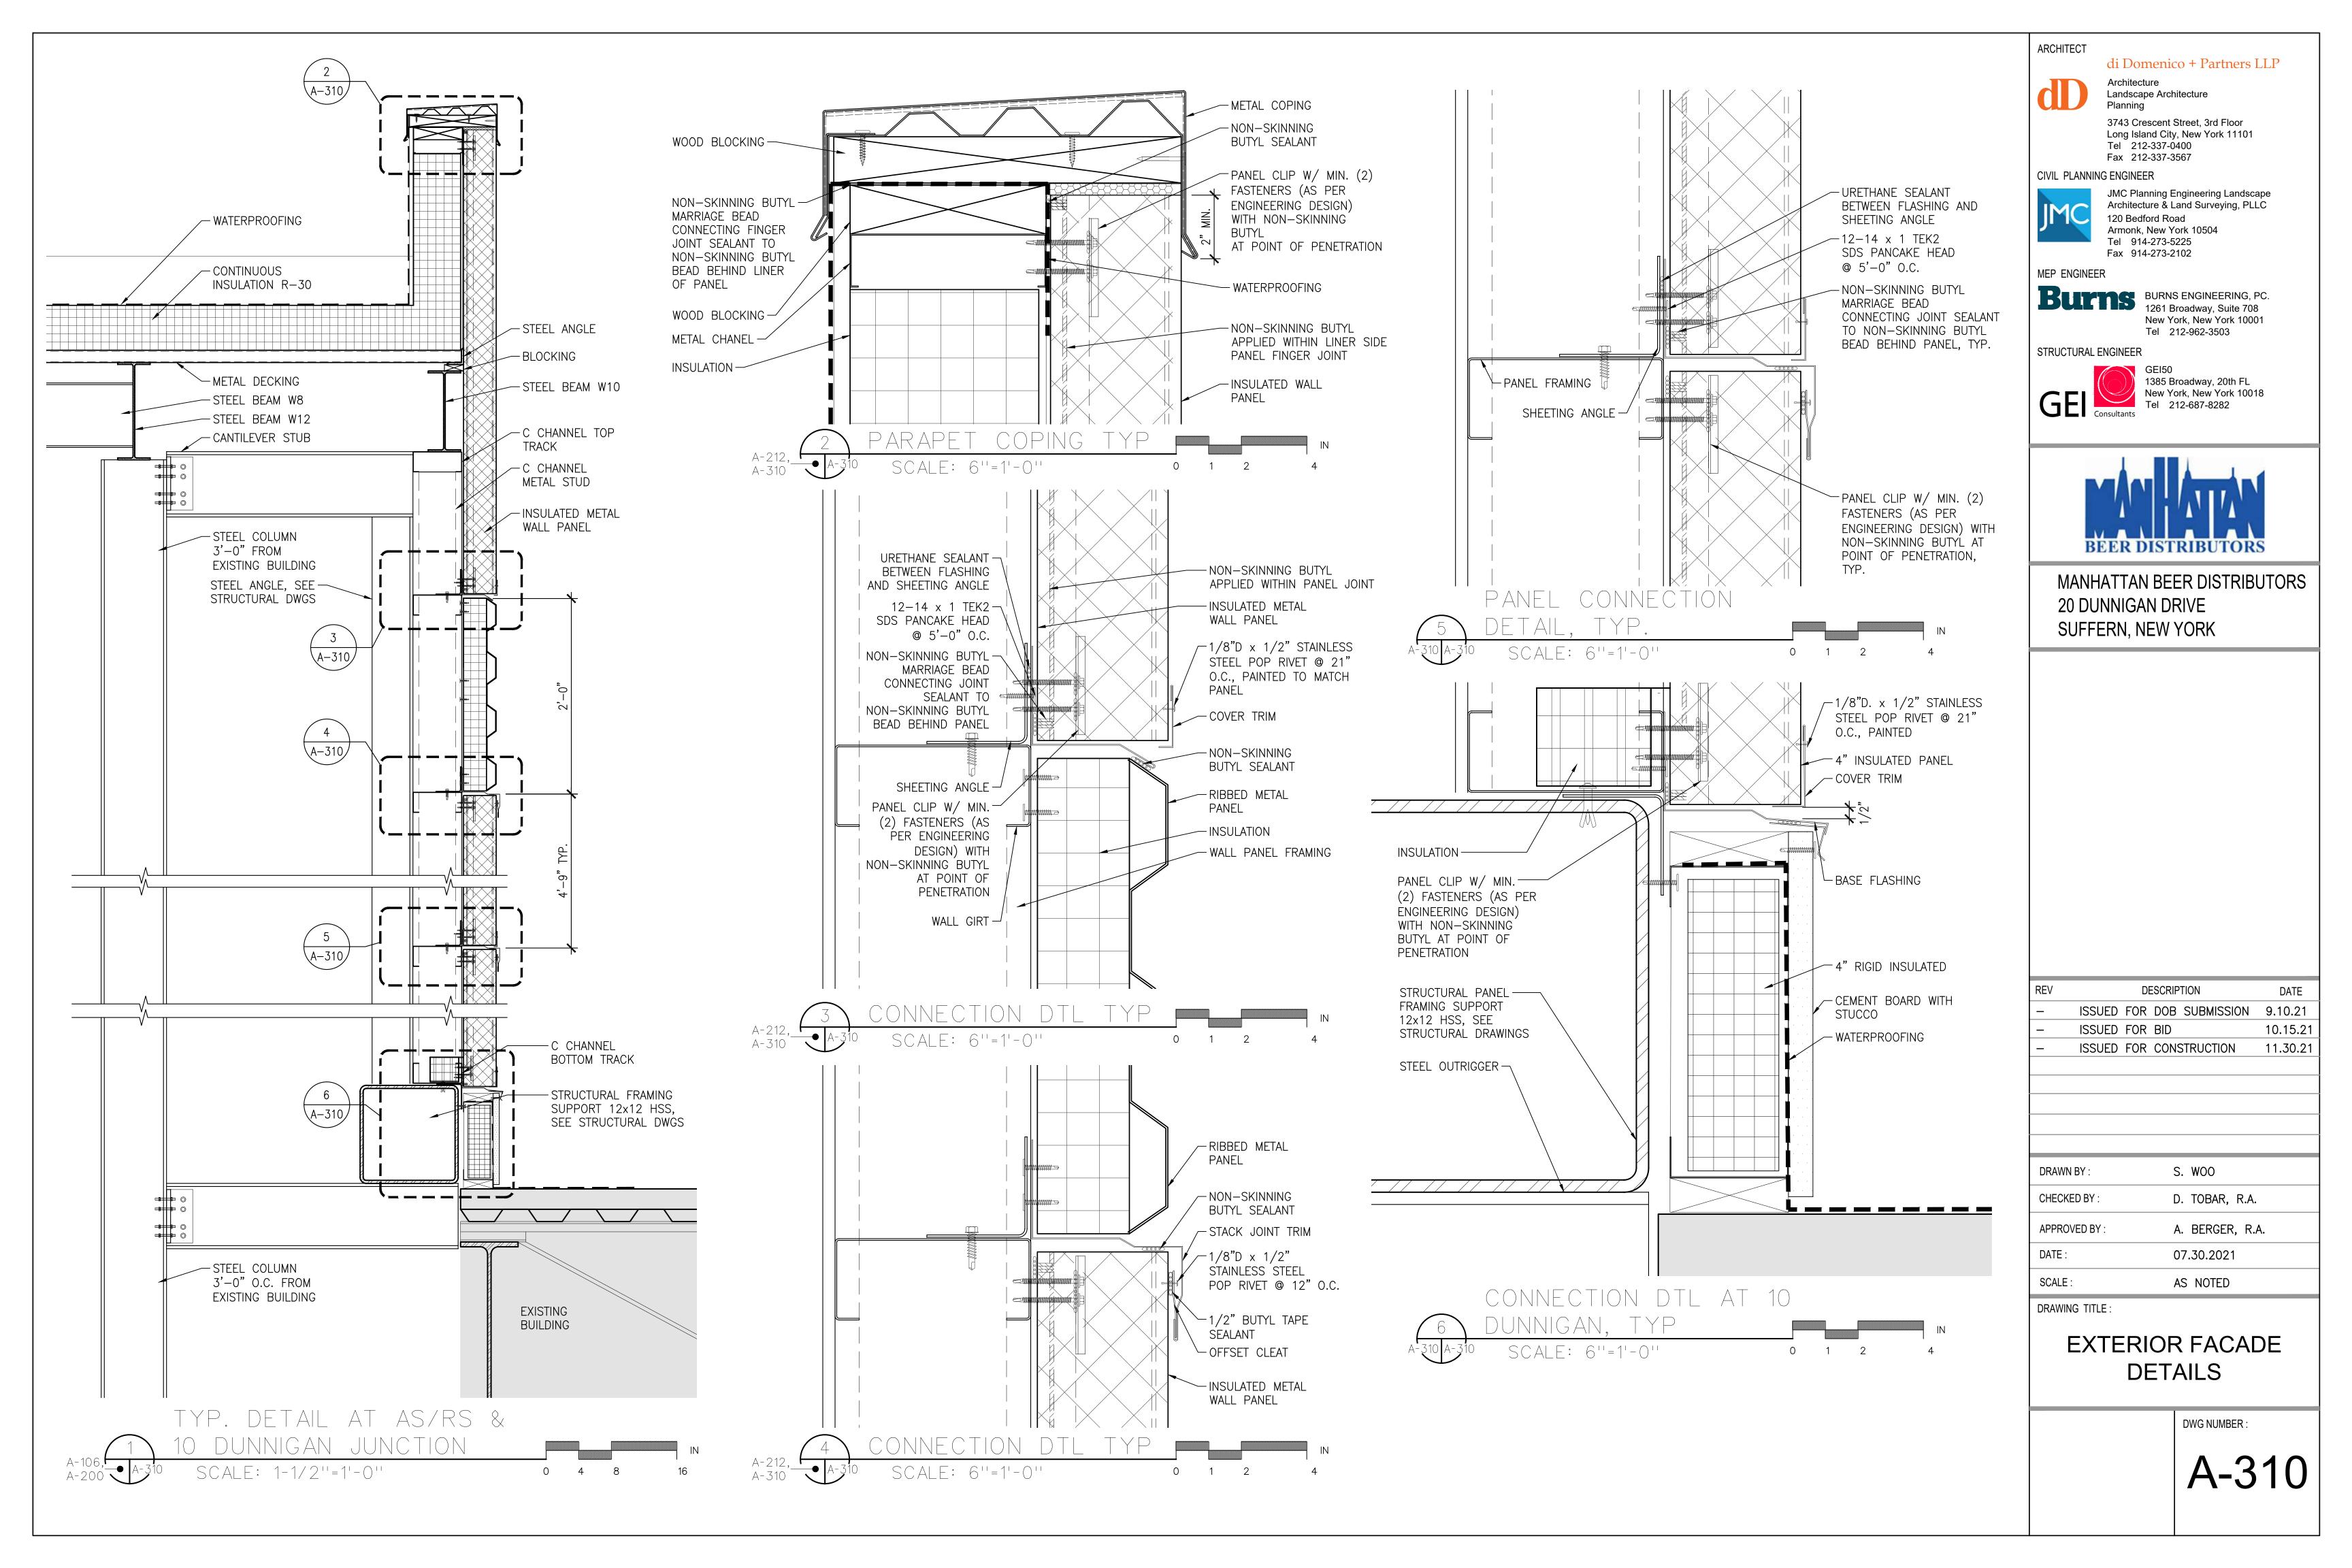


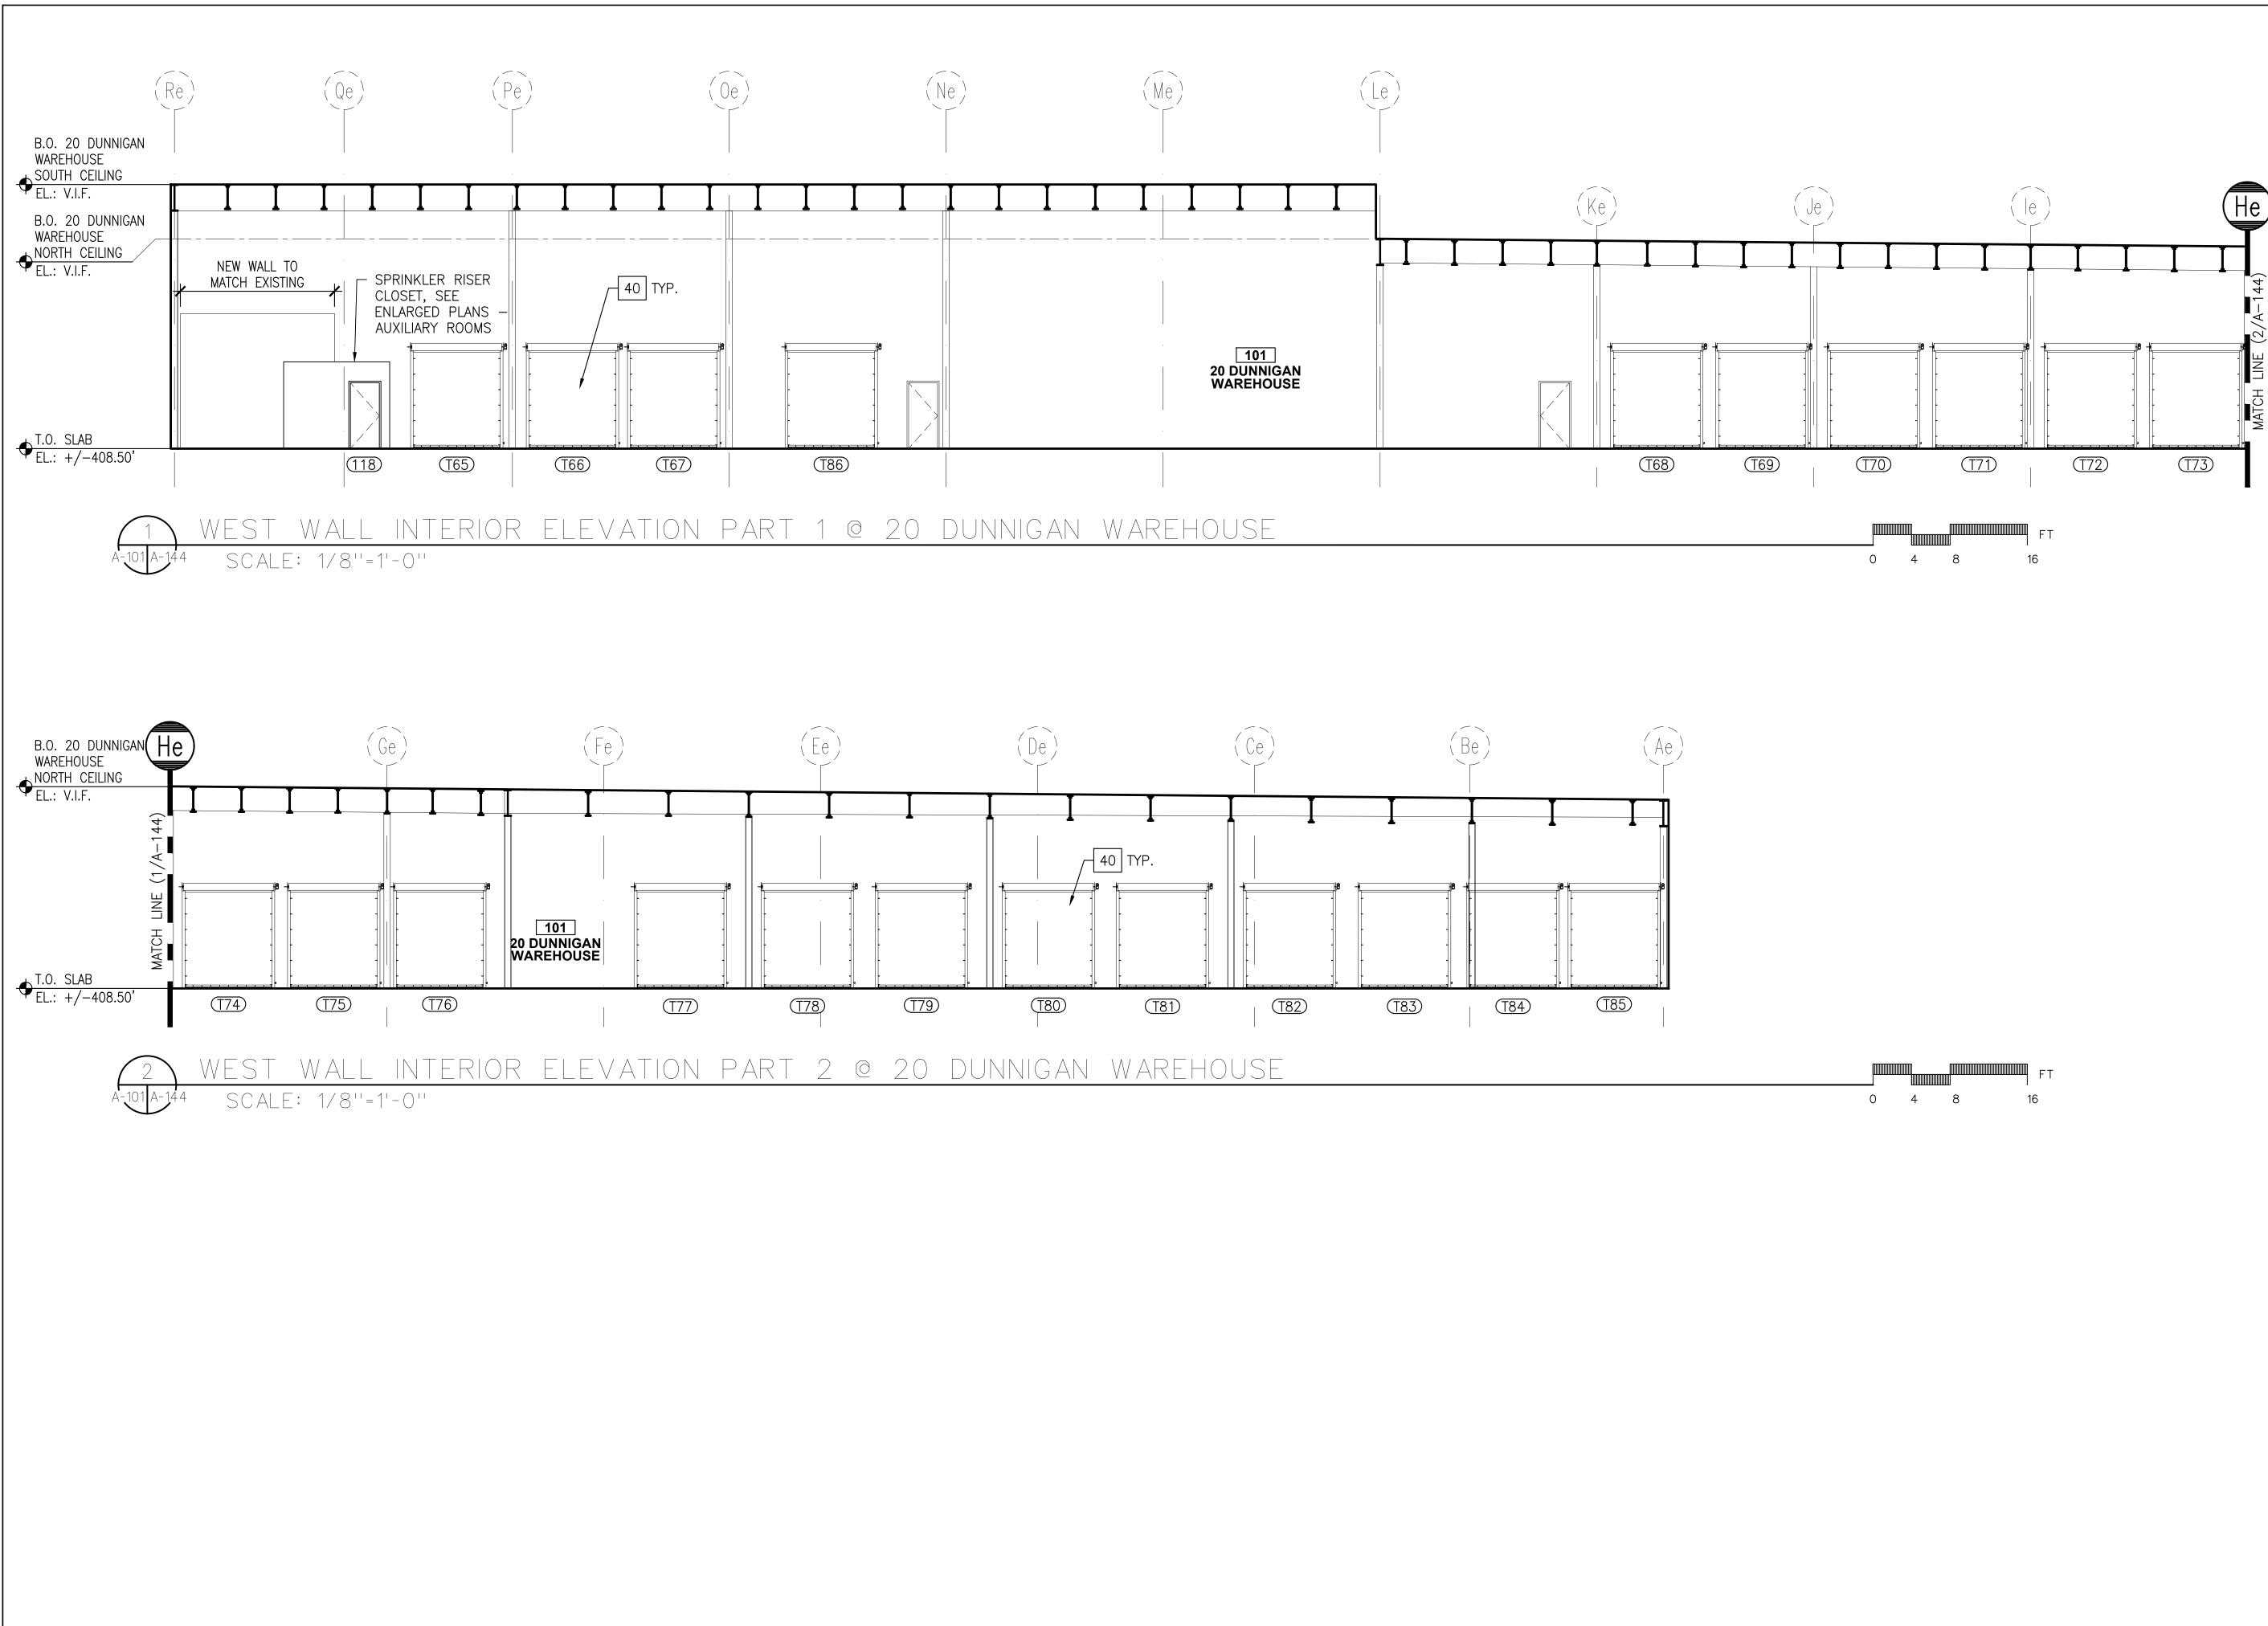



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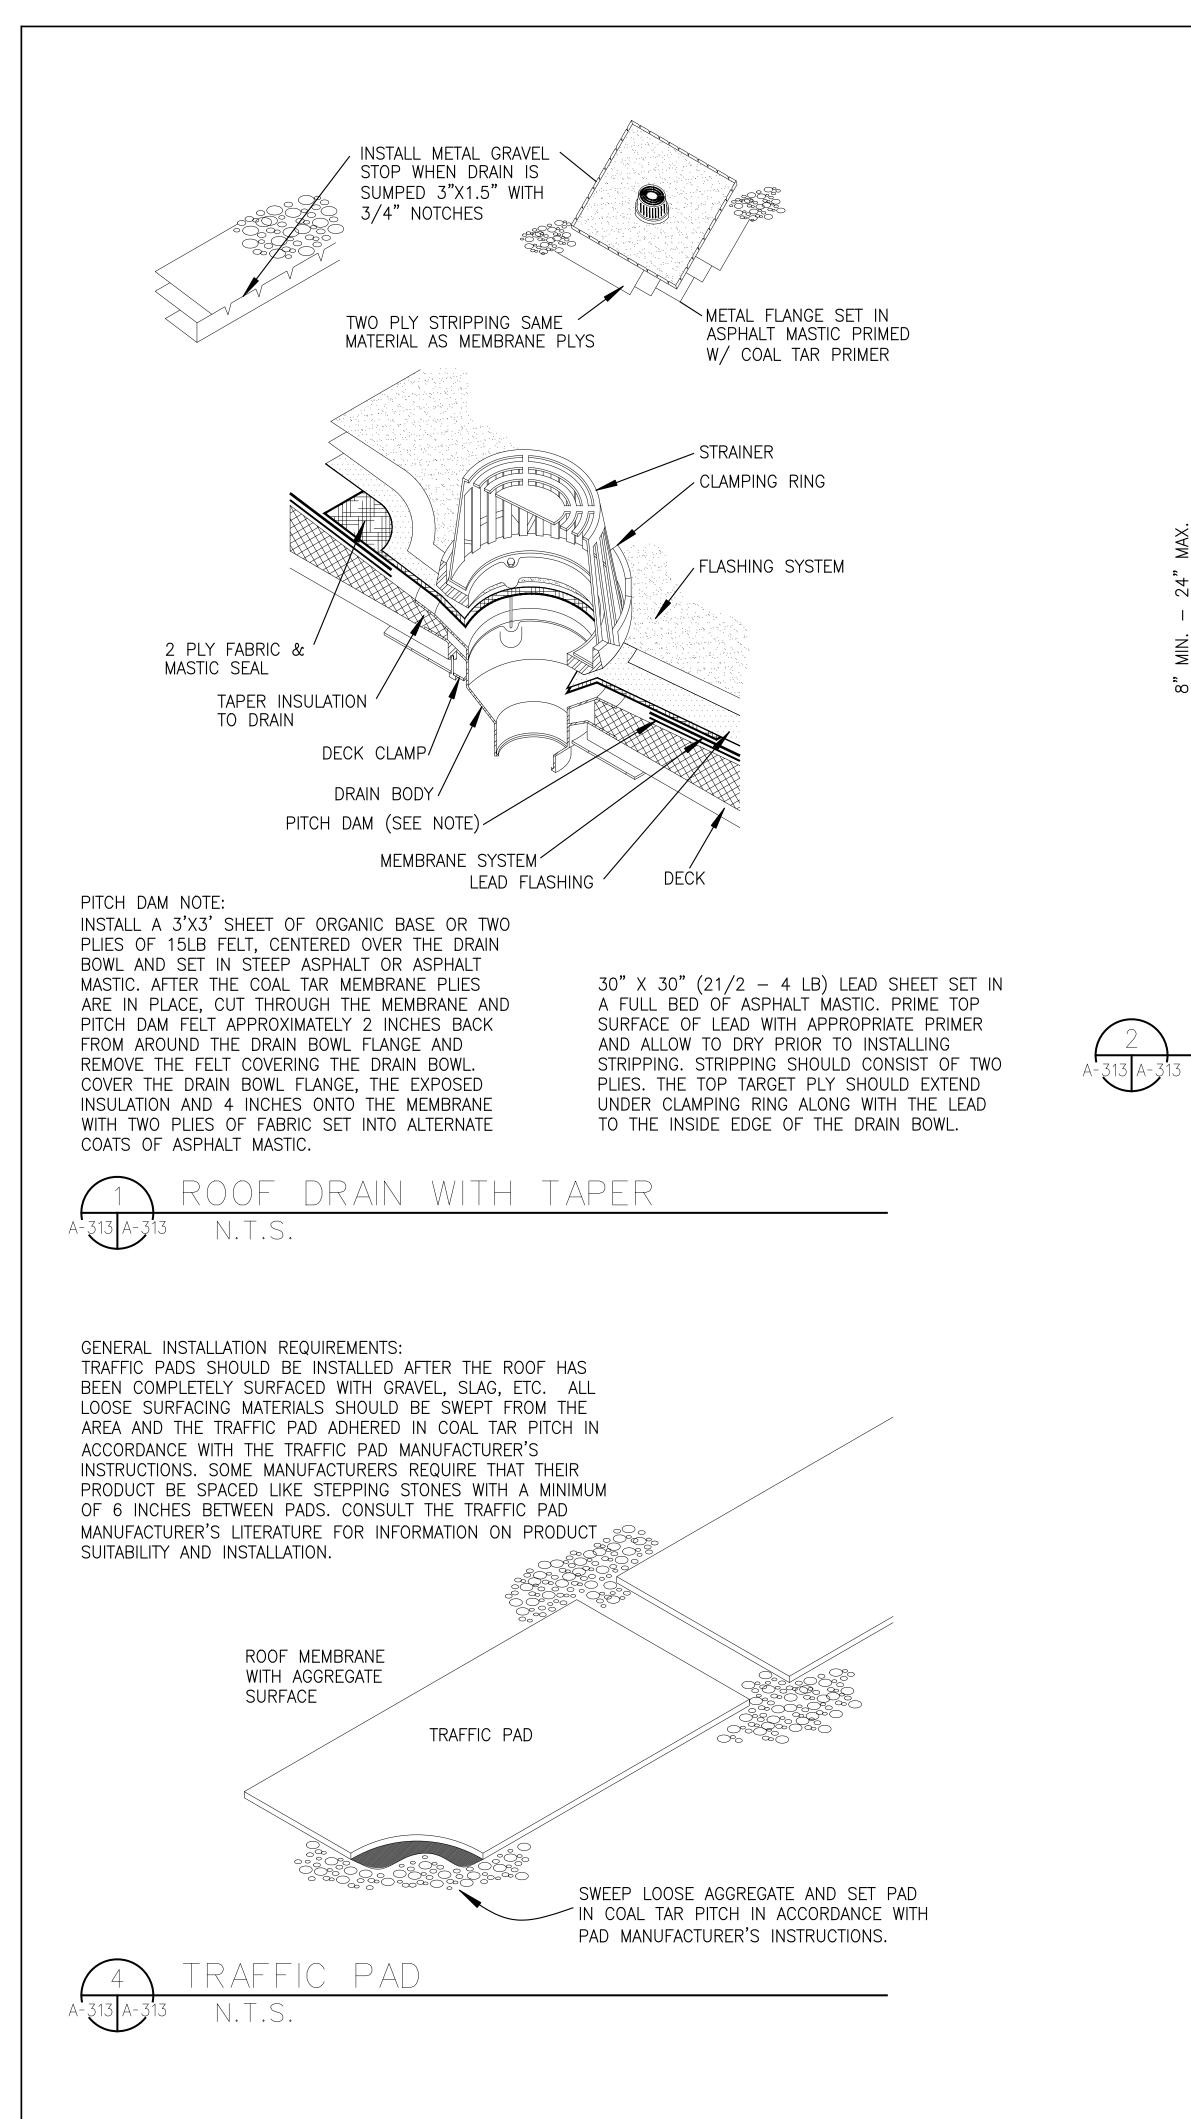
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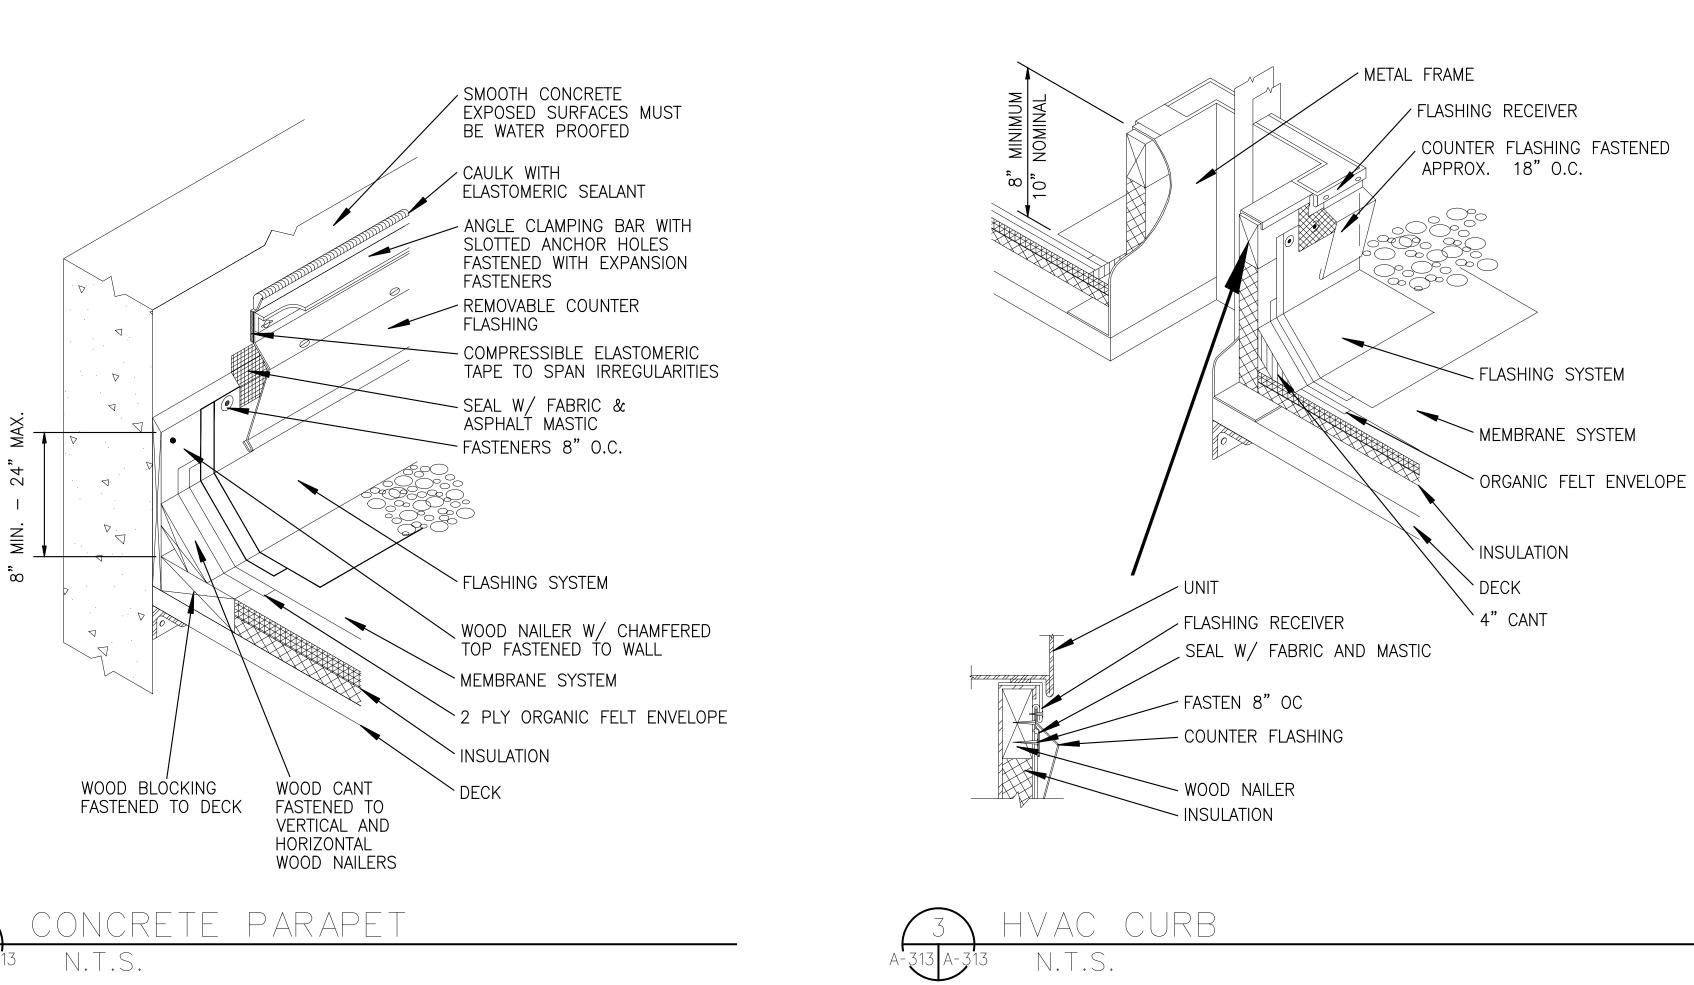
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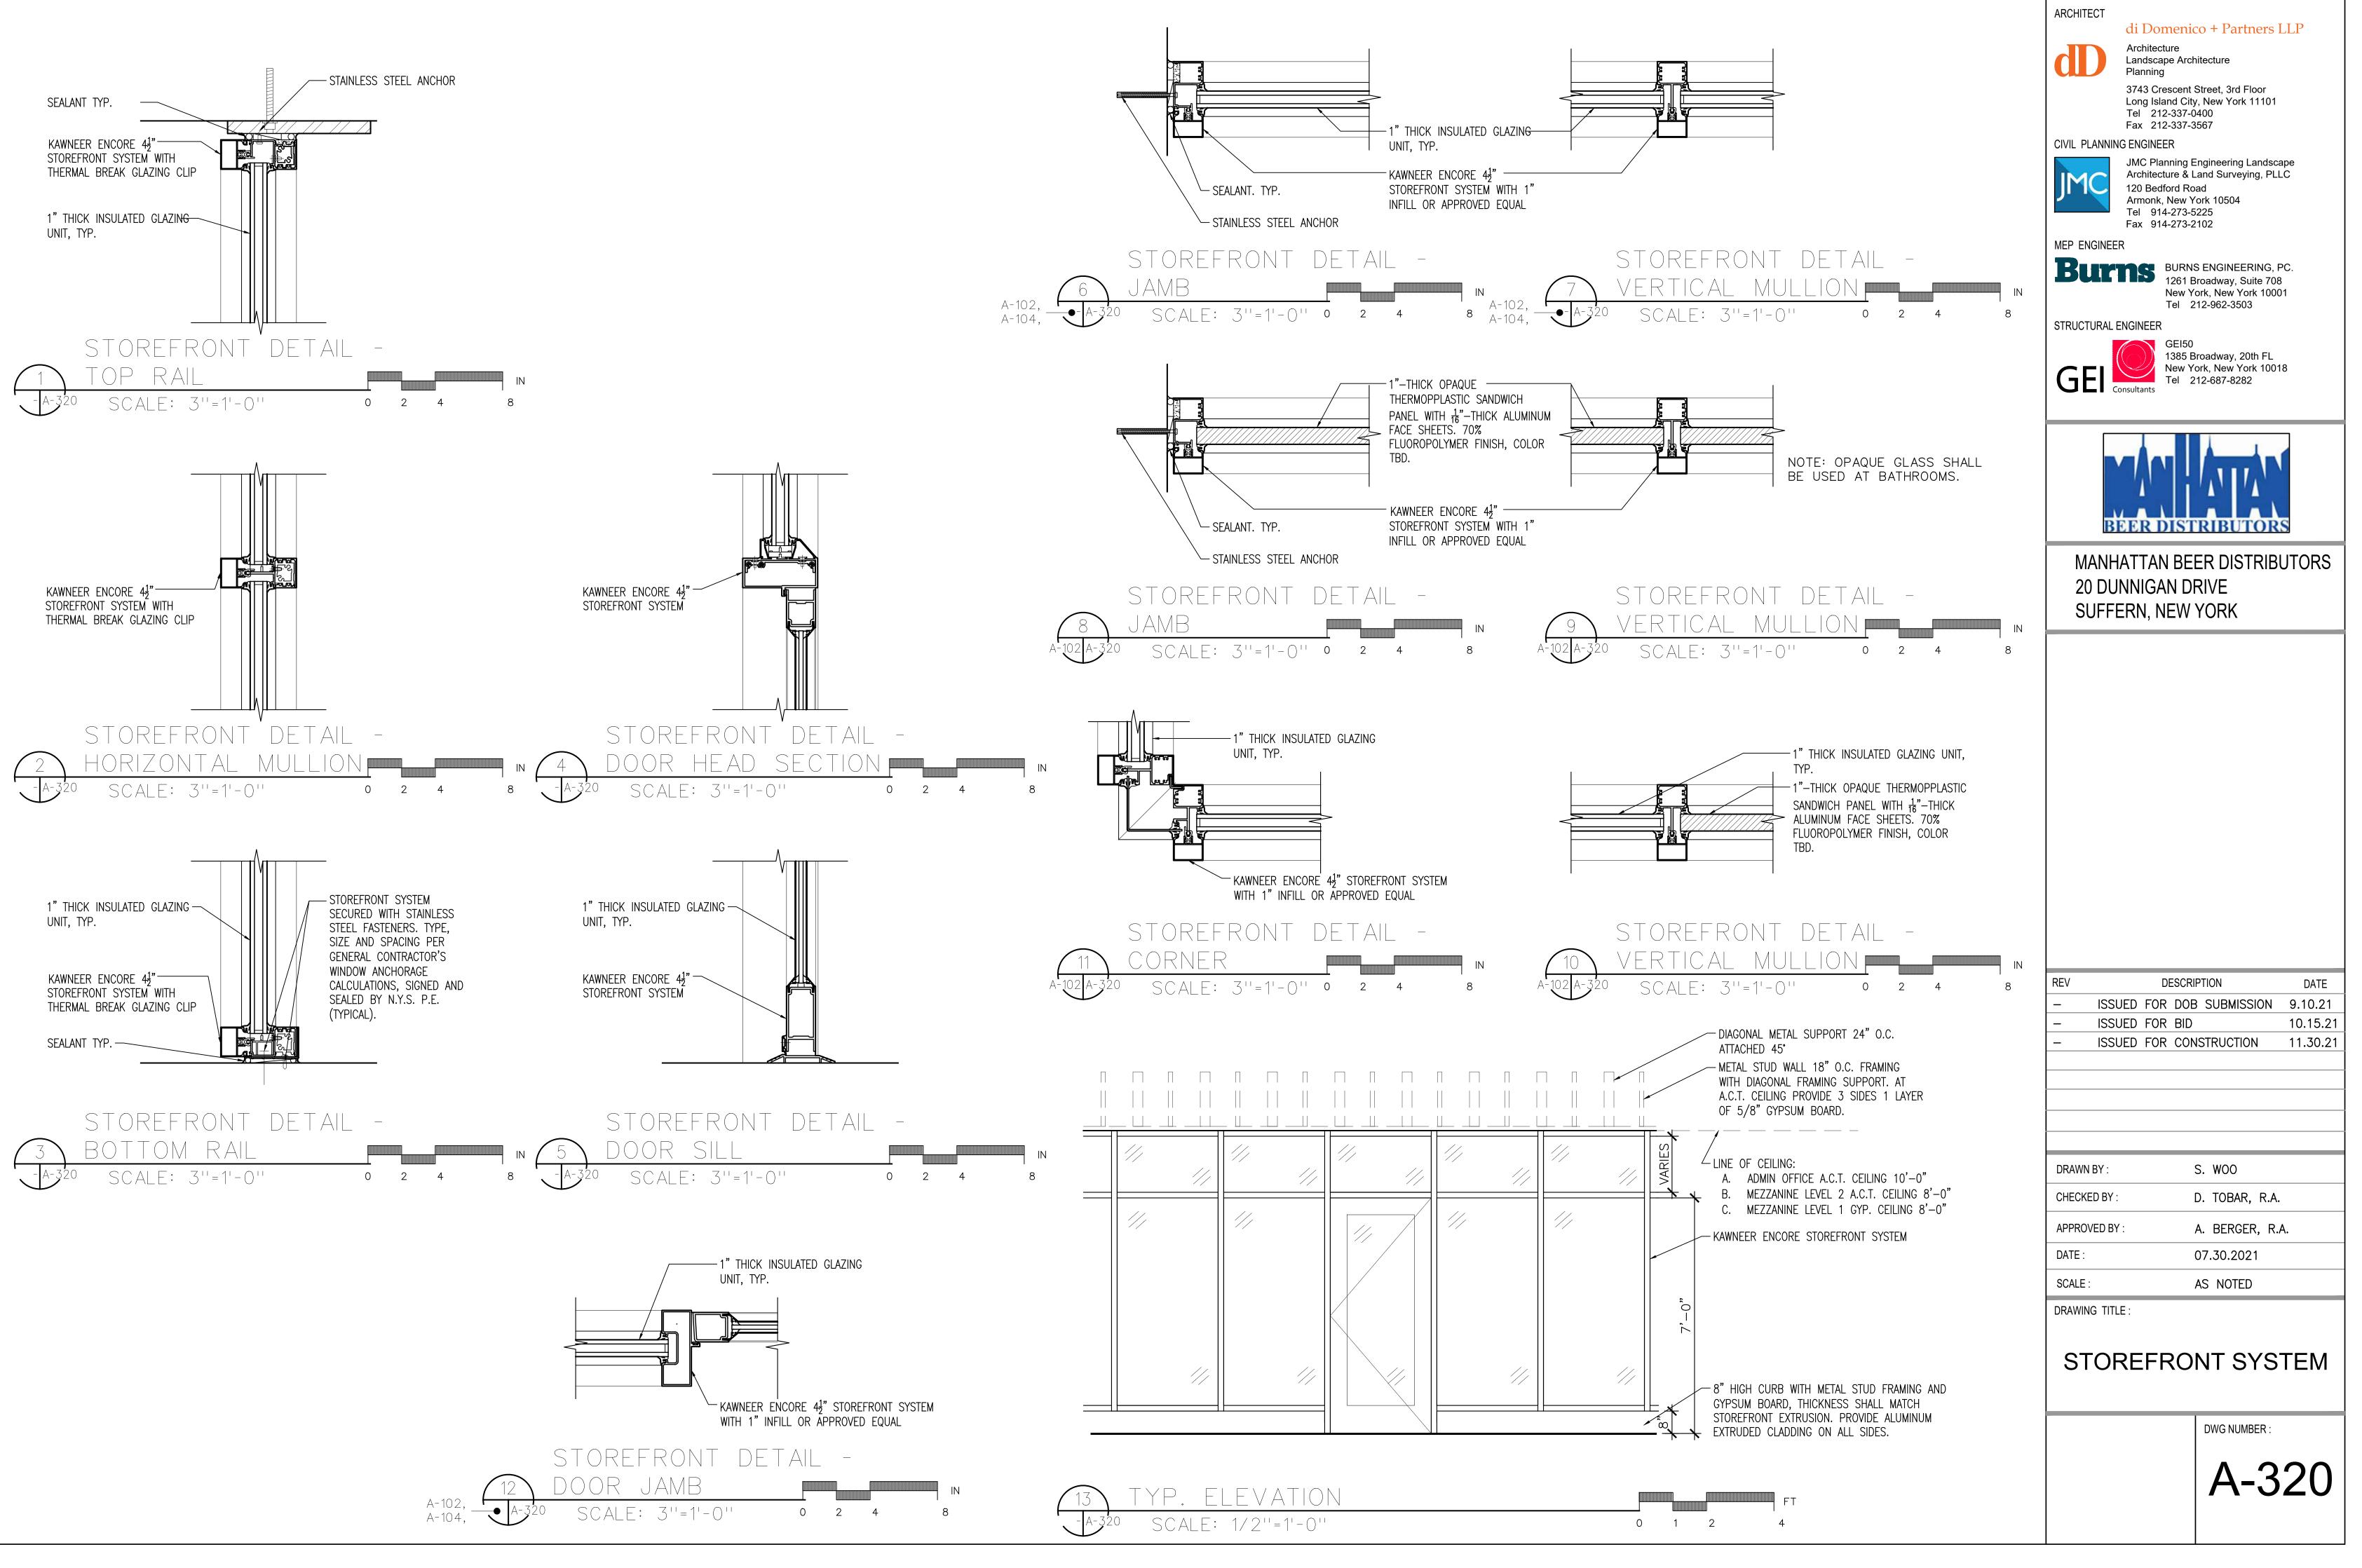




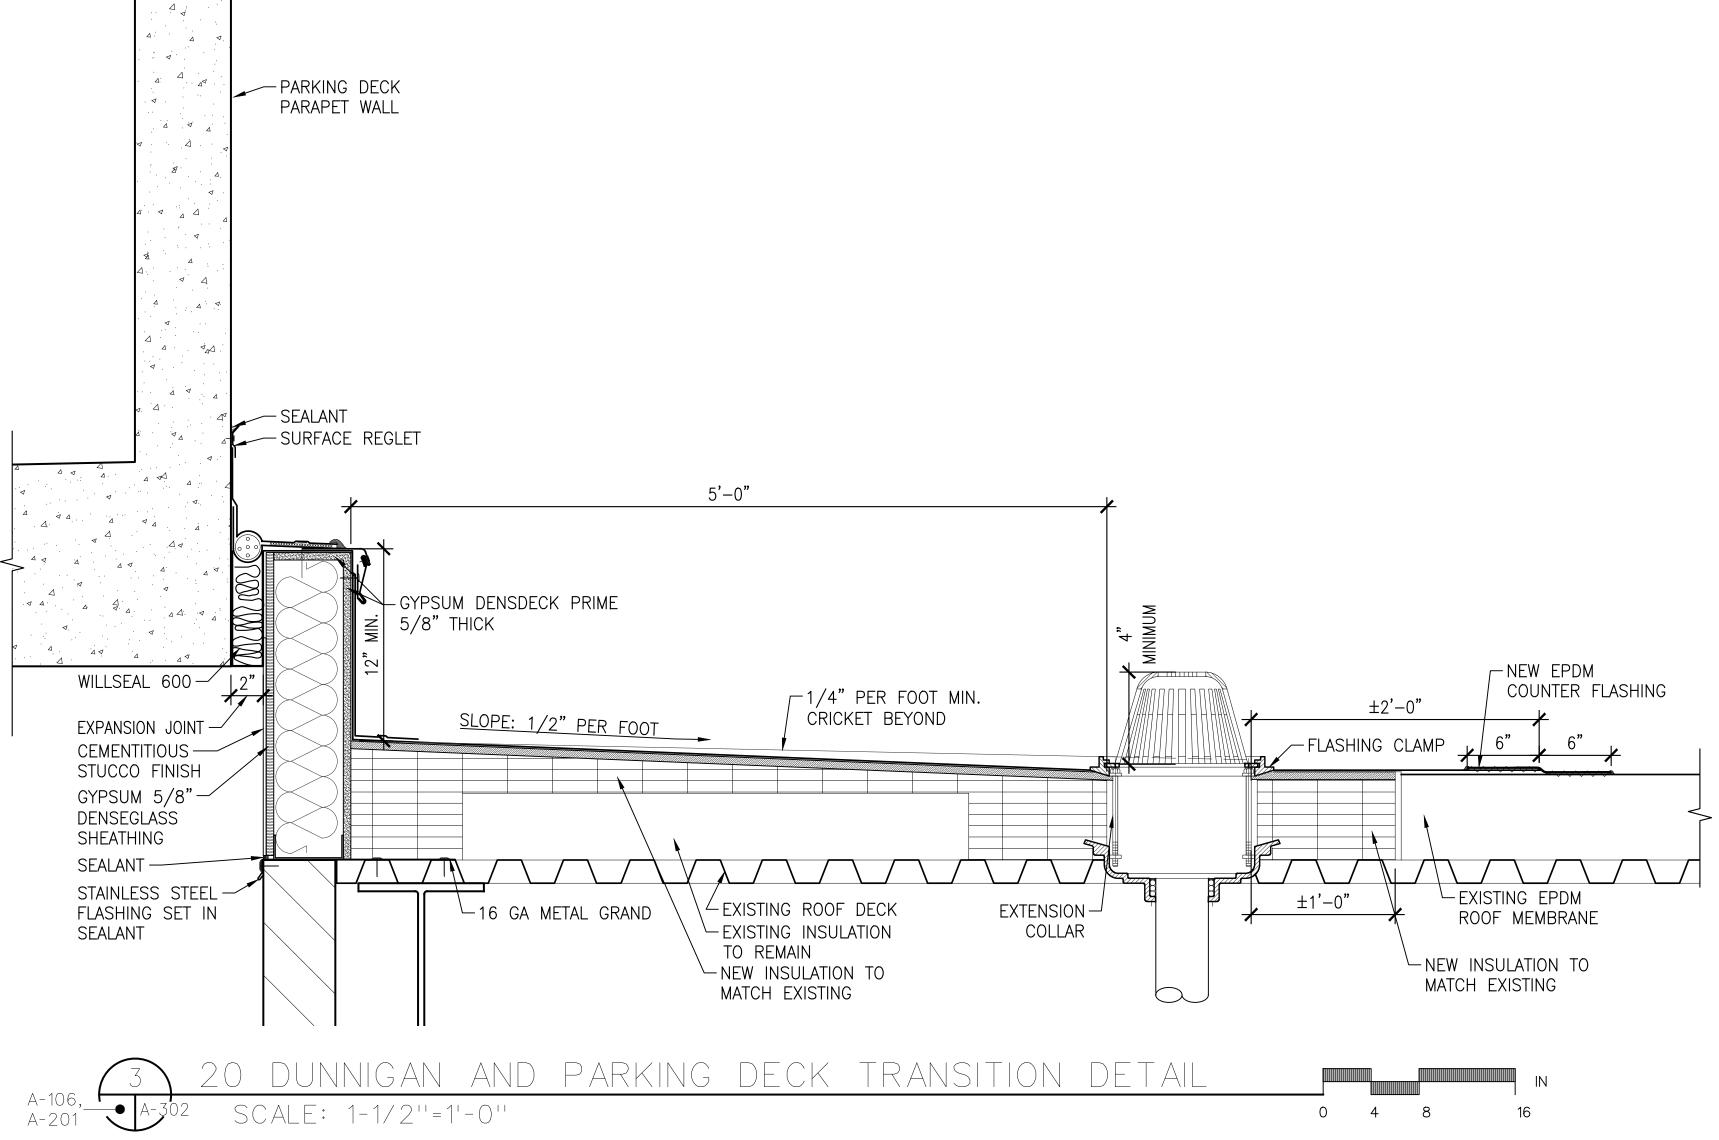



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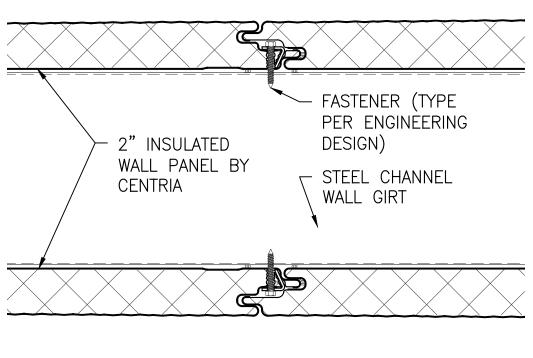
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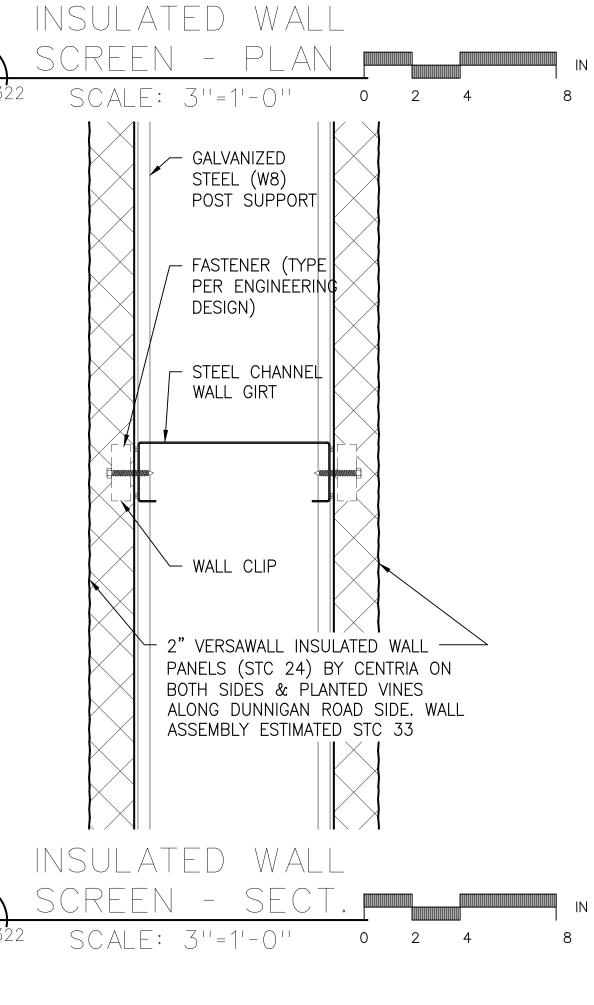


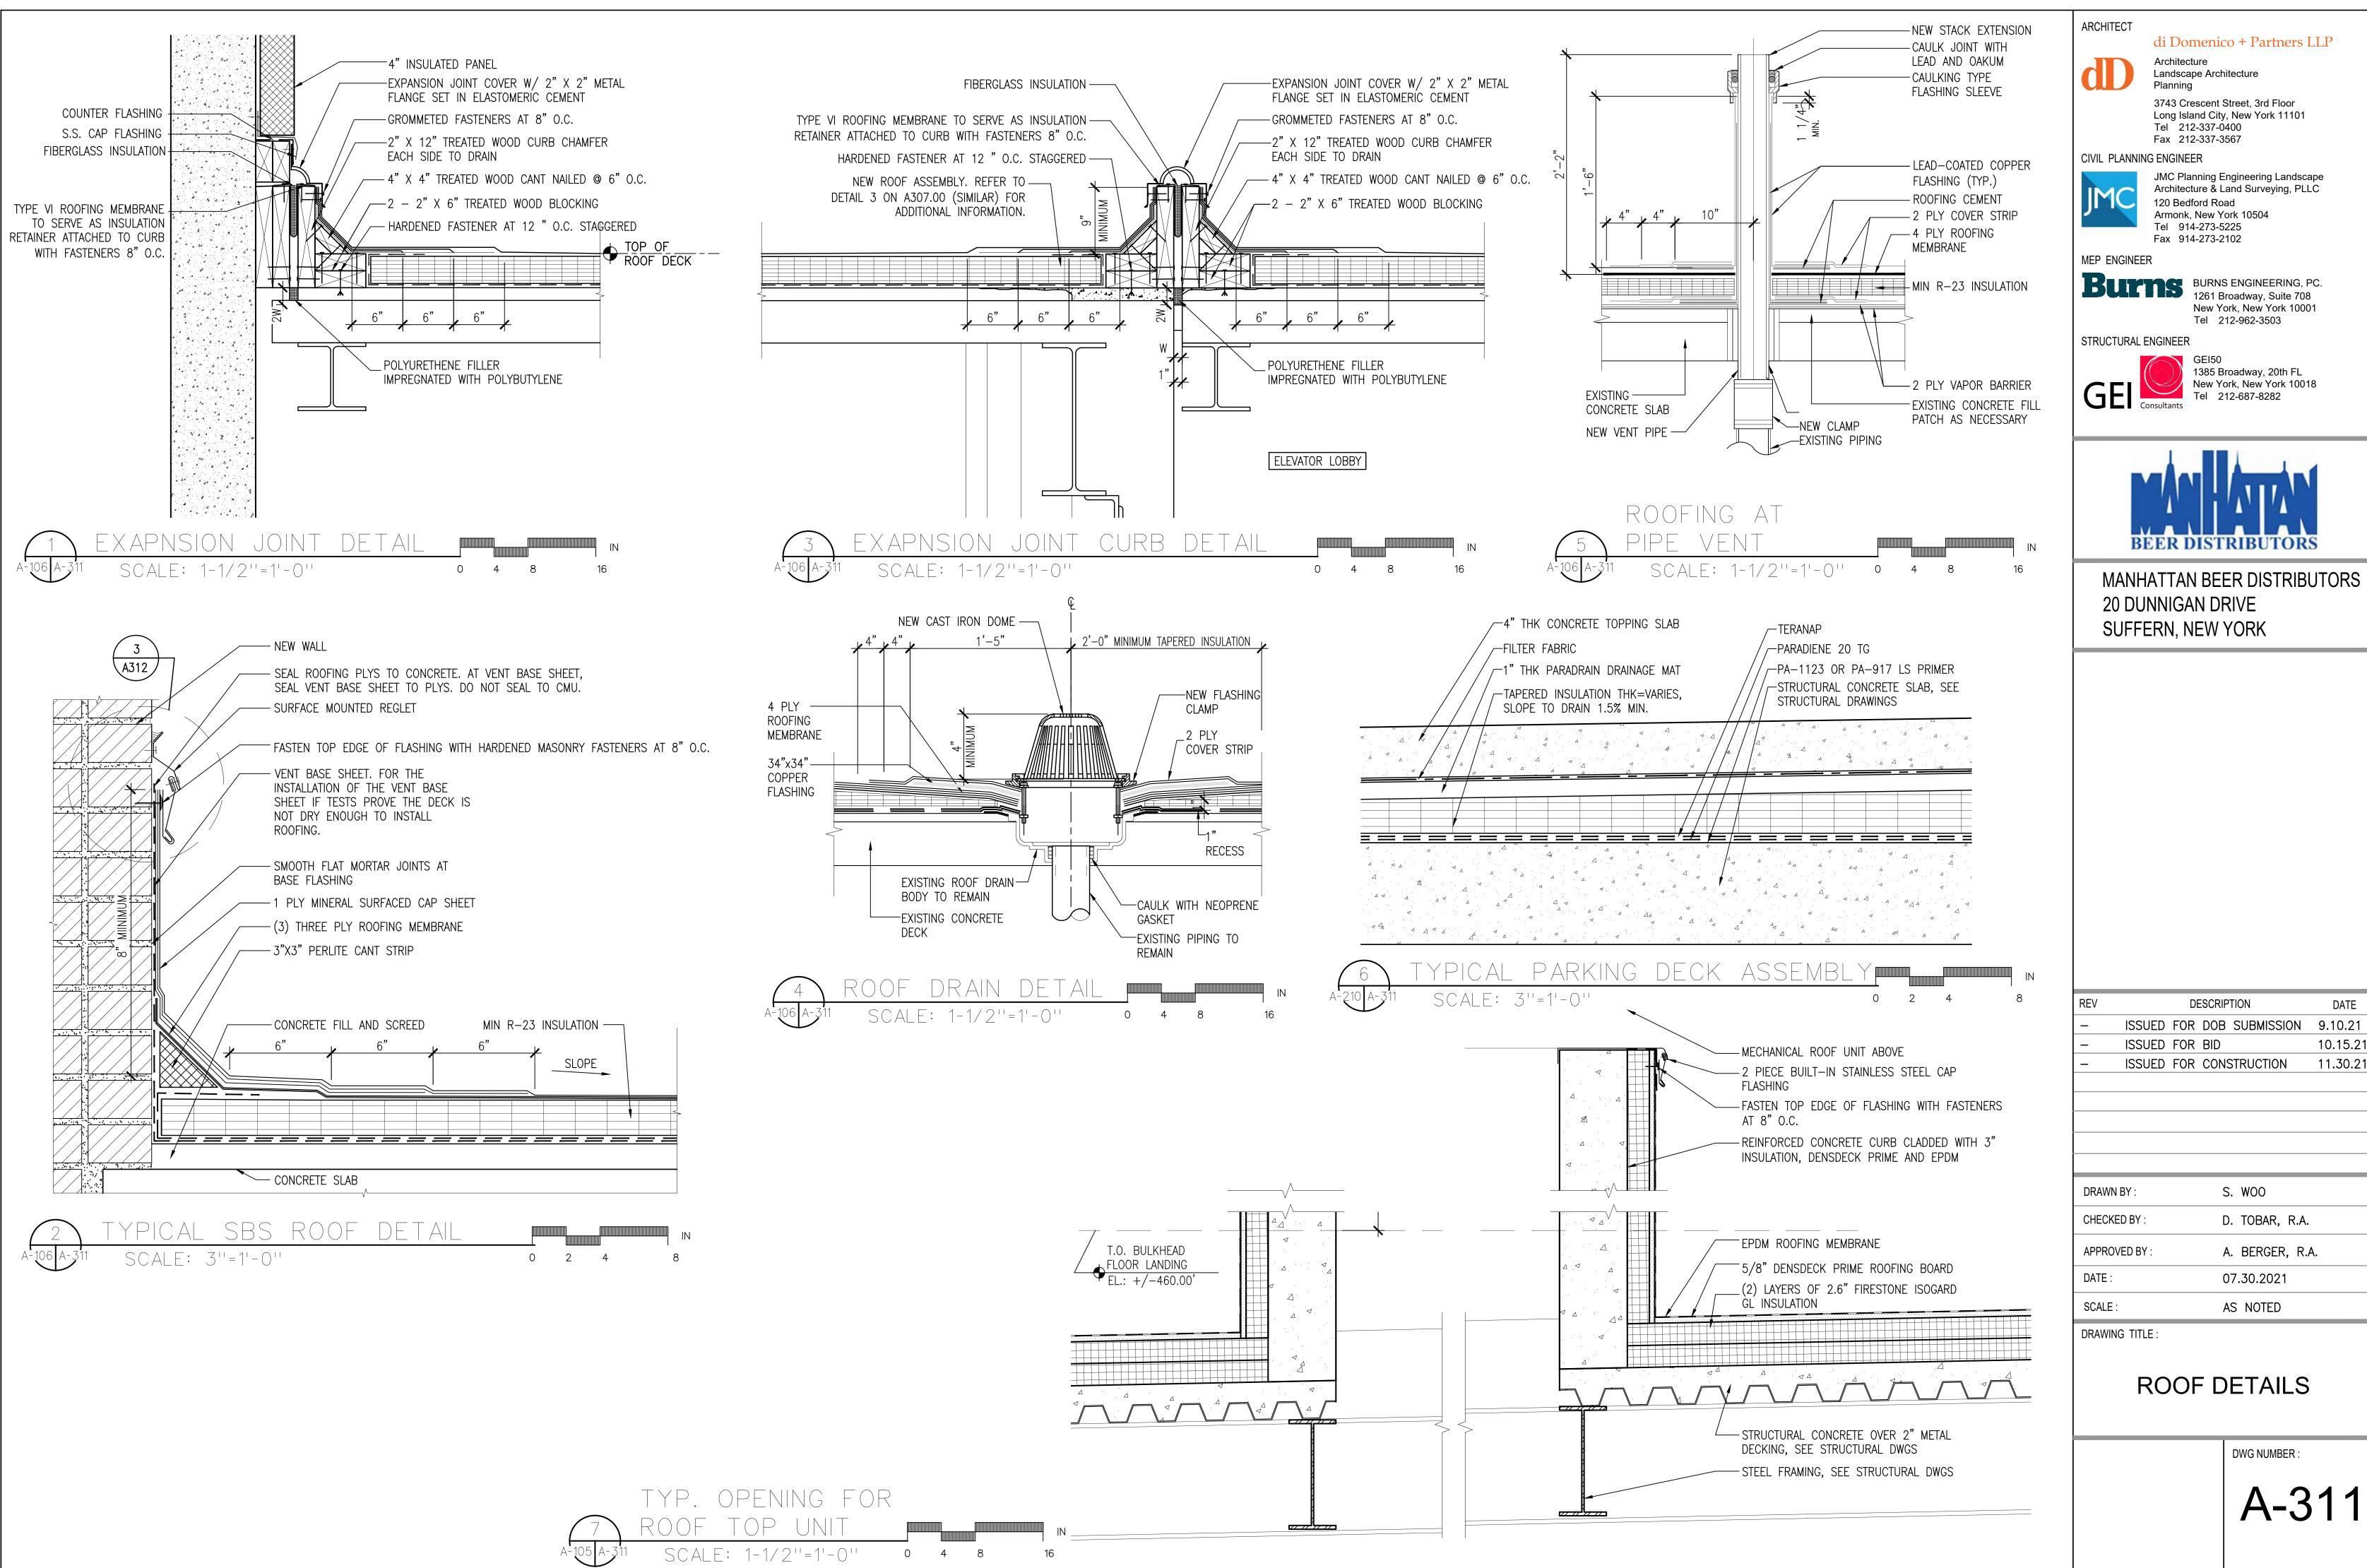

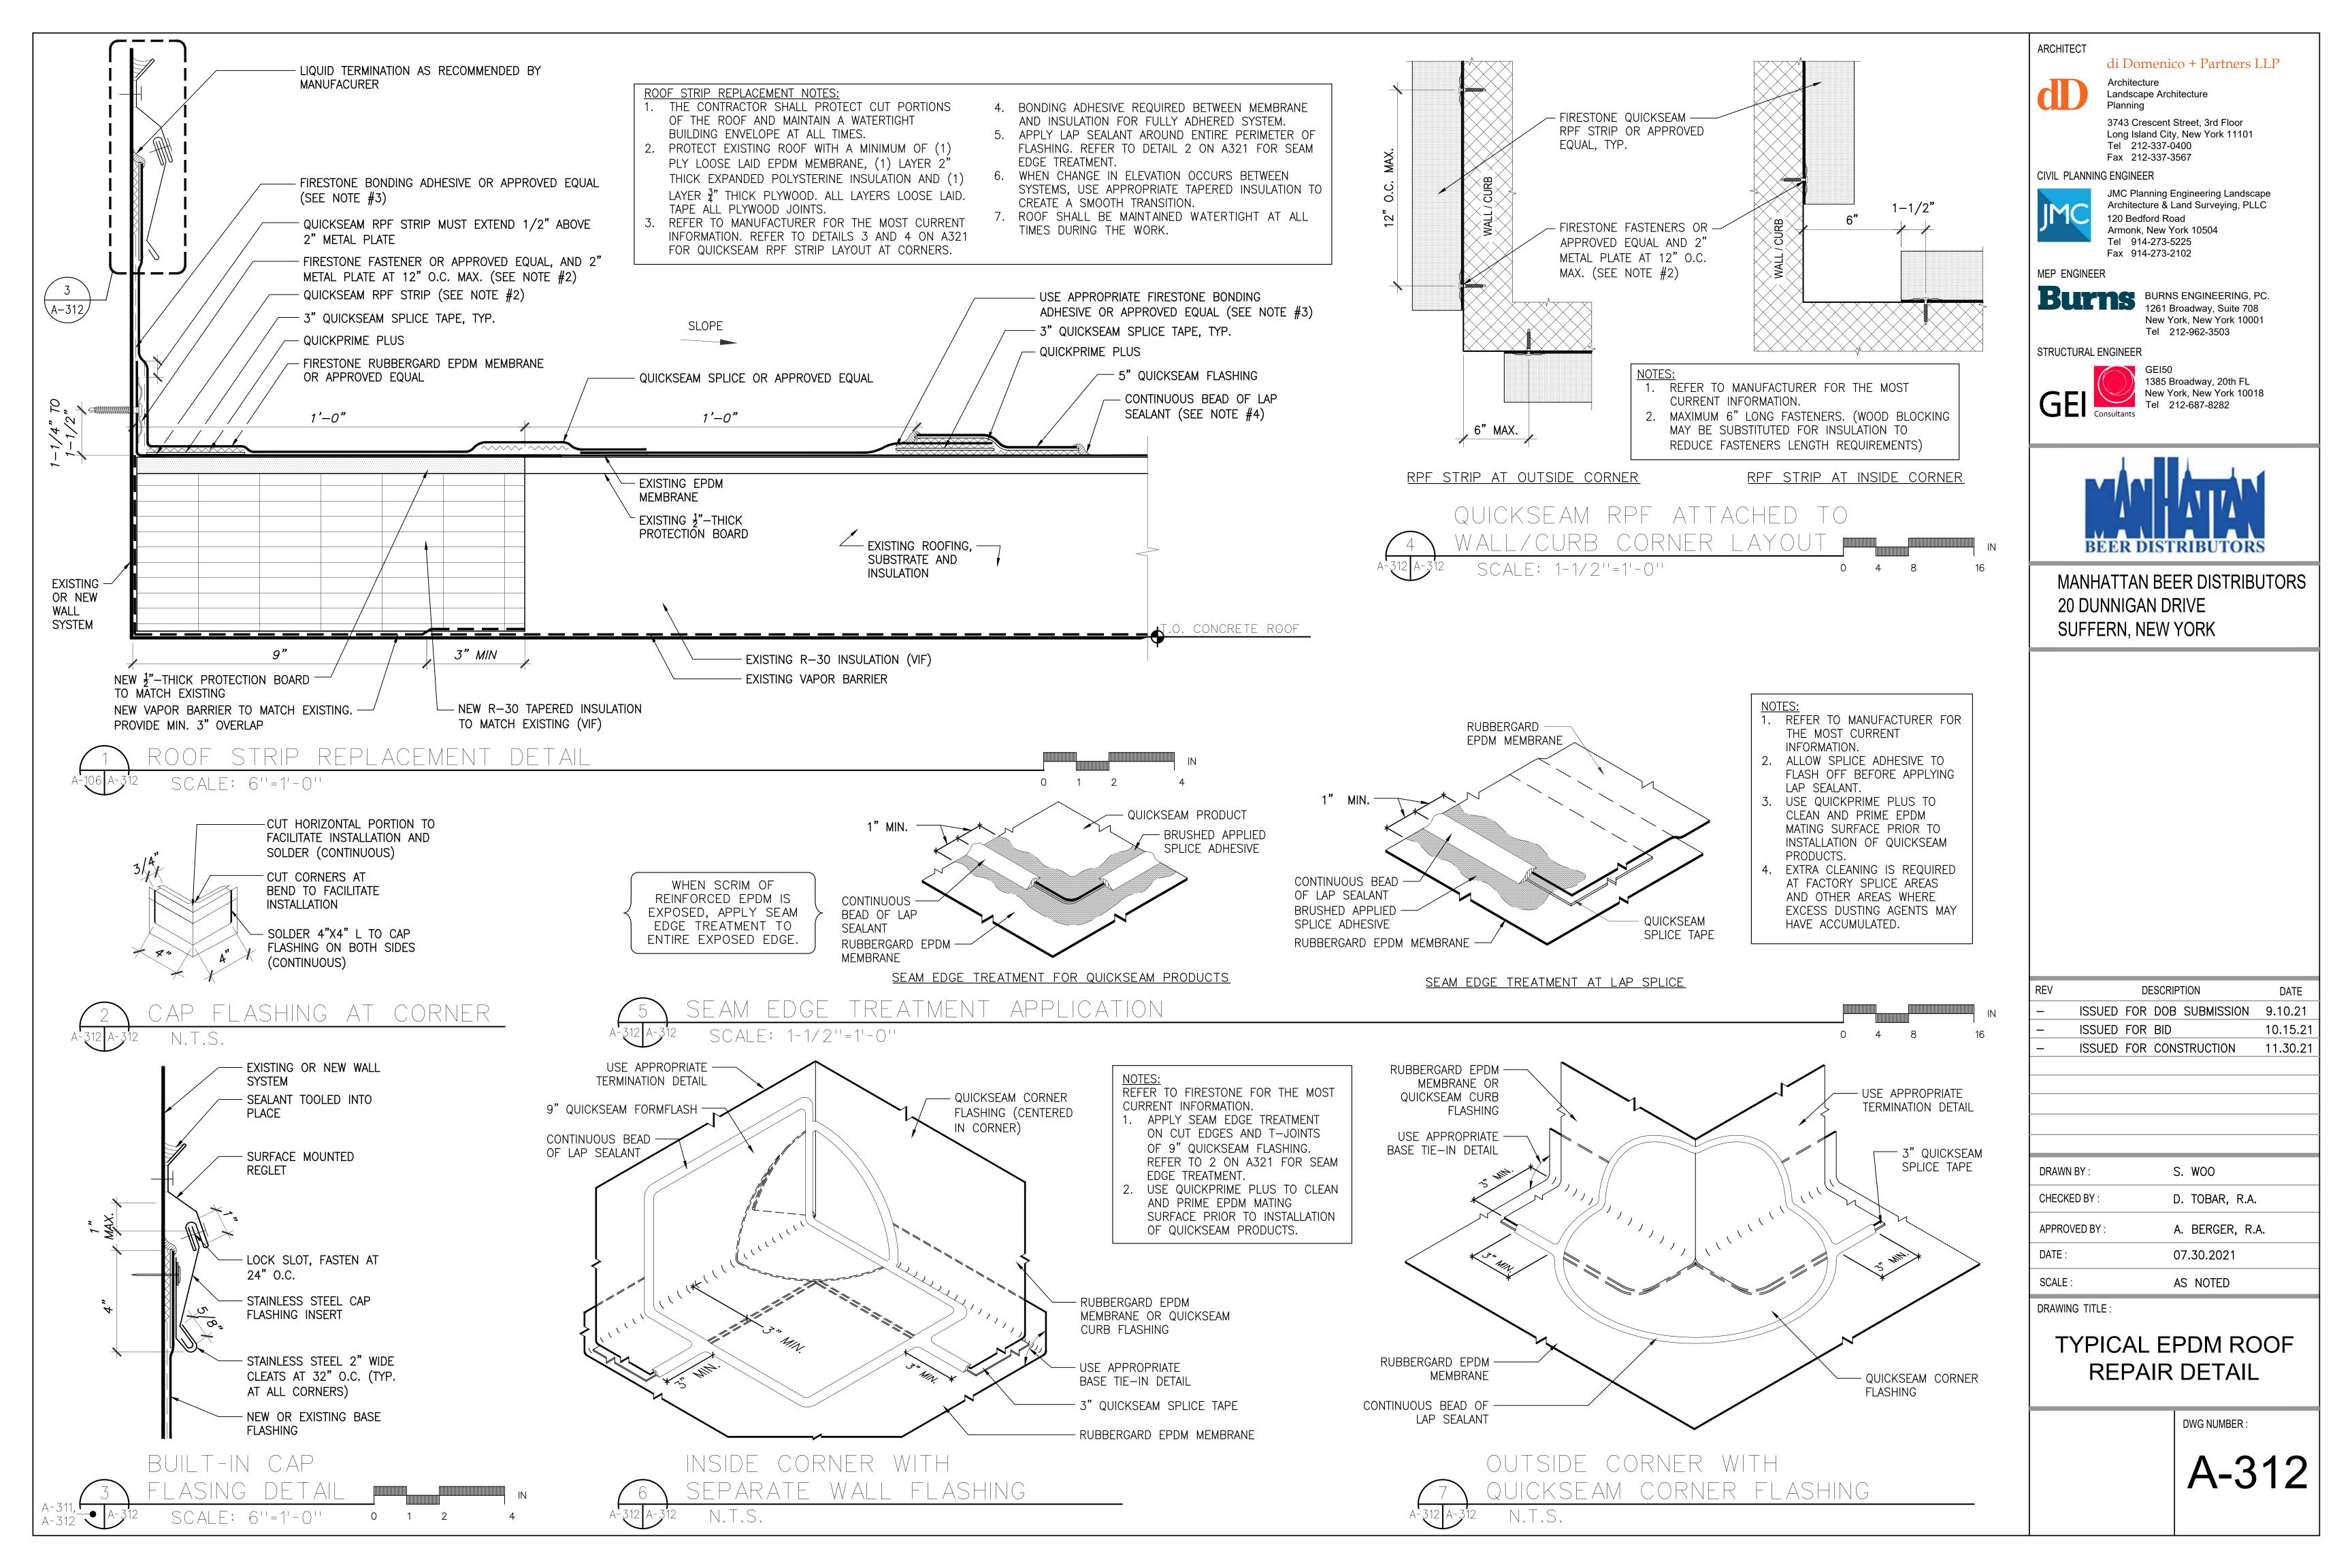




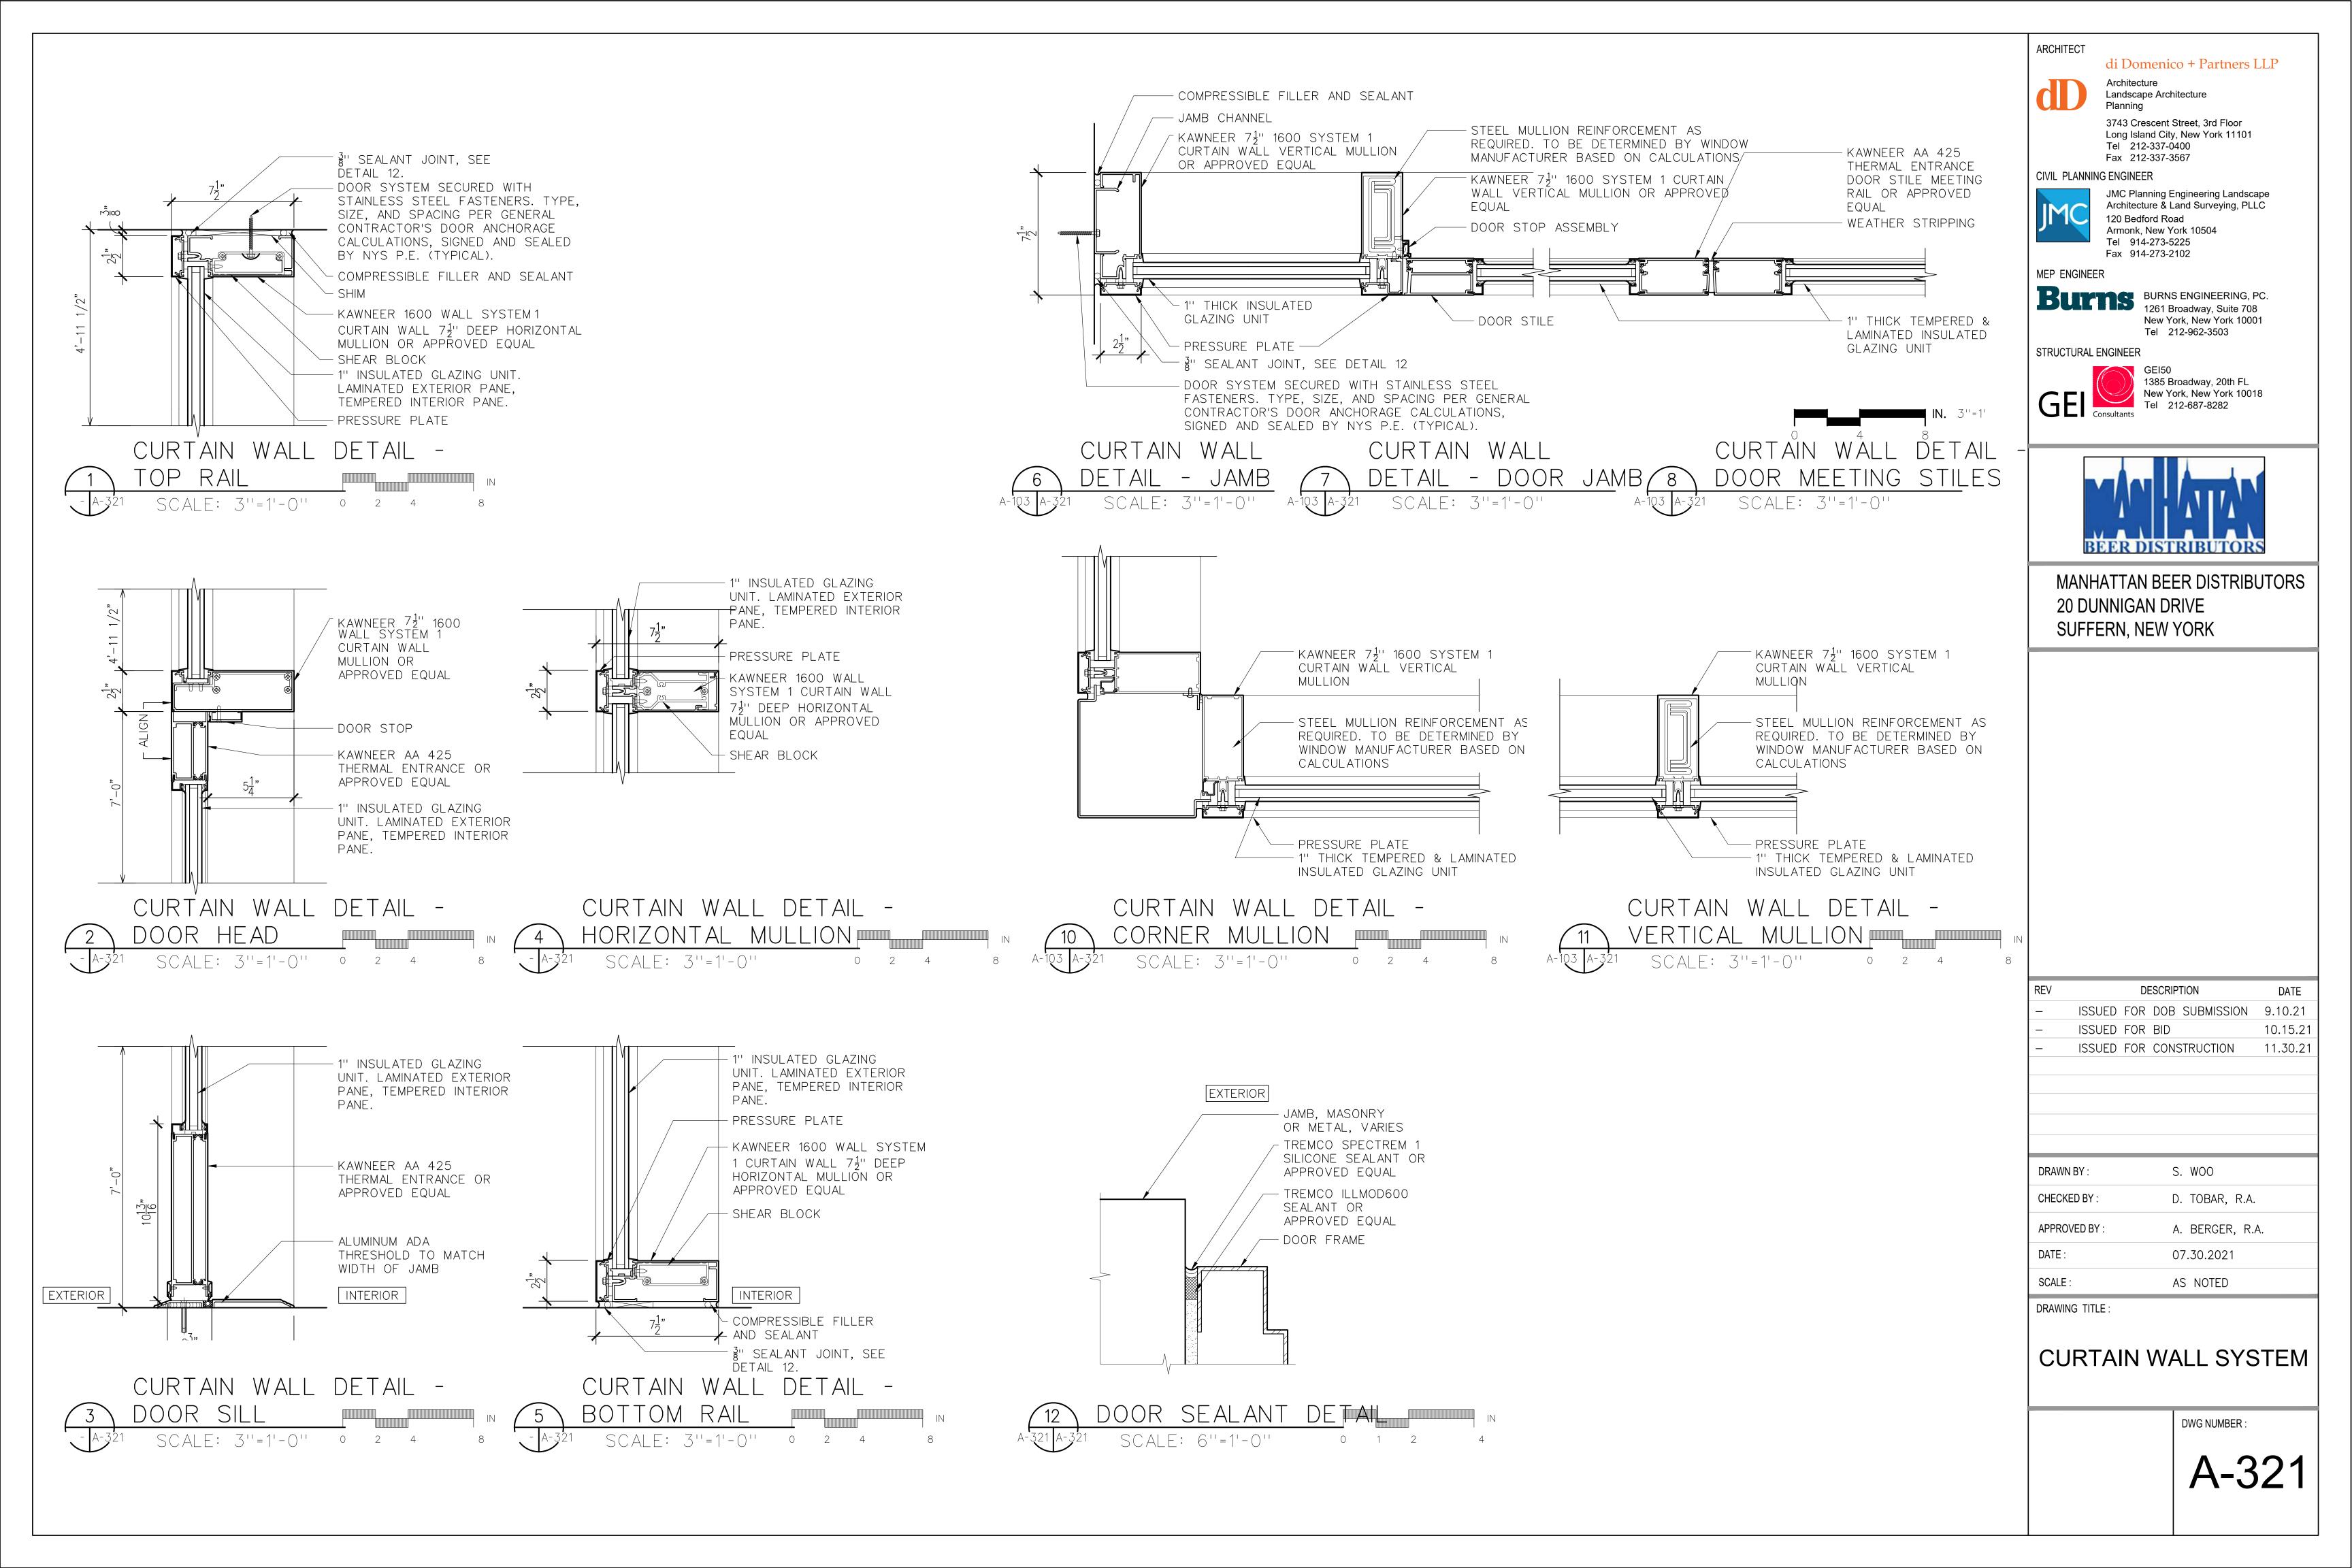


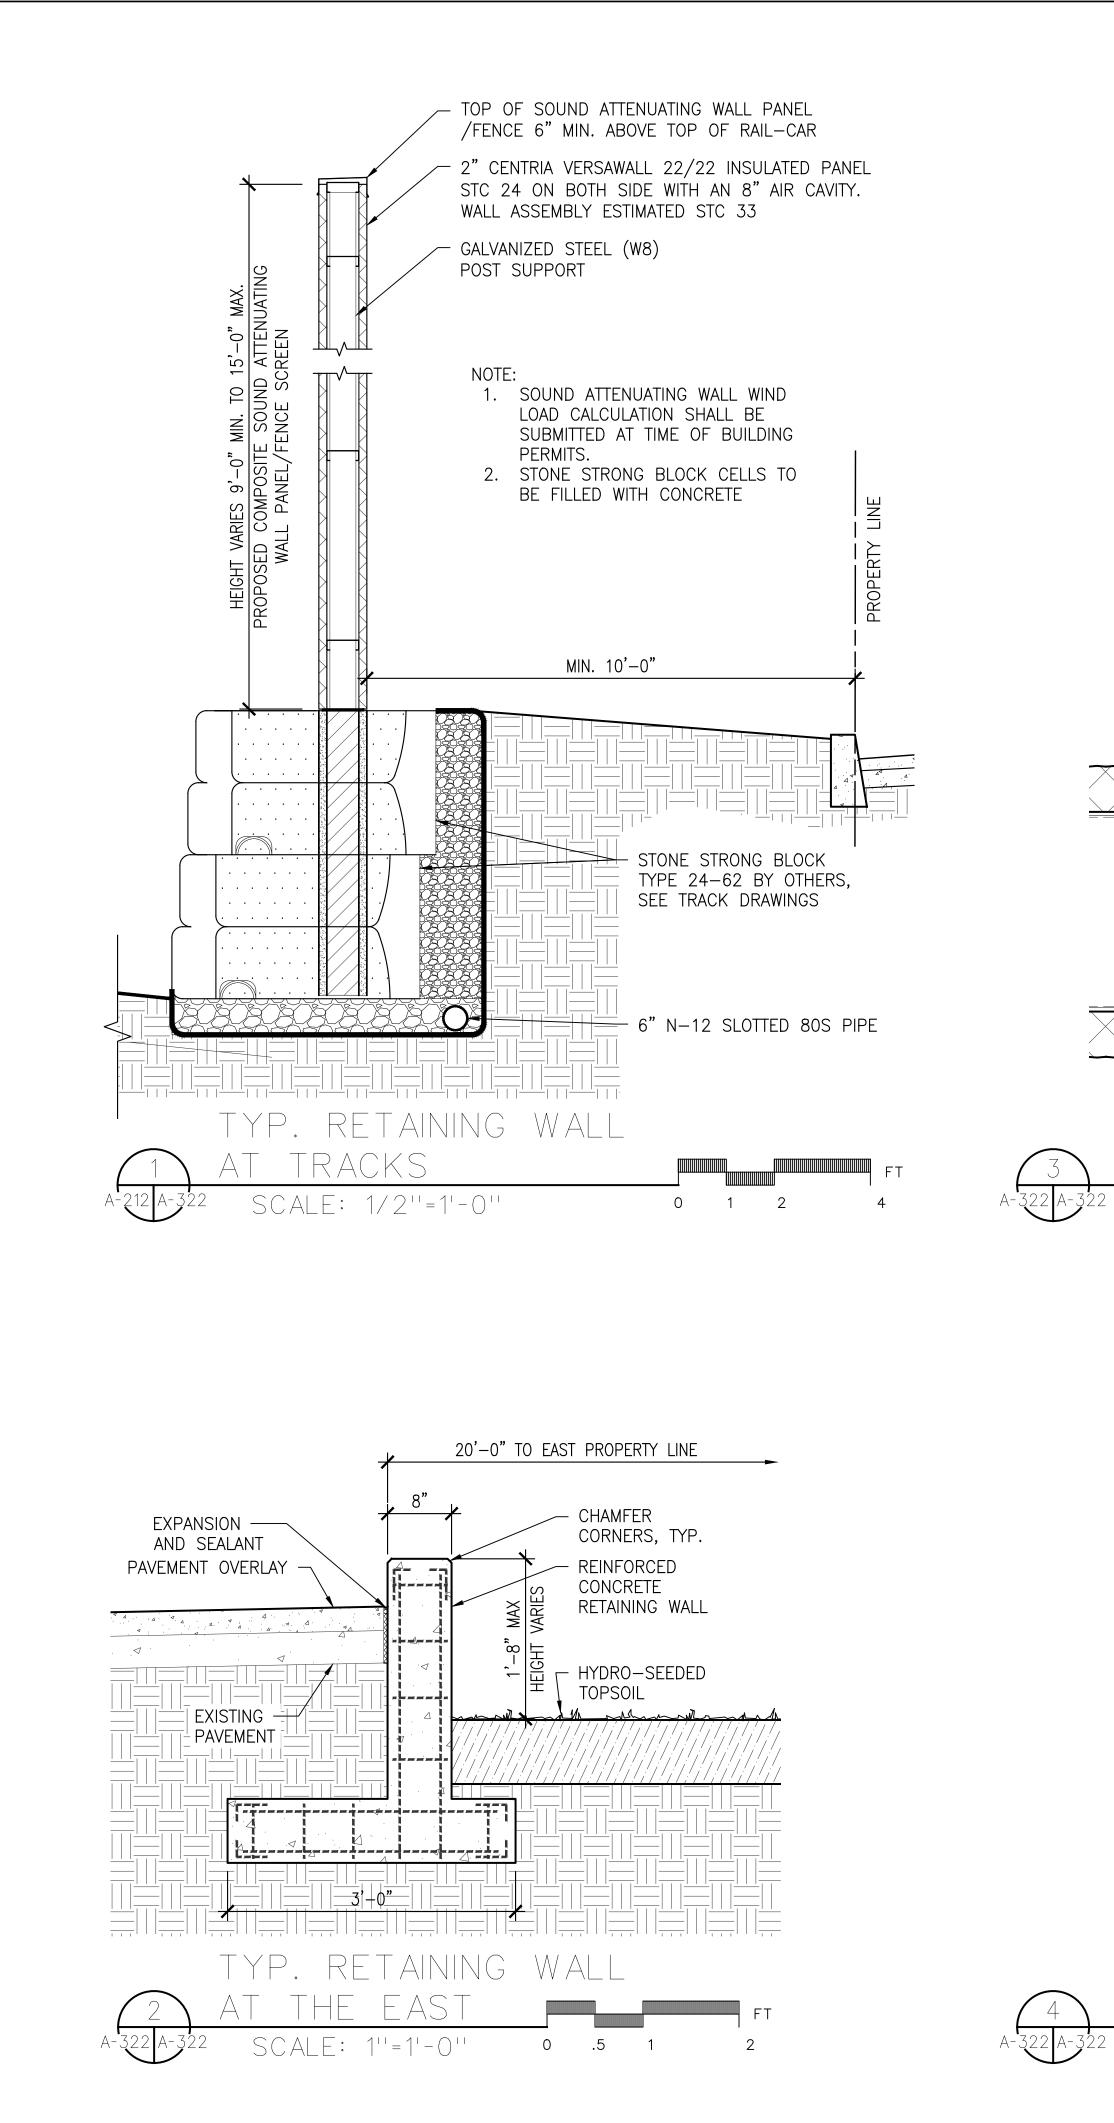



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	di Domenico + Partners LLP Architecture
dD	Landscape Architecture Planning
	3743 Crescent Street, 3rd Floor Long Island City, New York 11101
	Tel 212-337-0400 Fax 212-337-3567
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IMC	JMC Planning Engineering Landscape Architecture & Land Surveying, PLLC 120 Bedford Road
	Armonk, New York 10504 Tel 914-273-5225
	Fax 914-273-2102
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DUI	BURNS ENGINEERING, PC. 1261 Broadway, Suite 708 New York, New York 10001
	Tel 212-962-3503
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СГІ	1385 Broadway, 20th FL New York, New York 10018
GEI	Tel 212-687-8282 Consultants
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APPROVED E	BY: A. BERGER, R.A.
DATE :	07.30.2021
SCALE :	AS NOTED
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A-322



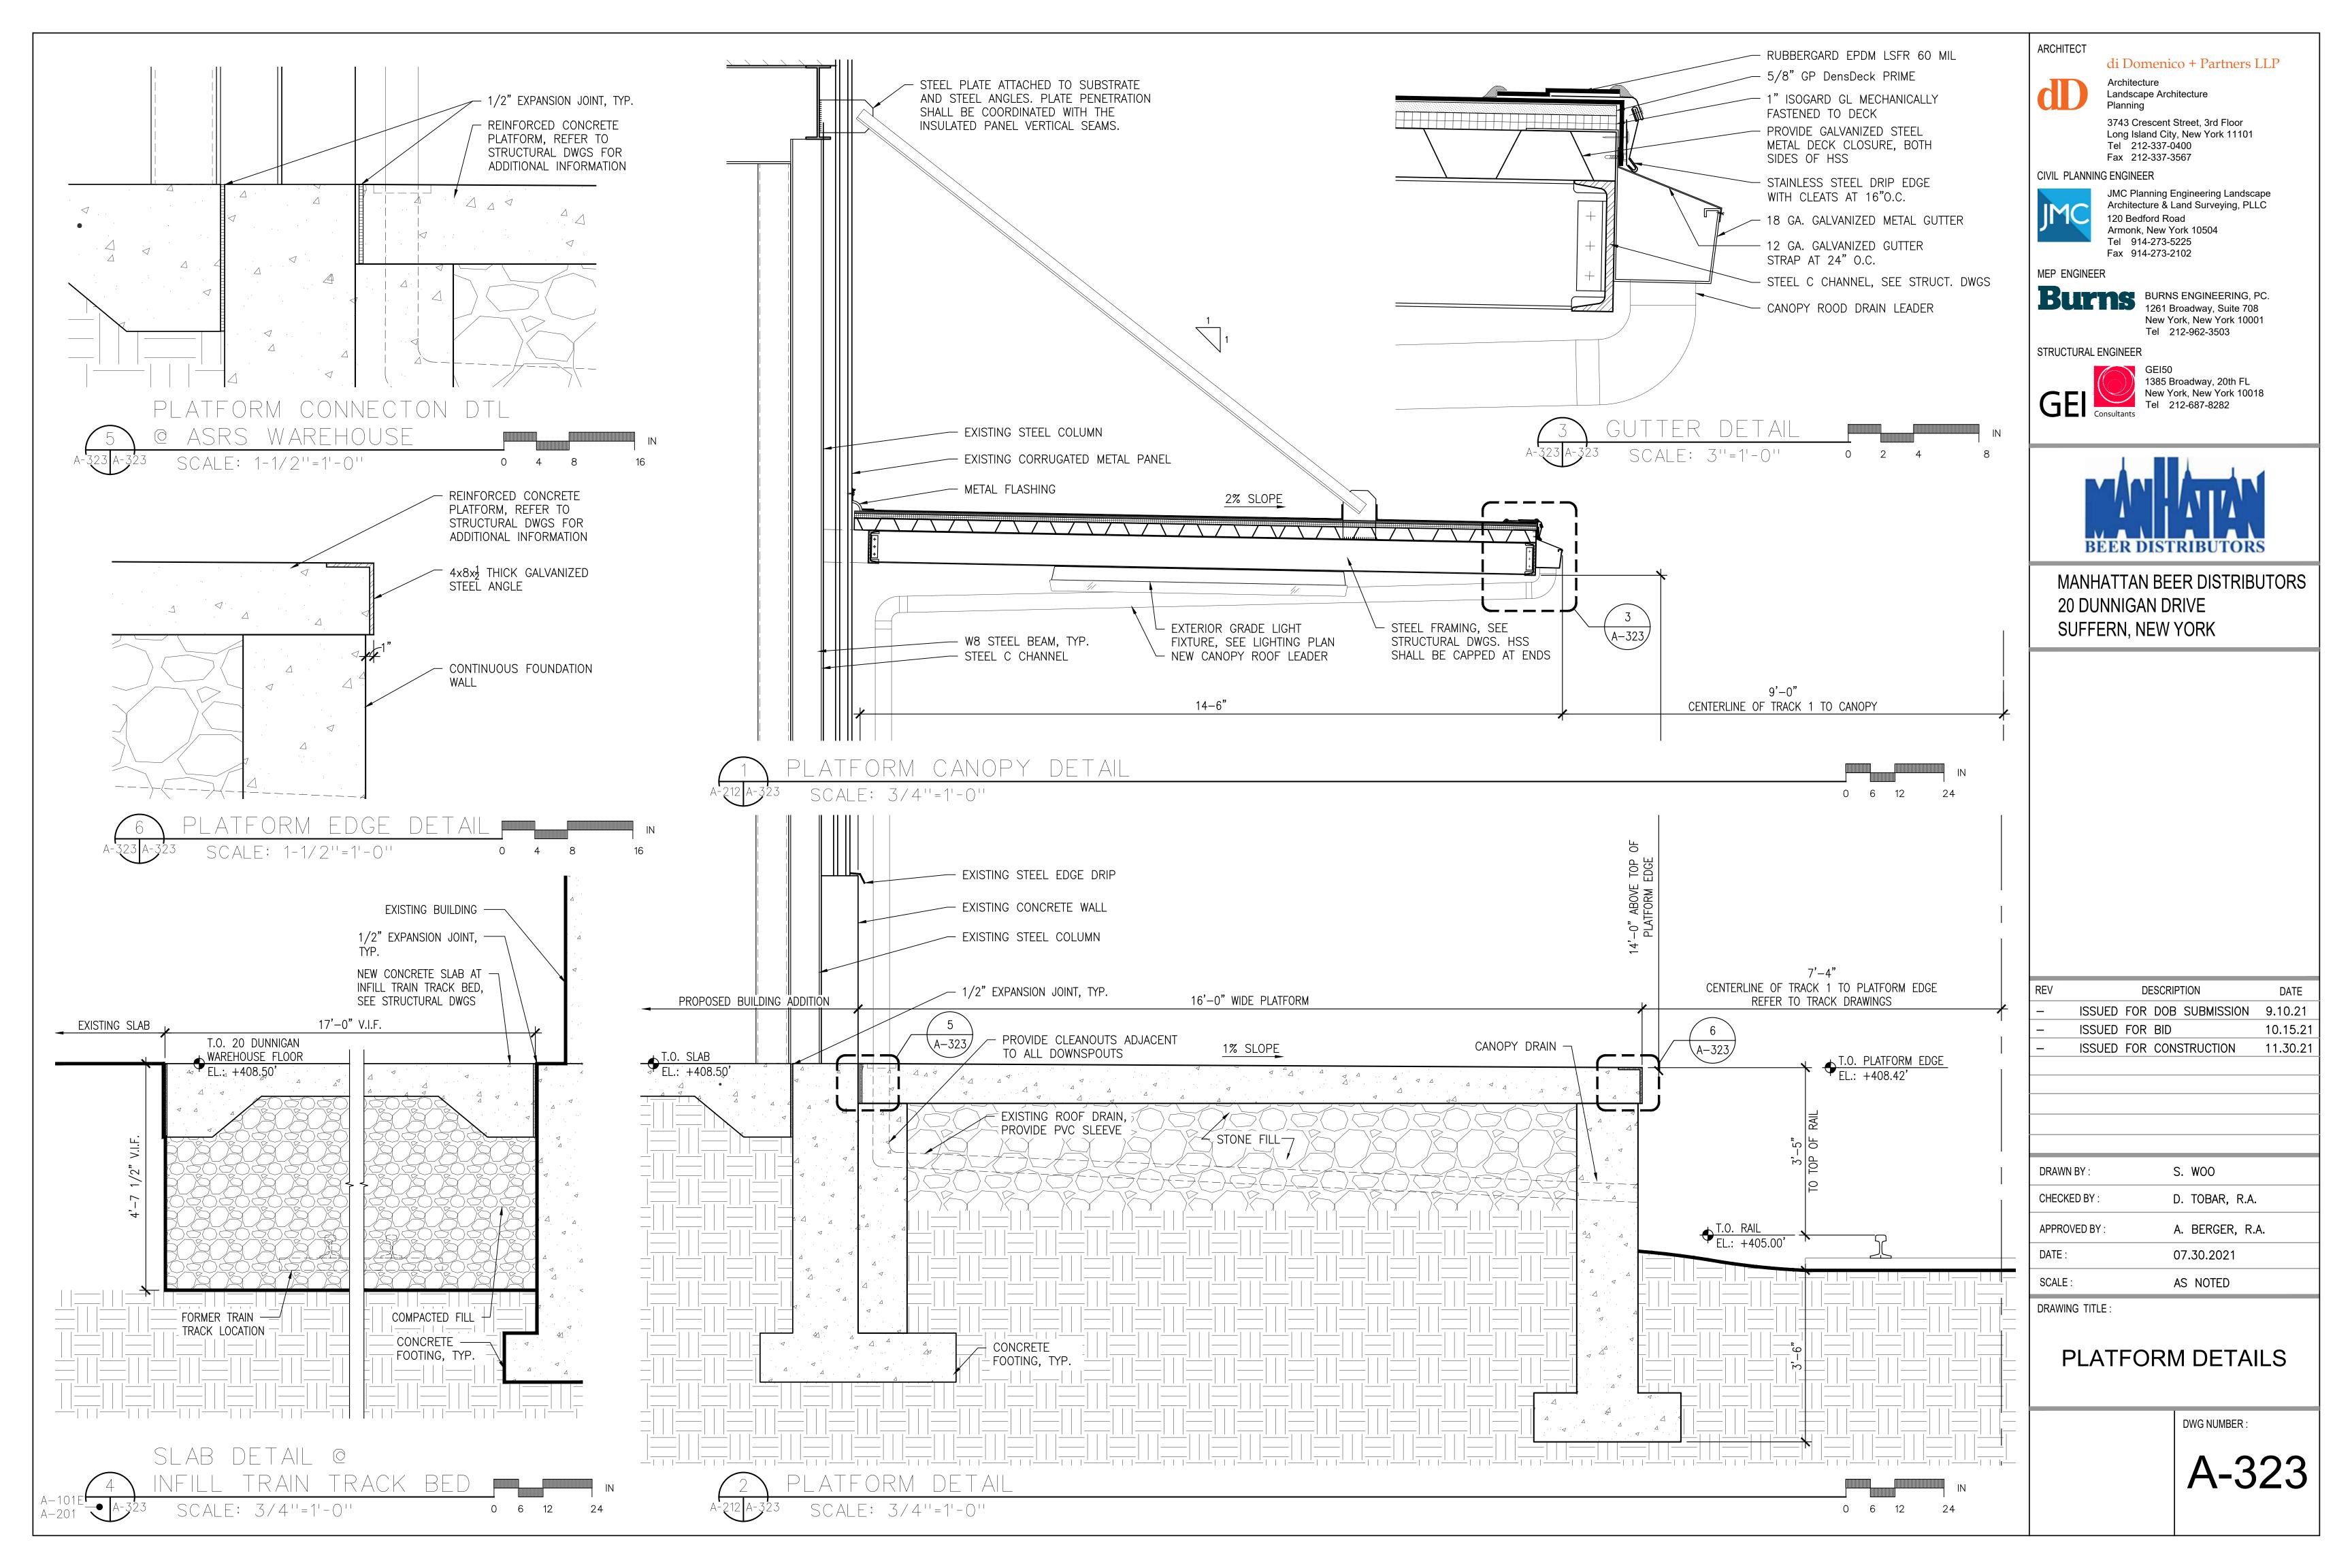

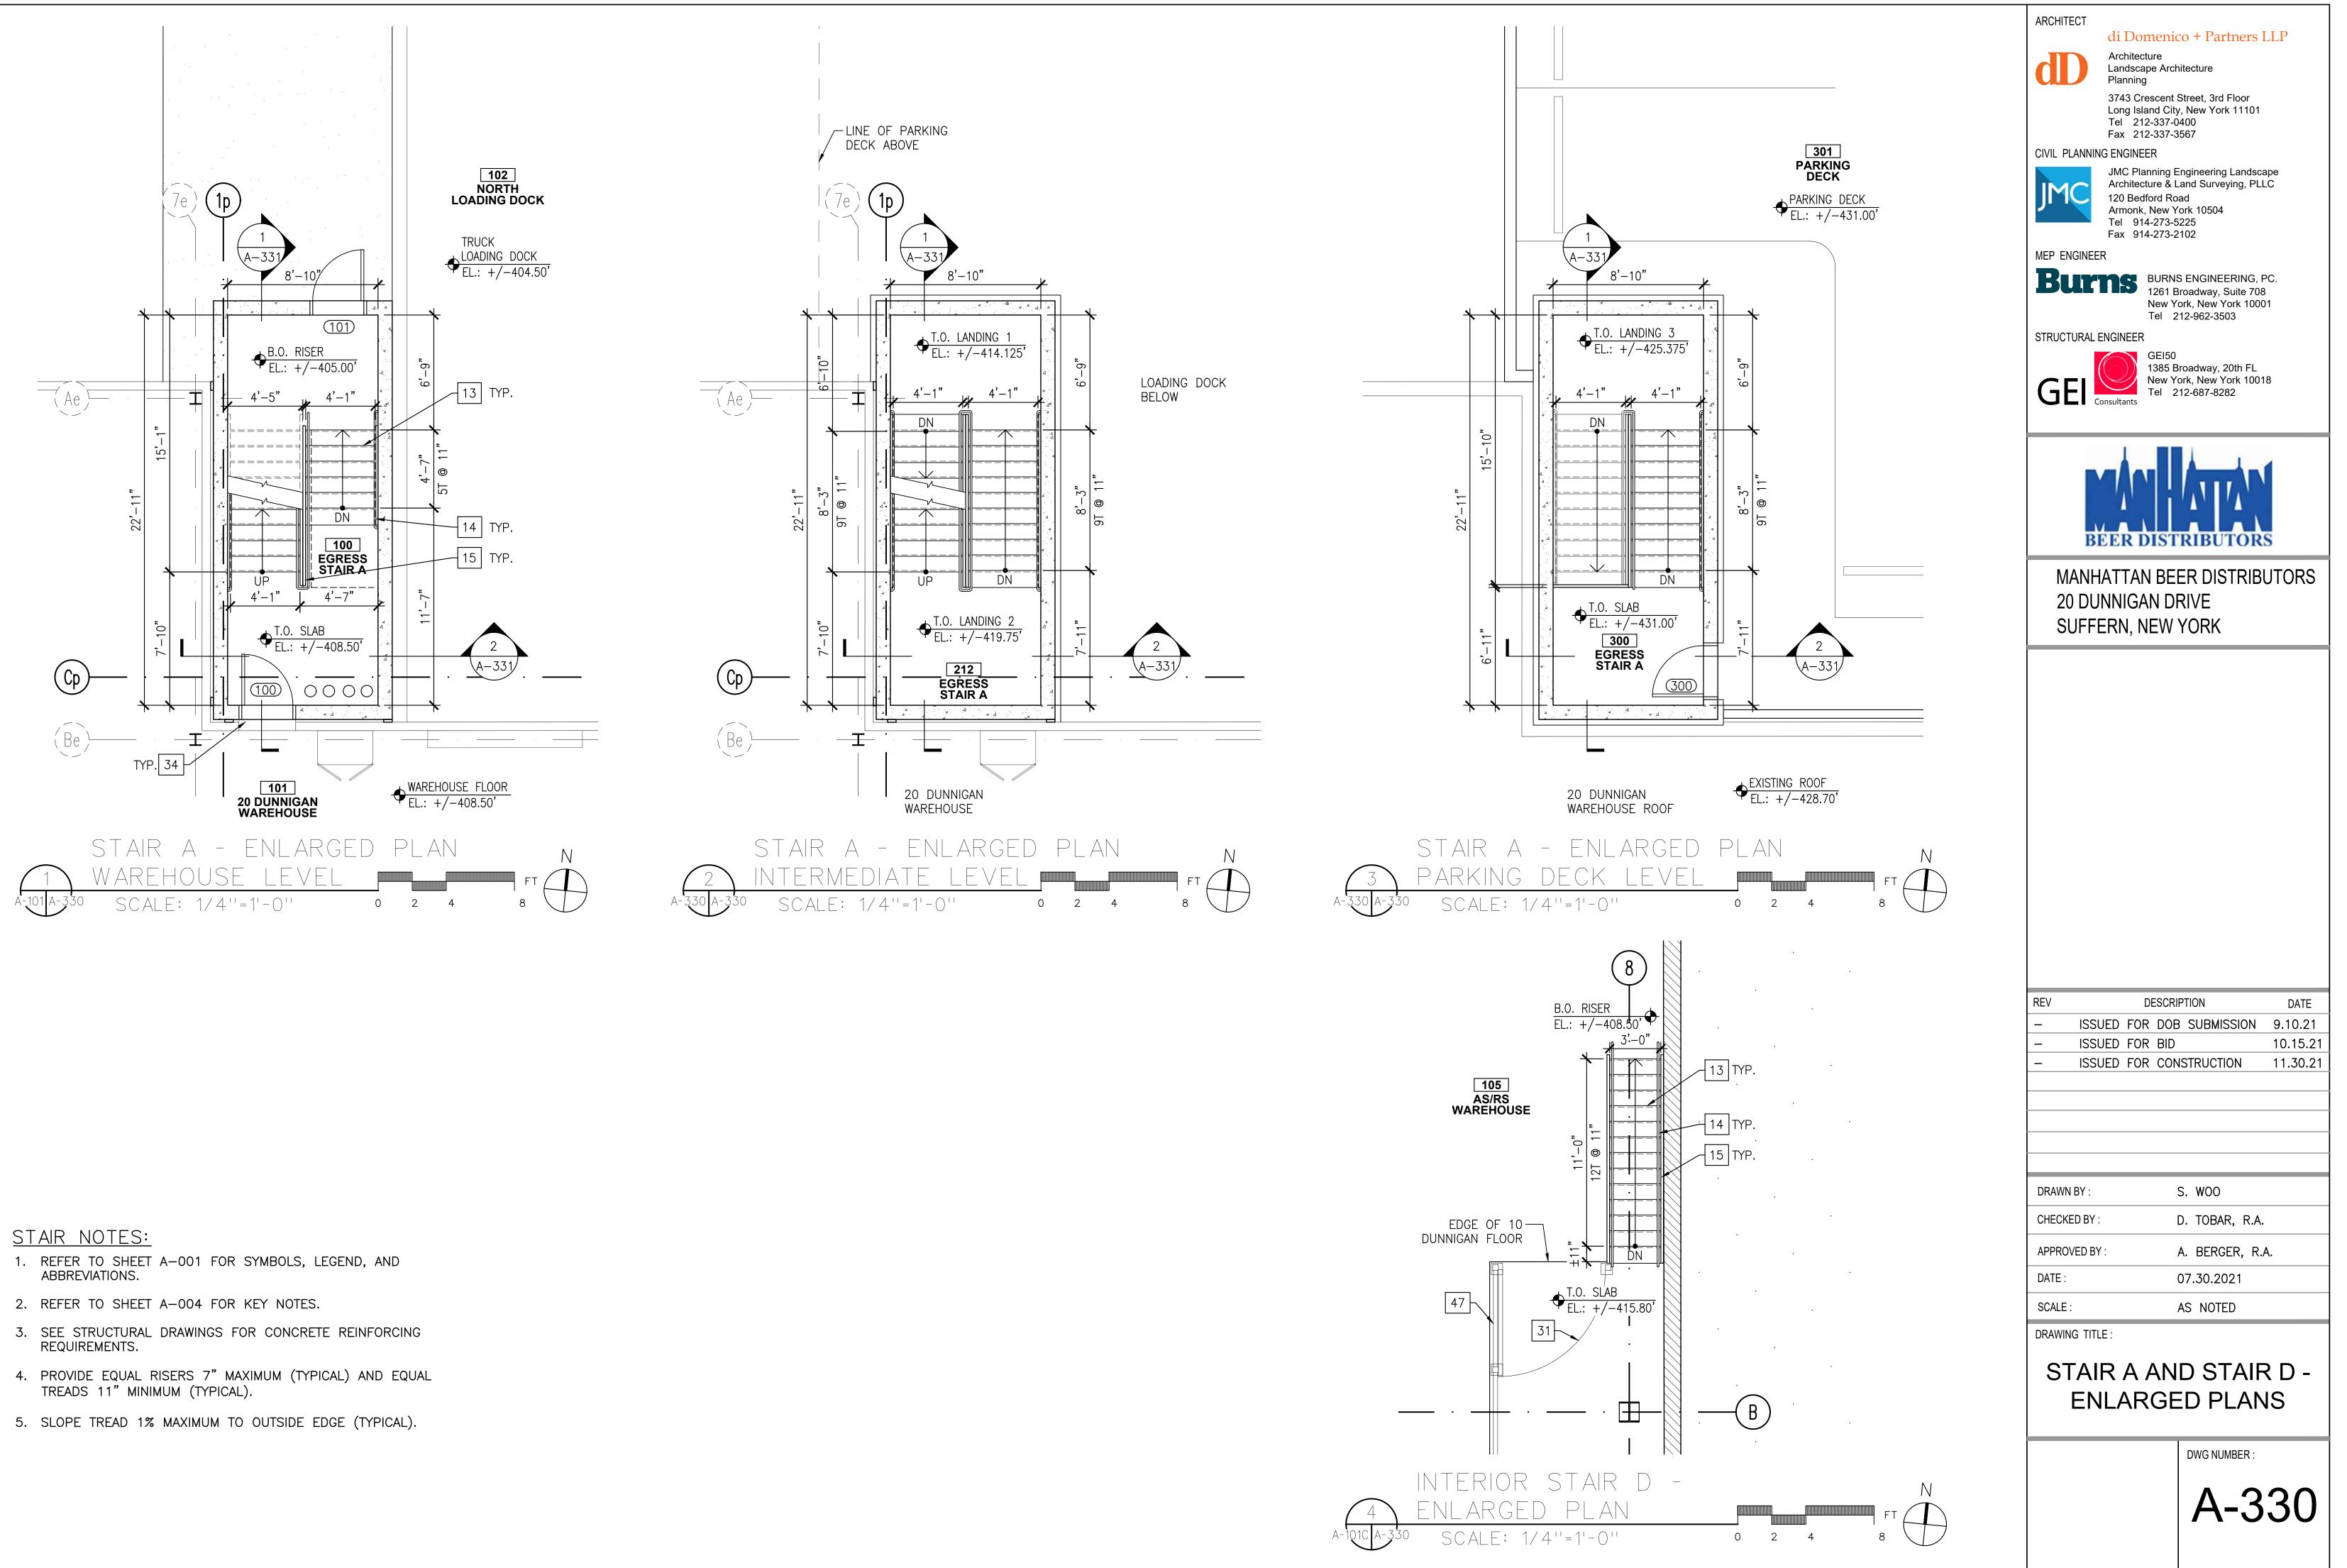

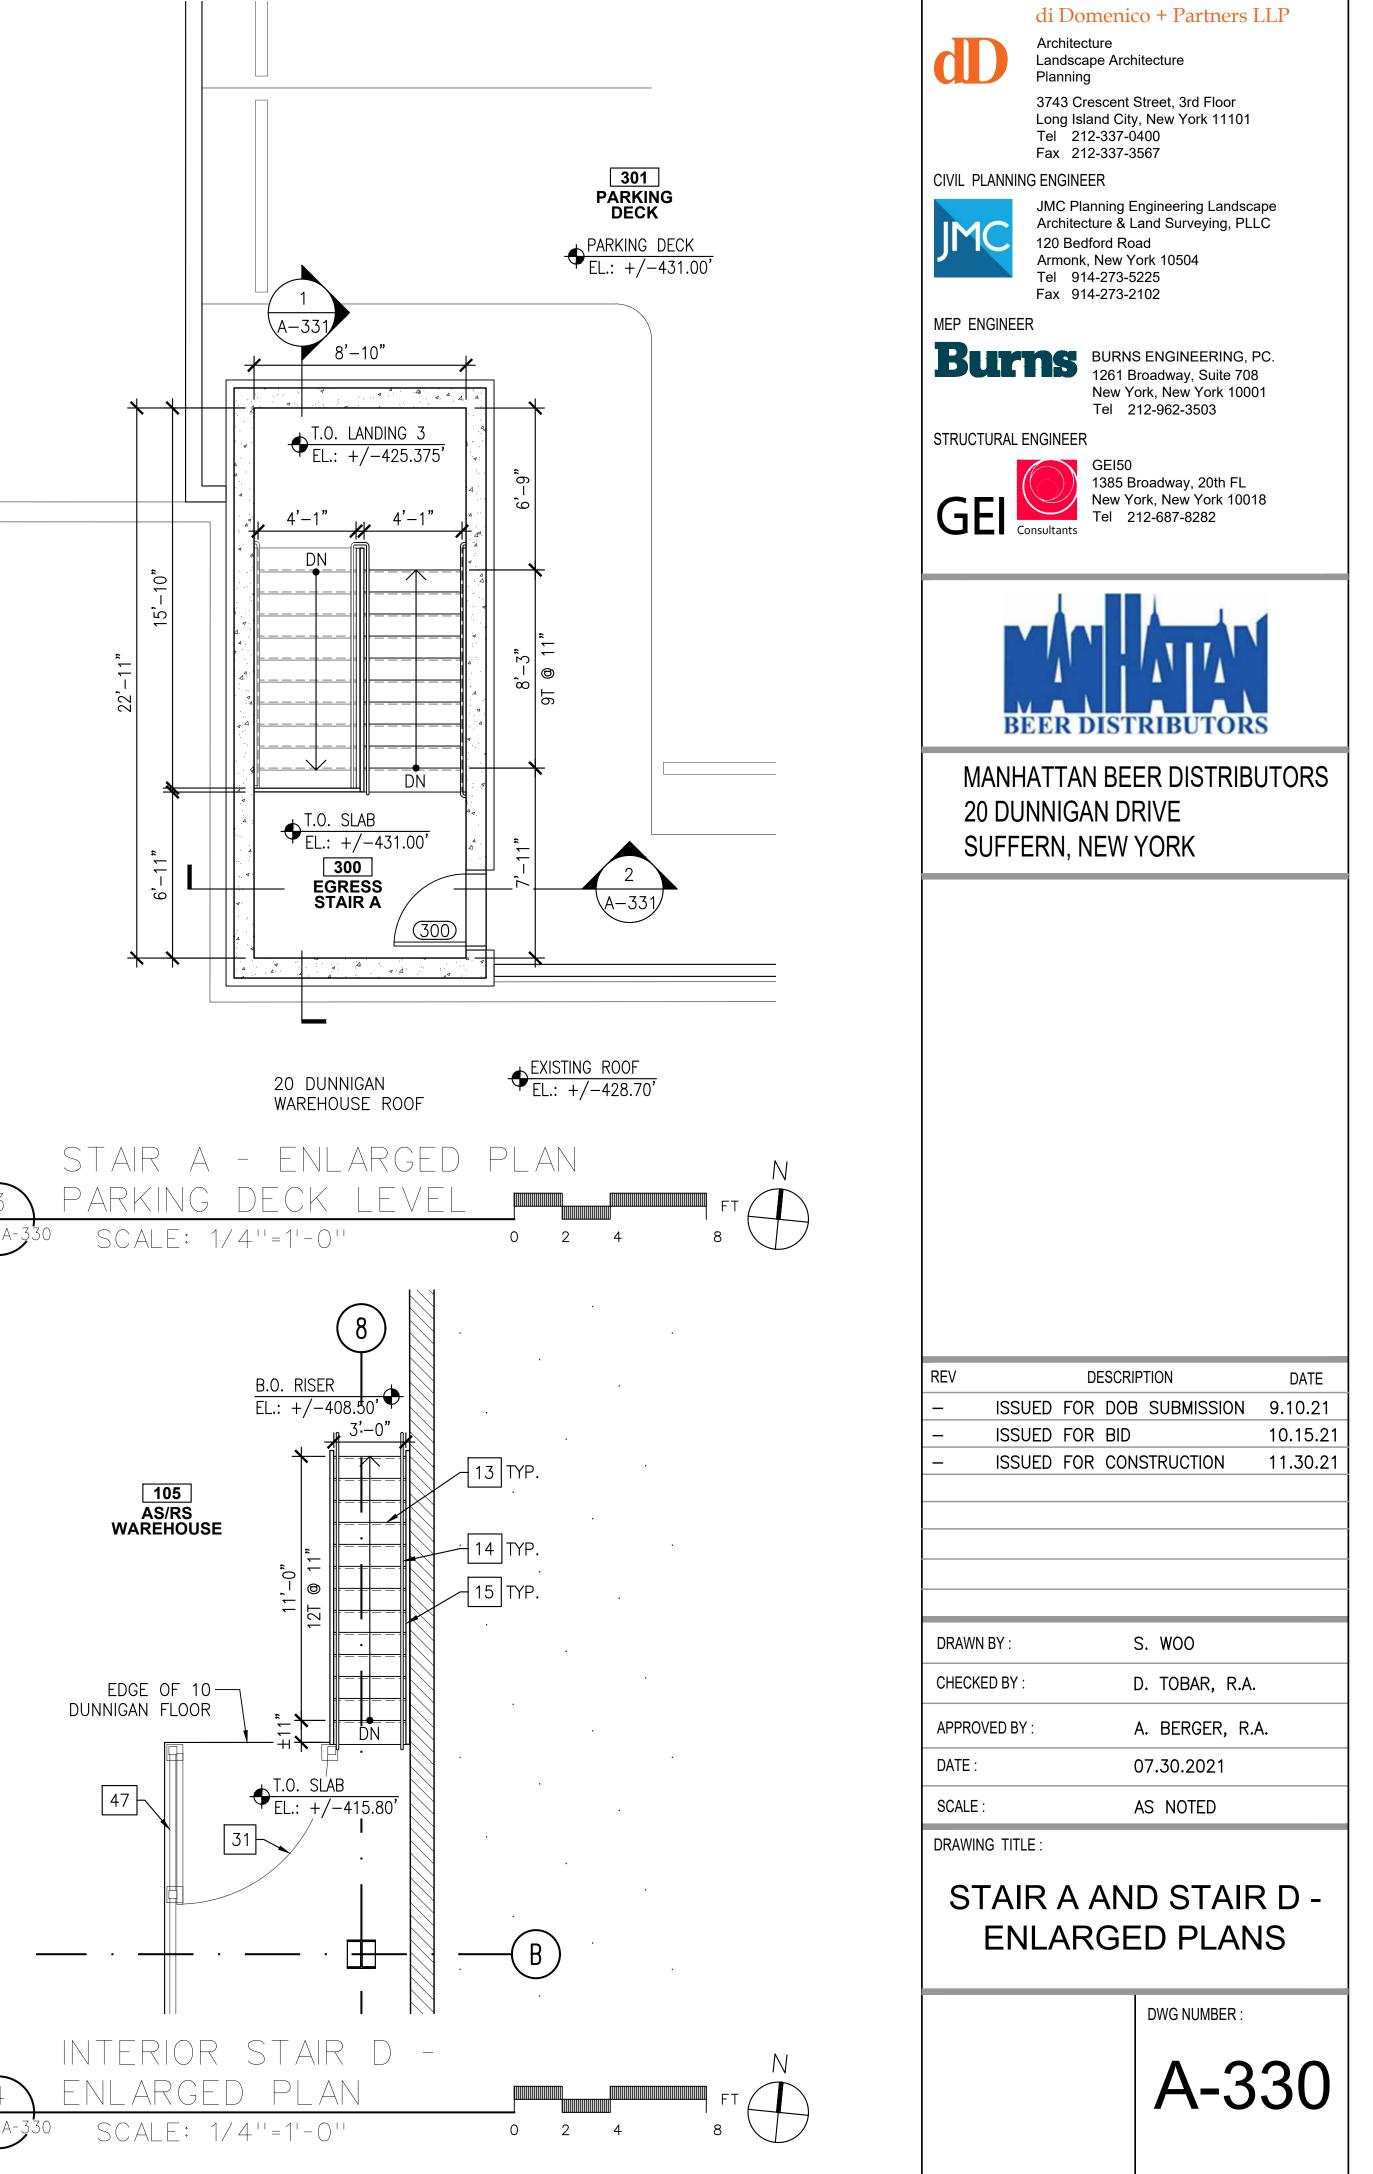

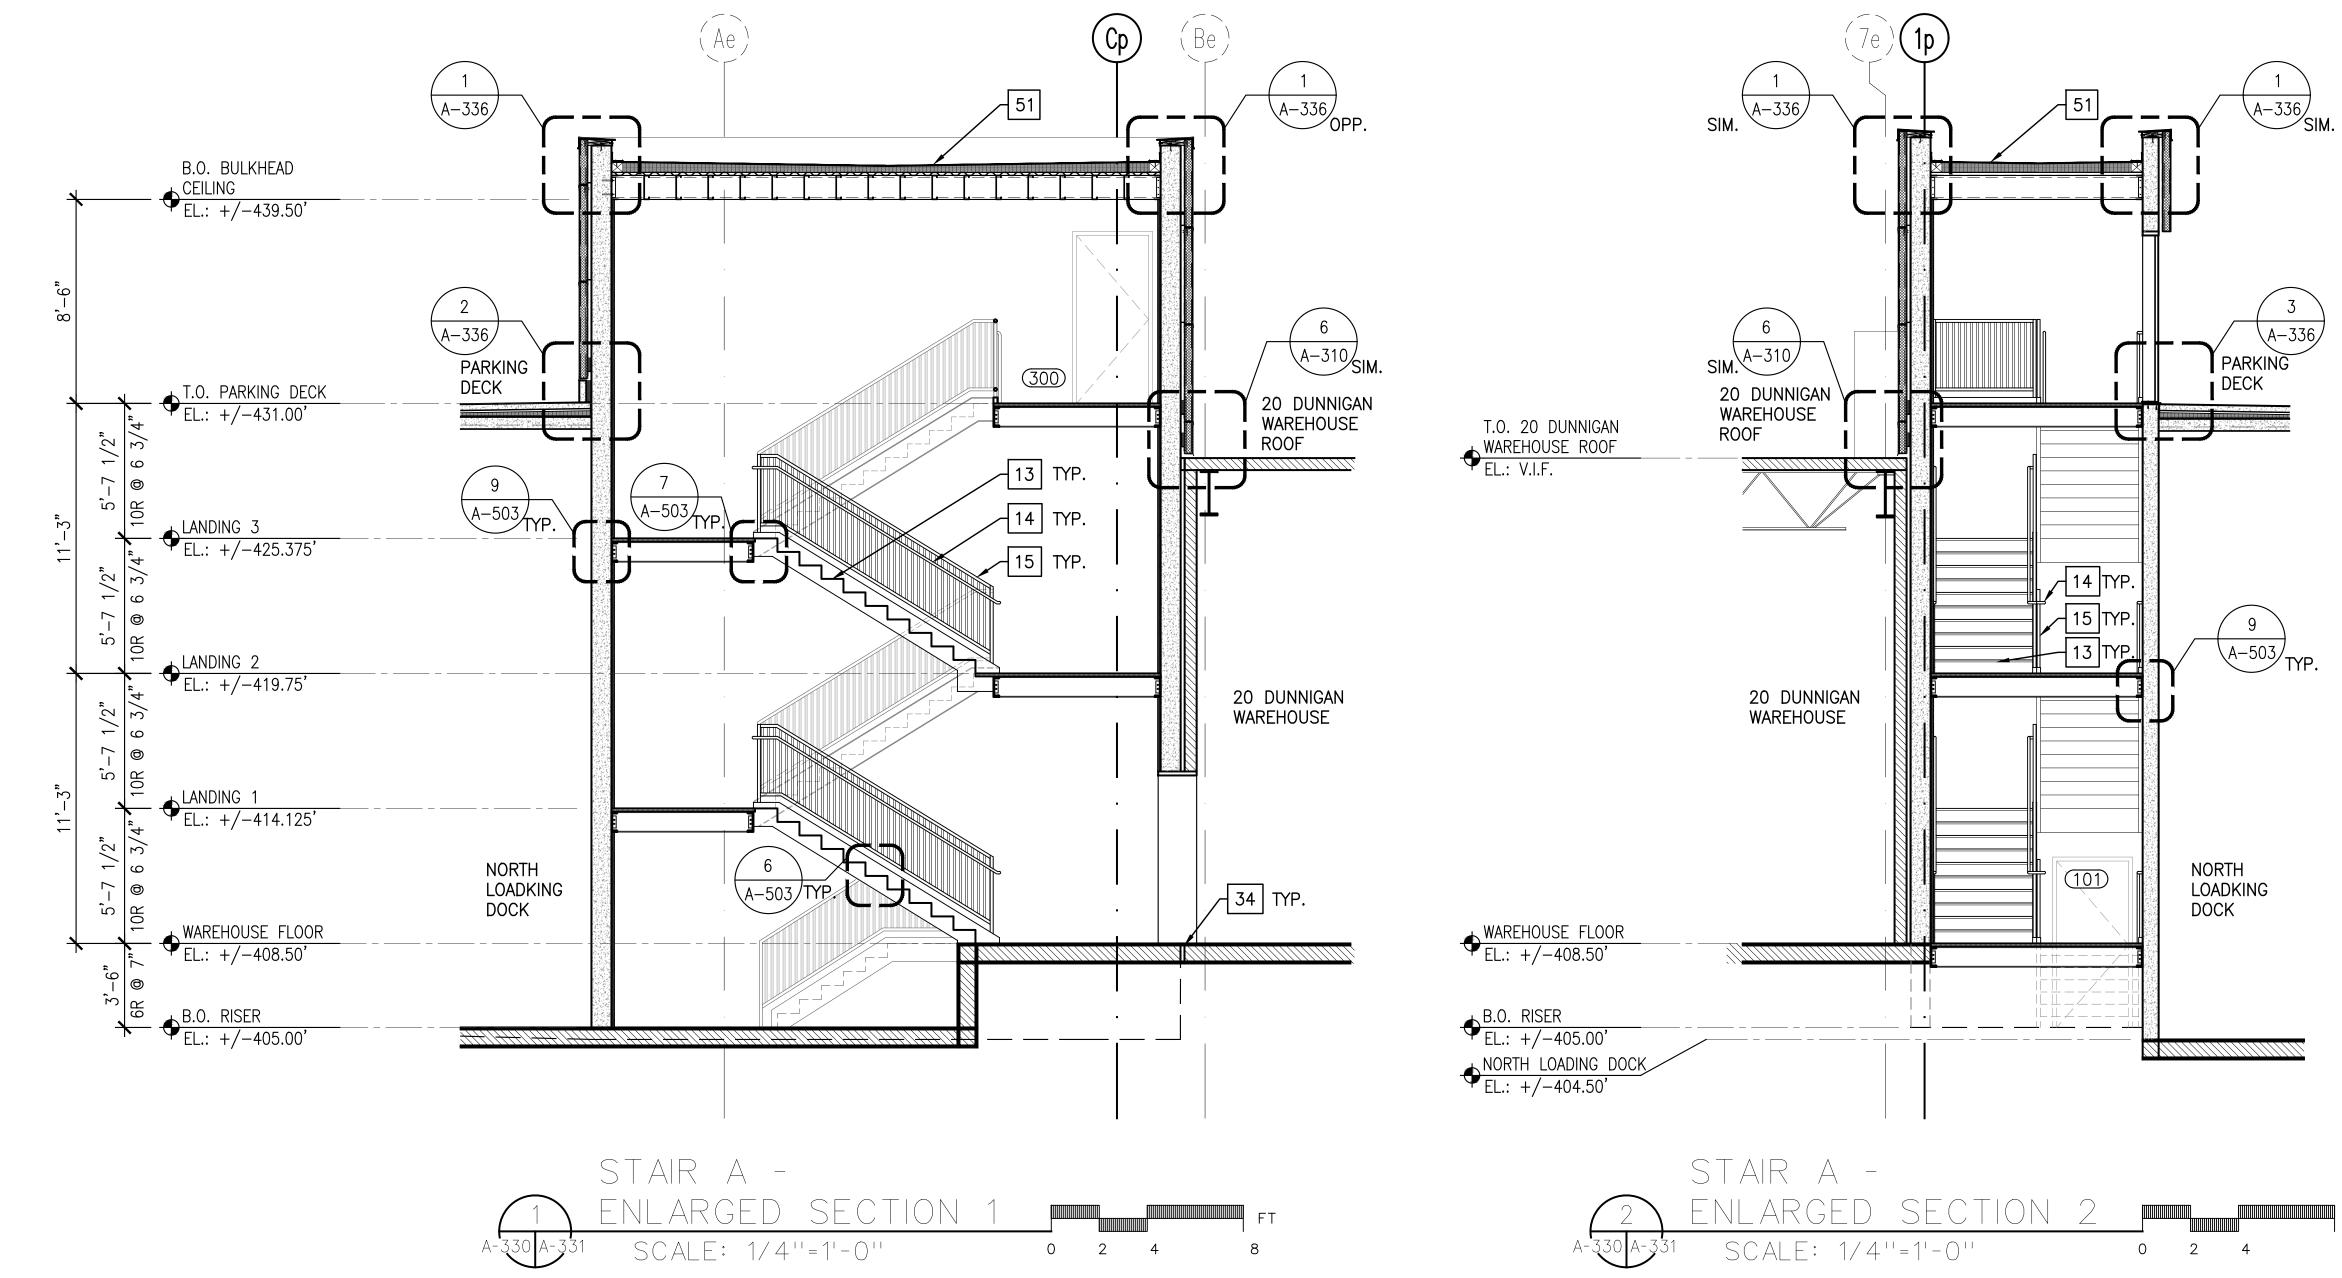STAIR NOTES:

REFER TO SHEET A-001 FOR SYMBOLS, LEGEND, AND ABBREVIATIONS.

11'-3"

11'-3"

- 2. REFER TO SHEET A-004 FOR KEY NOTES.
- 3. SEE STRUCTURAL DRAWINGS FOR CONCRETE REINFORCING REQUIREMENTS.
- 4. PROVIDE EQUAL RISERS 7" MAXIMUM (TYPICAL) AND EQUAL TREADS 11" MINIMUM (TYPICAL).
- 5. SLOPE TREAD 1% MAXIMUM TO OUTSIDE EDGE (TYPICAL).


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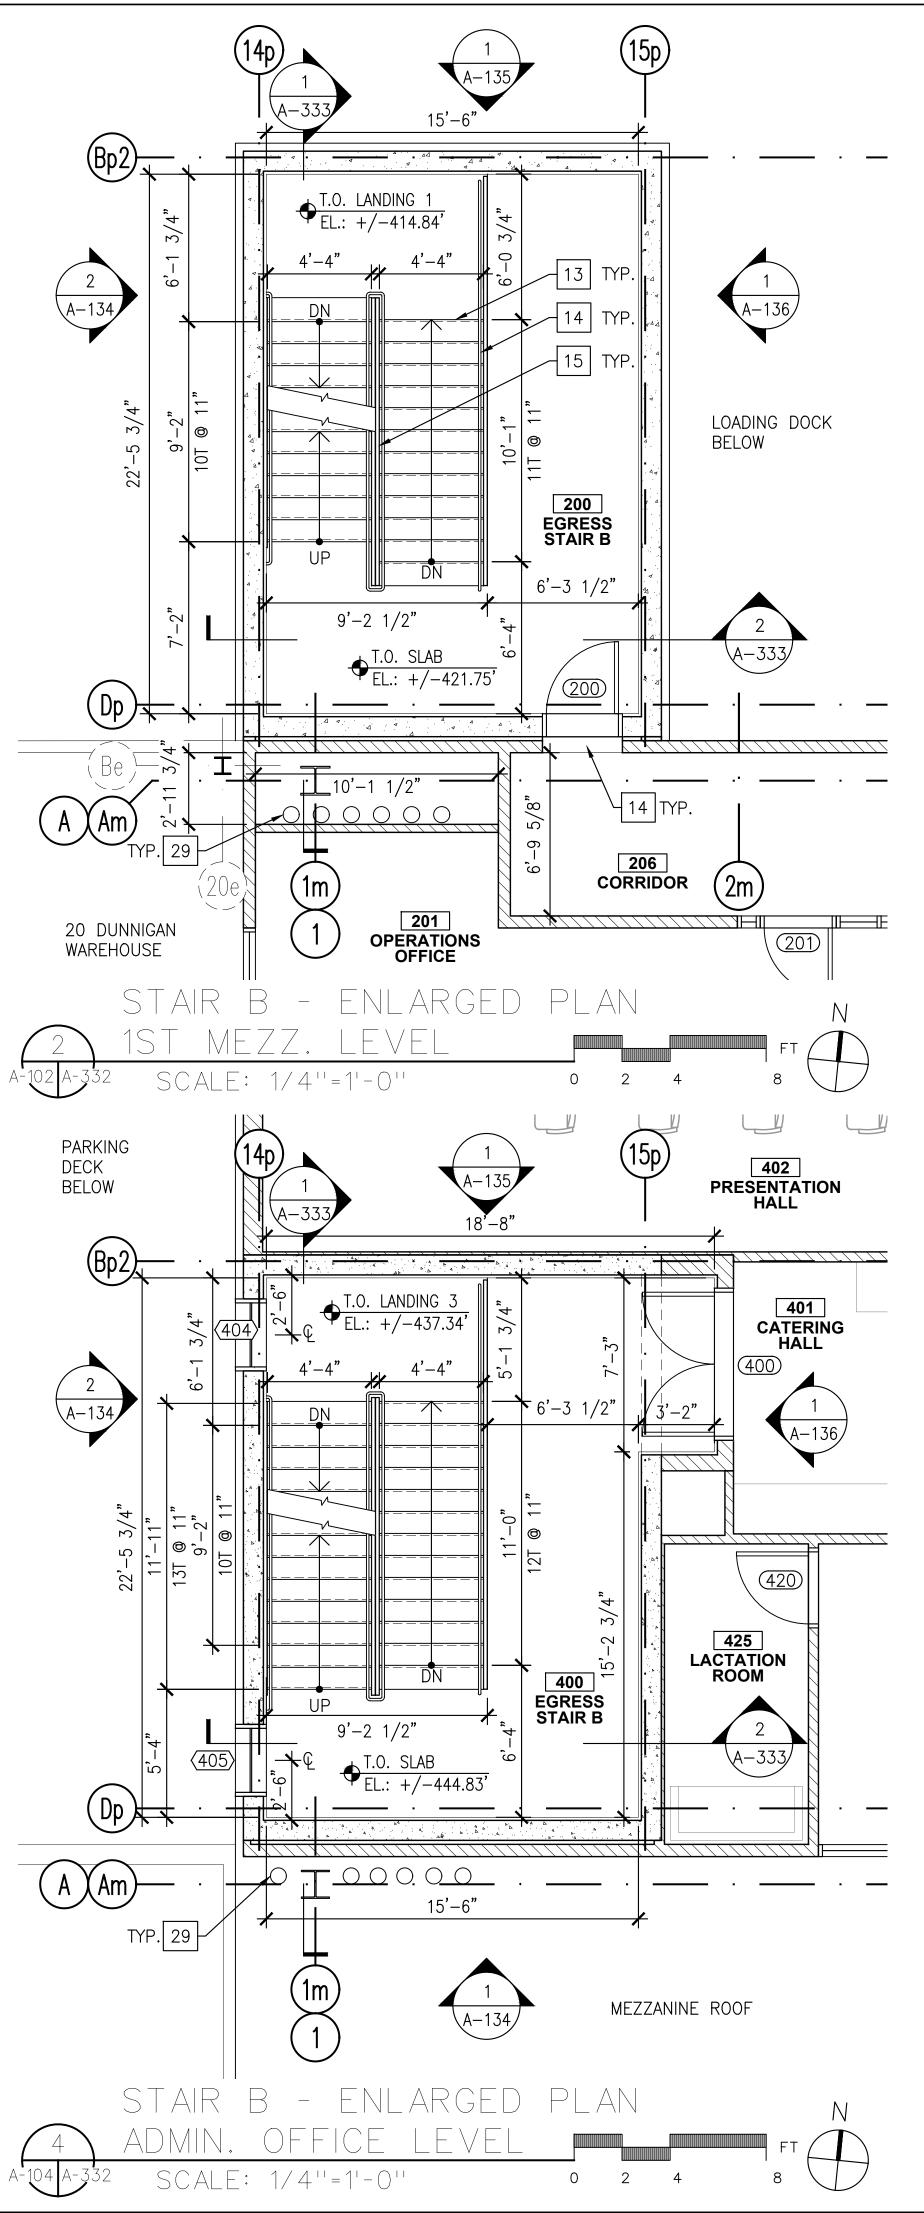
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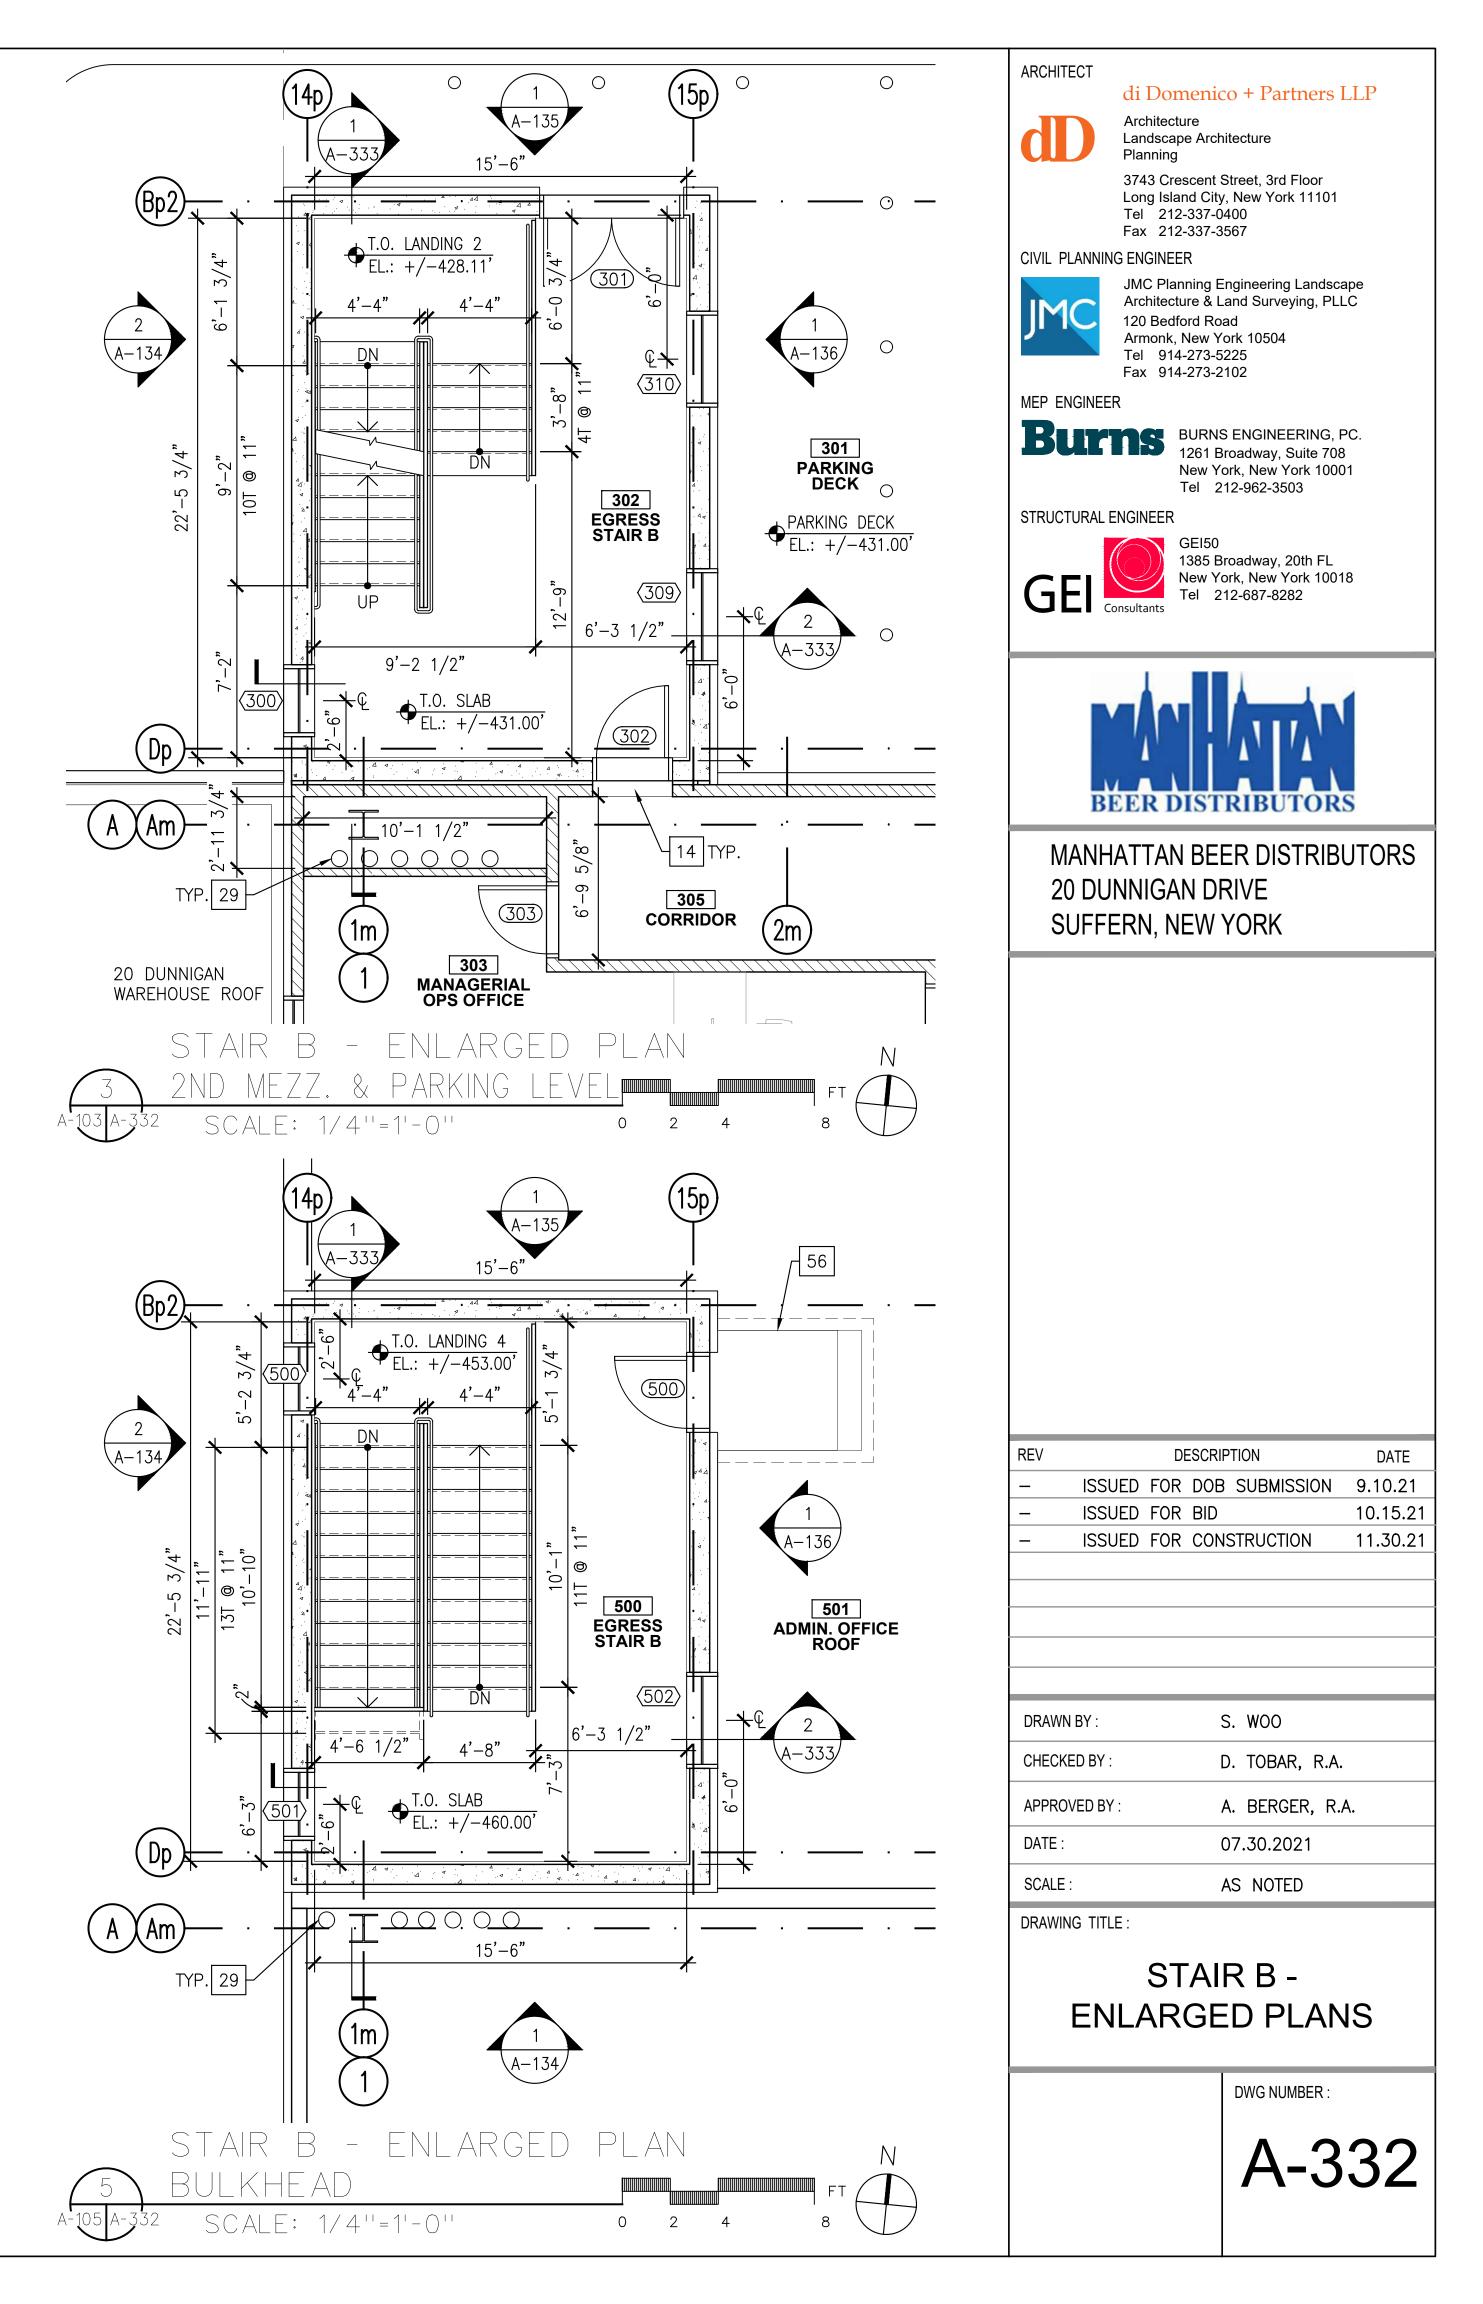
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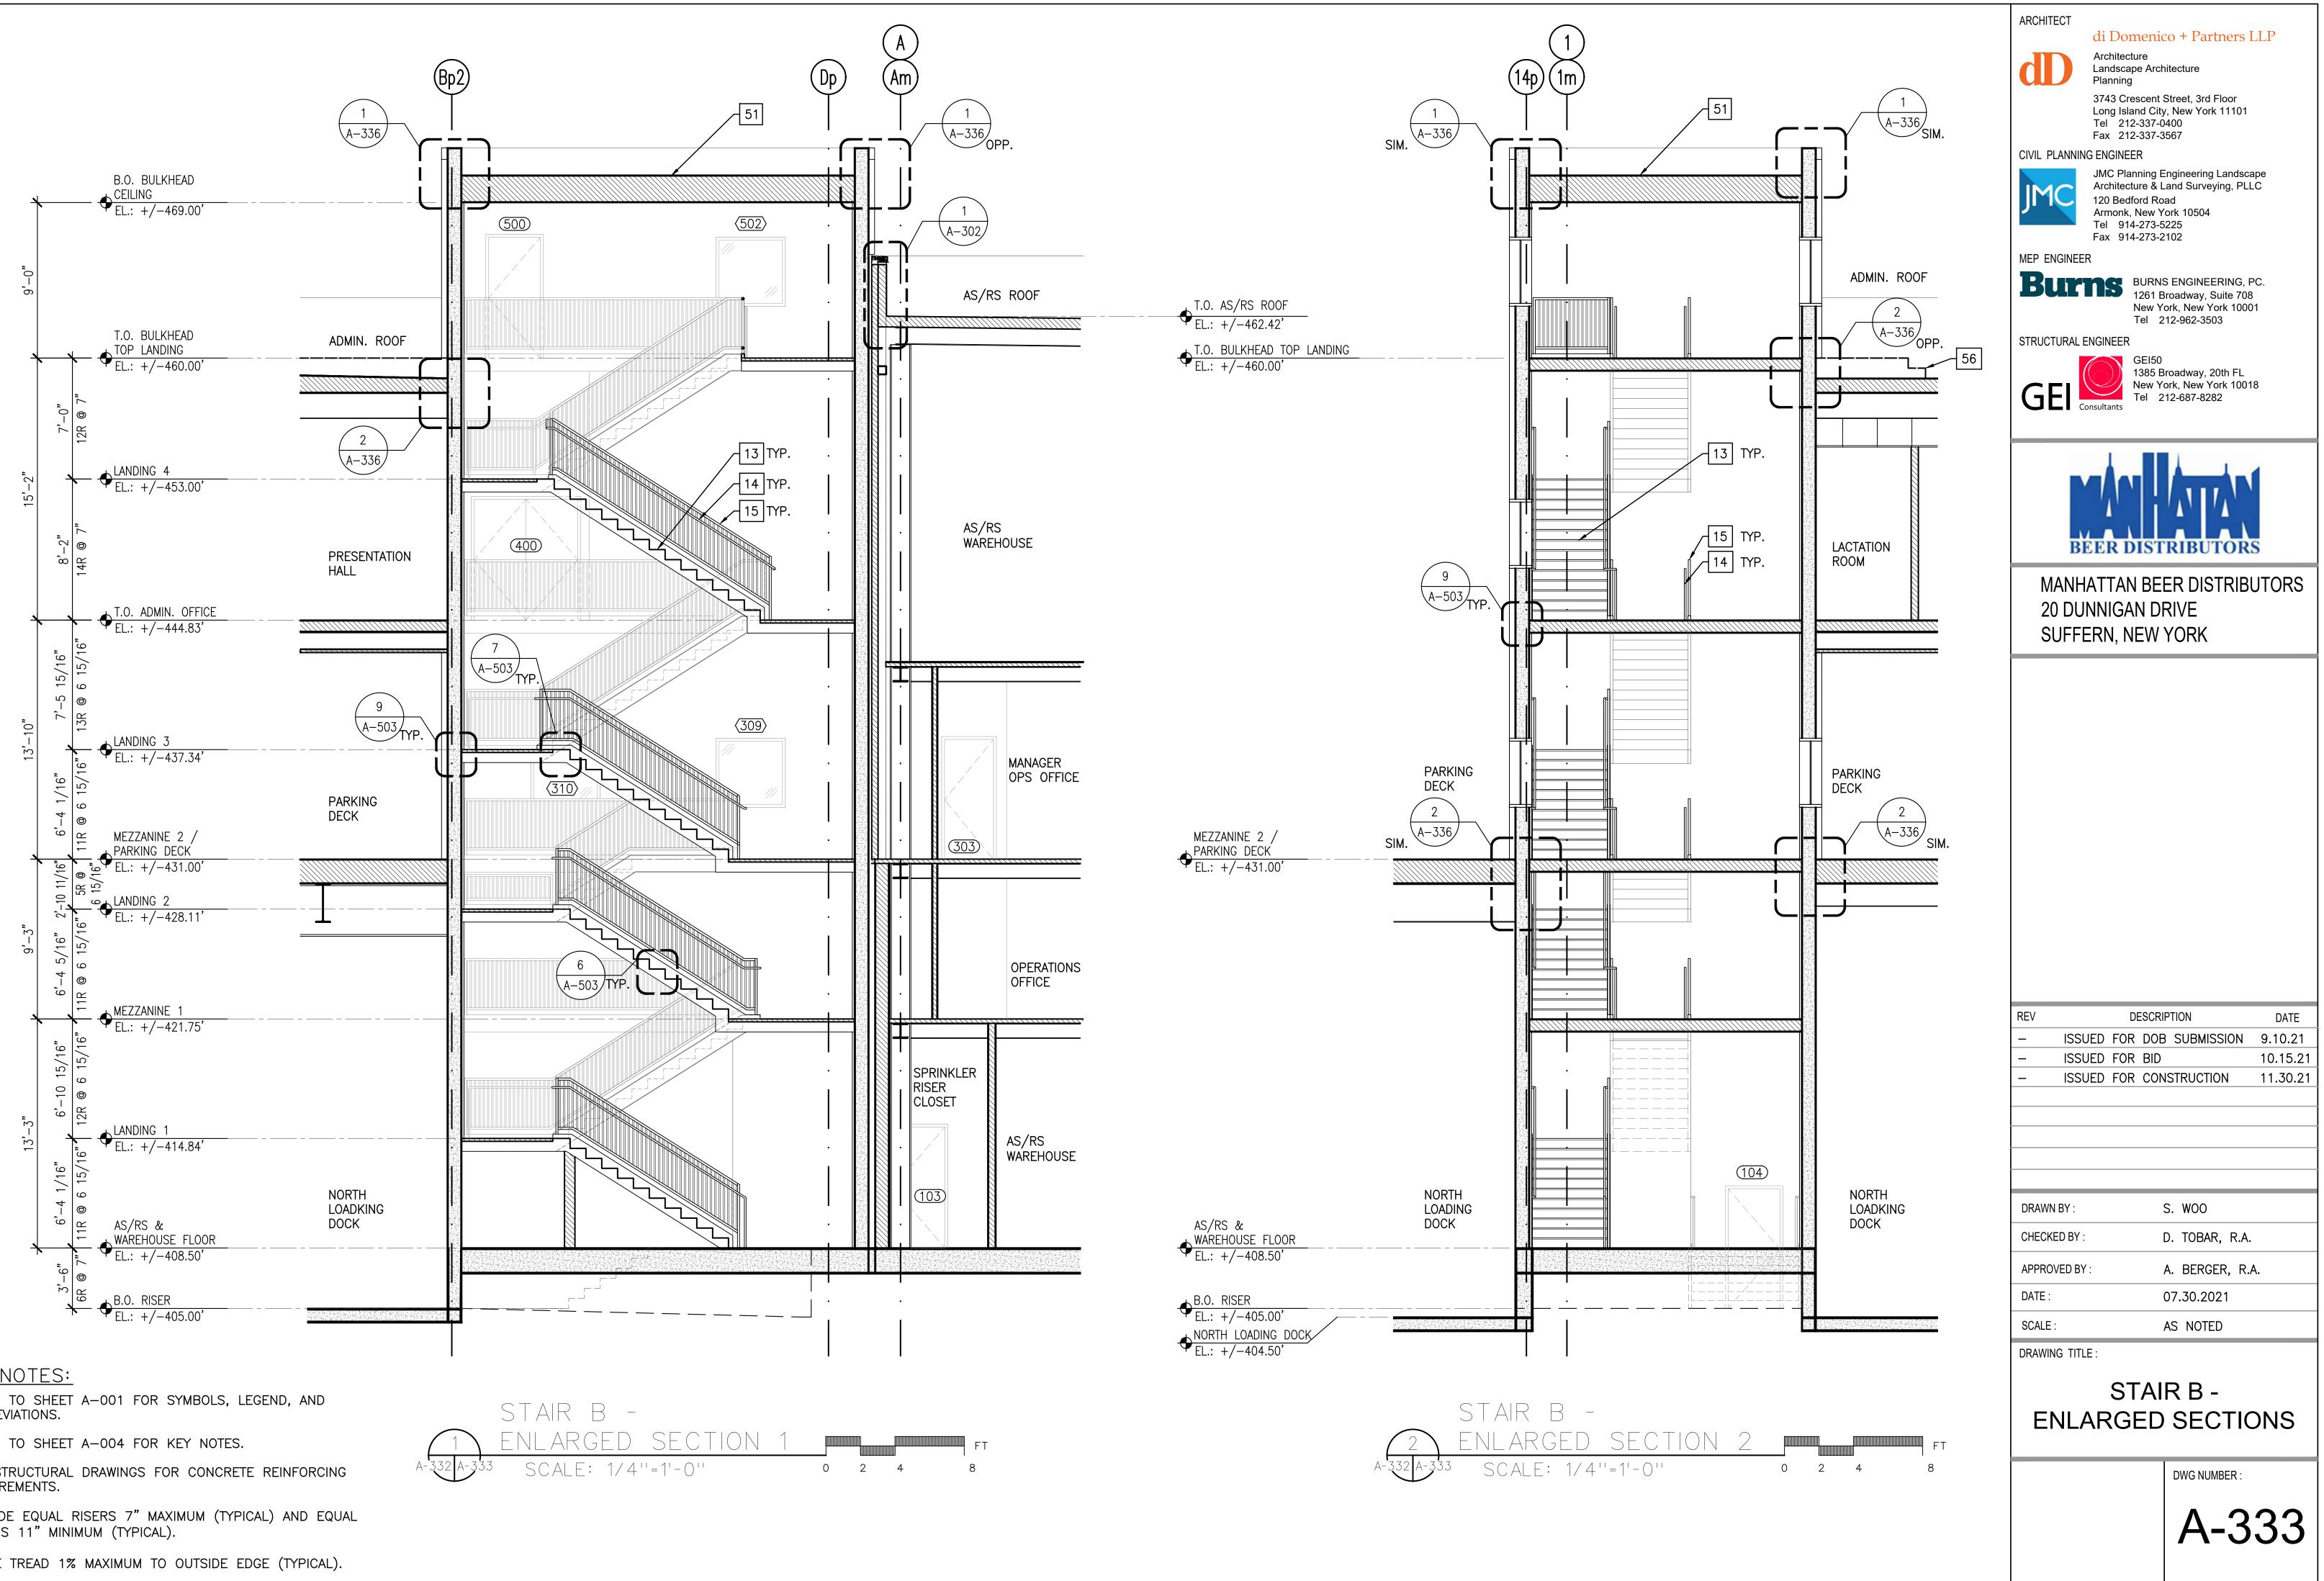
di Domenico + Partners LLP

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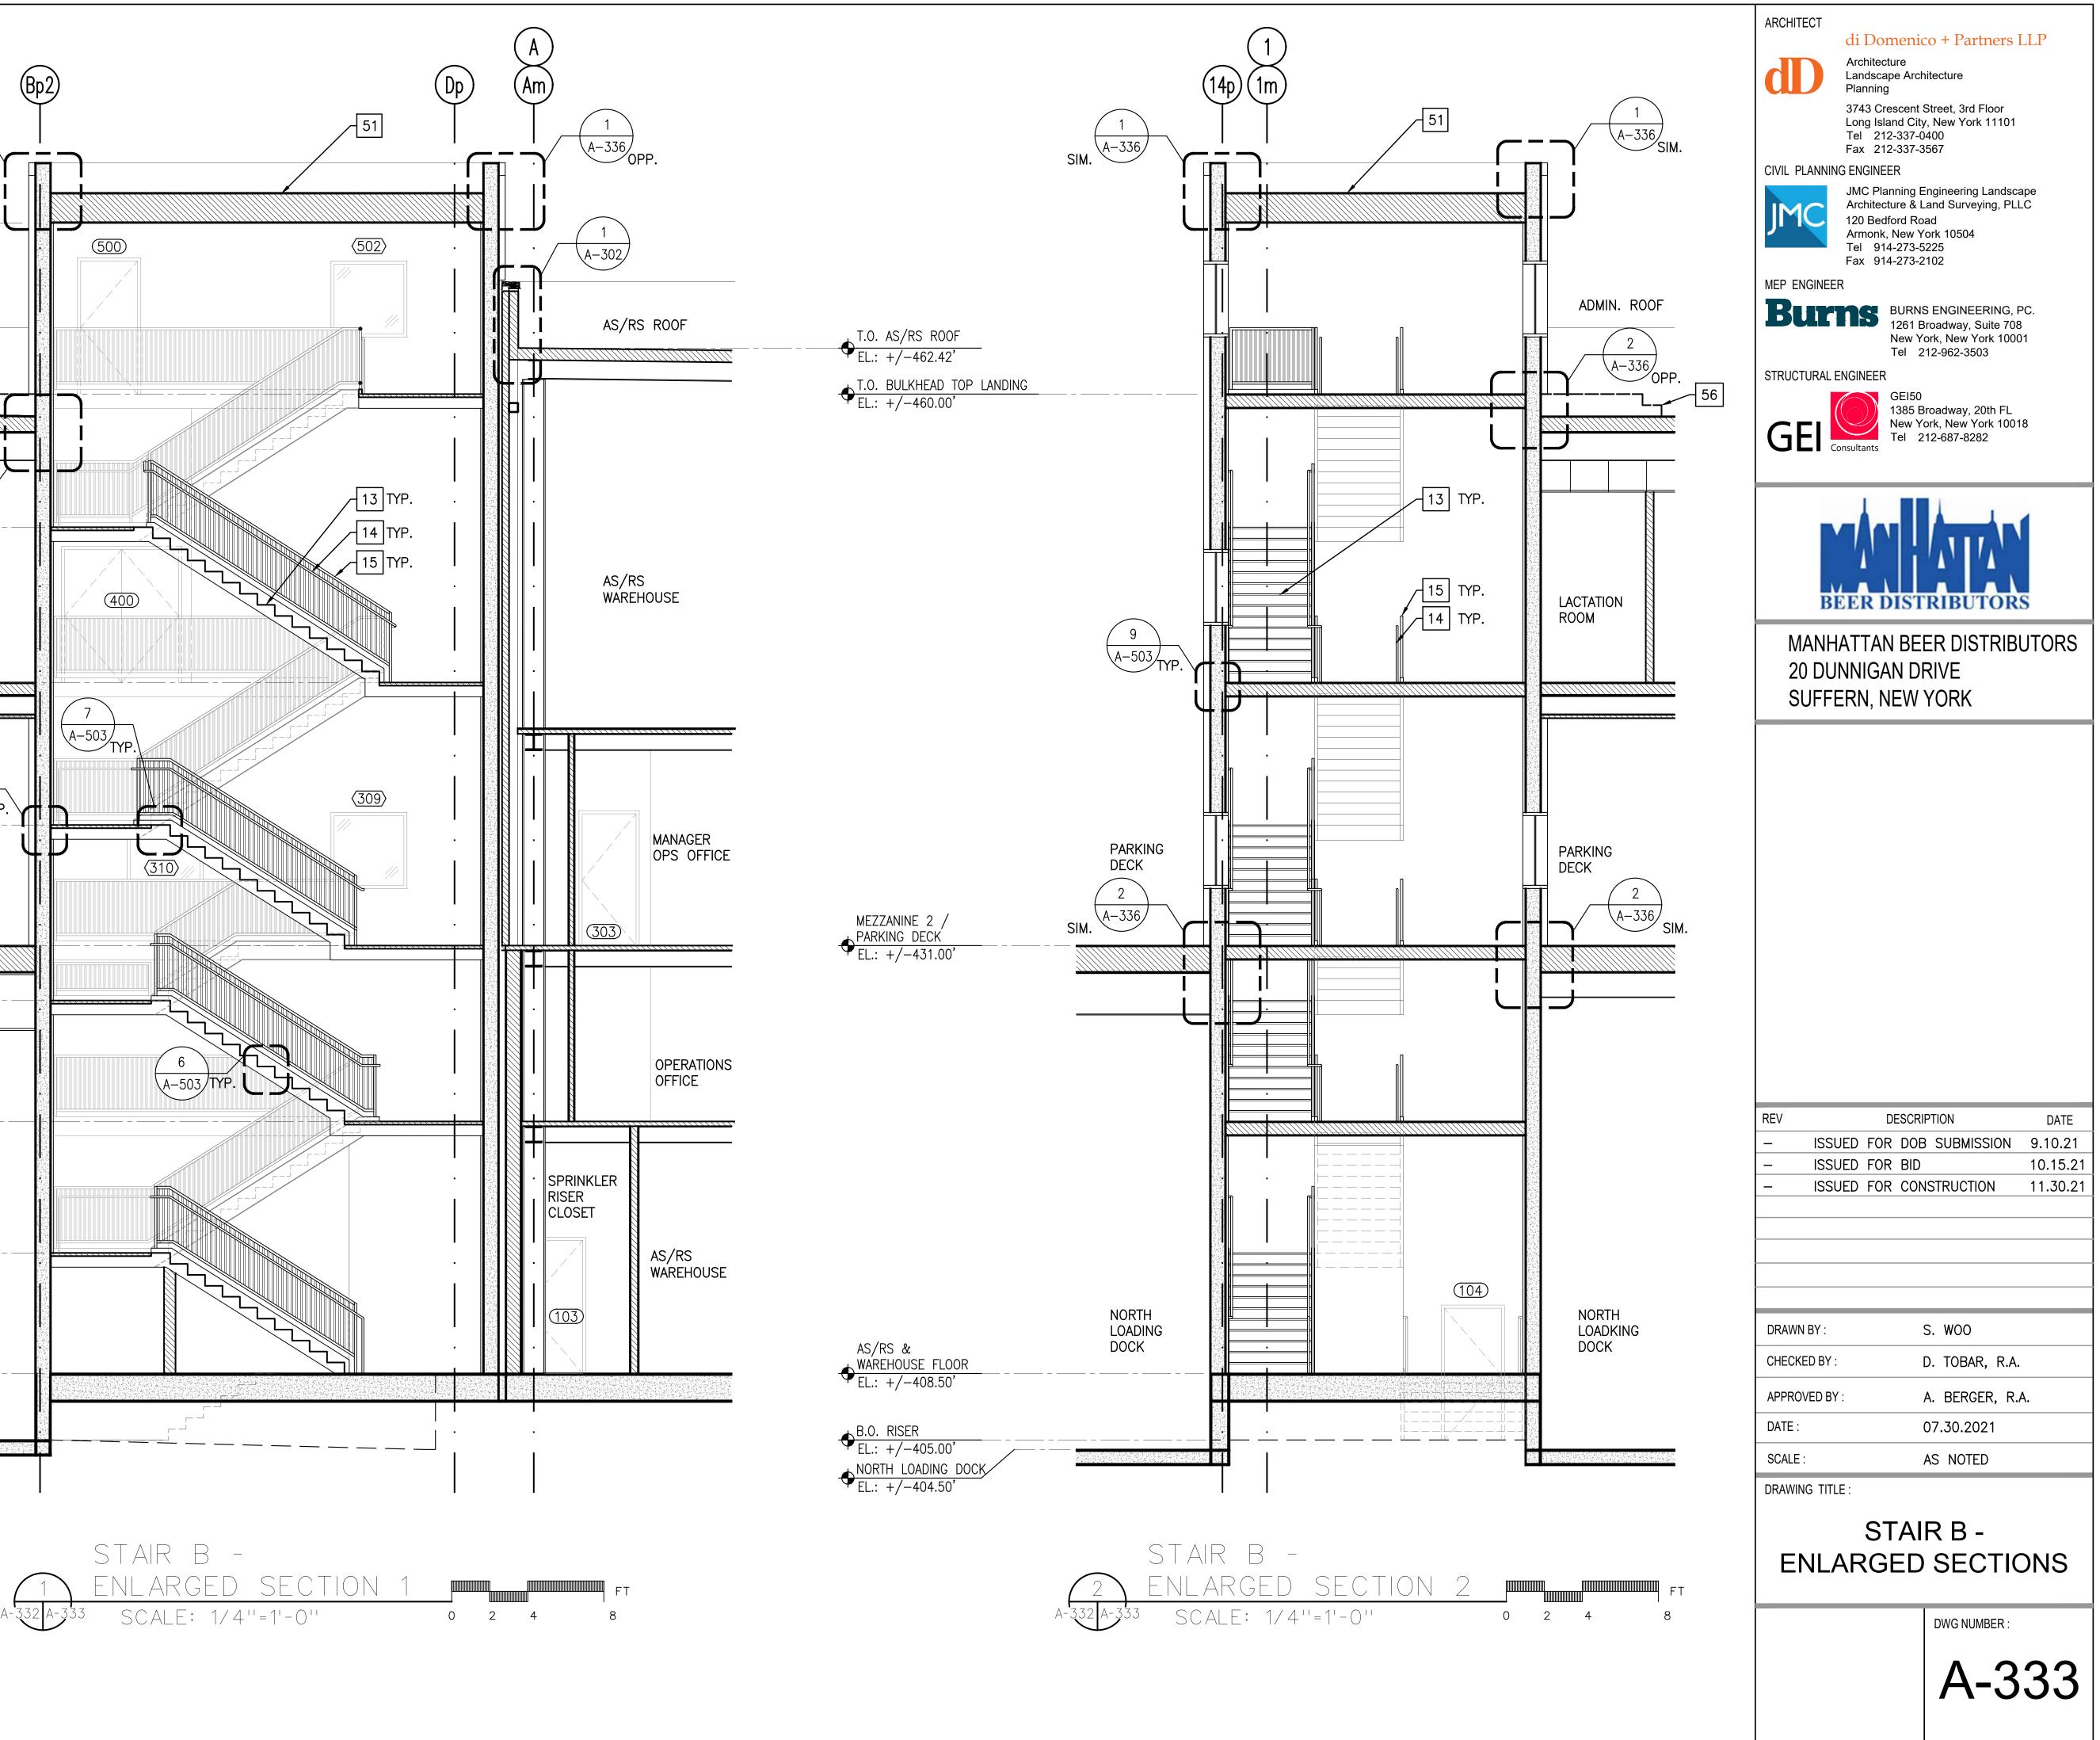









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- 1. REFER TO SHEET A-001 FOR SYMBOLS, LEGEND, AND ABBREVIATIONS.
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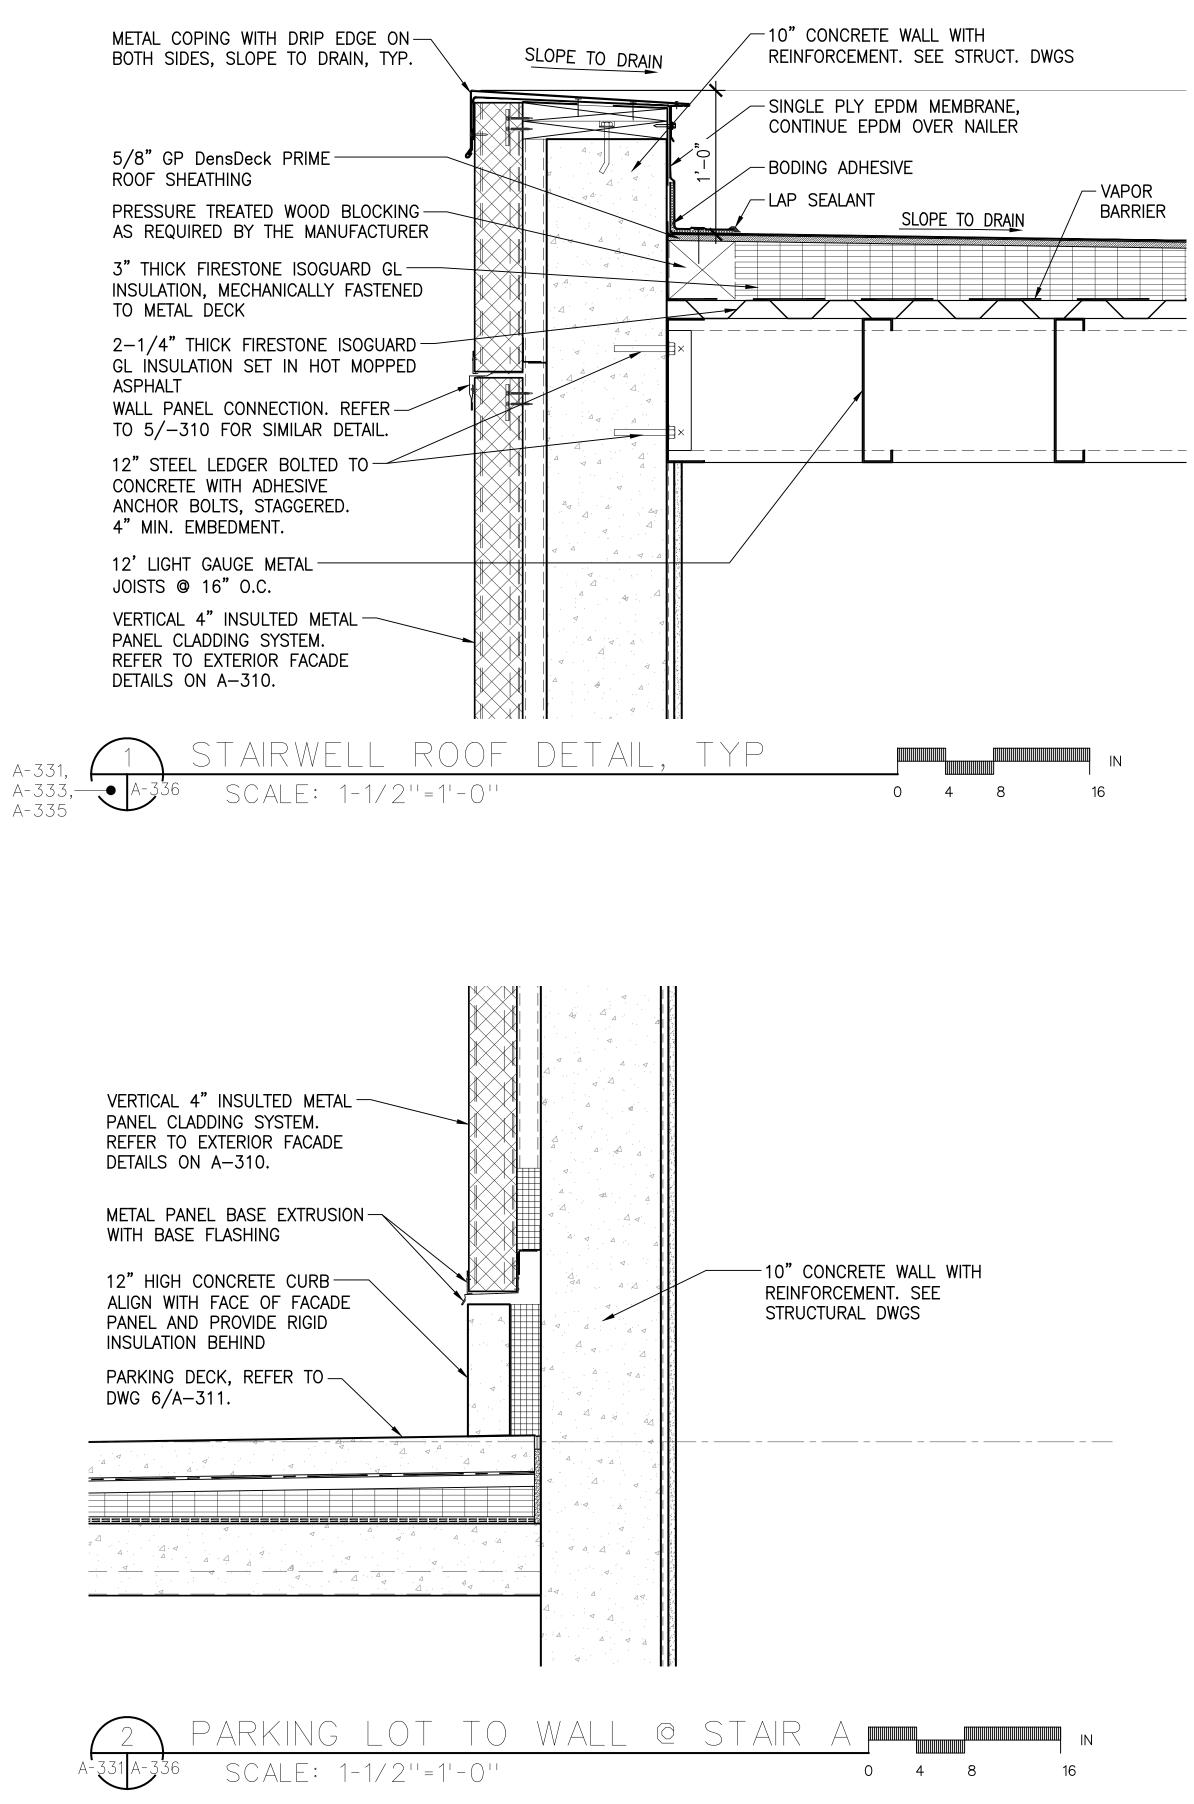


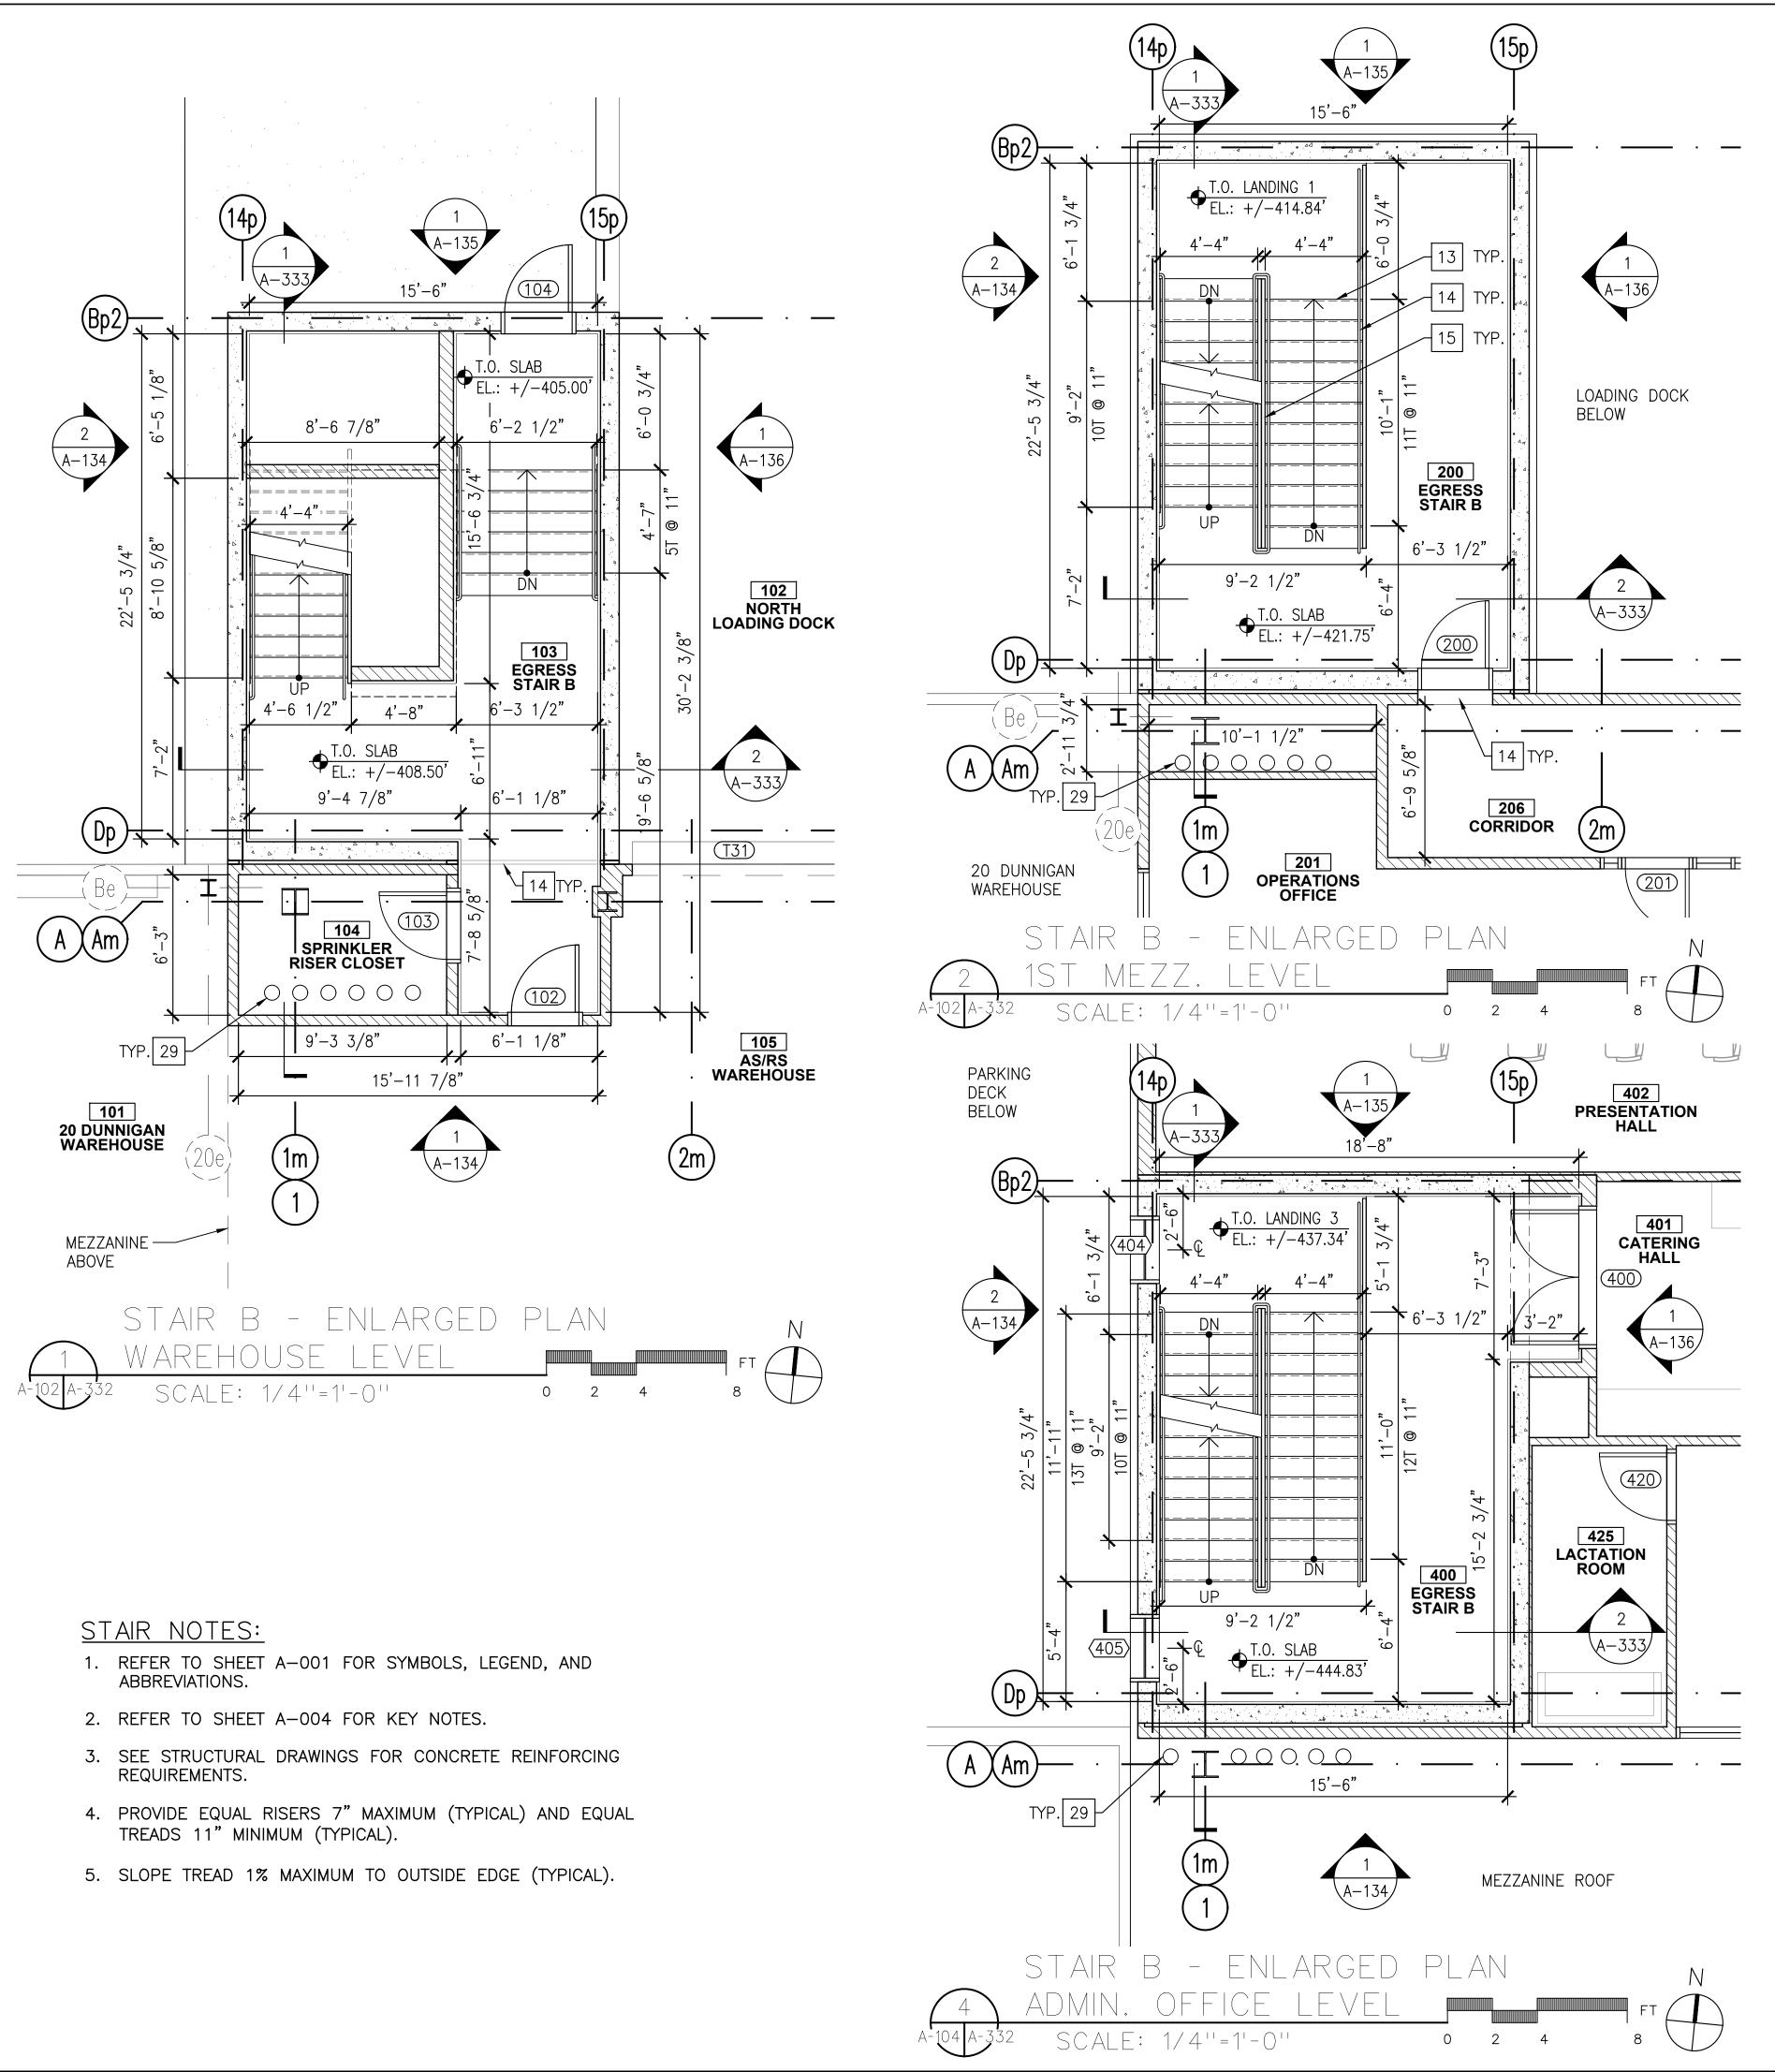




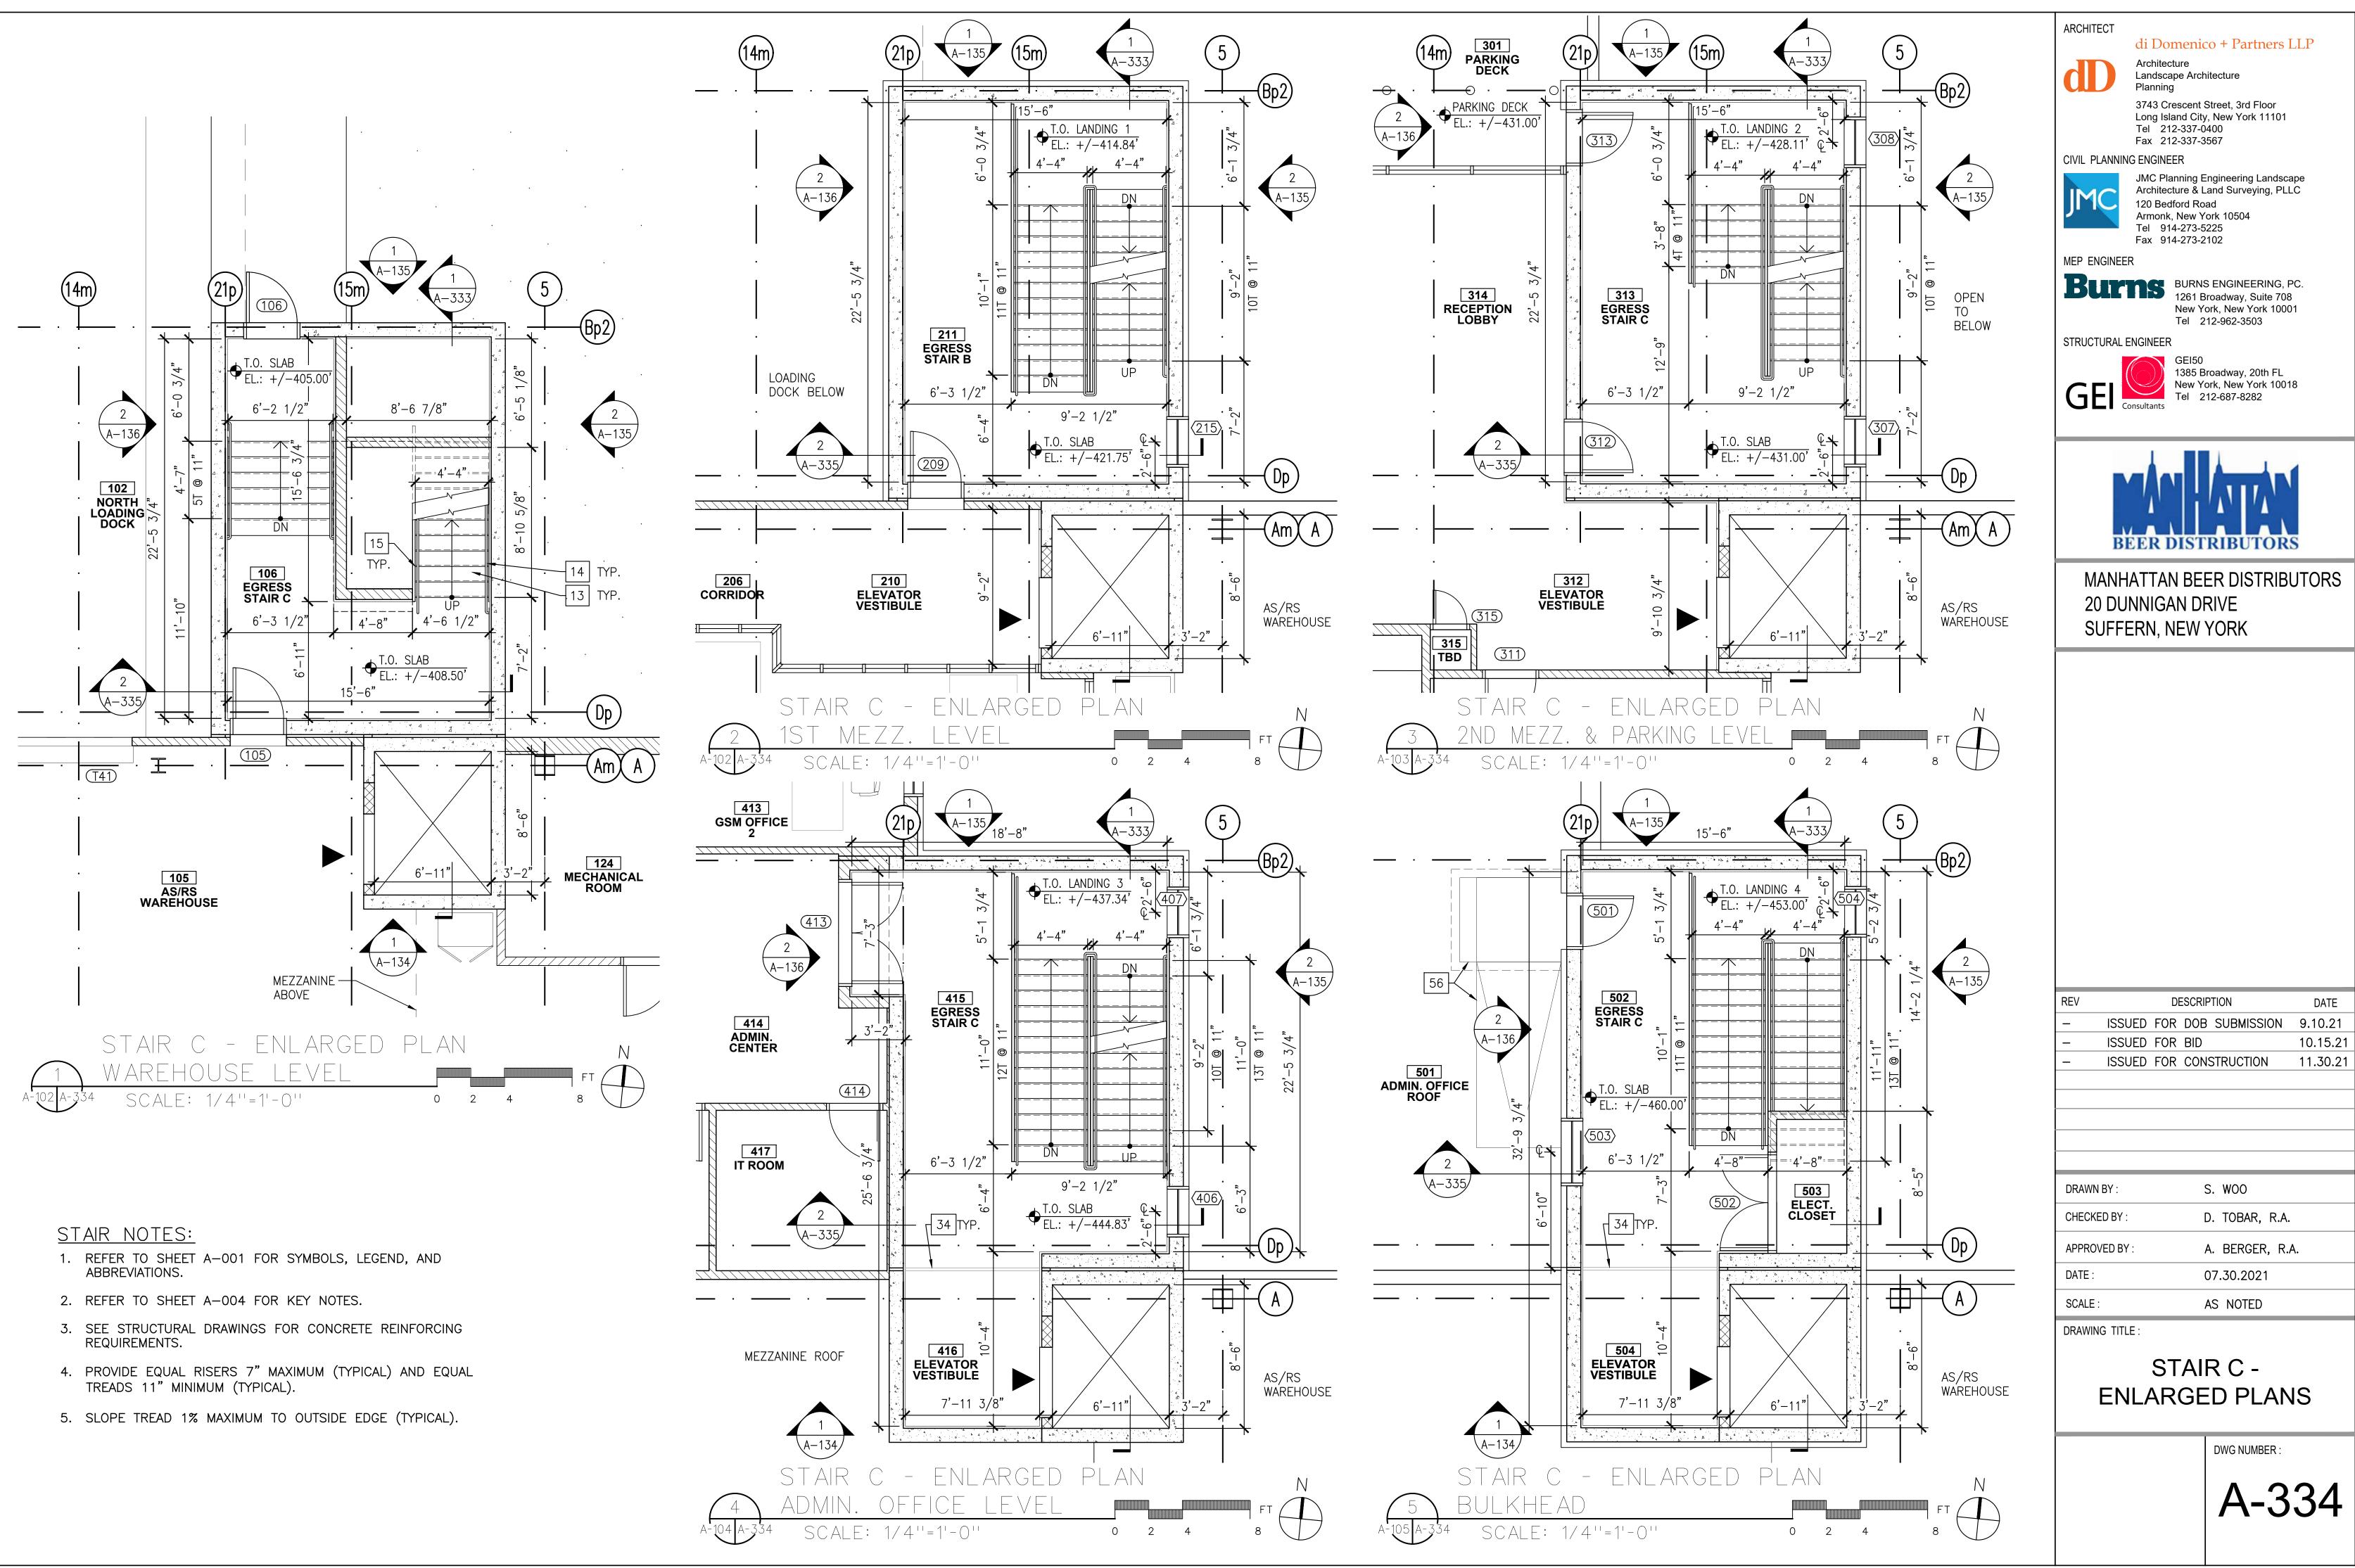

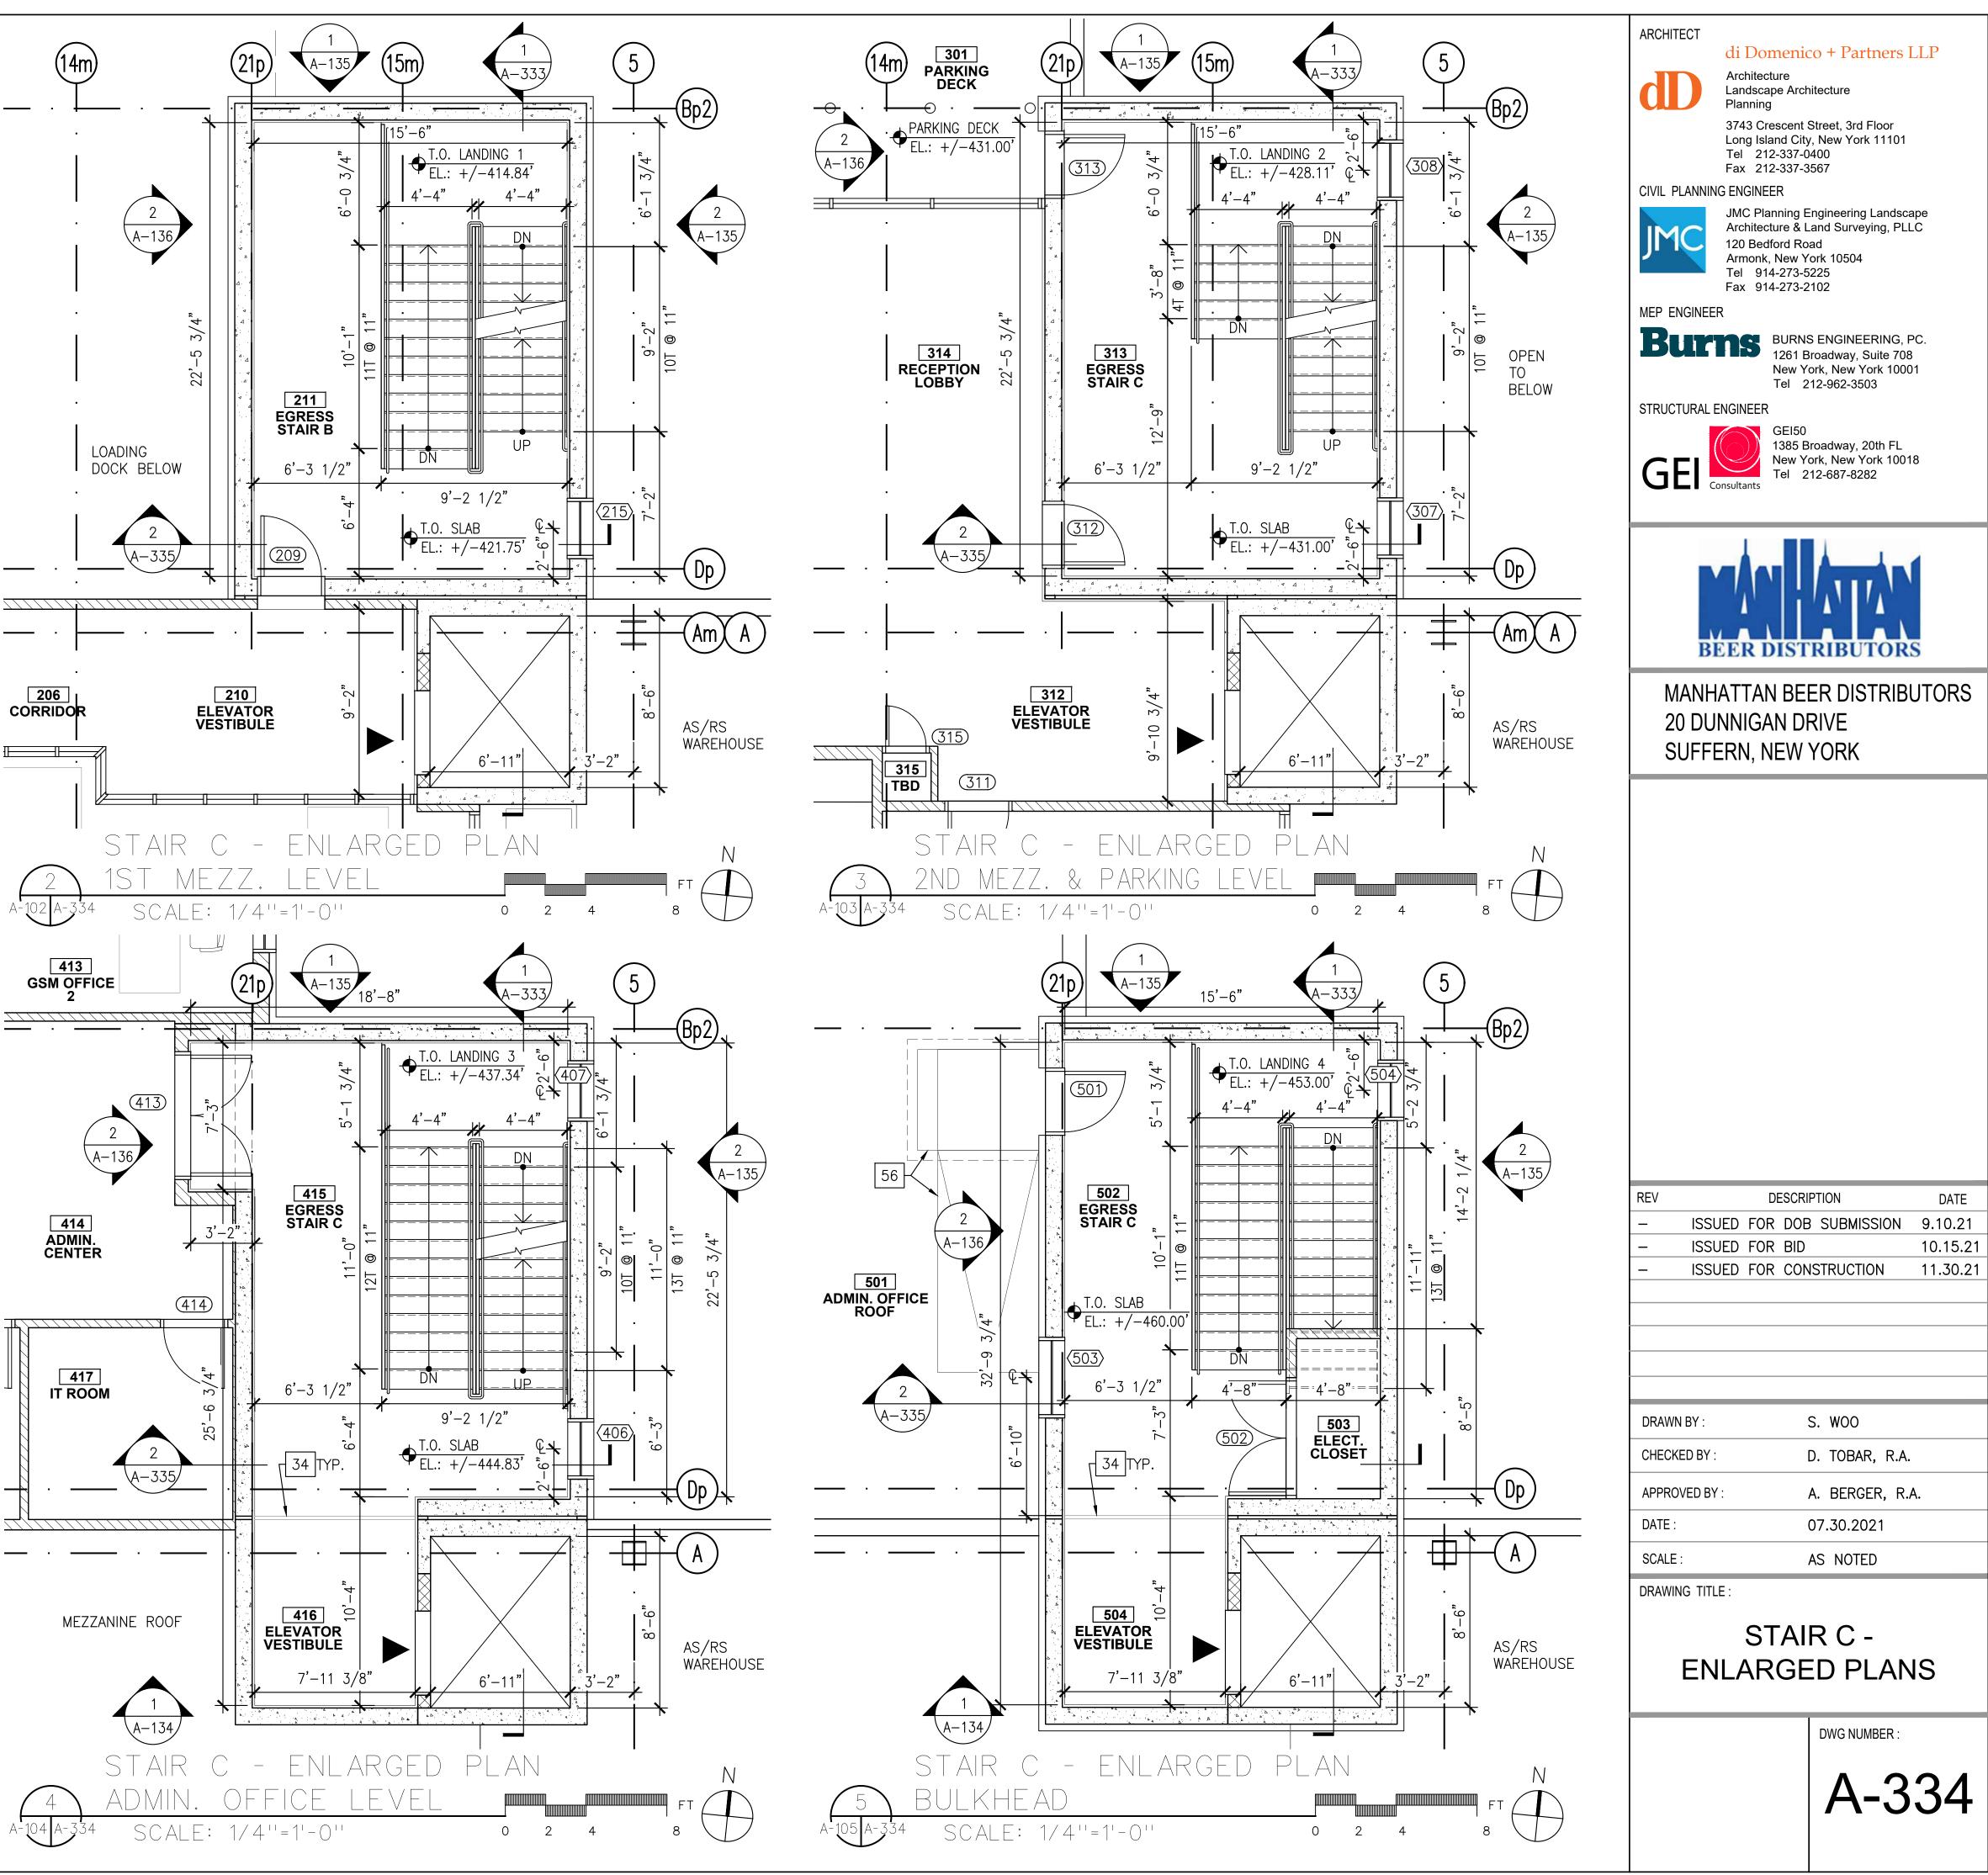5. SLOPE TREAD 1% MAXIMUM TO OUTSIDE EDGE (TYPICAL).

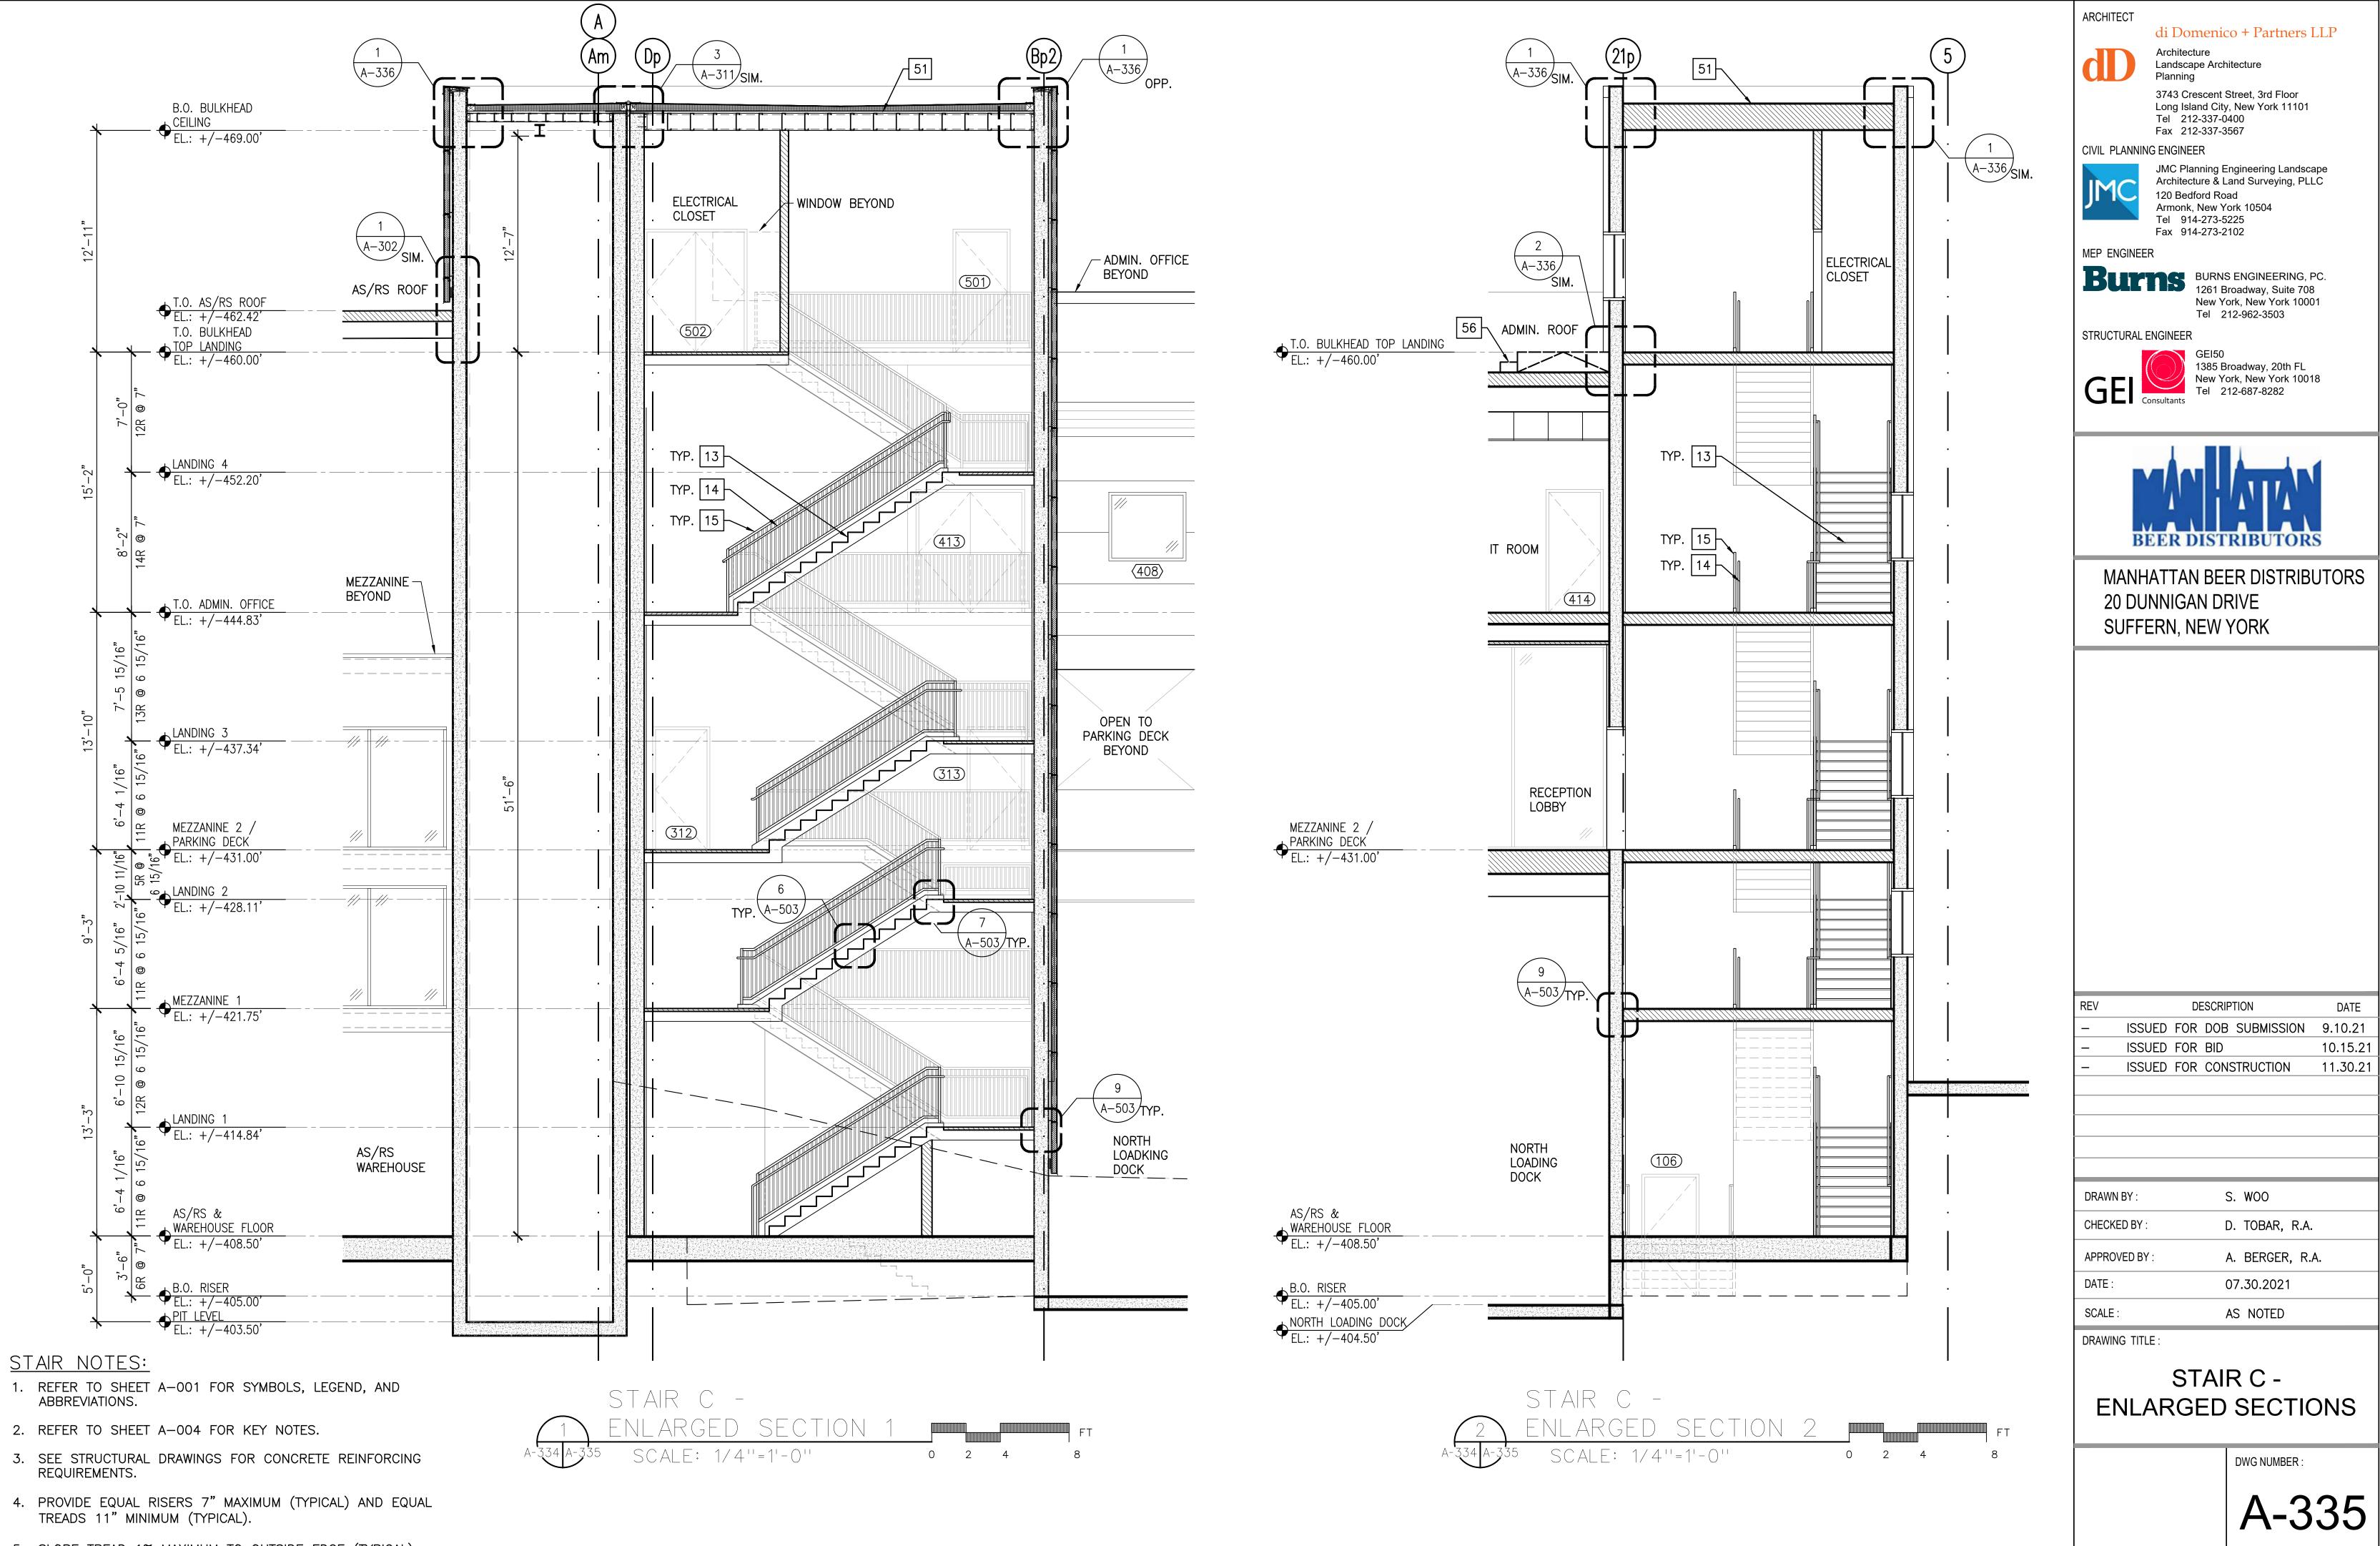

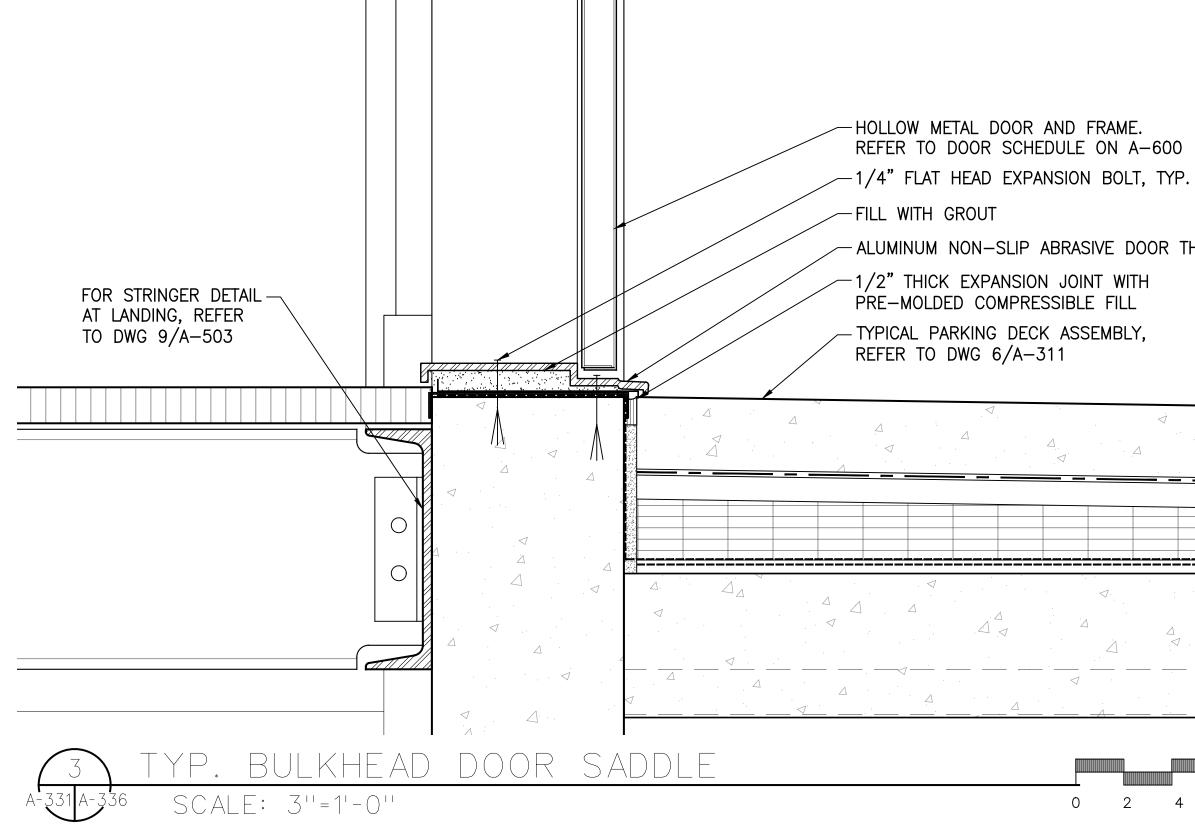



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DATE

New York, New York 10001 Tel 212-962-3503 GEI50 1385 Broadway, 20th FL GEI Consultants New York, New York Tel 212-687-8282 New York, New York 10018

20 DUNNIGAN DRIVE

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Long Island City, New York 11101



IMC

ARCHITECT

JMC Planning Engineering Landscape Architecture & Land Surveying, PLLC

di Domenico + Partners LLP

Architecture

Tel 212-337-0400

MEP ENGINEER





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ROOF DETAILS

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F9	F10	F8	F16	F17	F18				
10083 LBF	13448 LBF	11941 LBF	15910 LBF	3677 LBF	3677 LBF				
[44.9 KN]	[59.8 KN]	[53,1 KN]	[70.8 KN]	[16.4 KN]	[16.4 KN]				
1	NDN-SEISMI	C		SEISMIC					
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316 LBI	F 1	.54 LBF	696 LBI	- 3	348 LBF				
[1403 N		[685 N] [3095 N]			[1548 N]				
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STATIC RAIL LOADS FROM						
EQUIPMENT SUPPORTED						
F8	F16	F17	F18			
4481 LBF	7928 LBF	2259 LBF	2259 LBF			
[19,9 KN]	[35.3 KN]	[10.0 KN]	[10.0 KN]			
		· · · · · · · · · · · · · · · · · · ·				

754 LBF

[3351 N]


377 LBF

[1675 N]

7 LBF


[31 N]

NOTE: F9 & F10 Do not occur simultaneously with F8 & F16

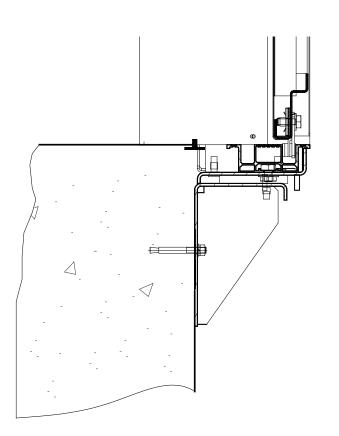

33 LBF


[146 N]

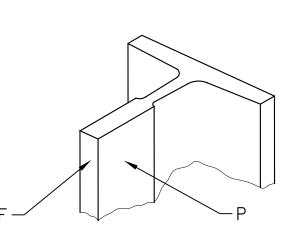

RAIL LOAD DIAGRAM


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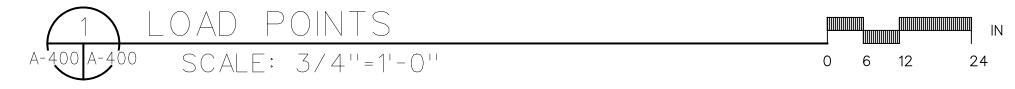
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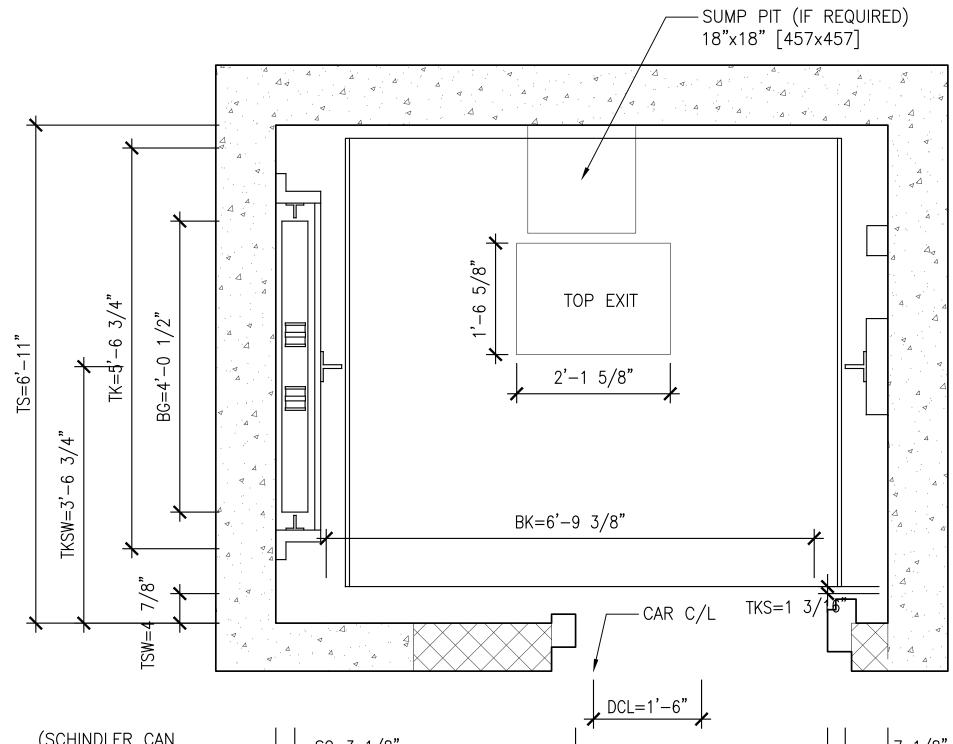


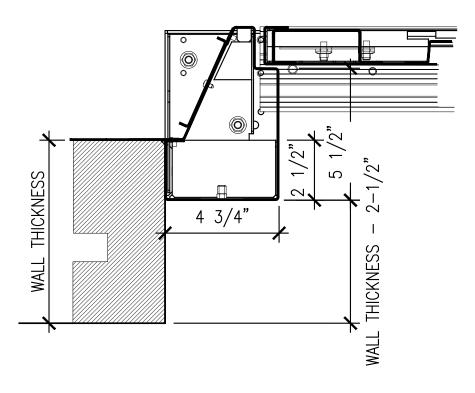



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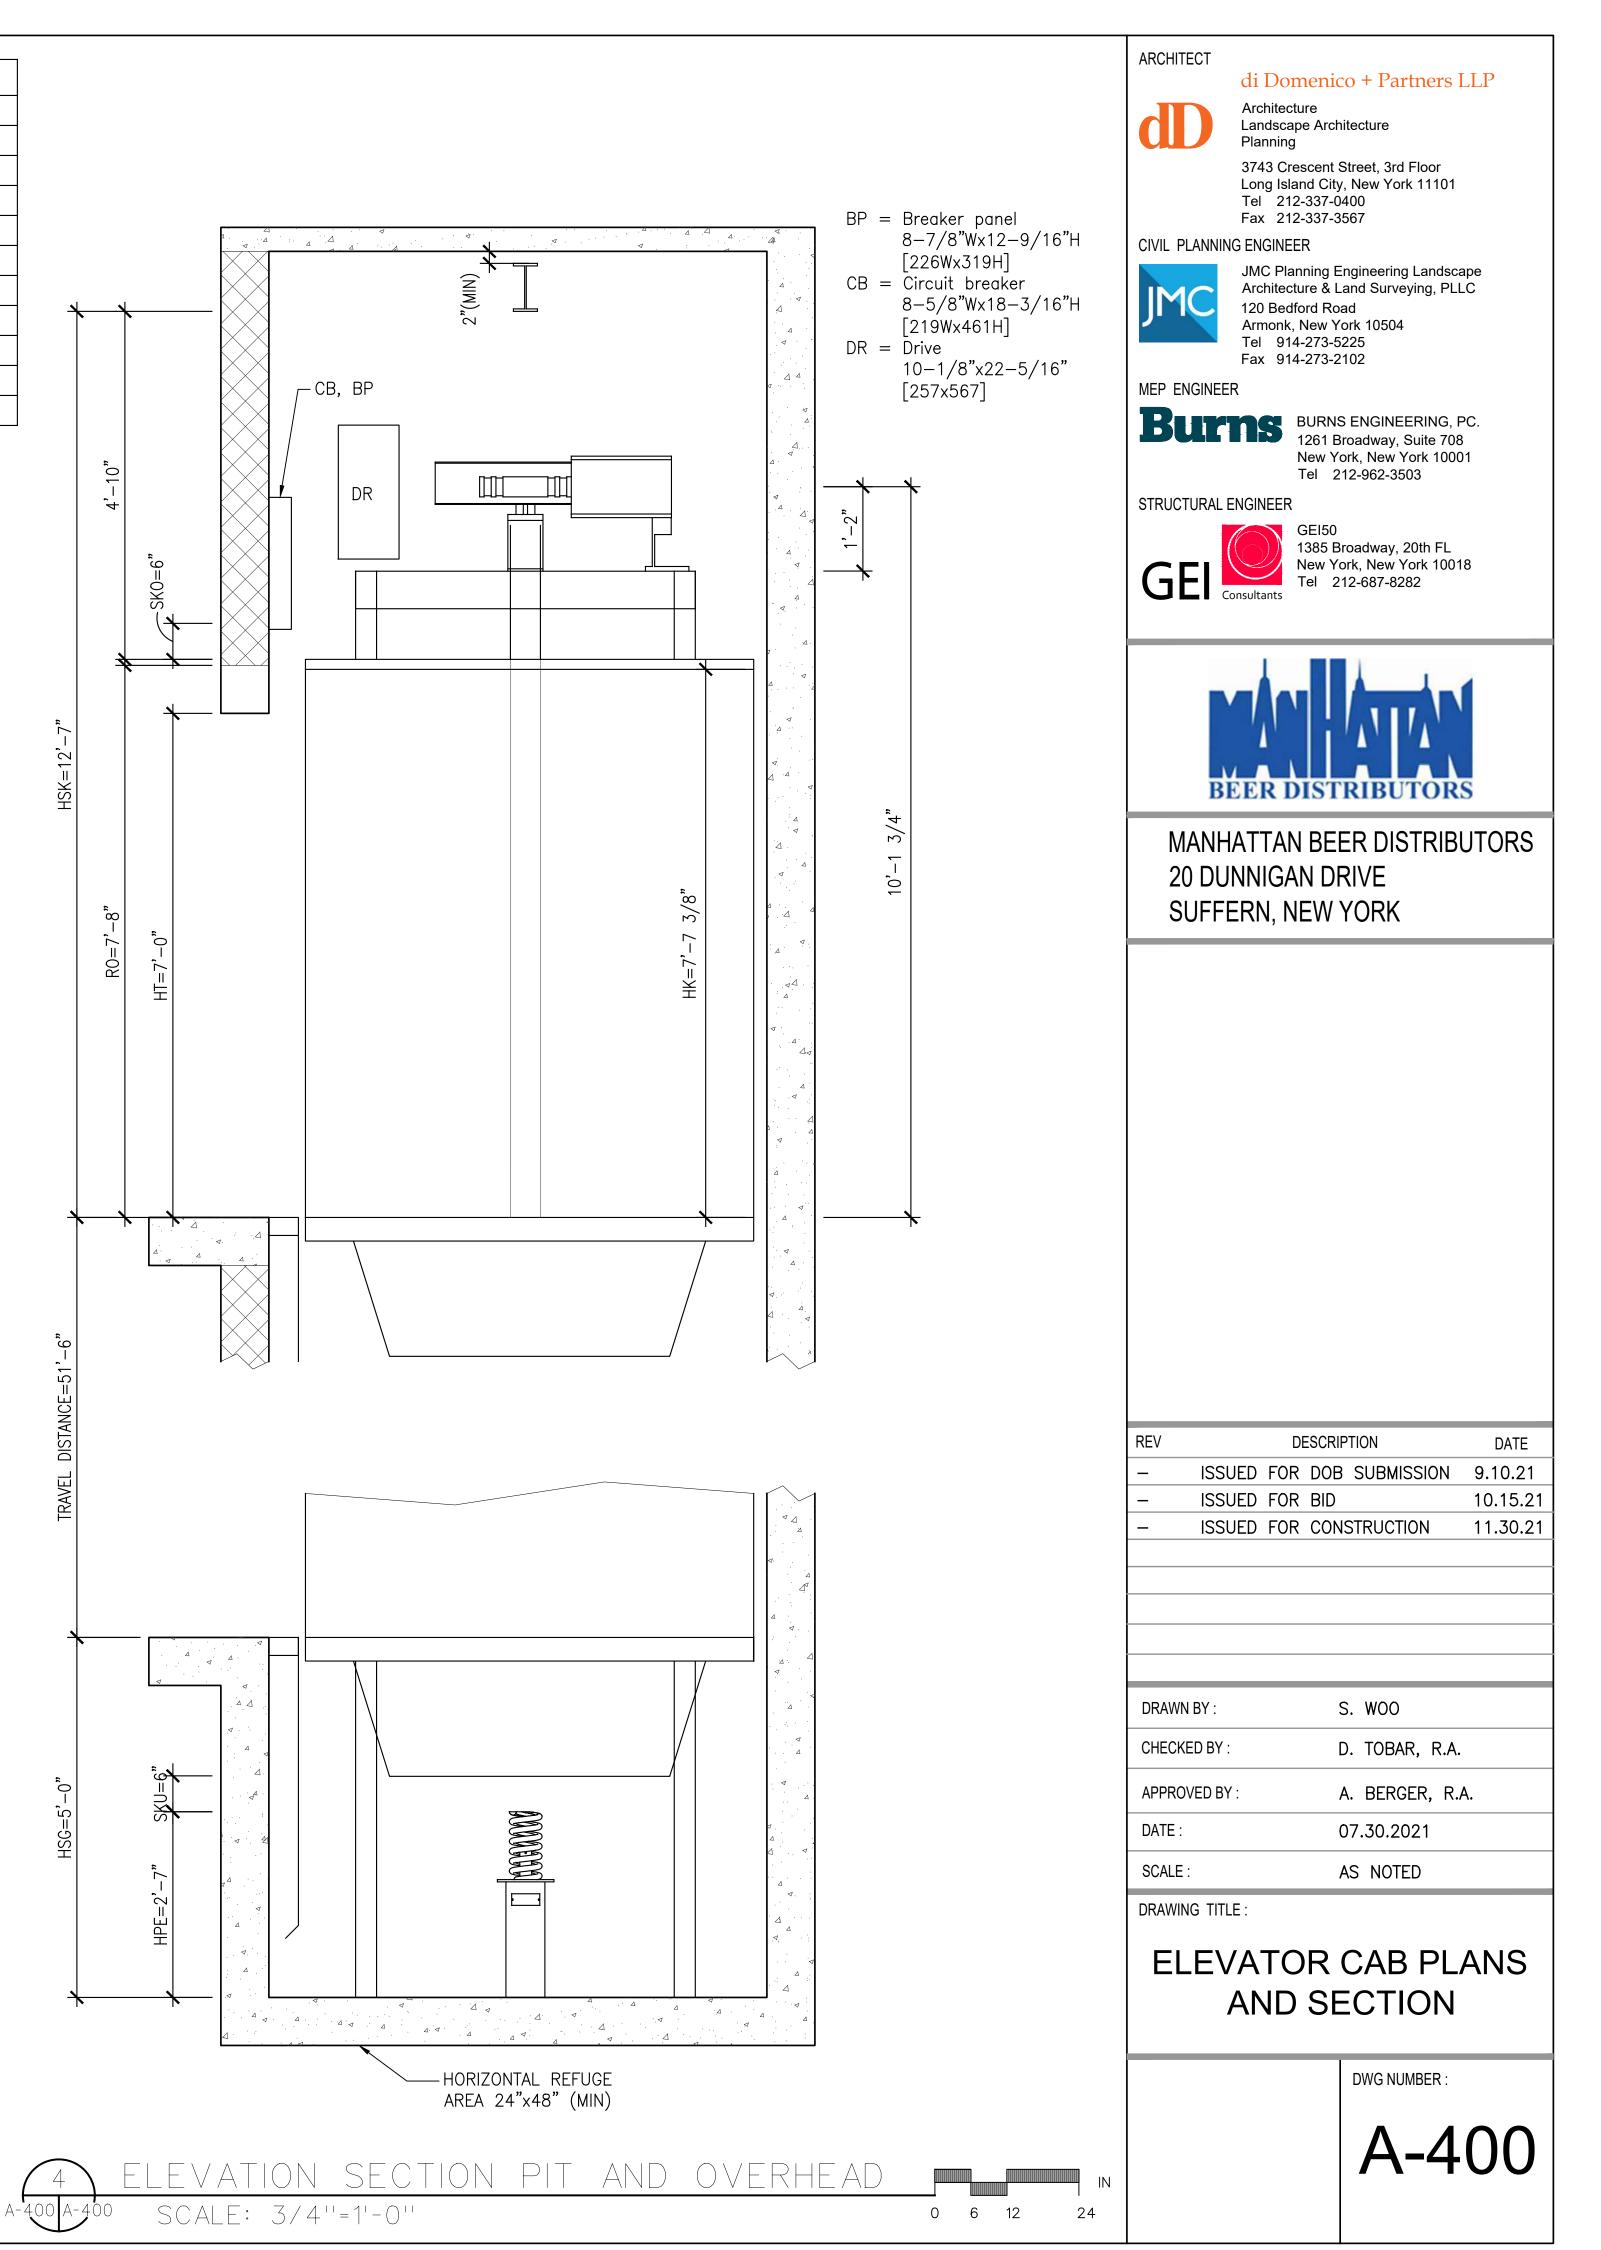








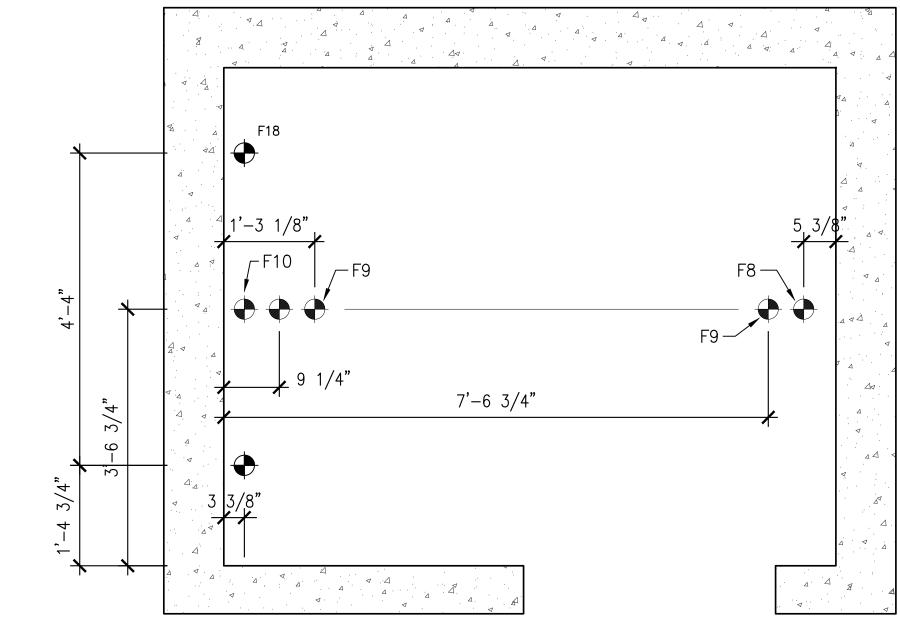


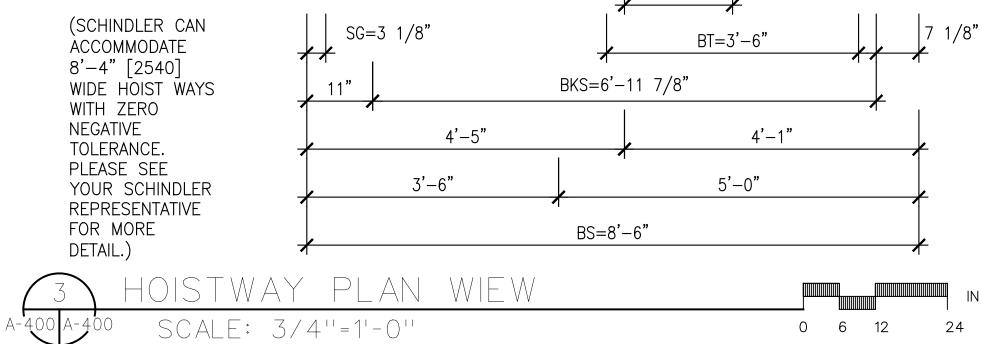

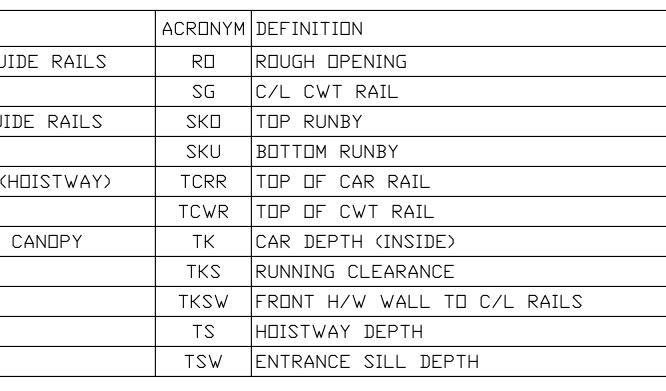


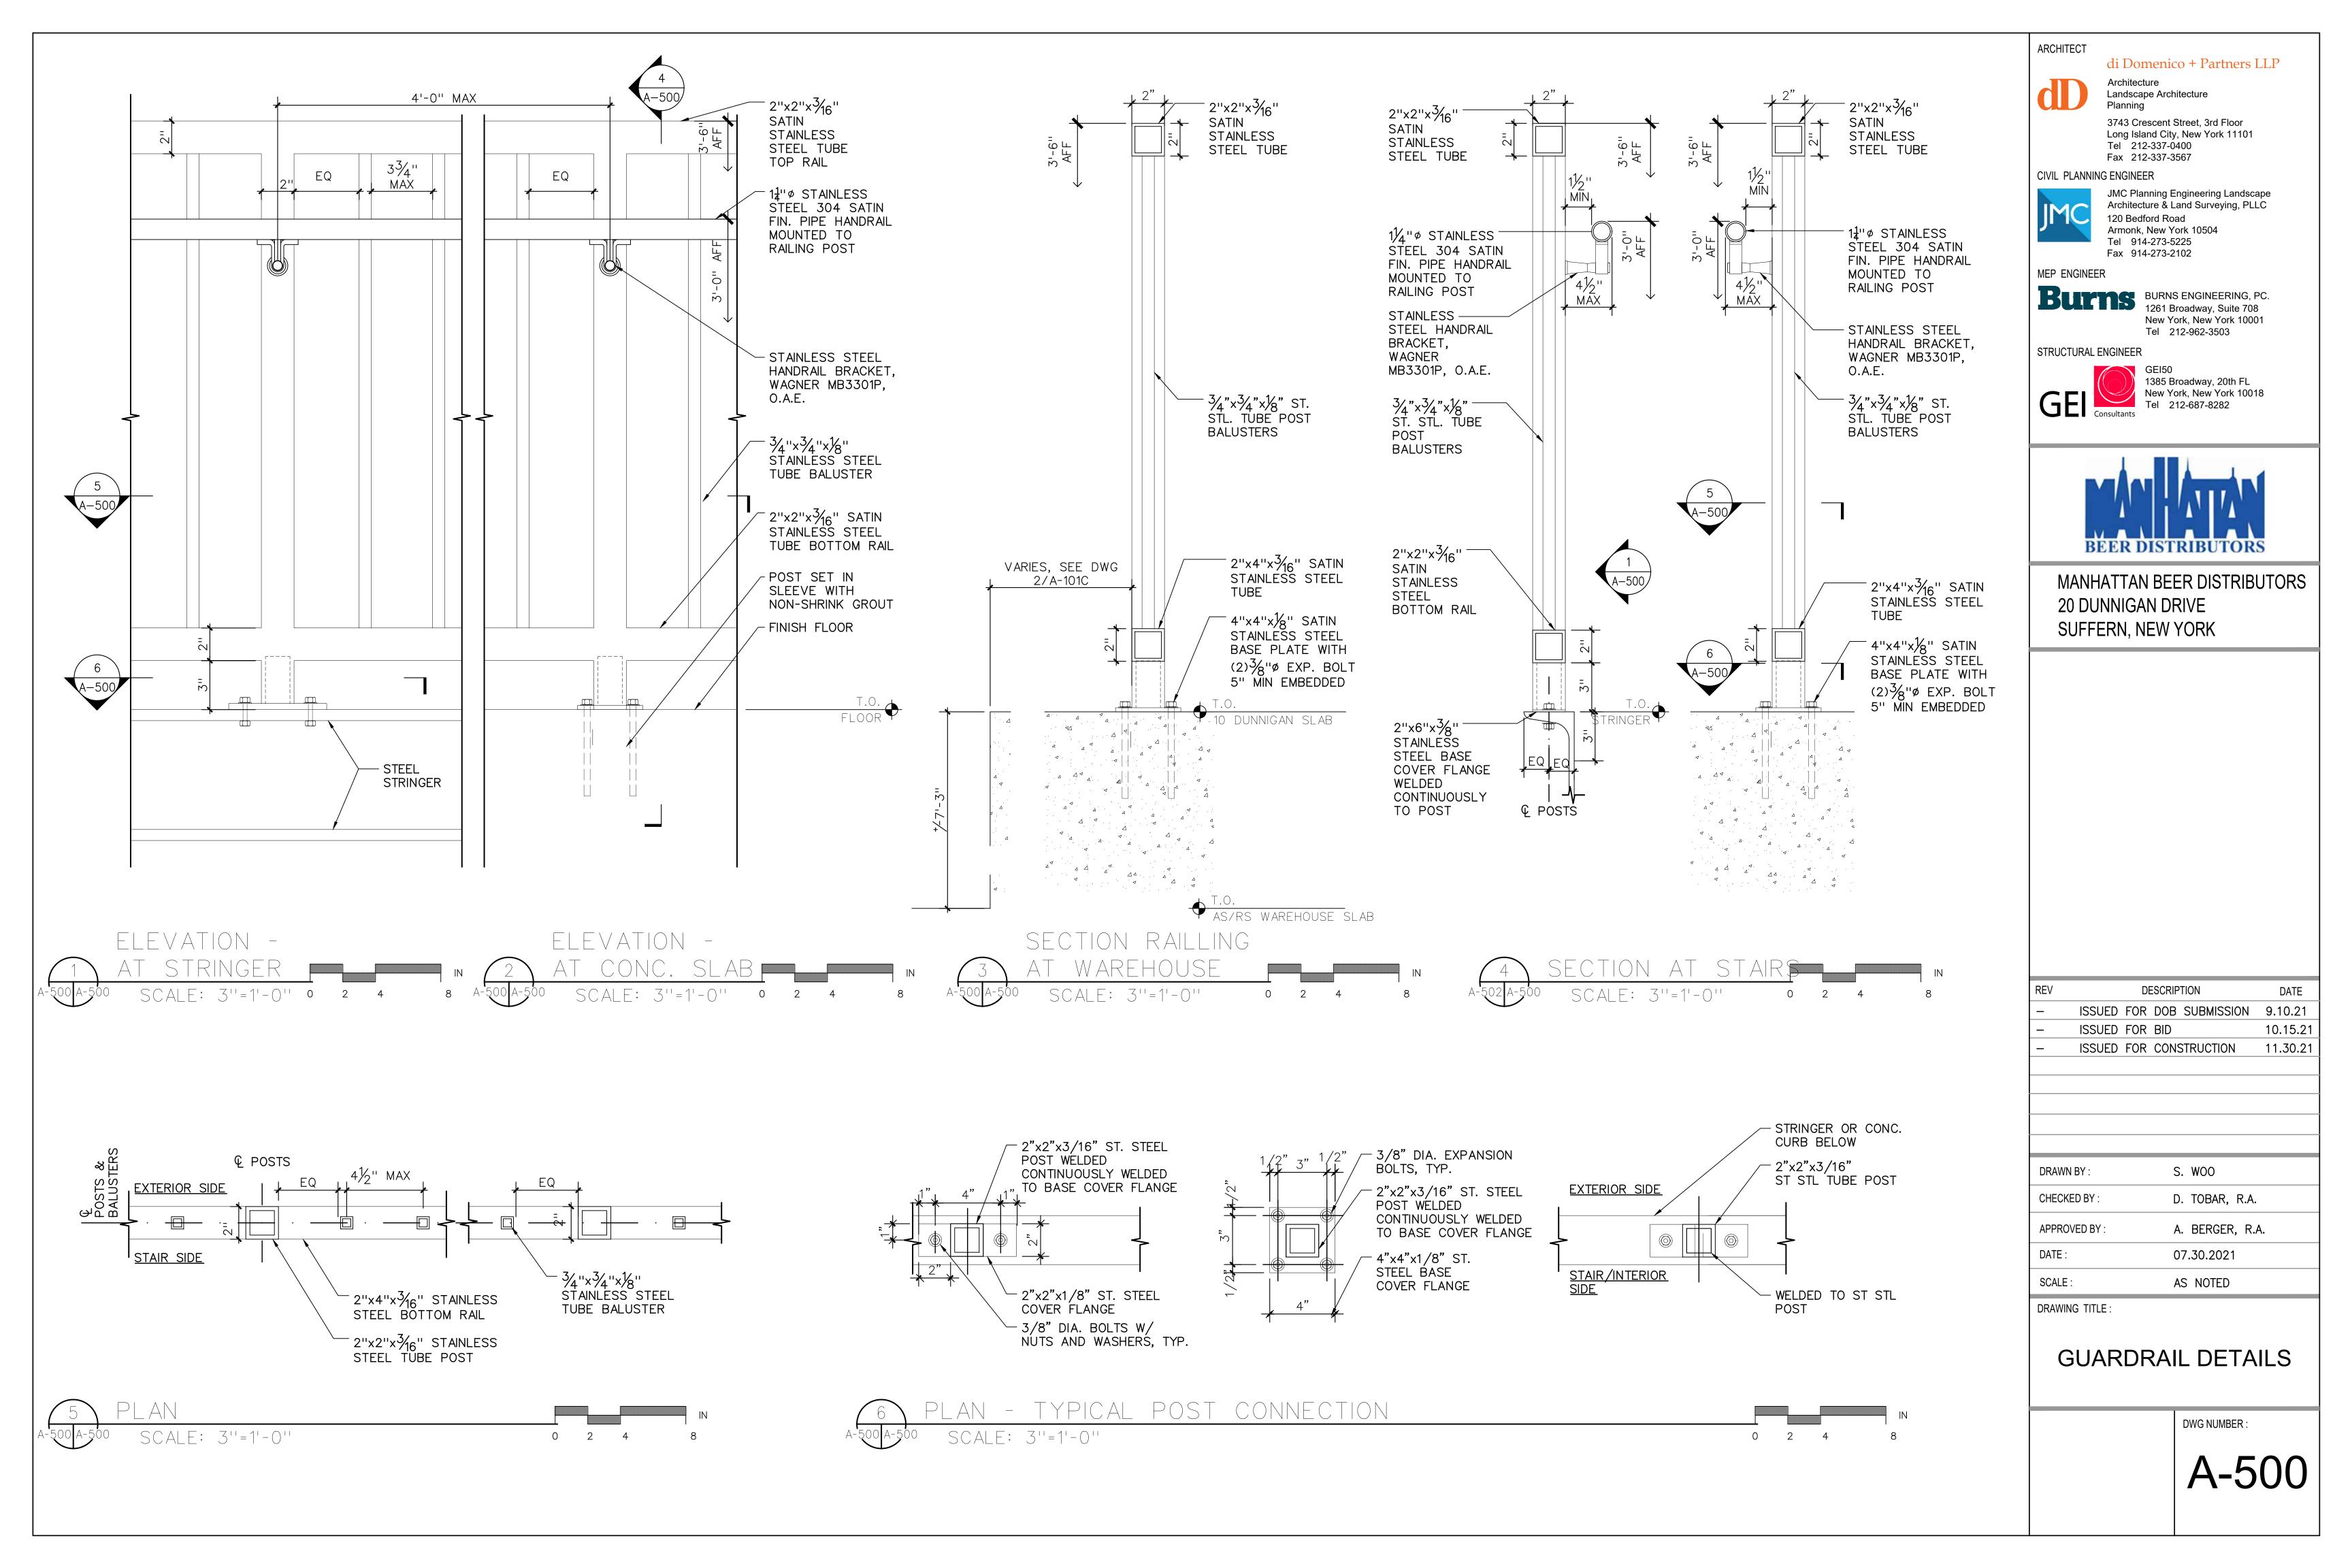


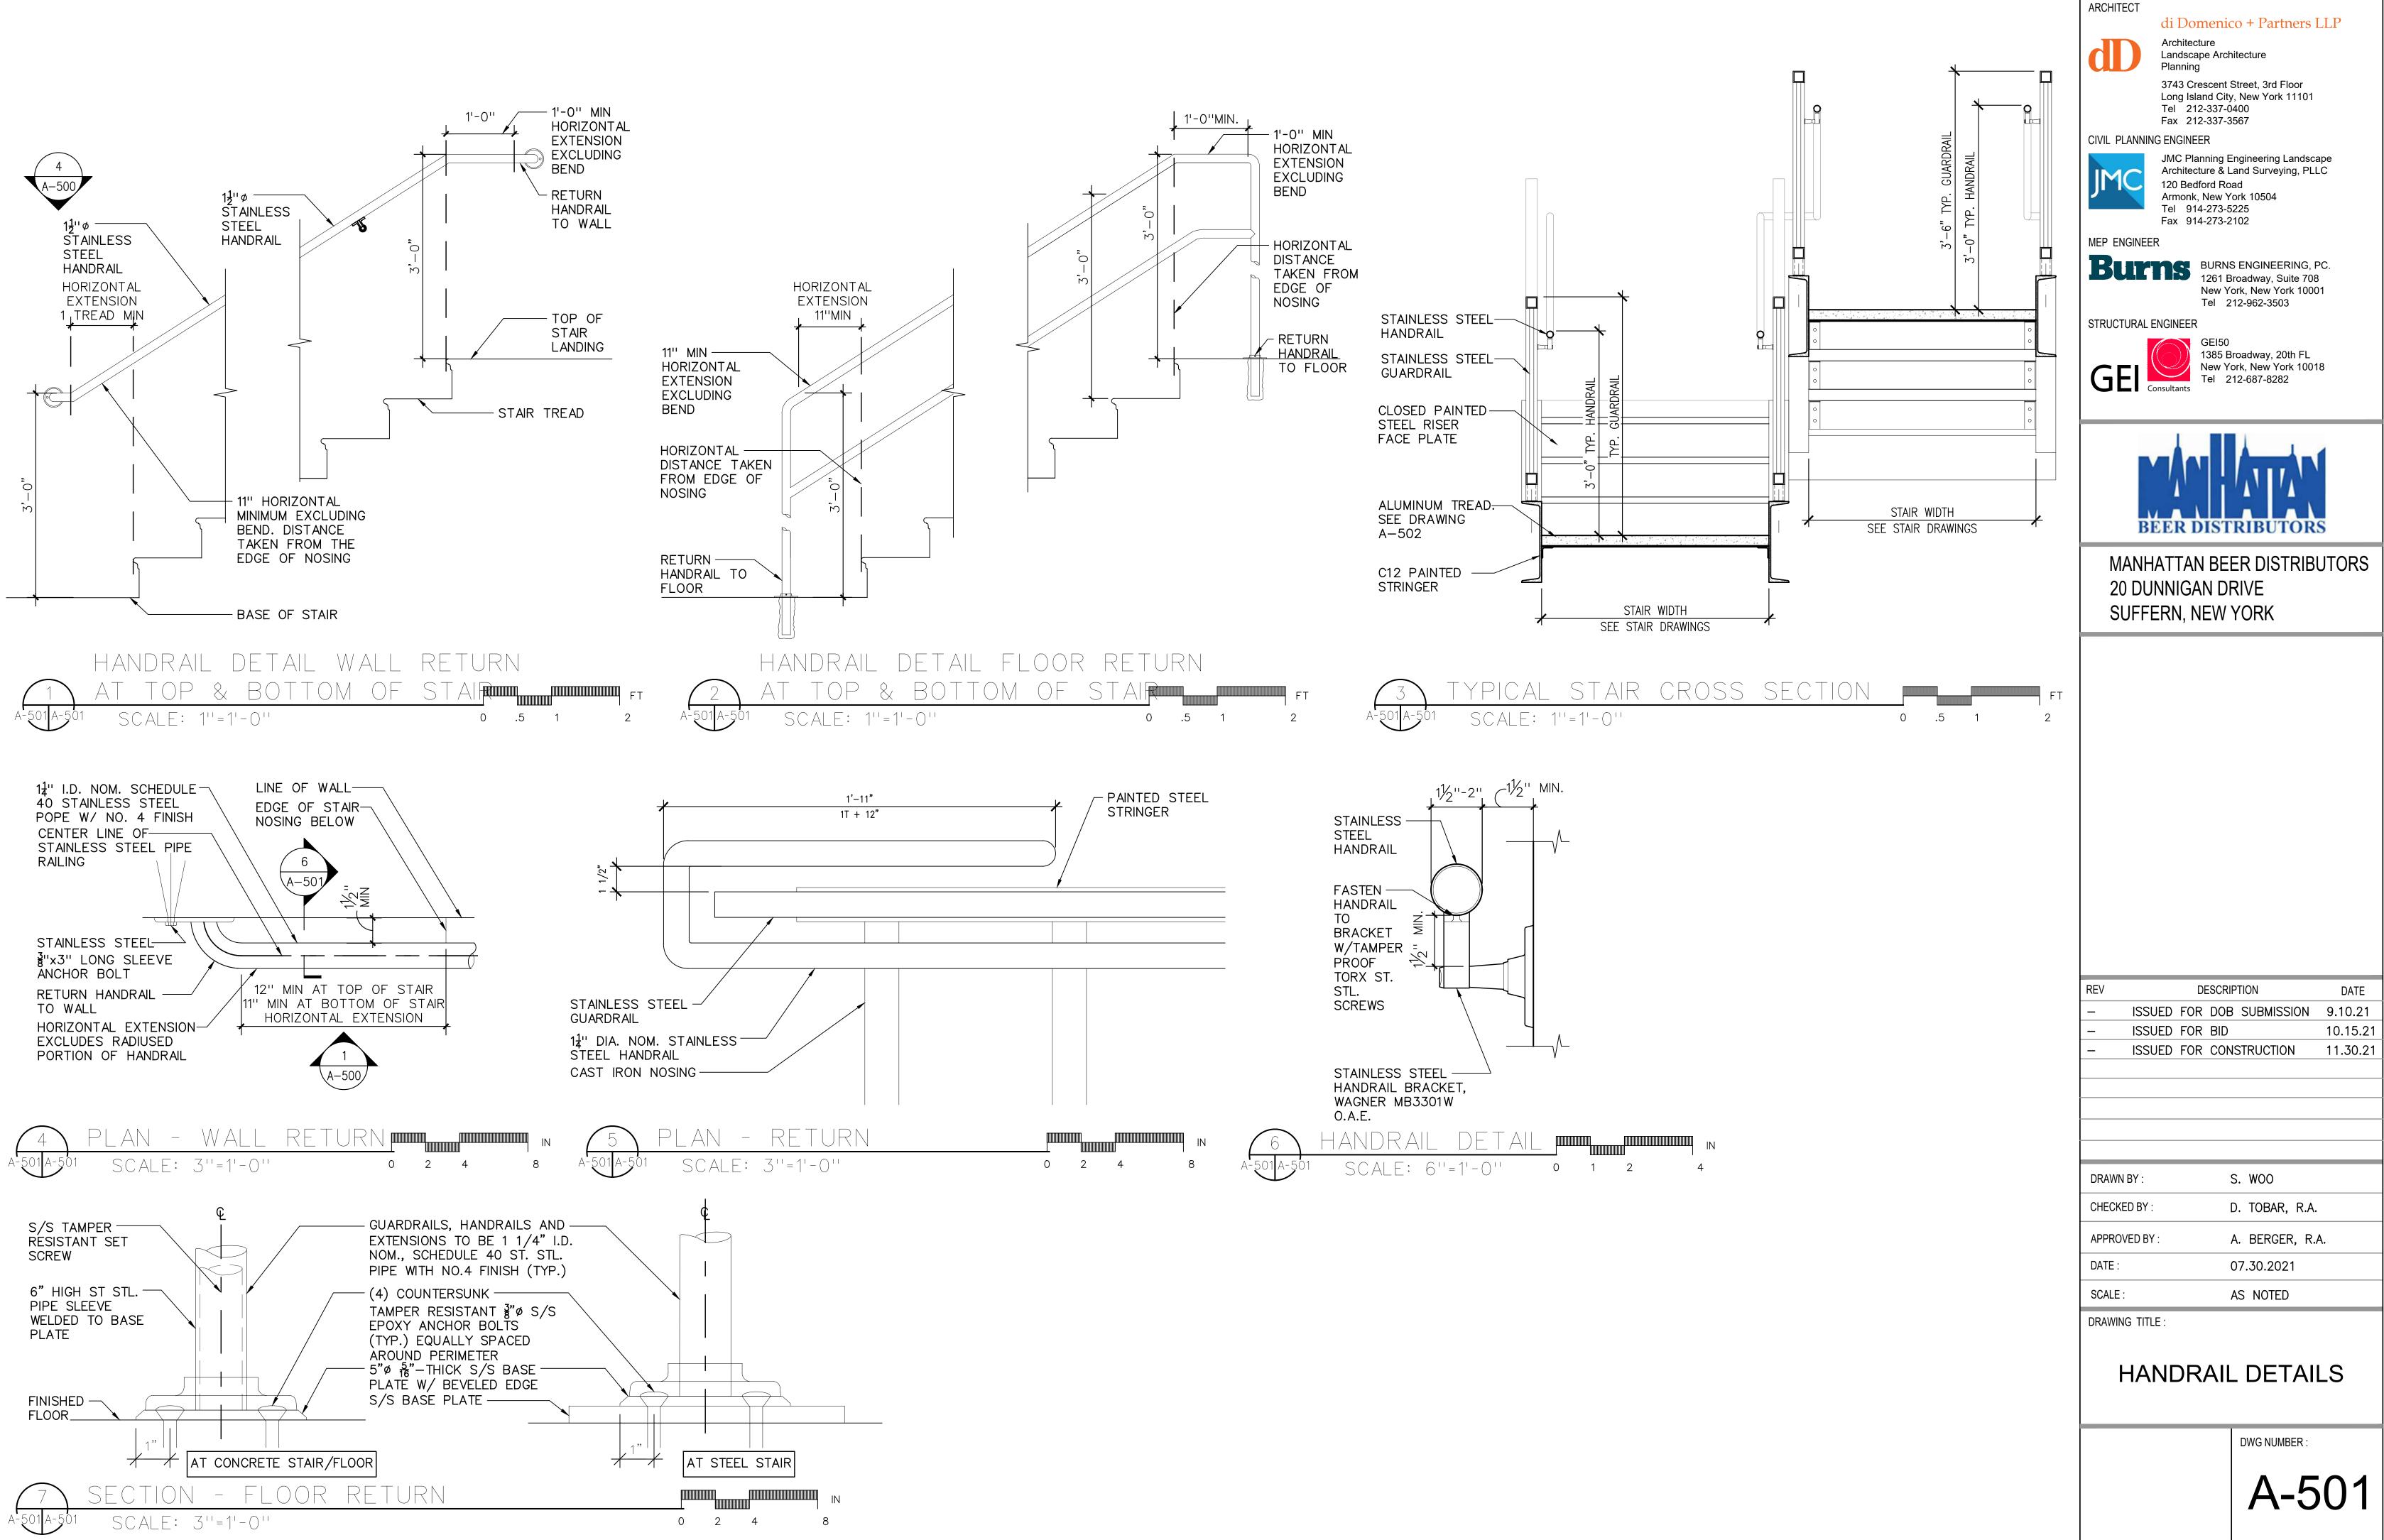


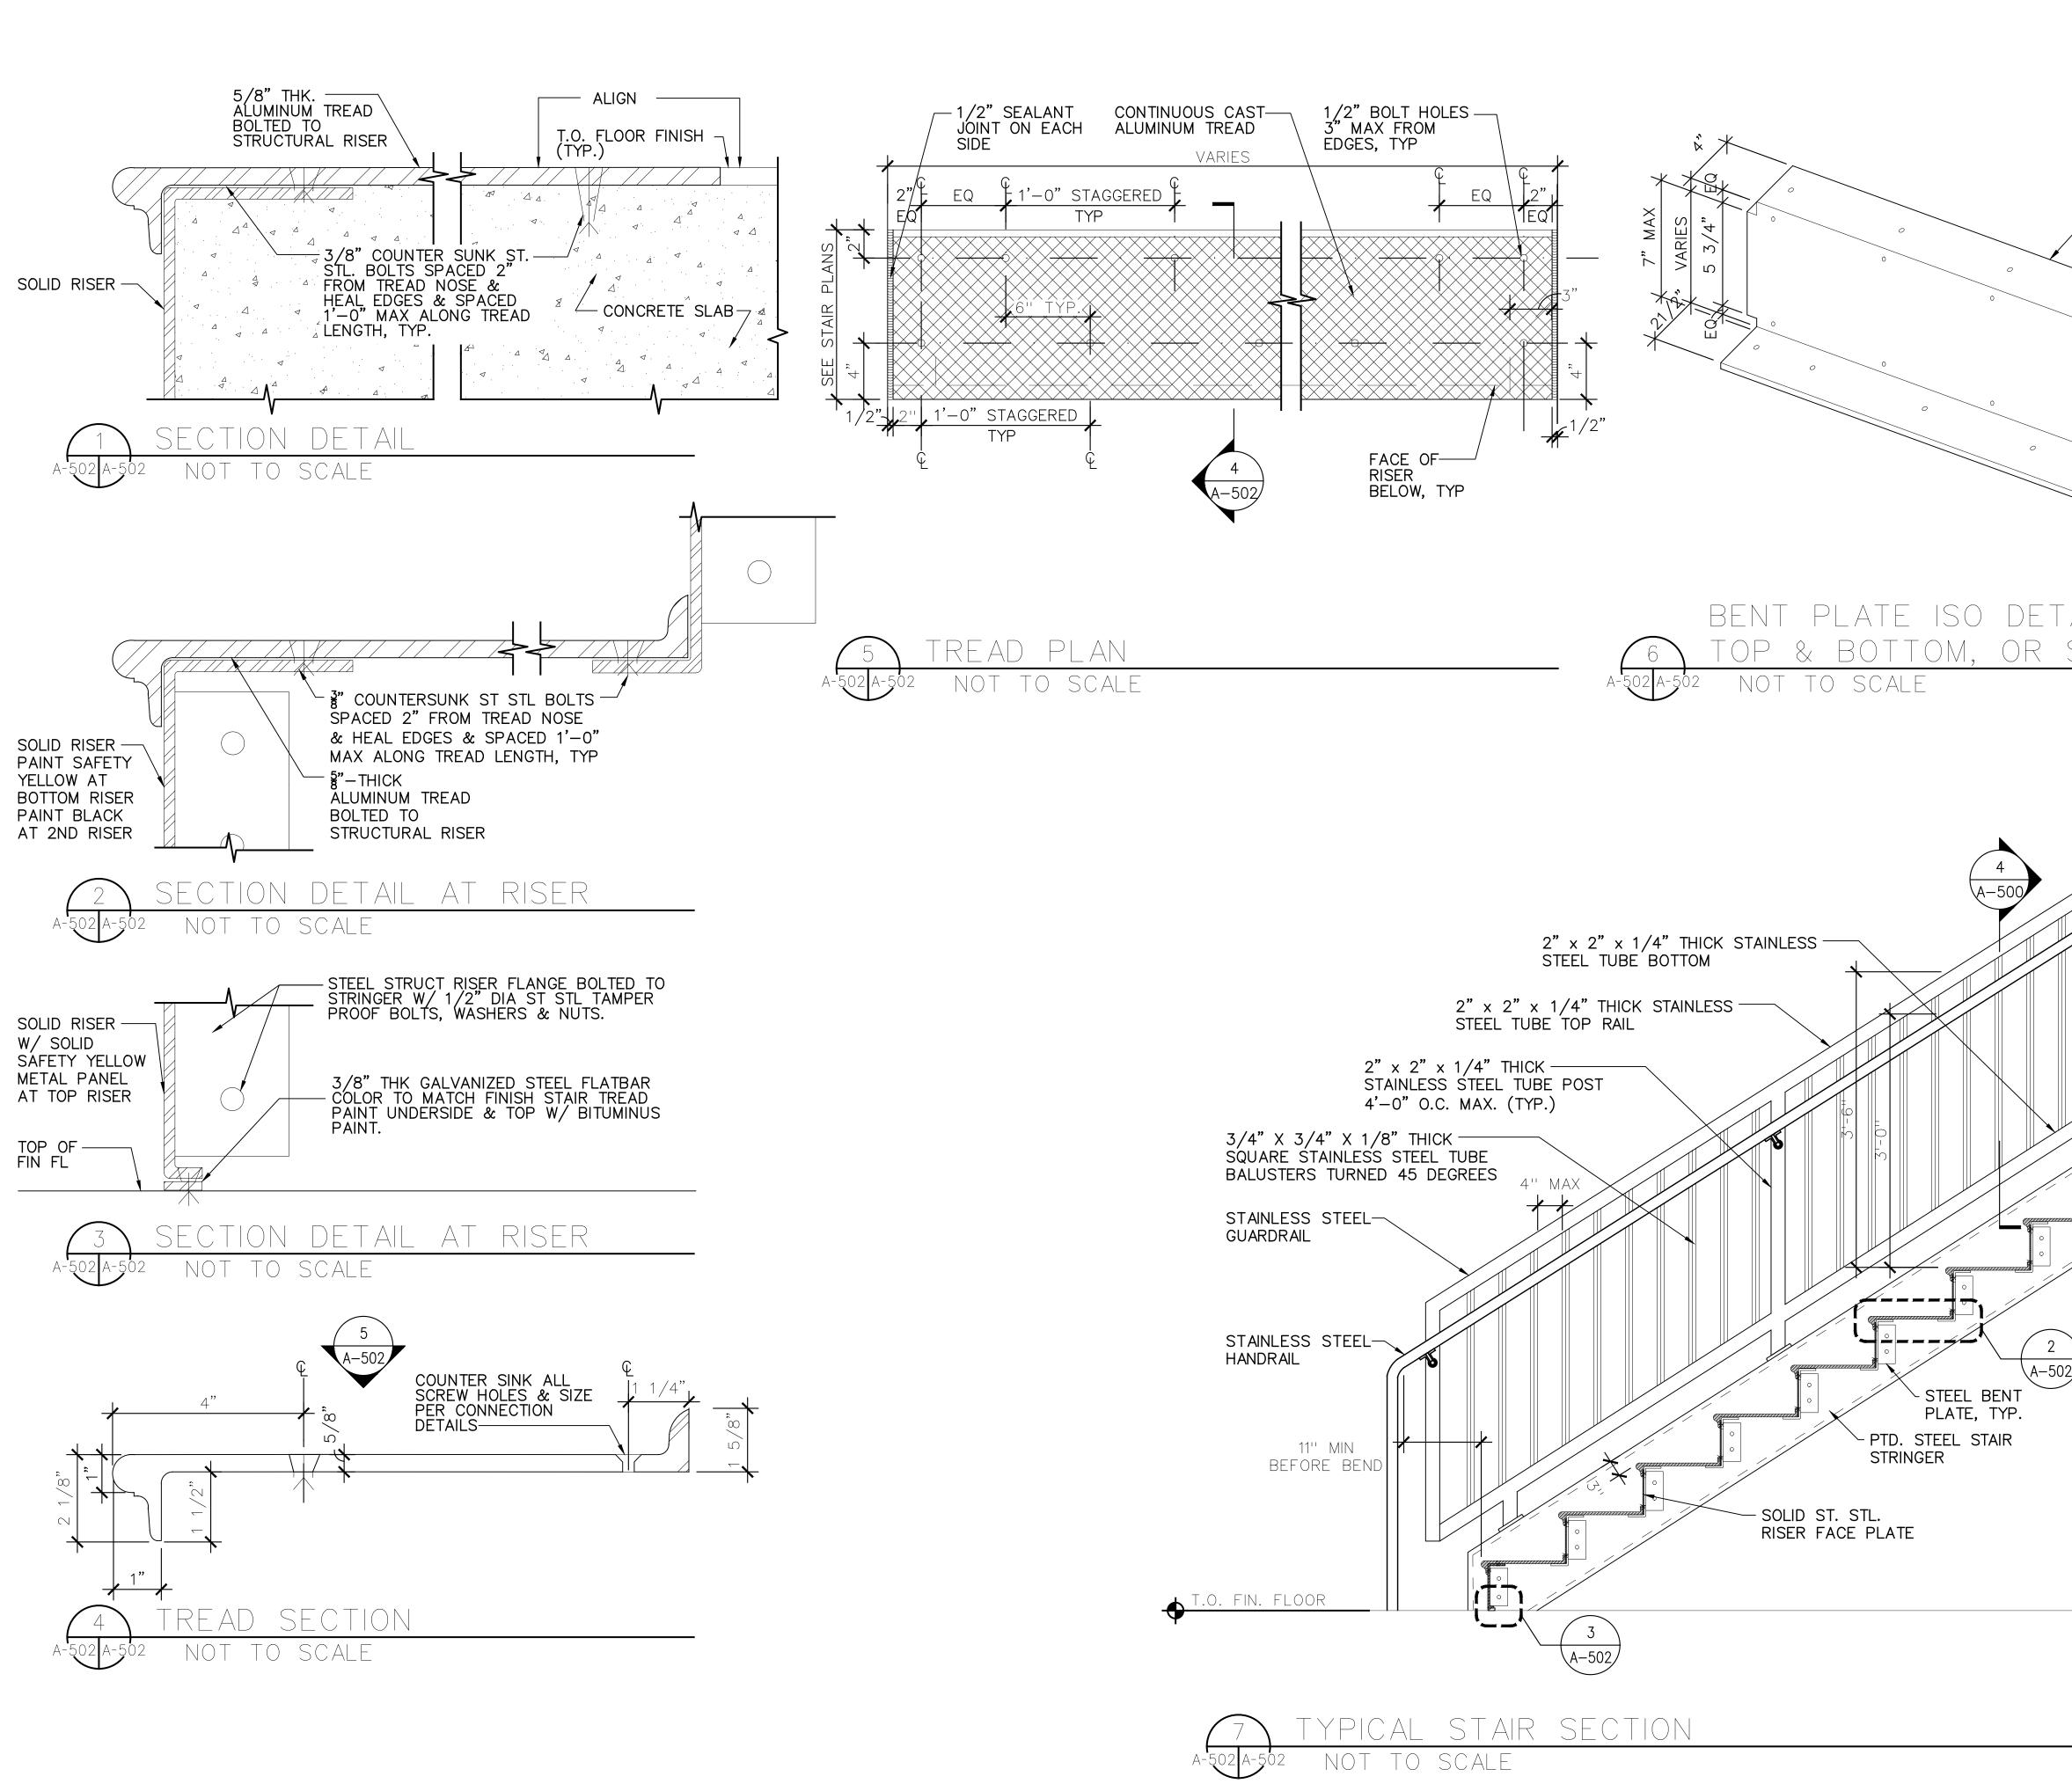

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	REVDESCRIPTIONDATE-ISSUED FOR DOB SUBMISSION9.10.21-ISSUED FOR BID10.15.21-ISSUED FOR CONSTRUCTION11.30.21
2)	DRAWN BY : S. WOO
	CHECKED BY : D. TOBAR, R.A.
	APPROVED BY : A. BERGER, R.A.
	DATE : 07.30.2021
	SCALE: AS NOTED
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	TYPICAL STAIR DETAILS
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3743 Crescent Street, 3rd Floor Long Island City, New York 11101 Tel 212-337-0400 Fax 212-337-3567 CIVIL PLANNING ENGINEER JMC Planning Engineering Landscape IMC Architecture & Land Surveying, PLLC 120 Bedford Road Armonk, New York 10504 Tel 914-273-5225 Fax 914-273-2102 MEP ENGINEER BURNS ENGINEERING, PC. 1261 Broadway, Suite 708 New York, New York 10001 Tel 212-962-3503 STRUCTURAL ENGINEER GEI50 1385 Broadway, 20th FL New York, New York 10018 GEI Consultants Tel 212-687-8282 BEER DISTRIBUTORS MANHATTAN BEER DISTRIBUTORS 20 DUNNIGAN DRIVE SUFFERN, NEW YORK DESCRIPTION REV DATE ISSUED FOR DOB SUBMISSION 9.10.21 ISSUED FOR BID 10.15.21 ISSUED FOR CONSTRUCTION 11.30.21 S. WOO DRAWN BY : CHECKED BY : D. TOBAR, R.A. A. BERGER, R.A. APPROVED BY : 07.30.2021 DATE : AS NOTED SCALE : DRAWING TITLE :
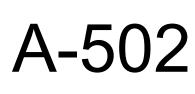
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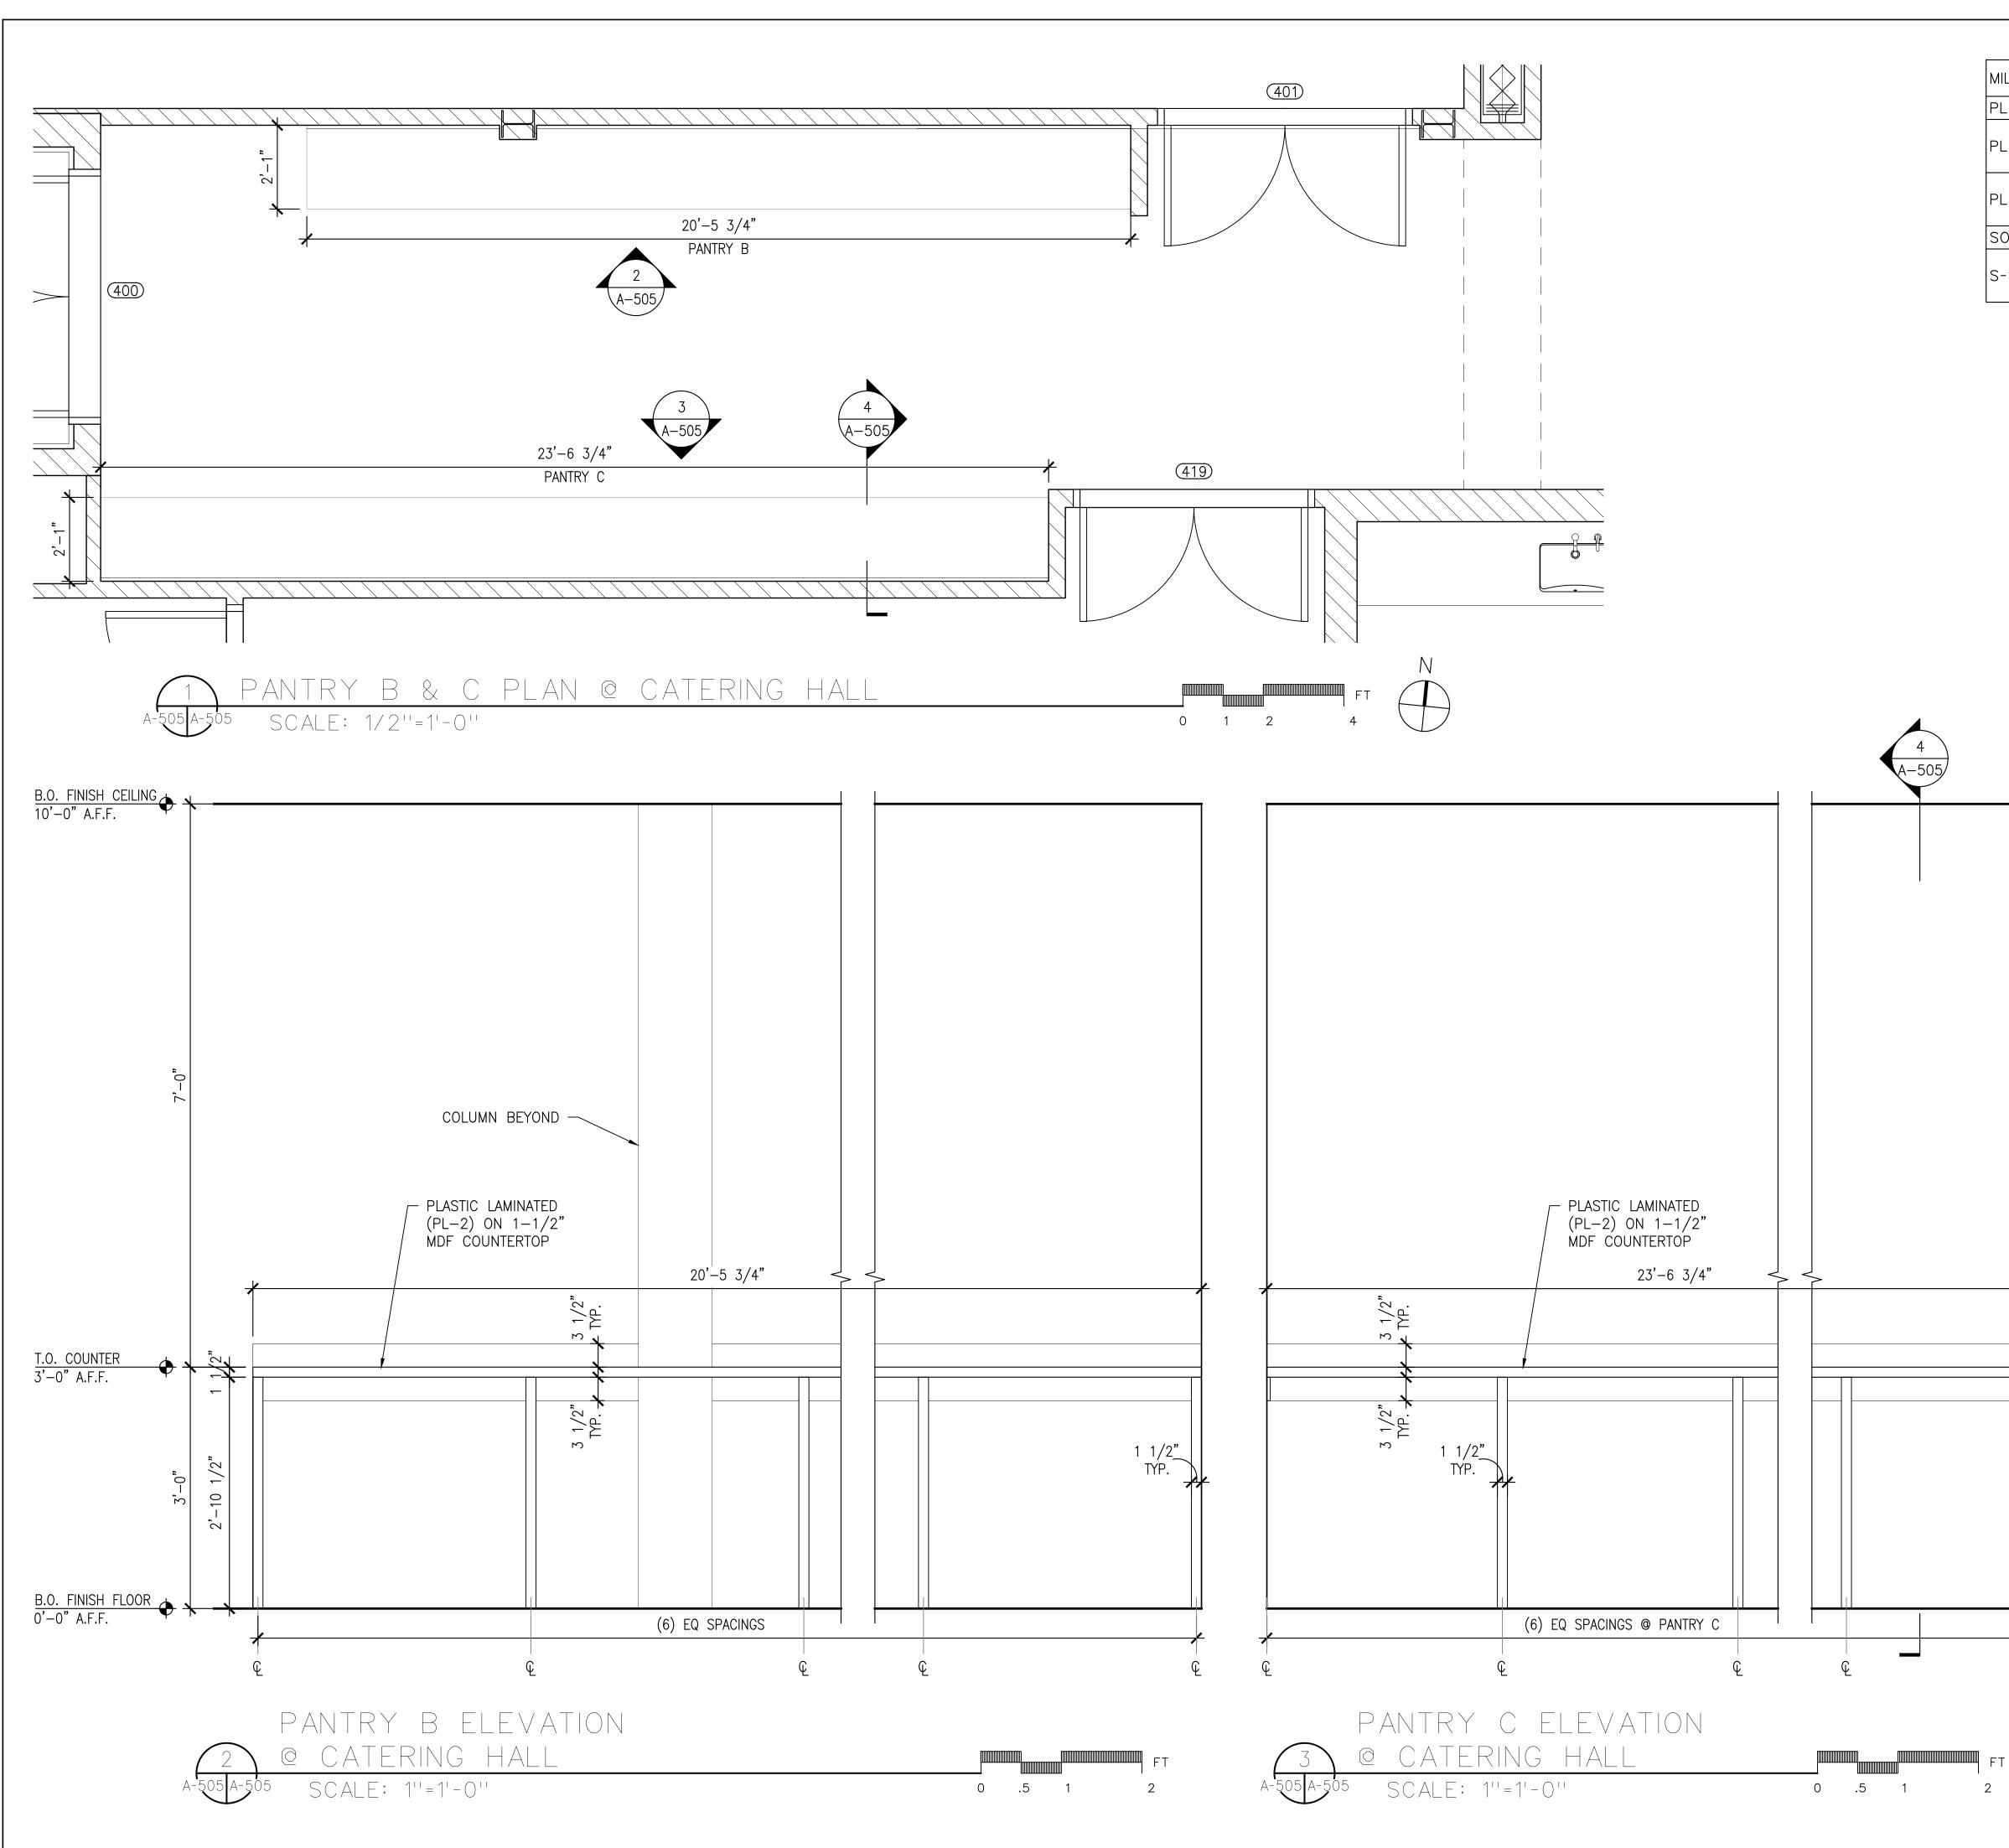
Architecture
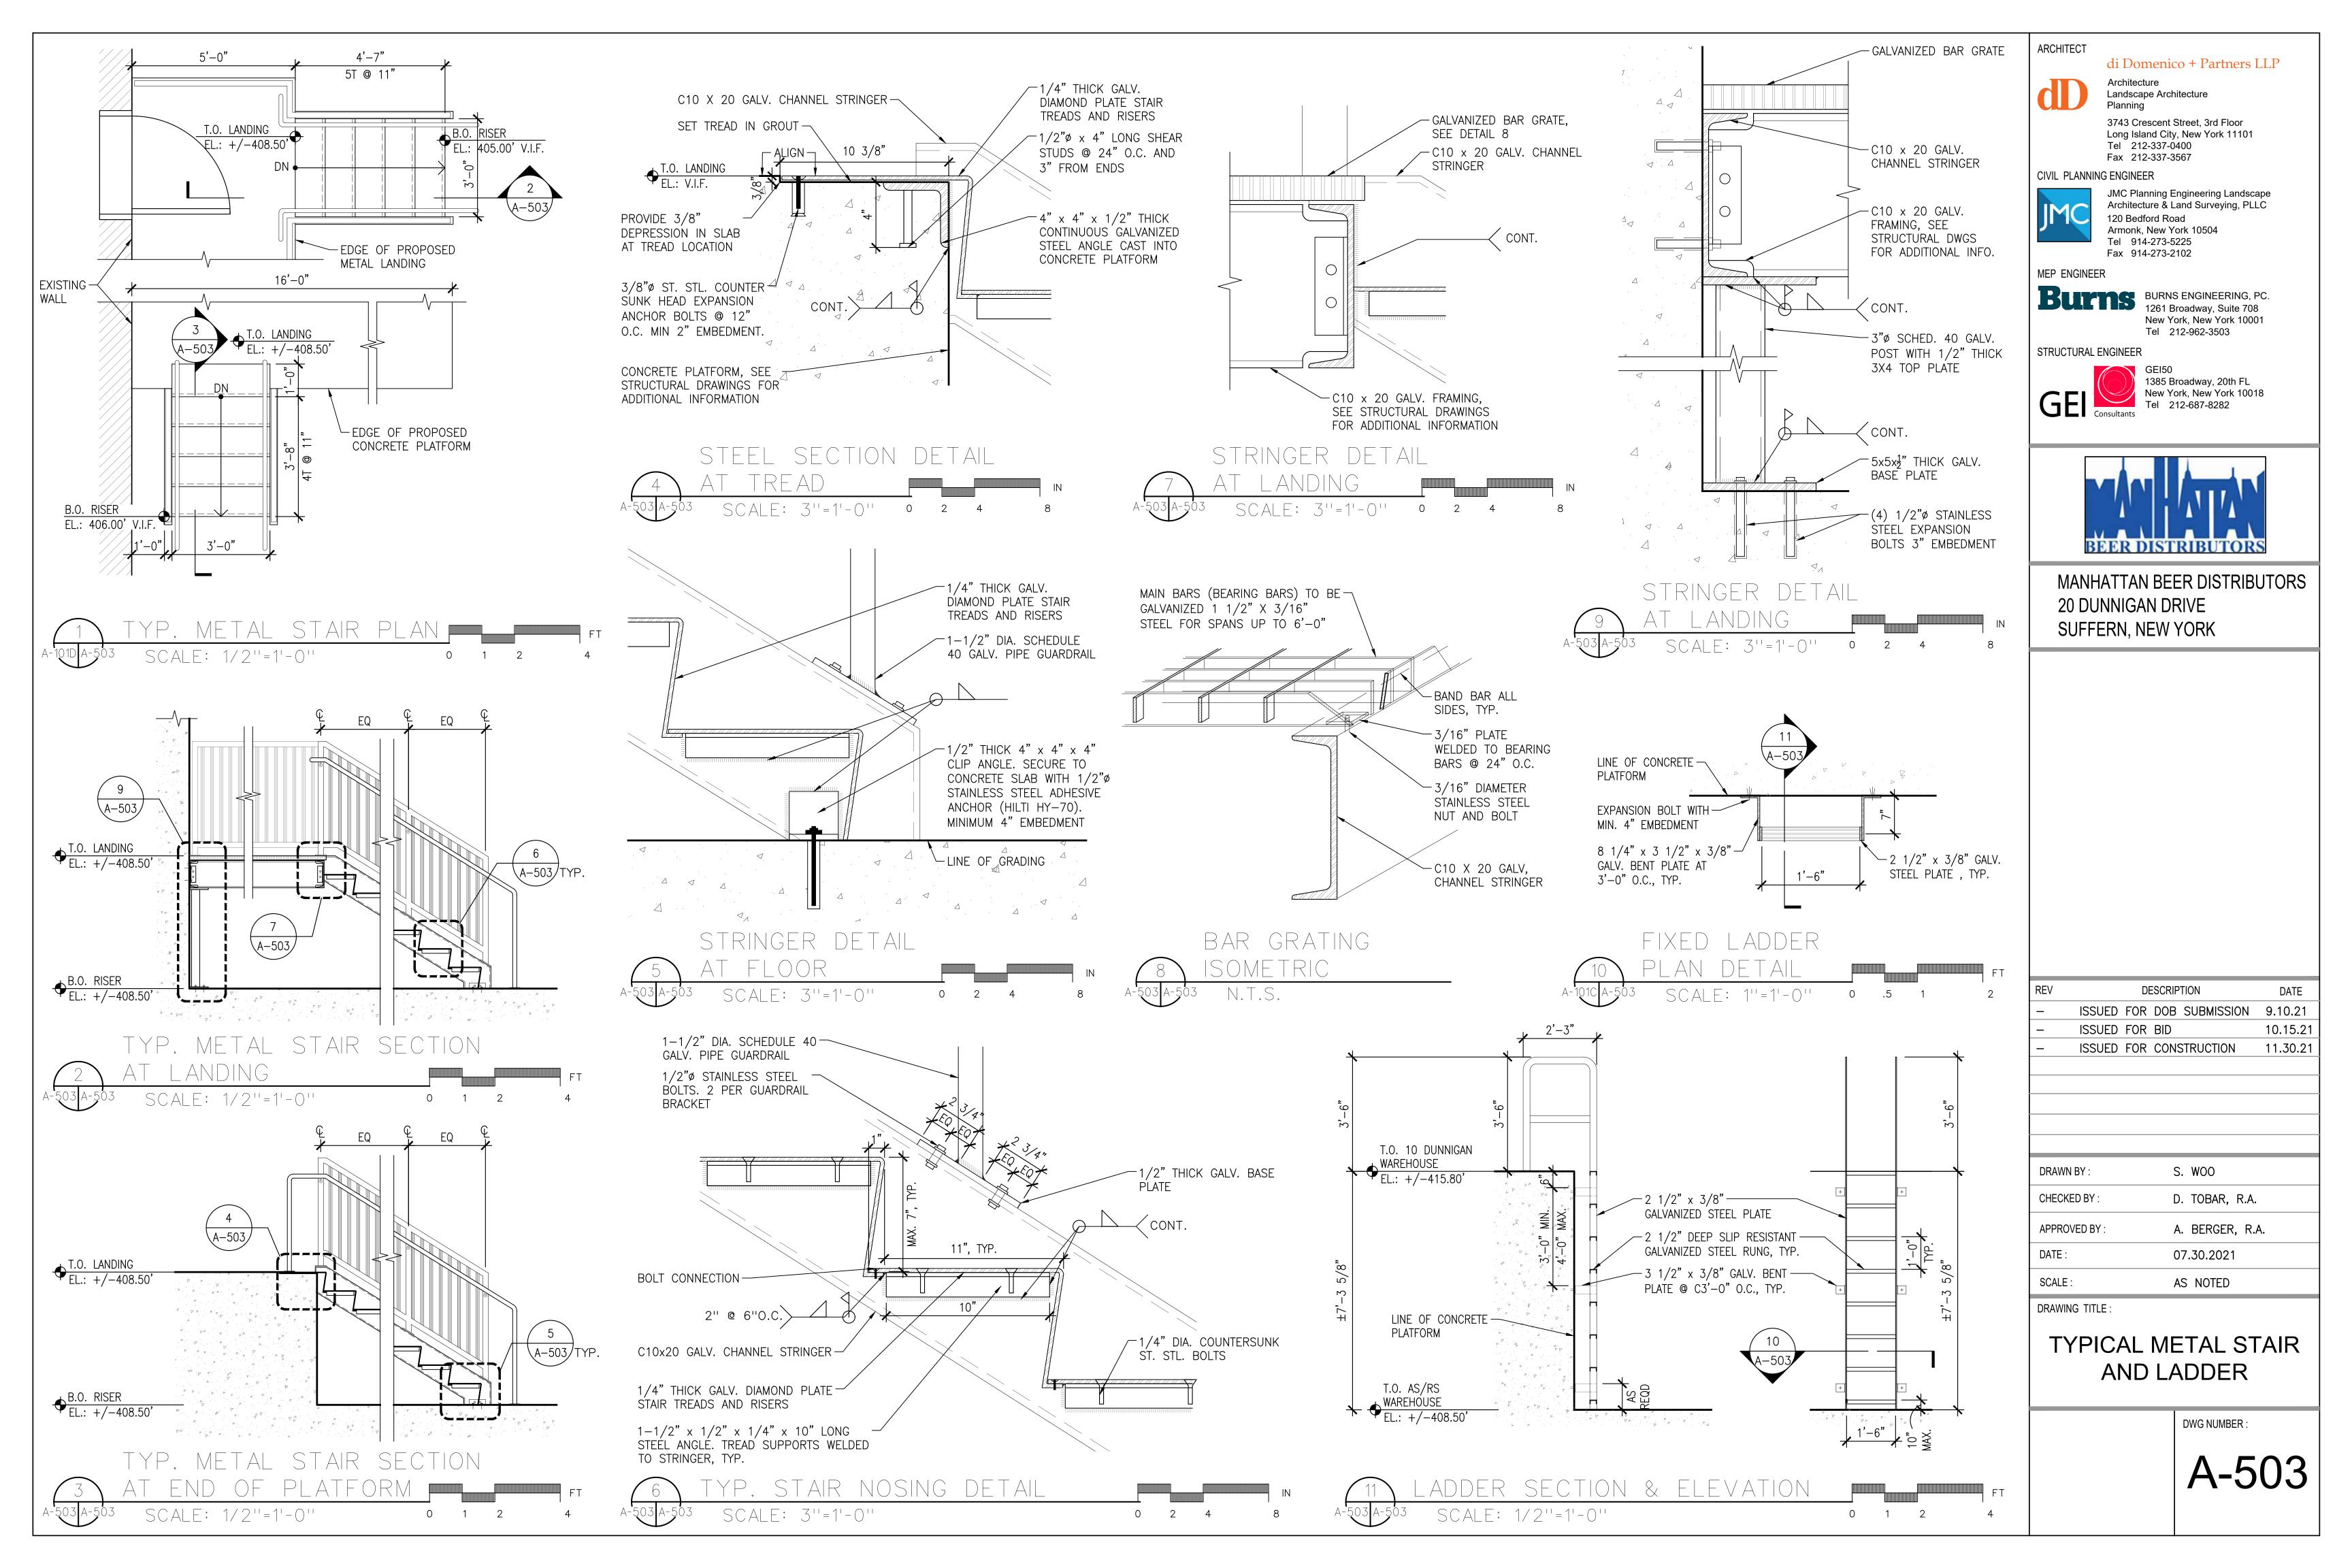
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Landscape Architecture

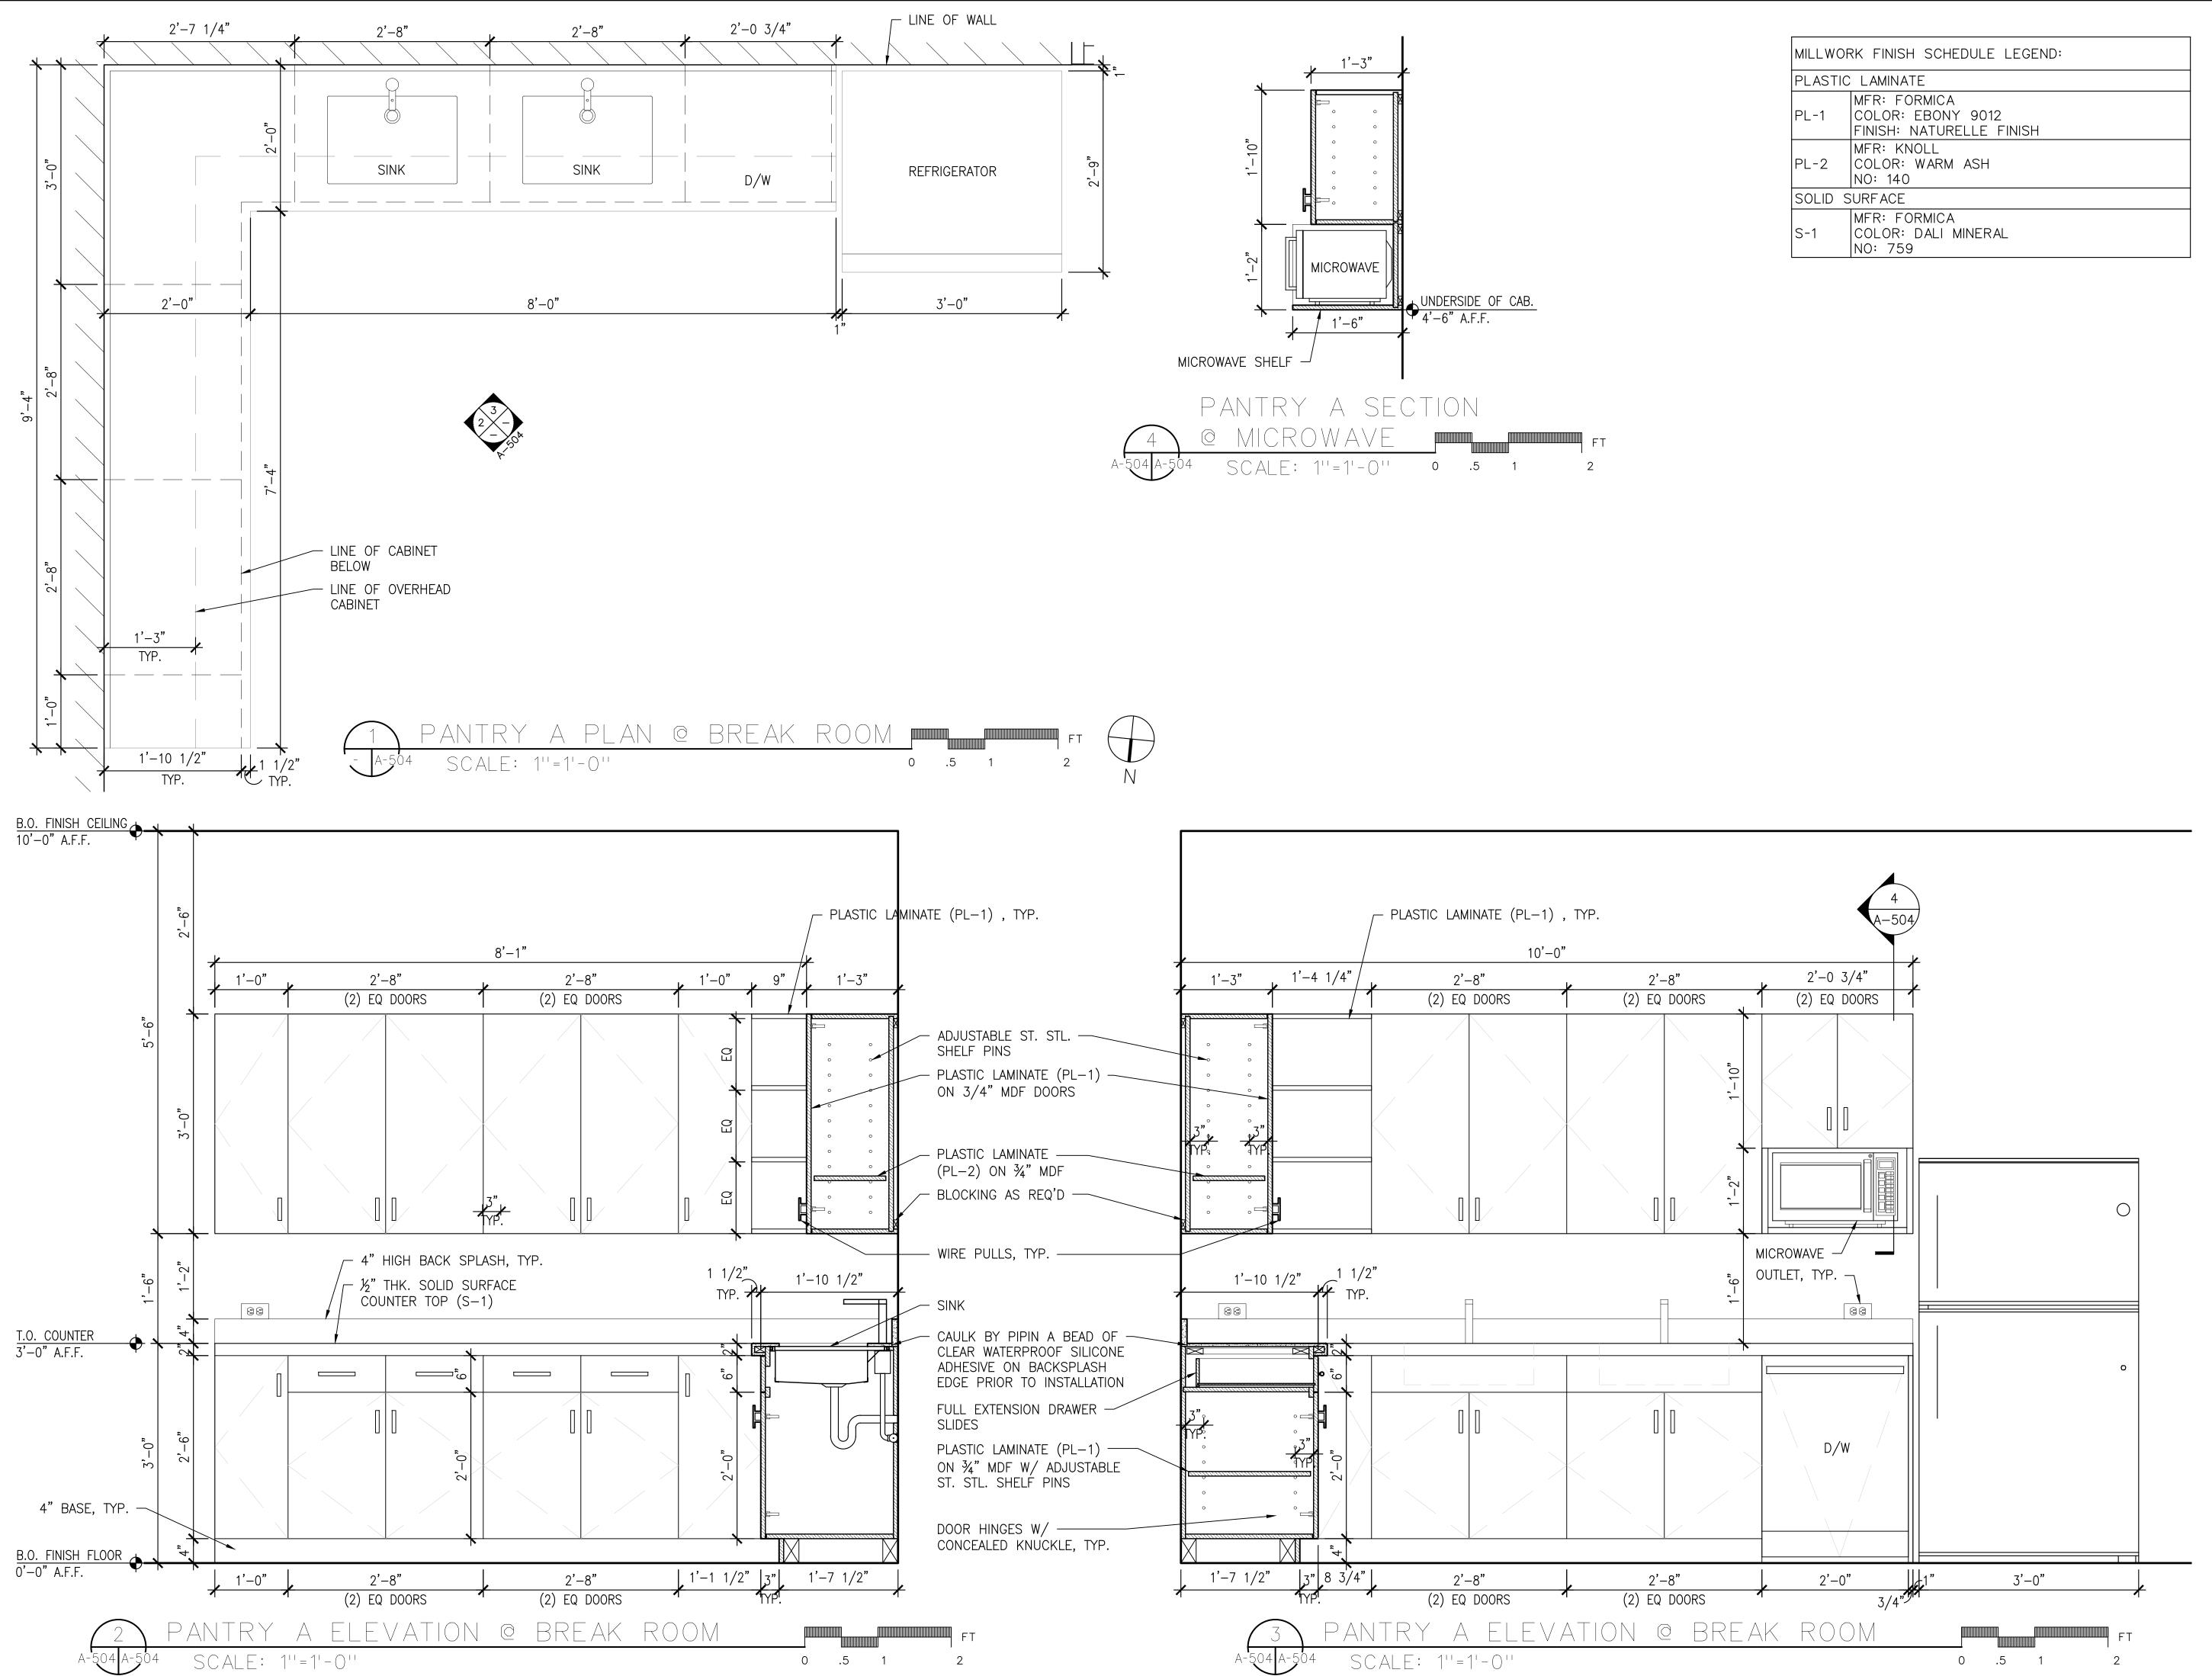MILLWORK DETAILS 1 OF 2

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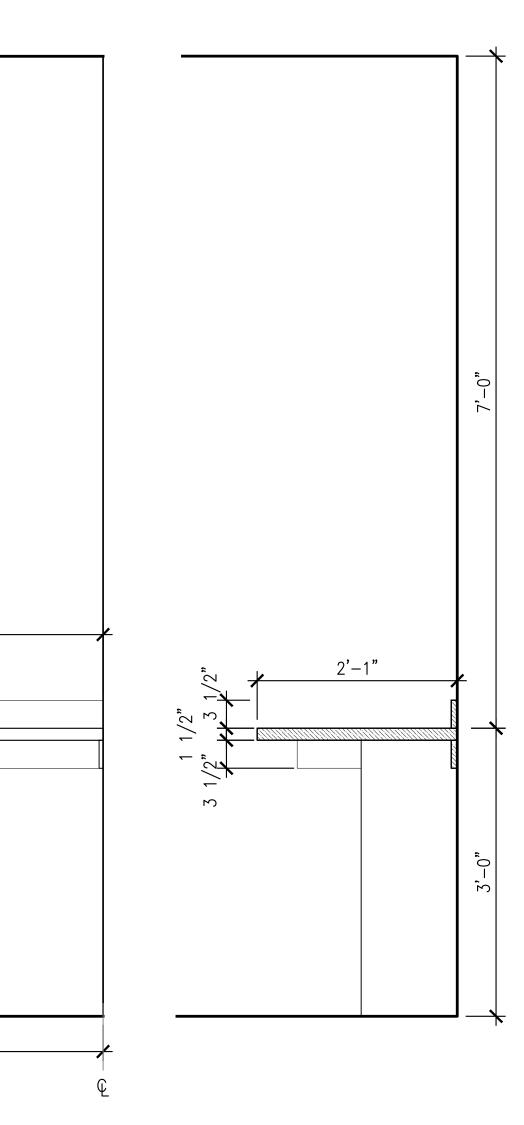
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3743 Crescent Street, 3rd Floor Long Island City, New York 11101 Tel 212-337-0400 Fax 212-337-3567 CIVIL PLANNING ENGINEER	
JMC Planning Engineering Landscape Architecture & Land Surveying, PLLC 120 Bedford Road Armonk, New York 10504 Tel 914-273-5225 Fax 914-273-2102	•
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STRUCTURAL ENGINEER GEI50 1385 Broadway, 20th FL New York, New York 10018 Tel 212-687-8282	
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DRAWN BY : S. WOO	
CHECKED BY : D. TOBAR, R.A.	
APPROVED BY : A. BERGER, R.A. DATE : 07.30.2021	
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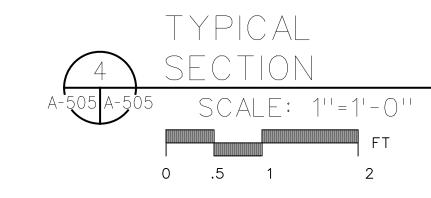
ARCHITECT


di Domenico + Partners LLP


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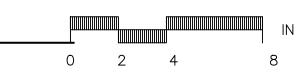









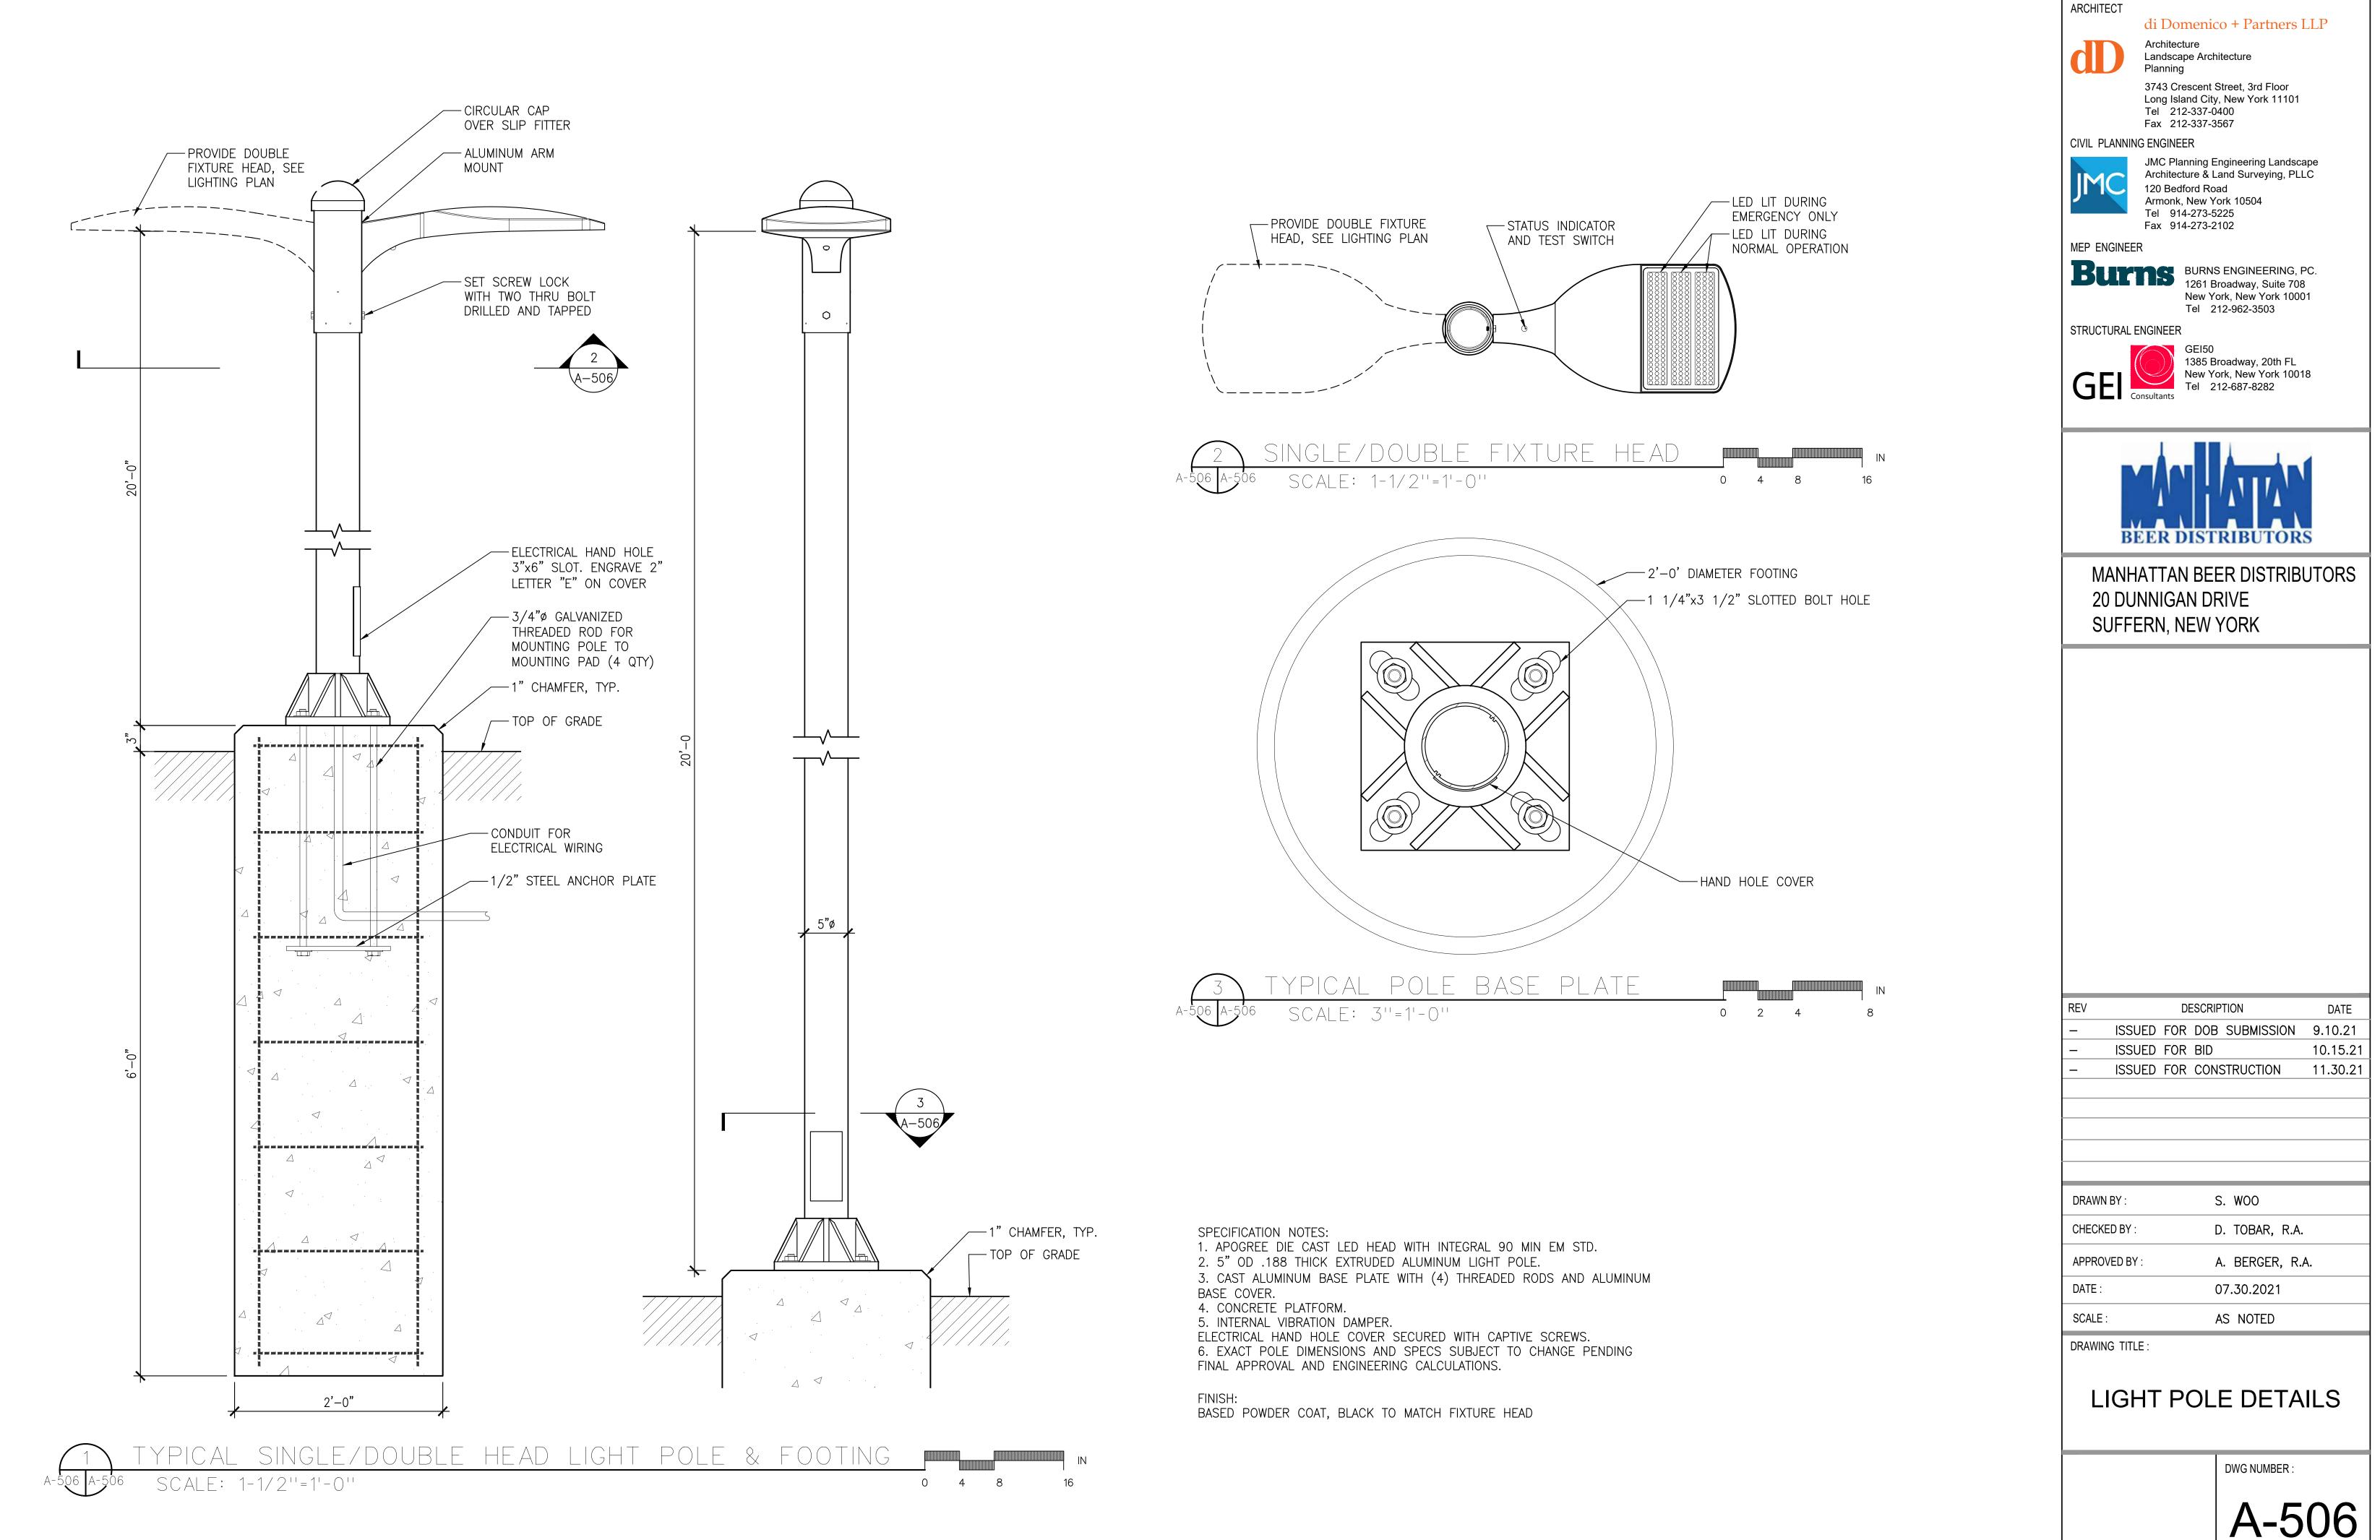

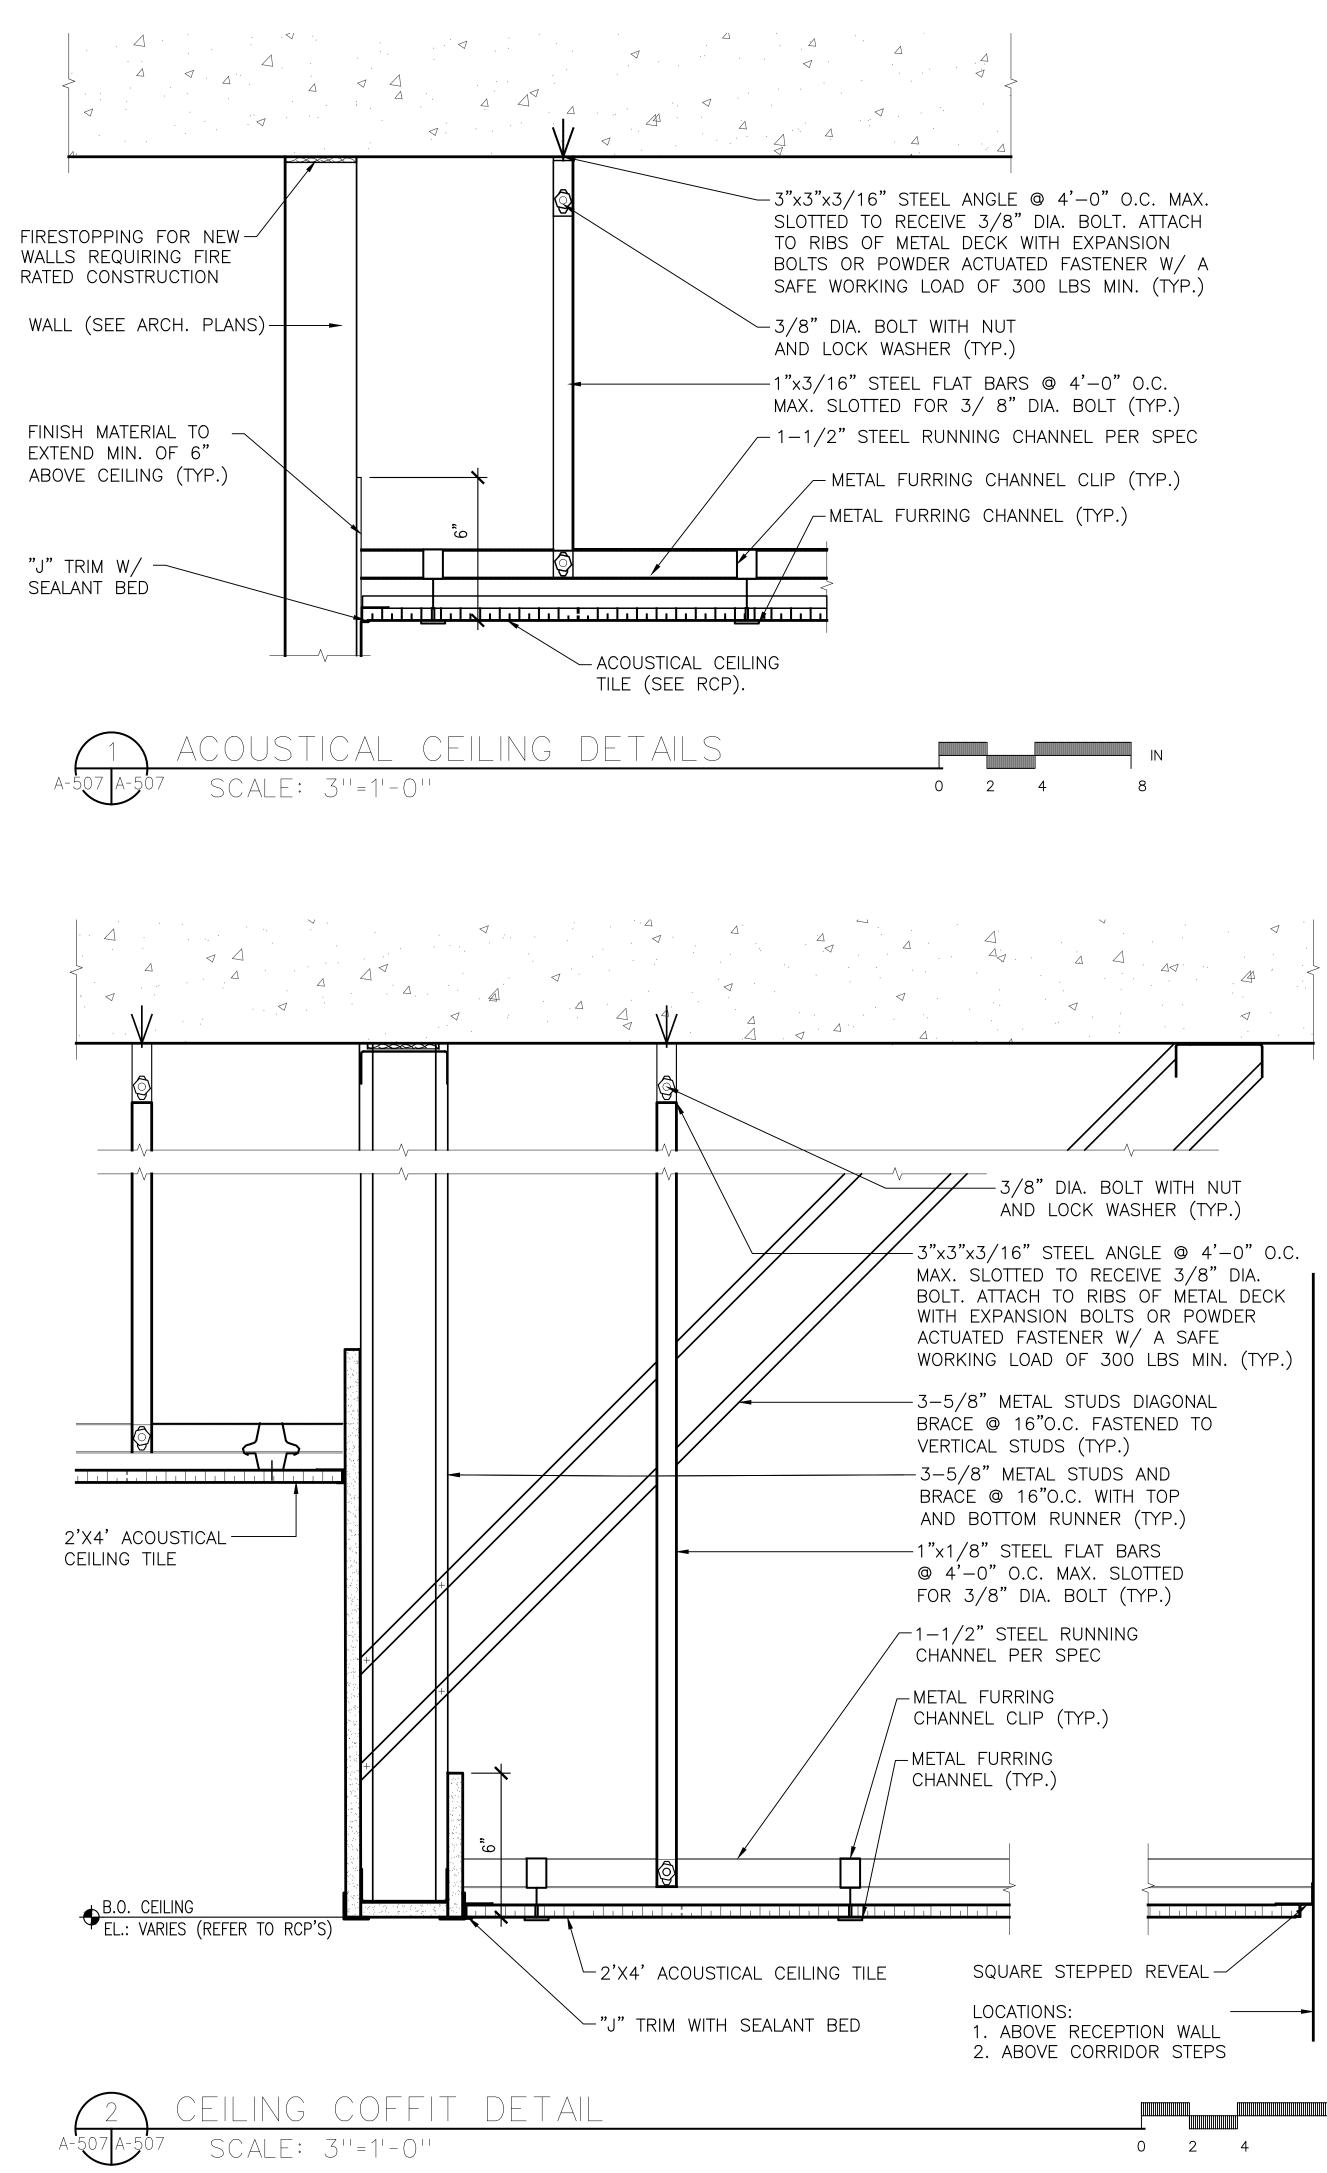

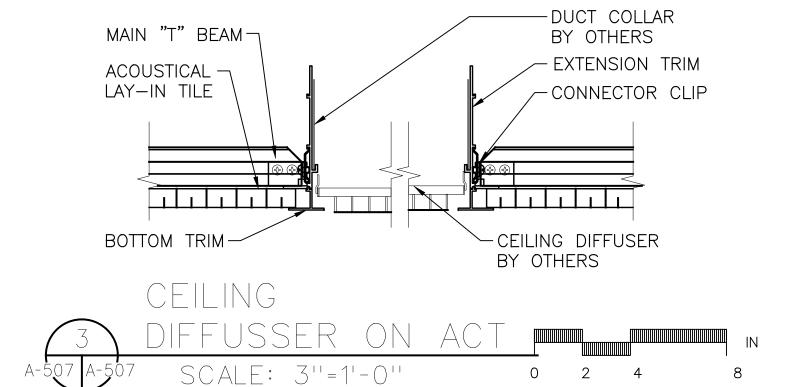

NOTES:

- 1. ALL MECHANICAL EQUIPMENT AND DUCTS SHALL BE SUPPORTED INDEPENDENTLY FROM THE CEILING SYSTEM.
- 2. RECESSED LUMINAIRES ADDITIONAL SUPPORT SHALL BE SECURED WITH SAFETY CHAINS OR AIRCRAFT CABLE ON EACH FIXTURE AT TWO DIAGONAL CORNERS AND SHALL BE ATTACHED TO BUILDING STRUCTURAL STEEL OR CONCRETE.

ARCHITECT

di Domenico + Partners LLP

Architecture Landscape Architecture Planning 3743 Crescent Street, 3rd Floor Long Island City, New York 11101 Tel 212-337-0400

Fax 212-337-3567 CIVIL PLANNING ENGINEER



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MEP ENGINEER




New York, New York 10001 Tel 212-962-3503

STRUCTURAL ENGINEER



GEI50 1385 Broadway, 20th FL New York, New York 10018 Tel 212-687-8282

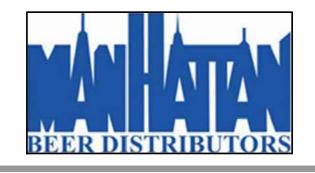


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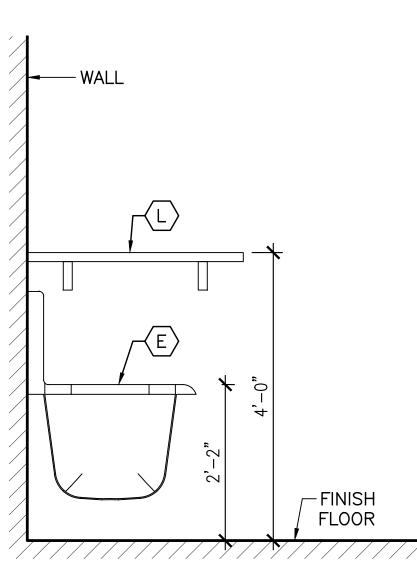
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DRAW	/N BY :		S	. WOO	
CHEC	KED BY :		D	. TOBAR, R.	Α.
APPROVED BY :		А	A. BERGER, R.A.		
DATE	:		0	7.30.2021	
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CEILING DETAILS








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di Domenico + Partners LLP Architecture
Landscape Architecture Planning
3743 Crescent Street, 3rd Floor Long Island City, New York 11101 Tel 212-337-0400
Fax 212-337-3567 CIVIL PLANNING ENGINEER
JMC Planning Engineering Landscape Architecture & Land Surveying, PLLC
120 Bedford Road Armonk, New York 10504
Tel 914-273-5225 Fax 914-273-2102
BURNS ENGINEERING, PC. 1261 Broadway, Suite 708 New York, New York 10001
Tel 212-962-3503 STRUCTURAL ENGINEER
GEI50 1385 Broadway, 20th FL
GEI Consultants New York, New York 10018 Tel 212-687-8282
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20 DUNNIGAN DRIVE
SUFFERN, NEW YORK
REVDESCRIPTIONDATE-ISSUED FOR DOB SUBMISSION9.10.21
- ISSUED FOR BID 10.15.21
– ISSUED FOR CONSTRUCTION 11.30.21
DRAWN BY : S. WOO
CHECKED BY : D. TOBAR, R.A.
APPROVED BY : A. BERGER, R.A.
DATE : 07.30.2021
SCALE : AS NOTED
DRAWING TITLE : TYPICAL TOILET ROOM
ELEVATIONS AND
DETAILS
DWG NUMBER :
A-508

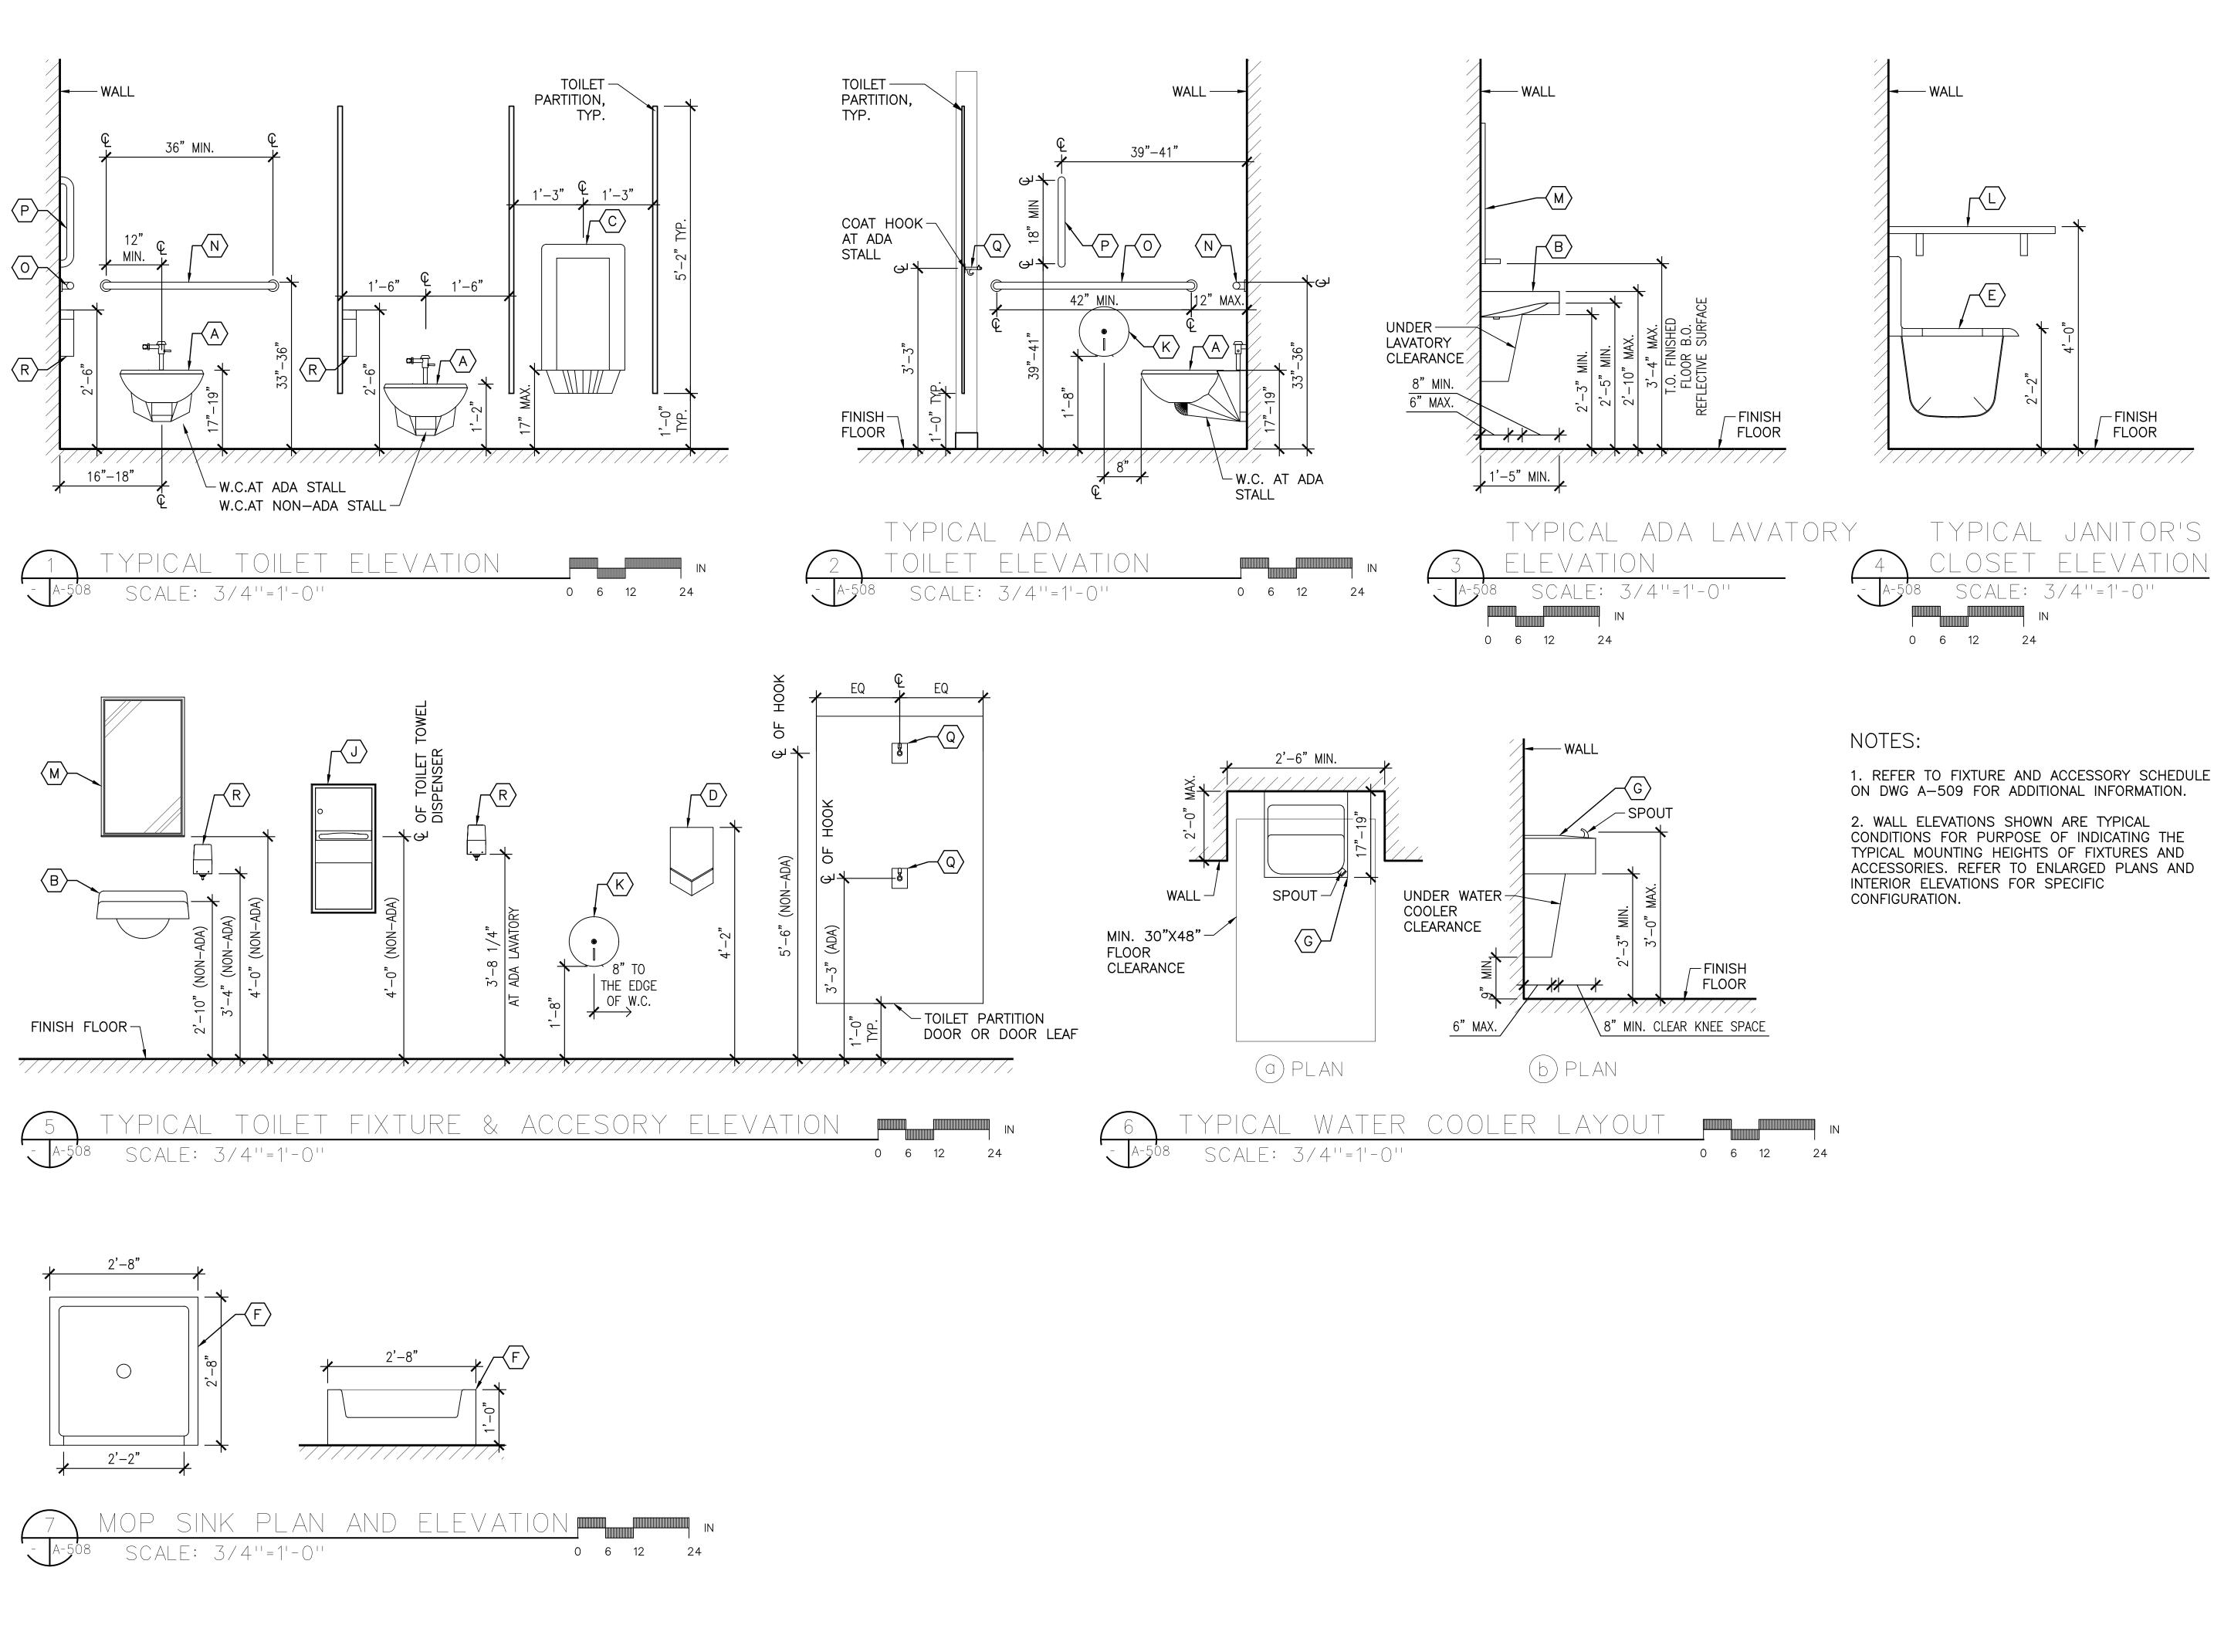		ACCESSORY & FIXTURE SCHEDULE/SYMBOL DESCRIPTION			MODEL		SYMBOL	
		ACCESSONT & FIATORE SCHEDULE/STMIDUL DESCRIPTION	REF DWG	MAKE	MODEL -	PLAN	ELEV.	SIDE ELEV.
	A	WALL MOUNTED WATER CLOSET FOR ADA MOUNTING HEIGHT 1'-7" MAXIMUM ABOVE FINISHED FLOOR WITH TOILET FLUSH VALVE AND ELONGATED FRONT OPEN SEAT	A-508	ТОТО	CT708UG WITH TET1UA AND SC534			
	В	WALL MOUNTED LAVATORY. ADA MOUNTING HEIGHT 2'-10" MAXIMUM ABOVE FINISHED FLOOR	A-508	ТОТО	LTG69			
	С	WALL MOUNTED URINAL FOR HANDICAPPED. MOUNTING HEIGHT 1'-5" MAXIMUM ABOVE FINISHED FLOOR	A-508	ТОТО	UT104E WITH TETU1LA			
U.	D	SURFACE MOUNTED ELECTRIC SENSOR HAND DRYER WITH STAINLESS STEEL BRUSHED FINISH. INSTALL BOTTOM OF UNIT ABOVE FINISH FLOOR IN ACCORDANCE TO ADA GUIDELINES	A-508	DYSON	HU02SPRAYED NICKEL 307172–01			
AND MISC.	E	SLOP/SERVICE SINK WITH UTILITY FAUCET. MOUNTING HEIGHT 2'-2" ABOVE FINISHED FLOOR	A-508	AMERICAN STANDARD	LAKEWELL SERVICE SINK 7692.000 W/ 8344.012	•		
	F	MOP SINK WITH UTILITY FAUCET	A-508	FIAT/ AMERICAN STANDARD	TSB3001 W/ 8344.012	о 		
FIXTURE	G	WALL MOUNTED WATER COOLER FOR HANDICAPPED. WATER SPOUT OUTLET SHALL BE NO HIGHER THAN 3'-0" ABOVE FINISHED FLOOR	A-508					
	Н	FIRE EXTINGUISHER. HANDLE AT 48" ABOVE FINISH FLOOR	A-511			đ		
	I	FIRE EXTINGUISHER WITH ENCLOSURE, RECESSED	A-511					
	J	RECESSED MOUNTED PAPER TOWEL DISPENSER AND WASTE RECEPTACLE, TOP OF UNIT MOUNTED 48" MAX. ABOVE FINISHED FLOOR	A-508					
	К	SURFACE MOUNTED STAINLESS STEEL SINGLE JUMBO-ROLL TOILET TISSUE DISPENSER MOUNTED 20" ABOVE FINISHED FLOOR TO BOTTOM OF DISPENSER	A-508	BOBRICK	B2890			
	L	CUSTODIAN UTILITY SHELF WITH MOP & BROOM HOLDERS & RAG HOOKS MOUNTED 4'-0" ABOVE FINISHED FLOOR	A-508					
L N N	М	18" X 30" STAINLESS STEEL FRAME MIRROR AND SHELF, TOP OF FRAME MOUNTED 6'-6" ABOVE FINISHED FLOOR	A-508					Ĺ
ACCESSORIES	N	1 1/4 " DIA S.S. GRAB BAR W/ CONCEALED MOUNTING, $3'-0$ " LONG PEENED NON-SLIP GRIPPING SURFACE. SHALL BE INSTALLED IN A HORIZONTAL POSITION, TOP OF BAR MOUNTED $3'-0$ " MAX. ABOVE FINISH FLOOR	A-508				C	q
ACCE	0	1 1/4 " DIA S.S. GRAB BAR W/ CONCEALED MOUNTING, 3'-6" LONG PEENED NON-SLIP GRIPPING SURFACE. SHALL BE INSTALLED IN A HORIZONTAL POSITION, TOP OF BAR MOUNTED 3'-0" MAX. ABOVE FINISH FLOOR	A-508				C	q
	Ρ	1 1/4 " DIA S.S. GRAB BAR W/ CONCEALED MOUNTING, 18" LONG PEENED NON-SLIP GRIPPING SURFACE. SHALL BE INSTALLED IN A VERTICAL POSITION, BOTTOM OF BAR MOUNTED 39" A.F.F. AND 39"-41" AWAY FROM WALL	A-508			- U -		
	Q	SOLID CAST ALUMINUM COAT HOOK WITH BUMPER IN EVERY TOILET COMPARTMENT. CENTER LINE OF HOOK SHALL BE MOUNTED 3'-3" (4'-0" MAX.) ABOVE FINISHED FLOOR AT ADA LOCATIONS AND 5'-6" ABOVE FINISHED FLOOR AT ALL OTHER LOCATIONS.						
	R	LIQUID SOAP DISPENSER WITH SHATTERPROOF TRANSLUCENT REFILL WINDOW. TOP OF UNIT MOUNTED $4'-2$ $1/2''$ ABOVE FINISHED FLOOR.	A-508					Ţ


RCHITECT	di Domonico I Doutrous IID
	di Domenico + Partners LLP Architecture
	Landscape Architecture Planning
	3743 Crescent Street, 3rd Floor Long Island City, New York 11101
	Tel 212-337-0400 Fax 212-337-3567
IVIL PLANNING	ENGINEER JMC Planning Engineering Landscape
IMC	Architecture & Land Surveying, PLLC 120 Bedford Road
	Armonk, New York 10504 Tel 914-273-5225
1EP ENGINEER	Fax 914-273-2102
-	BURNS ENGINEERING, PC. 1261 Broadway, Suite 708
	New York, New York 10001
TRUCTURAL EI	Tel 212-962-3503 NGINEER
	GEI50
GEI	1385 Broadway, 20th FL New York, New York 10018 Tel 212-687-8282
	nsultants
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	SCHEDULE



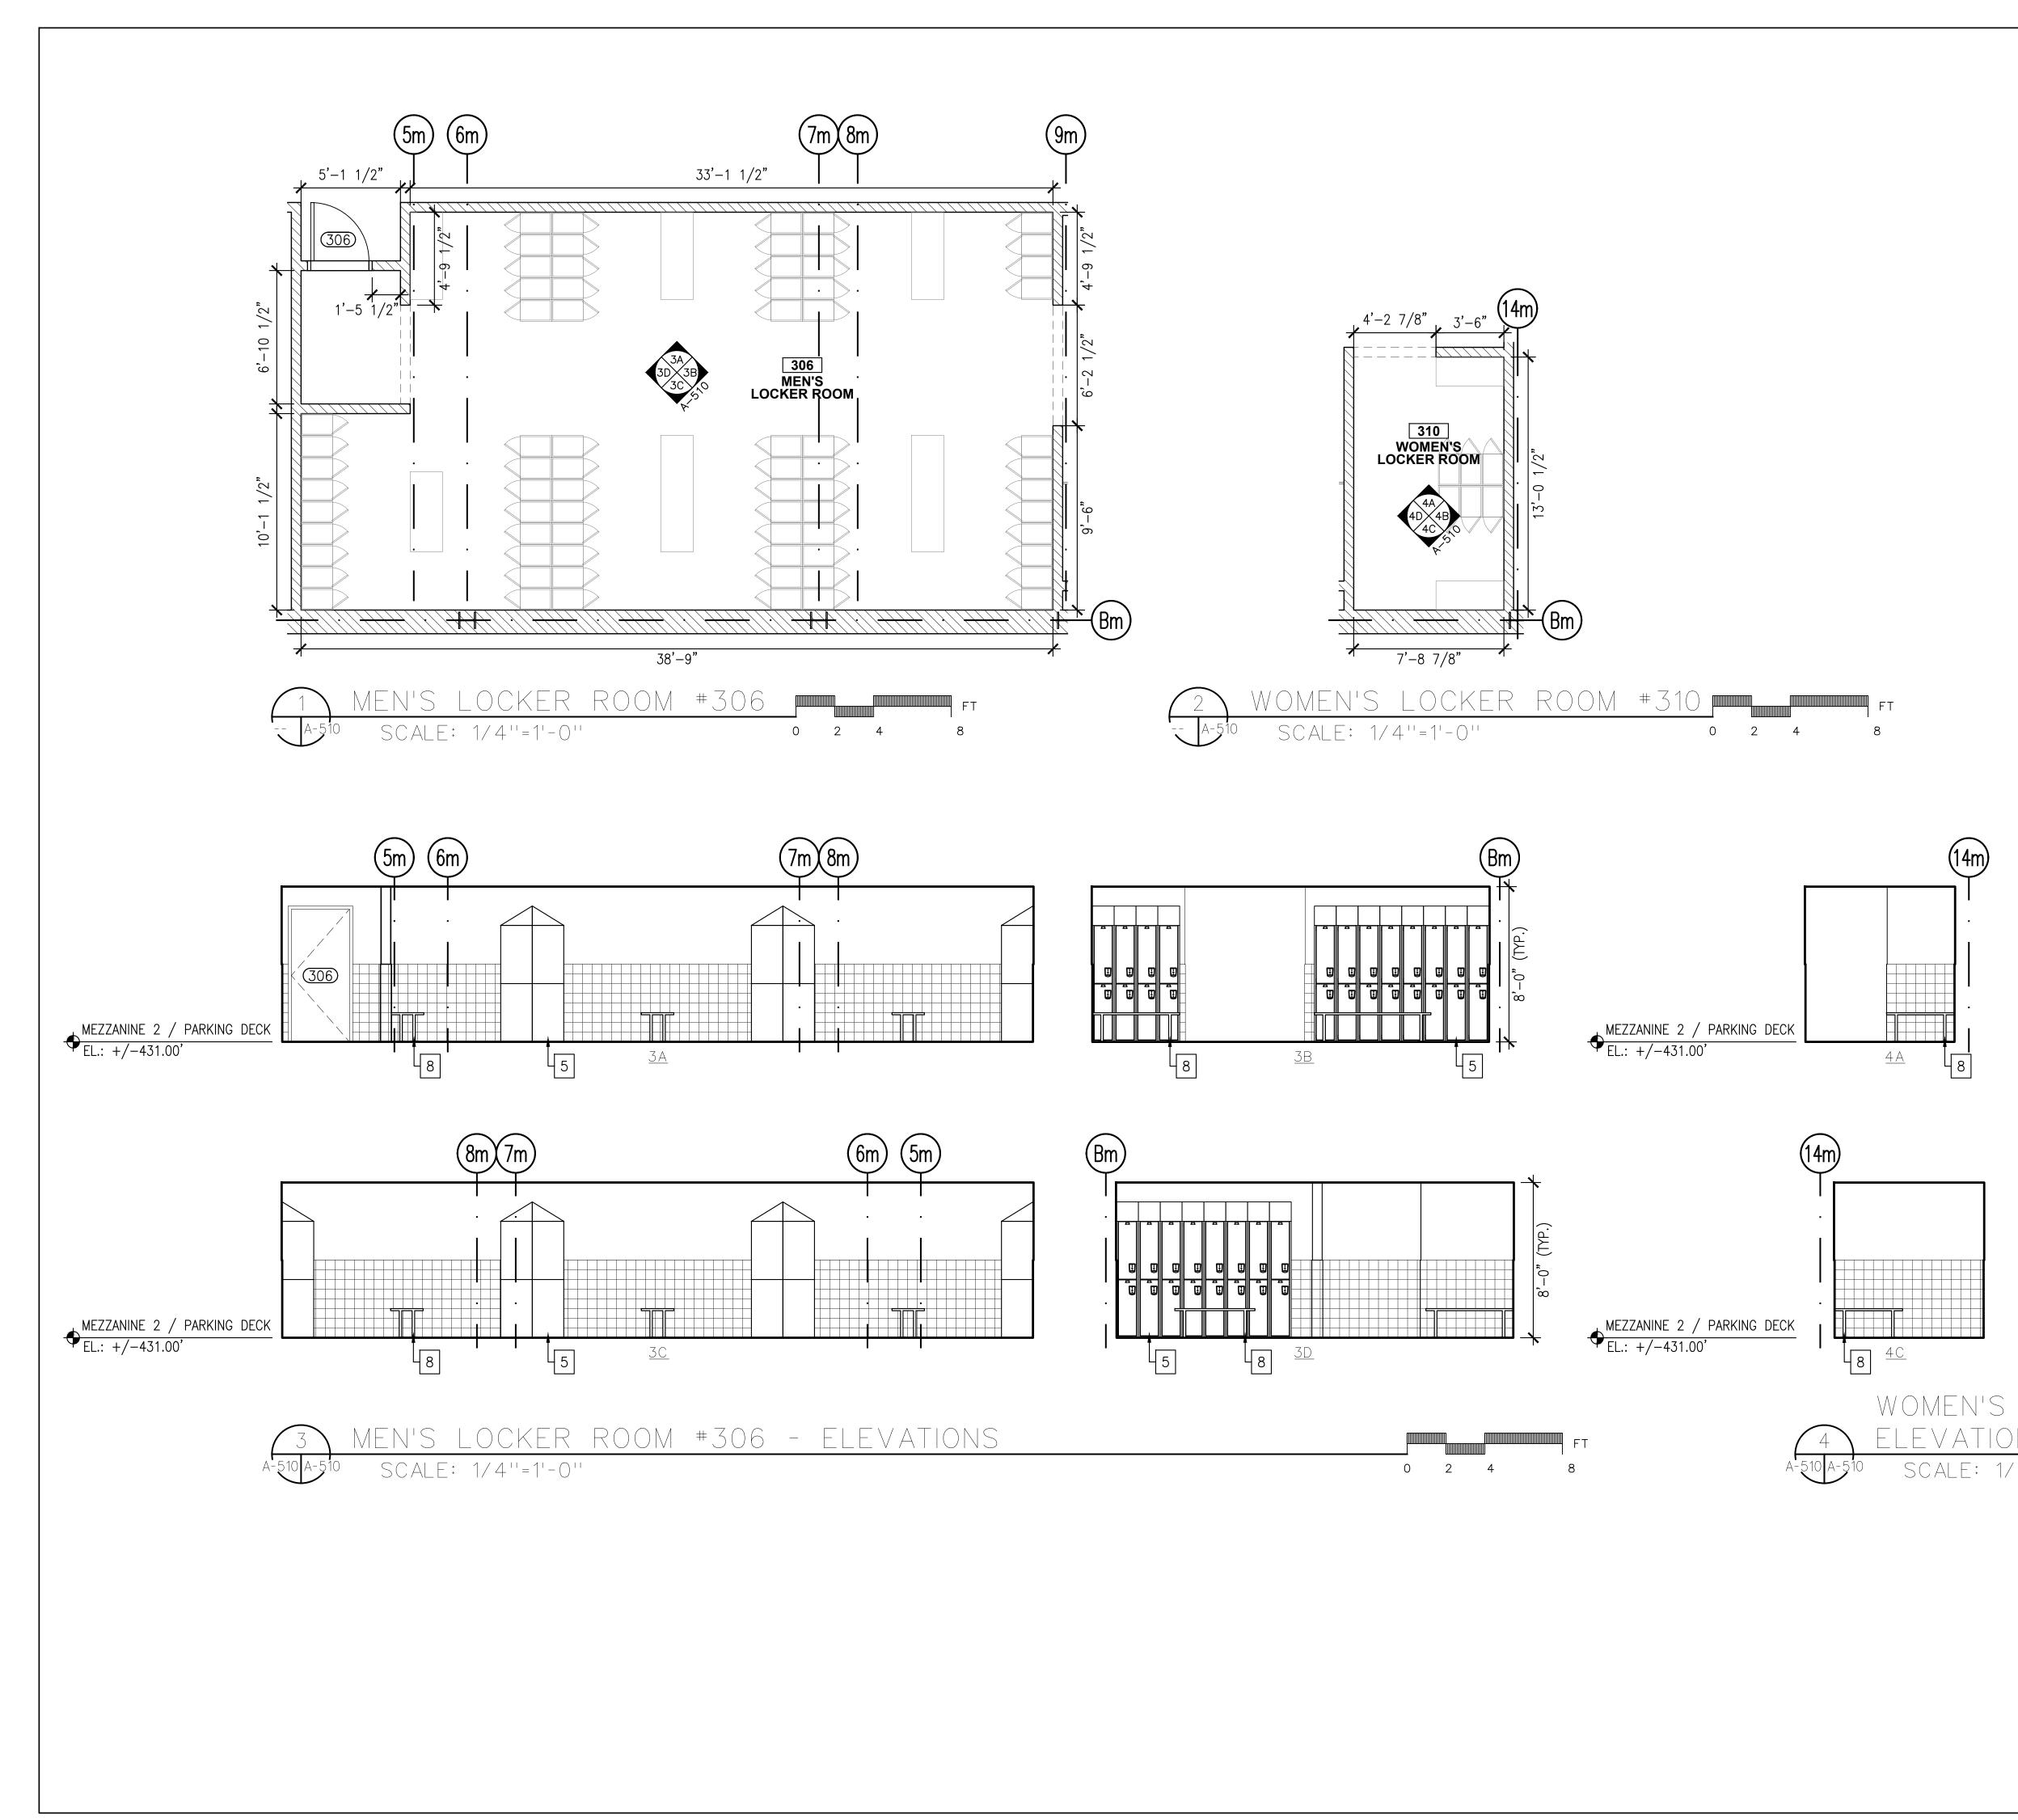

	ARCHITECT
	di Domenico + Partners LLP Architecture
	Landscape Architecture Planning
	3743 Crescent Street, 3rd Floor
	Long Island City, New York 11101 Tel 212-337-0400 Fax 212-337-3567
	CIVIL PLANNING ENGINEER
	JMC Planning Engineering Landscape
	Architecture & Land Surveying, PLLC 120 Bedford Road
	Armonk, New York 10504 Tel 914-273-5225
	Fax 914-273-2102
	Burns ENGINEERING, PC. 1261 Broadway, Suite 708
	New York, New York 10001 Tel 212-962-3503
	STRUCTURAL ENGINEER
	GEI50 1385 Broadway, 20th FL
	New York, New York 10018
	Consultants Tel 212-687-8282
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LOCKER ROOM #310	CHECKED BY : D. TOBAR, R.A.
VS FT	APPROVED BY : A. BERGER, R.A.
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	SCALE : AS NOTED
	DRAWING TITLE :
	LOCKER ROOM
	PLANS AND ELEVATIONS

DWG NUMBER :

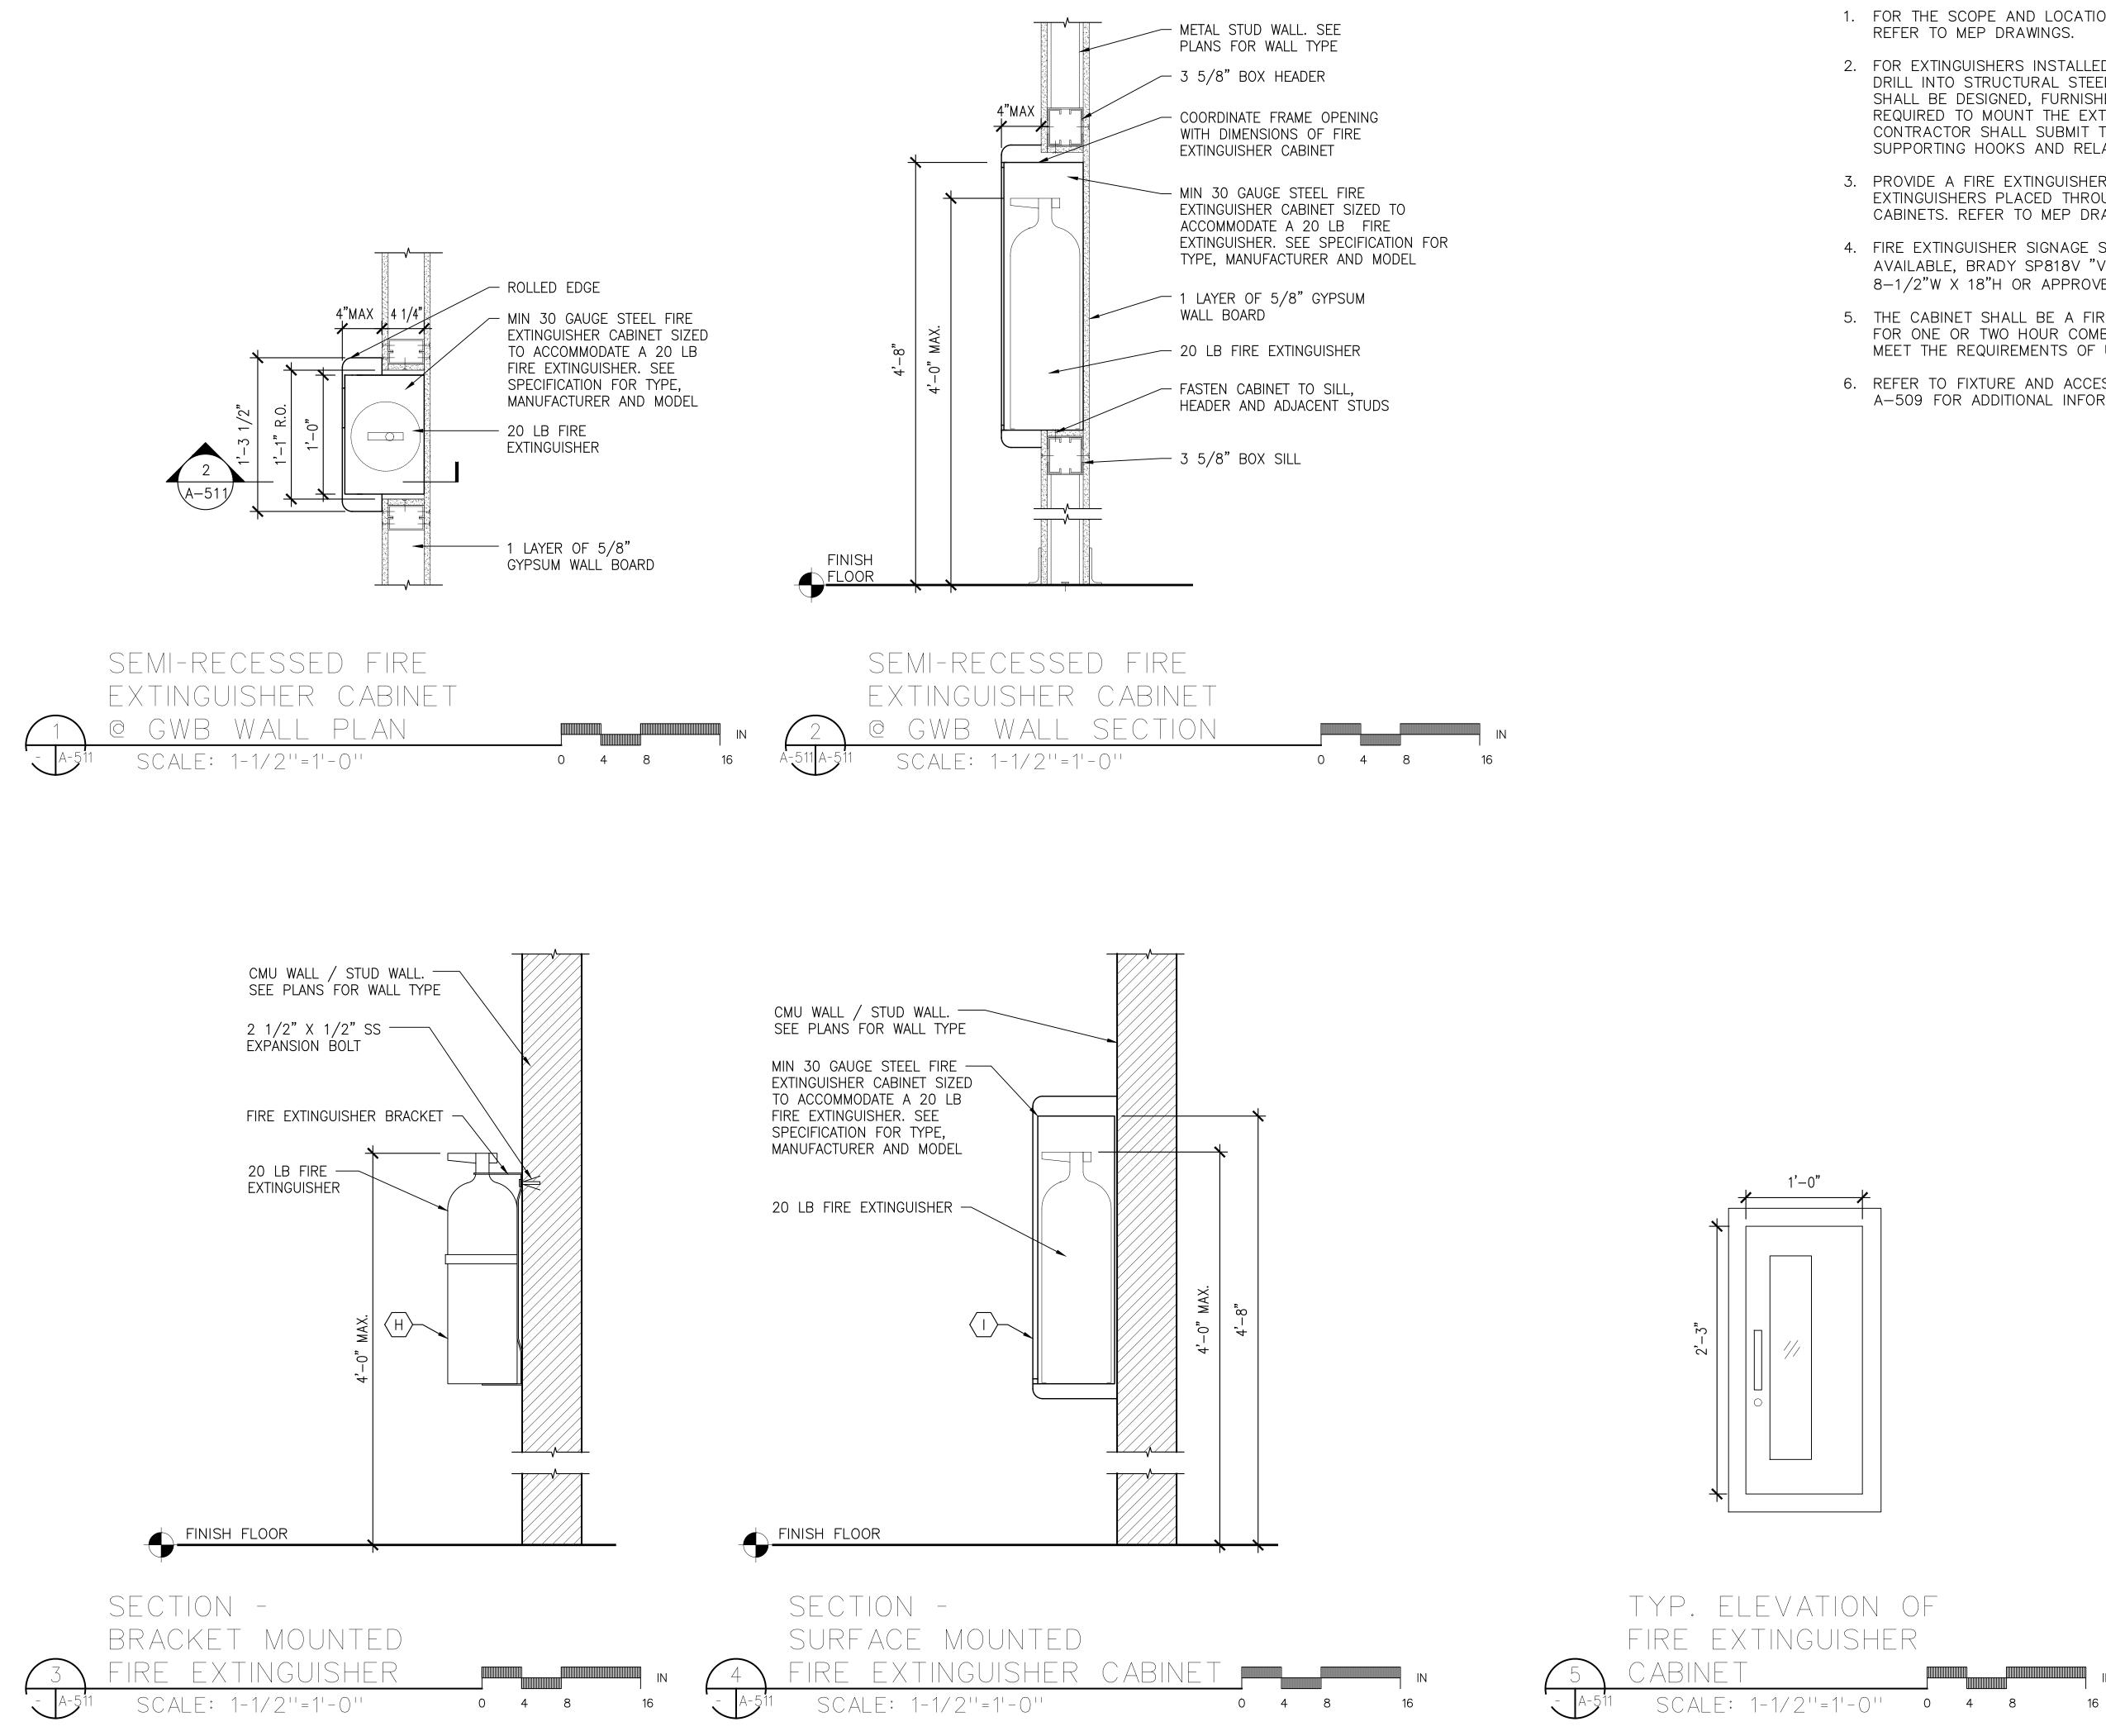

NOTES:

1. FOR THE SCOPE AND LOCATION OF FIRE EXTINGUISHERS, REFER TO MEP DRAWINGS.

2. FOR EXTINGUISHERS INSTALLED IN COLUMNS, DO NOT DRILL INTO STRUCTURAL STEEL. BRACKETS AND CLAMPS SHALL BE DESIGNED, FURNISHED, AND INSTALLED AS REQUIRED TO MOUNT THE EXTINGUISHERS. THE CONTRACTOR SHALL SUBMIT THE BRACKETS, CLAMPS, SUPPORTING HOOKS AND RELATED ITEMS FOR APPROVAL.


3. PROVIDE A FIRE EXTINGUISHER SIGNAGE ABOVE ALL FIRE EXTINGUISHERS PLACED THROUGHOUT WITH OR WITHOUT CABINETS. REFER TO MEP DRAWINGS.

4. FIRE EXTINGUISHER SIGNAGE SHALL BE COMMERCIALLY AVAILABLE, BRADY SP818V "V" SIGN TWO-SIDED, ACRYLIC, 8-1/2"W X 18"H OR APPROVED EQUAL.

5. THE CABINET SHALL BE A FIRE RATED CABINET, CERTIFIED FOR ONE OR TWO HOUR COMBUSTIBLE WALL SYSTEM TO MEET THE REQUIREMENTS OF UL 1479.

6. REFER TO FIXTURE AND ACCESSORY SCHEDULE ON DWG A-509 FOR ADDITIONAL INFORMATION.

	lanning
	743 Crescent Street, 3rd Floor ong Island City, New York 11101
Т	el 212-337-0400 ax 212-337-3567
CIVIL PLANNING E	INGINEER
	MC Planning Engineering Landscape
	20 Bedford Road vrmonk, New York 10504
Т	rel 914-273-5225 ax 914-273-2102
MEP ENGINEER	ax 914-273-2102
	BURNS ENGINEERING, PC.
	1261 Broadway, Suite 708 New York, New York 10001
	Tel 212-962-3503
STRUCTURAL ENG	GINEER GEI50
	1385 Broadway, 20th FL
GEL	New York, New York 10018 Tel 212-687-8282
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REV	DESCRIPTION DATE
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	D FOR BID 10.15.21
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DRAWN BY :	S. WOO
CHECKED BY :	D. TOBAR, R.A.
APPROVED BY :	A. BERGER, R.A.
DATE :	07.30.2021
SCALE :	AS NOTED
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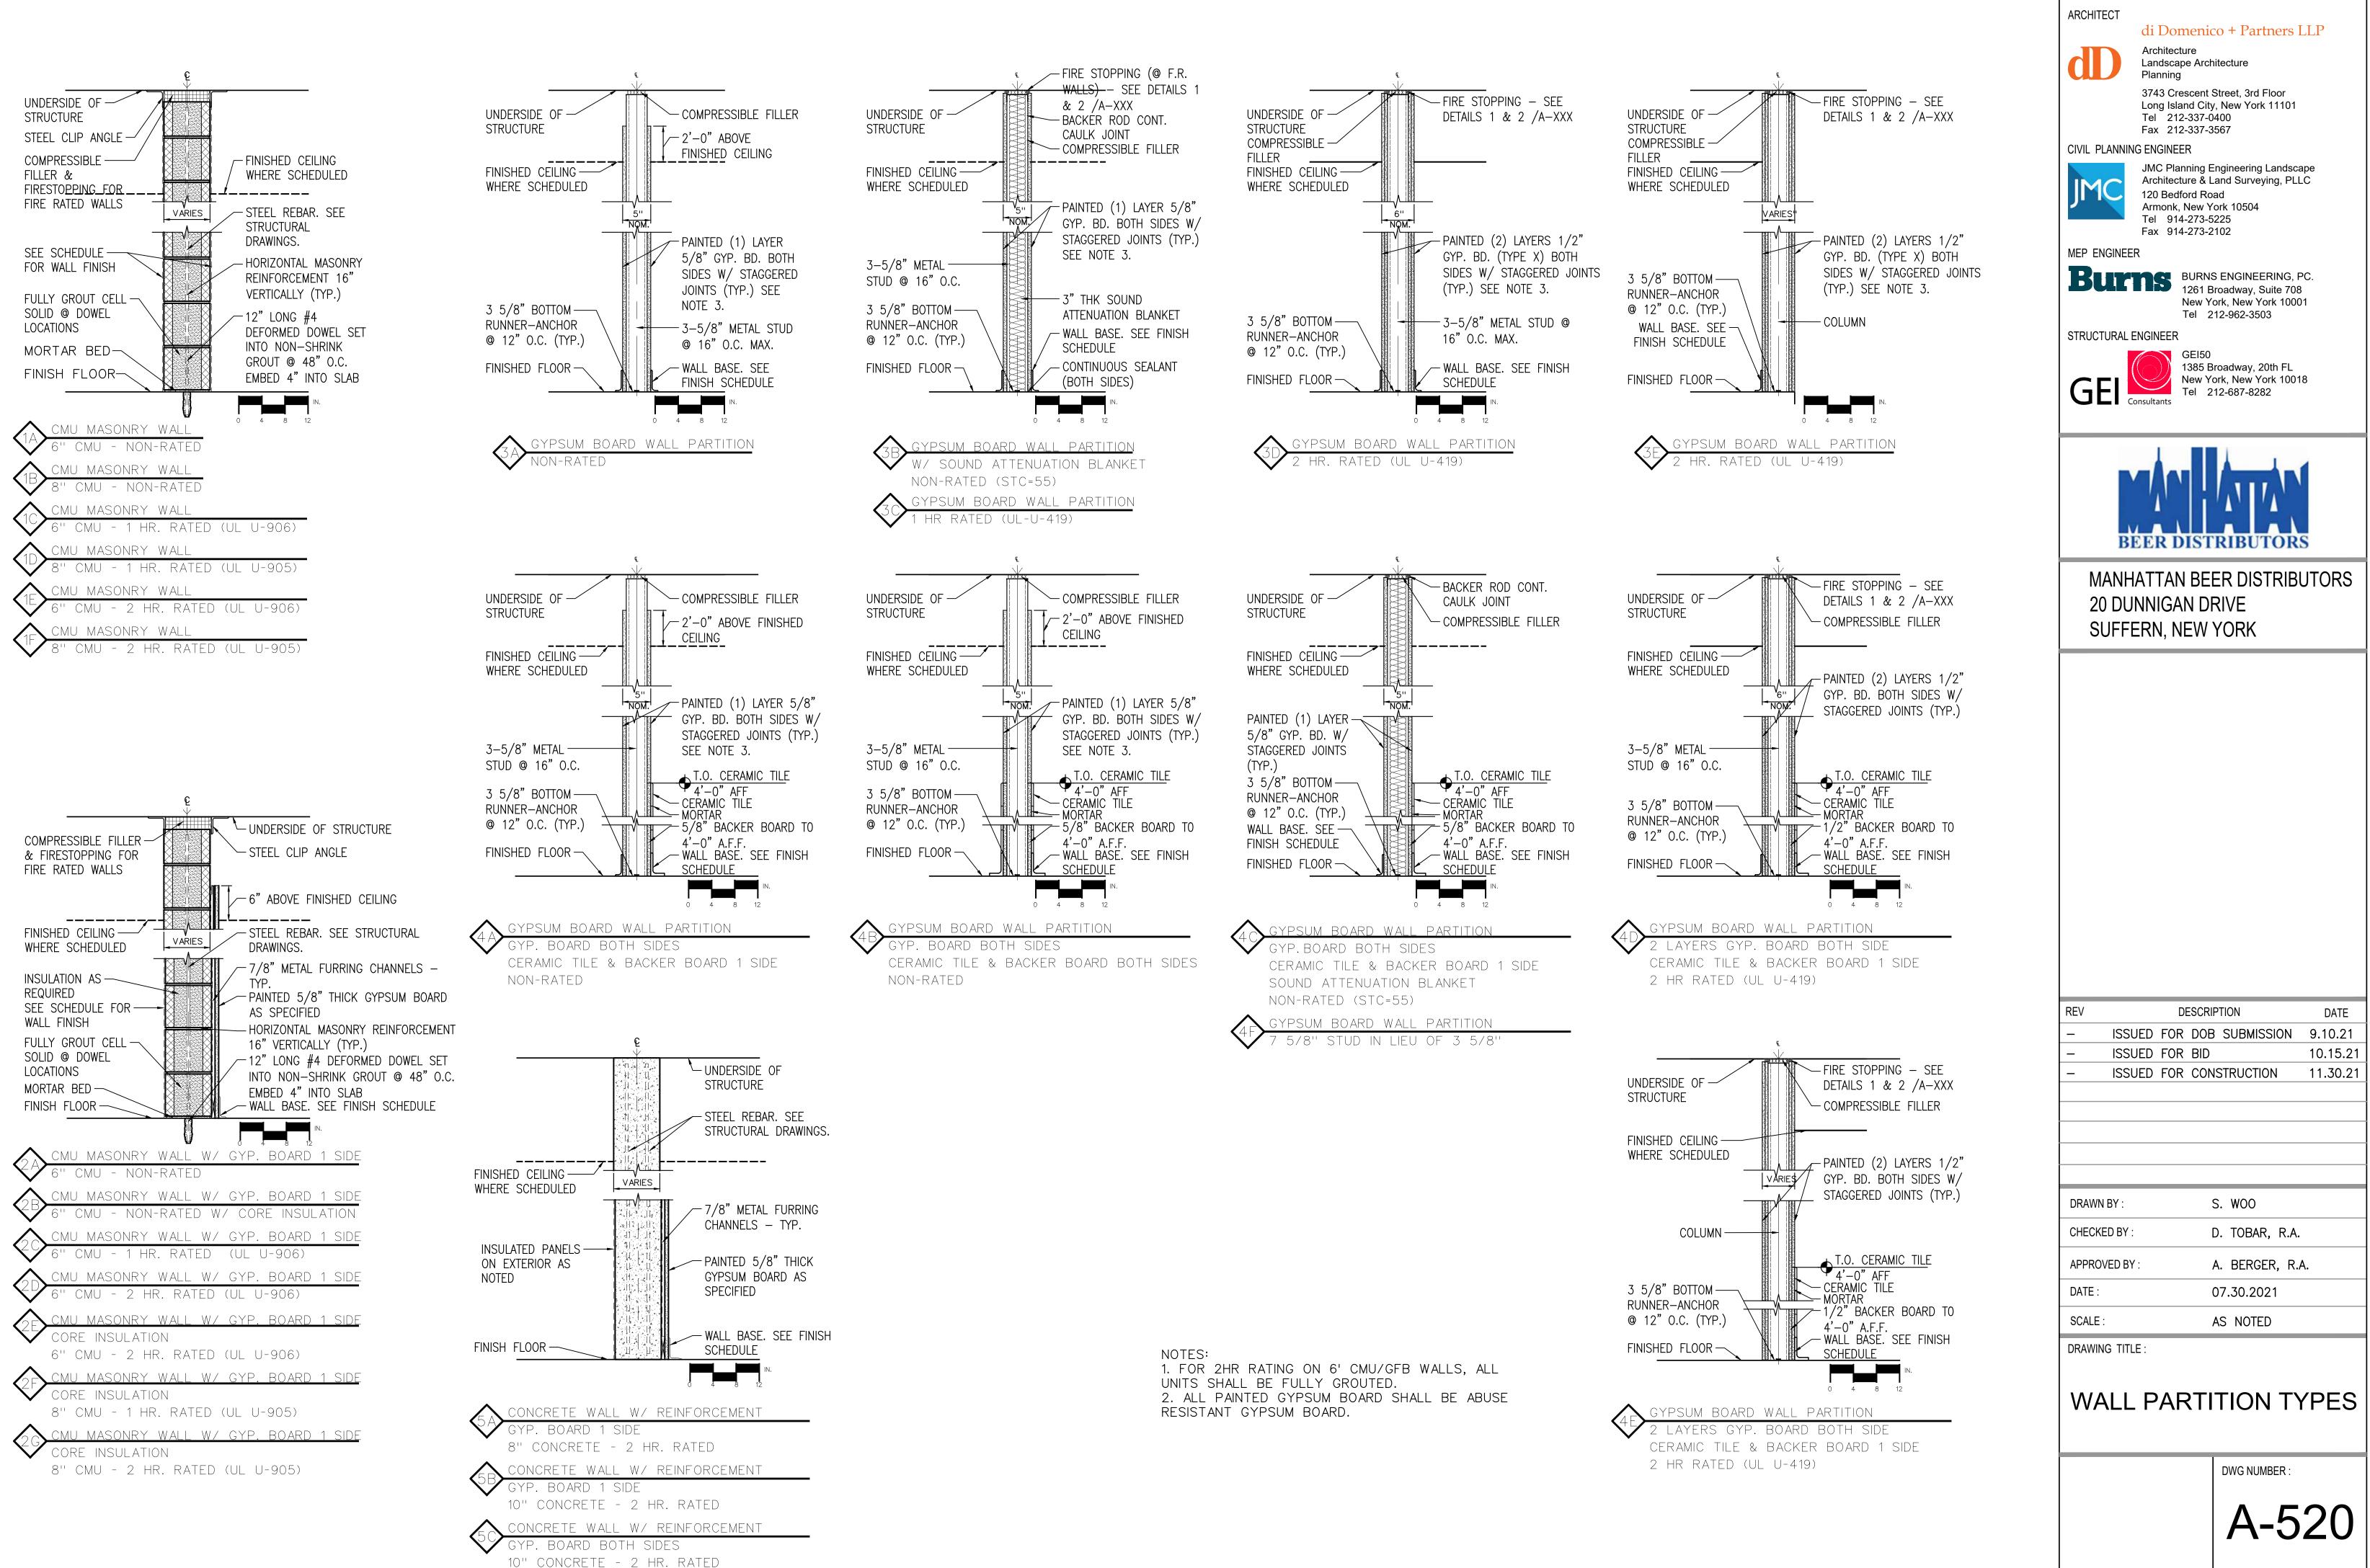


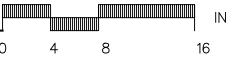
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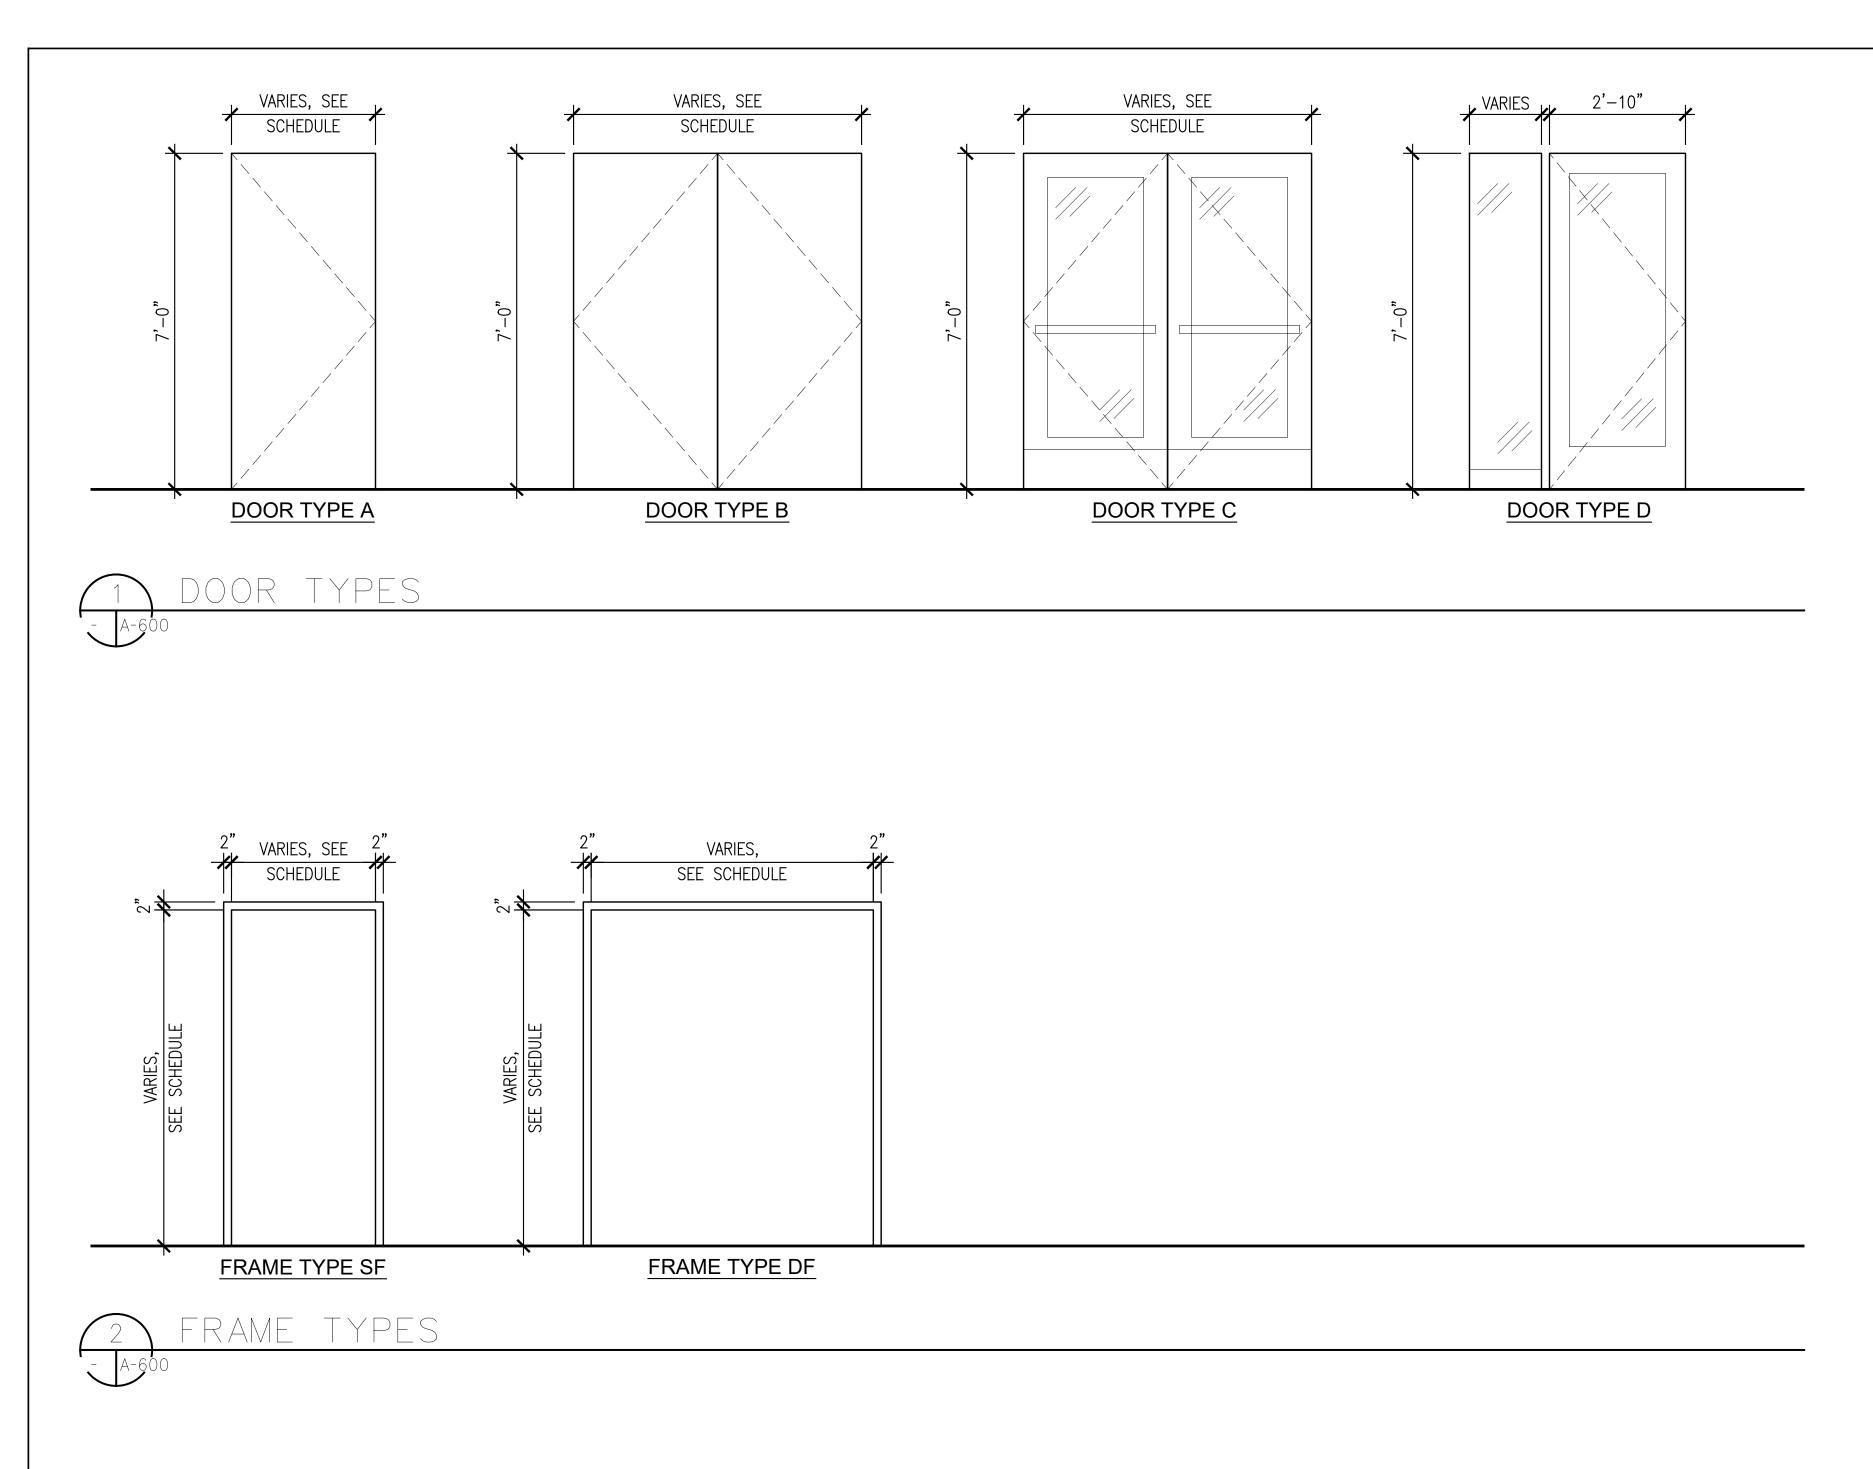






	ARCHITECT di Domenico + Partners LLP
	Architecture Landscape Architecture
OM OF METAL DECK	Planning
HIGH POINT	3743 Crescent Street, 3rd Floor Long Island City, New York 11101 Tel 212-337-0400
LOW POINT	Fax 212-337-3567 CIVIL PLANNING ENGINEER
	JMC Planning Engineering Landscape
	Architecture & Land Surveying, PLLC 120 Bedford Road
	Armonk, New York 10504 Tel 914-273-5225 Fax 914-273-2102
R WITH 1/2" STUD @ 24" O.C.	MEP ENGINEER
	Burns BURNS ENGINEERING, PC. 1261 Broadway, Suite 708
	New York, New York 10001 Tel 212-962-3503
	STRUCTURAL ENGINEER
0 2 4 8	GEI50 1385 Broadway, 20th FL
TACK 2" LONG PUDDLE WELD	GEI Consultants New York, New York 10018 Tel 212-687-8282
AT 24" O.C. AND STAGGERED	
L WOOL PACKING	
PLATE, EQUAL IN ESS AND WELDED	BEER DISTRIBUTORS
AL DECK R WITH 1/2" STUD	
@ 24" 0.C.	MANHATTAN BEER DISTRIBUTORS 20 DUNNIGAN DRIVE
	SUFFERN, NEW YORK
0 2 4 8	
@ 18"O.C	
- CONTINOUS	
EXTRUDED FLEXIBLE SEAL (COLOR TBD).	
- CONTINOUS	
EXTRUDED ALUMINUM FRAME	
	REV DESCRIPTION DATE
- FEATHER JOINT	- ISSUED FOR DOB SUBMISSION 9.10.21
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	APPROVED BY : A. BERGER, R.A.
DS	DATE : 07.30.2021
UDS AT 16" O.C.	SCALE : AS NOTED
	DRAWING TITLE :
UM BOARD	TYPICAL WALL DETAILS
WOOD BLOCKING EEL BEAM	
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	DWG NUMBER :


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<u>General notes:</u>

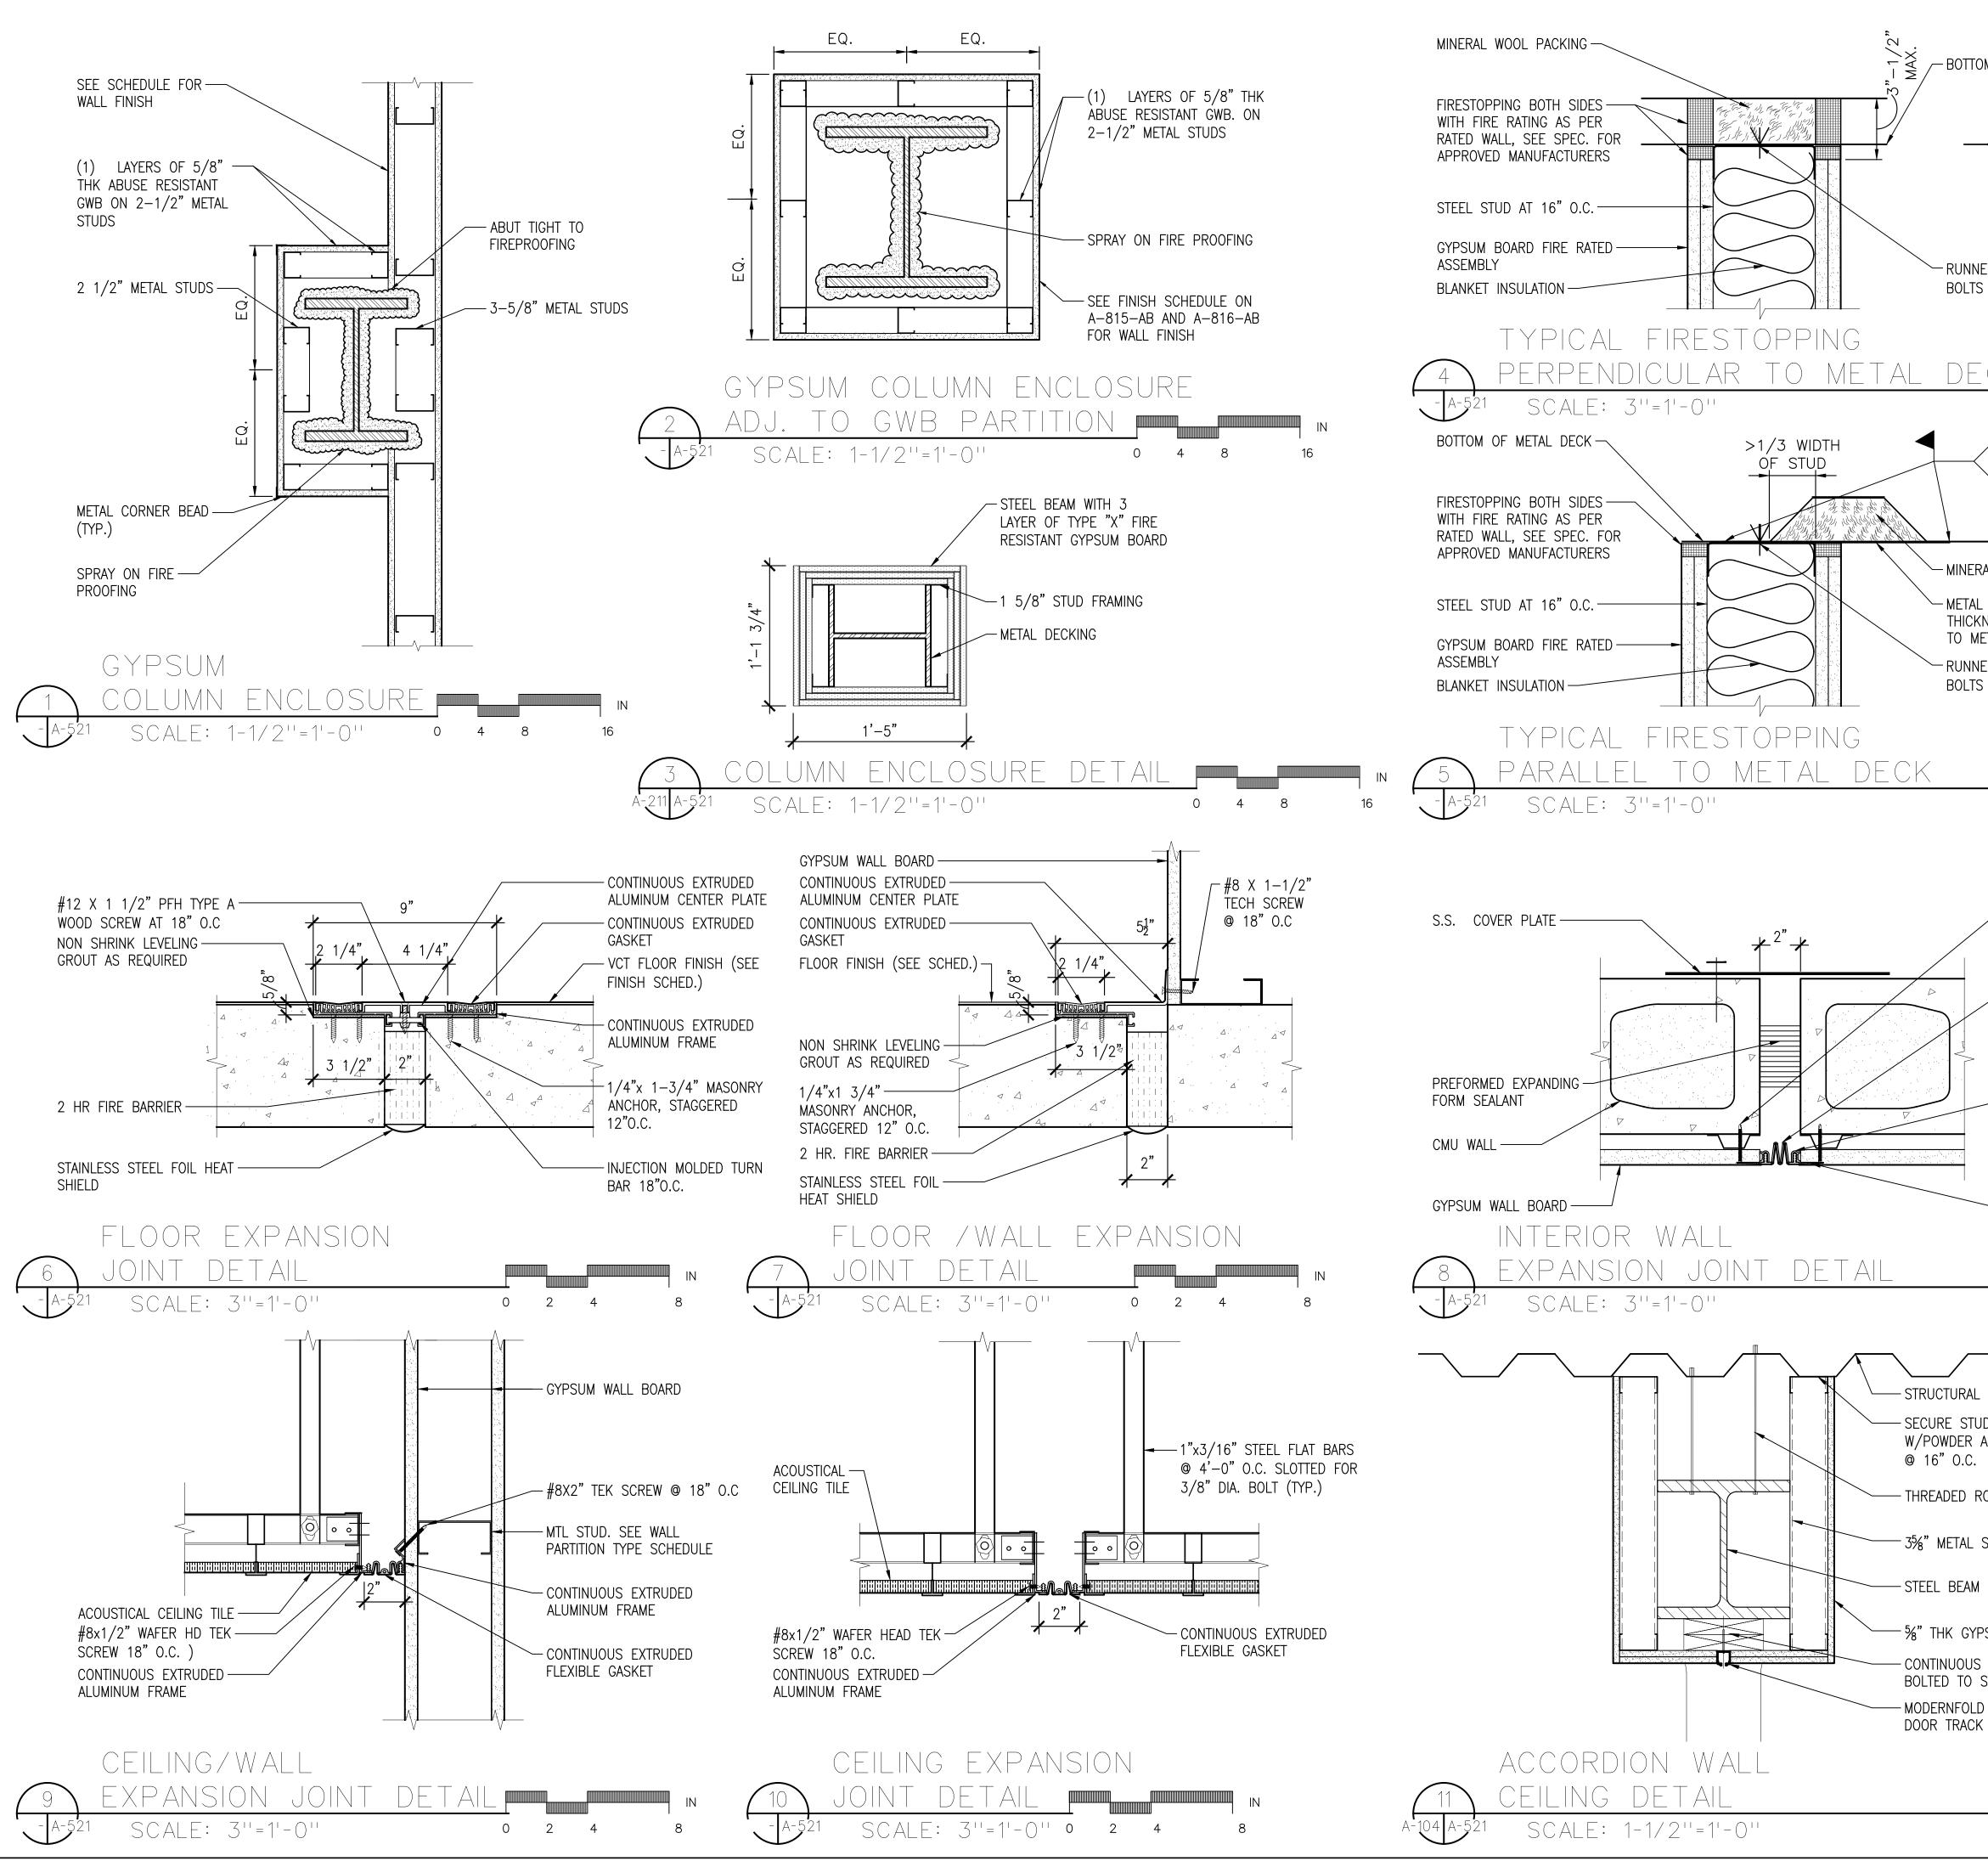- 1. ALL HOLLOW METAL DOORS THICKNESS SHALL BE 1 3/4" U.O.N. 2. WHERE (1) KICKPLATE IS SPECIFIED, INSTALL KICKPLATE ON PUSH
- SIDE OF DOOR IN THE DIRECTION OF TRAVEL.
- 3. REFER TO A-600 SERIES DWGS FOR DOOR DETAILS.

RCHITECT	
Architecture	co + Partners LLP
Landscape Arcl Planning	
	Street, 3rd Floor y, New York 11101 0400
Fax 212-337-3	3567
	Engineering Landscape Land Surveying, PLLC
120 Bedford Ro Armonk, New Y	′ork 10504
Tel 914-273-5 Fax 914-273-2	
IEP ENGINEER	S ENGINEERING, PC.
New Y	ork, New York 10001
Tel 2 TRUCTURAL ENGINEER	212-962-3503
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	DOOR SCHEDULE		LC	DCATION	F	FRAMES	DOOR IN H	ARCHITECT di Domenico + Partners LLP
LOCATION			DOOR FROM	ТО	DETAILS		SIZE LI · I SIZE SIZE SIZE SIZE SIZE SIZE SIZE SI	Architecture
DOOR FROM TO	DETAILS LU SIZE		NO. RM ROOM NAM	IE RM ROOM NAME				Planning
	AD SILL JAMB L & WIDTH WIDTH HEIG	HI TY A REWARKS	NO.	INU.				3743 Crescent Street, 3rd Floor Long Island City, New York 11101
	$\frac{1}{2} = \frac{1}{2} = \frac{1}$	$ \geq $	2ND MEZZANINE AND PARK					Tel 212-337-0400 Fax 212-337-3567
WAREHOUSE FLOOR LEVEL				K 300 EGRESS STAIR A		J2A SF H.M. 10"	3'-0'' A H.M. PTD 90 1	CIVIL PLANNING ENGINEER JMC Planning Engineering Landscape
100 101 20 DUNNIGAN WAREHOUSE 100 EGRESS STAIR A H5 101 100 EGRESS STAIR A 100 NORTH LOADING H10			301 301 PARKING DECI	K 302 EGRESS STAIR B	H2B S1	J2B DF H.M. 11-1/2"	2'-10'' 7'-0'' B H.M. PTD 90 2 DC	OUBLE DR Image: Difference of the structure of the
I IUI IUU EGRESS STAIR A IUZ DOCK			302 305 CORRIDOR	302 EGRESS STAIR B		J5 SF H.M. 11-1/2"	3'-0'' A H.M. PTD 90 1	Armonk, New York 10504 Tel 914-273-5225
102 105 AS/RS WAREHOUSE 103 EGRESS STAIR B H8			303 305 CORRIDOR	303 MANAGERIAL OPS OFFICE	H6 S5	J6 SF H.M. 4-7/8"	2'-10'' 7'-0'' A H.M. PTD NR 5	Fax 914-273-2102
I IUS IUS EGRESS STAIR B IU4 RISER CLOSET HO	3 S3 J8 SF H.M. 7-1/8" 3'-0" 7'-0"	A H.M. PTD 90 3	304 303 MANAGERIAL	304 CONFERENCE ROOM	H6 S5	J6 SF H.M. 4-7/8"	2'-10'' A H.M. PTD NR 5	
104 103 EGRESS STAIR B 102 NORTH LOADING H1E	B S1 J1B SF H.M. 11-1/2" 3'-0" 7'-0"	A H.M. PTD 90 1	305 305 CORRIDOR	304 CONFERENCE ROOM	H6 S5	J6 SF H.M. 4-7/8"	2'-10'' 7'-0'' A H.M. PTD NR 5	BURNS ENGINEERING, PC. 1261 Broadway, Suite 708 New York, New York 10001
105 105 AS/RS WAREHOUSE 106 EGRESS STAIR C H5	5 S2 J5 SF H.M. 11-1/2" 3'-0" 7'-0"	A H.M. PTD 90 1	306 306 MEN'S LOCKE		H6 S5	J6 SF H.M. 4-7/8"	3'-0'' 7'-0'' A H.M. PTD NR 4	Tel 212-962-3503
106 106 EGRESS STAIR C 102 NORTH LOADING H1E	B S1 J1B SF H.M. 11-1/2" 3'-0" 7'-0"	A H.M. PTD 90 1	JANITOR'S	307 MEN'S TOILET	H6 S4		3'-0'' 7'-0'' A H.M. PTD NR	STRUCTURAL ENGINEER GEI50
107107EMERGENCY SERVICE ROOM105AS/RS WAREHOUSEH6	5 S3 J6 SF H.M. 4-7/8" 3'-0" 7'-0"	A H.M. PTD 45 3						1385 Broadway, 20th FL New York, New York 10018
108 107 EMERGENCY SERVICE ROOM 105 WAREHOUSE H6	5 S3 J6 SF H.M. 4-7/8" 3'-0" 7'-0"	A H.M. PTD 45 3	308 307 MEN'S TOILET			J6 SF H.M. 4-7/8"		GEI Consultants New York, New York 10018 Tel 212-687-8282
10910810DUNNIGAN WAREHOUSE109SPRINKLER RISERH7	7 S3 J7 SF H.M. 5-5/8'' 3'-0'' 7'-0''	A H.M. PTD 90 3	309 305 CORRIDOR	309 WOMEN'S TOILET	H6 S4	J6 SF H.M. 4-7/8"		
110 100 SPRINKLER RISER _ EXTERIOR HA	4 S1 J4 SF H.M. 6'' 3'-0'' 7'-0''	A H.M. PTD 90 3	310 305 CORRIDOR	314 LOBBY	H6 S5	J6 SF H.M. 4-7/8"		
111 108 10 DUNNIGAN 111 SPRINKLER	7 S3 J7 SF H.M. 5-5/8'' 3'-0'' 7'-0''		311 312 ELEVATOR VESTIBULE	311 TBD	H6 S5	J6 SF H.M. 4-7/8"	3'-0'' A H.M. PTD NR 4	
III IUO WAREHOUSE III RISER CLOSET H7 SERING SERING SERING SERING SERING SERING			312 314 RECEPTION LOBBY	313 EGRESS STAIR C	H5 S5	J5 SF H.M. 11-1/2"	3'-0'' A H.M. PTD 90 1	Λ^{\prime}
CLOSET - EXTERIOR H4			313 301 PARKING DECI	K 313 EGRESS STAIR C	H2B S1	J2B SF H.M. 11-1/2"	3'-0'' 7'-0'' A H.M. PTD 90 1	BEER DISTRIBUTORS
TIS TIZ SWITCHGEAR ROOM TOO WAREHOUSE HO	S S3 J6 DF H.M. 4-7/8" 3'-8" 7'-0"	A H.M. PTD 45 2 DOUBLE DR	314 301 PARKING DECI	K 314 RECEPTION	STOREFR	RONT @ ENTRANCE	3'-0'' 7'-0'' C ALUM. TBD NR 2 DC	
114115FIRE PUMP ROOM10120 DUNNIGAN WAREHOUSEH7	7 S3 J7 DF H.M. 5-5/8" 3'-0" 7'-0"	B H.M. PTD 90 2 DOUBLE DR	315 315 TBD	312 ELEVATOR VESTIBULE	H6 S3	J6 SF H.M. 3-5/8"	2'-0'' A H.M. PTD TBD 4	TBD MANHATTAN BEER DISTRIBUTOR 20 DUNNIGAN DRIVE
115116AIR COMPRESSION ROOM10120 DUNNIGAN WAREHOUSEH7	7 S3 J7 DF H.M. 5-5/8" 3'-0" 7'-0"	B H.M. PTD 45 2 DOUBLE DR	ADMIN. OFFICE LEVEL	IVESTIDULE				SUFFERN, NEW YORK
116117ELECTRICAL CLOSET10120DUNNIGAN WAREHOUSEH6	5 S3 J6 SF H.M. 4-7/8" 3'-0" 7'-0"		400 401 CATERING HAI	LL 400 EGRESS STAIR B	H5 S5	J5 SF H.M. 11''	3'-0'' 7'-0'' B H.M. PTD 90 2 DC	
117 101 20 DUNNIGAN 114 SOUTH			401 402 PRESENTATION	N 401 CATERING HALL	H6 S5			
119 101 20 DUNNIGAN 119 SPRINKLER				404 CONFERENCE ROOM	H6 S5	J6 SF H.M. 4-7/8"	2'-10'' 7'-0'' A TBD TBD NR 5	
IIO IUI WAREHOUSE IIO RISER CLOSET H7 SPRINKLER SPRINKLER SPRINKLER WEST OADING	7 S3 J7 SF H.M. 5-5/8" 3'-0" 7'-0"		403 403 CORRIDOR	405 OFFICE ''1''		RONT @ CORRIDOR	2'-10'' 7'-0'' D ALUM. TBD NR 5	
CLOSET II9 DOCK	4 S1 J4 SF H.M. 6" 3'-0" 7'-0"	A H.M. PTD 90 3	404 403 CORRIDOR	406 OFFICE "2"	STOREFR	RONT @ CORRIDOR	2'-10'' 7'-0'' D ALUM. TBD NR 5	
12010120DUNNIGAN WAREHOUSE120JANITOR'S CLOSETH6	5 S3 J6 SF H.M. 4-7/8" 3'-0" 7'-0"	A H.M. PTD 45 3	405 403 CORRIDOR 406 414 ADMIN. CENTE	407 OFFICE ''3'' R 408 OFFICE ''4''		RONT © CORRIDOR	2'-10'' 7'-0'' D ALUM. TBD NR 5 2'-10'' 7'-0'' D ALUM. TBD NR 5	
121 101 20 DUNNIGAN WAREHOUSE 121 TOILET H6	S S3 J6 SF H.M. 4-7/8" 3'-0" 7'-0"	A H.M. PTD 45 4	408 414 ADMIN. CENTE 407 414 ADMIN. CENTE			NT @ ADMIN. CENTER	2 -10 7 -0 D ALOM. TBD NR 5 2'-10'' 7'-0'' D ALUM. TBD NR 5	
12210810DUNNIGAN WAREHOUSE122JANITOR'S CLOSETH6	5 S3 J6 SF H.M. 4-7/8'' 3'-0'' 7'-0''	A H.M. PTD 45 3	408 414 ADMIN. CENTE			NT @ ADMIN. CENTER	2'-10'' 7'-0'' D ALUM. TBD NR 5	
123 108 10 DUNNIGAN 123 TOULET	6 S3 J6 SF H.M. 4-7/8'' 3'-0'' 7'-0''	A H.M. PTD 45 4	409 414 ADMIN. CENTE			NT @ ADMIN. CENTER	2'-10'' 7'-0'' D ALUM. TBD NR 5 2'-10'' 7'-0'' D ALUM. TBD NR 5	———————————————————————————————————————
124 124 MECHANICAL ROOM 105 AS/RS			411 412 GSM OFFICE			J6 SF H.M. 4-7/8"	2'-10'' 7'-0'' D ALUM. TBD NR 5	
			412 414 ADMIN. CENTE		STOREFRON	J5 SF H.M. 11''	2'-10'' 7'-0'' D ALUM. TBD NR 5 3'-0'' 7'-0'' R H R 0 2 0	
125 125 MAINTENANCE AREA 108 WAREHOUSE H3			413 414 ADMIN. CENTE 414 414 ADMIN. CENTE		H6 S5	J5 SF H.M. 11'' J6 SF H.M. 4-7/8''	3'-0'' 7'-0'' B H.M. PTD 90 2 DC 3'-0'' 7'-0'' A H.M. PTD 45 3	OUBLE DR
1261010DUNNIGAN WAREHOUSE110EAST LOADING DOCKH3	3 S1 J3 SF H.M. V.I.F. 3'-0'' 7'-0''	A H.M. PTD 45 1	415 414 ADMIN. CENTE	ER 418 ELECT. ROOM		J6 SF H.M. 4-7/8"	3'-0'' 7'-0'' A H.M. PTD 45 3	
127 108 10 DUNNIGAN WAREHOUSE - EXTERIOR H3	3 S1 J3 SF H.M. 6" 3'-0" 7'-0"	A H.M. PTD 45 1	416 414 ADMIN. CENTE		H6 S5			REV DESCRIPTION DAT
1ST MEZZANINE LEVEL			417 422 TOILET VESTIBULE	421 MEN'S TOILET	H6 S4			– ISSUED FOR DOB SUBMISSION 9.10.2
200 204 CORRIDOR 200 EGRESS STAIR B H5			418 422 TOILET VESTIBULE	423 WOMEN'S TOILET	H6 S4	J6 SF H.M. 4-7/8"		– ISSUED FOR BID 10.15
201 204 CORRIDOR 201 OPERATIONS OFFICE	STOREFRONT @ CORRIDOR 2'-10'' 7'-0''	D ALUM. PTD NR 5	419 401 CATERING HAI	LL 424 PANTRY/KITCHEN	H6 S5	J6 DF H.M. 4-7/8" J6 SF H.M. 4-7/8"	2'-10'' 7'-0'' B TBD TBD NR 5 DC 3'-0'' 7'-0'' A H.M. PTD NR 4	UBLE DR - ISSUED FOR CONSTRUCTION 11.30
202203OPERATIONS OFFICE202SETTLEMENT ROOMH6	5 S5 J6 SF H.M. 4-7/8" 2'-10" 7'-0"	A H.M. PTD NR 5	420 424 PANTRT7RTCH		H6 S4			
203204CORRIDOR203OPERATIONS OFFICE	STOREFRONT @ CORRIDOR 2'-10'' 7'-0''	D ALUM. TBD NR 5	ROOF LEVEL	· · · · · · · · · · · · · · · · · · ·	I	I I		
204 204 CORRIDOR 205 DELIVERY	STOREFRONT @ CORRIDOR 2'-10'' 7'-0''		500 501 ADMIN. ROOF	500 EGRESS STAIR B			3'-0'' 7'-0'' A H.M. PTD 90 1	
205 204 CORRIDOR 206 MEN'S TOILET 206 204 CORRIDOR 207 WOMEN'S TOILET	STOREFRONT @ CORRIDOR 2'-10'' 7'-0'' STOREFRONT @ CORRIDOR 2'-10'' 7'-0''		501 501 ADMIN. ROOF	502 EGRESS STAIR C			3'-0'' 7'-0'' A H.M. PTD 90 1 2'-10'' 7'-0'' B H.M. PTD 45 3A DC	DUBLE DR DRAWN BY: S. WOO
208204CORRIDOR207WOMEN'S TOILET207204CORRIDOR209BREAK ROOM	STOREFRONT @ CORRIDOR 2'-10' 7'-0'' STOREFRONT @ CORRIDOR 2'-10'' 7'-0''		502 503 ELECTRICAL CLOSET	502 EGRESS STAIR C	H6 S3	J6 DF H.M. 4-7/8"	2'-10'' 7'-0'' B H.M. PTD 45 3A DC	CHECKED BY : D. TOBAR, R.A.
208 209 BREAK ROOM 208 JANITOR'S ROOM H6	5 S4 J6 SF H.M. 4-7/8" 3'-0" 7'-0"							
209 210 ELEVATOR VESTIBULE 211 EGRESS STAIR C H5	5 S2 J5 SF H.M. 11-1/2" 3'-0" 7'-0"	A H.M. PTD 90 1		DOOR & HAF			ASSEMBLY, WHICH INCLUDES DOORS, DOOR	APPROVED BY : A. BERGER, R.A.
DOOR HARDWARE SETS:				FRAMES AND H	IARDWARE. ALL	COMPONENTS SHALL HA	AVE THE SAME FIRE HOUR RATING.	DATE : 07.30.2021
<u>Set 1</u>	<u>SET 3</u>	<u>SET 4</u>		2. PROVIDE AND I 3. KEYING INFORM		ER STRIPS AND DOOR S	SWEEPS FOR ALL DOORS, TYP.	SCALE : AS NOTED
EMERGENCY EGRESS HARDWARE: SCHLAGE, FUNCTION TBD, FINISH - US32D.	LOCKSET: SCHLAGE MORTISE, STOREROOM FUNC FINISH - US32D.		PASSAGE FUNCTION,	4. VERIFY ALL DI	MENSIONS IN TH		ERING ANY NEW MATERIAL.	DRAWING TITLE :
HINGE: 1 1/2 PAIR STANLEY BALL BEARING HEAVY	HINGE: 1 1/2 PAIR STANLEY BALL BEARING HEAV	Y HINGE: 1 1/2 PAIR STANLEY		5. DOOR AND WIND FOR REVIEW AN		ALL BE 378" THICK TEMPE	ERED LAMINATED OBSCURE GLAZING. PROVIDE SAMPLES	
DUTY BUTT HINGES, FINISH - US32D. CLOSER: LCN HEAVY DUTY, FINISH - SILVER.	DUTY BUTT HINGES, FINISH - US32D. HINGE: LCN HEAVY DUTY, FINISH - SILVER.	HEAVY DUTY BUTT HINGES, FI CLOSER: LCN HEAVY DUTY, F		6. ALL HARDWARE 7. ALL HARDWARE		•		SCHEDULES
SILENCER: IVES.	SILENCER: IVES.	SILENCER: IVES.		8. ALL LOCKSETS	TO BE CYLIND	DRICAL, U.O.N.		
<u>SET 2</u> EMERGENCY EGRESS HARDWARE: SCHLIAGE SURFACE	<u>SET 3A</u> Lockset: schlage mortise, storeroom func ⁻	<u>SET 5</u> TION, LOCKSET: SCHLAGE MORTISE,	OFFICE FUNCTION.			TS AT FIXED LEAF. Shall be accompanie	D WITH THE FOLLOWING HARDWARE, O.U.N.:	DWG NUMBER :
ROD, FUNCTION TBD, FINISH - US32D.	FINISH - US32D FLUSH. FLUSH BOLTS ON FIXED	LEAF. FINISH - US32D.		- (1) SARGENT	20 SERIES RIM	M EXIT DEVICE WITH CY	LINDER AND PULL WITH STOREROOM FUNCTION	
HINGE: 3 PAIR STANLEY BALL BEARING HEAVY DUTY BUTT HINGES, FINISH - US32D.	HINGE: 3 PAIR STANLEY BALL BEARING HEAVY D BUTT HINGES, FINISH - US32D.	UTY HINGE: 1 1/2 PAIR STANLEY HEAVY DUTY BUTT HINGES, FI		- (1) LCN 100(- (3) HEAVY [A-60 ⁻
CLOSER: (2) LCN HEAVY DUTY, FINISH - SILVER.	CLOSER: NONE.	CLOSER: LCN HEAVY DUTY, F		11. ALL DOORS SH	ALL HAVE A YA	ALE HEAVY DUTY LATCH		
SILENCER: IVES.	SILENCER: IVES.	SILENCER: IVES.		12. PROVIDE CAST	ALUMINUM THRE	RESHOLDS AT ALL EXTER	RIOR DOORS.	

												1				1]
			<u>ING</u>	DOOR SC	1		1		DOOR	RM NO	FROM RM NAME	RM N	TO O. RM NAME	DOOF WIDTH		HDWR	REMARKS
DOOR NO.	RM NO	FROM . RM NAME	RM NO	TO . RM NAME		R SIZE	HDWR	REMARKS	EAST \							<u> </u>	
NORTH								1	T42	108	10 DUNNIGAN	112	EAST LOADING	8'-0''	10'-0''	D	
T01	101	20 DUNNIGAN	102	NORTH	9'-0''	10'-0''	A		T43	108	WAREHOUSE 10 DUNNIGAN	112	DOCK EAST LOADING	8'-0''	10'-0''	D	
T02	101	WAREHOUSE 20 DUNNIGAN	102	LOADING DOCK NORTH	9'-0''	10'-0''			T44	108	WAREHOUSE 10 DUNNIGAN	112	DOCK EAST LOADING	8'-0''	10'-0''	D	
	101	WAREHOUSE 20 DUNNIGAN	102	LOADING DOCK NORTH	9'-0''	10'-0''			T45	108	WAREHOUSE 10 DUNNIGAN	112	DOCK EAST LOADING	8'-0''	10'-0''		
	101	WAREHOUSE 20 DUNNIGAN	102	LOADING DOCK NORTH	9'-0''	10'-0''			T46	108	WAREHOUSE 10 DUNNIGAN		DOCK EAST LOADING	8'-0''	10'-0''		
		WAREHOUSE 20 DUNNIGAN		LOADING DOCK NORTH			A				WAREHOUSE 10 DUNNIGAN	112	DOCK EAST LOADING	8'-0''			
	101	WAREHOUSE 20 DUNNIGAN	102	LOADING DOCK NORTH	9'-0''	10'-0''	A		T47	108	WAREHOUSE 10 DUNNIGAN	112	DOCK EAST LOADING		10'-0''	D	
	101	WAREHOUSE 20 DUNNIGAN	102	LOADING DOCK NORTH	9'-0''	10'-0''	A		T48	108	WAREHOUSE 10 DUNNIGAN	112	DOCK EAST LOADING	8'-0''	10'-0''	D	
	101	WAREHOUSE 20 DUNNIGAN	102	LOADING DOCK NORTH	9'-0''	10'-0''	A		T49	108	WAREHOUSE 10 DUNNIGAN	112	DOCK EAST LOADING	8'-0''	10'-0''	D	
	101	WAREHOUSE 20 DUNNIGAN	102	LOADING DOCK	9'-0''	10'-0''	A		T50	108	WAREHOUSE 10 DUNNIGAN	112	DOCK EAST LOADING	8'-0''	10'-0''	D	
	101	WAREHOUSE 20 DUNNIGAN	102	LOADING DOCK	9'-0''	10'-0''	A		T51	108	WAREHOUSE 10 DUNNIGAN	112	EAST LOADING	8'-0''	10'-0''	D	
	101	WAREHOUSE 20 DUNNIGAN	102	LOADING DOCK	9'-0''	10'-0''	A		T52	108	WAREHOUSE 10 DUNNIGAN	112	EAST LOADING	8'-0''	10'-0''	D	
T11	101	WAREHOUSE	102	LOADING DOCK	9'-0''	10'-0''	A		T53	108	WAREHOUSE	112	DOCK	8'-0''	10'-0''	D	
T12	101	20 DUNNIGAN WAREHOUSE	102	NORTH LOADING DOCK	9'-0''	10'-0''	A		T54	108	10 DUNNIGAN WAREHOUSE	112	EAST LOADING DOCK	8'-0''	10'-0''	D	
T13	101	20 DUNNIGAN WAREHOUSE	102	NORTH LOADING DOCK	9'-0''	10'-0''	A		Т55	108	10 DUNNIGAN WAREHOUSE	112	EAST LOADING DOCK	8'-0''	10'-0''	D	
T14	101	20 DUNNIGAN WAREHOUSE	102	NORTH LOADING DOCK	9'-0''	10'-0''	A		Т56	108	10 DUNNIGAN WAREHOUSE	112	EAST LOADING DOCK	8'-0''	10'-0''	D	
T15	101	20 DUNNIGAN WAREHOUSE	102	NORTH LOADING DOCK	9'-0''	10'-0''	A		Т57	108	10 DUNNIGAN WAREHOUSE	112	EAST LOADING DOCK	8'-0''	10'-0''	D	
T16	101	20 DUNNIGAN WAREHOUSE	102	NORTH LOADING DOCK	9'-0''	10'-0''	A		Т58	108	10 DUNNIGAN WAREHOUSE	112	EAST LOADING DOCK	8'-0''	10'-0''	D	
T17	101	20 DUNNIGAN WAREHOUSE	102	NORTH LOADING DOCK	9'-0''	10'-0''	A		Т59	108	10 DUNNIGAN WAREHOUSE	112	EAST LOADING DOCK	8'-0''	10'-0''	D	
T18	101	20 DUNNIGAN WAREHOUSE	102	NORTH LOADING DOCK	9'-0''	10'-0''	A		Т60	108	10 DUNNIGAN WAREHOUSE	112	EAST LOADING DOCK	8'-0''	10'-0''	D	
T19	101	20 DUNNIGAN WAREHOUSE	102	NORTH LOADING DOCK	9'-0''	10'-0''	A		Т87	125	MAINTENANCE AREA	112	EAST LOADING DOCK	TBD	TBD	TBD	
Т20	101	20 DUNNIGAN WAREHOUSE	102	NORTH LOADING DOCK	9'-0''	10'-0''	A		Т88	108	10 DUNNIGAN WAREHOUSE	125	MAINTENANCE AREA	8'-0''	9'-0''	TBD	
T21	101	20 DUNNIGAN WAREHOUSE	102	NORTH LOADING DOCK	9'-0''	10'-0''	A		WEST	WALL							
T22	101	20 DUNNIGAN WAREHOUSE	102	NORTH LOADING DOCK	9'-0''	10'-0''	A		Т65	101	20 DUNNIGAN WAREHOUSE	119	WEST LOADING DOCK	9'-0''	10'-0''	С	
Т23	101	20 DUNNIGAN WAREHOUSE	102	NORTH LOADING DOCK	9'-0''	10'-0''	A		Т66	101	20 DUNNIGAN WAREHOUSE	119	WEST LOADING	9'-0''	10'-0''	С	
T24	101	20 DUNNIGAN WAREHOUSE	102	NORTH LOADING DOCK	9'-0''	10'-0''	A		Т67	101	20 DUNNIGAN	119	WEST LOADING	9'-0''	10'-0''	С	
T25	101	20 DUNNIGAN WAREHOUSE	102	NORTH LOADING DOCK	9'-0''	10'-0''	A		Т68	101	WAREHOUSE 20 DUNNIGAN	119	DOCK WEST LOADING	9'-0''	10'-0''	B	EXISTING
Т26	101	20 DUNNIGAN WAREHOUSE	102	NORTH LOADING DOCK	9'-0''	10'-0''	A		Т69	101	WAREHOUSE 20 DUNNIGAN	119	DOCK WEST LOADING	9'-0''	10'-0''	В	EXISTING
T27	101	20 DUNNIGAN	102	NORTH	9'-0''	10'-0''	A		T70	101	WAREHOUSE 20 DUNNIGAN	119	DOCK WEST LOADING	9'-0''	10'-0''	В	EXISTING
T28	101	WAREHOUSE 20 DUNNIGAN	102	LOADING DOCK	9'-0''	10'-0''	A		T71	101	WAREHOUSE 20 DUNNIGAN	119	DOCK WEST LOADING	9'-0''	10'-0''	B	EXISTING
T29	101	WAREHOUSE 20 DUNNIGAN	102	LOADING DOCK	9'-0''	10'-0''	A		T72	101	WAREHOUSE 20 DUNNIGAN	119	DOCK WEST LOADING	9'-0''	10'-0''	C C	
	101	WAREHOUSE 20 DUNNIGAN	102	LOADING DOCK	9'-0''	10'-0''	A		T73	101	WAREHOUSE 20 DUNNIGAN	119	DOCK WEST LOADING	9'-0''	10'-0''	c c	
	105	WAREHOUSE AS/RS	102	LOADING DOCK NORTH	11'-6''	11'-8''	F		T74	101	WAREHOUSE 20 DUNNIGAN	119	DOCK WEST LOADING	9'-0''	10'-0''	c c	
	105	WAREHOUSE AS/RS	102	LOADING DOCK NORTH	9'-0''	10'-0''	A				WAREHOUSE 20 DUNNIGAN		DOCK WEST LOADING	9'-0''			
	105	WAREHOUSE AS/RS	102	LOADING DOCK	9'-0''	10'-0''			T75	101	WAREHOUSE 20 DUNNIGAN	119	DOCK WEST LOADING	9'-0''	10'-0''	C	
T34	105	WAREHOUSE AS/RS	102	LOADING DOCK NORTH	9'-0''	10'-0''			T76	101	WAREHOUSE 20 DUNNIGAN	119	DOCK WEST LOADING		10'-0''	C	
	105	WAREHOUSE AS/RS	102	LOADING DOCK NORTH	9'-0''	10'-0''			T77	101	WAREHOUSE 20 DUNNIGAN	119	DOCK WEST LOADING	9'-0''	10'-0''	C	
	105	WAREHOUSE AS/RS		LOADING DOCK NORTH	9'-0''	10'-0''			T78	101	WAREHOUSE 20 DUNNIGAN	119	WEST LOADING	9'-0''	10'-0''	B	EXISTING
		WAREHOUSE AS/RS	102	LOADING DOCK NORTH			A		T79	101	WAREHOUSE 20 DUNNIGAN	119	WEST LOADING	9'-0''	10'-0''	B	EXISTING
	105	WAREHOUSE AS/RS	102	LOADING DOCK NORTH	9'-0''	10'-0''	A			101	WAREHOUSE 20 DUNNIGAN	119	WEST LOADING	9'-0''	10'-0''	B	EXISTING
	105	WAREHOUSE AS/RS	102	LOADING DOCK	9'-0''	10'-0''	A		T81	101	WAREHOUSE	119	DOCK	9'-0''	10'-0''	В	EXISTING
	105	WAREHOUSE AS/RS	102	LOADING DOCK	9'-0''	10'-0''	A		T82	101	20 DUNNIGAN WAREHOUSE	119	WEST LOADING DOCK	9'-0''	10'-0''	В	EXISTING
	105	WAREHOUSE AS/RS	102	LOADING DOCK	9'-0''	10'-0''	A		Т83	101	20 DUNNIGAN	119	WEST LOADING	9'-0''	10'-0''	В	EXISTING
T41	105	WAREHOUSE	102	LOADING DOCK	9'-0''	10'-0''	A				WAREHOUSE		DOCK	<u> </u>			
SOUTH	WALL	40.000				1	1		T84	101	20 DUNNIGAN WAREHOUSE	119	WEST LOADING DOCK	9'-0''	10'-0''	В	EXISTING
T61	105	AS/RS WAREHOUSE	114	SOUTH PLATFORM	9'-0''	10'-0''	E		Т85	101	20 DUNNIGAN	119	WEST LOADING	9'-0''	10'-0''	В	EXISTING
Т62	105	AS/RS WAREHOUSE	114	SOUTH PLATFORM	9'-0''	10'-0''	E				WAREHOUSE	J	DOCK	3-0-			
Т63	101	20 DUNNIGAN WAREHOUSE	114	SOUTH PLATFORM	9'-0''	10'-0''	E		Т86	101	20 DUNNIGAN WAREHOUSE	119	WEST LOADING DOCK	V.I.F.	V.I.F.	В	EXISTING
Т64	101	20 DUNNIGAN WAREHOUSE	114	SOUTH PLATFORM	9'-0''	10'-0''	E		L			1	I				

HARDWARE SCHEDULE:

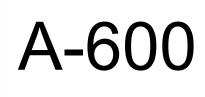HDWR "A"

DOORS T01- T30, T32-T41

- UNIACCESS 72" WIDE CUSTOM EDGE OF DOCK TRANSITION PLATE**
- CONTROLS
- BLUE GIANT INSIDE AND OUTSIDE LED LIGHT COMMUNICATION PACKAGE

• UNIACESS MDE-1000 42" MODULAR DOCK EXTENSION • UNIACCESS - PAIR OF 6" X 46" YELLOW SAFETY BOLLARDS** **AT OPENINGS THAT WILL HAVE NEW CONCRETE FLOOR POURED - CONTRACTOR TO PROVIDE 4"X4" X 3/4" STEEL ANGLE IN LIEU OF TRANSITION PLATES & INTERLOCKING BOLLARD SLEEVES

HDWR "B"

- DOORS T68-T71, T78-T85
- EXISTING PERFORMAX MAXDOCK™ 9' X 10'
- SHIELDOK CLIMA-SHELTER™ HEAVY DUTY SOFT-SIDED DOCK SHELTER
- UNIACCESS 72" WIDE CUSTOM EDGE OF DOCK TRANSITION PLATE**
- CONTROLS

 BLUE GIANT INSIDE AND OUTSIDE LED LIGHT COMMUNICATION PACKAGE • UNIACCESS MLEB - CUSTOM MAXON LIFT EXTENSION BRACKET FOR VEHICLE RESTRAINT SYSTEM **AT OPENINGS THAT WILL HAVE NEW CONCRETE FLOOR POURED – CONTRACTOR TO PROVIDE 4"X4" X $\frac{3}{4}$ " STEEL ANGLE IN LIEU OF TRANSITION PLATES

HDWR "C"

HDWR "D"

DOORS T42-T60

CONTROLS

HDWR "E"

HDWR "F"

DOORS T61-T64

ACTIVATION: TWO MOTION DETECTORS

INTERLOCKING BOLLARD SLEEVES

DOOR T31 EXTERIOR MOUNT

EXTERIOR OF OPENING

COILING DOOR NOTES:

MASTER OPERATOR

DOORS T65- T67, T72-T77

- SHIELDOK CLIMA-SHELTER™ HEAVY DUTY SOFT-SIDED DOCK SHELTER
- UNIACCESS 72" WIDE CUSTOM EDGE OF DOCK TRANSITION PLATE**

- CONTROLS
- BLUE GIANT INSIDE AND OUTSIDE LED LIGHT COMMUNICATION PACKAGE
- UNIACCESS MLEB CUSTOM MAXON LIFT EXTENSION BRACKET FOR VEHICLE RESTRAINT SYSTEM

• UNIACCESS - PAIR OF 6" X 46" YELLOW SAFETY BOLLARDS** **AT OPENINGS THAT WILL HAVE NEW CONCRETE FLOOR POURED - CONTRACTOR TO PROVIDE 4"X4" X 🕉" STEEL ANGLE IN LIEU OF TRANSITION PLATES & INTERLOCKING BOLLARD SLEEVES

1. ALL DIMENSIONS SHALL BE VERIFIED PRIOR TO FABRICATION.

• UNIACCESS - PAIR OF 6" X 46" YELLOW SAFETY BOLLARDS**

• ACTIVATION – 3 BUTTON CONTROL STATION

• CORNELL THERMISER 11'-6" X 11'-8" INSULATED MOTORIZED ROLLING STEEL DOOR MOUNTED ON

**AT OPENINGS THAT WILL HAVE NEW CONCRETE FLOOR POURED - CONTRACTOR TO PROVIDE

• UNIACCESS - PAIR OF 6" X 46" YELLOW SAFETY BOLLARDS**

• PERFORMAX – MAXSPEED 12' X 10' DIRECT DRIVE – INDUSTRIAL DUTY RUBBER ROLL-UP DOOR

**AT OPENINGS THAT WILL HAVE NEW CONCRETE FLOOR POURED - CONTRACTOR TO PROVIDE 4"X4" X 🕉" STEEL ANGLE IN LIEU OF TRANSITION PLATES & INTERLOCKING BOLLARD SLEEVES

• UNIACCESS - PAIR OF 6" X 46" YELLOW SAFETY BOLLARDS**

 BLUE GIANT INSIDE AND OUTSIDE LED LIGHT COMMUNICATION PACKAGE • UNIACESS MDE-1000 42" MODULAR DOCK EXTENSION

• BLUE GIANT STRONGARM SVR303 SWING-UP ARM STYLE VEHICLE RESTRAINT SYSTEM & BLUE GENIUS

• SHIELDOK CLIMA-SHELTER™ HEAVY DUTY SOFT-SIDED DOCK SHELTER • BLUE GIANT MD CM HEAVY DUTY MECHANICAL EDGE OF DOCK LEVELERS - 30K LB - 15" PROJECTION • UNIACCESS - 72" WIDE CUSTOM EDGE OF DOCK TRANSITION PLATE**

• PERFORMAX MAXDOCK™ 8' X 10' - INDUSTRIAL DUTY RUBBER ROLL-UP DOOR - SPRUNG WITH LIFT

• BLUE GIANT MD CM HEAVY DUTY MECHANICAL EDGE OF DOCK LEVELERS - 30K LB - 15" PROJECTION • BLUE GIANT STRONGARM SVR303 SWING-UP ARM STYLE VEHICLE RESTRAINT SYSTEM & BLUE GENIUS


• PERFORMAX MAXDOCK™ 9' X 10' DIRECT DRIVE – INDUSTRIAL DUTY RUBBER ROLL-UP DOOR

• BLUE GIANT STRONGARM SVR303 SWING-UP ARM STYLE VEHICLE RESTRAINT SYSTEM & BLUE GENIUS

• BLUE GIANT MD CM HEAVY DUTY MECHANICAL EDGE OF DOCK LEVELERS - 30K LB - 15" PROJECTION

• BLUE GIANT STRONGARM SVR303 SWING-UP ARM STYLE VEHICLE RESTRAINT SYSTEM & BLUE GENIUS • UNIACCESS MLEB - CUSTOM MAXON LIFT EXTENSION BRACKET FOR VEHICLE RESTRAINT SYSTEM

• PERFORMAX MAXDOCK™ 9'X 10' DIRECT DRIVE – INDUSTRIAL DUTY RUBBER ROLL-UP DOOR • SHIELDOK CLIMA-SHELTER™ HEAVY DUTY SOFT-SIDED DOCK SHELTER • BLUE GIANT MD CM HEAVY DUTY MECHANICAL EDGE OF DOCK LEVELERS - 30K LB - 15" PROJECTION

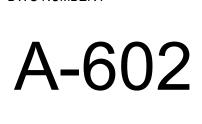

DWG NUMBER :

COILING DOOR SCHEDULE

DRAWING TITLE :

- 15	SSUED	FOR	CONST	RUCTION	11.30.21
DRAWN BY	:		S.	WOO	
CHECKED I	BY :		D.	TOBAR, F	R.A.
APPROVED) BY :		Α.	BERGER,	R.A.
DATE :			07.	30.2021	
SCALE :			AS	NOTED	

REV	DESCRIPTION	DATE
_	ISSUED FOR DOB SUBMISSION	9.10.21
_	ISSUED FOR BID	10.15.21
_	ISSUED FOR CONSTRUCTION	11.30.21

REV	DESCRIPTION	DATE
_	ISSUED FOR DOB SUBMISSIO	N 9.10.21
_	ISSUED FOR BID	10.15.21

REV	DESCRIPTION	DATE
_	ISSUED FOR DOB SUBMISSION	9.10.21
_	ISSUED FOR BID	10.15.21

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ARCHITECT

di Domenico + Partners LLP


JMC Planning Engineering Landscape


Architecture & Land Surveying, PLLC

Architecture Landscape Architecture Planning 3743 Crescent Street, 3rd Floor Long Island City, New York 11101 Tel 212-337-0400


Fax 212-337-3567


120 Bedford Road

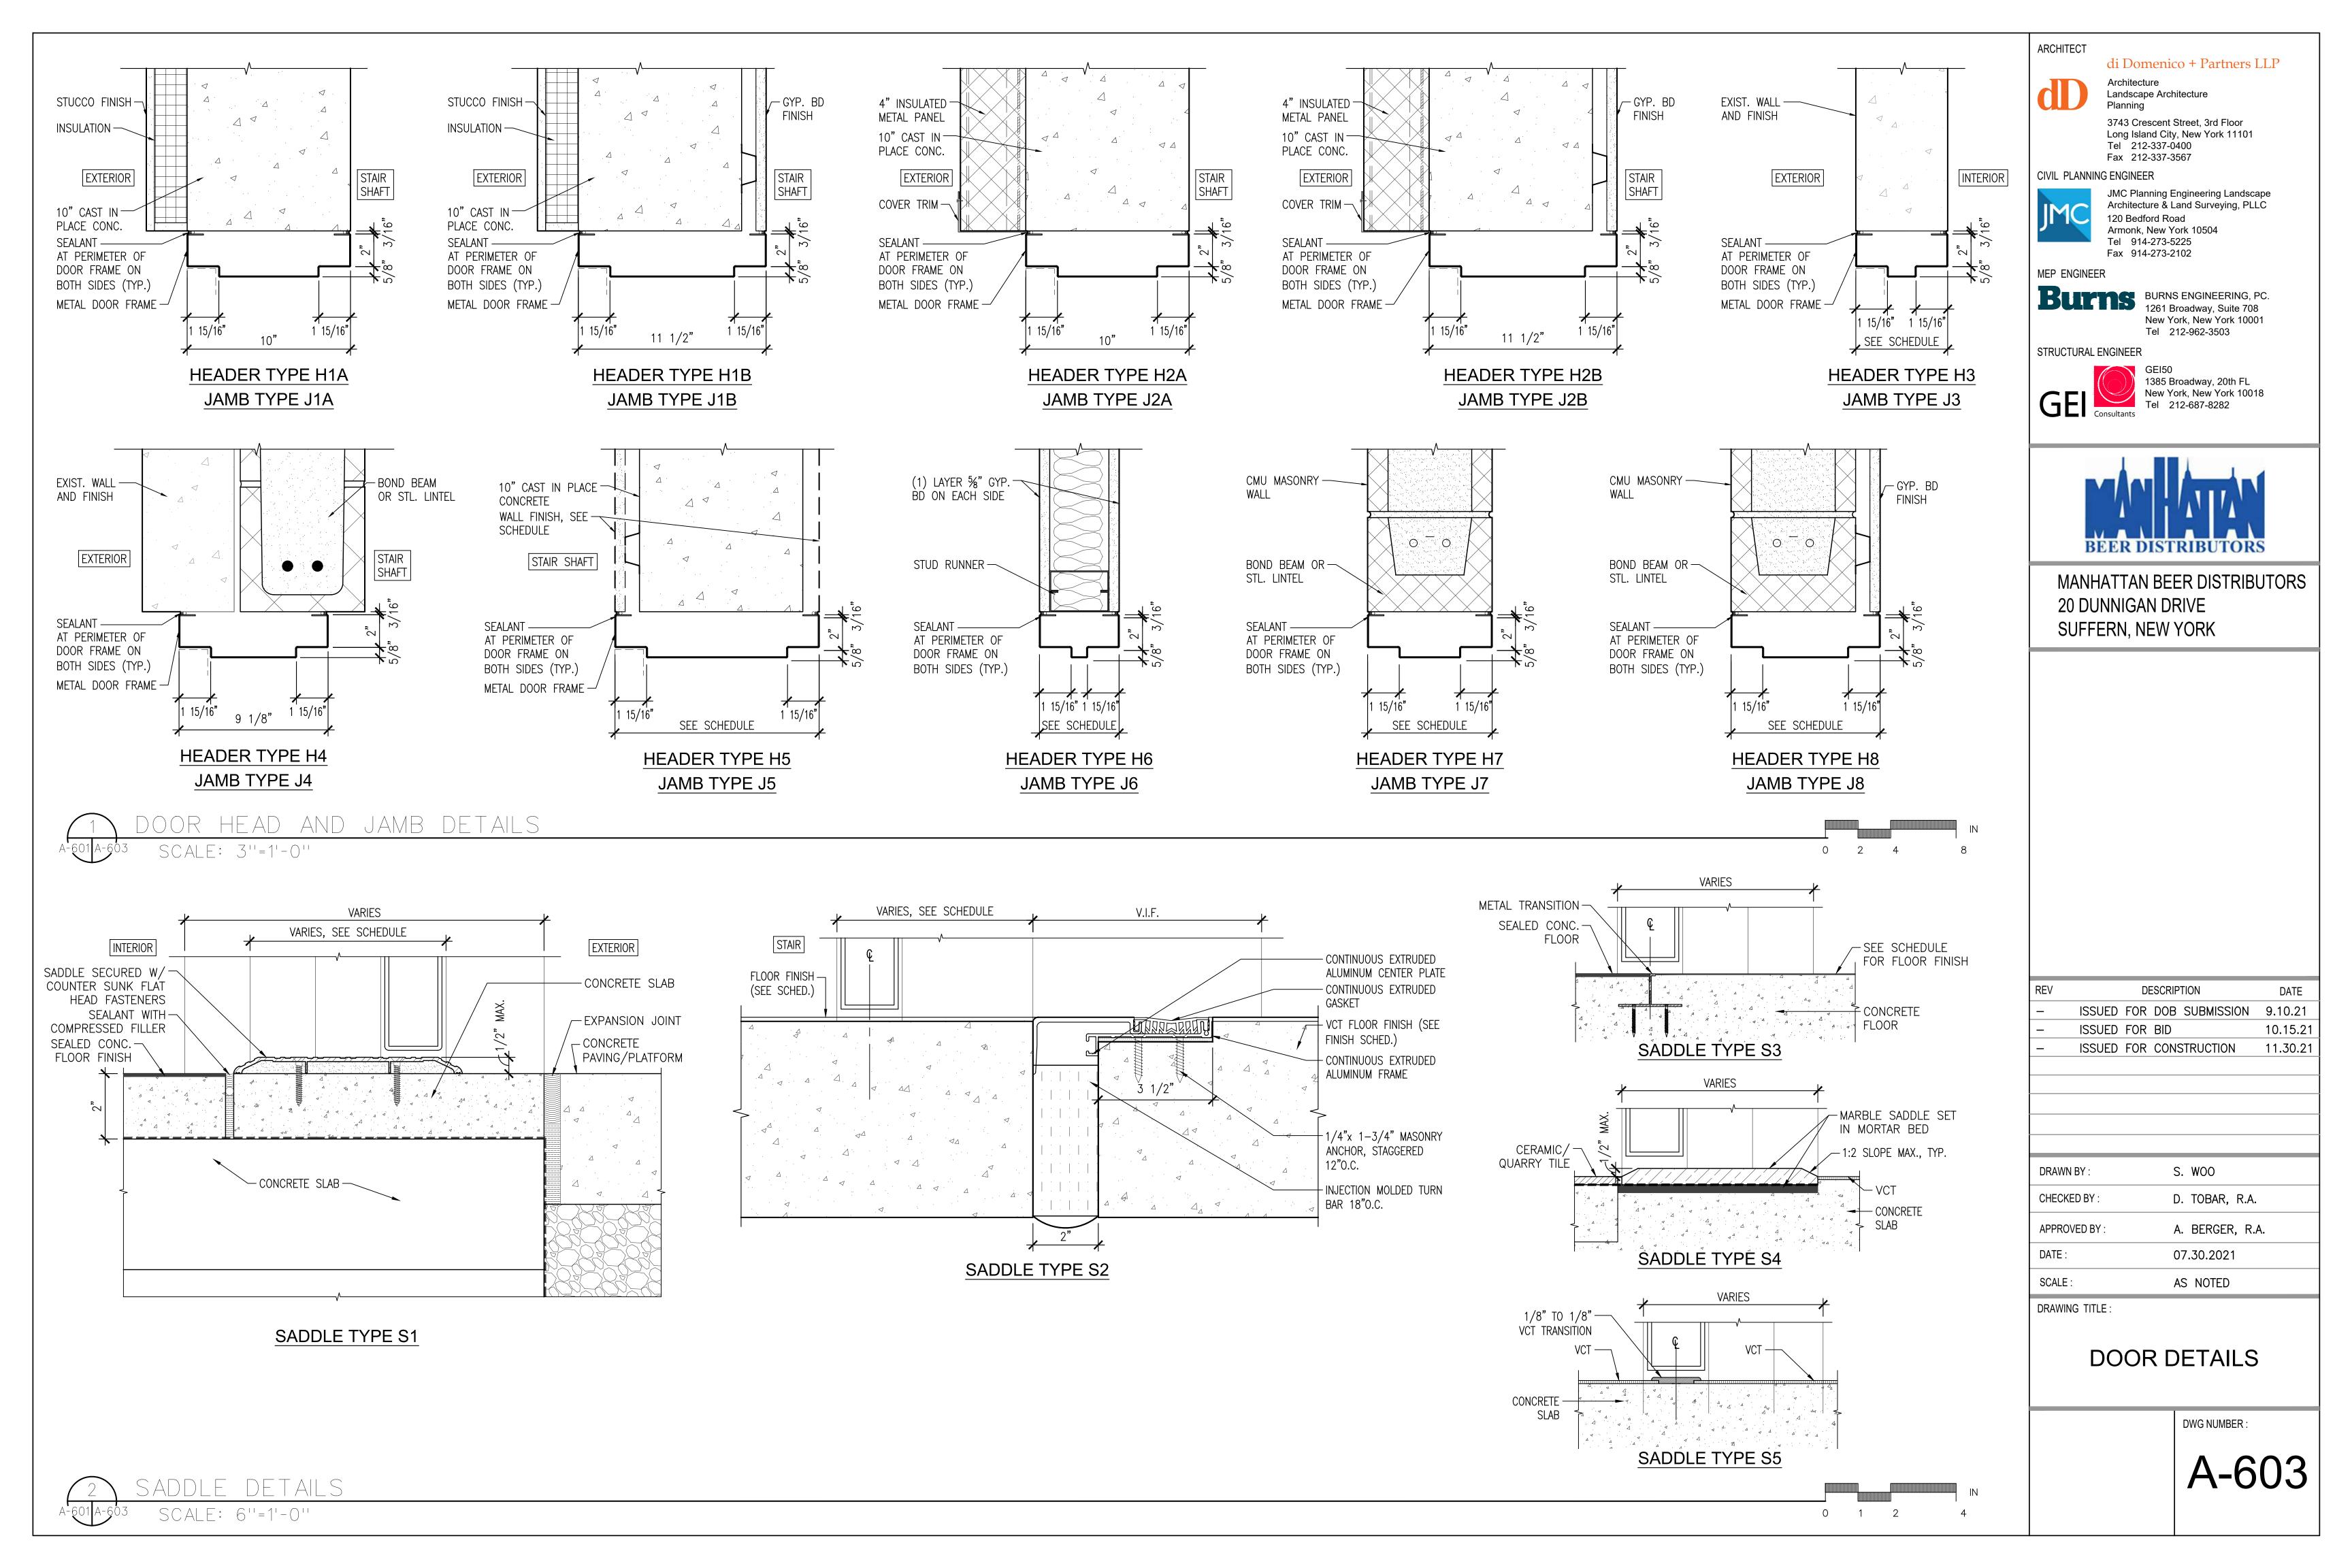

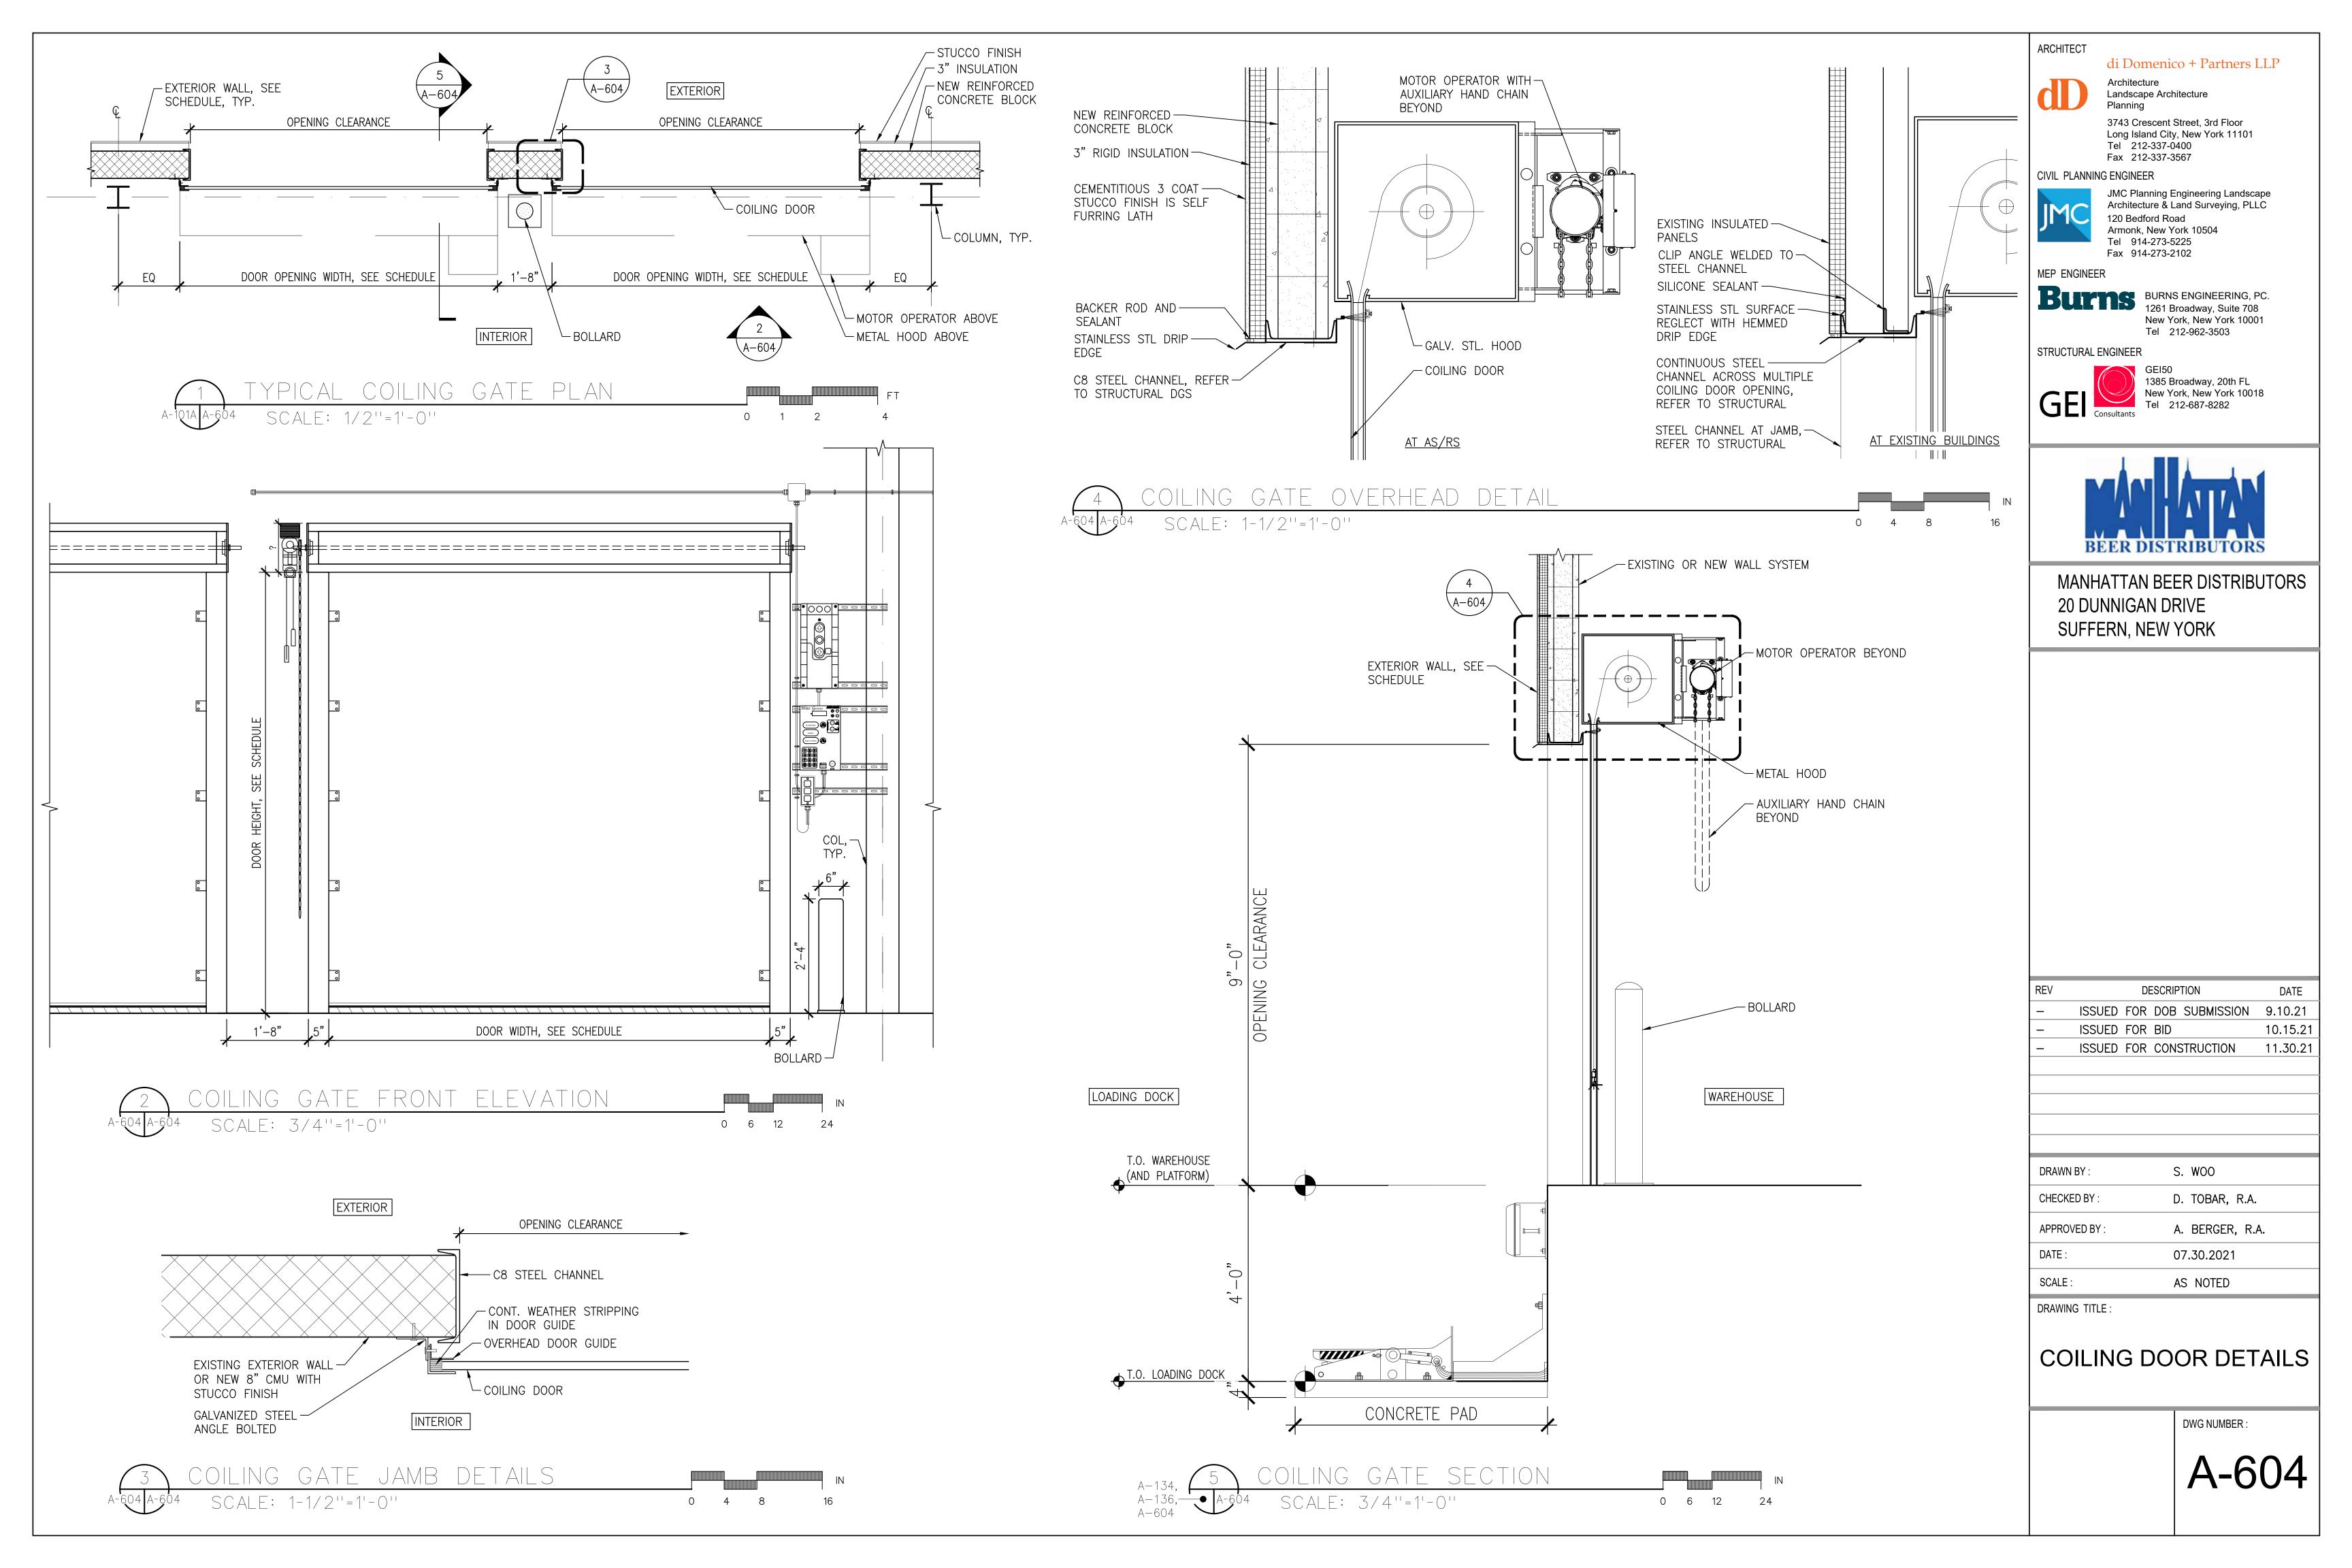

						\backslash	V IN D O	W S	SCHE	DULE						
NDOW	WINDOW		LOCATION	FRAME	ROUGH	OPENING	SILL HT. ABOVE		DETAI	LS	FIRE	OPERABLE	SHADES	MFR./	GLASS	
NO.	TYPE	RM	RM. NAME	MATERIAL	WIDTH	HEIGHT	FIN. FL.	HEAD	JAMB	SILL/	RATED (MINS)	(Y/N)	BLINDS	MODEL#	TYPE	REMARKS
	 Anine leve	<u> NO.</u>					(V.I.F.)			THRESHOLD						
200		201	OPERATIONS OFFICE	ALUMINUM	3'-8''	3'-2''	3'-0''	WH3	WJ3	WS3	NR	Y	N	_	В	
201	B	201	OPERATIONS OFFICE	ALUMINUM	3'-8''	3'-2''	3'-0''	WH3	WJ3	WS3	NR	Ý	N		B	
202	В	201	OPERATIONS OFFICE	ALUMINUM	3'-8''	3'-2''	3'-0''	WH3	WJ3	WS3	NR	Y	Ν	-	В	
203	В	201	OPERATIONS OFFICE	ALUMINUM	3'-8''	3'-2''	3'-0''	WH3	WJ3	WS3	NR	Y	Ν	_	В	
204	B		OPERATIONS OFFICE		3'-8"	3'-2"	3'-0"	WH3	WJ3	WS3	NR	Y	<u>N</u>	-	B	
205 206	B	203	OPERATIONS OFFICE BREAK ROOM	ALUMINUM ALUMINUM	3'-8'' 3'-8''	3'-2'' 3'-2''	3'-0'' 3'-0''	WH3 WH3	WJ3 WJ3	WS3 WS3	NR NR	Y Y	N	-	B	
200	B		BREAK ROOM	ALUMINUM	3'-8''	3'-2"	3'-0''	WH3	WJ3	WS3	NR	Ý	N	_	B	
208	В	209		ALUMINUM	3'-8''	3'-2''	3'-0''	WH3	WJ3	WS3	NR	Y	Ν	-	В	
209	В	209	BREAK ROOM	ALUMINUM	3'-8''	3'-2''	3'-0''	WH3	WJ3	WS3	NR	Y	Ν	-	В	
210	С	205	DELIVERY	ALUMINUM	2'-4''	3'-2''	3'-0''		STOREFR		NR	N	N	TBD		TELLER WINDOW
211		205			2'-4''	3'-2''	3'-0'' 3'-0''		STOREFR		NR	N	N	TBD		TELLER WINDOW
212 213		205	DELIVERY DELIVERY	ALUMINUM ALUMINUM	2'-4'' 3'-8''	3'-2'' 3'-2''	3'-0"	WH4	STOREFR	WS4	NR NR	N	<u> </u>	TBD -	D C	TELLER WINDOW
213	A		DELIVERY	ALUMINUM	3'-8''	3'-2''	3'-0''	WH4	WJ4	WS4	NR	N	N	_	C	
215	A		EGRESS STAIR C	ALUMINUM	3'-0''	4'-0''	3'-0''	WH1	WJ1	WS1	NR	N	N	_	A	
) MEZZ	ANINE LEVE	ĒL														
300	A	302	EGRESS STAIR B	ALUMINUM	3'-0''	4'-0''	3'-0''	WH1	WJ1	WS1	NR	Ν	Ν	-	A	
301	В	303	MANAGERIAL OPS OFFICE	ALUMINUM	3'-8''	3'-2''	3'-0''	WH3	WJ3	WS3	NR	Y	Y	_	В	
302	B	303	MANAGERIAL OPS	ALUMINUM	3'-8''	3'-2''	3'-0''	WH3	WJ3	WS3	NR	Y	Y		В	
303	В	303	OFFICE MANAGERIAL OPS OFFICE	ALUMINUM	3'-8''	3'-2''	3'-0''	WH3	WJ3	WS3	NR	Y	N		В	
304	В	303	MANAGERIAL OPS OFFICE	ALUMINUM	3'-8''	3'-2''	3'-0''	WH3	WJ3	WS3	NR	Y	Ν	-	В	
305	В	304	CONFERENCE ROOM	ALUMINUM	3'-8''	3'-2''	3'-0''	WH3	WJ3	WS3	NR	Y	Ν		В	
306	В	304	CONFERENCE ROOM	ALUMINUM	3'-8''	3'-2''	3'-0''	WH3	WJ3	WS3	NR	Y	Ν	-	В	
307	A	313	EGRESS STAIR C	ALUMINUM	3'-0''	4'-0''	3'-0''	WH1	WJ1	WS1	NR	N	Ν	-	A	
308	A	313	EGRESS STAIR C	ALUMINUM	3'-0''	4'-0''	3'-0''	WH1	WJ1	WS1	NR	Ν	Ν	_	A	@ LANDING 2
309	A		EGRESS STAIR B		4'-0''	4'-0''	3'-0"	WH1	WJ1	WS1	NR	N	<u>N</u>	-	A	
310 /IN. OFF	FICE LEVEL		EGRESS STAIR B	ALUMINUM	4'-0''	4'-0''	3'-0''	WH1	WJ1	WS1	NR	N	Ν	_	A	
400	В		CONFERENCE ROOM	ALUMINUM	4'-6''	4'-0''	3'-0''	WH2	WJ2	WS2	NR	Y	Y	_	A	
401	B		CONFERENCE ROOM	ALUMINUM	4'-6''	4'-0''	3'-0''	WH2	WJ2	WS2 WS2	NR	Ý	Y	_	A	
402	В		PRESENTATION HALL	ALUMINUM	4'-6''	4'-0''	3'-0''	WH2	WJ2	WS2	NR	Y	Y	_	A	
403	В		PRESENTATION HALL	ALUMINUM	4'-6''	4'-0''	3'-0''	WH2	WJ2	WS2	NR	Y	Y	_	A	
404	A		EGRESS STAIR B		3'-0''	4'-0''	3'-0''	WH1	WJ1	WS1	NR	N	N	_		@ LANDING 3
405 406	A	400	EGRESS STAIR B EGRESS STAIR C	ALUMINUM ALUMINUM	3'-0'' 3'-0''	4'-0'' 4'-0''	3'-0'' 3'-0''	WH1 WH1	WJ1 WJ1	WS1 WS1	NR NR	N N	<u> </u>	-	A	
406	A		EGRESS STAIR C	ALUMINUM	3'-0"	4'-0''	3'-0"	WH1 WH1	WJ1	WS1 WS1	NR NR	N	N N			@ LANDING 3
408	B		GSM OFFICE 2	ALUMINUM	4'-6''	4'-0''	3'-0''	WH2	WJ2	WS2	NR	Y	Y		A	
409	В	427	TOILET	ALUMINUM	4'-6''	4'-0''	3'-0''	WH2	WJ2	WS2	NR	Y	Y	-	A	
410	В	412		ALUMINUM	4'-6''	4'-0''	3'-0''	WH2	WJ2	WS2	NR	Y	Y	-	A	
411	B		GSM OFFICE 1		4'-6''	4'-0''	3'-0''	WH2	WJ2	WS2	NR	Y	Y	-	A	
412 413	B		OFFICE "7" OFFICE "6"	ALUMINUM ALUMINUM	4'-6''	4'-0'' 4'-0''	3'-0'' 3'-0''	WH2 WH2	WJ2 WJ2	WS2 WS2	NR NR	Y	<u> </u>	-	A A	
414	B		OFFICE '5''	ALUMINUM	4'-6''	4'-0''	3'-0''	WH2 WH2	WJ2	W32 WS2	NR	Y	N	-	A	
415	B		OFFICE "4"	ALUMINUM	4'-6''	4'-0''	3'-0''	WH2	WJ2	WS2	NR	Ý	N	-	A	
416	В	407	OFFICE "3"	ALUMINUM	4'-6''	4'-0''	3'-0''	WH2	WJ2	WS2	NR	Y	Ν	-	A	
417	В		OFFICE "2"	ALUMINUM	4'-6''	4'-0''	3'-0''	WH2	WJ2	WS2	NR	Y	Ν	-	A	
418	B	405		ALUMINUM	4'-6''	4'-0''	3'-0''	WH2	WJ2	WS2	NR	Y	<u>N</u>	_	A	
419		1	CONFERENCE ROOM	ALUMINUM	4'-6''	4'-0''	3'-0''	WH2	WJ2	WS2	NR	Υ Υ	N	-	A	
	FICE LEVEL	_					<u> </u>		· · · · ·	···	· · -				i	
500	A				3'-0''	4'-0''	3'-0''	WH1	W J1	WS1	NR	N	N	-		@ LANDING 4
501 502	A	500 500	EGRESS STAIR B EGRESS STAIR B	ALUMINUM ALUMINUM	3'-0''	4'-0'' 4'-0''	3'-0'' 3'-0''	WH1 WH1	WJ1 WJ1	WS1 WS1	NR NR	N N	<u> </u>		A	
503	A		EGRESS STAIR C	ALUMINUM	4'-0''	4'-0''	3'-0''	WH1	WJ1	WS1	NR	N	N	_	A	
		_	EGRESS STAIR C	ALUMINUM	3'-0''	4'-0''	3'-0''	WH1	WJ1		NR				· ·	

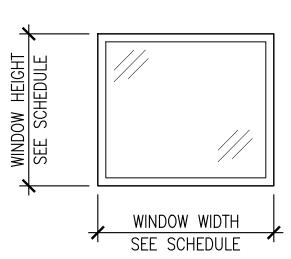


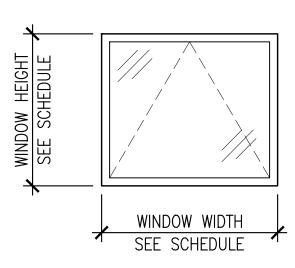

WINDOW TYPE B

WINDOW TYPES - A-605

WINDOW TYPE A

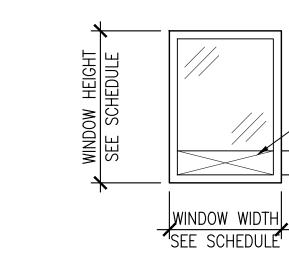

- PROVIDE 6" HIGH OPENING W/ EASED EDGÉS

WINDOW TYPE C

FRONT/CURTAIN WALL GLAZING								
ATION	FRAME	GLASS						
M. NAME	MATERIAL	TYPE	REMARKS					
1 ST MEZZANINE - STOREFRONT/CURTAIN WALL								
TIONS OFFICE	ALUMINUM	В						
)OR	ALUMINUM	С	PRIVACY AREA SHALL BE OPAQUE SOLID					
ROOM	ALUMINUM	В						
2 ST MEZZANINE	E - STOREFR	ONT/CURT	AIN WALL					
	ALUMINUM	В						
	ALUMINUM	В						
ADMIN. OFFICE - STOREFRONT/CURTAIN WALL								
Y/KITCHEN	ALUMINUM	В						
CENTER	ALUMINUM	А						

ED GLAZING UNITS WINDOWS IN FIXED AND OPERABLE FRAMES AND DOORS

ED GLAZING UNITS WINDOWS BETWEEN ADMIN AND WAREHOUSE

ED GLAZING UNITS FIXED GLAZING AND DOORS BETWEEN OFFICES

PERED GLASS ION WINDOWS AT SETTLEMENT OFFICE

ERIOR GLASS SHALL HAVE VISIBLE LIGHT TRANSMITTANCE (VLT) HAN 40% AND A SOLAR HEAT GAIN COEFFICIENT (SHGC) OF NO

'B' GLASS


GLAZING UNITS SHALL BE FORMED OF TWO SHEETS OF GLASS BY A 7/16" DEHYDRATED AIR SPACE, HERMETICALLY HE UNITS SHALL CONFORM TO ASTM E774 AND 773, CLASS A. NNER LIGHT SHALL BE TEMPERED 1/4" THICK GLASS, KIND PE I, CLASS 1, ASTM C1048, CONFORMING TO CPSC 16 201 AND ANSI Z 97.1. AT TYPE 'A' GLASS. PROVIDE A LOWE CONTROL COATING (SOLARBAN 70 BY VITRO (PPG) OR OVED EQUAL). DUTER LIGHT SHALL BE HEAT


GTHENED 5/16" THICK, CLEAR, KIND HS, LAMINATED , CONFORMING TO CPSC 16 CFR-1201 AND ANSI Z97.1. AMINATED GLASS SHALL CONSIST OF TWO 1/8" THICK PANELS AMINATED TOGETHER WITH A 0.060 INCH PÓLYVINYL BUTYRAL LEAR INTERLAYER.

GLAZING UNITS SHALL BE FORMED OF TWO SHEETS OF GLASS) BY A 1/2'' DEHYDRATED AIR SPACE, HERMETICALLY HE UNITS SHALL CONFORM TO ASTM E774 AND 773, CLASS A. NNER AND OUTER LIGHTS SHALL BE TEMPERED 1/4" THICK , KIND FT, TYPE I, CLASS 1, ASTM C1048, CONFORMING TO 16 CFR-1201 AND ANSI Z 97.1.

ENGTHENED 9/16" THICK, CLEAR, KIND HS, LAMINATED DNFORMING TO CPSC 16 CFR-1201 AND ANSI Z97.1. ATED GLASS SHALL CONSIST OF TWO 1/4" THICK PANELS ATED TOGETHER WITH A 0.060 INCH PÓLYVINYL BUTYRAL CLEAR

ARCHITECT	di Dor	nenico ·	+ Partners 1	LLP
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			et, 3rd Floor ew York 11101	
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JMC	120 Bedf	ure & Lanc ord Road New York	I Surveying, PLI	_C
	Tel 914	-273-5225 -273-2102	5	
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STRUCTURAL E		Tel 212-9	962-3503	
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– ISSU	ED FOR	CONST	RUCTION	11.30.21
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DRAWN BY : CHECKED BY :			WOO TOBAR, R.A.	
APPROVED BY	:		BERGER, R.	
DATE :			30.2021	
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			RC)OM	FINISH	SCHED)ULE								MATERI			1	
					MATE					RM NO.	. ROOM NAME	FLOOF	R BASE	CEILING	NORTH	EAST	WEST	SOUTH	REMARKS
RM NO.	ROOM NAME	FLOO	R BASE	CEILIN		EAST	WEST	SOUTH	REMARKS		FFICE LEVEL				WALL	WALL	WALL	WALL	
			IN DAJL		WALL	WALL	WALL	WALL			EGRESS STAIR B	RBT	VB	PNT	PNT	PNT	PNT	PNT	
WAREHOU	SE FLOOR LEVEL									401	CATERING HALL	CPT	VB	ACT	PNT	-	PNT	PNT	
100	EGRESS STAIR A	RBT	VB	PNT	PNT	PNT	PNT	PNT		402	PRESENTATION ROOM	СРТ	VB	PNT	PNT	FW	PNT	PNT	
101	20 DUNNIGAN WAREHOUSE	EXT	-	EXT	EXT	-	EXT	EXT		403	CORRIDOR	СРТ	VB	ACT	SFT	PNT	PNT	PNT	
103	EGRESS STAIR B	RBT	VB	PNT	PNT	PNT	PNT	PNT		404	CONFERENCE ROOM	CPT	VB	ACT	PNT	PNT	PNT	PNT	
104	SPRINKLER RISER CLOSET	EXT	PNT	PNT	PNT	PNT	PNT	PNT		405	OFFICE "1"		VB	ACT	PNT	PNT	PNT	SFT	
105	AS/RS WAREHOUSE	SC		PNT	PNT		_	PNT		406	OFFICE "2" OFFICE "3"	CPT CPT	VB	ACT ACT	PNT PNT	PNT PNT	PNT PNT	SFT SFT	
106	EGRESS STAIR C	RBT	VB	PNT	PNT	PNT	PNT	PNT		408	OFFICE "4"		VB	ACT	PNT	PNT	PNT	SFT	
107	EMERGENCY SERVICE	SC	VB	PNT	PNT	PNT	PNT	PNT		409	OFFICE "5"	CPT	VB	ACT	PNT	PNT	PNT	SFT	
	ROOM 10 DUNNIGAN									410	OFFICE "6"	СРТ	VB	ACT	PNT	PNT	PNT	SFT	
108	WAREHOUSE	EXT	-	EXT	EXT	EXT	-	EXT		4 11	OFFICE "7"	СРТ	VB	ACT	PNT	PNT	PNT	SFT	
109	SPRINKLER RISER	CF	VB	PNT	PNT	PNT	PNT	PNT		412	GSM OFFICE 1	CPT	VB	ACT	PNT	PNT	SFT/PNT	PNT	
111	SPRINKLER RISER	CF	VB	PNT	PNT	PNT	PNT	PNT			GSM OFFICE 2	CPT CPT	VB	ACT PNT	PNT SFT	PNT SFT/PNT	SFT	PNT PNT	
112	CLOSET SWITCHGEAR ROOM	CF	VB	PNT	PNT	PNT	PNT	PNT		414	ADMIN. CENTER EGRESS STAIR C	RBT	VB	PNT	PNT	PNT	PNT	PNT	
115	FIRE PUMP ROOM	CF	VB	PNT	PNT	PNT	PNT	PNT			ELEVATOR VESTIBULE	RBT	VB	PNT	PNT	-	PNT	PNT	
116	AIR COMPRESSION ROC	M CF	VB	PNT	PNT	PNT	PNT	PNT		417	IT ROOM	VCT	VB	ACT	PNT	PNT	PNT	PNT	
117	ELECTRICAL CLOSET	CF	VB	PNT	PNT	PNT	PNT	PNT			ELECTRICAL ROOM	VCT	VB	ACT	PNT	PNT	PNT	PNT	
118	SPRINKLER RISER	CF	VB	PNT	PNT	PNT	PNT	PNT		419	STORAGE	CPT	VB	ACT	PNT	PNT	PNT	PNT	
120	CLOSET JANITOR'S CLOSET	PTF	PTB	PNT	CT/PNT	CT/PNT	CT/PNT	CT/PNT	CT 48" HIGH A.F.F.	420	COPY ROOM	VCT PTF	VB	ACT					
121	TOILET	PTF	PTB	PNT	CT/PNT	CT/PNT	CT/PNT	CT/PNT	CT 48" HIGH A.F.F.	421	MEN'S TOILET TOILET VESTIBULE	CPT	PTB VB	ACT PNT	CT/PNT PNT	CT/PNT	CT/PNT	CT/PNT PNT	CT 48" HIGH A.F.F.
122	JANITOR'S CLOSET	PTF	РТВ	PNT	CT/PNT	CT/PNT	CT/PNT	CT/PNT	CT 48" HIGH A.F.F.	423	WOMEN'S TOILET	PTF	PTB	ACT	CT/PNT	CT/PNT	CT/PNT	CT/PNT	CT 48" HIGH A.F.F.
123	TOILET	PTF	РТВ	PNT	CT/PNT	CT/PNT	CT/PNT	CT/PNT	CT 48" HIGH A.F.F.	424	PANTRY/KITCHEN	VCT	VB	ACT	PNT	PNT	PNT	SFT/PNT	
	MECHANICAL ROOM	CF	VB	PNT	PNT	PNT	PNT	PNT		425	LACTATION ROOM	VCT	VB	ACT	PNT	PNT	PNT	PNT	
	MAINTENANCE AREA		-	EXT	EXT	EXT	EXT	EXT		426	TOILET	PTF	PTB	ACT	CT/PNT	CT/PNT	CT/PNT	CT/PNT	CT 48" HIGH A.F.F.
	ZANINE LEVEL										TOILET	PTF	PTB	ACT	CT/PNT	CT/PNT	CT/PNT	CT/PNT	CT 48" HIGH A.F.F.
	EGRESS STAIR B	RBT	VB	PNT				PNT		ROOF LE			i	i					
	OPERATIONS OFFICE SETTLEMENT ROOM	CPT CPT	VB VB	PNT PNT	PNT/SFT SFT	PNT PNT	PNT/SFT PNT	PNT PNT			EGRESS STAIR B	RBT	VB	PNT	PNT	PNT	PNT	PNT	
202	OPERATIONS OFFICE		VB	PNT	PNT/SFT	PNT/SFT	PNT	PNT		501	ADMIN. ROOF	CWD	-	PNT	- PNT		- PNT	- PNT	
204	CORRIDOR	CPT	VB	PNT	PNT	PNT	PNT	SFT			EGRESS STAIR C ELECTRICAL CLOSET	RBT VCT	VB VB	PNT	PNT	PNT PNT	PNT	PNT	
205	DELIVERY	СРТ	VB	PNT	SFT	PNT	PNT	PNT			ELEVATOR VESTIBULE	CPT	VB	PNT	PNT		PNT	PNT	
206	MEN'S TOILET	VCT	VB	PNT	SFT	CT/PNT	CT/PNT/SF		CT 48" HIGH A.F.F.										
207	WOMEN'S TOILET		VB	PNT	CT/PNT	CT/PNT	CT/PNT		CT 48" HIGH A.F.F.										
208	JANITOR'S ROOM	VCT VCT	VB VB	PNT PNT	CT/PNT SFT	CT/PNT SFT	CT/PNT PNT	CT/PNT PNT	CT 48" HIGH A.F.F.										
	BREAK ROOM ELEVATOR VESTIBULE	CPT	VB	PNT	PNT	PNT	PNI -	SET											
	EGRESS STAIR C	RBT	VB	PNT	PNT	PNT	PNT	PNT											
	EGRESS STAIR A	RBT	VB	PNT	PNT	PNT	PNT	PNT											
2ND MEZ	ZANINE AND PARKING DI	ECK																	
300	EGRESS STAIR A	RBT	VB	ACT	PNT	PNT	PNT	PNT											
302	EGRESS STAIR B	RBT	VB	ACT	PNT	PNT	PNT	PNT								Note	<u>ES:</u>		
303	MANAGERIAL OPS OFFICE	СРТ	VB	ACT	PNT	PNT	PNT	PNT		NT	ERIOR FINISH	H SCH	HEDUL	E LE	GEND			AT STAIRS, I	REFER TO STAIR DETAIL
304	CONFERENCE ROOM	СРТ	VB	ACT	PNT	PNT	PNT	PNT									RAWINGS.		
305	CORRIDOR	CPT	VB	ACT	PNT	PNT	PNT	PNT		ACT CF	ACOUSTICAL CEILING		HT BROOM	FINISH		2. WH AF	HERE MORE PPEARS ON	THAN ONE FI FINISH SCHED	NISHED MATERIAL/ASSEMBLY DULES, REFER TO DETAILS FOF
306	MEN'S LOCKER ROOM	PTF	РТВ	PNT	CT/PNT	CT/PNT	CT/PNT	CT/PNT	CT 48" HIGH A.F.F.	CPT	CARPET TILE						ROPER COO	RDINATION, IF	OULES, REFER TO DETAILS FOR DISCREPANCIES EXIST BETWEE AILS, DETAILS CONTROL.
307	MEN'S TOILET	PTF	PTB	PNT	CT/PNT	CT/PNT	CT/PNT	CT/PNT	CT 48" HIGH A.F.F.	СТ	CERAMIC TILE								
308	JANITOR'S CLOSET	PTF	PTB	PNT		CT/PNT	CT/PNT	CT/PNT	CT 48" HIGH A.F.F.	CWD	COMPOSITE WOOD	DECKING				J. AN SC	CHEDULES S	SHALL ASSEMBL	LIES NOT CALLED ON FINISH E PAINT FINISH.
309	WOMEN'S TOILET WOMEN'S LOCKER ROO		PTB PTB	PNT PNT	CT/PNT CT/PNT	CT/PNT CT/PNT	CT/PNT CT/PNT	CT/PNT CT/PNT	CT 48" HIGH A.F.F. CT 48" HIGH A.F.F.	EP	NON-SLIP EPOXY)		4. AL	L JOINT FI	NISH MATERIAL	S INCLUDING CAULKS.
310 311	TBD									EXT	EXISTING FINISH					SE	EALANTS, G Trips shai	ROUTS, MORT	S INCLUDING CAULKS, AR AND PREFORMED FILLER UP FOR APPROVAL AND FINA
	ELEVATOR VESTIBULE	PTF	VB	ACT	PNT	PNT	-	PNT		FW M.E.X	ACCORDION FOLD					CC	OLOR SELE	CTION BY ARC	CHITECT.
	EGRESS STAIR C	RBT	VB	PNT	PNT	PNT	PNT	PNT		PP	PAINTED PLASTER					5. CA	ARPET AND	VCT SHALL E	BE INSTALLED OVER SELF
	RECEPTION LOBBY	PTF	PTB	ACT	SFT	PNT	SFT	PNT	SEE NOTE 6	PNT	PAINT						EVELING UN EMBRANE.	UERLAYMENT.	TILES OVER CRACK ISOLATION
315	TBD									PTB	PORCELAIN TILE	(BASE)						CTRIC RADIANT	T HEAT UNDER TILE, IN ENTIRE
										PTF	PORCELAIN TILE	(FLOOR)					OBBY AREA		THERE ONDER THEE, IN LINTING

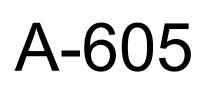ACT	ACOUSTICAL CEILING TILE
CF	CONCRETE FLOOR WITH LIGHT BROOM FINISH
СРТ	CARPET TILE
СТ	CERAMIC TILE
CWD	COMPOSITE WOOD DECKING
EP	NON-SLIP EPOXY PAINT (COLOR: GRAY)
EXT	EXISTING FINISH TO REMAIN
FW	ACCORDION FOLDING WALL
M.E.X.	FINISH TO MATCH EXISTING
PP	PAINTED PLASTER
PNT	PAINT
РТВ	PORCELAIN TILE (BASE)
PTF	PORCELAIN TILE (FLOOR)
RBT	RUBBER TILE
SC	STRUCTURAL CONCRETE
SFT	STOREFRONT/CURTAIN WALL
VB	VINYL WALL BASE
VCT	VINYL COMPOSITION TILE
WB	PAINTED WOOD BASE

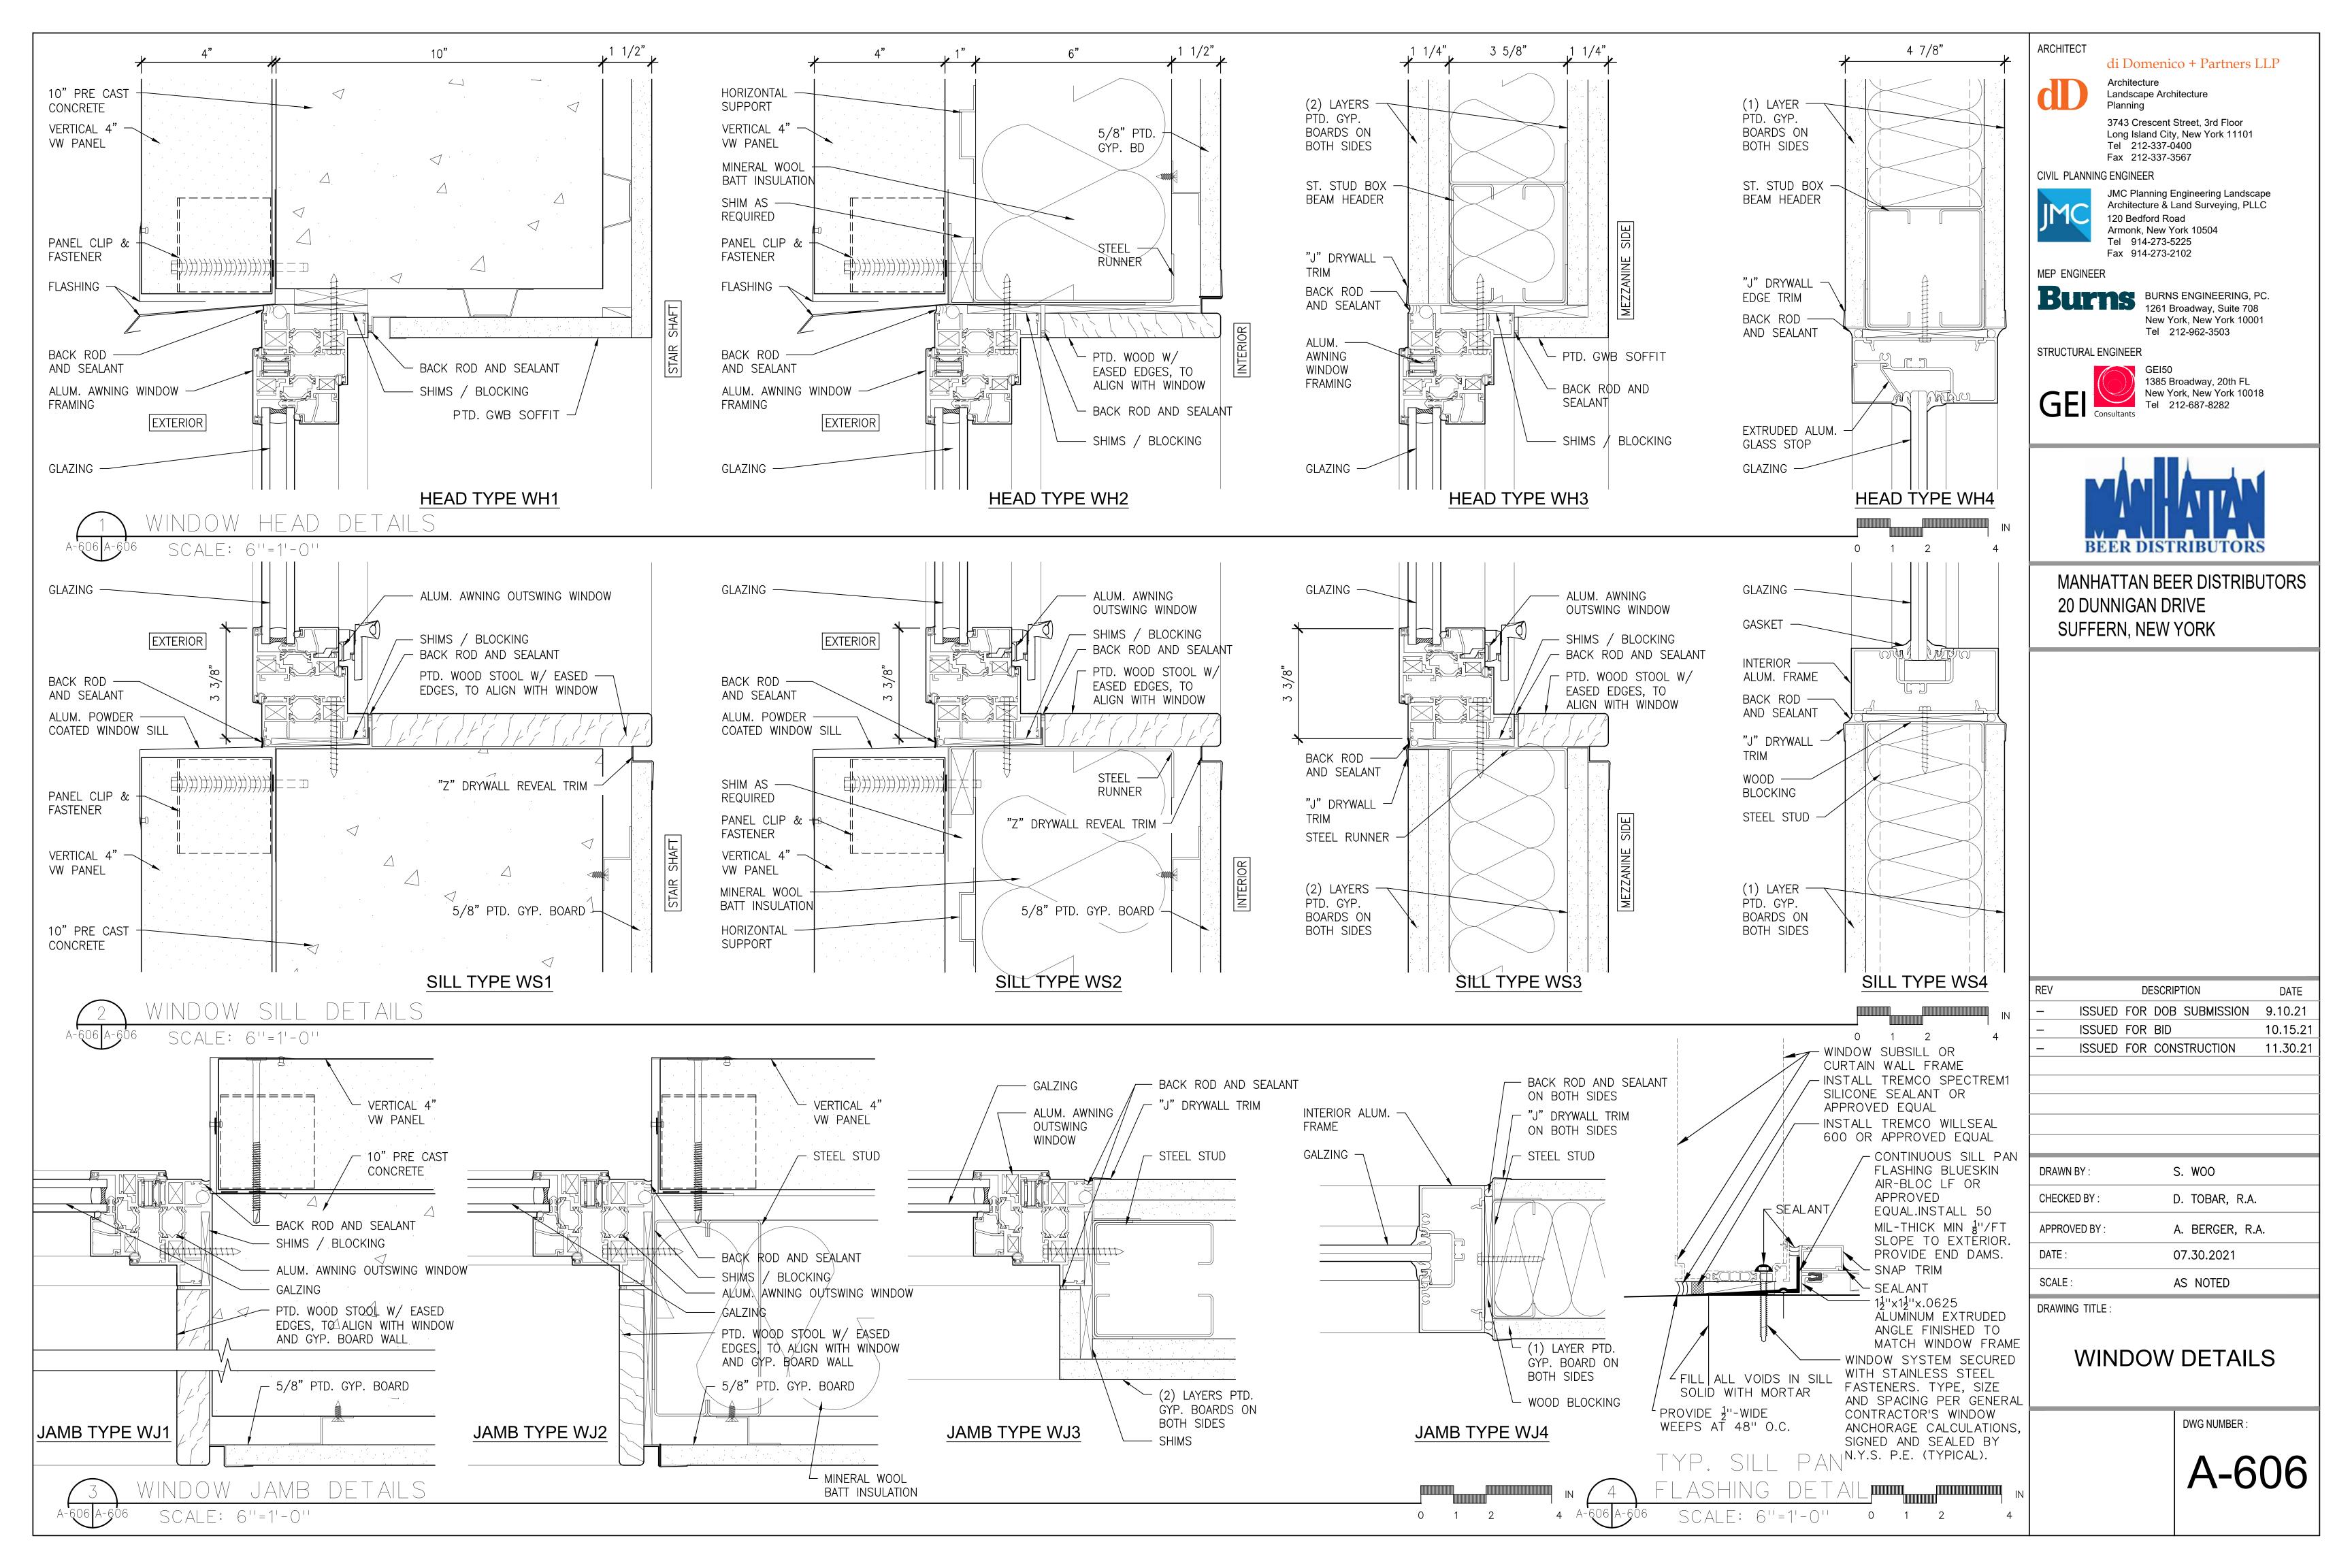ARCHITECT



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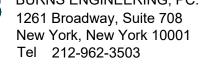
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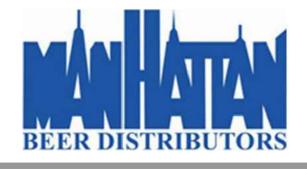




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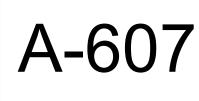
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-	ISSUED FOR DOB SUBMISSION	9.10.21
_	ISSUED FOR BID	10.15.21
-	ISSUED FOR CONSTRUCTION	11.30.21

DRAWN BY :	S. WOO
CHECKED BY :	D. TOBAR, R.A.
APPROVED BY :	A. BERGER, R.A.
DATE :	07.30.2021
SCALE :	AS NOTED

DRAWING TITLE :

ROOM FINISH SCHEDULE




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AV 22 29.82 58.838 0.850 SM-LC COUNDALL GYTTMO PELOTON HIGH PERFORMANCE HIGH BY PELOTON HIGH BY PELOTON HIGH BY	s	SYMBOL	LABEL	QTY	LUM. WATTS	LUM. LUMENS	LLF	ARRANGEMENT	MANUFACTURER	DESCRIPTION	MODEL NUMBER	REMARKS
A B Contract A Contract A Contract A Proceed on the Proceed on		4	AN	34	229.55	35493	0.850	SINGLE	COLUMBIA LIGHTING	PELOTON HIGH PERFORMANCE HIGH BAY	PEL4-40MX-FAN-EDU	
Bit Bit <td></td> <td>4</td> <td>AW</td> <td>22</td> <td>229.62</td> <td>35869</td> <td>0.850</td> <td>SINGLE</td> <td>COLUMBIA LIGHTING</td> <td>PELOTON HIGH PERFORMANCE HIGH BAY</td> <td>PEL4-40MX-FAW-EDU</td> <td></td>		4	AW	22	229.62	35869	0.850	SINGLE	COLUMBIA LIGHTING	PELOTON HIGH PERFORMANCE HIGH BAY	PEL4-40MX-FAW-EDU	
ハトビオ パロ シンク SNALE COLUMBAL LIGHTMG PELOTON HIGH PERFORMANCE HIGH PAY PEL-400X-FAX-EDU SEE NOTE BEAU 11 8.5 120 SNALE COLUMBAL LIGHTMG PELOTON HIGH PERFORMANCE HIGH PAY PEL-400X-FAX-EDU SEE NOTE DEFICI NUMEX 11 8.5 120 1000 SNALE COLUMBAL LIGHTMG MPELATON HIGH PERFORMANCE HIGH PAY REMAIN FRANCE SEE NOTE DFFICI NUMEX 10 SNALE COLUMBAL LIGHTMG PELATON HIGH PERFORMANCE HIGH PAY REMAIN FRANCE SEE NOTE 1 10 16.4 21 16.4 1000 SNALE COLUMBAL LIGHTMG PELATON HIGH PERFORMANCE HIGH PAY REMAIN FRANCE SNALE COLUMBAL LIGHTMG PELATON PAY REMAIN FRANCE SNALE COLUMBAL LIGHTMG PELATON PAY REMAIN FRANCE PELATON PAY REMAIN FRANCE PELATON PAY PELATON PAY REMAIN FRANCE PELATON PAY			A	6			0.850	SINGLE	COLUMBIA LIGHTING	PELOTON HIGH PERFORMANCE HIGH BAY	PEL2-40MH-FAW-EDU	
AV-EM 14 228.42 4158 1.00 BINGLE COLUMBAL LIGHT MA PELOTON HIGH PERFORMANCE HIGH BAX VPEL4 40%X FAXY EDU SEE NOTE FIFTER LAWE MEDICE AND MEZZAMMES 100 100 3NOLE COLUMBAL LIGHT MA MPEL4 MONACH MEDIL SEE NOTE SEE NOTE 100 100 3NOLE COLUMBAL LIGHT MA BENCHE DECORTINE LOW DAY. BLB add M-FAMILED DI HUB 10:0* AF.F. SEE NOTE 101 30 0.000 SNOLE COLUMBAL LIGHT MA BENCHE DECORTINE LOW DAY. BLB add M-FAMILED DI HUB 10:0* AF.F. SEE NOTE 10 30.4 2000 SNOLE COLUMBAL LIGHT MA BENCHE DECORTINE LOW DAY. BENCHE DECORTINE LIGHT MA BENCHE DECORTINE LIGHT MA<		\	B4	29	26.5	3174	0.850	SINGLE	COLUMBIA LIGHTING	MPS MULTIPURPOSE LINEAR	MPS4-40VW-FW-EDU	
Brief 11 28.5 1210 1.000 SINGLE COLUMBRA LIDENTING MPS-MOUTE AVMENT VERSU SEE NOTE CHICK AUXIMI OFFICE AVMENANCES UNING 1001 SINGLE COLUMBRA LIDENTING REVERIE DECORATIONE LOW BAY REAd. M.FAALUS EDU HUNG 1001 A.F.E. C LP1 85 11.3 1093 0.900 SINGLE COLUMBRA LIDENTING REVERIE DECORATIONE LOW BAY REAd. M.FAALUS EDU HUNG 1001 A.F.E. C LP1 85 11.3 1093 0.900 SINGLE COLUMBRA LIDENTING READ. TATE REPORT LIDENTING READ. M.FAALUS EDU HUNG 1001 A.F.E. SA 1.3 1.3 1.3 2.000 SINGLE COLUMBRA LIDENTING READ. TATE REPORT LIDENTING READ. READ. MES-400/W-W-EDU LIDENTING READ. READ. SA 1.3 1.3 1.93 0.800 SINGLE COLUMBRA LIDENTING READ. LIDENTING READ. READ. MES-400/W-W-WEDU LIDENTING READ. READ. V LFLEM 35 1.3 1.93 0.800 SINGLE COLUMBRA LIDENTING READ.		÷	AN-EM	32	229.62	4156	1.000	SINGLE	COLUMBIA LIGHTING	PELOTON HIGH PERFORMANCE HIGH BAY	PEL4-40MX-FAN-EDU	SEE NOTE
OFFICE (ADMIN OFFICE XDD ME77XNINES) V		+	AW-EM	14	229.62	4156	1.000	SINGLE	COLUMBIA LIGHTING	PELOTON HIGH PERFORMANCE HIGH BAY	PEL4-40MX-FAW-EDU	SEE NOTE
R6 21 184.2 1864 0.000 SINGLE COLUMBIA LIGHTING REVERIE DECORATIVE LOW RAY RLR6.4014-FAALUS-FDU HUNG 10-0* A F F. 10 LF1 80 11.3 1003 0.000 SINGLE CSL ECO DOWNLOHTS EUGL-MC-0349-06-175 EUGL-MC-0349-06-175 1 30.4 230 A SINGLE CSL ECO DOWNLOHTS EUGL-MC-0349-06-175 EUGL-MC-0349-06-175 1 30.4 230 A SINGLE COLUMBIA LIGHTING M24 ARCHTECTURAL LED FLAND MPS2-40MW-PW-EDU FLAND FLAND FLAND FLAND FLAND M24 ARCHTECTURAL LED FLAND MPS2-40MW-PW-EDU FLAND FLA			B4-EM	11	26.5	1210	1.000	SINGLE	COLUMBIA LIGHTING	MPS MULTIPURPOSE LINEAR	MPS4-40VW-FW-EDU	SEE NOTE
○ LF1 88 11.3 1008 0.000 SINGLE CSL ECO DOWNLIGHTS EUSL-AC-304/04/54/02 □ LF2 70 20 2255 0.000 SINGLE ELITE LIGHTINS 2.22 ARCHITECRALLED FLAT PAREL 2.24 FRU-LED-2000_DIM/16-M/01/14/06-MS 1 A2 1 50.4 2300 SINGLE COLUMBIA LIGHTING MS MULTPURPOSE LINEAR MS2-400X/H-VH-EDU STARWELLS ■ A4 13 76.5 3174 0.80 SINGLE COLUMBIA LIGHTING MS MULTPURPOSE LINEAR MS4.40/X-FW-EDU UNDERSIDE OF MEZZANDE 1 ■ CB 11 40.8 0.800 SINGLE COLUMBIA LIGHTING MS MULTPURPOSE LINEAR MS4.40/X-FW EDU UNDERSIDE OF MEZZANDE 1 ■ LF-EM 35 10.3 0.800 SINGLE COLUMBIA LIGHTING MS MULTPURPOSE LINEAR MS4.40/X-FW-EDU SEE NOTE ■ LF-EM 35 10.3 10.800 SINGLE COLUMBIA LIGHTING MS MULTPURPOSE LINEAR MS4.40/X-FW-EDU SEE NOTE <t< td=""><td>С</td><td>OFFICE (ADM</td><td>IIN OFFICE</td><td>AND M</td><td>EZZANINES)</td><td></td><td></td><td></td><td></td><td></td><td></td><td></td></t<>	С	OFFICE (ADM	IIN OFFICE	AND M	EZZANINES)							
IP IP2 79 20 2235 0.600 SINCLE ELITE LICHTING 222 ARCHITECTURAL LED FLAT PANEL 22-FRL14LED-2000LDINIO-MYOLT-0K-860 A2 1 0.40 2000 SINGLE COLUMBAL LICHTING MPS ALOUMPROSE LINBAR MPS2-400M/FW-EDU STATURELLS A1 1 0.65 3174 0.60 SINGLE COLUMBAL LICHTING RESALATE STARWELL LIMINARE ESL-4-09-HLH-FF-PW-ED STARWELLS C B4 13 0.65 3174 0.600 SINGLE COLUMBAL LICHTING MPS ALOUX-PW-EDU UNDERSDE OF MEZZAINE I C B4 13 0.60 1003 NOLE COLUMBAL LICHTING MPS ALOUX-PW-EDU UNDERSDE OF MEZZAINE I C LF1-EM 35 10.3 1003 NOLE COLUMBAL LICHTING SCALATE STARWELL LIMINARE ESL-40-HLHE-PW-ED SEE NOTE SEE SE 10 1000 SINGLE COLUMBAL LICHTING SGC-FCANOPY SELINBAR MPS-440W-FW-EDU SEE NOTE SEE SEE SINGLE COLUMBAL LICHTING	[RB	21	164.2	19064	0.900	SINGLE	COLUMBIA LIGHTING	REVERIE DECORATIVE LOW BAY	RLB8-40LM-FAM-U3-EDU	HUNG 10'-0" A.F.F.
L A2 1 50.4 2500 SINGLE COLUMBA LIGHTING MPS MULTPURPOSE LINEAR MPS2-40MW-FW-EDU SINGLE B4 13 26.5 3174 0.650 SINGLE COLUMBIA LIGHTING MPS MULTPURPOSE LINEAR MPS2-40MW-FW-EDU SINFUELS CB 11 40 406 0.650 SINGLE COLUMBIA LIGHTING MPS MULTPURPOSE LINEAR MPS3-40MW-FW-EDU UNDERSIDE OF MEZZANINE 1 C LF1-EM 35 11.3 1086 0.600 SINGLE COLUMBIA LIGHTING MPS MULTPURPOSE LINEAR MPS3-40MW-FW-EDU UNDERSIDE OF MEZZANINE 1 C LF1-EM 35 10.3 2000 SINGLE COLUMBIA LIGHTING MPS MULTPURPOSE LINEAR MPS3-40M-FW-EDU SEE NOTE L LF2-EM 35 0.0 SINGLE COLUMBIA LIGHTING MPS MULTPURPOSE LINEAR MPS3-40M-FW-EDU SEE NOTE SEE NOTE SEE NOTE SINGLE COLUMBIA LIGHTING MPS MULTPURPOSE LINEAR MPS4-40W-FW-EDU SEE NOTE STAT 44.24 44		0	LF1	86	11.3	1093	0.900	SINGLE	CSL	ECO DOWNLIGHTS	ED3L-NC-30-90-50-12S	
84 21 40.8 SINGLE COLUMBIA LIGHTING ESCALATE STARWELL LUMINARE ESL-4-0HLHE-FP-W-ED STARWELLS 0 14 40.8 4989 0.850 SINGLE COLUMBIA LIGHTING MPS MULTIPURPOSE LINEAR MPS-440W-FW-EDU UNDERSIDE OF MEZZANIE 1 0 LFI-EM 35 11.3 1093 0.800 SINGLE CSL ECO DOWNLICHTS ED3L-0504650-12S SEE NOTE 0 LFI-EM 35 20 2235 0.900 SINGLE CSL ECO DOWNLICHTS ED3L-0504650-12S SEE NOTE S4-EM 13 40.8 0 SINGLE COLUMBIA LIGHTING ESCALATE STARWELL LUMINARE ESCALATE STARW		÷	LF2	79	20	2235	0.900	SINGLE	ELITE LIGHTING	2'x2' ARCHITECTURAL LED FLAT PANEL	22-FPL1-LED-2000L-DIM10-MVOLT-40K-85	
B4 13 24.5 3174 0.850 SINCLE COLUMBIA LIGHTING MPS MULTPURPOSE LINEAR MPS4-40W-FW-EDU UNDERSIDE OF MEZZANINE 1 C LF1-EM 35 11.3 1093 0.900 SINGLE COLUMBIA LIGHTING MPS MULTPURPOSE LINEAR MPS4-40W-FW-EDU UNDERSIDE OF MEZZANINE 1 C LF1-EM 35 11.3 1093 0.900 SINGLE COLUMBIA LIGHTING MPS MULTPURPOSE LINEAR MPS4-40W-FW-EDU UNDERSIDE OF MEZZANINE 1 L LF1-EM 35 0.13 1093 0.900 SINGLE COLUMBIA LIGHTING 222 ARCHITECTURAL LED FLAT PANEL 224 ARCHITECTURAL LED FLAT PANEL			A2	1	30.4	2300		SINGLE	COLUMBIA LIGHTING	MPS MULTIPURPOSE LINEAR	MPS2-40MW-FW-EDU	
C8 11 40 4989 0.850 SINGLE COLUMBIA LIGHTING MPS MULTPURPOSE LINEAR MPS 40XX-FW-EDU UNDERSIDE OF MEZZANINE 1 C LF-EM 35 11.3 1003 0.900 SINGLE CSL ECO DOWNLIGHTS ED3L-NC3.390-55-12S SEE NOTE LF-EM 35 0.20 2235 0.900 SINGLE ELITE LIGHTING 2/2 A 2CATECTUCAULED FLAT PARE 22-FPL-14-D-2000L-DIMIT-0AVCOT-40K-4S SEE NOTE SHEM 8 285 1210 1.000 SINGLE COLUMBIA LIGHTING MPS 4-00W-FW-EDU SEE NOTE G4-EM 3 40 1211 1.000 SINGLE COLUMBIA LIGHTING MPS 4-00W-FW-EDU SEE NOTE SITE UNDERSIDE OF PARKING DECK MPS4-40W-FW-EDU SEE NOTE MDB 3000 SINGLE HUBBEL LIGHTING SCC-F CANOPY SLING SERIES SCC-F-20-4K UNDERSIDE OF PARKING DECK IF 2 153.6 2174 0.900 SINGLE HUBBEL LIGHTING RATO SERIES AREASITE LIGHTER RAR2-320L-165-4K7-3-U INCLE HUBBEL LIGHTING			S4	21	40.8			SINGLE	COLUMBIA LIGHTING	ESCALATE STAIRWELL LUMINAIRE	ESL-4-40-HLHE-FP-W-ED	STAIRWELLS
Image: Probability of the state of		→]	B4	13	26.5	3174	0.850	SINGLE	COLUMBIA LIGHTING	MPS MULTIPURPOSE LINEAR	MPS4-40VW-FW-EDU	
IP2-EM 35 20 Z35 0.600 SINGLE ELITE LIGHTING 2×2 ARCHITECTURAL LED FLAT PANEL Z2-FPL14_ED-2000L-DIM10-MVQCT-40K-85 SEE NOTE SH-EM 13 40.8 C SINGLE COLUMBIA LIGHTING ESCALATE STARWELL LUMINAIRE ESL4-40-HLHE-FP-W-ED SEE NOTE G-BM 8 20.5 1210 1.000 SINGLE COLUMBIA LIGHTING MPS MULTIPURPOSE LINEAR MPS4-40VW-FW-EDU SEE NOTE G-BH 8 20.5 1210 1.000 SINGLE COLUMBIA LIGHTING MPS MULTIPURPOSE LINEAR MPS4-40VW-FW-EDU SEE NOTE STE STE	-	*]	C8	11	40	4989	0.850	SINGLE	COLUMBIA LIGHTING	MPS MULTIPURPOSE LINEAR	MPS8-40XW-FW-EDU	UNDERSIDE OF MEZZANINE 1
S4-EM 13 40.8 Image: Set of the set		0	LF1-EM	35	11.3	1093	0.900	SINGLE	CSL	ECO DOWNLIGHTS	ED3L-NC-30-90-50-12S	SEE NOTE
B4-EM 8 26.5 1210 1.000 SINGLE COLUMBIA LIGHTING MPS MULTIPURPOSE LINEAR MPS4-40VW-FW-EDU SEE NOTE C8-EM 3 40 1211 1.000 SINGLE COLUMBIA LIGHTING MPS MULTIPURPOSE LINEAR MPS4-40VW-FW-EDU SEE NOTE SITE - A2 54 22.9 3225 0.900 SINGLE HUBBEL LIGHTING SGC-F CANOPY SLING SERIES SGC-F-20-4K UNDERSIDE OF PARKING DECK Image: PII 2 153.6 21484 0.900 SINGLE HUBBEL LIGHTING RATIO SERIES AREASITE LIGHTER RAR2-320L-165-4K7-3-JU C Image: PII 2 153.6 21130 0.900 SINGLE HUBBEL LIGHTING RATIO SERIES AREASITE LIGHTER RAR2-320L-165-4K7-3-JU C Image: PIV 2 153.6 21304 0.900 SINGLE HUBBEL LIGHTING RATIO SERIES AREASITE LIGHTER RAR2-320L-165-4K7-3-JU C Image: PIV 2 163.6 180.6 0.900 SINGLE HUBBEL LIGHTING RATIO SERIES AREASITE LIGHTER		÷	LF2-EM	35	20	2235	0.900	SINGLE	ELITE LIGHTING	2'x2' ARCHITECTURAL LED FLAT PANEL	22-FPL1-LED-2000L-DIM10-MVOLT-40K-85	SEE NOTE
C8-EM 3 40 1211 1.000 SINGLE COLUMBIA LIGHTING MPS MULTIPURPOSE LINEAR MPS8-40XW-FW-EDU SEE NOTE SITE - A2 54 22.9 3225 0.900 SINGLE HUBBEL LIGHTING SGC-F CANOPY SLING SERIES SGC-F-20-4K UNDERSIDE OF PARKING DECK - P II 2 153.6 21488 0.900 SINGLE HUBBEL LIGHTING RATO SERIES AREA/SITE LIGHTER RAR2-320L-165-4K7-3-U - - P II 2 153.6 21714 0.900 SINGLE HUBBEL LIGHTING RATIO SERIES AREA/SITE LIGHTER RAR2-320L-165-4K7-3-U - - P IV 2 153.6 21844 0.900 SINGLE HUBBEL LIGHTING RATIO SERIES AREA/SITE LIGHTER RAR2-320L-165-4K7-3-U - - W 13 29.1 3060 0.900 SINGLE HUBBEL LIGHTING RATIO SERIES AREA/SITE LIGHTER RAR2-320L-165-4K7-4W-U - PARKING DECK - - WP3 2 163.655 16666 0.850			S4-EM	13	40.8			SINGLE	COLUMBIA LIGHTING	ESCALATE STAIRWELL LUMINAIRE	ESL-4-40-HLHE-FP-W-ED	SEE NOTE
SITE A2 54 22.9 3225 0.900 SINGLE HUBBEL LIGHTING SGC-F CANOPY SLING SERIES SGC-F-20-4K UNDERSIDE OF PARKING DECK Image: Pli I 2 153.6 21488 0.900 SINGLE HUBBEL LIGHTING RATIO SERIES AREA/SITE LIGHTER RAR2-320L-165-4K7-T2-U Image: Pli III 2 153.6 21714 0.900 SINGLE HUBBEL LIGHTING RATIO SERIES AREA/SITE LIGHTER RAR2-320L-165-4K7-3-U Image: Pli IIII 2 153.6 21310 0.900 SINGLE HUBBEL LIGHTING RATIO SERIES AREA/SITE LIGHTER RAR2-320L-165-4K7-3-U Image: Pli IIIIIIIIIIIIIIIIIIIIIIIIIIIIIIIIIII			B4-EM	8	26.5	1210	1.000	SINGLE	COLUMBIA LIGHTING	MPS MULTIPURPOSE LINEAR	MPS4-40VW-FW-EDU	SEE NOTE
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Image: Pill2153.6217140.900SINGLEHUBBEL LIGHTINGRATIO SERIES AREA/SITE LIGHTERRAR2.320L-165.4K7.3-UImage: PillImage: Pill2153.6213100.900SINGLEHUBBEL LIGHTINGRATIO SERIES AREA/SITE LIGHTERRAR2.320L-165.4K7.4W-UImage: PillImage: Pill2153.6218340.900SINGLEHUBBEL LIGHTINGRATIO SERIES AREA/SITE LIGHTERRAR2.320L-165.4K7.5QW-UImage: PillImage: Pill32.9130600.900SINGLEHUBBEL LIGHTINGRATIO SERIES SLENDER WALLPACKSG1-30-4K7-FTWALL MOUNTEDPARKING DE/Image: Pill30600.900SINGLEHUBBEL LIGHTINGTRAVERSETRV-60L-136.4K7-3WALL MOUNTEDImage: Pill4.1136.423155240.850SINGLEHUBBEL LIGHTINGTRAVERSETRV-60L-136.4K7-4WWALL MOUNTEDImage: Pill4.1136.423155240.850SINGLEHUBBEL LIGHTINGRATIO SERIES AREA/SITE LIGHTERRAR2-480L-240.4K7-4W-UWALL MOUNTEDImage: Pill4.1136.423155240.850SINGLEHUBBEL LIGHTINGRATIO SERIES AREA/SITE LIGHTERRAR2-480L-240.4K7-4W-UWALL MOUNTEDImage: Pill4.1136.423155240.850SINGLEHUBBEL LIGHTINGRATIO SERIES AREA/SITE LIGHTERRAR2-480L-240.4K7-4W-UWALL MOUNTEDImage: Pill4.1136.423155240.850SINGLEHUBBEL LIGHTINGRATIO SERIES AREA/SITE LIGHTERRAR2-480L-240.4K7-4W-UUND		+	A2	54	22.9	3225	0.900	SINGLE	HUBBEL LIGHTING	SGC-F CANOPY SLING SERIES	SGC-F-20-4K	UNDERSIDE OF PARKING DECK
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Image: Note of the system of			PIV	2	153.6	21310	0.900	SINGLE	HUBBEL LIGHTING	RATIO SERIES AREA/SITE LIGHTER	RAR2-320L-165-4K7-4W-U	
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		→]	C8	2	40	4989	0.850	SINGLE	COLUMBIA LIGHTING	MPS MULTIPURPOSE LINEAR	MPS8-40XW-FW-EDU	

NOTE:

"-EM" DENOTES POWER RELAYED TO SECONDARY POWER SOURCE. IN AN EMERGENCY THE EM LIGHT FIXTURES SHALL BE POWERED BY THE EMERGENCY GENERATOR.


S/RS WAI	REHOU	SE		I
YMBOL	QTY	MANUFACTURER	MODEL NUMBER	REMARKS
NX NX	8	HUBBEL LIGHTING	NXOS-OMDT2	
EM	6	HUBBEL LIGHTING	NXRC-UL924-UNV	
FX1	6	HUBBEL LIGHTING	NXRCFX-1RD-UNV	
NX NX	4	HUBBEL LIGHTING	NXSW-OO-WH	
RJ45	4	HUBBEL LIGHTING	RJ45ADAPTER	
٢	24	HUBBEL LIGHTING	WSPLWOSM24V	MAX MOUNTING HEIO 45'-0" AND ANGLED T MAXIMIZE COVERAG
FFICE (18	ST MEZZ	ZANINE + UNDERSIDE)		
ALCR	2	HUBBEL LIGHTING	ALCR1277	
MS1	3	HUBBEL LIGHTING	LHMTS1-G-WH	
R	2	HUBBEL LIGHTING	OMNIDT2000RP	
NX NX	17	HUBBEL LIGHTING	NXOS-OMDT2	
EM	6	HUBBEL LIGHTING	NXRC-UL924-UNV	
FX1	6	HUBBEL LIGHTING	NXRCFX-1RD-UNV	
ORLO	6	HUBBEL LIGHTING	NXSW-ORLO-WH	
PP	1	HUBBEL LIGHTING	POWER PACK	
FICE (21	ND MEZ	ZANINE + ADMIN OFFI	CE UNDERSIDE)	
ALCR	3	HUBBEL LIGHTING	ALCR1277	
MS1	5	HUBBEL LIGHTING	LHMTS1-G-WH	
R	6	HUBBEL LIGHTING	OMNIDT2000RP	
NX	8	HUBBEL LIGHTING	NXOS-OMDT2	
EM	5	HUBBEL LIGHTING	NXRC-UL924-UNV	
FX1	6	HUBBEL LIGHTING	NXRCFX-1RD-UNV	
ORLO	4	HUBBEL LIGHTING	NXSW-ORLO-WH	
RJ45	2	HUBBEL LIGHTING	RJ45ADAPTER	
٢	14	HUBBEL LIGHTING	WSPLWOSM24V	
PP	3	HUBBEL LIGHTING	POWER PACK	
FX2	1	HUBBEL LIGHTING	NXRCFX-2RD-UNV	
FICE (AI	DMIN OI	FFICE)		
ALCR	12	HUBBEL LIGHTING	ALCR1277	
MS1	16	HUBBEL LIGHTING	LHMTS1-G-WH	
R R	2	HUBBEL LIGHTING	OMNIDT2000RP	
MX NX	14	HUBBEL LIGHTING	NXOS-OMDT2	
EM	6	HUBBEL LIGHTING	NXRC-UL924-UNV	
FX1	6	HUBBEL LIGHTING	NXRCFX-1RD-UNV	
ORLO	6	HUBBEL LIGHTING	NXSW-ORLO-WH	
RJ45	1	HUBBEL LIGHTING	RJ45ADAPTER	
NXP2	1	HUBBEL LIGHTING	16 RELAY PANEL	
PP	2	HUBBEL LIGHTING	POWER PACK	
NXD	1	HUBBEL LIGHTING	NXDS-O	EXTERIOR GRADE
ARKING [DECK UI	NDERSIDE		
FX1	3	HUBBEL LIGHTING	NXRCFX-1RD-UNV	
RJ45	4	HUBBEL LIGHTING	RJ45ADAPTER	
Ø	27	HUBBEL LIGHTING	WSPLWOSM24V	
FX2	1	HUBBEL LIGHTING	NXRCFX-2RD-UNV	
NXD	1	HUBBEL LIGHTING	NXDS-O	EXTERIOR GRADE
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EM	3	HUBBEL LIGHTING	NXRC-UL924-UNV	
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JXILIARY		 و	1	I

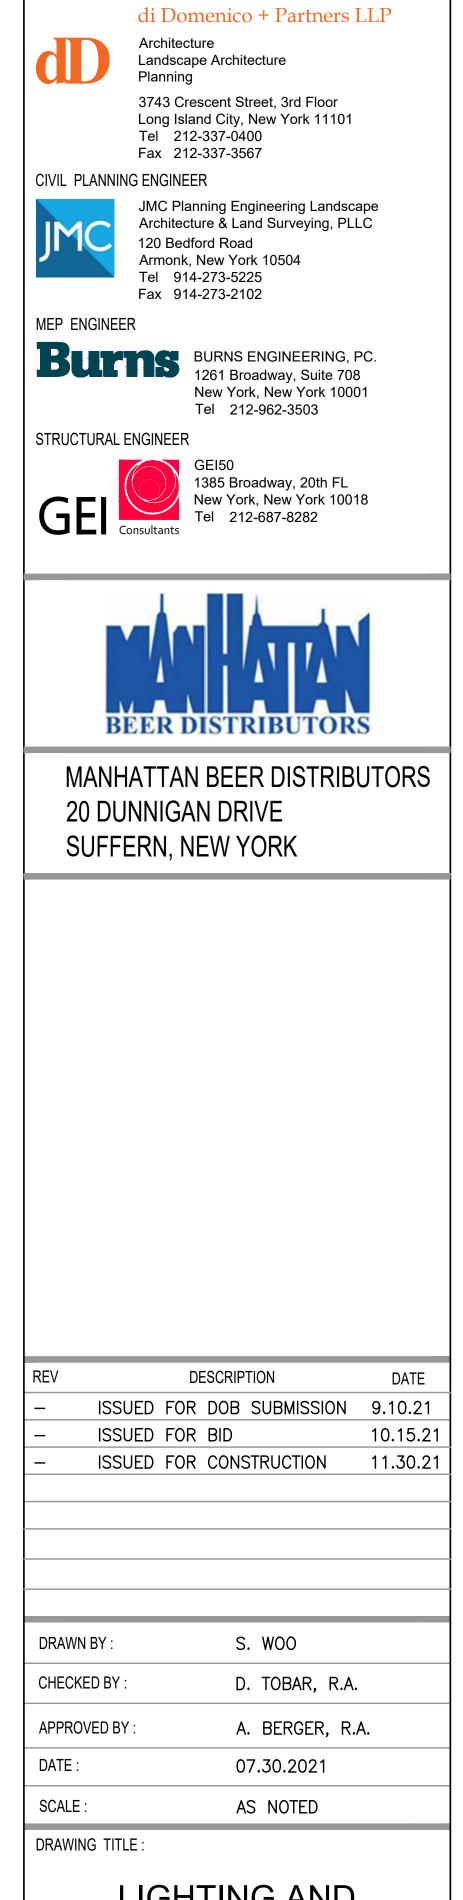

ARCHITECT


LIGHTING AND CONTROL SCHEDULES


DWG NUMBER :

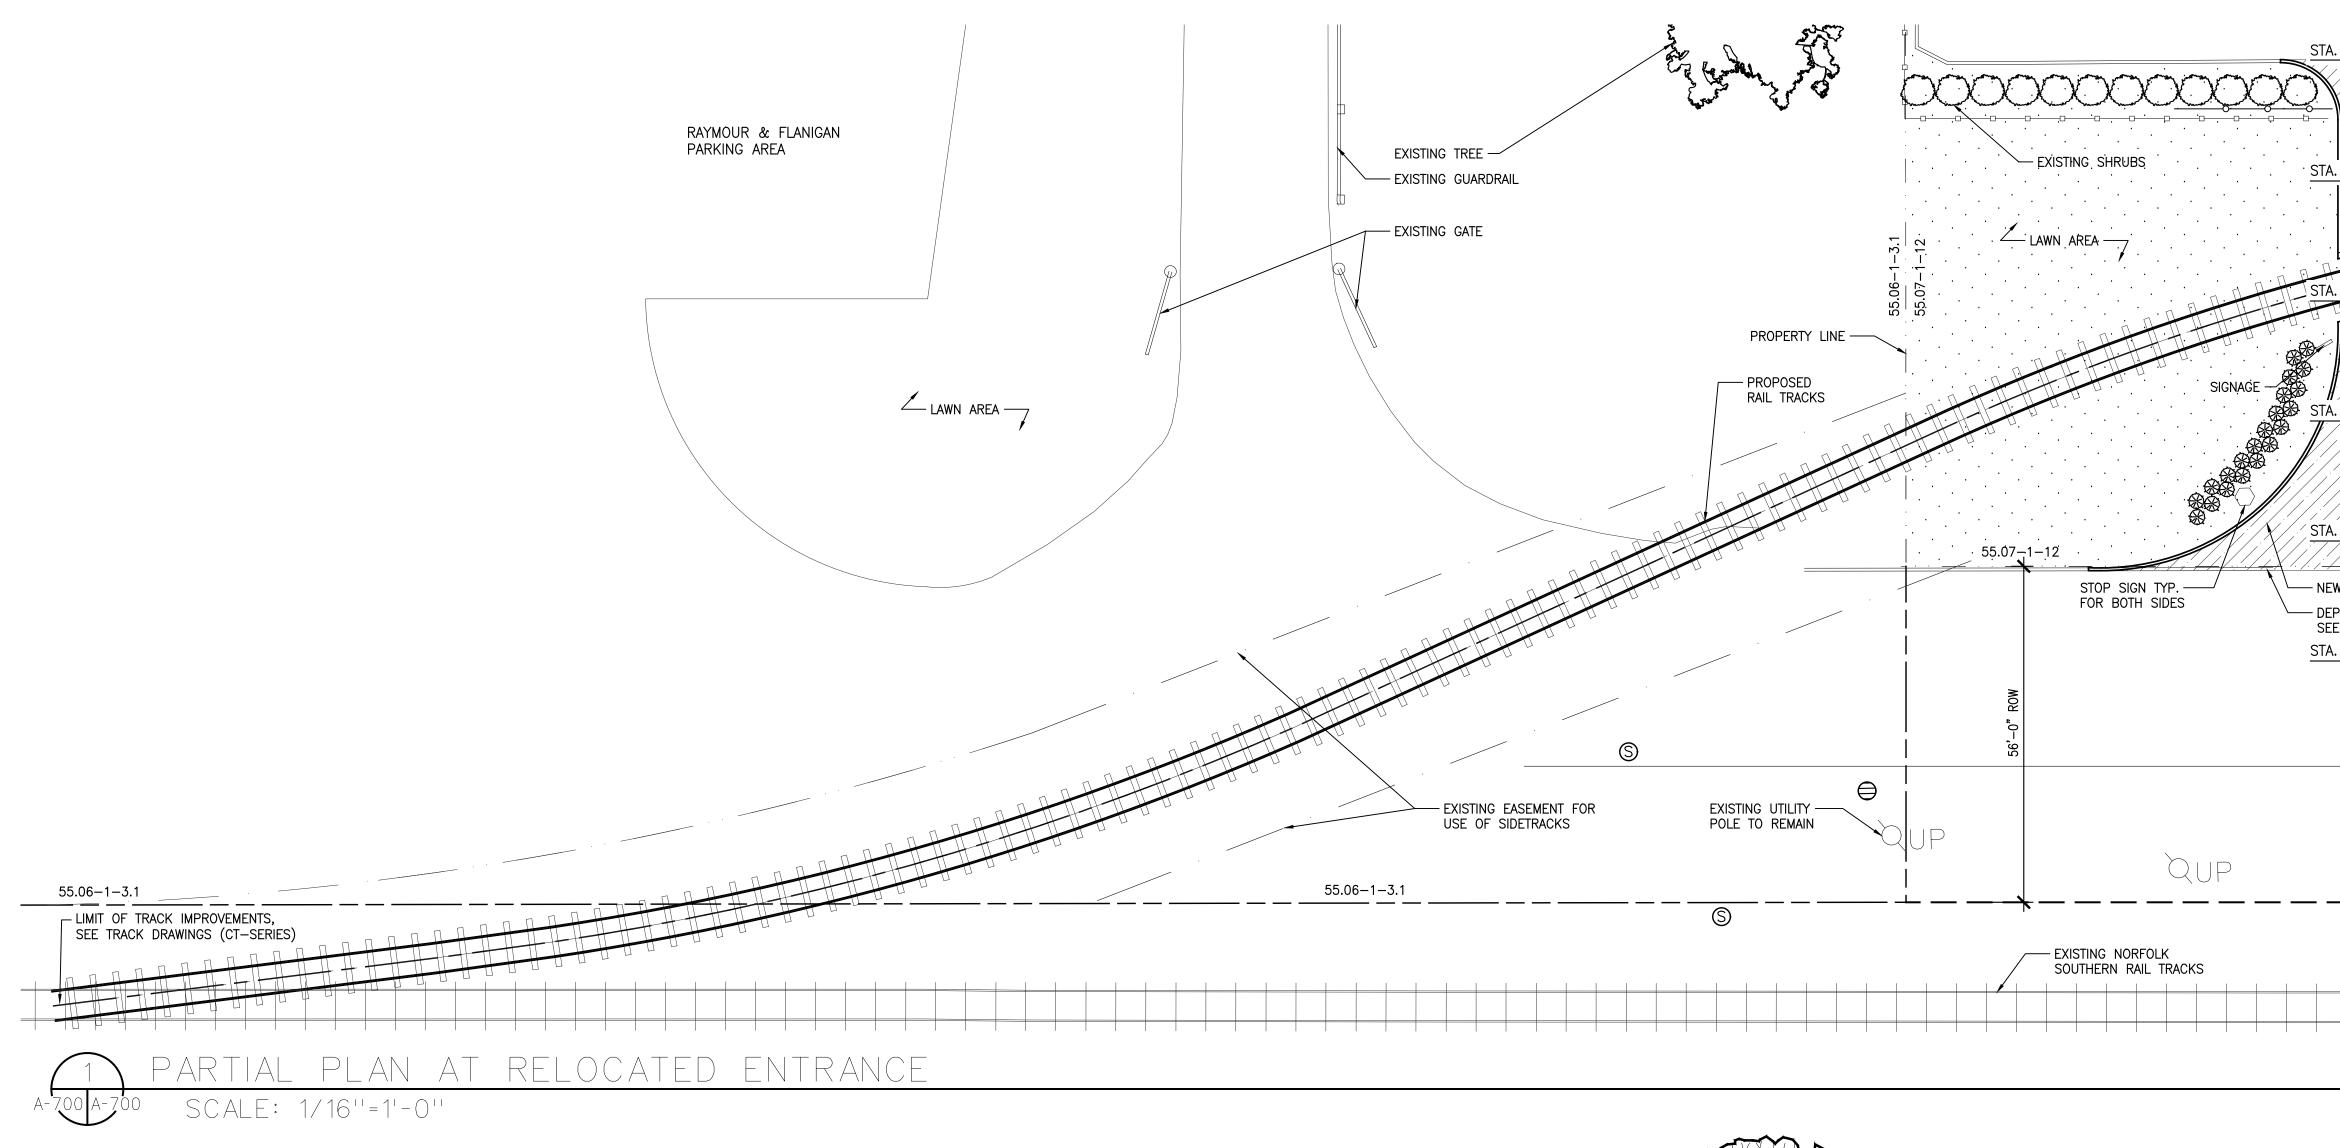

- UNACCEPTABLE TO THE ARCHITECT, FOR ANY
- INJURY OR DEFECTS. ALL PLANT MATERIAL TO .

- VARY DUE TO FIELD CONDITIONS, FINAL CONDITIONS, OR FINAL PLACEMENT OF PLANT
- PITS ARE DUG. IF INITIAL PLACEMENT IS NOT
- PLACED AND PLANTED AT THE SAME TIME. IF ANY PLANT REMAINS ON-SITE FOR MORE THAN BE HEELED IN ON-SITE TO MAINTAIN THEIR HEALTH AND VITALITY. PLANTS SHALL BE OTHERWISE PROTECTED AND MAINTAINED INCLUDING, BUT NOT LIMITED TO, WATER AND HEALTH OR CONDITION AT THE TIME OF PLANTING SHALL BE REPLACED AT THE
- CONSIDERATION DURING EXCAVATION AND PLANTING TO AVOID DISTURBING OR DAMAGING ANY EXISTING AND ADJACENT UNDERGROUND UTILITIES, CONSTRUCTION AND PLANT MATERIAL. ANY DAMAGE TO THE AFORE-MENTIONED FROM THIS CONSTRUCTION SHALL BE THE CONTRACTORS RESPONSIBILITY AND BE RESTORED AT HIS EXPENSE TO THE
- THAT PLANTINGS NOT DRY OUT DURING THE FIRST YEAR.
- EXISTING LAWN SHALL BE CONTINUOUS AND FLUSH .
- BULB BEDS: 9".

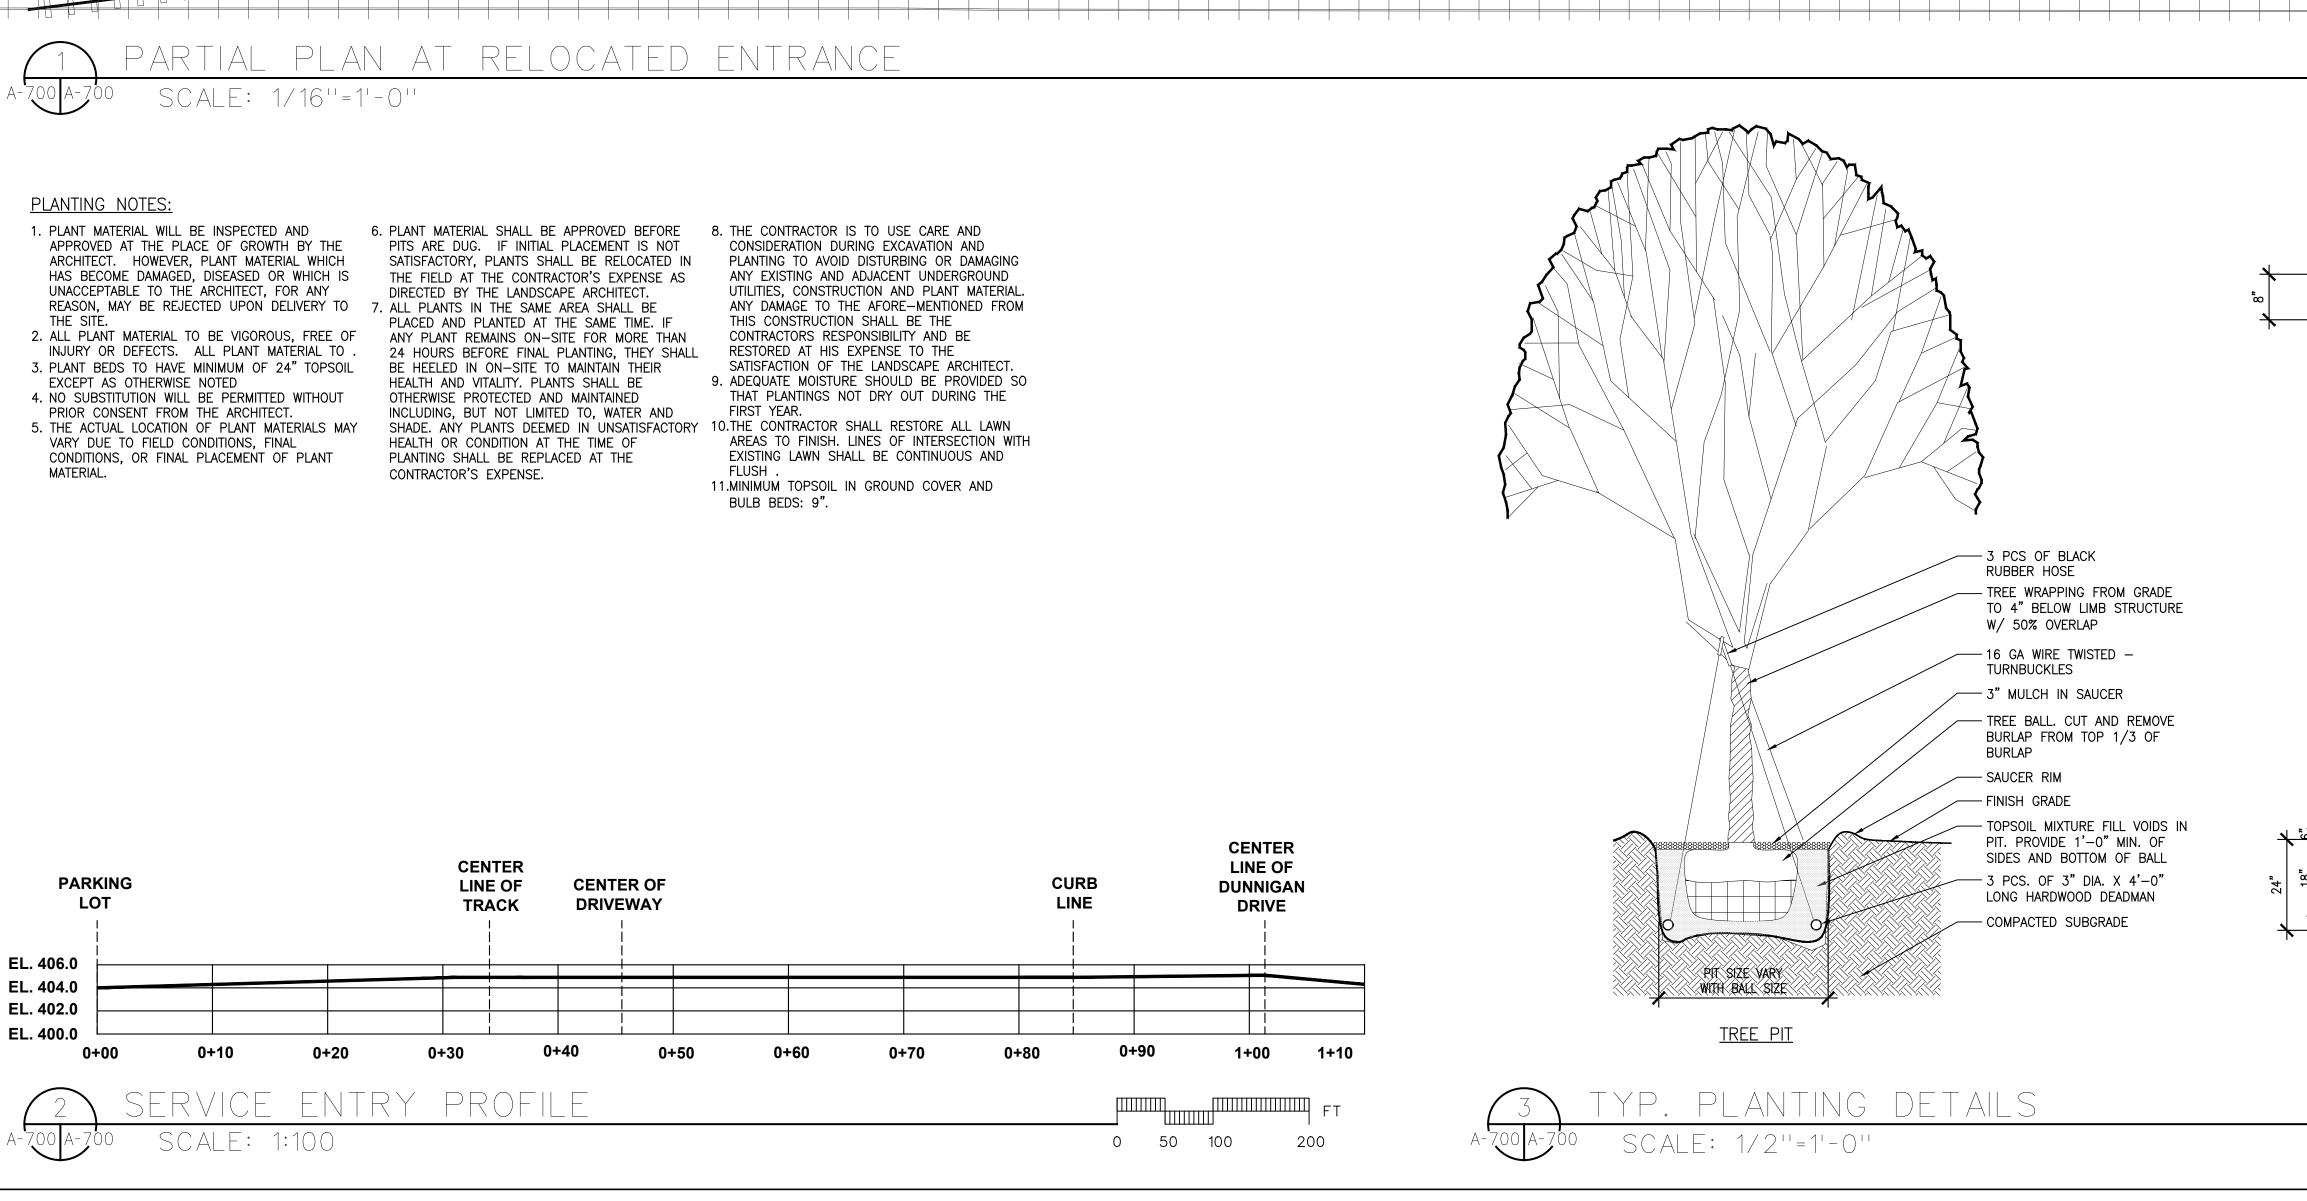

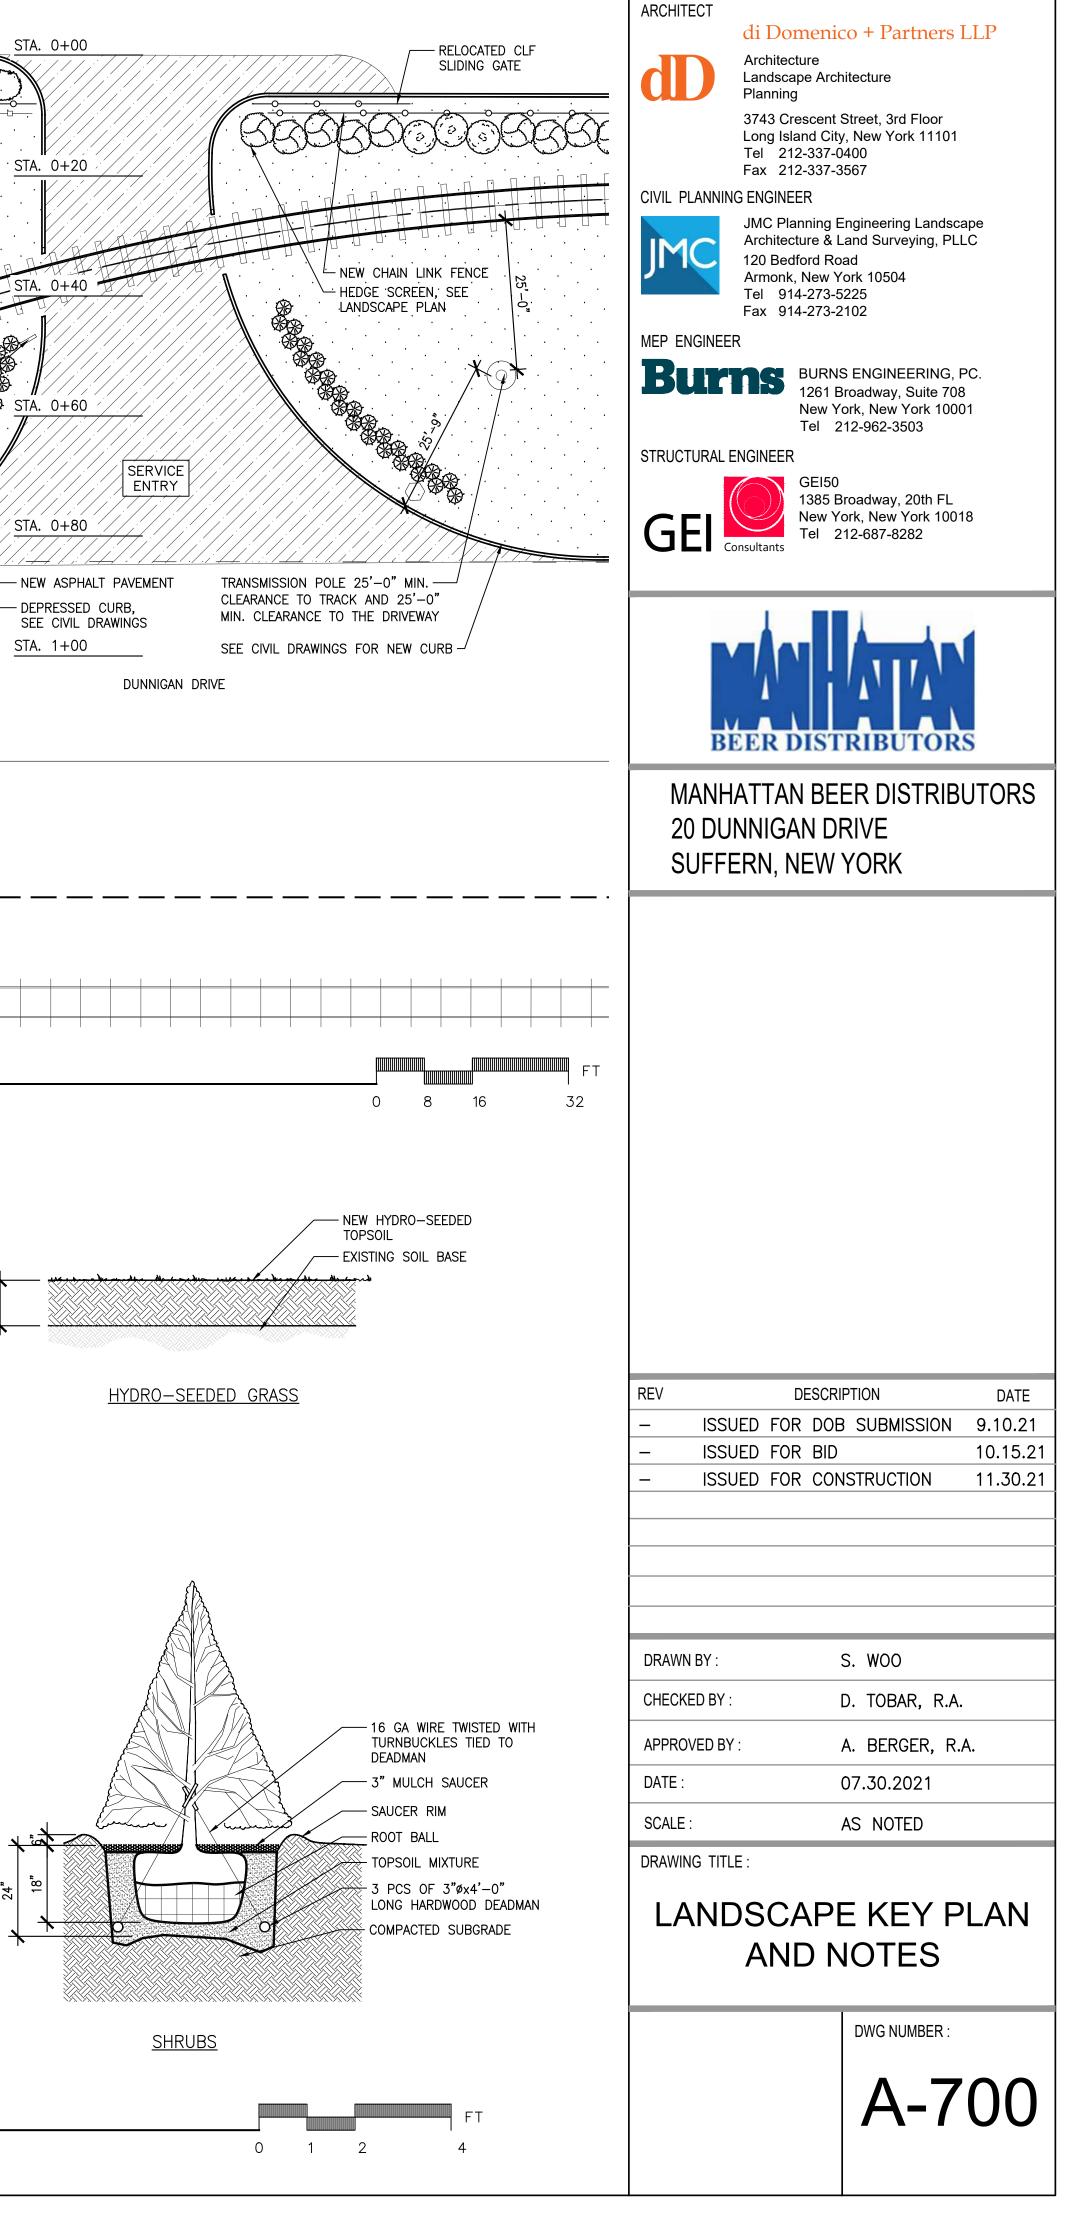

	PLANTING SCHEDULE								
TYPE	#	QTY	BOTANICAL NAME	COMMON NAME	CAL.	HEIGHT	ROOT	NOTES/COMMENTS	
	1	128	THUJA GREEN GIANT	THUJA STANDISHII X PLICATA	_	6' - 0"	B&B	PLANT AT 6'–6" STAGGERED	
SHRUB	2	79	JAPANESE CEDAR	CRYPTOMERIA JAPONICA	_	6'-0"	B&B	PLANT AT 6'-6" STAGGERED	
	3	0	ARBORVITAE HEDGE	THUJA OCCIDENTALIS SMARAGD	_	6'—0"	B&B	PLANT AT 6'-6" STAGGERED	
VINES	01	320 SF	WHITE CLIMBING HYDRANGEA	HYDRANGEA ANOMALA PETIOLARIS	_	_	1 QT	PLANT AT 12" O.C.	
VINES	02	640 SF	ENGLISH IVY	HEDRA HELIX	_	-	PLATS	PLANT AT 8" O.C.	
PERENNIALS	1	88	ORNAMENTAL FOUNTAIN GRASS	PENNISETUM ALOPECUROIDES 'MOUDRY'	_	_	3 GAL.	PLANT AT 30" STAGGERED	
	2	48	SPRING/SUMMER/FALL PERENNIAL FLOWER MIX	VARIES	_	_	1 GAL.	PLANT AT 18" STAGGERED	

LEGEND:

_00	NEW CHAIN LINK FENCE
00	EXISTING CHAIN LINK FENCE
00	PROPOSED SHRUB
\bigcirc	EXISTING SHRUB
Lord	EXISTING TREE
	EXISTING TREE TO BE REMOVED

GENERAL NOTES:

1. SEE CIVIL DRAWINGS FOR GRADING AND UTILITIES PLANS. 2. SEE PLANTING AND STANDARD LANDSCAPING NOTES IN A-700.

STANDARD LANDSCAPING NOTES:

- 1. ALL PLANTS SHALL BEAR THE SAME RELATIONSHIP TO FINISHED GRADE AS THAT WHICH EXISTED IN THE NURSERY.
- 2. ALL PLANTS SHALL BE ORIENTED AT THEIR PROPOSED LOCATION TO PRESENT THEIR BEST SIDE. THIS INSTALLATION SHALL BE CARRIED OUT UNDER THE SUPERVISION OF THE LANDSCAPE ARCHITECT.
- 3. MULCH ALL PLANT BEDS AND TREES WITH A THREE-INCH MINIMUM DEPTH OF WOODCHIPS, PINE BARK, PEAT MOSS, OR OTHER MULCH ACCEPTABLE
- TO THE VILLAGE'S LANDSCAPE CONSULTANT. 4. STAKE ALL TREES WITH TWO THREE-INCH-DIAMETER CEDAR STAKES 180° APART, REINFORCED RUBBER HOSE AROUND TREE (SIX FEET ZERO INCHES PLUS/MINUS ABOVE GRADE) AND TWISTED #10 GAUGE GALVANIZED WIRE WITH TURNBUCKLES. TREES LARGER THAN THREE-AND-ONE-HALF-INCH CALIPER SHALL BE STAKED WITH THREE STAKES EACH AT 120° APART.
- 5. PLANT PITS SHALL BE 18 INCHES WIDER AND SIX INCHES DEEPER THAN THE ROOT BALL AT A MINIMUM. REMOVE ALL EXISTING SOIL, LOOSEN SIDES OF PIT WITH PICK, AND BACKFILL WITH A MIXTURE OF ONE PART PEAT-HUMUS TO FOUR PARTS TOPSOIL. ADD APPROPRIATE QUANTITIES OF COMPLETE COMMERCIAL FERTILIZER (NITROGEN,
- PHOSPHORIC ACID, AND POTASH) AND BONEMEAL. 6. TREE TRUNKS SHALL BE WRAPPED WITH BURLAP, OR OTHER APPROVED WRAP, UP TO THE BOTTOM BRANCHES WITH 50% OVERLAP.
- 7. ALL PLANTS AND WORKMANSHIP SHALL BE UNCONDITIONALLY GUARANTEED FOR TWO FULL PLANTING SEASONS, OR ONE CALENDAR YEAR, WHICHEVER IS LONGER.
- 8. ALL PLANTS SHALL BE PRUNED BACK 1/4 TO 1/3 BRANCH LENGTHS IMMEDIATELY AFTER PLANTING, EXCEPT THAT MAIN LEADERS SHALL NOT BE CUT.
- 9. ALL PLANTING SHALL BE INSTALLED UNDER THE DIRECTION OF A LICENSED PROFESSIONAL LANDSCAPE ARCHITECT. THE VILLAGE'S LANDSCAPE CONSULTANT SHALL BE NOTIFIED 48 HOURS PRIOR TO PLANTING. 10. PROVIDE THE VILLAGE BUILDING INSPECTOR AND VILLAGE LANDSCAPE CONSULTANT WITH A COPY OF
- THE STATE CERTIFICATE OF SOURCE FOR ALL PLANT MATERIAL. 11. ALL PLANT MATERIAL SHALL BE NURSERY GROWN AND SHALL CONFORM TO THE STANDARDS OF
- AMERICAN STANDARD FOR NURSERY STOCK, THE AMERICAN ASSOCIATION OF NURSERYMEN, LATEST EDITION.
- 12. NO PLANTS EXISTING ON THE SITE SHALL BE REMOVED, EXCEPT FOR THOSE SPECIFICALLY IDENTIFIED ON THE DRAWINGS FOR REMOVAL. TREES AND VEGETATED AREAS TO REMAIN SHALL BE PROTECTED WITH BRIGHTLY COLORED TEMPORARY FENCING LOCATED BEYOND THE DRIPLINES.
- 13. A LICENSED PROFESSIONAL LANDSCAPE ARCHITECT SHALL CERTIFY THAT THE PLANTINGS WERE COMPLETED IN ACCORDANCE WITH THE APPROVED PLAN, AND SUCH CERTIFICATION SHALL BE PROVIDED TO THE VILLAGE'S LANDSCAPE CONSULTANT PRIOR TO THE ISSUANCE OF A CERTIFICATE OF OCCUPANCY.
- 14. ALL LANDSCAPE INSTALLATIONS SHALL BE MAINTAINED ON A REGULAR BASIS, AND SHALL NOT BE ALLOWED TO TAKE ON AN UNSIGHTLY APPEARANCE (EXCEPT FOR NATURAL AREAS WHICH SHALL BE ALLOWED TO GROW NATURALLY WITH A MINIMUM OF MAINTENANCE)

