

[illegible]

NAME	EXISTING ROOF COMPOSITION (IF APPLICABLE)	DECK TYPE	FLAT OR SLOPED STRUCTURE	APPROX. SF	DEMOLITION (IF APPLICABLE)	NEW WORK COMPOSITION	COMMENTS
R1	REFER TO EXISTING ROOF TYPE (A)	CONC	FLAT / SLOPED	5,000	REFER TO DEMOLITION ROOF TYPE (A)	REFER TO NEW WORK ROOF TYPE (A)	-
R2	REFER TO EXISTING ROOF TYPE (A)	CONC	FLAT / SLOPED	13,300	REFER TO GENERAL NOTE 10. REFER TO DEMOLITION ROOF TYPE (A)	REFER TO NEW WORK ROOF TYPE (A)	APPROX. 5600 SF OF EXISTING PV
R3	REFER TO EXISTING ROOF TYPE (B)	CONC	SLOPED	8,100	REFER TO GENERAL NOTE 10. REFER TO DEMOLITION ROOF TYPE (B)	REFER TO NEW WORK ROOF TYPE (B)	APPROX. 3700 SF OF EXISTING PV. REFER TO HS-A522 FOR DETAILS.
R4	REFER TO EXISTING ROOF TYPE (A)	CONC	FLAT / SLOPED	13,100	REFER TO DEMOLITION ROOF TYPE (A)	REFER TO NEW WORK ROOF TYPE (A)	-
R5	REFER TO EXISTING ROOF TYPE (C)	CONC/MTL	FLAT	10,300	REFER TO DEMOLITION ROOF TYPE (C)	REFER TO NEW WORK ROOF TYPE (C)	-
R6	REFER TO EXISTING ROOF TYPE (C)	MTL	FLAT	4,200	REFER TO DEMOLITION ROOF TYPE (C)	REFER TO NEW WORK ROOF TYPE (C)	-
R7	REFER TO EXISTING ROOF TYPE (C)	MTL	FLAT	14,900	REFER TO GENERAL NOTE 10. REFER TO DEMOLITION ROOF TYPE (C)	REFER TO NEW WORK ROOF TYPE (C)	APPROX. 5500 SF OF EXISTING PV
R8	REFER TO EXISTING ROOF TYPE (A)	CONC	FLAT	1,400	REFER TO DEMOLITION ROOF TYPE (A)	REFER TO NEW WORK ROOF TYPE (A)	-
R9	REFER TO EXISTING ROOF TYPE (A)	CONC	FLAT / SLOPED	14,680	REFER TO GENERAL NOTE 10. REFER TO DEMOLITION ROOF TYPE (A)	REFER TO NEW WORK ROOF TYPE (A)	APPROX. 1700 SF OF EXISTING PV
R10	REFER TO EXISTING ROOF TYPE (A)	CONC	FLAT / SLOPED	2,780	REFER TO DEMOLITION ROOF TYPE (A)	REFER TO NEW WORK ROOF TYPE (A)	-
R11	REFER TO EXISTING ROOF TYPE (A)	CONC	SLOPED	8,800	REFER TO GENERAL NOTE 10. REFER TO DEMOLITION ROOF TYPE (A)	REFER TO NEW WORK ROOF TYPE (A)	APPROX. 5000 SF OF EXISTING PV
R12	REFER TO EXISTING ROOF TYPE (A)	CONC	FLAT / SLOPED	2,750	REFER TO DEMOLITION ROOF TYPE (A)	REFER TO NEW WORK ROOF TYPE (A)	-
R13	REFER TO EXISTING ROOF TYPE (C)	MTL	FLAT	1,170	REFER TO DEMOLITION ROOF TYPE (C)	REFER TO NEW WORK ROOF TYPE (C)	-
R14	NOT IN CONTRACT	-	-	-	-	-	-
R15	REFER TO EXISTING ROOF TYPE (A)	MTL	FLAT	188	REFER TO DEMOLITION ROOF TYPE (A)	REFER TO NEW WORK ROOF TYPE (A)	-
R16	REFER TO EXISTING ROOF TYPE (A)	CONC	FLAT	1,342	REFER TO DEMOLITION ROOF TYPE (A)	REFER TO NEW WORK ROOF TYPE (A)	-
R17	REFER TO EXISTING ROOF TYPE (A)	CONC	FLAT	8,882	REFER TO DEMOLITION ROOF TYPE (A)	REFER TO NEW WORK ROOF TYPE (A)	-
R18	NOT IN CONTRACT	-	-	-	-	-	-
R19	REFER TO EXISTING ROOF TYPE (A)	CONC	FLAT	150	REFER TO DEMOLITION ROOF TYPE (A)	REFER TO NEW WORK ROOF TYPE (A)	-

*REFER TO SHEETS HS-A521 AND HS-A522 FOR ROOF DETAILS

$$1/16'' = 1'-0'''$$


SHEET NUMBER: _____

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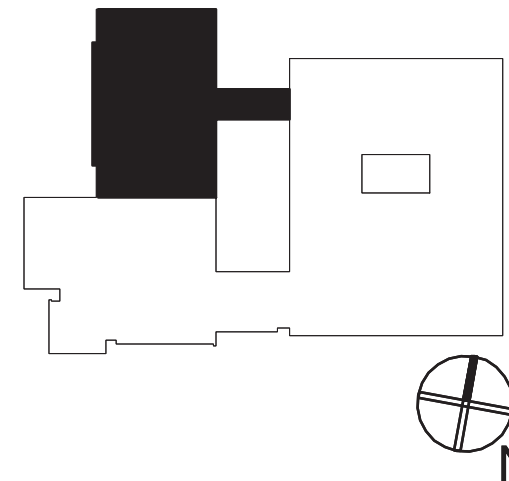
NUFSD
BOND
PROJECTS
PH3

☐ SED#50-01-08-03-0-003-035 (HIGH SCHOOL)
☒ SED#50-01-08-03-0-004-020 (BARR MIDDLE SCHOOL)

High School
103 Church St.
Nanuet, NY 10954

Barr Middle School
50 Blauvelt Rd #1
Nanuet, NY 10954

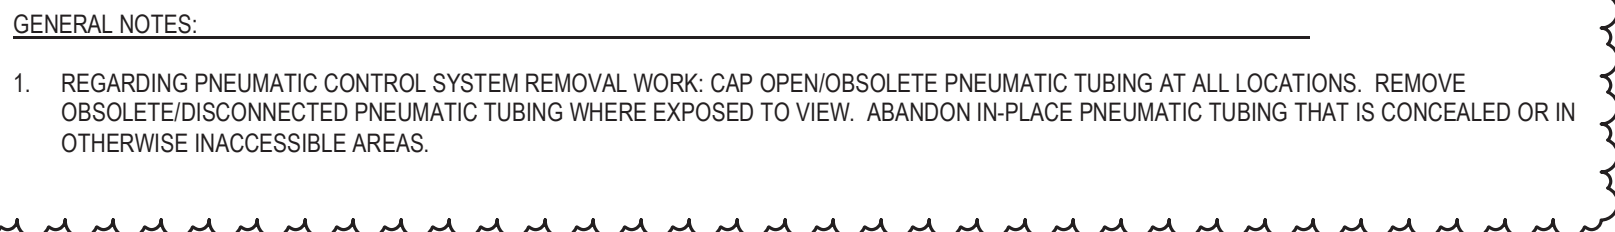KEY PLAN



REVISIONS

[illegible]

ISSUED: BID SET ISSUANCE

DATE: 06/06/2023

SCALE: 1/8" = 1'-0"

SHEET NAME:


PARTIAL FIRST FLOOR

REMOVALS -
NORTHWEST

SHEET NUMBER:

BM-M106

ISSUE FOR BID SET

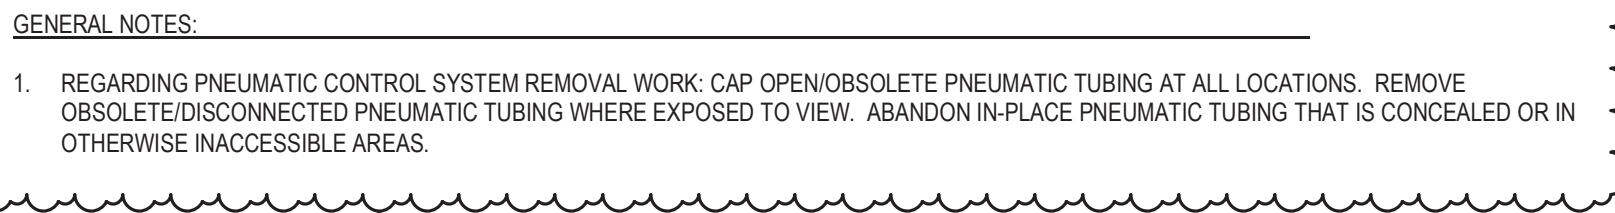


- KEY NOTES:**
1. DISCONNECT AND REMOVE FLOOR MOUNTED UNIT VENTILATOR AT LOCATION SHOWN. DISCONNECT OUTSIDE AIR DUCT SLEEVE FROM REMOVED UNIT VENTILATOR AND MAINTAIN OUTSIDE AIR DUCT SLEEVE CONNECTED TO EXTERIOR OUTSIDE AIR LOUVER. DISCONNECT AND REMOVE HWSHWR BRANCH PIPING TO REMOVED UNIT VENTILATOR HEATING COIL. DISCONNECT AND REMOVE HEATING COIL CONTROL VALVE, DAMPERS AND ALL ASSOCIATED UNIT VENTILATOR CONTROL WIRING, DDC CONTROLLER, SENSORS, RELAYS, GRAPHICS, PROGRAMMING, SEQUENCES OF OPERATIONS AND ASSOCIATED CONTROL DEVICES.
 2. DISCONNECT AND REMOVE SPACE TEMPERATURE SENSOR AT LOCATION SHOWN. DISCONNECT AND REMOVE DDC PROGRAMMING FROM REMOVED UNIT VENTILATOR IN SPACE. REMOVE CONTROL WIRING BETWEEN UNIT VENTILATOR DDC CONTROLLER AND SPACE SENSOR.
 3. DISCONNECT AND REMOVE PERIMETER SHELVING/CABINET UNITS AT LOCATION SHOWN AND FIN TUBE RADIATION LOCATED WITHIN PIPING TUNNEL AT REAR OF SHELVING SYSTEM.
 4. DISCONNECT AND REMOVE 1" HWSHWR PIPING ROUTED WITHIN PIPING TUNNEL BEHIND UNIT VENTILATORS AND CABINET SHELVING SYSTEMS BACK TO DISSECTION POINTS SHOWN AT POINT OF RISER PENETRATION THROUGH FLOOR AND CAP.
 5. DISCONNECT AND REMOVE HWSHWR ROUTED BEHIND REMOVE UNIT VENTILATORS AND CABINET SHELVING SYSTEMS. REMOVE HWSR BACK TO FLOOR PENETRATION AND CAP ABOVE FLOOR.
 6. DISCONNECT AND REMOVE HWSHWR ROUTED BEHIND REMOVE UNIT VENTILATORS AND CABINET SHELVING SYSTEMS. REMOVE HWSR BACK TO FLOOR PENETRATION AND CAP ABOVE FLOOR.
 7. DISCONNECT AND REMOVE TEMPERATURE SENSOR AT LOCATION SHOWN. DISCONNECT AND REMOVE DDC PROGRAMMING FROM REMOVED UNIT VENTILATORS IN SPACE. REMOVE CONTROL WIRING BETWEEN REMOVED UNIT VENTILATOR DDC CONTROLLER AND SPACE SENSOR.
 8. DISCONNECT AND REMOVE FLOOR MOUNTED UNIT VENTILATOR AT LOCATION SHOWN. DISCONNECT AND REMOVE OUTSIDE AIR DUCT SLEEVE FROM REMOVED UNIT VENTILATOR CONNECTED TO EXTERIOR OUTSIDE AIR LOUVER. PROVIDE A 1" THICK ALUMINUM GLASS FIBER BOARD PANEL OVER THE EXTERIOR FACE OF THE EXISTING OPENING. DISCONNECT AND REMOVE HWSHWR BRANCH PIPING TO REMOVED UNIT VENTILATOR HEATING COIL. DISCONNECT AND REMOVE HEATING COIL CONTROL VALVE, DAMPERS AND ALL ASSOCIATED UNIT VENTILATOR CONTROL WIRING, SENSORS, RELAYS AND CONTROL DEVICES.
 9. DISCONNECT AND REMOVE 1-1/4" HWSHWR PIPING LOCATED BETWEEN RISERS TO DISCONNECTION POINTS SHOWN ABOVE FLOOR PENETRATIONS AND CAP.
 10. DISCONNECT AND REMOVE HORIZONTAL PIPING ENCLOSURES BETWEEN REMOVED UNIT VENTILATORS AT LOCATIONS SHOWN INCLUDING ASSOCIATED HWSR PIPING ROUTED WITHIN THE ENCLOSURE UNITS.
 11. DISCONNECT AND REMOVE PNEUMATIC DAMPER. SENSORS AND RELAYS FROM EA RISER UP TO ROOFTOP EXHAUST FAN. REMOVE PNEUMATIC TUBING BACK TO PNEUMATIC PIPING MAN AND CAP. PROVIDE SHEETMETAL SLEEVE AT LOCATION OF REMOVED DAMPER TO MAINTAIN SEALED EA RISER UP THROUGH ROOF PENETRATION.
 12. DISCONNECT AND REMOVE SPACE TEMPERATURE SENSOR AT LOCATION SHOWN. DISCONNECT AND REMOVE DDC PROGRAMMING FROM REMOVED UNIT VENTILATOR IN SPACE. REMOVE CONTROL WIRING BETWEEN REMOVED UNIT VENTILATOR DDC CONTROLLER AND SPACE SENSOR.

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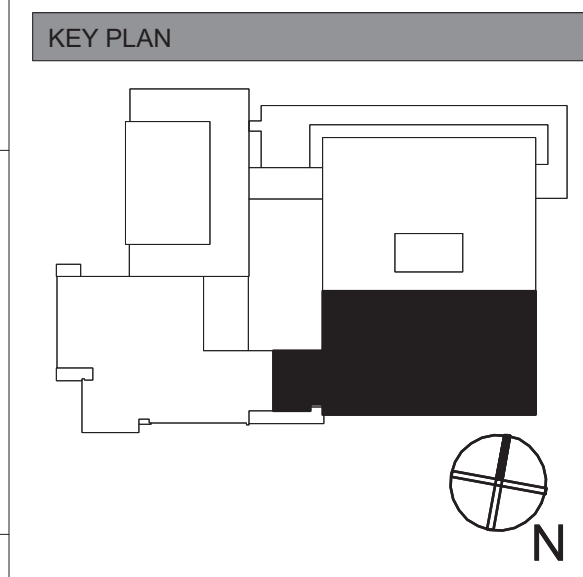
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☐ SED#50-01-08-03-0-003-035 (HIGH SCHOOL)
☒ SED#50-01-08-03-0-004-020 (BARR MIDDLE SCHOOL)


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BM-M108



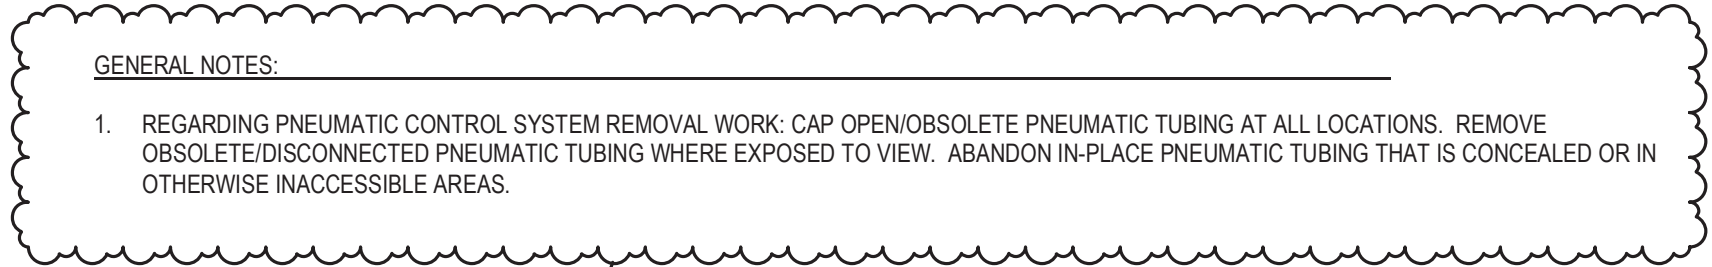

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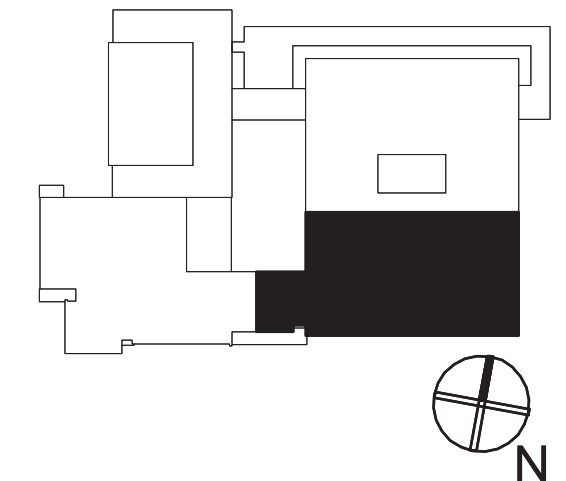
NUFSD BOND PROJECTS PH3

SED#50-01-08-03-0-003-035 (HIGH SCHOOL)
SED#50-01-08-03-0-004-020 (BARR MIDDLE SCHOOL)

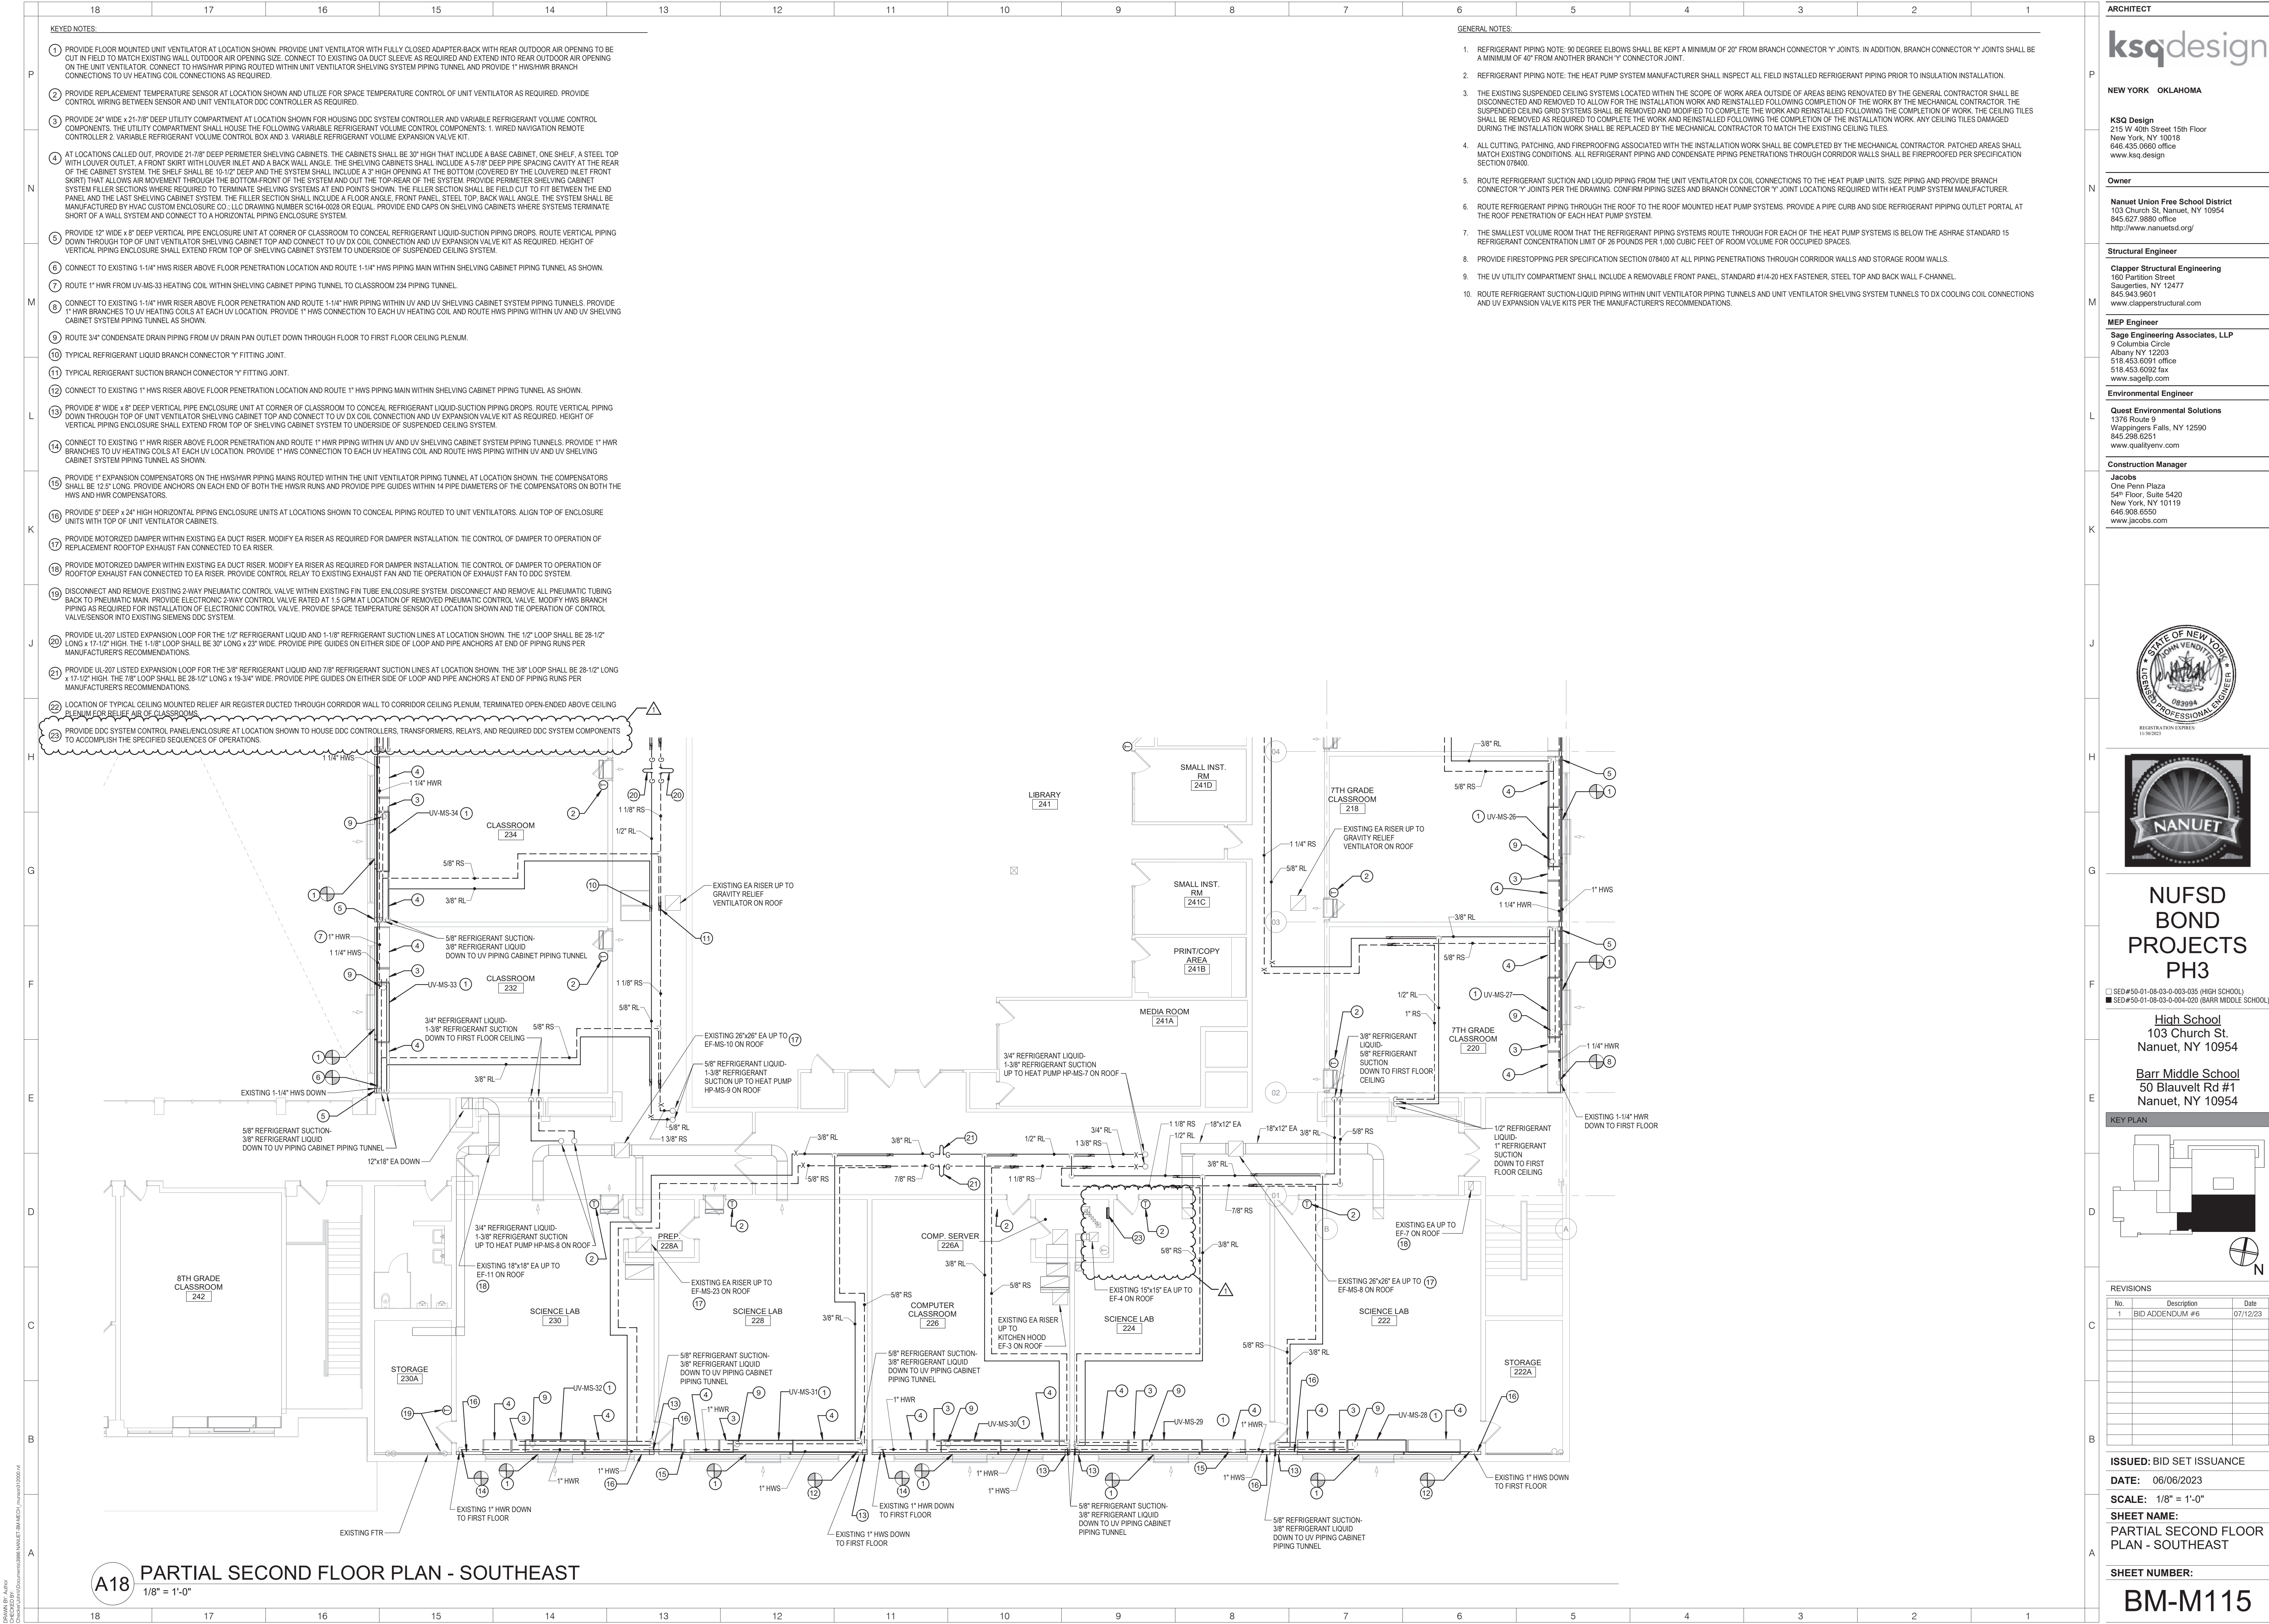High School
103 Church St.
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KEY PLAN



REVISIONS

No.	Description	Date
1	BID ADDENDUM #6	07/12/23

ISSUED: BID SET ISSUANCE

DATE: 06/06/2023

SCALE: 1/8" = 1'-0"


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PARTIAL SECOND FLOOR
PLAN - SOUTHEAST


SHEET NUMBER:

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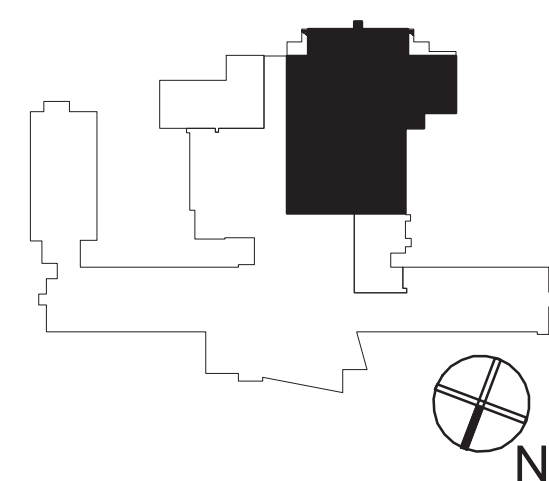
NUFSD BOND PROJECTS PH3

SED#50-01-08-03-0-003-035 (HIGH SCHOOL)
SED#50-01-08-03-0-004-020 (BARR MIDDLE SCHOOL)

High School
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KEY PLAN

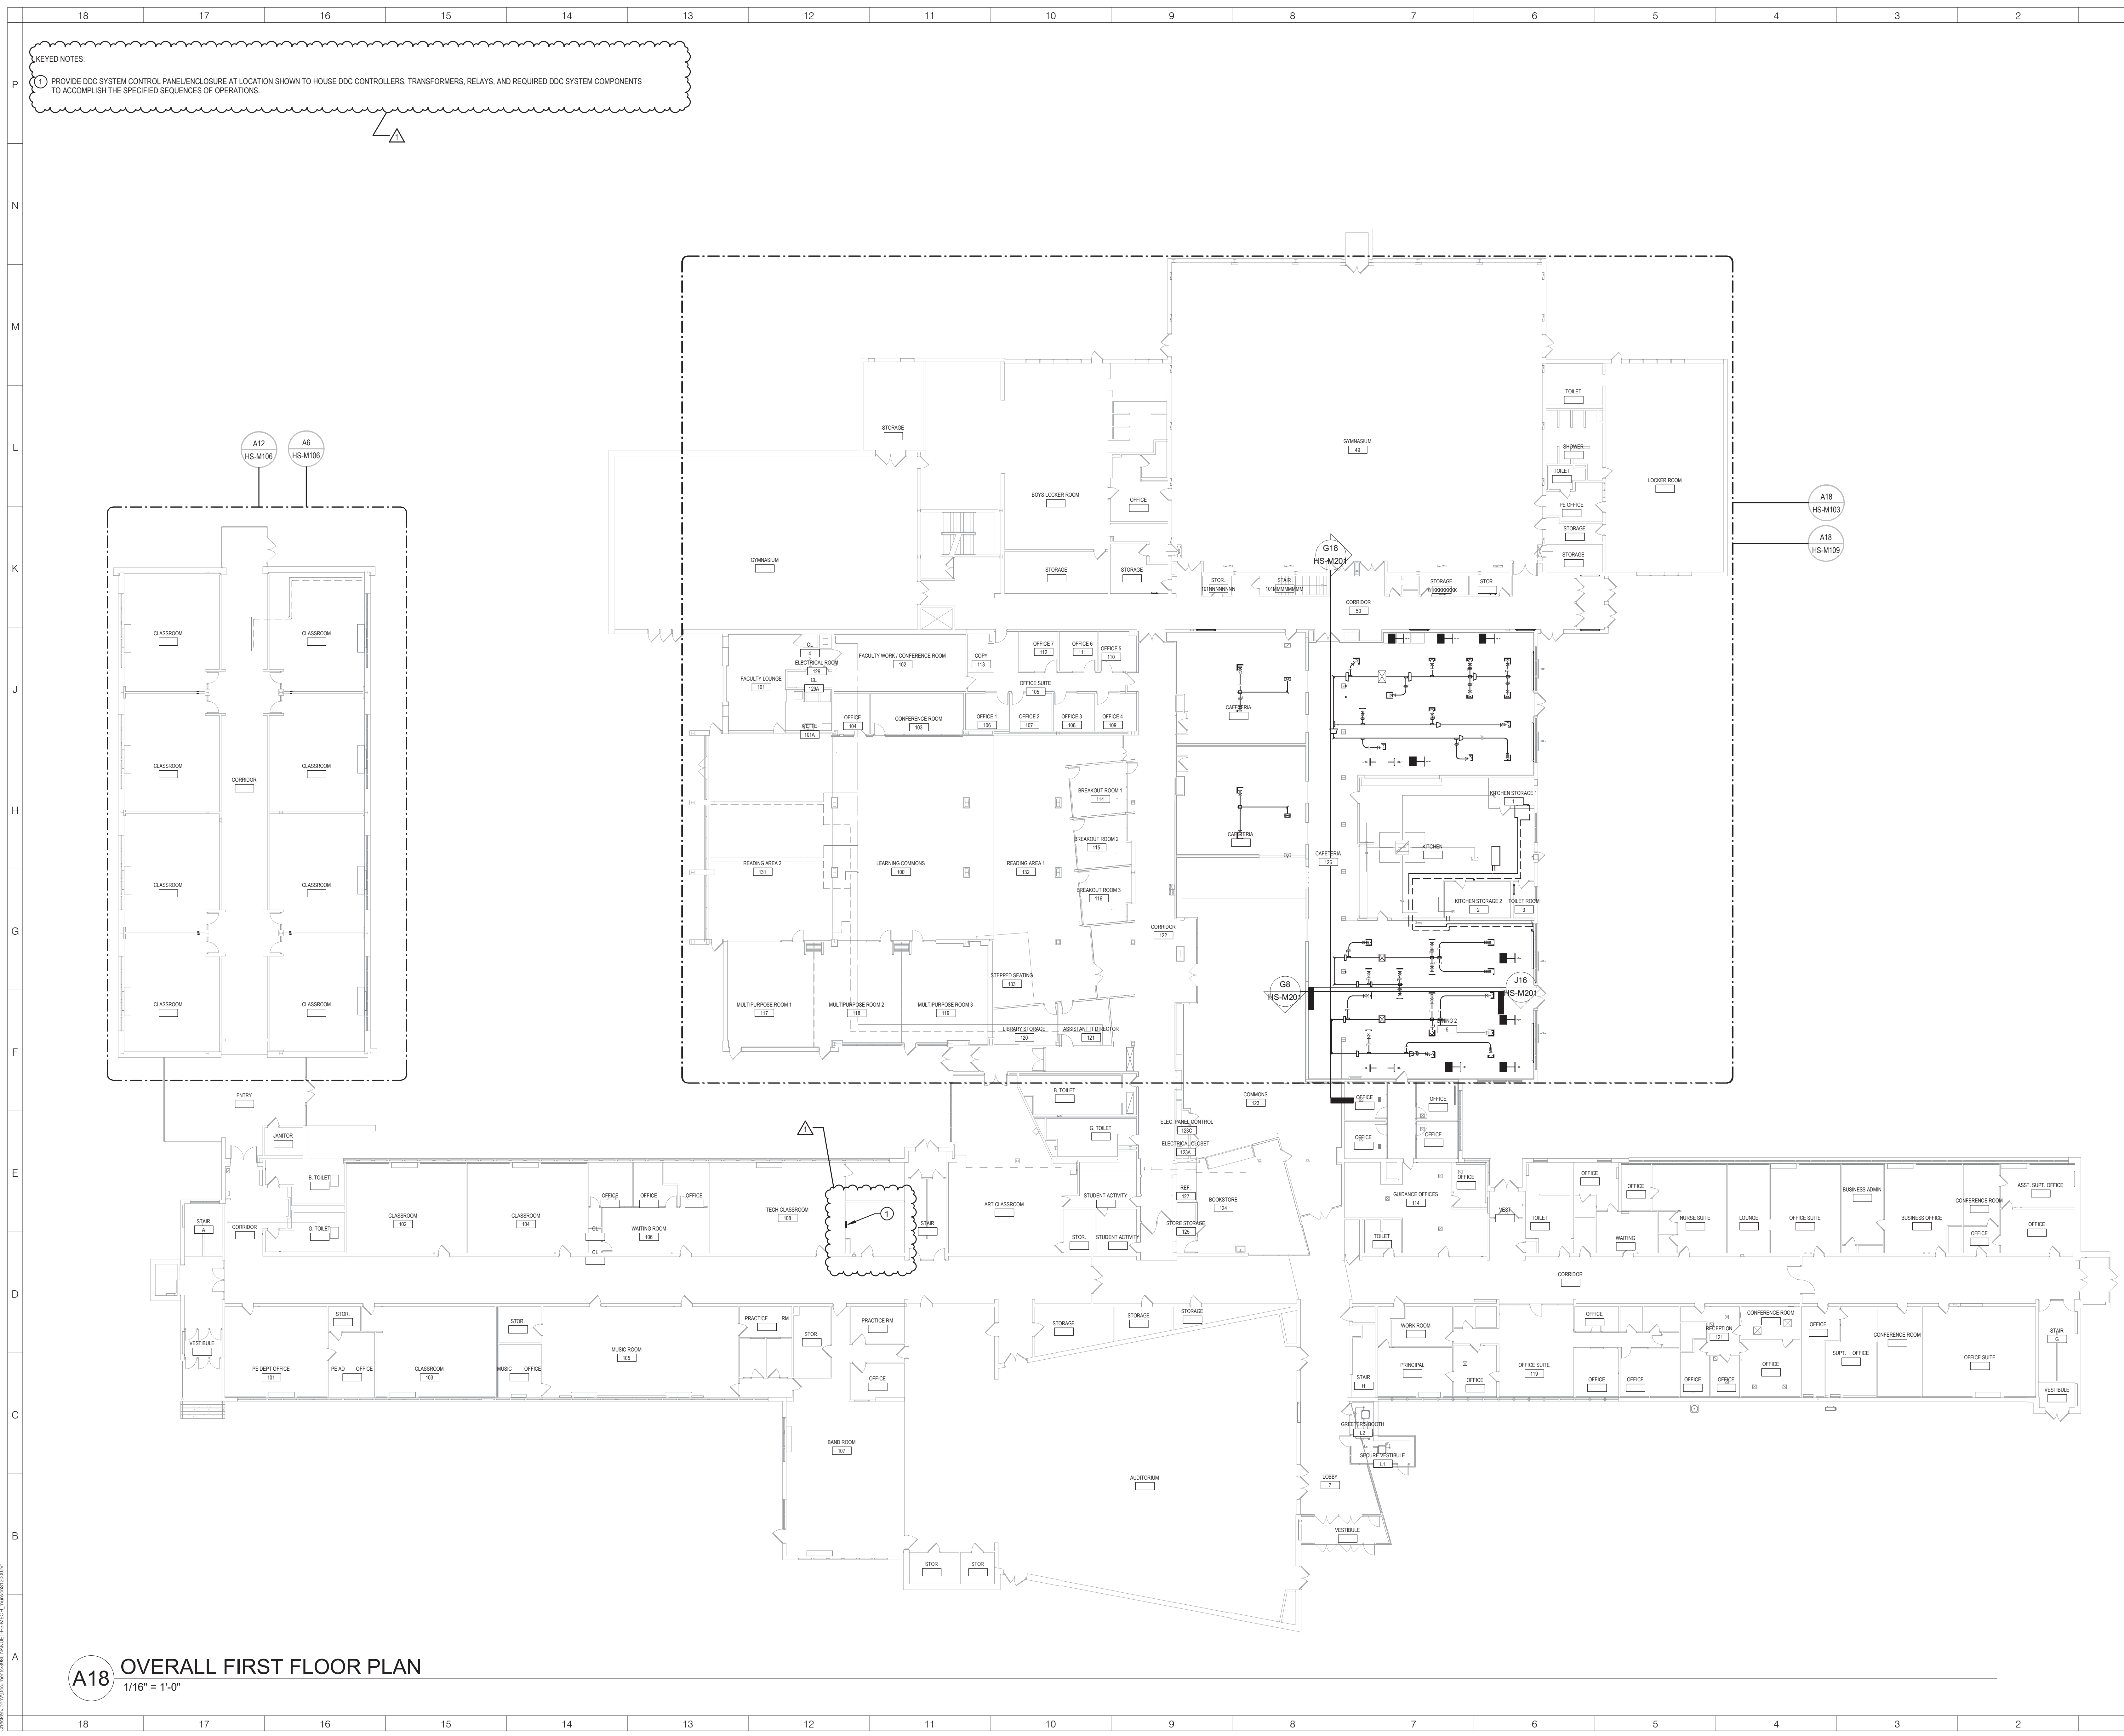

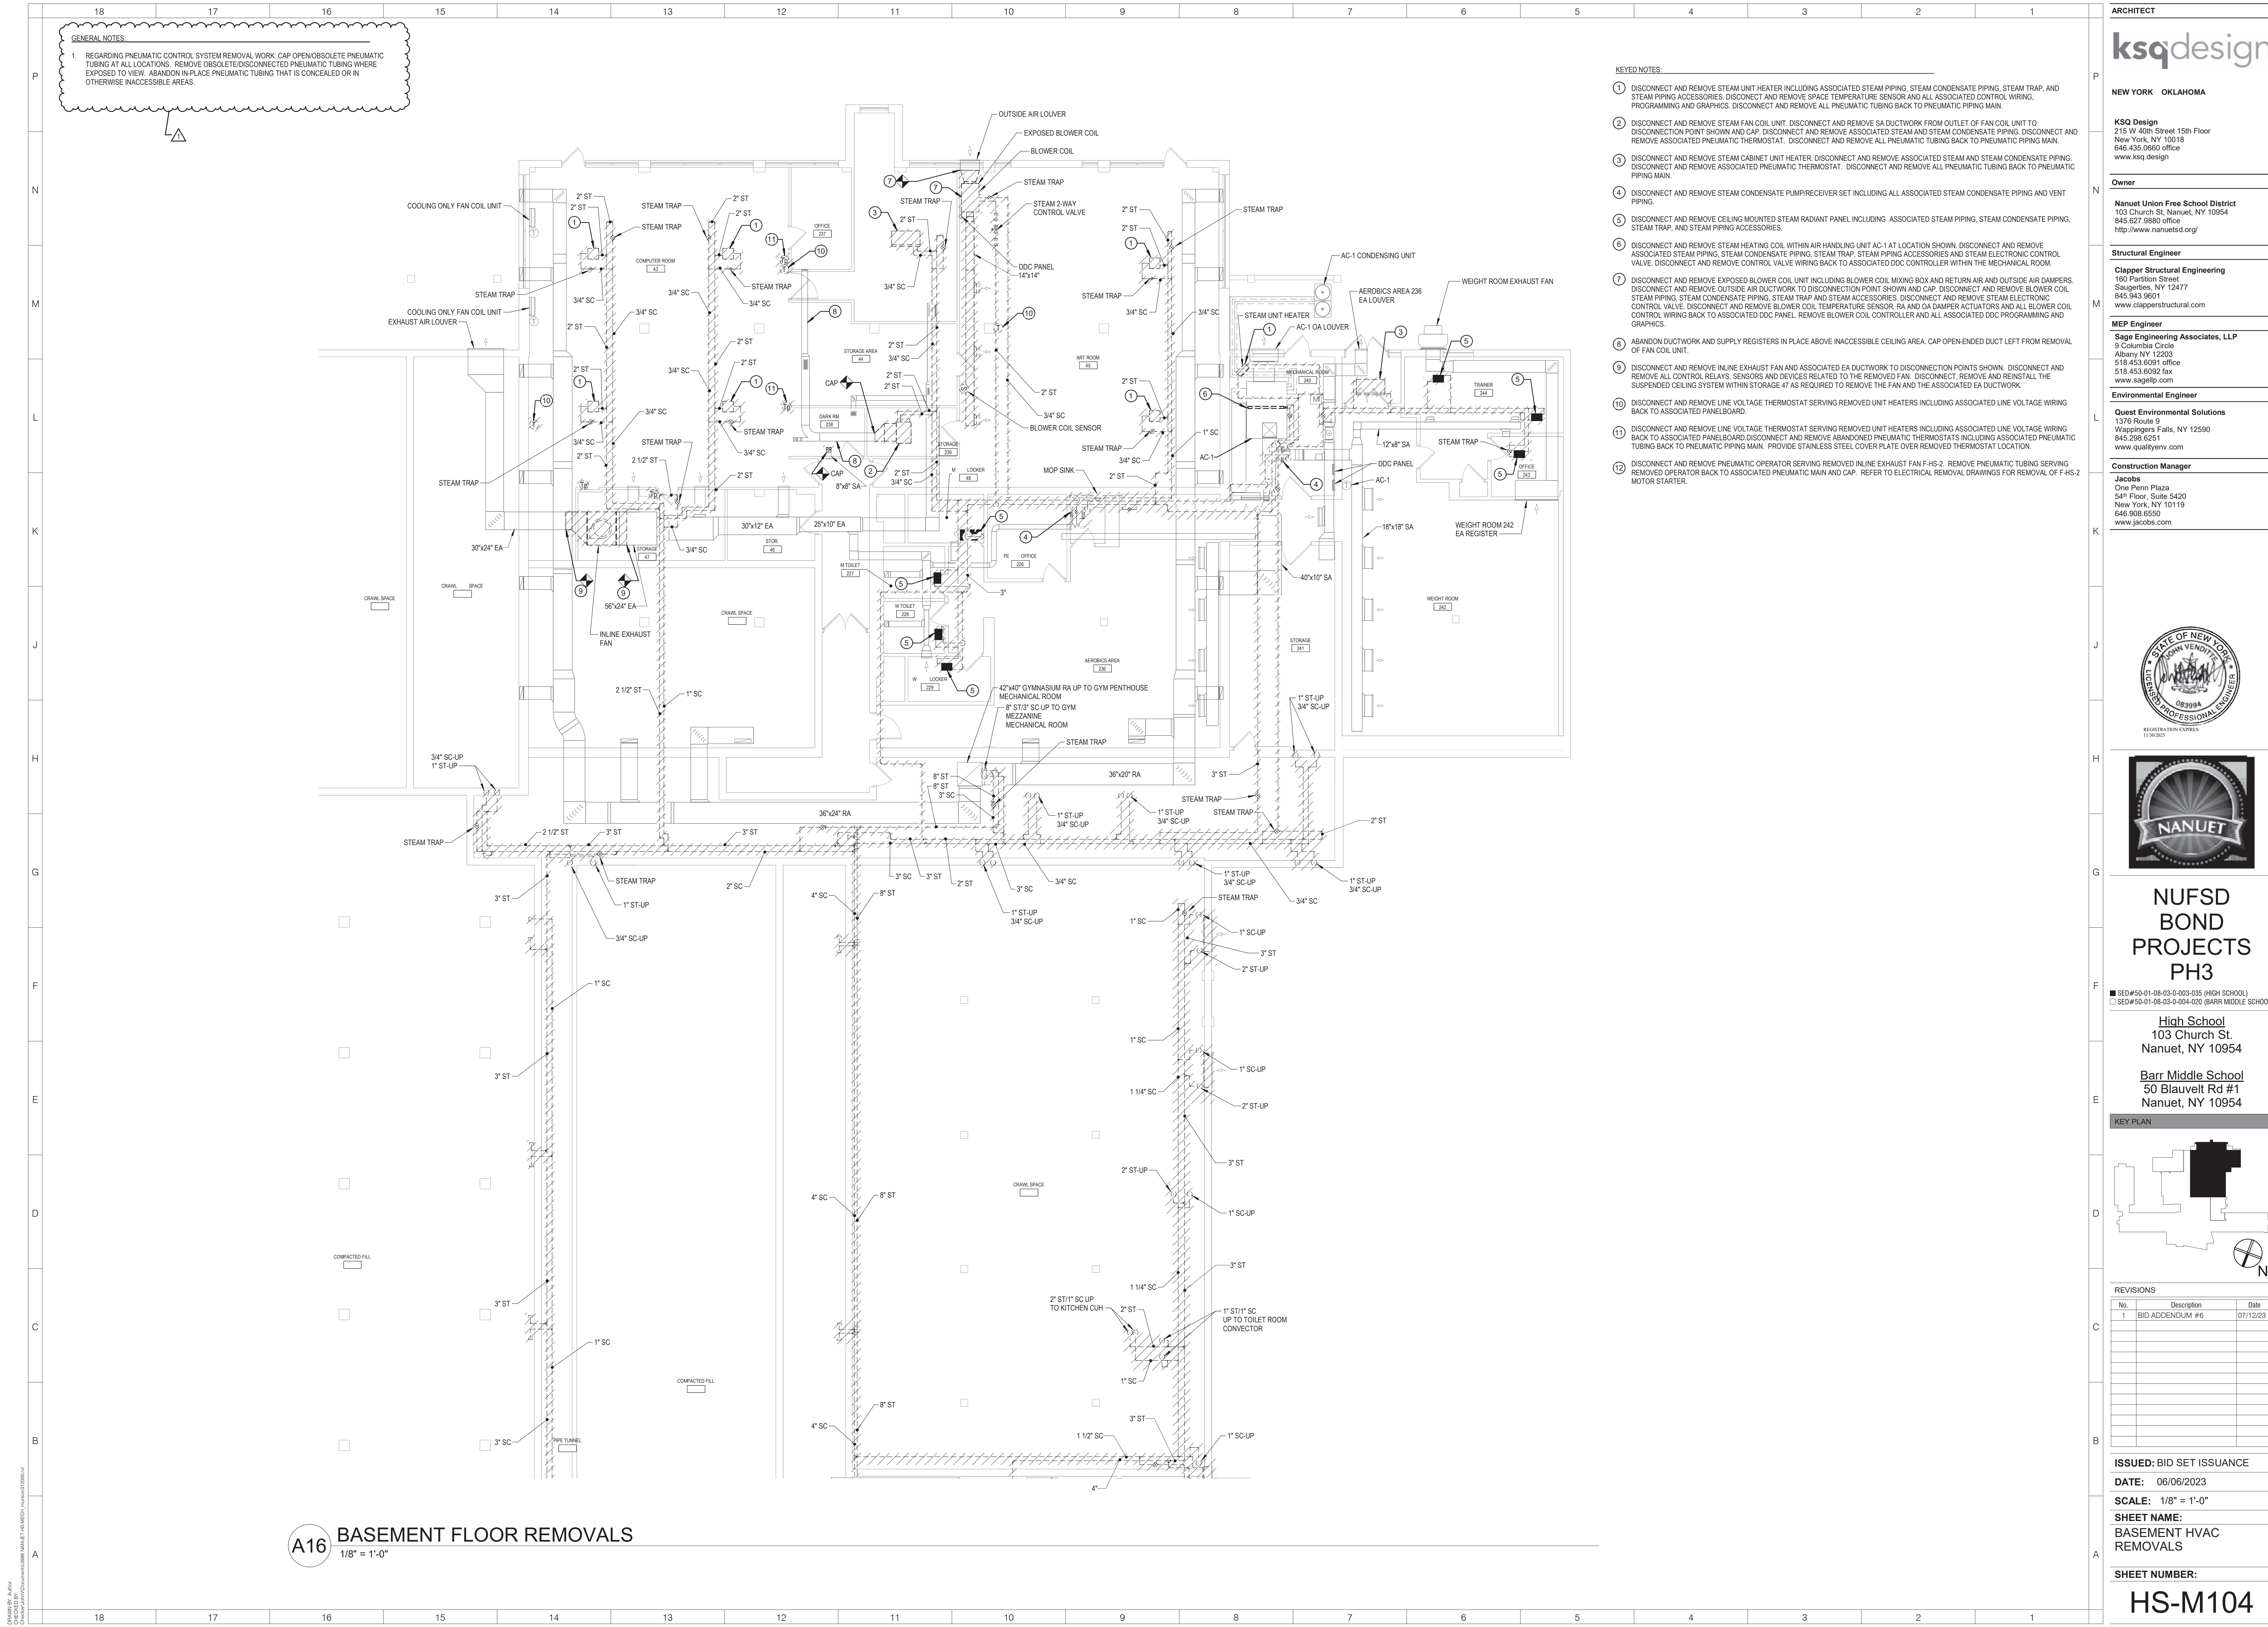REVISIONS

No.	Description	Date
1	BID ADDENDUM #6	07/12/23

ISSUED: BID SET ISSUANCE

DATE: 06/06/2023


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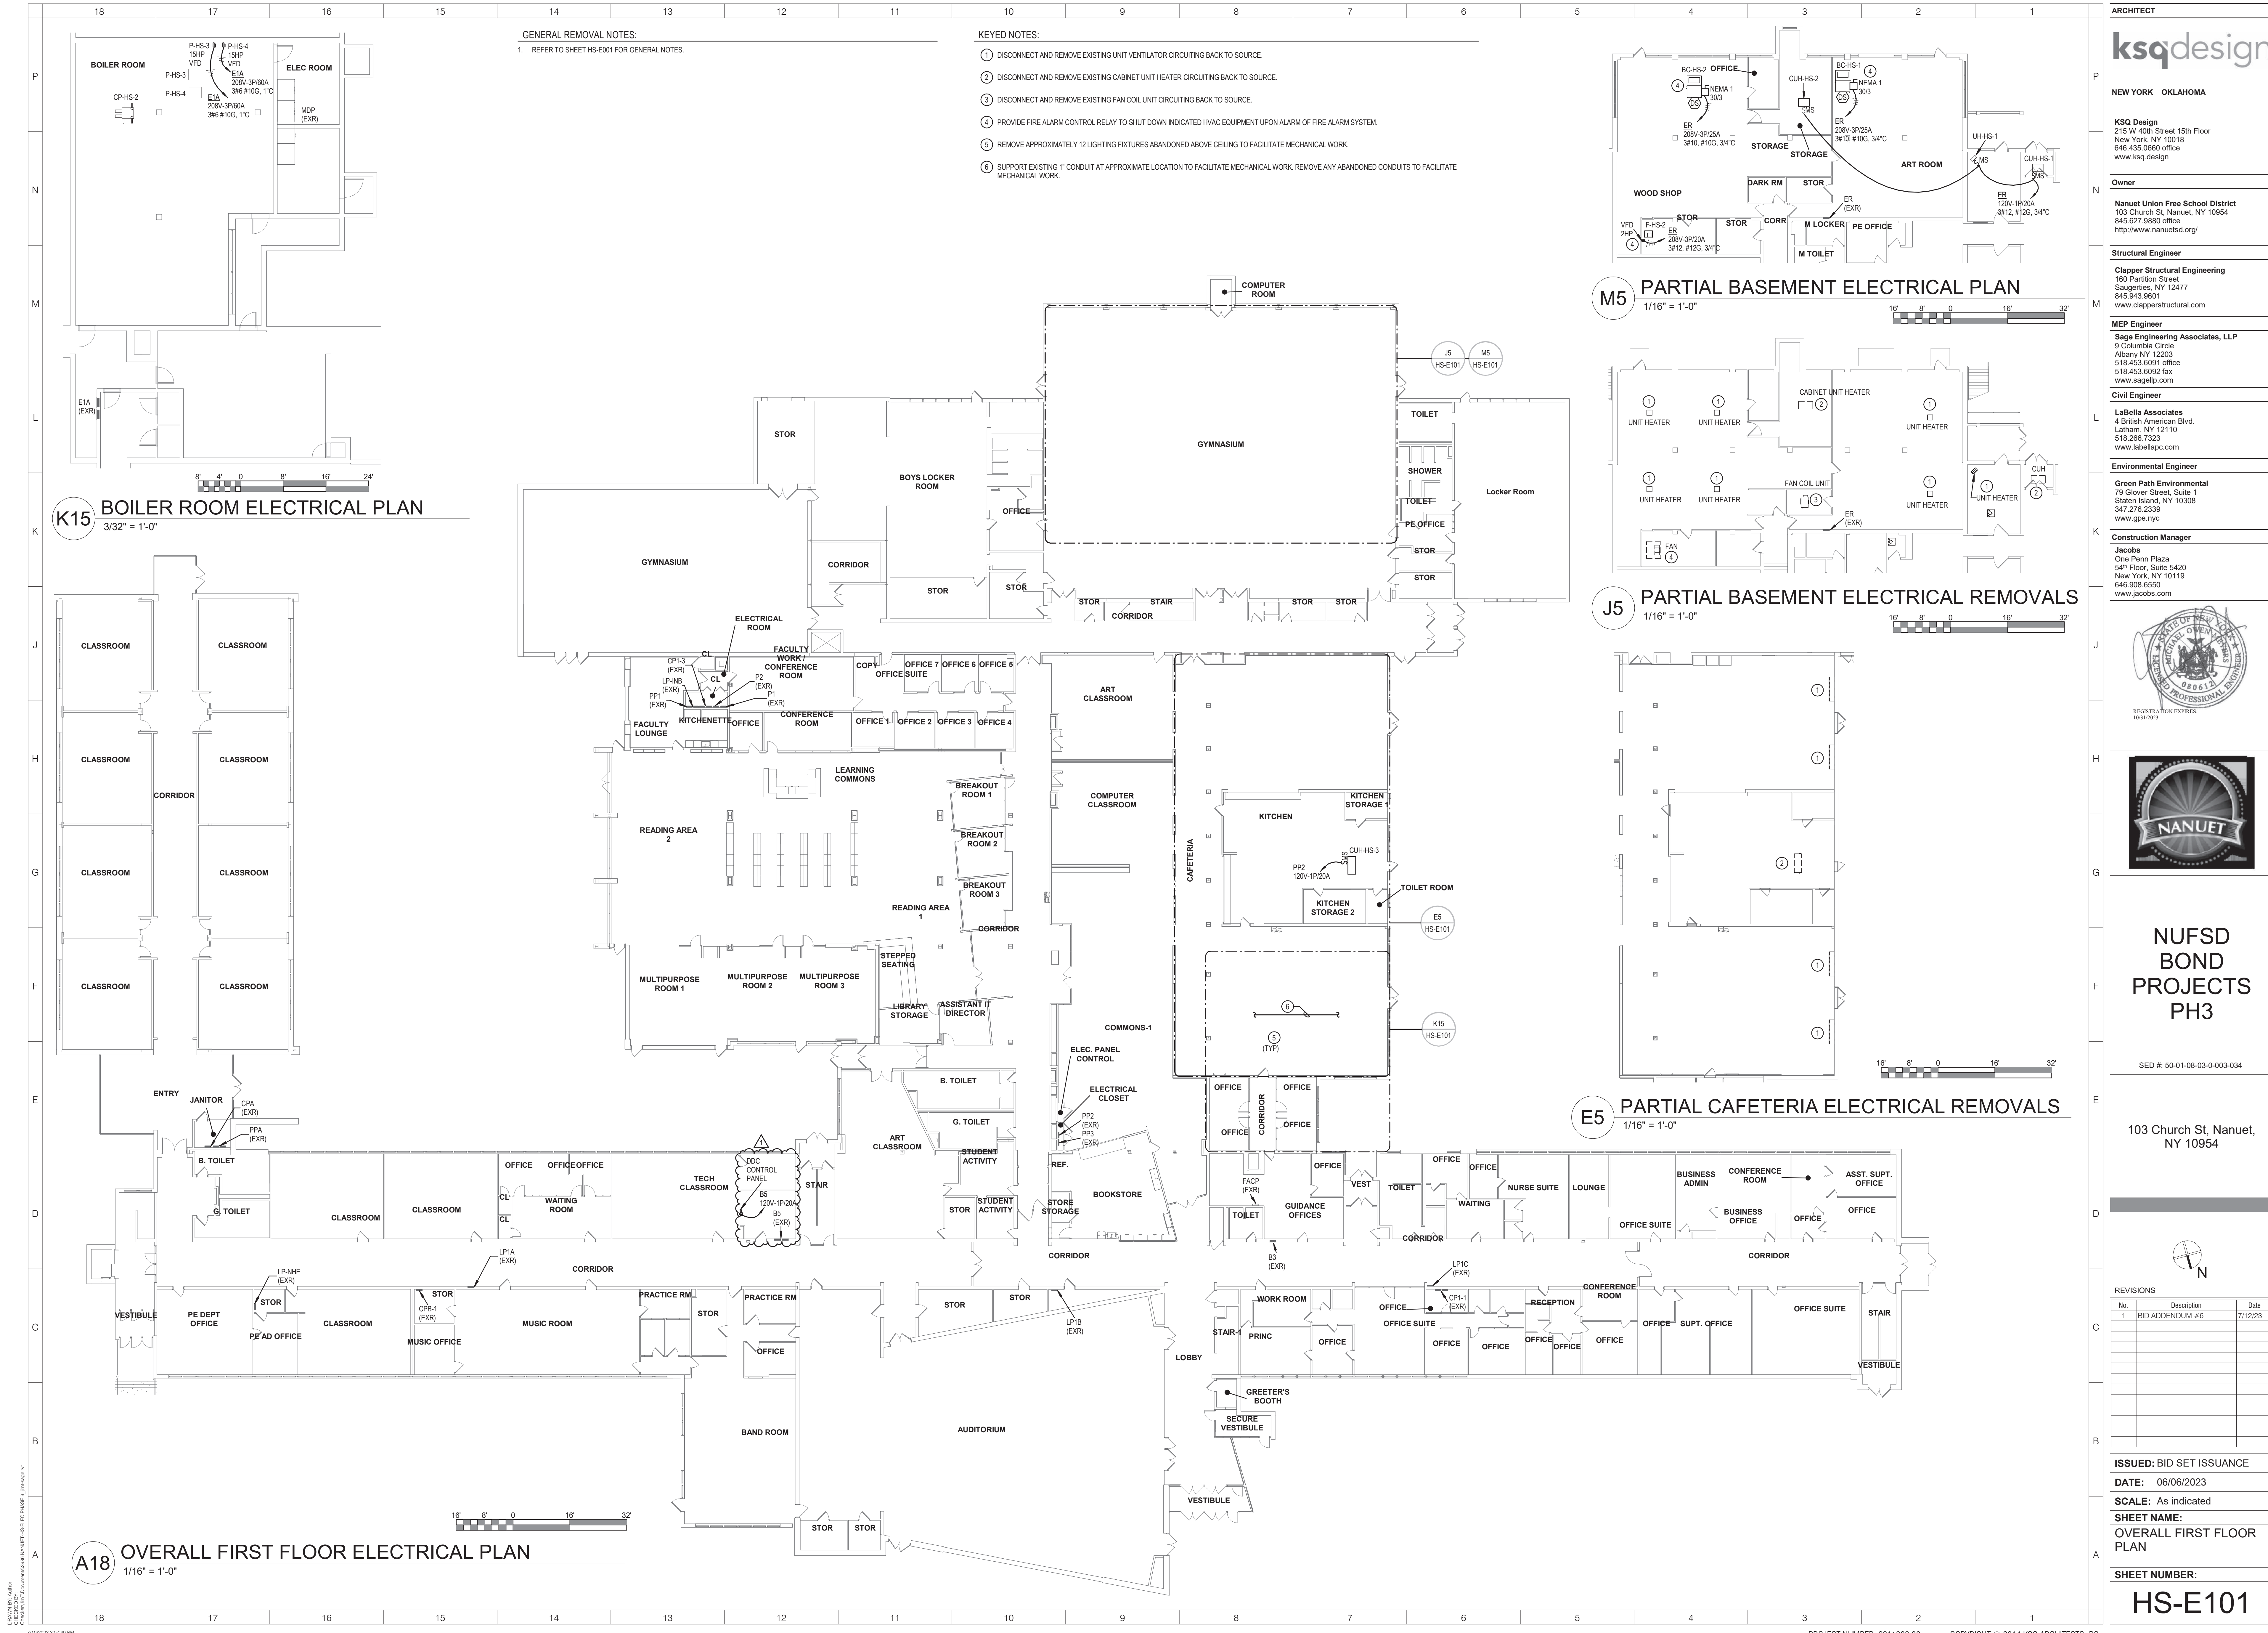
SHEET NAME:
BASEMENT HVAC
REMOVALS

SHEET NUMBER:

HS-M104

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PH3

SED #: 50-01-08-03-0-003-034

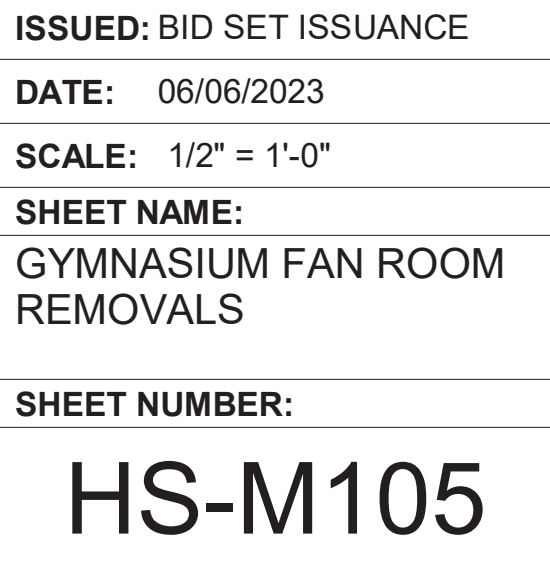103 Church St, Nanuet,
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REVISIONS

No.	Description	Date
1	BID ADDENDUM #6	7/12/23

ISSUED: BID SET ISSUANCE

DATE: 06/06/2023


SCALE: As indicated

SHEET NAME:
OVERALL FIRST FLOOR
PLAN


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HS-E101


ISSUE FOR BID SET

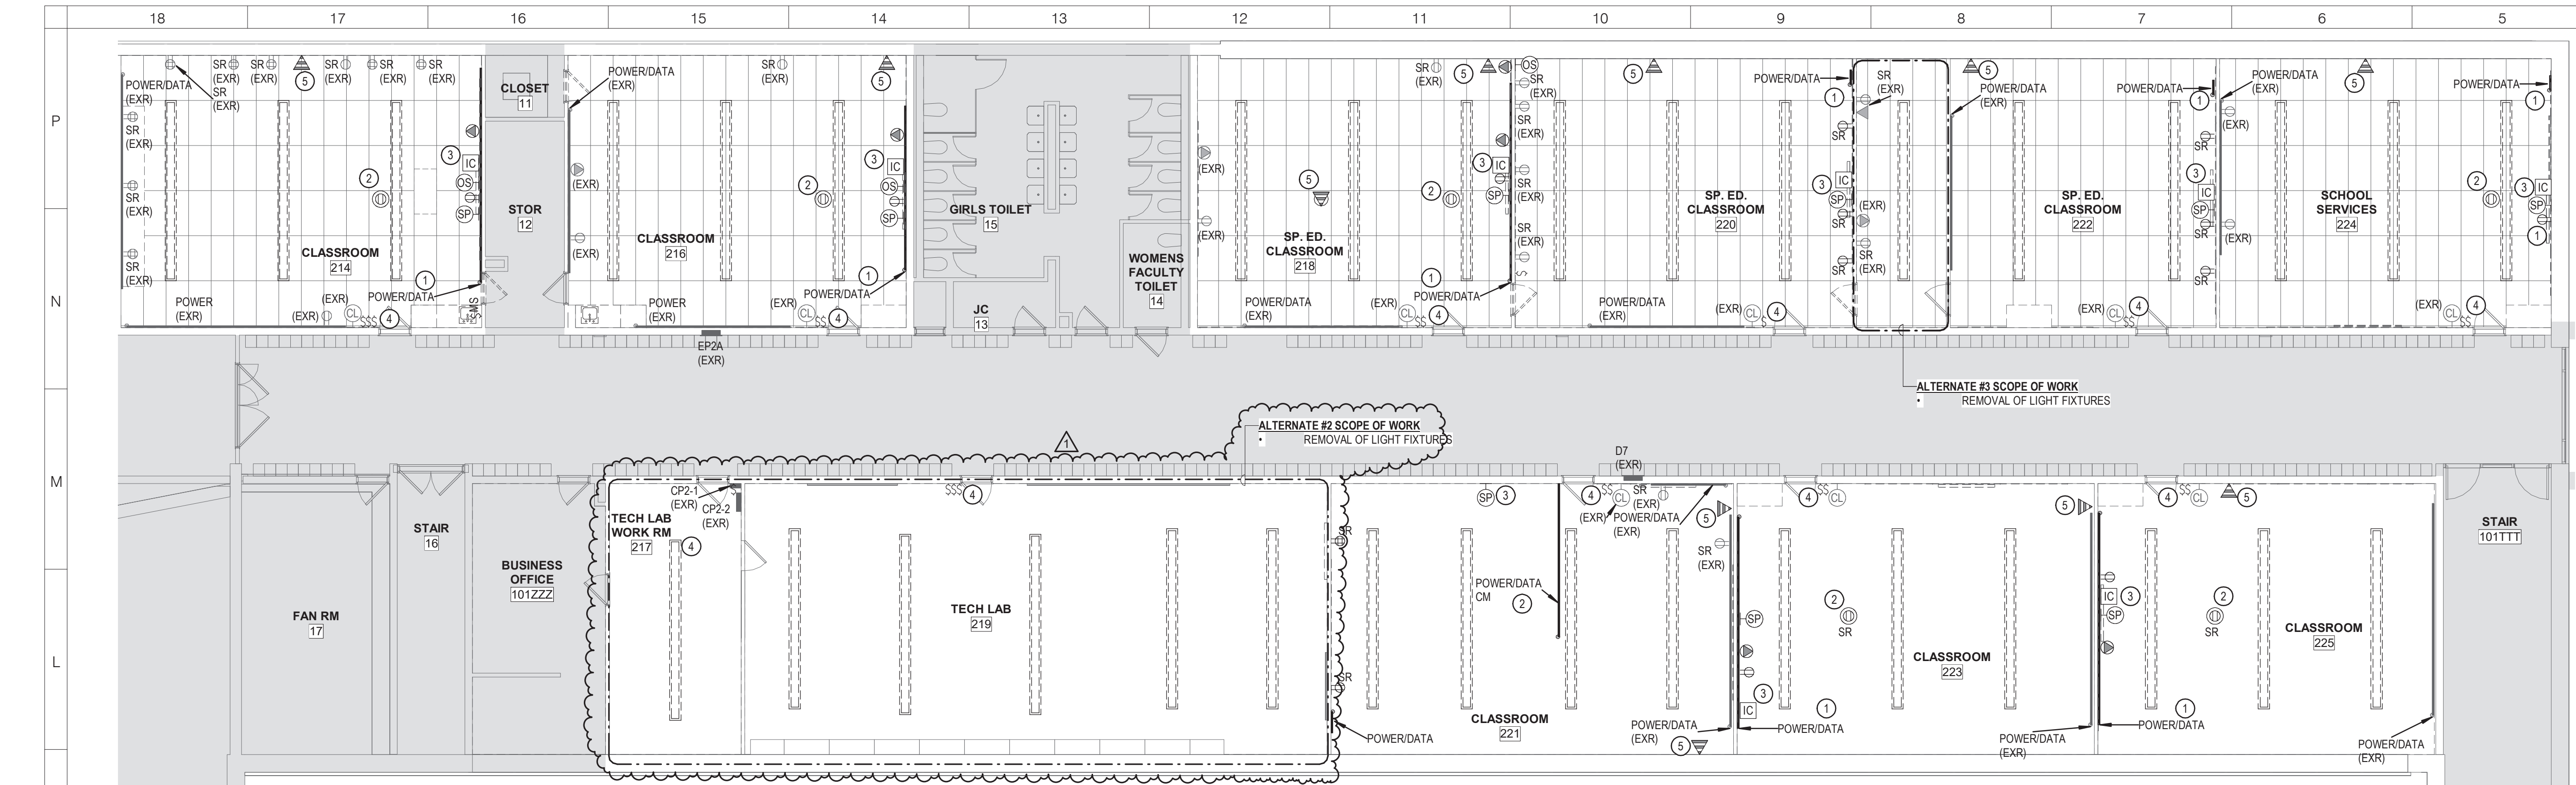

K18 PARTIAL SECOND FLOOR ELECTRICAL REMOVALS PLAN - NORTH WING
1/8" = 1'-0"

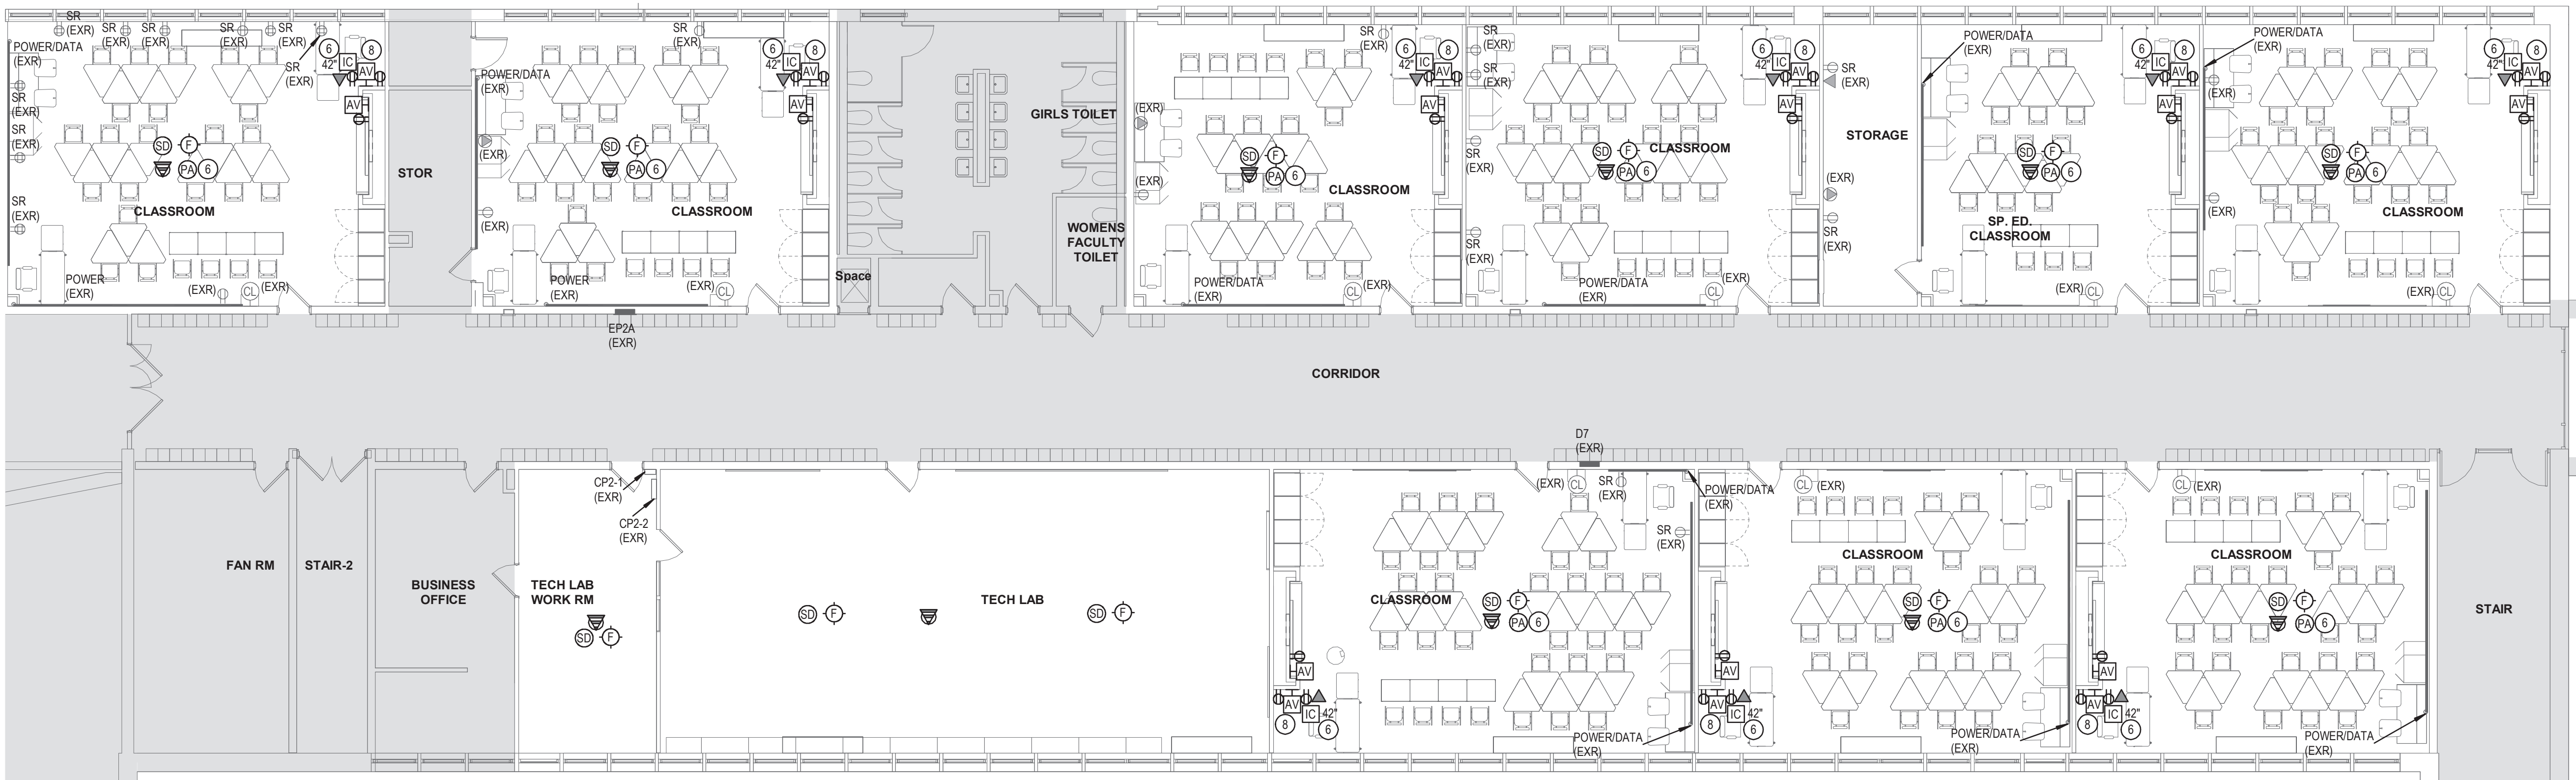

E18 PARTIAL SECOND FLOOR ELECTRICAL PLAN - NORTH WING
1/8" = 1'-0"

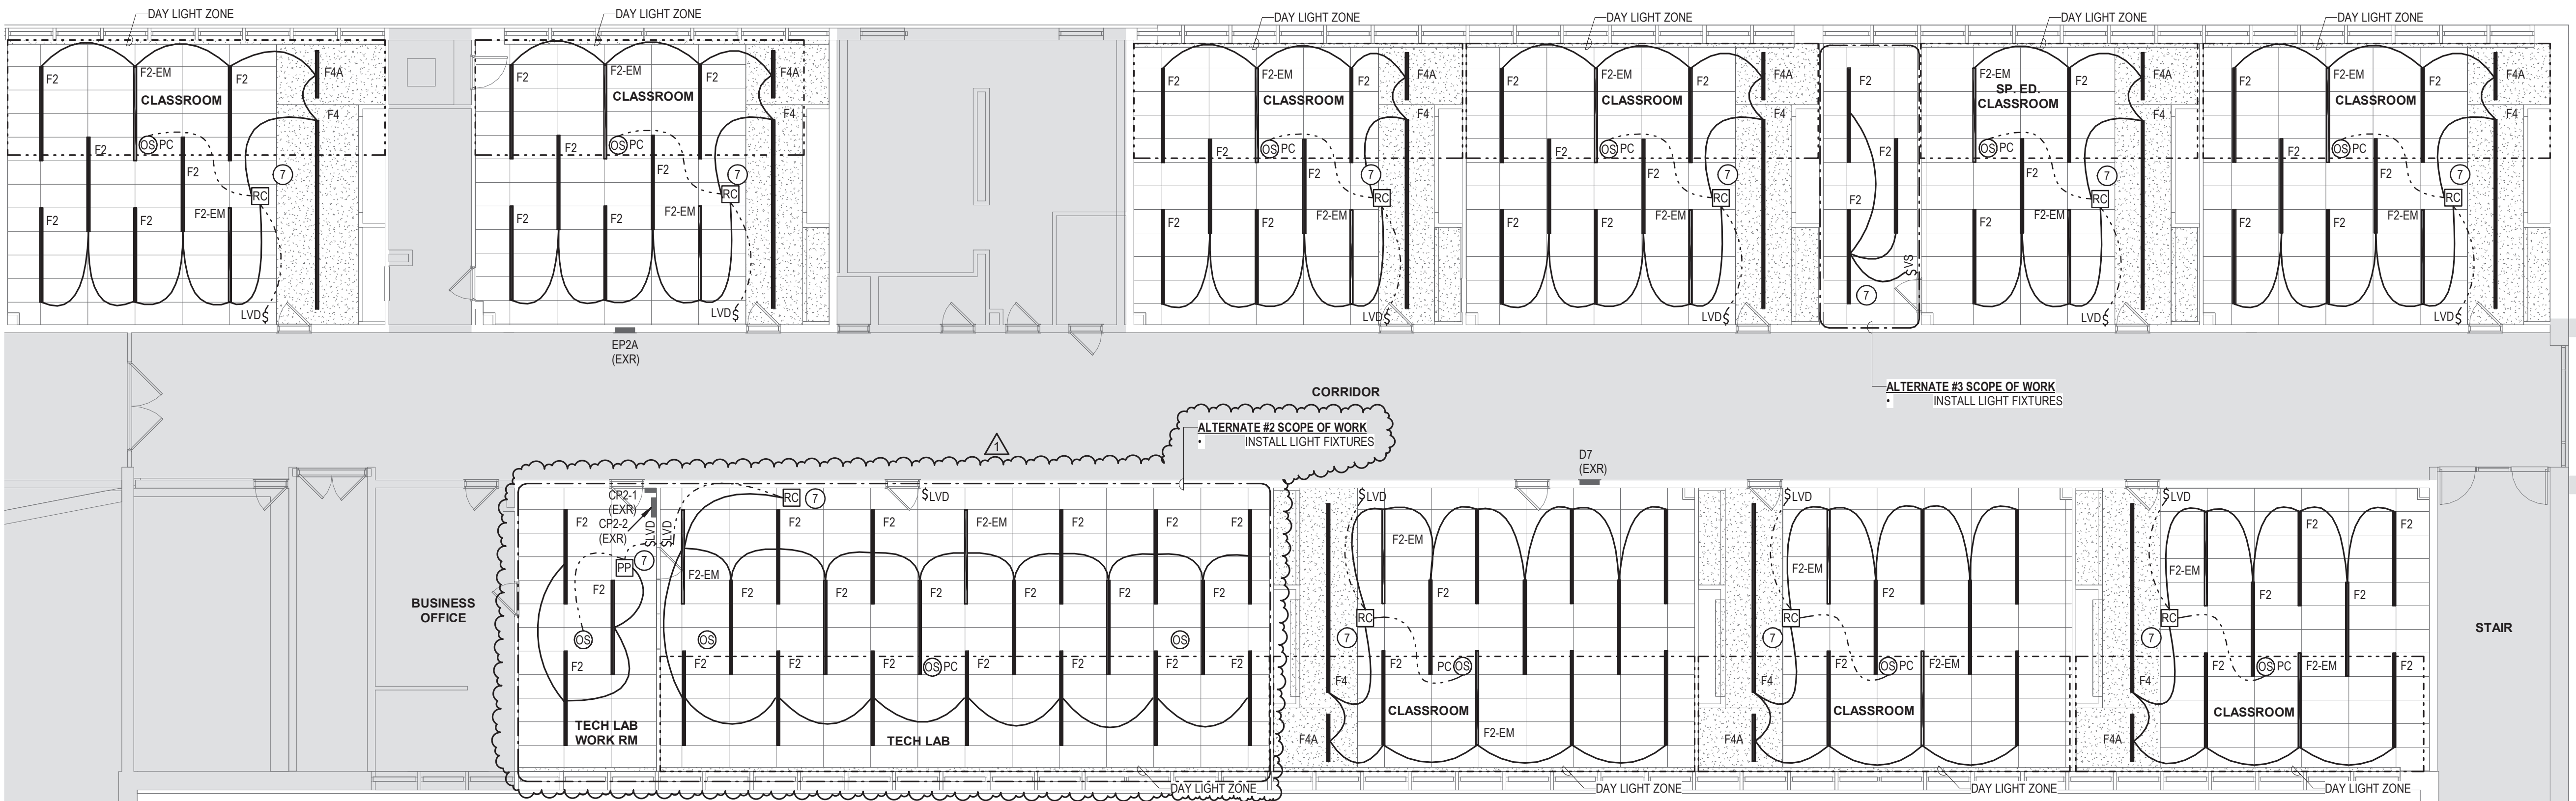

A18 PARTIAL SECOND FLOOR LIGHTING PLAN - NORTH WING
1/8" = 1'-0"

GENERAL REMOVAL NOTES:

1. REFER TO SHEET HS-E001 FOR GENERAL NOTES.

KEYED NOTES:

- 1 REMOVE LENGTH OF PLUGMOLD, POWER, AND DATA OUTLETS ON FROM THIS WALL.
- 2 REMOVE LENGTH OF PLUGMOLD, POWER, AND DATA OUTLETS ON FROM THE CEILING.
- 3 DISCONNECT AND REMOVE PA SYSTEM. PROTECT EXISTING WIRING AND PREPARE TO EXTEND WIRING TO LOCATION OF NEW CEILING MOUNTED PA SYSTEM.
- 4 REMOVE ALL LIGHTING AND CONTROLS. PRESERVE EXISTING CIRCUIT.
- 5 REMOVE WIRELESS ACCESS POINT.
- 6 PROVIDE NEW VALCOM CEILING MOUNTED PA SPEAKER (MODEL #V-1000A). EXTEND/PROVIDE NEW WIRING FOR PA SYSTEM AS REQUIRED TO ACCOMMODATE NEW LOCATION AS INDICATED. COORDINATE PA SYSTEM WITH DISTRICT AND MANUFACTURER INSTRUCTIONS PRIOR TO INSTALLATION.
- 7 CONNECT TO EXISTING LIGHTING CIRCUIT.
- 8 PROVIDE DRYWALL ACCESS PANEL 8X8 INCH HEAVY DURABLE PLASTIC WHITE. MANUFACTURER BOZZON. EXTEND EXISTING RECEPTACLE CIRCUIT TO NEW DEVICES.

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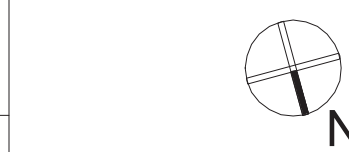
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PH3**

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DATE: 06/06/2023

SCALE: 1/8" = 1'-0"

SHEET NAME:
PARTIAL SECOND FLOOR
ELECTRICAL PLANS -
NORTH WING
SHEET NUMBER:

HS-E103

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