ORANGE-ULSTER BOCES ARDEN HILL - MAIN BUILDING ADDITIONS AND ALTERATIONS

4 HARRIMAN DRIVE GOSHEN, NY 10924

ISSUED FOR BID - JANUARY 09, 2025





ARDEN HILL - MAIN BUILDING ADDITIONS AND ALTERATIONS

KG&D Project No. **44-90-00-00-0-035-010**

DESIGN TEAM

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LIST OF DRAWINGS - VOLUME I

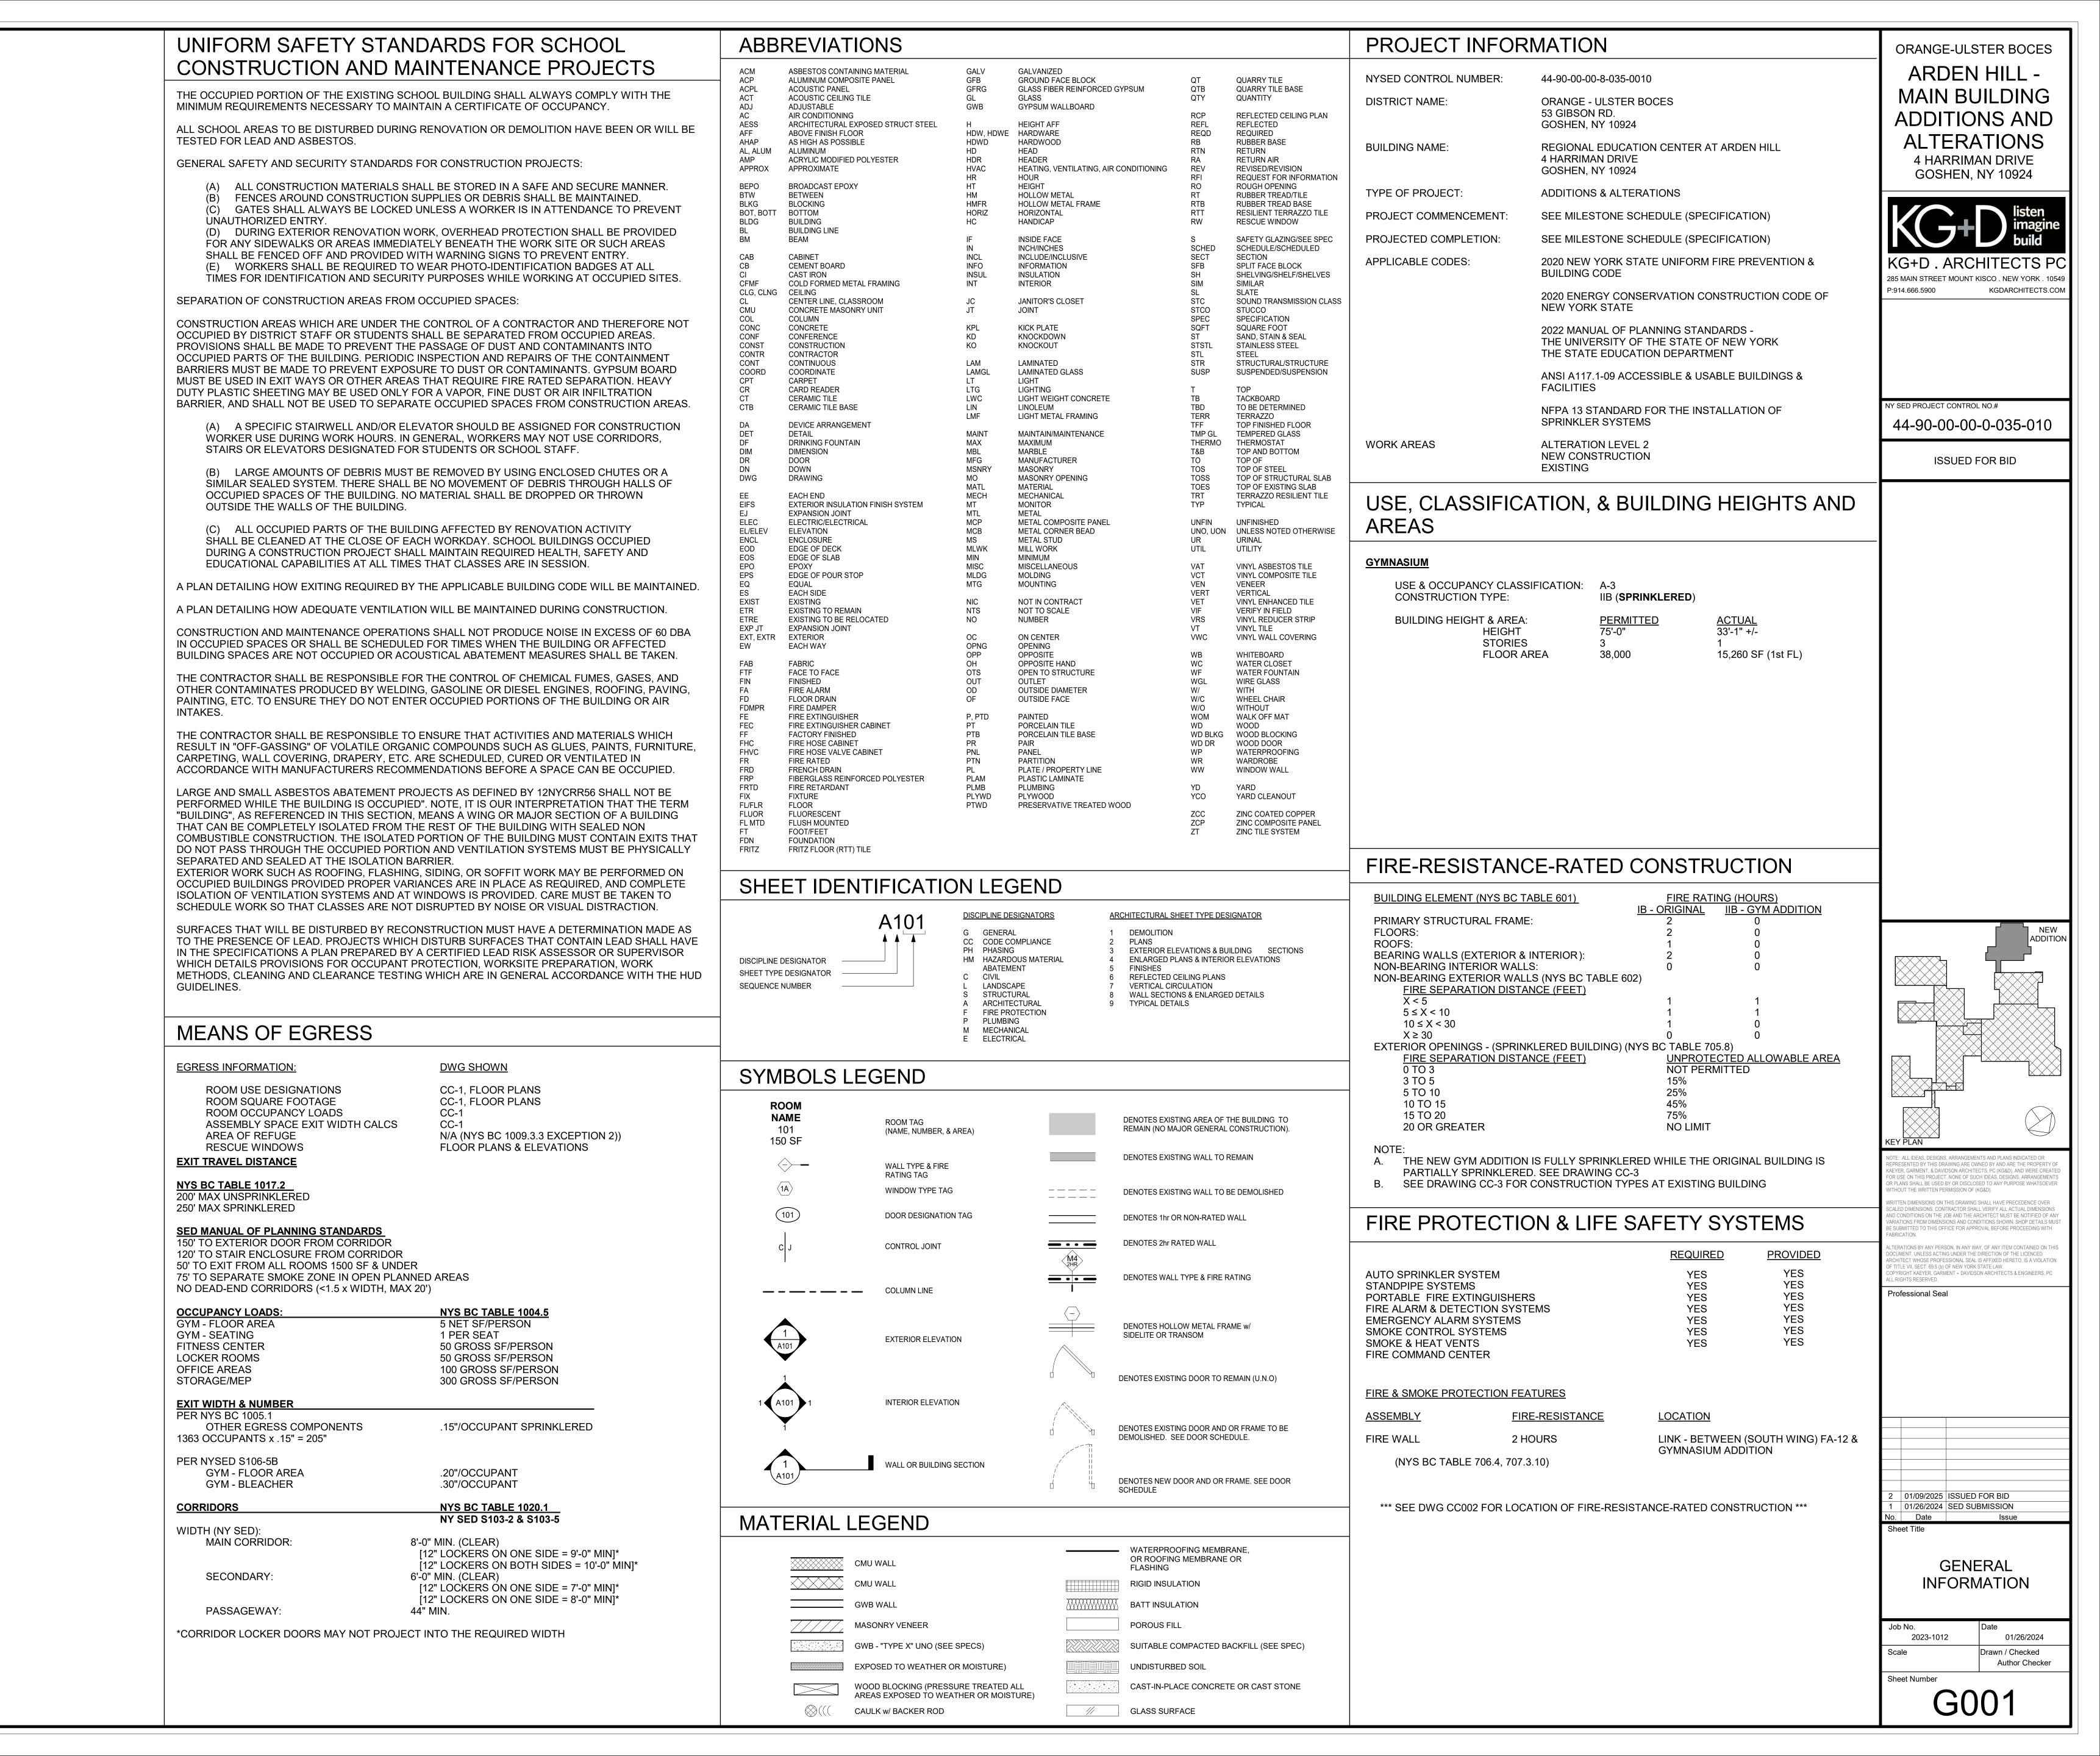
GENERAL	00/50
T1	COVER
GENERAL	
G001	GENERAL INFORMATION
G002	ADA COMPLIANCE DIAGRAMS
CODE COMPLA	ANCE
CC-1	CODE COMPLIANCE (OCCUPANCY) / SITE PLAN
CC-2	CODE COMPLIANCE
CC-3	CODE COMPLIANCE BLDG DIAGRAMS
CIVIL	
C101	EXISTING SITE PLAN
C102	PROPOSED SITE LAYOUT
C103	PROPOSED SITE LAYOUT 1 OF 3
C104	PROPOSED SITE LAYOUT 2 OF 3
C105	PROPOSED SITE LAYOUT 3 OF 3
C106	EROSION & SEDIMENT CONTROL PLAN
C201	EROSION & SEDIMENT CONTROL DETAILS
C202	CONSTRUCTION DETAILS
C203	CONSTRUCTION DETAILS
LANDSCAPE	
L100	LANDSCAPE PLAN
STRUCTURE	
S-001	STRUCTURAL NOTES
S-101	FOUNDATION PLA N
S-102	SLAB PLAN
S-103	CMU WALL AND LINTEL PLAN
S-104	LOW ROOF FRAMING PLAN
S-105	UPPER ROOF FRAMING PLAN
S-301	BUILDING SECTIONS

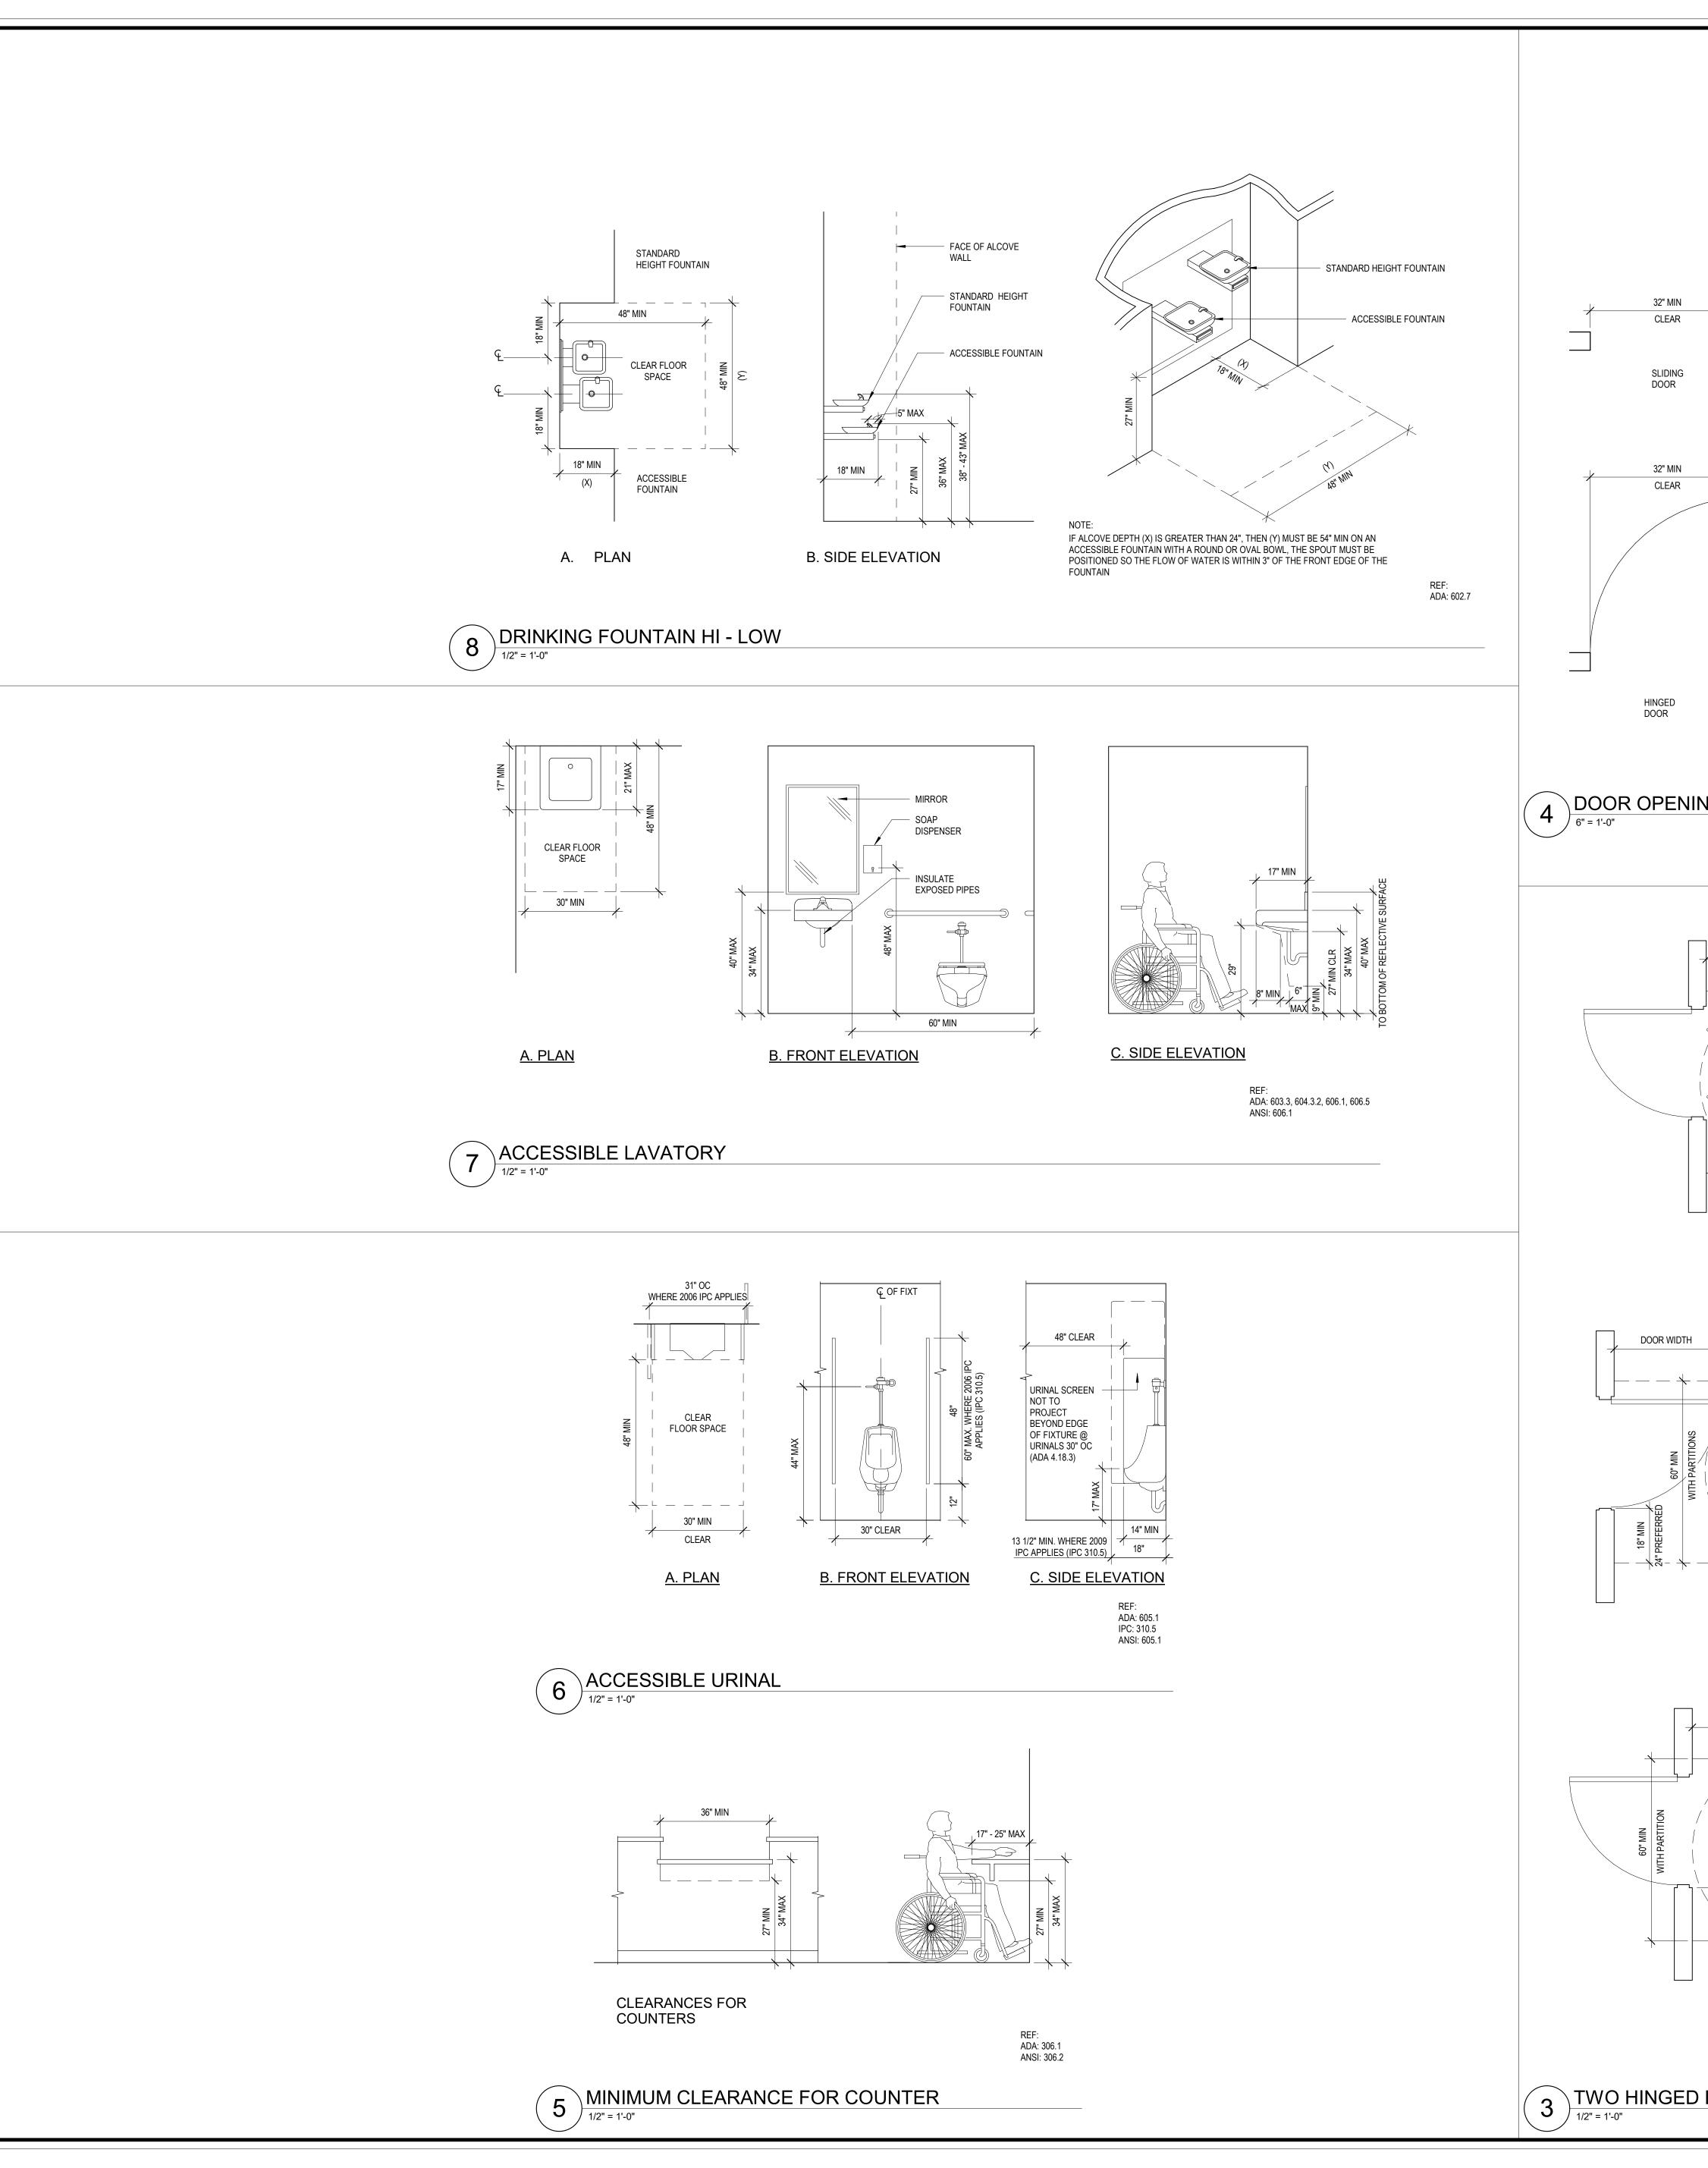
S-302	WALL SECTIONS
S-401	ELEVATIONS AND SECTIONS
S-501	FOUNDATION & SLAB DETAILS
S-502	MASONRY WALL DETAILS
S-503	STRUCTURAL STEEL DETAILS
HITECTUR	ĽE
A102	OVERALL 1ST FLOOR PLAN DEMOLITION
A200	OVERALL PLANS
A202A	GYMNASIUM FLOOR PLAN
A202B	GYMNASIUM CLERESTORY PLAN
A205	GYMNASIUM LOWER ROOF PLAN (BASE BID)
A205A	GYMNASIUM LOWER ROOF PLAN (ADD ALT)
A206	GYMNASIUM UPPER ROOF PLAN
A230	GYM ADDITION ROOF DETAILS
A304	GYMNASIUM EXTERIOR ELEVATIONS
A305	BUILDING SECTIONS
A401	INTERIOR ELEVATIONS
A402	INTERIOR ELEVATIONS
A403	INTERIOR ELEVATIONS
A404	INTERIOR TOILET PLANS & ELEVATIONS
A501	FINISH SCHEDULE & FLOOR FINISH PLANS
A530	SIGNAGE TYPES & SCHEDULE
A601	REFLECTED CEILING PLAN
A610	TYPICAL CEILING DETAILS
A801	WALL SECTIONS
A802	WALL SECTIONS
A803	WALL SECTIONS
A804	WALL SECTIONS
A805	WALL SECTIONS
A810	WALL SECTION DETAILS
A811	WALL SECTION DETAILS
A812	WALL SECTION DETAILS

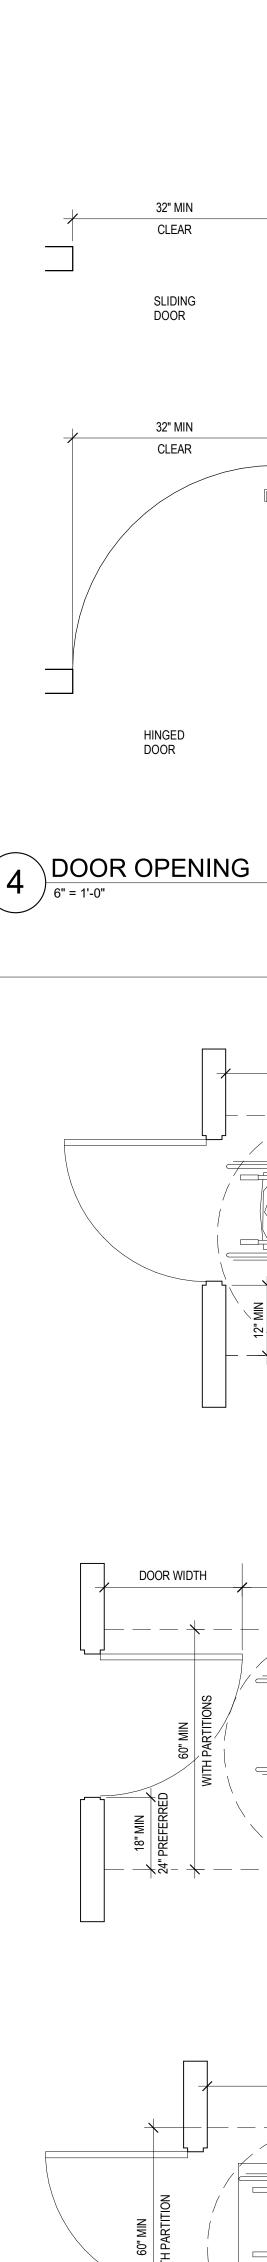
A830	PLAN DETAILS
A831	PLAN DETAILS
A832	MISCELLANEOUS DETAILS
A901	PARTITION TYPES
A902	DOOR SCHEDULES, DOOR TYPES & DETAILS
A903	WINDOW TYPES
A904	WINDOW DETAILS
	FOTDION
UMBING & EI	
PESP200	SITE PLAN
RE PROTECT	ION
FP202A	GYMNASIUM PLANS
FP202B	GYMNASIUM CLERESTORY PLAN
FP601	DETAILS
FP602	DETAILS
FP701	EQUIPMENT SCHEDULES
UMBING	
P202A	GYMNASIUM BELOW SLAB PLAN
P202B	GYMNASIUM FLOOR PLANS
P202C	GYMNASIUM CLERESTORY PLAN
P203	GYMNASIUM ROOF PLAN
P401	BACKFLOW PREVENTER FILING
P601	DETAILS
P602	DETAILS
P701	EQUIPMENT SCHEDULES
ECHANICAL	
N 4000 A	GYMNASIUM PLANS
M202A	
M202A M202B	GYMNASIUM CLERESTORY PLAN
	GYMNASIUM CLERESTORY PLAN GYMNASIUM ROOF PLAN

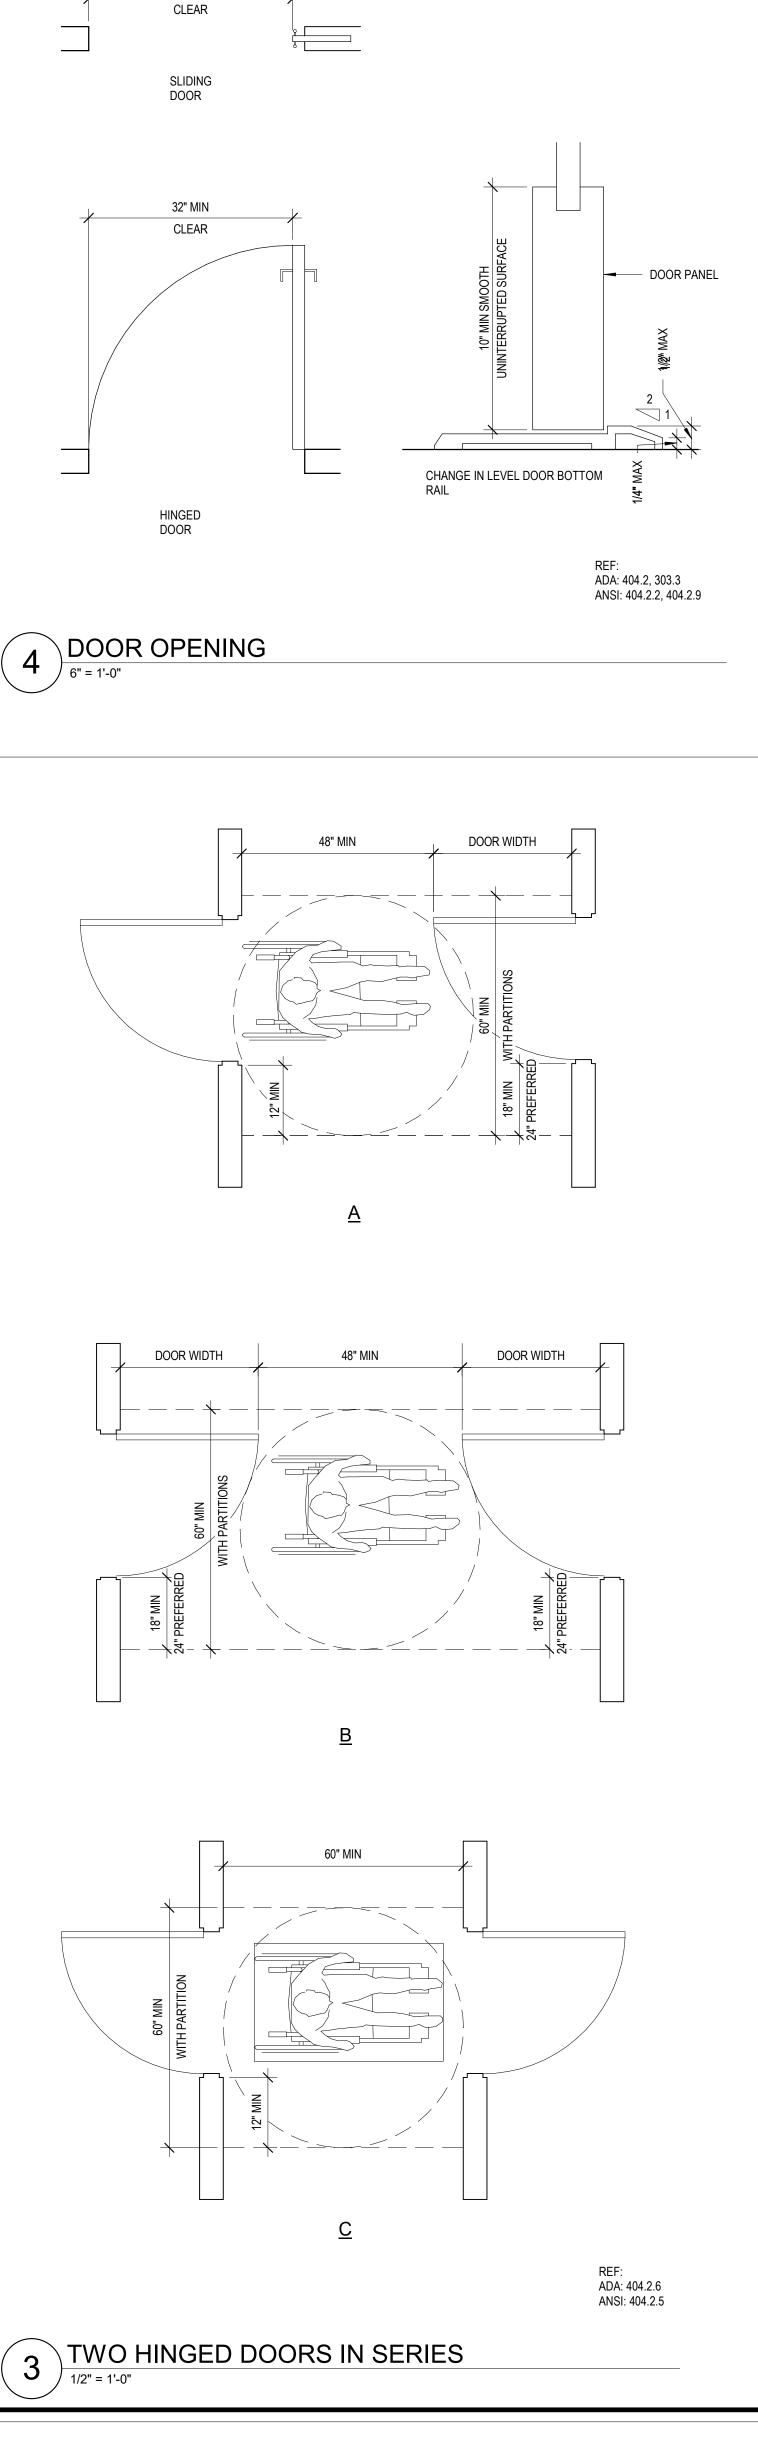
M601	DETAILS
M602	DETAILS
M701	EQUIPMENT SCHEDULES
M702	EQUIPMENT SCHEDULES
LECTRICAL	
E201	GROUND, FIRST & SECOND FLOOR PLANS
E202A	GYMNASIUM POWER PLAN
E202B	GYMNASIUM CLERESTORY POWER PLAN
E203	GYMNASIUM ROOF PLANS
E302A	GYMNASIUM LIGHTING PLANS
E402A	GYMNASIUM DATA A/V & SECURITY PLANS
E502A	GYMNASIUM LIGHTNING PROTECTION PLANS
E601	DETAILS
E602	DETAILS
E701	EQUIPMENT SCHEDULES
IRE ALARM	
FA202A	GYMNASIUM PLANS
FA202B	GYMNASIUM CLERESTORY PLAN
FA601	DETAILS
Frand total: 96	

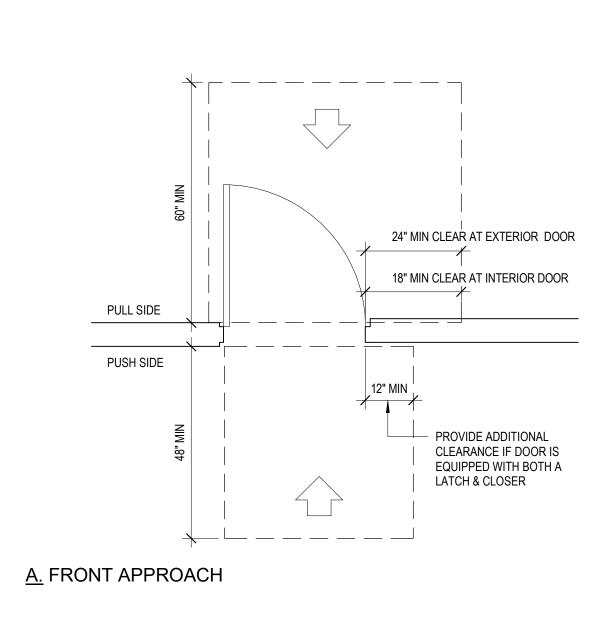
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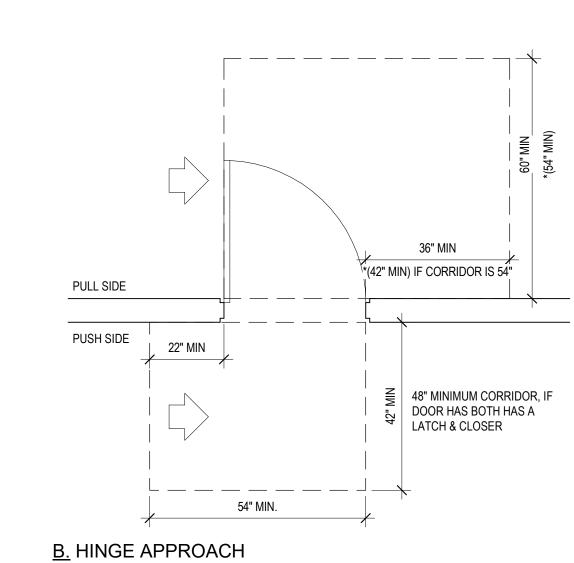


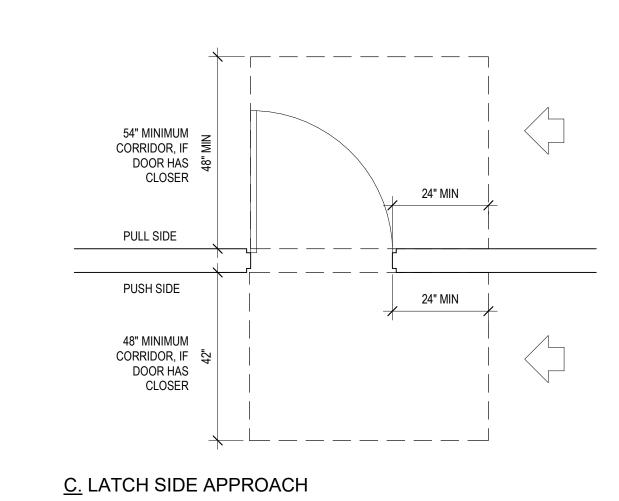




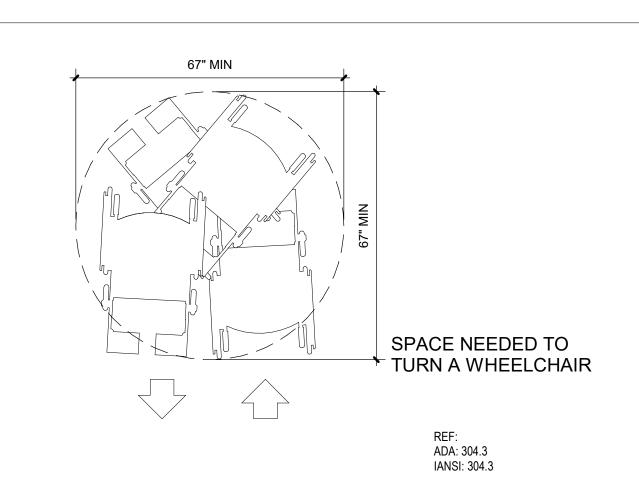












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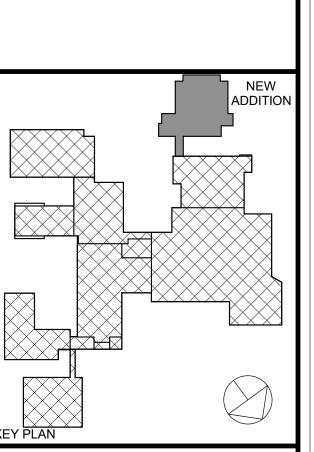


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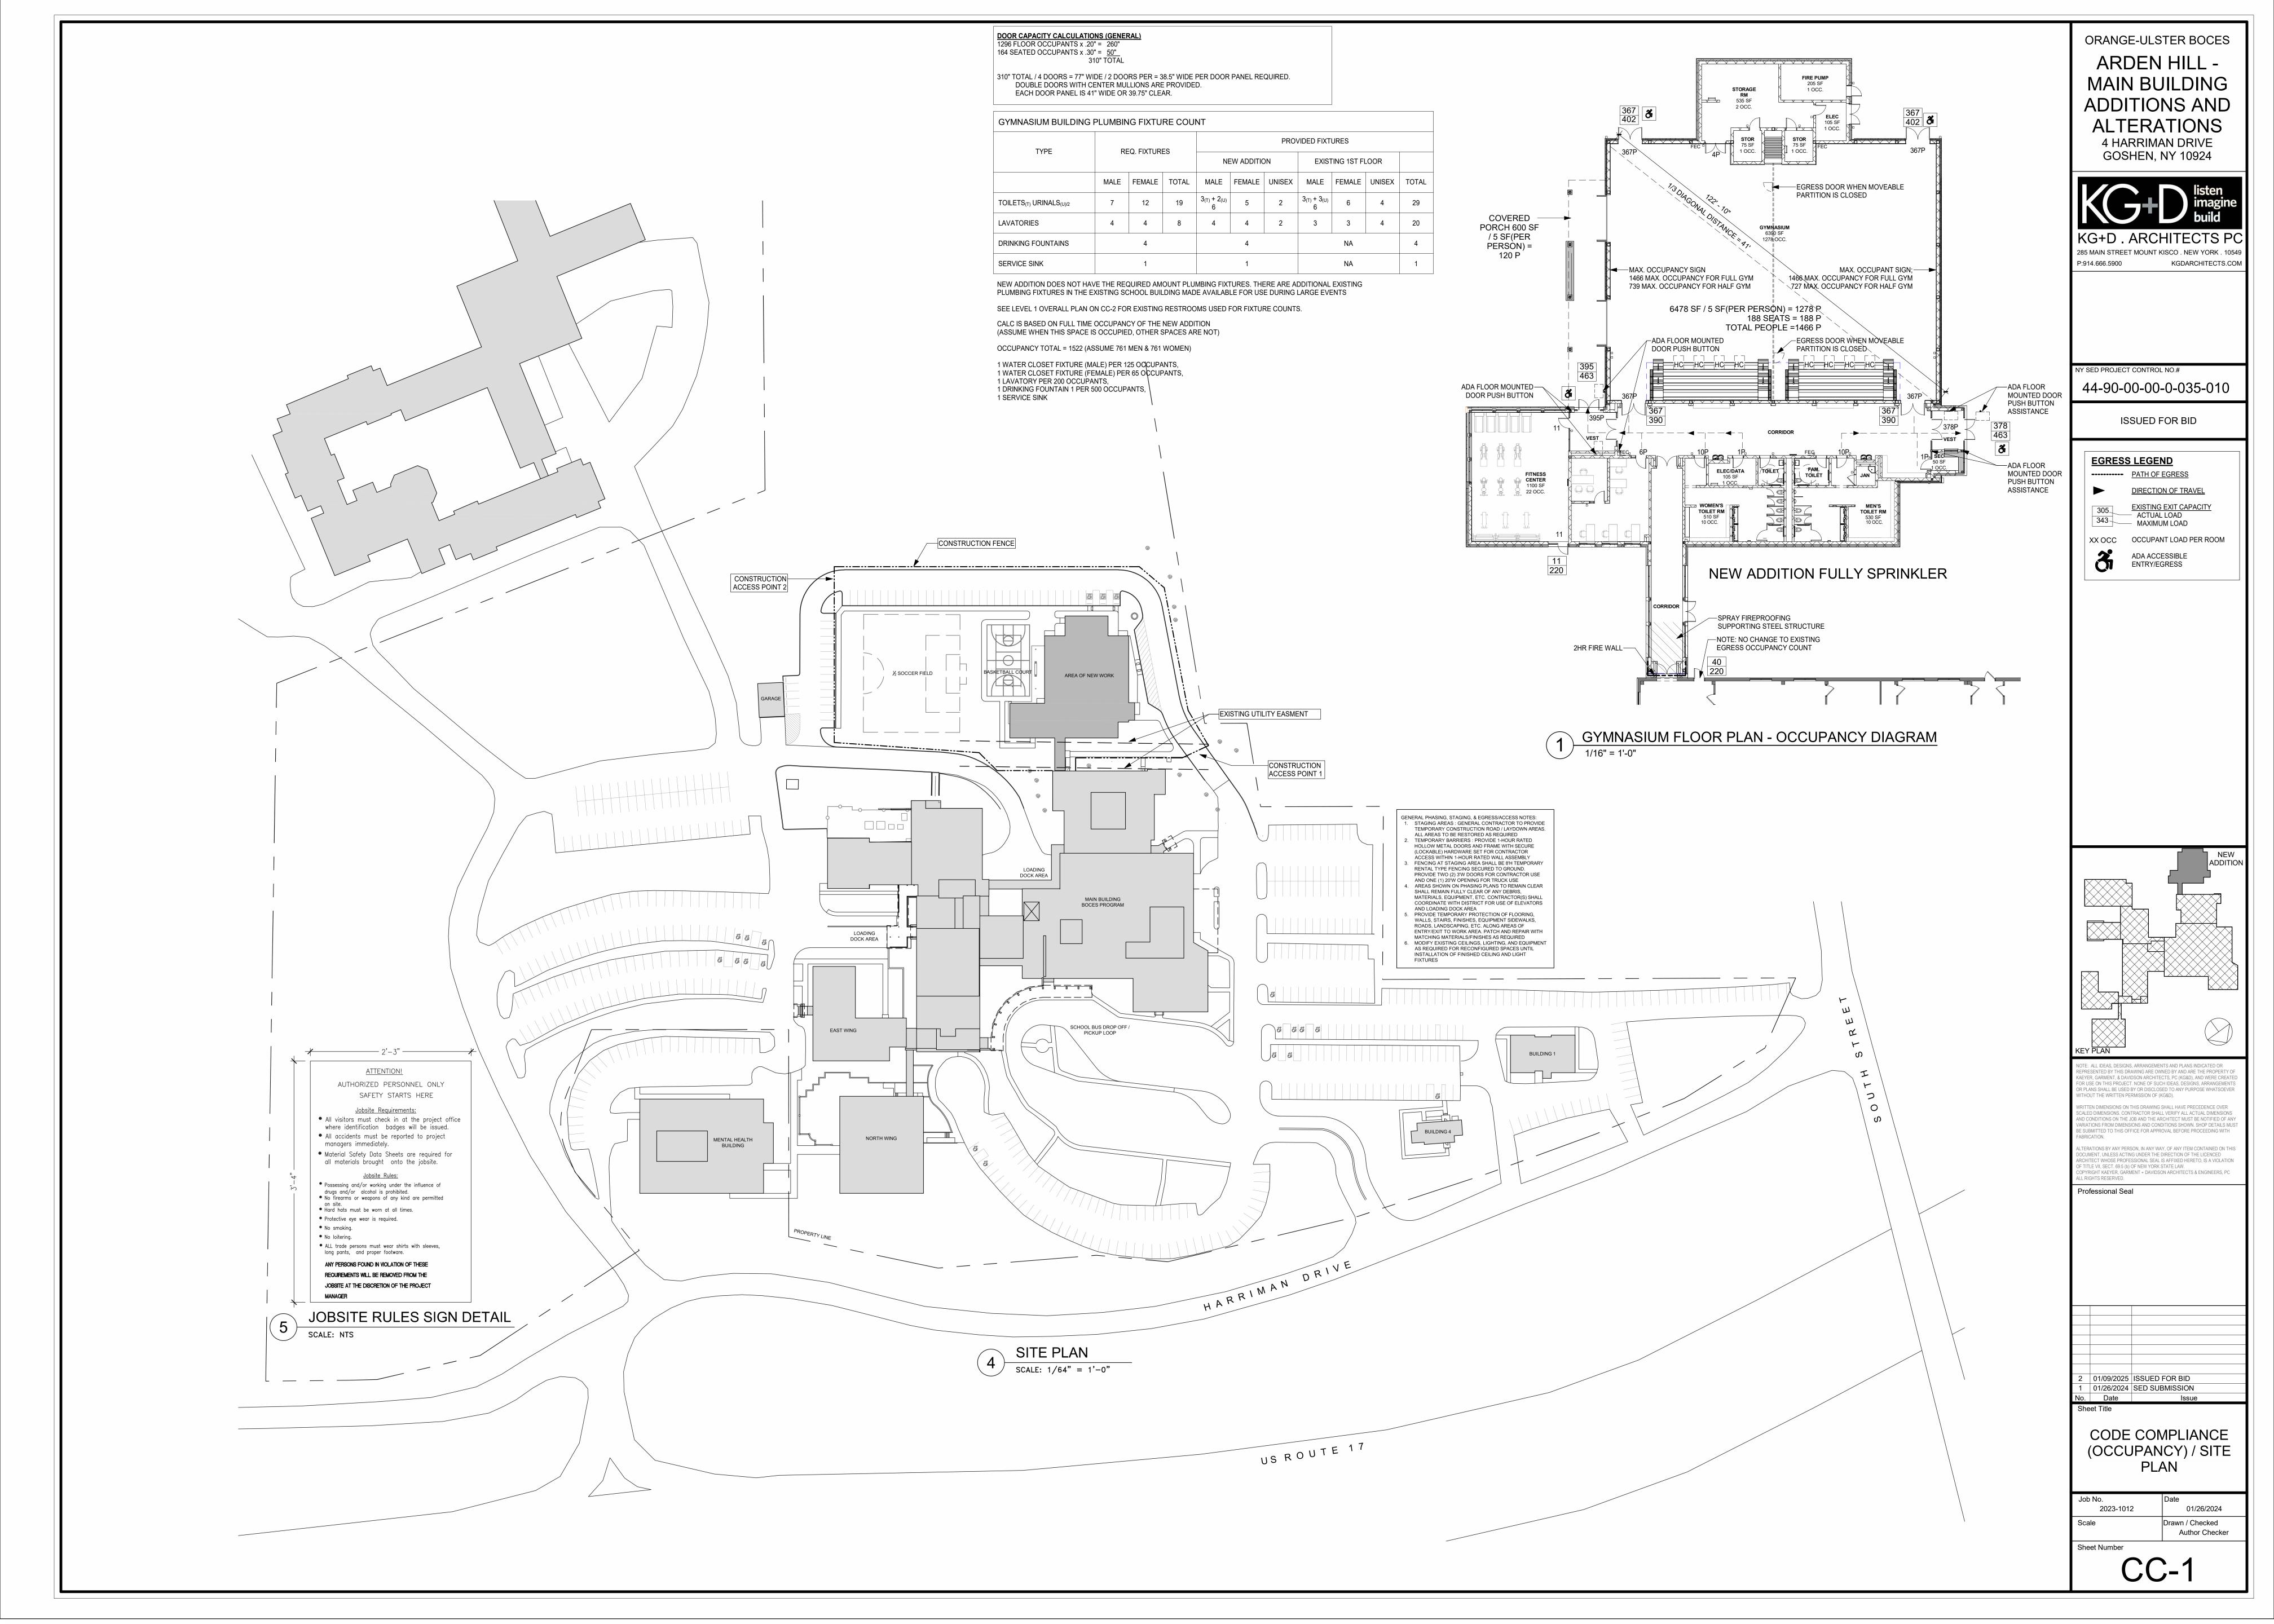
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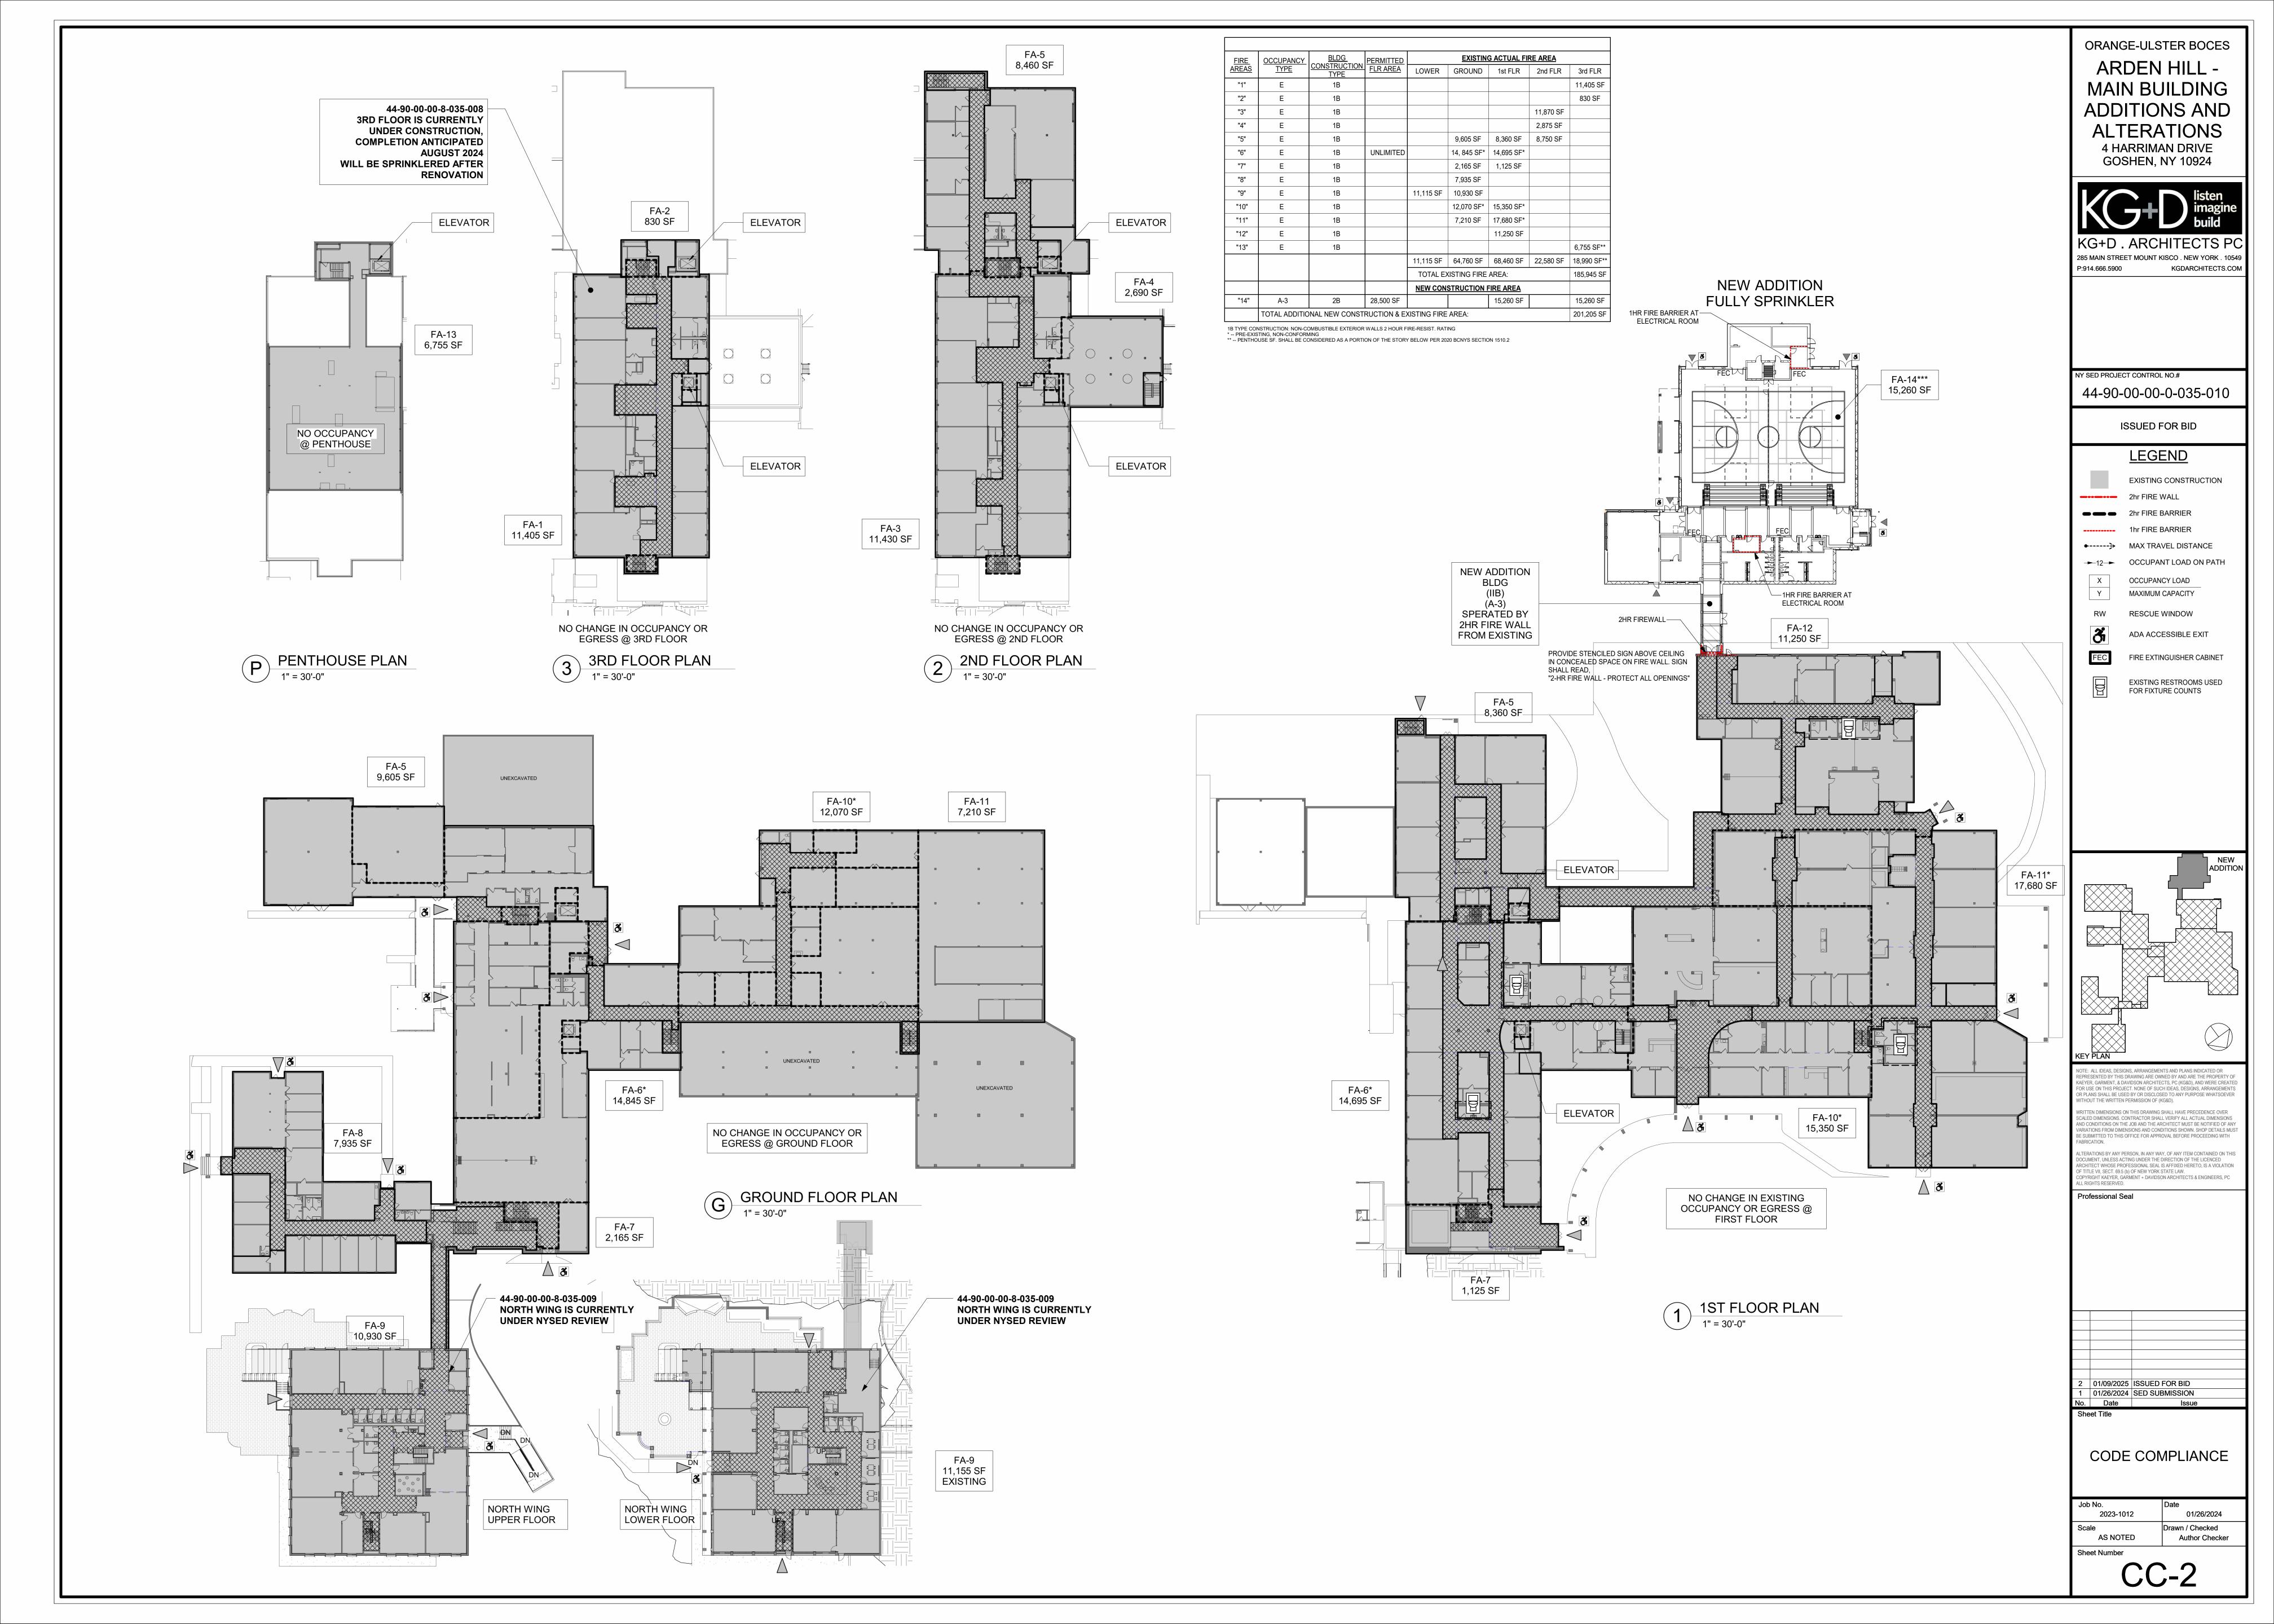
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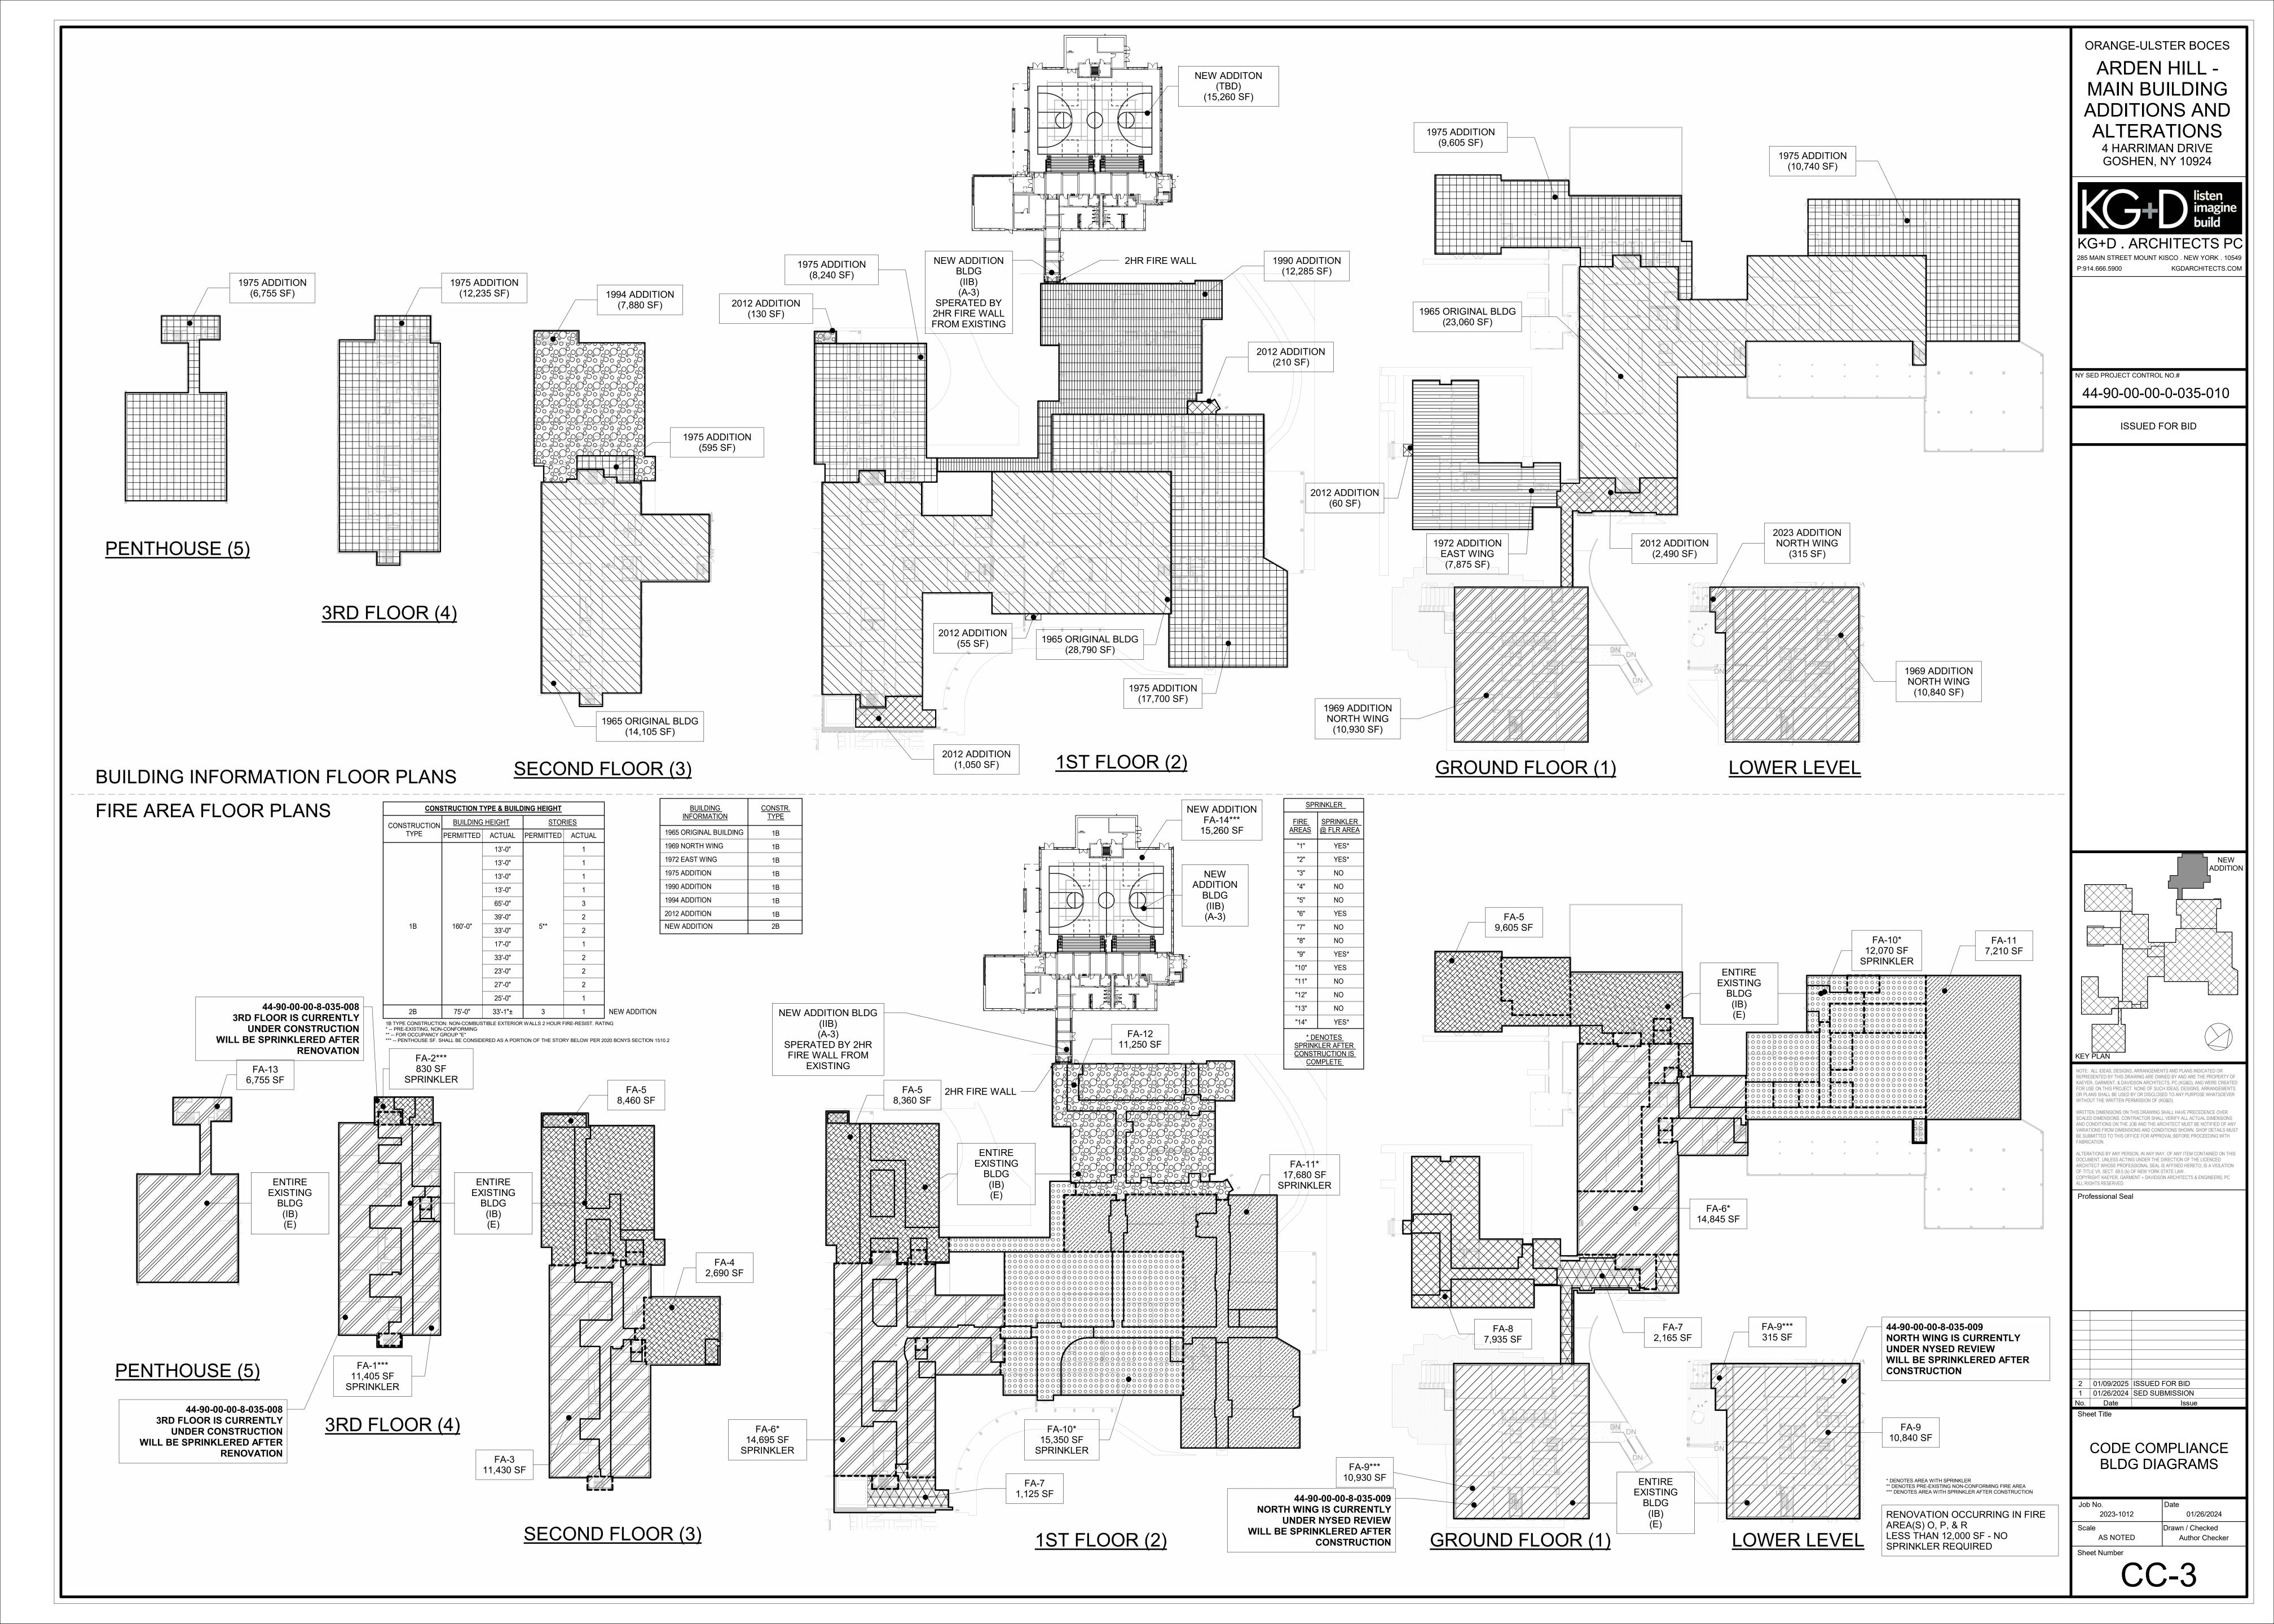
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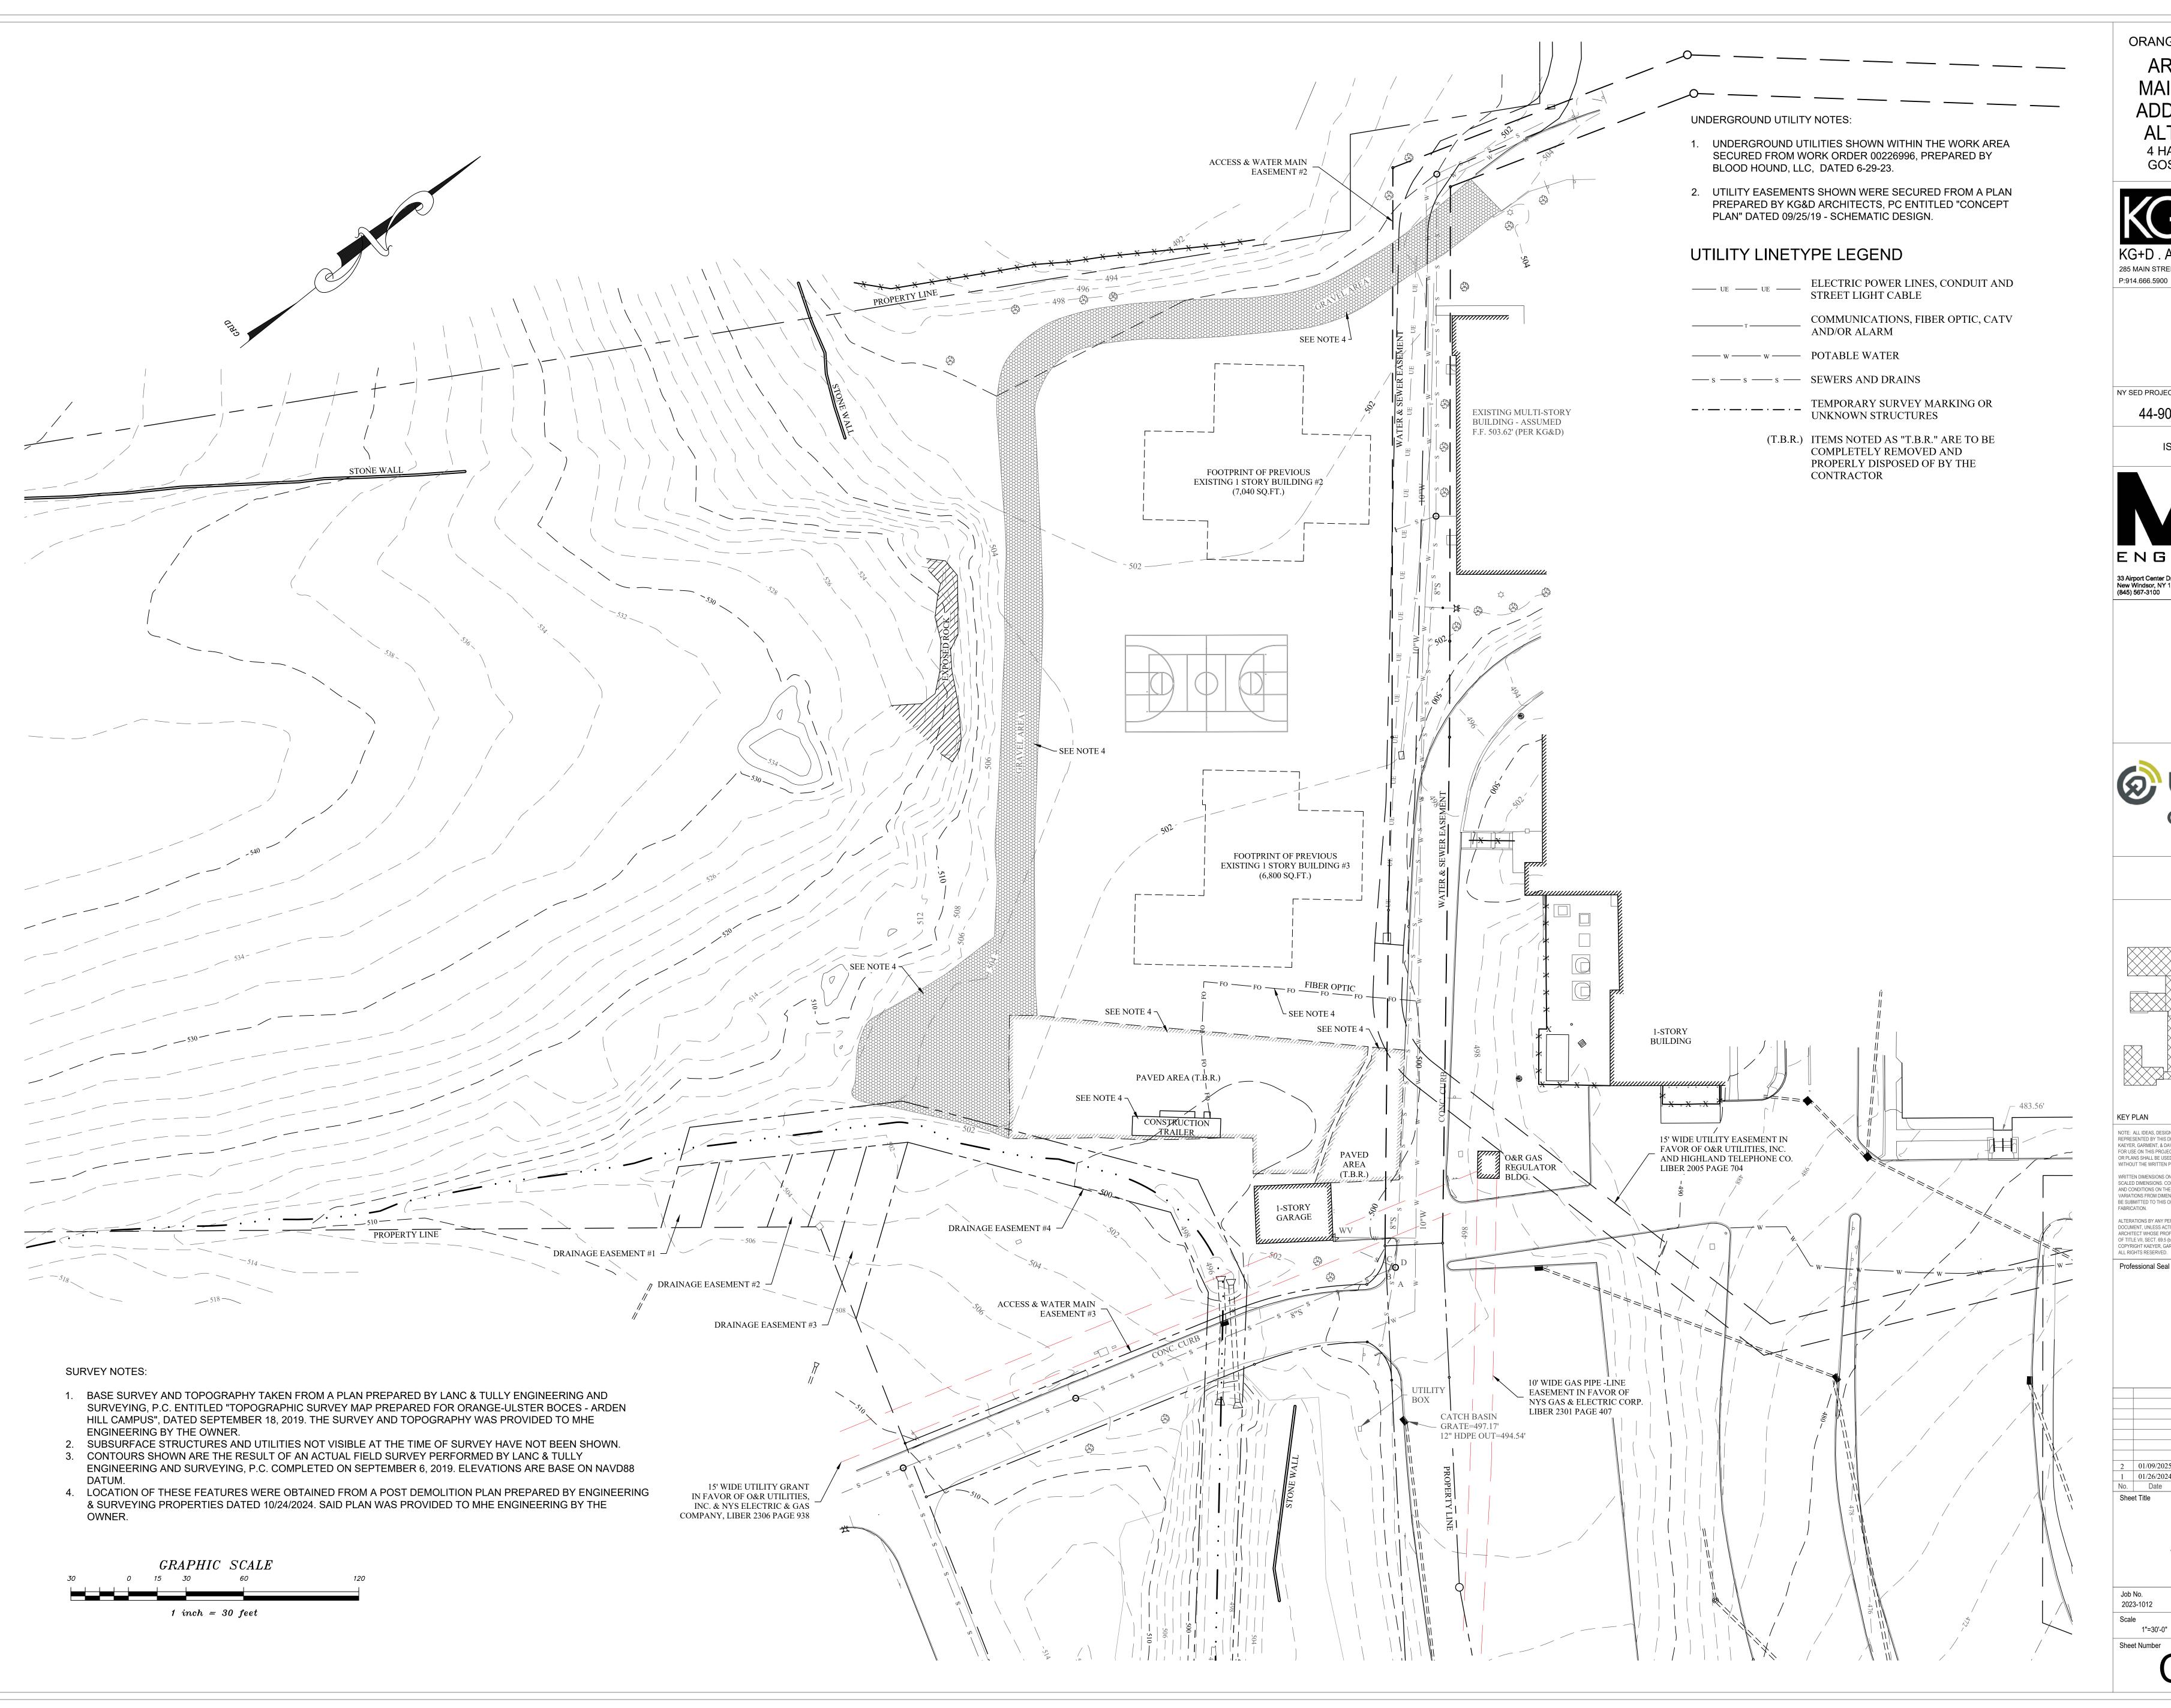
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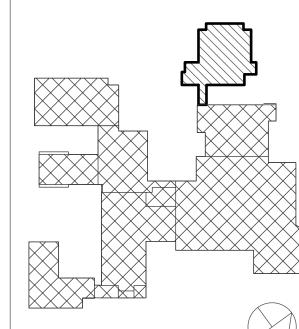
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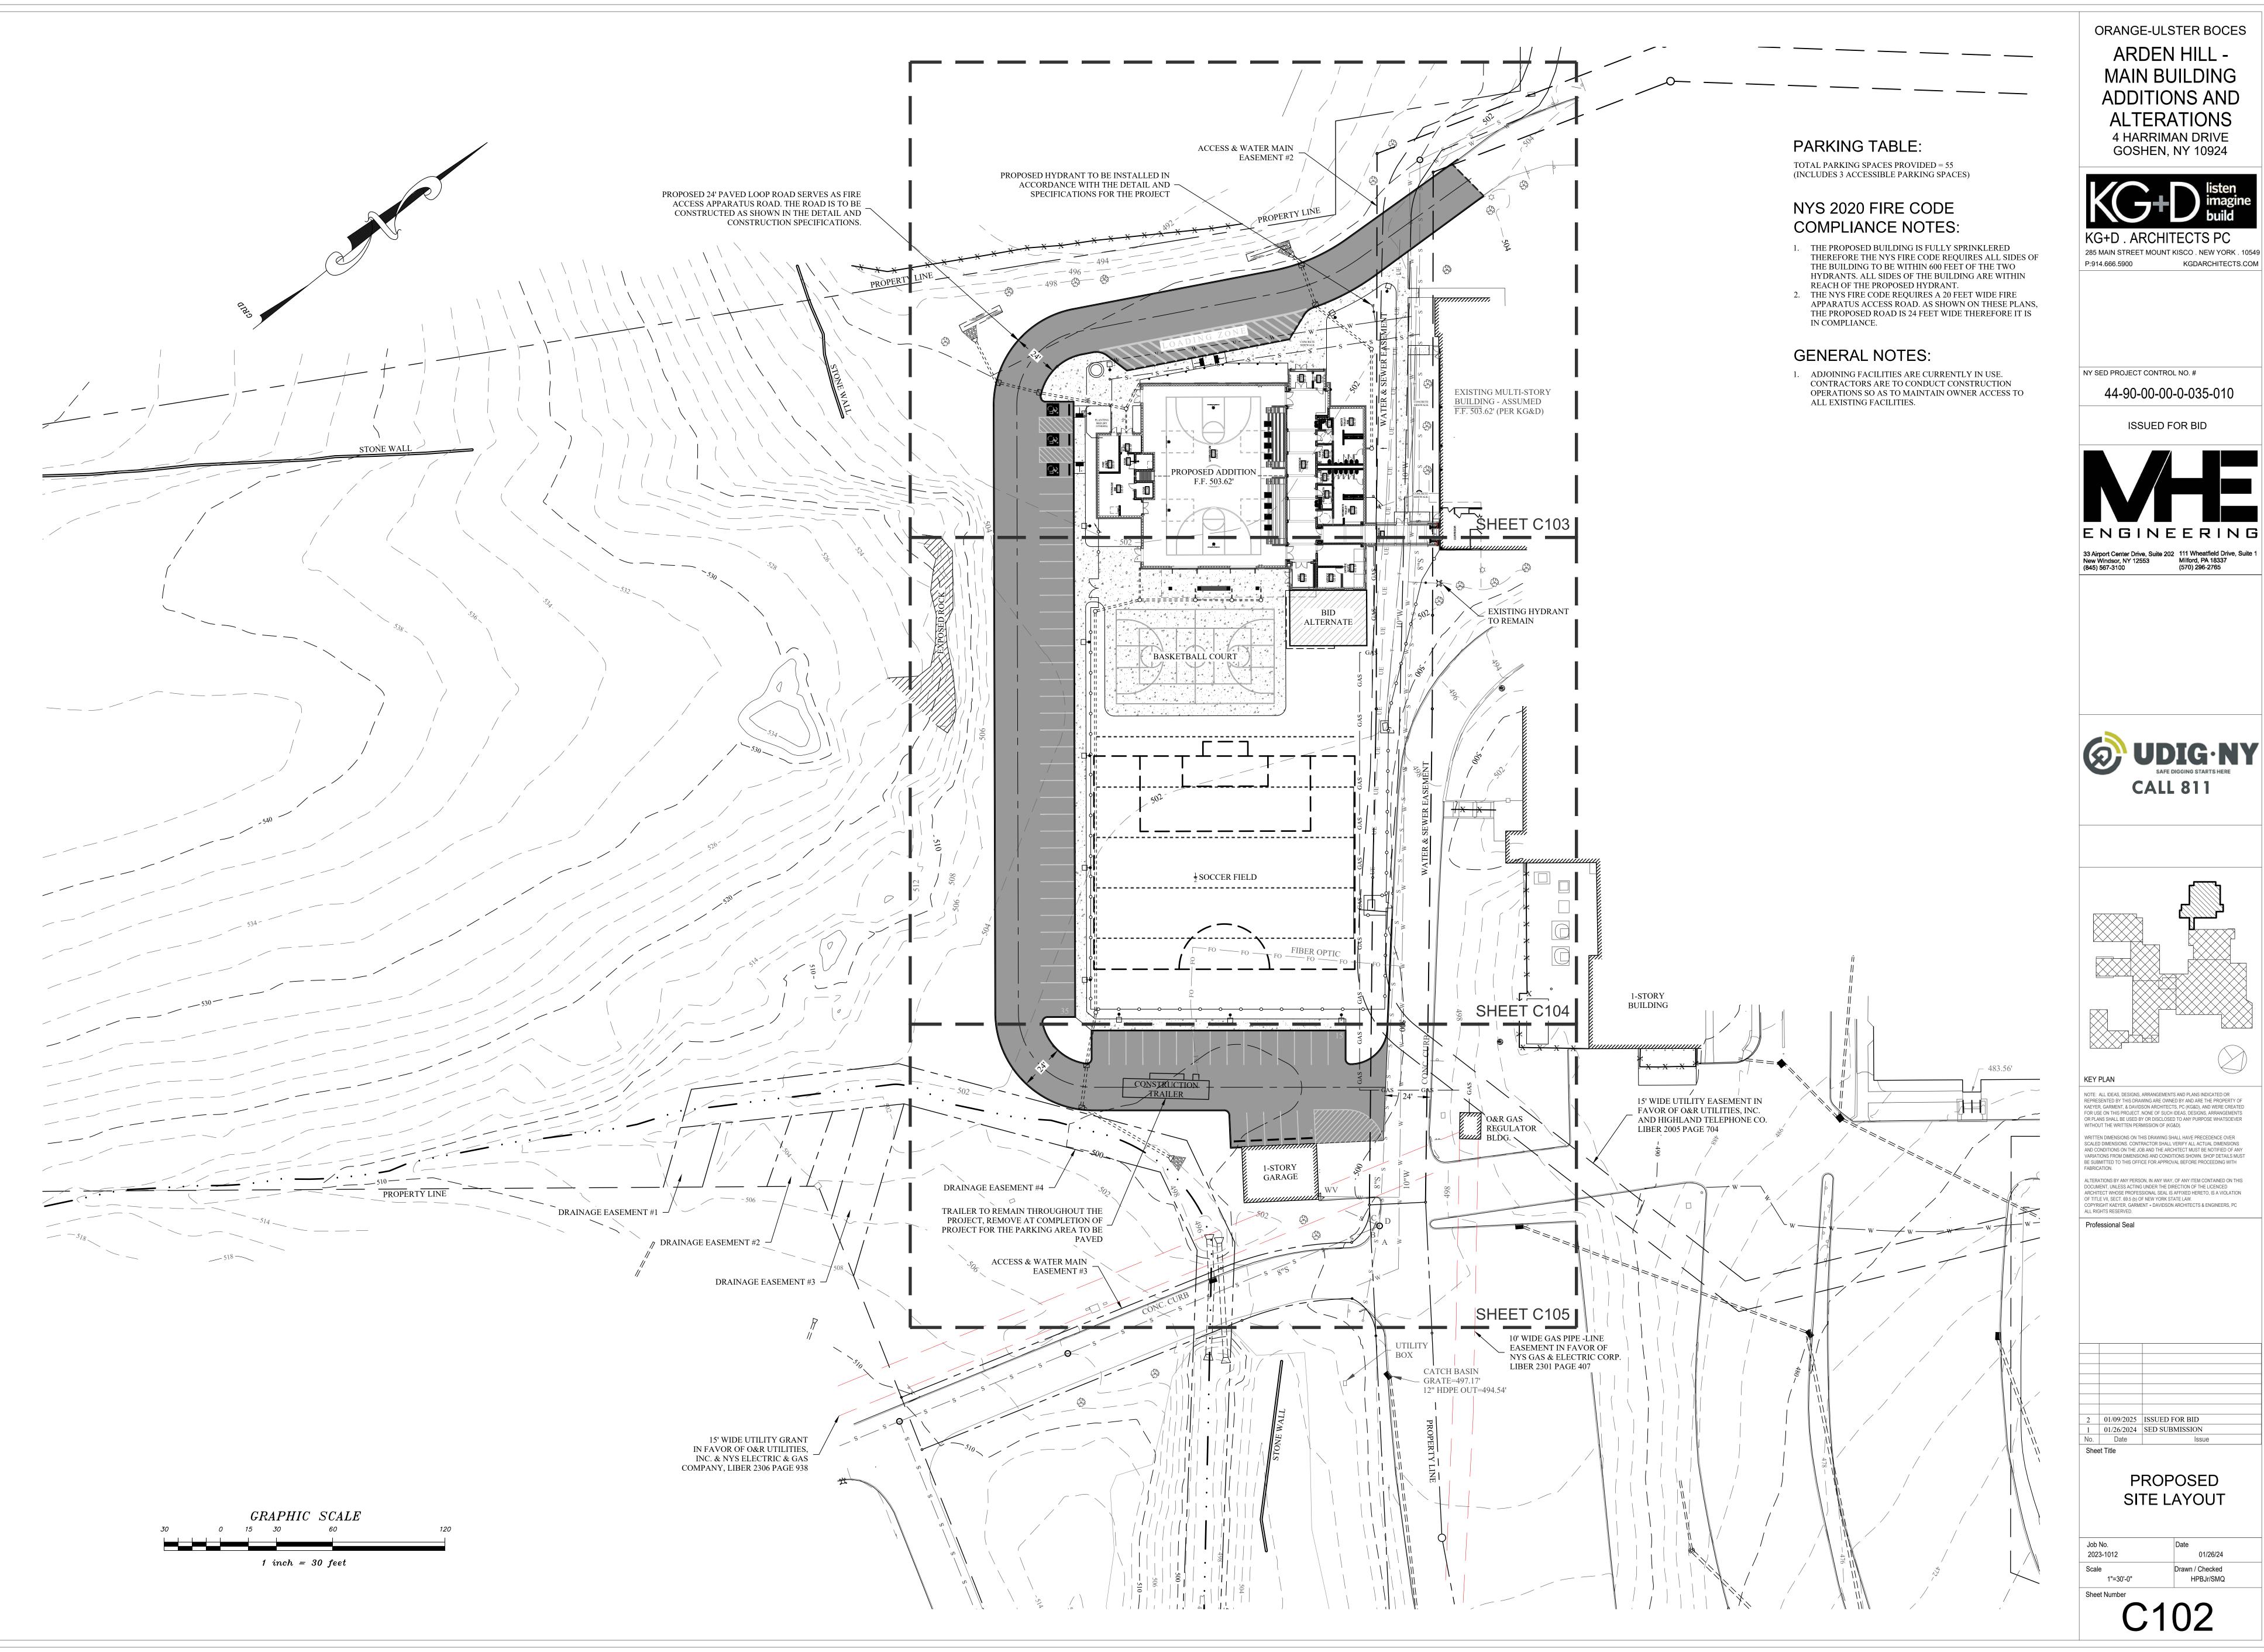
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> **EXISTING** SITE PLAN

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ORANGE-ULSTER BOCES

ARDEN HILL -MAIN BUILDING **ADDITIONS AND ALTERATIONS**

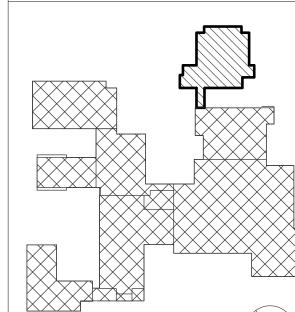
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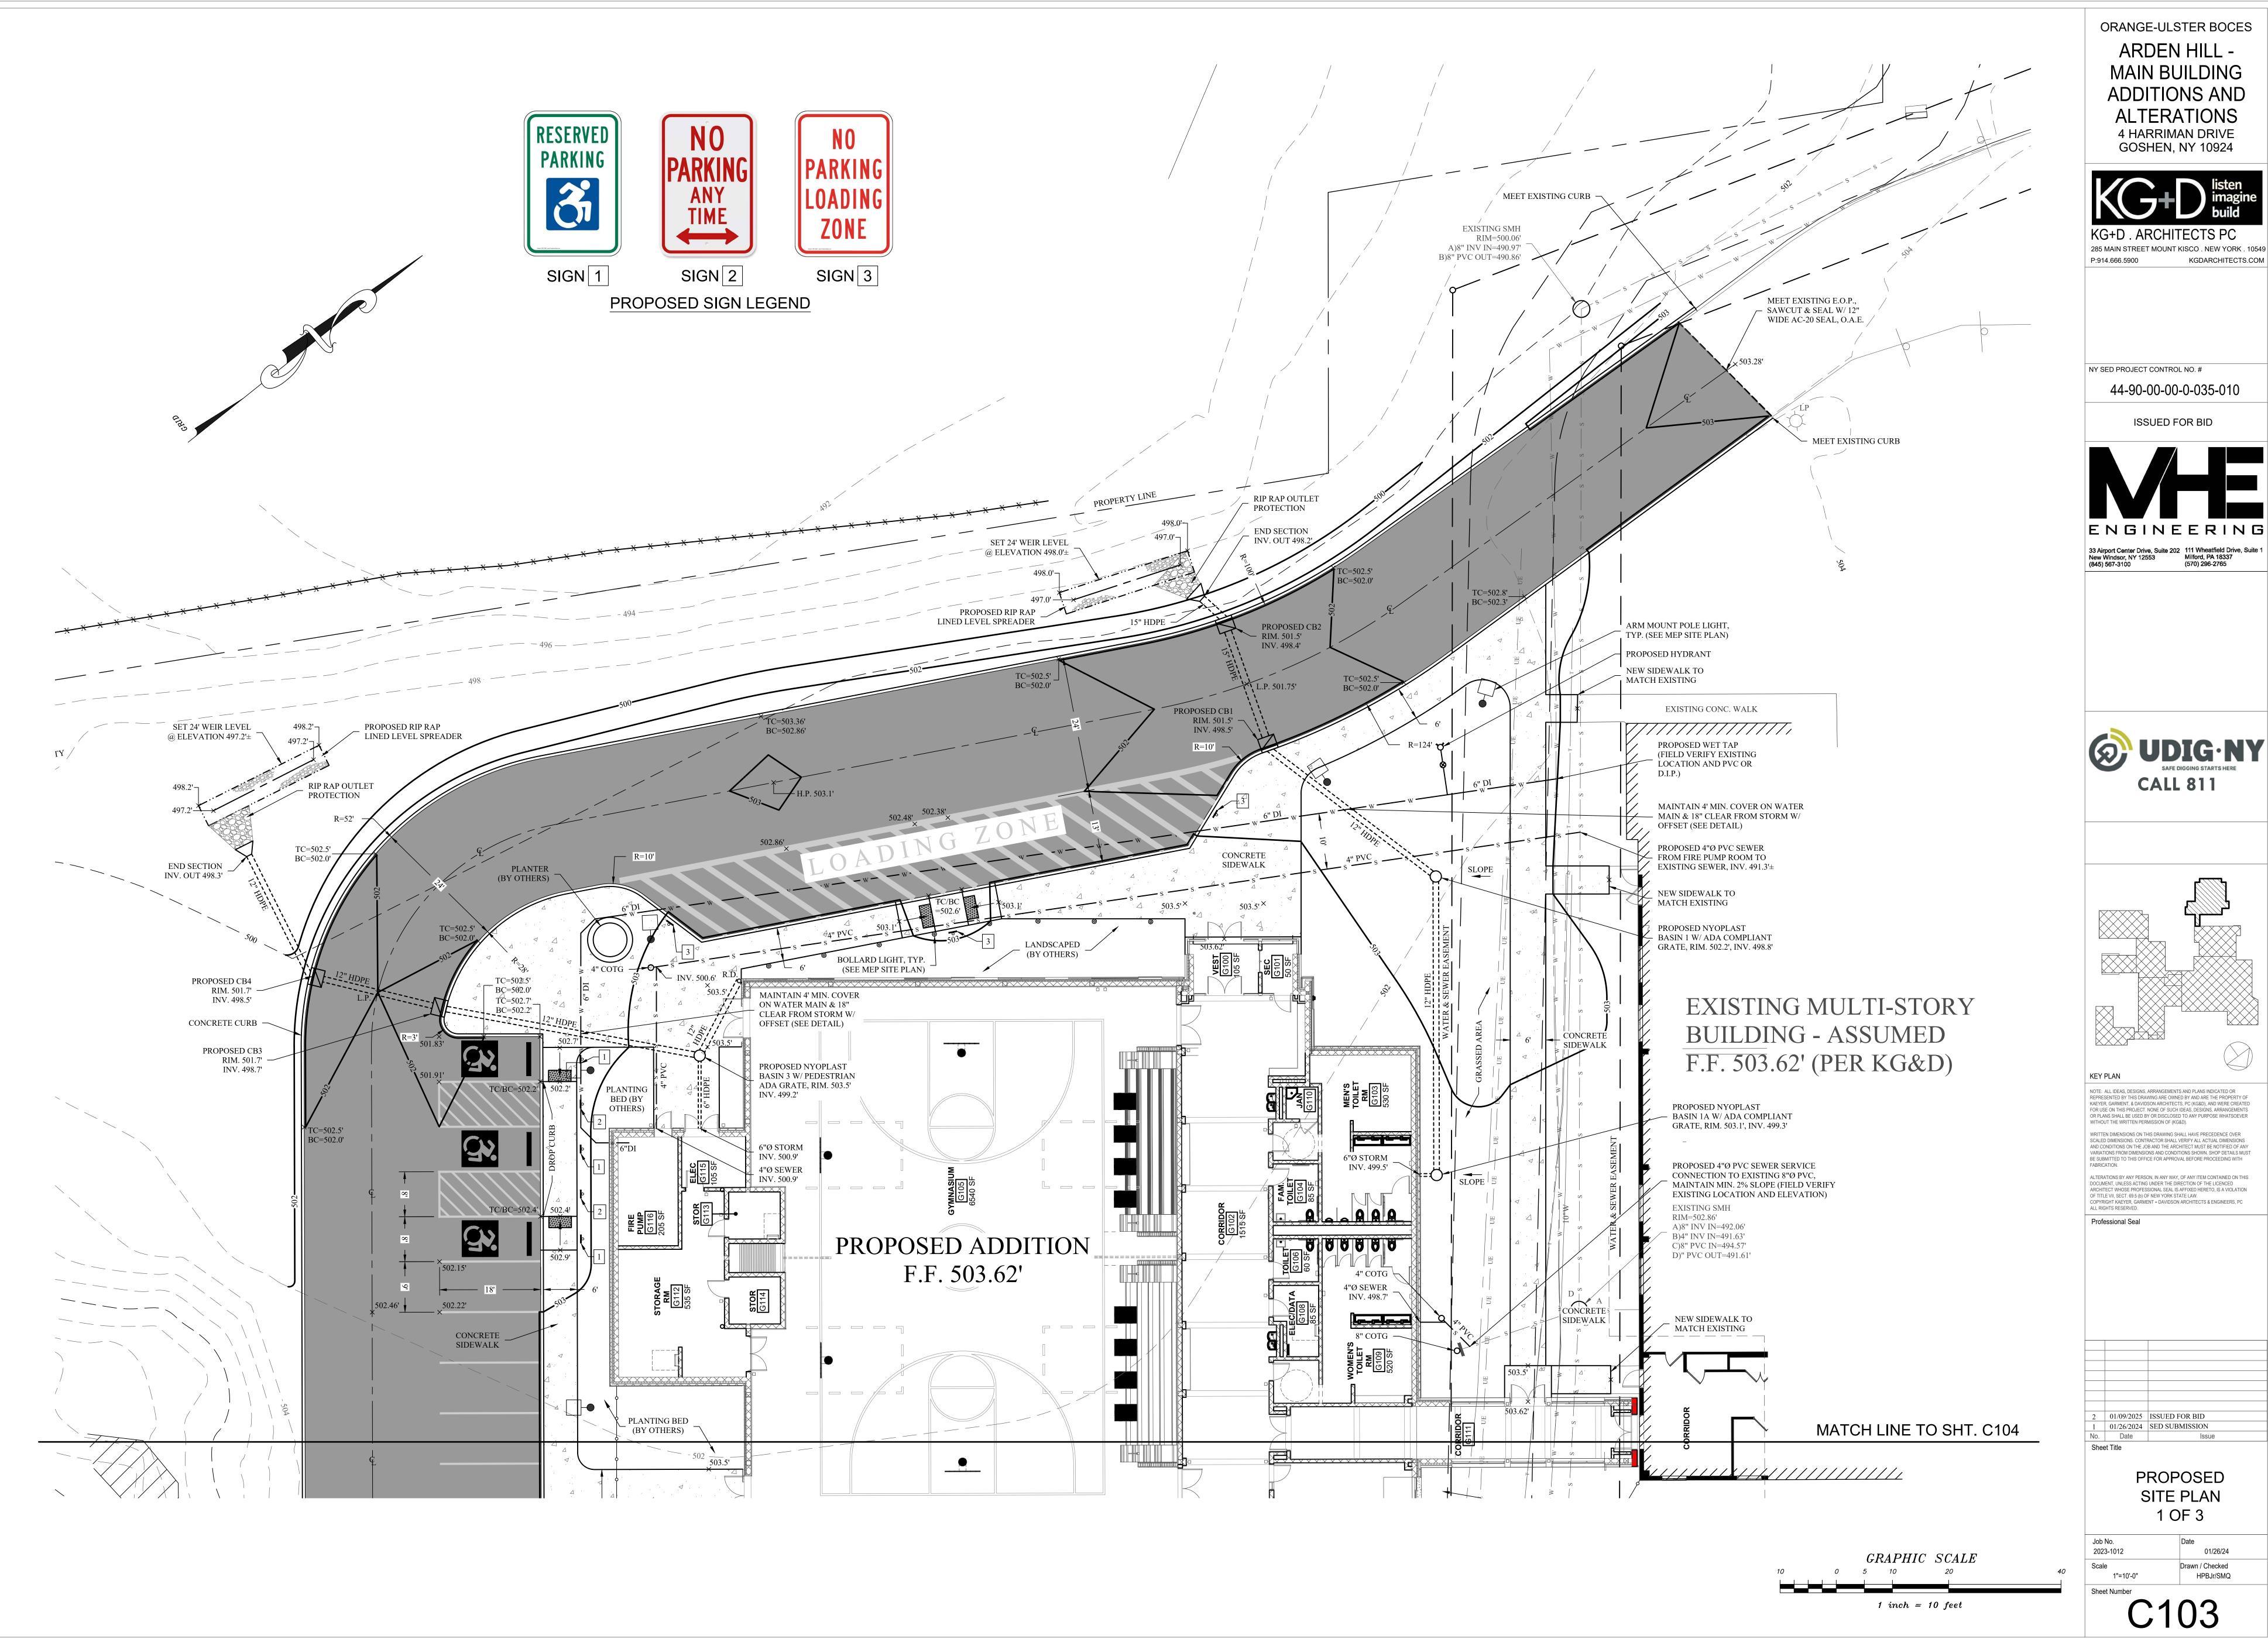
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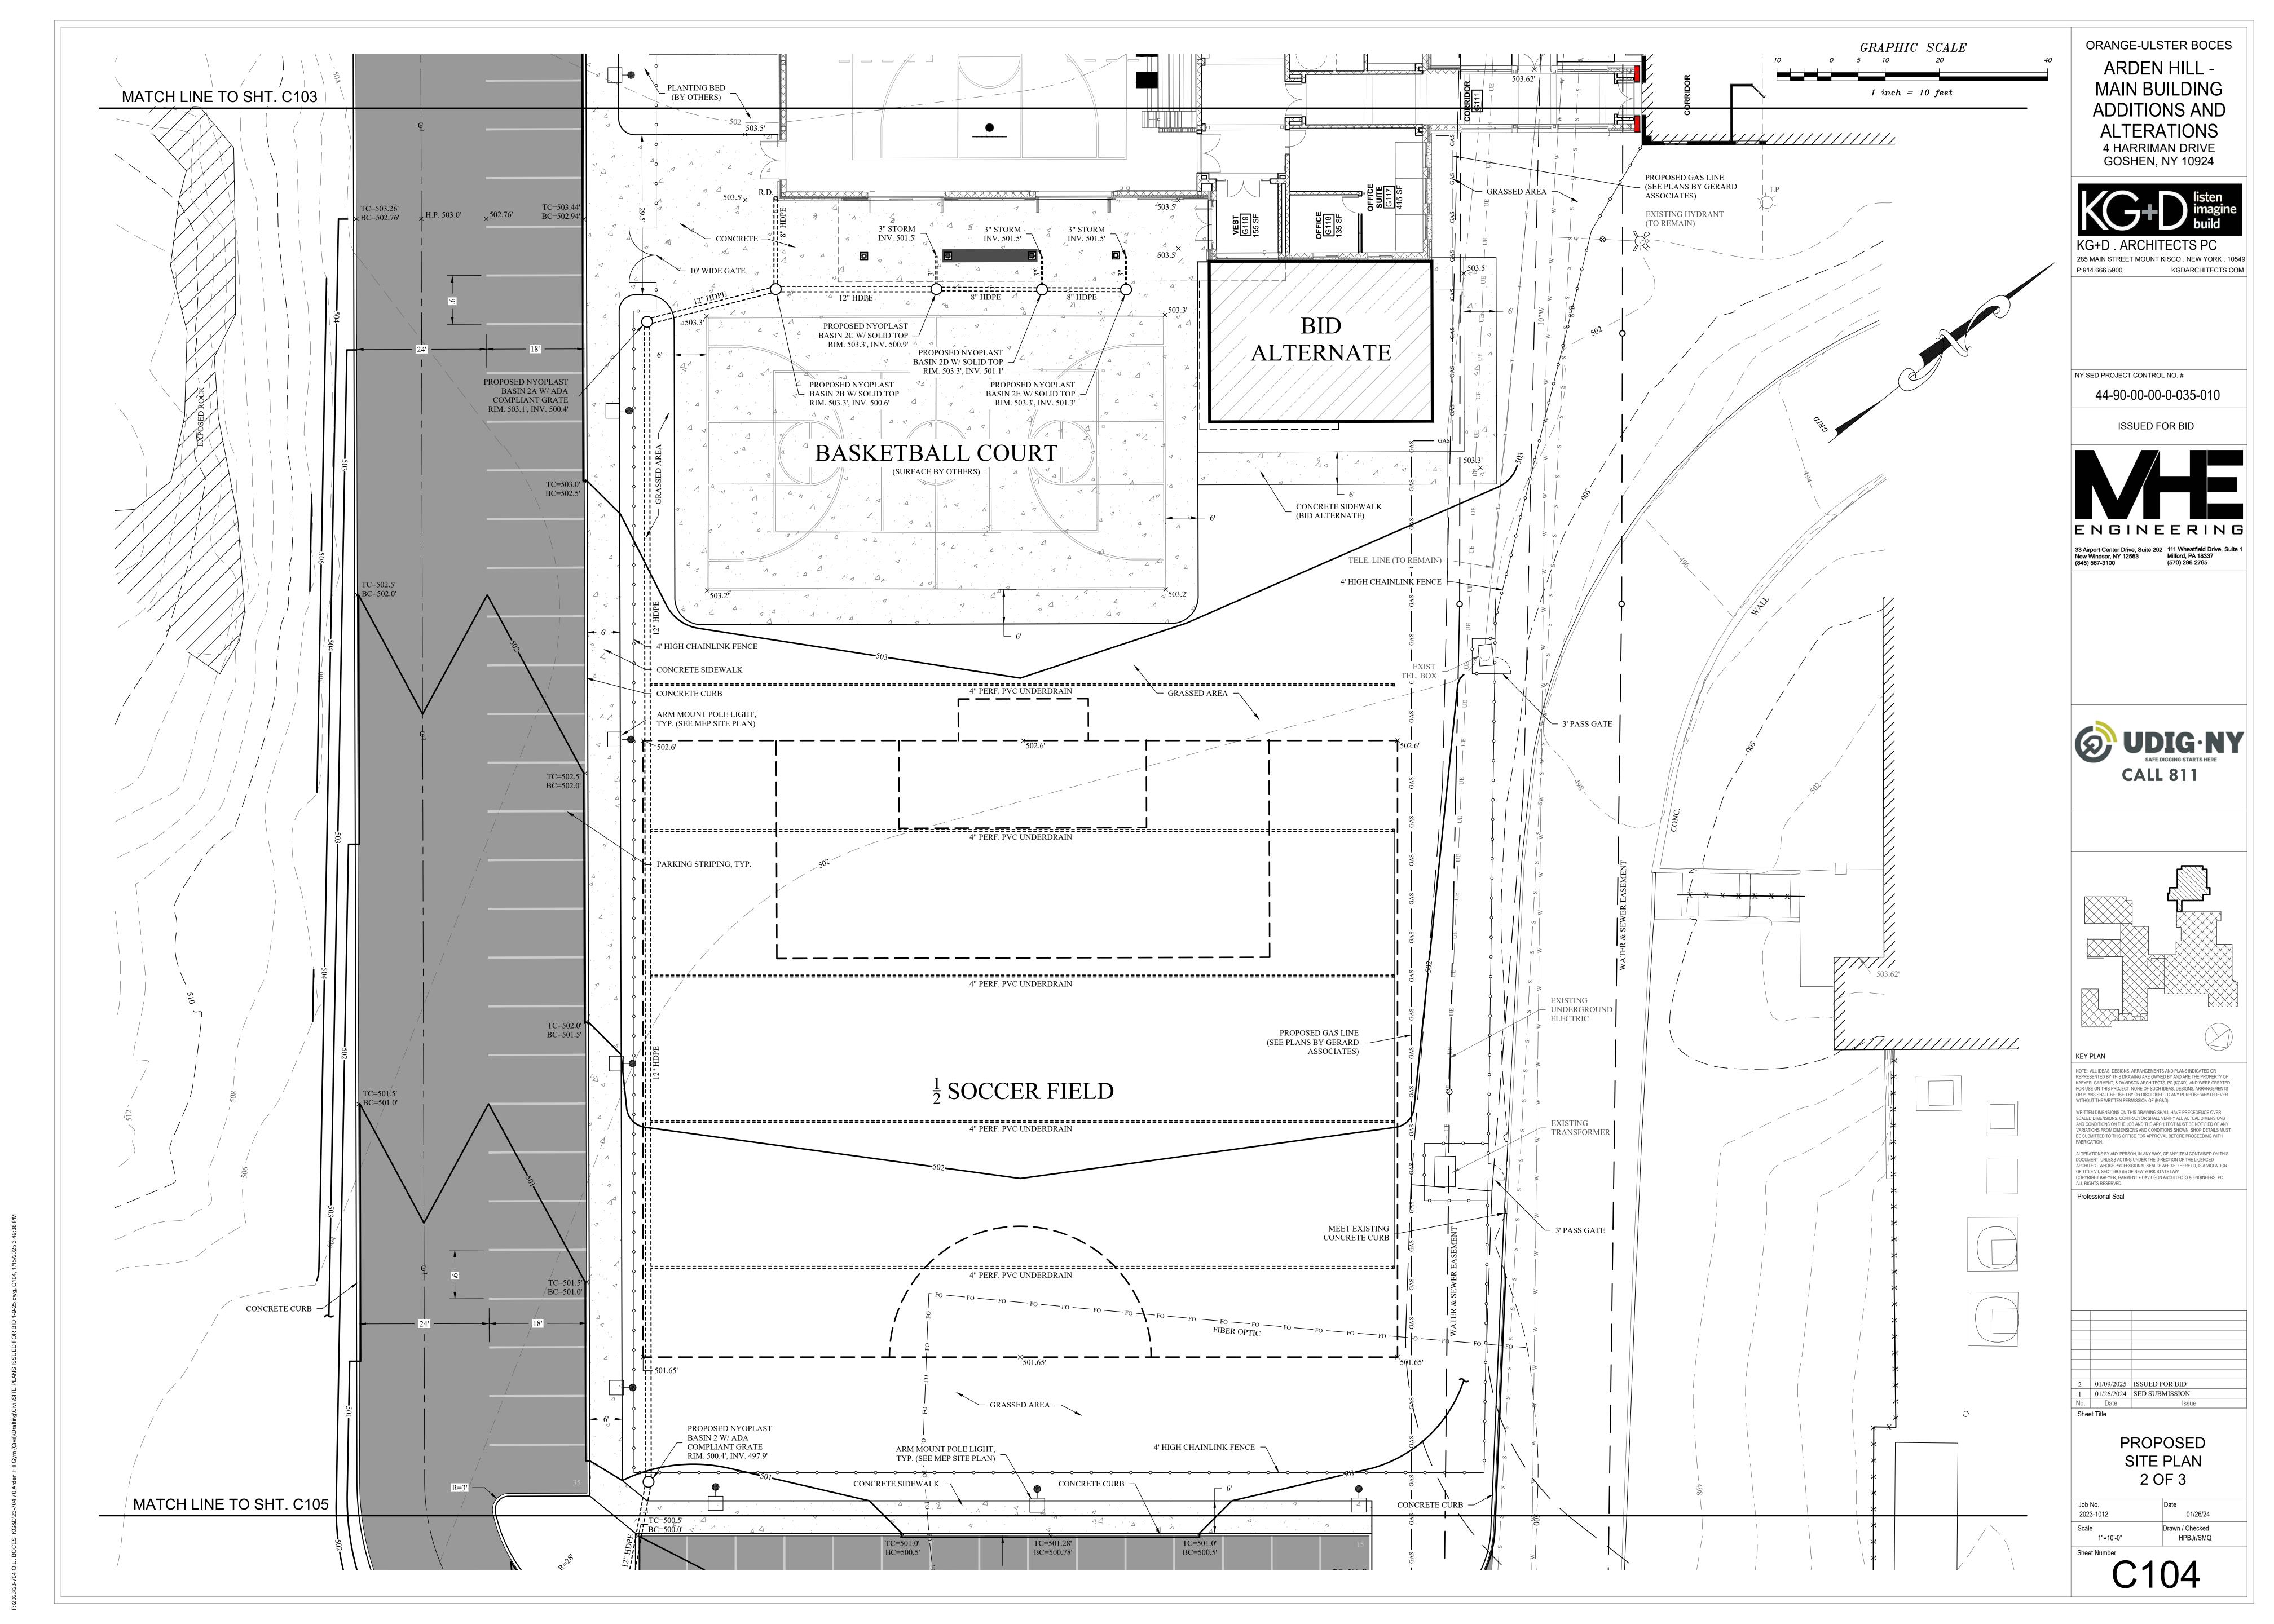
PROPOSED

SITE LAYOUT

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GRAPHIC SCALE 1 inch = 10 feet

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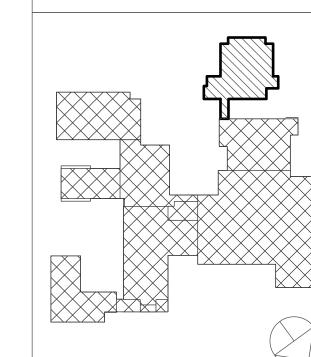
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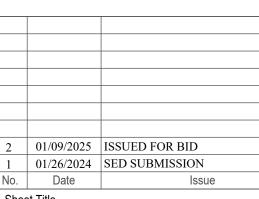
KEY PLAN

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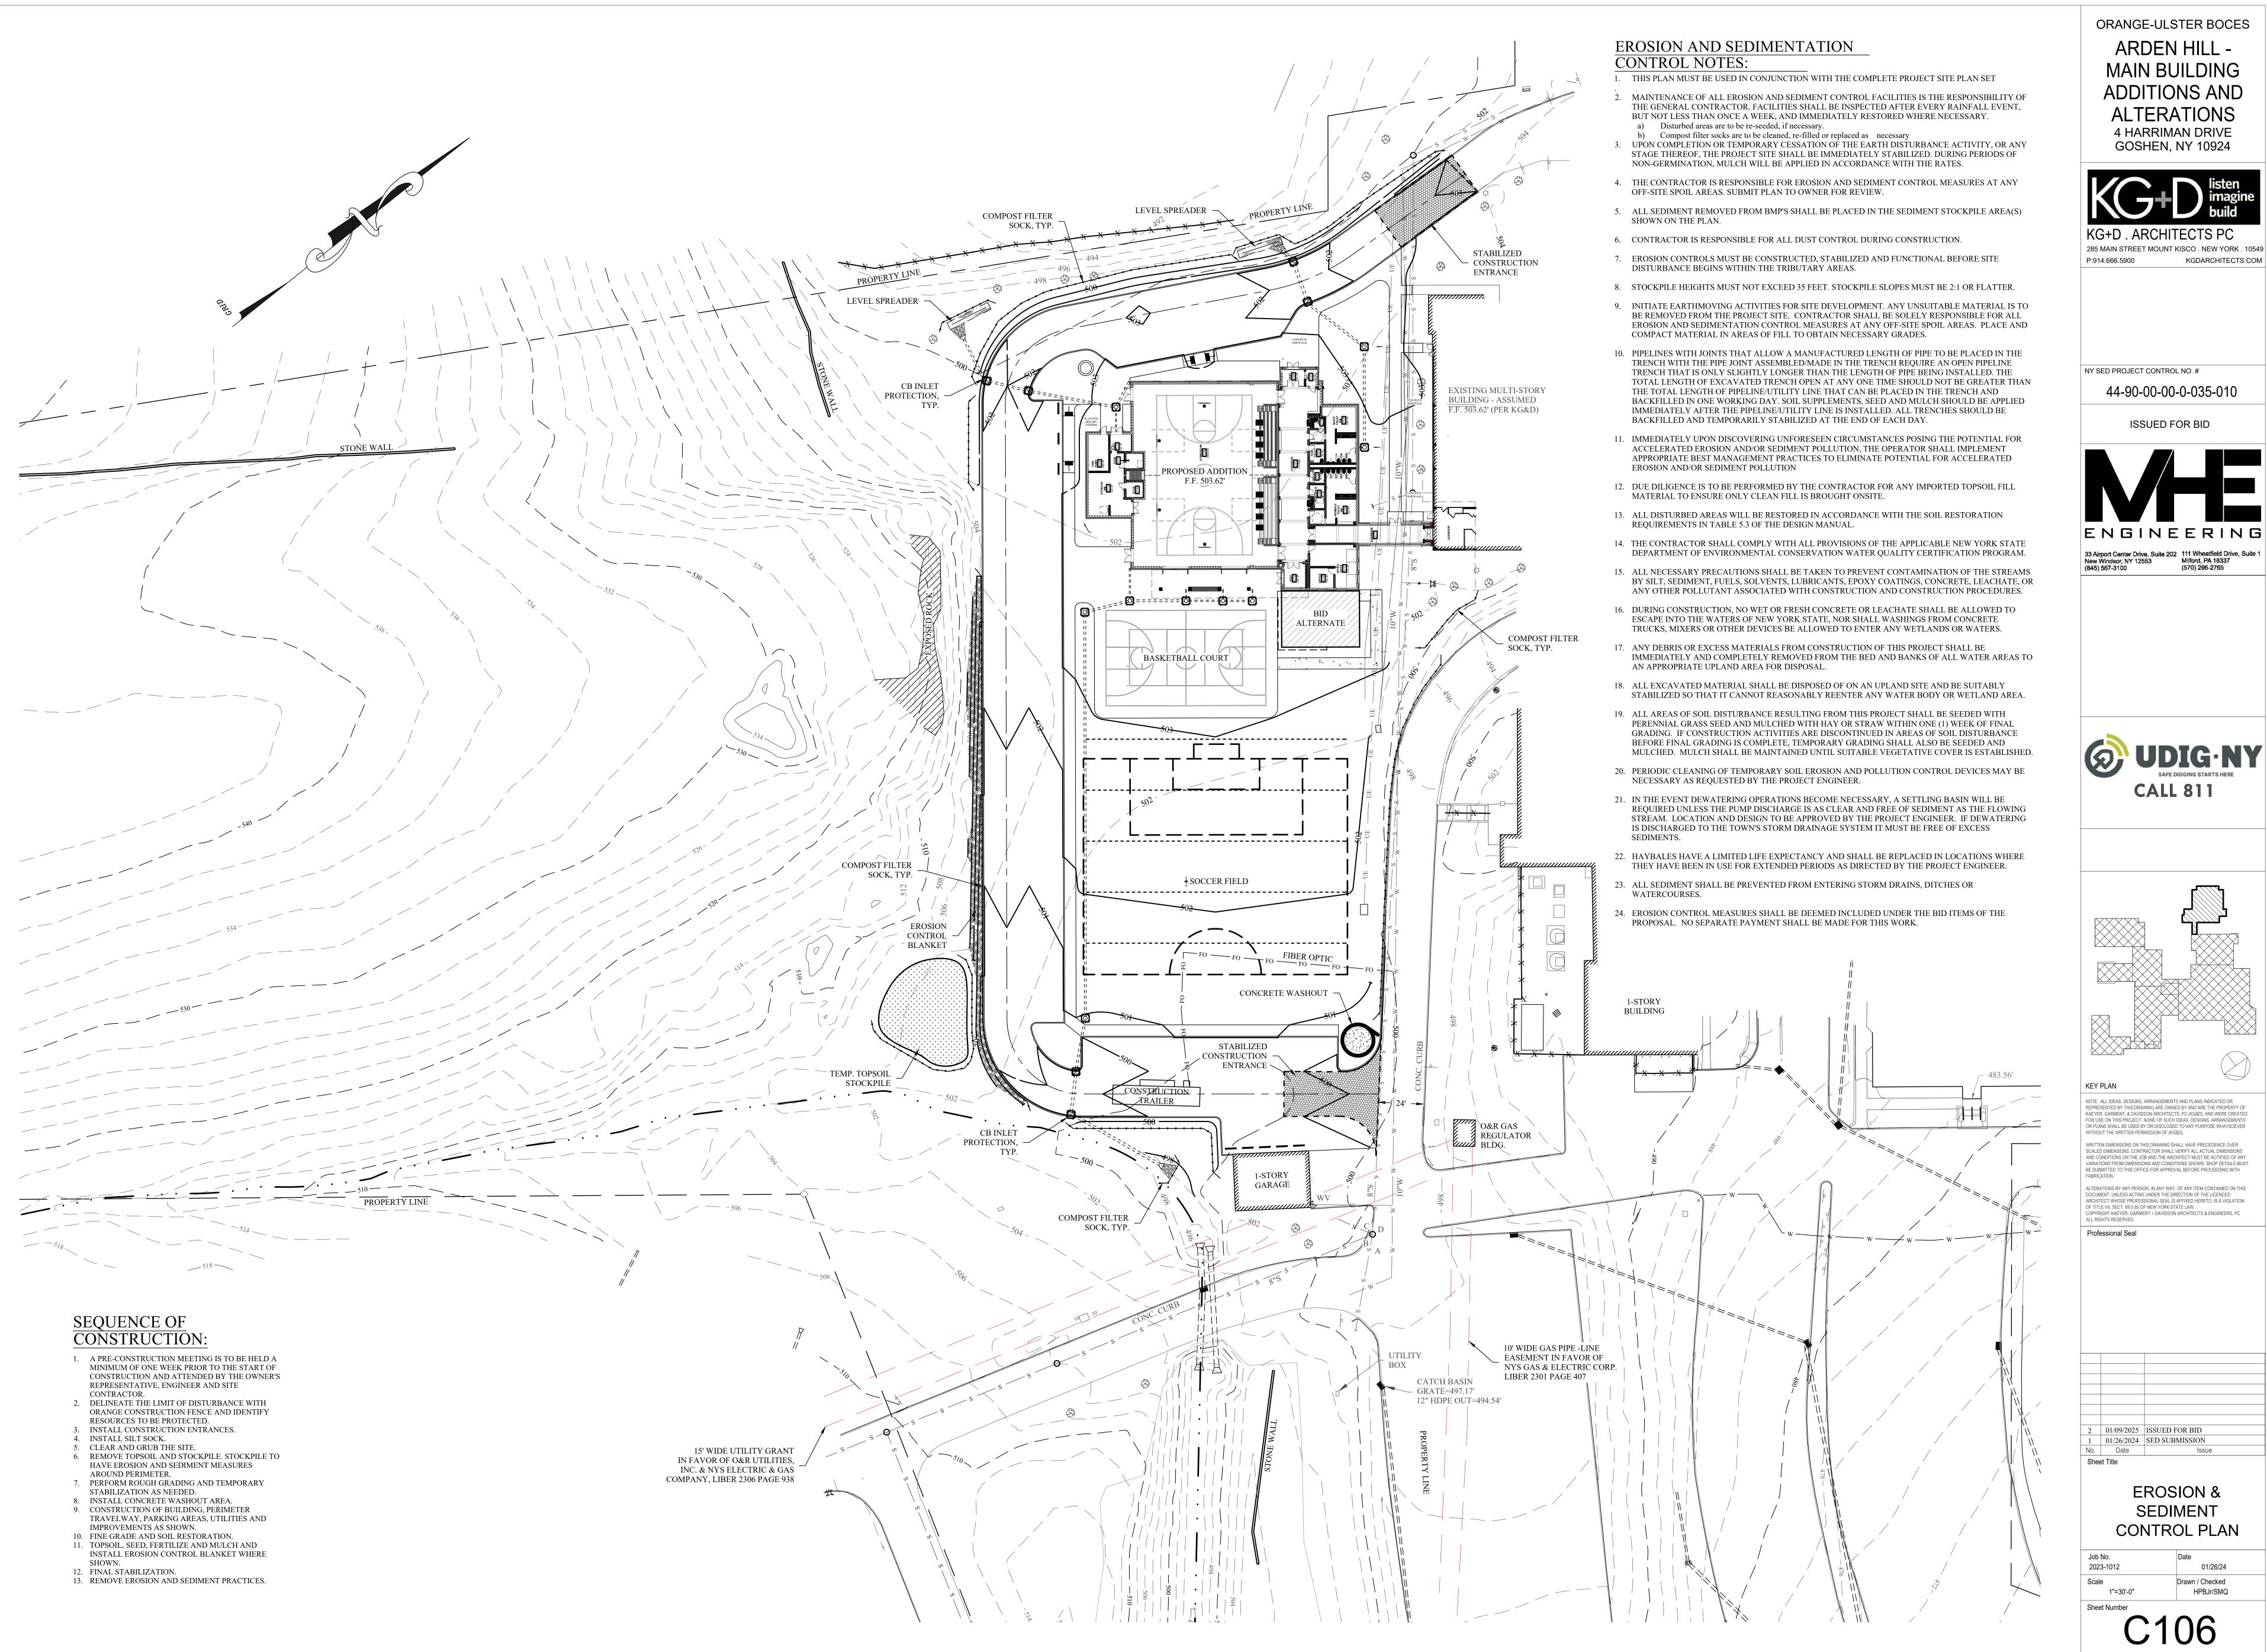


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PROPOSED SITE PLAN 3 OF 3

Job No. 2023-1012 01/26/24 Scale Drawn / Checked 1"=10'-0" HPBJr/SMQ



ORANGE-ULSTER BOCES

ARDEN HILL -MAIN BUILDING **ADDITIONS AND ALTERATIONS**

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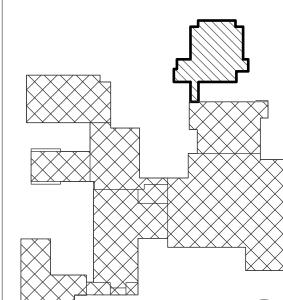
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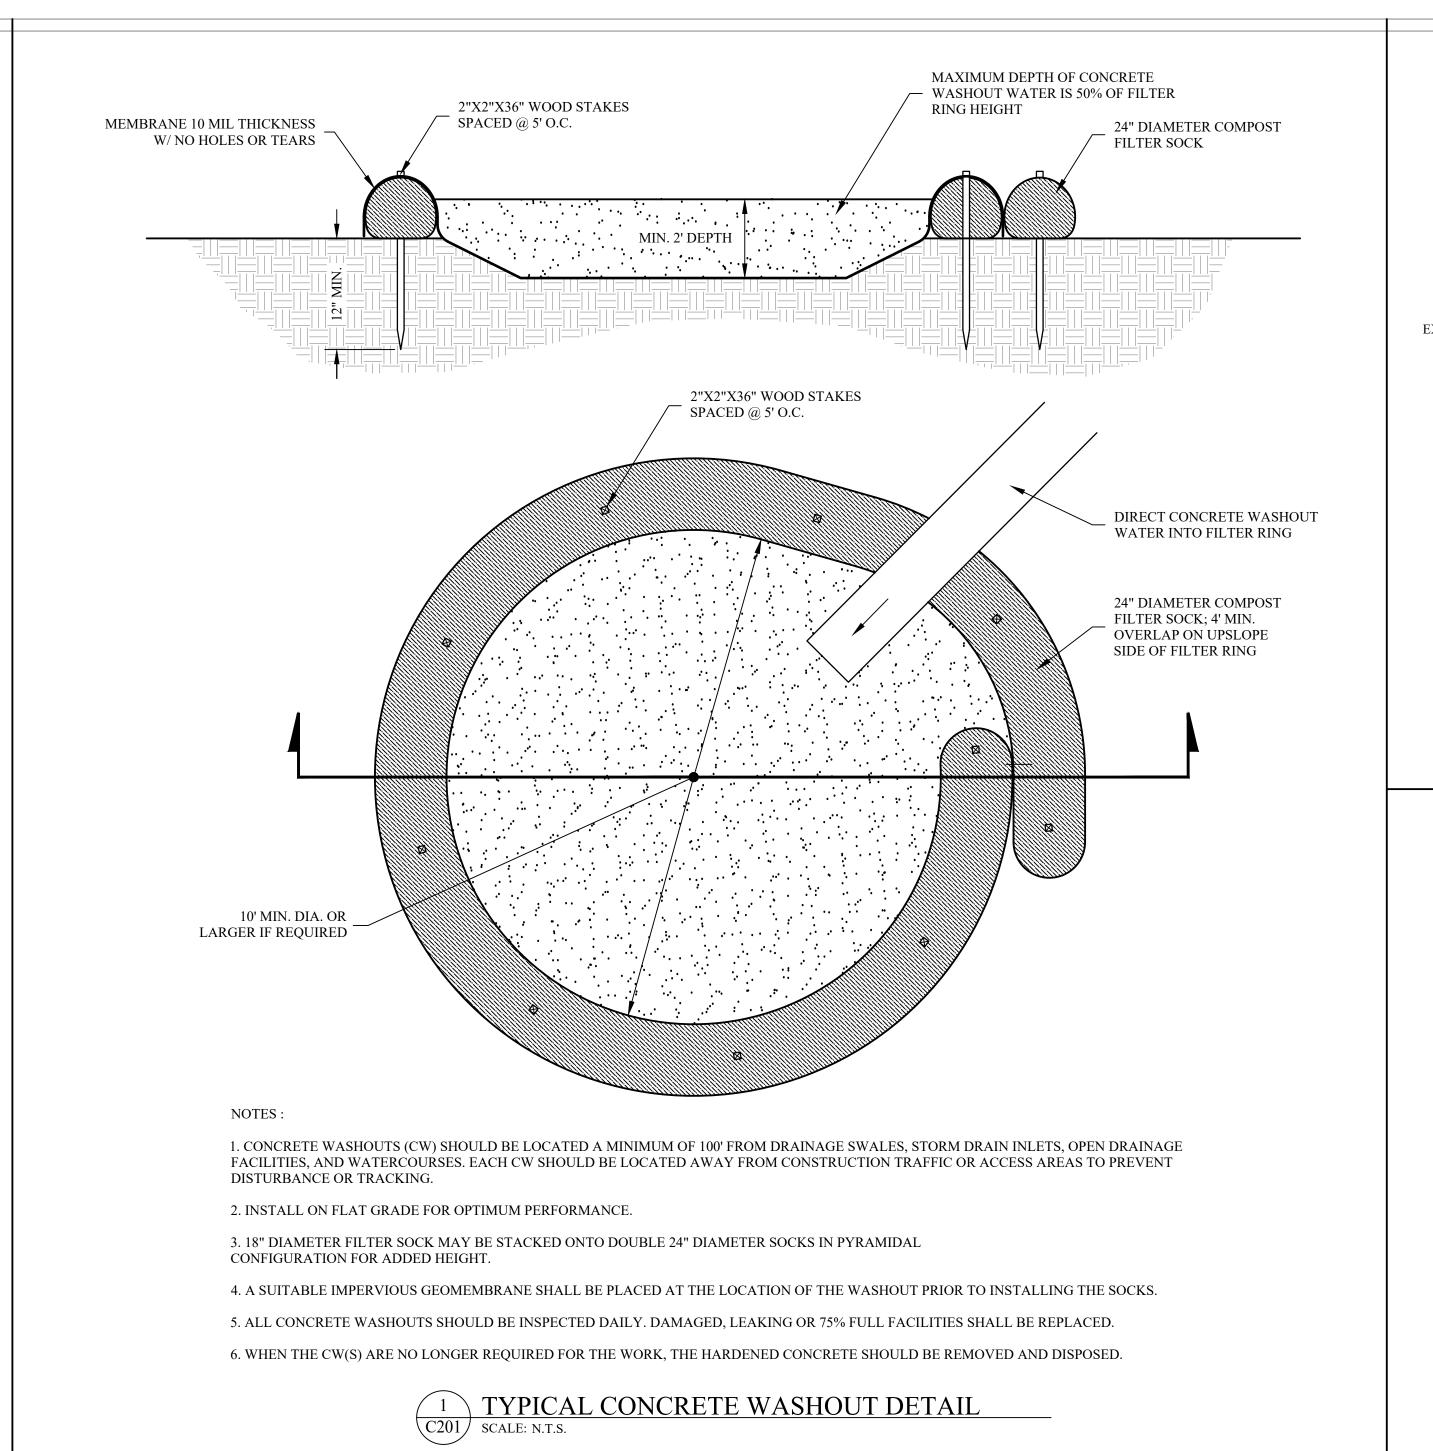
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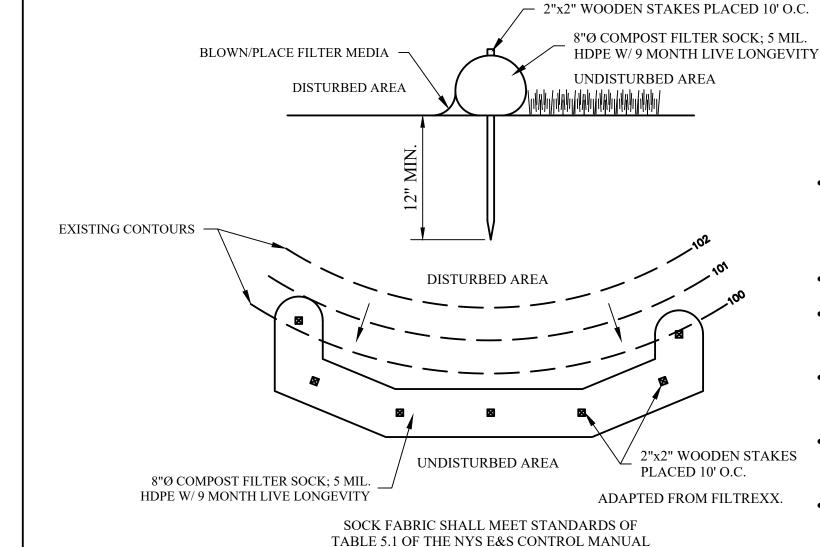
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EROSION & SEDIMENT **CONTROL PLAN**

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ORGANIC MATTER CONTENT 25%-100% (DRY WEIGHT BASIS) FIBROUS AND ELONGATED ORGANIC PORTION MOISTURE CONTENT 30% - 60% % PASS THROUGH 3/8" SCRE PARTICLE SIZE SOLUBLE SALT CONCENTRATION 5.0 dS MAXIMUM

- COMPOST FILTER SOCK SHALL BE PLACED AT EXISTING LEVEL GRADE. BOTH ENDS OF THE SOCK SHALL BE EXTENDED AT LEAST 8 FEET UP SLOPE AT 45 DEGREES TO THE MAIN SOCK ALIGNMENT. MAXIMUM SLOPE LENGTH ABOVE ANY SOCK SHALL NOT EXCEED THAT SHOWN ON PAGE 5.7 OF THE NYS EROSION AND SEDIMENT
- CONTROL MANUAL.
- ACCUMULATED SEDIMENT SHALL BE REMOVED WHEN IT REACHES $\frac{1}{2}$ THE ABOVE GROUND HEIGHT OF THE SOCK AND DISPOSED IN THE MANNER DESCRIBED ELSEWHERE ON THE PLAN.

• TRAFFIC SHALL NOT BE PERMITTED TO CROSS FILTER SOCKS.

- SOCKS SHALL BE INSPECTED WEEKLY AND AFTER EACH RUNOFF EVENT. DAMAGED SOCKS SHALL BE REPAIRED ACCORDING TO MANUFACTURER'S SPECIFICATIONS OR REPLACED WITHIN 24 HOURS OF INSPECTION.
- BIODEGRADABLE FILTER SOCK SHALL BE REPLACED AFTER 6 MONTHS; PHOTODEGRADABLE SOCKS AFTER 1 YEAR. POLYPROPYLENE SOCKS SHALL BE REPLACED ACCORDING TO MANUFACTURER'S RECOMMENDATIONS.
- UPON STABILIZATION OF THE AREA TRIBUTARY TO THE SOCK, THE STAKES SHALL BE REMOVED. THE SOCK MAY BE LEFT IN PLACE AND VEGETATED OR REMOVED. IN THE LATTER CASE, THE MESH SHALL BE CUT OPEN AND THE MULCH SPREAD AS A SOIL SUPPLEMENT.

2 STANDARD CONSTRUCTION DETAIL COMPOST FILTER SOCK

STABILIZED CONSTRUCTION ENTRANCE DETAIL

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ORANGE-ULSTER BOCES

ARDEN HILL -

MAIN BUILDING


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CONSTRUCTION SPECIFICATIONS


- 1. STONE SIZE = AASHTO #1 ROCK.
- LENGTH = NOT LESS THAN FIFTY (50) FEET. THICKNESS = NOT LESS THAN EIGHT (8) INCHES.
- 4. WIDTH = TWENTY (20) FOOT MINIMUM, BUT NOT LESS THAN THE FULL WIDTH AT POINTS WHERE INGRESS OR EGRESS OCCUR. TWELVE (12) FEET IF SINGLE ENTRANCE TO SITE.
- 5. GEOTEXTILE WILL BE PLACED OVER THE ENTIRE AREA PRIOR TO PLACING OF 6. SURFACE WATER - ALL SURFACE WATER FLOWING OR DIVERTED TOWARD
- CONSTRUCTION ENTRANCES SHALL BE PIPED ACROSS THE ENTRANCE. IF PIPING IS IMPRACTICAL, A MOUNTABLE BERM WITH 5:1 SLOPES WILL BE PERMITTED. 7. MAINTENANCE - THE ENTRANCE SHALL BE MAINTAINED IN A CONDITION
- WHICH WILL PREVENT TRACKING OR FLOWING OF SEDIMENT ONTO PUBLIC RIGHTS-OF-WAY. ALL SEDIMENT SPILLED, DROPPED, WASHED OR TRACKED ONTO PUBLIC RIGHT-OF-WAY MUST BE REMOVED IMMEDIATELY. 8. WHEN WASHING IS REQUIRED, IT SHALL BE DONE ON AN AREA STABILIZED
- WITH STONE AND WHICH DRAINS INTO AN APPROVED SEDIMENT TRAPPING 9. PERIODIC INSPECTION AND NEEDED MAINTENANCE SHALL BE PROVIDED
- AFTER EACH RAIN. 10. TEMPORARY CONSTRUCTION ENTRANCES, EXITS AND TEMPORARY ACCESS
- SHALL BE SUBJECT TO THE APPROVAL OF THE APPROPRIATE AUTHORITIES.



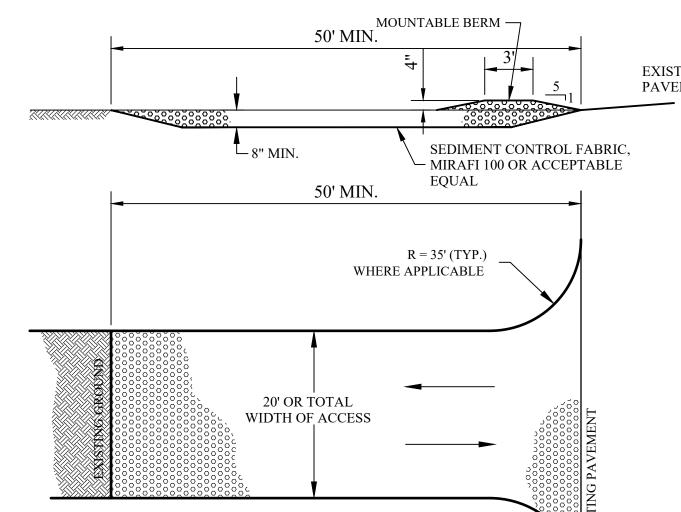EXISTING PAVEMENT



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1. SEED AND SOIL AMENDMENTS SHALL BE APPLIED ACCORDING TO THE RATES IN THE PLAN DRAWINGS PRIOR TO INSTALLING THE BLANKET.

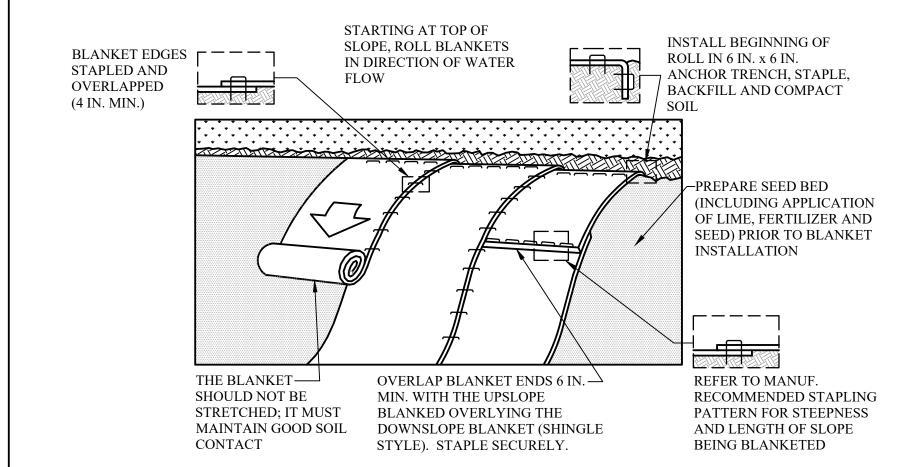
- 2. PROVIDE ANCHOR TRENCH AT TOE OF SLOPE IN SIMILAR FASHION AS AT TOP OF SLOPE.
- 3. SLOPE SURFACE SHALL BE FREE OF ROCKS, CLODS, STICKS, AND GRASS.
- 4. BLANKET SHALL HAVE GOOD CONTINUOUS CONTACT WITH UNDERLYING SOIL THROUGHOUT ENTIRE LENGTH. LAY BLANKET LOOSELY AND STAKE OR STAPLE TO MAINTAIN DIRECT CONTACT WITH SOIL. DO NOT STRETCH BLANKET.


5. THE BLANKET SHALL BE STAPLED IN ACCORDANCE WITH THE MANUFACTURER'S RECOMMENDATIONS.


6. BLANKETED AREAS SHALL BE INSPECTED WEEKLY AND AFTER EACH RUNOFF EVENT UNTIL PERENNIAL VEGETATION IS ESTABLISHED TO A MINIMUM UNIFORM 70% COVERAGE THROUGHOUT THE BLANKETED AREA. DAMAGED OR DISPLACED BLANKETS SHALL BE RESTORED OR REPLACED WITHIN 4 CALENDAR DAYS.

10-20-10 FERTILIZER

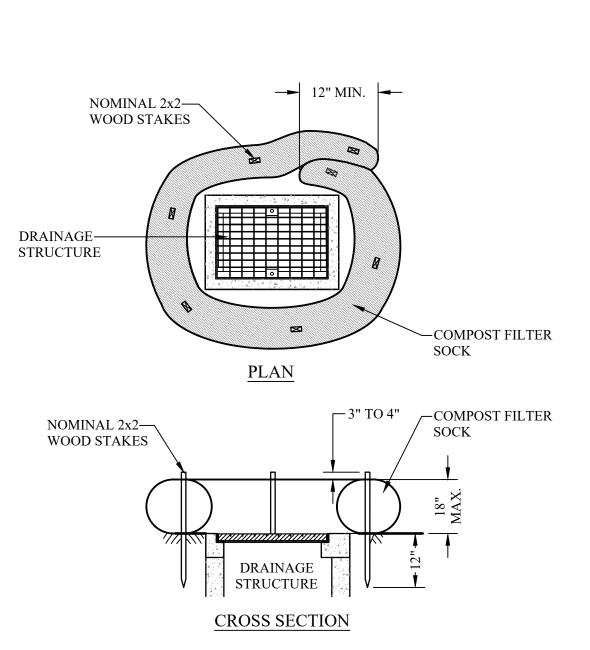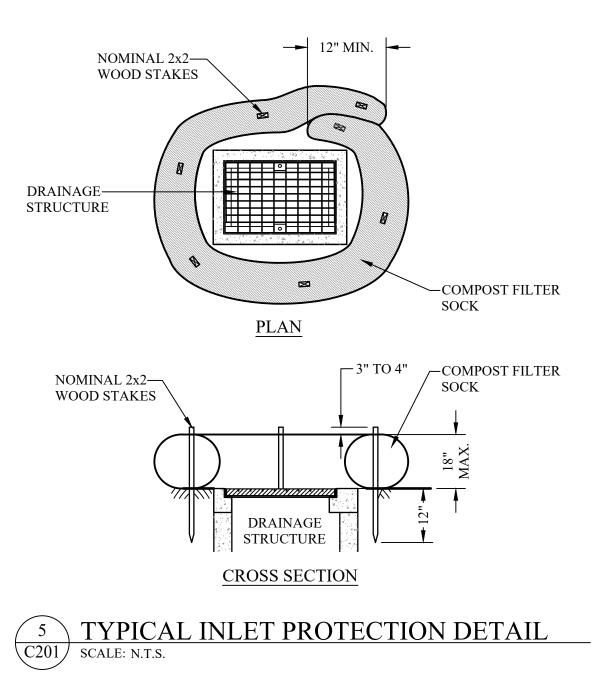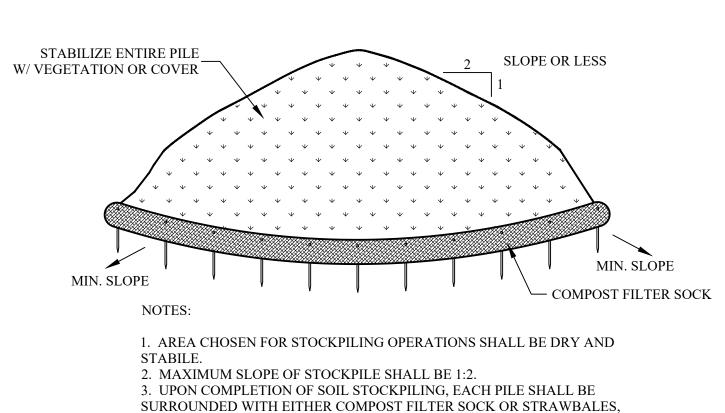EROSION CONTROL BLANKET INSTALLATION









THEN STABILIZED WITH VEGETATION OR COVERED. 4. SEE DETAILS FOR INSTALLATION OF COMPOST FILTER SOCK

C201 | SCALE: N.T.S.

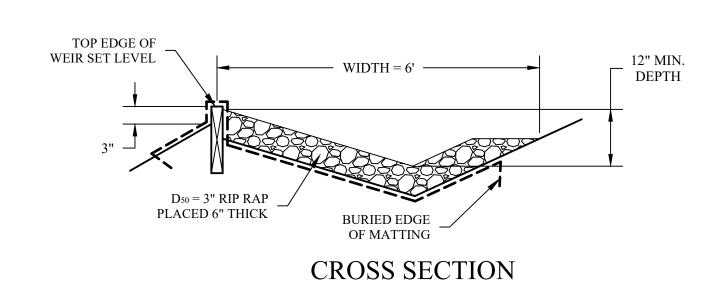

CONSTRUCTION SPECIFICATIONS:

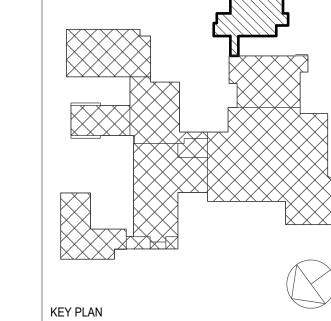- 1. THE MATTING SHOULD PLACED BENEATH RIP RAP, OVER THE LIP AND BURIED 6 INCHES DEEP IN A VERTICAL TRENCH ON LOWER EDGE, BOTH EDGES AND BE SECURELY HELD IN PLACE WITH CLOSELY SPACED HEAVY DUTY WIRE STAPLES AT LEAST 12 INCHES IN LENGTH.
- 2. ENSURE THAT THE WEIR IS LEVEL TO UNIFORMLY SPREAD DISCHARGE.
- 3. THE WEIR SHALL BE CONSTRUCTED ON UNDISTURBED SOIL NOT FILL.
- 4. THE RUNOFF DISCHARGE WILL BE OUTLETED ONTO A STABILIZED VEGETATED
- 5. SEED AND MULCH THE DISTURBED AREA IMMEDIATELY AFTER CONSTRUCTION AND APPLY MATTING OVER ALL DISTURBED AREAS AS NEEDED.



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> **EROSION &** SEDIMENT **CONTROL DETAILS**

Job No. 2023-1012 01/26/24 Scale Drawn / Checked AS NOTED HPBJr/SMQ

Sheet Number

RATE (TONS/ACRE) <u>RATE</u> (LBS./1,000 SQ. FT.) 1.0 TONS/ACRE

50 LBS./ACRE

SEEDING AND MULCHING SPECIFICATIONS:

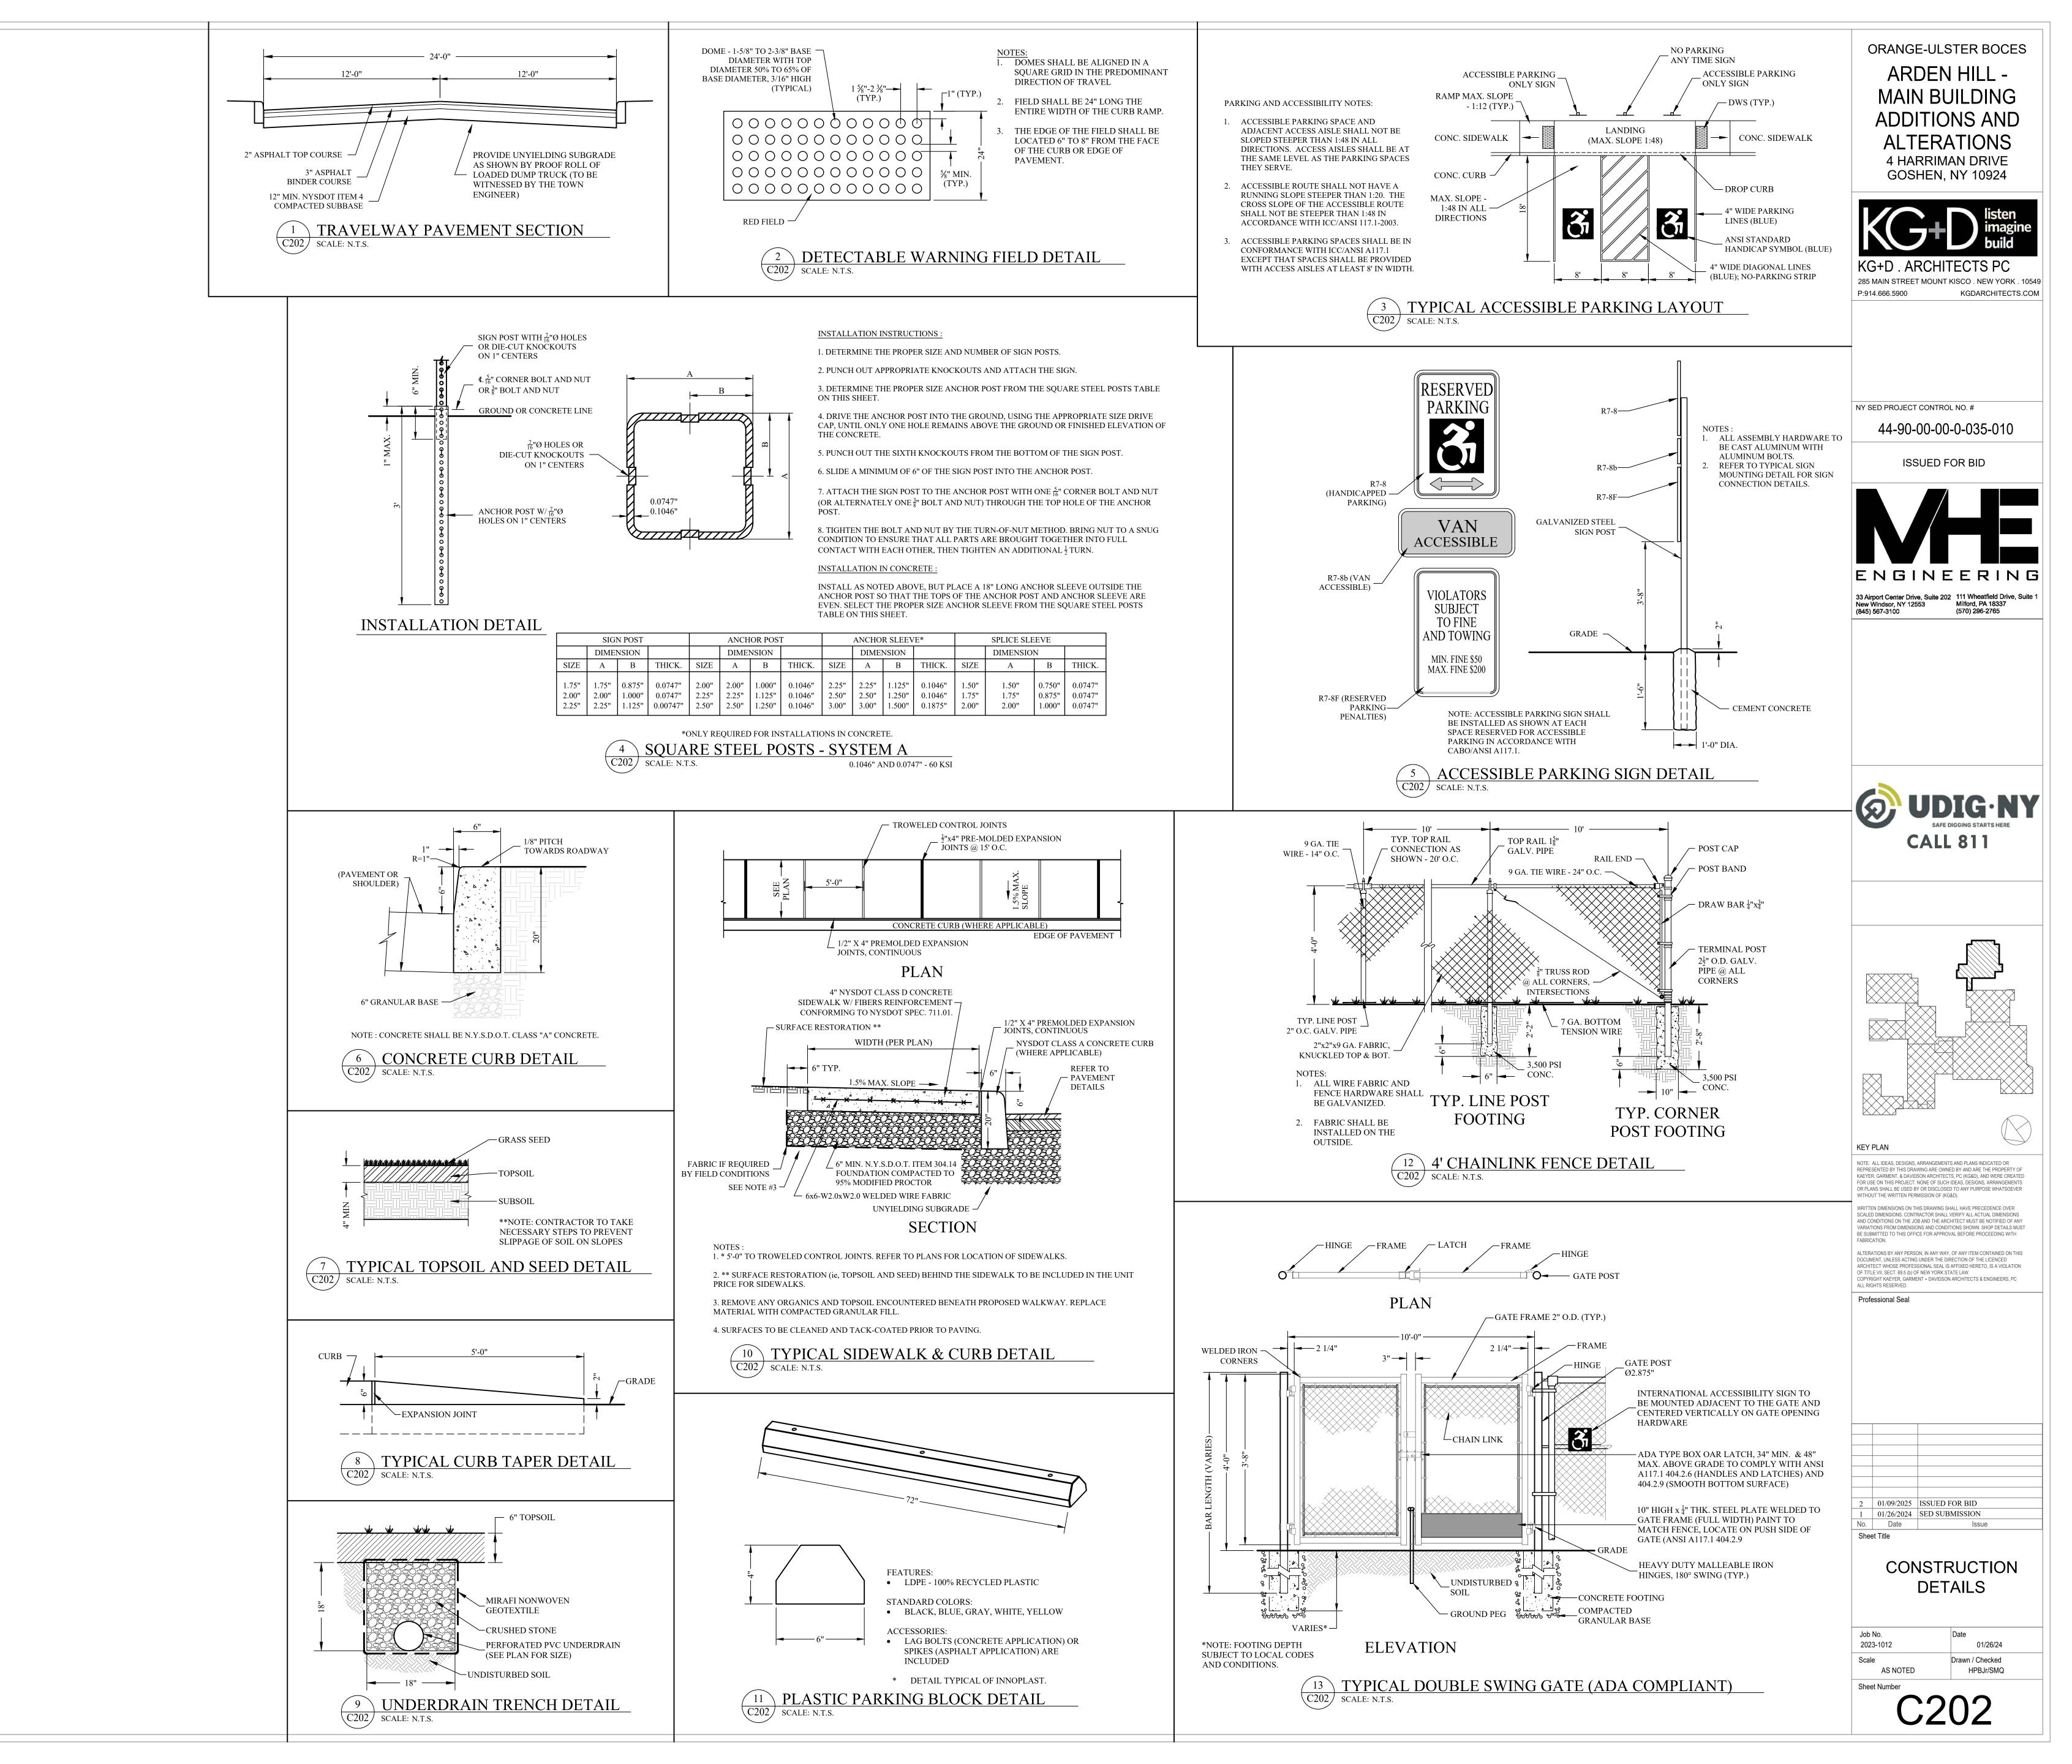
SEEDING MIXTURE % BY WEIGHT (LBS./1,000 SQ. FT.) PERENNIAL RYE GRASS 20% KENTUCKY BLUEGRASS 80% TOTAL = 4.0 LBS./1,000 SQ. FT**MULCH** <u>TYPE</u> RATE (TONS/ACRE) HAY OR STRAW SOIL PREPARATION (LBS./1,000 SQ. FT.) SOIL AMENDMENT <u>RATE</u> AGRICULTURAL GRADE 6.0 TONS/ACRE 275 LIMESTONE

1,000 LBS./ACRE


PERMANENT STABILIZATION (UNPAVED AREAS)

10-20-10 FERTILIZER

TEMPORARY STABILIZATION: SEEDING MIXTURE RATE (LBS./ACRE) (LBS./1,000 SQ. FT.) ANNUAL RYE GRASS 1.0 <u>MULCH</u> **TYPE** HAY OR STRAW SOIL PREPARATION SOIL AMENDMENT AGRICULTURAL GRADE LIMESTONE **PLUS**



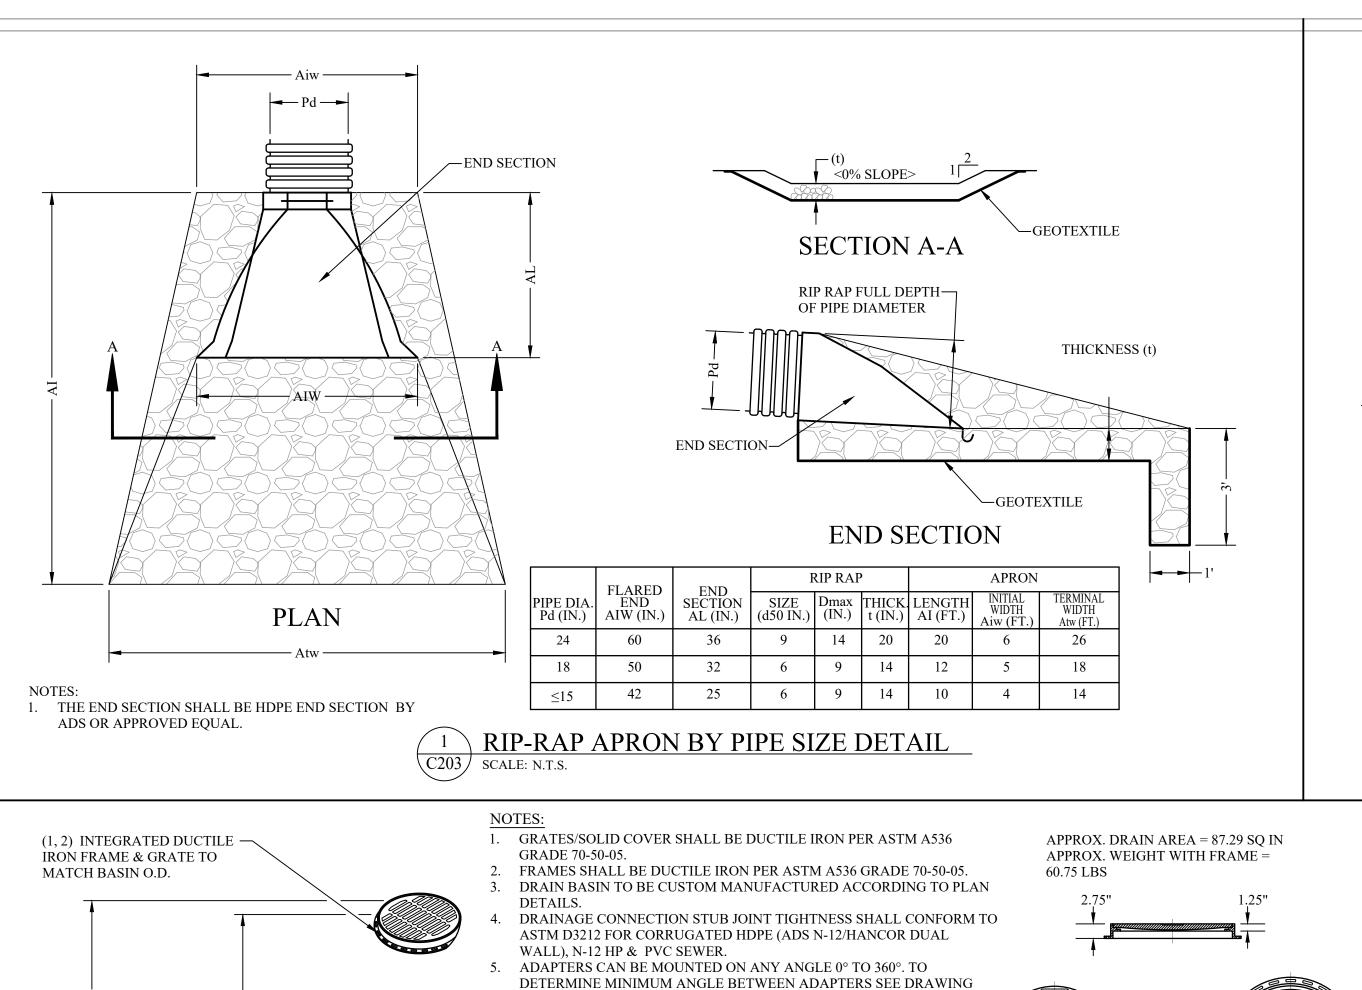E:\2023\23-704 O.U. BOCES KG&D\23-704 70 Arden Hill Gvm (Civil\\Draftina\Civil\\SITE PLANS ISSUED FOR BID 1-9-25 dwg C202: 1/15/2025 3:49:37 PM



NO. 7001-110-012.

—4" MIN.

(5) ADAPTER ANGLES

ACCORDING TO PLANS

VARIABLE 0° - 360°

3 VARIABLE INVERT

HEIGHTS

AVAILABLE

(ACCORDING TO

PLANS/TAKE OFF)

(4) VARIOUS TYPES OF INLET & OUTLET —

ADAPTERS AVAILABLE: 4" - 24" FOR

DUAL WALL, ADS/HANCOR SINGLE

CORRUGATED & RIBBED PVC

CORRUGATED HDPE (ADS N-12/HANCOR

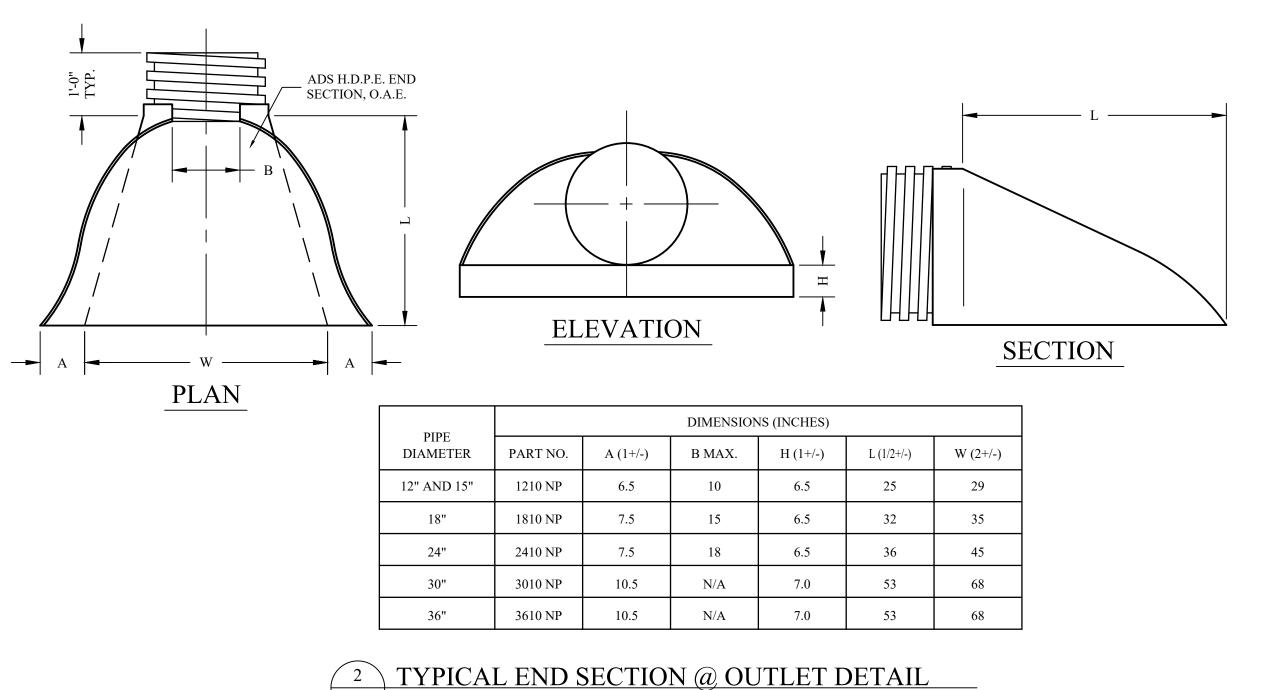
WALL), N-12 HP, PVC SEWER (EX: SDR 35),

WATERTIGHT JOINT -


(CORRUGATED HDPE

SHOWN)

PVC DWV (EX: SCH 40), PVC C900/C905,



C203 SCALE: N.T.S.

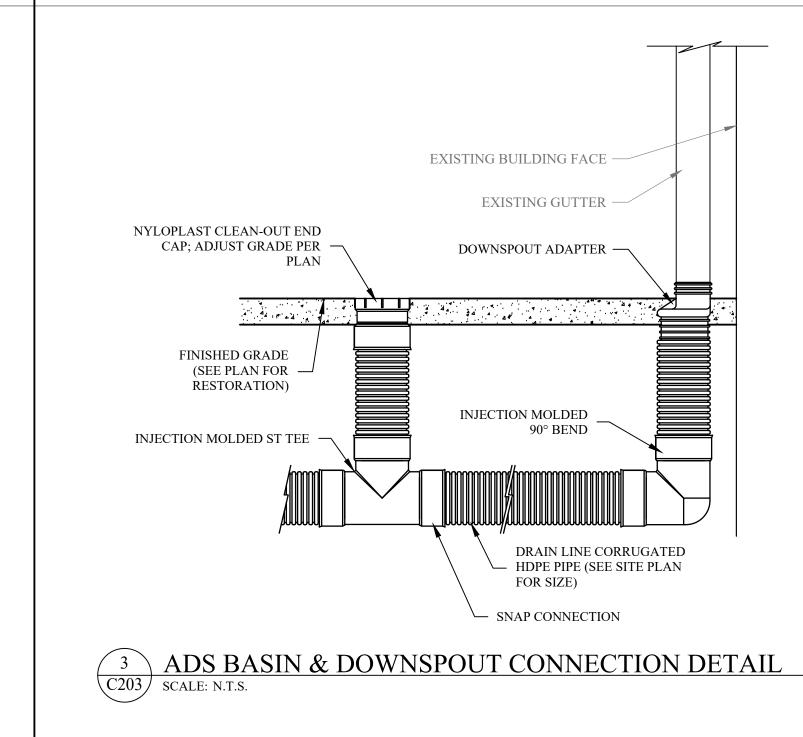

ORANGE-ULSTER BOCES ARDEN HILL -MAIN BUILDING **ALTERATIONS** 4 HARRIMAN DRIVE GOSHEN, NY 10924

285 MAIN STREET MOUNT KISCO . NEW YORK . 10549

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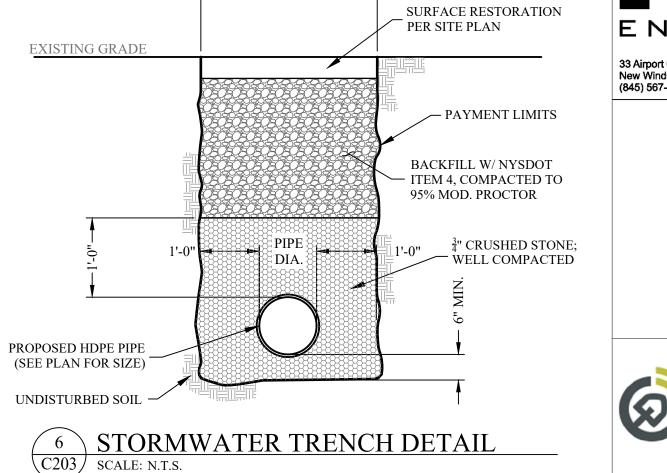
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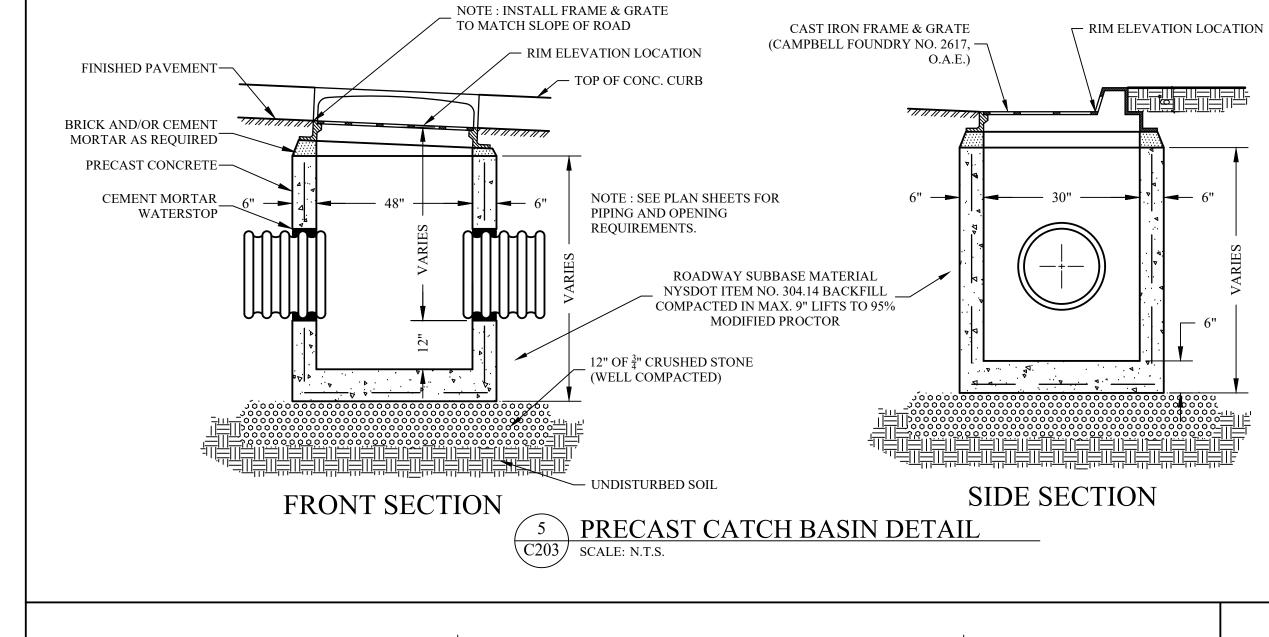





RESTORATION

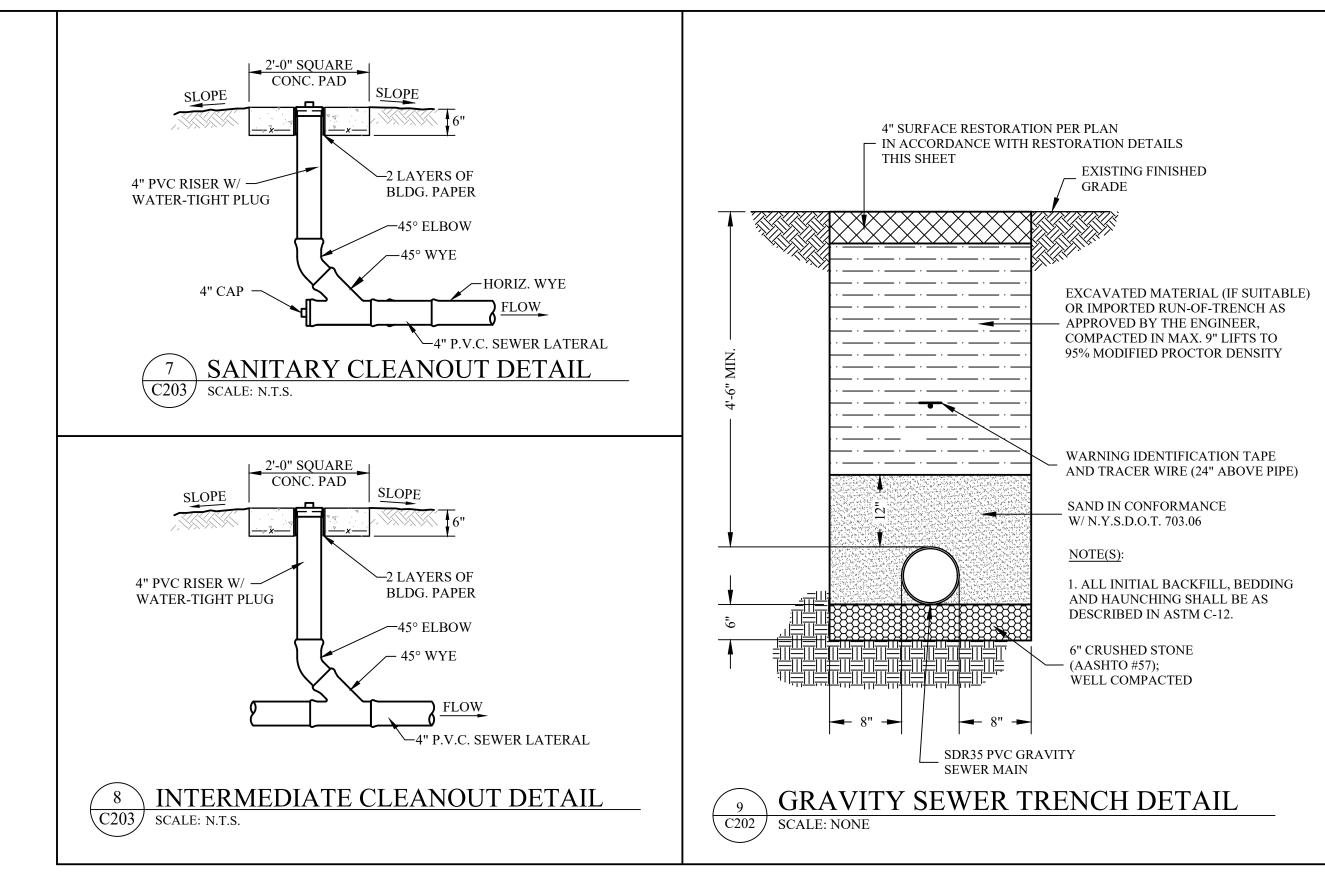PAYMENT LIMITS







(3) VARIABLE SUMP DEPTH

ACCORDING TO PLANS

MANUFACTURERS REQ.)

(6" MIN. BASED ON

THE BACKFILL MATERIAL SHALL BE CRUSHED

BE PLACED & COMPACTED UNIFORMLY IN

4 NYLOPLAST 18" CATCH BASIN DETAIL (O.A.E.)
SCALE: N.T.S.

ACCORDANCE WITH ASTM D2321.

STONE OR OTHER GRANULAR MATERIAL MEETING

THE REQUIREMENTS OF CLASS I, CLASS II, OR CLASS

III MATERIAL AS DEFINED IN ASTM D2321. BEDDING

& BACKFILL FOR SURFACE DRAINAGE INLETS SHALL

PEDESTRIAN GRATE (1899CGP)

PAINT: CASTINGS ARE FURNISHED WITH A BLACK PAINT

QUALITY: MATERIALS SHALL CONFORM TO ASTM A536 GRADE 70-50-05

SIZE OF OPENING MEETS REQUIREMENTS OF AMERICAN DISABILITY

ACT AS STATED IN FEDERAL REGISTER PART III, DEPARTMENT OF

LOCKING DEVICE AVAILABLE UPON REQUEST SEE DRAWING NO.

DIMENSIONS ARE FOR REFERENCE ONLY

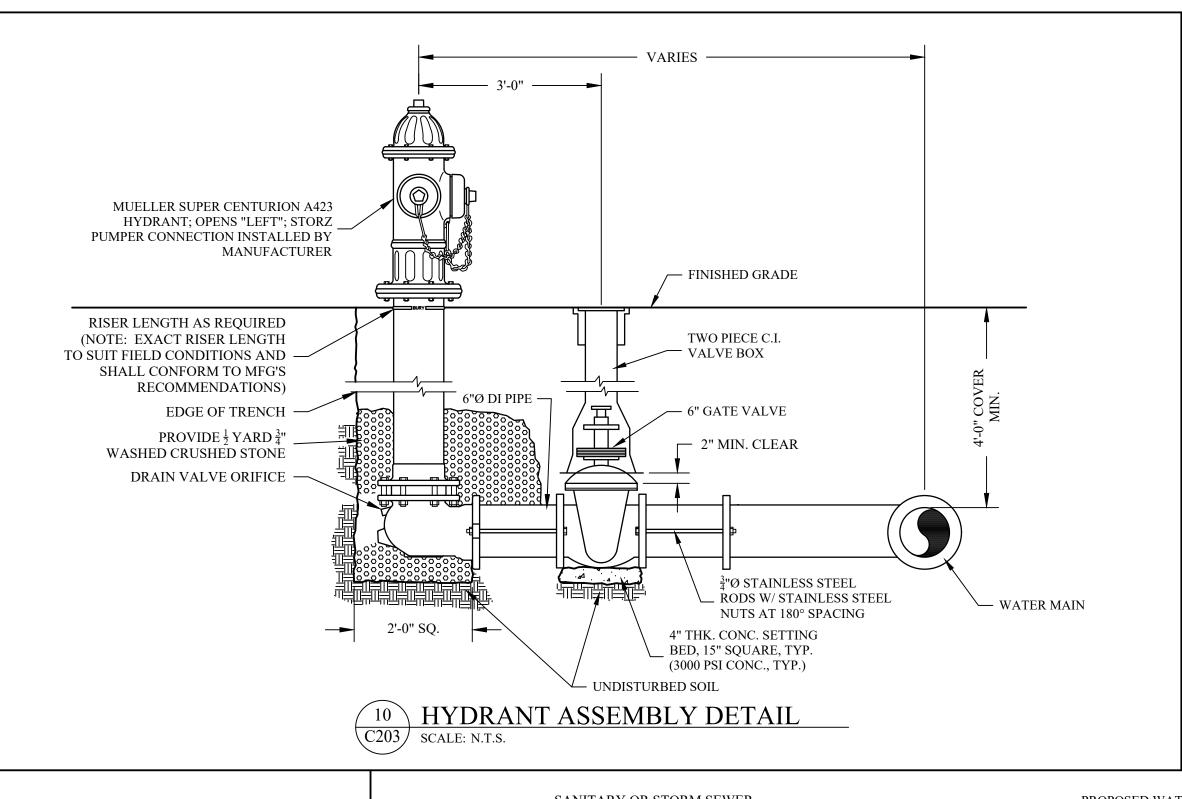
ACTUAL DIMENSIONS MAY VARY

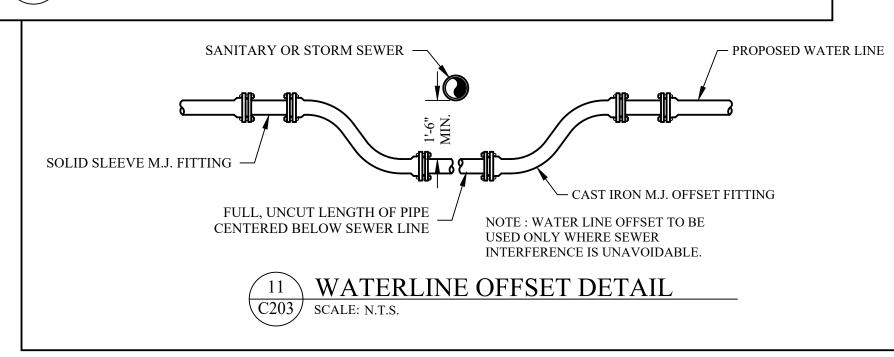
GRATE MEETS H-10 LOAD RATING

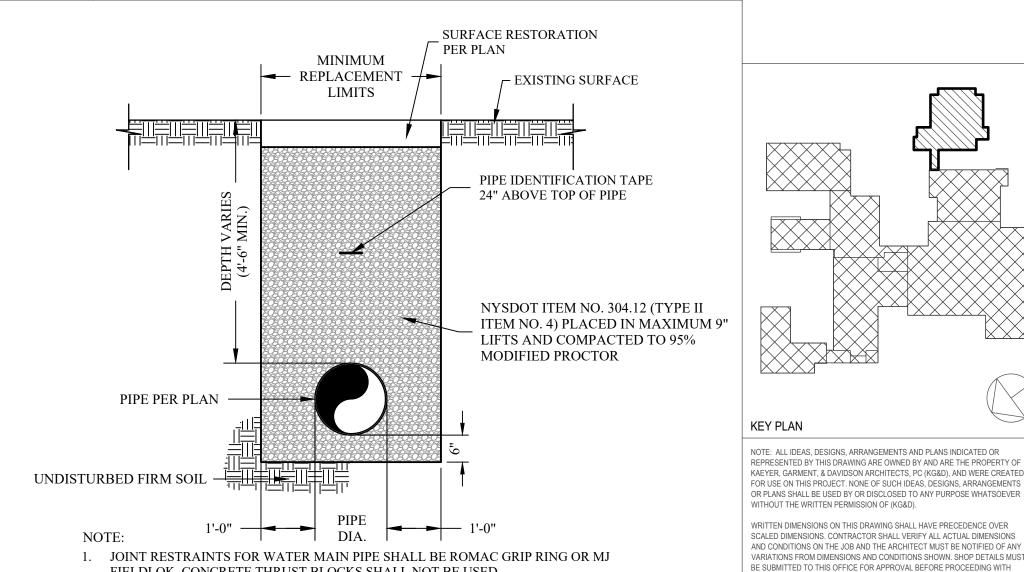
DIMENSIONS ARE IN INCHES

JUSTICE, 28 CFR PART 36.

7001-110-023









FIELDLOK. CONCRETE THRUST BLOCKS SHALL NOT BE USED. 2. ALL BOLTS ON WATER MAIN FITTINGS, RESTRAINTS, ETC. SHALL BE COR-BLUE OR

12 TYPICAL WATER TRENCH DETAIL C203 | SCALE: N.T.S.

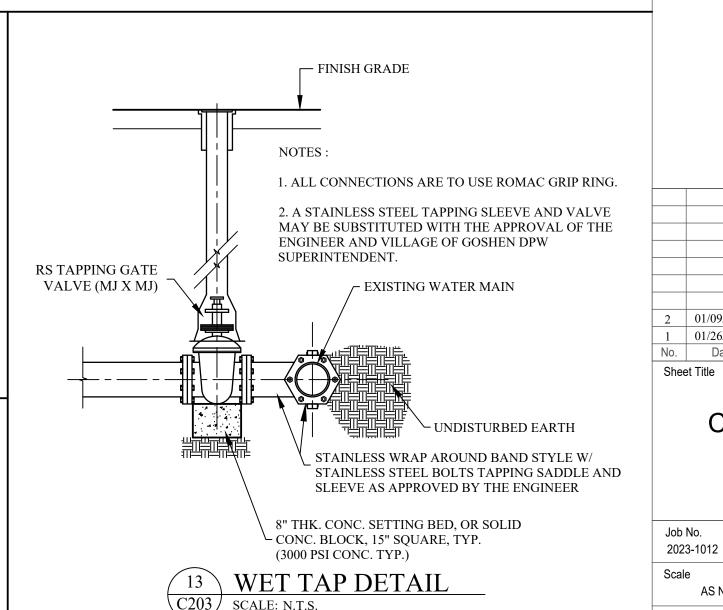

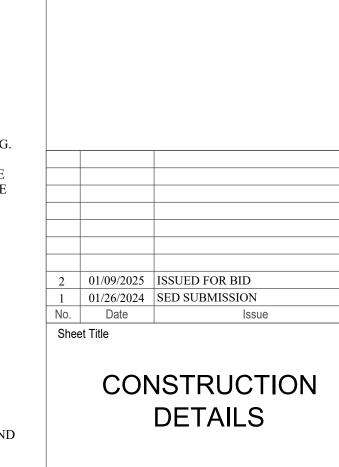

ALTERATIONS BY ANY PERSON, IN ANY WAY, OF ANY ITEM CONTAINED ON THIS

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AS NOTED HPBJr/SMQ Sheet Number

01/26/24

Drawn / Checked

C203 SCALE: N.T.S.

GENERAL PLANTING NOTES

OTHER THAN PLANTING.

1. THE CONTRACTOR SHALL USE CARE DURING CONSTRUCTION TO AVOID UNNECESSARY DAMAGE TO PROPERTY. RESTORE ALL DAMAGE TO THE SATISFACTION OF THE OWNER.

- 2. LOCATIONS OF UNDERGROUND UTILITIES AND OTHER SUBSURFACE ELEMENTS, TO THE EXTENT SHOWN, ARE APPROXIMATE ONLY. ALL EXISTING UTILITY LINES MAY NOT BE SHOWN ON THE DRAWING. IT IS THE CONTRACTOR'S RESPONSIBILITY TO IDENTIFY AND DETERMINE THE EXACT LOCATION OF ANY UTILITY OR DRAINAGE LINE THAT MAY BE ENCOUNTERED DURING CONSTRUCTION AND TO PROTECT ALL LINES INTENDED TO REMAIN.
- 3. CALL "DIG SAFELY NY" AT 811 [OR 1-800-962-7962] AND ANY OTHER REQUIRED UTILITY LOCATORS AT LEAST 72 HOURS PRIOR TO EXCAVATION TO IDENTIFY LOCATIONS OF UTILITIES.
- 4. IF AND WHEREVER PLANTS CANNOT BE LOCATED AS INDICATED DUE TO UNDERGROUND OBSTRUCTIONS, ADJUST SUCH LOCATIONS KEEPING PLANTS IN RELATIVE CONFORMANCE WITH THE OVERALL PLAN CONFIGURATION AND LAYOUT.
- 5. ALL AREAS UPON WHICH CONSTRUCTION OR PLANT BEDS DO NOT OCCUR WITHIN THE CONTRACT LIMITS SHALL BE TOPSOILED MINIMUM FOUR (4) INCHES, SEEDED WITH PERMANENT GRASS SEED MIX AND MULCHED UNLESS OTHERWISE SHOWN.
- 6. CONTRACTOR SHALL CLEAN UP AND REMOVE FROM THE SITE ALL RUBBISH, DEBRIS AND SURPLUS MATERIAL AS FAST AS IT ACCUMULATES AND NOT PERMIT MATERIAL OR EQUIPMENT TO BE SCATTERED ABOUT THE SITE.
- 7. REFER TO OTHER SHEETS IN THE CONSTRUCTION DRAWING SET FOR SITEWORK INFORMATION
- 8. CONTRACTOR SHALL CONDUCT ALL PLANTING IN A WORKMANLIKE MANNER AND IN ACCORDANCE WITH PREVAILING HORTICULTURAL PRACTICES.
- 9. ALL PLANT MATERIALS MAY BE SUBJECT TO INSPECTION AND REJECTION BY THE LANDSCAPE
- ARCHITECT AT ANY TIME PRIOR TO FINAL ACCEPTANCE OF THE WORK.

 10. OBTAIN LANDSCAPE ARCHITECT'S APPROVAL OF PLANT SUBSTITUTIONS PRIOR TO DELIVERY
- 11. PLANT SIZE AND GRADING SHALL CONFORM TO AMERICAN ASSOCIATION OF NURSERYMEN STANDARDS. ALL PLANT MATERIAL SHALL BE NURSERY GROWN, FULLY FORMED AND IN A HEALTHY CONDITION FREE OF INSECTS, PESTS, DISEASE OR DAMAGE AT THE TIME OF
- 12. MULCH ALL PLANT BEDS. COVER SHRUB AND GROUNDCOVER BEDS WITH A PERVIOUS WEED BARRIER FABRIC PRIOR TO MULCHING. EXTEND BEDS TO INCLUDE ALL SHRUBS IN THE MASS, MAKE A SMOOTH OUTLINE, NEATLY EDGE AND MULCH.
- 13. CONTRACTOR SHALL MAINTAIN ALL PLANTINGS UNTIL FINAL ACCEPTANCE OF THE WORK.
 MAINTENANCE INCLUDES WATERING AND WEEDING AS MANY TIMES AS MAY BE NEEDED TO
 MAINTAIN HEALTHY PLANTS AND A NEAT APPEARANCE.

TREE BN Betul ZS Zelko MIN AL Amel SR Syrir EVER PE-1 Picea PS-1 Pinus PS-2 Pinus SHRI EC Enkic HP Hydr KL Kalmi PL Prunc	nical Name Signa 'Heritage' Sova serrata 'Green Vase' OR DECIDUOUS TREES Ianchier laevis Inga reticulata 'Ivory Silk'	Common Name Heritage River Birch Green Vase Zelkova Allegheny Shadblow Japanese Tree Lilac	3 5	5ize 12'-14' HT. 2 1/2"-3" CAL. 10'-12' HT. 2"- 2 1/2" CAL.	B&B, LIMBED TO 7' B&B, SINGLE STEM
TREE BN Betul ZS Zelko MIN AL Amel SR Syrir EVER PE-1 Picea PS-1 Pinus PS-2 Pinus SHRI EC Enkic HP Hydr KL Kalmi PL Prunc	ES la nigra 'Heritage' ova serrata 'Green Vase' OR DECIDUOUS TREES lanchier laevis nga reticulata 'Ivory Silk'	Heritage River Birch Green Vase Zelkova Allegheny Shadblow	3 5	12'-14' HT. 2 1/2"-3" <i>CA</i> L. 10'-12' HT.	B&B, TRIPLE-STEM B&B, LIMBED TO 7' B&B, SINGLE STEM
BN Betul ZS Zelko MIN AL Amel SR Syrir EVER PE-1 Picea PS-1 Pinus PS-2 Pinus SHRI EC Enkic HP Hydr KL Kalmi PL Prunc	la nigra 'Heritage' ova serrata 'Green Vase' OR DECIDUOUS TREES lanchier laevis nga reticulata 'Ivory Silk'	Green Vase Zelkova Allegheny Shadblow	5 4	2 1/2"-3" <i>CA</i> L. 10'-12' HT.	B&B, LIMBED TO 7' B&B, SINGLE STEM
AL Amel SR Syrir EVER PE-1 Picea PS-1 Pinus PS-2 Pinus SHRI EC Enkic HP Hydr KL Kalmi PL Prunc	ova serrata 'Green Vase' OR DECIDUOUS TREES lanchier laevis nga reticulata 'Ivory Silk'	Green Vase Zelkova Allegheny Shadblow	5 4	2 1/2"-3" <i>CA</i> L. 10'-12' HT.	B&B, LIMBED TO 7' B&B, SINGLE STEM
MIN AL Amel SR Syrir EVER PE-1 Picea PS-1 Pinus PS-2 Pinus SHRI EC Enkic HP Hydr KL Kalmi PL Prunc	OR DECIDUOUS TREES lanchier laevis nga reticulata 'Ivory Silk'	Allegheny Shadblow	4	10'-12' HT.	B&B, SINGLE STEM
AL Amel SR Syrir EVER PE-1 Picea PS-1 Pinus PS-2 Pinus SHRI EC Enkic HP Hydr KL Kalmi PL Prunc	lanchier laevis nga reticulata 'Ivory Silk'	- ,			•
SR Syrir EVER PE-1 Picea PS-1 Pinus PS-2 Pinus SHRI EC Enkic HP Hydr KL Kalmi PL Prunc	nga reticulata 'Ivory Silk'	- ,			•
EVER PE-1 Picea PS-1 Pinus PS-2 Pinus SHRI EC Enkic HP Hydr KL Kalmi PL Prunc	•	Japanese Tree Lilac	5	2"- 2 1/2" CAL.	DAD STAIGHT STEM
PE-1 Piced PS-1 Pinus PS-2 Pinus SHRI EC Enkic HP Hydr KL Kalmi PL Prunu	RGREEN TREES				DOD, STINGLE SICIN
PS-1 Pinus PS-2 Pinus SHRI EC Enkic HP Hydr KL Kalmi PL Prunc					
PS-2 Pinus SHRI EC Enkic HP Hydr KL Kalmi PL Pruni	n excelsa (abies)	Norway Spruce	11	10'-12' HT.	В&В
SHRI EC Enkid HP Hydr KL Kalmi PL Prund	strobus	White Pine	4	14'-16' HT.	В&В
EC Enkic HP Hydr KL Kalmi PL Prund	strobus	White Pine	6	10'-12' HT.	В&В
HP Hydr KL Kalmi PL Prund	UBS				
KL Kalmi PL Pruni	anthus campanulatus	Redvein Enkianthus	4	30"-36"	В&В
PL Prunc	angea paniculata 'Bobo'	Bobo Hydrangea	12	#3 POT	
	ia latifolia 'Olympic Fire'	Mountain Laurel	5	#3 POT	
GRO	us laurocerasus 'Schipkaensis'	Cherrylaurel	10	#5 POT	
	UNDCOVERS				
LMV Lirio _l	pe muscari 'Variegata'	Blue Lilyturf	900	FLATS	
ORN	AMENTAL GRASSES				
MSP Misc	anthus sinensis 'Purpurescens'	Purple Eulalia Grass	3	2 GAL	
SSB Schi	zachyrium scoparium 'The Blues'	Little Bluestem	400	#1 CONT.	

1. All plants to be balled & burlapped (B&B) or container grown unless otherwise indicated.

3. Contractor shall verify all quantities and furnish all plants shown on the plan.

5. Mulch shall be shredded bark mulch, black.

2. Quantities listed in Plant List are for reference only. The plan quantities take precedence.

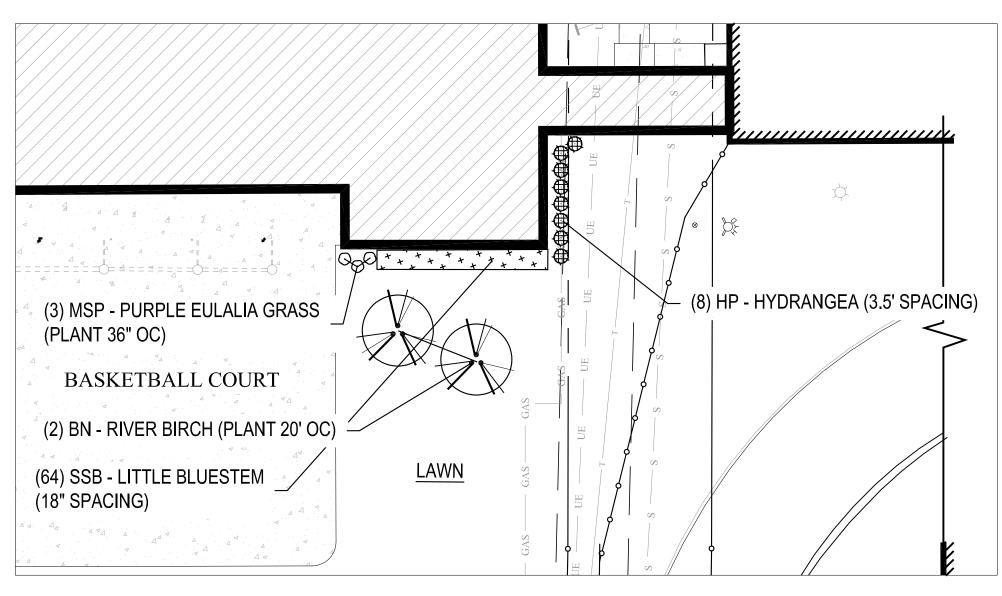
4. All plant beds shall receive 3" depth of specified mulch over fabric weed barrier unless otherwise shown.

TREE PLANTING DETAIL

3 TREE PLANTING DETAIL


SHOULD BLANTING BLANTING DETAIL

SHOULD BLANTING BLANTIN



BASE BID PLANTING LAYOUT WITHOUT FITNESS CENTER

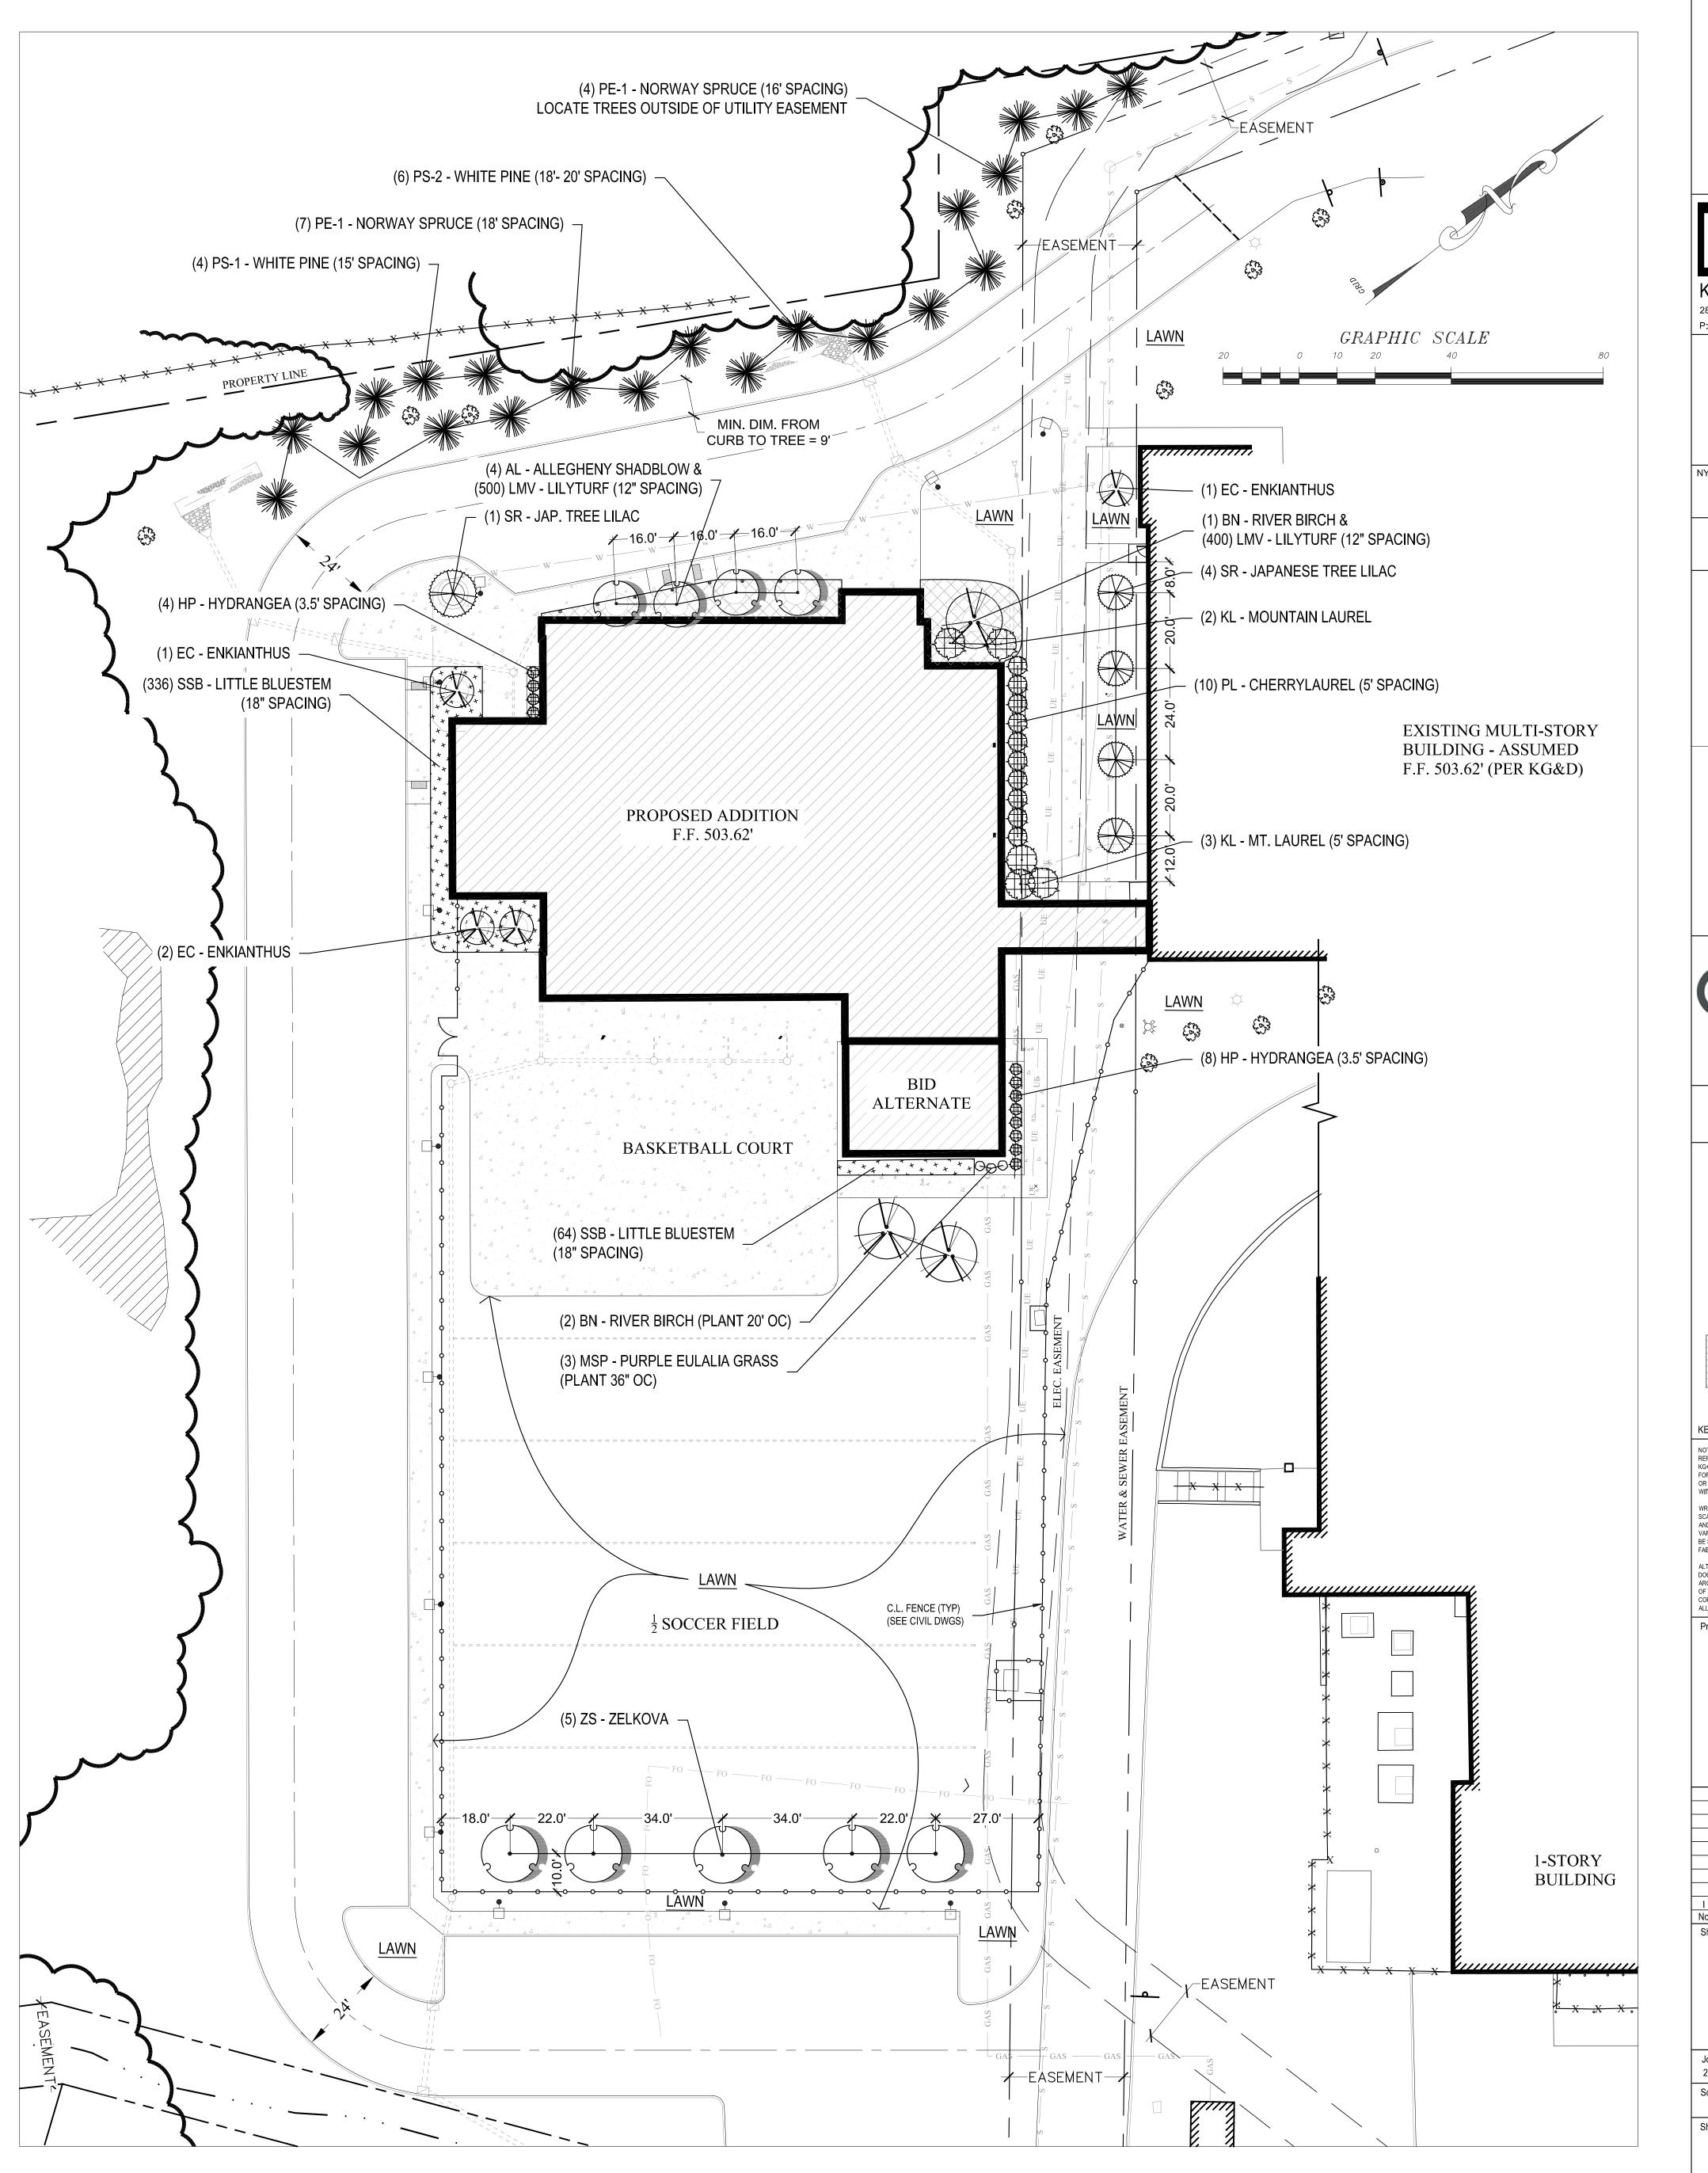SCALE: 1" = 20'



ARDEN HILL MAIN BUILDING
ADDITIONS AND
ALTERATIONS
4 HARRIMAN DRIVE

GOSHEN, NY 10924




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WITHOUT THE WRITTEN PERMISSION OF KG+D.

WRITTEN DIMENSIONS ON THIS DRAWING SHALL HAVE PRECEDENCE OVER
SCALED DIMENSIONS. CONTRACTOR SHALL VERIFY ALL ACTUAL DIMENSIONS
AND CONDITIONS ON THE JOB AND THE ARCHITECT MUST BE NOTIFIED OF ANY
VARIATIONS FROM DIMENSIONS AND CONDITIONS SHOWN. SHOP DETAILS MUST
BE SUBMITTED TO THIS OFFICE FOR APPROVAL BEFORE PROCEEDING WITH

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LANDSCAPE

PLAN

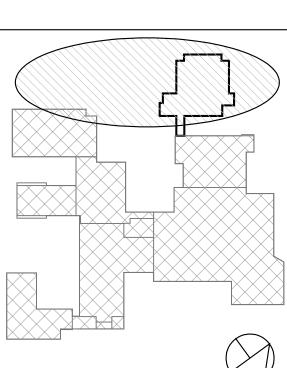2023-1012 01/15/25

Scale Drawn / Checked FPW.LA

Sheet Number

L100

ALL ITEMS NOT INDICATED TO BE EXISTING [OR SUPPLIED BY OTHERS] SHALL BE PROVIDED AND INSTALLED UNDER THE REQUIREMENTS OF THIS CONTRACT.

THE STRUCTURAL DRAWINGS SHALL BE USED IN CONJUNCTION WITH THE CIVIL, ARCHITECTURAL, MECHANICAL, ELECTRICAL AND PLUMBING DRAWINGS. THE CONTRACTOR SHALL VERIFY THE REQUIREMENTS OF OTHER TRADES REGARDING SLEEVES, CHASES, HANGERS, INSERTS, ANCHORS, HOLES, AND ADDITIONAL ITEMS TO BE PLACED OR SET IN STRUCTURAL WORK.

THE CONTRACTOR SHALL FIELD VERIFY ALL EXISTING DIMENSIONS AND CONDITIONS PRIOR TO BEGINNING CONSTRUCTION. ANY DISCREPANCIES BETWEEN FIELD CONDITIONS AND THE CONTRACT DRAWINGS SHALL BE BROUGHT TO THE ATTENTION OF

6. ANY ITEMS INDICATED TO BE REPLACED-IN-KIND SHALL BE INSTALLED TO MATCH EXISTING LOCATIONS, CONFIGURATIONS, AND ELEVATIONS UNLESS OTHERWISE NOTED. ALL MATERIALS SHALL BE INSTALLED IN ACCORDANCE WITH MANUFACTURER'S

THE CONTRACTOR SHALL PROVIDE TEMPORARY SHORING AND BRACING REQUIRED TO ERECT AND HOLD THE STRUCTURE IN PROPER ALIGNMENT. NEITHER THE STRUCTURE NOR INDIVIDUAL STRUCTURAL ELEMENTS SUCH AS WALLS, BEAMS, JOISTS, AND COLUMNS WILL BE LATERALLY STABLE UNTIL ALL WORK INDICATED ON THE STRUCTURAL DRAWINGS IS COMPLETE.

SPECIFICATIONS. IF MANUFACTURER'S SPECIFICATIONS CONFLICT WITH CONTRACT

DRAWINGS OR SPECIFICATIONS, THE ENGINEER SHALL BE NOTIFIED IMMEDIATELY.

ALL SUBSURFACE UTILITIES SHALL BE IDENTIFIED PRIOR TO EXCAVATION. THE CONTRACTOR SHALL EXERCISE EXTREME CAUTION DURING EXCAVATION. IF UNIDENTIFIED UTILITIES ARE ENCOUNTERED, THE ENGINEER SHALL BE NOTIFIED

10. ALL ITEMS SHOWN TO BE REMOVED SHALL BE PROPERLY REMOVED, AND PROPERLY DISPOSED OF OFF SITE.

11. NO BACKFILLING OF THE STRUCTURE SHALL OCCUR UNTIL CONCRETE BREAKS SATISFACTORY TO THE ENGINEER ARE OBTAINED OR UNTIL THE CONTAINMENT

12. ALL ITEMS INDICATED TO BE PRECAST OR DESIGNED BY OTHERS SHALL BE SUBMITTED TO THE ENGINEER OF RECORD (E.O.R.) PRIOR TO ORDERING MATERIALS. SUBMITTALS SHALL INCLUDE PLANS AND CALCULATIONS SIGNED AND SEALED BY A NEW YORK STATE LICENSED PROFESSIONAL ENGINEER.

STRUCTURE HAS SUCCESSFULLY PASSED HYDROSTATIC TESTING IF APPLICABLE.

MASONRY NOTES:

1. ALL MASONRY CONSTRUCTION SHALL CONFORM TO THE LATEST EDITION OF THE "BUILDING CODE REQUIREMENTS FOR MASONRY STRUCTURES" ACI 530/TMS 402.

ALL CONCRETE MASONRY UNITS SHALL BE NORMAL WEIGHT WITH TWO (2) CELLS AND CONFORM TO ASTM C90 UNLESS OTHERWISE SPECIFIED.

ALL BRICK MASONRY UNITS SHALL CONFORM TO ASTM C216.

ALL MORTAR SHALL CONFORM TO ASTM C270

ALL GROUT SHALL CONFORM TO ASTM C476. THE MINIMUM SPECIFIED NET AREA COMPRESSIVE STRENGTH OF MASONRY (fm) SHALL BE 2000 PSI AND SHALL CONSIST OF THE FOLLOWING COMPONENTS: A. CONCRETE MASONRY UNITS: 2000 PSI MINIMUM NET AREA COMPRESSIVE

BRICK MASONRY UNITS: 4950 PSI MINIMUM NET AREA COMPRESSIVE STRENGTH PORTLAND CEMENT MORTAR: TYPE S GROUT: 2000 PSI MINIMUM 28 DAY COMPRESSIVE STRENGTH (GROUT COMPRESSIVE STRENGTH SHALL NOT BE LESS THAN f'm)

PROVIDE CONTINUOUS HORIZONTAL BOND BEAMS REINFORCED WITH (2) #5 BARS UNLESS OTHERWISE SPECIFIED WITH TOP OF BOND BEAM ELEVATIONS AS INDICATED. DO NOT CONTINUE REINFORCEMENT ACROSS CONTROL JOINTS EXCEPT FOR CONTROL JOINTS AS

GROUT ALL CELLS CONTAINING REINFORCEMENT AND/OR HEADED STUD ANCHORS AS

WELL AS DIRECTLY BELOW ALL BEARING PLATES. REINFORCEMENT SPLICES SHALL BE KEPT TO A PRACTICAL MINIMUM. SEE THE MASONRY

LAP SPLICE TABLE ON THIS SHEET FOR MINIMUM LAP SPLICE LENGTHS.

UNLESS OTHERWISE INDICATED, ALL CMU WALLS SHALL BE PROVIDED WITH HOT DIPPED GALVANIZED HORIZONTAL REINFORCEMENT (DURO-WAL W1.7 LADDER WIRE, OR EQUAL) EVERY OTHER COURSE (16" O.C.). PROVIDE HORIZONTAL REINFORCING FOR THE FIRST TWO COURSES ABOVE ALL LINTELS.

REINFORCEMENT SHALL BE PLACED SUCH THAT A MINIMUM OF 5/8" MORTAR COVER EXISTS FOR EXTERIOR FACES, AND A MINIMUM OF 1/2" MORTAR COVER EXISTS FOR ALL

UNLESS OTHERWISE NOTED, PROVIDE (1) CONTINUOUS VERTICAL #5 BAR FOR THE FULL HEIGHT OF WALL AND ANCHORED INTO THE FOUNDATION AT THE FOLLOWING LOCATIONS:

EACH SIDE OF CONTROL JOINTS SIDES OF MASONRY OPENINGS (DOOR JAMBS, ETC.)

WALL CORNERS

PROVIDE CONTROL JOINTS IN MASONRY WALLS AT A MAXIMUM SPACING OF 3 TIMES THE 6. WALL HEIGHT. CONTROL JOINTS SHALL BE SPACED AT A MAXIMUM OF 15 FEET FROM ALL CORNERS, SUBMIT CONTROL JOINT PLAN TO ENGINEER FOR REVIEW PRIOR TO CONSTRUCTION

CONTROL JOINTS SHALL BE PLACED AT ALL CHANGES IN MASONRY WALL HEIGHT AND MASONRY WALL THICKNESS.

15. UNLESS OTHERWISE NOTED, ALL LOAD BEARING MASONRY WALLS SHALL HAVE #4 @ 48" O.C. VERTICAL REINFORCEMENT. NON-LOAD BEARING MASONRY SHALL HAVE #4 @ 120"

AISI COLD FORMED FRAMING NOTES:

METAL STUD SIZES SHOWN ON PLANS AND DETAILS ARE BASED ON CLARKDIETRICH GALVANIZED STEEL STUDS. ALL FRAMING MATERIALS AND CONNECTIONS SHALL BE EQUIVALENT TO THOSE MANUFACTURED BY CLARKDIETRICH. ALL STUDS AND THEIR CONNECTIONS SHALL BE GALVANIZED AND SHALL COMPLY WITH THE REQUIREMENTS OF AISI SPECIFICATION FOR THE DESIGN OF COLD FORM STEEL STRUCTURAL MEMBERS, LATEST EDITION.

ALL METAL STUDS SHALL HAVE A MINIMUM YIELD STRENGTH OF 50 KSI.

STEEL STUDS: MANUFACTURER'S STANDARD C-SHAPED STEEL STUDS, OF WEB DEPTHS INDICATED, PUNCHED, WITH STIFFENED FLANGES, AND AS FOLLOWS: A. MINIMUM BASE-METAL THICKNESS: 20 GA. (33 MILS) B FLANGE WIDTH: 1-5/8 INCHES

INSTALL CONTINUOUS U-SHAPED STEEL TRACKS SIZED TO MATCH STUDS. ALIGN TRACKS ACCURATELY AND SECURELY ANCHOR TO SUPPORTING STRUCTURE AT EACH STUD LOCATION. TRACKS SHALL BE UNPUNCHED WITH STRAIGHT FLANGES AND MATCH MINIMUM BASE METAL THICKNESS OF STUDS.

FASTEN BOTH FLANGES OF STUDS TO BOTTOM TRACK UNLESS OTHERWISE INDICATED. SPACE STUDS AS FOLLOWS: A. STUD SPACING: 24" O.C. MAX

SET STUDS PLUMB. EXCEPT AS NEEDED FOR DIAGONAL BRACING OR REQUIRED FOR NON-PLUMB WALLS OR WARPED SURFACES AND SIMILAR REQUIREMENTS.

ISOLATE NON-LOAD-BEARING STEEL FRAMING FROM BUILDING STRUCTURE TO PREVENT TRANSFER OF VERTICAL LOADS WHILE PROVIDING LATERAL SUPPORT.

BRIDGE ALL JOISTS, RAFTERS AND BEARING WALL STUDS WITH BRIDGING CHANNEL AT 4' O.C. MAX. SCREW OR WELD BOTTOM OF BRIDGING AFTER SHEATHING IS IN PLACE.

ALL CLIP AND UTILITY ANGLES SHALL BE THE SAME GAUGE AS THE MEMBERS BEING CONNECTED. IF THE MEMBERS BEING CONNECTED ARE DIFFERENT GAUGES, ANGLES SHALL BE A MINIMUM OF THE THINNER GAUGE.

FOR ALL OPENINGS LARGER THAN JOIST FRAMING, FRAME WITH DOUBLE-HEADERS AND TRIMMERS AROUND OPENINGS. PROVIDE DOUBLE BOX JOISTS AROUND PARTITION WALLS PARALLEL TO JOISTS.

SHOP DRAWINGS OF ALL LIGHT GAUGE METAL FRAMING SHALL BE SUBMITTED TO THE ENGINEER PRIOR TO MANUFACTURING.

12. IF BASIS OF DESIGN MANUFACTURER'S LIGHT GAUGE FRAMING IS NOT USED, CONTRACTOR SHALL PROVIDE ALL SPECIFICATIONS AND MATERIAL PROPERTIES FOR THE SELECTED LIGHT GAUGE MANUFACTURER FOR APPROVAL PRIOR TO THE COMMENCEMENT OF CONSTRUCTION.

WELDING NOTES:

ALL WELDING SHALL BE CONDUCTED BY CERTIFIED WELDERS IN ACCORDANCE WITH AWS D1.1, LATEST EDITION FOR STRUCTURAL STEEL AND AWS D1.3, LATEST EDITION FOR STRUCTURAL SHEET STEEL.

THE CONTRACTOR SHALL BEAR FULL RESPONSIBILITY FOR PROTECTING EXISTING EQUIPMENT, MATERIALS, BUILDING STRUCTURES, AND BUILDING COMPONENTS DURING ANY FIELD WELDING OPERATIONS.

WELDS OF HEADED STUDS SHALL MATCH STRENGTH OF STUDS.

STEEL JOISTS NOTES: STEEL JOISTS SHALL BE DESIGNED, FABRICATED, AND INSTALLED IN ACCORDANCE WITH STEEL JOIST INSTITUTE (SJI) "STANDARD SPECIFICATIONS LOAD TABLES AND WEIGHT TABLES FOR STEEL JOISTS AND JOIST GIRDERS" LATEST EDITION AND SJI "CODE OF

STEEL JOIST FABRICATOR SHALL SUPPLY AN AFFIDAVIT STATING COMPLIANCE WITH ALL APPLICABLE AISC, SJI AND AISI REQUIREMENTS.

3. STEEL JOIST SUPPLIER MUST BE A MEMBER OF SJI.

STANDARD PRACTICE" LATEST EDITION.

ALL STEEL JOISTS SHALL BE BRACED IN ACCORDANCE WITH SJI. JOIST BRIDGING SHALL BE FURNISHED BY THE JOIST MANUFACTURER.

JOIST LAYOUTS SHOWN ON PLANS ARE CONCEPTUAL, WITH MAXIMUM SPACING AS INDICATED, ACTUAL JOIST LAYOUT SHALL BE PER APPROVED SHOP DRAWINGS.

GEOTECHNICAL NOTES:

SEE THE SITE SPECIFIC GEOTECHNICAL REPORT PREPARED BY TECTONIC DATED SEPT. 21 2023 PROVIDED IN THE CONTRACT

SELECT FILL SHALL BE UTILIZED FOR BACKFILL OF ALL STRUCTURES (UNLESS OTHERWISE NOTED).

OVER-EXCAVATED AREAS BENEATH BUILDING FOUNDATIONS OR SLAB-ON-GRADE FLOORS SHALL BE RE-ESTABLISHED WITH COMPACTED SELECT FILL.

THE CONTRACTOR SHALL SUBMIT DESIRED BACKFILL MATERIAL SPECIFICATION MEETING ALL DESIGN CRITERIA LISTED IN SPECIFICATION 312334 - STRUCTURAL EXCAVATION BACKFILL AND COMPACTION AND PROJECT GEOTECHNICAL REPORT, AT A MINIMUM, TO THE ENGINEER OF RECORD PRIOR TO USE ON SITE. ALTERNATIVELY, THE CONTRACTOR SHALL ELECT TO PERFORM A FIELD PROCTOR OF THE EXISTING SITE SOILS TO VERIFY THAT EXISTING SOILS MEET THE MINIMUM DESIGN VALUES STATED IN SPECIFICATION 312334 - STRUCTURAL EXCAVATION BACKFILL AND COMPACTION AND PROJECT

IN-SITU COMPACTION TESTING OF SUBGRADE AND BACKFILL MATERIAL SHALL BE PERFORMED BY THE OWNERS DESIGNATED SPECIAL INSPECTOR.

CONCRETE SHALL CONFORM TO ACI 211.1, ACI 301, ACI 304R (WHEN PUMPING). AND ACI 318-14. AGGREGATE SHALL CONFORM TO ASTM C33. COMPRESSIVE STRENGTH, RANGE OF SLUMP, WATER-TO-CEMENT RATIO, AND AIR ENTRAINMENT SHALL BE PER THE CONCRETE CLASS SPECIFIED HEREIN AND IN ACCORDANCE WITH CAST-IN-PLACE CONCRETE SPECIFICATION 033000. SUBMIT COPIES OF TEST REPORTS SHOWING THAT THE MIX HAS BEEN SUCCESSFULLY TESTED TO PRODUCE CONCRETE WITH THE PROPERTIES SPECIFIED. TEST REPORTS SHALL BE SUBMITTED TO THE ENGINEER FOR APPROVAL PRIOR TO CONCRETE PLACEMENT.

A. CONCRETE CLASSIFICATIONS PER SPECIFICATION SECTION 033000: FOOTINGS & FROST WALLS: CLASS A ABOVE GRADE WALLS, EXPOSED FOUNDATION WALLS: CLASS B

INTERIOR SLABS-ON-GROUND: CLASS C APRONS, LANDINGS, EQUIPMENT PADS, SIDEWALKS & CURBS: CLASS H

FILL CONCRETE: CLASS G CONCRETE FINISHES PER SPECIFICATION SECTION 033000: FOUNDATIONS BELOW GRADE: AS-CAST SF-2.0 FINISH

EXPOSED FOUNDATION WALLS: GROUT-CLEANED FINISH EXTERIOR SLABS: BROOM FINISH INTERIOR SLABS: FLOAT FINISH

CONCRETE NOTES:

CEMENT SHALL CONFORM TO ASTM C150, TYPE I/II AND SHALL HAVE A CURING PERIOD OF NOT LESS THAN 7 DAYS. CONCRETE SHALL BE WET CURED, USING BURLAP OR COTTON CURING MATS, OR CURED

USING ASTM D4397 POLYETHYLENE SHEETING IN ACCORDANCE WITH ASTM C171. WET

DIRECTLY ON CONCRETE SURFACE. PROVIDE SHEETING NOT LESS THAN 18 INCHES

WIDER THAN CONCRETE SURFACE. OVERLAP EDGES 12 INCHES AND CONTINUOUSLY

THE ENTIRE EXPOSED SURFACE OF THE CONCRETE THOROUGHLY WITH A FINE SPRAY OF

WATER AND COVER WITH SHEETING THROUGHOUT THE CURING PERIOD. LAY SHEETING

TAPE JOINTS. PUMPING SHALL NOT RESULT IN SEPARATION OR LOSS OF MATERIALS NOR CAUSE INTERRUPTIONS SUFFICIENT TO PERMIT LOSS OF PLASTICITY BETWEEN SUCCESSIVE INCREMENTS. LOSS OF SLUMP IN PUMPING EQUIPMENT SHALL NOT EXCEED 2 INCHES. CONCRETE SHALL NOT BE CONVEYED THROUGH PIPE MADE OF ALUMINUM OR ALUMINUM ALLOY. RAPID CHANGES IN PIPE SIZES SHALL BE AVOIDED. MAXIMUM SIZE OF COURSE AGGREGATE SHALL BE LIMITED TO 33 PERCENT OF THE DIAMETER OF THE PIPE. MAXIMUM SIZE OF WELL ROUNDED AGGREGATE SHALL BE LIMITED TO 40 PERCENT OF THE PIPE DIAMETER. SAMPLES FOR TESTING SHALL BE TAKEN AT BOTH THE POINT OF

CONCRETE SHALL NOT BE PLACED WHEN WEATHER CONDITIONS PREVENT PROPER PLACEMENT AND CONSOLIDATION INCLUDING PERIODS OF PRECIPITATION. TRANSPORT CONCRETE AS RAPIDLY AS PRACTICABLE TAKING PRECAUTION TO PREVENT SEGREGATION OR LOSS OF INGREDIENTS. PUMPING IN ACCORDANCE WITH ACI 304 SHALL 5 BE PERMITTED. DO NOT EXCEED A FREE VERTICAL DROP OF 3 FEET FROM THE POINT OF DISCHARGE. PLACE CONCRETE IN ONE CONTINUOUS OPERATIONS FROM ONE SIDE OF SLAB TO THE OTHER. POSITION GRADE STAKES AT 12 FEET ON CENTER MAXIMUM IN EACH DIRECTION.

DELIVERY TO THE PUMP AND AT THE DISCHARGE END.

UNLESS OTHERWISE NOTED, REINFORCEMENT BARS SHALL BE BLACK STEEL. REINFORCING BARS SHALL CONFORM TO ASTM A615 AND SHALL HAVE A MINIMUM YIELD STRENGTH OF 60 KSI. WELDED WIRE FABRIC REINFORCEMENT SHALL CONFORM TO ASTM A1064. REINFORCEMENT SHALL NOT CONTAIN RUST, SCALE, OIL, GREASE, CLAY, OR FOREIGN SUBSTANCES THAT WOULD REDUCE THE CONCRETE BONDING STRENGTH. REMOVE LOOSE RUST PRIOR TO PLACEMENT OF REINFORCEMENT.

REINFORCEMENT SPLICES SHALL BE KEPT TO A PRACTICAL MINIMUM. SEE THE LAP SPLICE TABLE ON THIS SHEET FOR MINIMUM LAP SPLICE LENGTHS.

PROVIDE MINIMUM 2" OF CONCRETE COVER FOR ALL REINFORCING STEEL UNLESS OTHERWISE INDICATED.

CONCRETE FOOTINGS AND MAT FOUNDATIONS SHALL BE PLACED MONOLITHICALLY WITH THE EXCEPTION THAT VERTICAL CONSTRUCTION JOINTS WILL BE ALLOWED IF EPOXY BONDING COMPOUND IS APPLIED TO THE ROUGHENED SURFACE OF THE HARDENED CONCRETE.

INTERIOR SLABS: THE CONTRACTOR SHALL SUBMIT CONTRACTION JOINT LAYOUT PLAN TO ENGINEER FOR REVIEW PRIOR TO INSTALLATION OF SLABS. JOINTS MAY BE SAWCUT OR CUT WITH A JOINTING TOOL. SAWED JOINTS SHALL BE COMPLETED WITHIN 4 TO 12 HOURS AFTER PLACEMENT OF CONCRETE. JOINTS SHALL INTERSECT WITH THE CORNERS OF ISOLATION JOINT AT COLUMN LOCATIONS, IF ANY ARE PRESENT, AND BE SPACED A MAXIMUM OF 16 FEET ON CENTER, UNLESS NOTED OTHERWISE.

REINFORCEMENT SUPPORTS SHALL BE CONCRETE OR OTHER NON-CORRODIBLE MATERIAL HAVING A COMPRESSIVE STRENGTH EQUAL TO OR GREATER THAN THE COMPRESSIVE STRENGTH OF THE CONCRETE BEING PLACED.

PROVIDE A 1/2" ROUNDED EDGE ON ALL EXPOSED SLAB EDGES. PROVIDE A 3/4" CHAMFER ON ALL OTHER EXPOSED CONCRETE CORNERS.

EPOXY BONDING COMPOUND SHALL BE USED ON ALL CONTACTING SURFACES BETWEEN EXISTING CONCRETE AND NEW CONCRETE. EPOXY BONDING COMPOUND SHALL CONFORM TO ASTM C881, TYPE AND GRADE TO BE IN ACCORDANCE WITH APPROPRIATE USE INDICATED IN SPECIFICATION 033000 CAST-IN-PLACE CONCRETE. DO NOT ALLOW COMPOUND TO HARDEN PRIOR TO CONCRETE PLACEMENT.

PLACE, CONSOLIDATE AND IMMEDIATELY STRIKE OFF CONCRETE TO OBTAIN PROPER CONTOUR GRADE AND ELEVATION BEFORE BLEEDWATER APPEARS. PERMIT CONCRETE TO ATTAIN A SET SUFFICIENT FOR FLOATING AND SUPPORTING THE WEIGHT OF THE FINISHER AND EQUIPMENT. IF BLEEDWATER IS PRESENT PRIOR TO FLOATING THE SURFACE, DRAG THE EXCESS WATER OFF OR REMOVE BY ABSORPTION WITH POROUS MATERIALS. DO NOT USE DRY CEMENT TO ABSORB BLEEDWATER.

UNLESS OTHERWISE NOTED, ALL CONCRETE CONSTRUCTION SHALL MEET THE SPECIFIED TOLERANCES OF ACI 117. TOP ELEVATIONS SHALL MATCH THE SPECIFIED ELEVATIONS WITHIN A TOLERANCE OF ±1/4"

THE REQUIREMENTS OF ACI 302.1R CLASS 4 SHALL BE IN EFFECT FOR THE CONSTRUCTION OF ALL FLOORS AND SLABS. THE REQUIREMENTS OF ACI 360.R-10 SHALL BE IN EFFECT FOR THE CONSTRUCTION OF ALL SLABS-ON-GROUND. SLABS UNDER CARPET; $F_F = 25$ AND $F_L = 20$ SLABS WITH THIN-SET, VINYL OR TILE FLOORING; $F_F = 35$ AND $F_L = 25$

GYMNASIUM FLOOR SLAB SHALL MEET THE REQUIREMENTS OF A CLASS 9 FLOOR AND BE TROWELED SMOOTH AND FLAT TO A TOLERANCE OF 1/8" IN A 10' RADIUS NO CONCRETE SHALL BE PLACED UNTIL ALL EMBEDDED ITEMS (I.E. PROCESS, ELECTRICAL, MECHANICAL, ETC) HAVE BEEN SET. CONTRACTOR IS RESPONSIBLE FOR

COORDINATING ALL TRADES. 18. ALL BAR PLACING AND BENDING SHALL BE IN ACCORDANCE WITH ACI 315.

PERFORM COMPRESSIVE TESTS IN ACCORDANCE WITH ASTM C39. OBTAIN ONE COMPOSITE SAMPLE FOR EACH DAY'S POUR OF EACH CONCRETE MIXTURE EXCEEDING 5 CU. YD., BUT LESS THAN 25 CU. YD., PLUS ONE SET FOR EACH ADDITIONAL 50 CU. YD. OR FRACTION THEREOF. TAKE PRECAUTIONS TO PREVENT EVAPORATION AND LOSS OF WATER FROM SPECIMENS. TEST ONE CYLINDER AT 3 DAYS, ONE CYLINDER AT 7 DAYS, AND TWO (THREE FOR 4"x8" CYLINDERS) CYLINDERS AT 28 DAYS AND HOLD ONE IN RESERVE. PERFORM SLUMP TESTS IN ACCORDANCE WITH ASTM C143. PERFORM AIR CONTENT TESTS IN ACCORDANCE WITH ASTM C173 OR ASTM C231. SUBMIT ALL TEST DATA TO THE ENGINEER.

CONSOLIDATE CONCRETE WITH HIGH FREQUENCY, INTERNAL, MECHANICAL VIBRATING EQUIPMENT SUPPLEMENTED BY HAND SPADING AND TAMPING. FURNISH A SPARE VIBRATOR ON THE JOB SITE WHENEVER CONCRETE IS PLACED. OPERATE VIBRATORS WITH VIBRATORY ELEMENT SUBMERGED IN THE CONCRETE, WITH A MINIMUM FREQUENCY OF NOT LESS THAN 6000 IMPULSES PER MINUTE WHEN SUBMERGED. INSERT AND WITHDRAW VIBRATORS AT INTERVALS APPROXIMATELY 18 INCHES APART

ELASTOMERIC JOINT SEALANT SHALL CONFORM TO ASTM C920, TYPE S, GRADE P, CLASS

22. CONTROLLED DENSITY FILL SHALL BE IN ACCORDANCE WITH SPECIFICATION 033110. STRUCTURAL STEEL NOTES:

STRUCTURAL STEEL SYSTEMS INCLUDING MATERIALS, INSTALLATION, WORKMANSHIP FABRICATION, ASSEMBLY, ERECTION, INSPECTION, QUALITY CONTROL, AND TESTING SHALL BE PROVIDED IN ACCORDANCE WITH AISC MANUAL OF STEEL CONSTRUCTION,

LATEST EDITION. ALL STEEL SHALL CONFORM TO THE FOLLOWING UNLESS OTHERWISE NOTED: W SHAPES: ASTM A992, Fy = 50KSI

HSS: ASTM A500 GR. C, Fy = 50KSI PLATES AND OTHER STEEL SHAPES: ASTM A36, Fy = 36KSI

OF NOTCHES. DEPTH AND LENGTH OF COPES SHALL BE AS INDICATED.

ALL HOLES IN STEEL SHALL BE STANDARD SIZE 1/16" LARGER THAN BOLT DIAMETER UNLESS OTHERWISE NOTED. ALL HOLES SHALL BE DRILLED OR PUNCHED. BURNING IS NOT ALLOWED. COLUMN ANCHOR BOLT HOLES MAY BE OVERSIZED. COPES SHALL BE PROVIDED WITH 1/2" RADIUS MINIMUM, SMOOTH CORNERS, AND FREE

UNLESS OTHERWISE NOTED. ALL BOLTS SHALL CONFORM TO ASTM A325. EXCEPT ANCHOR BOLTS SHALL CONFORM TO ASTM F1554. ALL NUTS SHALL CONFORM TO ASTM A563. GRADE AND STYLE FOR APPLICABLE ASTM BOLT STANDARD. ALL WASHERS SHALL CONFORM TO ASTM F436 FOR ASTM A325 BOLTS AND F1554 ANCHOR BOLTS.

UNLESS OTHERWISE NOTED, ALL BOLTS SHALL BE SNUG-TIGHT. BOLTS SPECIFIED AS PRE-TENSIONED (PT) SHALL BE PRE-TENSIONED USING THE TURN-OF-NUT METHOD. CONNECTIONS SPECIFIED AS SLIP-CRITICAL (SC) SHALL HAVE BOLTS PRE-TENSIONED USING THE TURN-OF-NUT METHOD AND FAYING SURFACES PREPARED IN ACCORDANCE WITH THE CLASSIFICATION INDICATED. BOLTS INDICATED TO USE A JAM NUT SHALL BE INSTALLED USING THE FOLLOWING SEQUENCE: A. INSTALL THIN NUT (JAM NUT) FIRST AND TORQUE TO 50% OF TORQUE VALUE INSTALL THICK NUT (STANDARD HEX) SECOND AND TORQUE TO 100% OF TORQUE VALUE WHILE HOLDING THE JAM NUT TO PREVENT ROTATION

STEEL DETAILER SHALL PROVIDE CONNECTION DESIGN IN ACCORDANCE WITH ANSI/AISC 303. DETAILER SHALL SELECT AND COMPLETE CONNECTIONS USING SCHEMATIC DETAILS INDICATED ON PLANS AND ANSI/AISC 360.

UNLESS NOTED OTHERWISE, ALL EXPOSED/EXTERIOR STRUCTURAL STEEL MEMBERS SHALL BE HOT DIPPED GALVANIZED IN ACCORDANCE WITH ASTM A123 AND ALL STRUCTURAL STEEL FASTENERS (INCLUDING NUTS, BOLTS, WASHERS, ETC...) SHALL BE HOT DIPPED GALVANIZED IN ACCORDANCE WITH ASTM A153. REPAIR AREAS OF DAMAGED GALVANIZATION IN ACCORDANCE WITH ASTM A780.

9. UNLESS NOTED OTHERWISE, ALL COLUMNS SHALL BE PROVIDED WITH A 1/2" THICK CAP ALLOWABLE BEARING STRENGTH = 4000 PSF

10. EXTERIOR/INTERIOR STEEL MEMBERS WHICH PENETRATE THE INSULATION ENVELOPE OF THE BUILDING SHALL BE COATED WITH TNEMEC AEROLON SERIES 971 FLUID-APPLIED ACRYLIC INSULATION COATING, OR APPROVED EQUAL. SEE SPEC 072163. APPLY COATING IN ACCORDANCE MANUFACTURERS RECOMMENDED CONSTRUCTION DETAILS AND AS NOTED BELOW: FULLY COAT EXPOSED HSS10X10X1/2 COLUMNS IN GYM.

B. FULLY COAT EXPOSED HSS COLUMNS IN VESTIBULES G100 AND G119.

SPECIAL INSPECTIONS:

ALL SPECIAL INSPECTIONS LISTED ARE IN ADDITION TO ALL INSPECTION REQUIRED BY STATE AND LOCAL BUILDING CODES. ALL SPECIAL INSPECTIONS SHALL BE PERFORMED BY AN AGENCY RETAINED AND PAID BY THE OWNER OR OWNER'S REPRESENTATIVE. THE APPROVED AGENCY SHALL PROVIDE ALL INFORMATION AS NECESSARY FOR THE BUILDING OFFICIAL TO DETERMINE THAT THE AGENCY MEETS THE APPLICABLE REQUIREMENTS. COPIES OF NECESSARY TEST AND INSPECTION RECORDS SHALL BE FILED WITH THE BUILDING OFFICIAL AND REGISTERED DESIGN PROFESSIONAL. ALL SPECIAL INSPECTIONS AND REPORTS SHALL BE IN ACCORDANCE WITH CHAPTER 17 OF THE 2020 NEW YORK STATE BUILDING CODE LATEST REVISION.

CONTRACTOR IS RESPONSIBLE FOR COORDINATION WITH OWNER'S DESIGNATED INSPECTOR FOR SCHEDULING OF ALL SPECIAL INSPECTIONS. CONTRACTOR SHALL NOTIFY INSPECTOR

SPECIAL INSPECTIONS REQUIRED INCLUDE BUT ARE NOT LIMITED TO:

INSTALLATION OF OPEN-WEB STEEL JOISTS AND JOIST GIRDERS

PERIODIC INSPECTION OF REINFORCING STEEL.

PERIODIC INSPECTION OF ANCHORS CAST IN CONCRETE

INSPECTION OF ANCHORS POST-INSTALLED IN HARDENED CONCRETE.

PERFORM SLUMP, AIR, AND TEMPERATURE TESTS: CONTINUOUS.

PERIODIC INSPECTION OF ERECTION OF PRECAST CONCRETE MEMBERS.

STRUCTURAL STEEL:

CONCRETE

AISC 360-16.

COLD-FORMED STEEL DECK:

DEFINED IN 3.1

TECHNIQUES.

AND TMS 602.

PERIODIC VERIFICATION OF DESIGN MIX.

CONCRETE MEMBER BEING FORMED.

CONTINUOUS INSPECTION OF

DENSITIES

PERIODIC INSPECTION OF

MATERIAL

NYSBC 2020 STRUCTURAL PROVISIONS:

FIRST FLOOR CORRIDOR AND COMMON AREAS: 100 PSF

DISTRIBUTED LOAD = 20 PSF (SNOW LOAD GOVERNS)

ACCORDANCE WITH NYSBC 2020

CONCENTRATED LOAD = 300 LBS

GROUND SNOW LOAD (P/g) = 30 PSF

FLAT ROOF SNOW LOAD (P/f) = 22 PSF

SNOW EXPOSURE FACTOR (C/e) = 0.9

SNOW IMPORTANCE FACTOR (I) = 1.10

THERMAL FACTOR (C/t) = 1.0

DRIFT SURCHARGE (P/d) = 66.7 PSF

SLOPE FACTOR (C/s) = 1.0

WIDTH OF DRIFT (w) = 14.9 FT

BASIC WIND SPEED = 120 MPH

TOPOGRAPHIC FACTOR = Kzt=1.0

9.35/-21.093

9.35/-36.757

9.35/-48.416

9.35/-66.038

23.051/-25.009

23.051/-30.883

9.35/-21.093

9.35/-36.757

9.35/-48.416

9.35/-66.038

23.051/-25.009

23.051/-30.883

WIND EXPOSURE = B

GUST FACTOR = 0.85

BUILDING CATEGORY = RISK CATEGORY III

WIND DIRECTIONALITY FACTOR = Kd=0.85

ENCLOSURE CLASSIFICATION = ENCLOSED

APPLICABLE. INTERNAL PRESSURE COEFF. = ±0.18

<u> COMPONENTS & CLADDING PRESSURE - HIGH ROOF</u>

8.00/-16.688

8.00/-27.104

8.00/-35.728

8.00/-47.152

7.360/-22.736

8.00/-16.688

8.00/-27.104

8.00/-35.728

8.00/-47.152

FROM THE PROJECTED SURFACE, RESPECTIVELY.

SPECTRAL RESPONSE PARAMETERS: S_{DS} = 0.244 AND S_{D1} = 0.089

ANALYSIS PROCEDURE = EQUIVALENT LATERAL FORCE METHOD

SERVICE BY MULTIPLYING BY 0.6

HIGH ROOF: a = 7.7 FT.

B. LOW ROOFS: a = 3.0 FT

SEISMIC RESPONSE COEFFICIENT: C/S = 0.1517

RESPONSE MODIFICATION COEFFICIENT: R = 2

OCCUPANCY RISK CATEGORY = III

SEISMIC DESIGN CATEGORY = B

DESIGN BASE SHEAR = 213.5 KIPS

GEOTECHNICAL DESIGN DATA:

SEISMIC IMPORTANCE FACTOR = 1.25

EISMIC DESIGN DATA:

SITE CLASS = D

WIDTH OF PRESSURE COEFFICIENT ZONE

7.360/-18.928

17.360/-22.736 | 16.240/-20.496

PLUS AND MINUS SIGNS SIGNIFY PRESSURES ACTING TOWARD AND AWAY

WIND PRESSURES SHOWN ARE ULTIMATE AND CAN BE CONVERTED TO

JOIST NET UPLIFT LOAD COMBINATION IS 0.6D+0.6W. "D" = 14 PSF

MAPPED SPECTRAL RESPONSE ACCELERATIONS: S_{MS} = 0.366 AND S_{M1} = 0.0134

BASIC SEISMIC FORCE RESIST. SYS. = A.10 INTERMEDIATE REINFORCED MASONRY SHEAR WALLS

EOTECHNICAL EVALUATION REPORT PREPARED BY TECTONIC ENGINEERING DATED OCT. 9.

<u> OMPONENTS & CLADDING PRESSURE - LOW ROOFS:</u>

SLAB ON GRADE: N/A

ROOF LIVE LOAD:

COMPLIANCE.

PROPER MATERIALS

LIFT THICKNESS DURING PLACEMENT

COMPACTION OF CONTROLLED FILL

MINIMUM 24 HOURS PRIOR TO NEED OF INSPECTION. THE OWNER RESERVES THE RIGHT TO BACK CHARGE THE CONTRACTOR FOR ANY COSTS ASSOCIATED WITH ADDITIONAL SPECIAL INSPECTIONS REQUIRED DUE TO CANCELLATION OF SCHEDULED INSPECTIONS AND RE-INSPECTION OF PREVIOUSLY FAILED INSPECTIONS.

ELEMENTS IN BUILDINGS, STRUCTURES AND PORTIONS THEREOF SHALL BE IN

SPECIAL INSPECTIONS AND QUALIFICATION OF WELDING SPECIAL INSPECTORS

WITH THE QUALITY ASSURANCE INSPECTION REQUIREMENTS OF SDI QA/QC.

A. 3.1. PERIODIC SPECIAL INSPECTION OF END CONNECTIONS - WELDED OR

B. 3.2. PERIODIC SPECIAL INSPECTION OF BRIDGING - HORIZONTAL OR DIAGONAL

CONTINUOUS INSPECTION OF ADHESIVE ANCHORS INSTALLED IN HORIZONTALLY

PRIOR TO CONCRETE PLACEMENT, FABRICATE SPECIMENS FOR STRENGTH TESTS,

CONTINUOUS INSPECTION OF PLACEMENT & FOR PROPER APPLICATION TECHNIQUES.

PERIODIC INSPECTION FOR MAINTENANCE OF SPECIFIED CURING TEMPERATURE AND

PERIODIC INSPECTION OF FORMWORK FOR SHAPE, LOCATION AND DIMENSIONS, OF THE

SPECIAL INSPECTIONS AND TESTS OF MASONRY CONSTRUCTION SHALL BE PERFORMED

IN ACCORDANCE WITH THE QUALITY ASSURANCE PROGRAM REQUIREMENTS OF TMS 402

MATERIALS BELOW FOOTINGS ADEQUATE TO ACHIEVE THE DESIGN BEARING

CLASSIFICATION AND TESTING OF CONTROLLED FILL MATERIALS

THE APPROVED SOILS REPORT, IF ANY EXISTS, SHALL BE USED TO DETERMINE

WIND PRESSURES (PSF)

ZONE | < 10 SQ. FT. | < 20 SQ. FT. | < 50 SQ. FT. | < 100 SQ. FT. | < 500 SQ. FT.

7.360/-18.928 | 16.240/-17.808

WIND PRESSURES (PSF)

ZONE | <10 SQ. FT. | <20 SQ. FT. | <50 SQ. FT. | <100 SQ. FT. | <500 SQ. FT.

8.00/-16.688

8.00/-24.528

8.00/-32.480

8.00/-40.656

16.240/-20.496

8.00/-16.688

8.00/-24.528

8.00/-32.480

8.00/-40.656

16.240/-17.808

8.00/-22.624

8.00/-30.016

8.00/-35.728

16/-17.024

16/-18.928

8.00/-22.624

8.00/-30.016

8.00/-35.728

16/-17.024

16/-18.928

8.00/-22.624

8.00/-30.016

8.00/-35.728

16/-17.024

16/-18.928

8.00/-16.688

8.00/-22.624

8.00/-30.016

8.00/-35.728

16/-17.024

16/-18.928

SUBGRADE PRIOR TO PLACEMENT OF COMPACTED FILL

THE STRUCTURE SHOWN HEREON HAS/SHALL BE DESIGNED FOR THE FOLLOWING IN

EXCAVATIONS ARE EXTENDED TO PROPER DEPTH AND HAVE REACHED PROPER

OR UPWARDLY INCLINED ORIENTATIONS TO RESIST SUSTAINED TENSION LOADS.

PERIODIC INSPECTION OF MECHANICAL ANCHORS AND ADHESIVE ANCHORS NO

FOR COLD-FORMED STEEL FLOOR AND ROOF DECK SHALL BE IN ACCORDANCE

SPECIAL INSPECTIONS AND NONDESTRUCTIVE TESTING OF STRUCTURAL STEEL ACCORDANCE WITH THE QUALITY ASSURANCE INSPECTION REQUIREMENTS OF

KG+D . ARCHITECTS PC 285 MAIN STREET MOUNT KISCO . NEW YORK . 10549 P:914.666.5900

ORANGE-ULSTER BOCES

ARDEN HILL -

MAIN BUILDING

ADDITIONS AND

4 HARRIMAN DRIVE

GOSHEN, NY 10924

NY SED PROJECT CONTROL NO.# 44-90-00-00-0-035-010

ISSUED FOR BID

KEY PLAN TE: ALL IDEAS DESIGNS ARRANGEMENTS AND PLANS INDICATED OR ESENTED BY THIS DRAWING ARE OWNED BY AND ARE THE PROPERTY 'ER, GARMENT, & DAVIDSON ARCHITECTS, PC (KG&D), AND WERE CREATE R USE ON THIS PROJECT, NONE OF SUCH IDEAS, DESIGNS, ARRANGEMEN PLANS SHALL BE USED BY OR DISCLOSED TO ANY PURPOSE WHATSOEVE HOUT THE WRITTEN PERMISSION OF (KG&D).

ALED DIMENSIONS, CONTRACTOR SHALL VERIFY ALL ACTUAL DIMENSIONS D CONDITIONS ON THE JOB AND THE ARCHITECT MUST BE NOTIFIED OF AN SUBMITTED TO THIS OFFICE FOR APPROVAL BEFORE PROCEEDING WITH

ERATIONS BY ANY PERSON. IN ANY WAY, OF ANY ITEM CONTAINED ON THIS UMENT, UNLESS ACTING UNDER THE DIRECTION OF THE LICENCED HITECT WHOSE PROFESSIONAL SEAL IS AFFIXED HERETO, IS A VIOLATION TITLE VII, SECT. 69.5 (b) OF NEW YORK STATE LAW. RIGHT KAEYER, GARMENT + DAVIDSON ARCHITECTS & ENGINEERS, PO RIGHTS RESERVED.

Professional Seal

2 | 01/09/2025 | ISSUED FOR BID 1/26/2024 | SED SUBMISSION

STRUCTURAL NOTES

44-90-00-00-0-035-010 01/26/2024 Drawn / Checked WRB/JB WRB

Sheet Number

TYPICAL LAP SPLICE - CONCRETE


	CONCRETE LAP SPLICES					
	BAR .	LENGTH, IN. (U.N.O.)				
		F'c = 3000 PSI	F'c = 3500 PSI	F'c = 4000 PS		
	#3	13	12	12		
	#4	18	16	15		
	#5	22	20	19		
	#6	26	24	23		
	#7	41	38	36		
	40	E4	50	47		


TYPICAL LAP SPLICE - MASONRY

MASONRY LAP SPLICES				
BAR		LENGTH, IN. (U.N.O.)		
<u>-</u>	F'm = 1500 PSI	F'm = 2000 PSI	F'm = 2500 PSI	
#3	16	15	15	
#4	27	24	21	
#5	33	30	27	
#6	40	36	33	
#7	54	48	42	
#8	59	51	46	

WHEN TWO BAR SIZES ARE SPLICED, USE LAP LENGTH OF SMALLER BAR.


	MASONRY L	AP SPLICES			
BAR		LENGTH, IN. (U.N.O.)			
	F'm = 1500 PSI	F'm = 2000 PSI	F'm = 2500 PSI		
#3	16	15	15		
#4	27	24	21		
#5	33	30	27		
#6	40	36	33		
#7	54	48	42		
#8	59	51	46		

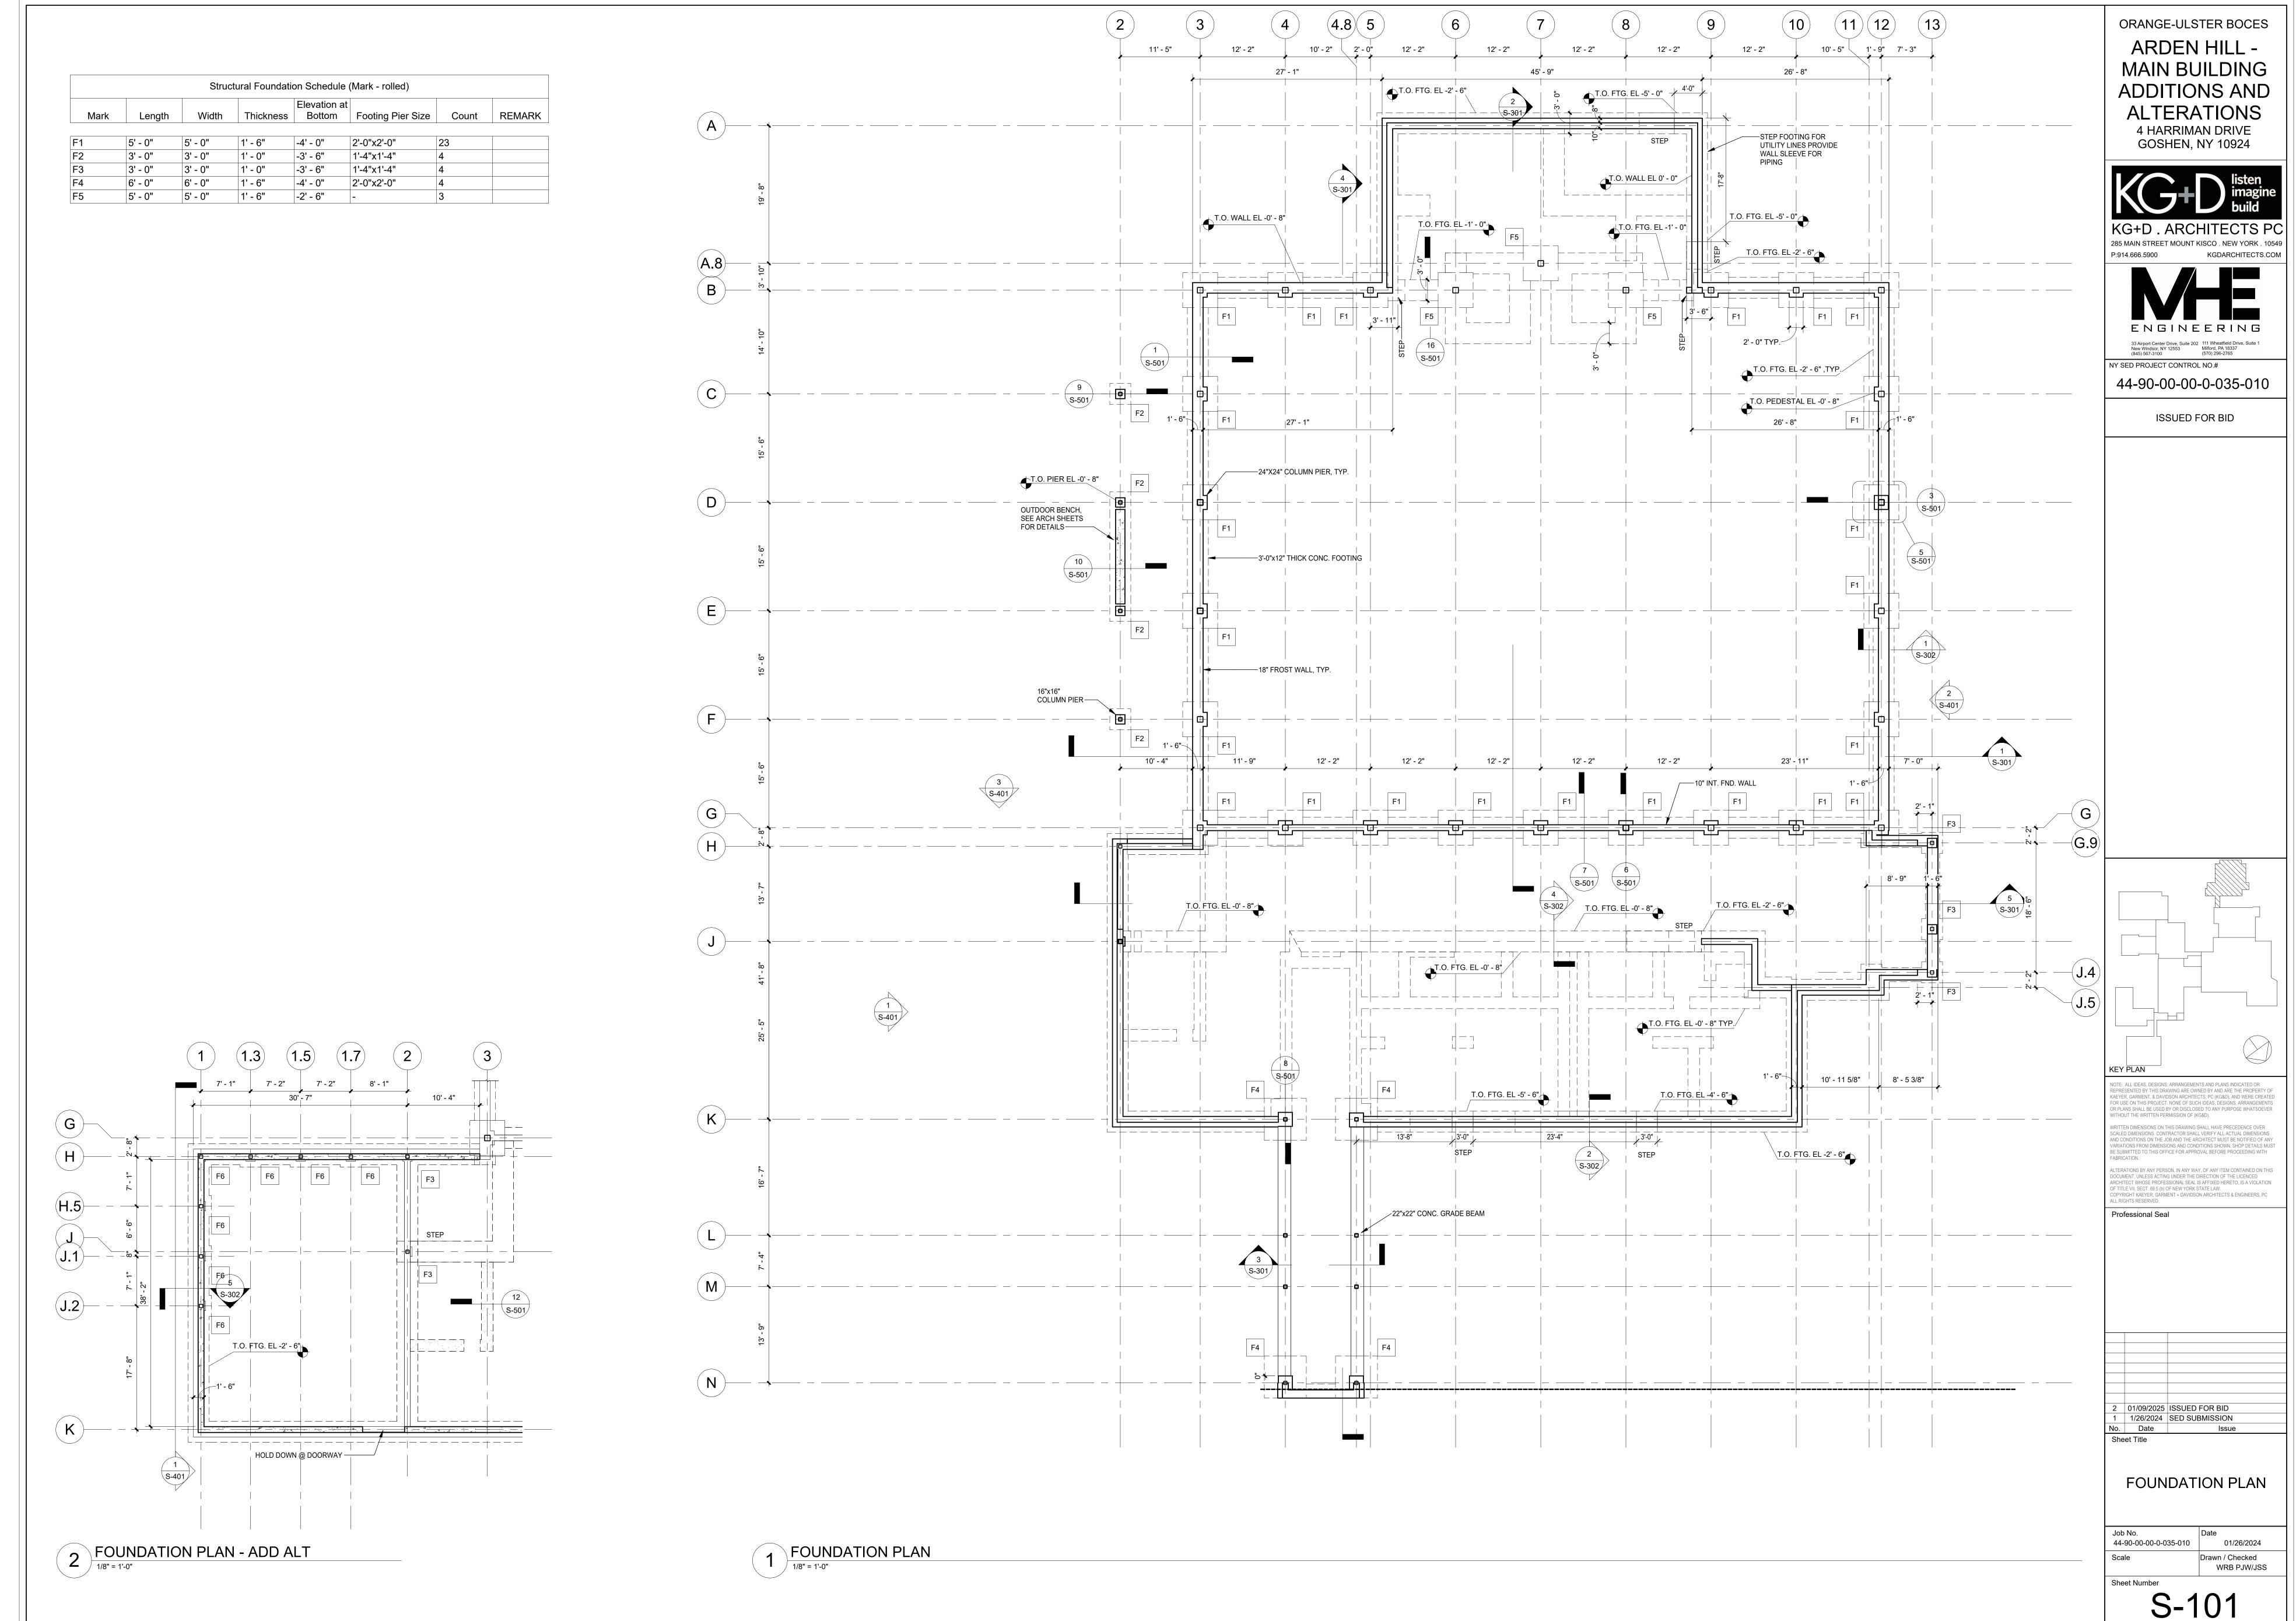


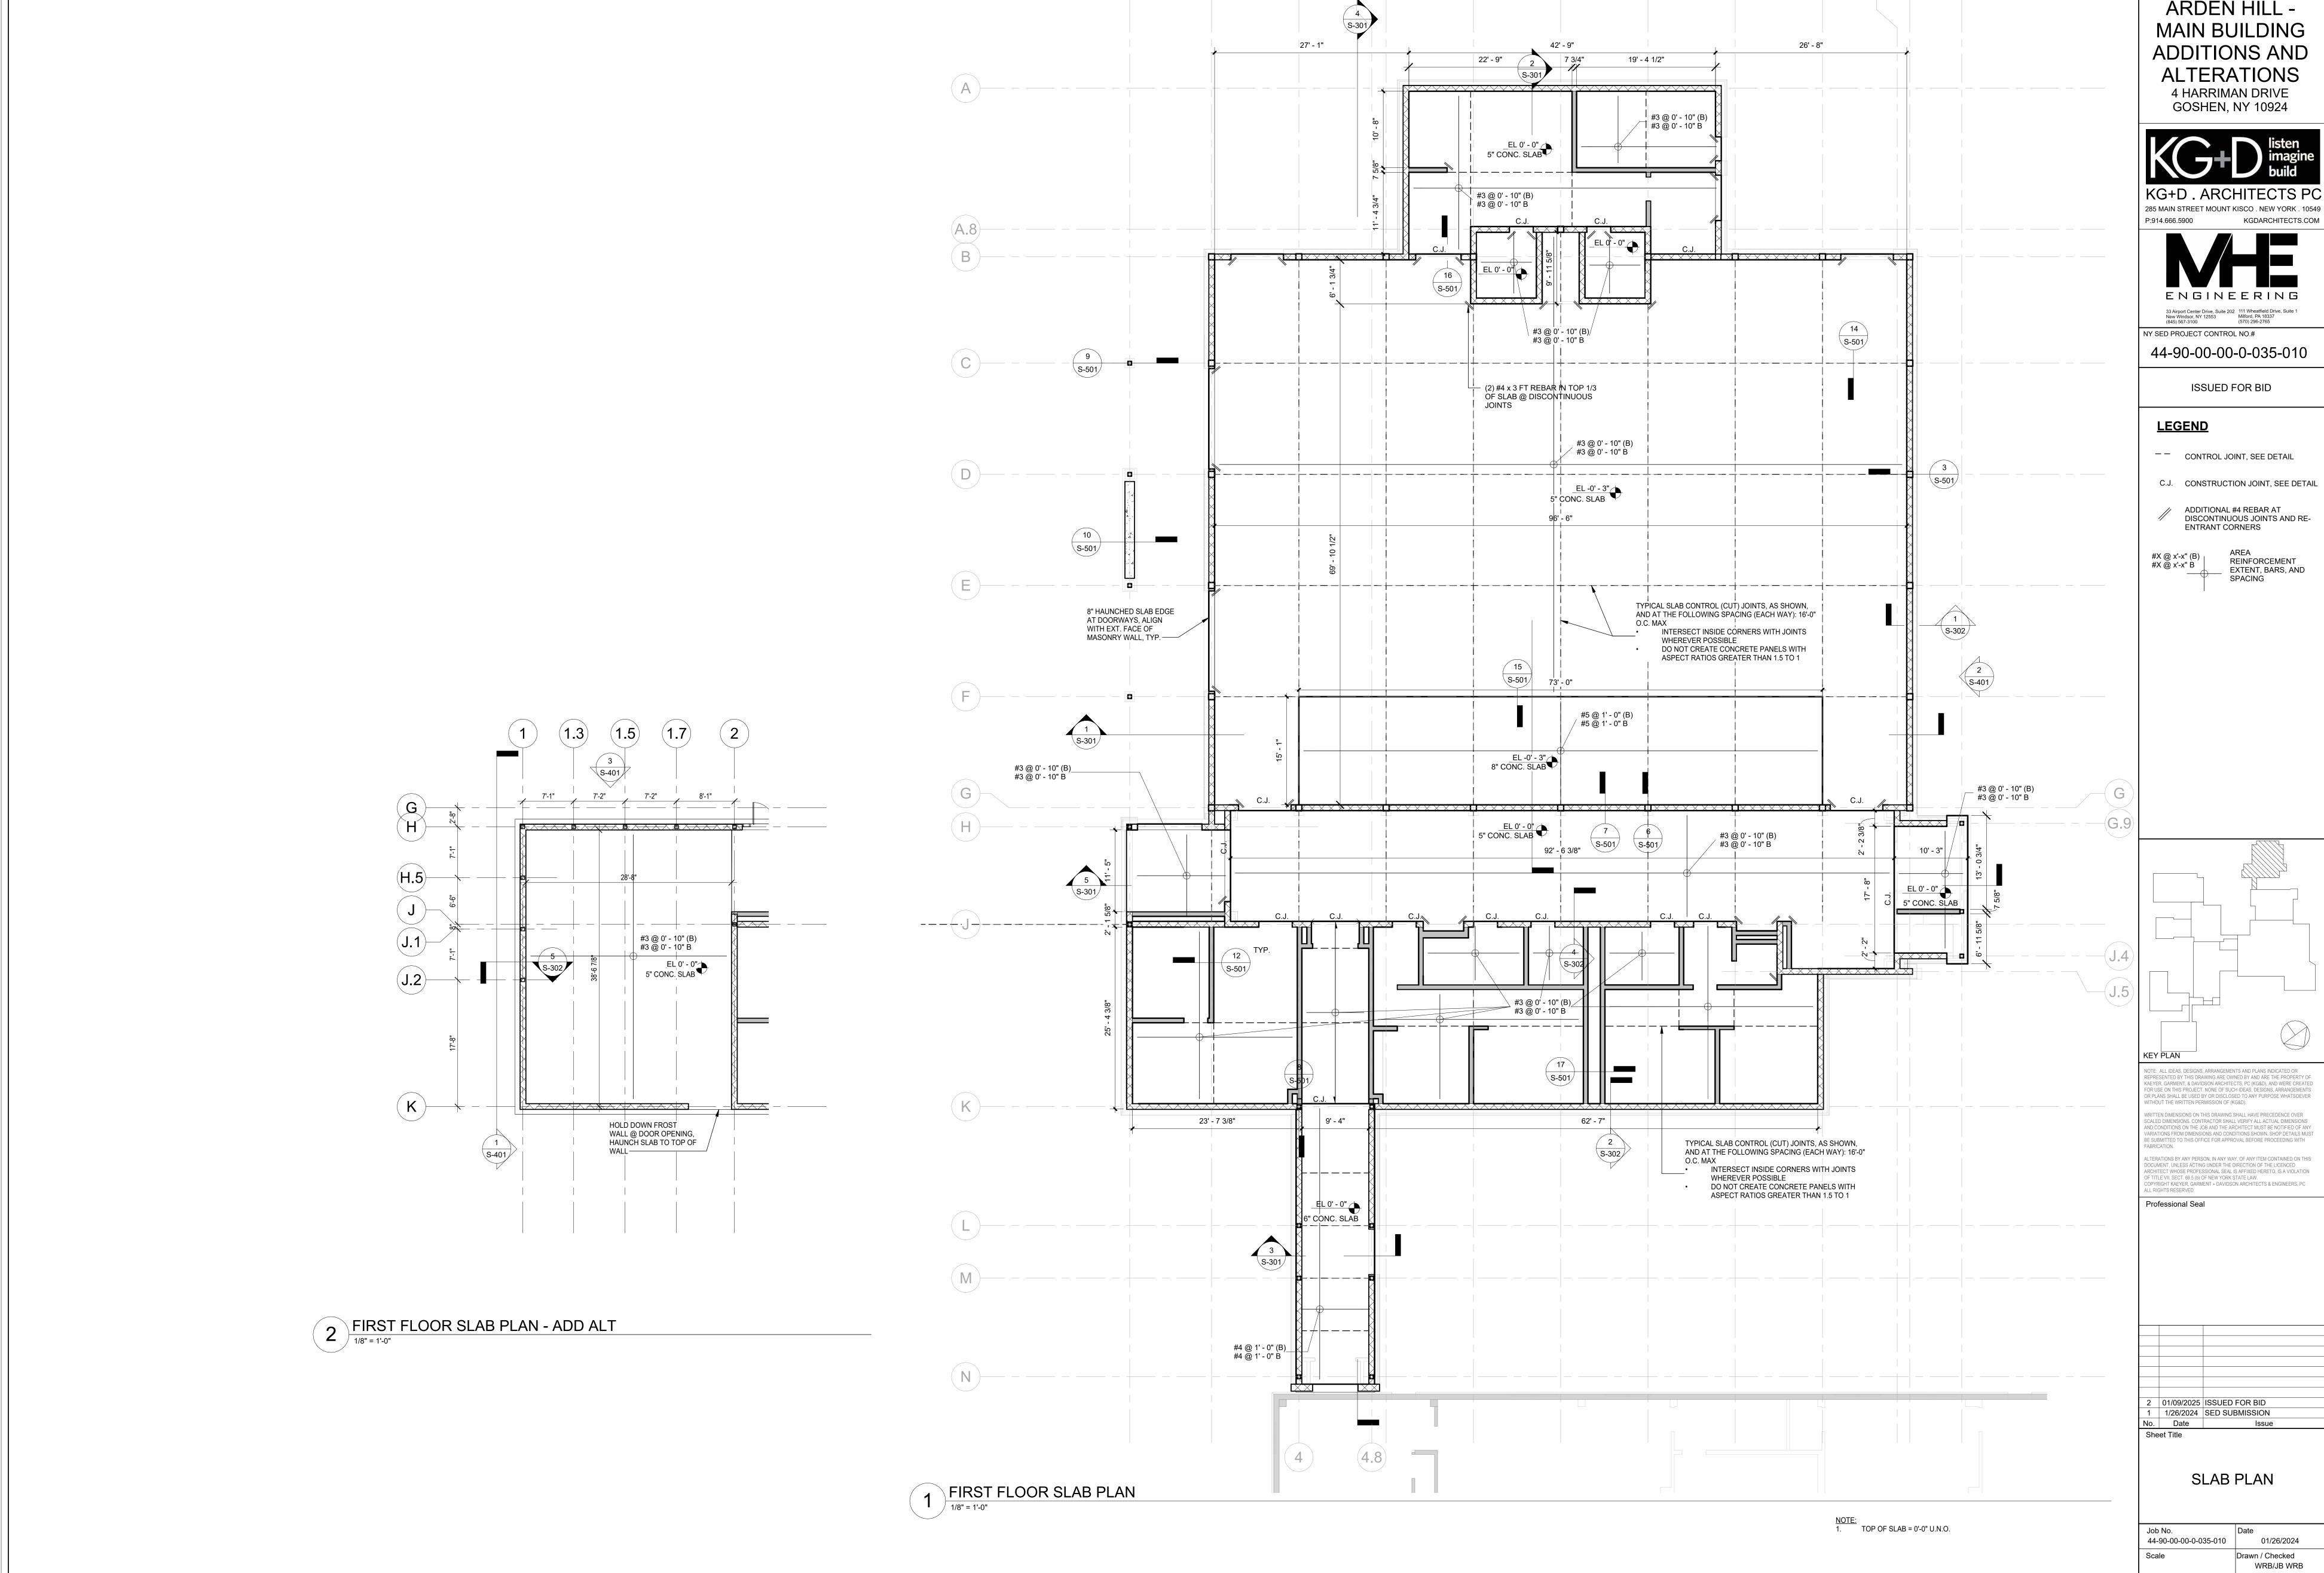



ORANGE-ULSTER BOCES ARDEN HILL -

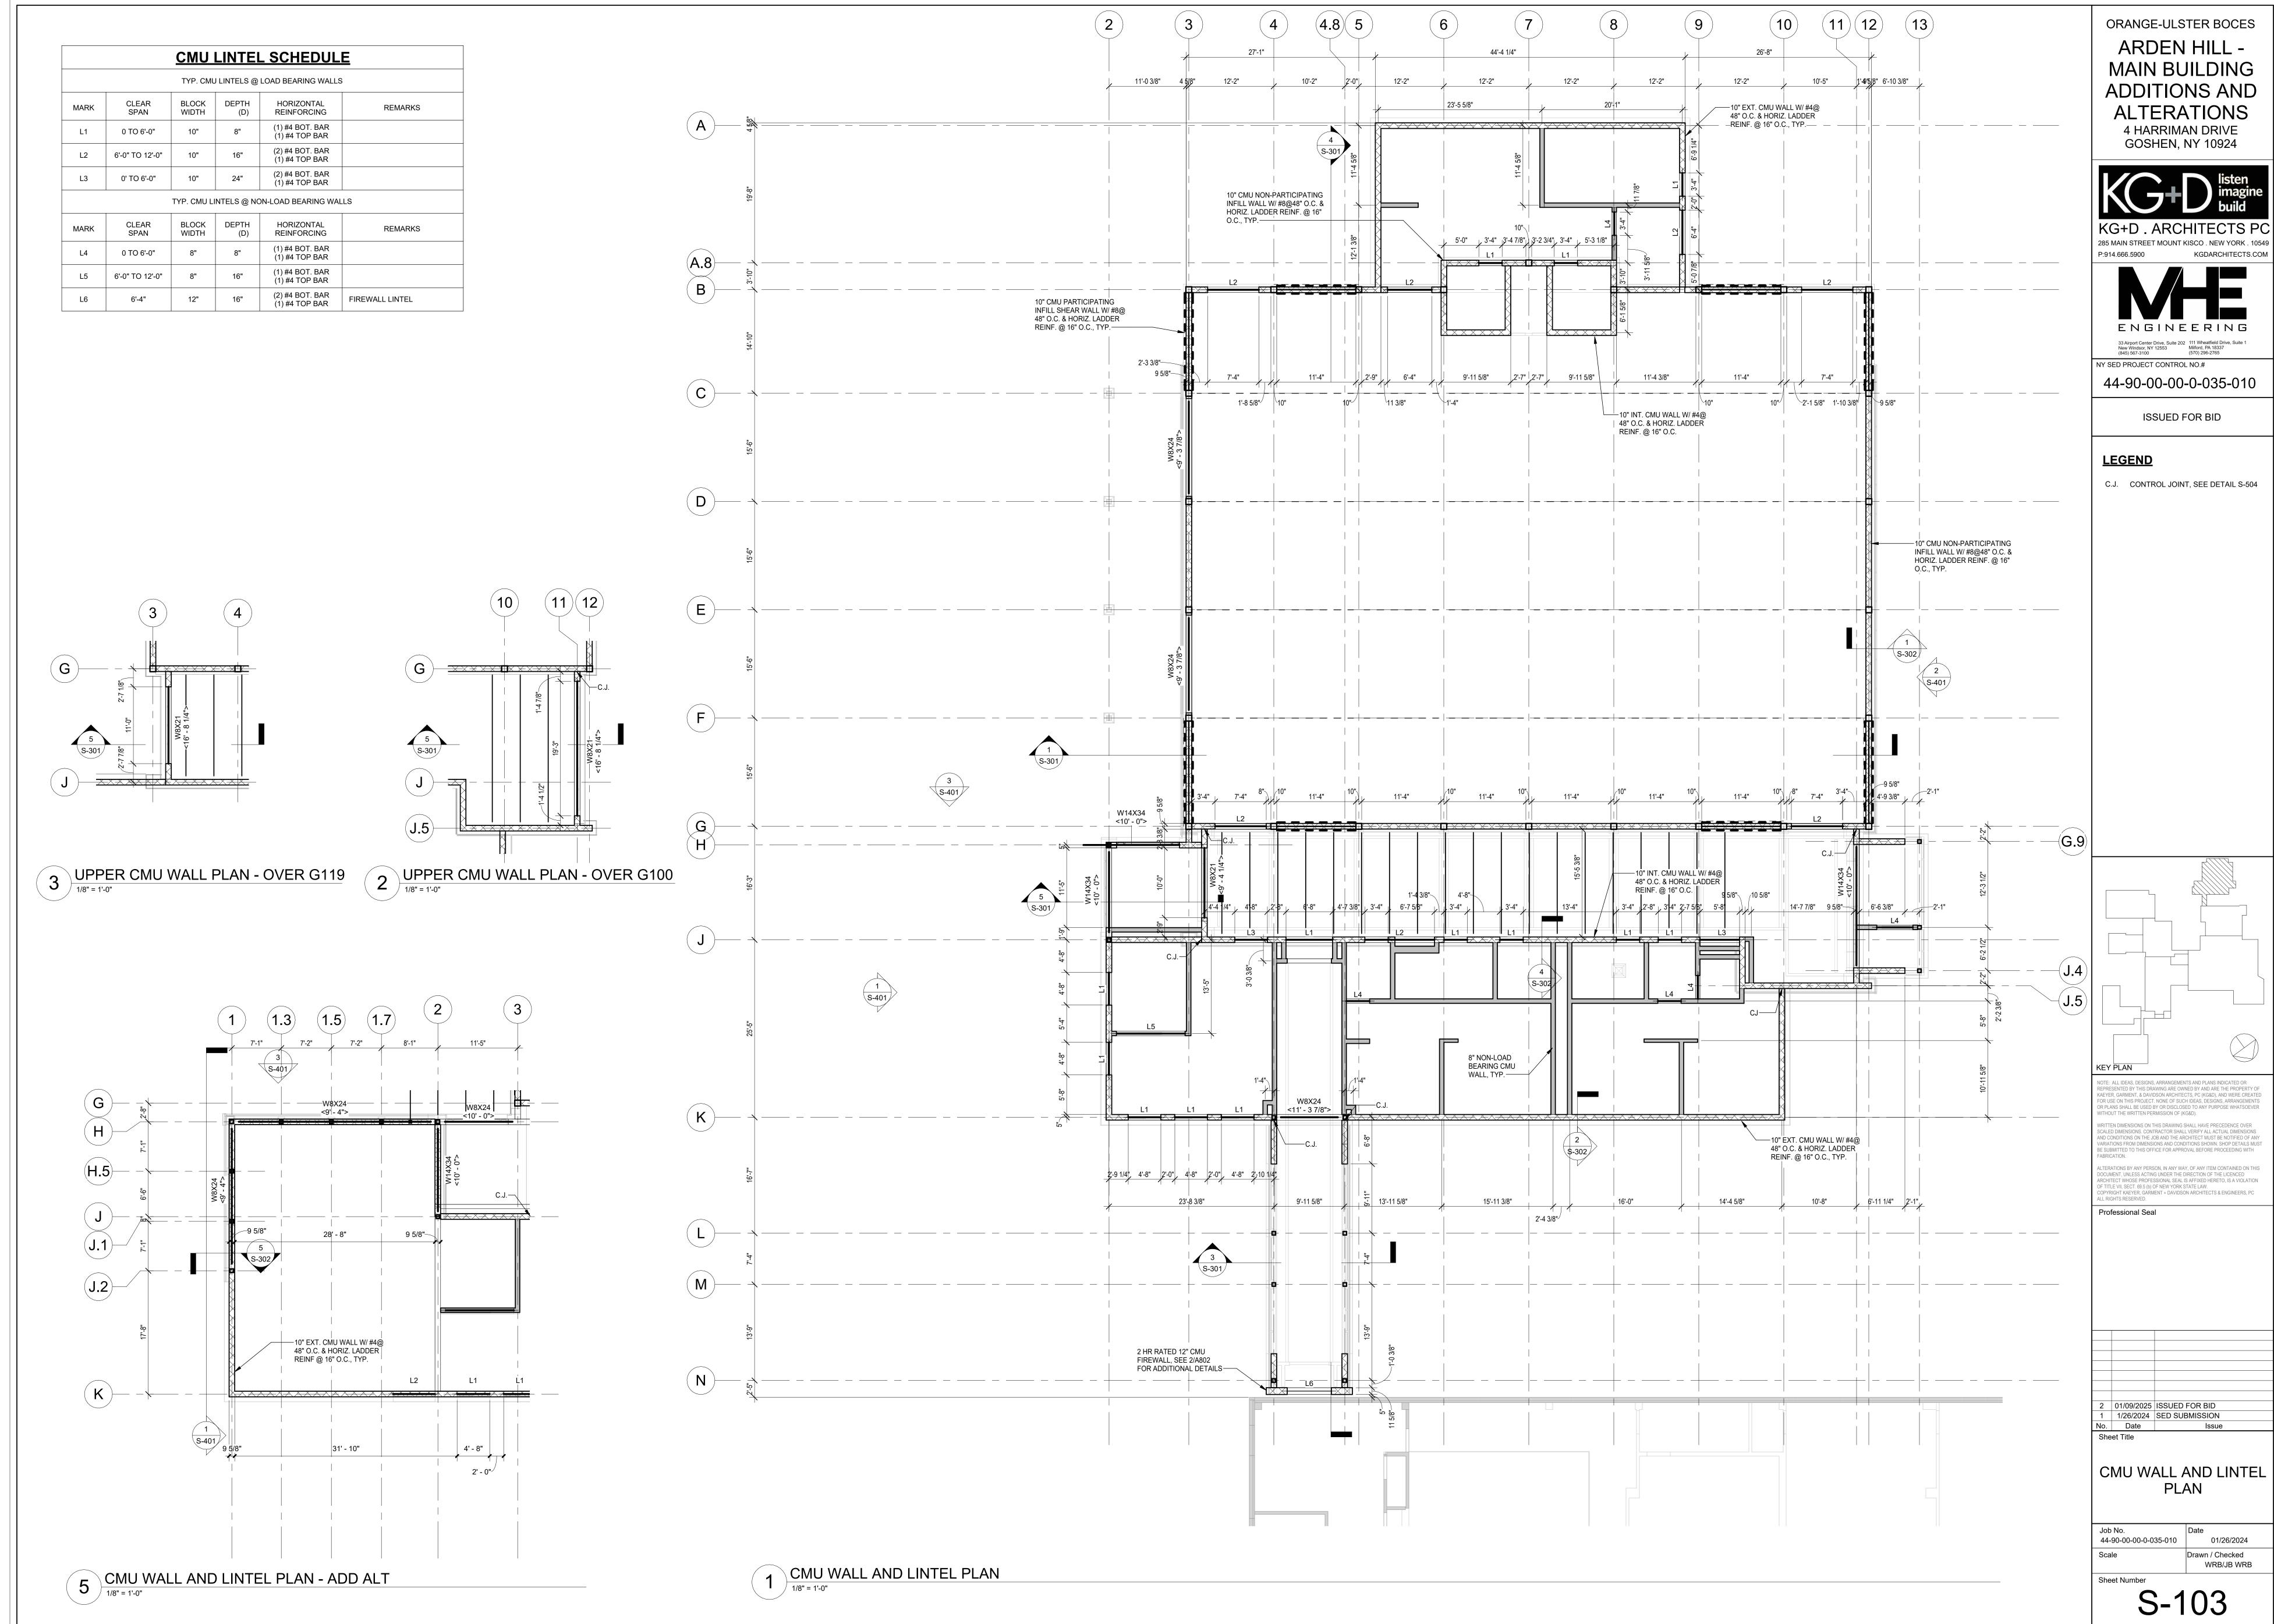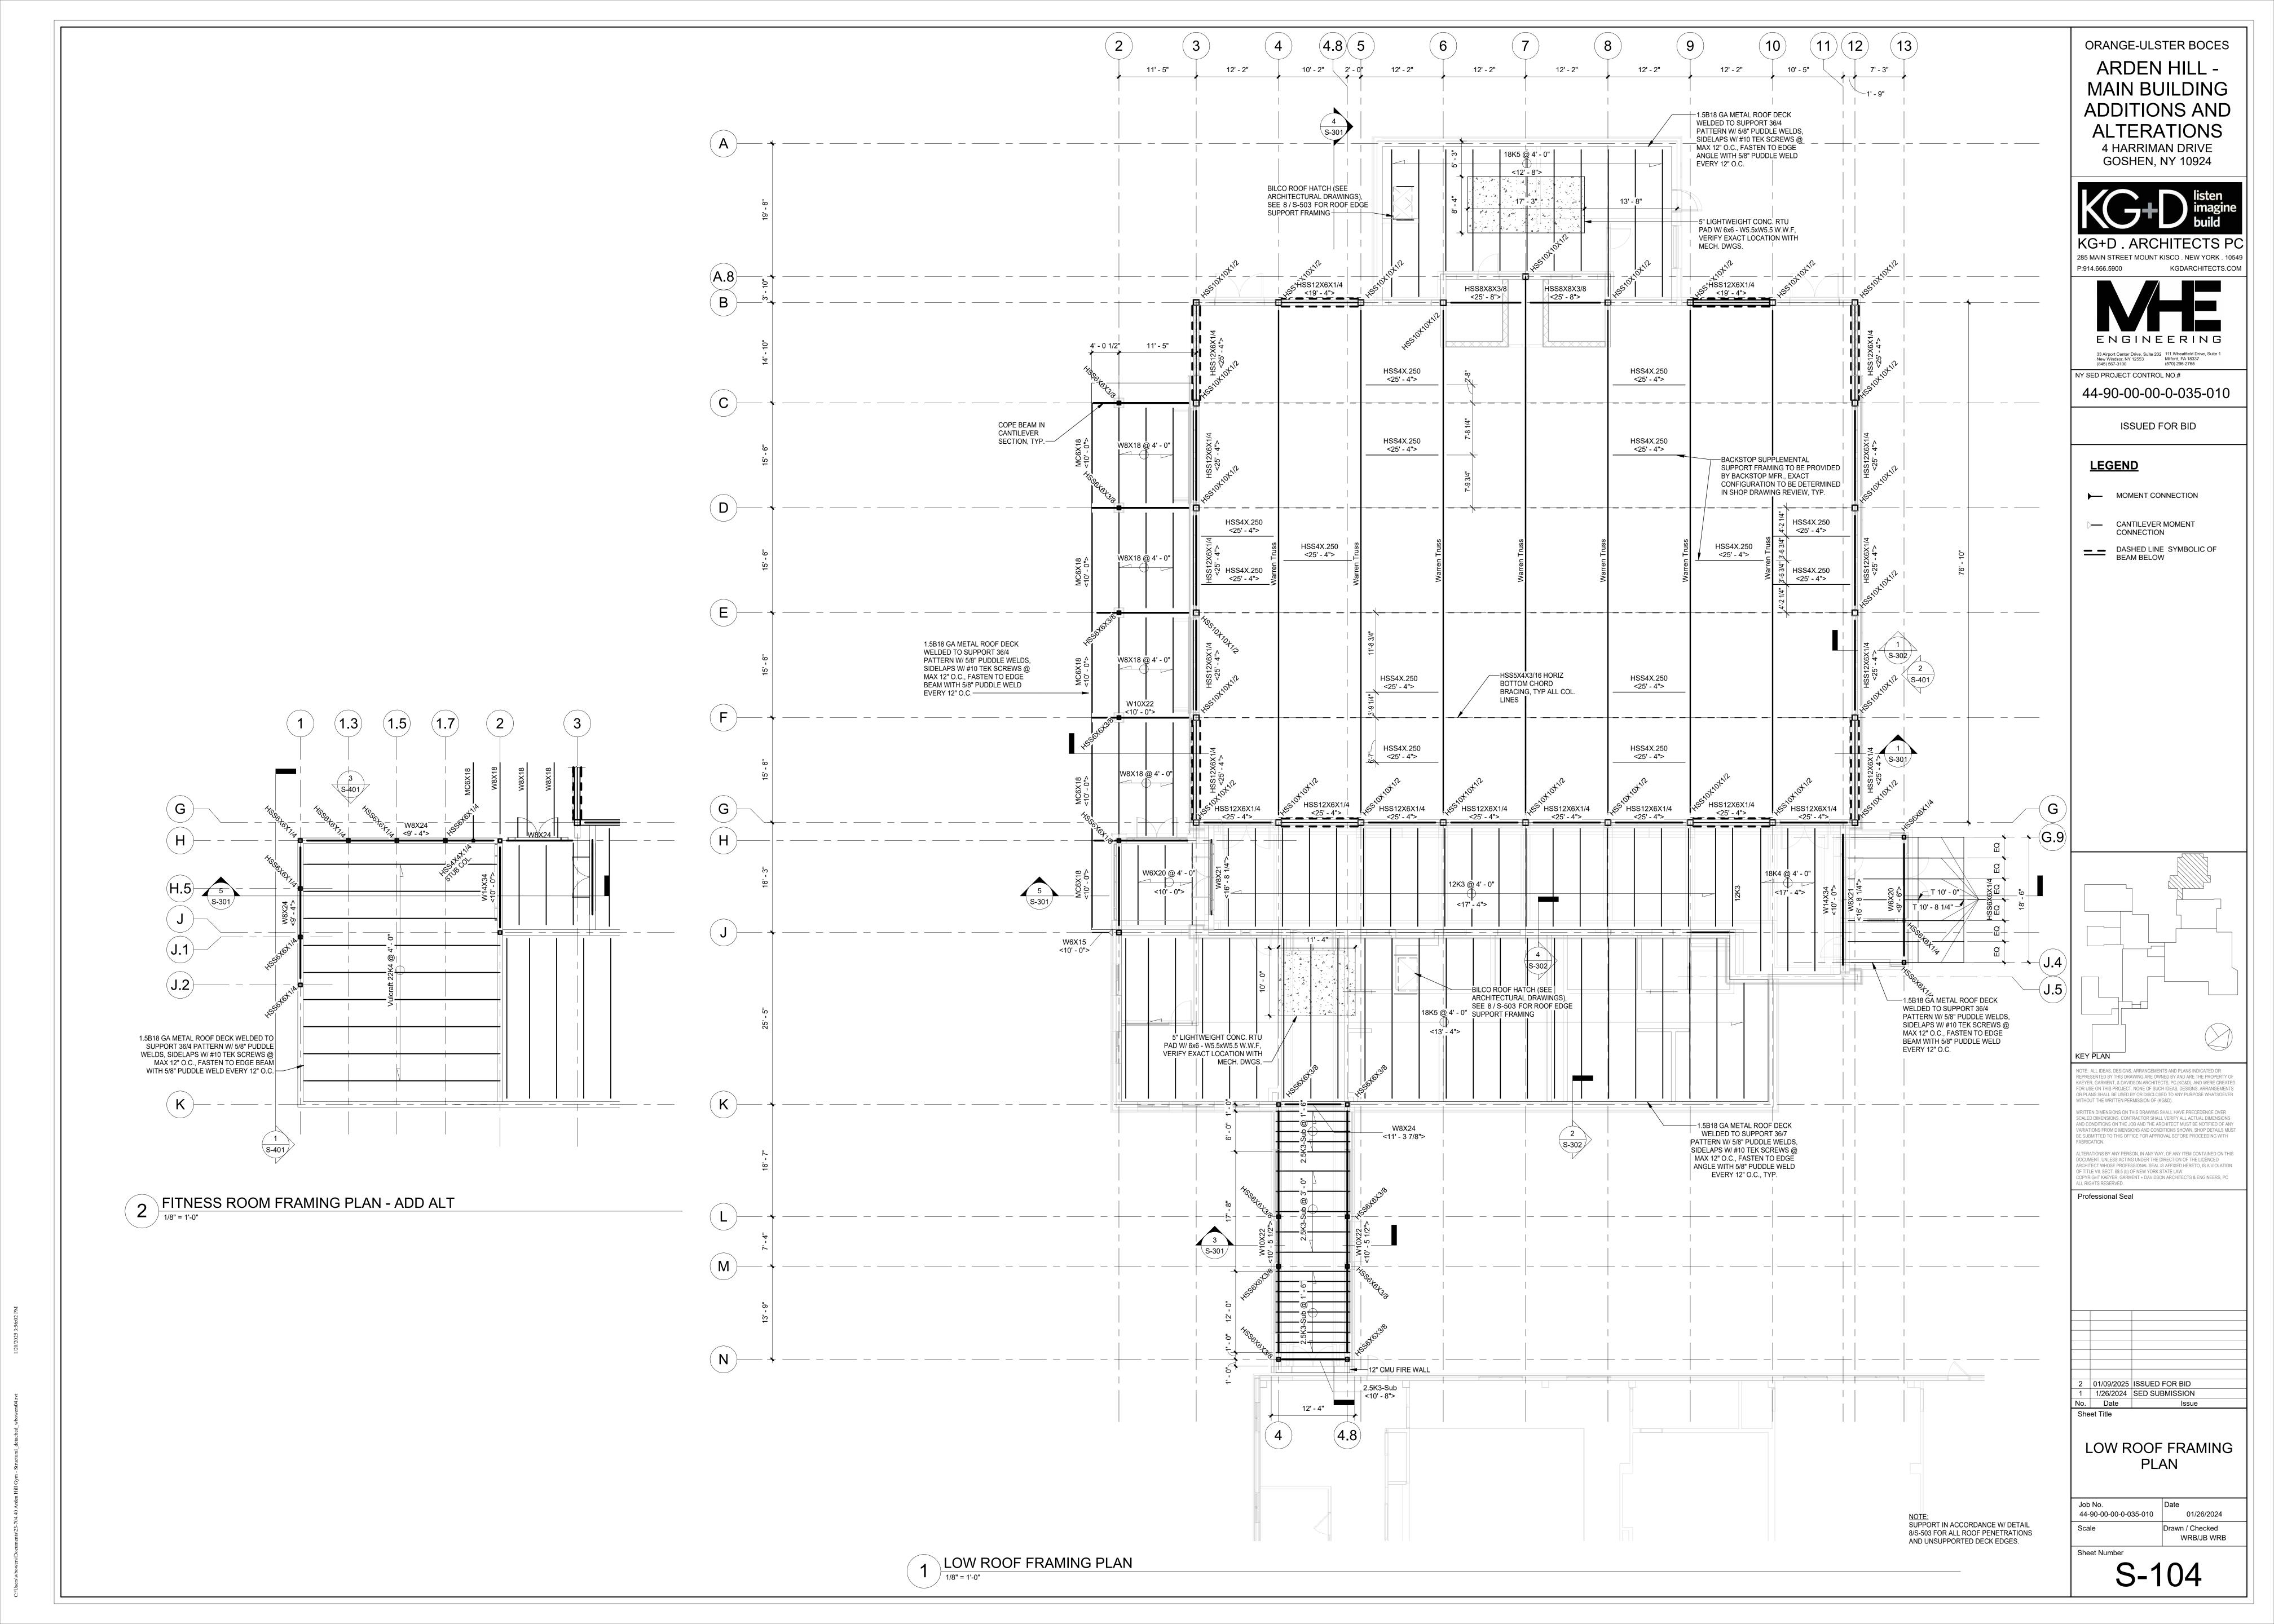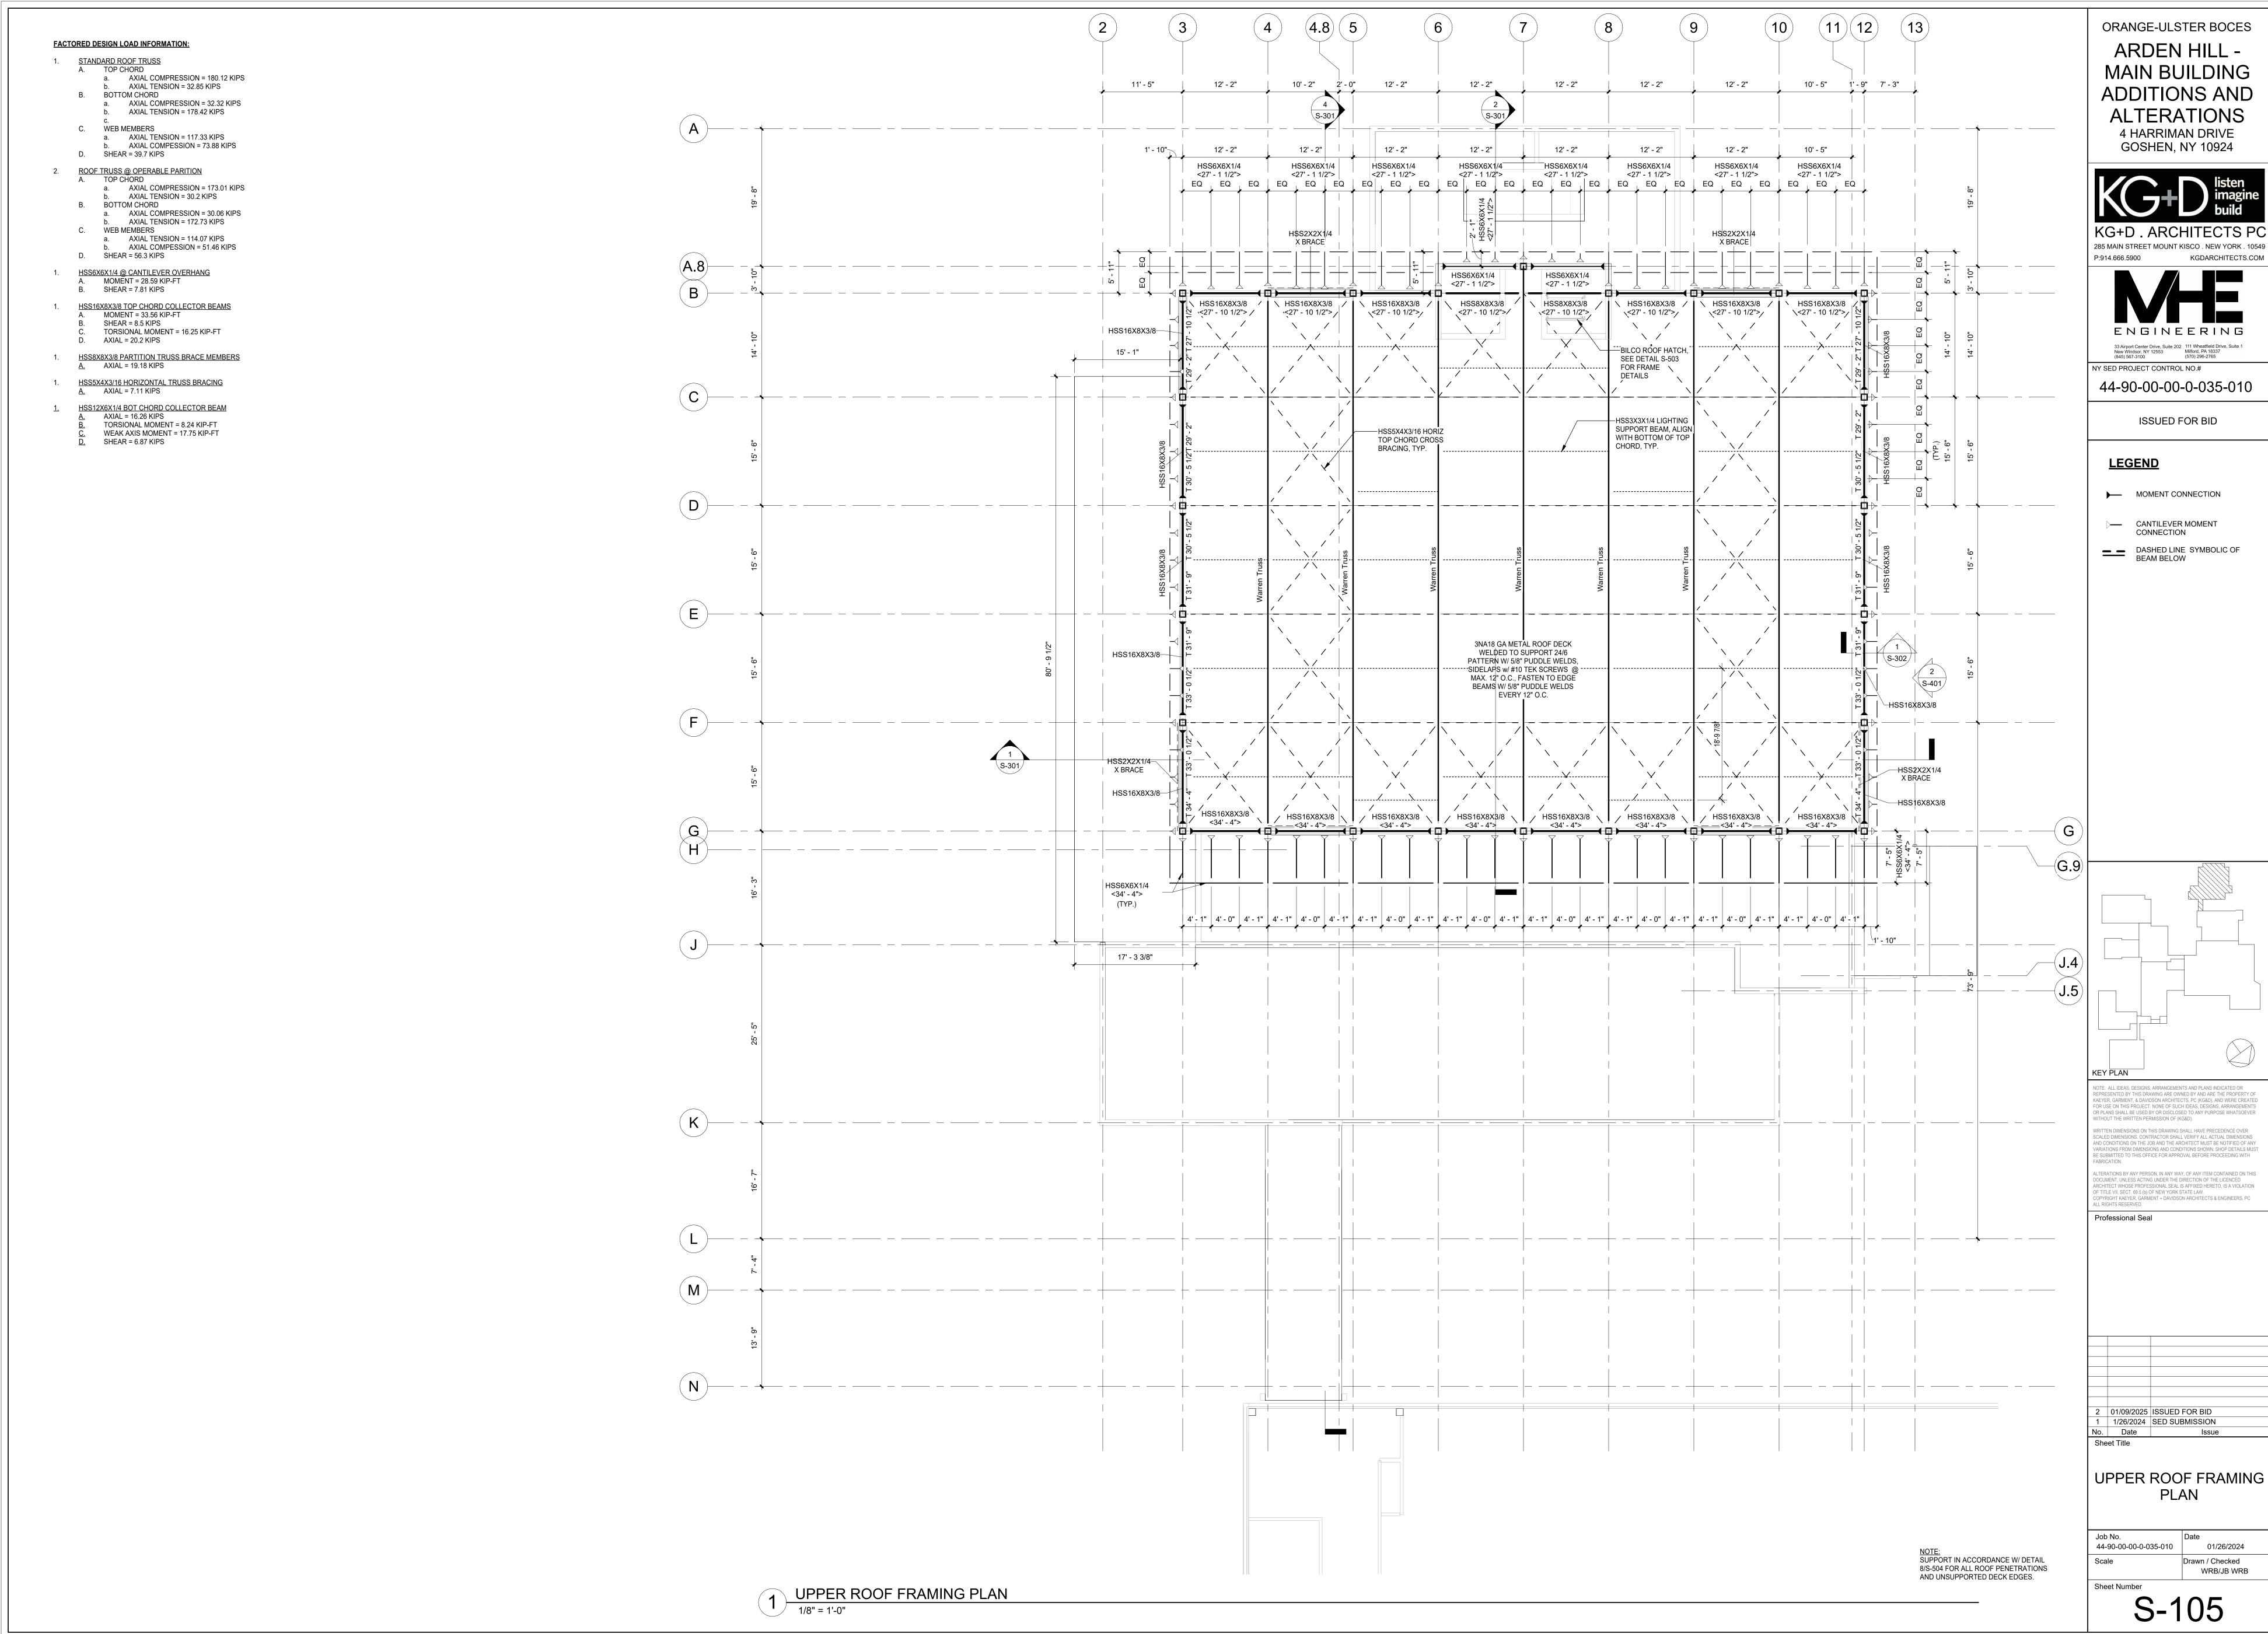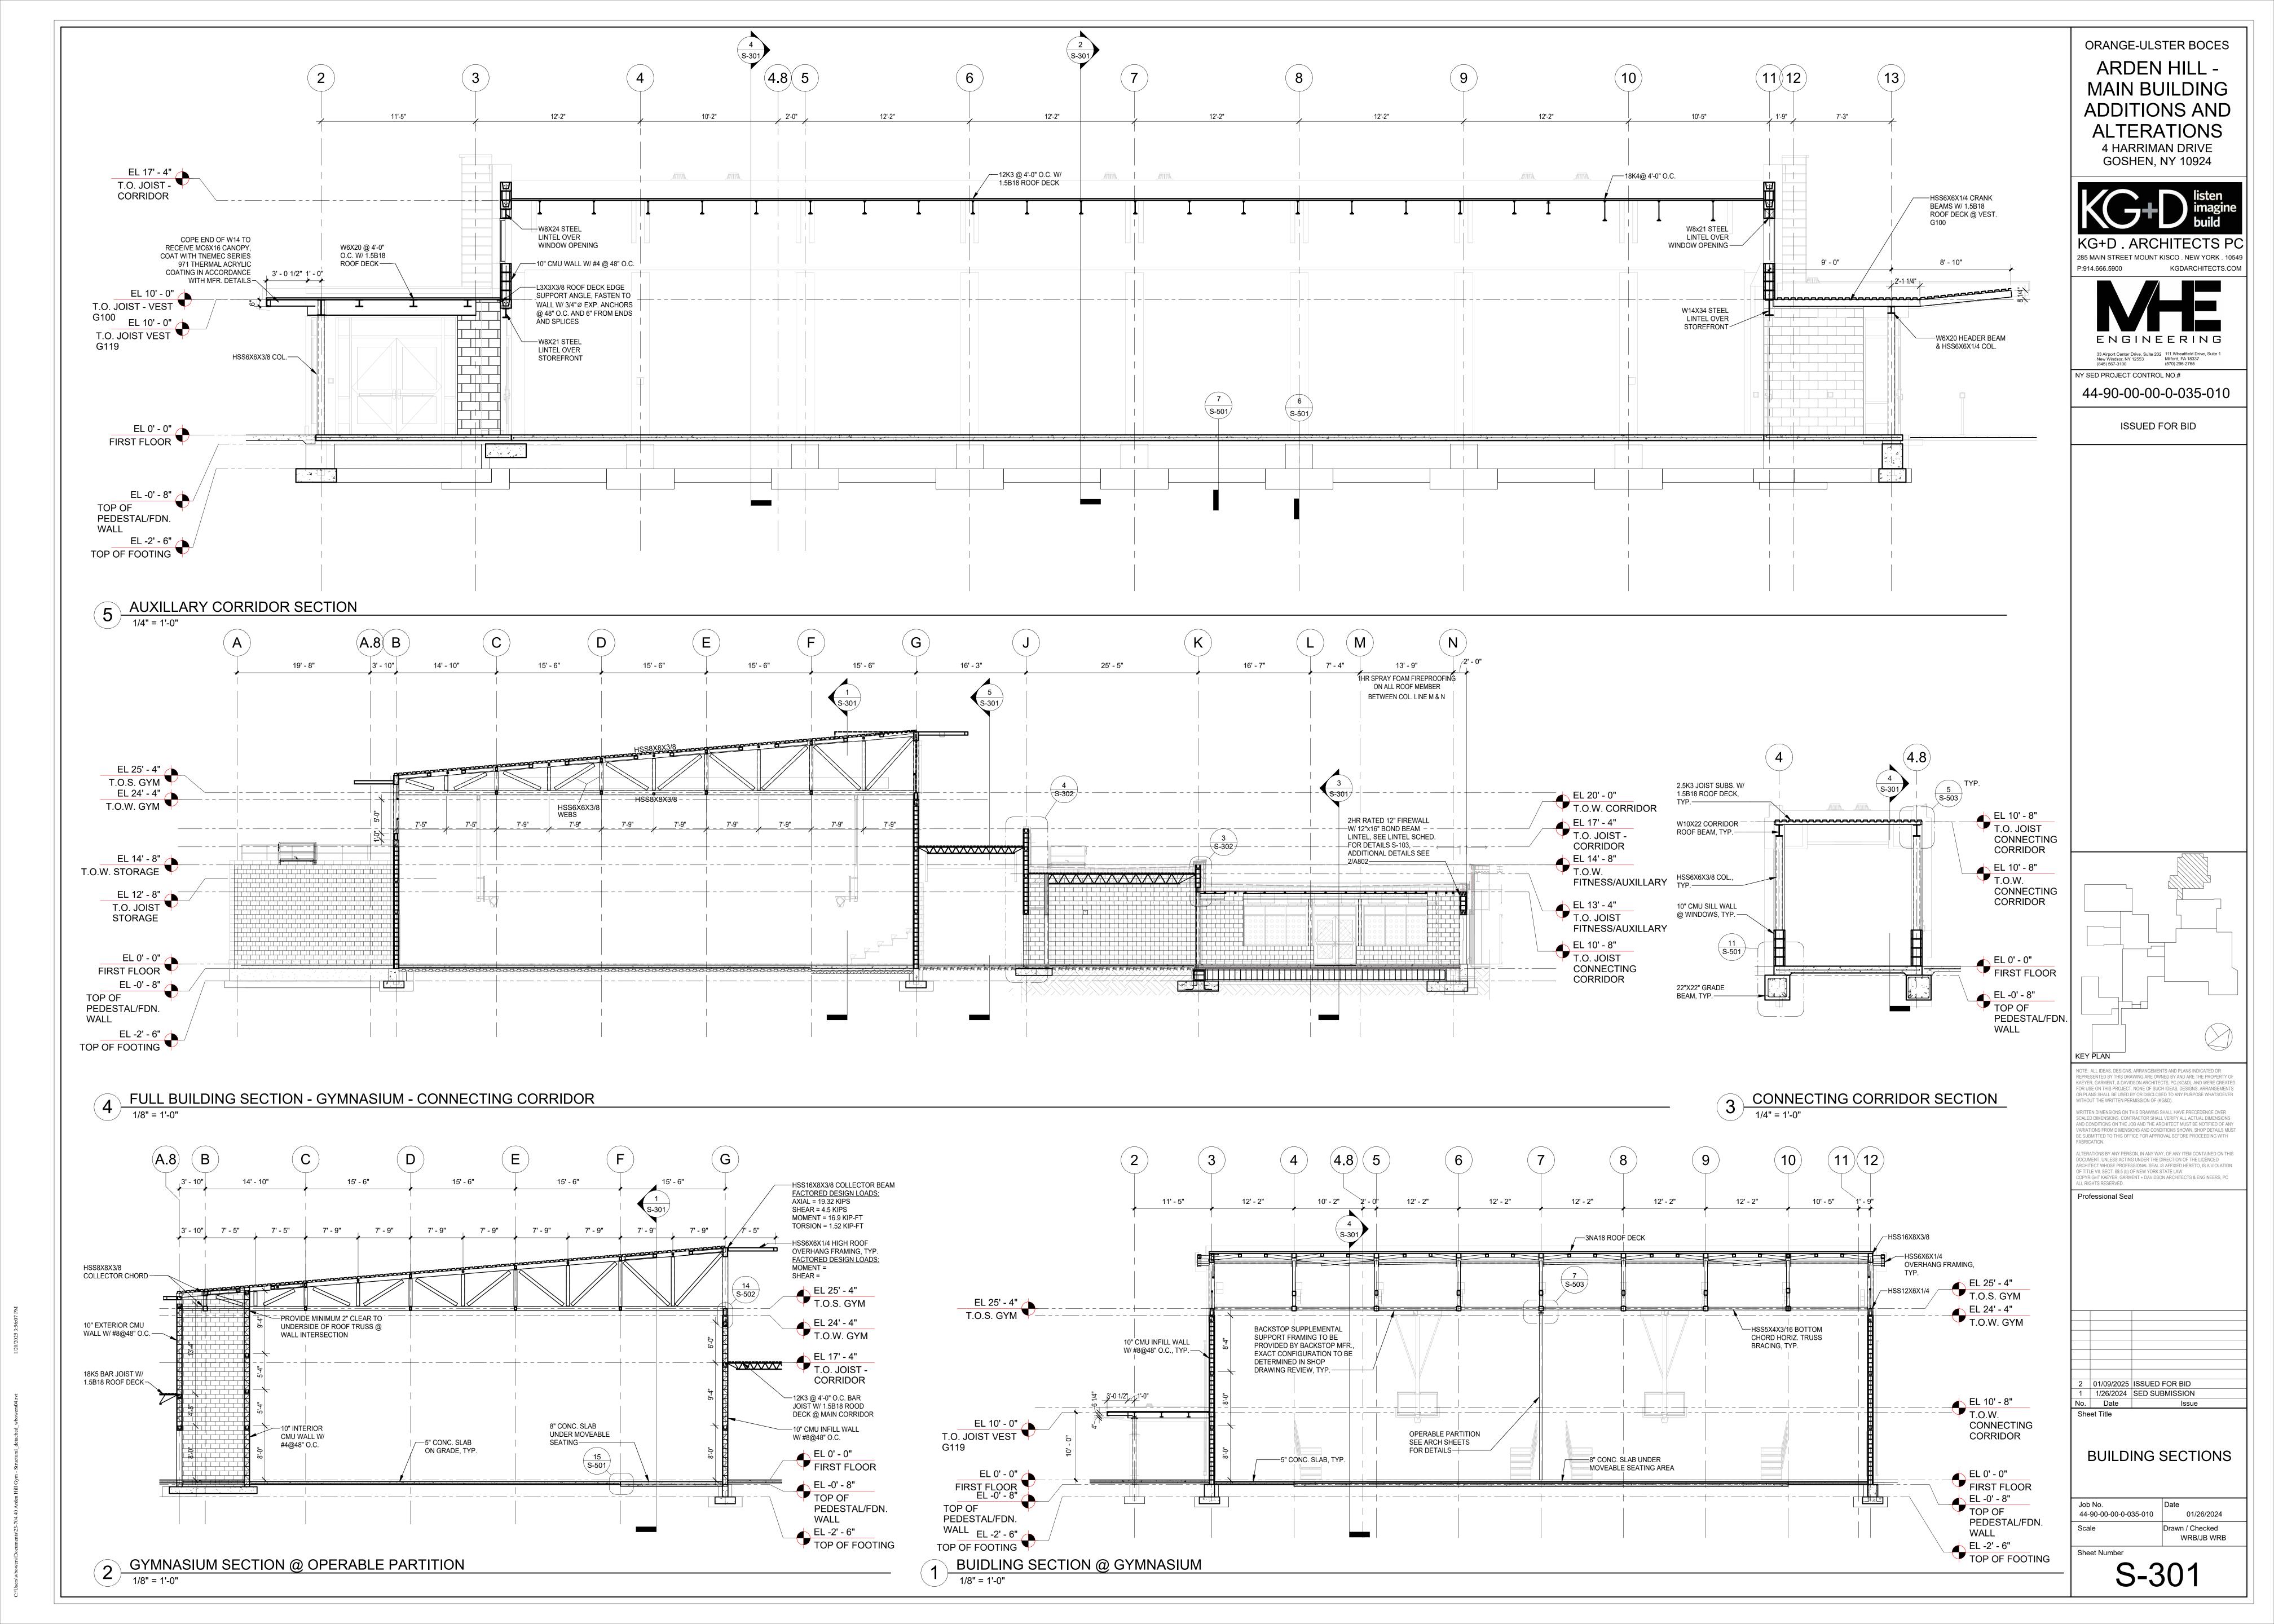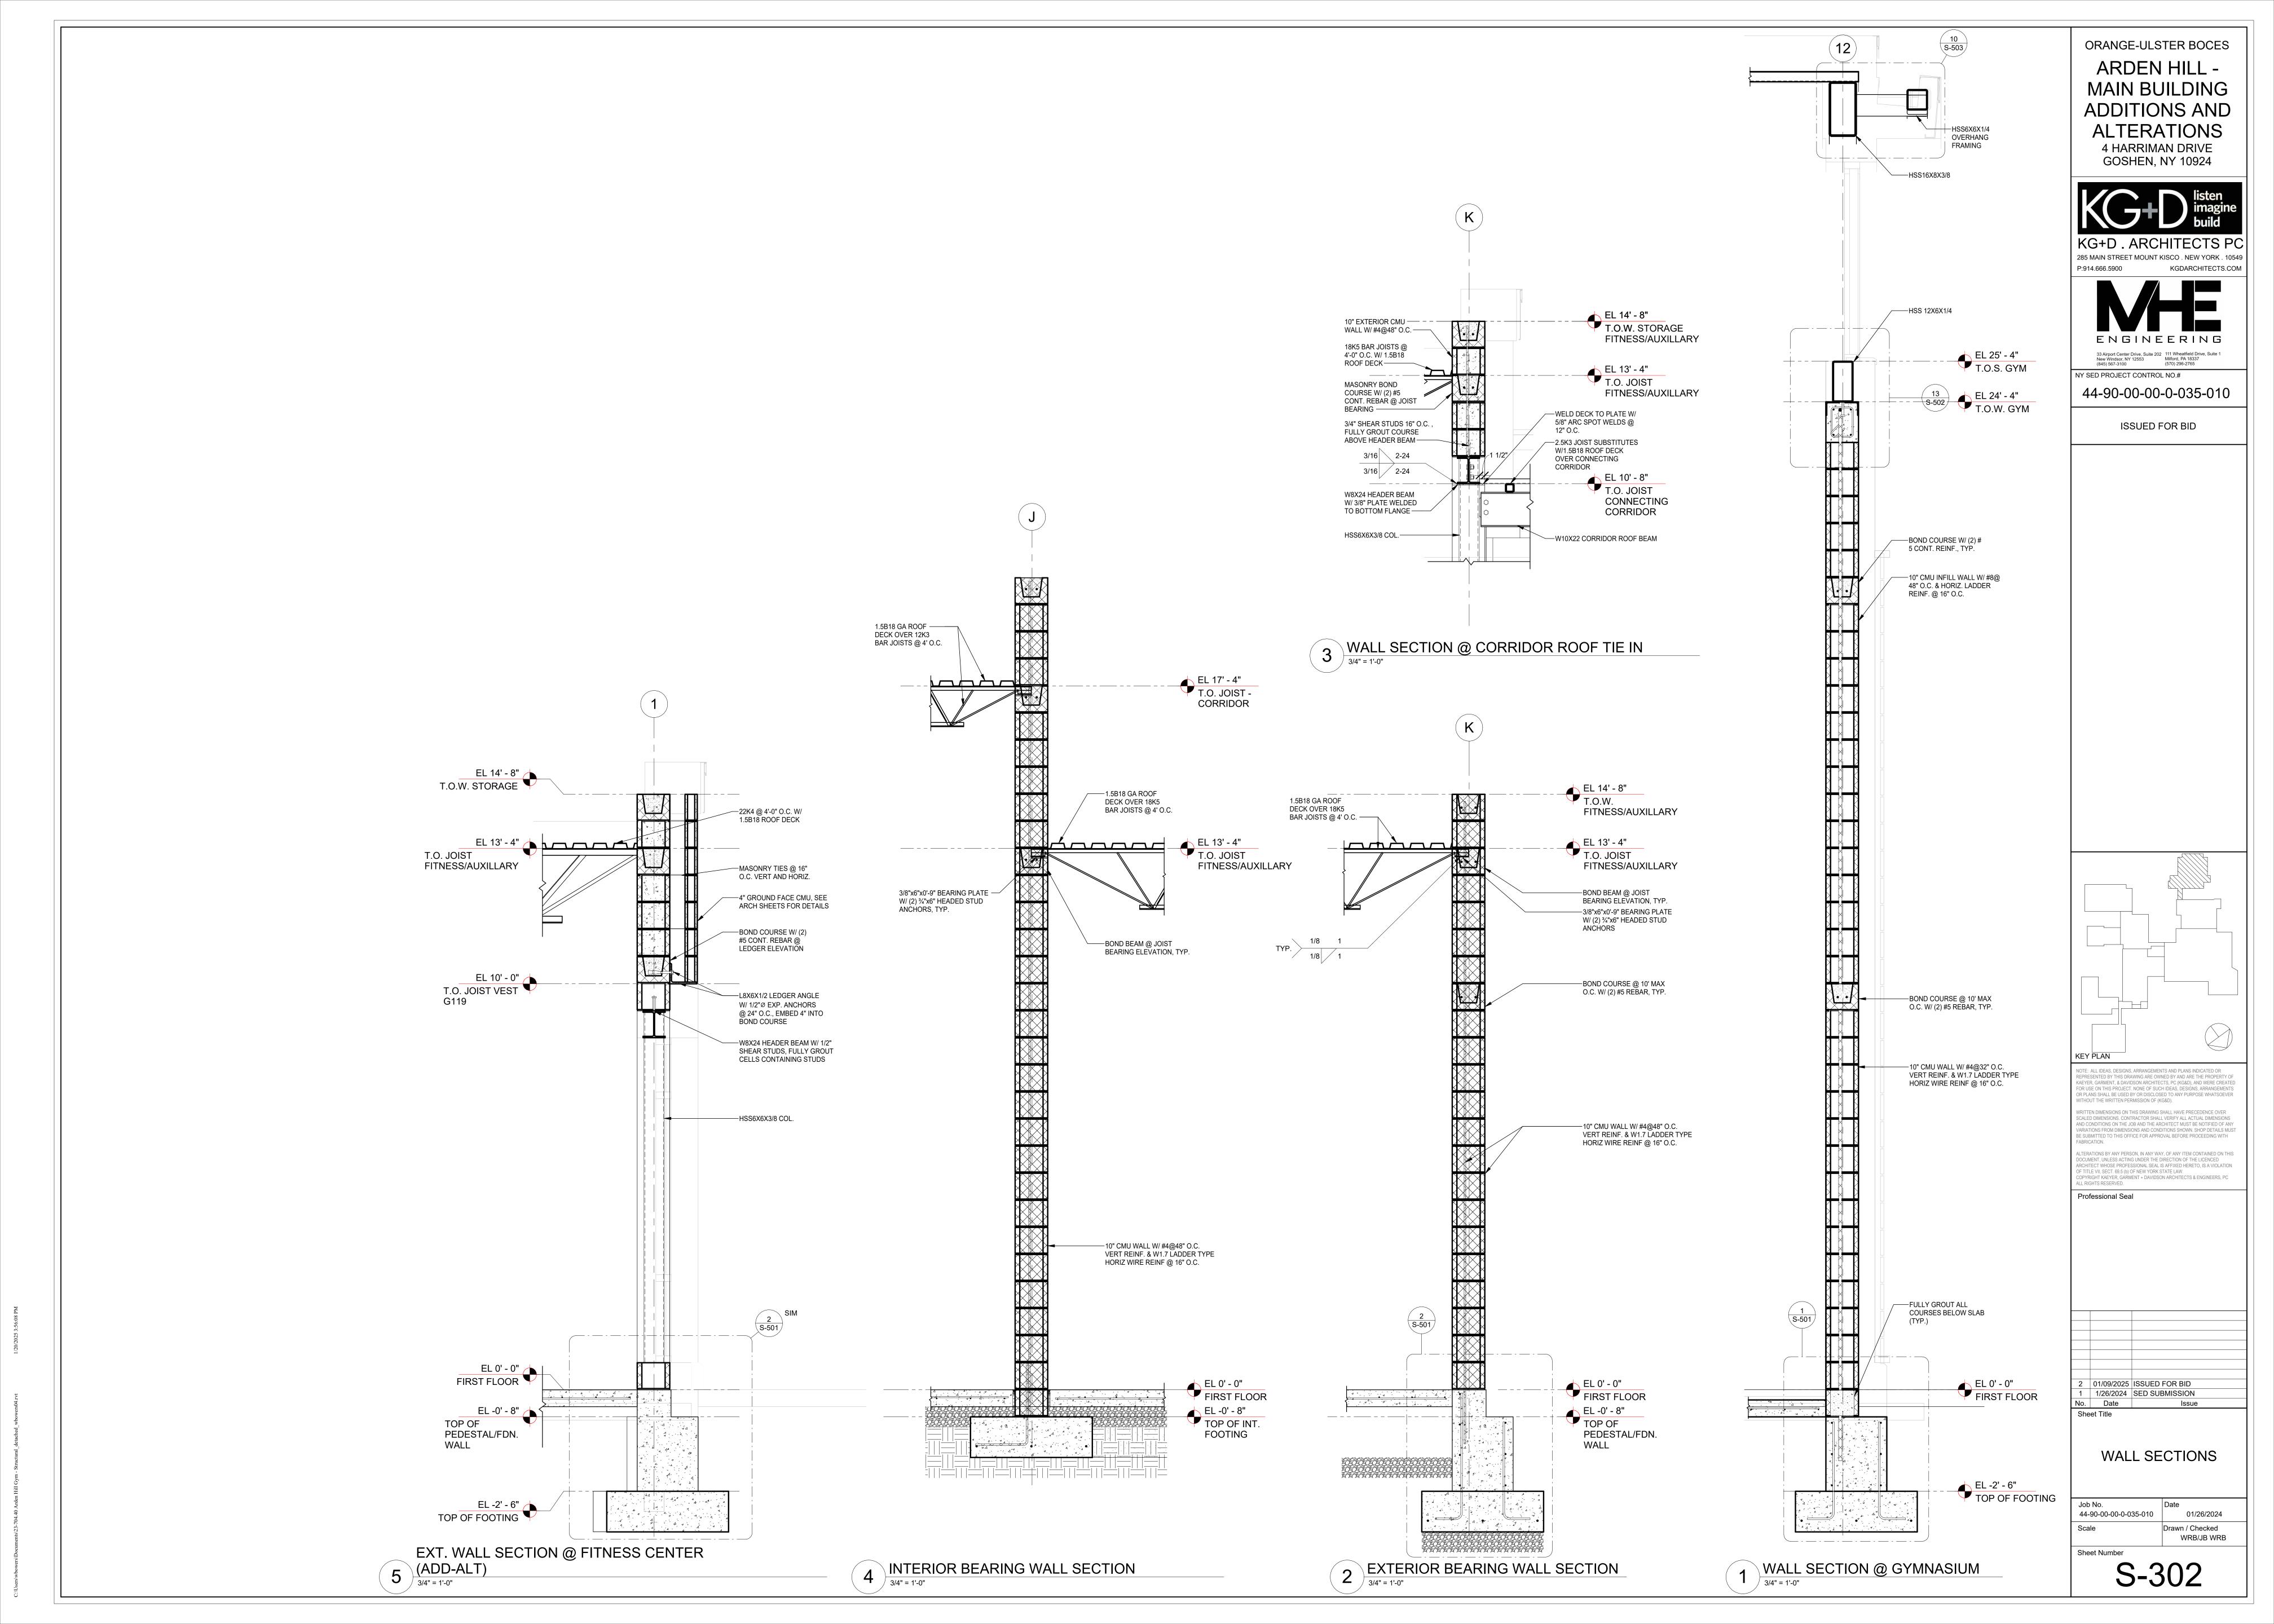
S-102

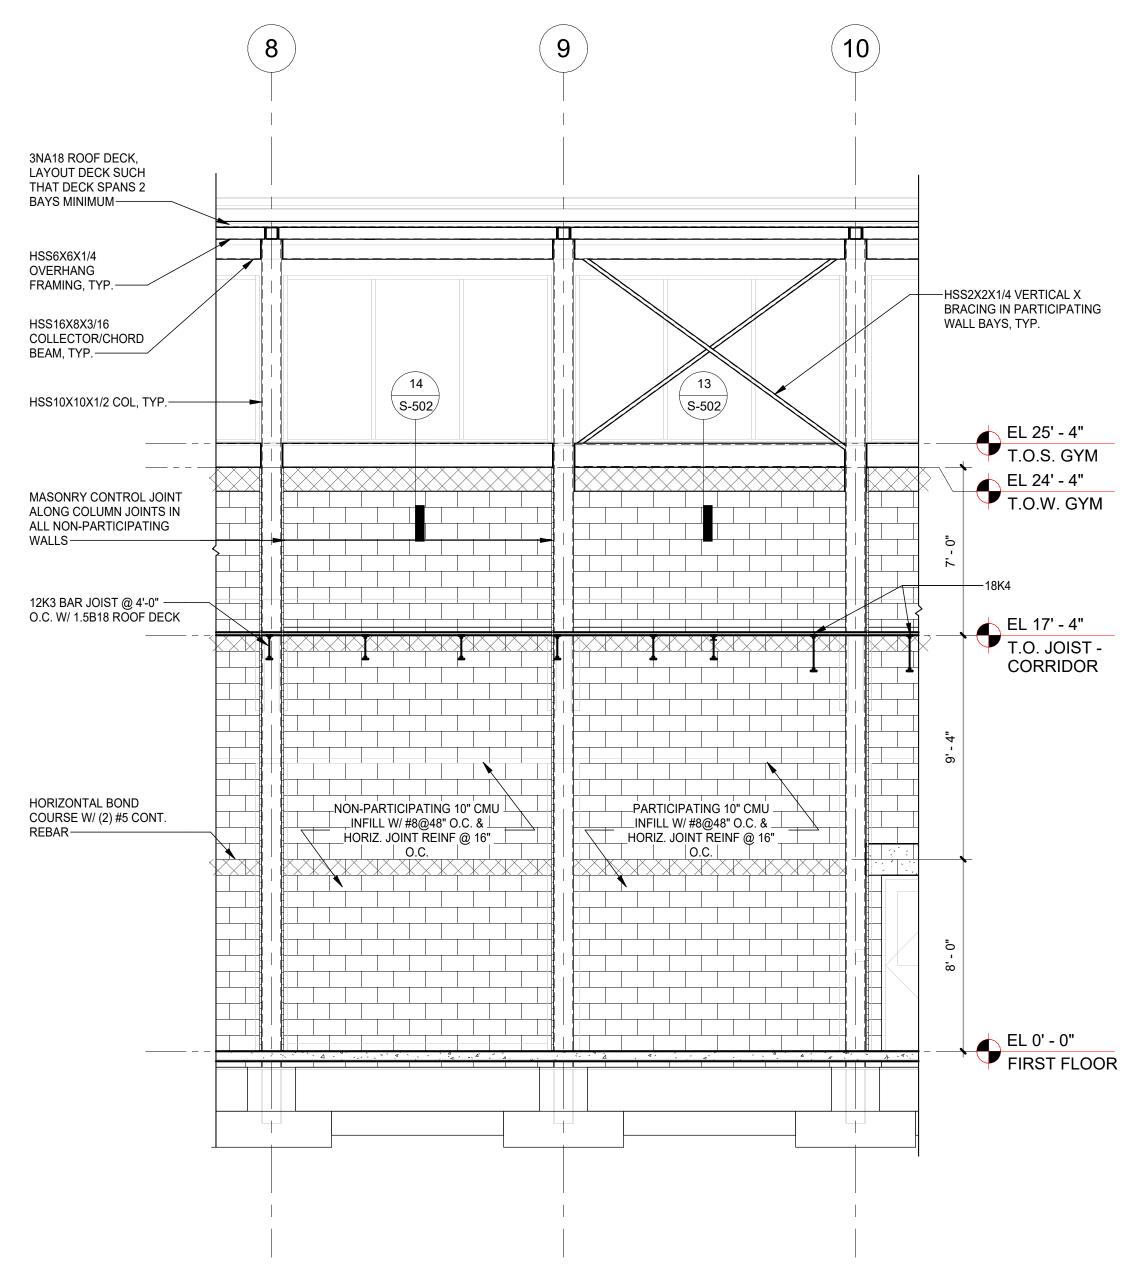















4 CMU INFILL ELEVATION - END WALLS

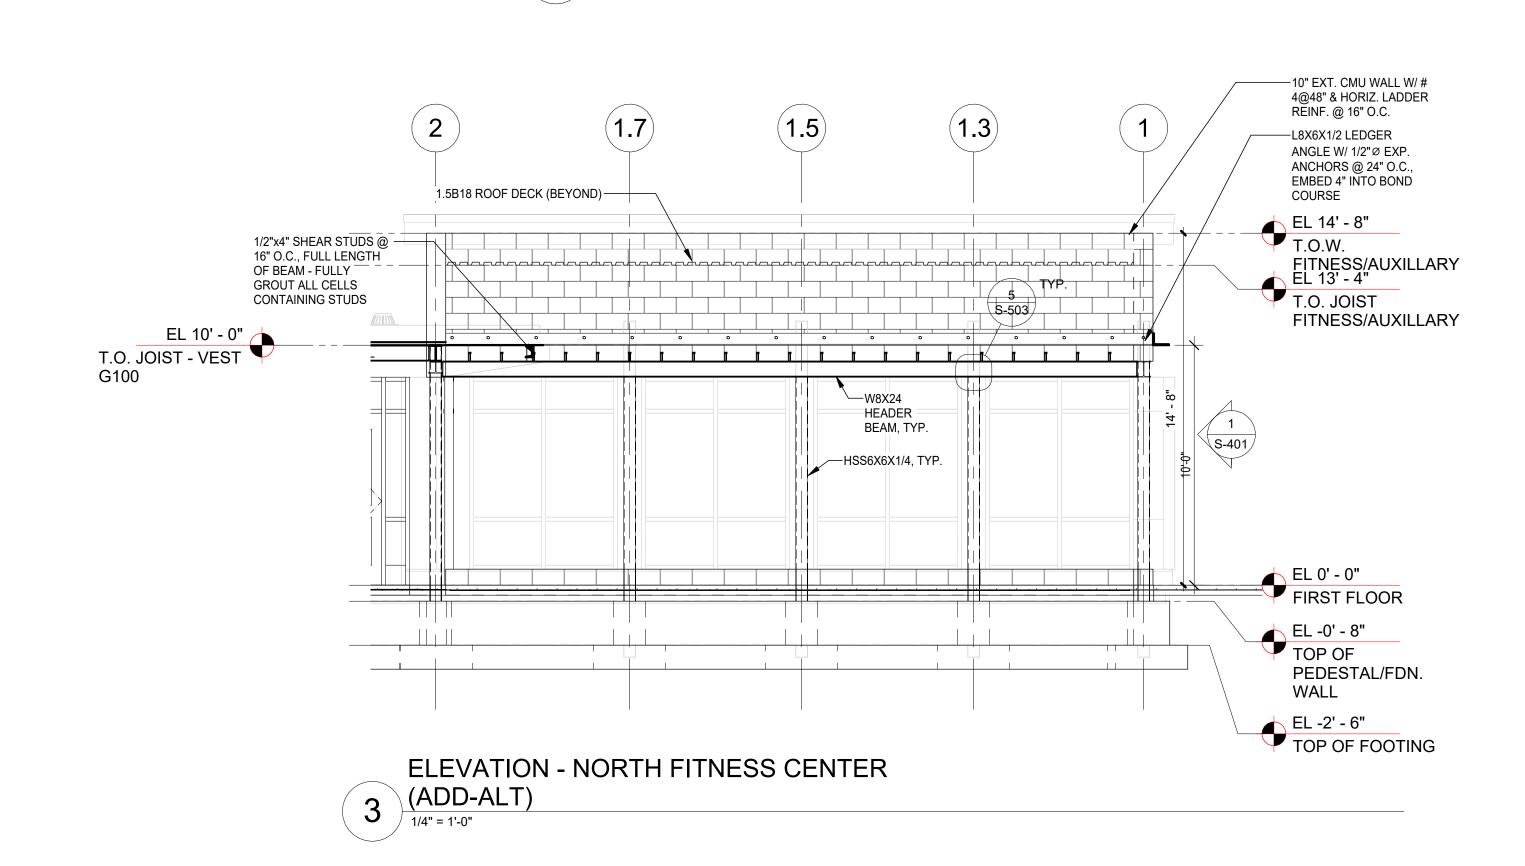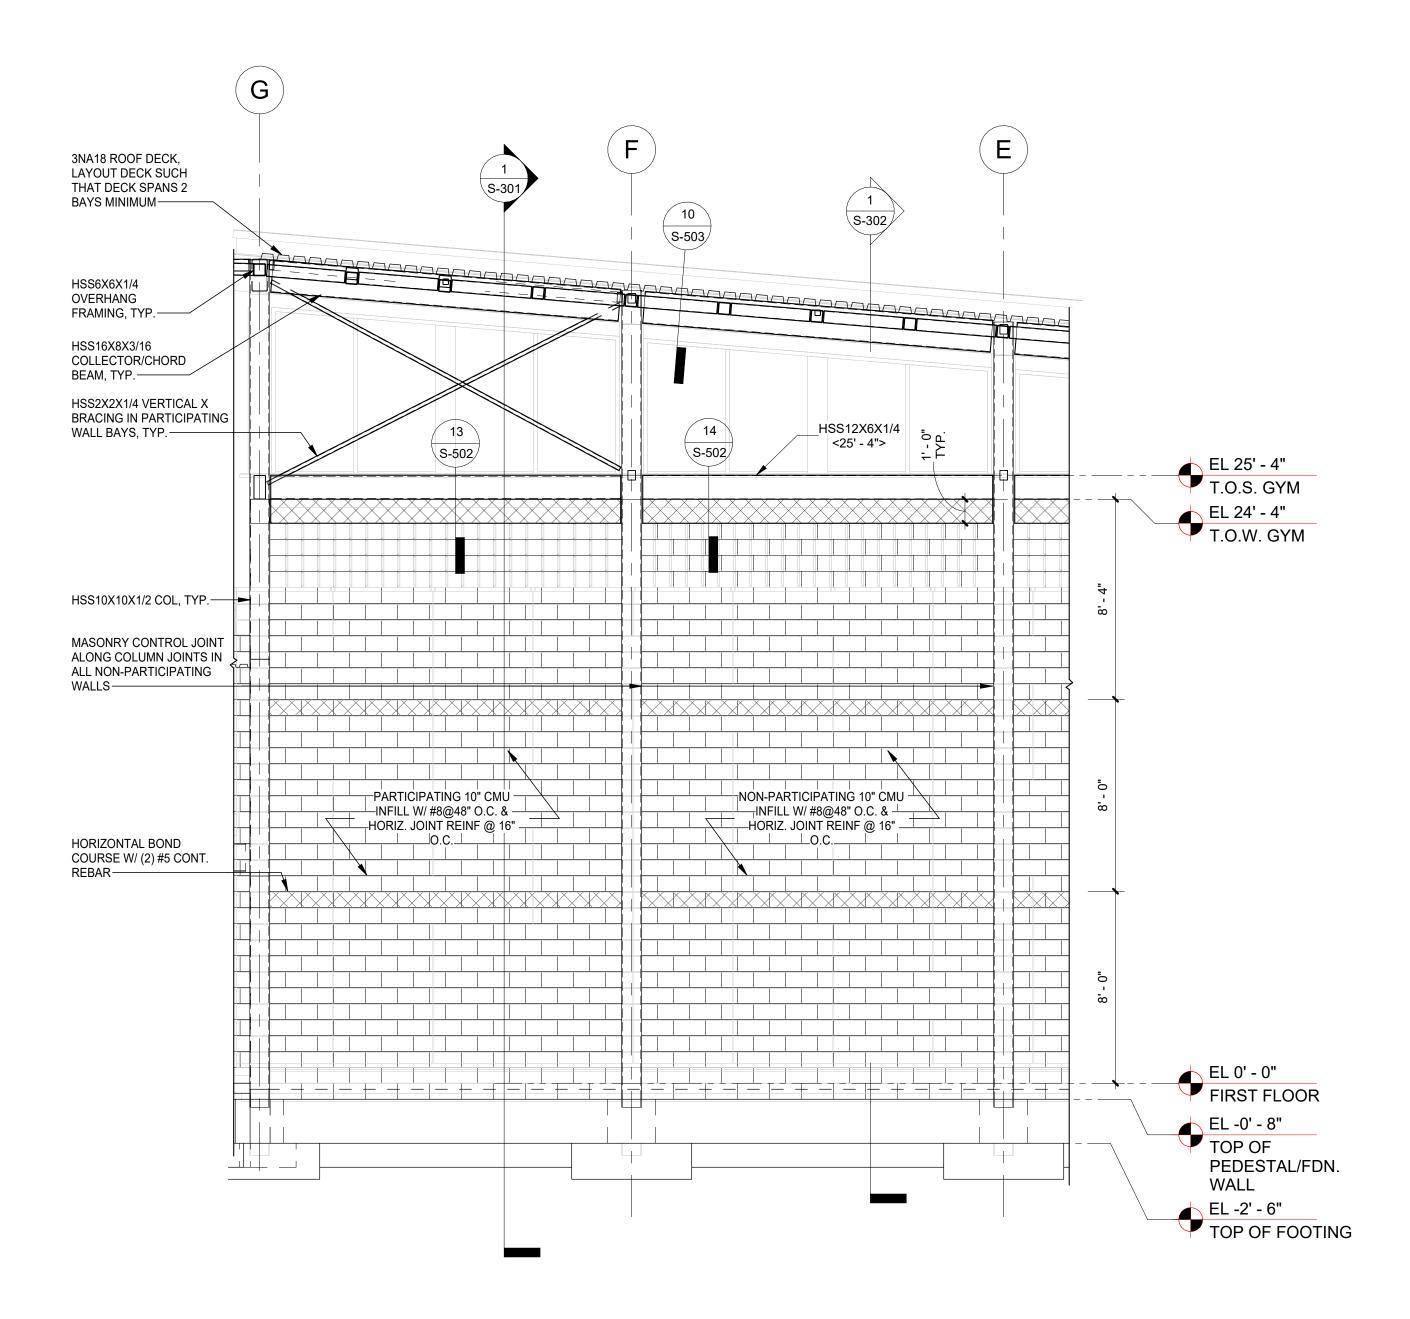1/4" = 1'-0"





2 CMU INFILL ELEVATION - SIDE WALLS

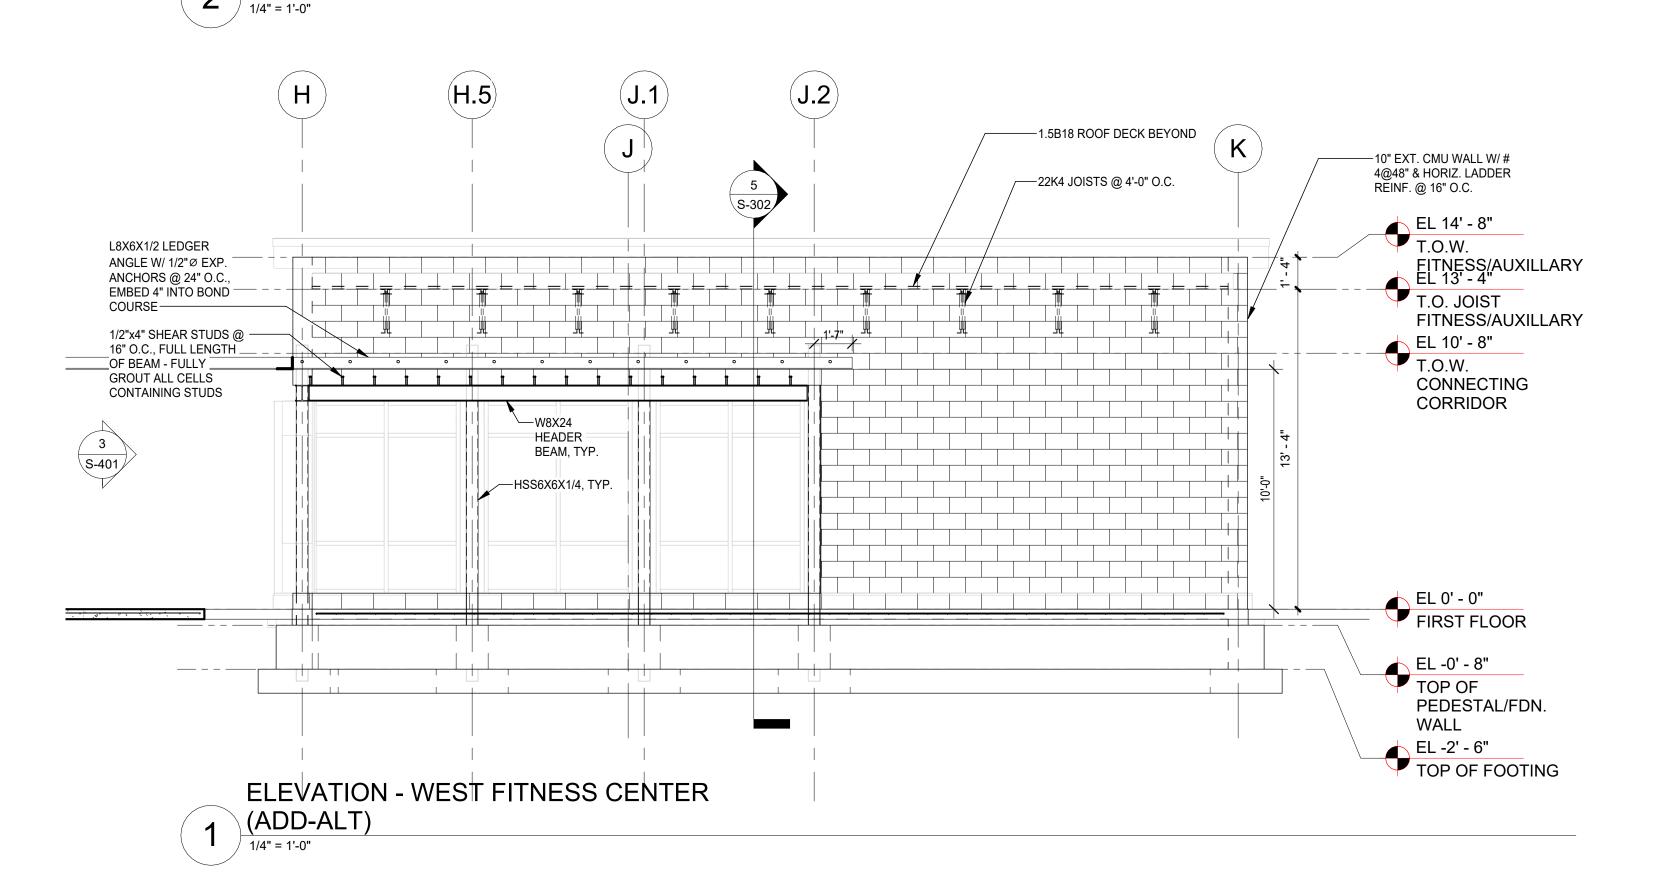

ORANGE-ULSTER BOCES

ARDEN HILL
MAIN BUILDING

ADDITIONS AND ALTERATIONS 4 HARRIMAN DRIVE GOSHEN, NY 10924



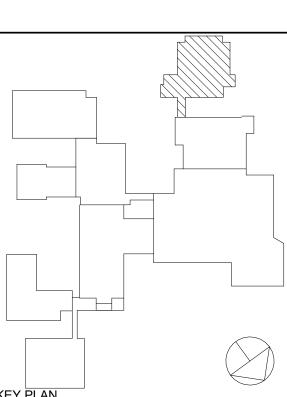
ENGINEERING

33 Airport Center Drive, Suite 202
New Windsor, NY 12553
(845) 567-3100

111 Wheatfield Drive, Suite 1
Milford, PA 18337
(570) 296-2765

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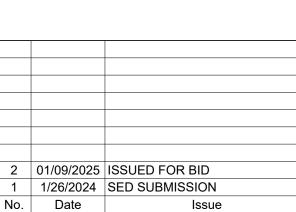
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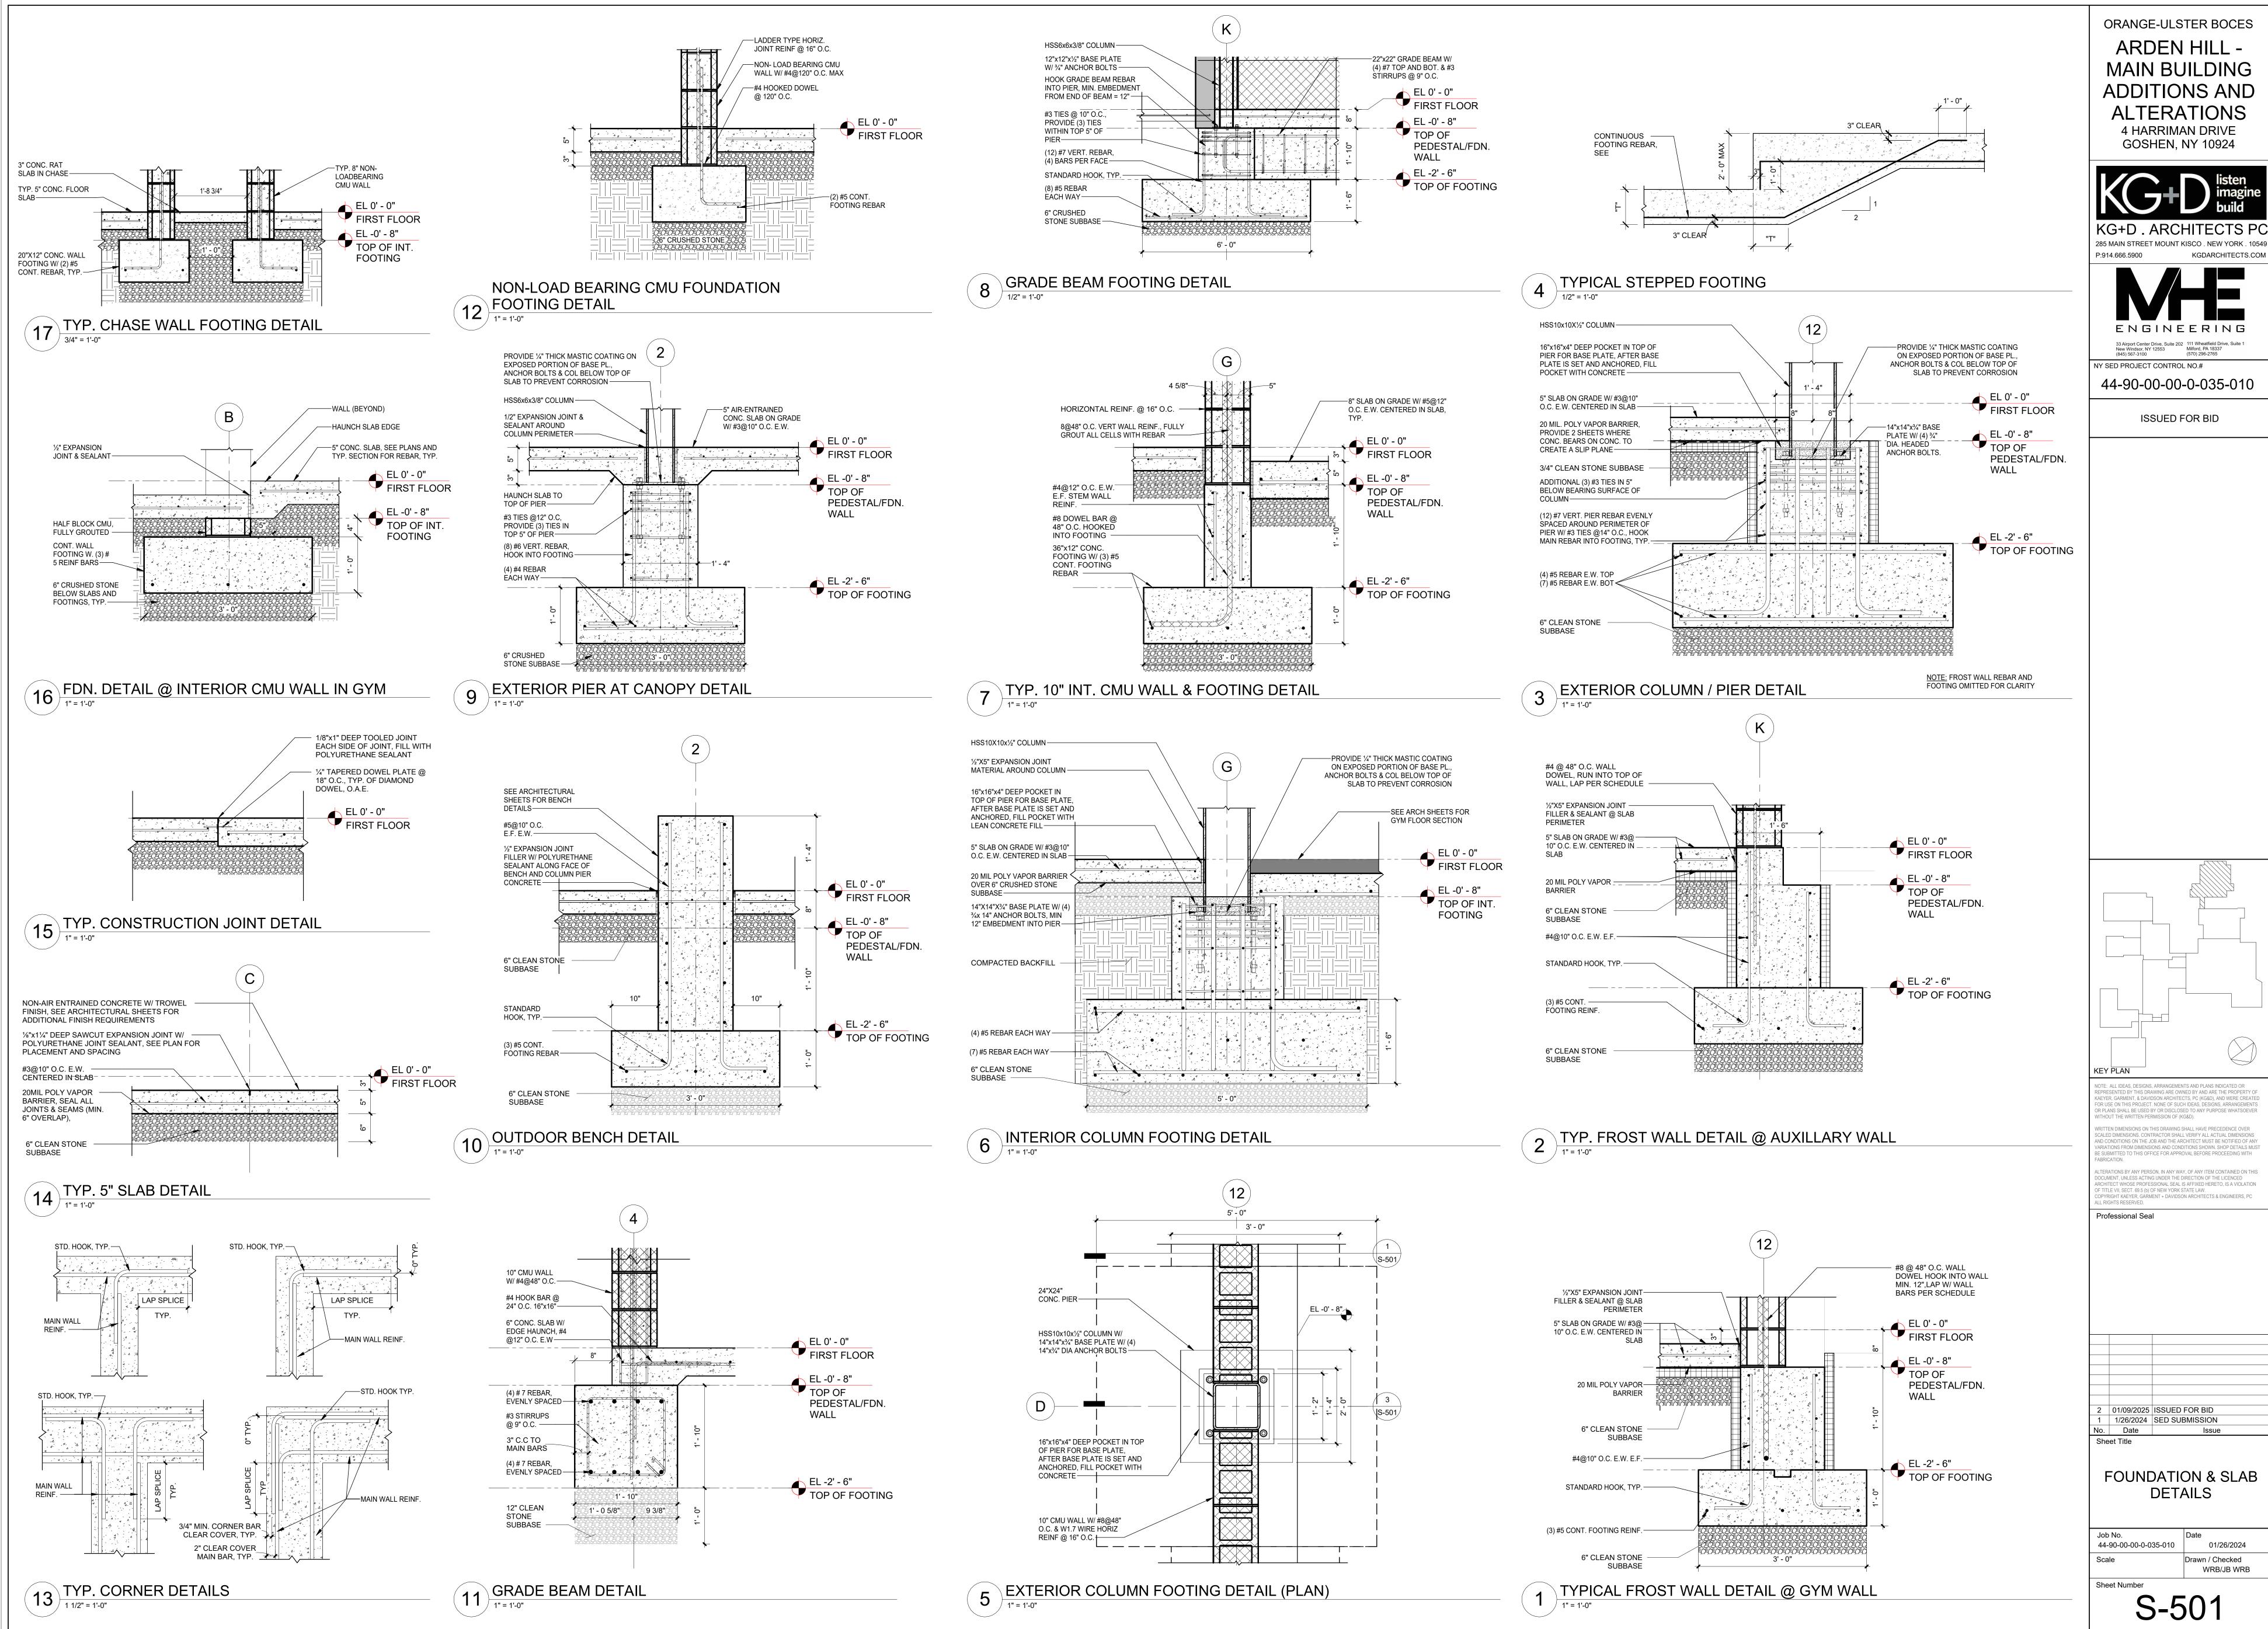
ELEVATIONS AND SECTIONS

44-90-00-00-0-035-010 01/26/2024

Scale Drawn / Checked WRB/JB WRB

Sheet Number

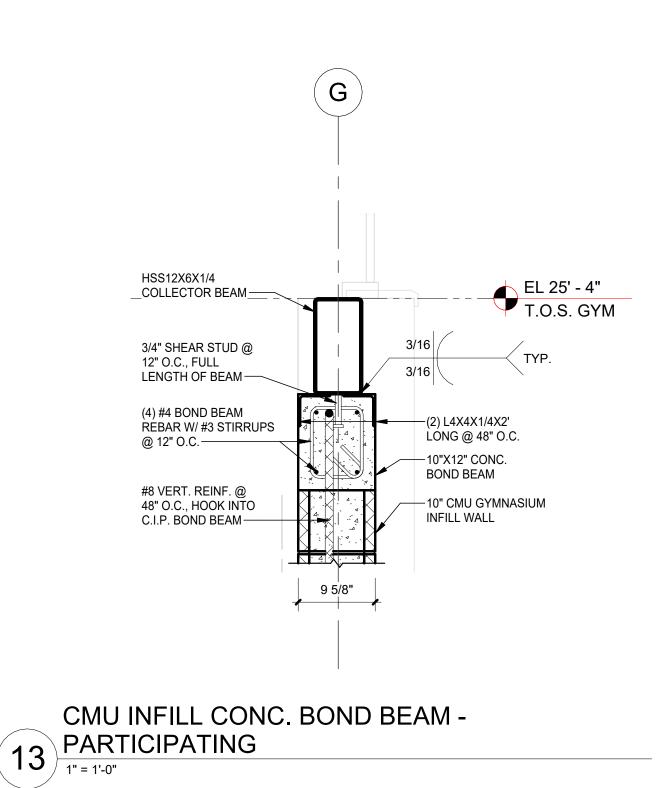
S-401



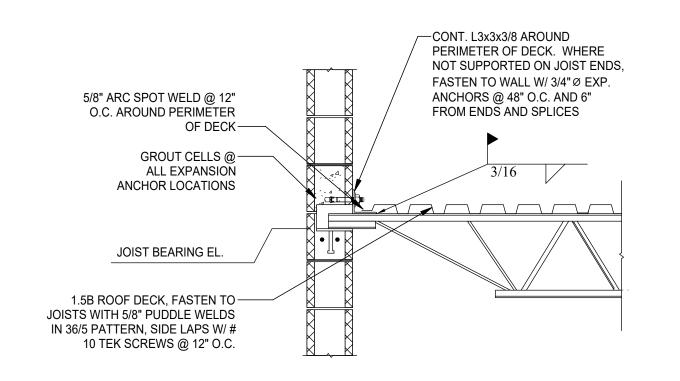
S-501

01/26/2024


Drawn / Checked WRB/JB WRB








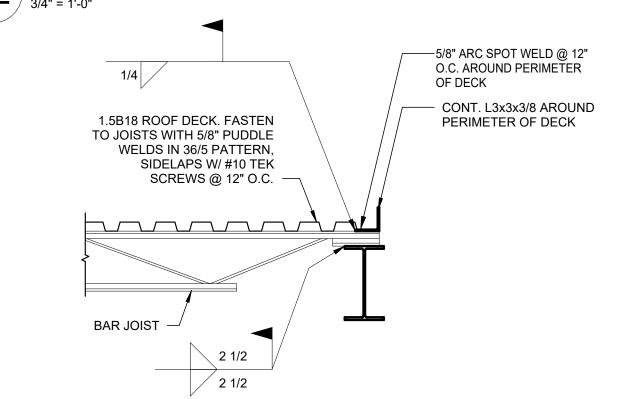
12 METAL DECK ON JOIST ON CMU DETAIL 3/4" = 1'-0"




JOIST CONNECTION TO STEEL DETAIL -

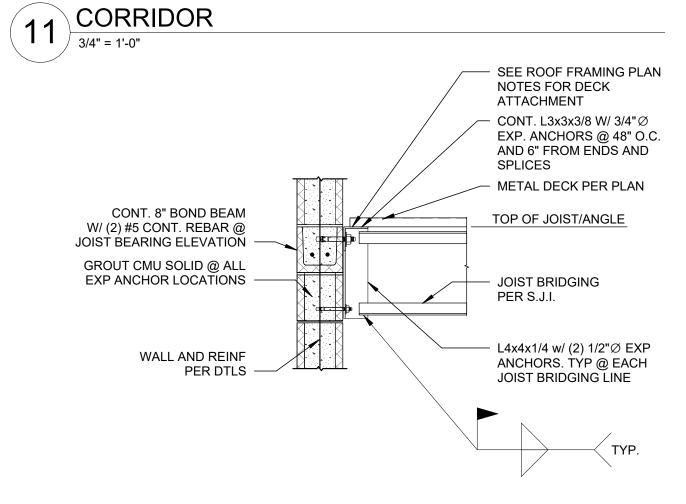


JOIST BRIDGING AT WALL 3/4" = 1'-0"

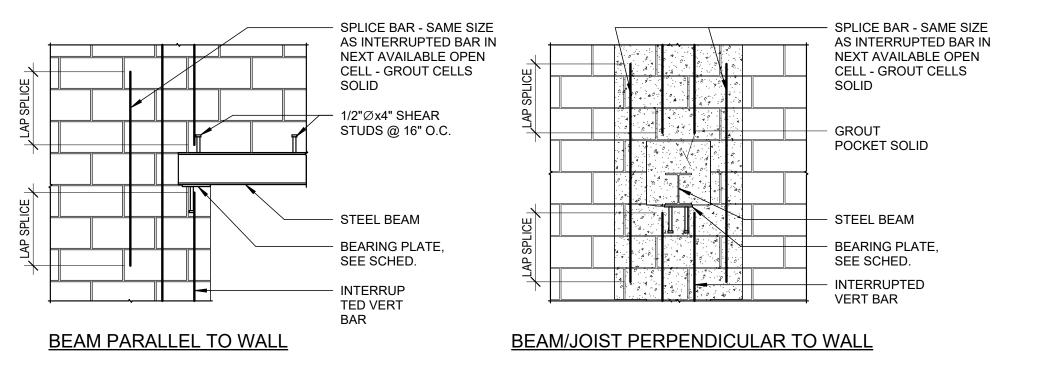


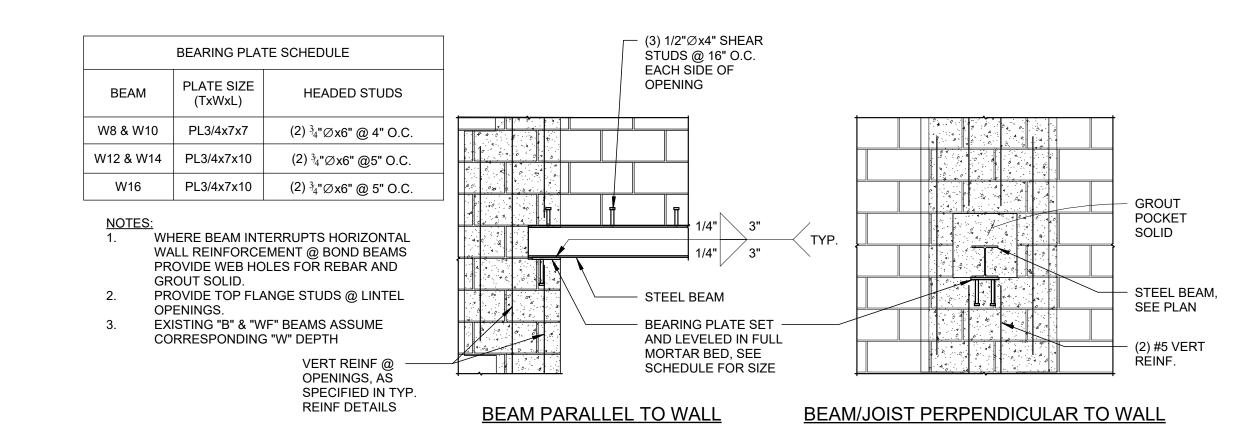

BEAM BEARING ON MASONRY DETAILS

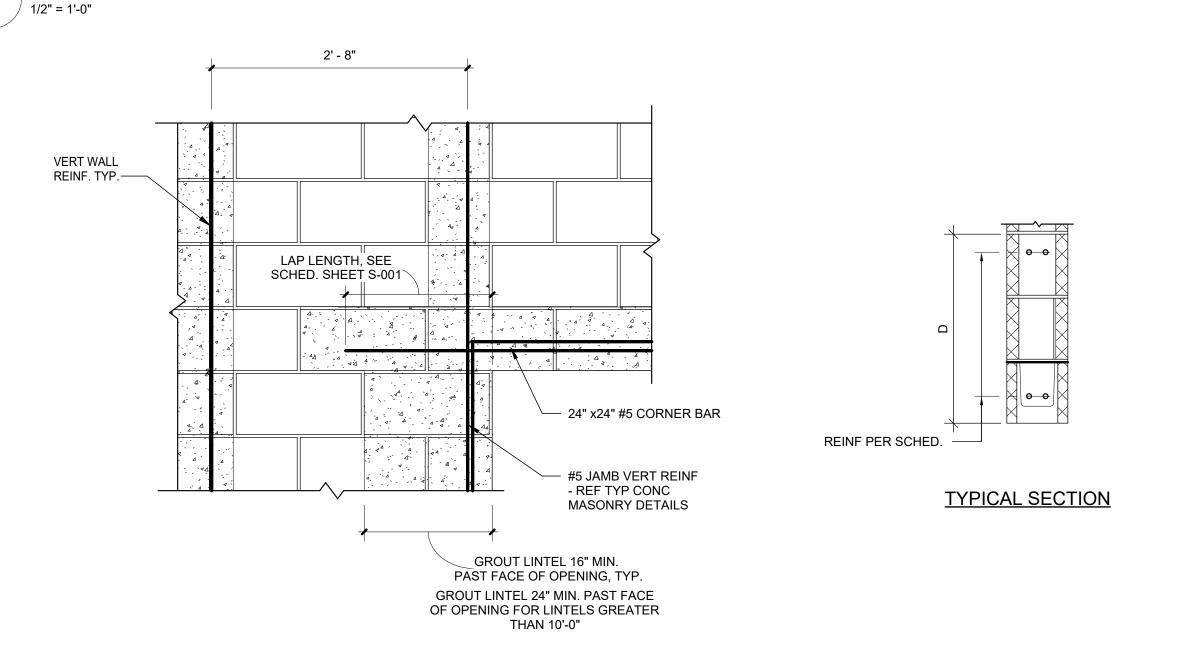


TYPICAL CMU WALL LINTELS

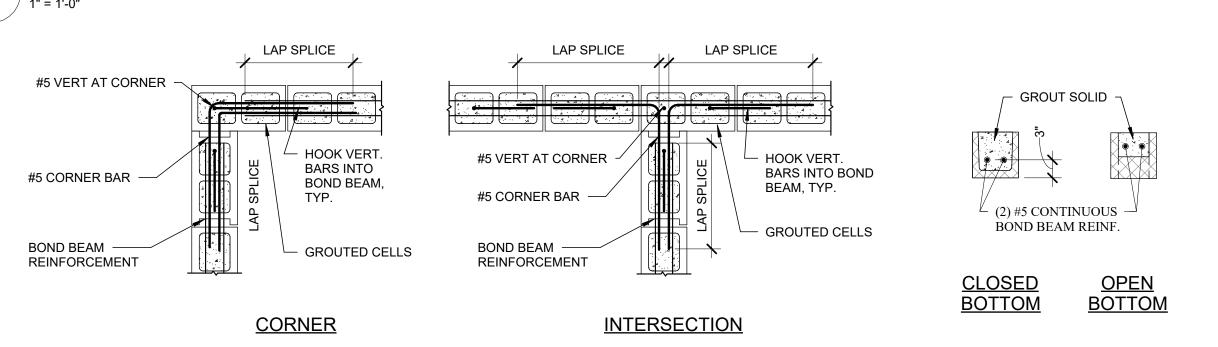


TYPICAL BOND BEAM REINFORCING DETAILS

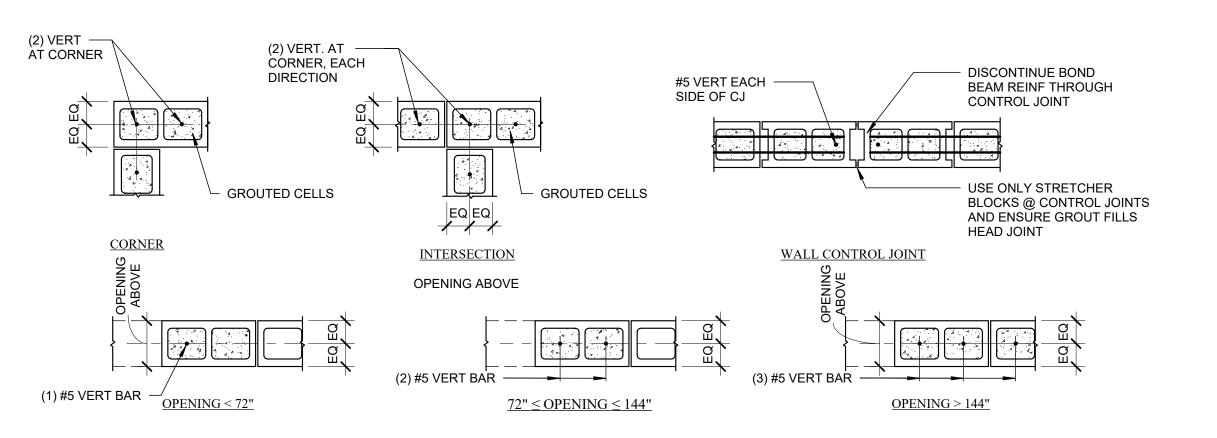
3/4" = 1'-0"



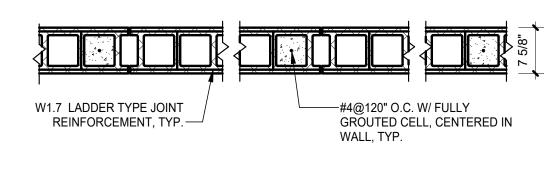TYPICAL CONCRETE MASONRY REINFORCING **DETAILS**3/4" = 1'-0"




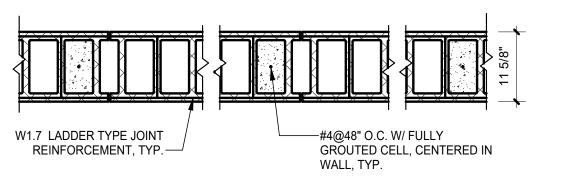TYP. 8" CMU WALL - NON-LOAD BEARING $\begin{pmatrix} 4 \end{pmatrix} \frac{14P.6}{3/4" = 1'-0"}$




2 TYP. 12" CMU WALL - FIREWALL

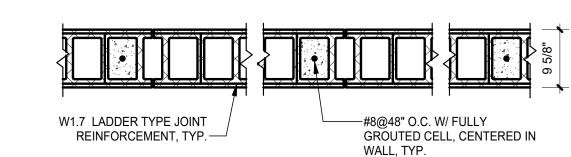3/4" = 1'-0"



3 TYP. 10" CMU WALL - GYM

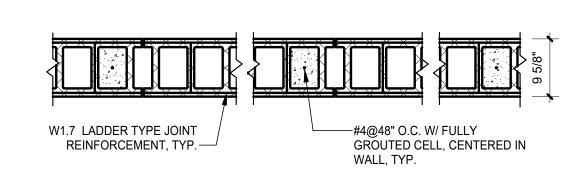

TYP. 10" CMU WALL - AUXILLARY

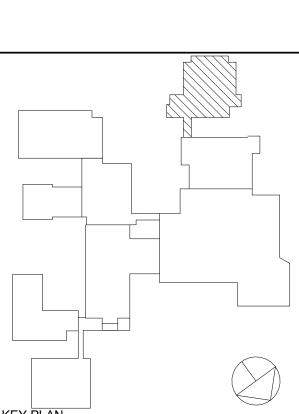
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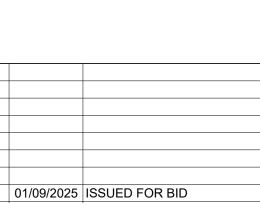
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> **MASONRY WALL DETAILS**

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Sheet Number

S-502

CMU INFILL CONC. BOND BEAM -NON-PARTICIPATING

1" = 1'-0"

HSS12X6X1/4

COLLECTOR BEAM

(4) #4 BOND BEAM

#8 VERT. REINF. @

C.I.P. BOND BEAM-

48" O.C., HOOK INTO

@ 12" O.C.—

REBAR W/ #3 STIRRUPS

COAT INSIDE SURFACE OF ANGLES IN CONTACT WITH BOND BEAM W/ BOND BREAK MATERIAL - G

9 5/8"

—10"X12" CONC.

BOND BEAM

INFILL WALL

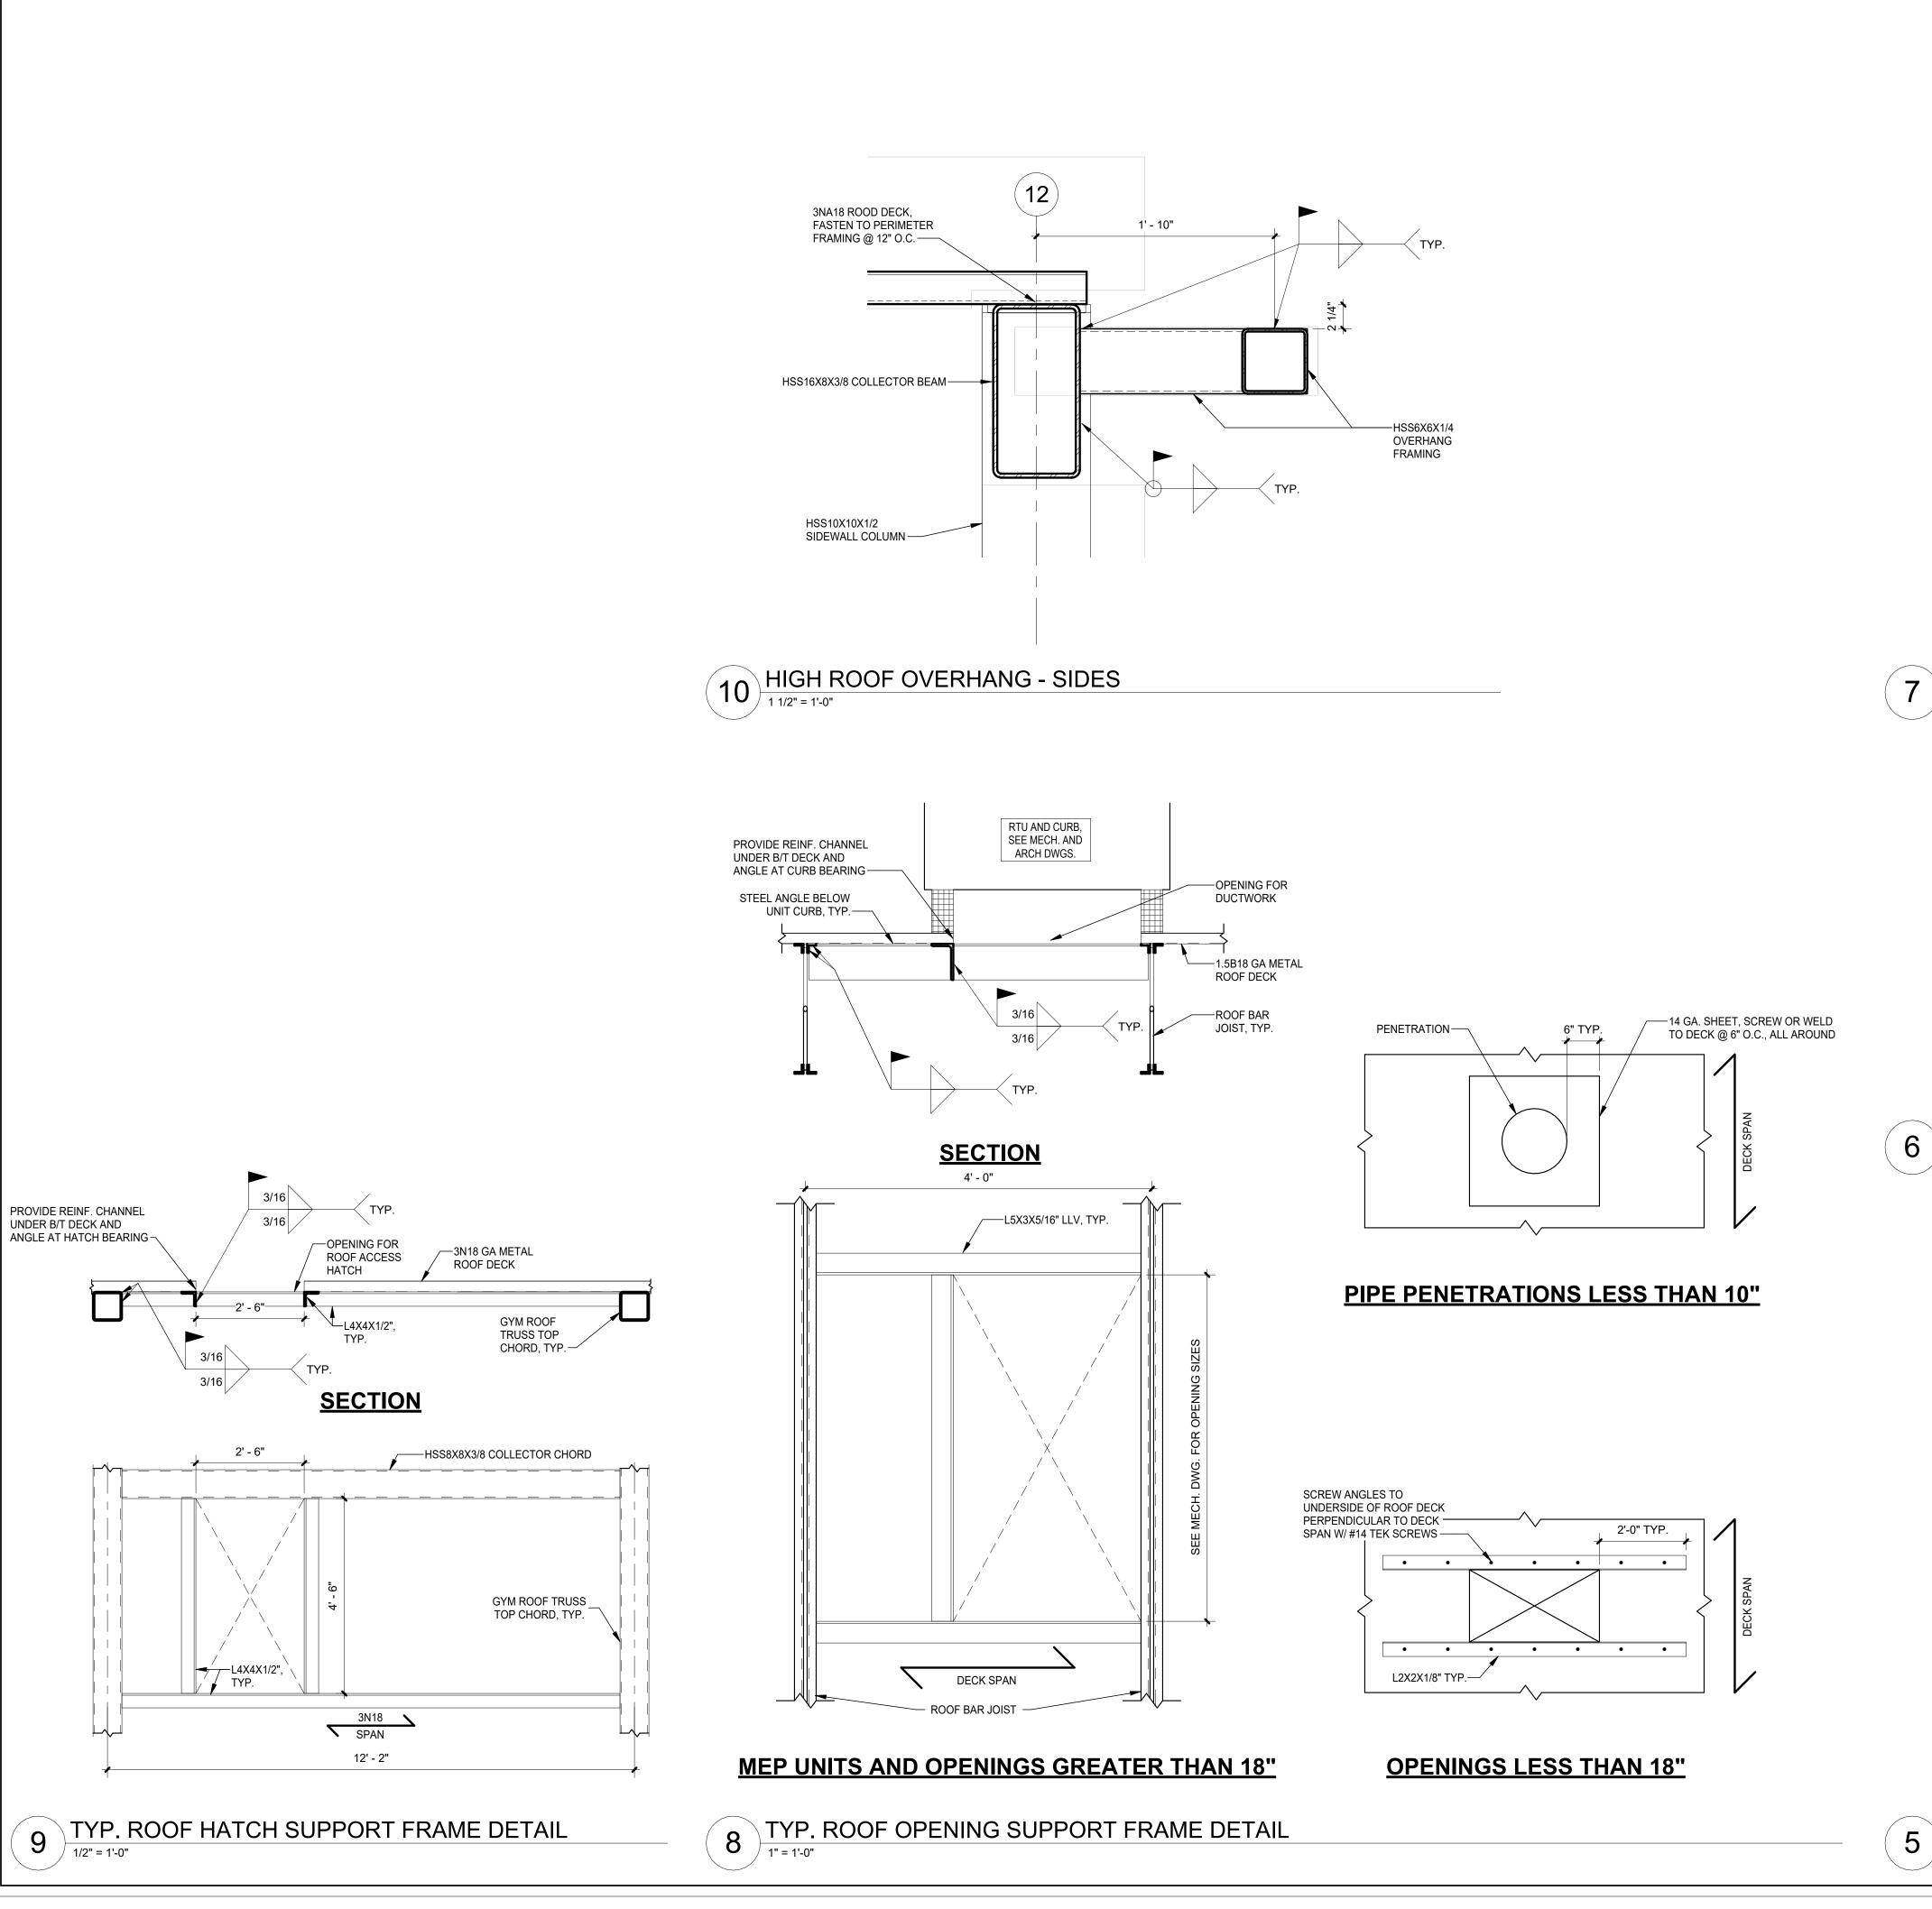
____10" CMU GYMNASIUM

EL 25' - 4" T.O.S. GYM

EL 24' - 4" T.O.W. GYM

9 TYPICAL OFFSET SPLICE AT MASONRY WALL


1/2" = 1'-0"




PROVIDE REINF. CHANNEL

ANGLE AT HATCH BEARING -

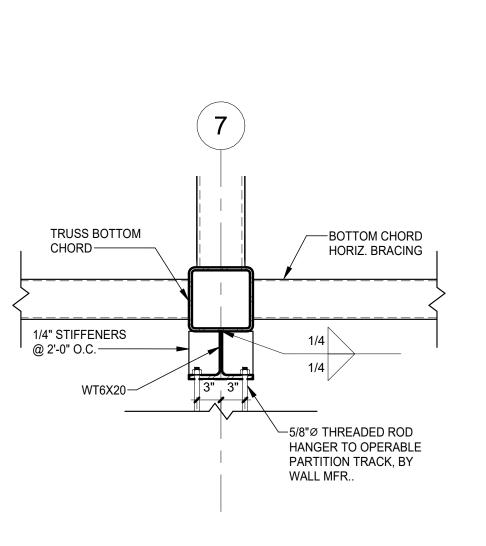
UNDER B/T DECK AND



OPERABLE PARTITION CONNECTION TO

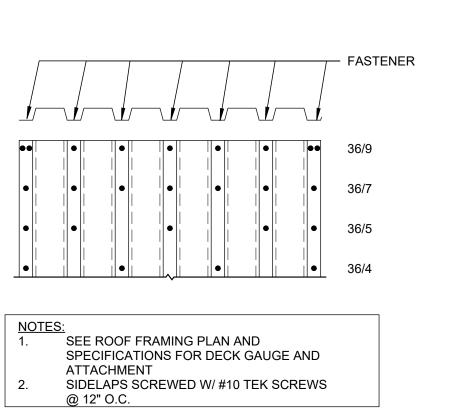


6 1.5B DECK ATTACHMENT PATTERNS

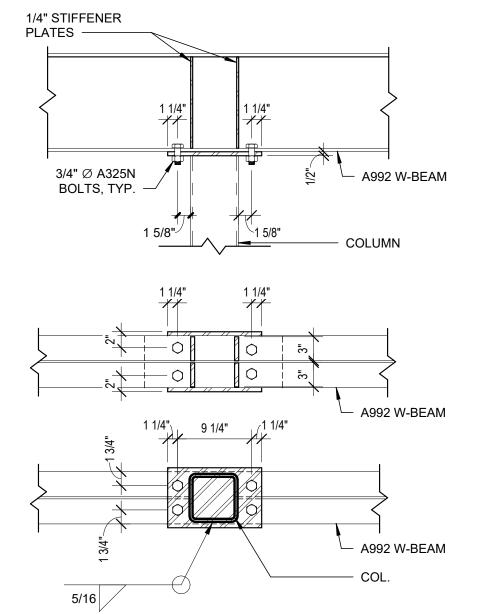


5 W-BEAM COLUMN CAP CONNECTION DETAIL

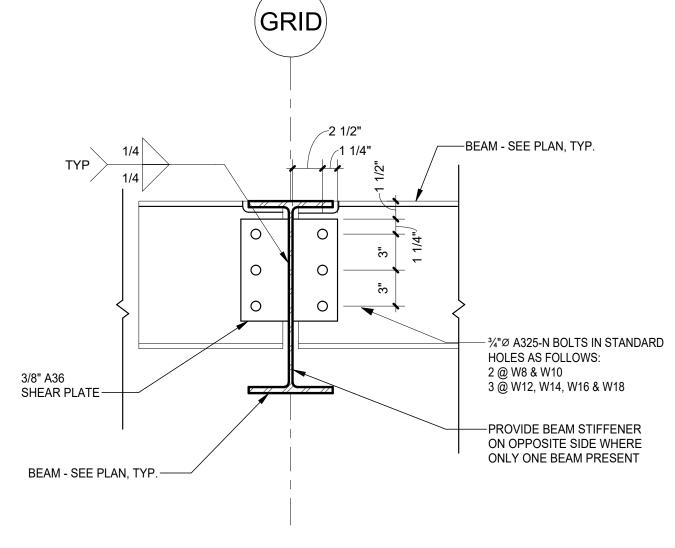
1" = 1'-0"



4 TYP. SHEAR PLATE CONNECTION BEAM-BEAM

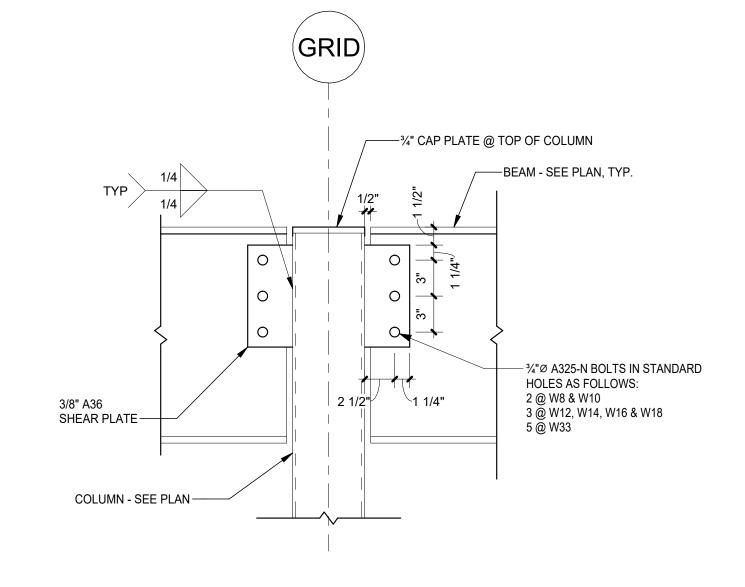


TYP. SHEAR PLATE CONNECTION BEAM-COL

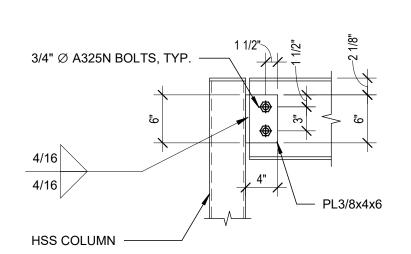

2 TYP. W-BEAM TO HSS CONNECTION DETAIL

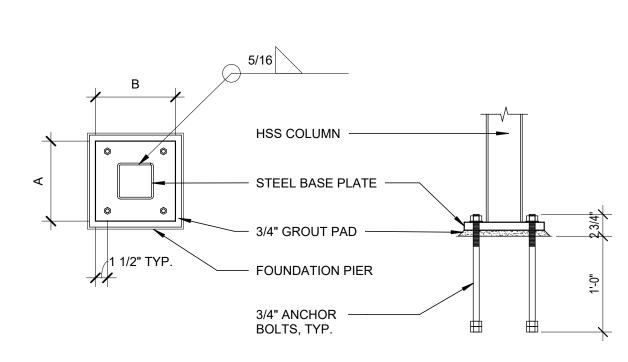1" = 1'-0"




1 HSS BASE PLATE DETAIL

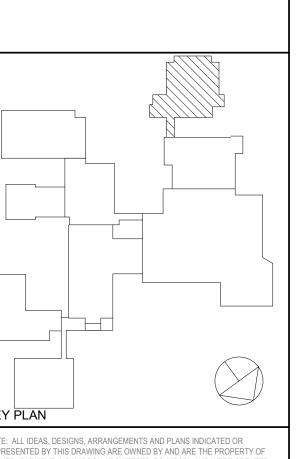ORANGE-ULSTER BOCES ARDEN HILL -MAIN BUILDING **ADDITIONS AND ALTERATIONS** 4 HARRIMAN DRIVE GOSHEN, NY 10924

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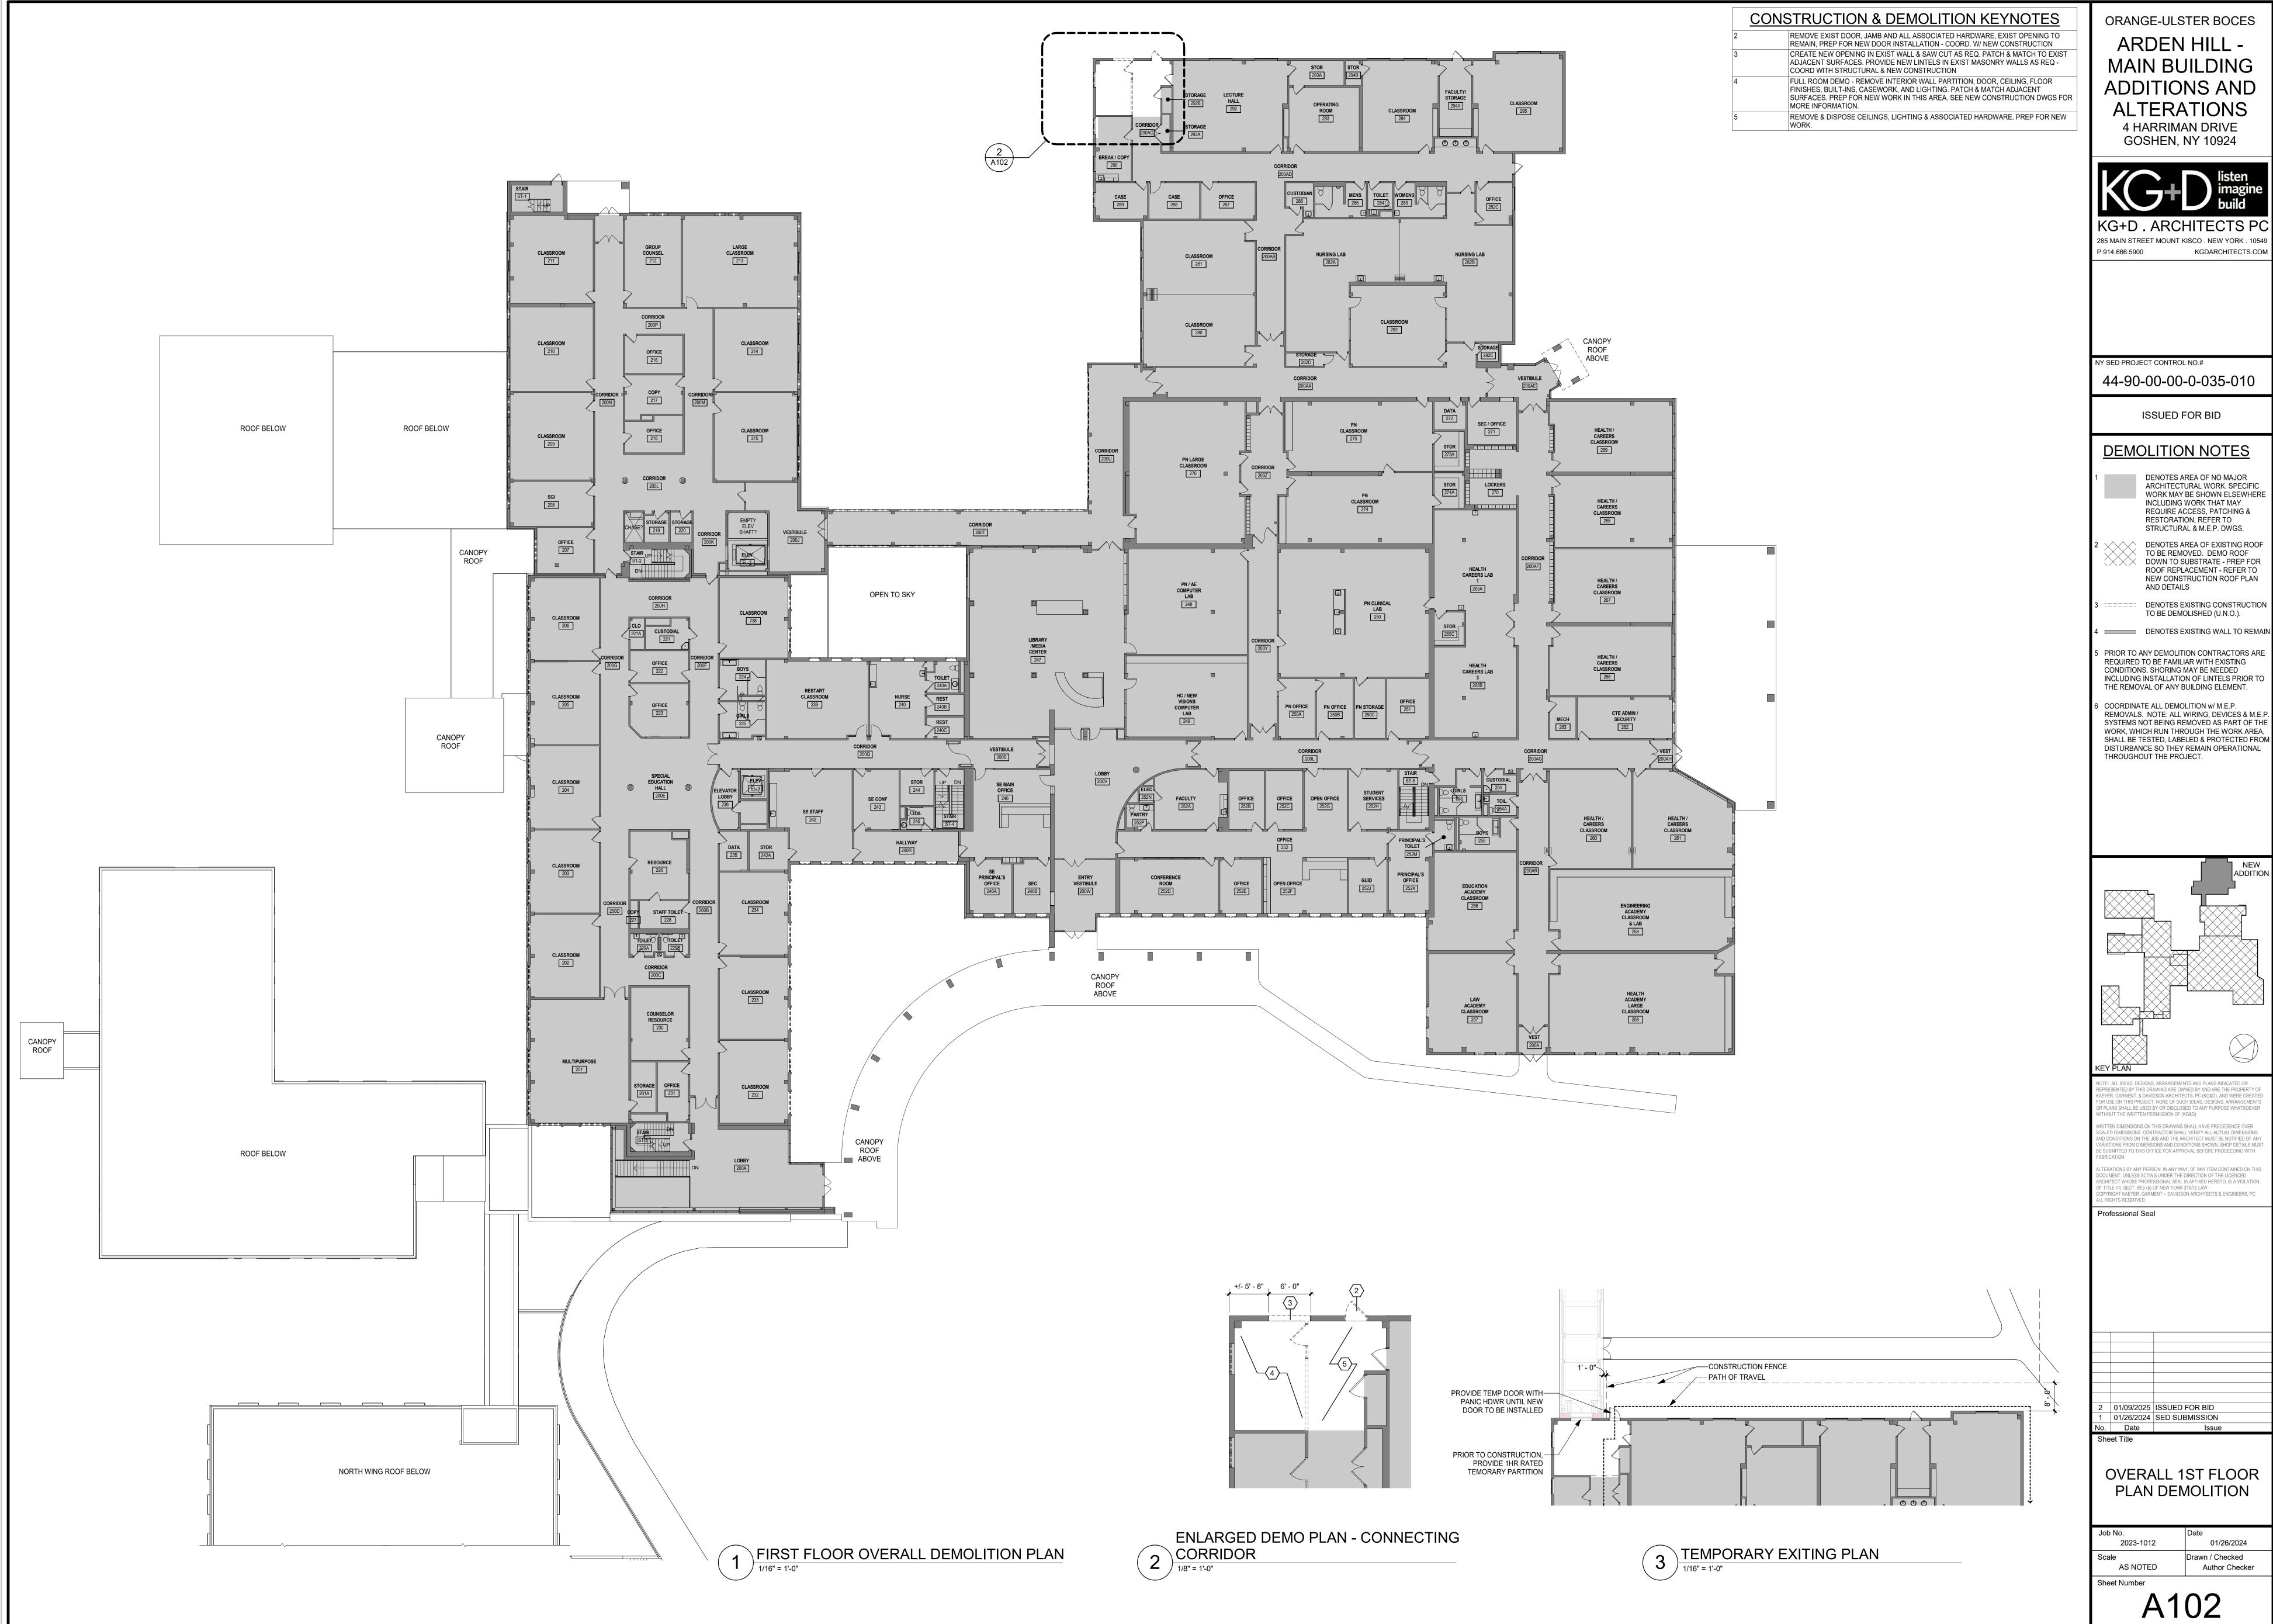
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Date Issue

STRUCTURAL STEEL **DETAILS**

01/26/2024 44-90-00-00-0-035-010 Drawn / Checked WRB/JB WRB

S-503

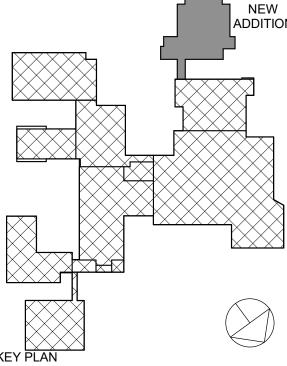


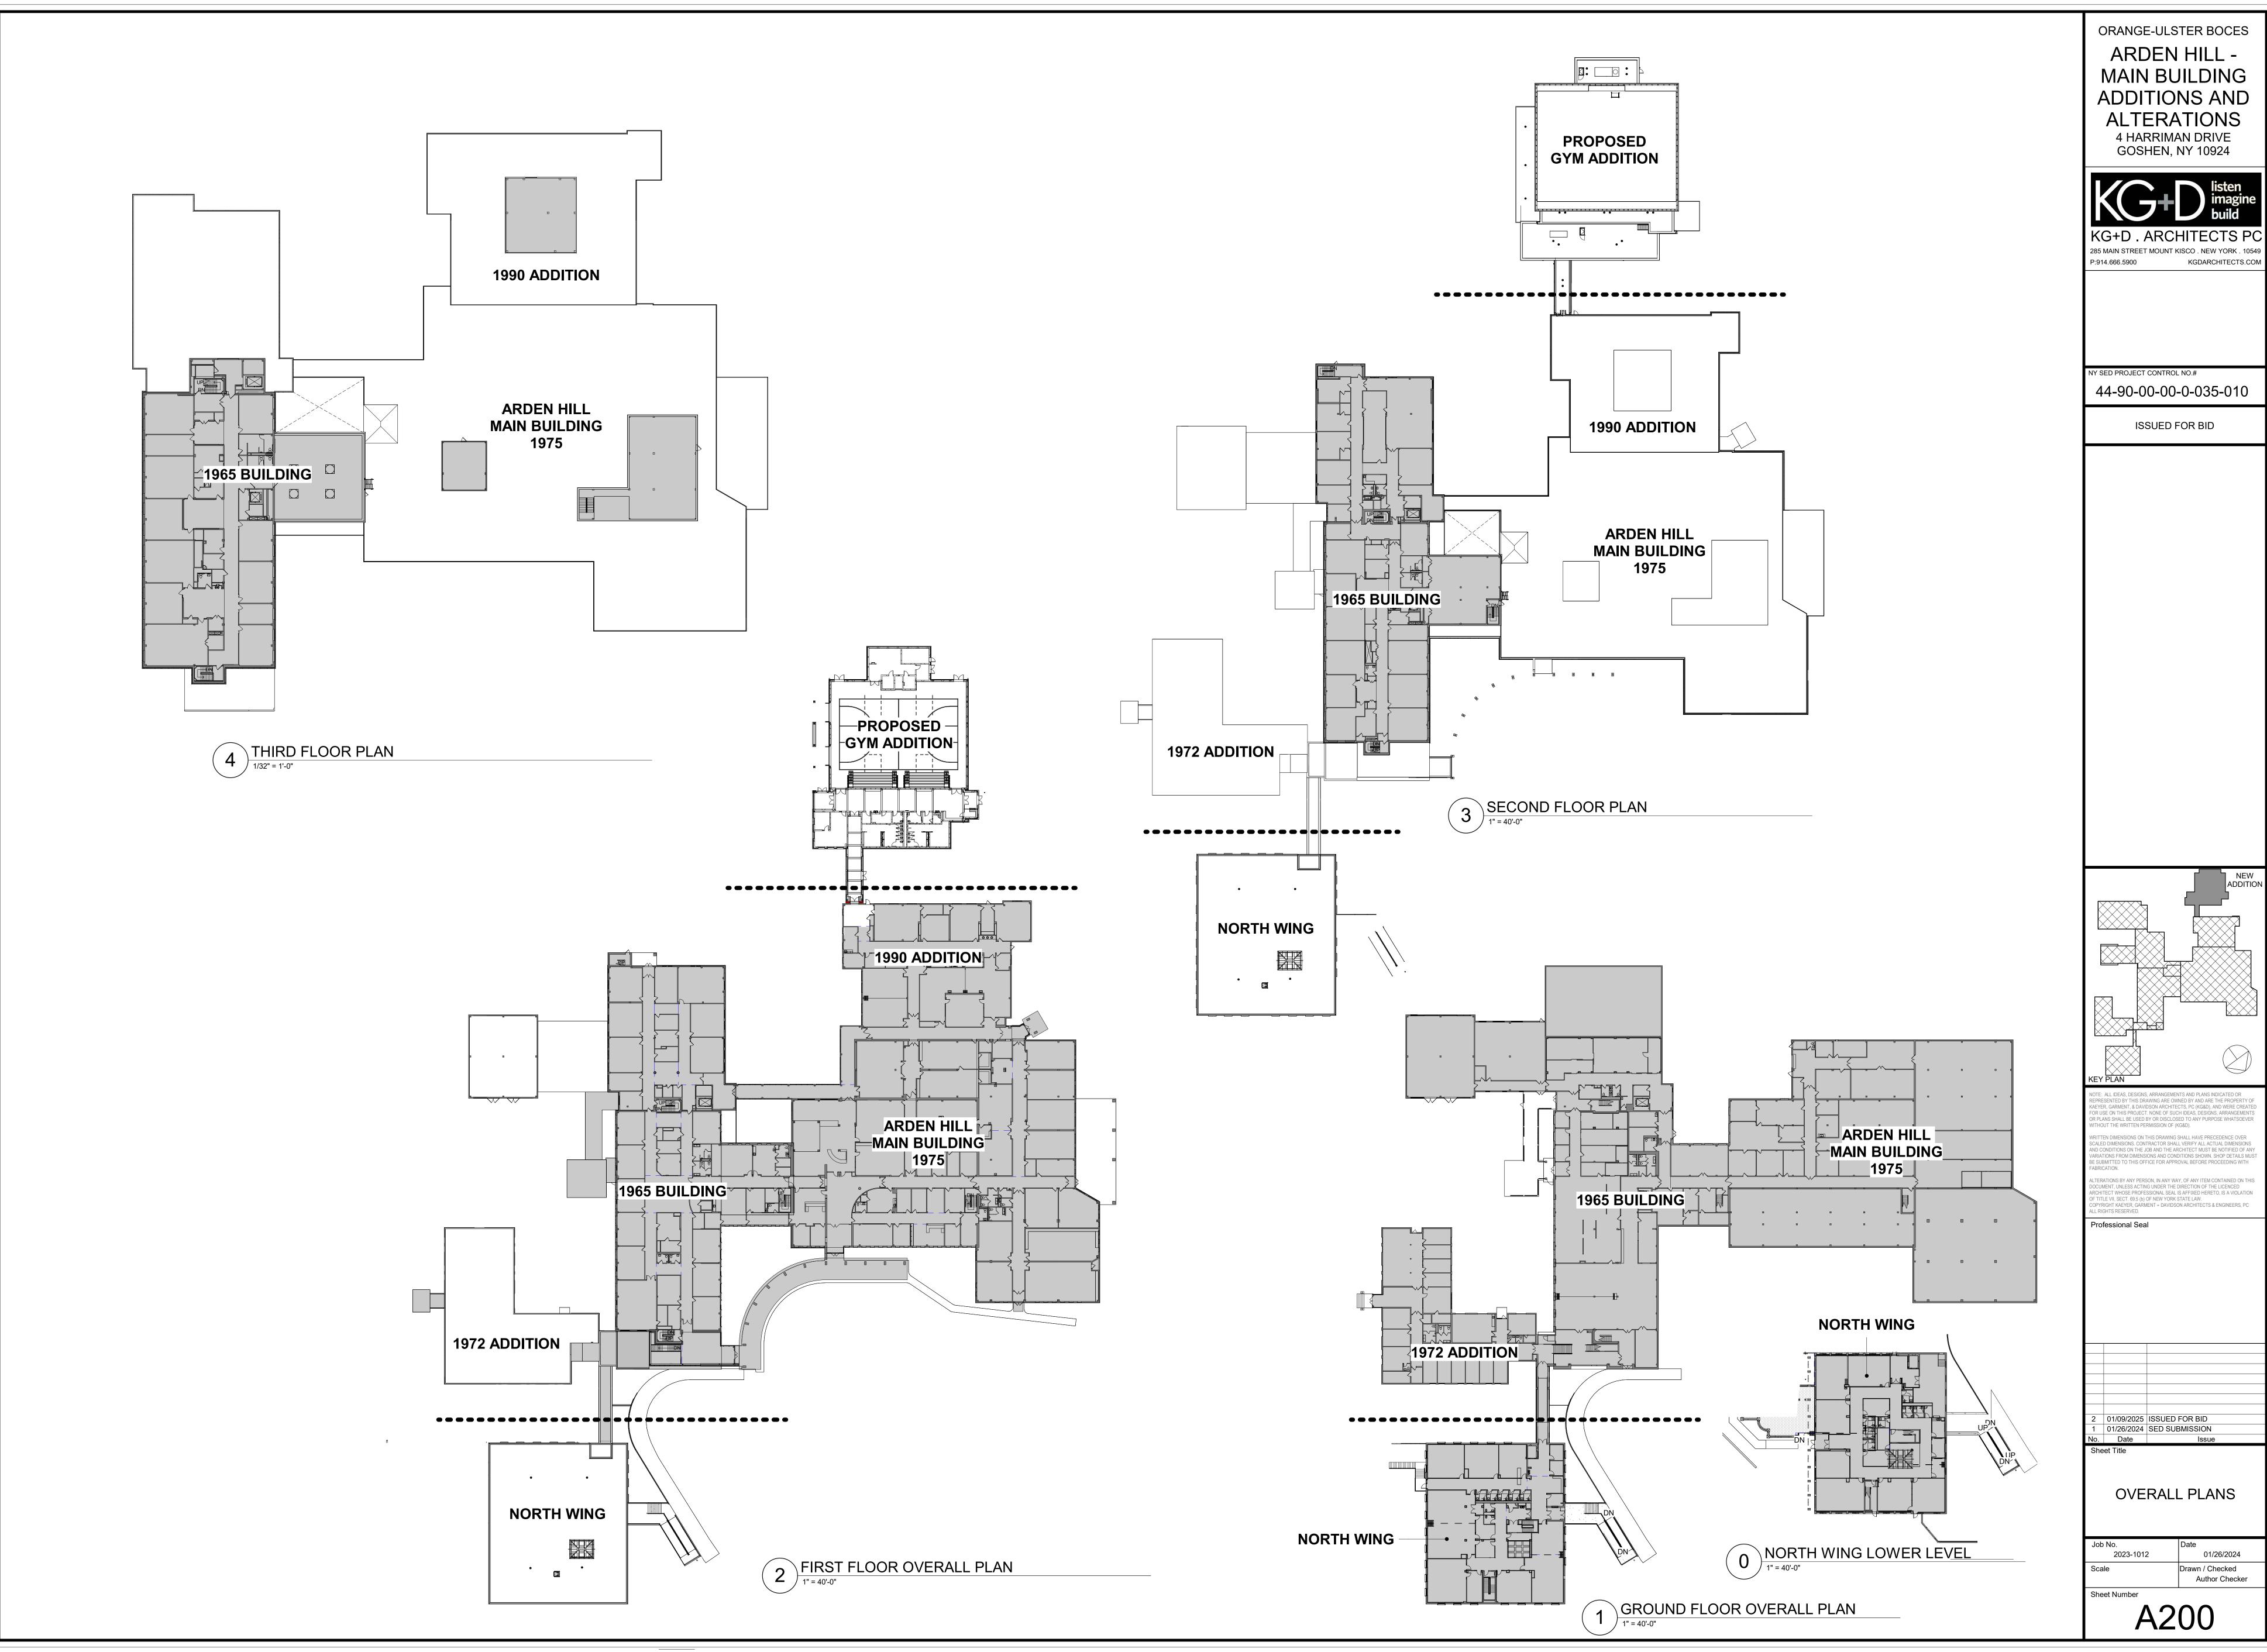


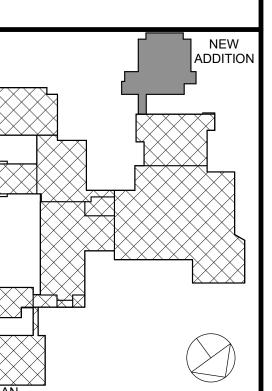
WORK MAY BE SHOWN ELSEWHERE

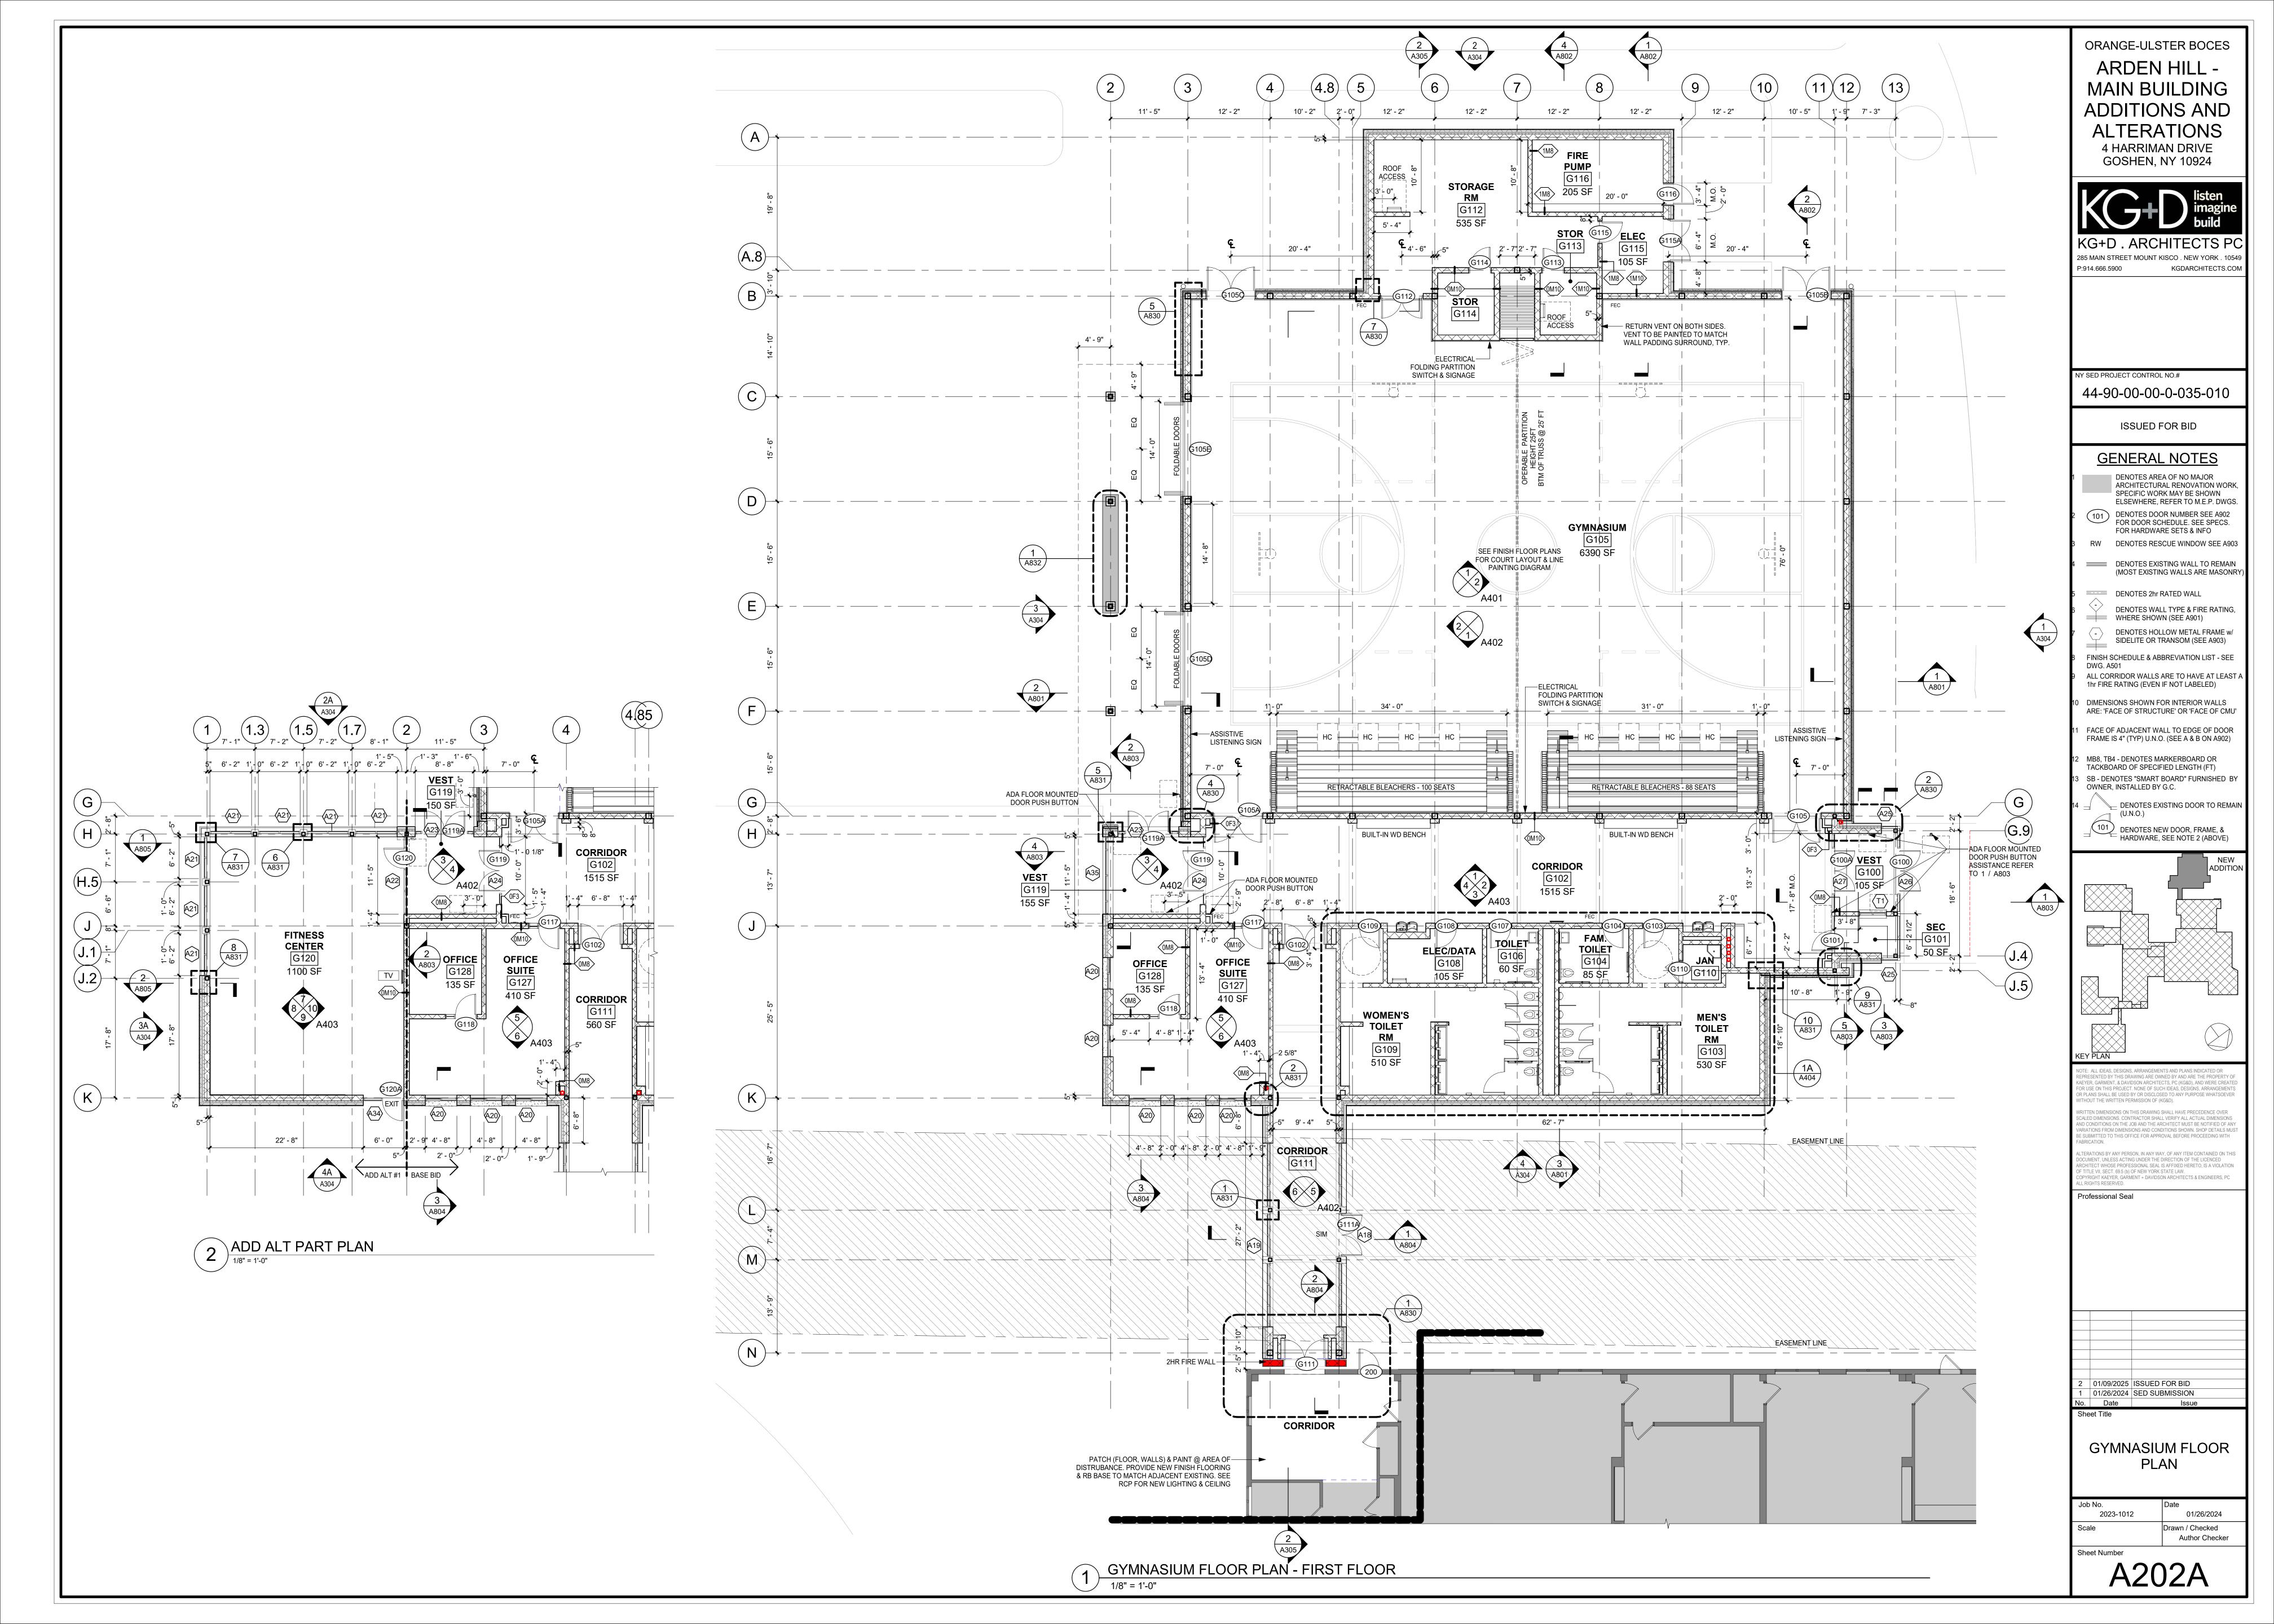
INCLUDING INSTALLATION OF LINTELS PRIOR TO

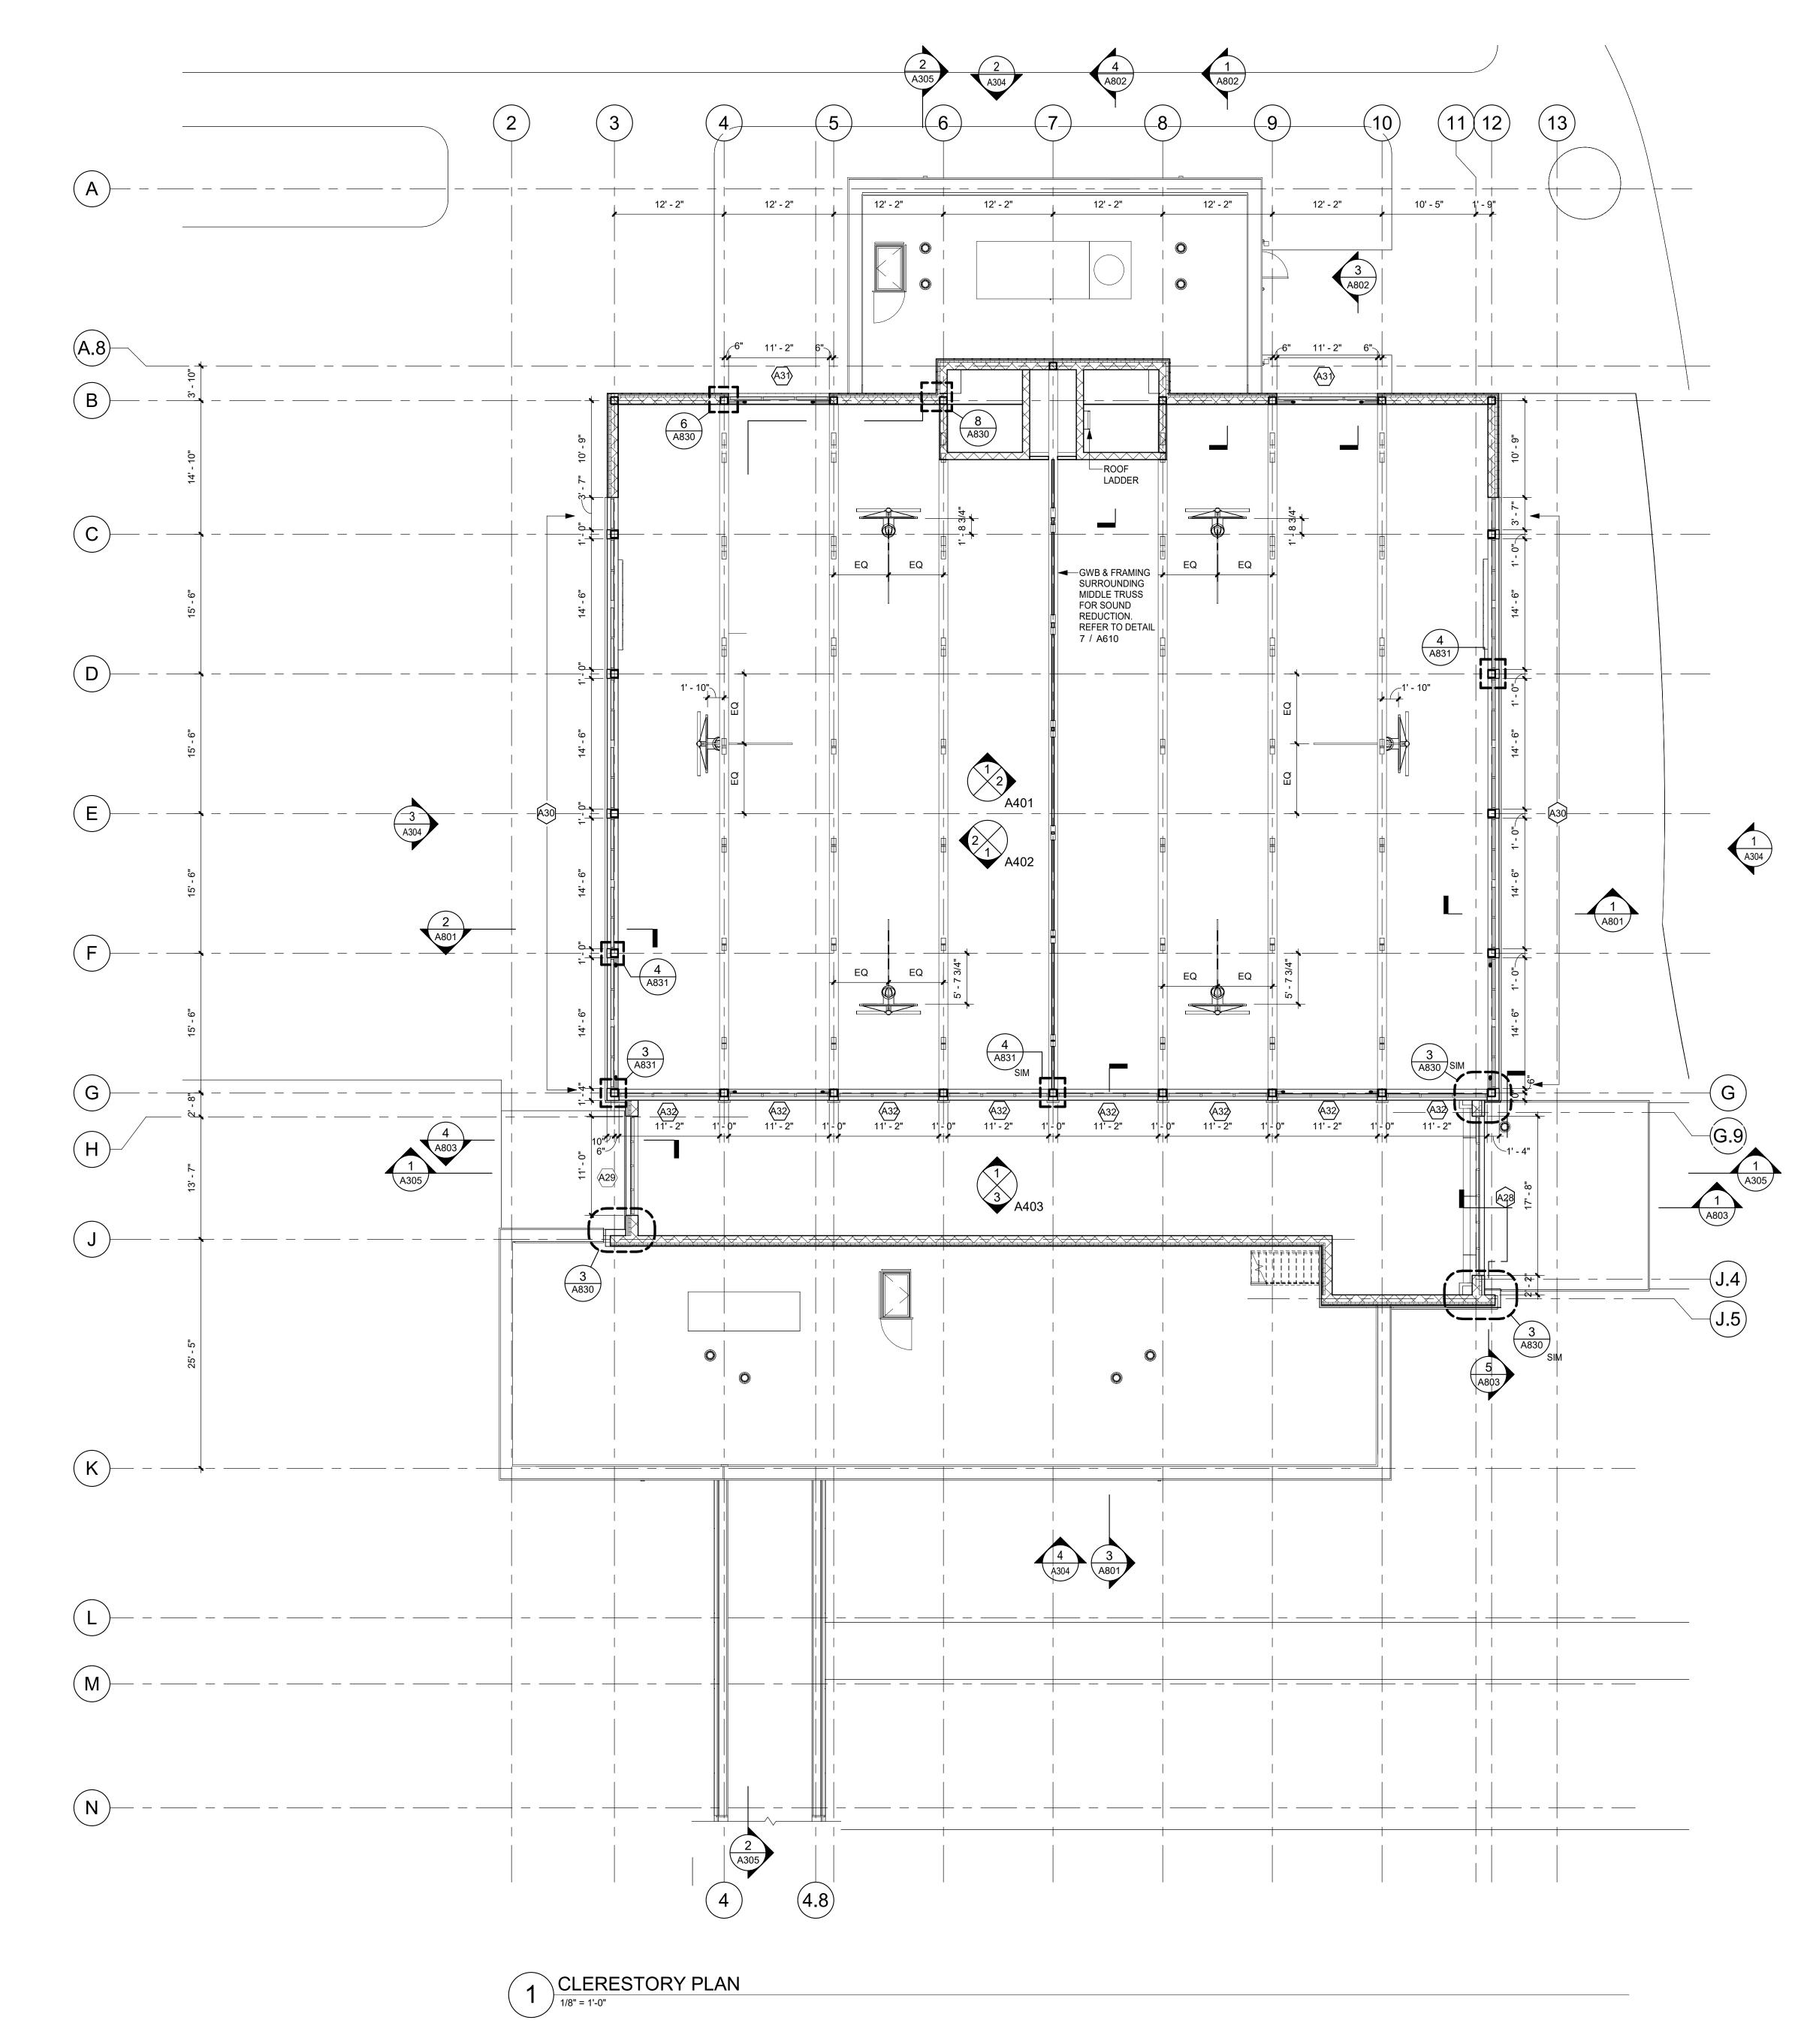
SYSTEMS NOT BEING REMOVED AS PART OF THE











ORANGE-ULSTER BOCES ARDEN HILL -MAIN BUILDING

ADDITIONS AND ALTERATIONS 4 HARRIMAN DRIVE GOSHEN, NY 10924



285 MAIN STREET MOUNT KISCO . NEW YORK . 10549 P:914.666.5900 KGDARCHITECTS.COM

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GENERAL NOTES

DENOTES AREA OF NO MAJOR ARCHITECTURAL RENOVATION WORK, SPECIFIC WORK MAY BE SHOWN ELSEWHERE, REFER TO M.E.P. DWGS.

DENOTES DOOR NUMBER SEE A902 FOR DOOR SCHEDULE. SEE SPECS. FOR HARDWARE SETS & INFO

RW DENOTES RESCUE WINDOW SEE A903

DENOTES EXISTING WALL TO REMAIN (MOST EXISTING WALLS ARE MASONRY)

==== DENOTES 2hr RATED WALL

DENOTES WALL TYPE & FIRE RATING, WHERE SHOWN (SEE A901) DENOTES HOLLOW METAL FRAME w/ SIDELITE OR TRANSOM (SEE A903)

FINISH SCHEDULE & ABBREVIATION LIST - SEE DWG. A501

1hr FIRE RATING (EVEN IF NOT LABELED)

ALL CORRIDOR WALLS ARE TO HAVE AT LEAST

DIMENSIONS SHOWN FOR INTERIOR WALLS ARE: 'FACE OF STRUCTURE' OR 'FACE OF CMU'

FACE OF ADJACENT WALL TO EDGE OF DOOR FRAME IS 4" (TYP) U.N.O. (SEE A & B ON A902)

MB8, TB4 - DENOTES MARKERBOARD OR TACKBOARD OF SPECIFIED LENGTH (FT)

SB - DENOTES "SMART BOARD" FURNISHED BY OWNER, INSTALLED BY G.C.

4 🚽 🔪 DENOTES EXISTING DOOR TO REMAIN (U.N.O.)

101 DENOTES NEW DOOR, FRAME, & HARDWARE, SEE NOTE 2 (ABOVE)

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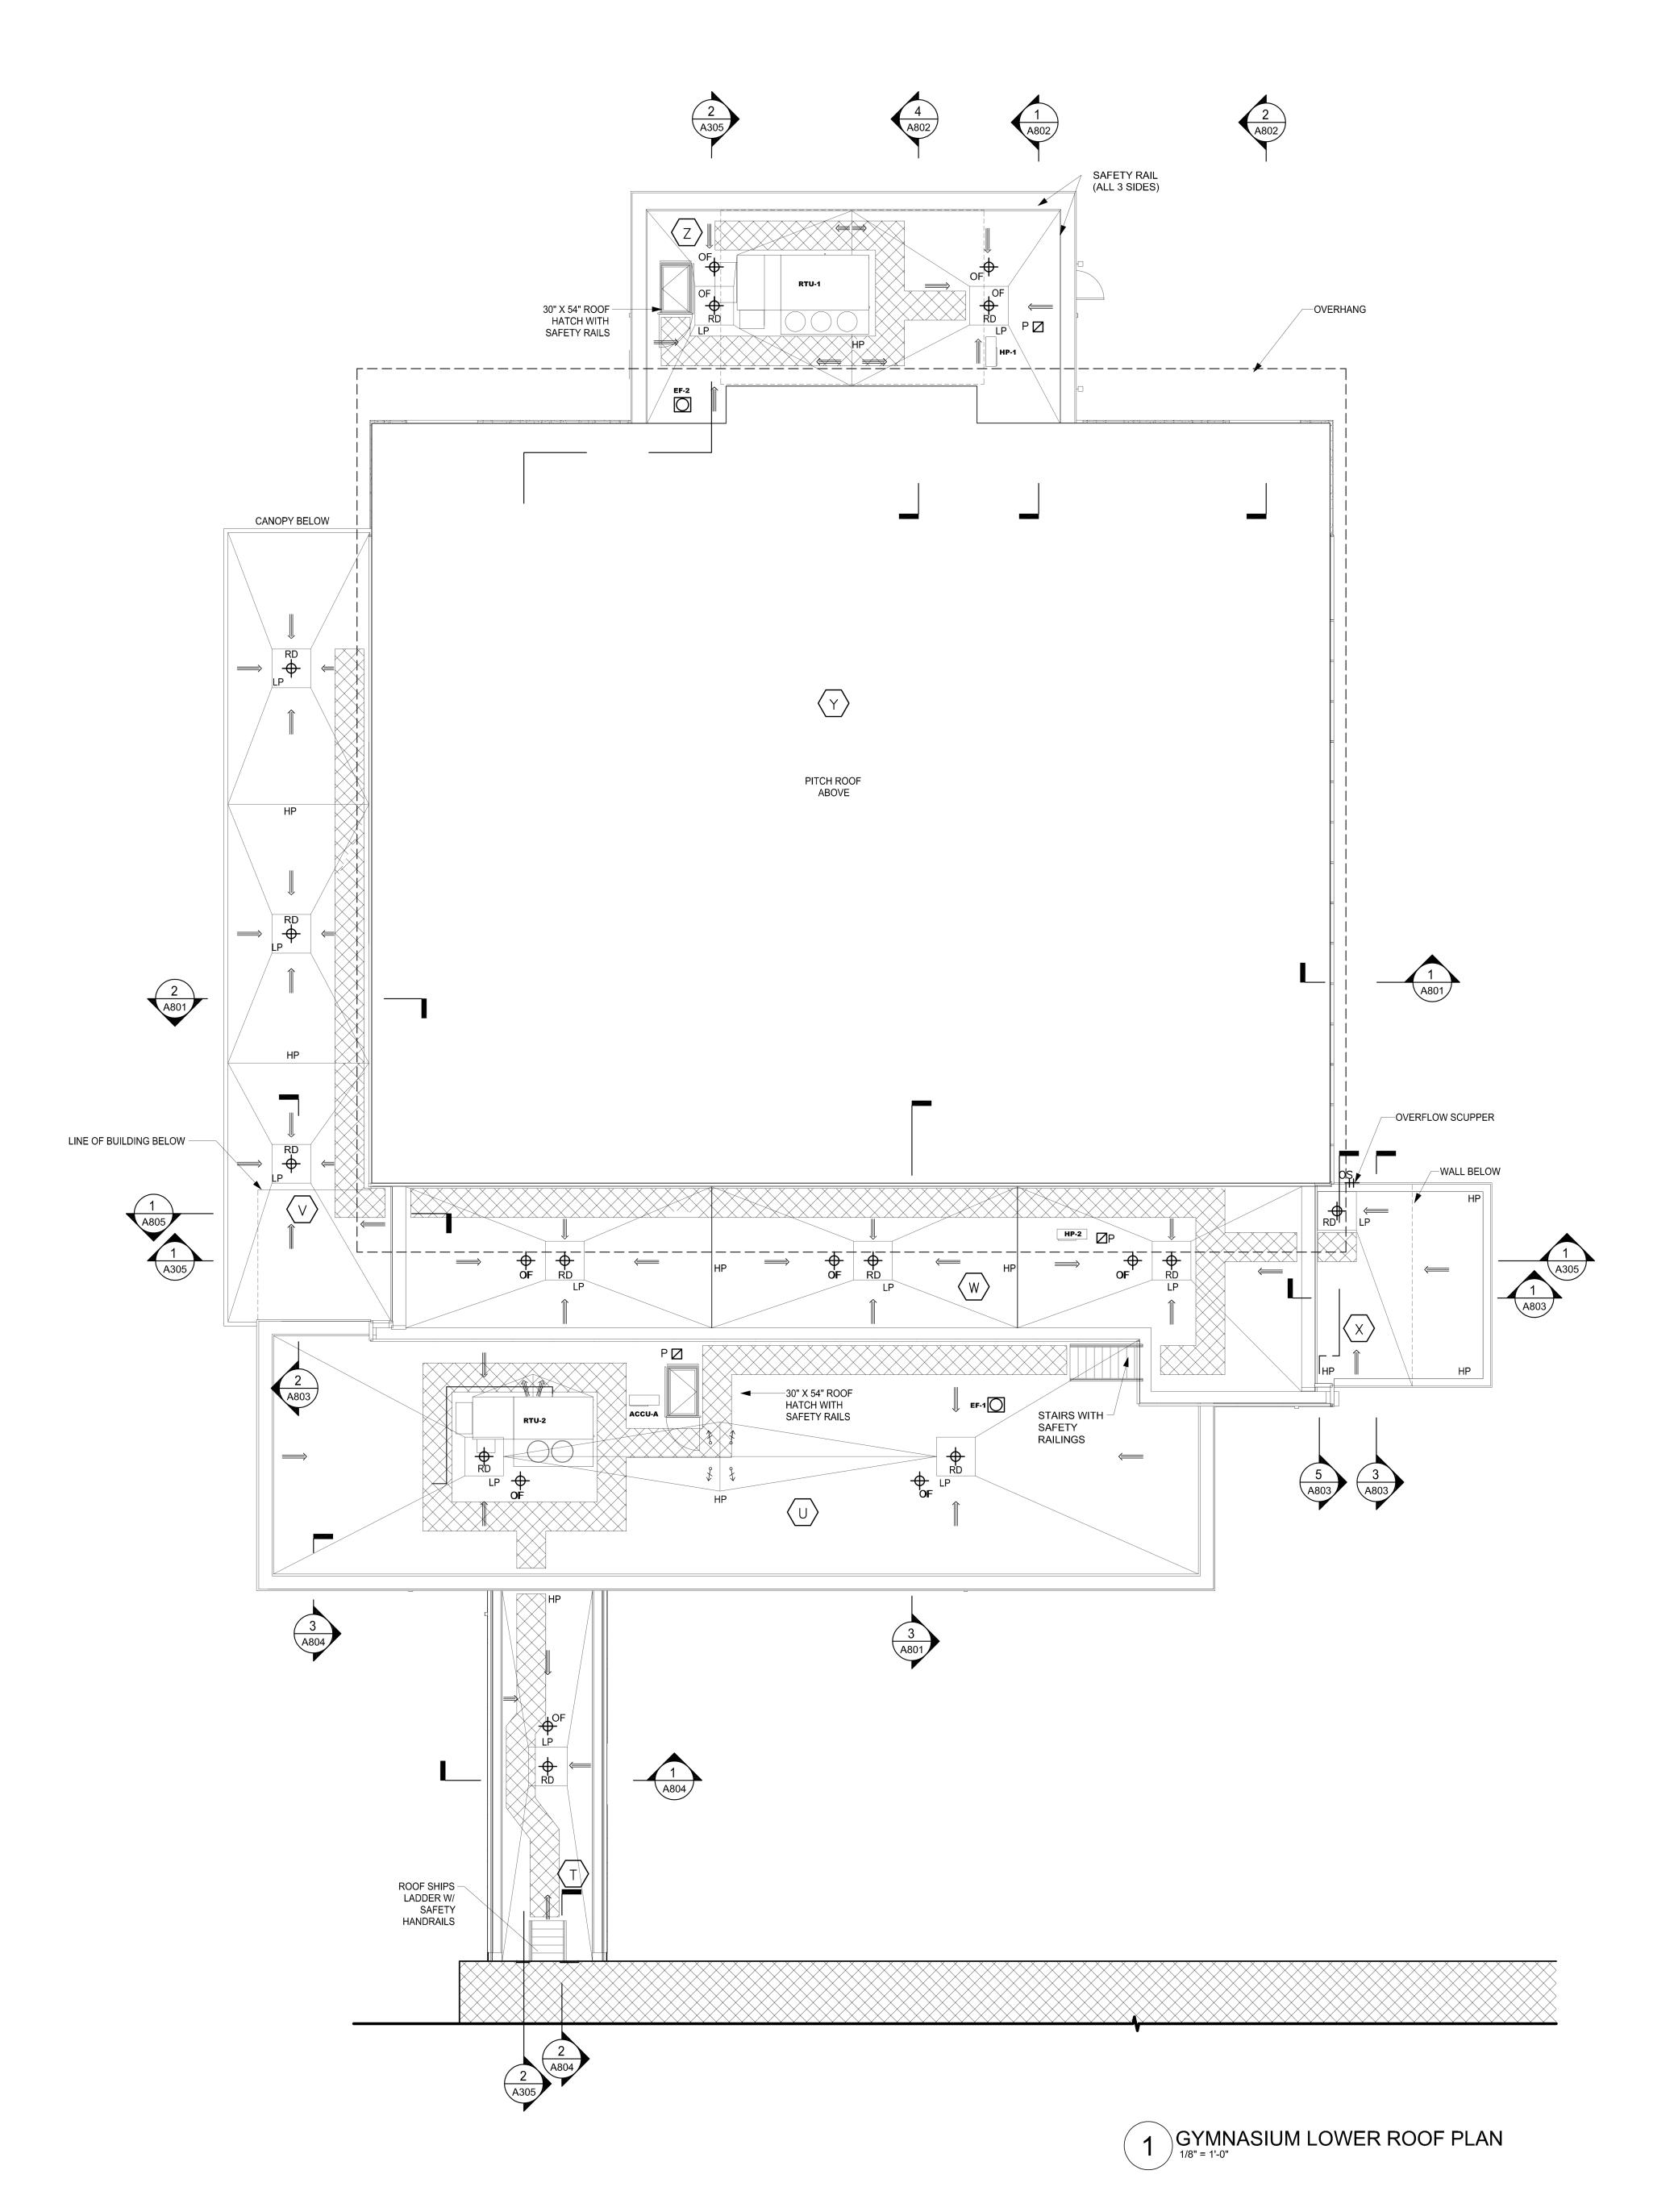
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> GYMNASIUM **CLERESTORY PLAN**

2023-1012 01/26/2024 Drawn / Checked Author Checker



GENERAL NOTES:

WORK ON THE NEW ADDITIONS IS SHOWN ON SEPARATE DRAWINGS.

THESE DRAWINGS ARE SUPPLEMENTED BY DETAILED TECHNICAL SPECIFICATIONS. PERFORM THE WORK AS SHOWN ON THE DRAWINGS AND AS DESCRIBED IN THE SPECIFICATIONS.

2. DIMENSIONS AND CONDITIONS ON THE ROOF PLAN AND DETAILS ARE APPROXIMATE AND SHALL BE CONFIRMED BY THE CONTRACTOR.

3. ONLY CERTAIN FASTENERS ARE SHOWN ON THE DRAWINGS, REFER TO THE SPECIFICATIONS FOR ADDITIONAL FASTENER REQUIREMENTS.

LIGHTNING PROTECTION COMPONENTS & CABLES ARE NOT SHOWN; REFER TO THE M/E DRAWINGS.

4. ROOF TOP EQUIPMENT IS NOT SHOWN REFER TO THE M/E DRAWINGS.

CODE COMPLIANCE REQUIREMENTS:

1. INSTALL NEW ROOFING TO MEET THE FOLLOWING MINIMUM REQUIREMENTS: A. NEW YORK STATE UNIFORM FIRE PREVENTION AND BUILDING CODE, WHICH INCLUDES BY REFERENCE THE NEW YORK STATE ENERGY CONSERVATION CODE.

B. UNDERWRITERS LABORATORIES INC. CLASS A EXTERNAL FIRE RATING FOR ROOF ASSEMBLIES TESTED IN ACCORDANCE WITH ASTM E 108 OR UL 790.

C. UNDERWRITERS LABORATORIES INC. STANDARD 1256 FOR ROOF ASSEMBLIES WITH FOAM INSULATION.

2. INSTALL ROOFING TO COMPLY WITH THE WIND UPLIFT REQUIREMENTS OF THE NY STATE UNIFORM FIRE PREVENTION AND BUILDING CODE, BASED ON THIS **CRITERIA:**

RISK CATEGORY III BASIC WIND SPEED 130 MPH EXPOSURE CATEGORY B BUILDING HEIGHT 30 FT.

3. INSTALL ROOFING AS INDICATED TO RESIST THE FOLLOWING UPLIFT LOADS, CALCULATED IN ACCORDANCE WITH ASCE 7 USING A SAFETY FACTOR OF 2: FIELD ZONE: 60 PSF PERIMETER ZONE: 100 PSF CORNER ZONE: 150 PSF

4. FABRICATE AND INSTALL ROOF PERIMETER FLASHINGS THAT COMPLY WITH THE NY STATE UNIFORM FIRE PREVENTION AND BUILDING CODE AND WITH ANSI/SPRI ES-1 "WIND STANDARD FOR EDGE SYSTEMS USED WITH LOW SLOPE ROOFING SYSTEMS", ON A BUILDING USING THE CRITERIA DESCRIBED ABOVE.

5. FABRICATE AND INSTALL WOOD BLOCKING COMPONENTS TO RESIST A FORCE OF 275 POUNDS PER LINEAL FOOT APPLIED IN ANY DIRECTION.

ROOF PROTECTION NOTES:

1. AVOID WALKING ON NEW AND EXISTING ROOF AREAS.

2. DO NOT STORE MATERIAL OR EQUIPMENT, AND DO NOT PILE DEBRIS ON NEW AND EXISTING ROOF AREAS. 3. INSTALL 1 INCH THICK EXTRUDED POLYSTYRENE INSULATION OVER 6

MIL FIRE RETARDANT POLYETHYLENE, COVERED WITH 2x10 WOOD PLANKS TO PROTECT ROOFING WHERE CONSTRUCTION WORK AND TRAFFIC WILL OCCUR.

4. NEATLY CUT AND POSITION ROOF PROTECTION COMPONENTS TO FIT WITHIN 1/2 INCH OF ROOF PENETRATIONS, EAVES AND CHANGE IN

5. DO NOT COVER THE ROOF DRAINS. MAINTAIN THE ROOF DRAIN STRAINERS VISIBLE AND CLEAR AT ALL TIMES.

DECK TYPE CHART & INSULATION REQUIREMENTS ROOF AREA STARTING THICKNESS MINIMUM R-VALUE DECK TYPE OF NEW INSULATION OF NEW INSULATION METAL DECK 30 5.5" U METAL DECK 5.5" 30 5.5" 30 V METAL DECK 30 W METAL DECK 5.5" 30 X METAL DECK 5.5"

8.0" 5.5" 30

30

Z METAL DECK

METAL DECK

I.INSTALL CONTINUOUS INSULATION WITH A MINIMUM R-VALUE OF 30 ABOVE THE DECK, TO MEET THE NYS ENERGY CONSERVATION CONSTRUCTION CODE, INCLUDING THE INTERNATIONAL ENERGY CONSERVATION CODE AND THE NY STATE SUPPLEMENT, FOR A BUILDING IN CLIMATE ZONE 5.

2.INSTALL TAPERED ISOCYANURATE INSULATION THAT SLOPES 1/4 INCH PER FOOT; MINIMUM STARTING THICKNESS 5-1/2 INCHES UNLESS OTHERWISE NOTED. INSTALL THE ISOCYANURATE INSULATION IN MULTIPLE LAYERS, WITH THE THICKEST LAYER BEING 4 INCHES. STAGGER ALL JOINTS BETWEEN LAYERS 12 INCHES.

3.INSTALL ISOCYANURATE INSULATION CRICKETS UNDER THE TAPERED INSULATION.

4.INSTALL A COVER BOARD USING LOW RISE FOAM ADHESIVE OVER

THE INSULATION AND CRICKETS. 5.INSTALL SLOPING CRICKETS ON THE UP-HILL SIDE OF ALL CURBS THAT ARE 30 INCHES AND WIDER.

LEGEND:

ROOF AREA DESIGNATION

EXPANSION JOINT (SEE DET. 29&30/A252 ROOF DRAIN (SEE DET. 35/A252)

OVER FLOW DRAIN (SEE DET. 35/A252 SIM) VENT PIPE o V (SEE DET. 36/A52)

ROOF HATCH

HVAC CURB

(SEE DET. 38/A253) PORTALS PLUS (SEE DET. 39/A253)

> HVAC (SEE DET. 40/A253) EXHAUST FAN (SEE DET. 44/A253)

±OS OVERFLOW SCUPPER (SEE DET. 45/A253)) SCUPPER AND LEADER HEAD

(SEE DET. 46/A253) GUARD RAIL (SEE DET. 50/A254)

→ → NEW GUARD RAIL (SEE DET. 53/A254)

 \longrightarrow DECK SLOPE

TAPERED ISOCYANURATE INSULATION, SLOPE 1/4" PER FT

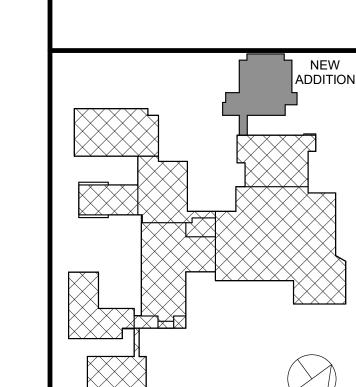
°→ CRICKET- SLOPE 1/2" PER FT

H.P. INSULATION HIGH POINT

WALKWAY PADS

NEW ROOF STAIR

(SEE DET. 7/A806) ‡OSOVERFLOW SCUPPER
(SEE DET. 9/A806



ORANGE-ULSTER BOCES

ARDEN HILL -

MAIN BUILDING

ADDITIONS AND

ALTERATIONS

4 HARRIMAN DRIVE GOSHEN, NY 10924

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CONDITIONS ON THE JOB AND THE ARCHITECT MUST BE NOTIFIED OF A

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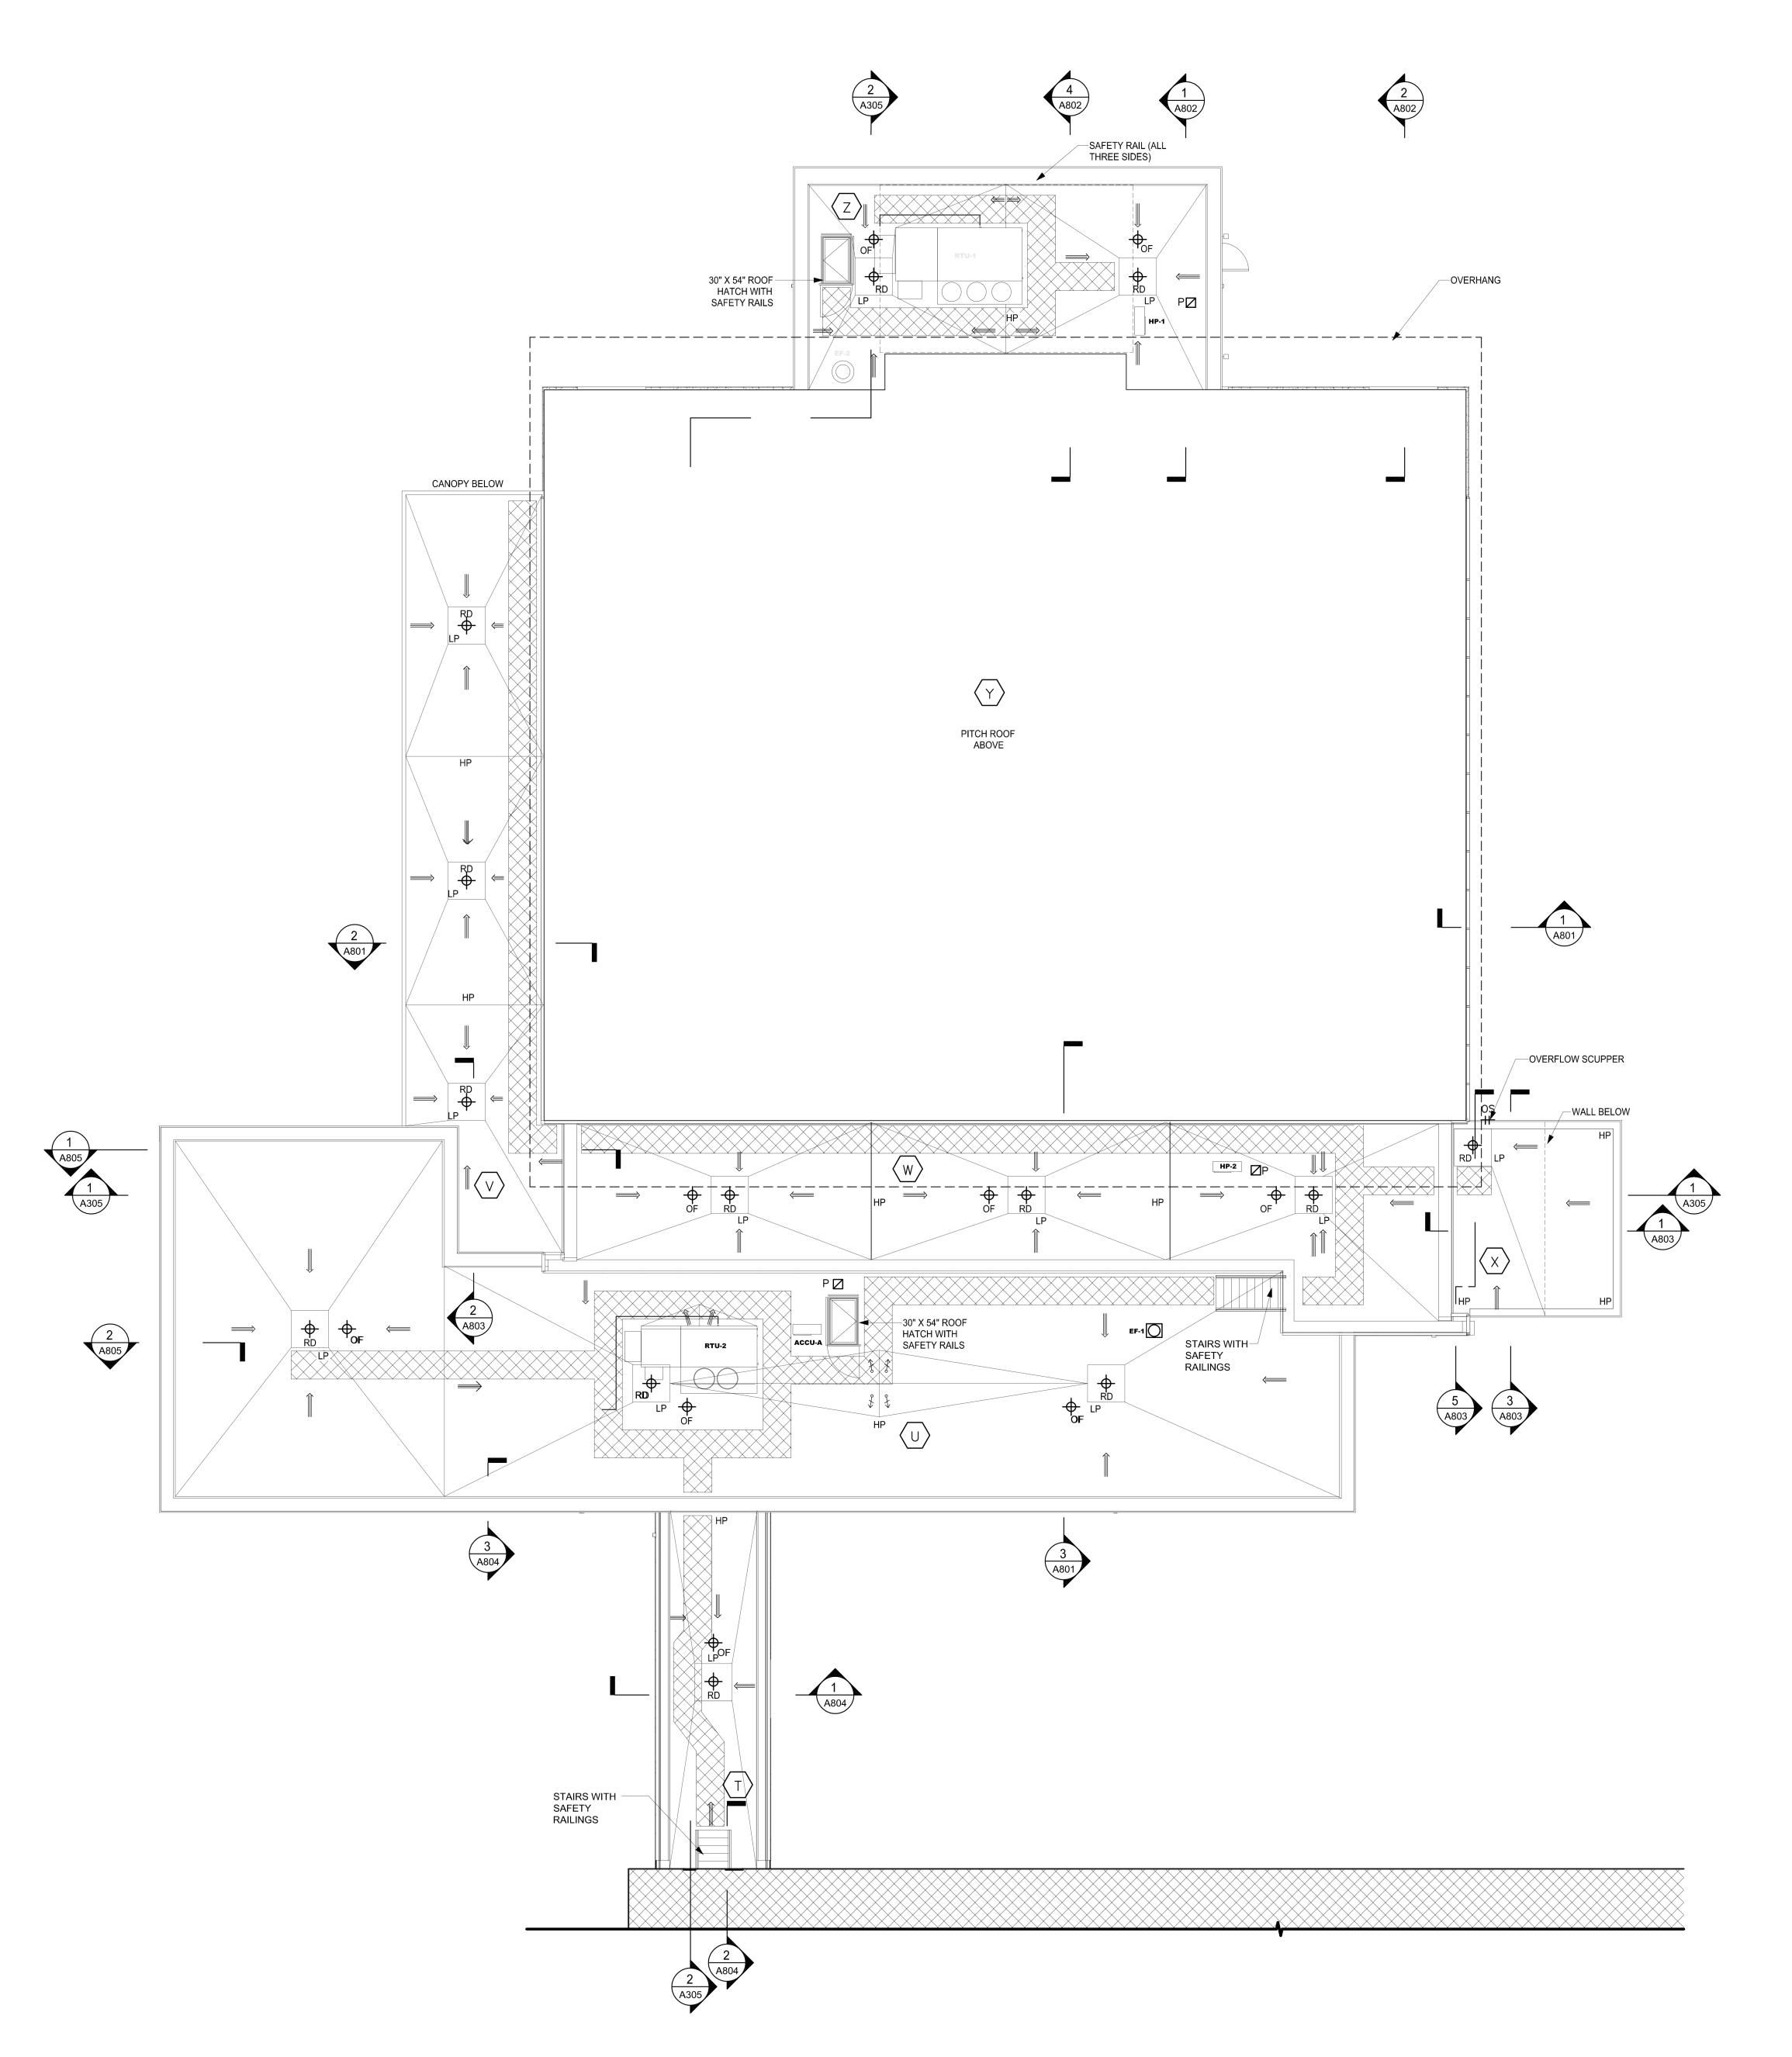
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GYMNASIUM LOWER ROOF PLAN (BASE BID)

01/26/2024 2023-1012 Drawn / Checked Author Checker

A205



GENERAL NOTES:

1. THESE DRAWINGS ARE SUPPLEMENTED BY DETAILED TECHNICAL SPECIFICATIONS. PERFORM THE WORK

2. DIMENSIONS AND CONDITIONS ON THE ROOF PLAN AND DETAILS ARE APPROXIMATE AND SHALL BE

3. ONLY CERTAIN FASTENERS ARE SHOWN ON THE DRAWINGS, REFER TO THE SPECIFICATIONS FOR ADDITIONAL FASTENER REQUIREMENTS.

5. ROOF TOP EQUIPMENT IS NOT SHOWN REFER TO THE M/E DRAWINGS.

CODE COMPLIANCE REQUIREMENTS:

1. INSTALL NEW ROOFING TO MEET THE FOLLOWING MINIMUM REQUIREMENTS: A. NEW YORK STATE UNIFORM FIRE PREVENTION AND BUILDING CODE, WHICH INCLUDES BY REFERENCE THE NEW YORK STATE ENERGY CONSERVATION CODE.

B. UNDERWRITERS LABORATORIES INC. CLASS A EXTERNAL FIRE RATING FOR ROOF ASSEMBLIES TESTED IN ACCORDANCE WITH ASTM E 108 OR UL 790.

C. UNDERWRITERS LABORATORIES INC. STANDARD 1256 FOR ROOF ASSEMBLIES WITH FOAM INSULATION.

2. INSTALL ROOFING TO COMPLY WITH THE WIND UPLIFT REQUIREMENTS OF THE NY STATE UNIFORM FIRE PREVENTION AND BUILDING CODE, BASED ON THIS

RISK CATEGORY III BASIC WIND SPEED 130 MPH EXPOSURE CATEGORY B

BUILDING HEIGHT 30 FT. 3. INSTALL ROOFING AS INDICATED TO RESIST THE FOLLOWING UPLIFT LOADS, CALCULATED IN ACCORDANCE WITH ASCE 7 USING A SAFETY FACTOR OF 2:

PERIMETER ZONE: 100 PSF CORNER ZONE: 150 PSF

4. FABRICATE AND INSTALL ROOF PERIMETER FLASHINGS THAT COMPLY WITH THE NY STATE UNIFORM FIRE PREVENTION AND BUILDING CODE AND WITH ANSI/SPRI ES-1 "WIND STANDARD FOR EDGE SYSTEMS USED WITH LOW SLOPE ROOFING SYSTEMS", ON A BUILDING USING THE CRITERIA DESCRIBED ABOVE.

5. FABRICATE AND INSTALL WOOD BLOCKING COMPONENTS TO RESIST A FORCE OF 275 POUNDS PER LINEAL FOOT APPLIED IN ANY DIRECTION.

ROOF PROTECTION NOTES:

1. AVOID WALKING ON NEW AND EXISTING ROOF AREAS.

2. DO NOT STORE MATERIAL OR EQUIPMENT, AND DO NOT PILE DEBRIS ON NEW AND EXISTING ROOF AREAS.

3. INSTALL 1 INCH THICK EXTRUDED POLYSTYRENE INSULATION OVER 6 MIL FIRE RETARDANT POLYETHYLENE, COVERED WITH 2x10 WOOD PLANKS TO PROTECT ROOFING WHERE CONSTRUCTION WORK AND TRAFFIC WILL OCCUR.

4. NEATLY CUT AND POSITION ROOF PROTECTION COMPONENTS TO FIT WITHIN 1/2 INCH OF ROOF PENETRATIONS, EAVES AND CHANGE IN ELEVATION WALLS.

5. DO NOT COVER THE ROOF DRAINS. MAINTAIN THE ROOF DRAIN STRAINERS VISIBLE AND CLEAR AT ALL TIMES.

DECK TYPE CHART & INSULATION REQUIREMENTS

ROOF AREA	DECK TYPE	STARTING THICKNESS OF NEW INSULATION	
Т	METAL DECK	5.5"	30
U	METAL DECK	5.5"	30
٧	METAL DECK	5.5"	30
W	METAL DECK	5.5"	30
Х	METAL DECK	5.5"	30
Υ	METAL DECK	8.0"	30
Z	METAL DECK	5.5"	30

1.INSTALL CONTINUOUS INSULATION WITH A MINIMUM R-VALUE OF 30 ABOVE THE DECK, TO MEET THE NYS ENERGY CONSERVATION CONSTRUCTION CODE, INCLUDING THE INTERNATIONAL ENERGY CONSERVATION CODE AND THE NY STATE SUPPLEMENT, FOR A BUILDING IN CLIMATE ZONE 5.

2.INSTALL TAPERED ISOCYANURATE INSULATION THAT SLOPES 1/4 INCH PER FOOT; MINIMUM STARTING THICKNESS 5-1/2 INCHES UNLESS OTHERWISE NOTED. INSTALL THE ISOCYANURATE INSULATION IN MULTIPLE LAYERS, WITH THE THICKEST LAYER

3.INSTALL ISOCYANURATE INSULATION CRICKETS UNDER THE TAPERED INSULATION.

BEING 4 INCHES. STAGGER ALL JOINTS BETWEEN LAYERS 12

4.INSTALL A COVER BOARD USING LOW RISE FOAM ADHESIVE OVER THE INSULATION AND CRICKETS.

5.INSTALL SLOPING CRICKETS ON THE UP-HILL SIDE OF ALL CURBS THAT ARE 30 INCHES AND WIDER.

WORK ON THE NEW ADDITIONS IS SHOWN ON SEPARATE DRAWINGS.

AS SHOWN ON THE DRAWINGS AND AS DESCRIBED IN THE SPECIFICATIONS.

CONFIRMED BY THE CONTRACTOR.

4. LIGHTNING PROTECTION COMPONENTS & CABLES ARE NOT SHOWN; REFER TO THE M/E DRAWINGS.

ROOF AREA DESIGNATION EXPANSION JOINT (SEE DET. 29&30/A252 ROOF DRAIN (SEE DET. 35/A252) OVER FLOW DRAIN *O/F (SEE DET. 35/A252 SIM) VENT PIPE o ∨ (SEE DET. 36/A52) ROOF HATCH (SEE DET. 38/A253) PORTALS PLUS (SEE DET. 39/A253) HVAC CURB HVAC CURB (SEE DET. 40/A253) EXHAUST FAN (SEE DET. 44/A253)

LEGEND:

OVERFLOW SCUPPER (SEE DET. 45/A253)) SCUPPER AND LEADER HEAD (SEE DET. 46/A253) GUARD RAIL

(SEE DET. 50/A254) ← → → NEW GUARD RAIL (SEE DET. 53/A254)

→ DECK SLOPE

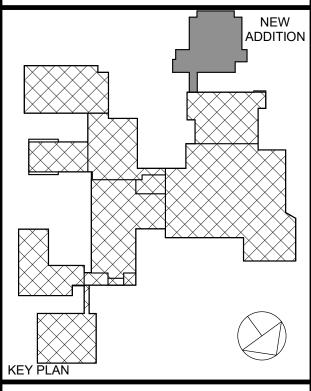
TAPERED ISOCYANURATE INSULATION, SLOPE 1/4" PER FT

_____ INSULATION HIGH POINT

WALKWAY PADS

NEW ROOF STAIR (SEE DET. 7/A806)

‡OSOVERFLOW SCUPPER
(SEE DET. 9/A806



ORANGE-ULSTER BOCES

ARDEN HILL -

MAIN BUILDING

ADDITIONS AND

ALTERATIONS

4 HARRIMAN DRIVE

GOSHEN, NY 10924

285 MAIN STREET MOUNT KISCO . NEW YORK . 10549

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CONDITIONS ON THE JOB AND THE ARCHITECT MUST BE NOTIFIED OF A

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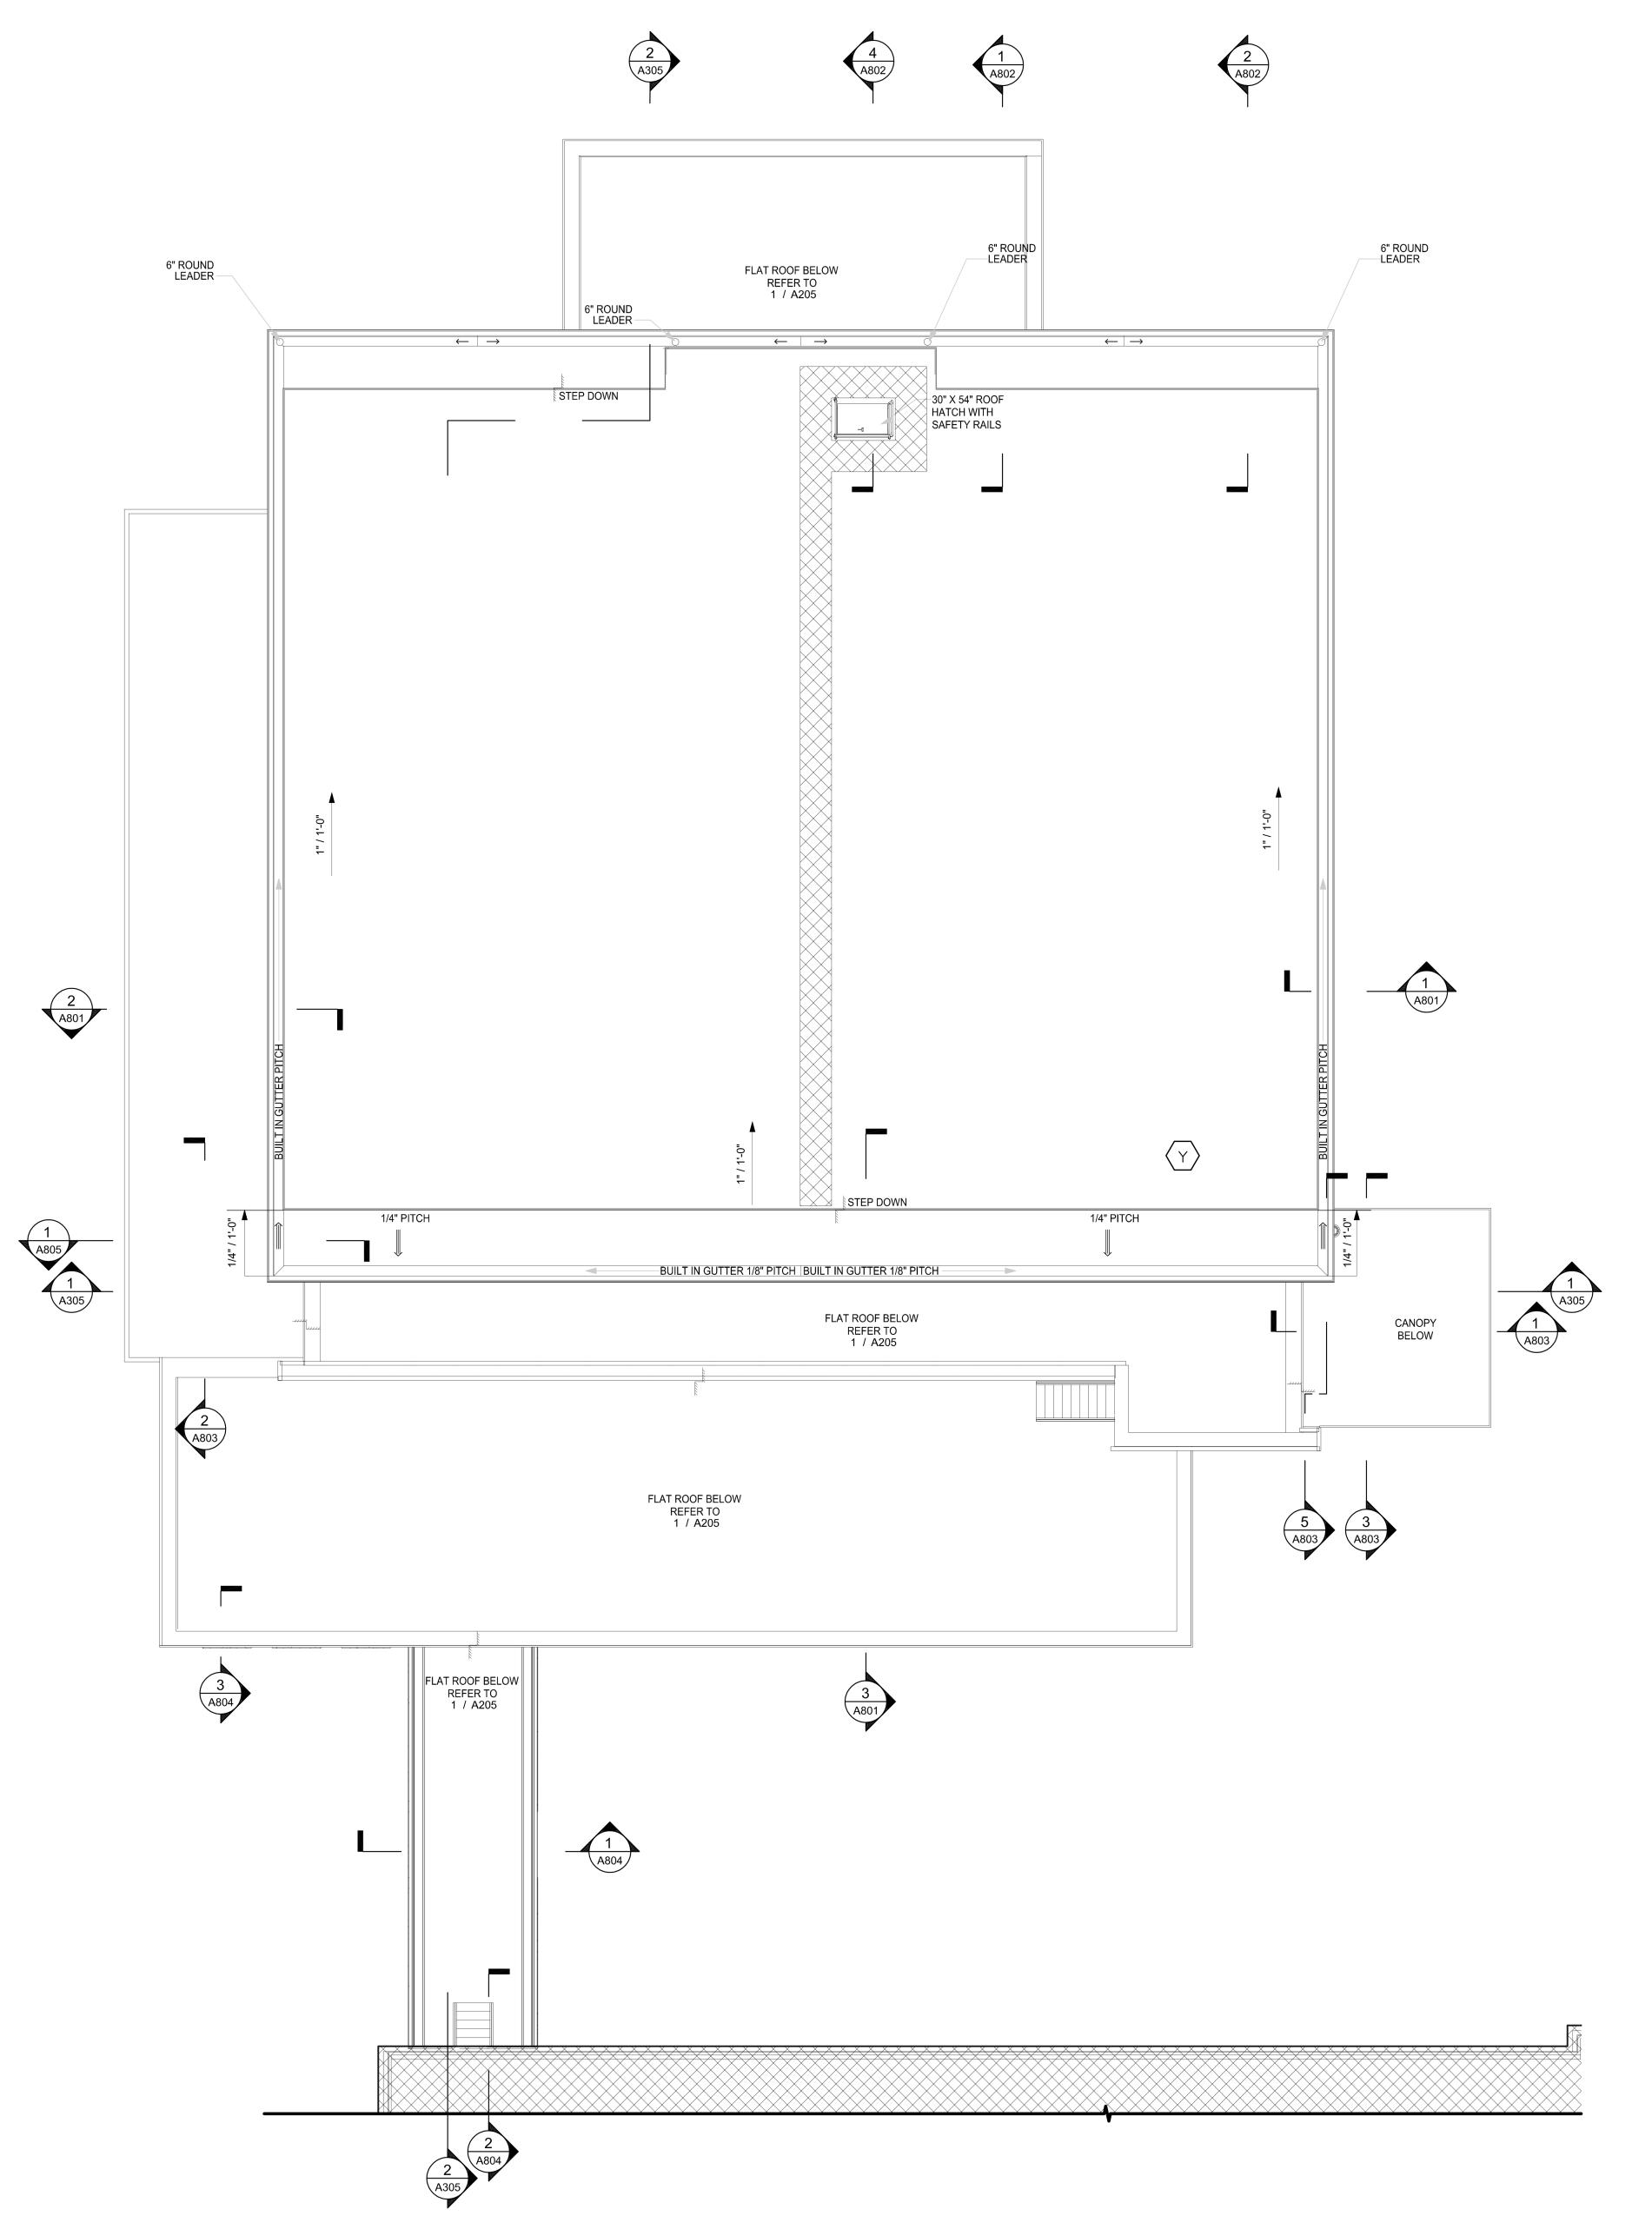
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GYMNASIUM LOWER ROOF PLAN (ADD ALT)

01/26/2024 Drawn / Checked Author Checker

A205A

GYMNASIUM LOWER ROOF PLAN (ADD ALT)



GENERAL NOTES:

WORK ON THE NEW ADDITIONS IS SHOWN ON SEPARATE DRAWINGS.

1. THESE DRAWINGS ARE SUPPLEMENTED BY DETAILED TECHNICAL SPECIFICATIONS. PERFORM THE WORK AS SHOWN ON THE DRAWINGS AND AS DESCRIBED IN THE SPECIFICATIONS.

2. DIMENSIONS AND CONDITIONS ON THE ROOF PLAN AND DETAILS ARE APPROXIMATE AND SHALL BE CONFIRMED BY THE CONTRACTOR.

3. ONLY CERTAIN FASTENERS ARE SHOWN ON THE DRAWINGS, REFER TO THE SPECIFICATIONS FOR ADDITIONAL FASTENER REQUIREMENTS.

LIGHTNING PROTECTION COMPONENTS & CABLES ARE NOT SHOWN; REFER TO THE M/E DRAWINGS.

4. ROOF TOP EQUIPMENT IS NOT SHOWN REFER TO THE M/E DRAWINGS.

CODE COMPLIANCE REQUIREMENTS:

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B. UNDERWRITERS LABORATORIES INC. CLASS A EXTERNAL FIRE RATING FOR ROOF ASSEMBLIES TESTED IN ACCORDANCE WITH ASTM E 108 OR UL 790.

C. UNDERWRITERS LABORATORIES INC. STANDARD 1256 FOR ROOF ASSEMBLIES WITH FOAM INSULATION.

2. INSTALL ROOFING TO COMPLY WITH THE WIND UPLIFT REQUIREMENTS OF THE NY STATE UNIFORM FIRE PREVENTION AND BUILDING CODE, BASED ON THIS

RISK CATEGORY III BASIC WIND SPEED 130 MPH EXPOSURE CATEGORY B BUILDING HEIGHT 30 FT.

3. INSTALL ROOFING AS INDICATED TO RESIST THE FOLLOWING UPLIFT LOADS, CALCULATED IN ACCORDANCE WITH ASCE 7 USING A SAFETY FACTOR OF 2: FIELD ZONE: 60 PSF

PERIMETER ZONE: 100 PSF CORNER ZONE: 150 PSF

4. FABRICATE AND INSTALL ROOF PERIMETER FLASHINGS THAT COMPLY WITH THE NY STATE UNIFORM FIRE PREVENTION AND BUILDING CODE AND WITH ANSI/SPRI ES-1 "WIND STANDARD FOR EDGE SYSTEMS USED WITH LOW SLOPE ROOFING SYSTEMS", ON A BUILDING USING THE CRITERIA DESCRIBED ABOVE.

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4. NEATLY CUT AND POSITION ROOF PROTECTION COMPONENTS TO FIT WITHIN 1/2 INCH OF ROOF PENETRATIONS, EAVES AND CHANGE IN ELEVATION WALLS.

5. DO NOT COVER THE ROOF DRAINS. MAINTAIN THE ROOF DRAIN STRAINERS VISIBLE AND CLEAR AT ALL TIMES.

DECK TYPE CHART & INSULATION REQUIREMENTS ROOF DECK TYPE STARTING THICKNESS MINIMUM R-VALUE OF NEW INSULATION OF NEW INSULATION T METAL DECK U METAL DECK 5.5" 30 V METAL DECK 5.5" 30 W METAL DECK 5.5" 30 X METAL DECK 5.5" 30 Y METAL DECK 8.0" 30

Z METAL DECK

1.INSTALL CONTINUOUS INSULATION WITH A MINIMUM R-VALUE OF 30 ABOVE THE DECK, TO MEET THE NYS ENERGY CONSERVATION CONSTRUCTION CODE, INCLUDING THE INTERNATIONAL ENERGY CONSERVATION CODE AND THE NY STATE SUPPLEMENT, FOR A BUILDING IN CLIMATE ZONE 5.

5.5"

30

2.INSTALL TAPERED ISOCYANURATE INSULATION THAT SLOPES 1/4 INCH PER FOOT; MINIMUM STARTING THICKNESS 5-1/2 INCHES UNLESS OTHERWISE NOTED. INSTALL THE ISOCYANURATE INSULATION IN MULTIPLE LAYERS, WITH THE THICKEST LAYER BEING 4 INCHES. STAGGER ALL JOINTS BETWEEN LAYERS 12

5.INSTALL SLOPING CRICKETS ON THE UP-HILL SIDE OF ALL CURBS

3.INSTALL ISOCYANURATE INSULATION CRICKETS UNDER THE TAPERED INSULATION.

THAT ARE 30 INCHES AND WIDER.

4.INSTALL A COVER BOARD USING LOW RISE FOAM ADHESIVE OVER THE INSULATION AND CRICKETS.

— EXP - (SEE DET. 29&30/A252

LEGEND: ROOF AREA DESIGNATION EXPANSION JOINT

ROOF DRAIN (SEE DET. 35/A252) OVER FLOW DRAIN

(SEE DET. 35/A252 SIM) VENT PIPE OV (SEE DET. 36/A52)

ROOF HATCH (SEE DET. 38/A253) PORTALS PLUS

(SEE DET. 39/A253) HVAC CURB HVAC CURB (SEE DET. 40/A253)

(SEE DET. 44/A253) +OS OVERFLOW SCUPPER (SEE DET. 45/A253))

SCUPPER AND LEADER HEAD (SEE DET. 46/A253) GUARD RAIL

(SEE DET. 50/A254) ---- NEW GUARD RAIL (SEE DET. 53/A254)

→ DECK SLOPE

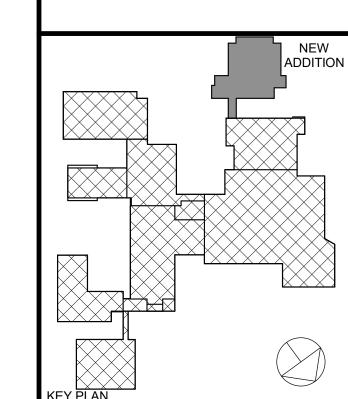
TAPERED ISOCYANURATE INSULATION, SLOPE 1/4" PER FT

°→ CRICKET- SLOPE 1/2" PER FT

H.P. INSULATION HIGH POINT

WALKWAY PADS

NEW ROOF STAIR (SEE DET. 7/A806)



ORANGE-ULSTER BOCES

ARDEN HILL -

MAIN BUILDING

ADDITIONS AND

ALTERATIONS

4 HARRIMAN DRIVE

GOSHEN, NY 10924

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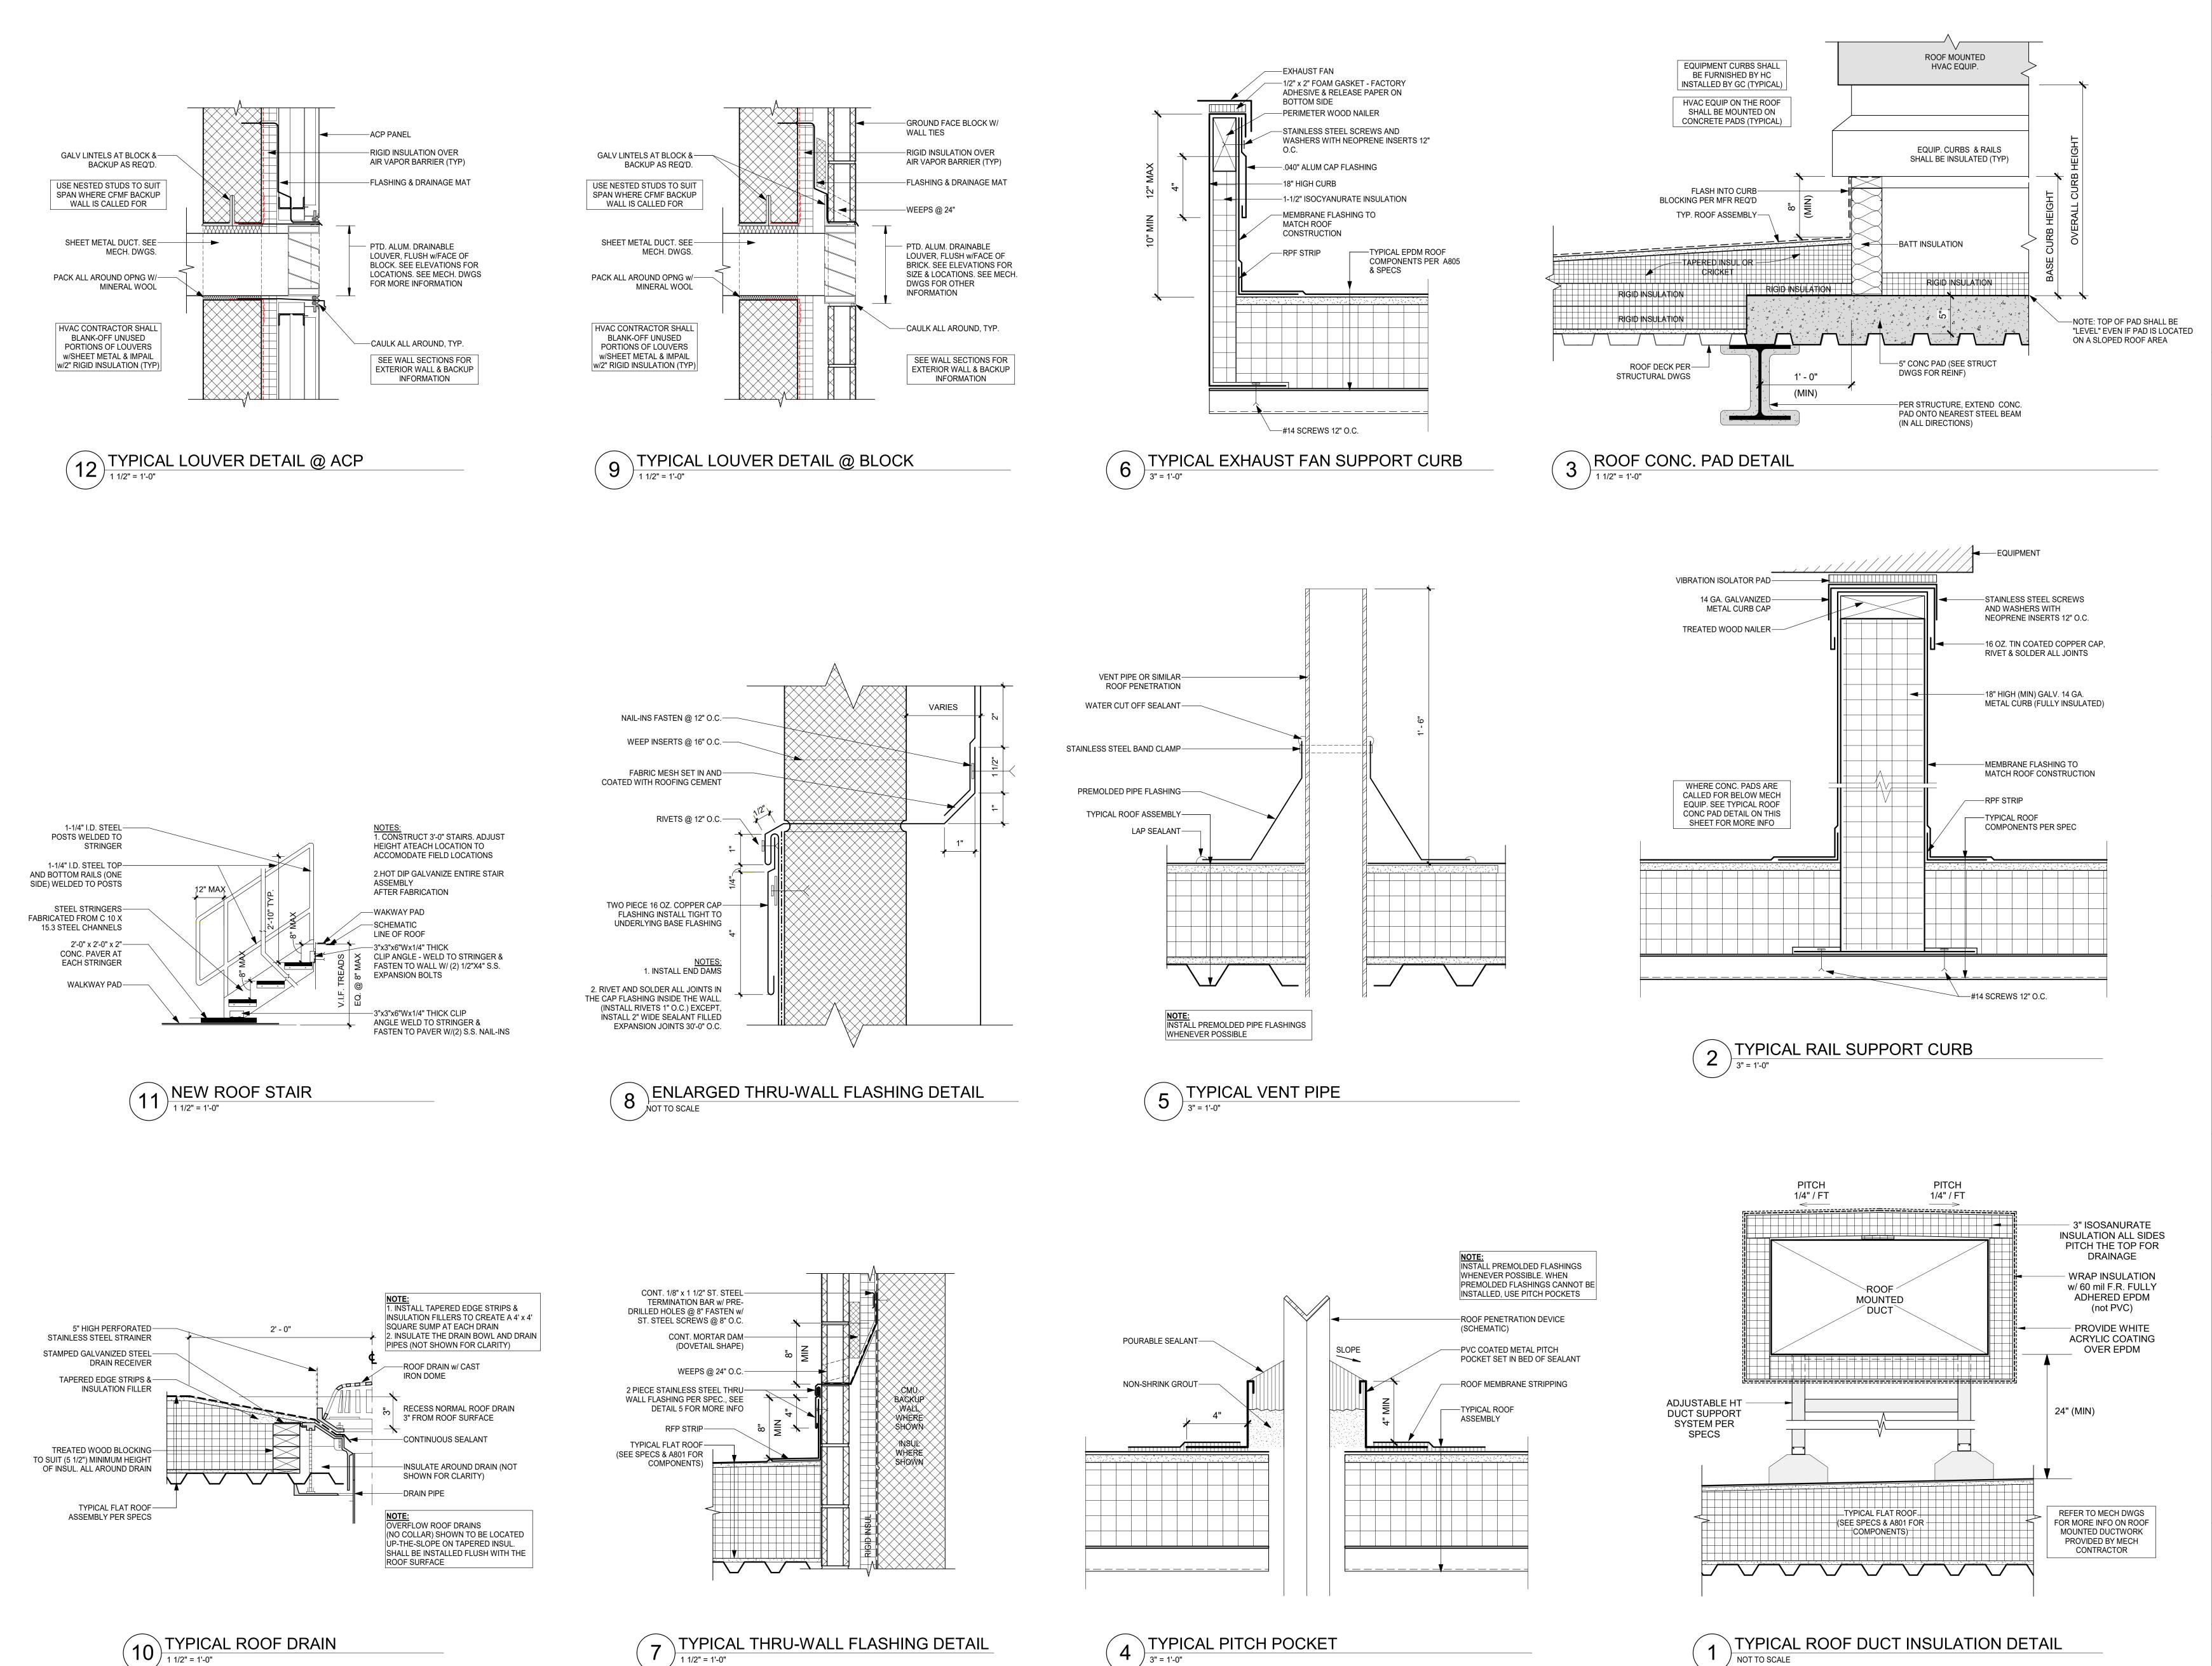
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GYMNASIUM UPPER ROOF PLAN

01/26/2024 Drawn / Checked Author Checker

A206

1 GYMNASIUM ROOF PLAN



ORANGE-ULSTER BOCES

ARDEN HILL MAIN BUILDING
ADDITIONS AND
ALTERATIONS
4 HARRIMAN DRIVE
GOSHEN, NY 10924



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GYM ADDITION ROOF DETAILS

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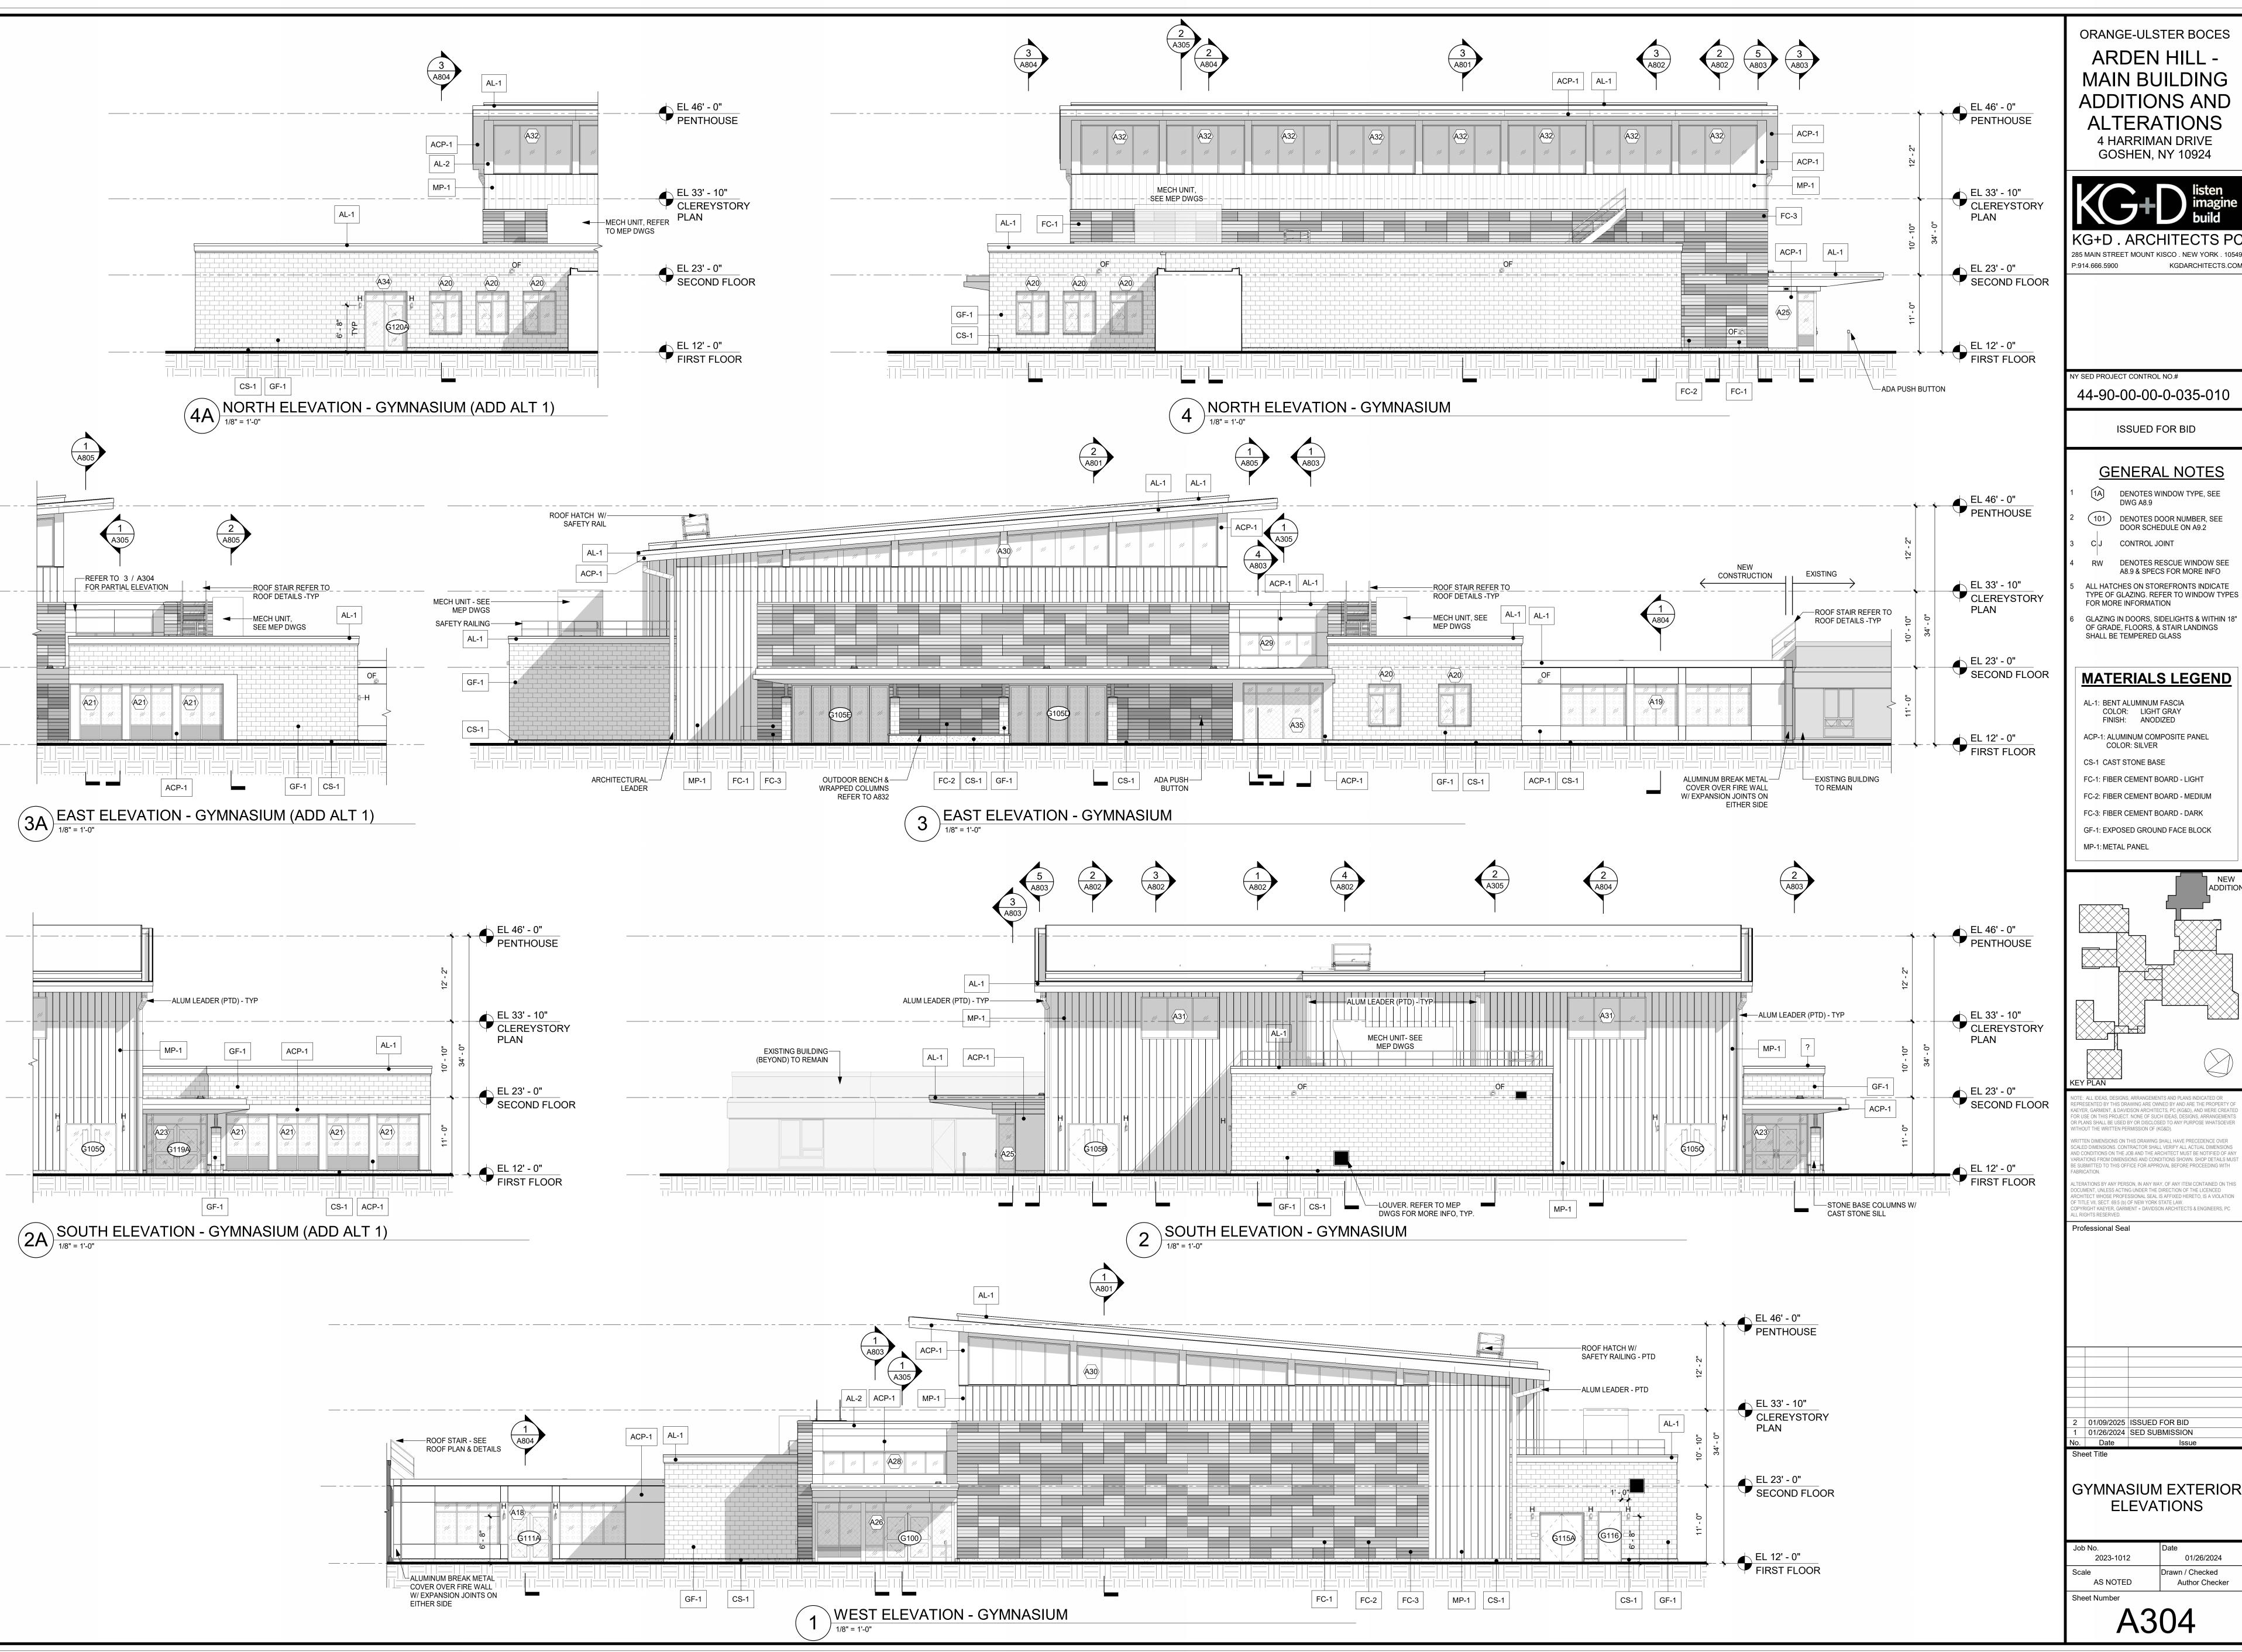
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ORANGE-ULSTER BOCES

ARDEN HILL -MAIN BUILDING **ADDITIONS AND ALTERATIONS** 4 HARRIMAN DRIVE



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GENERAL NOTES

DENOTES WINDOW TYPE, SEE DWG A8.9

DENOTES DOOR NUMBER, SEE DOOR SCHEDULE ON A9.2

CONTROL JOINT

DENOTES RESCUE WINDOW SEE A8.9 & SPECS FOR MORE INFO ALL HATCHES ON STOREFRONTS INDICATE TYPE OF GLAZING. REFER TO WINDOW TYPES

GLAZING IN DOORS, SIDELIGHTS & WITHIN 18" OF GRADE, FLOORS, & STAIR LANDINGS SHALL BE TEMPERED GLASS

MATERIALS LEGEND

AL-1: BENT ALUMINUM FASCIA COLOR: LIGHT GRAY FINISH: ANODIZED

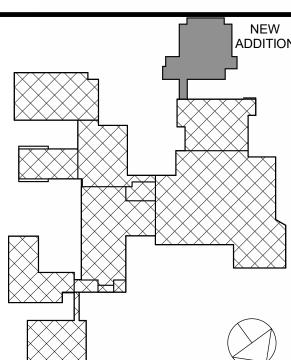
ACP-1: ALUMINUM COMPOSITE PANEL COLOR: SILVER

CS-1 CAST STONE BASE FC-1: FIBER CEMENT BOARD - LIGHT

FC-2: FIBER CEMENT BOARD - MEDIUM

FC-3: FIBER CEMENT BOARD - DARK GF-1: EXPOSED GROUND FACE BLOCK

MP-1: METAL PANEL



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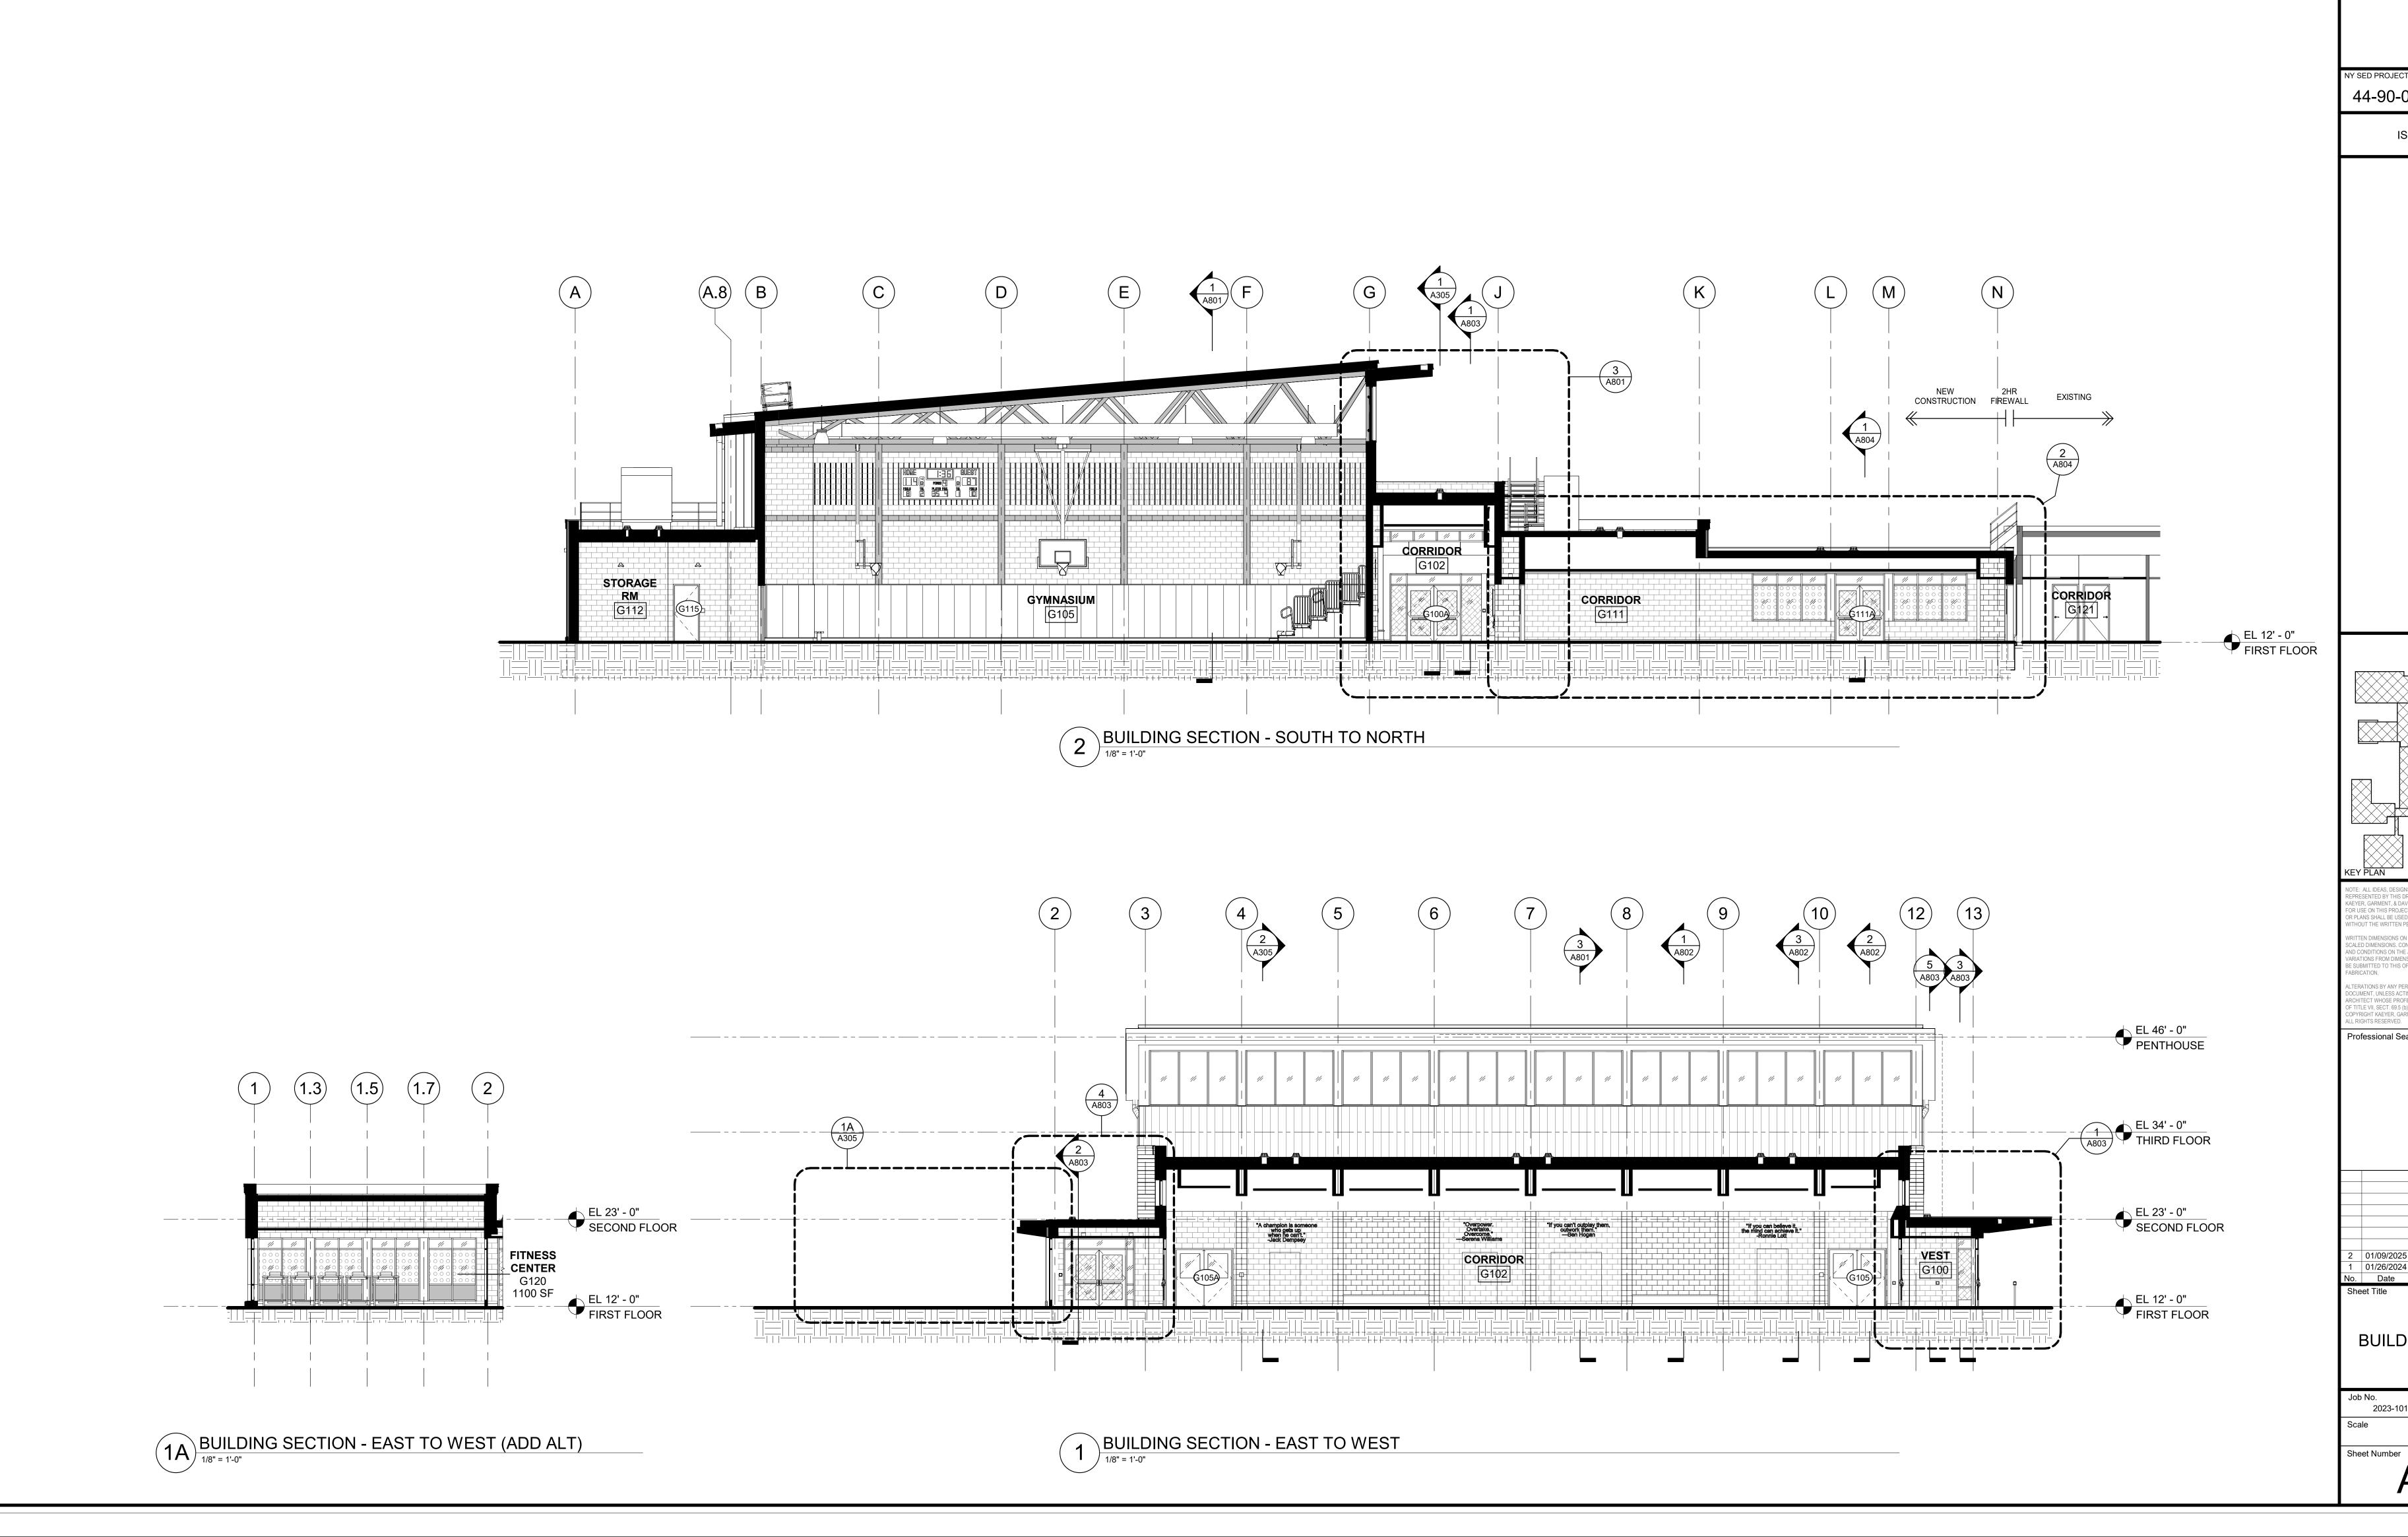
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GYMNASIUM EXTERIOR **ELEVATIONS**

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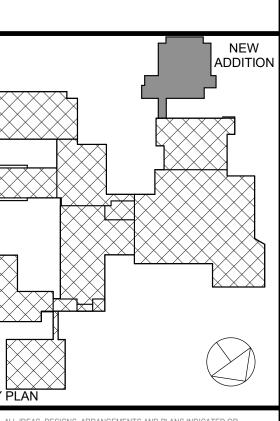


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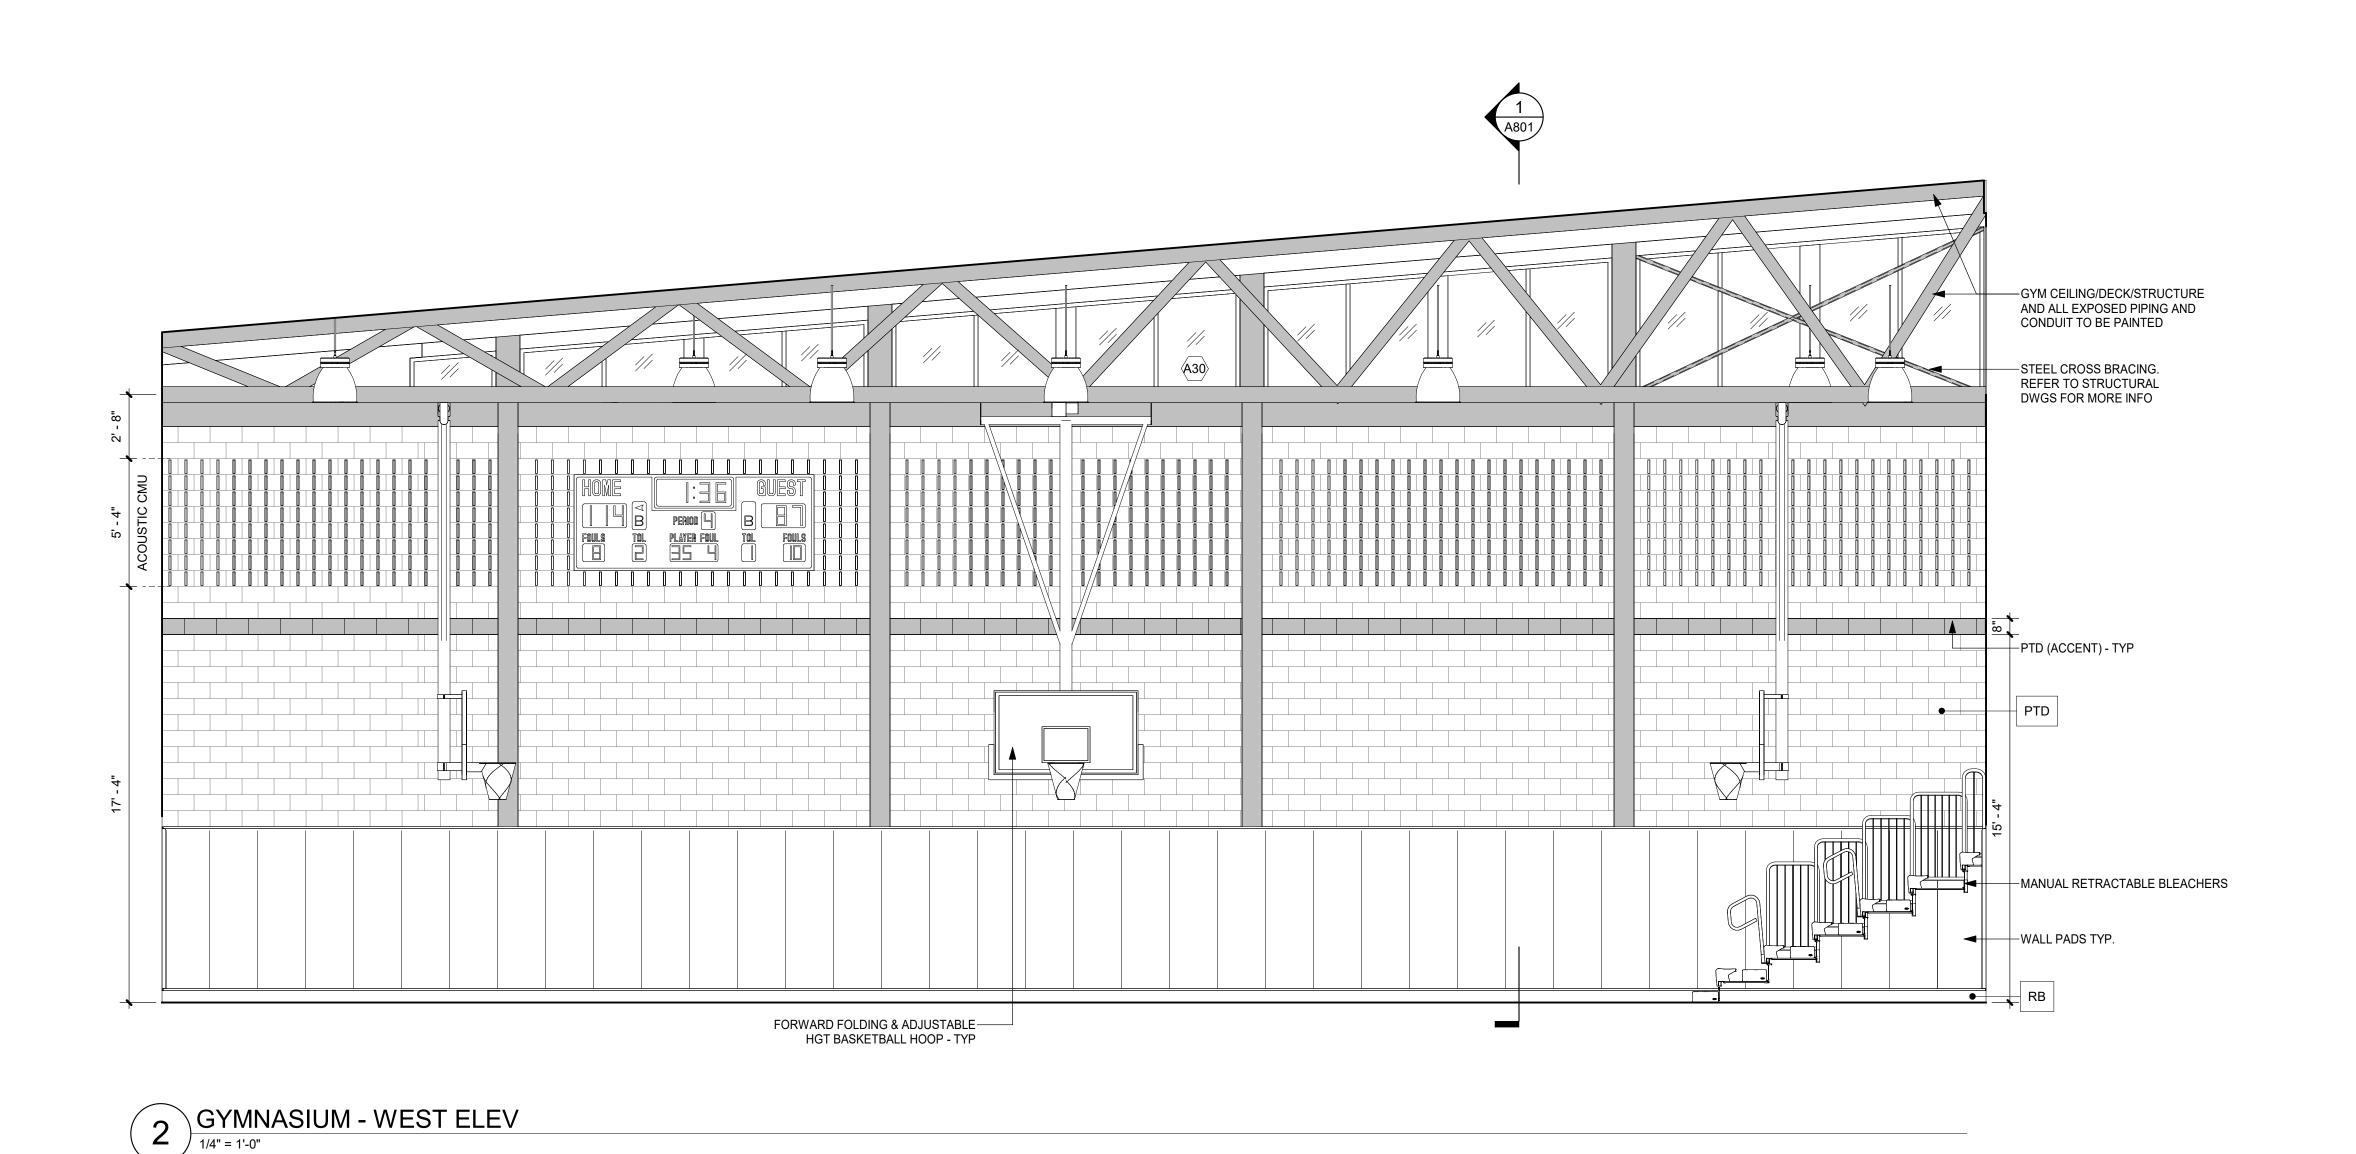
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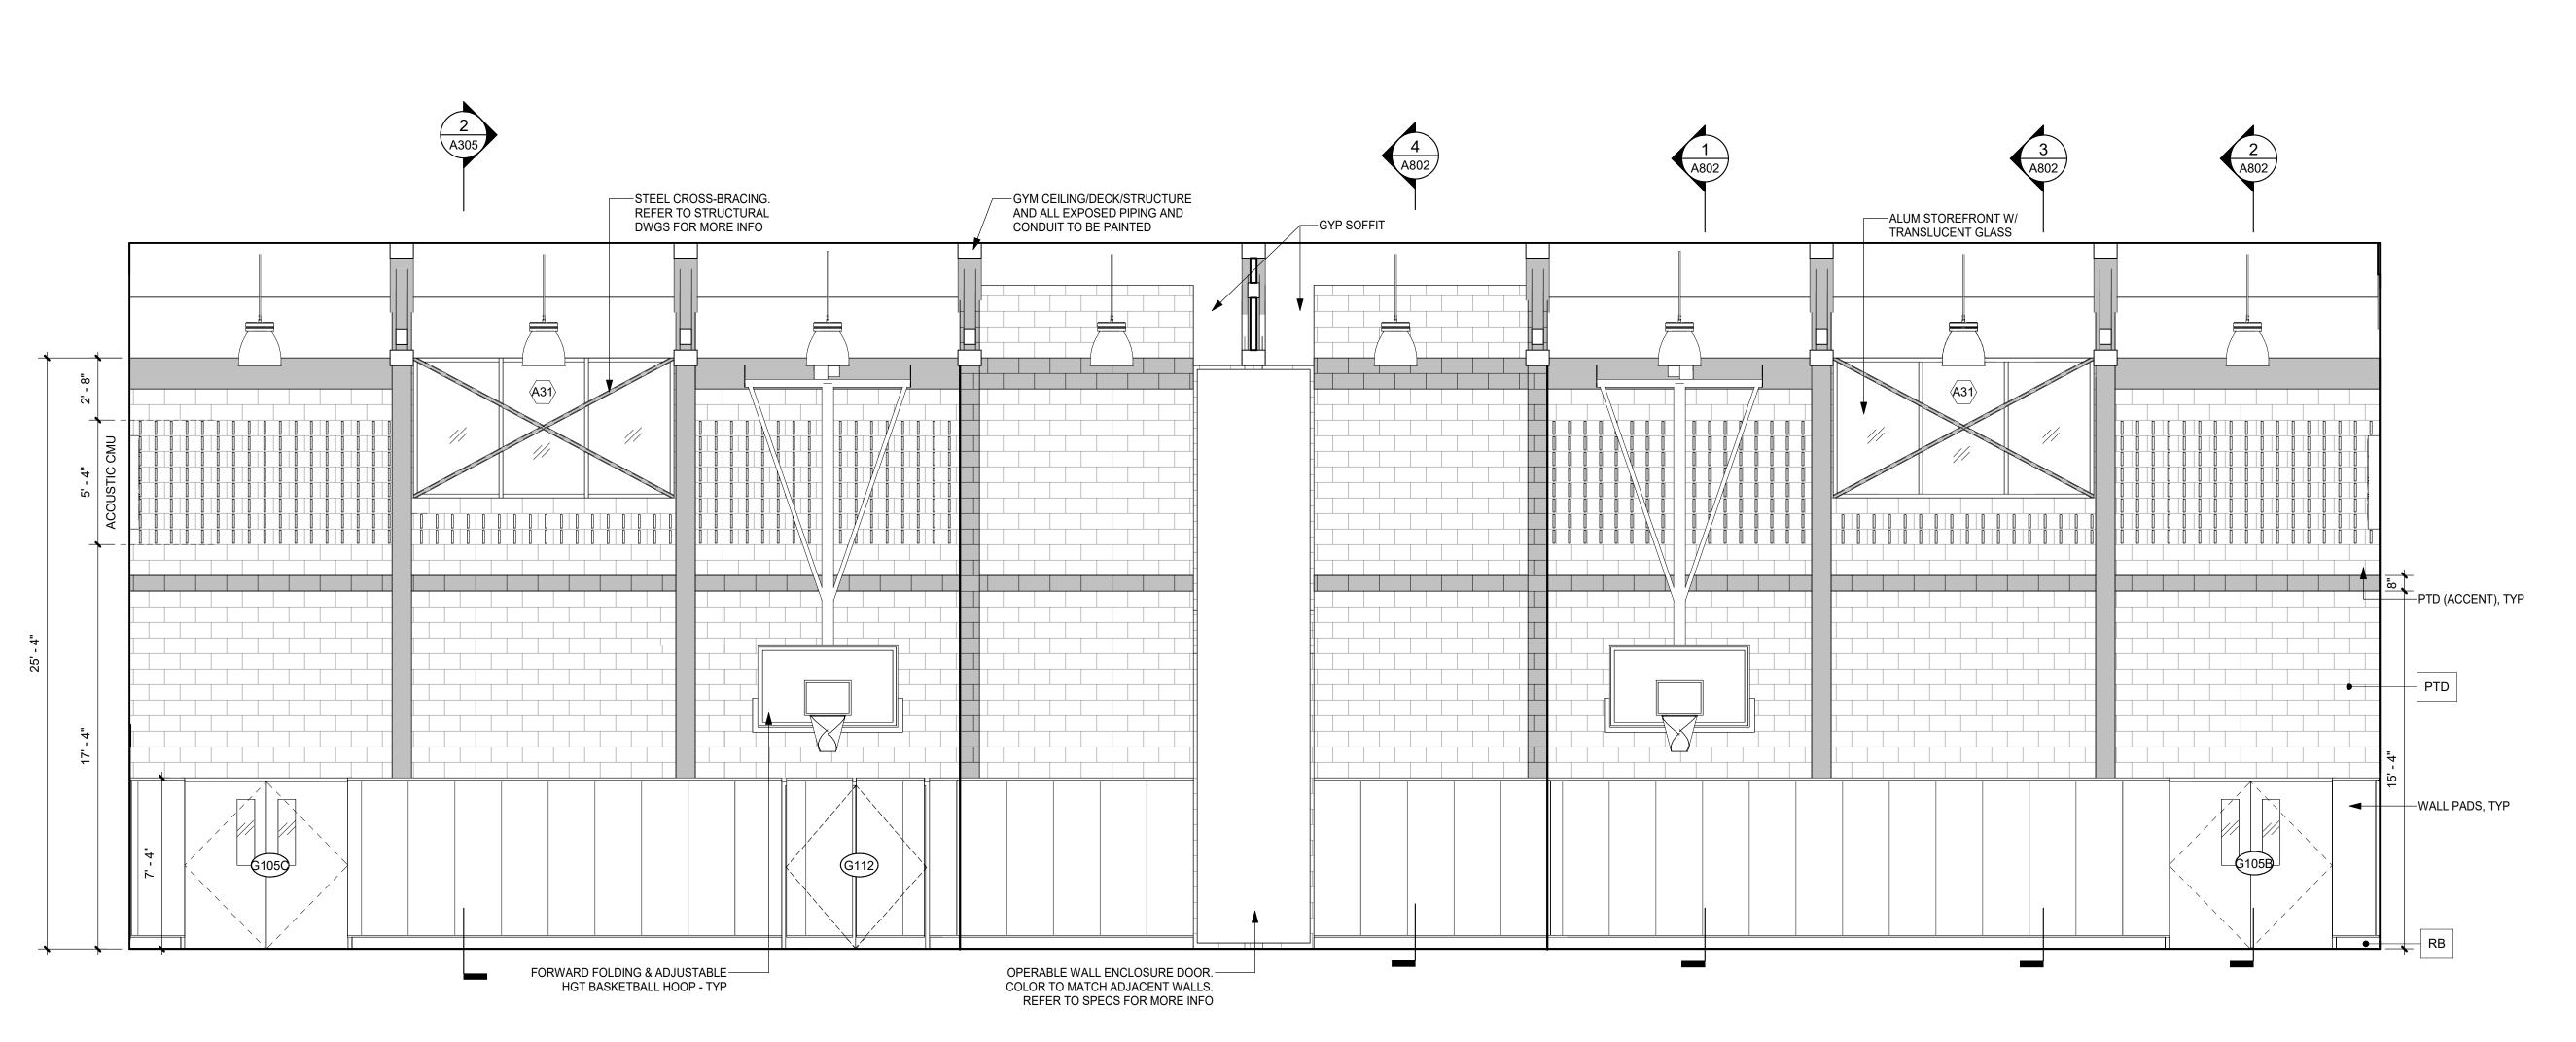
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BUILDING SECTIONS

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GYMNASIUM - SOUTH ELEV

1/4" = 1'-0"

ORANGE-ULSTER BOCES

ARDEN HILL MAIN BUILDING
ADDITIONS AND
ALTERATIONS
4 HARRIMAN DRIVE

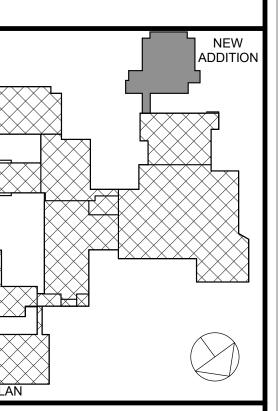


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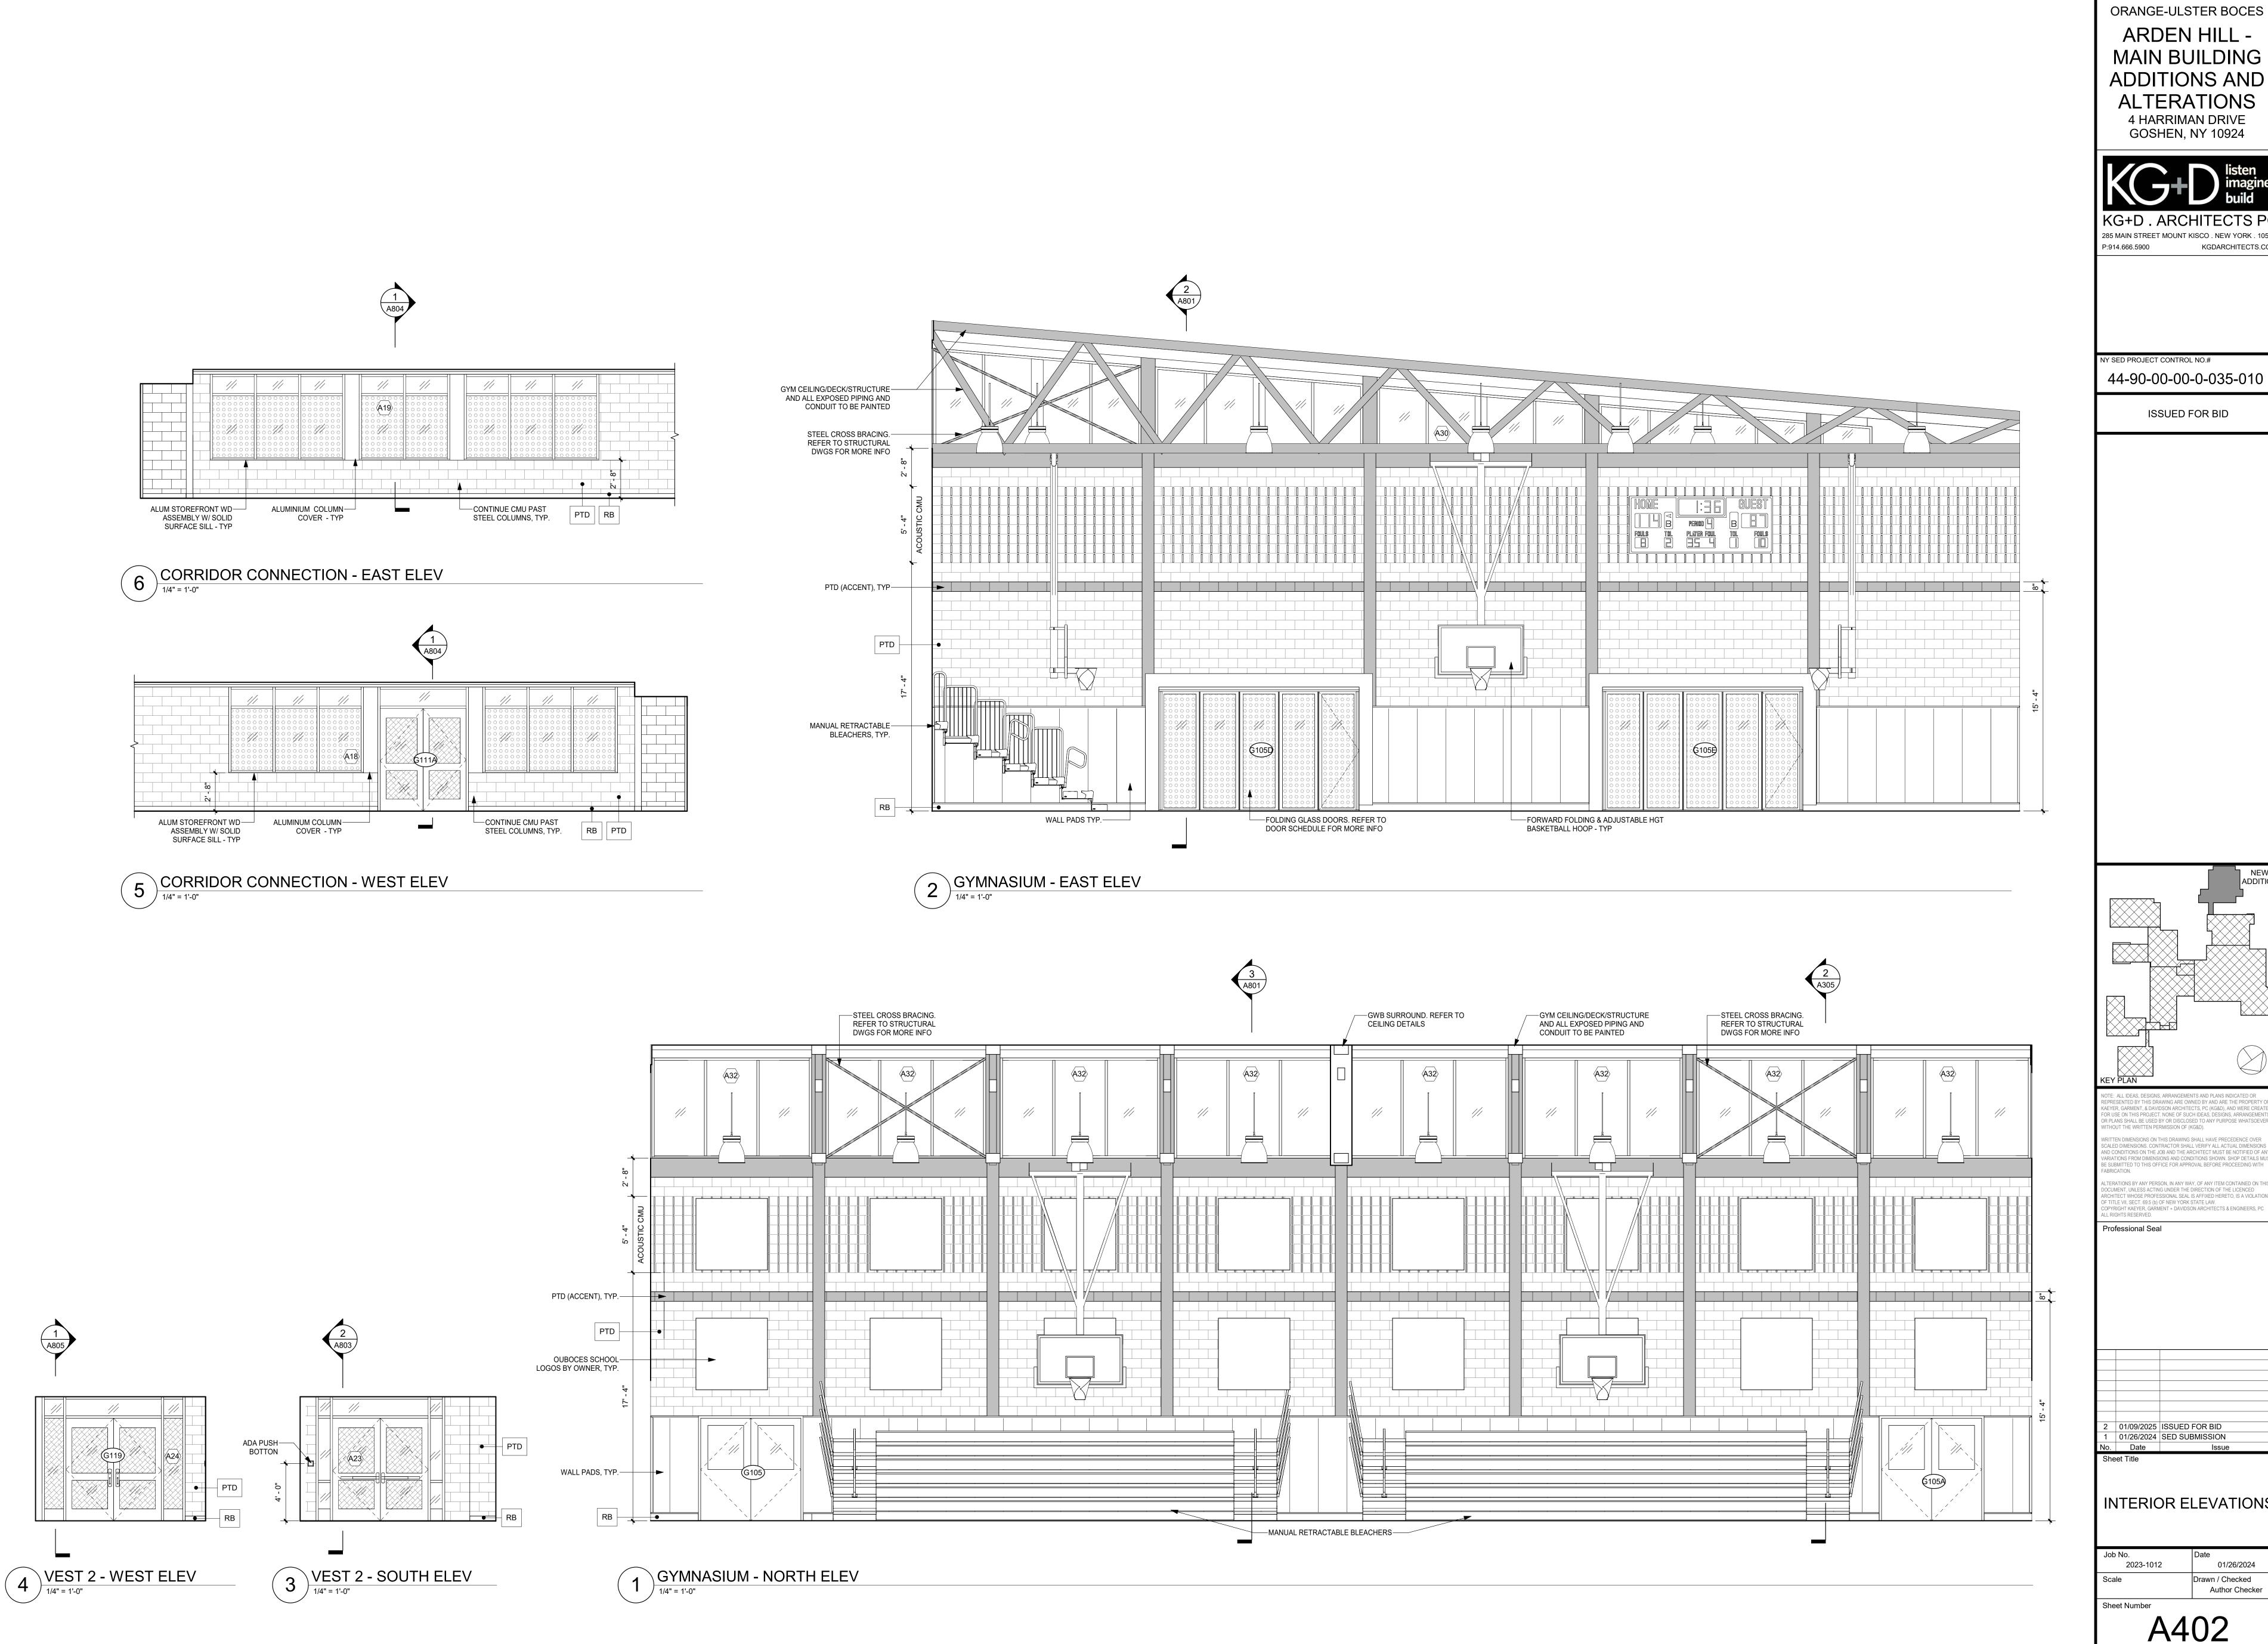
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2023-1012

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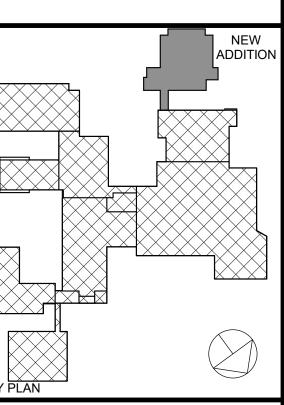




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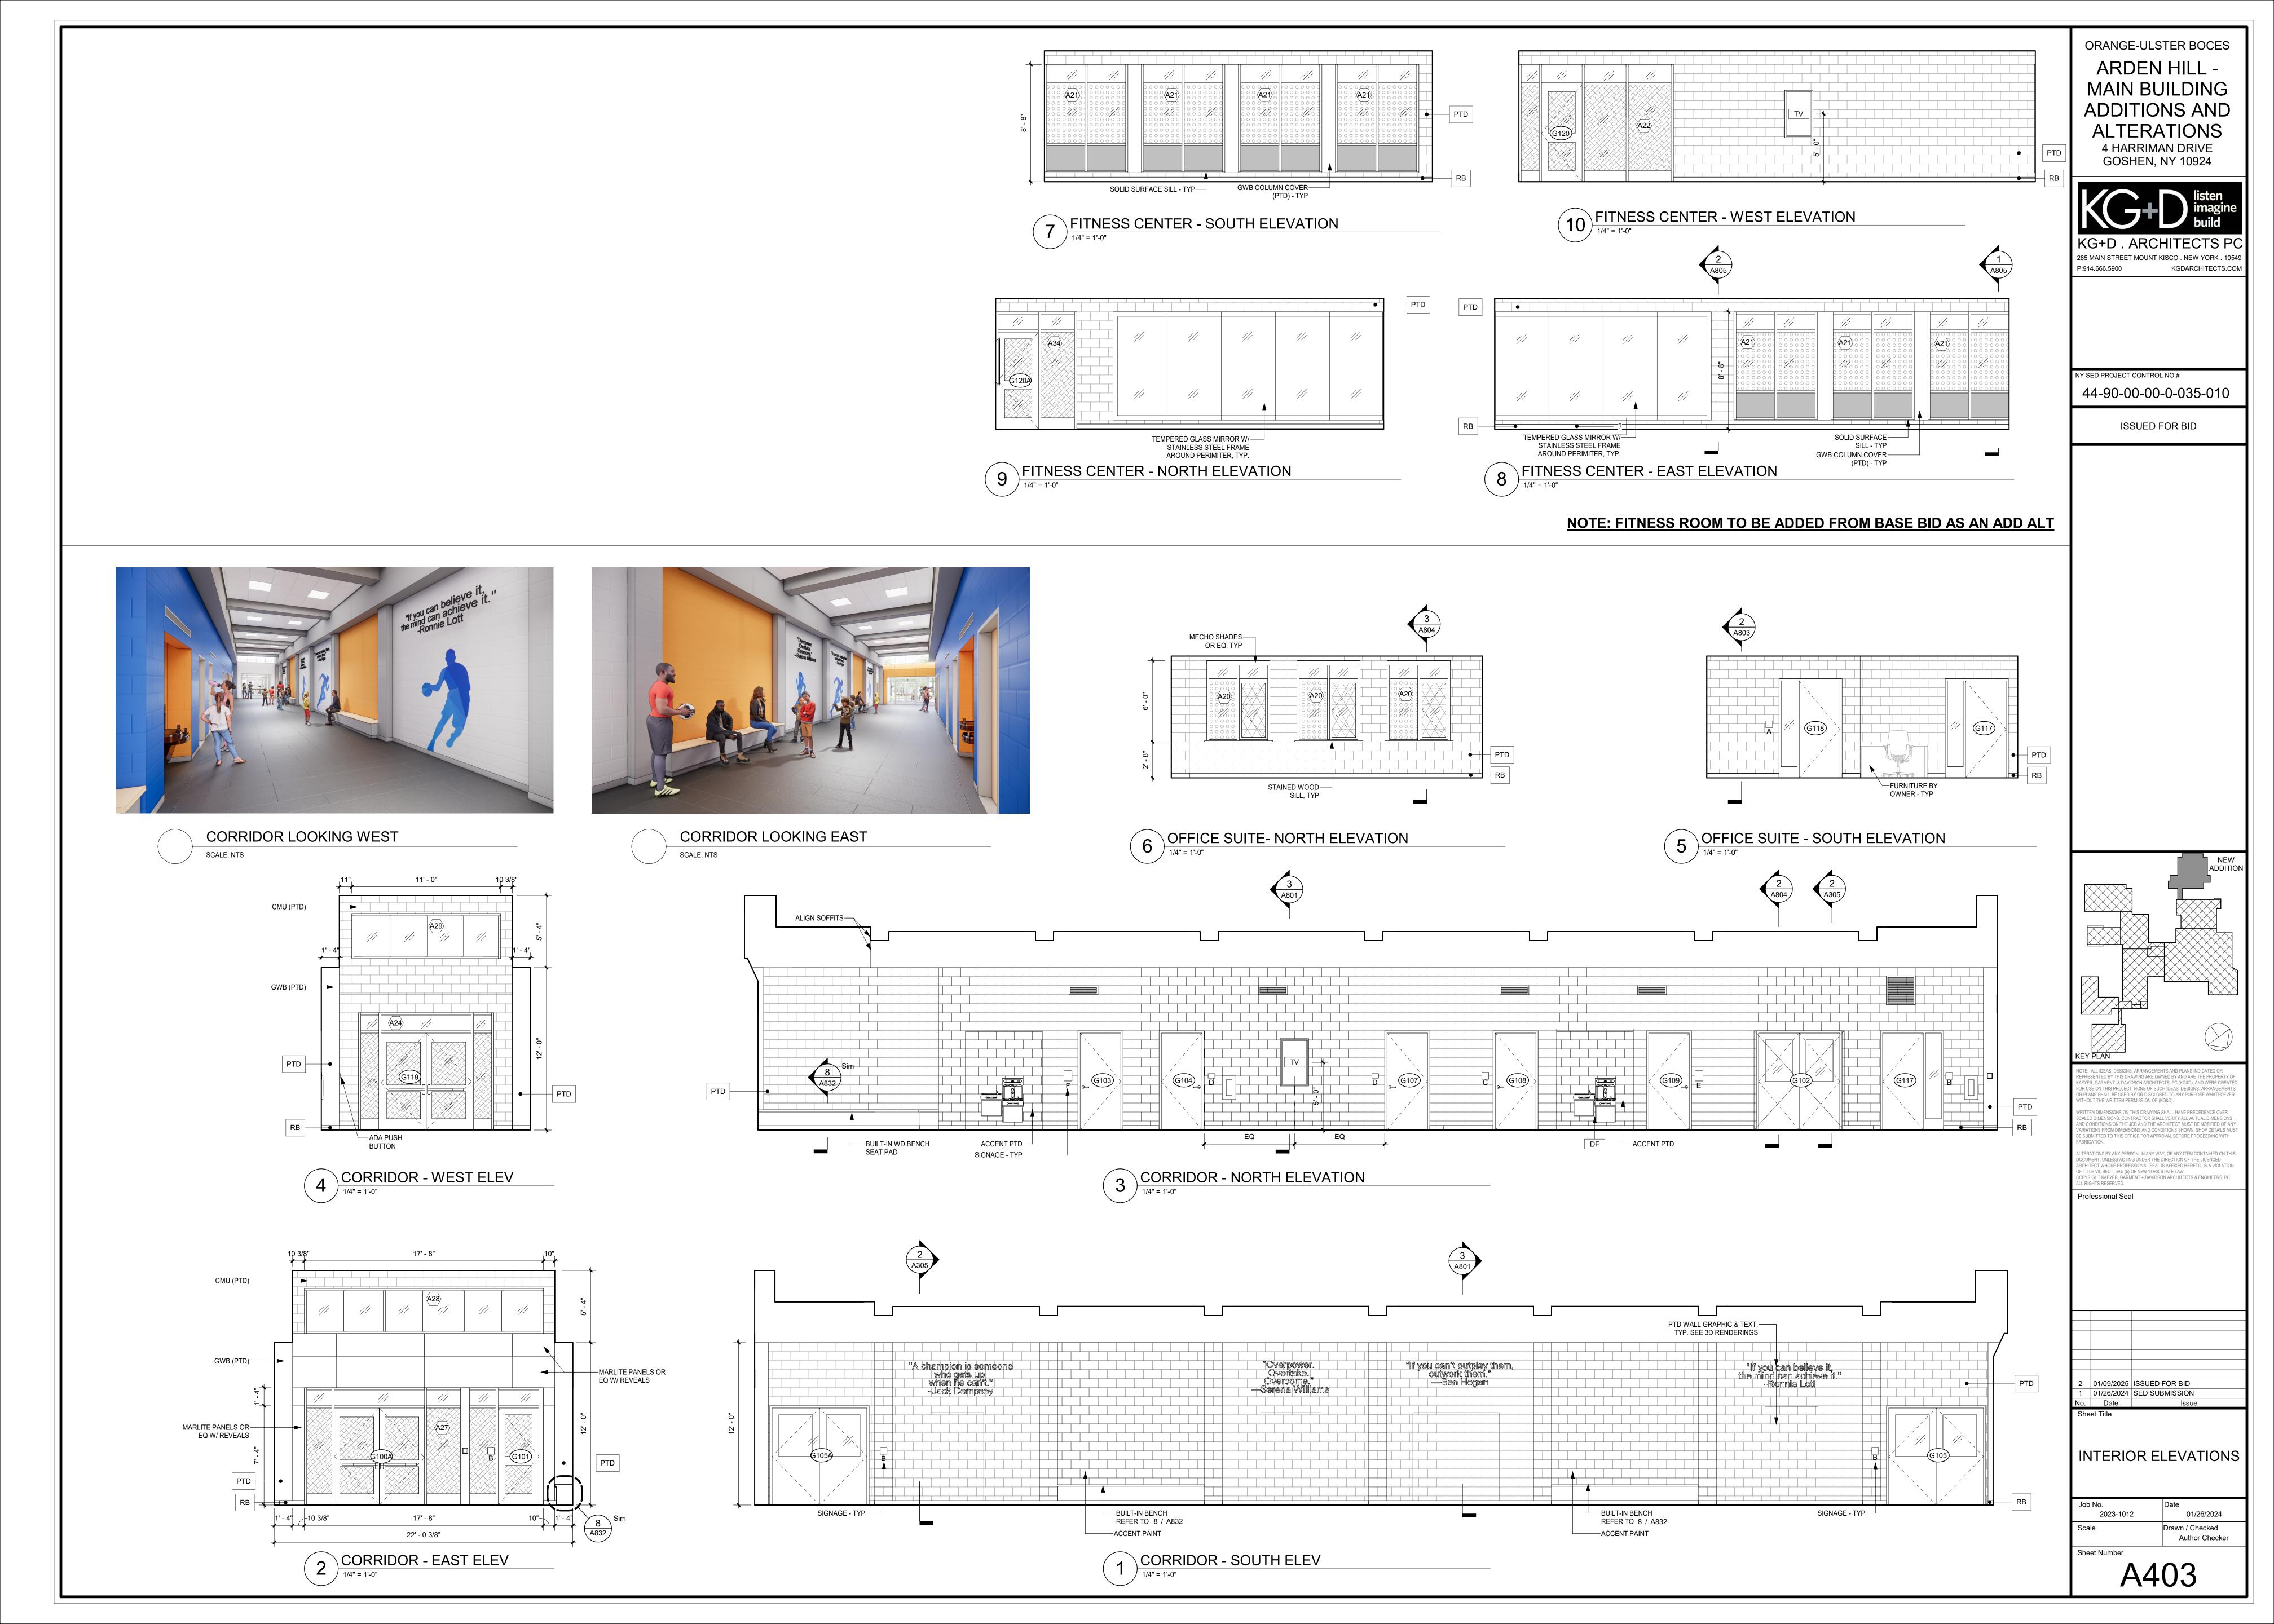
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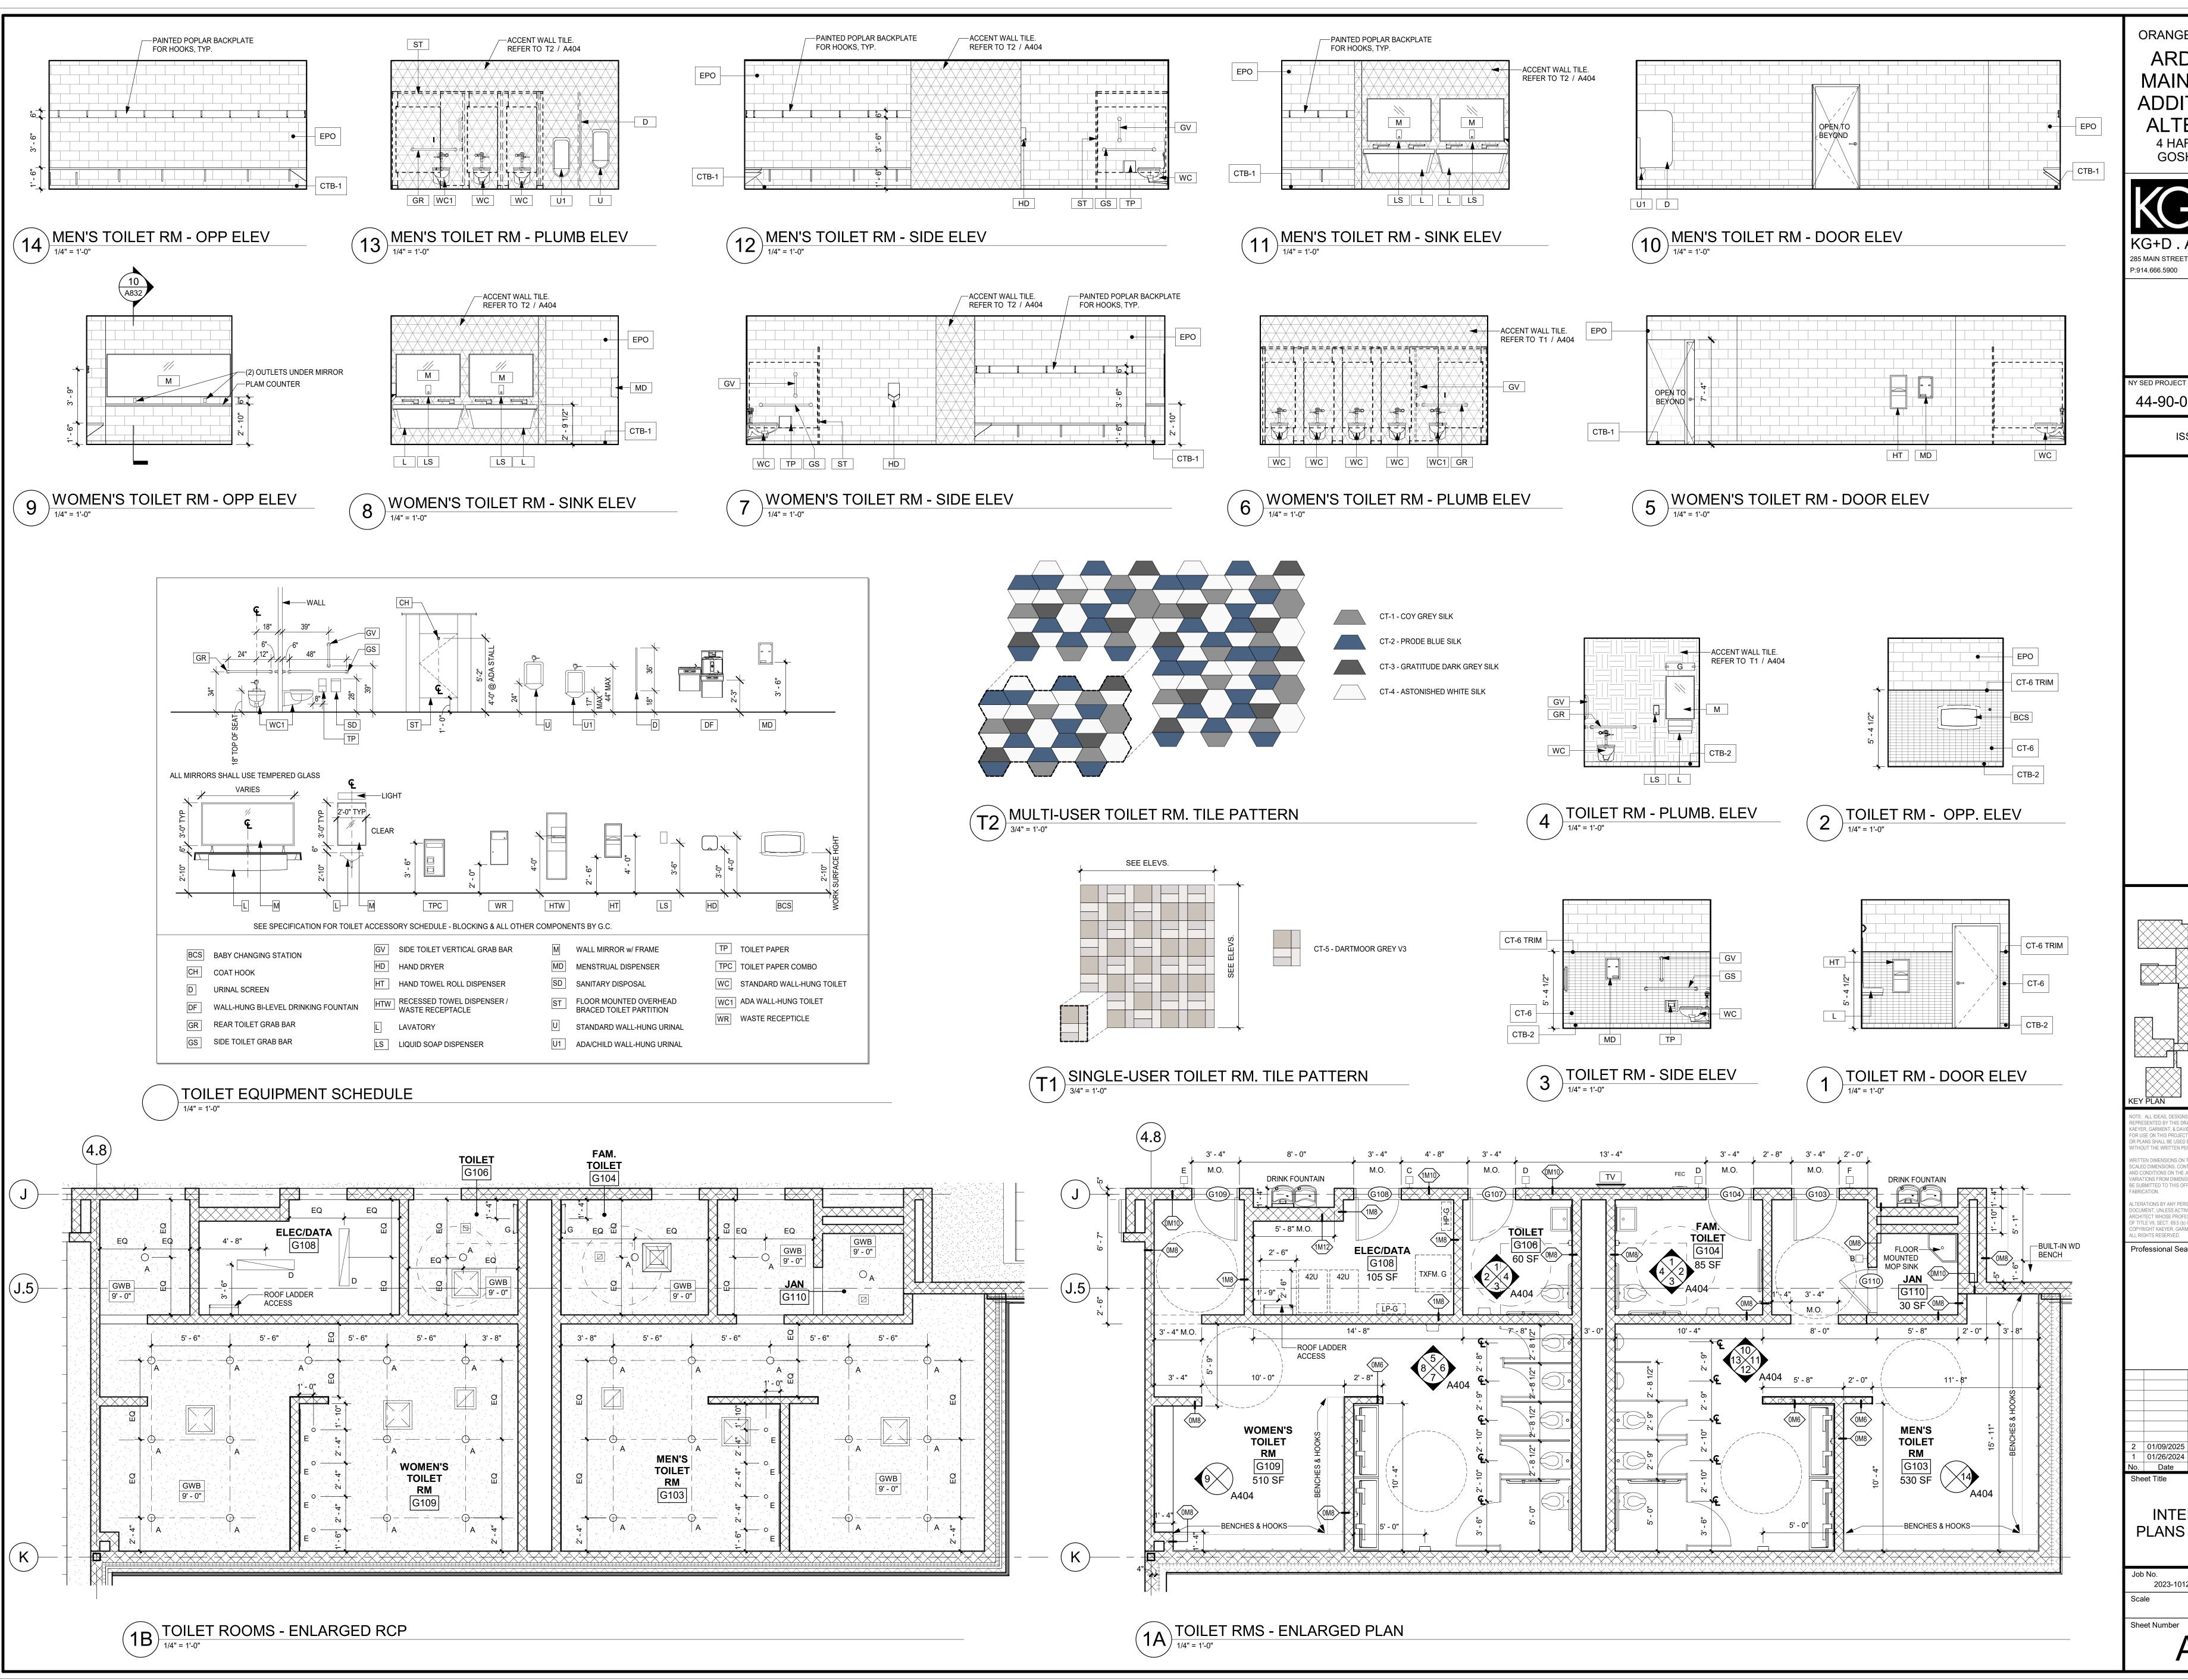
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INTERIOR ELEVATIONS

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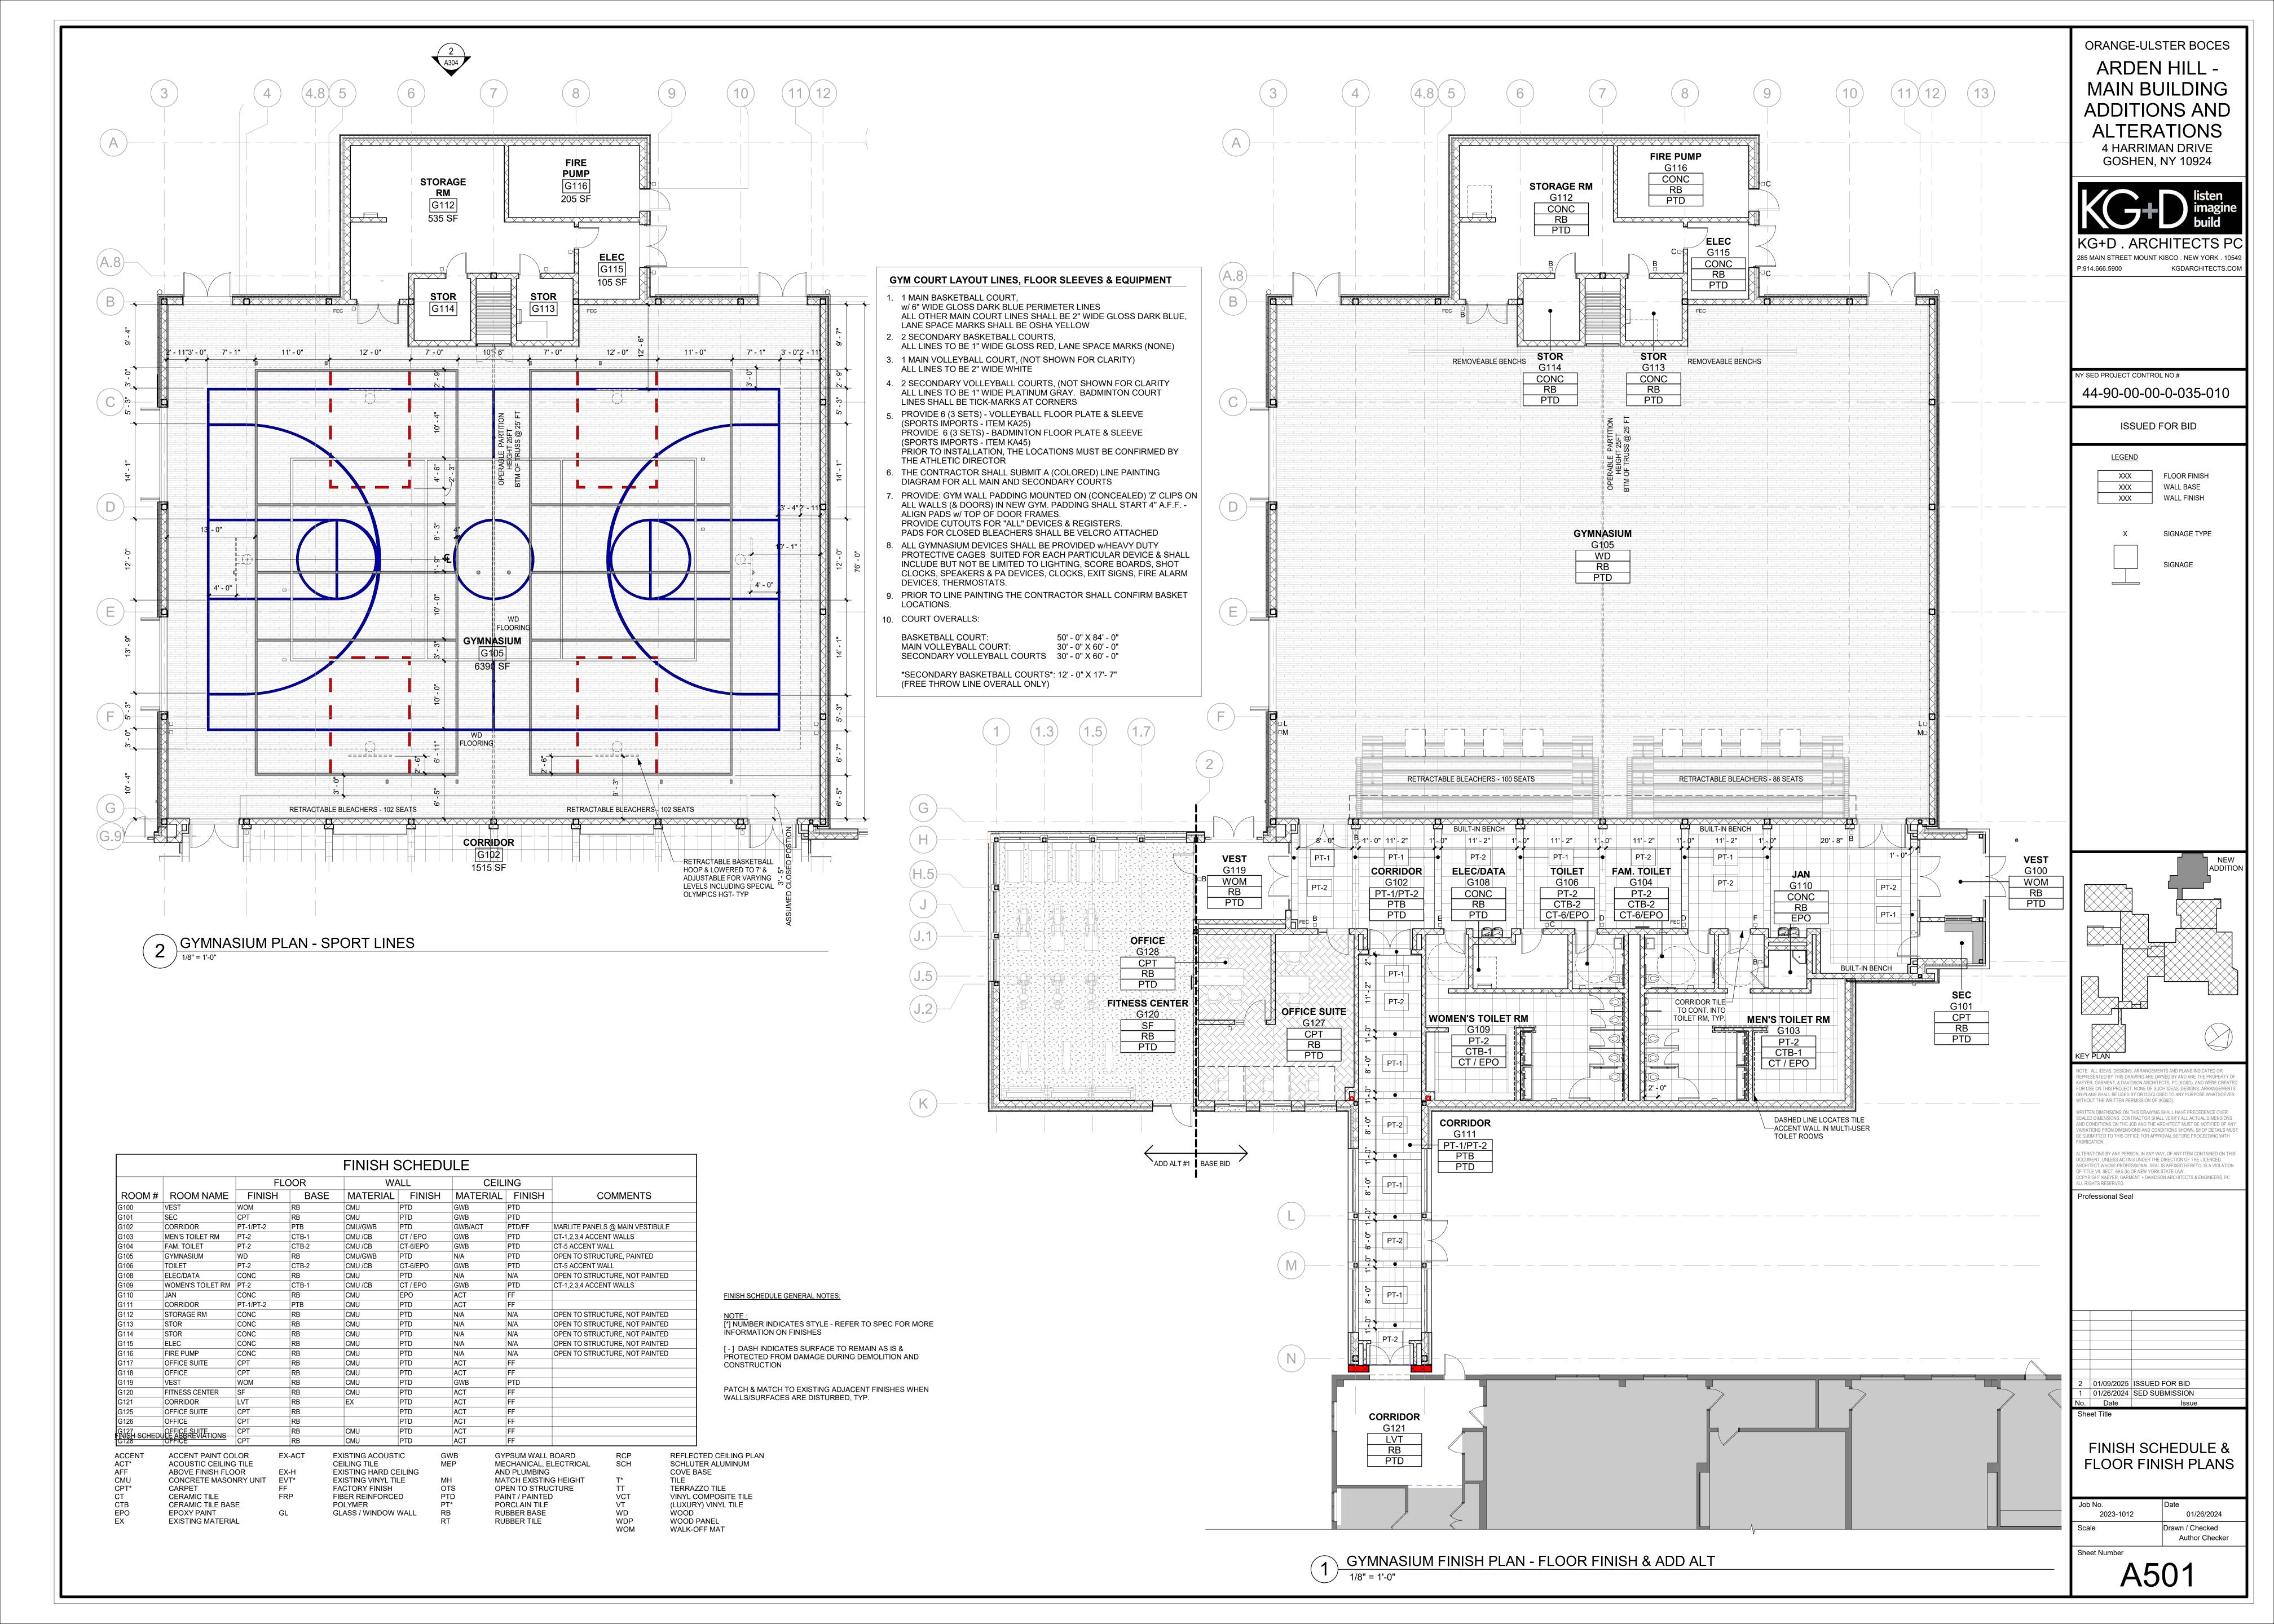
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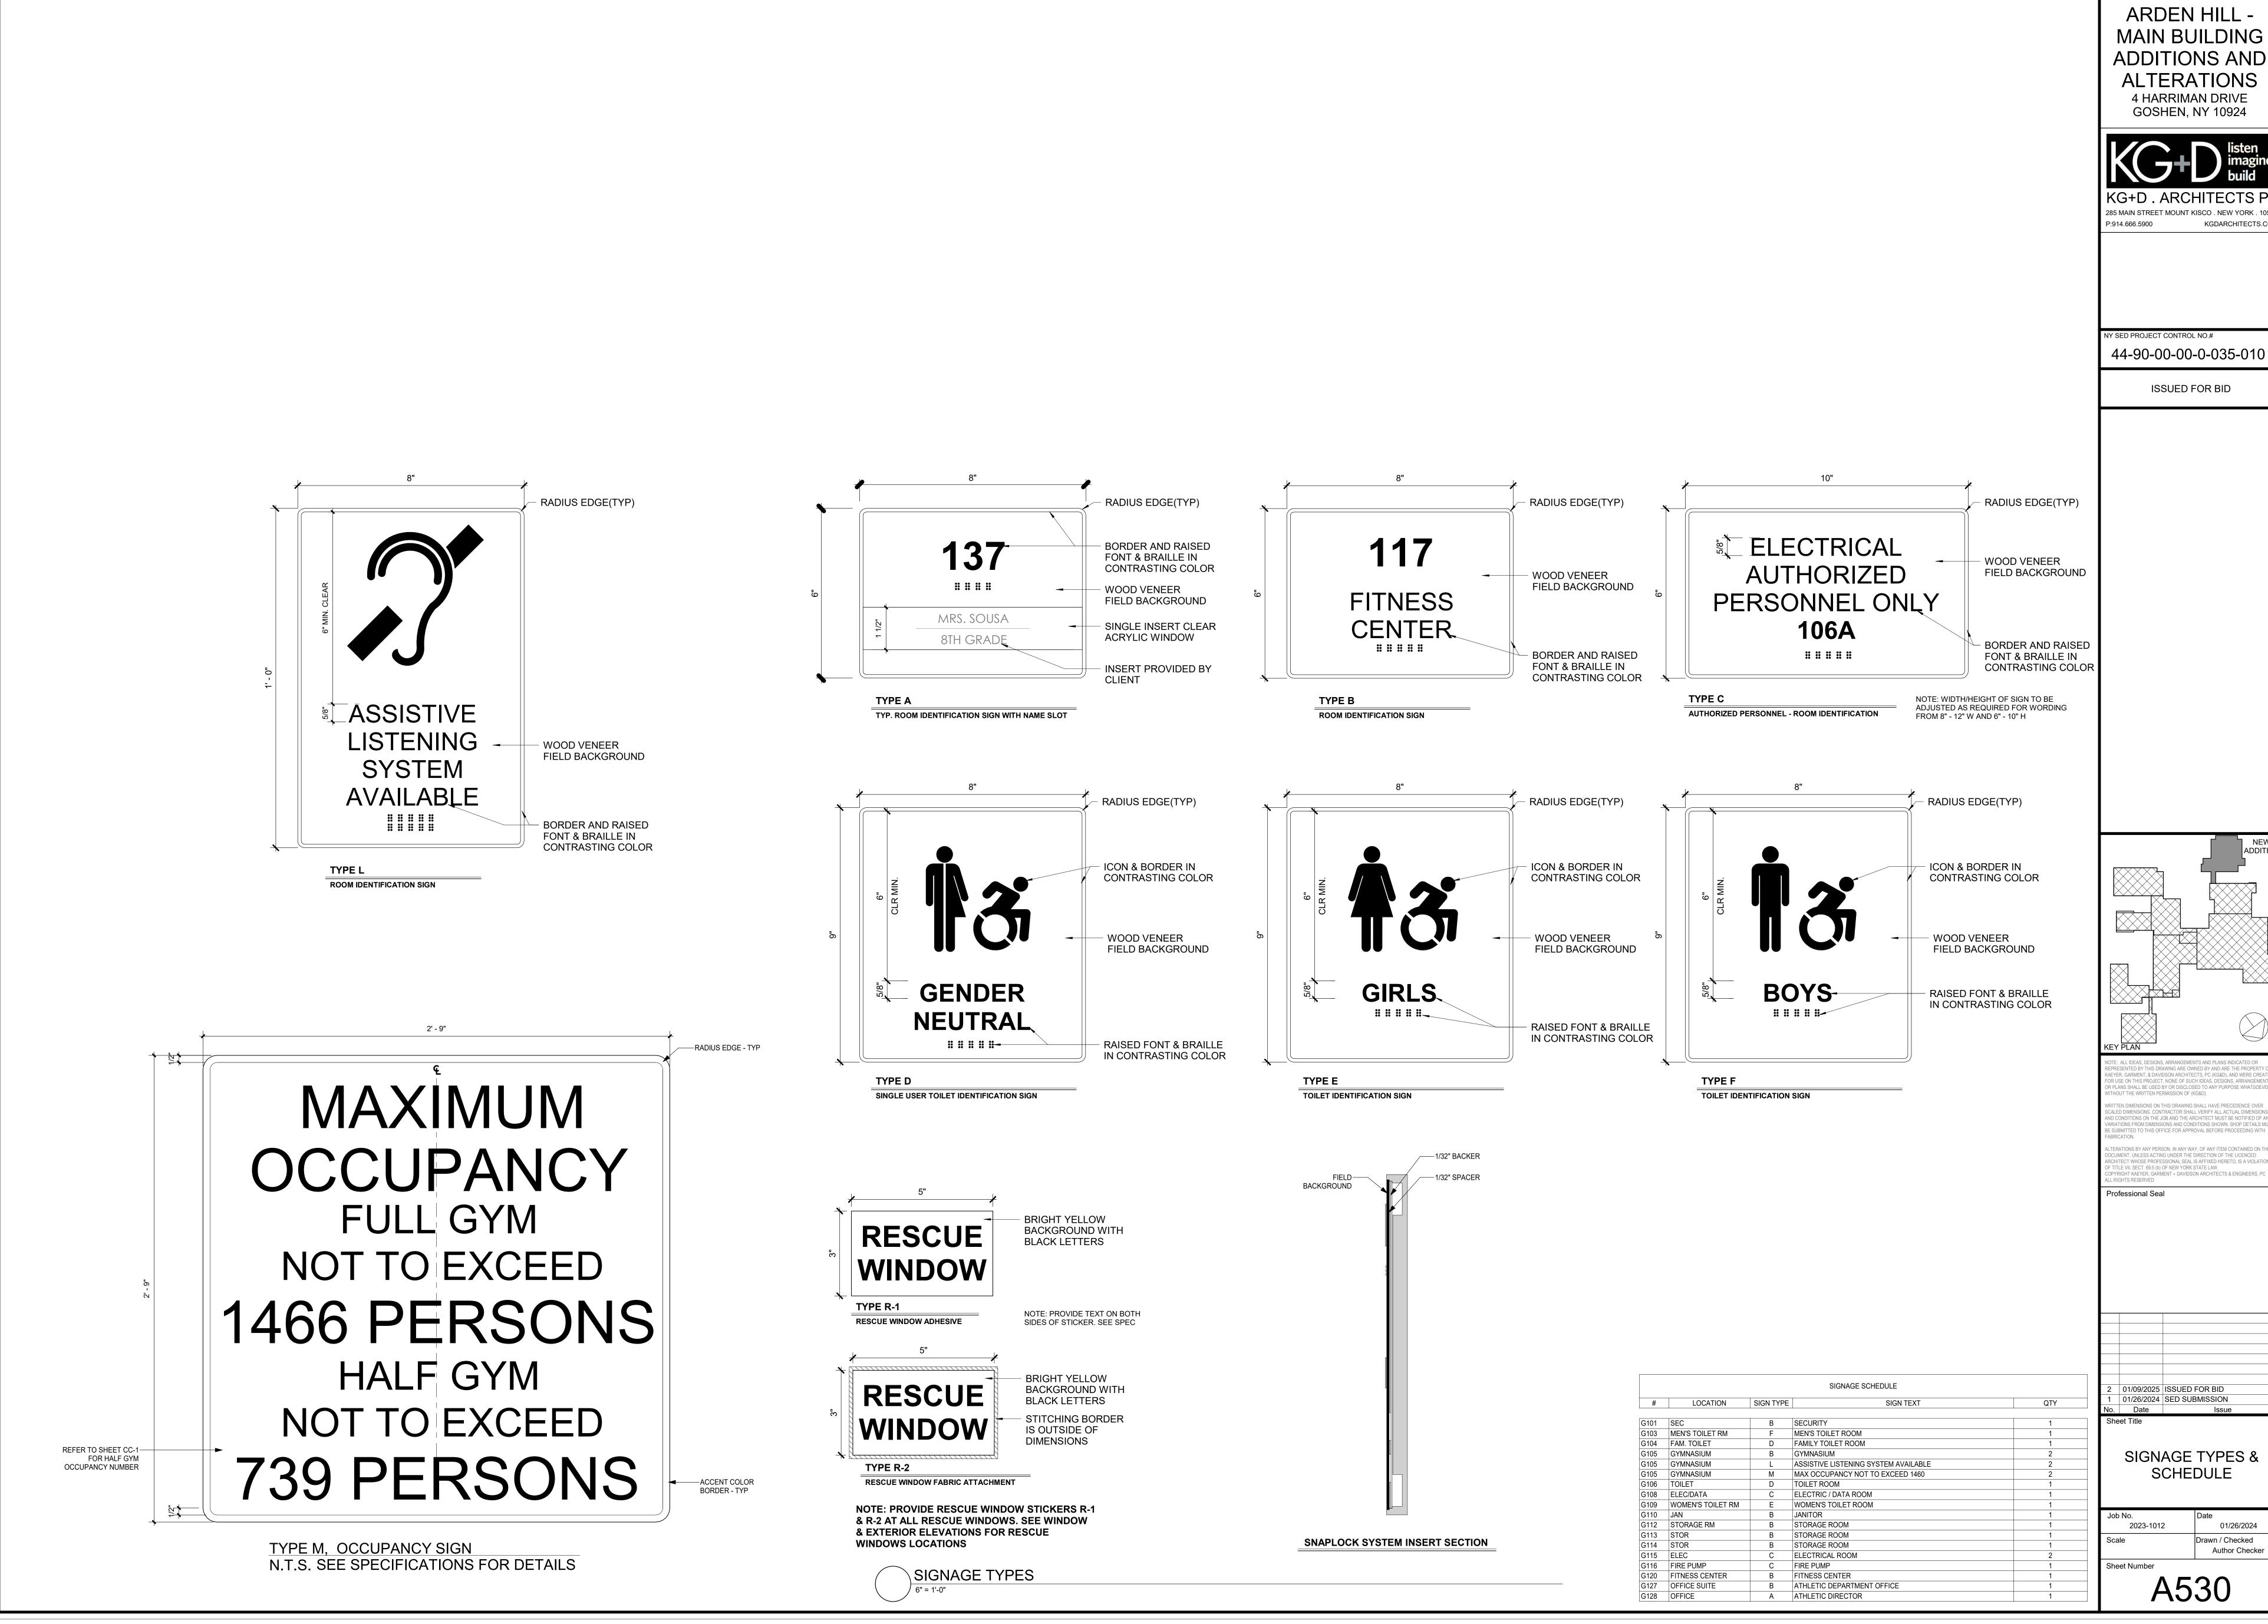
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INTERIOR TOILET PLANS & ELEVATIONS

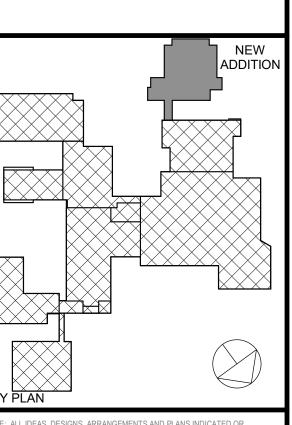
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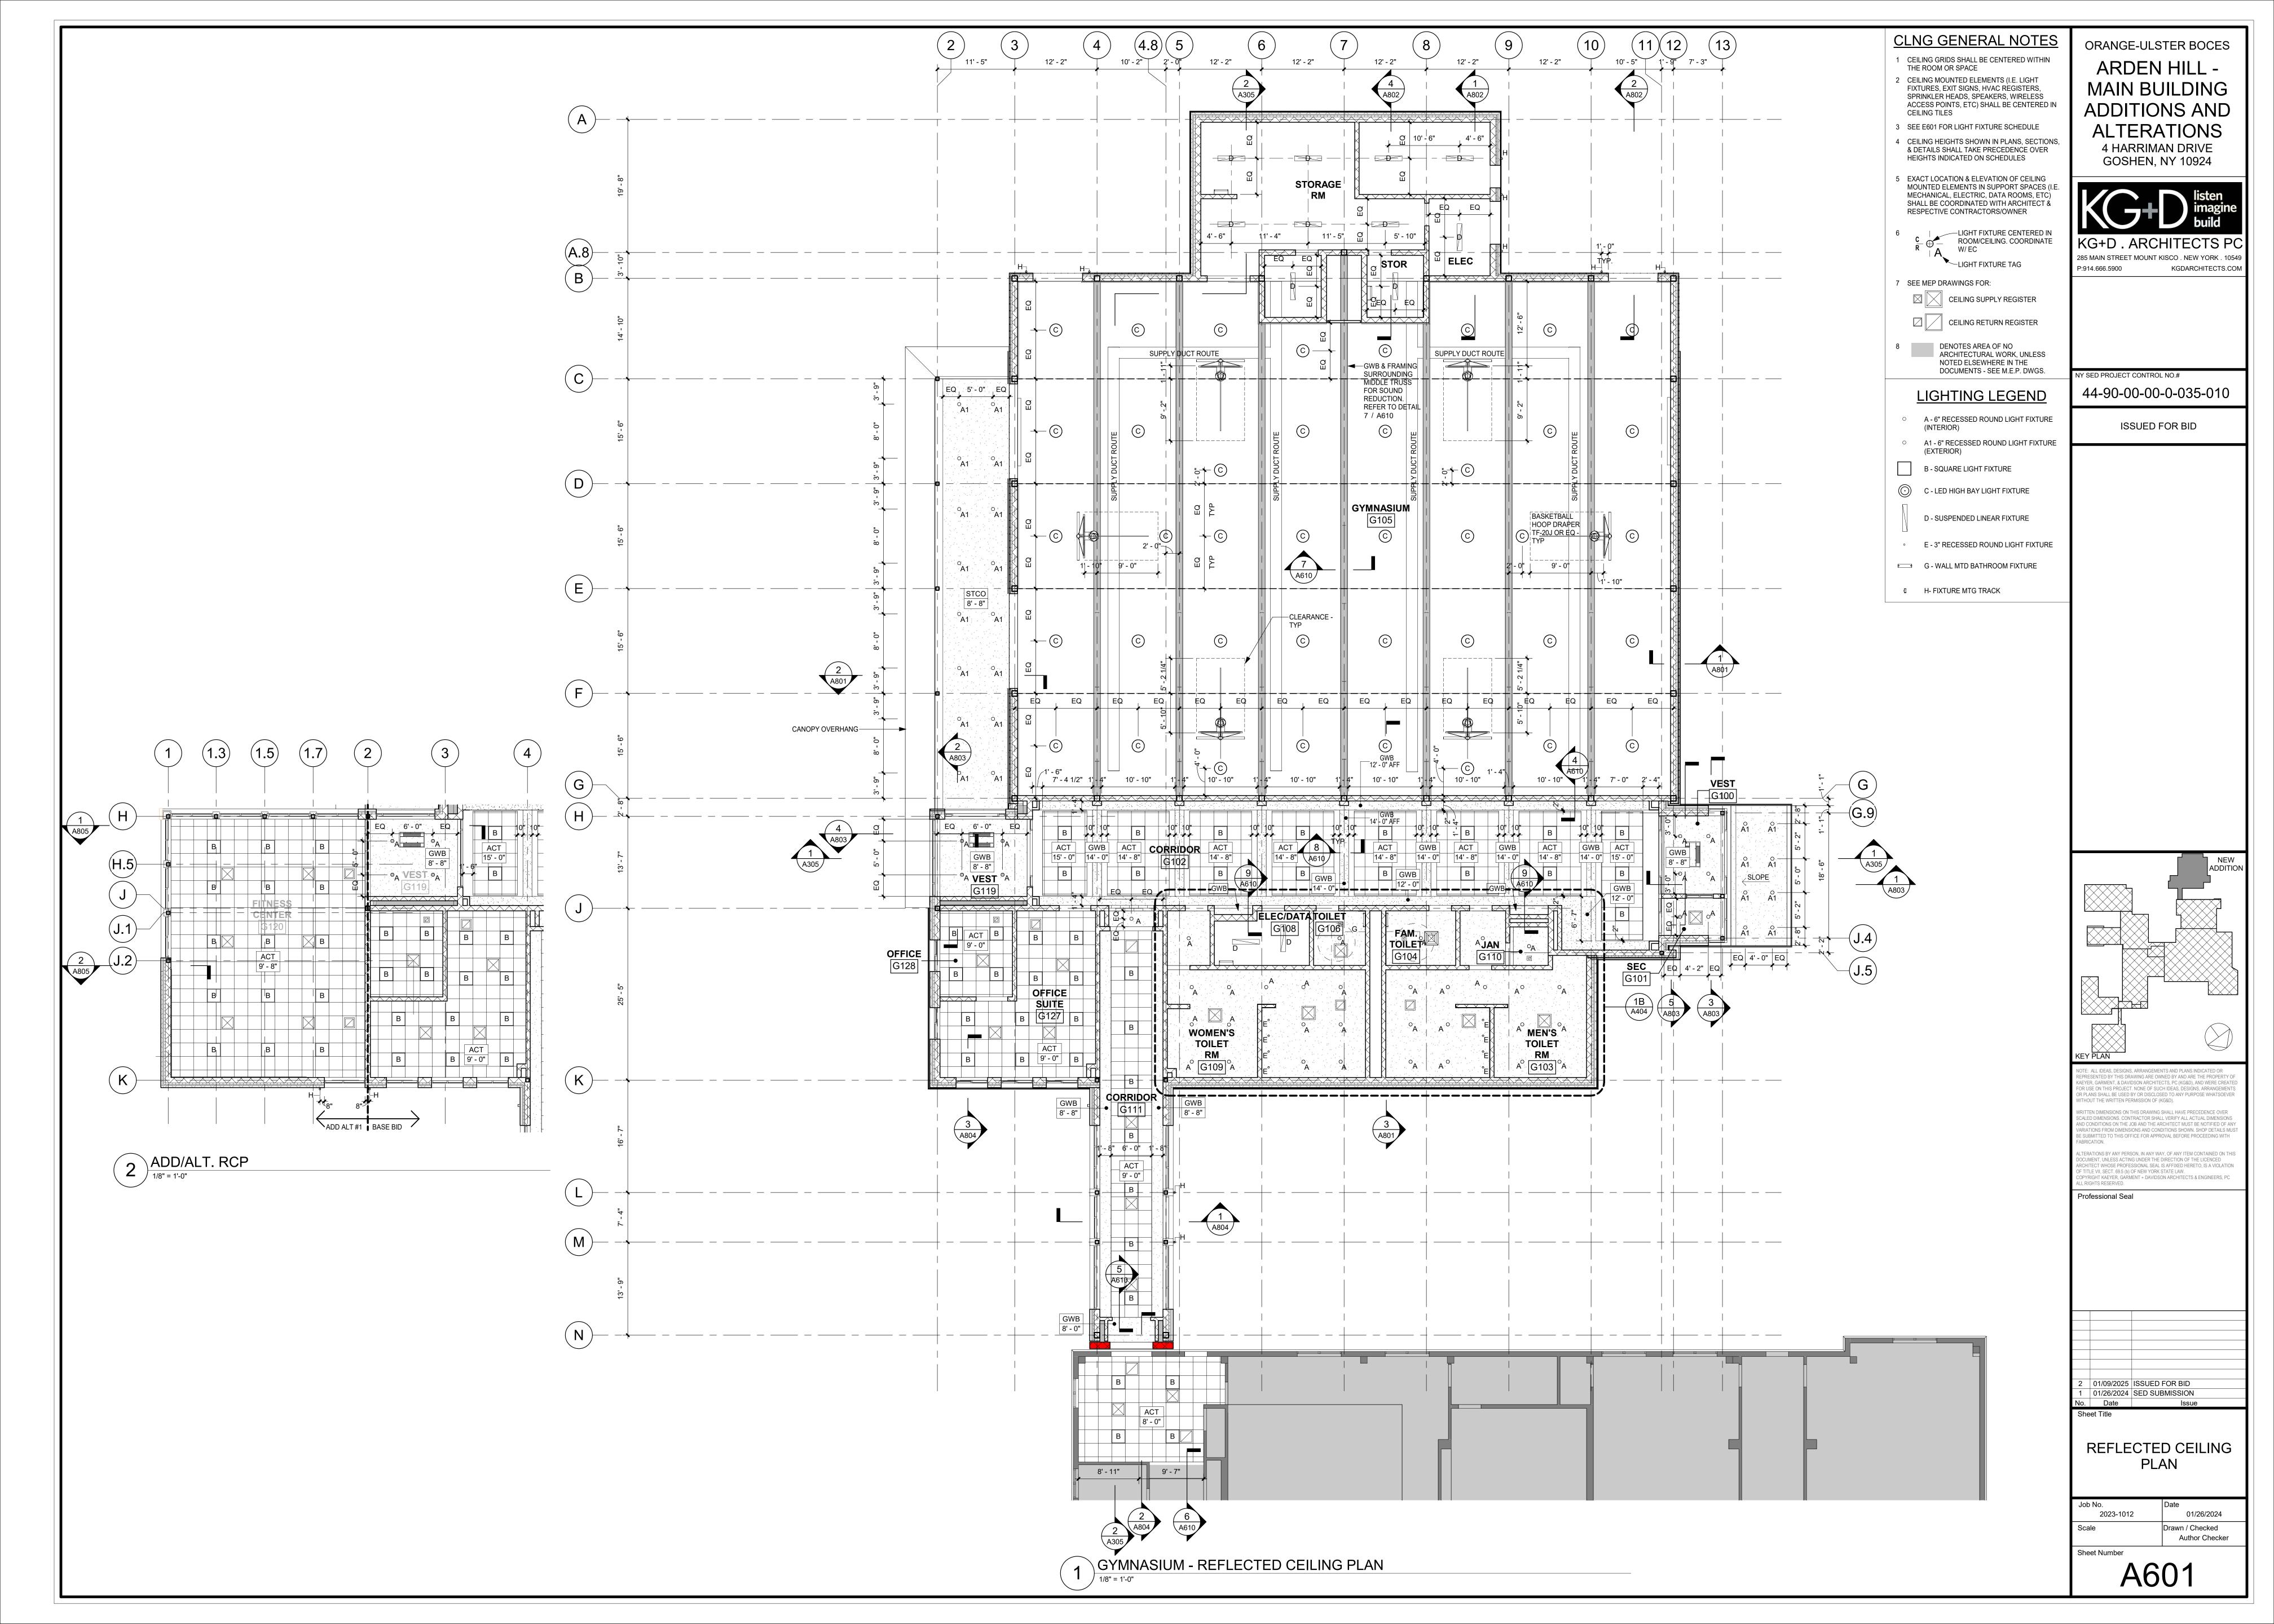



ORANGE-ULSTER BOCES






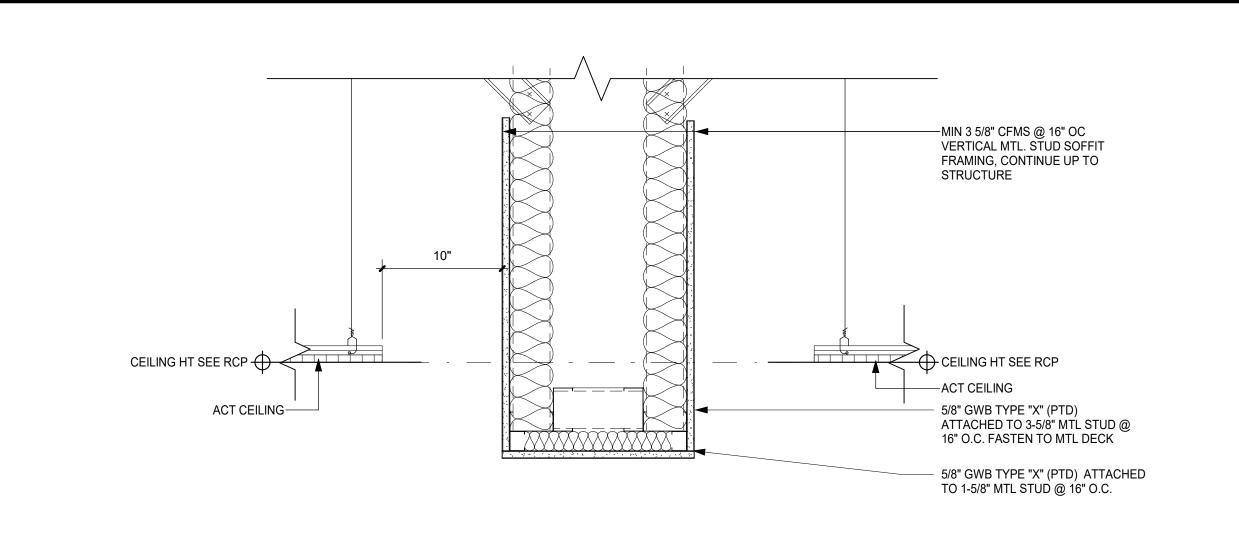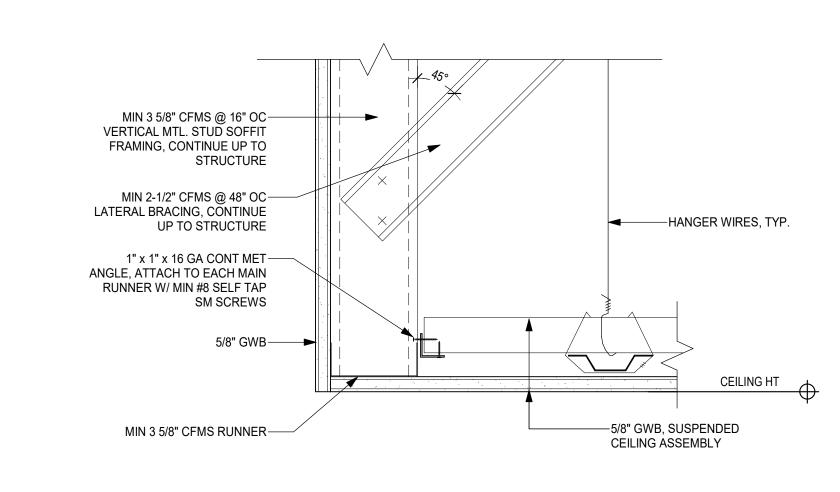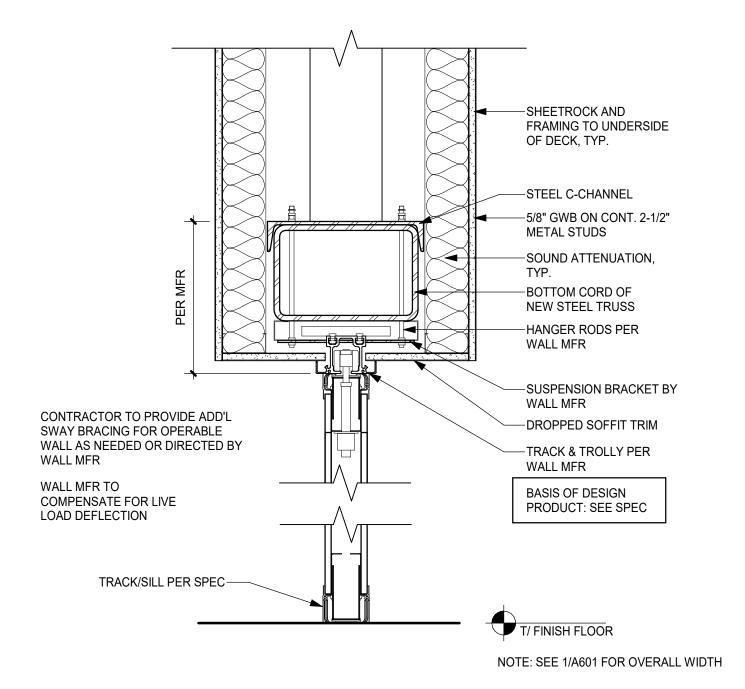
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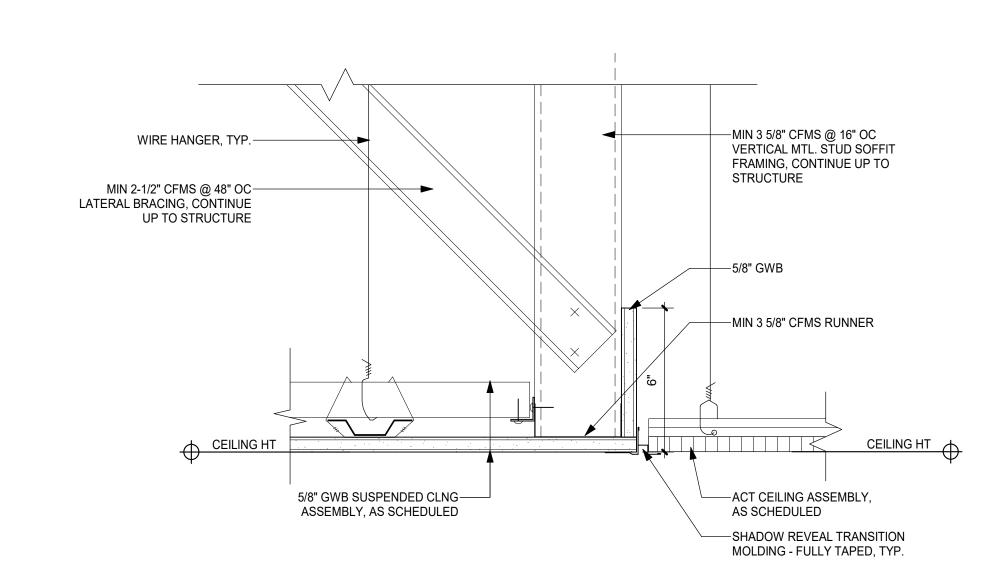







8 CEILING SOFFIT DETAIL @ CORRIDOR 4 CEILING DETAIL - GYP TO OPEN ABOVE 3" = 1'-0"






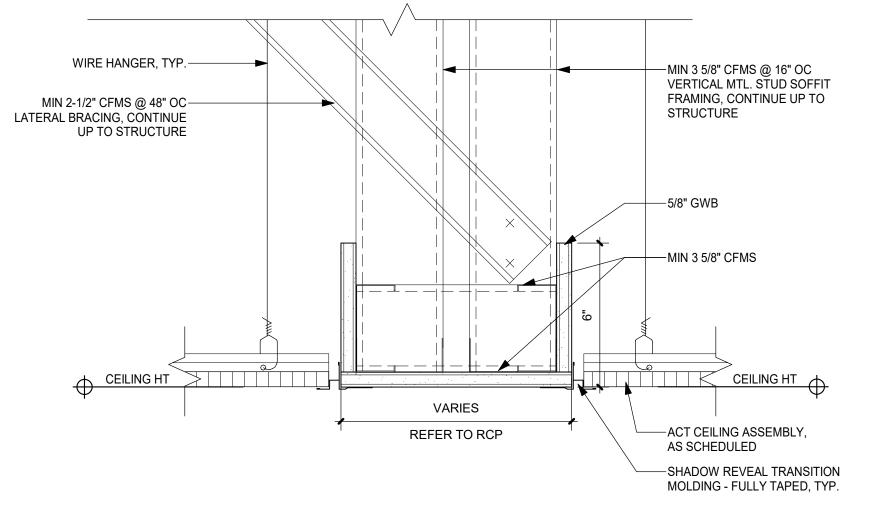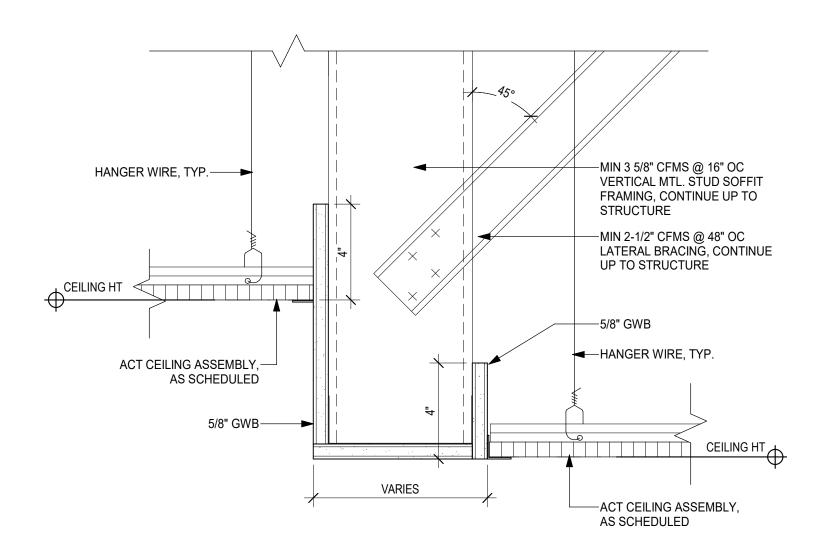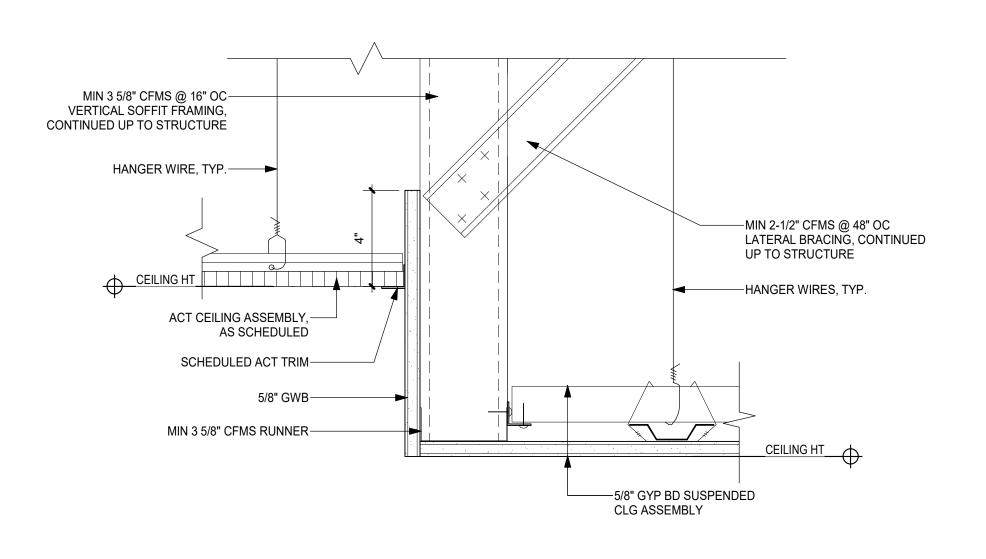
7 FOLDING MOVEABLE PARTITION WALL













CEILING DETAIL - ACT TO ACT BULKHEAD

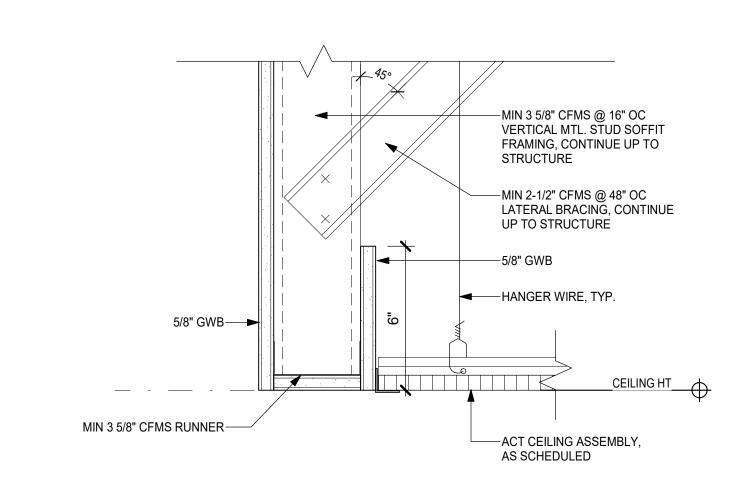3" = 1'-0"



CEILING DETAIL - ACT & GYP. SOFFIT

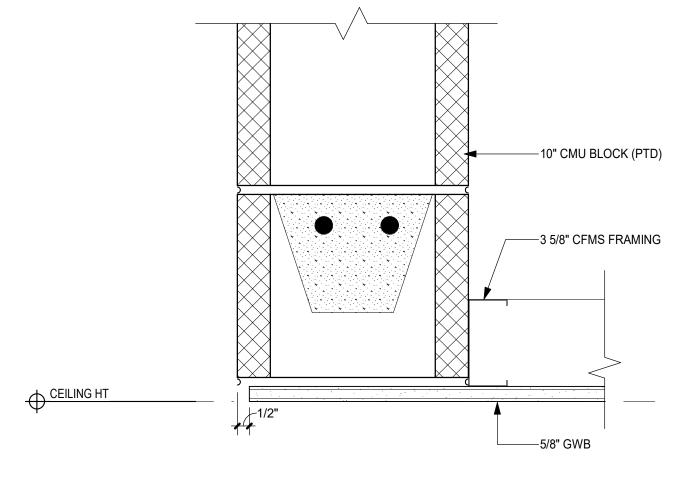

9 CEILING DETAIL - GYP MASONRY SOFFIT

5 CEILING DETAIL - GWB TO ACT BULKHEAD

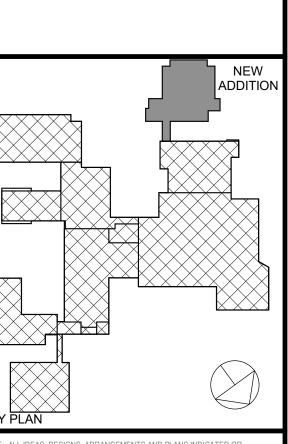
3" = 1'-0"

ARDEN HILL MAIN BUILDING
ADDITIONS AND
ALTERATIONS
4 HARRIMAN DRIVE
GOSHEN, NY 10924



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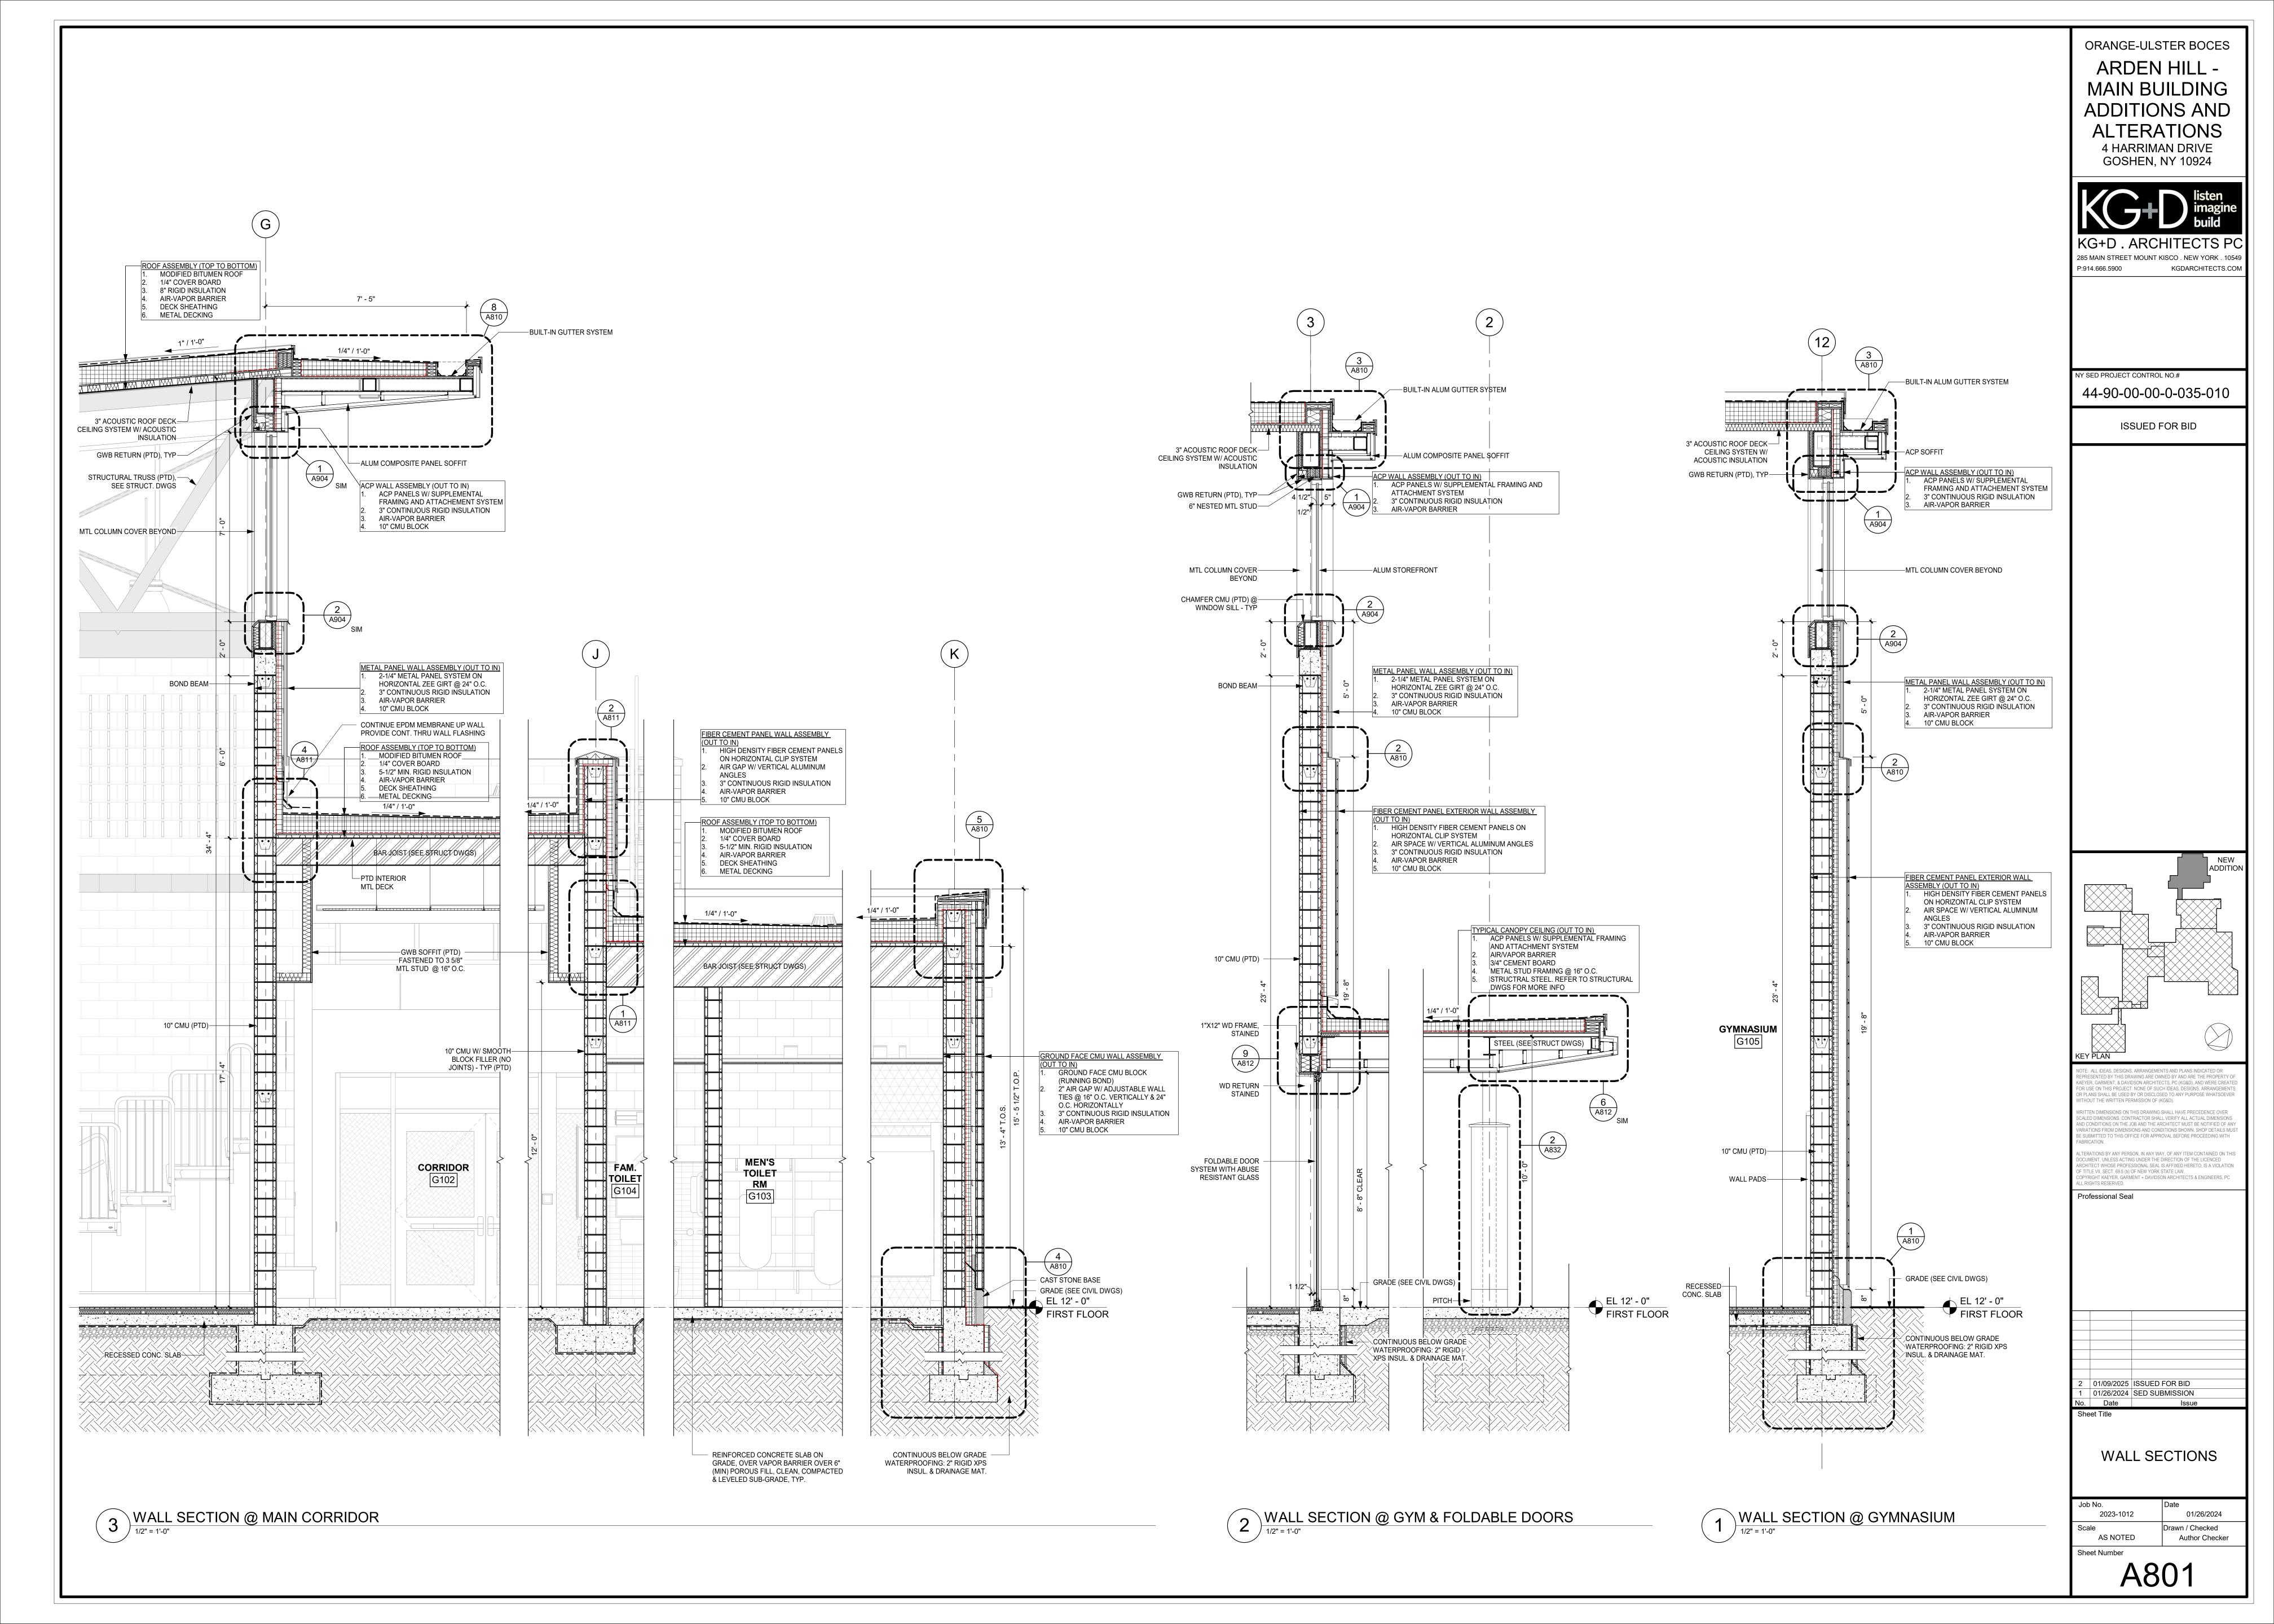
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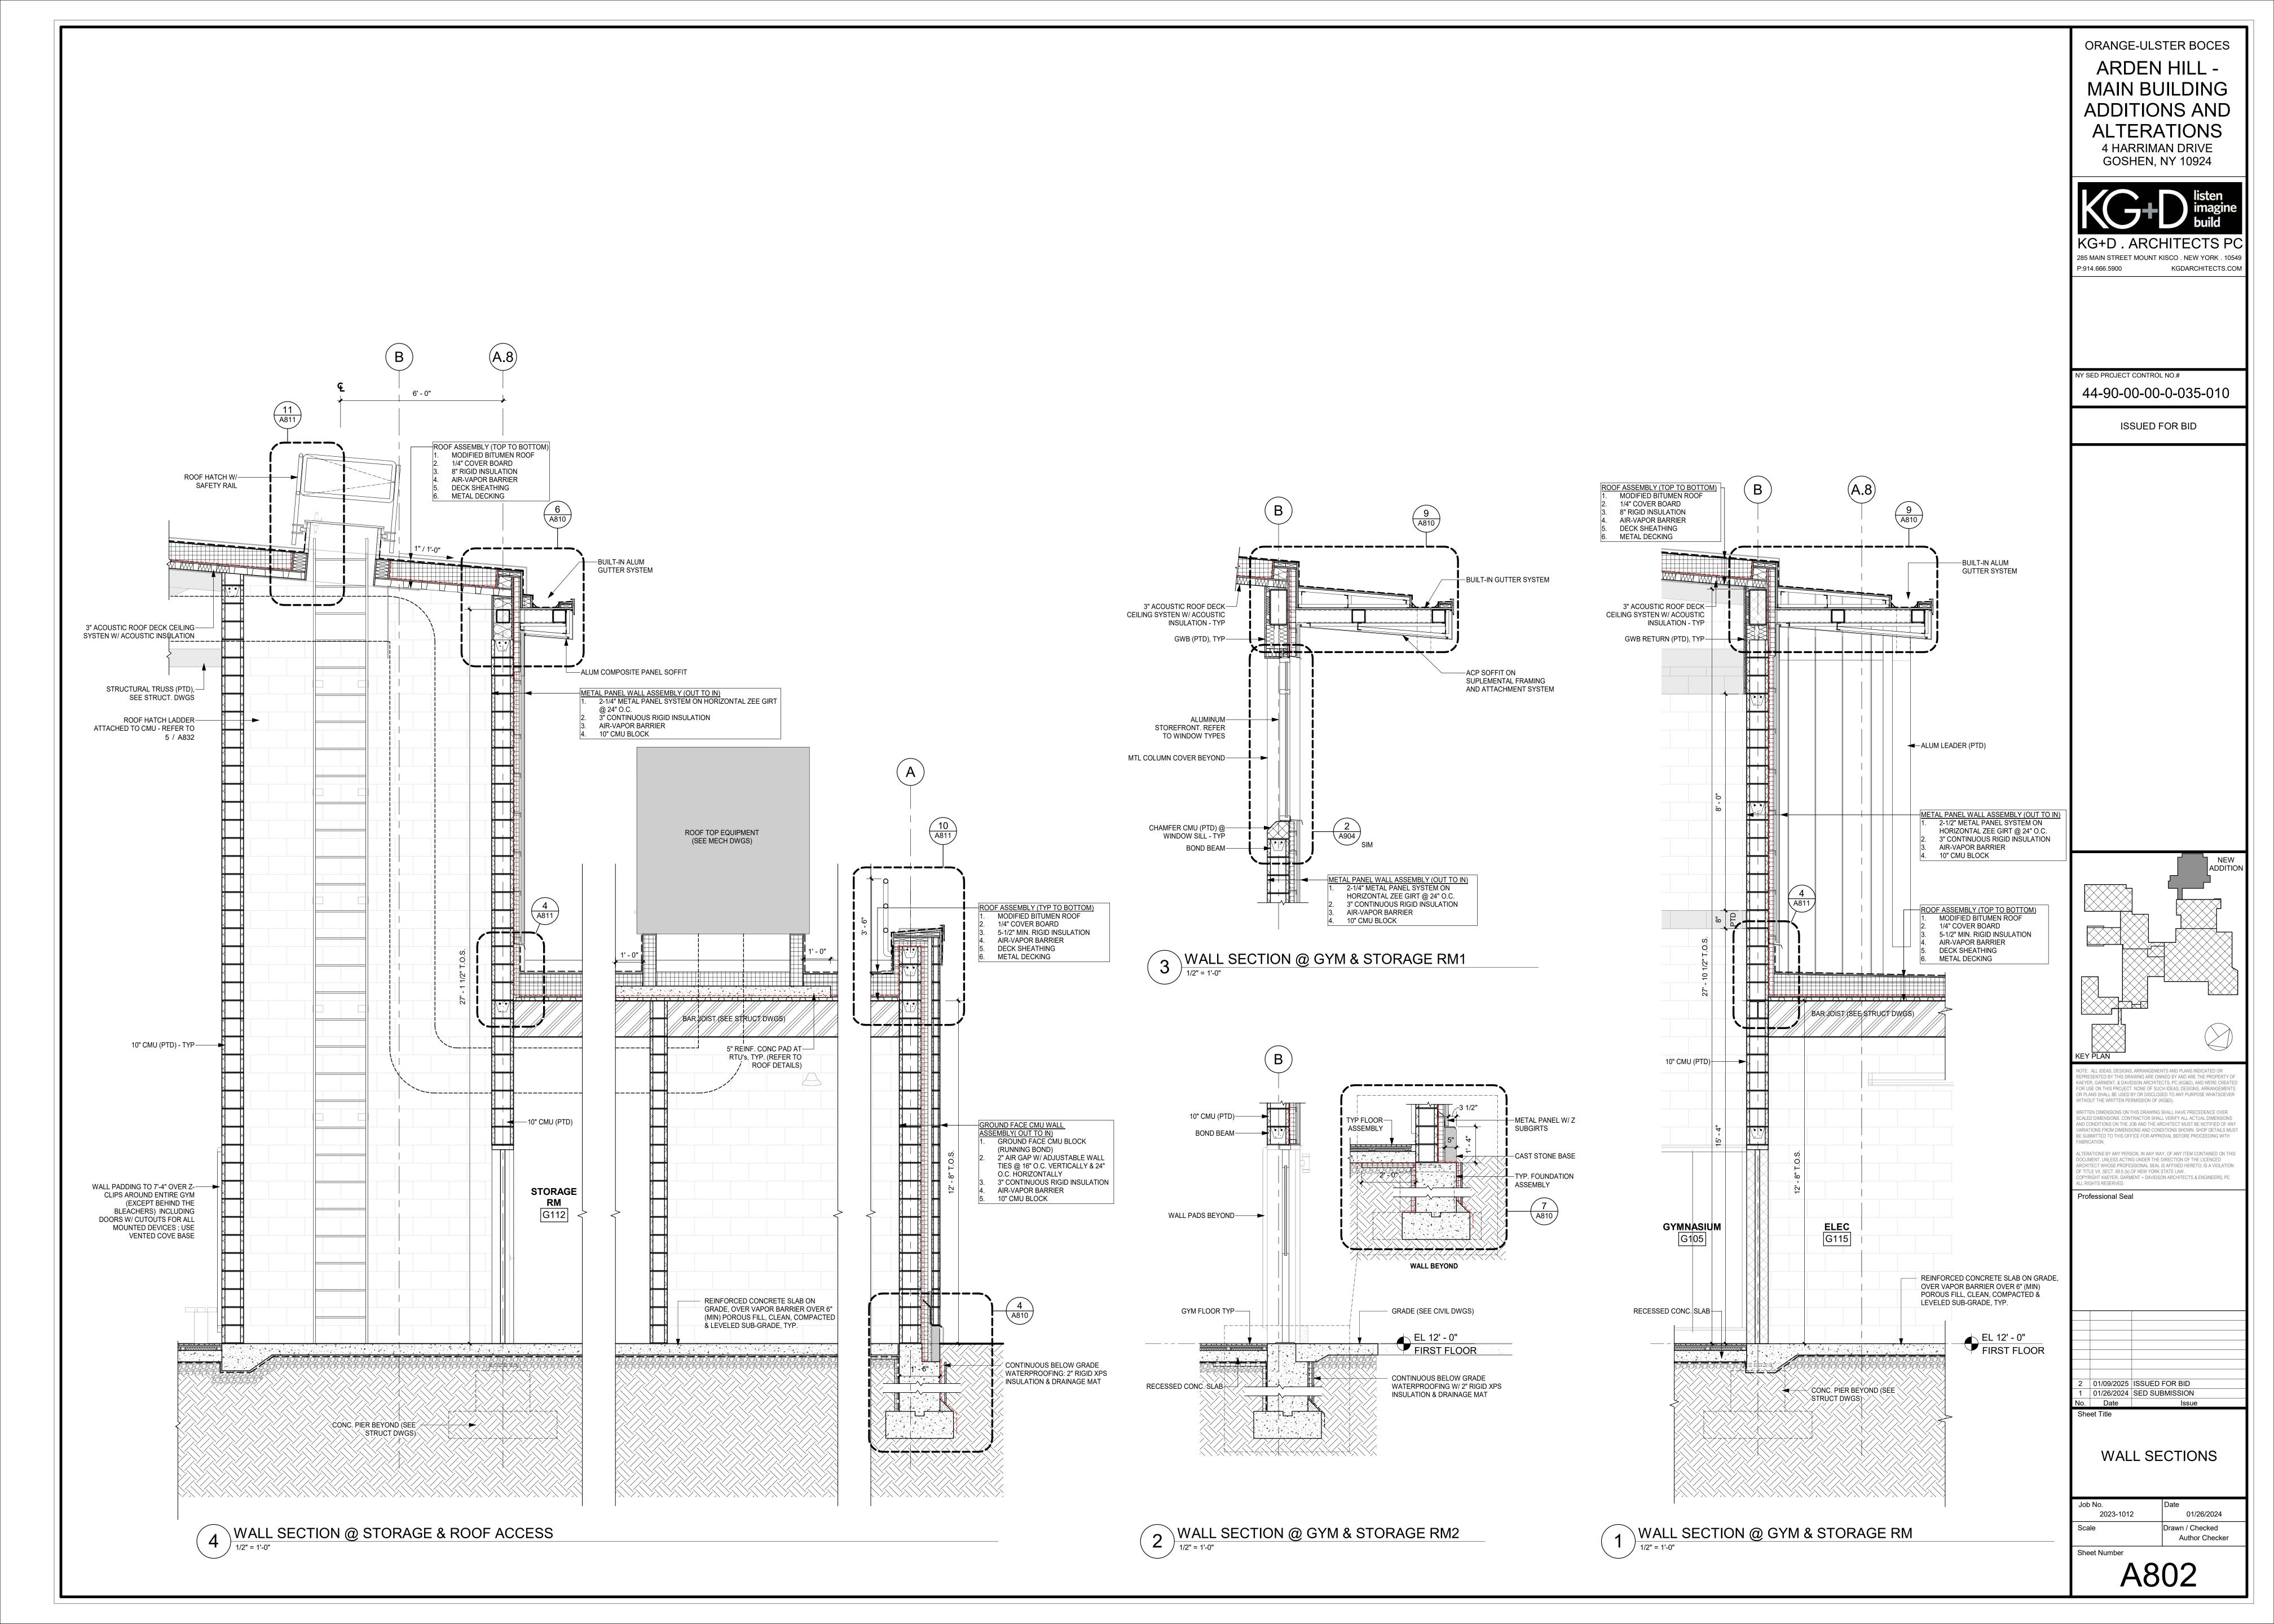
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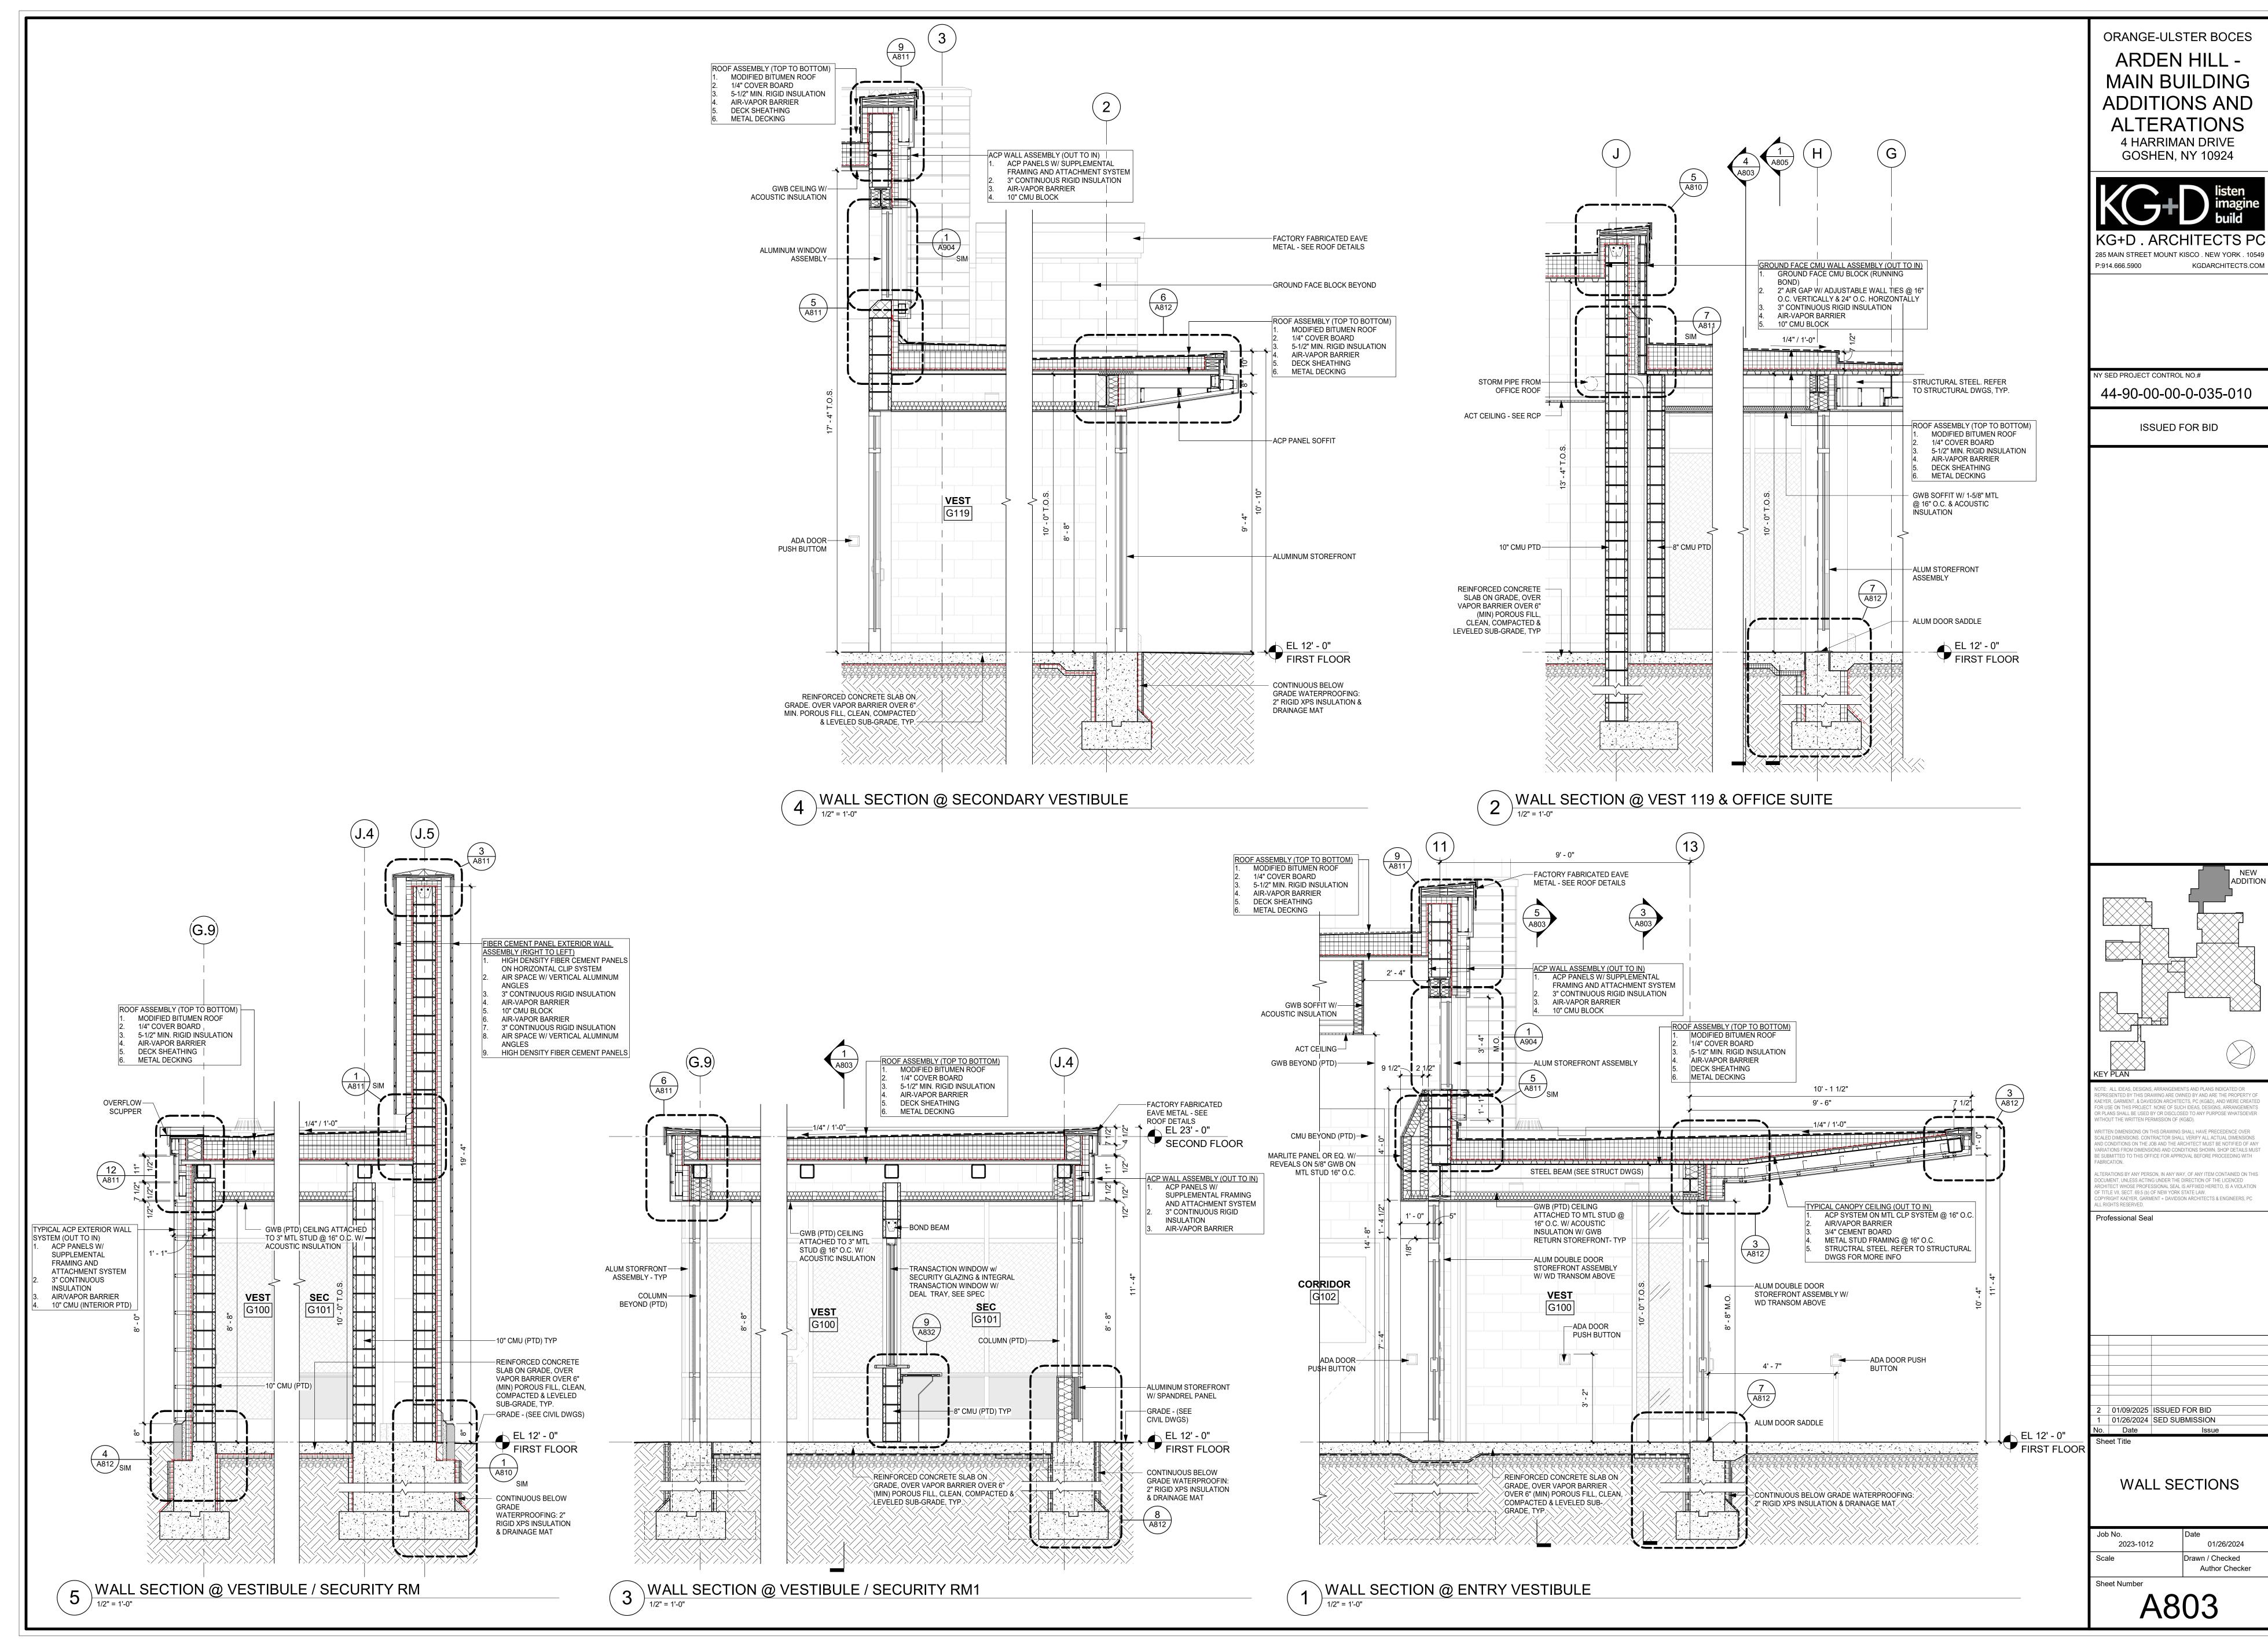
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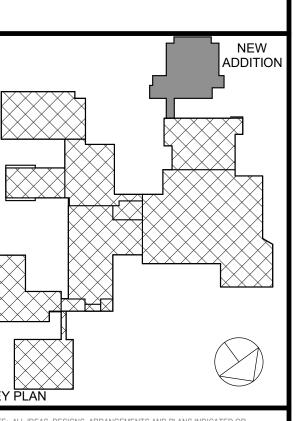
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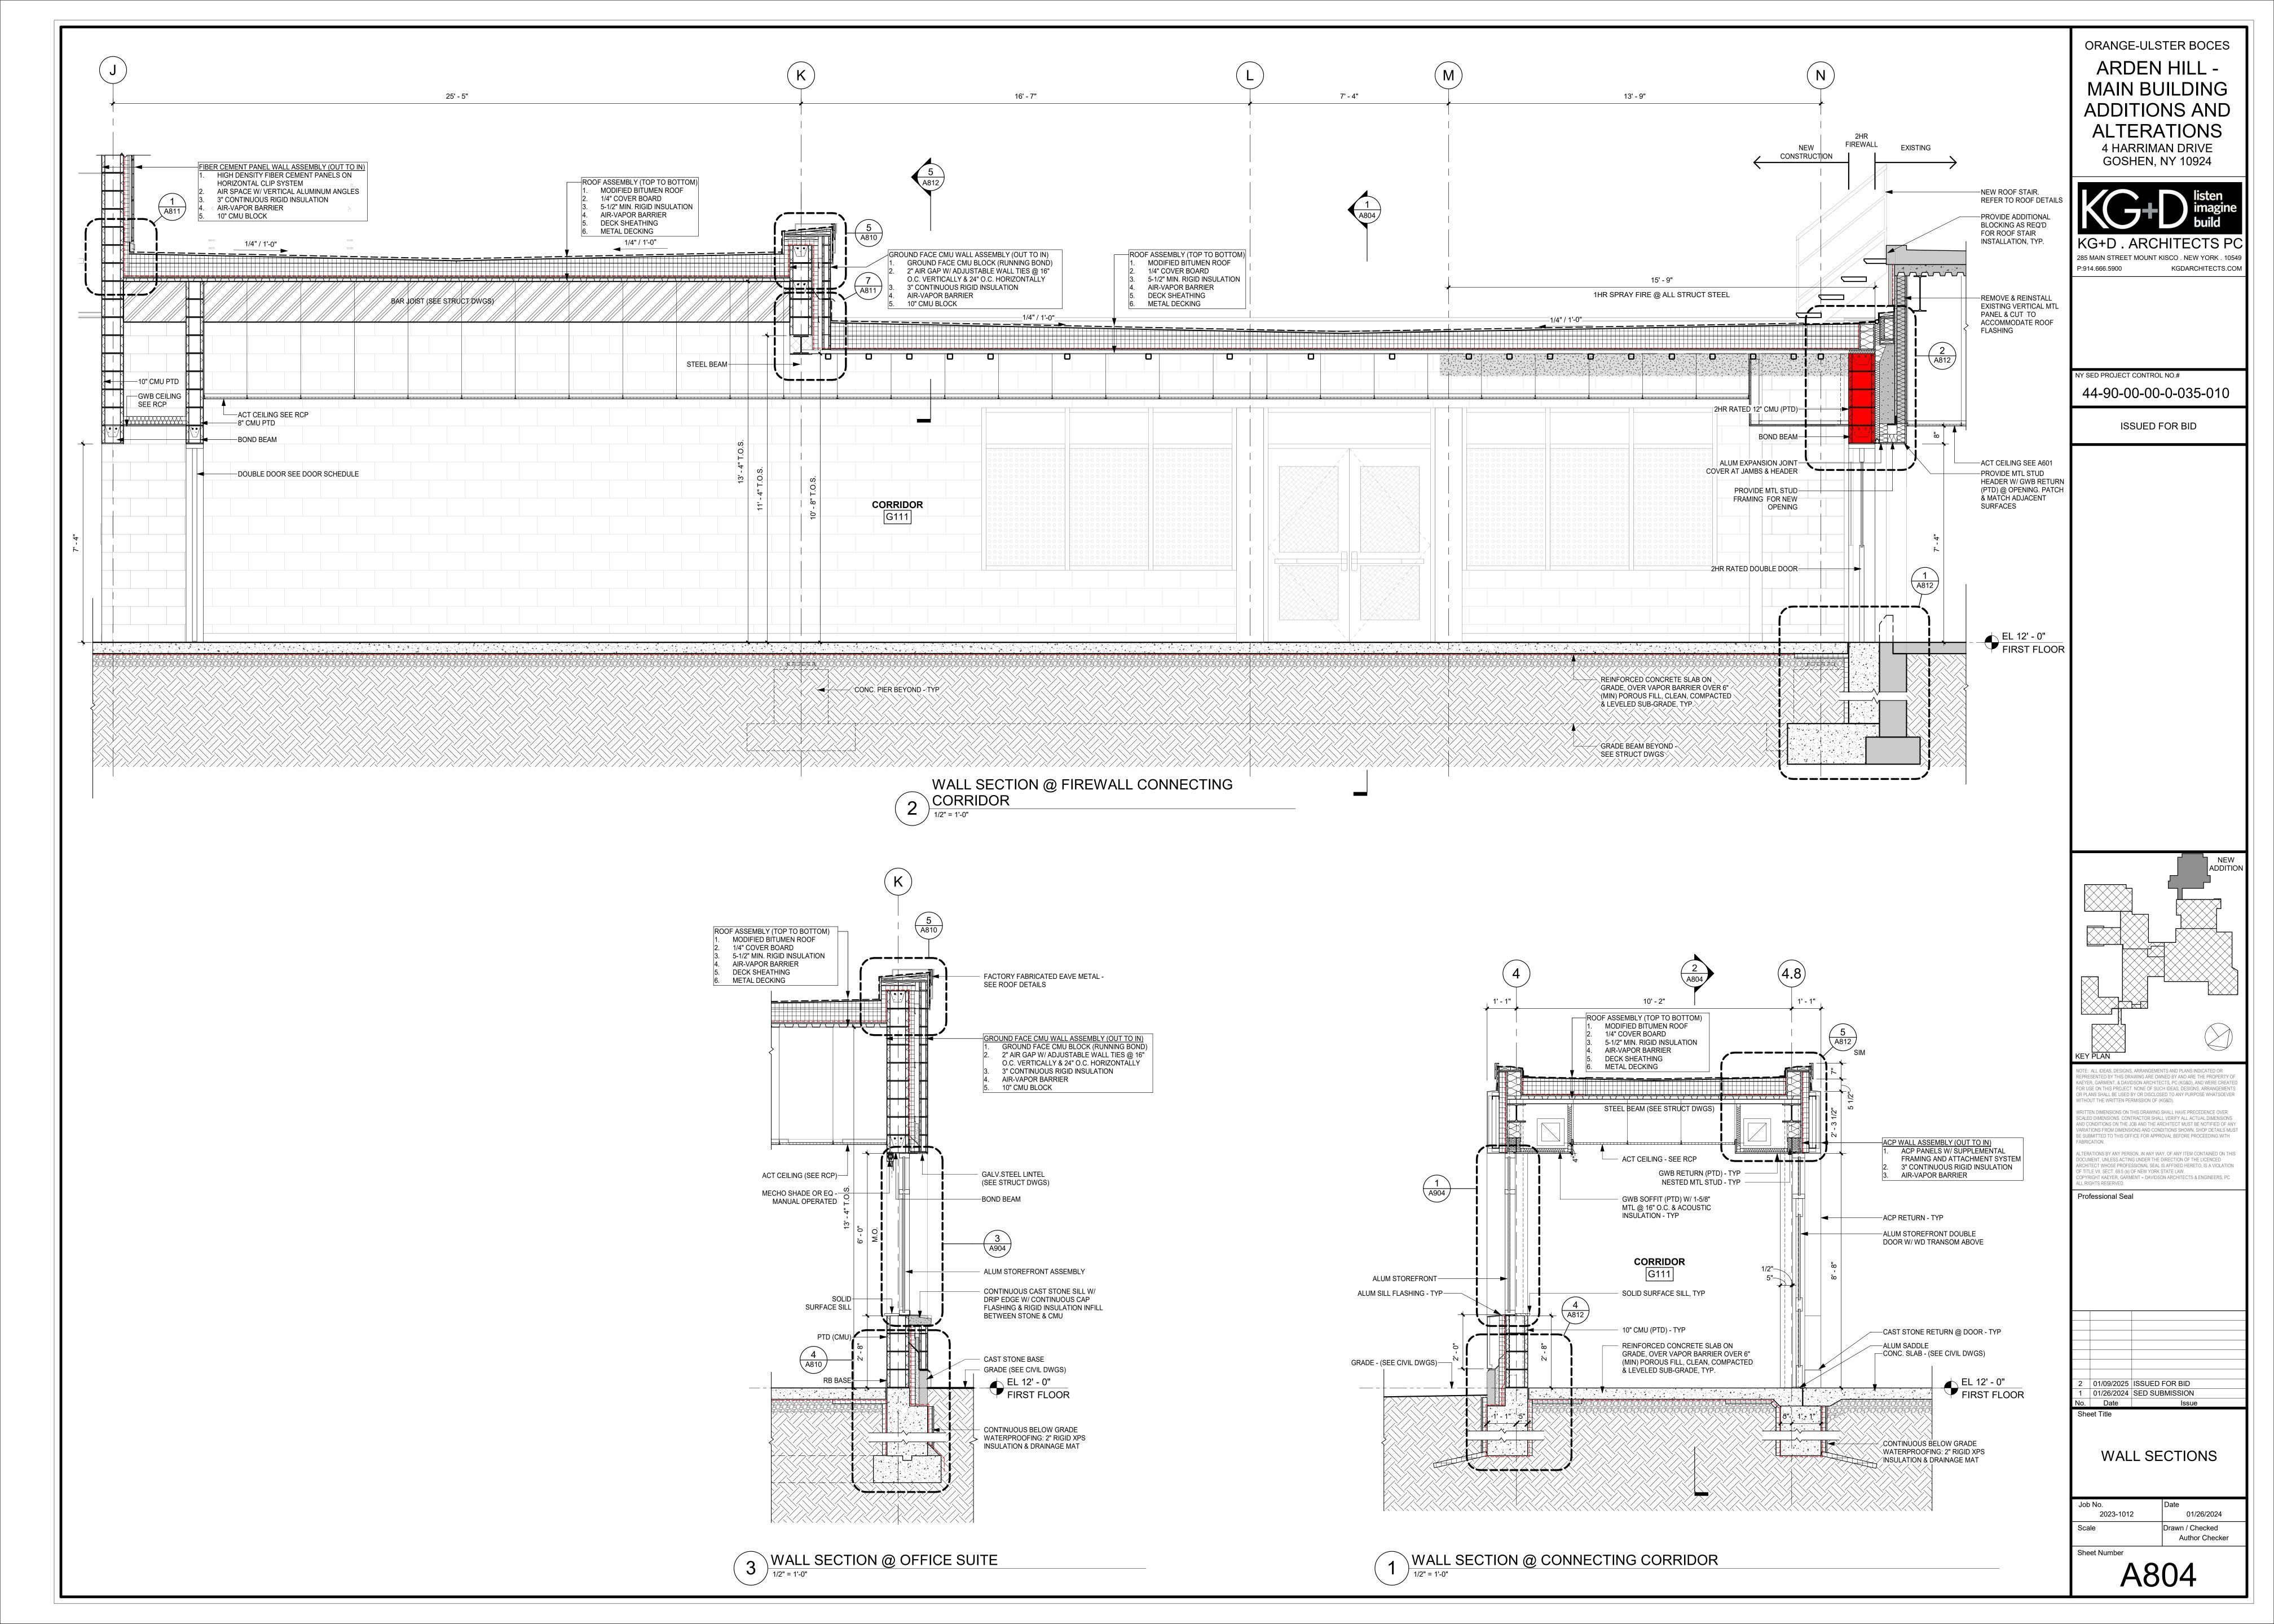


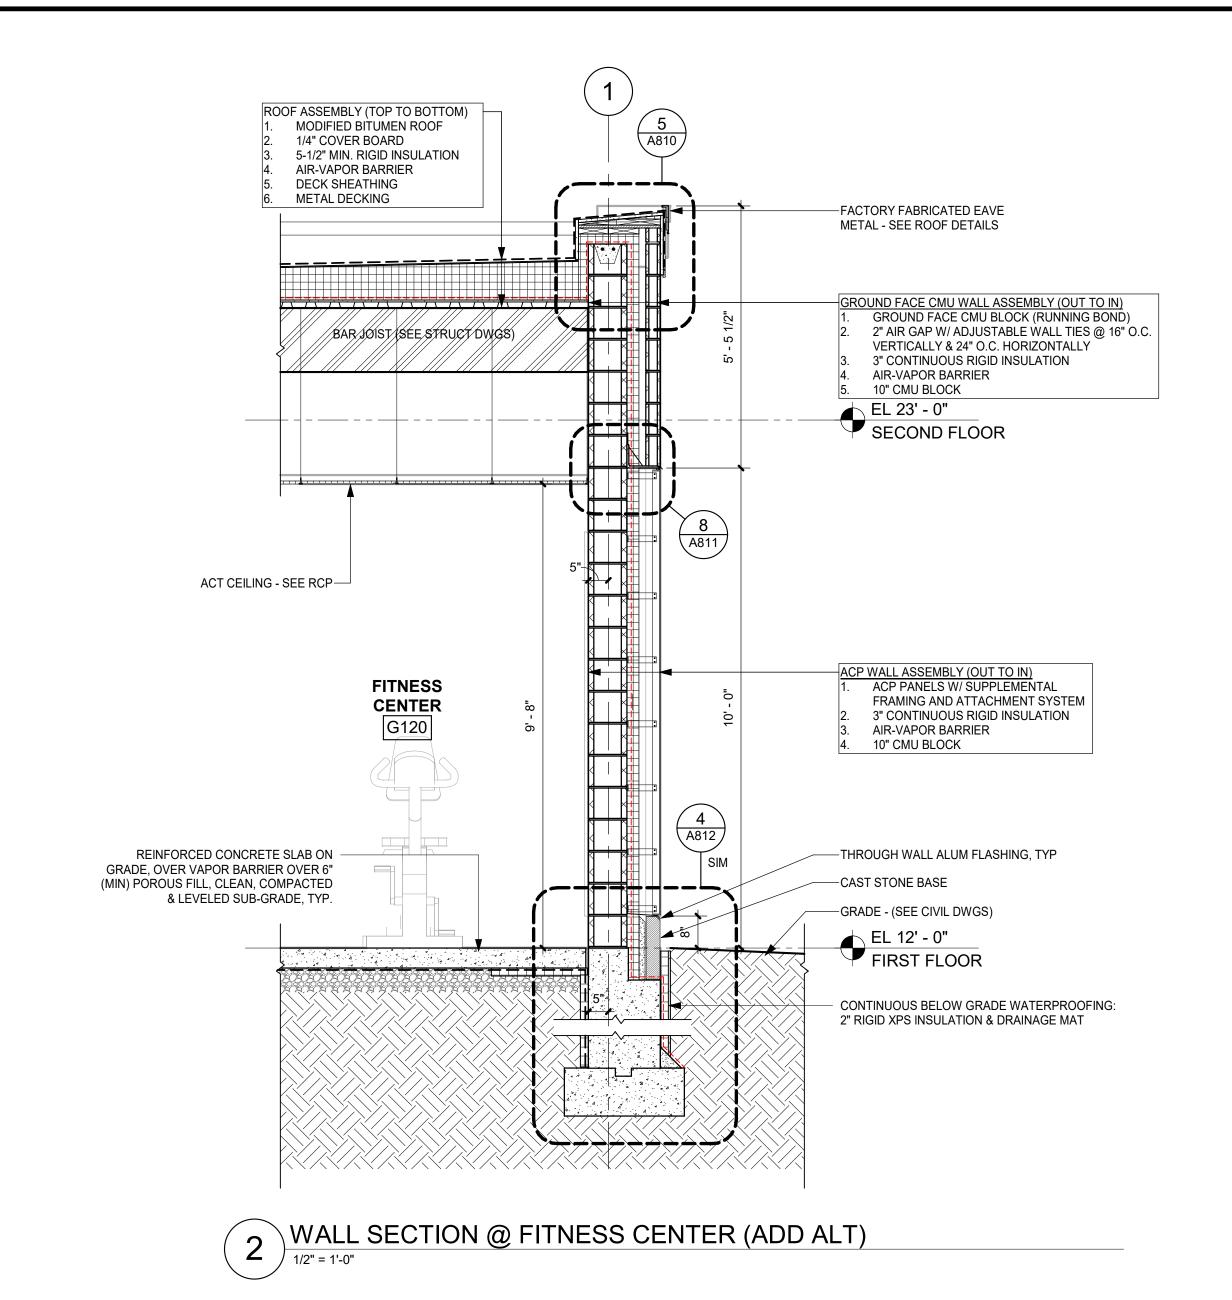


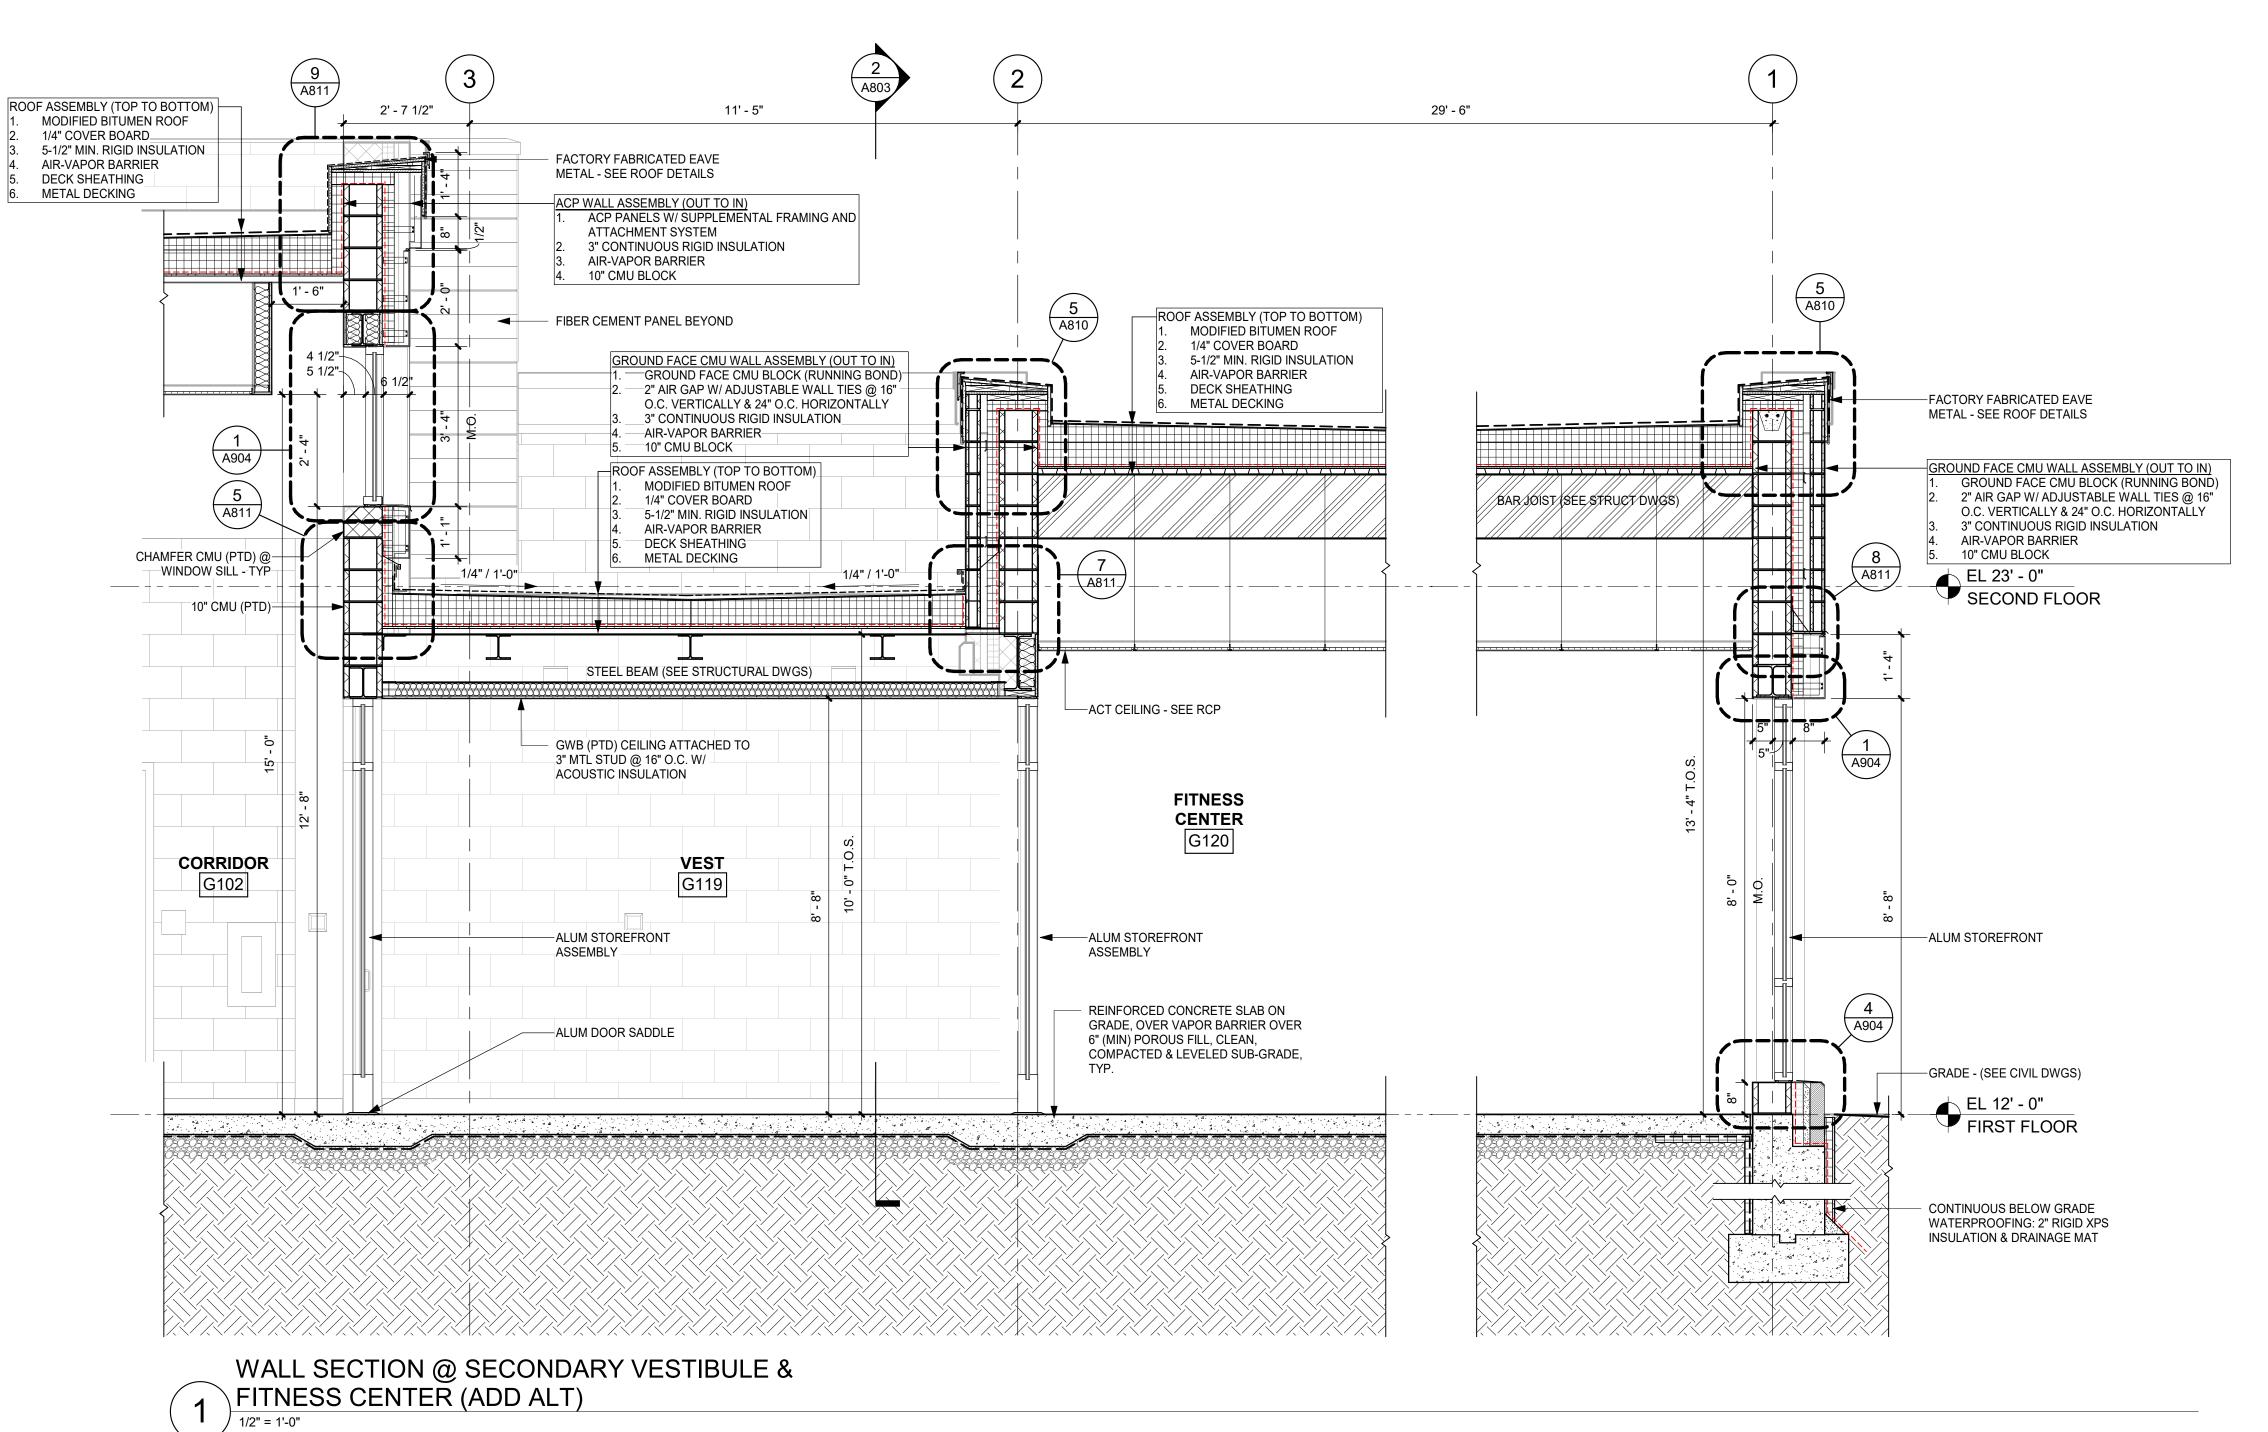












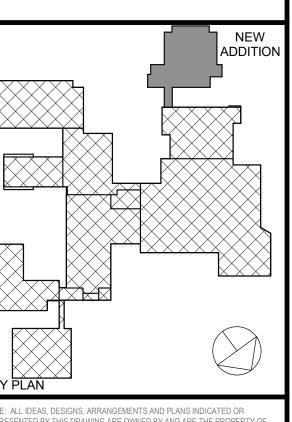


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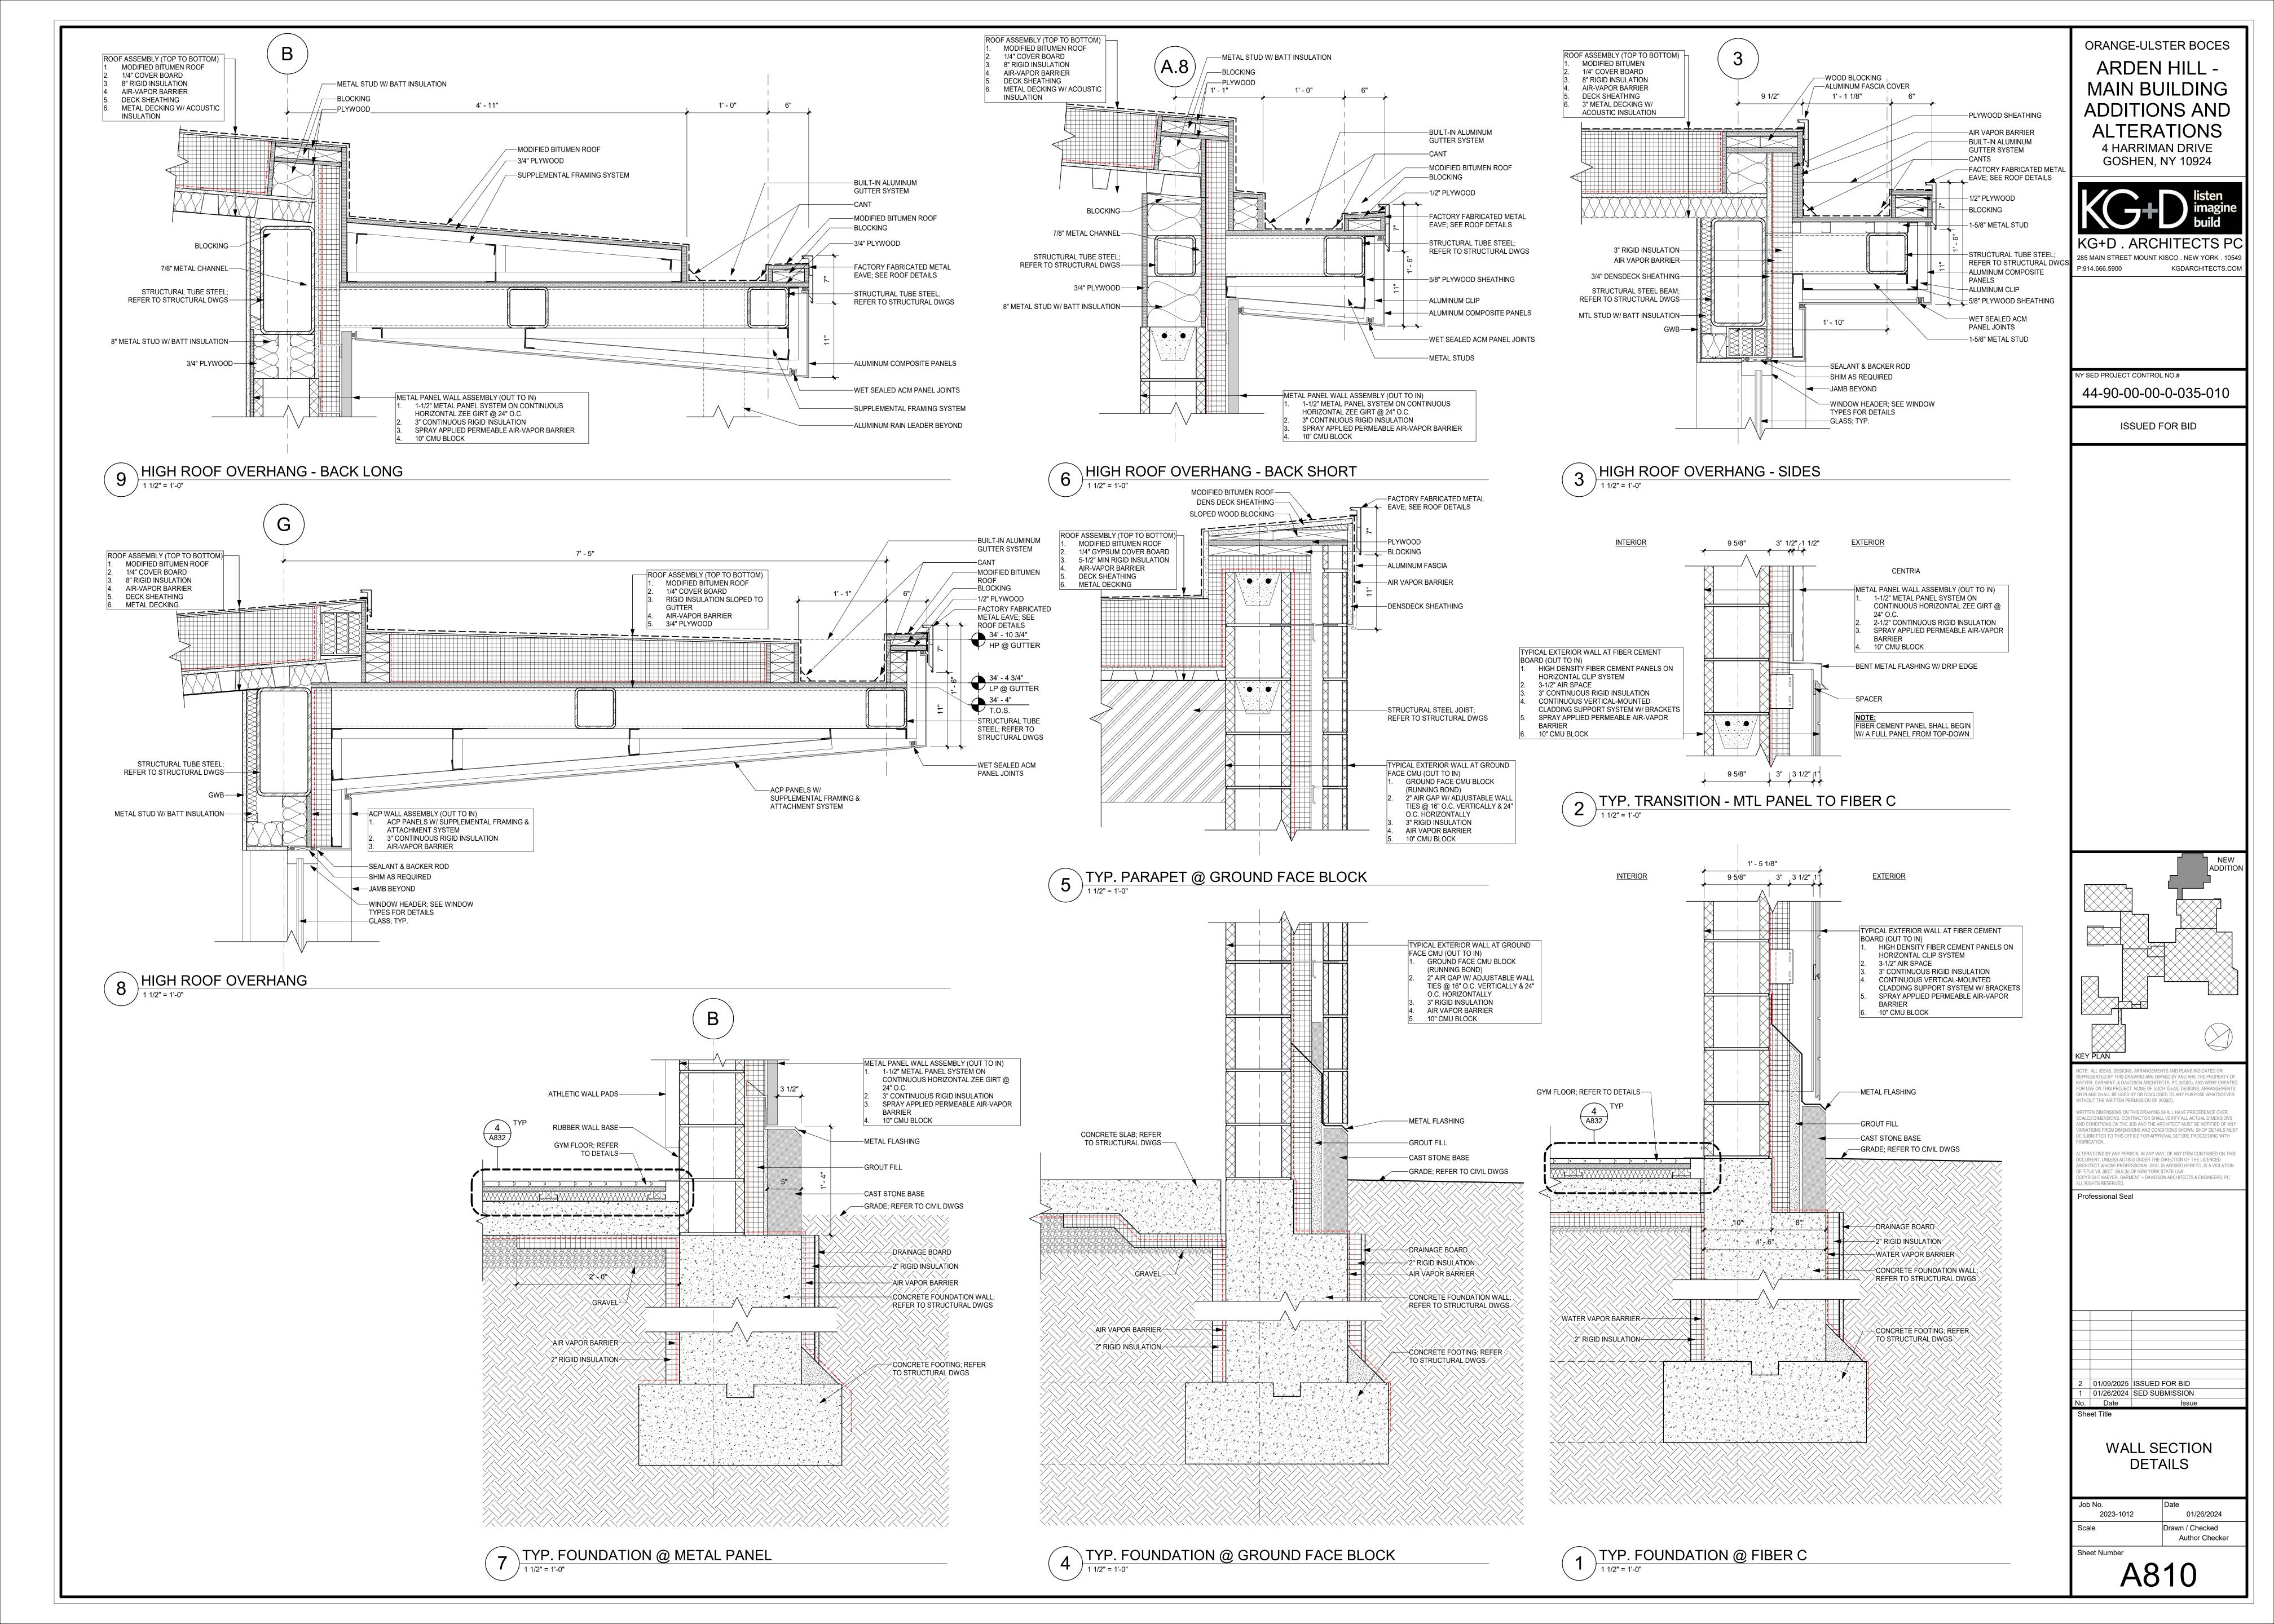
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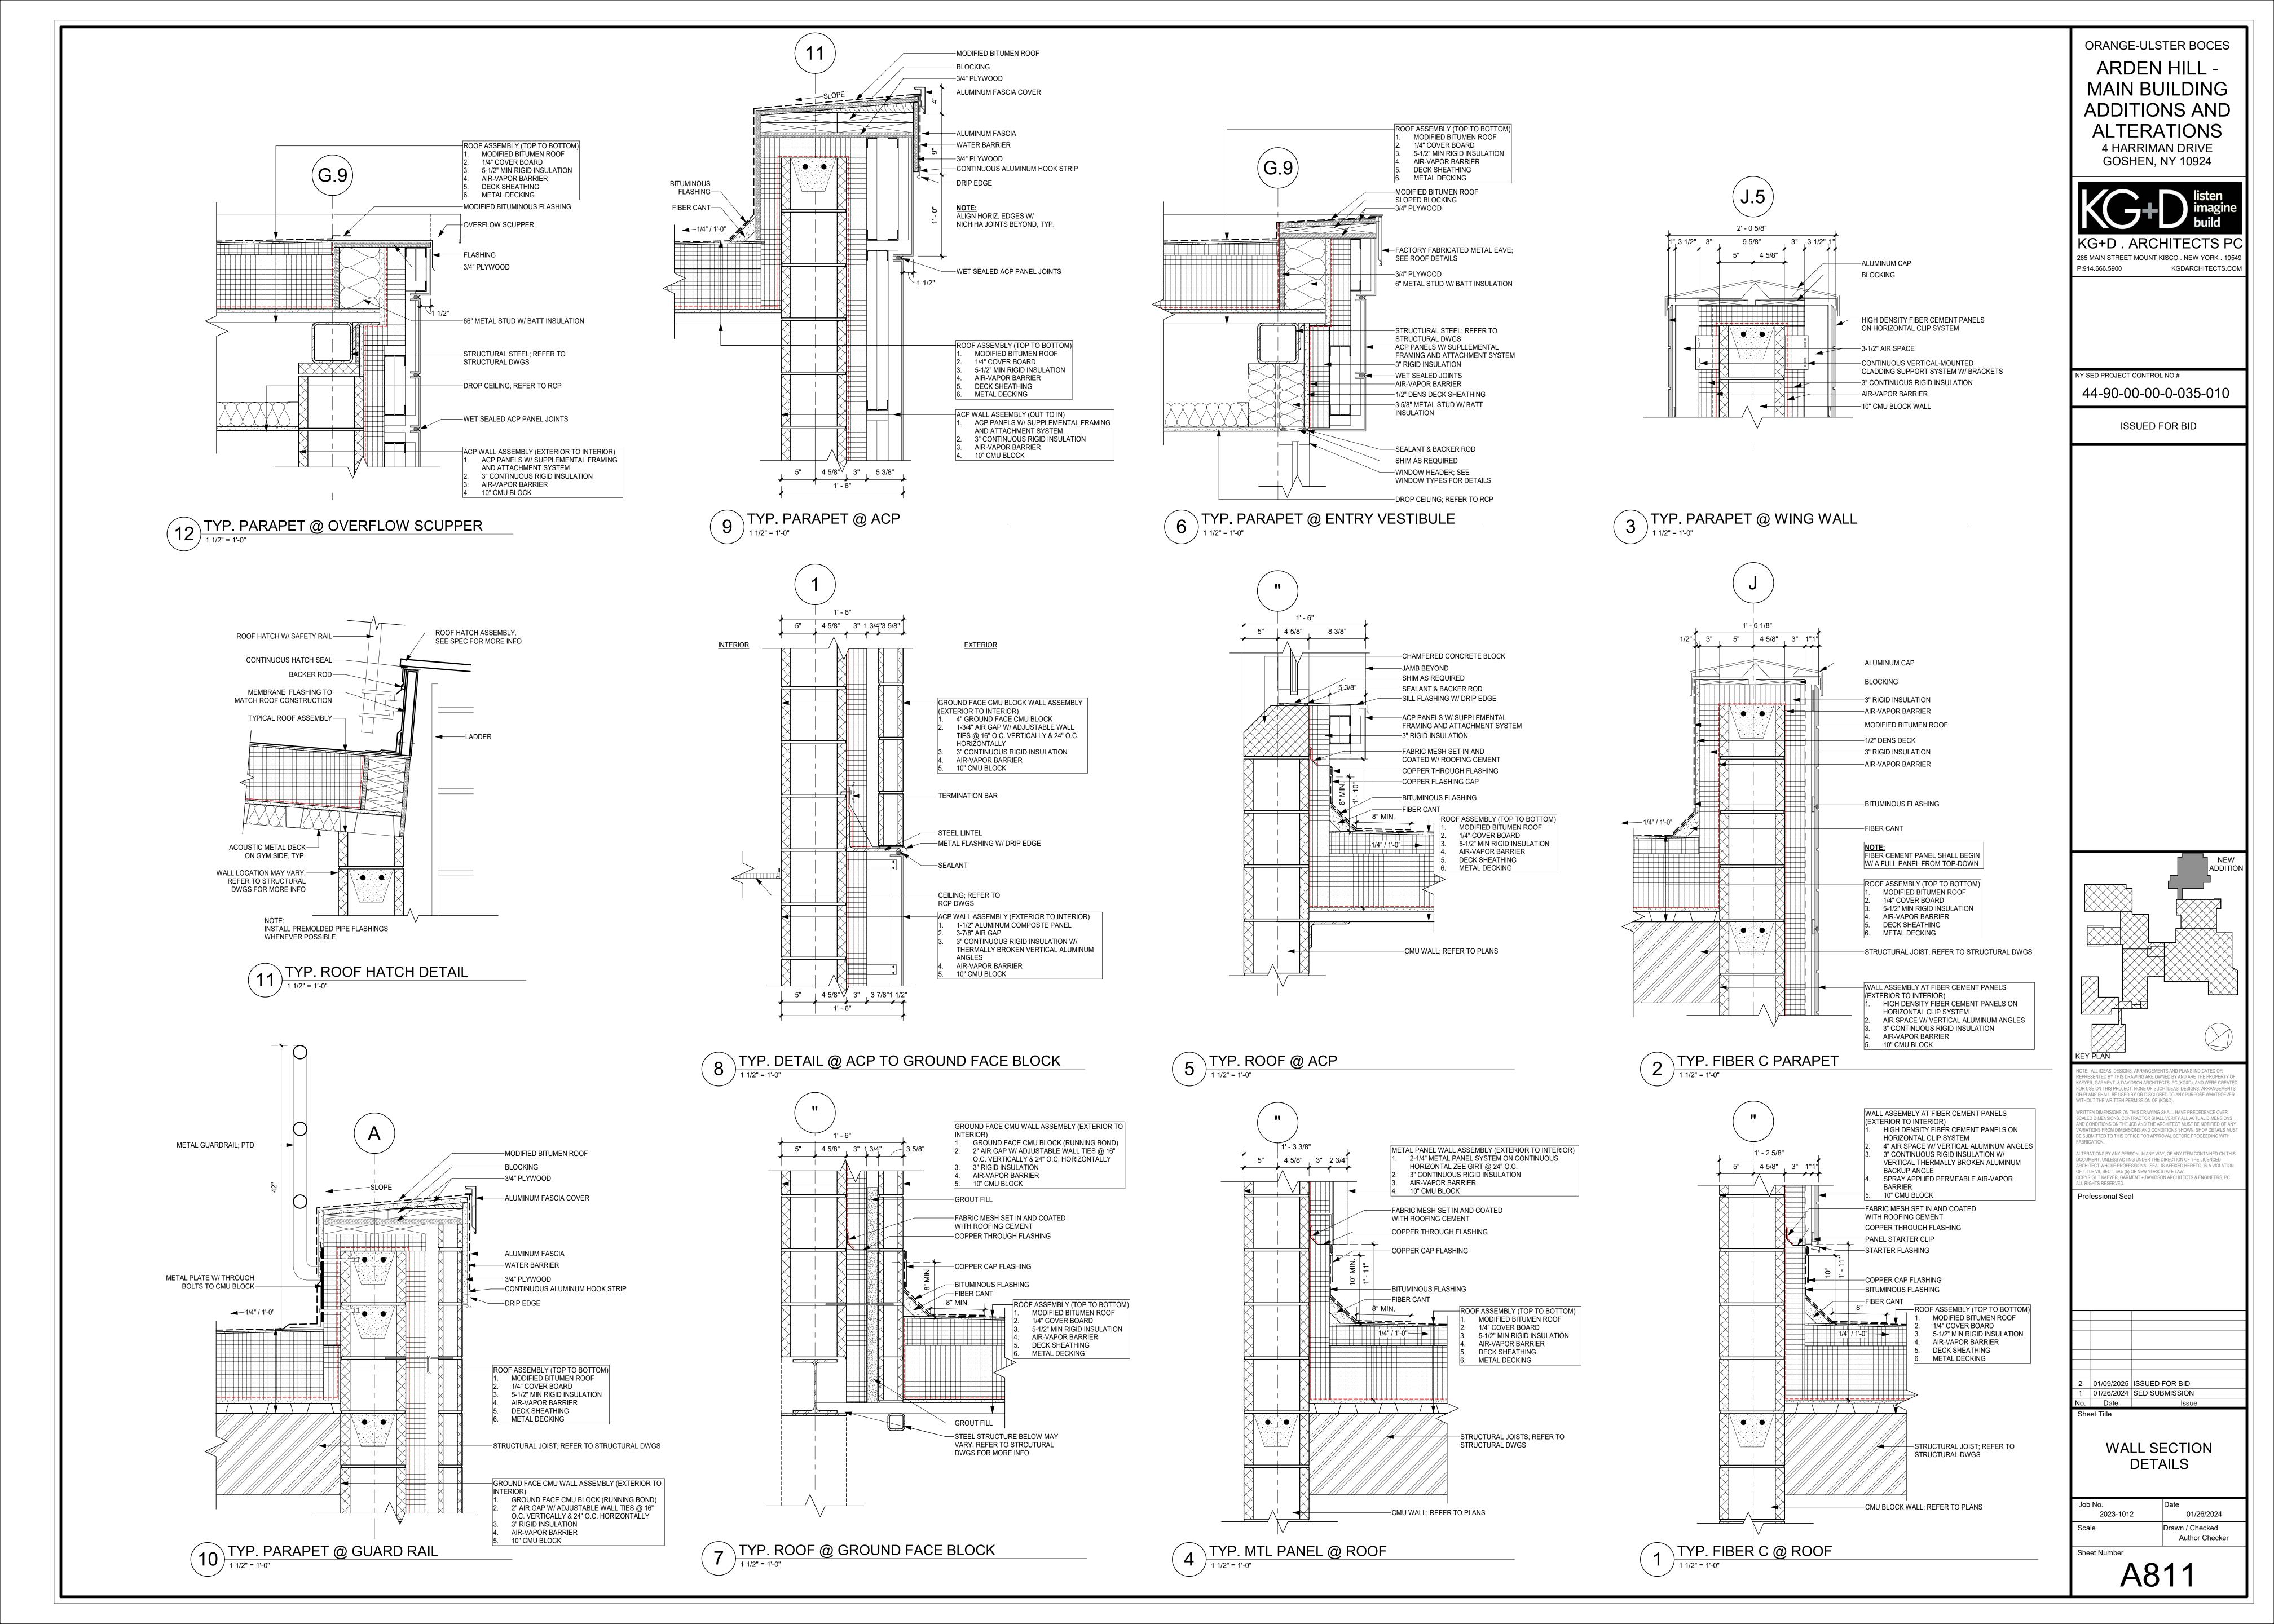
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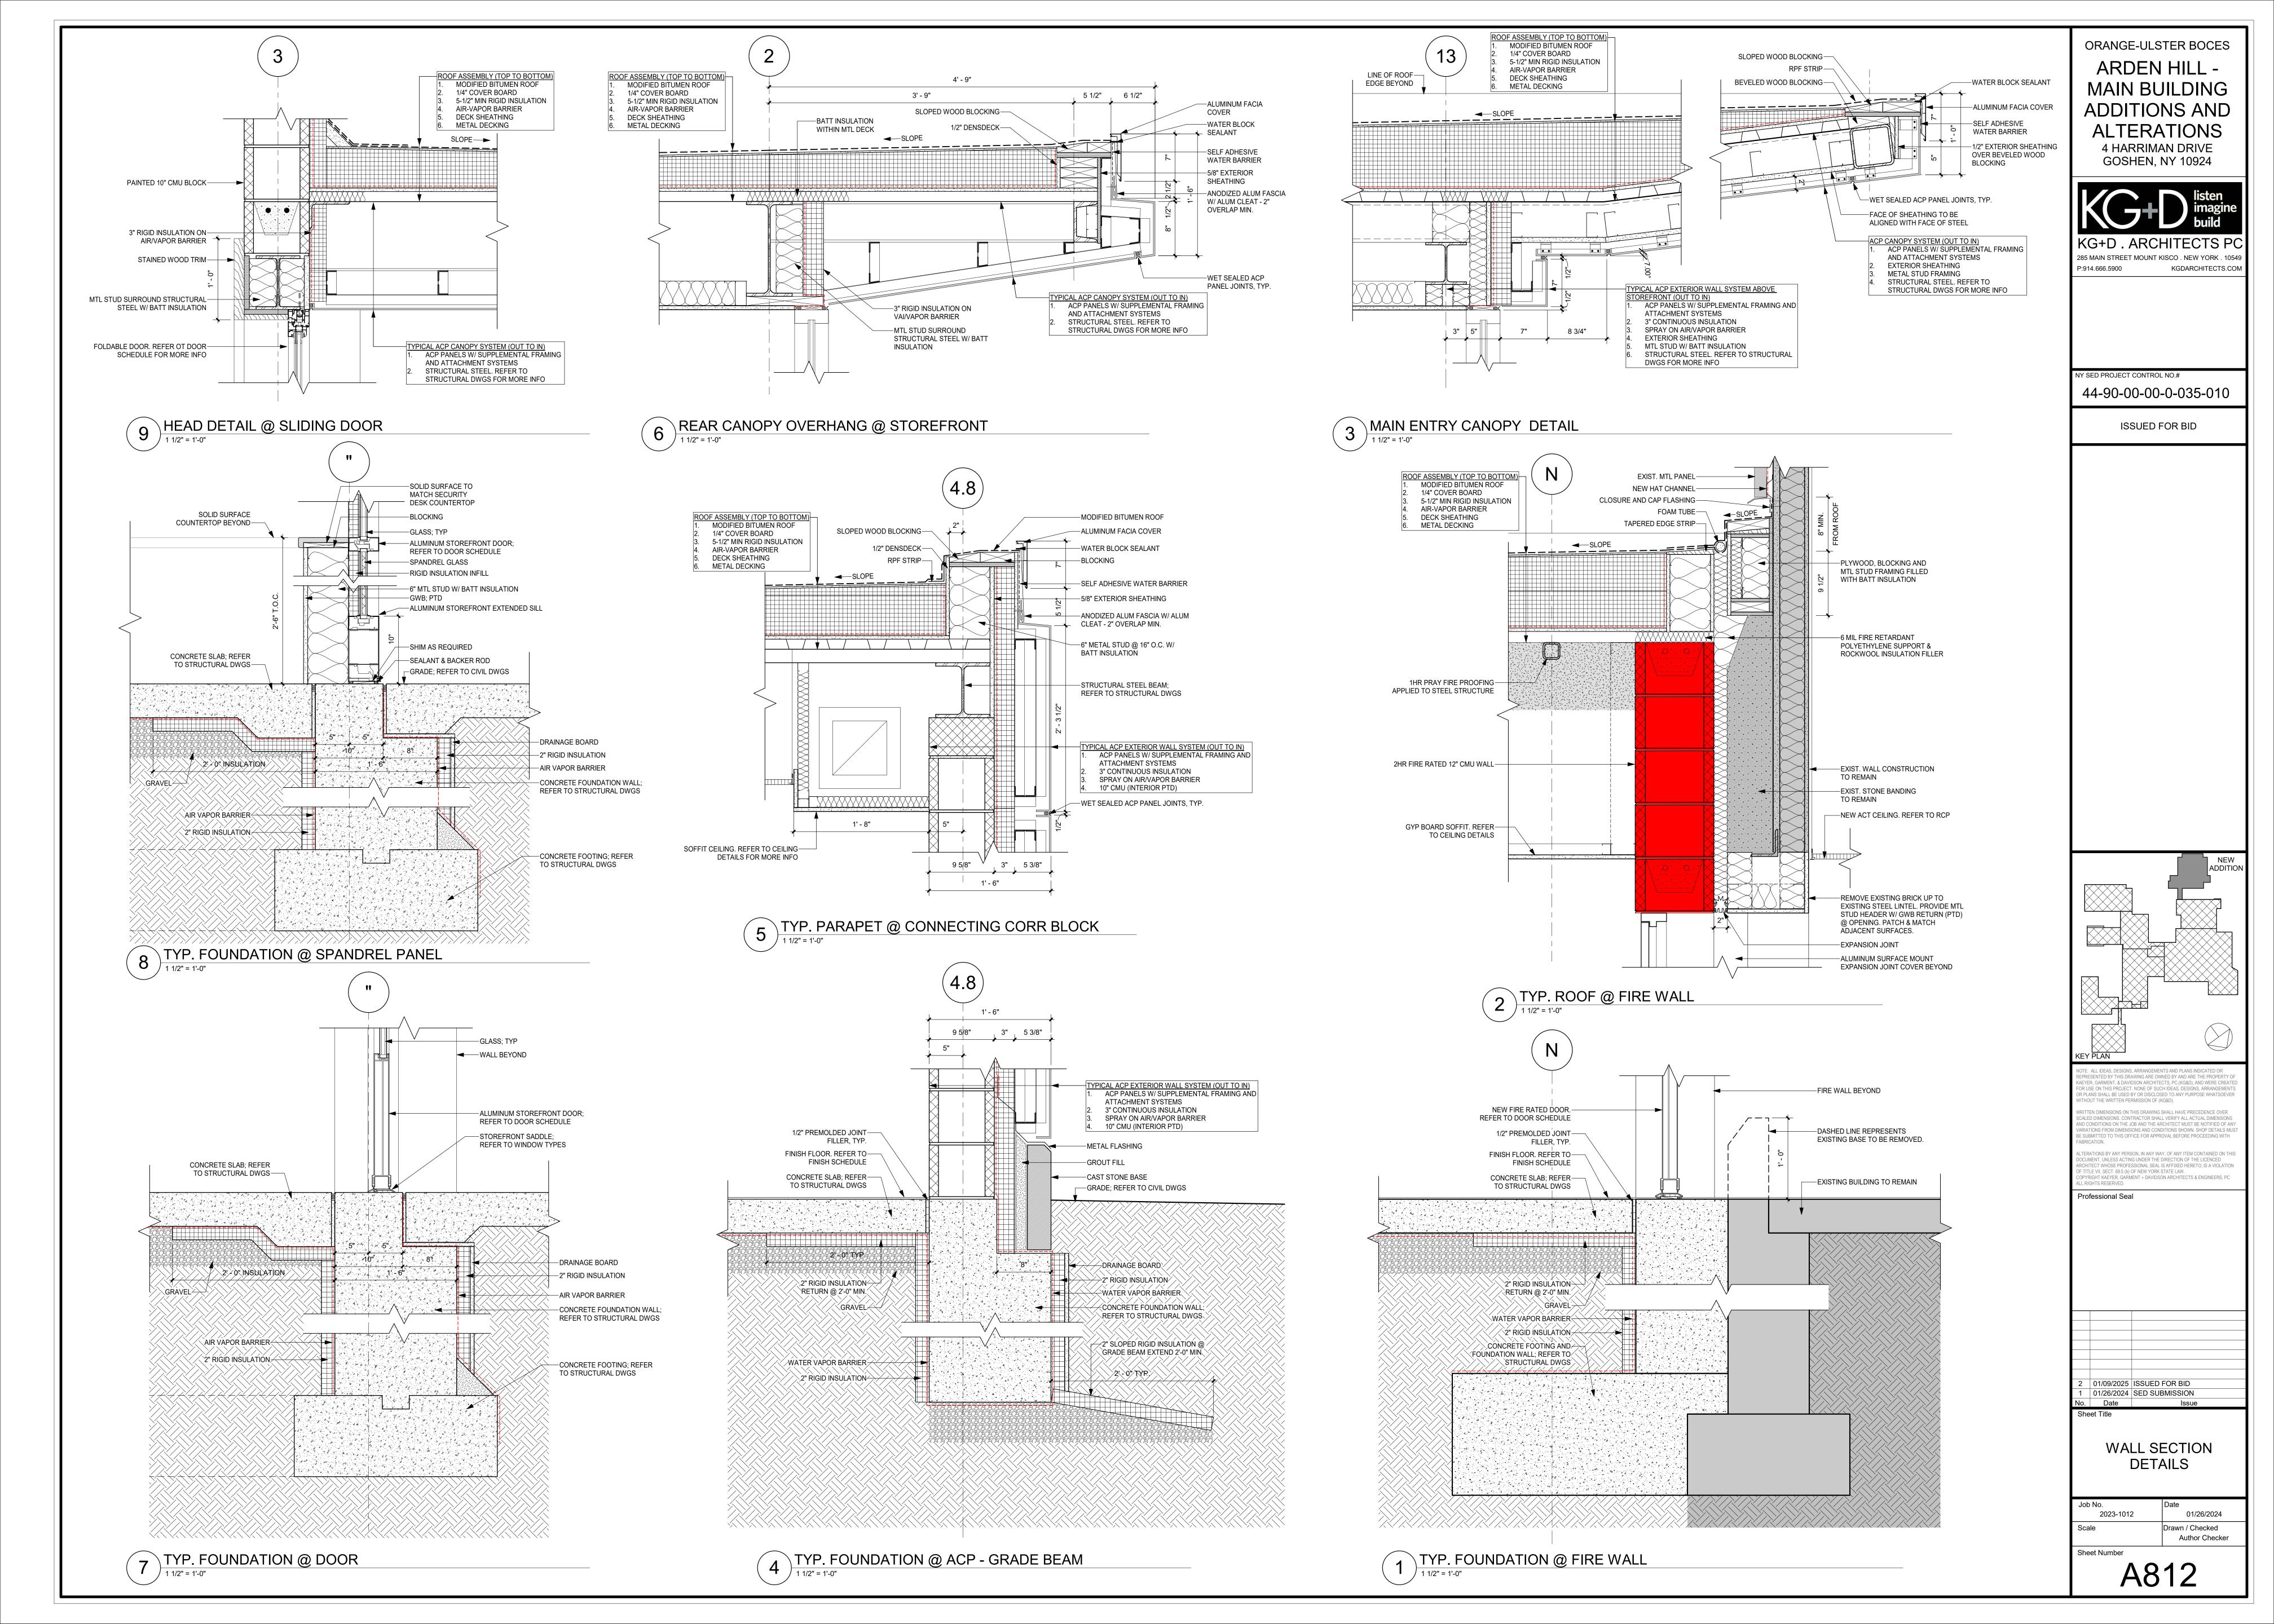
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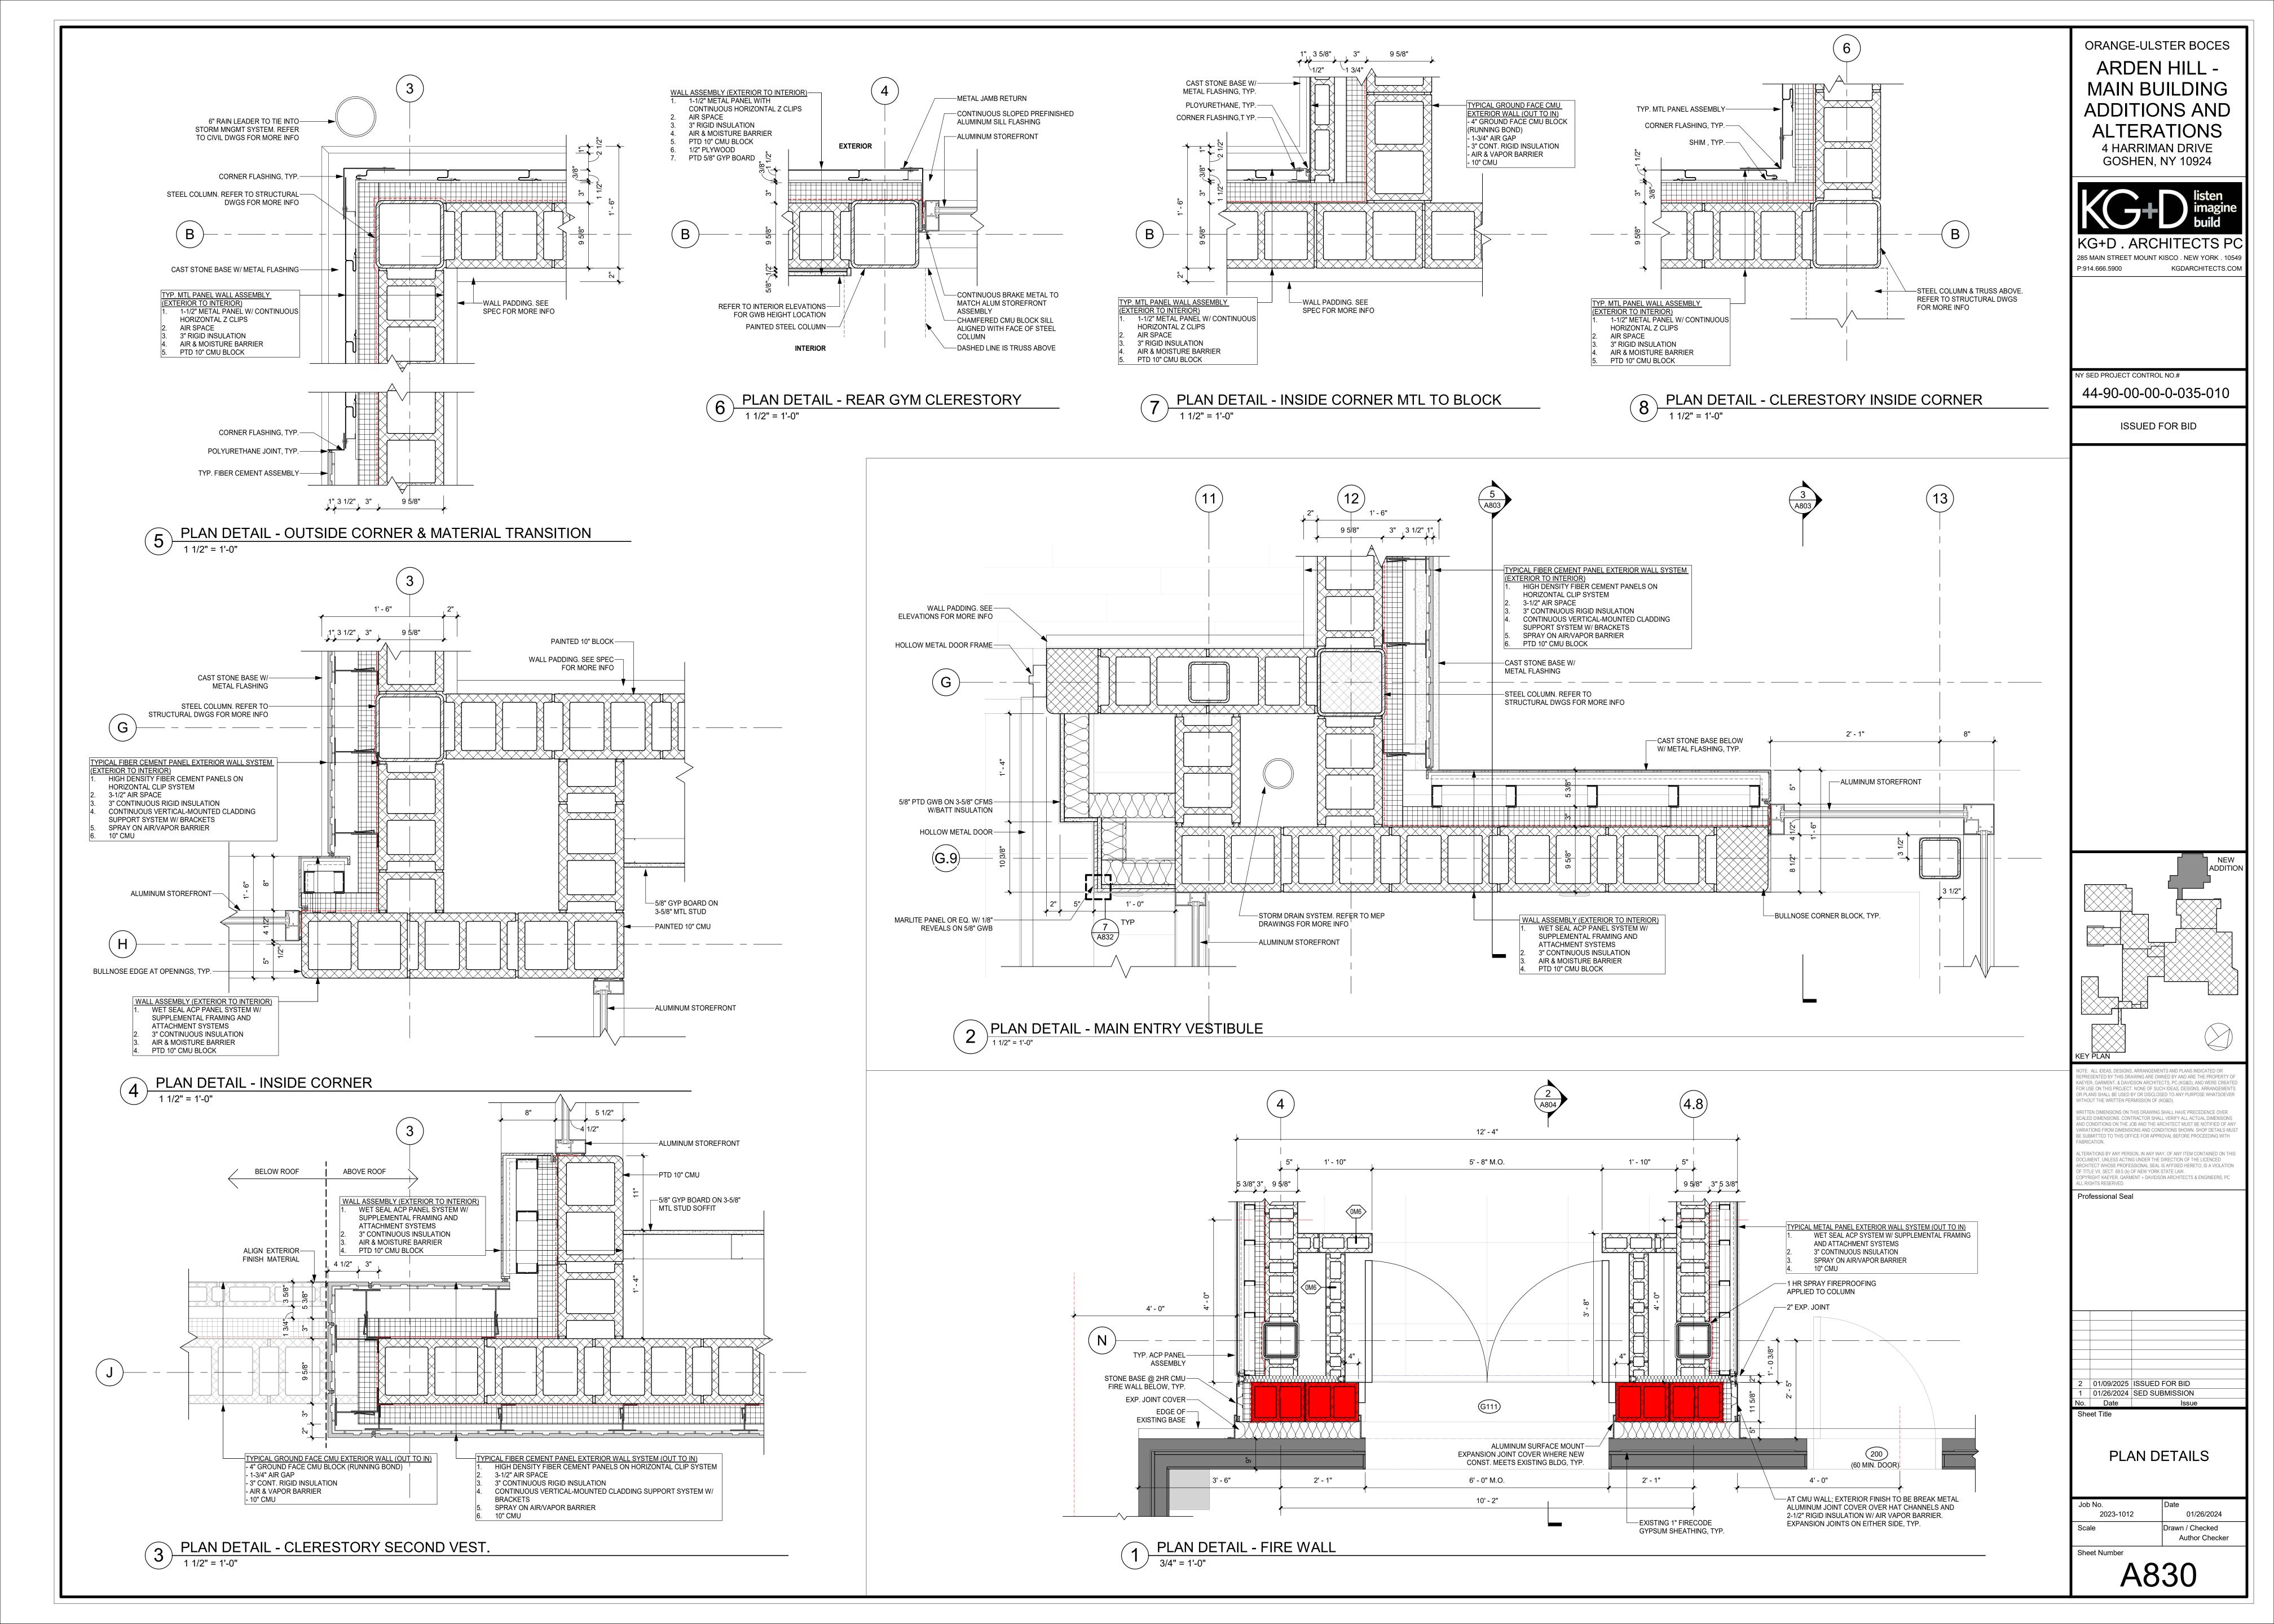
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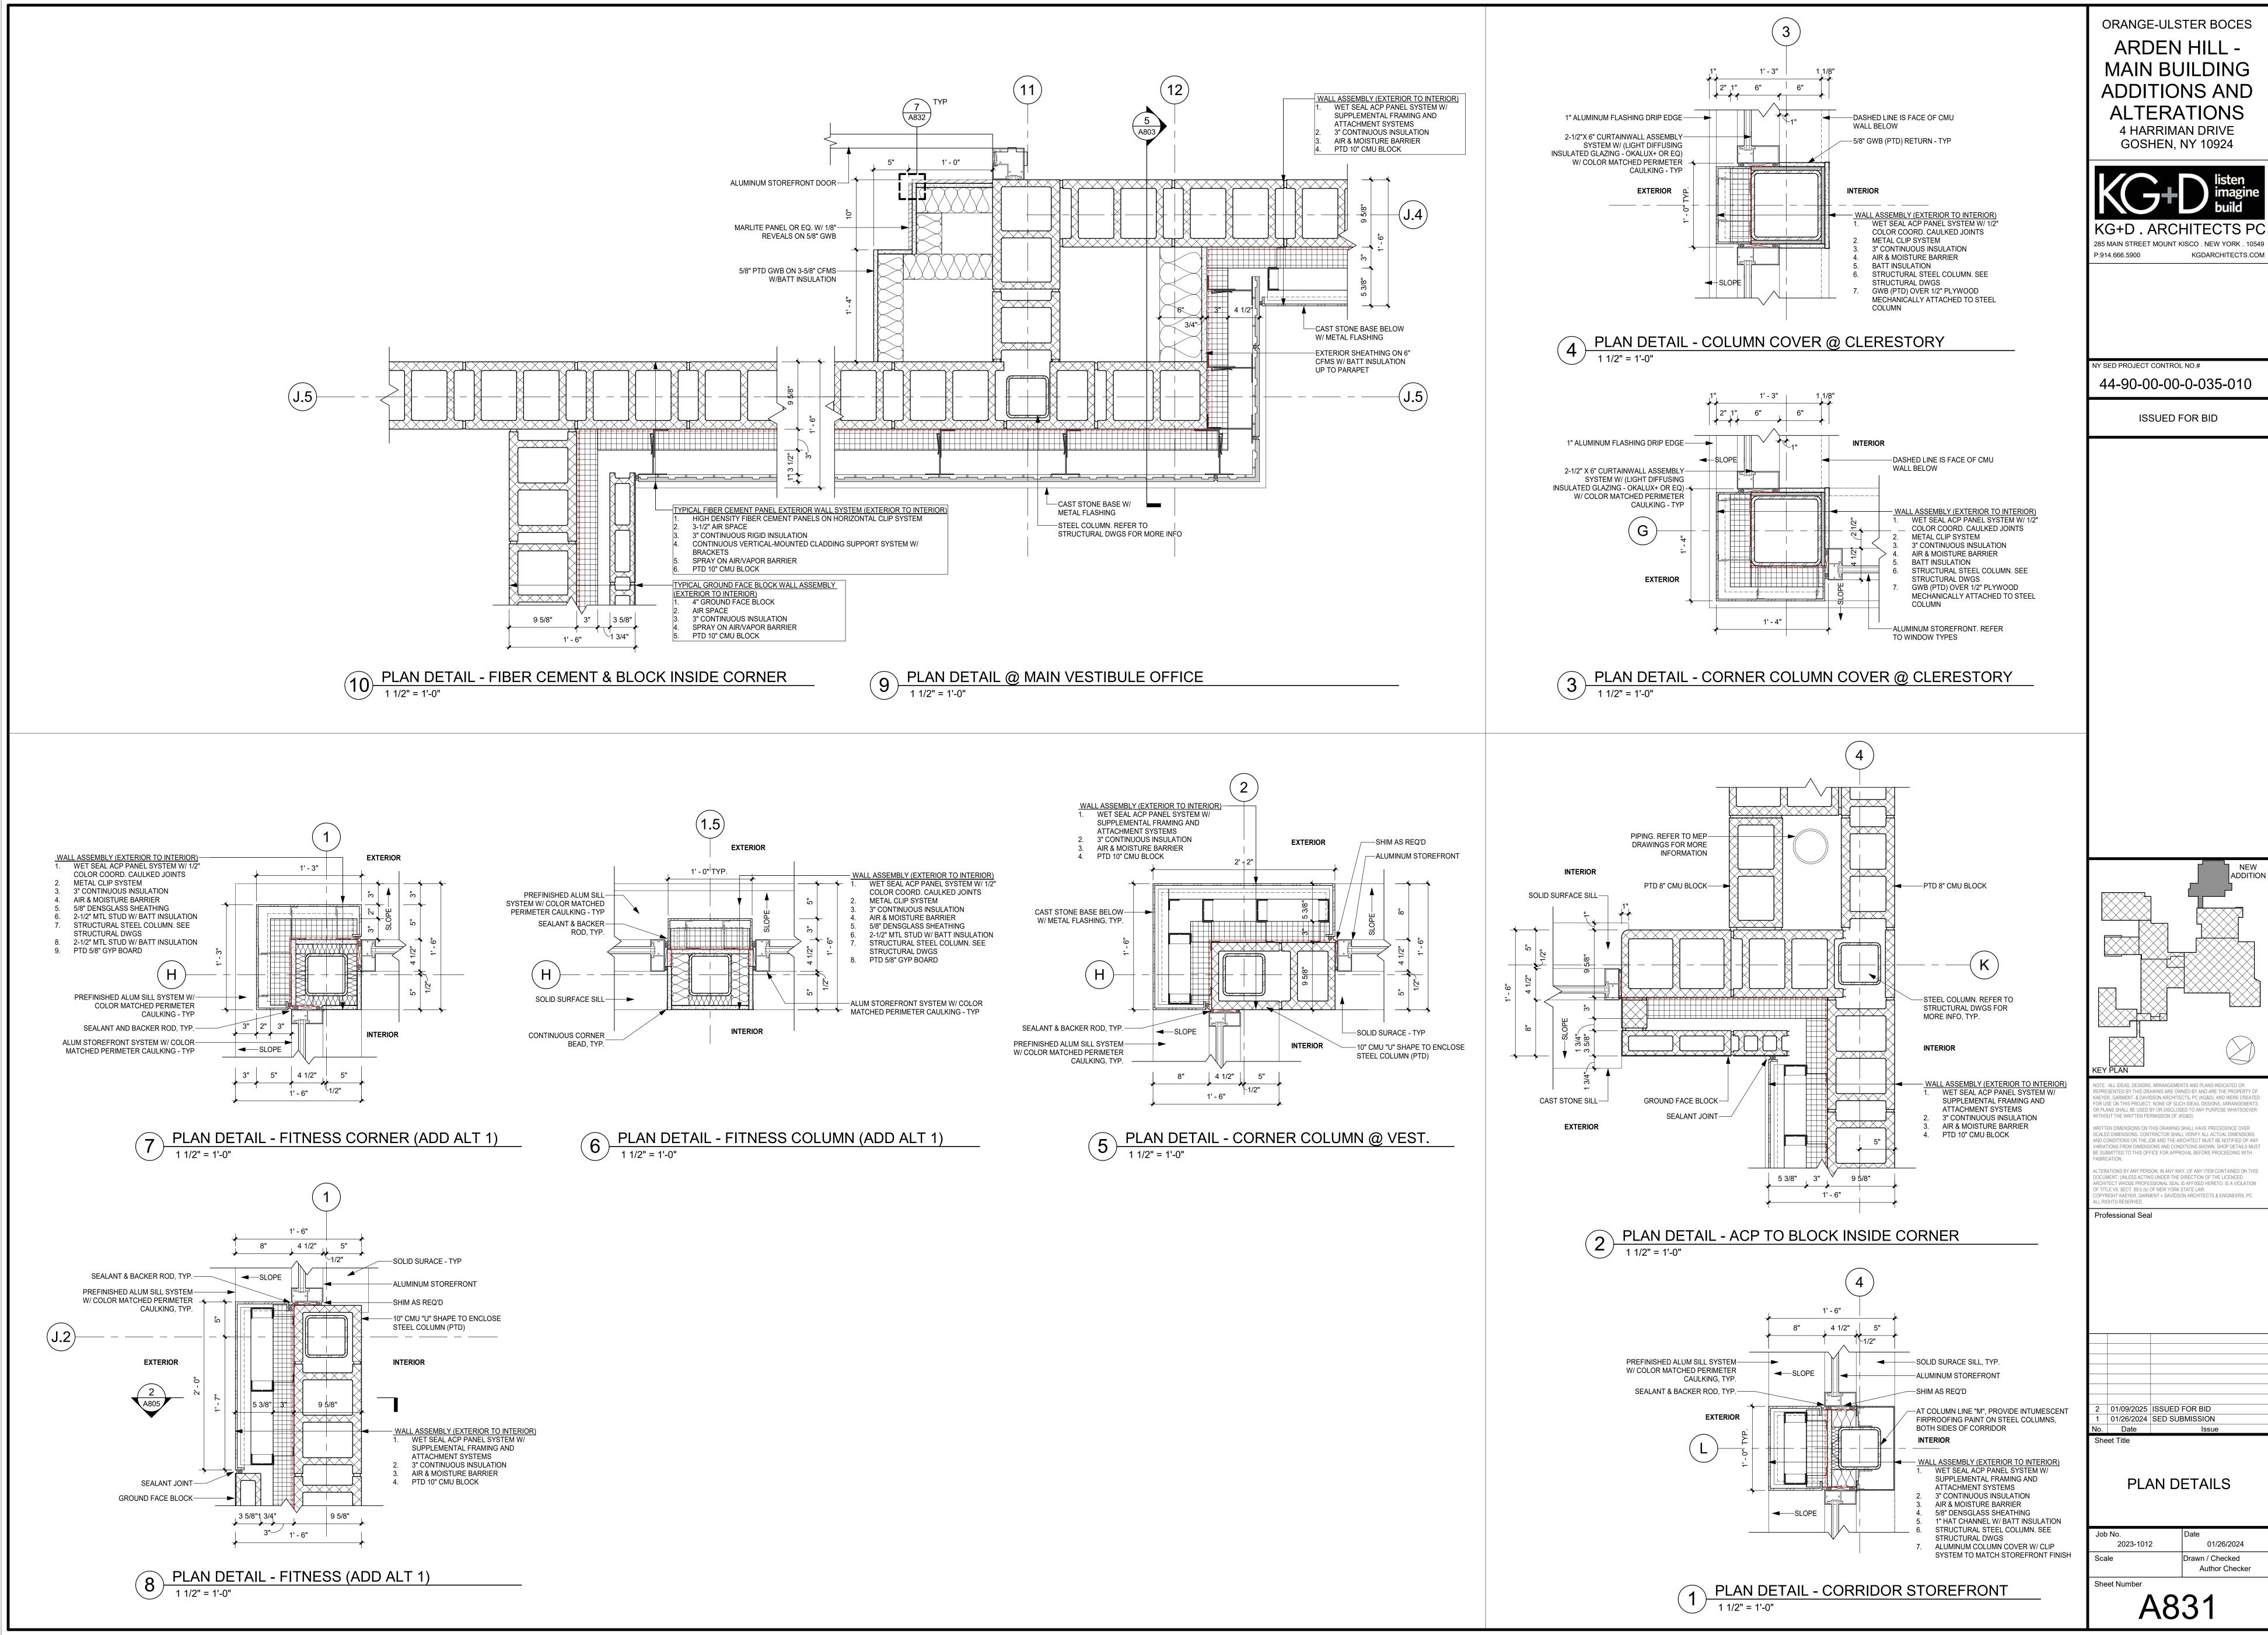
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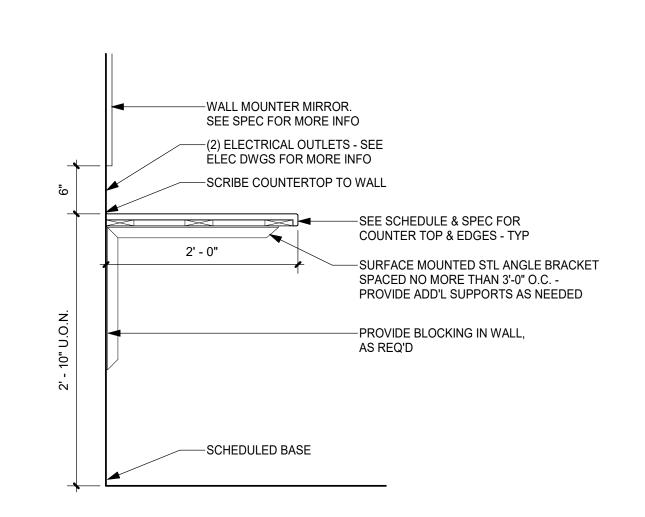










ADDITION



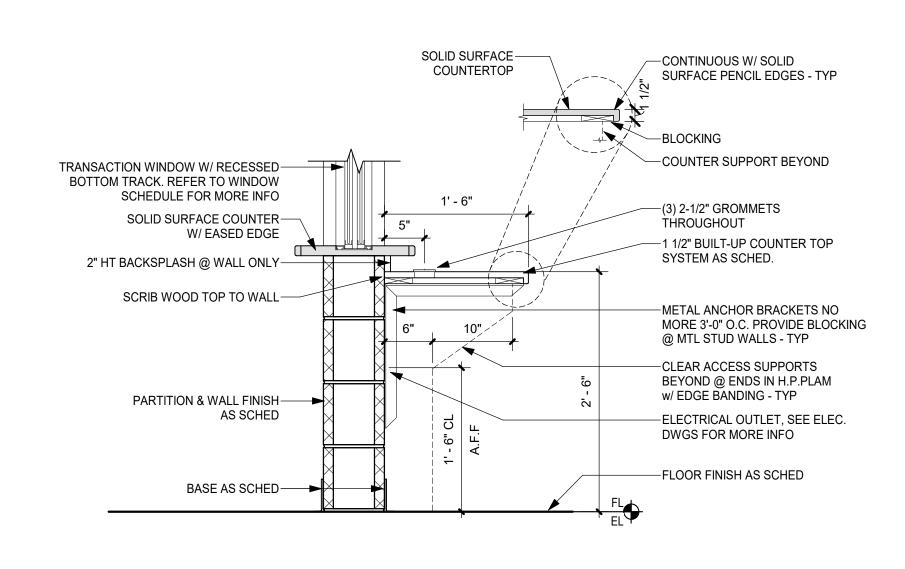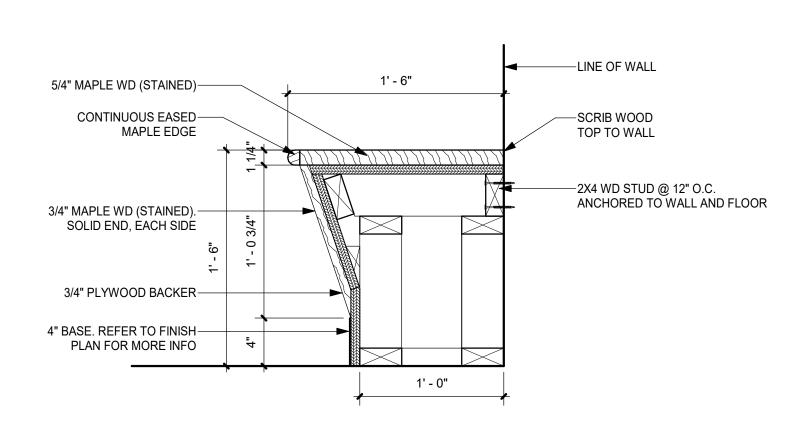
10 SECTION @ COUNTER







SECURITY DESK DETAIL

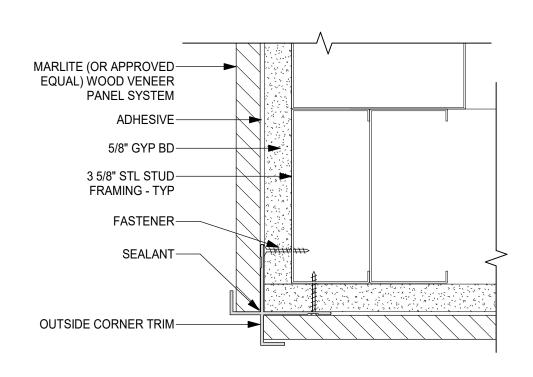
8 BUILT-IN BENCH DETAIL
1 1/2" = 1'-0"





7 WALL PANEL DETAIL
6" = 1'-0"

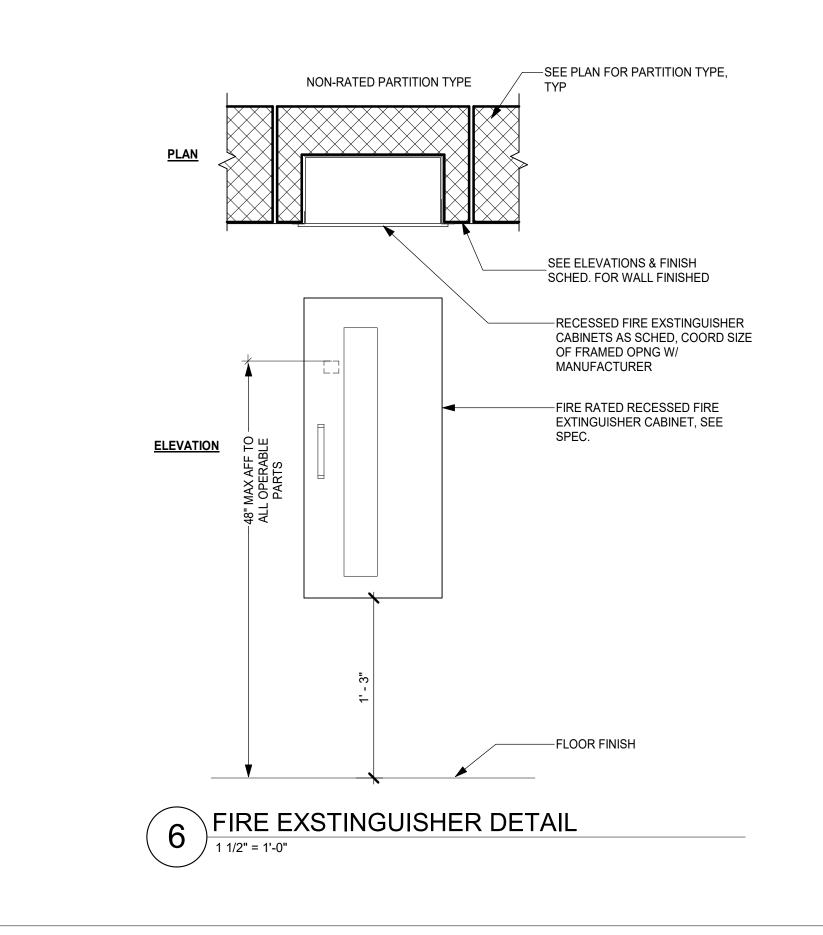

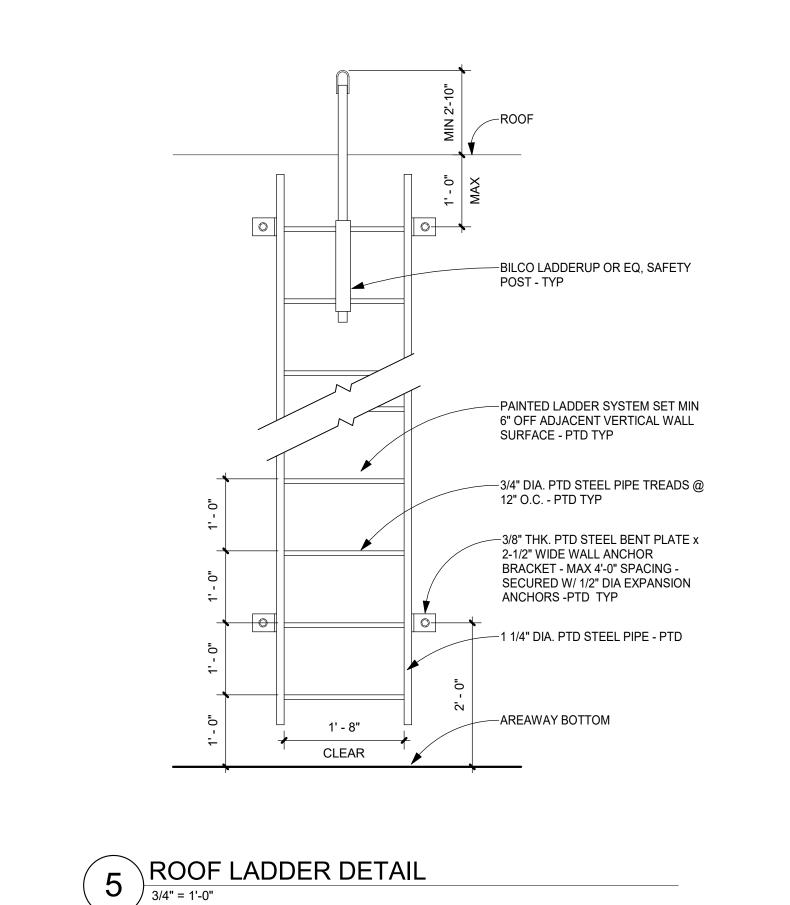

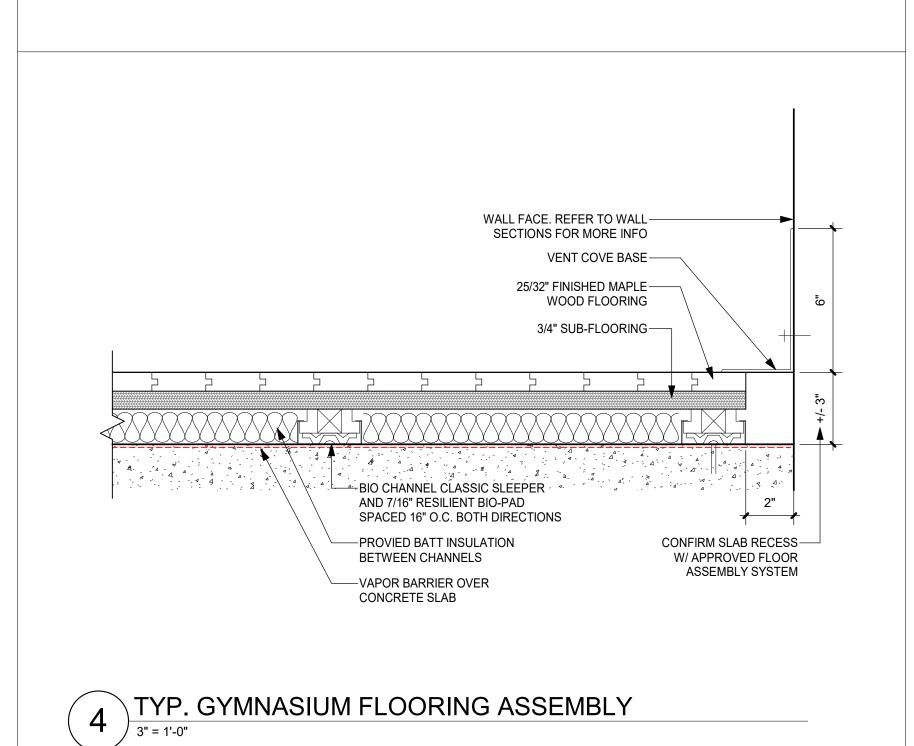

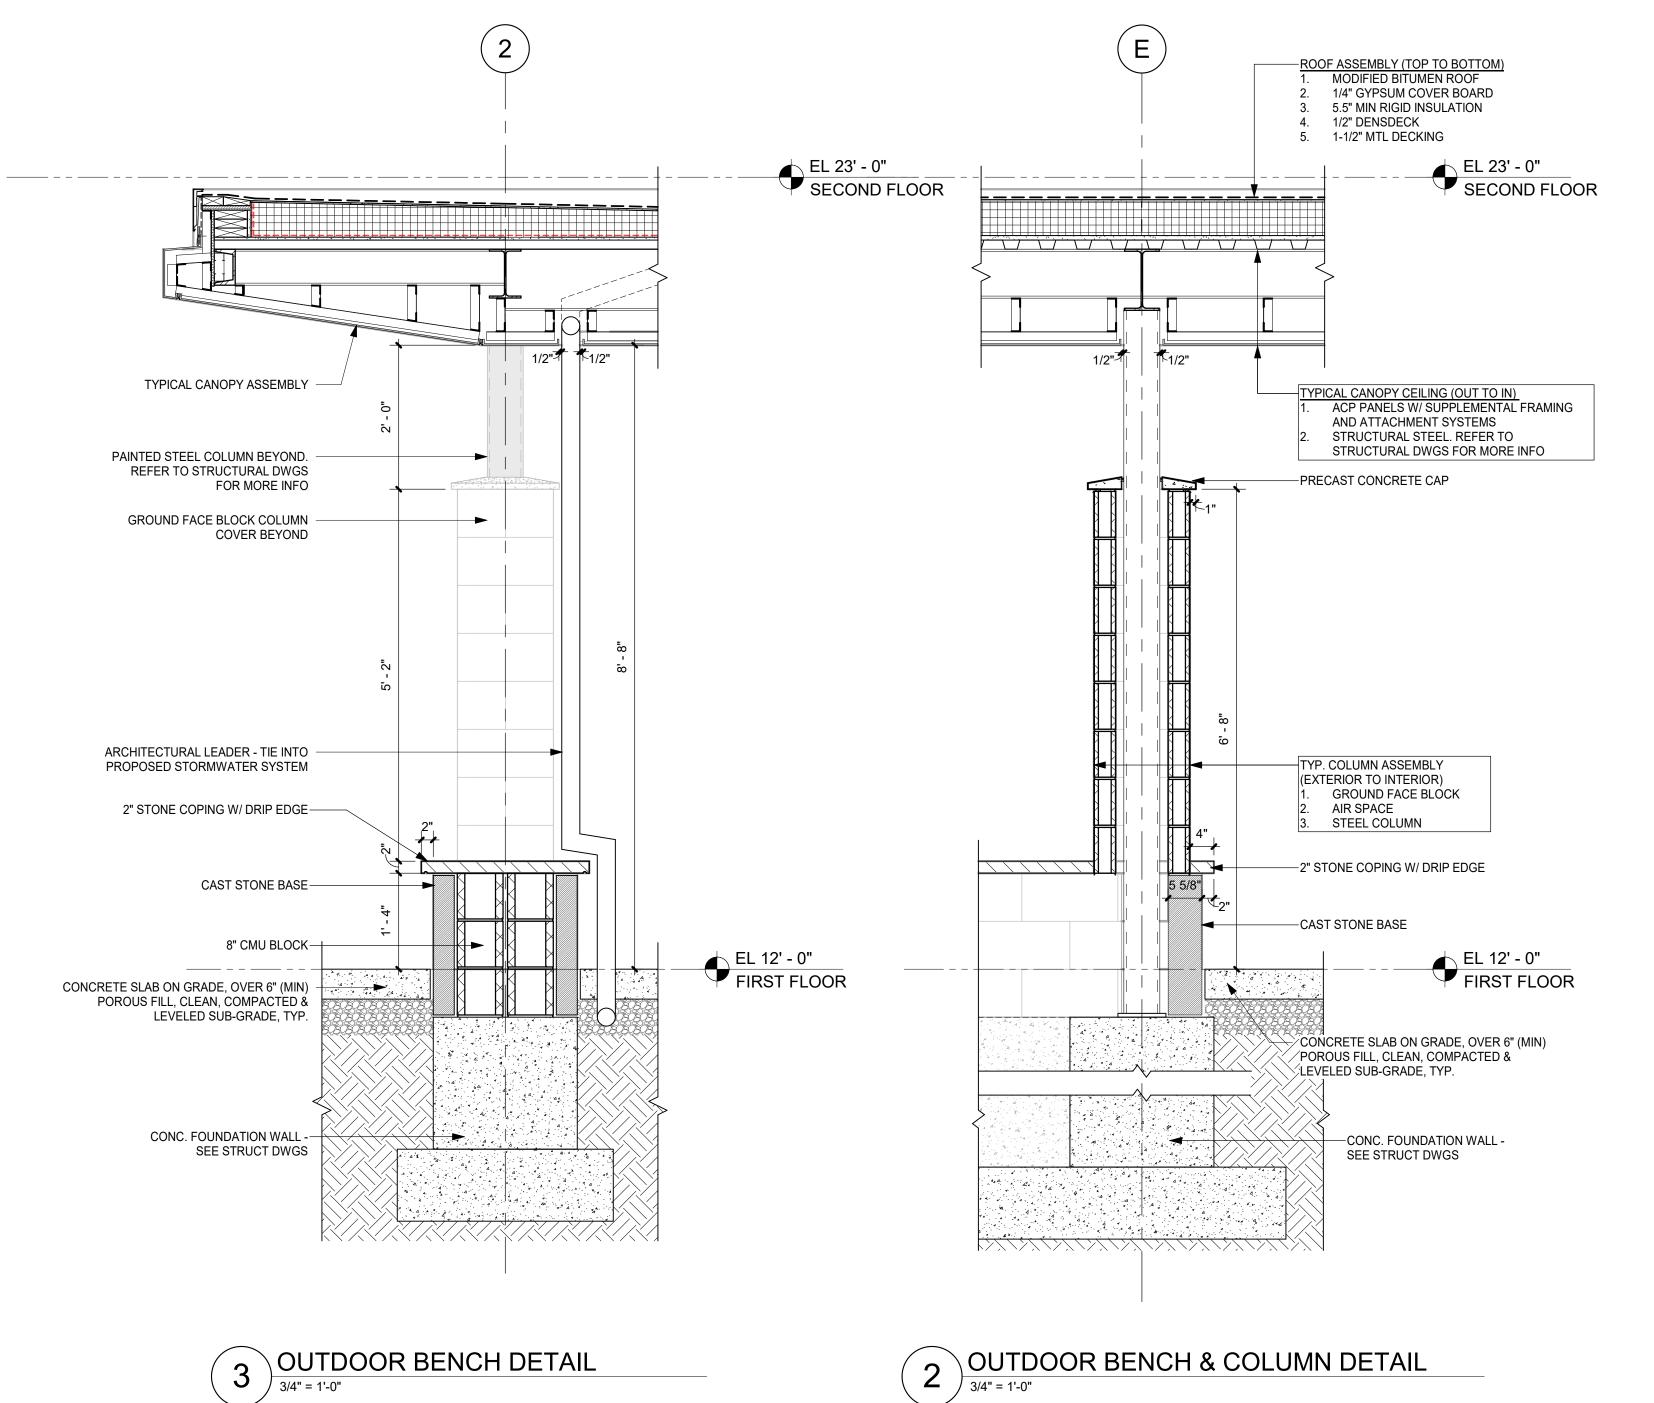

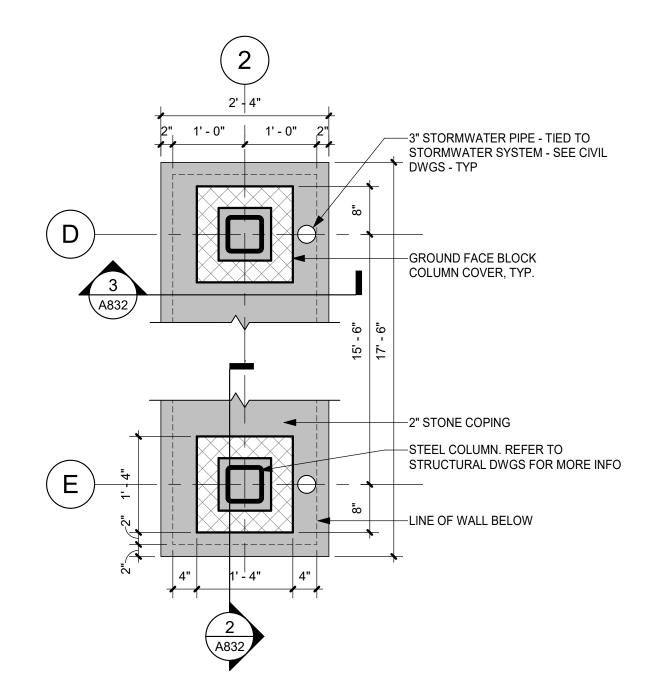

1 OUTDOOR BUILT-IN BENCH PLAN
3/4" = 1'-0"

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ADDITIONS AND
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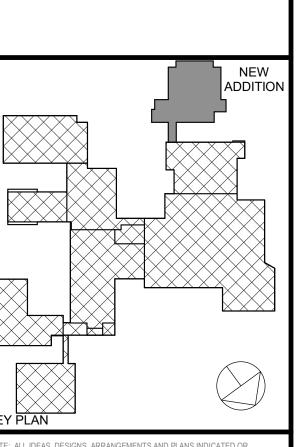
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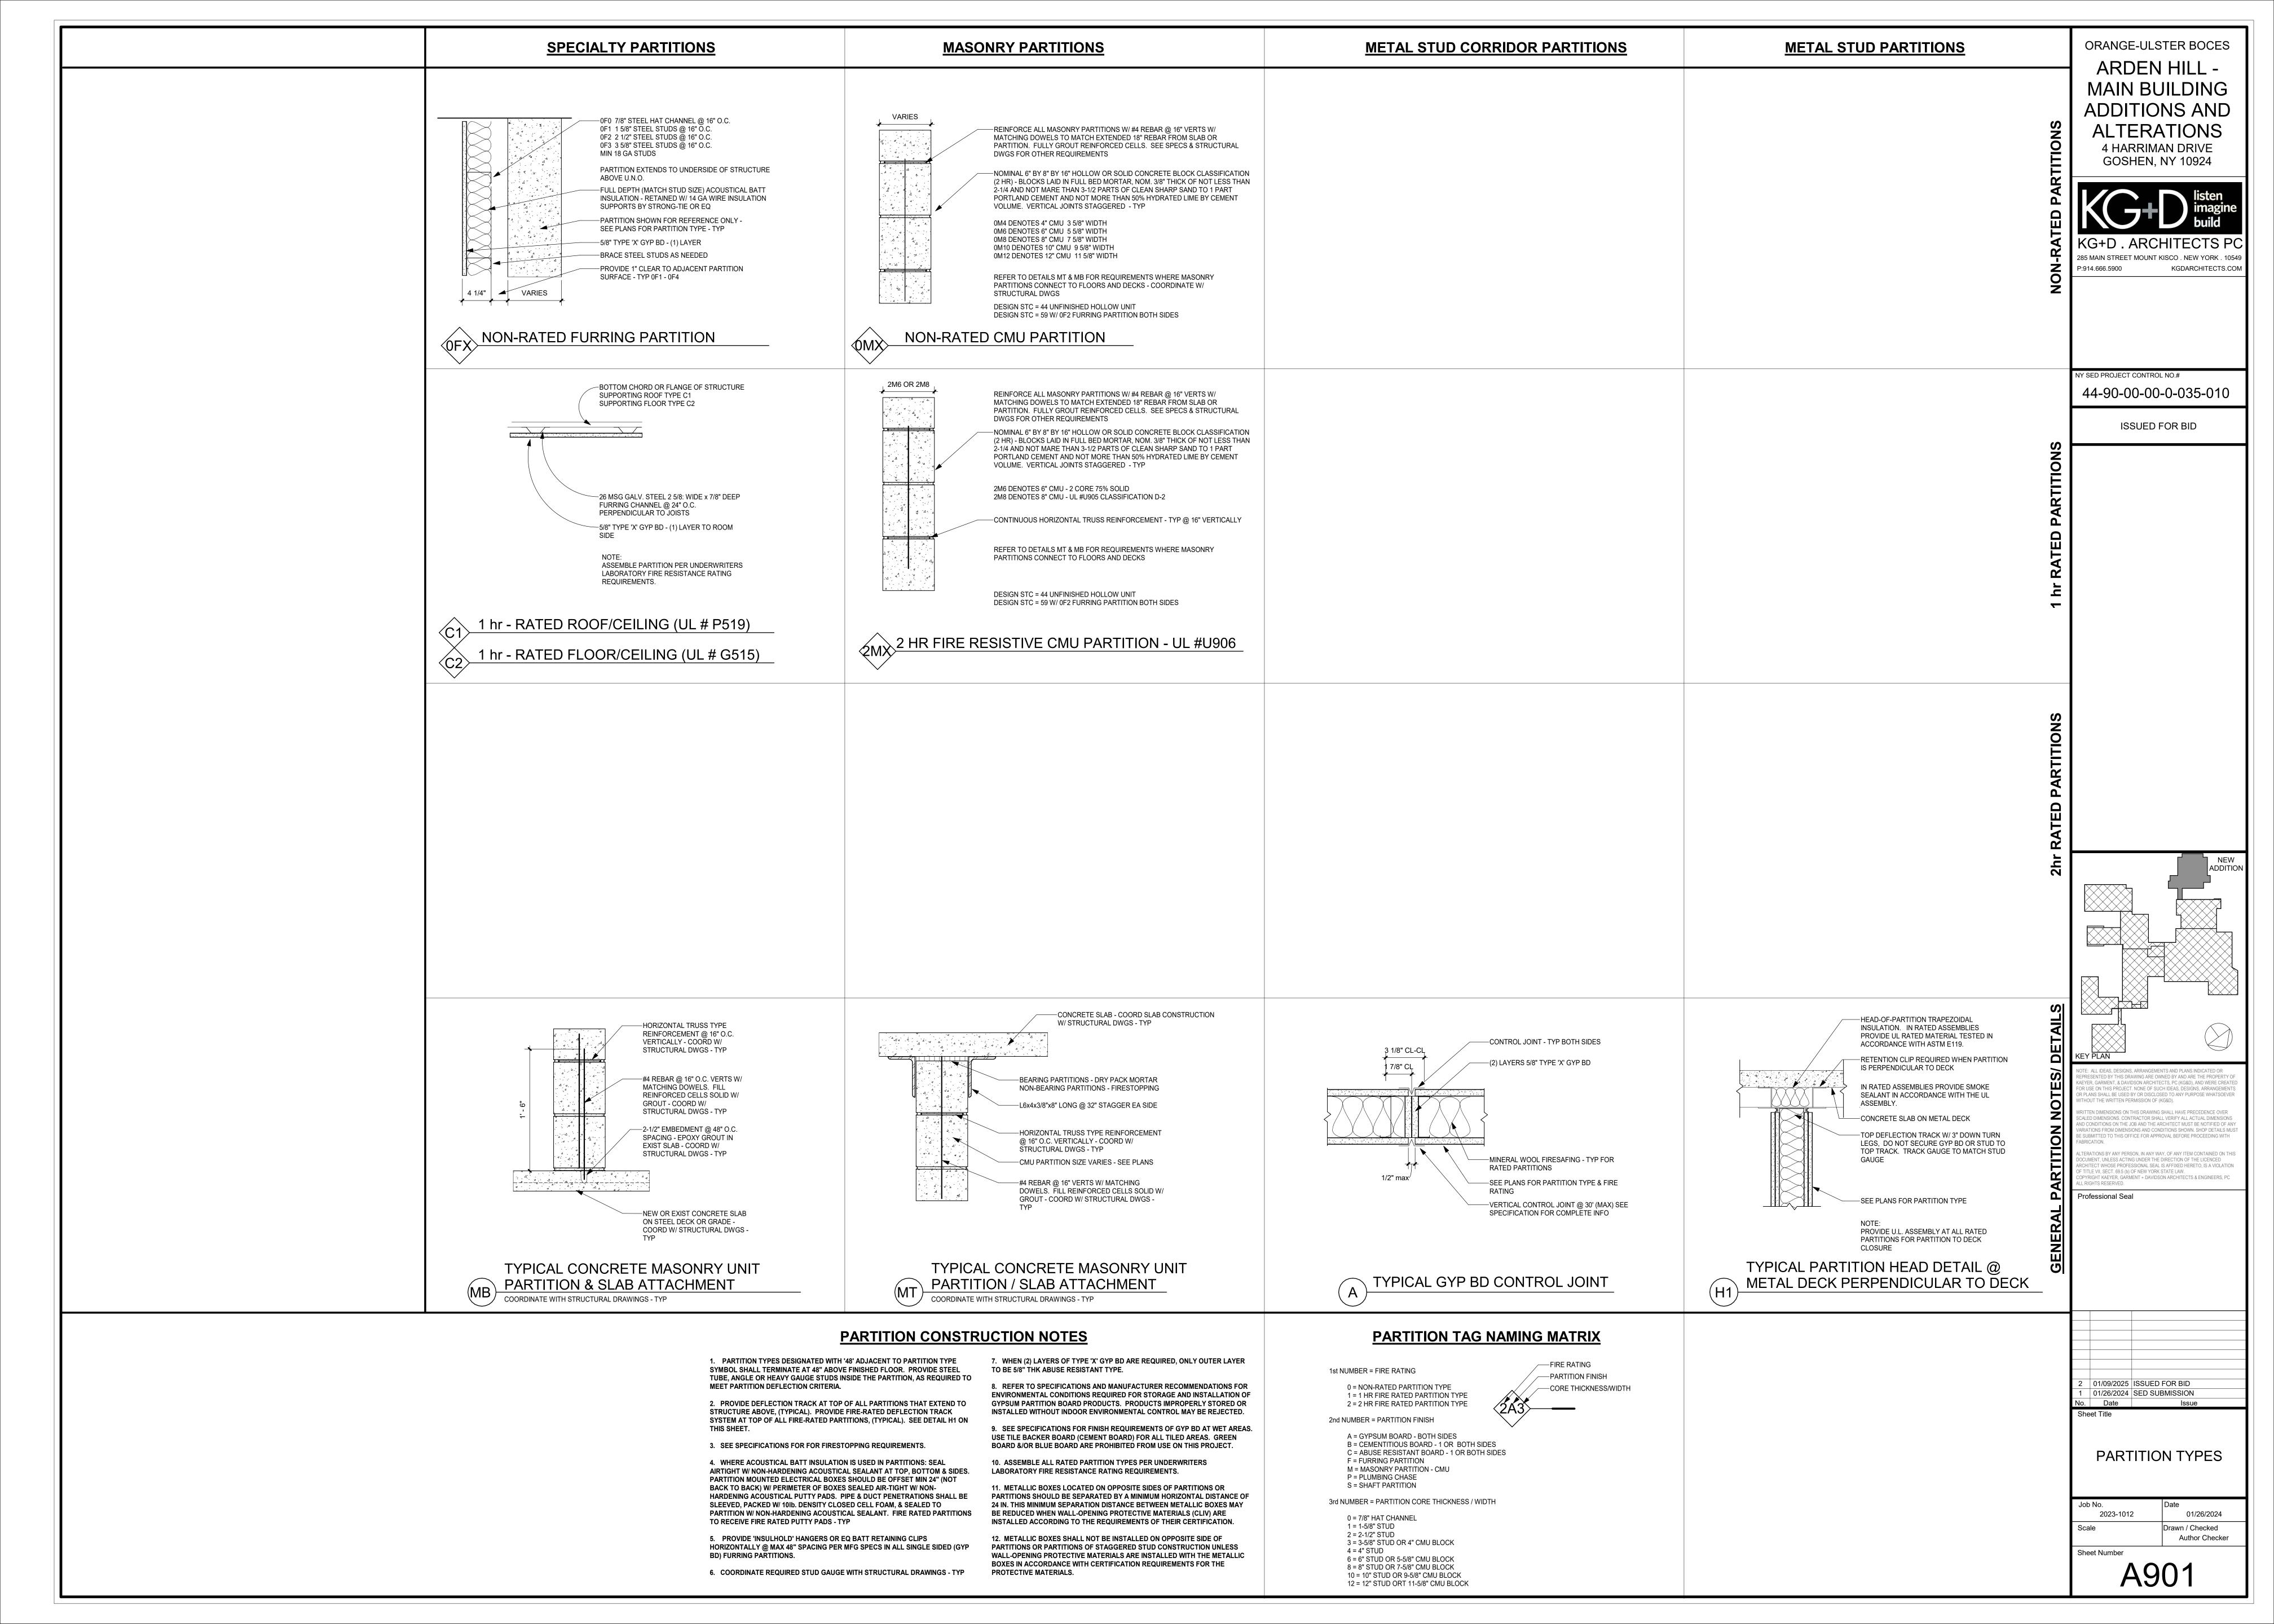
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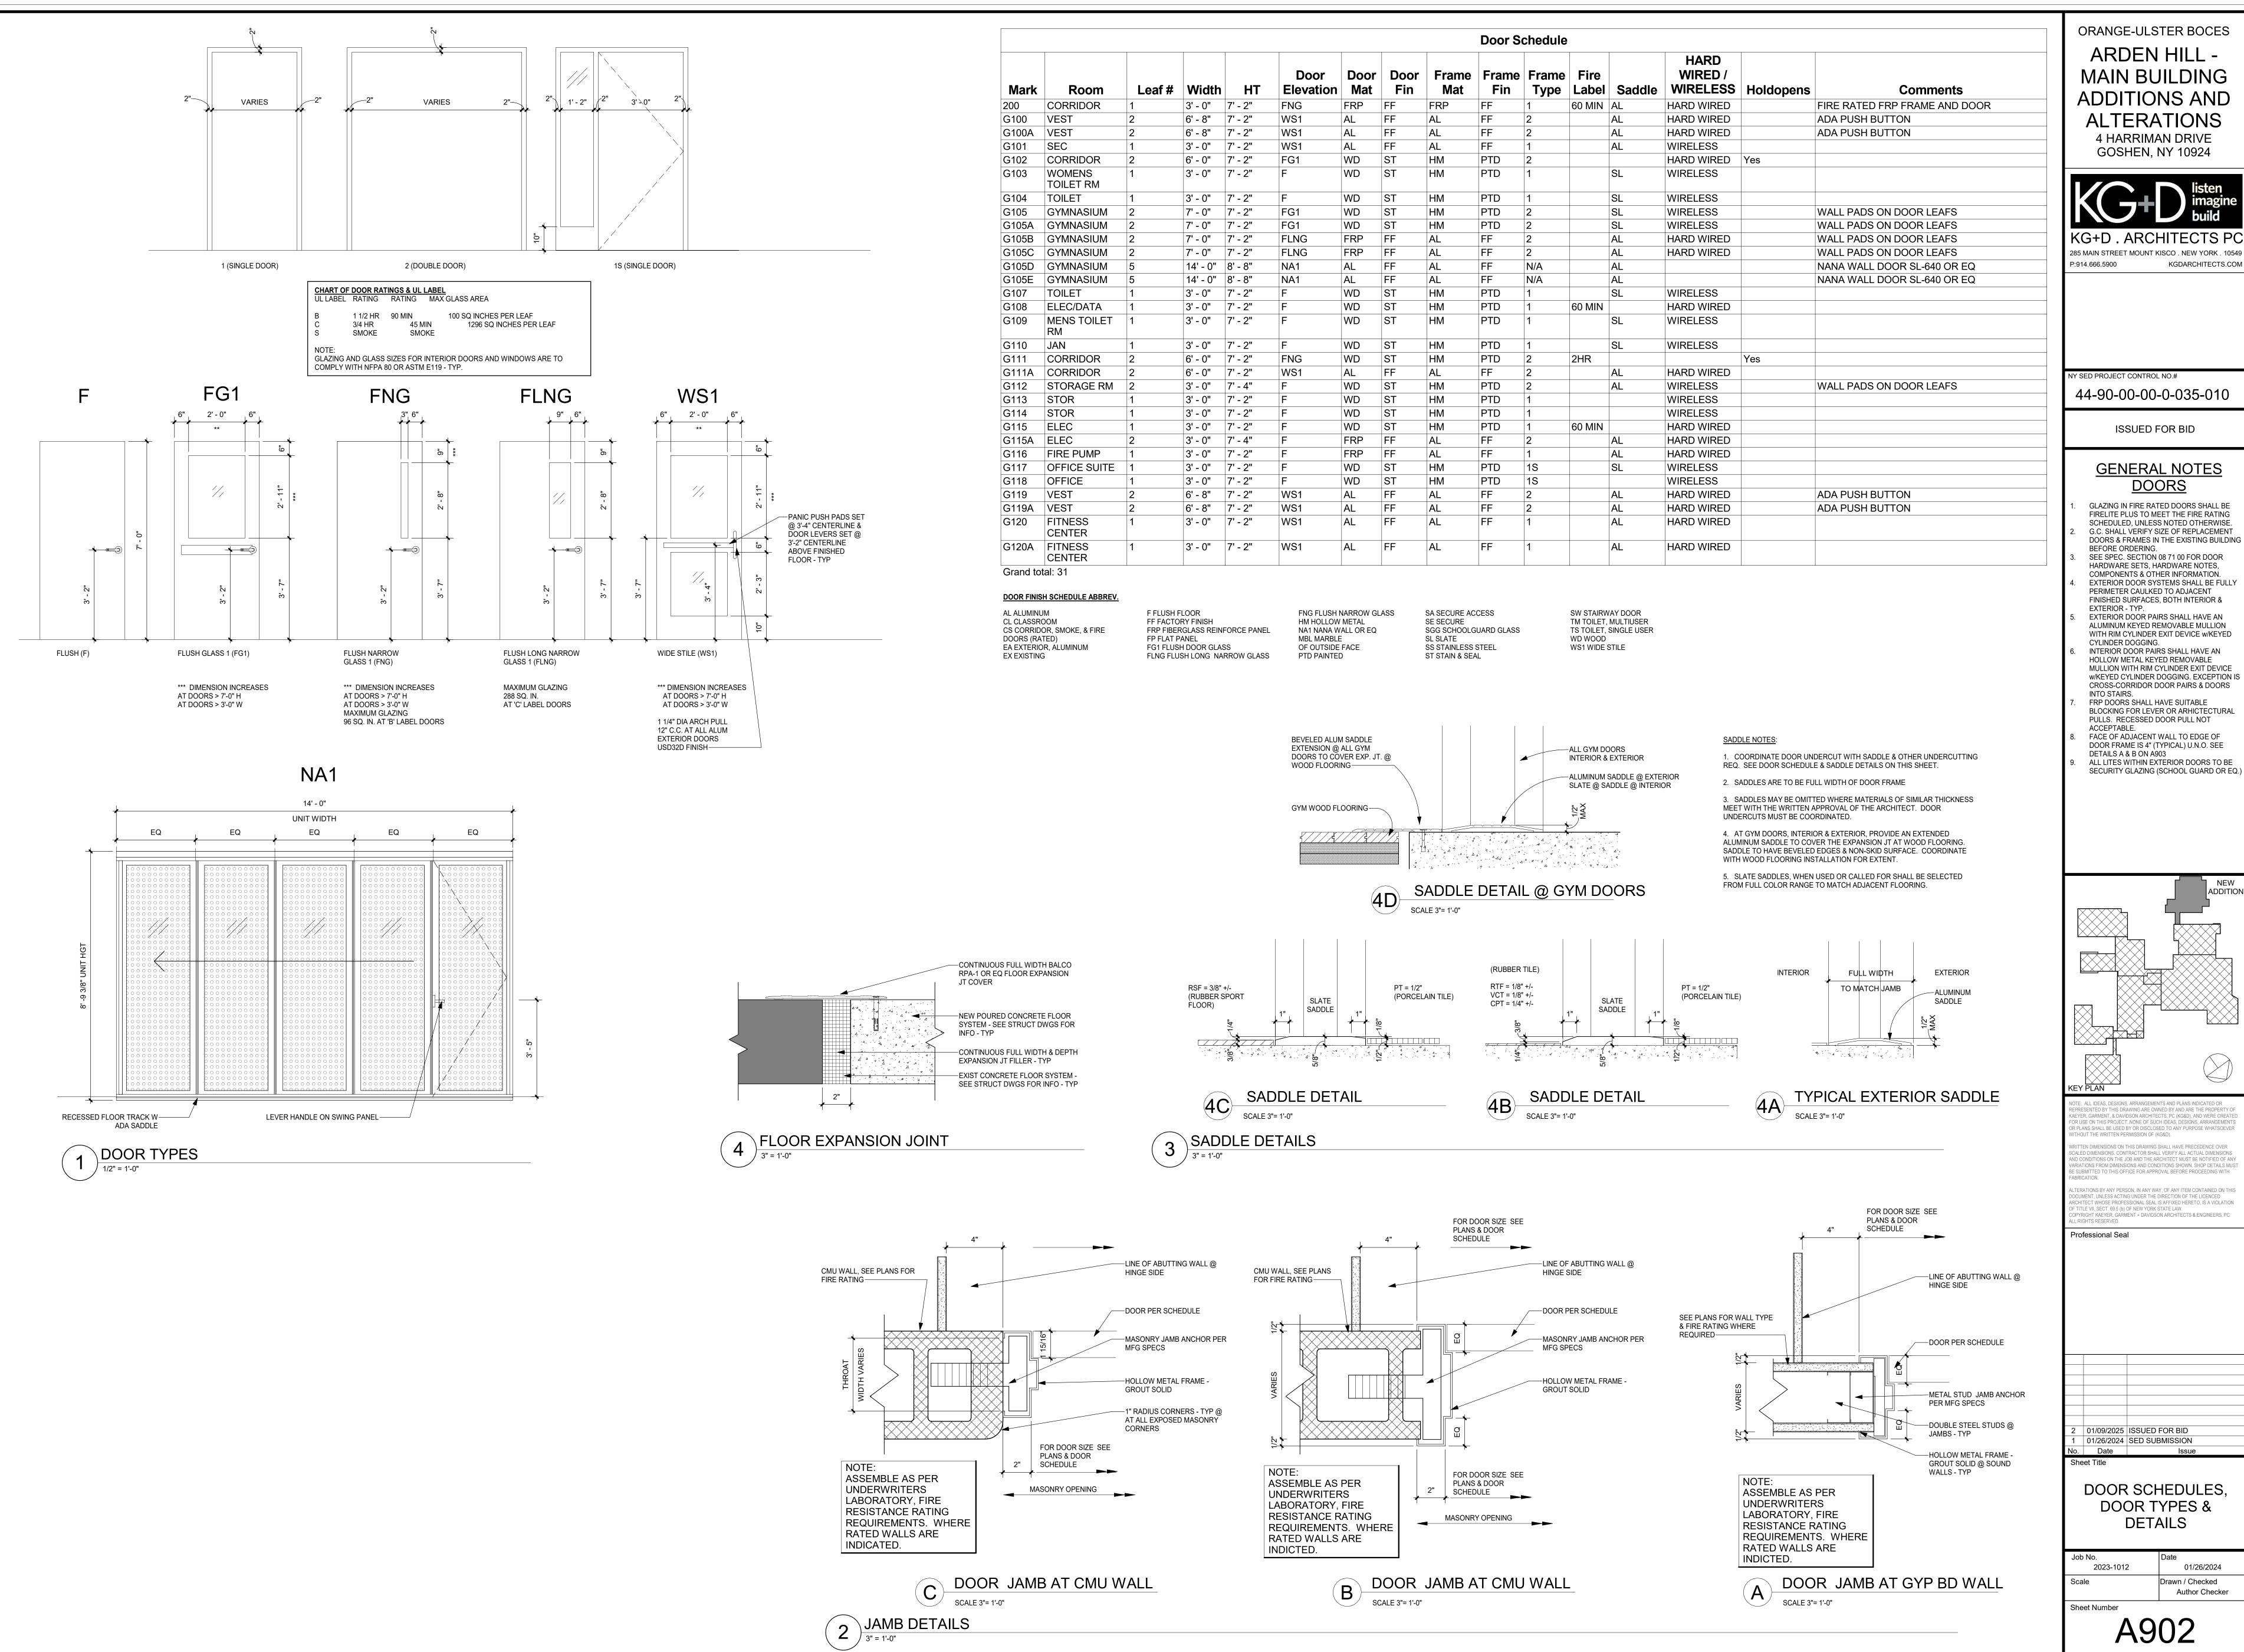
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ORANGE-ULSTER BOCES

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GENERAL NOTES

GLAZING IN FIRE RATED DOORS SHALL BE

FIRELITE PLUS TO MEET THE FIRE RATING SCHEDULED, UNLESS NOTED OTHERWISE. G.C. SHALL VERIFY SIZE OF REPLACEMENT DOORS & FRAMES IN THE EXISTING BUILDING BEFORE ORDERING.

SEE SPEC. SECTION 08 71 00 FOR DOOR HARDWARE SETS, HARDWARE NOTES, COMPONENTS & OTHER INFORMATION. EXTERIOR DOOR SYSTEMS SHALL BE FULL PERIMETER CAULKED TO ADJACENT

FINISHED SURFACES, BOTH INTERIOR & EXTERIOR - TYP. EXTERIOR DOOR PAIRS SHALL HAVE AN ALUMINUM KEYED REMOVABLE MULLION WITH RIM CYLINDER EXIT DEVICE w/KEYED CYLINDER DOGGING.

INTERIOR DOOR PAIRS SHALL HAVE AN HOLLOW METAL KEYED REMOVABLE MULLION WITH RIM CYLINDER EXIT DEVICE w/KEYED CYLINDER DOGGING. EXCEPTION IS CROSS-CORRIDOR DOOR PAIRS & DOORS FRP DOORS SHALL HAVE SUITABLE

BLOCKING FOR LEVER OR ARHICTECTURAL PULLS. RECESSED DOOR PULL NOT ACCEPTABLE. FACE OF ADJACENT WALL TO EDGE OF

DOOR FRAME IS 4" (TYPICAL) U.N.O. SEE DETAILS A & B ON A903

ALL LITES WITHIN EXTERIOR DOORS TO BE SECURITY GLAZING (SCHOOL GUARD OR EQ.)

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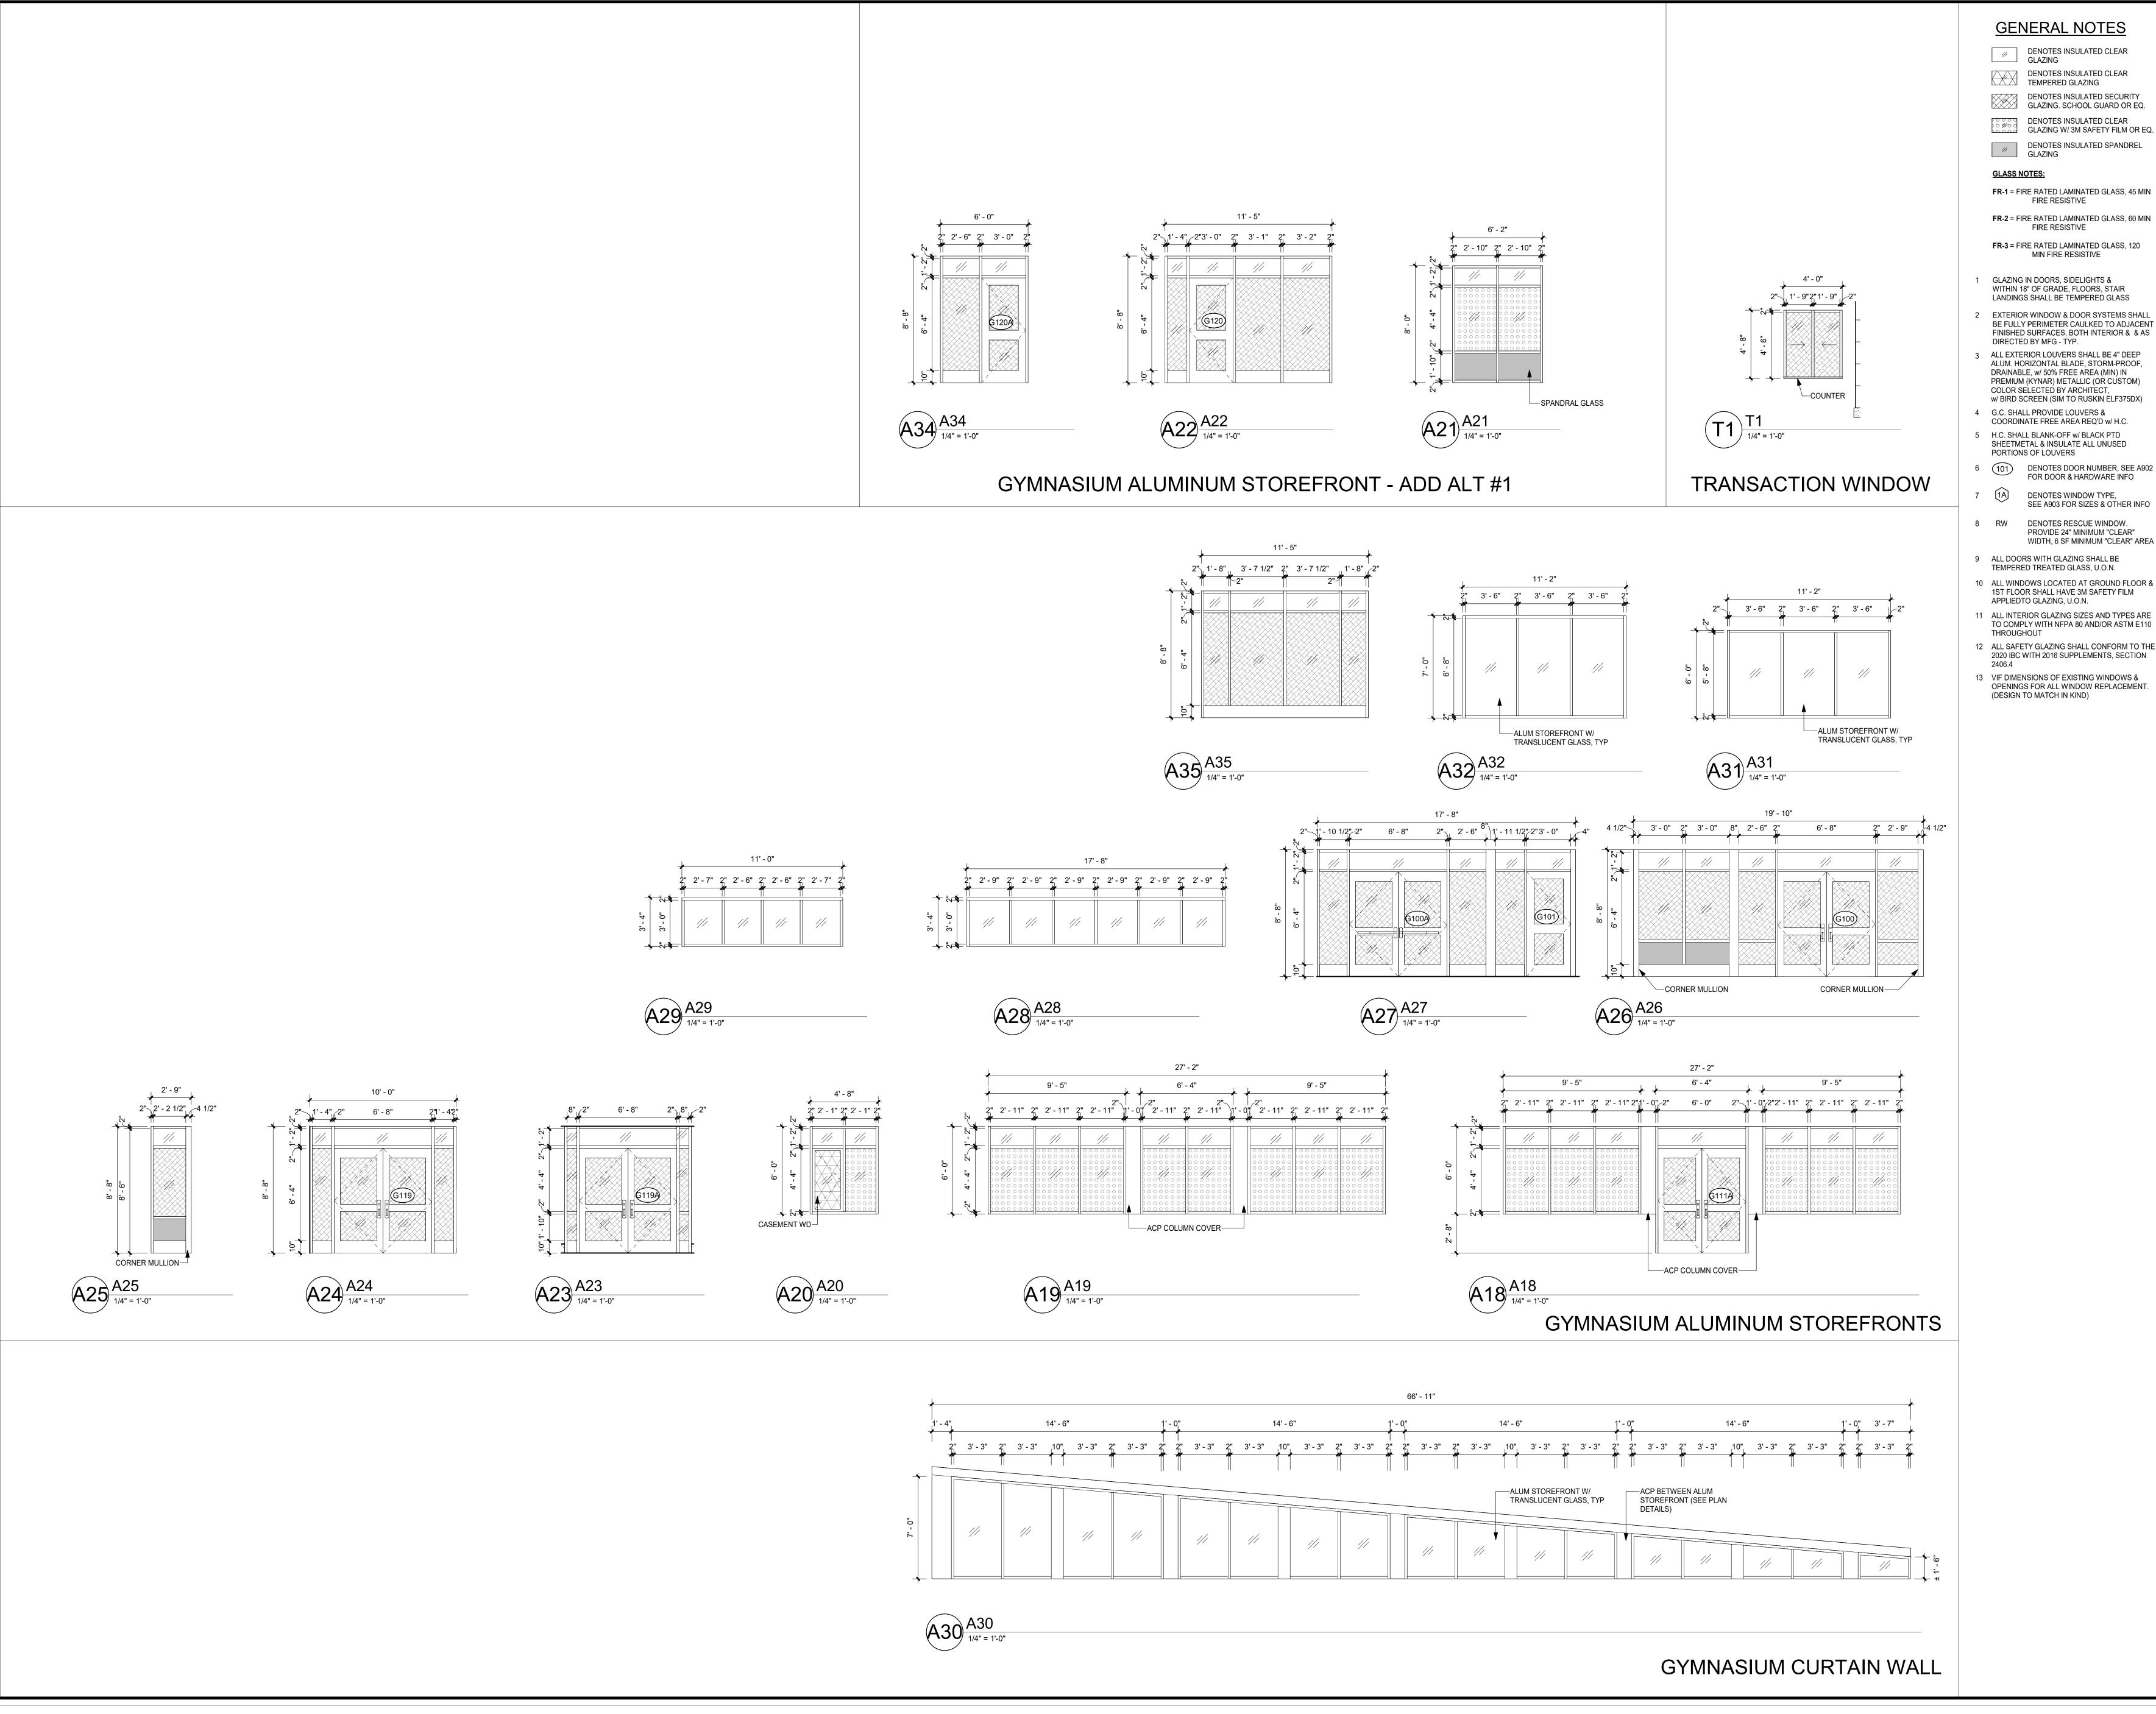
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DOOR SCHEDULES, DOOR TYPES & **DETAILS**

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DENOTES INSULATED CLEAR TEMPERED GLAZING

DENOTES INSULATED SECURITY GLAZING. SCHOOL GUARD OR EQ.

DENOTES INSULATED CLEAR
GLAZING W/ 3M SAFETY FILM OR EQ. DENOTES INSULATED SPANDREL GLAZING

FR-2 = FIRE RATED LAMINATED GLASS, 60 MIN

WITHIN 18" OF GRADE, FLOORS, STAIR LANDINGS SHALL BE TEMPERED GLASS EXTERIOR WINDOW & DOOR SYSTEMS SHALL BE FULLY PERIMETER CAULKED TO ADJACENT FINISHED SURFACES, BOTH INTERIOR & & AS

PREMIUM (KYNAR) METALLIC (OR CÚSTOM) w/ BIRD SCREEN (SIM TO RUSKIN ELF375DX) COORDINATE FREE AREA REQ'D w/ H.C. 5 H.C. SHALL BLANK-OFF w/ BLACK PTD

6 101 DENOTES DOOR NUMBER, SEE A902 FOR DOOR & HARDWARE INFO

DENOTES WINDOW TYPE, SEE A903 FOR SIZES & OTHER INFO

WIDTH, 6 SF MINIMUM "CLEAR" AREA

10 ALL WINDOWS LOCATED AT GROUND FLOOR & 1ST FLOOR SHALL HAVE 3M SAFETY FILM

TO COMPLY WITH NFPA 80 AND/OR ASTM E110 12 ALL SAFETY GLAZING SHALL CONFORM TO THE

13 VIF DIMENSIONS OF EXISTING WINDOWS & OPENINGS FOR ALL WINDOW REPLACEMENT. ARDEN HILL -

MAIN BUILDING **ADDITIONS AND ALTERATIONS** 4 HARRIMAN DRIVE GOSHEN, NY 10924

ORANGE-ULSTER BOCES



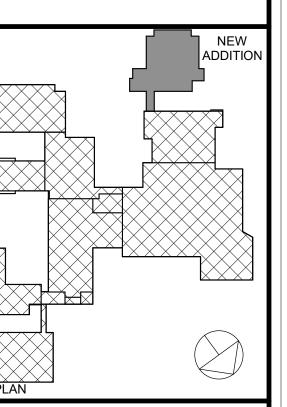
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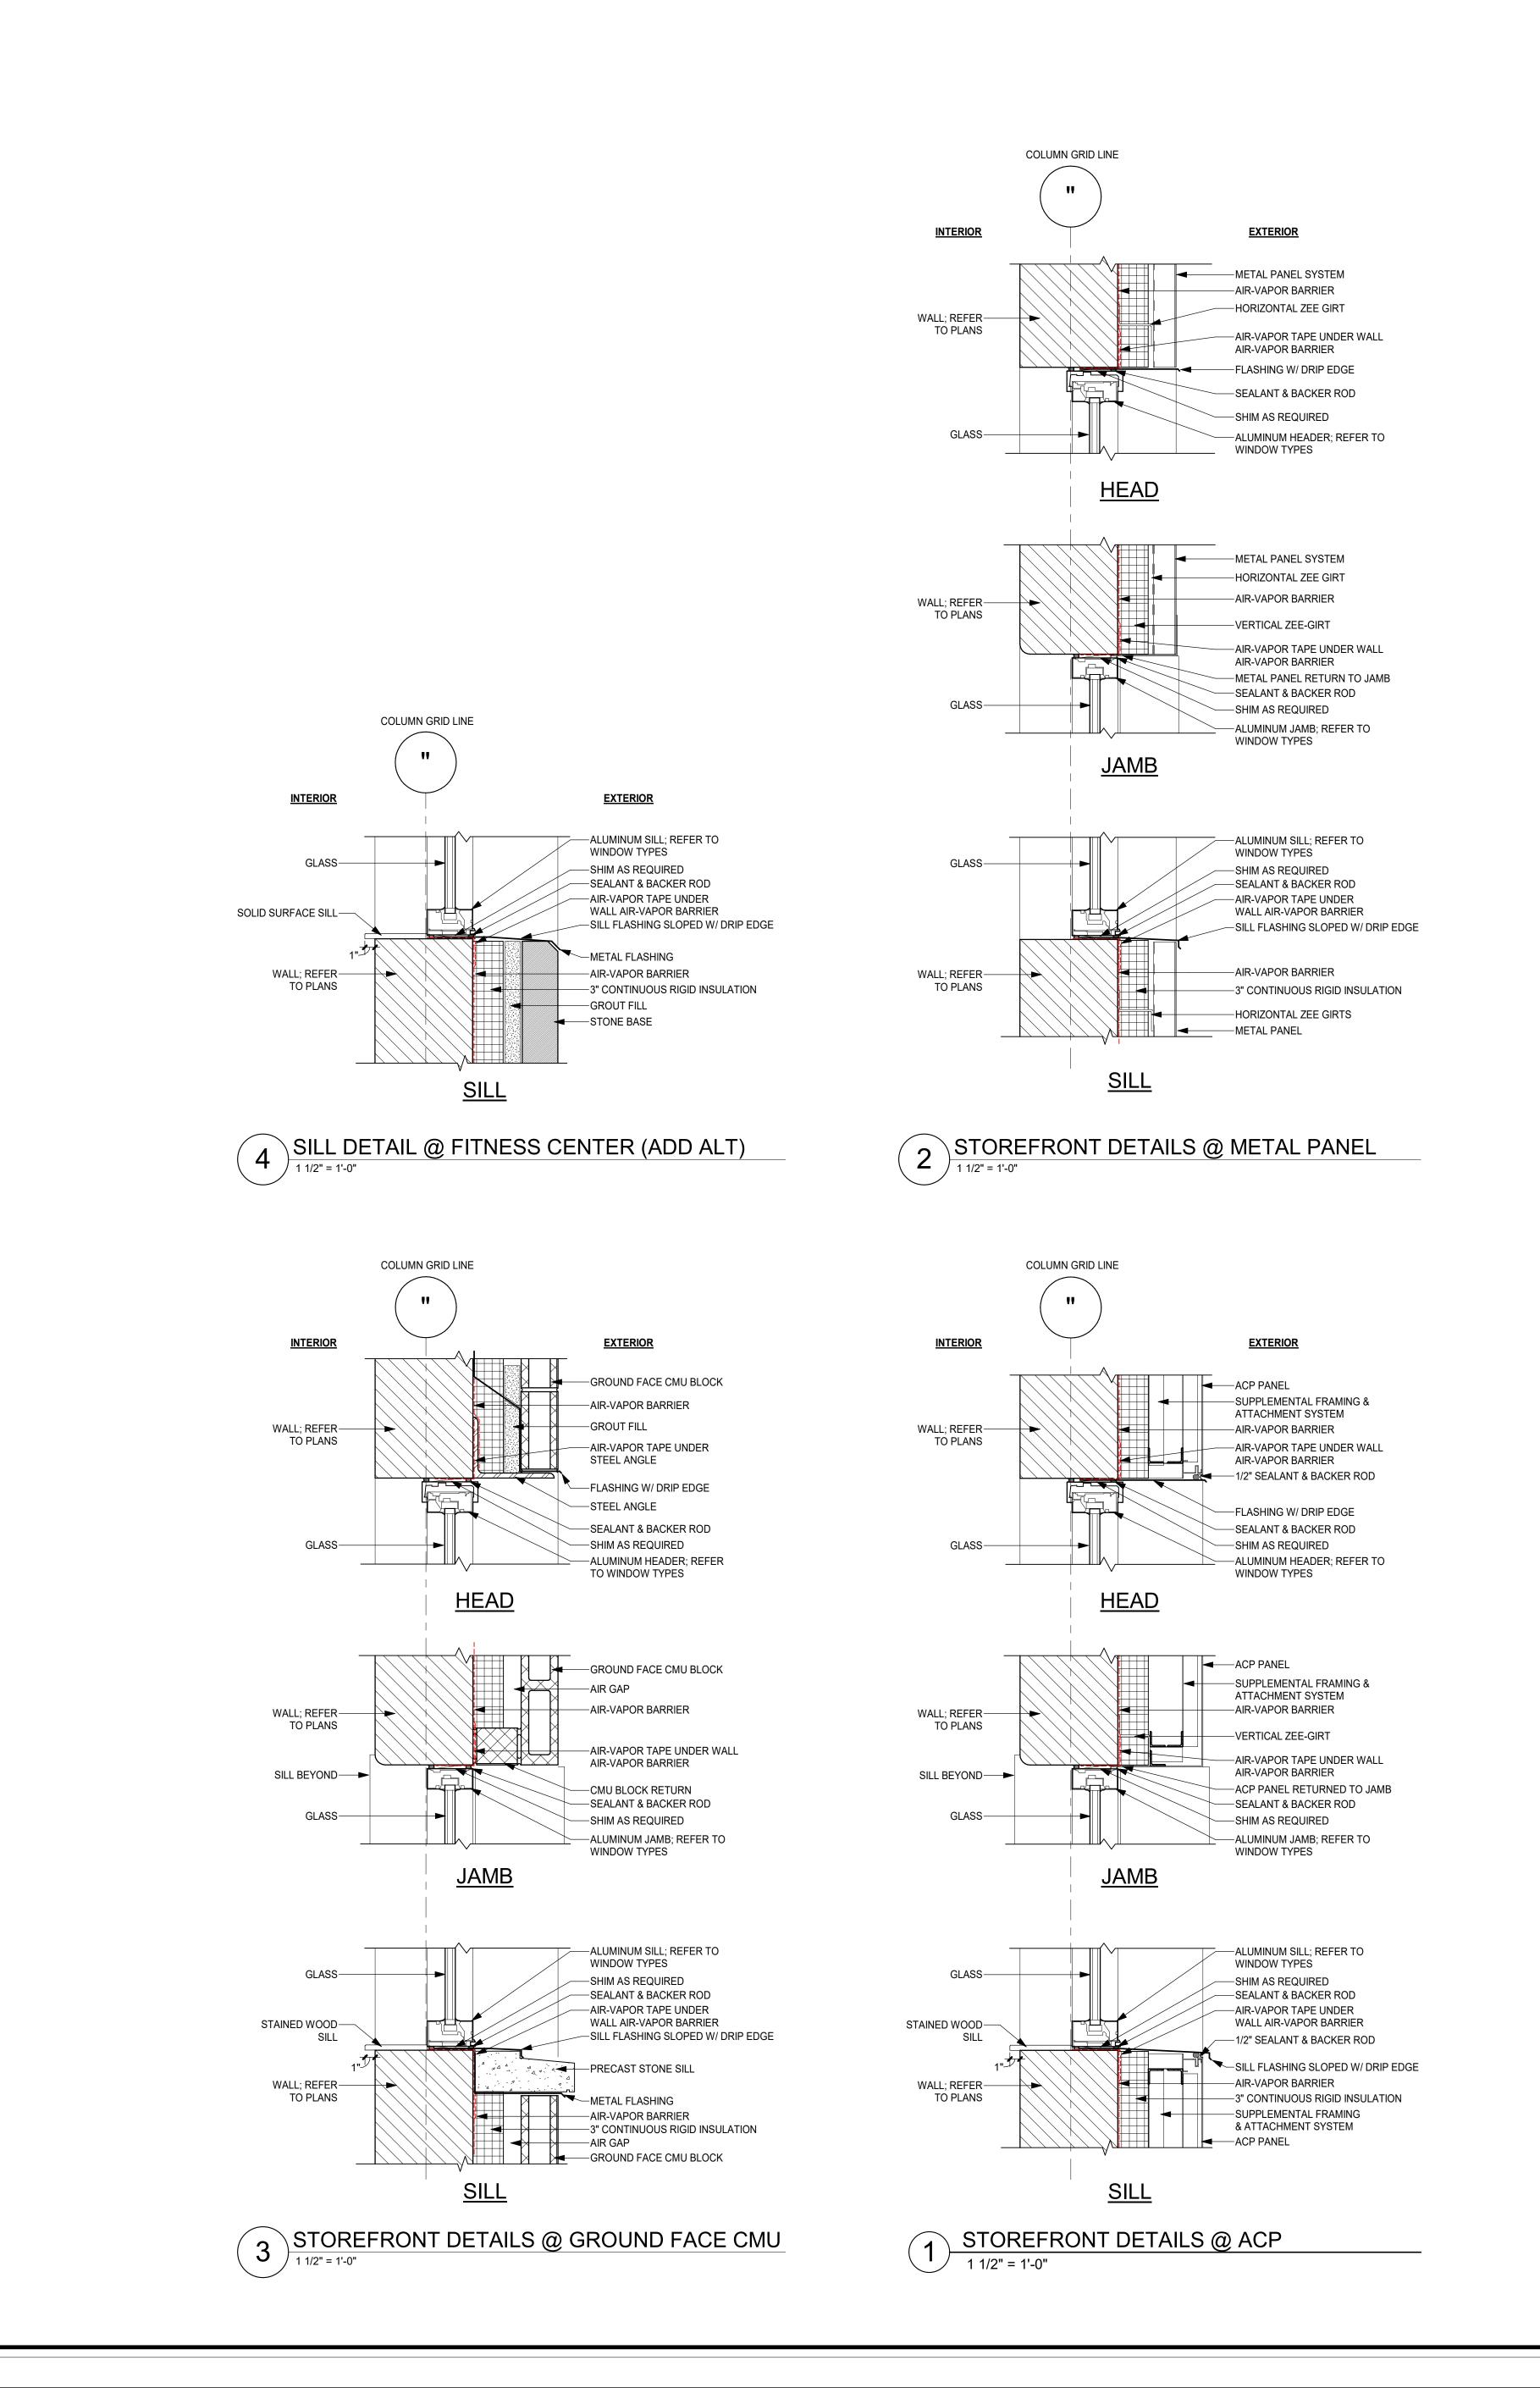
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WINDOW TYPES

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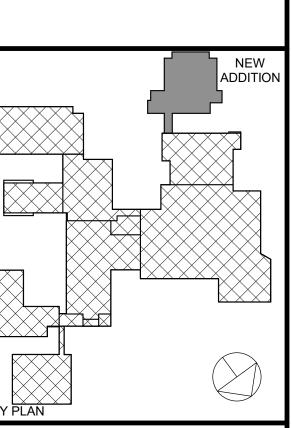
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