GENERAL NOTES:

- ALL WIRING, POWER, CONDUCTORS, CONDUITS ETC. SHALL MEET NYS ELECTRICAL CODE ARTICLE 760.
- 2. ALL WORK SHALL BE IN ACCORDANCE WITH THE NYS BUILDING CODE AND NFPA 72.
- 3. ALL FIRE ALARM CIRCUITS SHALL BE SIZED TO INCLUDE A MINIMUM OF 20% SPARE CAPACITY.
- 4. ALL FIRE ALARM EQUIPMENT SHALL BE INSTALLED WITH AESTHETICS IN MIND, AS FOLLOWS: PAINT ALL NEW CONDUIT AND BOXES TO MATCH EXISTING CONDITIONS, PATCH AND PAINT LOCATIONS OF REMOVED BOXES TO
- 5. ALL FIRE ALARM CABINETS SHALL BE CLEARLY LABELED WITH A LAMINATE ENGRAVED LABEL.
- 6. ALL FIRE ALARM WIRE SHALL BE CLEARLY LABELED IN JUNCTION BOXES AND CABINETS. ALL TERMINALS SHALL BE NUMBERED AND LABELED. ALL CONNECTIONS SHALL BE EITHER SOLDERED, APPROVED TERMINAL STRIPS OR SCOTCH LOCKS.
- 7. ALL FIRE ALARM CONDUCTORS SHALL BE PROTECTED BY EITHER BUILDING CONSTRUCTION OR CONDUIT. LOADING DOCKS, GARAGES, SUPPRESSION AND EXTINGUISHING SYSTEM WIRING, MECHANICAL AND ELECTRICAL ROOMS AND OTHER LOCATIONS SUBJECT TO MECHANICAL DAMAGE SHALL BE IN FULL RIGID CONDUIT. IN ALL AREAS, WIRING MUST MEET NEC ARTICLE 760.
- 8. FIRE ALARM CABLES SHALL NOT BE MIXED WITH NON FIRE ALARM CABLING. LOW VOLTAGE FIRE ALARM CABLING SHALL NOT BE MIXED OR WIRED NEAR ANY AC CIRCUIT.
- 9. ALL NOTIFICATION CIRCUITS SHALL BE A MINIMUM OF 12 AWG AND ALL OTHER LOW VOLTAGE FIRE ALARM CIRCUITS SHALL BE 14 AWG MINIMUM.
- 10. ALL WIRING SHALL BE INSPECTED TO ASSURE THERE ARE NO OPENS, SHORTS OR EARTH GROUNDS.
- 11. THE CONTRACTOR SHALL BE RESPONSIBLE FOR REMOVING ANY AND ALL ABANDONED FIRE ALARM CABINETS, DEVICES, AND WIRE. PAINT, PATCH AND CLEANUP SHALL ALSO BE INCLUDED.
- 12. FIRE ALARM PANEL SHALL PROVIDE CONTINUOUSLY SUPERVISED MONITORING OF ALL SYSTEMS FOR OPENS, SHORTS AND GROUNDS.
- 13. UPON ENTERING THE PANEL ALARM MODE, THE ALARM INDICATING DEVICE SHALL BE ACTIVATED, AND HVAC LOADS SHALL SHUT DOWN. THE DIGITAL COMMUNICATOR SHALL NOTIFY THE CENTRAL RECEIVING STATION.
- 14. CONTRACTOR SHALL PROVIDE ALL NECESSARY ADDITIONAL RELAY DEVICES OR POWER TRANSFORMERS FOR
- PROPER OPERATION OF ALL INTERLOCKED DEVICES WITH FIRE ALARM PANEL. 15. BATTERY BACKUP SHALL PROVIDE A MINIMUM OF 24 HRS OPERATION WITH A 10 MINUTE ALARM AT THE END OF 24
- 16. ALL WIRING SHALL BE IN ACCORDANCE WITH NFPA CODES 70, 72, 72E, AS WELL AS LOCAL AND STATE CODE REQUIREMENTS.
- 17. FIRE ALARM SYSTEM SHALL BE TESTED IN ACCORDANCE WITH NFPA CODES 70, 72, 72E, AS WELL AS ALL LOCAL AND STATE CODE REQUIREMENTS.
- 18. ENTIRE FIRE DETECTION AND ALARM SYSTEM SHALL BE FURNISHED AND INSTALLED BY A N.Y. STATE LICENSED ALARM CONTRACTOR.
- 19. CONTRACTOR SHALL PROVIDE ALL ADDITIONAL APPURTENANCES AS REQUIRED FOR A COMPLETE AND OPERABLE SYSTEM. MODEL NUMBERS GIVEN MAY NOT INCLUDE ALL SPECIFIC REQUIRED ACCESSORIES FOR COMPLETE INSTALLATION.
- 20. GENERAL LOCATIONS ARE SHOWN ON PLANS. DETECTORS SHALL NOT BE MOUNTED FURTHER THAN 30' APART AND THOSE ALONG WALLS SHALL NOT BE FURTHER THAN 15'-16' FROM THE WALL.
- 21. SMOKE DETECTORS MUST BE MOUNTED AT LEAST 3 FEET AWAY FROM ANY AIR REGISTER.
- 22. ALL CELING MOUNT DEVICES MUST BE SECURELY FASTENED TO BUILDING CONSTRUCTION.
- 23. DEVICE LOCATIONS MUST BE READILY ACCESSIBLE TO ALLOW FOR MAINTENANCE AND REPAIR.
- 24. DUCT MOUNTED SMOKE DETECTORS SHALL BE MOUNTED ON THE DUCTWORK IN STRICT ACCORDANCE WITH THE MANUFACTURERS INSTRUCTIONS. DETECTORS SHALL BE PROVIDED WITH A REMOTE LED.
- 25. ALL AUXILIARY RELAYS FOR FAN SHUTDOWN, ETC SHALL BE WIRED A MAXIMUM OF 3 FT FROM THE CONTROLLED DEVICE. THE AUXILIARY RELAY SHALL FUNCTION WITHIN THE REQUIRED VOLTAGE AND CURRENT OF THE CONTROLLED DEVICE. SLAVE OR INTERPOSING RELAYS SHALL BE INCLUDED AND POWERED BY THE FIRE ALARM CONTROL PANEL IN A FAIL-SAFE (FIRE FUNCTION) POSITION. POWER TO THE INTERPOSING RELAY SHALL BE MONITORED BY THE FIRE ALARM SYSTEM.
- 26. RISER DIAGRAM ON THIS DRAWING IS FOR DESIGN PURPOSE ONLY. FIRE ALARM CONTRACTOR SHALL PROVIDE A COMPLETE RISER DIAGRAM WITH ACTUAL FIELD WIRING REQUIRED.
- 27. THE CONTRACTOR IS TO RE-PROGRAM THE EXISTING FIRE ALARM SYSTEM TO MATCH THE EXISTING SEQUENCE OF

ABBREVIATIONS

ABBREVIATION: DESCRIPTION:

ALTERNATING CURRENT ACS ADMINISTRATIVE CONTROL STATION ADA AMERICANS WITH DISABILITIES ACT AFF ABOVE FINISHED FLOOR **ARCH** ARCHITECTURAL ATS AUTOMATIC TRANSFER SWITCH AIR CONDITIONING CONDUIT CAB CABINET CLG CEILING CB CIRCUIT BREAKER CKT(S) CIRCUIT(S) COL COLUMN DWG DRAWING EC **EMPTY CONDUIT** ELEC ELECTRIC **EMR** ELEVATOR MECHANICAL ROOM EMT ELECTRIC METALLIC TUBING EXH **EXHAUST EXIST EXISTING** FATB FIRE ALARM TERMINAL BOX FLOOR GUARD GROUND GND GFI GROUND FAULT INTERRUPTER GALVANIZED RIGID CONDUIT GRC ISOLATED GROUND JUNCTION BOX KVA KILOVOLT AMPERE KW KILOWATT KWH KILOWATT HOUR 120/208V PANEL LOUDSPEAKER LTG LIGHTING MATV MASTER TELEVISION MCC MOTOR CONTROL CENTER MECH MECHANICAL MER MECHANICAL EQUIPMENT ROOM MIC MICROPHONE MTD MOUNTED NEUTRAL NORMALLY CLOSED N.O. NORMALLY OPEN ORANGE AND ROCKLAND 0 & R POLE(S) PULL BOX PANEL 277/480V PANEL REMOTE CONTROL SSB SOLID STATE BALLAST

STANDARD

SWITCHBOARD

WEATHERPROOF

TELEPHONE **TELEVISION**

SWITCH

VOLT

WATT

SUMMARY OF WORK:


STD

THE WORK OF THIS PROJECT INCLUDES PROVIDING ELECTRICAL POWER TO THE HVAC UPGRADES AT STONY POINT ELEMENTARY SCHOOL. PROVIDE MATERIALS AND SERVICES AS FOLLOWS. THE FOLLOWING IS NOT INTENDED TO BE A COMPLETE DESCRIPTION OF THE WORK; PERFORM THE WORK AS HEREINAFTER DESCRIBED IN THESE CONTRACT DOCUMENTS.


- A. DISCONNECT POWER TO EXISTING UNIT VENTILATORS AND RETAIN THE EXISTING CABLES AND CONDUIT.
- RECONNECT EXISTING ELECTRIC POWER TO THE NEW UNIT VENTILATORS THROUGHOUT THE BUILDING WHERE INDICATED.
- C. PROVIDE POWER TO ALL NEW HVAC VRF EQUIPMENT BY MAKING MODIFICATIONS TO THE EXISITNG SWITCHGEAR IN THE ELECTRICAL ROOM.

SYMBOLS:

FACP	EXISTING FIRE ALARM SYSTEM CONTROL PANEL
CZ	CONTROL MODULE. "WP" INDICATES WEATHERPRO
R	RELAY
$\langle D \rangle$	DUCT MOUNTED SMOKE DETECTOR
FS	FIRE SMOKE DAMPERS
⟨S⟩	SMOKE DETECTOR

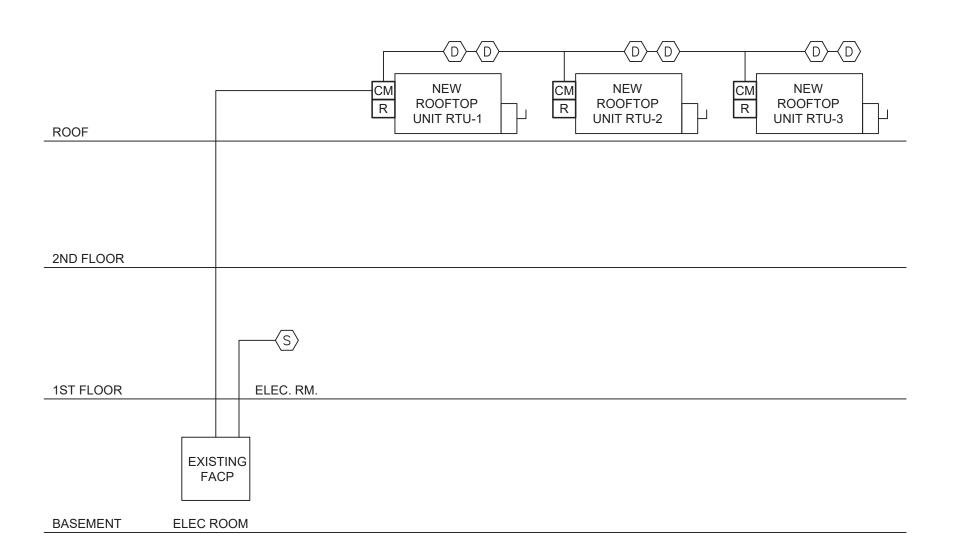


PARTIAL RISER DIAGRAM

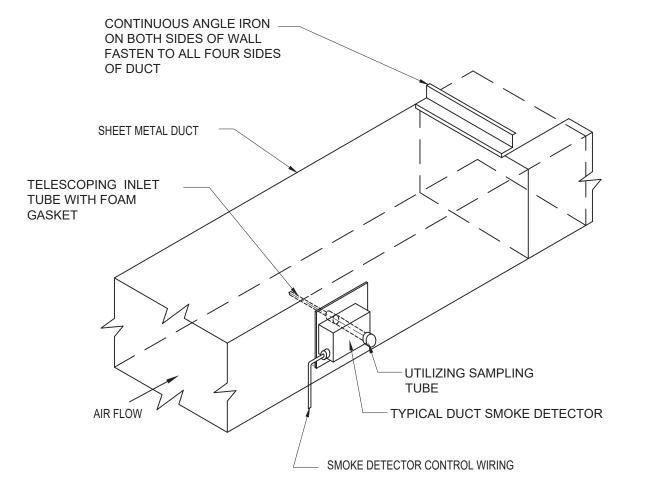

HVAC CONTRACTOR SHALL INSTALL DUCT SMOKE DETECTOR AS PER MANUFACTURER'S RECOMMENDATIONS AND NFPA 72.


TYPICAL DUCT MOUNTED SMOKE DETECTOR DETAIL SCALE: NTS

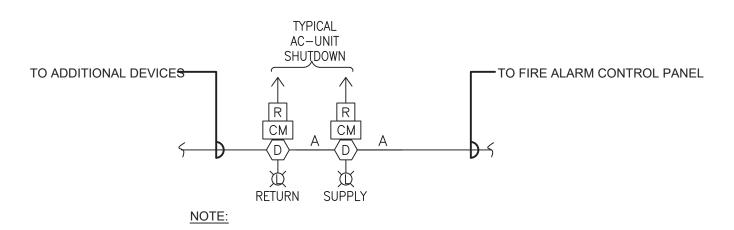

ALL DUCT DETECTORS SHALL BE PROVIDED WITH A REMOTE LED LIGHT FOR VISUAL





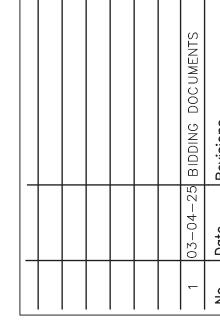




DK/KD	Checked by	SH	Project No.	43040	Scale	AS NOTED	Date	03-04-25

GREENMAN PEDERSEN, INC 2 EXECUTIVE BOULEVARD SUITE 202 SUFFERN, NY 10901 PROJ. NO.: MNY-2300088.00	GREENMAN PEDERSEN, INC 2 EXECUTIVE BOULEVARD SUITE 202 SUFFERN, NY 10901
Mechanical & Electrical Engineer:	Structural Engineer:

UNIVENT REPLACEMENT A STONY POINT, THIELLS, WEST HAVESTRAW ELEMENTARY SCHOOL



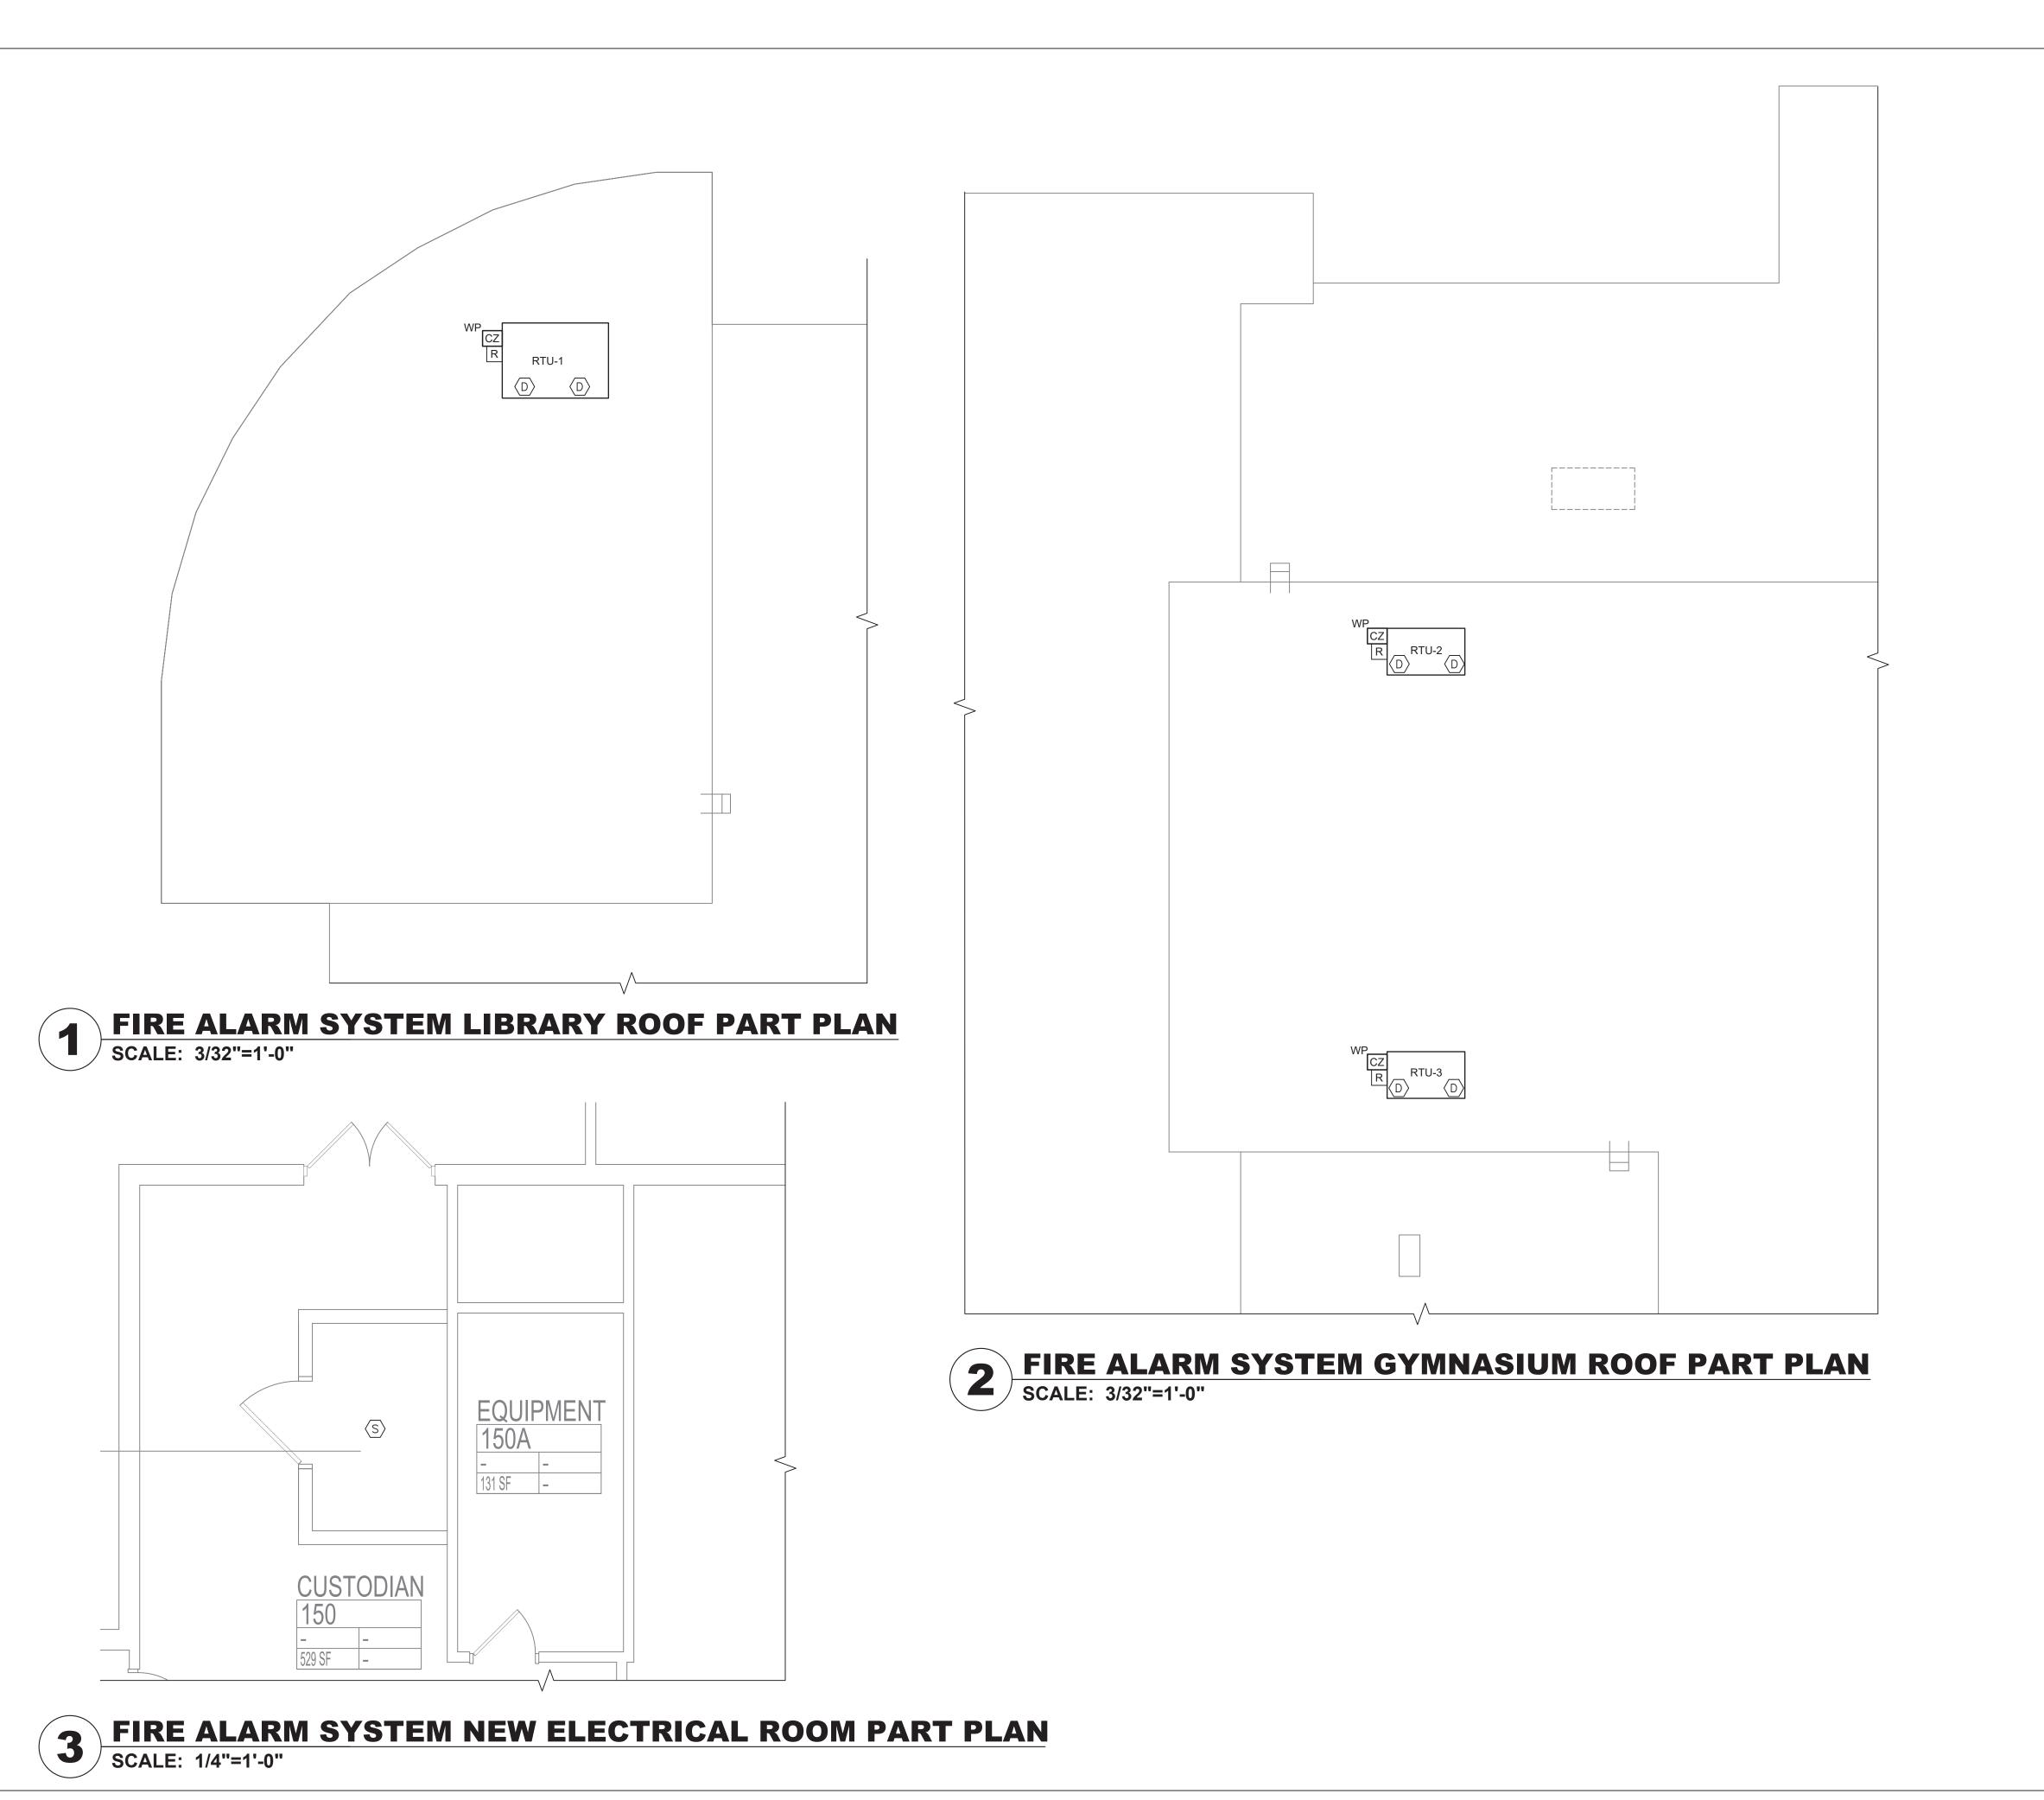

PLAN NOTES:

- FOR GENERAL NOTES, SYMBOL LIST, ABBREVIATIONS AND FIRE ALARM SYSTEM DRAWING LIST REFER TO DWG FA001.00.
- FOR EXACT LOCATION AND QUANTITIES OF MECHANICAL AND PLUMBING EQUIPMENT AND DEVICES REFER TO MECHANICAL AND PLUMBING DWGS.
- 3. ALL CONDUIT PENETRATIONS THROUGH FIRE RATED PARTITIONS ARE TO BE PROVIDED WITH FIRE STOP SEALS AS REQUIRED BY CODE TO MAINTAIN FIRE RATING OF
- 4. UNLESS OTHERWISE NOTED ON DRAWING MOUNTING HEIGHTS OUTLETS AND EQUIPMENT SHALL BE AS INDICATED ON SYMBOL LIST & SPECIFICATIONS.
- 5. ACCESS SHALL BE PROVIDE TO EACH DETECTOR FOR PERIODIC INSPECTION, MAINTENANCE AND TESTING AS PER SECTION 907.12 OF N.Y.C. BUILDING CODE.

_	03-04-25	03-04-25 BIDDING DOCUMENTS
No.	Date	Revisions



Drawn by	DK/KD	Checked by	SH	Project No.	43040	Scale	AS NOTED	Date	03-04-25

GREENMAN PEDERSEN, INC 2 EXECUTIVE BOULEVARD SUITE 202 SUFFERN, NY 10901 PROJ. NO.: MNY-2300088.00	GREENMAN PEDERSEN, INC 2 EXECUTIVE BOULEVARD SUITE 202 SUFFERN, NY 10901
Mechanical & Electrical Engineer:	Structural Engineer:

NTARY SCHOOL	TENT REPLACEMENT AT ONY POINT, THIELLS, WEST HAVESTRAW
50-02-01-06-0-014-012	LEMENTARY SCHOOL



KEY PLAN