



- RADIANT FLOOR ZONE LEGEND:**
- = ZONE 1, CONTAINS RADIANT FLOOR PIPING WITH 10 CIRCUITS TO MANIFOLD RFM-1.
 - = ZONE 2, CONTAINS RADIANT FLOOR PIPING WITH 10 CIRCUITS TO MANIFOLD RFM-2.
 - = ZONE 3, CONTAINS RADIANT FLOOR PIPING WITH 2 CIRCUITS TO MANIFOLD RFM-3.
 - = ZONE 4, CONTAINS RADIANT FLOOR PIPING WITH 4 CIRCUITS TO MANIFOLD RFM-4.
 - = ZONE 5, CONTAINS RADIANT FLOOR PIPING WITH 2 CIRCUITS TO MANIFOLD RFM-5.
 - = ZONE 6, CONTAINS RADIANT FLOOR PIPING WITH 2 CIRCUITS TO MANIFOLD RFM-6.
 - = ZONE 7, CONTAINS RADIANT FLOOR PIPING WITH 2 CIRCUITS TO MANIFOLD RFM-7.

1 Slab HVAC Piping Plan
SCALE: 3/8" = 1'-0"

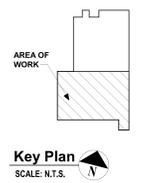

Key Plan
SCALE: N.T.S.

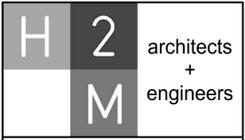

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Melville, NY 11747
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CONSULTANTS:

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MARK	DATE	DESCRIPTION



DESIGNED BY: DJR	DRAWN BY: DJR	CHECKED BY: MAM	REVIEWED BY: JML
PROJECT NO.: VQFD2001	DATE: JULY 2022	SCALE: AS SHOWN	

CLIENT

VAILS GATE FIRE DISTRICT

New Storage Building (Phase I)
New Fire Station (Phase II)

872 Blooming Grove Turnpike
New Windsor, NY 12553

CONTRACT

CONTRACT G
GENERAL CONSTRUCTION

STATUS

FINAL BID DOCUMENT

SHEET TITLE

SLAB HVAC PIPING PLAN AREA A

DRAWING NO.

M2 100A.00

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- GENERAL NOTES:**
- REFRIGERANT PIPING IS SCHEMATIC. COORDINATE REFRIGERANT PIPE SIZE WITH MANUFACTURER. PROVIDE PIPING SHOP DRAWING FROM MANUFACTURER FOR REVIEW.
 - ROUTE CONDENSATE PIPING TO NEAREST JANITORS SINK OR ROUTE TO FLOOR DRAIN AS SHOWN. ALL COND. PIPING NOT CONNECTED TO CONDENSATE PUMP (TAGGED AS CDP) TO BE SLOPED DOWN 1/8" - 1'-0" MINIMUM TOWARDS DRAIN.
 - SEE DETAILS FOR ISOLATION VALVE REQUIREMENTS. REFER TO SEISMIC RESTRAINT SCHEDULE FOR PIPING REQUIRING SEISMIC SUPPORTS

REVISIONS:

MARK	DATE	DESCRIPTION
2	12/22/2022	REVS. PER TOWN COMMENT

MARK	DATE	DESCRIPTION

DESIGNED BY: DKR
 DRAWN BY: DKR
 PROJECT No.: VGF02001

CHECKED BY: DKR
 DATE: JULY 2022
 SCALE: AS SHOWN

REVIEWED BY: [Signature]

VAILS GATE FIRE DISTRICT

New Storage Building (Phase I)
 New Fire Station (Phase II)




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CONTRACT G
 GENERAL CONSTRUCTION


STATUS
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SHEET TITLE
 SECOND FLOOR HVAC PIPING
 PLAN AREA B


DRAWING No.
M2 102B.02



1 Second Floor HVAC Piping Plan
 SCALE: 3/16" = 1'-0"

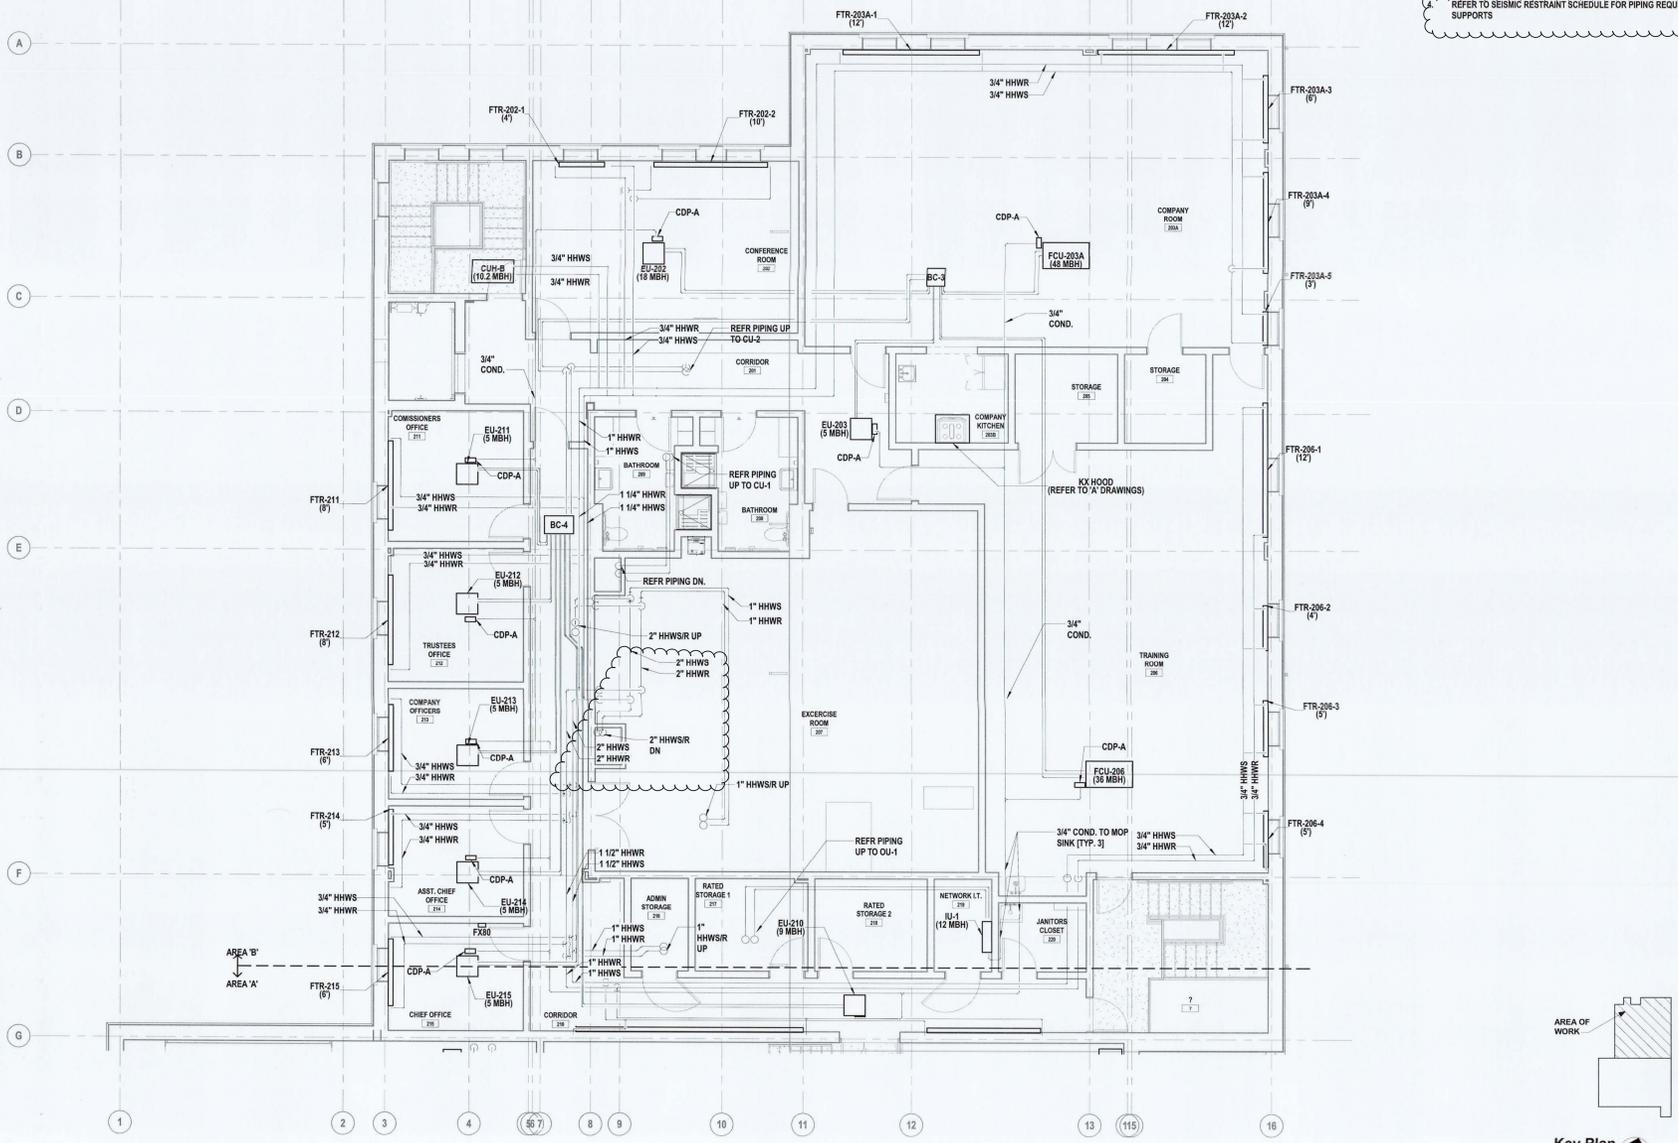
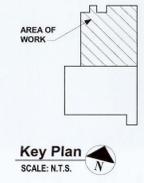
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- GENERAL NOTES:**
1. ALL DUCT SIZES ARE CLEAR INSIDE DIMENSIONS. REFER TO SPECIFICATIONS FOR ALL DUCT CONSTRUCTION REQUIREMENTS.
 2. ALL SUPPLY, RETURN AND EXHAUST BRANCH DUCTWORK SHALL BE PROVIDED WITH VOLUME DAMPERS.
 3. MAINTAIN 1/4" CLEARANCE BETWEEN OUTSIDE AIR AND EXHAUST AIR TERMINATIONS ON ROOF.
 4. PROVIDE SOUND PROOFED PENETRATIONS THROUGH ALL NON FIRE RATED INTERIOR WALLS. USE TREMCO ACOUSTICAL SEALANT OR APPROVED EQUAL.

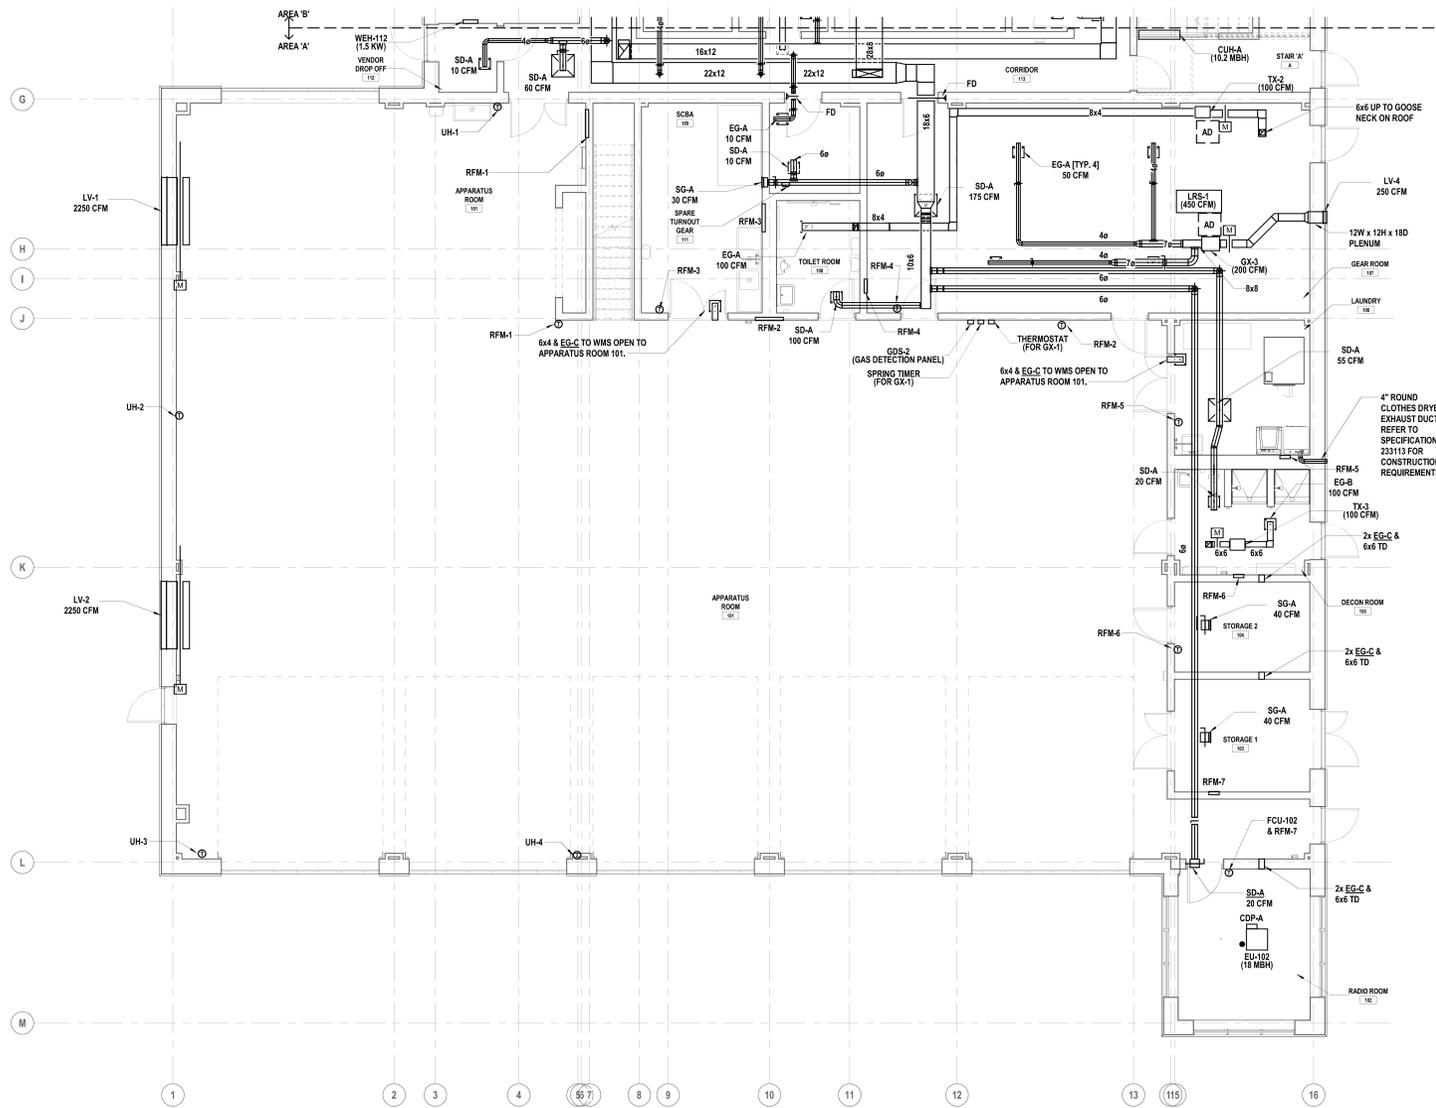H 2 M architects + engineers

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CONSULTANTS:

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MARK	DATE	DESCRIPTION



DESIGNED BY: DHR	DRAWN BY: DHR	CHECKED BY: MAM	REVIEWED BY: JML
PROJECT NO.: VQFD2001	DATE: JULY 2022	SCALE: AS SHOWN	

CLIENT

VAILS GATE FIRE DISTRICT

New Storage Building (Phase I)
New Fire Station (Phase II)

872 Blooming Grove Turnpike
New Windsor, NY 12553

CONTRACT

CONTRACT G
GENERAL CONSTRUCTION

STATUS

FINAL BID DOCUMENT


SHEET TITLE

FIRST FLOOR DUCTWORK PLAN
AREA A

DRAWING NO.

M2 131A.00

1 First Floor Ductwork Plan
SCALE: 3/8" = 1'-0"

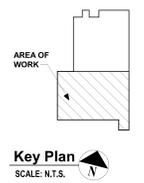

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- GENERAL NOTES:**
1. ALL DUCT SIZES ARE CLEAR INSIDE DIMENSIONS. REFER TO SPECIFICATIONS FOR ALL DUCT CONSTRUCTION REQUIREMENTS.
 2. ALL SUPPLY, RETURN AND EXHAUST BRANCH DUCTWORK SHALL BE PROVIDED WITH VOLUME DAMPERS.
 3. MAINTAIN 1/4" CLEARANCE BETWEEN OUTSIDE AIR AND EXHAUST AIR TERMINATIONS ON ROOF.
 4. COORDINATE WITH NEW STRUCTURE, OFFSET AS REQUIRED.
 5. MAINTAIN HEADROOM FOR ALL NEW HORIZONTAL DUCTWORK (6'-8" MINIMUM).
 6. PROVIDE SOUND PROOFED PENETRATIONS THROUGH ALL NON FIRE RATED INTERIOR WALLS. USE TREMCO ACOUSTICAL SEALANT OR APPROVED EQUAL.

CONSULTANTS:

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MARK	DATE	DESCRIPTION

SEALING & INSULATION
 STATE OF NEW YORK
 JOHN LAMAY
 101303
 LICENSED PROFESSIONAL ENGINEER

DESIGNED BY: DMR DRAWN BY: DMR CHECKED BY: JML REVIEWED BY: JML
 PROJECT NO.: VOFD2001 DATE: JULY 2022 SCALE: AS SHOWN

CLIENT
VAILS GATE FIRE DISTRICT

New Storage Building (Phase I)
 New Fire Station (Phase II)





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**CONTRACT G
 GENERAL CONSTRUCTION**


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FINAL BID DOCUMENT

SHEET TITLE
**FIRST FLOOR DUCTWORK PLAN
 AREA B**

DRAWING NO.
M2 131B.00

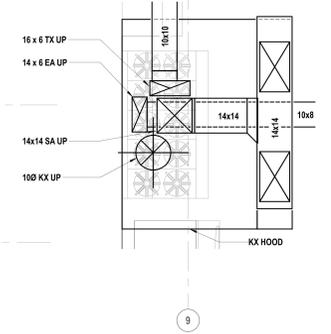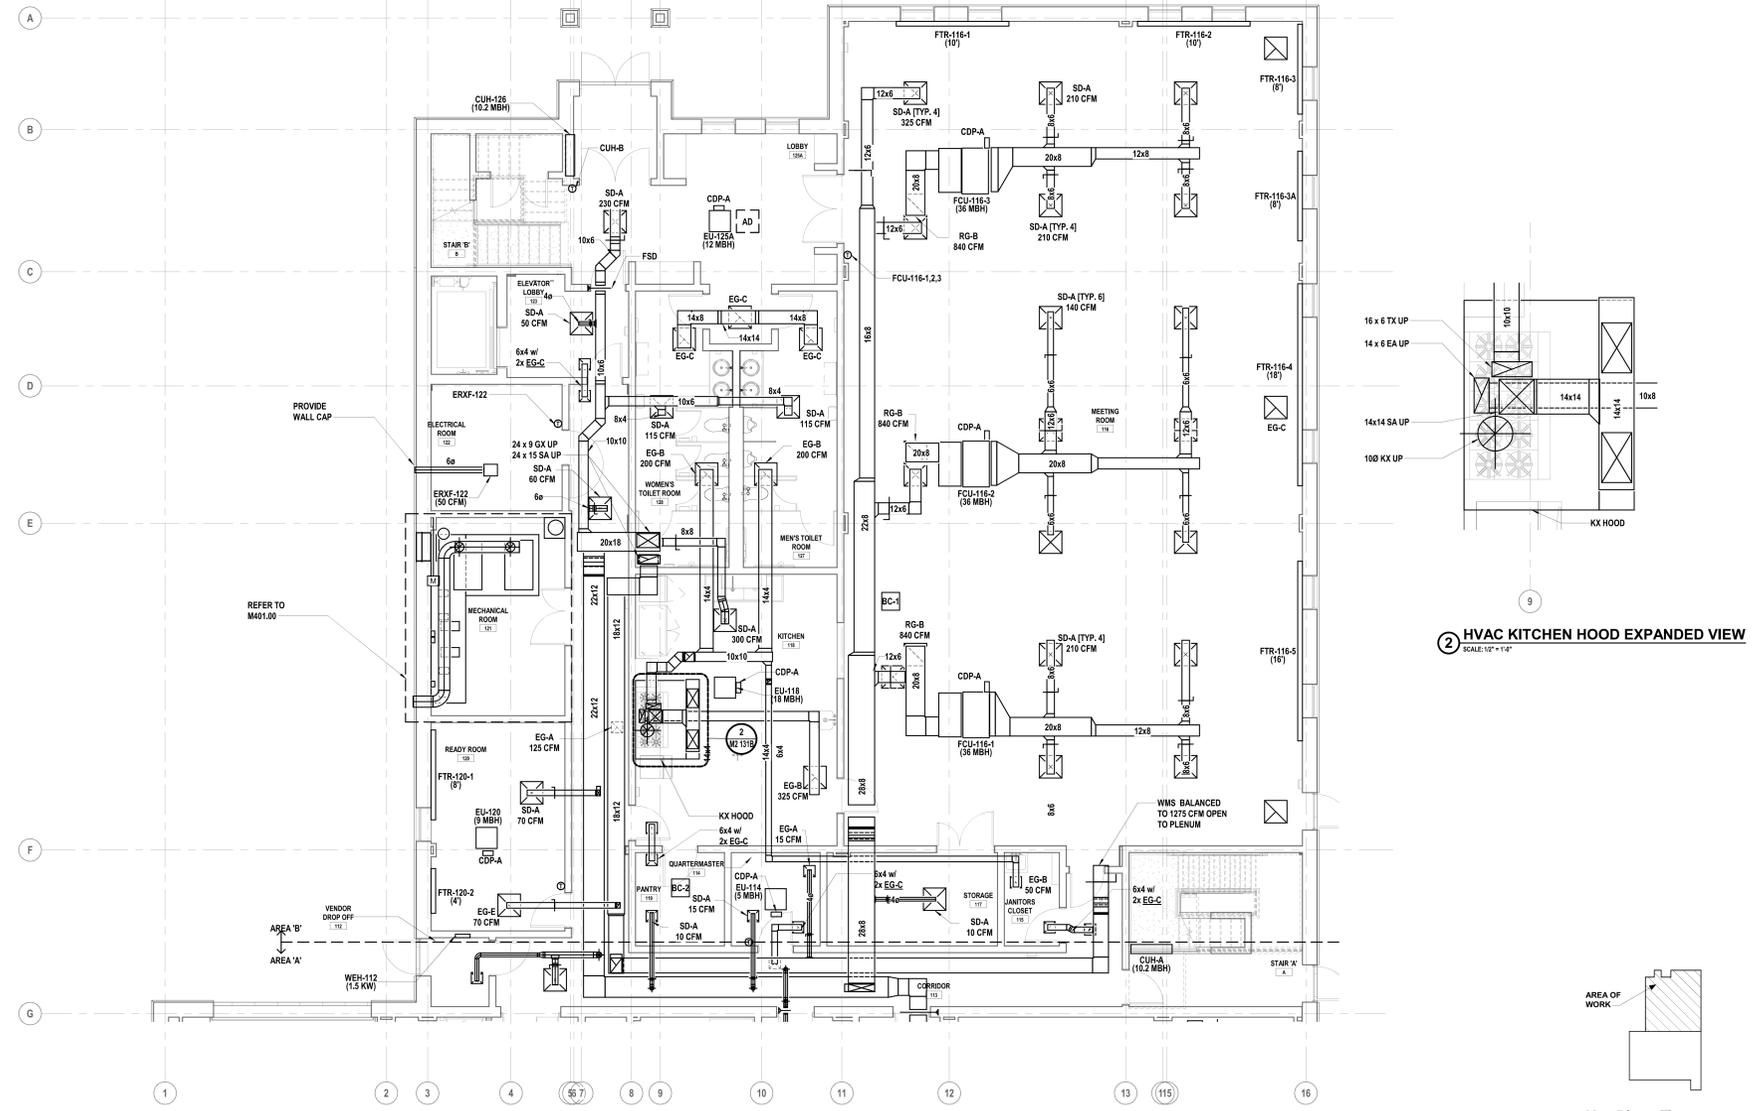

2 HVAC KITCHEN HOOD EXPANDED VIEW
 SCALE: 1/2" = 1'-0"

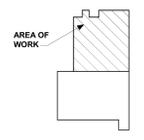

1 First Floor Ductwork Plan
 SCALE: 3/16" = 1'-0"

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CONSULTANTS:

MARK	DATE	DESCRIPTION



DESIGNED BY: DKR DRAWN BY: DKR CHECKED BY: MLV REVIEWED BY: JML
 PROJECT No.: VQFD2001 DATE: JULY 2022 SCALE: AS SHOWN

CLIENT
VAILS GATE FIRE DISTRICT

New Storage Building (Phase I)
 New Fire Station (Phase II)




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**CONTRACT G
 GENERAL CONSTRUCTION**

STATUS
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SHEET TITLE
HVAC ROOF PLAN AREA A

DRAWING No.
M2 133A.00



1 ROOF AREA A
 SCALE: 3/16" = 1'-0"

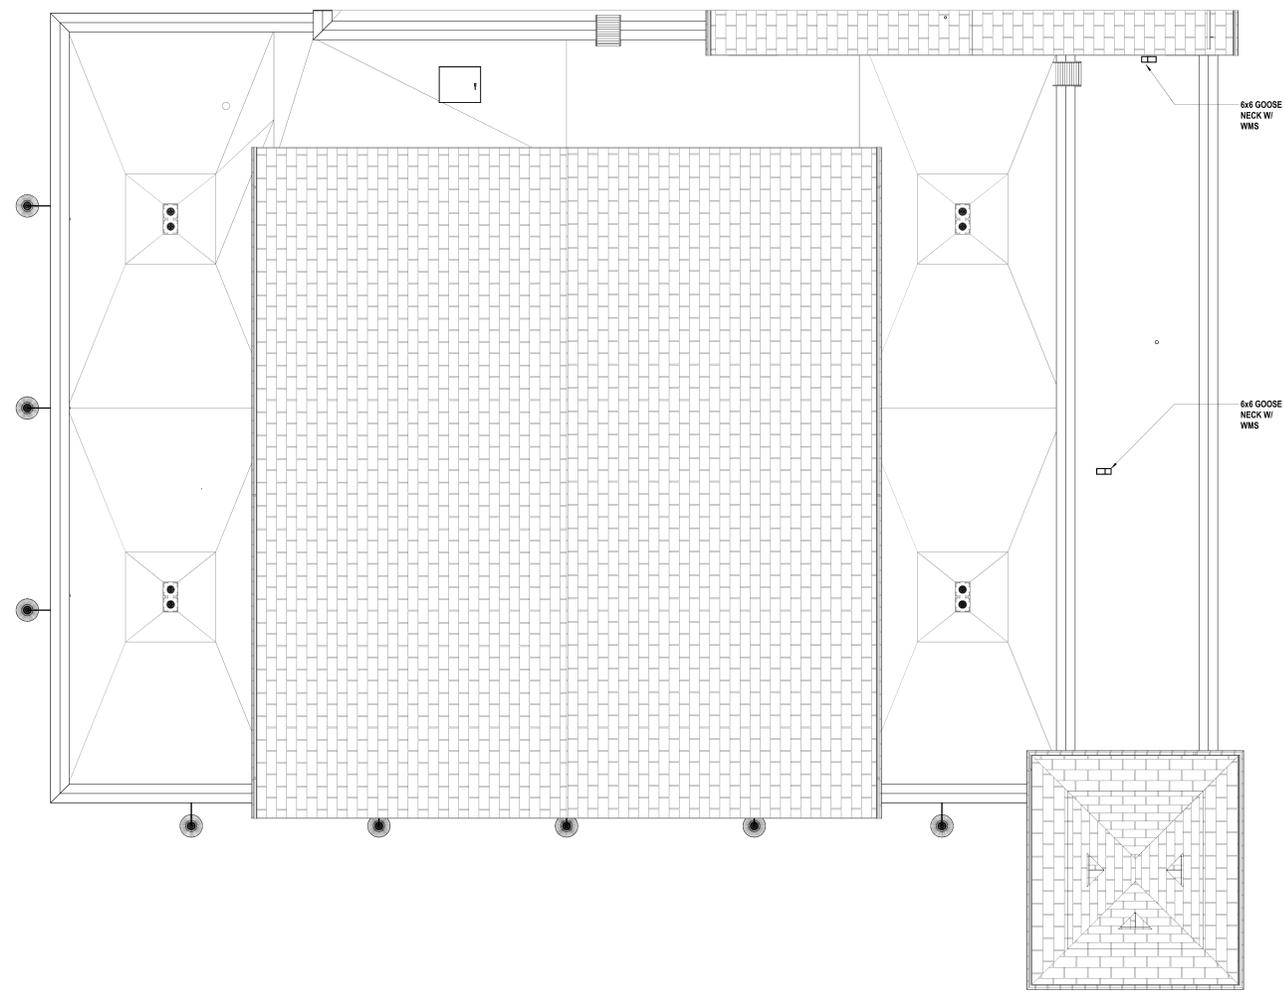

Key Plan
 SCALE: N.T.S.

EQUIPMENT NO.	LOCATION	QUANTITY	AREA SERVED	PERFORMANCE/ CONSTRUCTION REQUIREMENTS														BASIS OF DESIGN INFORMATION						NOTES					
				SUPPLY FAN				COOLING COIL				HEATING COIL						ELECTRICAL DATA											
				MAXIMUM FLOW (CFM)	EXT. S.P. (IN. W.G.)	BHP	OUTSIDE AIR FLOW (CFM)	REFRIGERANT TYPE	TOTAL CAPACITY (MBH)	SENSIBLE CAPACITY (MBH)	EER	SEER	AIR DATA	MIN TOTAL CAPACITY (MBH)	FLOW RATE (GPM)	EWI (°F)	LWT (°F)	COIL WATER ΔP (FT H2O)	EAT (°F)	COIL LAT (°F)	MNF	MODEL NO.	NOMINAL DIMENSIONS (LxWxH) (IN.)		NOMINAL OPERATING WEIGHT (LBS)	VOLTS/ PHASE	SUPPLY FAN HP	UNIT MCA/MCOP	
RTU-207	ROOF	1	207 TRAINING ROOM	1,200	0.60	0.57	325	R-410A	33.0	26.7	12.2	14.7	80.0/67.0	59.4/58.4	65.6	4.4	150	119.9	0.8	55	195.1	TEMPMASTER	ZR037C00B2BAC1A2	89 x 59 x 42	962	208/3	1.50	41.3/50	1-18

- NOTES:
1. 4" PLEATED MERV-13 FILTERS WITH FOUR (4) SETS OF SPARE FILTER MEDIA.
 2. HINGED ACCESS DOORS.
 3. DISCONNECT SWITCH (FACTORY MOUNTED).
 4. DIRTY FILTER INDICATOR SWITCH.
 5. POWERED CONVENIENCE OUTLET.
 6. CONDENSER HAL GUARD.
 7. LOW LEAK COMPARATIVE ENTHALPY ECONOMIZER.
 8. ELECTRICAL CONTRACTOR TO FURNISH AND WIRE SUPPLY AND RETURN AIR SMOKE DETECTORS. MECHANICAL CONTRACTOR TO INSTALL.
 9. VERTICAL SUPPLY/RETURN CONNECTIONS.
 10. BACNET DDC COMMUNICATION. INTERLOCK WITH BMS.
 11. 14" ROOF CURBS AND THRU BASE ELECTRICAL CONNECTIONS.
 12. PHASE MONITOR (PHASE LOSS PROTECTION).
 13. PROVIDE SPACE TEMPERATURE SENSOR(S) WITH DIGITAL DISPLAY, SETPOINT ADJUSTMENT, OCCUPANCY SCHEDULE.
 14. SINGLE ZONE VARIABLE AIR VOLUME CONFIGURATION.
 15. VARIABLE FREQUENCY DRIVE.
 16. SINGLE POINT POWER FEED TO RTU AND CONVENIENCE OUTLET.
 17. HOT GAS REHEAT DEHUMIDIFICATION.
 18. TWO STAGES OF COOLING.

DEDICATED OUTDOOR AIR UNITS

EQUIPMENT NO.	AREA SERVED	PERFORMANCE/ CONSTRUCTION REQUIREMENTS														BASIS OF DESIGN INFORMATION						NOTES																	
		SUPPLY FAN				EXHAUST FAN				COOLING COIL						ELECTRICAL DATA																							
		OUTSIDE AIR FLOW (CFM)	MOTOR HP	EXT. S.P. (IN. W.G.)	TOTAL S.P. (IN. W.G.)	AIR FLOW (CFM)	MOTOR HP	EXT. S.P. (IN. W.G.)	TOTAL S.P. (IN. W.G.)	REFRIGERANT TYPE	IMRRE	TOTAL SYSTEM CAPACITY (MBH)	SENSIBLE CAPACITY (MBH)	AIR DATA	MIN TOTAL CAPACITY (MBH)	FLOW RATE (GPM)	EWI (°F)	LWT (°F)	COIL WATER ΔP (IN. W.C.)	RA DB (°F)	RA DB (°F)		EAT (°F)	MAX COIL LAT (°F)	UNIT LAT (°F)	MNF	MODEL NO.	NOMINAL DIMENSIONS L" x W" x H" (IN.)	NOMINAL OPERATING WEIGHT (LBS)	VOLTS/ PHASE	MCA	MOCP							
DOAS-1	1ST AND 2ND FLOOR VENTILATION	4,500	5	2.97	1.00	2,677	2,800	2	1.16	1.00	1.596	R-410A	6.8	206.9	143.7	0.24	95.0/75.0	75.0/63.0	84.2/69.2	55.1/54.7	75/50%	295.8	18.1	150	120	0.7	12.0	70.0	40.8	95.7	75	LG	ARDE-212-92-15H-150	180.5 x 98.5 x 76.5	4,527	208/3	84.4	100	1-19

- NOTES:
1. ENERGY RECOVERY WHEEL.
 2. HORIZONTAL DISCHARGE EXHAUST CONFIGURATION.
 3. FACTORY PROVIDED INTEGRAL NONFUSED DISCONNECT.
 4. POWERED CONVENIENCE OUTLET.
 5. PROVIDE 1" ROOF CURBS W/ THRU BASE CONNECTIONS.
 6. SINGLE POINT POWER FEED.
 7. BACNET DDC COMMUNICATION. INTEGRATE WITH BMS.
 8. FROST CONTROL (MODULATING WHEEL).
 9. STAINLESS STEEL DRAIN PAN.
 10. DIRTY FILTER INDICATOR SWITCH.
 11. HAL GUARDS.
 12. MODULATING HOT GAS REHEAT.
 13. DIGITAL SCROLL COMPRESSOR FOR ALL CIRCUITS.
 14. MANUFACTURER TO PROVIDE FACTORY INSTALLED UNIT CONTROLLER.
 15. PHASEBROWN OUT PROTECTION.
 16. SUPPLY AIR FLOW MONITORING.
 17. 2" PLEATED MERV-8 FILTERS PROVIDE WITH FOUR (4) SETS OF SPARE FILTER MEDIA.
 18. ELECTRICAL CONTRACTOR TO FURNISH AND WIRE SUPPLY AND RETURN AIR SMOKE DETECTORS. MECHANICAL CONTRACTOR TO INSTALL.
 19. HINGED ACCESS DOORS.

SPLIT CONDENSING UNITS

EQMT. #	LOCATION	TYPE	INDOOR UNITS SERVED	PERFORMANCE/ CONSTRUCTION REQUIREMENTS														BASIS OF DESIGN INFORMATION						NOTES
				COOLING PERFORMANCE				HEATING PERFORMANCE						ELECTRICAL DATA										
				REFRIGERANT	ESTIMATED CONDENSER CHARGE (LB)	TOTAL CAPACITY (MBH)	MIN OPER. TEMP. (°F)	MAX OPER. TEMP. (°F)	EER	IEER [SEER]	TOTAL CAPACITY (MBH) @ 9°F DB / -2°F WB [-3°F DB / -4°F WB]	MIN OPER. TEMP. (°F)	MAX OPER. TEMP. (°F)	COP @ 47°F [HSPF]	COP @ 17°F	MANUF.	MODEL #	NOMINAL DIMENSIONS L x W x H (IN.)	NOMINAL OPERATING WEIGHT (LBS.)	VOLTS/ PHASE / HZ	MCA	MOCP		
CU-1	ROOF	MULTIZONE HEAT RECOVERY	SEE EVAPORATOR UNIT SCHEDULE	R410A	26.5	168	5	122	11.1	21.9	163.8	-22	61	3.20	2.38	LG	ARUM168BTE5	49 x 30 x 67	639	208/60/3	53.6	70	1-8	
CU-2	ROOF	MULTIZONE HEAT RECOVERY	SEE EVAPORATOR UNIT SCHEDULE	R410A	26.5	168	5	122	11.1	21.9	163.7	-22	61	3.20	2.38	LG	ARUM168BTE5	49 x 30 x 67	639	208/60/3	53.6	70	1-8	
CU-1	ROOF	1 TO 1 HEAT PUMP	BU-1	R410A	2.21	13.8	14	118	12.5	22.7	[10.36]	-4	65	[11.4]	-	LG	LSU120HSV5	30.5 x 12.5 x 21.5	74	208-230/60/1	10.0	15	1-4,7-8	

- NOTES:
1. REFRIGERANT CHARGE IS SOLELY PRE-CHARGE FROM CONDENSERS. CONTRACTOR TO NOTIFY ENGINEER IF ADDITIONAL SYSTEM CHARGE IS REQUIRED.
 2. ELECTRICAL CONTRACTOR TO PROVIDE DISCONNECT SWITCH FOR OUTDOOR UNIT IN NEMA-4X ENCLOSURE.
 3. PROVIDE AND INSTALL REFRIGERANT PIPING SPECIALTIES PER MANUFACTURER'S RECOMMENDATIONS.
 4. CONTRACTOR TO PROVIDE 14" HIGH RAIRS.
 5. MANUFACTURER TO PROVIDE HAL GUARD KIT.
 6. MANUFACTURER PROVIDED AIR GUIDE.
 7. MANUFACTURER PROVIDED LOW AMBIENT BAFFLE KIT.
 8. MANUFACTURER PROVIDED BASE PAN HEATER.

SPLIT EVAPORATING UNITS

UNIT TAG	UNIT LOCATION	TYPE	PAIRED EQUIPMENT	PERFORMANCE/ CONSTRUCTION REQUIREMENTS														BASIS OF DESIGN INFORMATION						NOTES
				SUPPLY UNIT DATA				HEATING PERFORMANCE						ELECTRICAL DATA										
				REFRIGERANT	DRY AIRFLOW (HI TO LO) [HI-DEL-LO]	EXTERNAL STATIC (IN. W.C.) [HI TO LO]	SOUND LEVEL LOW TO HIGH [dB(A)]	NOMINAL SIZE	TOTAL COOLING CAPACITY (MBH)	SENSIBLE COOLING CAPACITY (MBH)	HEATING CAPACITY (MBH) @ 9°F DB / -2°F WB [-3°F DB / -4°F WB]	MANUF.	MODEL	NOMINAL DIMENSIONS L" x W" x H"	OPERATING WEIGHT (LBS.)	VOLTS/ PHASE/ HZ	MCA	MOCP						
EU-102	RADIO ROOM 102	CEILING CASSETTE	BC-1	CU-1	R410A	396-388-353	-	3435/37	18	19.15	13.82	22.2	6.3	LG	ARNU183TQD4	24.5 x 24.5 x 10	35	208/160	0.25	15	1-6			
EU-114	114 QUARTERMASTER	CEILING CASSETTE			R410A	265-247-212	-	2627/29	5	5.52	3.90	6.3	6.3	LG	ARNU183TQD4	24.5 x 24.5 x 10	29	208/160	0.25	15	1-6			
EU-118	118 KITCHEN	CEILING CASSETTE	BC-2	CU-1	R410A	396-388-353	-	3435/37	18	19.15	13.82	22.2	6.3	LG	ARNU183TQD4	24.5 x 24.5 x 10	35	208/160	0.25	15	1-6			
EU-120	120 READY ROOM	CEILING CASSETTE			R410A	283-265-251	-	2729/30	9	9.63	6.91	11.2	11.2	LG	ARNU183TQD4	24.5 x 24.5 x 10	32	208/160	0.25	15	1-6			
FCU-116-1	116 MEETING	CONCEALED FAN COIL	BC-3	CU-1	R410A	1554-476	0.71 - 0.16	6062/65	36	36.31	26.84	42.0	6.3	LG	ARNU363M2A4	27.5 x 54 x 11	86	208/160	2.90	15	1-6			
FCU-116-2	116 MEETING	CONCEALED FAN COIL			R410A	1554-476	0.71 - 0.16	6062/65	36	36.31	26.84	42.0	6.3	LG	ARNU363M2A4	27.5 x 54 x 11	86	208/160	2.90	15	1-6			
FCU-116-3	116 MEETING	CONCEALED FAN COIL	BC-4	CU-1	R410A	1554-476	0.71 - 0.16	6062/65	36	36.31	26.84	42.0	6.3	LG	ARNU363M2A4	27.5 x 54 x 11	86	208/160	2.90	15	1-6			
EU-125A	125A LOBBY	CEILING CASSETTE			R410A	307-283-247	-	2730/32	12	12.34	8.91	14.1	14.1	LG	ARNU123TRD4	24.5 x 24.5 x 10	32	208/160	0.25	15	1-6			
EU-202	202 MEETING	CEILING CASSETTE	BC-4	CU-1	R410A	396-388-353	-	3435/37	18	19.15	13.82	22.2	6.3	LG	ARNU183TQD4	24.5 x 24.5 x 10	35	208/160	0.25	15	1-6			
EU-203	203 VESTIBULE	CEILING CASSETTE			R410A	265-247-212	-	2627/29	5	5.52	3.90	6.3	6.3	LG	ARNU183TQD4	22.5 x 22.5 x 8.5	29	208/160	0.25	15	1-6			
FCU-203A	203A COMPANY ROOM	CONCEALED FAN COIL	BC-4	CU-1	R410A	2075-522	0.79 - 0.16	626/67	48	48.24	36.16	58.0	6.3	LG	ARNU183M2A4	27.5 x 30.5 x 12	96.10	208/160	3.10	15	1-6			
FCU-206	206 TRAINING	CONCEALED FAN COIL			R410A	1554-476	0.71 - 0.16	6062/65	36	36.31	26.84	42.0	6.3	LG	ARNU363M2A4	27.5 x 54 x 11	86	208/160	2.90	15	1-6			
EU-210	210 CORRIDOR	CEILING CASSETTE	BC-4	CU-1	R410A	283-265-251	-	2729/30	9	9.63	6.91	11.2	11.2	LG	ARNU183TQD4	24.5 x 24.5 x 10	32	208/160	0.25	15	1-6			
EU-211	211 OFFICE	CEILING CASSETTE			R410A	265-247-212	-	2627/29	5	5.52	3.90	6.3	6.3	LG	ARNU183TQD4	22.5 x 22.5 x 8.5	29	208/160	0.25	15	1-6			
EU-212	212 OFFICE	CEILING CASSETTE	BC-4	CU-1	R410A	265-247-212	-	2627/29	5	5.52	3.90	6.3	6.3	LG	ARNU183TQD4	22.5 x 22.5 x 8.5	29	208/160	0.25	15	1-6			
EU-213	213 OFFICE	CEILING CASSETTE			R410A	265-247-212	-	2627/29	5	5.52	3.90	6.3	6.3	LG	ARNU183TQD4	22.5 x 22.5 x 8.5	29	208/160	0.25	15	1-6			
EU-214	214 OFFICE	CEILING CASSETTE	BC-4	CU-1	R410A	265-247-212	-	2627/29	5	5.52	3.90	6.3	6.3	LG	ARNU183TQD4	22.5 x 22.5 x 8.5	29	208/160	0.25	15	1-6			
EU-215	215 OFFICE	CEILING CASSETTE			R410A	265-247-212	-	2627/29	5	5.52	3.90	6.3	6.3	LG	ARNU183TQD4	22.5 x 22.5 x 8.5	29	208/160	0.25	15	1-6			
BU-1	219 IT	WALL MOUNT	CU-1	R410A	338-317-229	-	3933/23	12	13.785	-	[10.36]	-	LG	LSN120HSV5	30 x 12 x 7.5	18.30	208-230/160	-	-	1-3,5-4				

- NOTES:
1. MANUFACTURER TO PROVIDE HARDWIRED, WALL MOUNTED, PROGRAMMABLE THERMOSTAT.
 2. PROVIDE WITH 208V / 1 CONDENSATE PUMP TAGGED AS CDP-A (LITTLE GIANT MODEL VCCA-20ULST)
 3. DRAIN PAN LEVEL SENSOR THE UNIT SHALL TURN OFF IF WATER IS SENSED.
 4. ELECTRICAL CONTRACTOR TO PROVIDE DISCONNECT SWITCH.
 5. FURNISH AND INSTALL BACNET INTERFACE AND INTEGRATE WITH BMS.
 6. INSTALL ALL EQUIPMENT AND COMPONENTS ACCORDING TO MANUFACTURER'S INSTRUCTIONS. POWERED BY PAIRED CONDENSER.
 7. ELECTRICAL CONTRACTOR TO PROVIDE DISCONNECT SWITCH BETWEEN INDOOR AND OUTDOOR UNIT.
 8. PROVIDE PIPE COVER FOR ALL EXPOSED REFRIGERANT PIPING. PROVIDE C/J INNOVATIONS OR APPROVED EQUAL. COORDINATE FINISH WITH ARCHITECT/OWNER.

VRF BRANCH CONTROL BOXES

EQMT NO.	LOCATION	CNSR. PAIRING	# OF INDOOR UNIT PORTS	BASIS OF DESIGN INFORMATION						NOTES	
				MANUF.	MODEL NO.	NOMINAL DIMENSIONS L" x W" x H"	NOMINAL OPERATING WEIGHT (LBS.)	ELECTRICAL DATA	VOLTS/ PHASE		MCA
BC-1	FIRST FLOOR	CU-1	4	LG	PRR943A	19 x 19 x 8.5	40	208-230/1	0.17	15	1, 2
BC-2	FIRST FLOOR	CU-2	4	LG	PRR943A	19 x 19 x 8.5	40	208-230/1	0.17	15	1, 2
BC-3	SECOND FLOOR	CU-3	4	LG	PRR943A	19 x 19 x 8.5	40	208-230/1	0.17	15	1, 2
BC-4	SECOND FLOOR	CU-3	6	LG	PRR943A	31 x 19 x 8.5	60	208-230/1	0.27	15	1, 2

- NOTES:
1. PROVIDE BALL VALVES.
 2. CONDENSATE DRAIN NOT REQUIRED FOR THIS MANUFACTURER.

REFRIGERANT DENSITY CALCS

SYSTEM	EFFECTIVE PIPE LENGTH (FT.)	EFFECTIVE FURTHEST PIPE RUN (FT.)	TOTAL NUMBER OF ELBOWS	TOTAL REFRIGERANT AMOUNT (LBS)	ZONE SMALLEST SPACE, TOTAL AREA (SQFT.)	ZONE SMALLEST SPACE, TOTAL VOLUME (FT3)	REFRIGERANT DENSITY (LB/1000FT3)
CU-1 & 2	-	-	-	38.15 [NOTE 1]	503	4,024	19.64
CU-1	88	88	0	39.82 [NOTE 1]	42	336	9.91

- NOTES:
1. LINE LENGTHS ARE ESTIMATED BY MANUFACTURER VRF DESIGN SOFTWARE. REFRIGERANT LINE LENGTHS, SIZES & CHARGES TO BE VERIFIED BY EQUIPMENT MANUFACTURER.
 2. CONTRACTOR TO NOTIFY ENGINEER IF ADDITIONAL SYSTEM CHARGE IS REQUIRED.

ELECTRIC HEAT TRACE


EQMT. TAG	EQMT. SERVED	SERVING	DESIGN CONDITIONS				BASIS OF DESIGN INFORMATION				NOTES					
			NOMINAL PIPE SIZE (IN.)	MINIMUM OA TEMP. (°F)	PIPE TEMP. SETPOINT (°F)	STARTUP PIPE TEMP. (°F)	INSULATION TYPE	APPROXIMATE LENGTH REQUIRED (FT)	MANUF.	MODEL NO.		POWER OUTPUT (W/FT)	VOLTS/ PHASE	MOCP		
HT-D	HHWSR	DOAS-1	2	-10	40	35	2	FIBERGLASS	30'	THEMOM	S-FLX-2	5	150	208/1	20	1-2
HT-208	HHWSR	RTU-208	1	-10	40	35	1-1/2	FIBERGLASS	30'	THEMOM	S-FLX-2	5	150	208/1	20	1-2
HT-MAU	HHWSR	MAU-1	1	-10	40	35	1-1/2	FIBERGLASS	30'	THEMOM	S-FLX-2	5	150	208/1	20	1-2

- NOTES:
1. PROVIDE ALL REQUIRED TEMPERATURE SENSORS AND CONTROLS FOR A COMPLETELY FUNCTIONING HEAT TRACE SYSTEM.
 2. HEAT TRACE ASSOCIATED HOT WATER PIPING OUTDOORS. VALVES AND FITTINGS AS REQUIRED.

CONDENSATE DRAIN PUMPS

EQMT. NO.	SYSTEM SERVED	PERFORMANCE/CONSTRUCTION REQUIREMENTS				BASIS OF DESIGN INFORMATION						NOTES
		FLUID	MAX FLOW RATE (GPH)	MAX HEAD (FT.)	HP	MANUF.	MODEL NO.	DIMS. L x W x H	WEIGHT (LBS.)	VOLTS/ PHASE	POWER DRAW (W)	
CDP-A	SEE PLANS	WATER	48	10	1/30	LITTLE GIANT	VCCA-20ULST	11 x 5 x 7	6.3	115V/1	93	1-3

- NOTES:
1. UL RATED.
 2. OVERFLOW DETECTION SWITCH.
 3. 1/2 GALLON COLLECTION TANK.

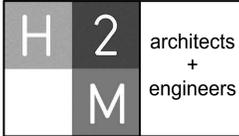

HEATING HOT WATER BOILERS

EQUIPMENT NO.	LOCATION	RATED GROSS INPUT (MBH)	RATED GROSS OUTPUT (MBH)	GAS (%)	PERFORMANCE/CONSTRUCTION REQUIREMENTS				BASIS OF DESIGN INFORMATION							NOTES					
					WATER DATA	GAS DATA			MANUFACTURER	MODEL NO.	NOMINAL DIMENSIONS (L x W x H)	WEIGHT (LBS)	ELECTRIC DATA								
FLOW RATE (GPM)	MAX. RATE PRESS. (PSIG)	INLET TEMP. (DEG. F)	OUTLET TEMP. (DEG. F)	CFH	MIN. PRESSURE (IN. W.C.)	MAX. PRESSURE (IN. W.C.)	BOILER VENT SIZE (IN)	VOLTAGE					FLA	MCA	MOCP						
WB-1 & BL-2	MECHANICAL ROOM	800	768.8	96.1	45.3	90	114	150	800	4	13.5	6	RIELO	ARRAY 800	29.5 x 52.5 x 63.5	926	115V/1	15.5	16	20	1-7

- ASME RELIEF VALVE - SET AT 50 PSI
- SINGLE POINT POWER FEED
- PROVIDE MULTIPLE LOW WATER CUTOFFS
- PROVIDE INTERLOCKS FOR GAS DETECTION AND BREAK GLASS STATION
- PROVIDE CONDENSATE TRAP AND TRANSPARENT NEUTRALIZATION KIT.
- PROVIDE IN THERMOSTAT.
- MANUFACTURER PROVIDED DISCONNECT SWITCH.
- OUTSIDE AIR TEMPERATURE SENSOR.
- CONTROLLED BY BMS

HEATING HOT WATER PUMPS

EQMT. NO.	LOCATION	SYSTEM SERVED	WORKING FLUID	FLOW RATE (GPM)	TOTAL HEAD (FT.)	HP	PUMP SPEED (RPM)	MNF	BASIS OF DESIGN INFORMATION				REMARKS
									MODEL NO.	NOMINAL DIMENSIONS (L x W x H)	NOMINAL OPERATING WEIGHT (LBS)	VOLTS/ PHASE	
HWP-1&2	MECHANICAL ROOM	BUILDING HW HEAT	WATER	70	65	3.0	1760	TACO	SKV-150D-A-2P-PD	22x19x20	246	208/3	1-8
HWP-3&4	MECHANICAL ROOM	RADIANT FLOOR	WATER	28	40	0.9	-	TACO	VR15H	16x7x15.5	226	208/1	2,4,6,8-10
HWP-5&6	MECHANICAL ROOM	UNIT HEATERS	WATER	20	35	0.6	-	TACO	VR15M	10x7x15	226	208/1	2,4,6,8-10

- OPEN DRIP PROOF MOTOR
- ANSI CLASS 125
- MANUFACTURER TO PROVIDE DISCONNECT SWITCH
- MANUFACTURER PROVIDED VFD
- SELF SENSING
- INTERLOCK WITH BMS
- PROVIDE WITH BASE STAND AND SUPPLEMENTAL STEEL AS REQUIRED
- PROVIDE S2020N15-S SUCTION DIFFUSER
- PROVIDE BPP 615-4 MULTIPURPOSE VALVE
- PROVIDE ALARM HORN WITH STROBE
- PROVIDE STARTUP, TEST AND CALIBRATION REPORT
- ELECTRICAL CONTRACTOR TO PROVIDE DISCONNECT SWITCH

AIR/DIRT SEPARATORS

EQMT. NO.	LOCATION	SYSTEM SERVED	PERFORMANCE REQUIREMENTS	BASIS OF DESIGN INFORMATION				NOTES	
				FLOW RATE (GPM)	MAX. PD (FT. H2O)	MNF	MODEL NO.		NOMINAL DIMENSION DIA. x H
ADS-1	BOILER ROOM	HOT WATER LOOPS	118	1.07	TACO	4904AD-125	12 x 25	75	1-2

- AIR VENT
- BLOW DOWN PIPED TO DRAIN

EXPANSION TANKS

EQUIPMENT NO.	LOCATION	SYSTEM SERVED	PERFORMANCE/CONSTRUCTION REQUIREMENTS			BASIS OF DESIGN INFORMATION				REMARKS	
			ESTIMATED VOLUME (GAL.)	MAX. OPERATING PRESS. RANGE (PSIG)	MAX. OPERATING TEMP. RANGE (°F)	MNF	MODEL NO.	NOMINAL DIMENSION DIA. x H	TANK VOLUME (GAL.)		SHIPPING WEIGHT (LBS.)
ET-1	BOILER ROOM	HOT WATER	500	17-47	40-150	TACO	CA10A-150	16 x 40.5	37	195	1

- CHARGE OF EXPANSION TANK SHALL BE ADJUSTED TO MATCH THE PRESSURE AT THE POINT WHERE THE TANK IS CONNECTED TO THE PIPING.

FIN TUBE RADIATOR

EQMT. NO.	AREA SERVED	TOTAL CAPACITY (MBH)	PERFORMANCE / CONSTRUCTION REQUIREMENTS					MNF	MODEL NO.	NOMINAL DIMENSIONS L"XW"XH"	REMARKS
			HEATING COIL DATA								
			BTU/FT	PIPE DIA.	FINS/FT	FIN DIMS W" x H"	GPM				
FTR-116-1	116 MEETING	5.2	5/8	3/4"	50	4.25 X 4.25	2.5	MOODINE	9012	6' x 5.25" 12"	1-2
FTR-116-2	116 MEETING	5.2	5/8	3/4"	50	4.25 X 4.25	2.5	MOODINE	9012	6' x 5.25" 12"	1-2
FTR-116-3-1	116 MEETING	4.1	5/8	3/4"	50	4.25 X 4.25	2.5	MOODINE	9012	8' x 5.25" 12"	1-2
FTR-116-3-2	116 MEETING	4.1	5/8	3/4"	50	4.25 X 4.25	2.5	MOODINE	9012	8' x 5.25" 12"	1-2
FTR-116-4	116 MEETING	9.3	5/8	3/4"	50	4.25 X 4.25	2.5	MOODINE	9012	18' x 5.25" 12"	1-2
FTR-116-5	116 MEETING	8.3	5/8	3/4"	50	4.25 X 4.25	2.5	MOODINE	9012	16' x 5.25" 12"	1-2
FTR-120-1	120 READY ROOM	4.1	5/8	3/4"	50	4.25 X 4.25	2.5	MOODINE	9012	8' x 5.25" 12"	1-2
FTR-120-2	120 READY ROOM	2.1	5/8	3/4"	50	4.25 X 4.25	2.5	MOODINE	9012	4' x 5.25" 12"	1-2
FTR-202-1	202 CONFERENCE	5.2	5/8	3/4"	50	4.25 X 4.25	2.5	MOODINE	9012	10' x 5.25" 12"	1-2
FTR-202-2	202 CONFERENCE	5.2	5/8	3/4"	50	4.25 X 4.25	2.5	MOODINE	9012	10' x 5.25" 12"	1-2
FTR-203A-1	COMPANY ROOM 203A	6.2	5/8	3/4"	50	4.25 X 4.25	2.5	MOODINE	9012	12' x 5.25" 12"	1-2
FTR-203A-2	COMPANY ROOM 203A	6.2	5/8	3/4"	50	4.25 X 4.25	2.5	MOODINE	9012	12' x 5.25" 12"	1-2
FTR-203A-3	COMPANY ROOM 203A	3.1	5/8	3/4"	50	4.25 X 4.25	2.5	MOODINE	9012	6' x 5.25" 12"	1-2
FTR-203A-4	COMPANY ROOM 203A	2.1	5/8	3/4"	50	4.25 X 4.25	2.5	MOODINE	9012	4' x 5.25" 12"	1-2
FTR-203A-5	COMPANY ROOM 203A	1.5	5/8	3/4"	50	4.25 X 4.25	2.5	MOODINE	9012	3' x 5.25" 12"	1-2
FTR-206-1	TRAINING ROOM 206	6.2	5/8	3/4"	50	4.25 X 4.25	2.5	MOODINE	9012	12' x 5.25" 12"	1-2
FTR-206-2	TRAINING ROOM 206	2.1	5/8	3/4"	50	4.25 X 4.25	2.5	MOODINE	9012	4' x 5.25" 12"	1-2
FTR-206-3	TRAINING ROOM 206	2.6	5/8	3/4"	50	4.25 X 4.25	2.5	MOODINE	9012	5' x 5.25" 12"	1-2
FTR-206-4	TRAINING ROOM 206	2.6	5/8	3/4"	50	4.25 X 4.25	2.5	MOODINE	9012	5' x 5.25" 12"	1-2
FTR-210-1	CORRIDOR 210	10.3	5/8	3/4"	50	4.25 X 4.25	2.5	MOODINE	9012	20' x 5.25" 12"	1-2
FTR-210-2	CORRIDOR 210	5.2	5/8	3/4"	50	4.25 X 4.25	2.5	MOODINE	9012	10' x 5.25" 12"	1-2
FTR-212	211 OFFICE	4.1	5/8	3/4"	50	4.25 X 4.25	2.5	MOODINE	9012	8' x 5.25" 12"	1-2
FTR-213	212 OFFICE	4.1	5/8	3/4"	50	4.25 X 4.25	2.5	MOODINE	9012	8' x 5.25" 12"	1-2
FTR-214	213 OFFICE	2.6	5/8	3/4"	50	4.25 X 4.25	2.5	MOODINE	9012	5' x 5.25" 12"	1-2
FTR-215	214 OFFICE	3.1	5/8	3/4"	50	4.25 X 4.25	2.5	MOODINE	9012	6' x 5.25" 12"	1-2
FTR-216	215 OFFICE	3.1	5/8	3/4"	50	4.25 X 4.25	2.5	MOODINE	9012	6' x 5.25" 12"	1-2

- PROVIDE ALL CORNER SECTIONS, END PANELS, SUPPORTS AND ACCESSORIES AS REQUIRED TO PROVIDE CONTINUOUS ENCLOSE.
- PROVIDE SPACE MOUNTED THERMOSTAT AND CONTROL VALVE (CV = 4.6 MINIMUM).

CONTROL VALVES

EQMT. NO.	QTY.	VALVE FAMILY	CONFIG.	FAIL POSITION	VALVE SIZE	PERFORMANCE/CONSTRUCTION REQUIREMENTS							NOTES		
						MEDIUM	VALVE COEFFICIENT (CV)	VALVE CLOSE OFF (PSI)	TRIM MATERIAL	CONNECTION	MNF.	MODEL NUMBER		ACTUATOR POWER	ACTUATOR CONTROL
MV-1	1	BALL VALVE	3-WAY	LAST POSITION	1-1/2"	WATER	23.5	40	BRASS	THREADED	GRSWSOLD CONTROLS	URSEF8M	24VC	2-10VDC MODULATING	1-5

- MANUFACTURER TO PROVIDE TIP STARTER DISCONNECT SWITCH TO BE INSTALLED BY ELECTRICAL CONTRACTOR.
- ELECTRICAL TO PROVIDE WITH LINE VOLTAGE WALL MOUNTED THERMOSTAT.
- MANUFACTURER TO PROVIDE WITH ADJUST KIT.
- MANUFACTURER TO PROVIDE WITH CEILING SUSPENSION KIT.
- INTERLOCK WITH APPARATUS BAY DOORS

WALL MOUNTED ELECTRIC HEATERS

EQMT. NO.	LOCATION	FLOW (CFM)	TOTAL CAPACITY (MBH)	PERFORMANCE/CONSTRUCTION REQUIREMENTS			BASIS OF DESIGN INFORMATION					NOTES
				HEATING COIL DATA	ELECTRIC DATA		MNF	MODEL NO.	NOMINAL DIMENSIONS L" x W" x H"	NOMINAL OPERATING WEIGHT (LBS.)		
ENT. TEMP. (DEG. F)	LVG. TEMP. (DEG. F)	FLOW (GPM)	MAX. P.D. (FT. H2O)	VOLTS/PHASE	TOTAL KW	AMPS						
WEH-112	112 VENDOR DROPOFF	100	5.1	208/1	1.5	7.2	QMARK / MARLEY	AWH44048*	16 x 4 x 19.5	25	1-3	

- FIELD WIRING FOR HALF WATTAGE, COORDINATE WITH 'E' AND MANUFACTURER'S INSTALLATION INSTRUCTIONS.

RADIANT FLOOR MANIFOLDS

EQMT. NO.	AREA SERVED	FLOOR AREA SERVED (FT²)	PERFORMANCE/CONSTRUCTION REQUIREMENTS					NOTES		
			TOTAL CAPACITY (BTU/HR)	HEATING COIL DATA		MNF	MODEL NO.		NOMINAL DIMENSIONS L" x W" x H"	
EWT (°F)	GPM	CIRCUITS								
RFM-1	APPARATUS ROOM	2429	98621	123.6	9.7	10	UPONOR	A2721002	28 x 3.5 x 14.5	1-5
RFM-2	APPARATUS ROOM	2593	102663	123.6	10	10	UPONOR	A2721002	28 x 3.5 x 14.5	1-5
RFM-3	APPARATUS ROOM	266	8962	123.6	0.9	2	UPONOR	A2720202	11 x 3.5 x 14.5	1-5
RFM-4	APPARATUS ROOM	895	26534	123.6	2.4	4	UPONOR	A2720402	15 x 3.5 x 14.5	1-5
RFM-5	APPARATUS ROOM	260	6376	123.6	0.6	2	UPONOR	A2720202	11 x 3.5 x 14.5	1-5
RFM-6	APPARATUS ROOM	217	6973	123.6	0.7	2	UPONOR	A2720202	11 x 3.5 x 14.5	1-5
RFM-7	APPARATUS ROOM	229	6520	123.6	0.6	2	UPONOR	A2720202	11 x 3.5 x 14.5	1-5

- MANUFACTURER TO PROVIDE DISCONNECT SWITCH TO BE INSTALLED BY ELECTRICAL CONTRACTOR.

GAS DETECTION SYSTEM

EQMT. NO.	LOCATION	SYSTEM SERVED	BASIS OF DESIGN INFORMATION				REMARKS
			MNF	MODEL NO.	NOMINAL DIMENSIONS L" x W" x H"	VOLTAGE / PHASE	
GBS-1	MECHANICAL ROOM	BOILERS BL-1, BL-2	R90 BEACON	416A (4 CHANNEL)	10.5 x 6.5 x 14	120/1	1-7

- INCLUDE TWO CHANNEL DIGITAL CONTROLLER IN NEMA 4 ENCLOSURE FOR WALL MOUNT.
- LED DISPLAY FOR LEL AND CO.
- INCLUDE COMBUSTIBLE GAS SENSOR AND CARBON MONOXIDE SENSOR.
- PROVIDE CONFIGURABLE ALARM OUTPUTS WITH ISOLATION RELAYS FOR INTERLOCK WITH BOILER AND FACP.
- PROVIDE PANEL MOUNTED ADJUSTABLE ALARM AND SILENCING SWITCH
- PROVIDE ALARM HORN WITH STROBE
- PROVIDE STARTUP, TEST AND CALIBRATION REPORT

" VIBRATION ISOLATION / SEISMIC & WIND RESTRAINTS SCHEDULE [2020 New York State Building Code, SD C = C, RISK CAT = IV]"


UNIT TAG	EQUIPMENT TYPE	LOCATION (FLOOR LEVEL)	MOUNTING METHOD	BASE TYPE	MANUF	ISOLATOR TYPE	NOM. DEFL. IN	RESTRAINT REQ'D	SEISMIC COMPONENT IMPORTANCE FACTOR, I _p	NOTES (1, 2, TYP.)
HVLS-1,2,3	HVLS FANS	VARIOUS	SUSPENDED	---	VIBRO-ACOUSTICS	---	---	SEIS	1.5	6
GX-1	EXHAUST FANS	MECH MEZ	SUSPENDED	---	VIBRO-ACOUSTICS	SHR	2.00	SEIS	1.5	6,7
GX-4, TX-1	EXHAUST FANS	ROOF	---	---	VIBRO-ACOUSTICS	---	---	SEIS/WIND	1.5	---
VX [TBO]	VEHICLE EXHAUST	MECH MEZ	SUSPENDED	---	VIBRO-ACOUSTICS	SHR	2.00	SEIS	1.5	6,7
LRS-1	AIR SCRUBBERS	GEAR ROOM	SUSPENDED	---	VIBRO-ACOUSTICS	---	---	SEIS	1.5	6
RTU-207, DOAS-1	ROOFTOP UNITS	ROOF	ROOF	RC	VIBRO-ACOUSTICS	VCR	2.00	SEIS/WIND	1.5	---
CU-1, 2, CU-1	CONDENSING UNIT	ROOF	ROOF	---	VIBRO-ACOUSTICS	NP	0.18	SEIS/WIND	1.5	---
EU-102 THRU 215	SPLIT SYSTEM INDOOR	VARIOUS	SUSPENDED	---	VIBRO-ACOUSTICS	SHR	1.00	SEIS	1.5	6, 7
BC-1, 2, 3, 4	VRF BRANCH CONTROL	VARIOUS	SUSPENDED	---	VIBRO-ACOUSTICS	---	---	SEIS	1.5	6
BL-1, 2	BOILER	MECH ROOM	FLOOR	---	VIBRO-ACOUSTICS	NP	0.18	SEIS	1.5	4, 5
HWP1 THRU 6	PUMPS	MECH ROOM	FLOOR	CIB	VIBRO-ACOUSTICS	SFS+ SIPS	2.00	SEIS	1.5	4, 5
ADS-1	AIR DIRT SEPARATOR	MECH ROOM	SUSPENDED	---	VIBRO-ACOUSTICS	---	---	SEIS	1.5	6
ET-1	EXPANSION TANK	MECH ROOM	FLOOR	---	VIBRO-ACOUSTICS	---	---	SEIS	1.5	6
CUH-A, B, 129	CABINET UNIT HEATER	VARIOUS	SUSPENDED	---	VIBRO-ACOUSTICS	SHR	2.00	SEIS	1.5	6, 7
UH-1 THRU 4	UNIT HEATER	VARIOUS	SUSPENDED	---	VIBRO-ACOUSTICS	SHR	2.00	SEIS	1.5	6, 8
KITCHEN HOOD	KITCHEN HOOD	KITCHEN	SUSPENDED	---	VIBRO-ACOUSTICS	---	---	SEIS	1.5	6
MAU-118	MAKE-UP AIR	ROOF	ROOF	RC	VIBRO-ACOUSTICS	VCR	2.00	SEIS/WIND	1.5	---
KX-118	EXHAUST FANS	ROOF	ROOF	---	VIBRO-ACOUSTICS	---	---	SEIS/WIND	1.5	6, 7
DUCTWORK (2' x 6' CLEAR AREA)	DUCTWORK	VARIOUS	SUSPENDED	---	VIBRO-ACOUSTICS	---	---	SEIS	1.5	---
HVAC PIPING (>2" NOMINAL DIAMETER)	PIPING	VARIOUS	SUSPENDED	---	VIBRO-ACOUSTICS	---	---	SEIS	1.5	---

- BASIS OF DESIGN: VIBRO-ACOUSTICS
- SEISMICALLY RATED FOR PROJECT CONDITIONS
- STAND SUPPORT MUST BE ABLE TO MEET CALCULATED SEISMIC LOADS
- PROVIDE FLEXIBLE PIPING CONNECTORS
- PROVIDE TYPE SHR OR SFS ISOLATORS ON ADJACENT PIPING/DUCTWORK
- PROVIDE SEISMIC RESTRAINT CABLES. PROVIDE ROD STIFFENERS AS REQUIRED.
- PROVIDE SEISMIC UPLIFT STRIP WASHER.
- SUPPORT INLINE PUMP AT FLANGE CONNECTION.

CABINET UNIT HEATERS


EQMT. NO.	LOCATION	CONFIGURATION	FAN DATA		TOTAL CAPACITY (MBH)	AIR DATA		HEATING COIL DATA				BASIS OF DESIGN INFORMATION				NOTES	
			FLOW (CFM)	HP		ENT. DB TEMP. (DEG. F)	LVG. DB TEMP. (DEG. F)	ENT. TEMP. (DEG. F)	LVG. TEMP. (DEG. F)	FLOW (GPM)	MAX. P.D. (FT. H2O)	MNF	MODEL NO.	NOMINAL DIMENSIONS L x W x H	NOMINAL OPERATING WEIGHT (LBS.)		
CUH-A	STAIR A	STANDALONE CABINET	280	0.93	115W/1	10.2	70	98	150	122.1	1.5	0.20	MOODINE	C 0030	44 x 9.5 x 25	90	1, 2
CUH-B	STAIR B	CEILING MOUNTED	280	0.93	115W/1	10.2	70	98	150	122.1	1.5	0.20	MOODINE	CW 0035	44 x 9.5 x 25	100	2, 3

* PIPING ON EXTERIOR OF BUILDING, HEAT TRACED.

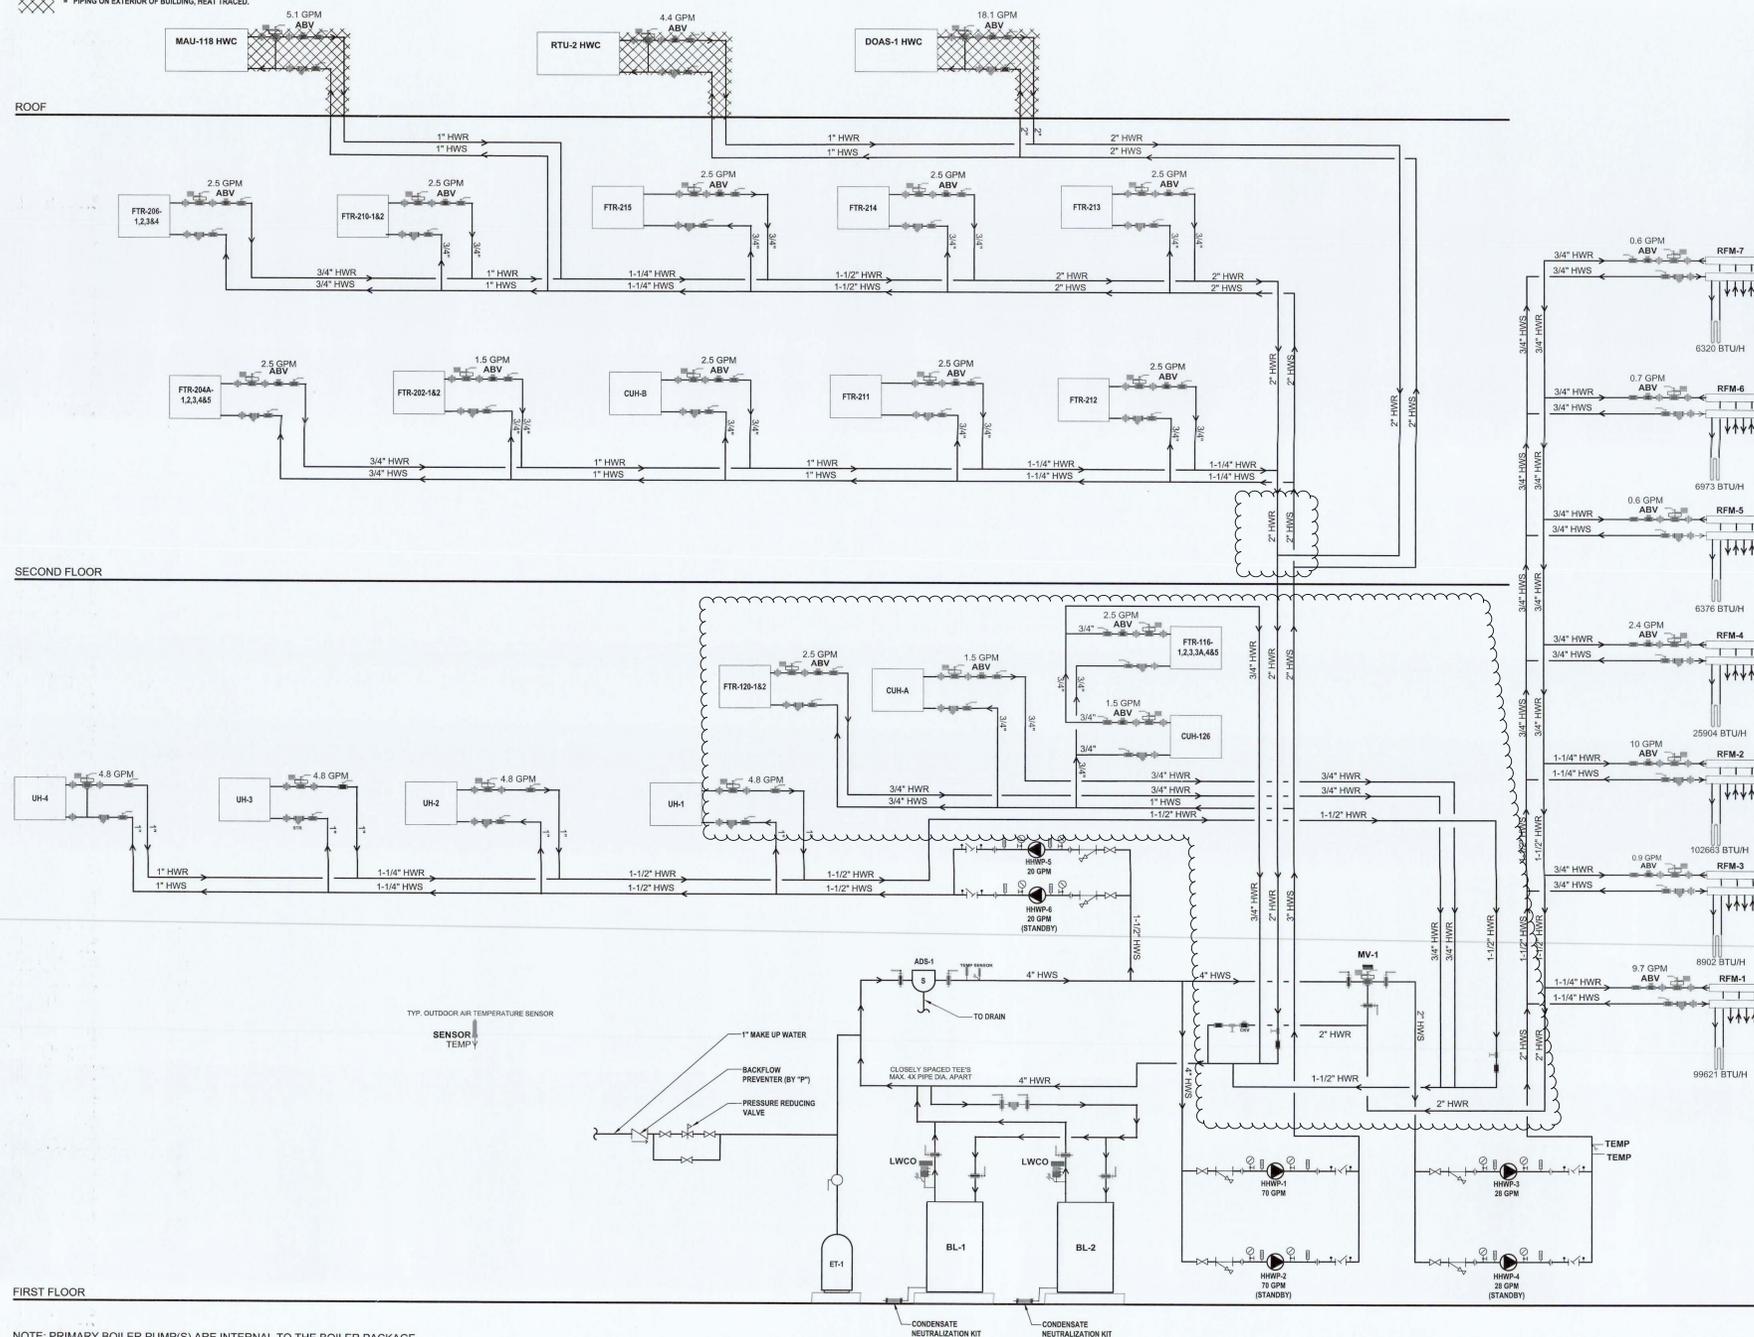

FIRST FLOOR

NOTE: PRIMARY BOILER PUMP(S) ARE INTERNAL TO THE BOILER PACKAGE

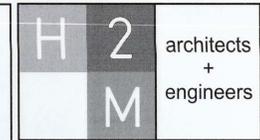

538 Broad Hollow Road, 4th Floor East
Melville, NY 11747
631.756.8000 • www.h2m.com

CONSULTANTS:

MARK	DATE	DESCRIPTION
2	12/22/2022	REVS. PER TOWN COMMENTS

DESIGNED BY: [] DRAWN BY: [] CHECKED BY: [] REVISIONS BY: []
PROJECT NO.: VGF02001 DATE: JULY 2022 SCALE: AS SHOWN

VAILS GATE FIRE DISTRICT

New Storage Building (Phase I)
New Fire Station (Phase II)

872 Blooming Grove Turnpike
New Windsor, NY 12553

CONTRACT G
GENERAL CONSTRUCTION

STATUS
FINAL BID DOCUMENT

SHEET TITLE
HVAC FLOW DIAGRAM (1 OF 1)

DRAWING NO.
M2 640.02

